

2100 AND 2150 NW LOWENSTEIN DR. LEE'S SUMMIT, MISSOURI 64081

PROJECT NO.: 20-001

ISSUE DATE: 3.1.2022 Revision 2

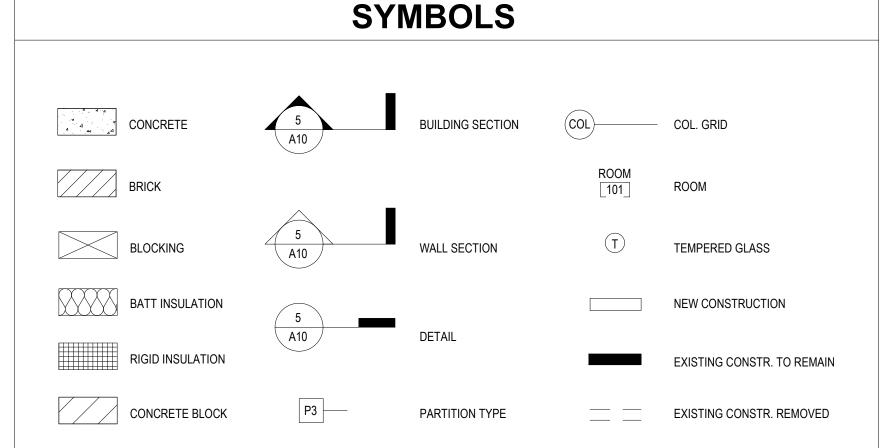
GENERAL NOTES AIA DOCUMENT A-201, GENERAL CONDITIONS OF THE CONTRACT FOR CONSTRUCTION, CURRENT EDITION, AND SPECIAL CONDITIONS AS NOTED IN

- ONLY CONTRACT DOCUMENTS APPROVED FOR CONSTRUCTION AND REVIEWED SHOP DRAWINGS SHALL BE USED FOR CONSTRUCTION. GENERAL
- IT SHALL BE THE RESPONSIBILITY OF THE GENERAL CONTRACTOR TO COORDINATE THE SUBCONTRACTOR WORK WITH THESE PROJECT
- DO NOT SCALE DRAWINGS.

- REFERENCE CIVIL DRAWINGS FOR SITE WORK, INCLUDING THE BUILDING LOCATION ON THE SITE.

	ABBI	REVIA	TIONS		
ABV	ABOVE	HDWD	HARDWOOD	SCHED	SCHEDULE
AFF	ABOVE FINISH FLOOR	HDPB	HIGH DENSITY	SECT	SECTION
ACT	ACOUSTICAL		PARTICLE BOARD	SHT	SHEET
ALUM	ALUMINUM	HT	HEIGHT	SIM	SIMILAR
&	AND	HR	HOUR	SC	SOLID CORE
@	AT	INIOLII	INIONII ATIONI	SPEC	SPECIFICATION
DUZ	DI OOK	INSUL	INSULATION	SQ	SQUARE
BLK	BLOCK	IT.	IOINT	SF	SQUARE FOOT
BD BO	BOARD BOTTOM OF	JT	JOINT	SS	STAINLESS STEEL
ВО	BOTTOM OF	1.41/	LAVATORY	STD STL	STANDARD
CLG	CEILING	LAV	LAVATORY	STRUCT	STEEL STRUCTURAL
€ CT	CENTER LINE	MO	MASONRY OPENING	SUSP	SUSPENDED
СŢ	CERAMIC TILE	MSRY	MASONRY	3035	SUSPENDED
CLR	CLEAR	MDF	MEDIUM DENSITY	TEL	TELEPHONE
CONC	CONCRETE		FIBERBOARD	THK	THICK
CMU	CONC. MASONRY UNIT	MECH	MECHANICAL	TO	TOP OF
CONT	CONTINOUS	MTL	METAL	T&G	TONGUE & GROOVE
CONTR	CONTRACTOR			TYP	TYPICAL
CFCI	CONTRACTOR FURNISHED	NIC	NOT IN CONTRACT		
	CONTRACTOR INSTALLED	NTS	NOT TO SCALE	UNF	UNFINISHED
CJ	CONTROL JOINT		1101 10 00/122	UNO	UNLESS NOTED OTHERWISE
CG	CORNER GUARD	OFCI	OWNER FURNISHED CONTRACTOR INSTALLED	VERT	VERTICAL
DTL	DETAIL	OFOI	OWNER FURNISHED	VEST	VESTIBULE
DIA	DIAMETER		OWNER INSTALLED		
DR	DOOR	OC	ON CENTER	WP	WATERPROOF
DS DWG	DOWNSPOUT DRAWING	OPNG	OPENING	WT	WEIGHT
DWG	DRAWING			W/	WITH
EOS	EDGE OF SLAB	PTD	PAINTED	W/O	WITH OUT
ELEC	ELECTRICAL	PLAM	PLASTIC LAMINATE	WD	WOOD
ELEV	ELEVATION	PLYWD PT	PLYWOOD		
EQ	EQUAL	PI	PRESSURE TREATED		
EQUIP	EQUIPMENT	RAD	RADIUS		
EXIST	EXISTING	RE:	REFERENCE		
EJ	EXPANSION JOINT	REINF	REINFORCING		
FT	FEET	RCP	REFLECTED CEILING PLAN		
FG	FINISH GRADE	REQ'D	REQUIRED		
FF	FINISH FLOOR	RD	ROOF DRAIN		
FR	FIRE RETARDANT	RM	ROOM		
FL	FLOOR	RO	ROUGH OPENING		
00	OFNEDAL CONTE				
GC GYP	GENERAL CONTR. GYPSUM				
GIF	GIFOUN				





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PROJECT DIRECTORY

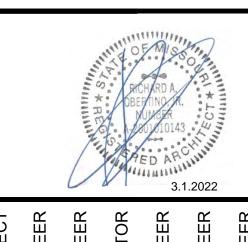
General Contractor BRINKMANN CONSTRUCTORS 8700 INDIAN CREEK PARKWAY SUITE 150 OVERLAND PARK, KANSAS 66210 Phone: 785.554.2280 Contact: SCOTT GRAUSE

SM ENGINEERING Phone: 785.341.9747 Contact: SAM MALINOWSKY *FOR COMPLETE CODE ANALYSIS SEE LIFE SAFETY PLAN SHEET AXXX - AXXX PROJECT NAME: The Signature at West Pryor PROJECT ADDRESS: 2100 AND 2150 NW LOWENSTEIN LEE'S SUMMIT, MISSOURI 64081 PROJECT DESCRIPTION: DESCRIPTION **BUILDING CODES:** 2018 International Building Code 2017 National Electric Code 2018 International Mechanical Code 2018 International Plumbing Code 2018 International Fire Code 2018 International Energy Conservation Code **ACCESSIBILITY** 2010 ADA Guidelines & 2009 ICC/ANSI A117.1 & FAIR HOUSING ACT

OCCUPANCY TYPE / USE GROUP: R-2

PROJECT SUMMARY

LOCATION MAP HIGHVIEW — PROJECT LOCATION



ARCHITECTS

REVISIONS /#\

Revision 2

DWG BY

SHEET NO.

TR,i PROJECT NO.

COVER SHEET

7.15.2021

3.1.2022

	DRAWING IND	EX						
= REIS	SED SHEET SUED SHEET/NO REVISION ED AS 8.5x11							
			121	1.2021				
		BID / PERMIT SET 7.15.2021	COMMENTS 8.17.2021	FOUNDATION PERMIT 10.11.2021	022	52		
		IT SET 7	MMENT	ON PERI	-2.11.2	- 3.1.2022		
		/ PERM	PERMIT CO	JNDATIC	REVISION 1 - 2.11.2022	REVISION 2		
A000	ARCHITECTURAL COVER SHEET	• BID	o PER	· F0L	∘ RE	° RE		
A001 A002	SHEET INDEX ACCESSIBILITY REQUIREMENTS - TYPE A UNITS ACCESSIBILITY REQUIREMENTS - TYPE B LINITS	•	0	•	0	0		_
A003 A004 A010	ACCESSIBILITY REQUIREMENTS -TYPE B UNITS SOUND TRANSMISSION ASSEMBLIES BLDG 1 - LIFE SAFETY PLAN	•						_
A010 A011 A012	BLDG 1 - LIFE SAFETY PLAN BLDG 1 - LIFE SAFETY PLAN	•						_
A013 A014	BLDG 2 - LIFE SAFETY PLAN BLDG 2 - LIFE SAFETY PLAN	•						
A015 A016	BLDG 2 - LIFE SAFETY PLAN ENLARGED AMENITY LIFE SAFETY PLANS	•						
A017 A018 A020	UNIT LIFE SAFETY PLANS MAINTENANCE / POOL HOUSE LIFE SAFETY PLAN ARCHITECTURAL SITE PLAN	•	•		•			_
A020 A021 A022	SITE DETAILS MAINTENANCE SHED / POOL HOUSE	•	•					
A023 A024	BLDG 1 - FIRST FLOOR ADDRESS PLAN BLDG 1 - SECOND FLOOR ADDRESS PLAN	•	•					_
A025 A026	BLDG 1 - THIRD FLOOR ADDRESS PLAN BLDG 2 - FIRST FLOOR ADDRESS PLAN	•	•					F
A027 A028	BLDG 2 - SECOND FLOOR ADDRESS PLAN BLDG 2 - THIRD FLOOR ADDRESS PLAN	•	•					F
A030 A031	PARTITION TYPES FLOORING / ROOFING ASSEMBLIES	•			•			
A040 A041	DOOR SCHEDULE DOOR DETAILS	•	•		•			
A042 A043 A050	DOOR DETAILS FIRE DOOR DETAILS WINDOW SCHEDULE & DETAILS	•	•		•			_
A050 A051 A055	WINDOW SCHEDULE & DETAILS WINDOW DETAILS STOREFRONT SCHEDULE	•			•			
A056 A057	STOREFRONT SCHEDULE STOREFRONT SCHEDULE	•			•			
A058 A059	STOREFRONT DETAILS STOREFRONT DETAILS	•			•			-
A060 A101	UNIT SCHEDULE BLDG 1 - FIRST FLOOR PLAN	•						
A101A A101B	BLDG 1-A - ENLARGED FIRST FLOOR PLAN BLDG 1-B & C - ENLARGED FIRST FLOOR PLAN	•			•	•		
A101D A102	BLDG 1-D - ENLARGED FIRST FLOOR PLAN BLDG 1 - SECOND FLOOR PLAN BLDG 1-A - ENLARGED SECOND FLOOR PLAN	•				•		
A102A A102B A102D	BLDG 1-A - ENLARGED SECOND FLOOR PLAN BLDG 1-B & C - ENLARGED SECOND FLOOR PLAN BLDG 1-D - ENLARGED SECOND FLOOR PLAN	•				•		_
A102D A103 A103A	BLDG 1-D - ENLARGED SECOND FLOOR PLAN BLDG 1-A - ENLARGED THIRD FLOOR PLAN	•				•		
A103B A103D	BLDG 1-B & C - ENLARGED THIRD FLOOR PLAN BLDG 1-D - ENLARGED THIRD FLOOR PLAN	•				•		+
A110 A121	BLDG 1 - ROOF PLAN BLDG 2 - FIRST FLOOR PLAN	•	•		•			
A121A A121B	BLDG 2-A - ENLARGED FIRST FLOOR PLAN BLDG 2-B - ENLARGED FIRST FLOOR PLAN	•			•	•		
A121C A122	BLDG 2-C - ENLARGED FIRST FLOOR PLAN BLDG 2 - SECOND FLOOR PLAN BLDG 2-A - ENLARGED SECOND FLOOR PLAN	•			•	_		
A122A A122B A122C	BLDG 2-A - ENLARGED SECOND FLOOR PLAN BLDG 2-B - ENLARGED SECOND FLOOR PLAN BLDG 2-C - ENLARGED SECOND FLOOR PLAN	•				•		_
A123 A123A	BLDG 2- THIRD FLOOR PLAN BLDG 2-A - ENLARGED THIRD FLOOR PLAN	•				•		H
A123B A123C	BLDG 2-B - ENLARGED THIRD FLOOR PLAN BLDG 2-C - ENLARGED THIRD FLOOR PLAN	•						
A124 A130	BLDG 2 - ROOF PLAN BLDG 1 - FIRST FLOOR RCP	•	•		•			
A131 A132	BLDG 1 - SECOND FLOOR RCP BLDG 1 - THIRD FLOOR RCP BLDG 2 - FIRST FLOOR RCP	•						_
A140 A141 A142	BLDG 2 - FIRST FLOOR RCP BLDG 2 - THIRD FLOOR RCP	•						_
A150 A151	BLDG 1 - ENLARGED AMENITY PLAN BLDG 1 - ENLARGED AMENITY RCP	•						_
A160 A200	BLDG 2 - ENLARGED AMENITY PLANS BLDG 1 - OVERALL EXTERIOR ELEVATIONS	•			•			
A201 A202	BLDG 1 - ENLARGED SOUTHWEST & WEST ELEVATIONS BLDG 1 - ENLARGED SOUTH ELEVATIONS	•			•			
A203 A204	BLDG 1 - ENLARGED EAST & NORTHEAST ELEVATIONS BLDG 1 - ENLARGED NORTH & NORTHWEST ELEVATIONS	•			•	•		_
A220 A221 A222	BLDG 2 - OVERALL EXTERIOR ELEVATIONS BLDG 2 - ENLARGED EAST ELEVATIONS BLDG 2 - ENLARGED NORTH ELEVATIONS	•			•	•		
A223 A224	BLDG 2 - ENLARGED NORTH ELEVATIONS BLDG 2 - ENLARGED SOUTH ELEVATIONS BLDG 2 - ENLARGED SOUTH ELEVATIONS	•			•	•		_
A230 A300	VENT & LOUVER ELEVATIONS BUILDING 1 SECTIONS	•			•			_
A301 A302	BUILDING 2 SECTIONS MAINTENANCE/POOL BUILDING & WALL SECTIONS	•	•		•			
A310 A311	WALL SECTIONS WALL SECTIONS	•			•			f
A312 A313	WALL SECTIONS WALL SECTIONS	•			•			_
A314 A315 A316	WALL SECTIONS WALL SECTIONS	•			•			+
A316 A317 A318	WALL SECTIONS WALL SECTIONS WALL SECTIONS	•			•			+
A350 A351	WALL SECTIONS WALL SECTION DETAILS WALL SECTION DETAILS	•	•		•			+
A352 A360	WALL SECTION DETAILS TREX BALCONY DETAILS	•	•		•		_	
A361 A362	CONCRETE BALCONY DETAILS BALCONY RAILING DETAILS	•						_
A365 A366	BLDG 1 CANOPY PLANS & DETAILS BLDG 2 CANOPY PLANS & DETAILS COLUMN PLAN DETAILS	•						<u></u>
A370 A371 A401	COLUMN PLAN DETAILS PLAN DETAILS UNIT A1, A1.1 & A1.2 - PLANS AND ELEVATIONS	•	•					_
A401 A402 A403	UNIT A2 - PLANS AND ELEVATIONS UNIT A3 - PLANS AND ELEVATIONS	•						-
A404 A405	UNIT A4 - PLANS AND ELEVATIONS UNIT A4-TYPE A - PLANS AND ELEVATIONS	•			•	•		-
A406 A407	UNIT A5 - PLANS AND ELEVATIONS UNIT B1, B1.1, B1.2 & B1.3 - PLANS AND ELEVATIONS	•			•			_
A408 A409	UNIT B1 - TYPE A - PLANS AND ELEVATIONS UNIT B2 - PLANS AND ELEVATIONS UNIT B2 TYPE A DI ANS AND ELEVATIONS	•			•	•		-
A410 A411 A412	UNIT B2-TYPE A - PLANS AND ELEVATIONS UNIT B3 & B3.1 - PLANS AND ELEVATIONS UNIT B4 - PLANS AND ELEVATIONS	•			•	•		_
A412 A413 A414	UNIT C1 & C1.1 - PLANS AND ELEVATIONS UNIT C2 & C2.1 - PLANS AND ELEVATIONS	•						+
A414 A415 A420	UNIT C2 - TYPE A - PLANS AND ELEVATIONS UNIT DETAILS	•			•	•		<u></u>
A421 A500	UNIT DETAILS BLDG 1 STAIR A - PLAN & SECTIONS	•			•			<u> </u>
A501 A502	BLDG 1 STAIR B - PLAN & SECTIONS BLDG 1 STAIR C - PLAN & SECTIONS	•			•			F
A503 A520	BLDG 1 STAIR D - PLAN & SECTIONS BLDG 2 STAIR A - PLAN & SECTIONS BLDG 2 STAIR B. PLAN & SECTIONS	•			•			<u> </u>
A521 A522	BLDG 2 STAIR B - PLAN & SECTIONS BLDG 2 STAIR C - PLAN & SECTIONS	•			•			_
A523	BLDG 2 STAIR D - PLAN & SECTIONS	•			•	1		

	ARCHITECTURAL	BID / PERMIT SET 7.15.2021	PERMIT COMMENTS 8.17.2021	FOUNDATION PERMIT 10.11.2021	REVISION 1 - 2.11.2022	REVISION 2 - 3.1.2022		
A541	BLDG 2 ELEVATOR - PLAN & SECTIONS	•			•			
A600	BLDG 1 - INTERIOR ELEVATIONS	•	•		•			
A601	BLDG 1 - INTERIOR ELEVATIONS	•	•					
A650	BLDG 2 - INTERIOR ELEVATIONS	•	•					
A651	BLDG 2 - INTERIOR ELEVATIONS	•						
A700	FINISH SCHEDULE	•						
A701	BLDG 1 - FIRST FLOOR FINISH PLAN	•	•					
A702	BLDG 1 - SECOND FLOOR FINISH PLAN	•						
A703	BLDG 1 - THIRD FLOOR FINISH PLAN	•						
A704	BLGD 1 - ENLARGED AMENITY FINISH PLAN	•						
A720	BLDG 2 - FIRST FLOOR FINISH PLAN	•	•					
A721	BLDG 2 - SECOND FLOOR FINISH PLAN	•						
A722	BLDG 2 - THIRD FLOOR FINISH PLAN	•						
A723	BLDG 2 - ENLARGED AMENITY FINISH PLAN	•						
A750	INTERIOR DETAILS	•			•			

	STRUCTURAL	BID / PERMIT SET 7.15.2021	PERMIT COMMENTS 8.17.2021	FOUNDATION PERMIT 10.11.2021	REVISION 1 - 2.11.2022	REVISION 2 - 3.1.2022			
S001	GENERAL NOTES	•		•					_
S002	SCHEDULES & CMU DETAILS	•		•					╁
S003	TYPICAL WOOD GRAVITY SCHEDULES & DETAILS	•		_					_
S004	TYPICAL WOOD LATERAL SCHEDULES & DETAILS	•		•					_
S005 S006	TYPICAL WOOD DETAILS	•						+	-
S006 S007	TYPICAL WOOD DETAILS TYPICAL WOOD DETAILS	•							-
S007 S022	MAINTENANCE SHED/POOL HOUSE	•		_				+	+
S022 S023	MAINTENANCE SHED/POOL HOUSE MAINTENANCE SHED/POOL HOUSE	•	•	•				+	+
S101	FOUNDATION PLAN	•	_	•				+	+
S101A	FOUNDATION PLAN - AREA A	•		•				+	\vdash
S101A	FOUNDATION PLAN - AREA B	•		•	•			+	\vdash
S101C	FOUNDATION PLAN - AREA C	•		•					\vdash
S102	SECOND FLOOR FRAMING PLAN	•							\vdash
S102A	SECOND FLOOR FRAMING PLAN- AREA A	•						+	\vdash
S102B	SECOND FLOOR FRAMING PLAN- AREA B	•			•			_	H
S102C	SECOND FLOOR FRAMING PLAN- AREA C	•						+	\vdash
S103	THIRD FLOOR FRAMING PLAN	•							T
S103A	THIRD FLOOR FRAMING PLAN- AREA A	•						+	T
S103B	THIRD FLOOR FRAMING PLAN- AREA B	•			•				T
S103C	THIRD FLOOR FRAMING PLAN- AREA C	•							T
S104	ROOF FRAMING PLAN	•							T
S104A	ROOF FRAMING PLAN- AREA A	•							
S104B	ROOF FRAMING PLAN- AREA B	•			•				
S104C	ROOF FRAMING PLAN- AREA C	•							
S121	BLDG 2 - FOUNDATION PLAN	•		•					
S121A	BLDG 2- FOUNDATION PLAN - AREA A	•		•					
S121B	BLDG 2- FOUNDATION PLAN - AREA B	•		•	•				L
S121C	BLDG 2- FOUNDATION PLAN - AREA C	•		•					
S122	BLDG 2 - SECOND FLOOR FRAMING PLAN	•							L
S122A	BLDG 2 - SECOND FLOOR FRAMING PLAN - AREA A	•							_
S122B	BLDG 2- SECOND FLOOR FRAMING PLAN - AREA B	•			•			 	_
S122C	BLDG 2- SECOND FLOOR FRAMING PLAN - AREA C	•						-	_
S123	BLDG 2 - THIRD FLOOR FRAMING PLAN	•						-	_
S123A	BLDG 2- THIRD FLOOR FRAMING PLAN - AREA A	•			_			-	_
S123B S123C	BLDG 2- THIRD FLOOR FRAMING PLAN - AREA B BLDG 2- THIRD FLOOR FRAMING PLAN - AREA C	•			•			-	+
S123C S124	BLDG 2 - ROOF FRAMING PLAN BLDG 2 - ROOF FRAMING PLAN	•						+	+
S124 S124A	BLDG 2- ROOF FRAMING PLAN BLDG 2- ROOF FRAMING PLAN - AREA A	•						+	\vdash
S124A S124B	BLDG 2- ROOF FRAMING PLAN - AREA B	•			•			_	\vdash
S124D S124C	BLDG 2- ROOF FRAMING PLAN - AREA C	•						_	\vdash
S200	FOUNDATION SECTIONS	•		•					T
S201	FOUNDATION SECTIONS	•		•					\vdash
S202	FOUNDATION SECTIONS	•		•					\vdash
S300	STEEL FRAMING SECTIONS	•							
S301	STEEL FRAMING SECTIONS	•						†	\vdash
S330	WOOD FLOOR FRAMING SECTIONS	•		•				1	
S331	WOOD FLOOR FRAMING SECTIONS	•							
S332	WOOD FLOOR FRAMING SECTIONS	•			•				
S333	WOOD FLOOR FRAMING SECTIONS	•							
S340	WOOD ROOF FRAMING SECTIONS	•							
S341	WOOD ROOF FRAMING SECTIONS	•							
S342	WOOD ROOF FRAMING SECTIONS	•							П


	UNDERGROUND PLUMBING & ELECTRICAL	BID / PERMIT SET 7.15.2021	PERMIT COMMENTS 8.17.2021	FOUNDATION PERMIT 10.11.2021	REVISION 1 - 2.11.2022	REVISION 2 - 3.1.2022		
UG101	BLDG 1-A, PARTIAL FIRST FLOOR PLAN - BELOW GRADE		Н.	<u> </u>	-			
UG102	BLDG 1-B, PARTIAL FIRST FLOOR PLAN - BELOW GRADE							
UG103	BLDG 1-C, PARTIAL FIRST FLOOR PLAN - BELOW GRADE							
UG104	BLDG 2-A, PARTIAL FIRST FLOOR PLAN - BELOW GRADE							
UG105	BLDG 2-B, PARTIAL FIRST FLOOR PLAN - BELOW GRADE							
UG106	BLDG 2-C, PARTIAL FIRST FLOOR PLAN - BELOW GRADE							

	ELECTRICAL	BID / PERMIT SET 7.15.2021	PERMIT COMMENTS 8.17.2021	FOUNDATION PERMIT 10.11.2021	REVISION 1 - 2.11.2022	REVISION 2 - 3.1.2022		
E001	SITE PLAN - PHOTOMETRIC	•		ш.	•		+	
E001a	SITE PLAN - PHOTOMETRIC	-			•		+ +	
E101	BLDG 1-A, PARTIAL FIRST FLOOR PLAN - ELECTRICAL	•					+	
E102	BLDG 1-B, PARTIAL FIRST FLOOR PLAN - ELECTRICAL	•						
E102a	BLDG 1-B, PARTIAL FIRST FLOOR PLAN - ELECTRICAL	•	•		•			
E102b	BLDG 1-B, PARTIAL FIRST FLOOR PLAN - ELECTRICAL	•						
E103	BLDG 1-C, PARTIAL FIRST FLOOR PLAN - ELECTRICAL	•				•		
E104	BLDG 1-A, PARTIAL SECOND FLOOR PLAN - ELECTRICAL	•						
E105	BLDG 1-B, PARTIAL SECOND FLOOR PLAN - ELECTRICAL	•						
E106	BLDG 1-C, PARTIAL SECOND FLOOR PLAN - ELECTRICAL	•						
E107	BLDG 1-A, PARTIAL THIRD FLOOR PLAN - ELECTRICAL	•						
E108	BLDG 1-B, PARTIAL THIRD FLOOR PLAN - ELECTRICAL	•						
E109	BLDG 1-C, PARTIAL THIRD FLOOR PLAN - ELECTRICAL	•						
E110	BLDG 1-A, PARTIAL ROOF PLAN -ELECTRICAL	•						
E111	BLDG 1-B, PARTIAL ROOF PLAN -ELECTRICAL	•						
E112	BLDG 1-C, PARTIAL ROOF PLAN -ELECTRICAL	•						
E113	BLDG 2-A, PARTIAL FIRST FLOOR PLAN - ELECTRICAL	•				•		
E114	BLDG 2-B, PARTIAL FIRST FLOOR PLAN - ELECTRICAL	•					\perp	
E114a	BLDG 2-B, PARTIAL FIRST FLOOR PLAN - ELECTRICAL	•	•		•			
E115	BLDG 2-C, PARTIAL FIRST FLOOR PLAN - ELECTRICAL	•						
E116	BLDG 2-A, PARTIAL SECOND FLOOR PLAN - ELECTRICAL	•					+-+	
E117	BLDG 2-B, PARTIAL SECOND FLOOR PLAN - ELECTRICA	•					+-+	
E118	BLDG 2-C, PARTIAL SECOND FLOOR PLAN - ELECTRICAL	•					+-+	
E119	BLDG 2-A, PARTIAL THIRD FLOOR PLAN - ELECTRICAL	•					++	
E120	BLDG 2-B, PARTIAL THIRD FLOOR PLAN - ELECTRICAL	•					++	
E121	BLDG 2-C, PARTIAL THIRD FLOOR PLAN - ELECTRICAL	•					++	
E122	BLDG 2-A, PARTIAL ROOF PLAN -ELECTRICAL	•					++	
E123	BLDG 2-B, PARTIAL ROOF PLAN -ELECTRICAL	•					+-+	-+
E124 E201	BLDG 2-C, PARTIAL ROOF PLAN -ELECTRICAL TYPICAL UNIT PLANS - ELECTRICAL	•			_		++	
E201 E202	TYPICAL UNIT PLANS - ELECTRICAL TYPICAL UNIT PLANS - ELECTRICAL	•	•		•		+-+	-+
E202 E203	TYPICAL UNIT PLANS - ELECTRICAL TYPICAL UNIT PLANS - ELECTRICAL	-	-		•		+	-
E301	ELECTRICAL DETAILS	•			•		+	-+
E302	ELECTRICAL DETAILS ELECTRICAL DETAILS	•					+	-+
E303	ELECTRICAL DETAILS ELECTRICAL DETAILS	•					+	+
E304	ELECTRICAL DETAILS	•	•			•	+	+
E305	ELECTRICAL DETAILS	•	•		•	•	+	-+
E306	ELECTRICAL DETAILS	•	<u> </u>		1	-	+	_

	MECHANICAL TO A DATE OF THE CORPORATION OF THE CORP	BID / PERMIT SET 7.15.2021	PERMIT COMMENTS 8.17.2021	FOUNDATION PERMIT 10.11.2021	REVISION 1 - 2.11.2022	REVISION 2 - 3.1.2022			
M101	BLDG 1-A, PARTIAL FIRST FLOOR PLAN - HVAC	•							4
M102	BLDG 1-B, PARTIAL FIRST FLOOR PLAN - HVAC	•							4
M103	BLDG 1-C, PARTIAL FIRST FLOOR PLAN - HVAC	•							4
M104	BLDG 1-A, PARTIAL SECOND FLOOR PLAN - HVAC	•							4
M105	BLDG 1-B, PARTIAL SECOND FLOOR PLAN - HVAC	•							4
M106	BLDG 1-C, PARTIAL SECOND FLOOR PLAN - HVAC	•							4
M107	BLDG 1-A, PARTIAL THIRD FLOOR PLAN - HVAC	•							4
M108	BLDG 1-B, PARTIAL THIRD FLOOR PLAN - HVAC	•							4
M109	BLDG 1-C, PARTIAL THIRD FLOOR PLAN - HVAC	•							4
M110	BLDG 1-A, PARTIAL ROOF PLAN -HVAC	•							_
M111	BLDG 1-B, PARTIAL ROOF PLAN -HVAC	•							
M112	BLDG 1-C, PARTIAL ROOF PLAN -HVAC	•							_
M113	BLDG 2-A, PARTIAL FIRST FLOOR PLAN – HVAC	•							4
M114	BLDG 2-B, PARTIAL FIRST FLOOR PLAN - HVAC	•							_
M115	BLDG 2-C, PARTIAL FIRST FLOOR PLAN - HVAC	•							_
M116	BLDG 2-A, PARTIAL SECOND FLOOR PLAN - HVAC	•							_
M117	BLDG 2-B, PARTIAL SECOND FLOOR PLAN - HVAC	•							_
M118	BLDG 2-C, PARTIAL SECOND FLOOR PLAN - HVAC	•	•						
M119	BLDG 2-A, PARTIAL THIRD FLOOR PLAN - HVAC	•							
M120	BLDG 2-B, PARTIAL THIRD FLOOR PLAN - HVAC	•							
M121	BLDG 2-C, PARTIAL THIRD FLOOR PLAN - HVAC	•							\bot
M122	BLDG 2-A, PARTIAL ROOF PLAN -HVAC	•							
M123	BLDG 2-B, PARTIAL ROOF PLAN -HVAC	•							
M124	BLDG 2-C, PARTIAL ROOF PLAN -HVAC	•							
M201	TYPICAL UNIT PLANS - HVAC	•							
M202	TYPICAL UNIT PLANS - HVAC	•							
M203	TYPICAL UNIT PLANS - HVAC	•			•				
ME101	SITE PLAN - MECH/ELEC	•	•		•				
ME201	MAINTENANCE BLDG - PLUMBING	•	•		•	•			
ME202	MAINTENANCE BLDG - HVAC		•			•			
ME203	MAINTENANCE BLDG - ELECTRICAL		•		•	•			
MP101	MECHANICAL DETAILS	•							
MP102	MECHANICAL DETAILS	•							
MP103	MECHANICAL DETAILS	•							
MP104	MECHANICAL SCHEDULES	•	•						7

	PLUMBING	BID / PERMIT SET 7.15.2021	PERMIT COMMENTS 8.17.2021	FOUNDATION PERMIT 10.11.2021	REVISION 1 - 2.11.2022	REVISION 2 - 3.1.2022		
P101	BLDG 1-A, PARTIAL FIRST FLOOR PLAN - PLUMBING	•	•					
P102	BLDG 1-B, PARTIAL FIRST FLOOR PLAN - PLUMBING	•						
P103	BLDG 1-C, PARTIAL FIRST FLOOR PLAN - PLUMBING	•						
P104	BLDG 1-A, PARTIAL SECOND FLOOR PLAN - PLUMBING	•						
P105	BLDG 1-B, PARTIAL SECOND FLOOR PLAN - PLUMBING	•						
P106	BLDG 1-C, PARTIAL SECOND FLOOR PLAN - PLUMBING	•						
P107	BLDG 1-A, PARTIAL THIRD FLOOR PLAN - PLUMBING	•						
P108	BLDG 1-B, PARTIAL THIRD FLOOR PLAN - PLUMBING	•						
P109	BLDG 1-C, PARTIAL THIRD FLOOR PLAN - PLUMBING	•						
P110	BLDG 2-A, PARTIAL FIRST FLOOR PLAN - PLUMBING	•	•					
P111	BLDG 2-B, PARTIAL FIRST FLOOR PLAN - PLUMBING	•						
P112	BLDG 2-C, PARTIAL FIRST FLOOR PLAN - PLUMBING	•						
P113	BLDG 2-A, PARTIAL SECOND FLOOR PLAN - PLUMBING	•						
P114	BLDG 2-B, PARTIAL SECOND FLOOR PLAN - PLUMBING	•						
P115	BLDG 2-C, PARTIAL SECOND FLOOR PLAN - PLUMBING	•						
P116	BLDG 2-A, PARTIAL THIRD FLOOR PLAN - PLUMBING	•						
P117	BLDG 2-B, PARTIAL THIRD FLOOR PLAN - PLUMBING	•						
P118	BLDG 2-C, PARTIAL THIRD FLOOR PLAN - PLUMBING	•						
P119	PLUMBING RISERS	•						
P120	PLUMBING RISERS	•						
P121	PLUMBING RISERS	•						
P201	TYPICAL UNIT PLANS - PLUMBING	•						
P202	TYPICAL UNIT PLANS - PLUMBING	•						
P203	TYPICAL UNIT PLANS - PLUMBING	•			•			

	TELECOM	BID / PERMIT SET 7.15.2021	PERMIT COMMENTS 8.17.2021	FOUNDATION PERMIT 10.11.203	REVISION 1 - 2.11.2022	REVISION 2 - 3.1.2022			
T101	BLDG 1-A FIRST FLOOR PLAN - TELECOM	•							
T102	BLDG 2-A, PARTIAL FIRST FLOOR PLAN - TELECOM	•							
T201	TELECOM DETAILS	•	•						

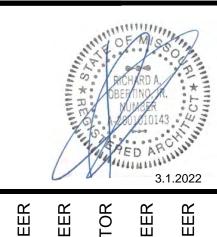

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2 FOUNDATION PERMIT 10.11.2021 4 Revision 2


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PLUMBING ENGINEER

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RINKMANN CONSTRUCTORS
TIMER SOMMERS &

SM ENGINEE

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ASSOCIATES
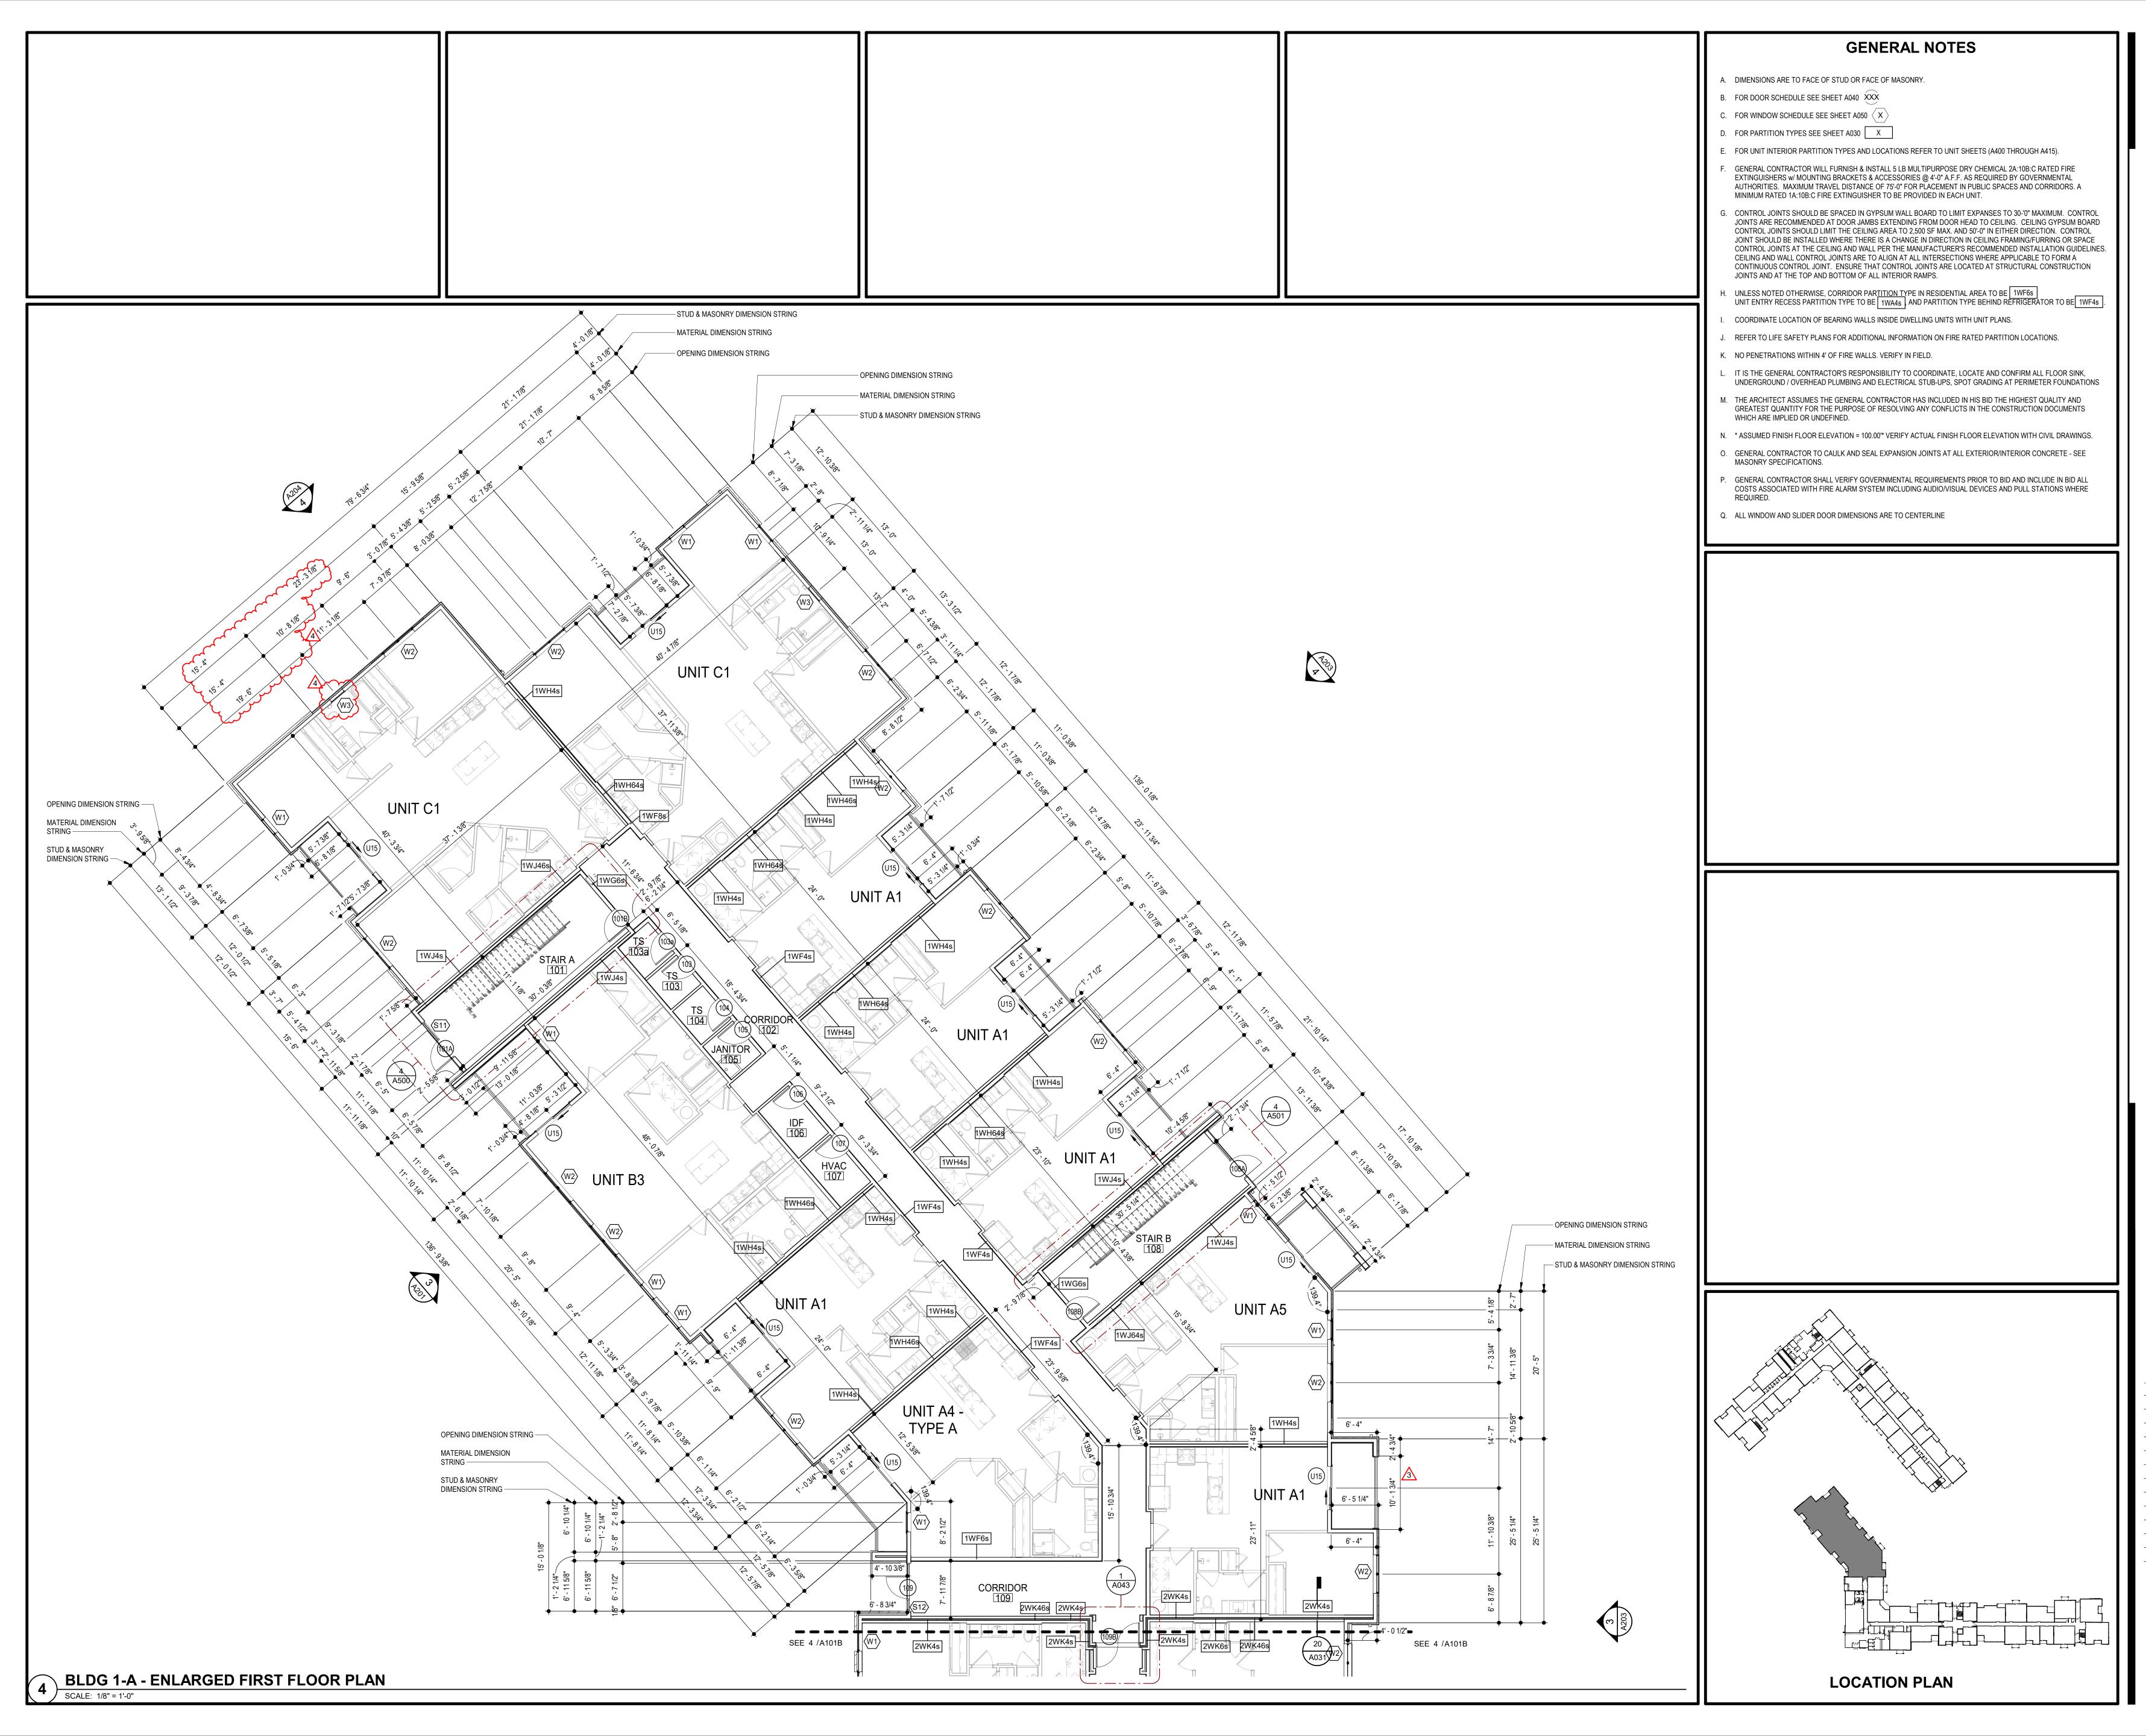
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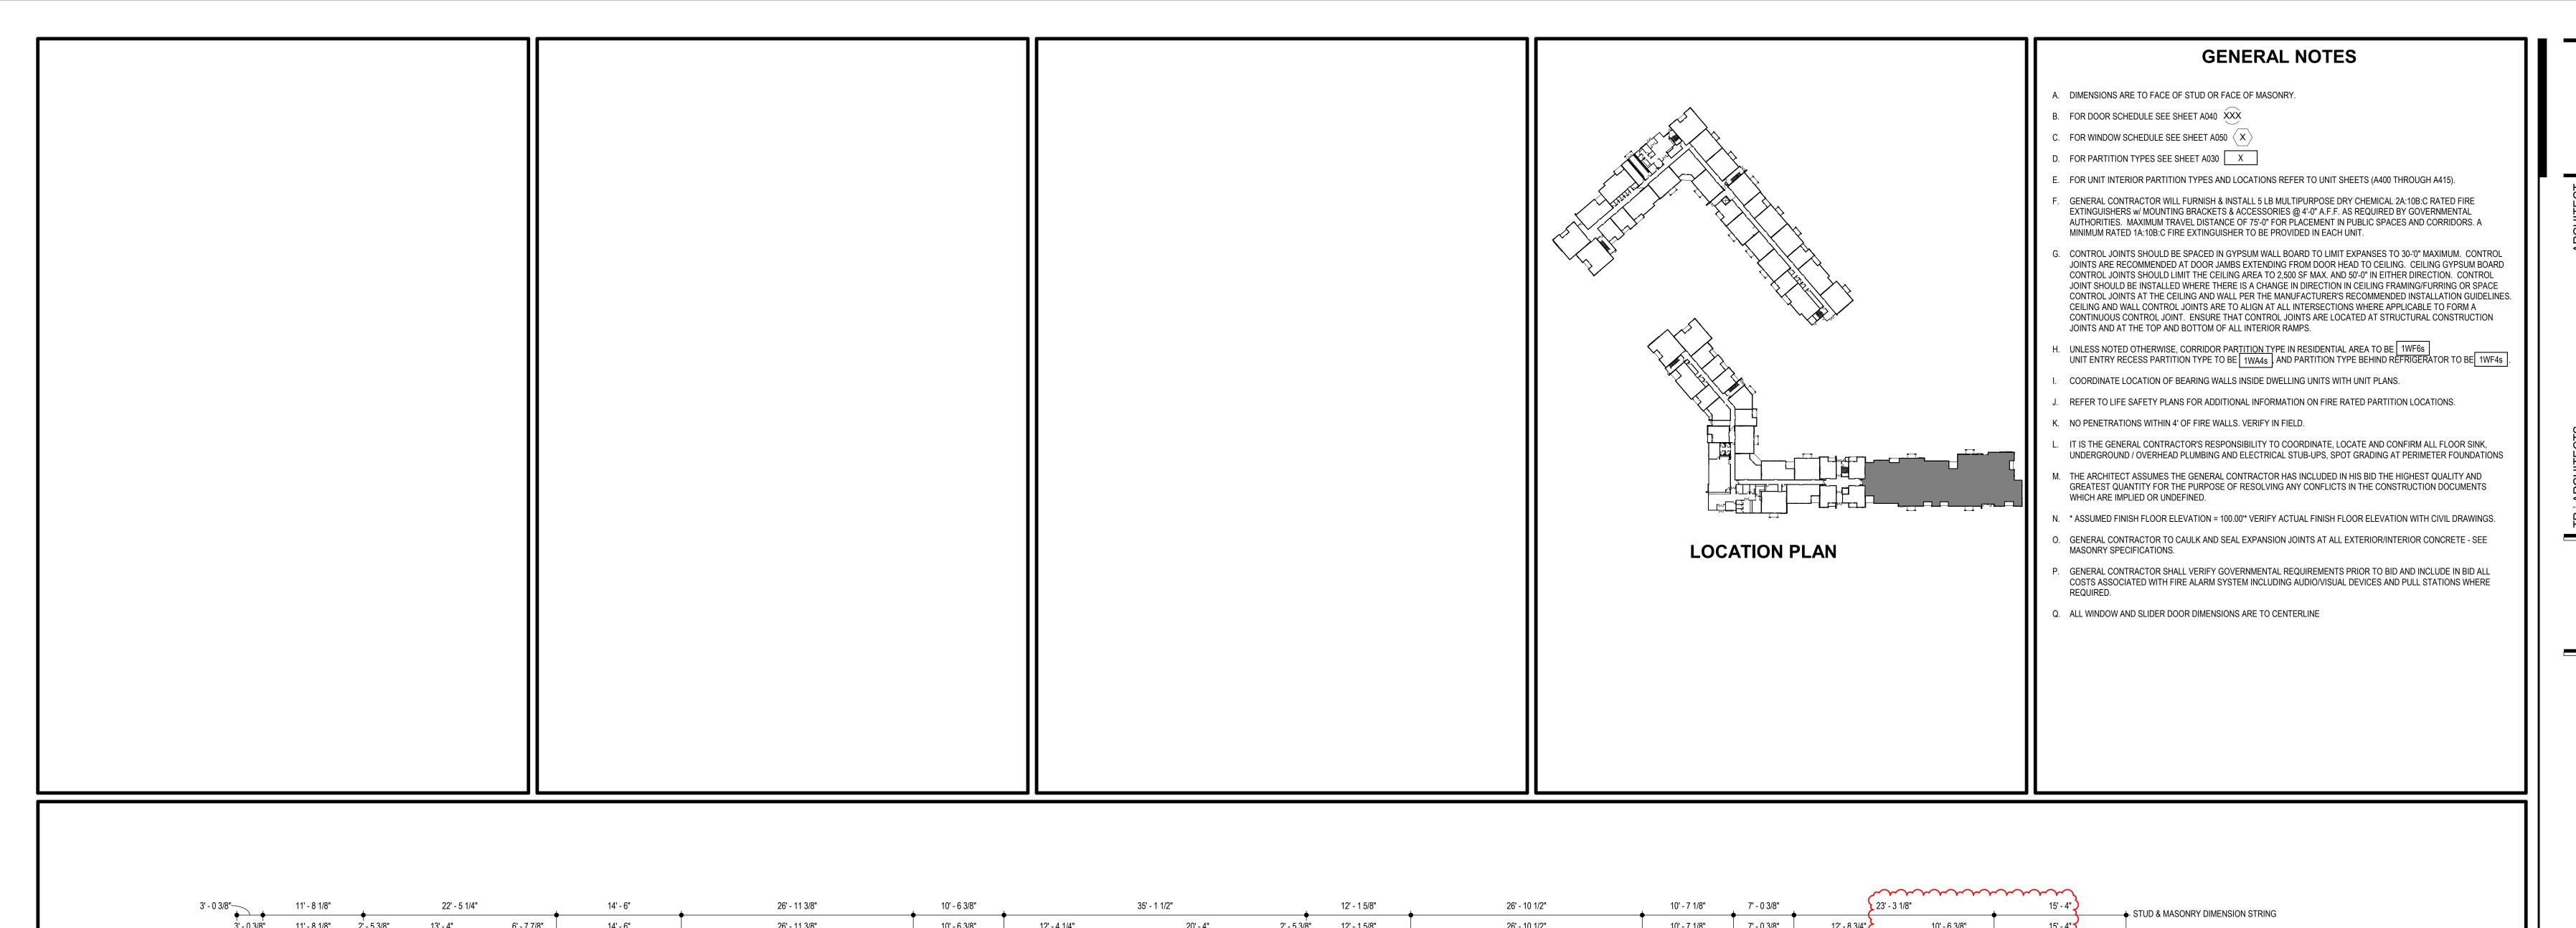
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REVISIONS #

3 Revision 1
2.11.2022
4 Revision 2
3.1.2022

DWG BY MKSS
TR,i PROJECT NO. 20-001

A101A



20' - 4"

9' - 8"

UNIT B3

48' - 0 7/8"

5' - 6 3/4" | 5' - 4 7/8" | 5' - 8 5/8" | 6' - 8 5/8" | 6' - 8 5/8" | 4' - 10 5/8" | 6' - 2 7/8" | 7 - 9 1/8"

4' - 0 5/8" 5' - 4" 4' - 0 5/8"

+ + +

13' - 5 1/4"

1WF4s

11' - 1 1/2"

24' - 0"

2' - 5 1/8" 13' - 5 3/8"

A204 1

2' - 5 3/8"

26' - 10 1/2"

2' - 4 3/4" 8' - 9 1/4" 2' - 4 3/4"

UNIT B1

⁻36' - 5 1/2"[─]

36' - 5 1/2"

UNIT B1

2' - 4 3/4" 8' - 9 1/4" 2' - 4 3/4"

31' - 10 7/8"

12' - 7 1/2"

11' - 0 1/2"

47' - 9 1/2"

5' - 1 1/4" 7' - 3 3/8"

7' - 7 1/8"

7' - 0 5/8"

1' - 2 1/4"

10' - 6 3/8"

DOM. WATER

1WH4s

12' - 6 1/2"

7' - 0 3/8"

8' - 9 1/8" | 5' - 1 3/4" | 5' - 5 3/8" | 6' - 9" | 8' - 2 1/2"

MATERIAL DIMENSION STRING

OPENING DIMENSION STRING

5' - 7 3/8" 1' - 0 3/4"

5' - 7 3/8" 1' - 7 1/2"

6' - 8 1/8"

UNIT C1

OPENING DIMENSION STRING

MATERIAL DIMENSION STRING

8' - 10" 4' - 3 1/2" STUD & MASONRY DIMENSION STRING

8' - 10" 4' - 3 1/2"

39' - 8 7/8"

12' - 7 1/4"

UNIT C1

37' - 6 3/4"

6'-11/8" 6'-10" 4'-9" 5'-3" 6'-0|5/8" 6|-0" 4'-0" 6'-33/4" 6'-31/2" 4'-31/2" 4'-61/2" 4'-31/2"

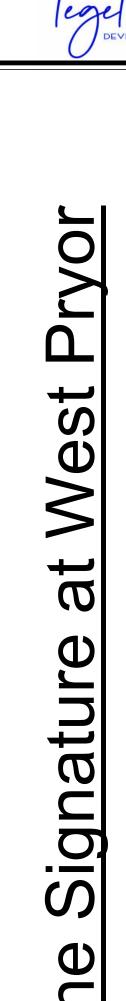
10' - 0" 5' - 4" 3' - 4" 4' - 0"

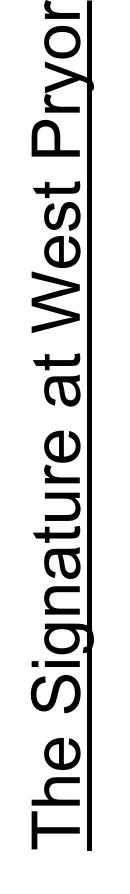
17' - 0 3/4" 3' - 4 5/8" 12' - 0 5/8" 4' - 0" 12' - 7 1/4"

OPENING DIMENSION STRING

— MATERIAL DIMENSION STRING

— STUD & MASONRY DIMENSION STRING





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SHEET NO.

BLDG 1-D - ENLARGED FIRST FLOOR PLAN SCALE: 1/8" = 1'-0"

2' - 6 3/4"

4' - 3 3/8" 7' - 5 3/4"

11' - 9 1/8"

11' - 9 1/8" 2' - 5 3/8"

3' - 0 3/8" 11' - 8 1/8" 2' - 5 3/8"

SEE 4 /4101B

2WK46s—

3' - 0 5/8" 4' - 8" 3' - 11 1/2" 7' - 9 3/8" 11' - 2 5/8" 3' - 5 1/4"

49' - 8 3/8"

UNIT B3

48' - 3 1/4"

9' - 8"

20' - 4"

35' - 0 3/8"

1WF4s

26' - 11 3/8"

2' - 4 3/4" 8' - 9 1/4" 2' - 4 3/4"

UNIT B1

36' - 6"

36' - 8"

UNIT B1

2' - 4 3/4" 8' - 9 1/4" 2' - 4 3/4"

12' - 6 3/8"

26' - 10 1/4"

26' - 10 1/4"

8' - 9"

CORRIDOR

1WH4s

12' - 4 1/2"

6' - 0 7/8" 5' - 0 1/8" 5' - 9 7/8"

3' - 5 1/8"

2 - 4 3/4" | 12' - 1 1/4"

1WH64s

--1WH4s

10' - 7 1/2"

10' - 7 1/2"

9' - 4 3/4" | 4' - 8" 3' - 6 1/4" 5' - 3 1/2" | 5' - 4" |

12' - 3"


+ + |

10' - 6 3/8"

5' - 5 1/4" | 3' - 8 1/4" | 4' - 8" | 9' - 4"

+ + + + + + +

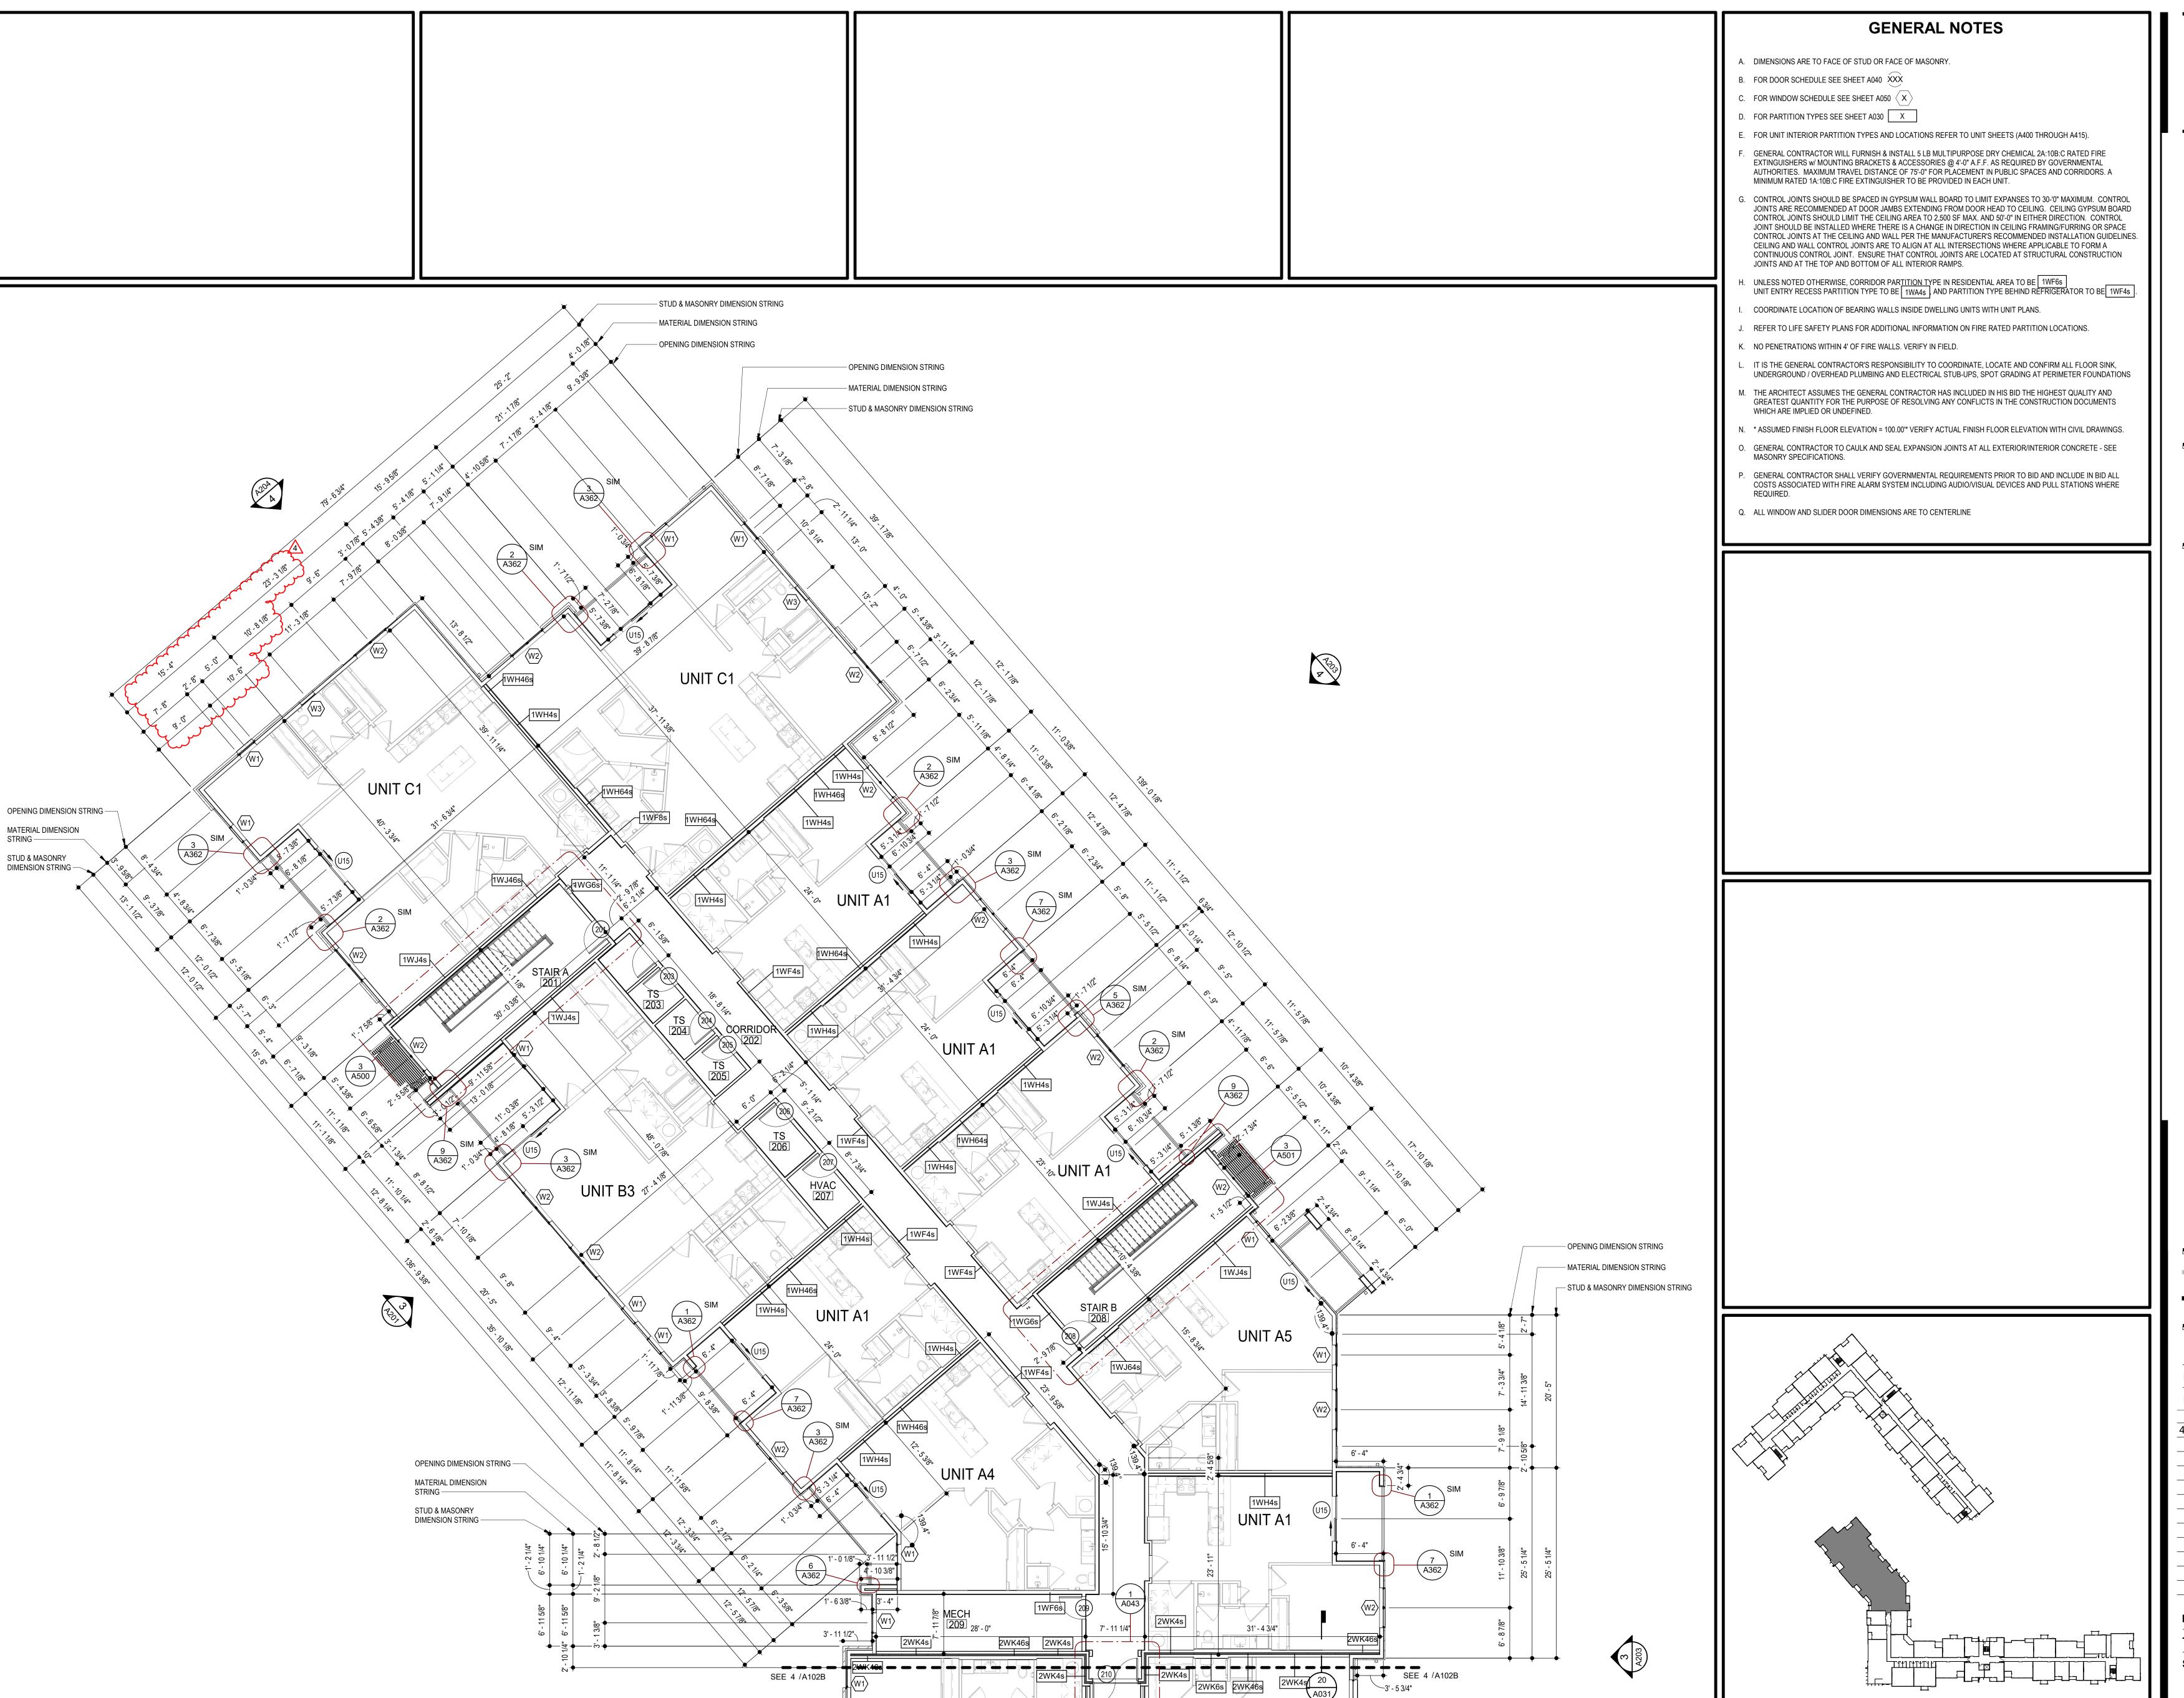13' - 10 1/8"



BLDG 1-A - ENLARGED SECOND FLOOR PLAN

SCALE: 1/8" = 1'-0"

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4 Revision 2 3.1.2022

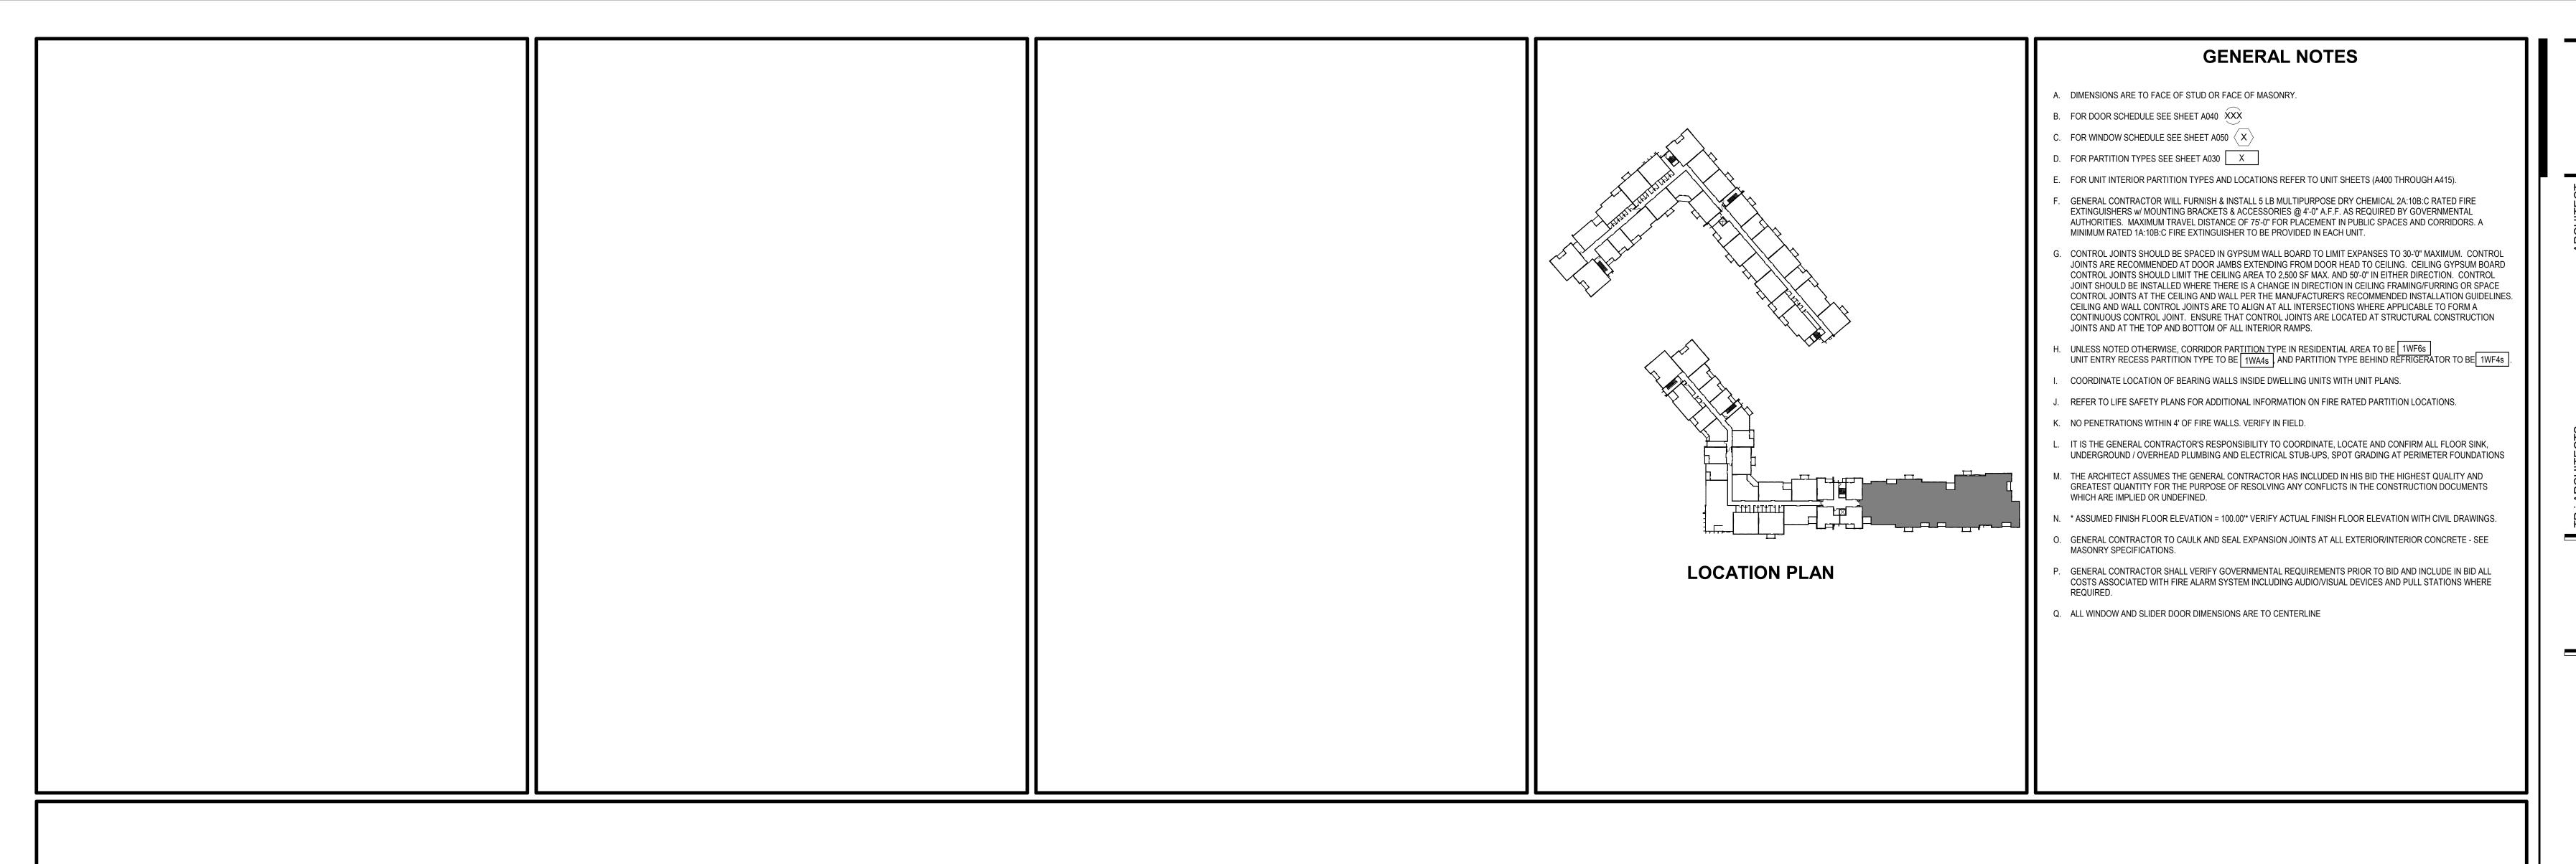
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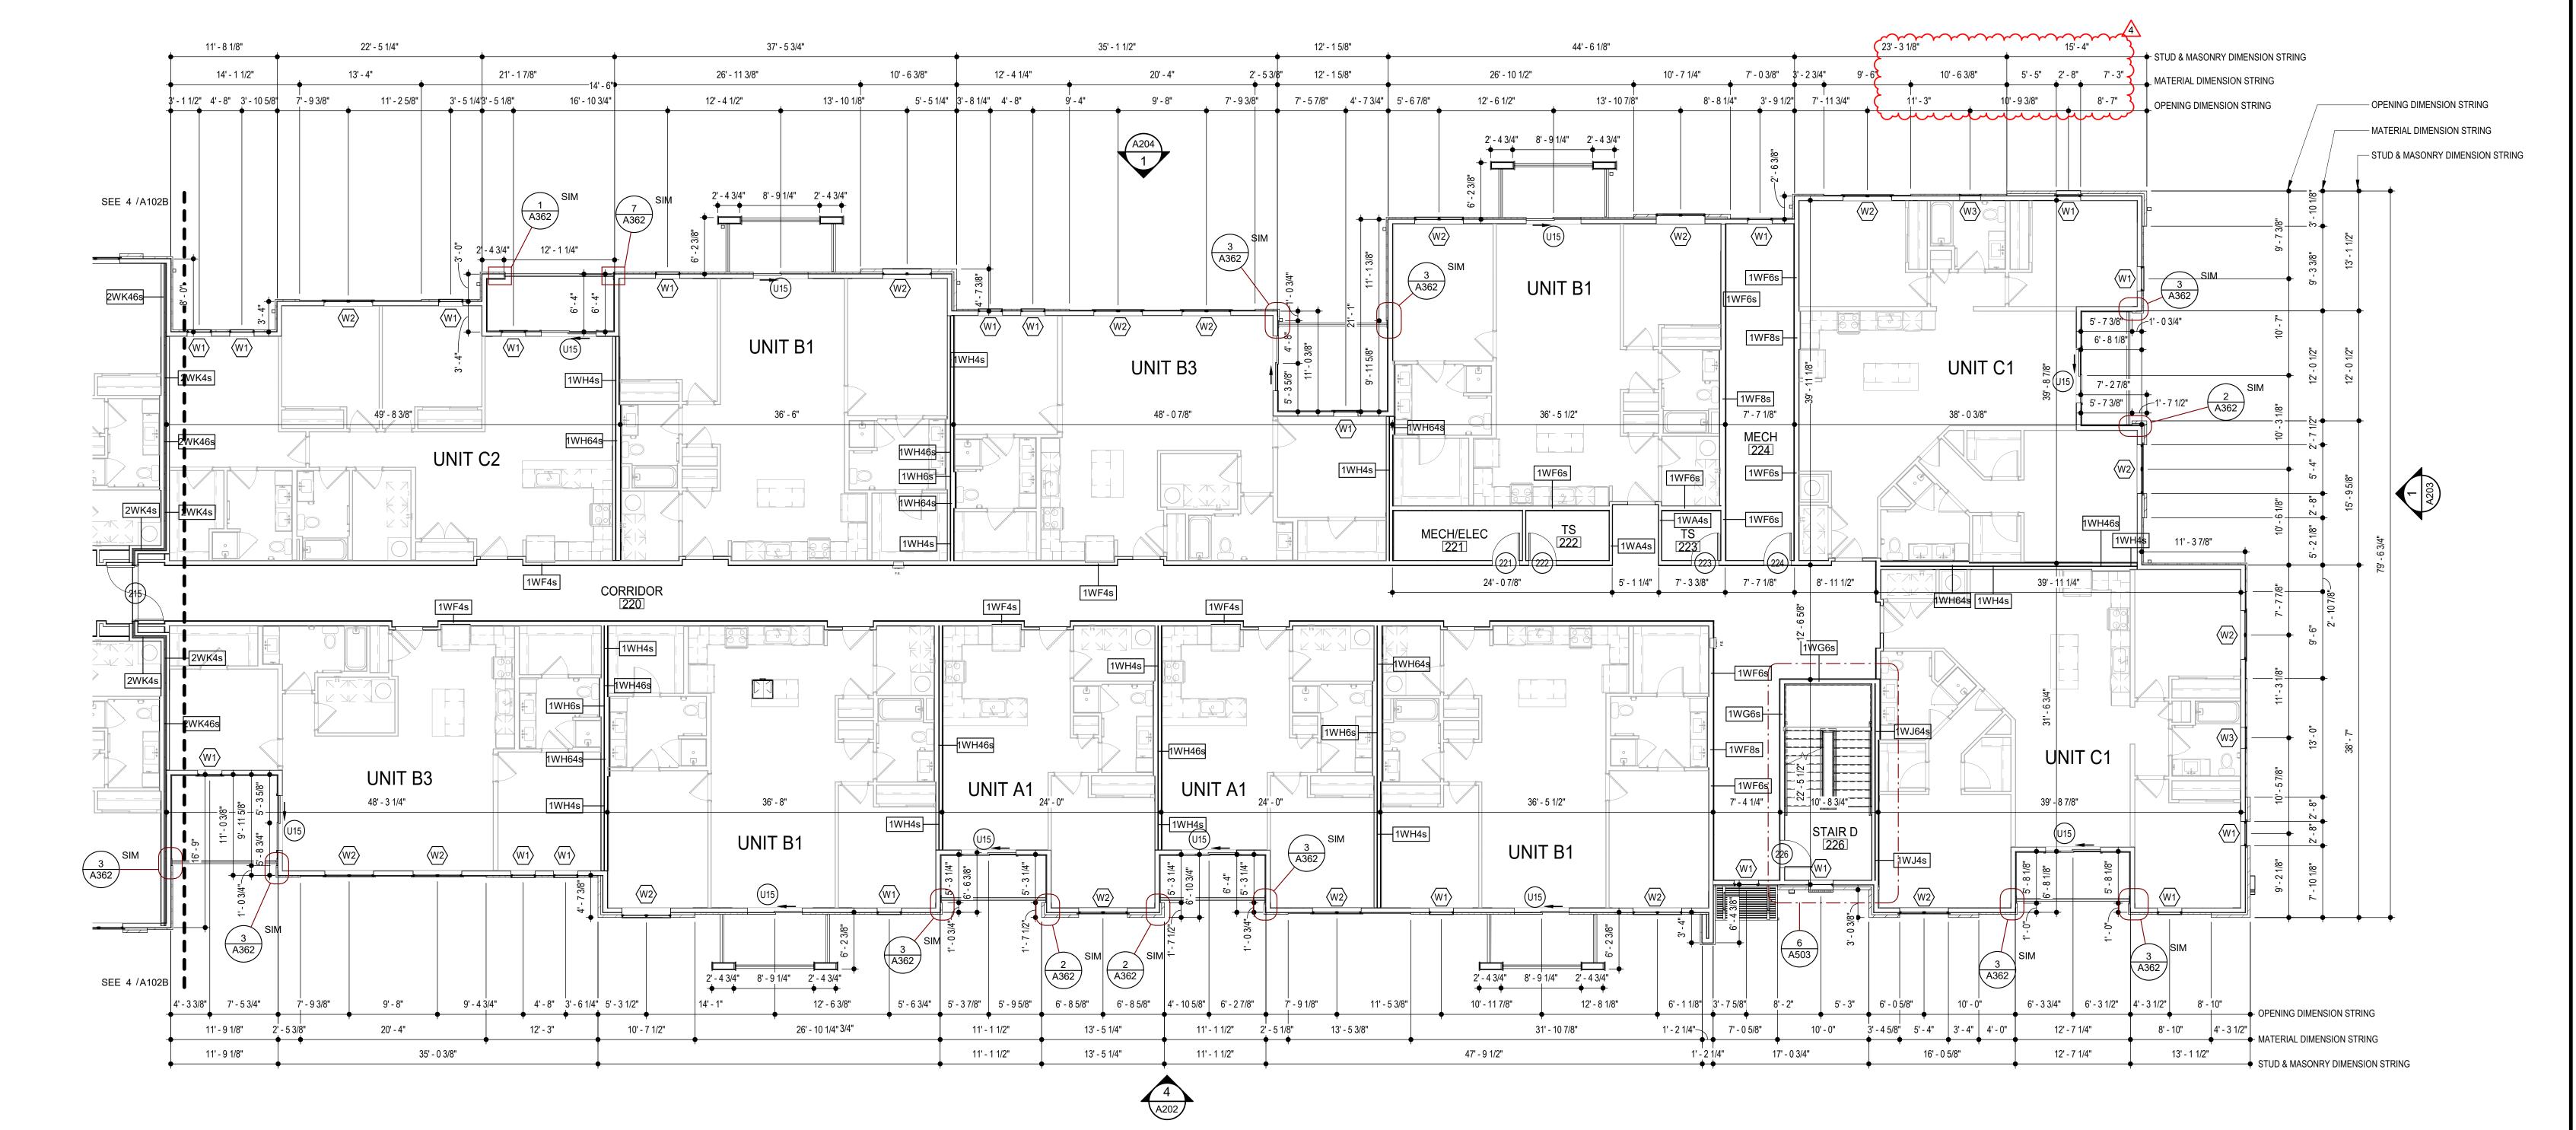
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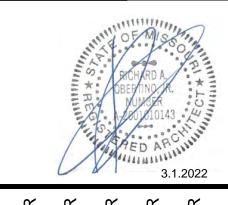
LOCATION PLAN

BLDG 1-A - ENLARGED SECOND

FLOOR PLAN







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ECHANICAL ENGINEER
ECHANICAL ENGINEER

GINEERING

JANN CONSTRUCTORS GEN

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RESOMMERS & MEGINATES

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SM ENGINE
BRINKMANN
LATIMER SC
ASSOCIATE
LATIMER SC

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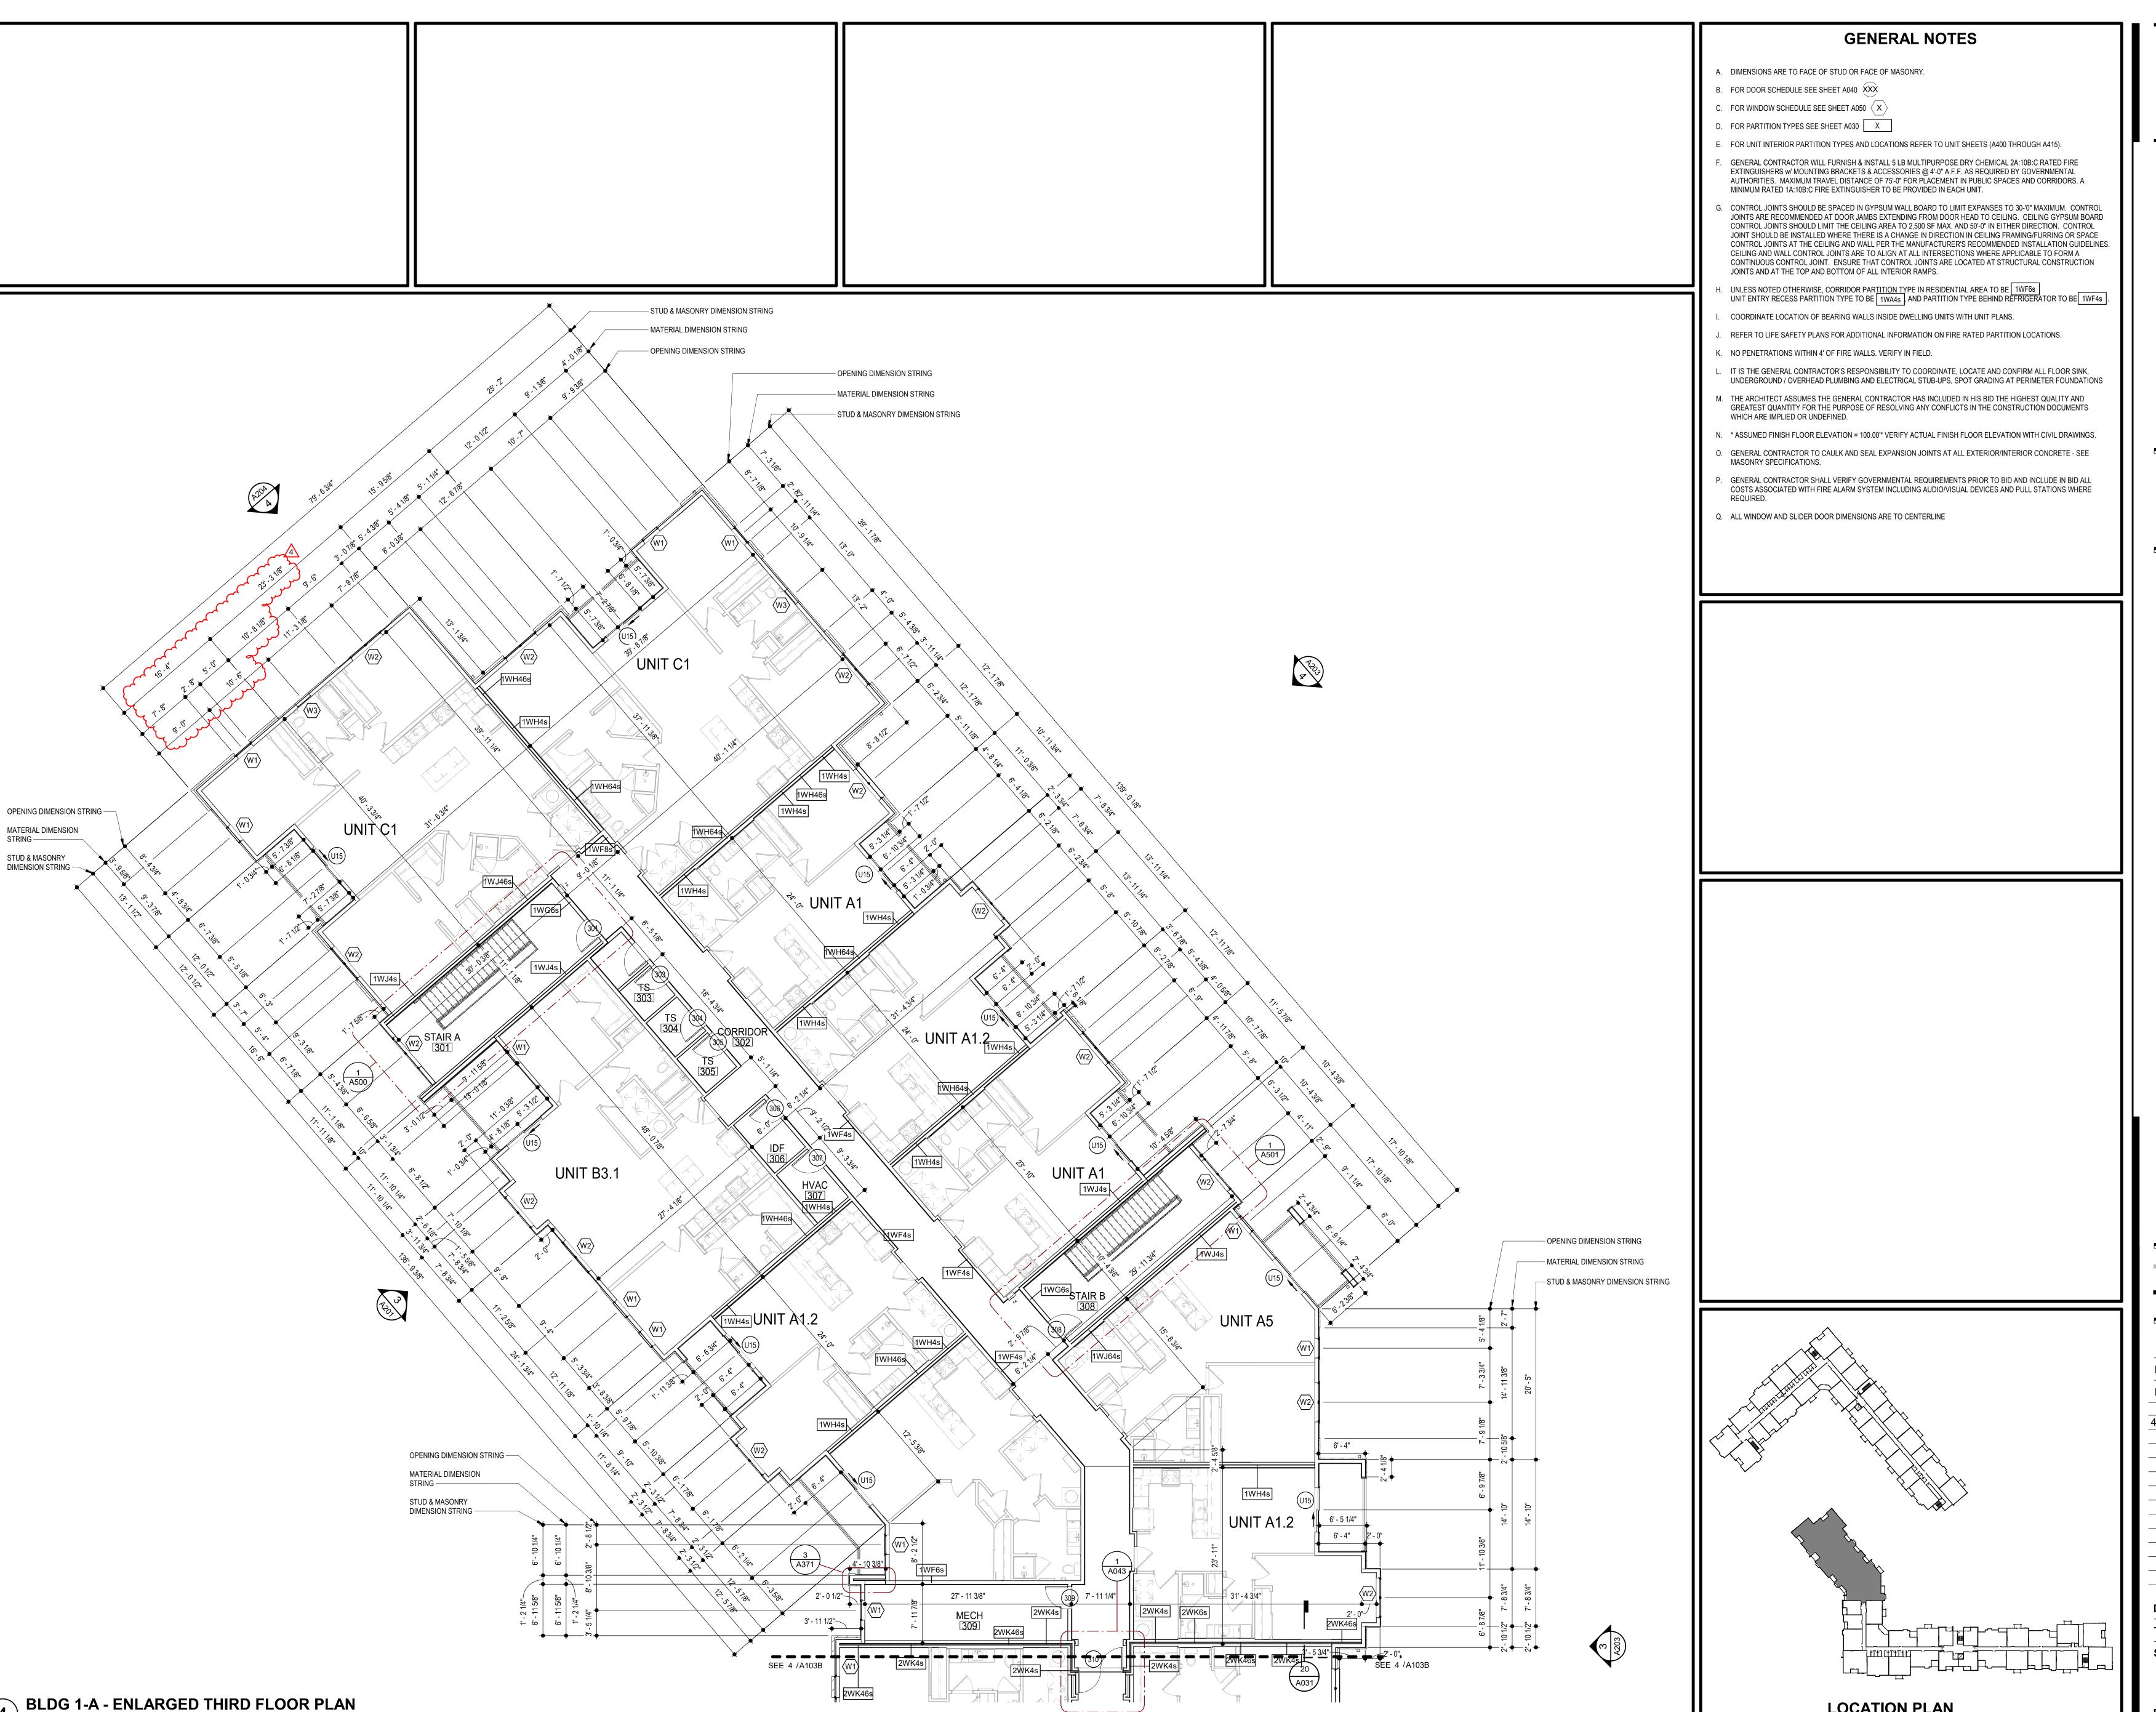
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SHEET NO.

A102D



SCALE: 1/8" = 1'-0"



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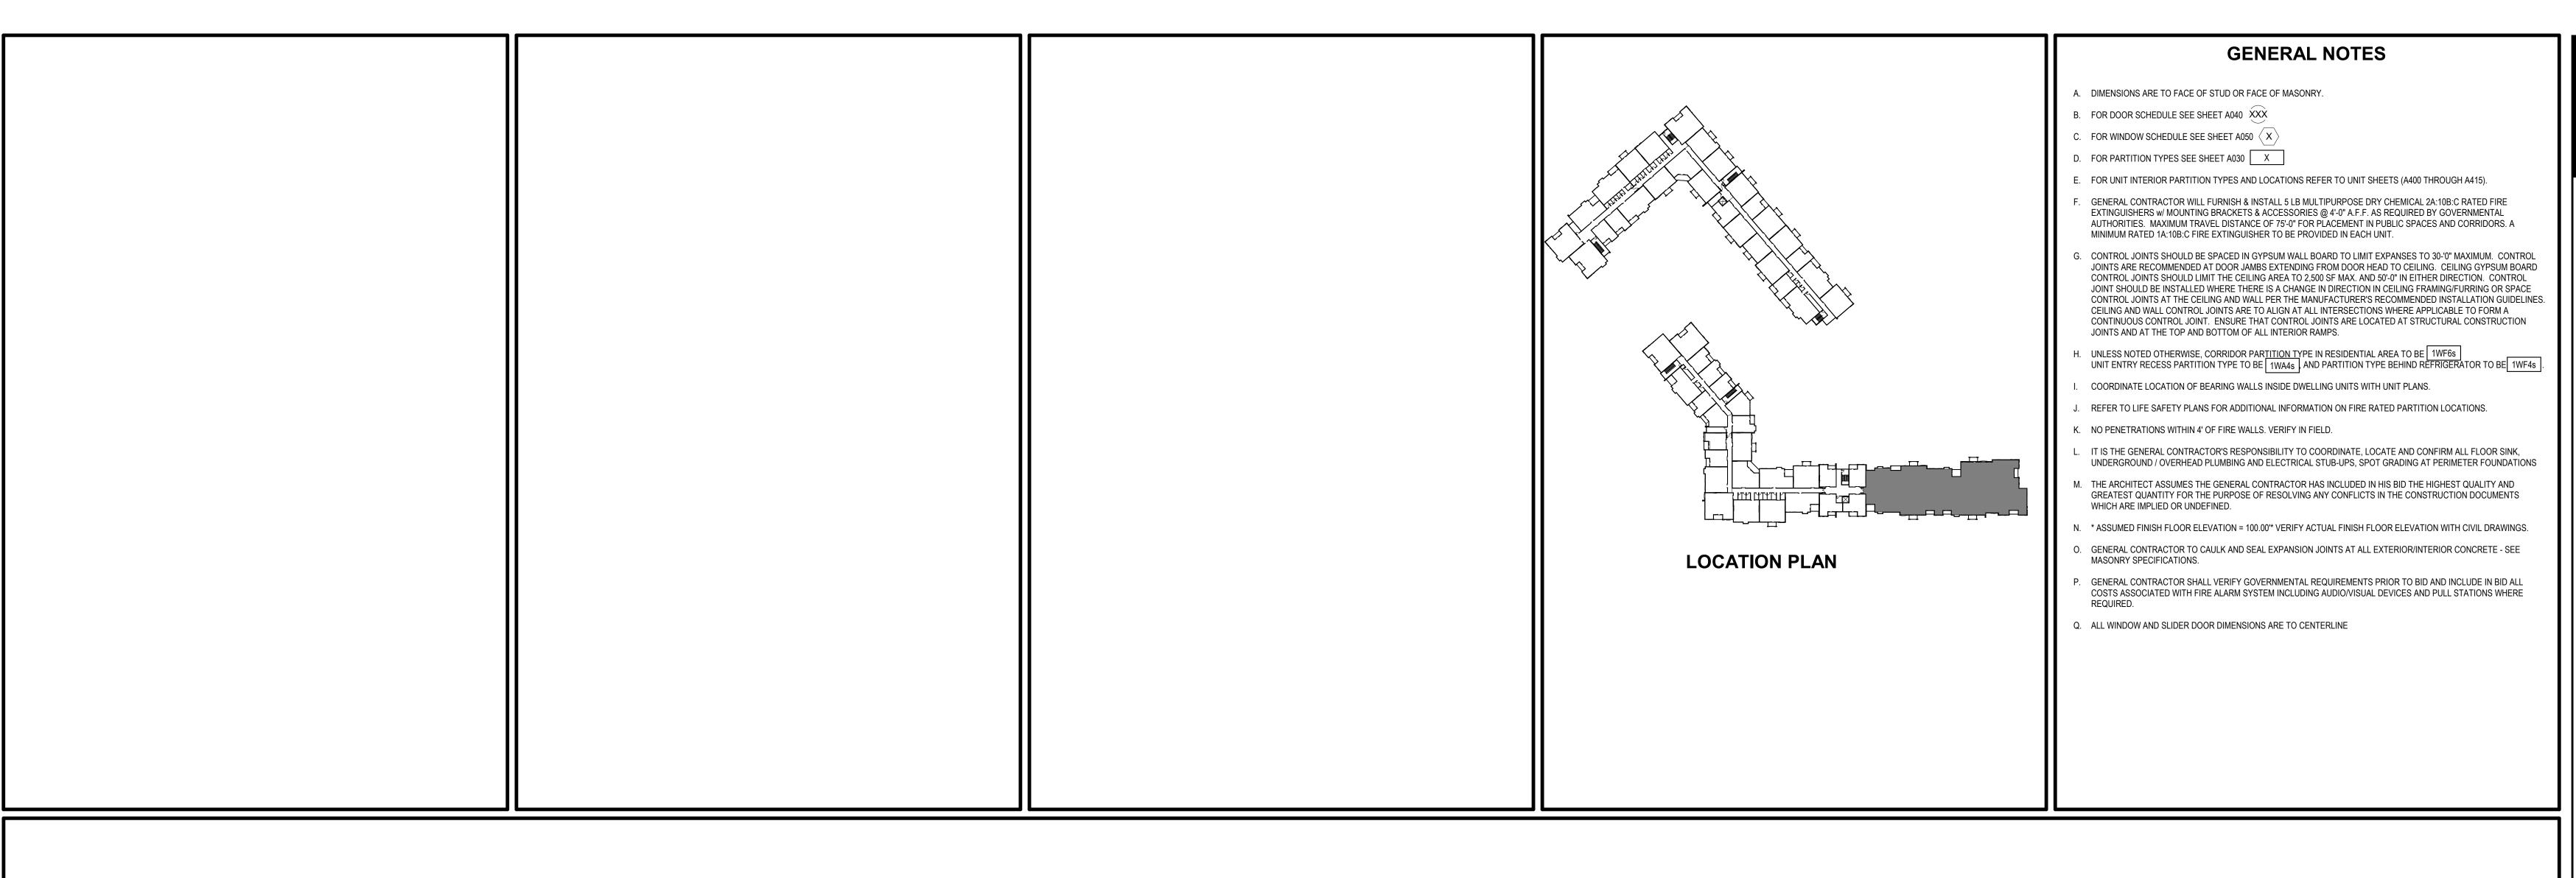
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4 Revision 2

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SHEET NO.

LOCATION PLAN



7' - 8 3/4" 3' - 11" 12' - 1 5/8"

7' - 9 3/8"

7' - 5 7/8" 4' - 7 3/4" 5' - 6 7/8"

37' - 5 3/4"

2' - 4 3/4" 8' - 9 1/4" 2' - 4 3/4"

UNIT B1

36' - 8"

UNIT B1 - TYPE A

2' - 4 3/4" 8' - 9 1/4" 2' - 4 3/4"

37' - 5 3/4"

12' - 6 3/8"

26' - 10 1/4"

13' - 10 1/8"

26' - 11 3/8"

12' - 4 1/2"

11' - 0 7/8"

12' - 1 1/4"

UNIT C2.1

1WH4s

5 A371

9' - 8" 9' - 4 3/4" 4' - 8" 3' - 6 1/4" 5' - 3 1/2"

23' - 4 5/8"

12' - 3"

2' - 4 3/4"

48' - 3 1/4"

UNIT B3.1

5' - 9 7/8"

23' - 5 7/8"

A204 1

UNIT B3.1

48' - 2 7/8"

UNIT A1.1

5' - 6 3/4" 5' - 3 7/8" 5' - 9 5/8" 6' - 8 5/8" 6' - 8 5/8" 4' - 10 5/8" 6' - 2 7/8" 7' - 9 1/8" 11' - 5 3/8"


11' - 1 1/2" | 4' - 0 5/8" | 5' - 4" | 4' - 0 5/8" | 11' - 1 1/2" | 2' - 5 1/8" / 7' - 8 3/4" | 4' - 3" |

11' - 1 1/2" 3' - 10 3/4" 7' - 8 3/4"

5' - 5 1/4" | 3' - 8 1/4" | 4' - 8"

-UNH4s

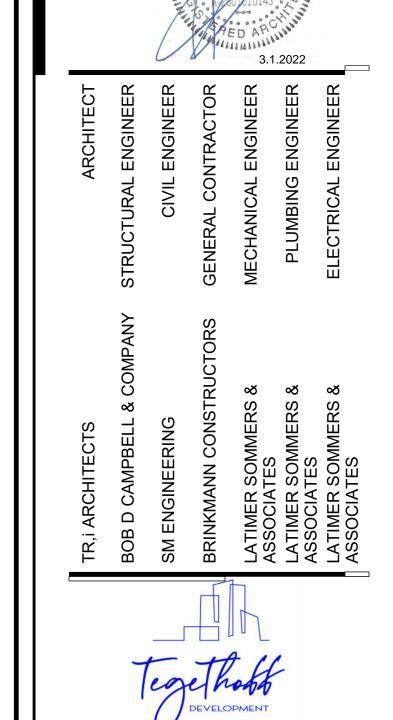11' - 1 1/2"



UNIT C1

30' - 10 3/4"

UNIT C1

12' - 7 1/4"

6' - 1 1/8" | 3' - 7 5/8" | 8' - 2" | 5' - 3" | 6' - 0 5/8" | 10' - 0" | 6' - 3 3/4" | 6' - 3 1/2" | 4' - 3 1/2" | 8' - 10" | OPENING DIMENSION STRING

16' - 0 5/8"

11' - 3"

15' - 4"

5' - 7 3/8" | 1' - 0 3/4"

6' - 8 1/8"

10' - 9 3/8" 8' - 7"

OPENING DIMENSION STRING

✓ STUD & MASONRY DIMENSION STRING

◆ MATERIAL DIMENSION STRING

→ STUD & MASONRY DIMENSION STRING

8' - 10" 4' - 3 1/2"

13' - 1 1/2"

OPENING DIMENSION STRING

— MATERIAL DIMENSION STRING

- STUD & MASONRY DIMENSION STRING

44' - 6 1/8"

2' - 4 3/4" 8' - 9 1/4" 2' - 4 3/4"

UNIT B1

₹ 36' - 3 1/2"

ŲNIT B1

2' - 4 3/4" 8' - 9 1/4" 2' - 4 3/4"

31' - 10 7/8"

36' - 1 7/8"

12' - 8 1/8"

10' - 11 7/8"

1WH4s

13' - 10 7/8"

1WF6s

5' - 1 1/4" 7' - 3 3/8"

1WF8s

8' - 3 1/2" 4' - 2 1/4" 7' - 11 3/4"

26' - 10 1/2"

12' - 6 1/2"

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BLDG 1-D - ENLARGED THIRD FLOOR PLAN SCALE: 1/8" = 1'-0"

SEE 4 /A103B

CORRIDOR

2WK46s

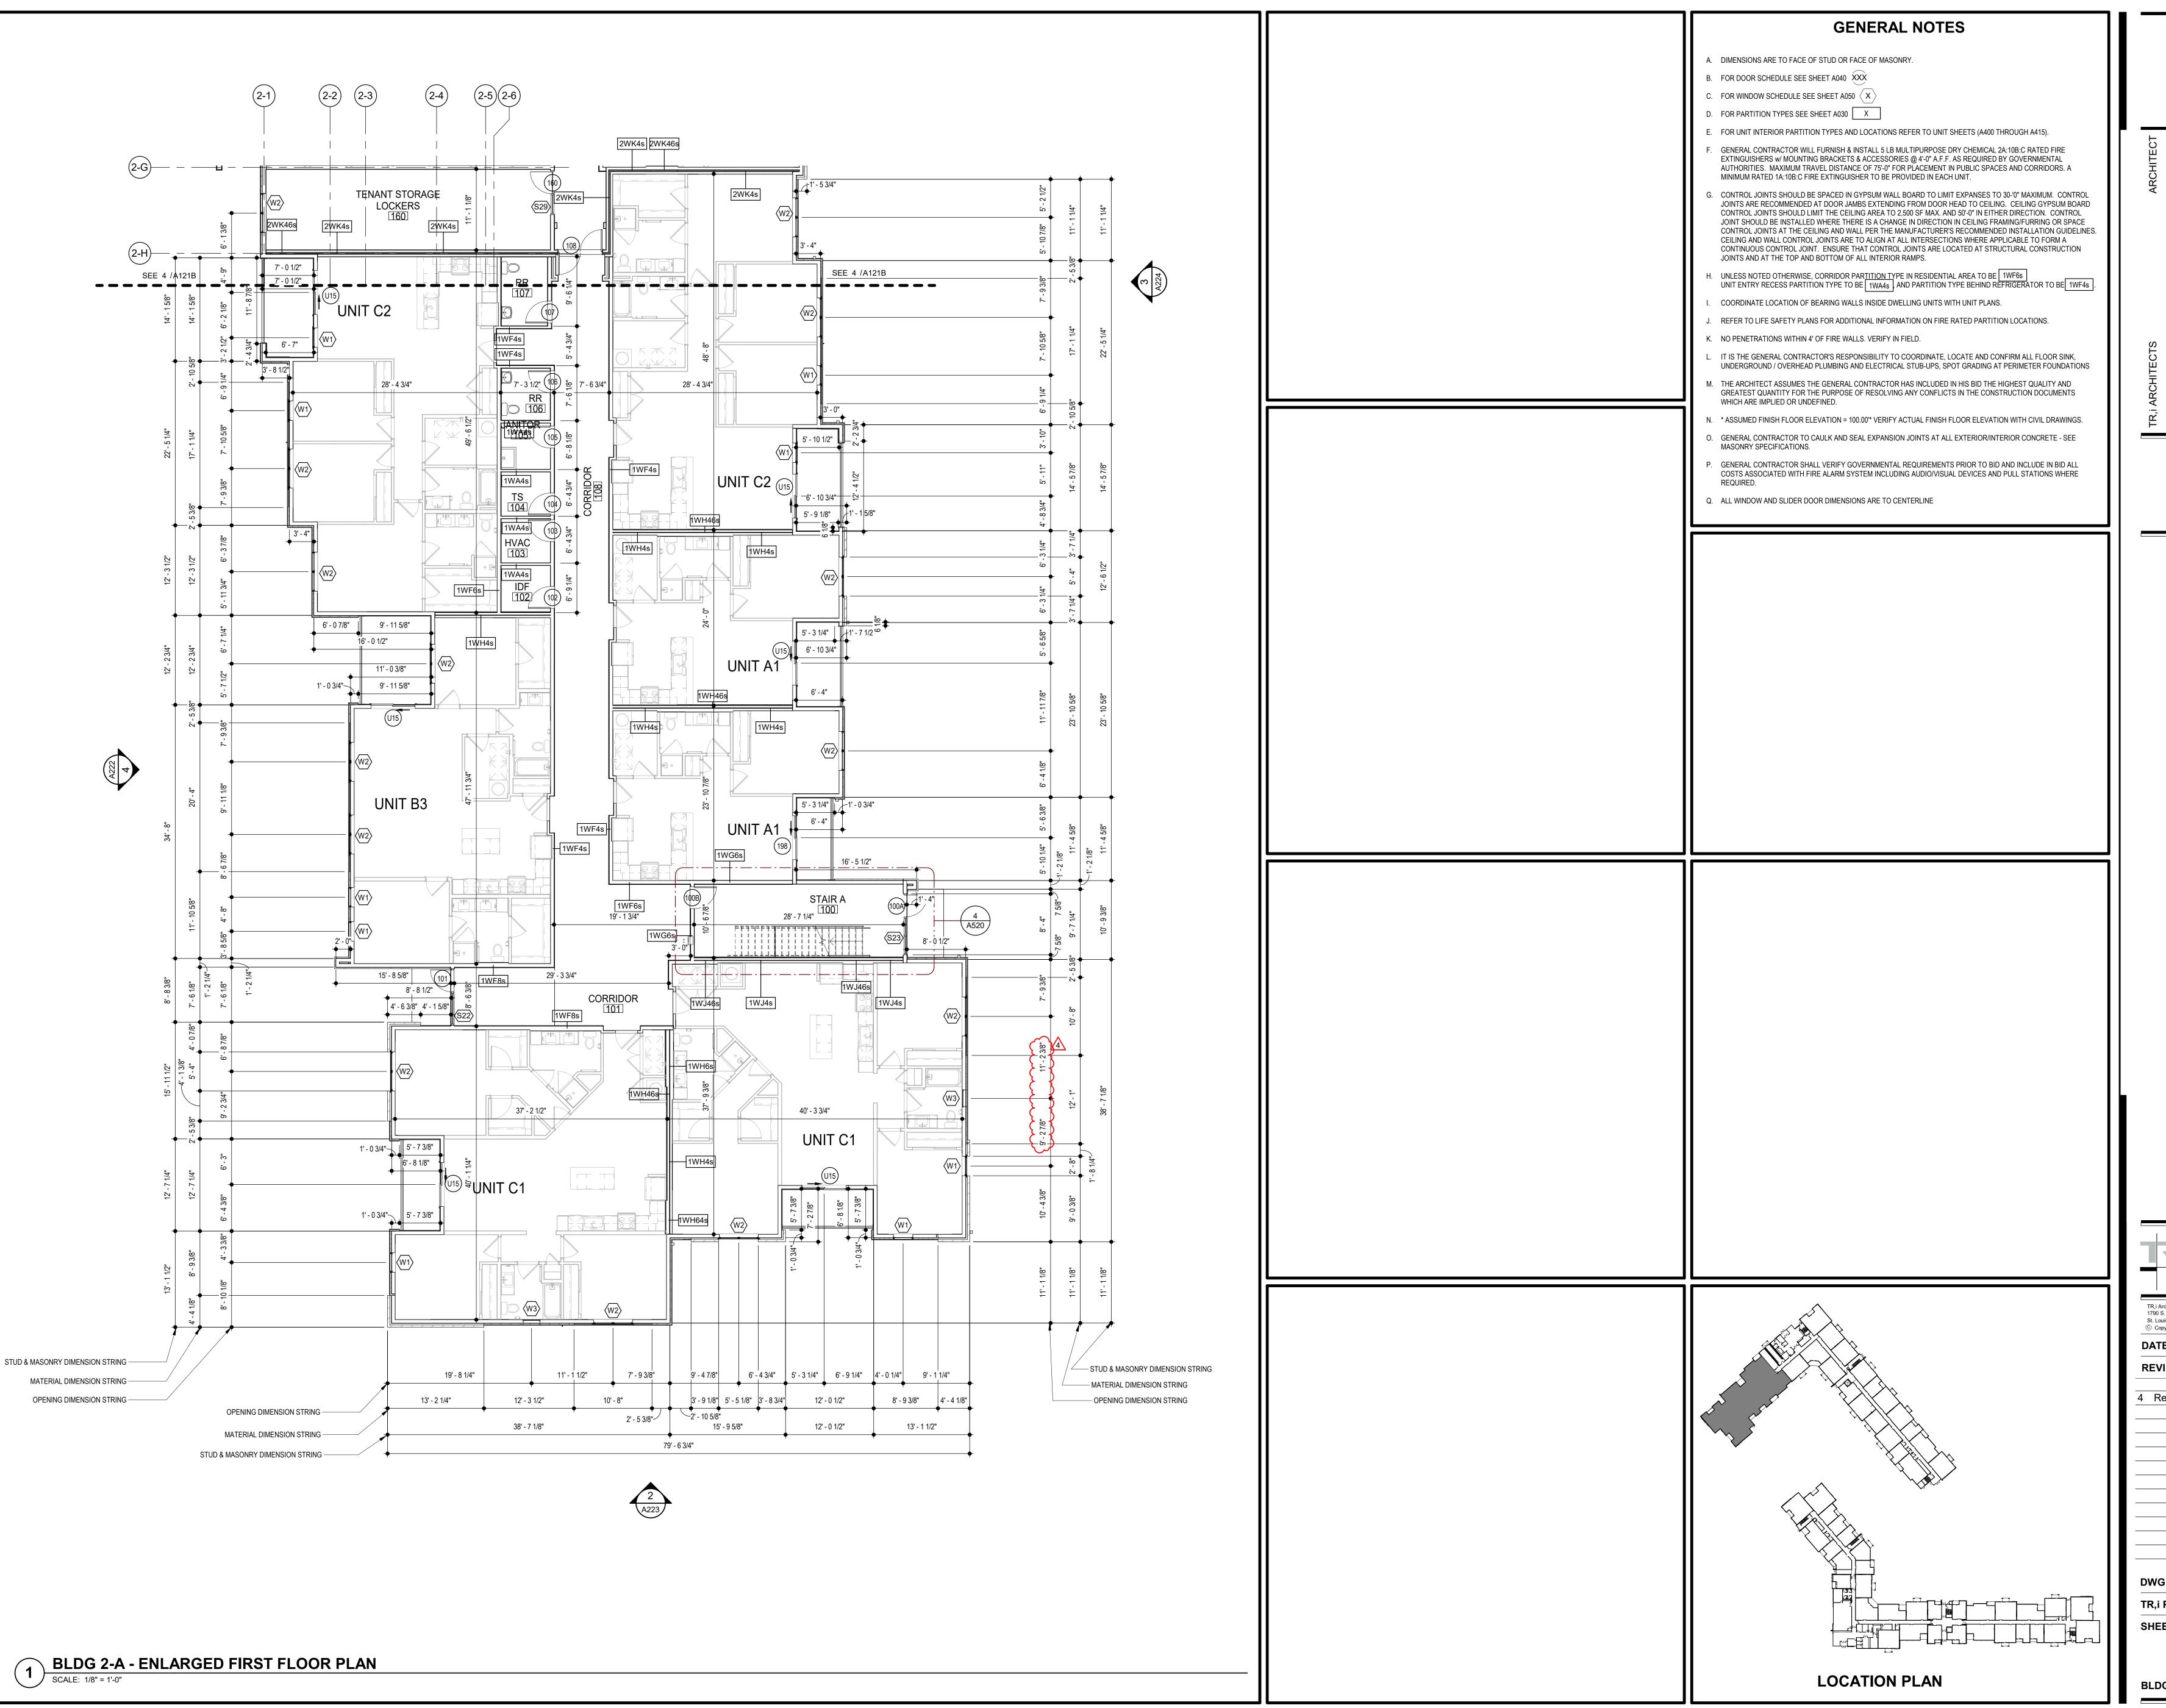
2WK46s—

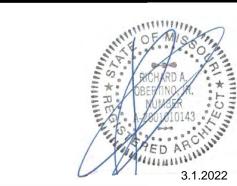
SEE 4 /A103B

4' - 3 3/8" 7' - 5 3/4" 7' - 9 3/8"

11' - 9 1/8" 2' - 5 3/8"/ 7' - 8 3/4"

+ + '+ 11' - 9 1/8" 3' - 11" 7' - 8 3/4"





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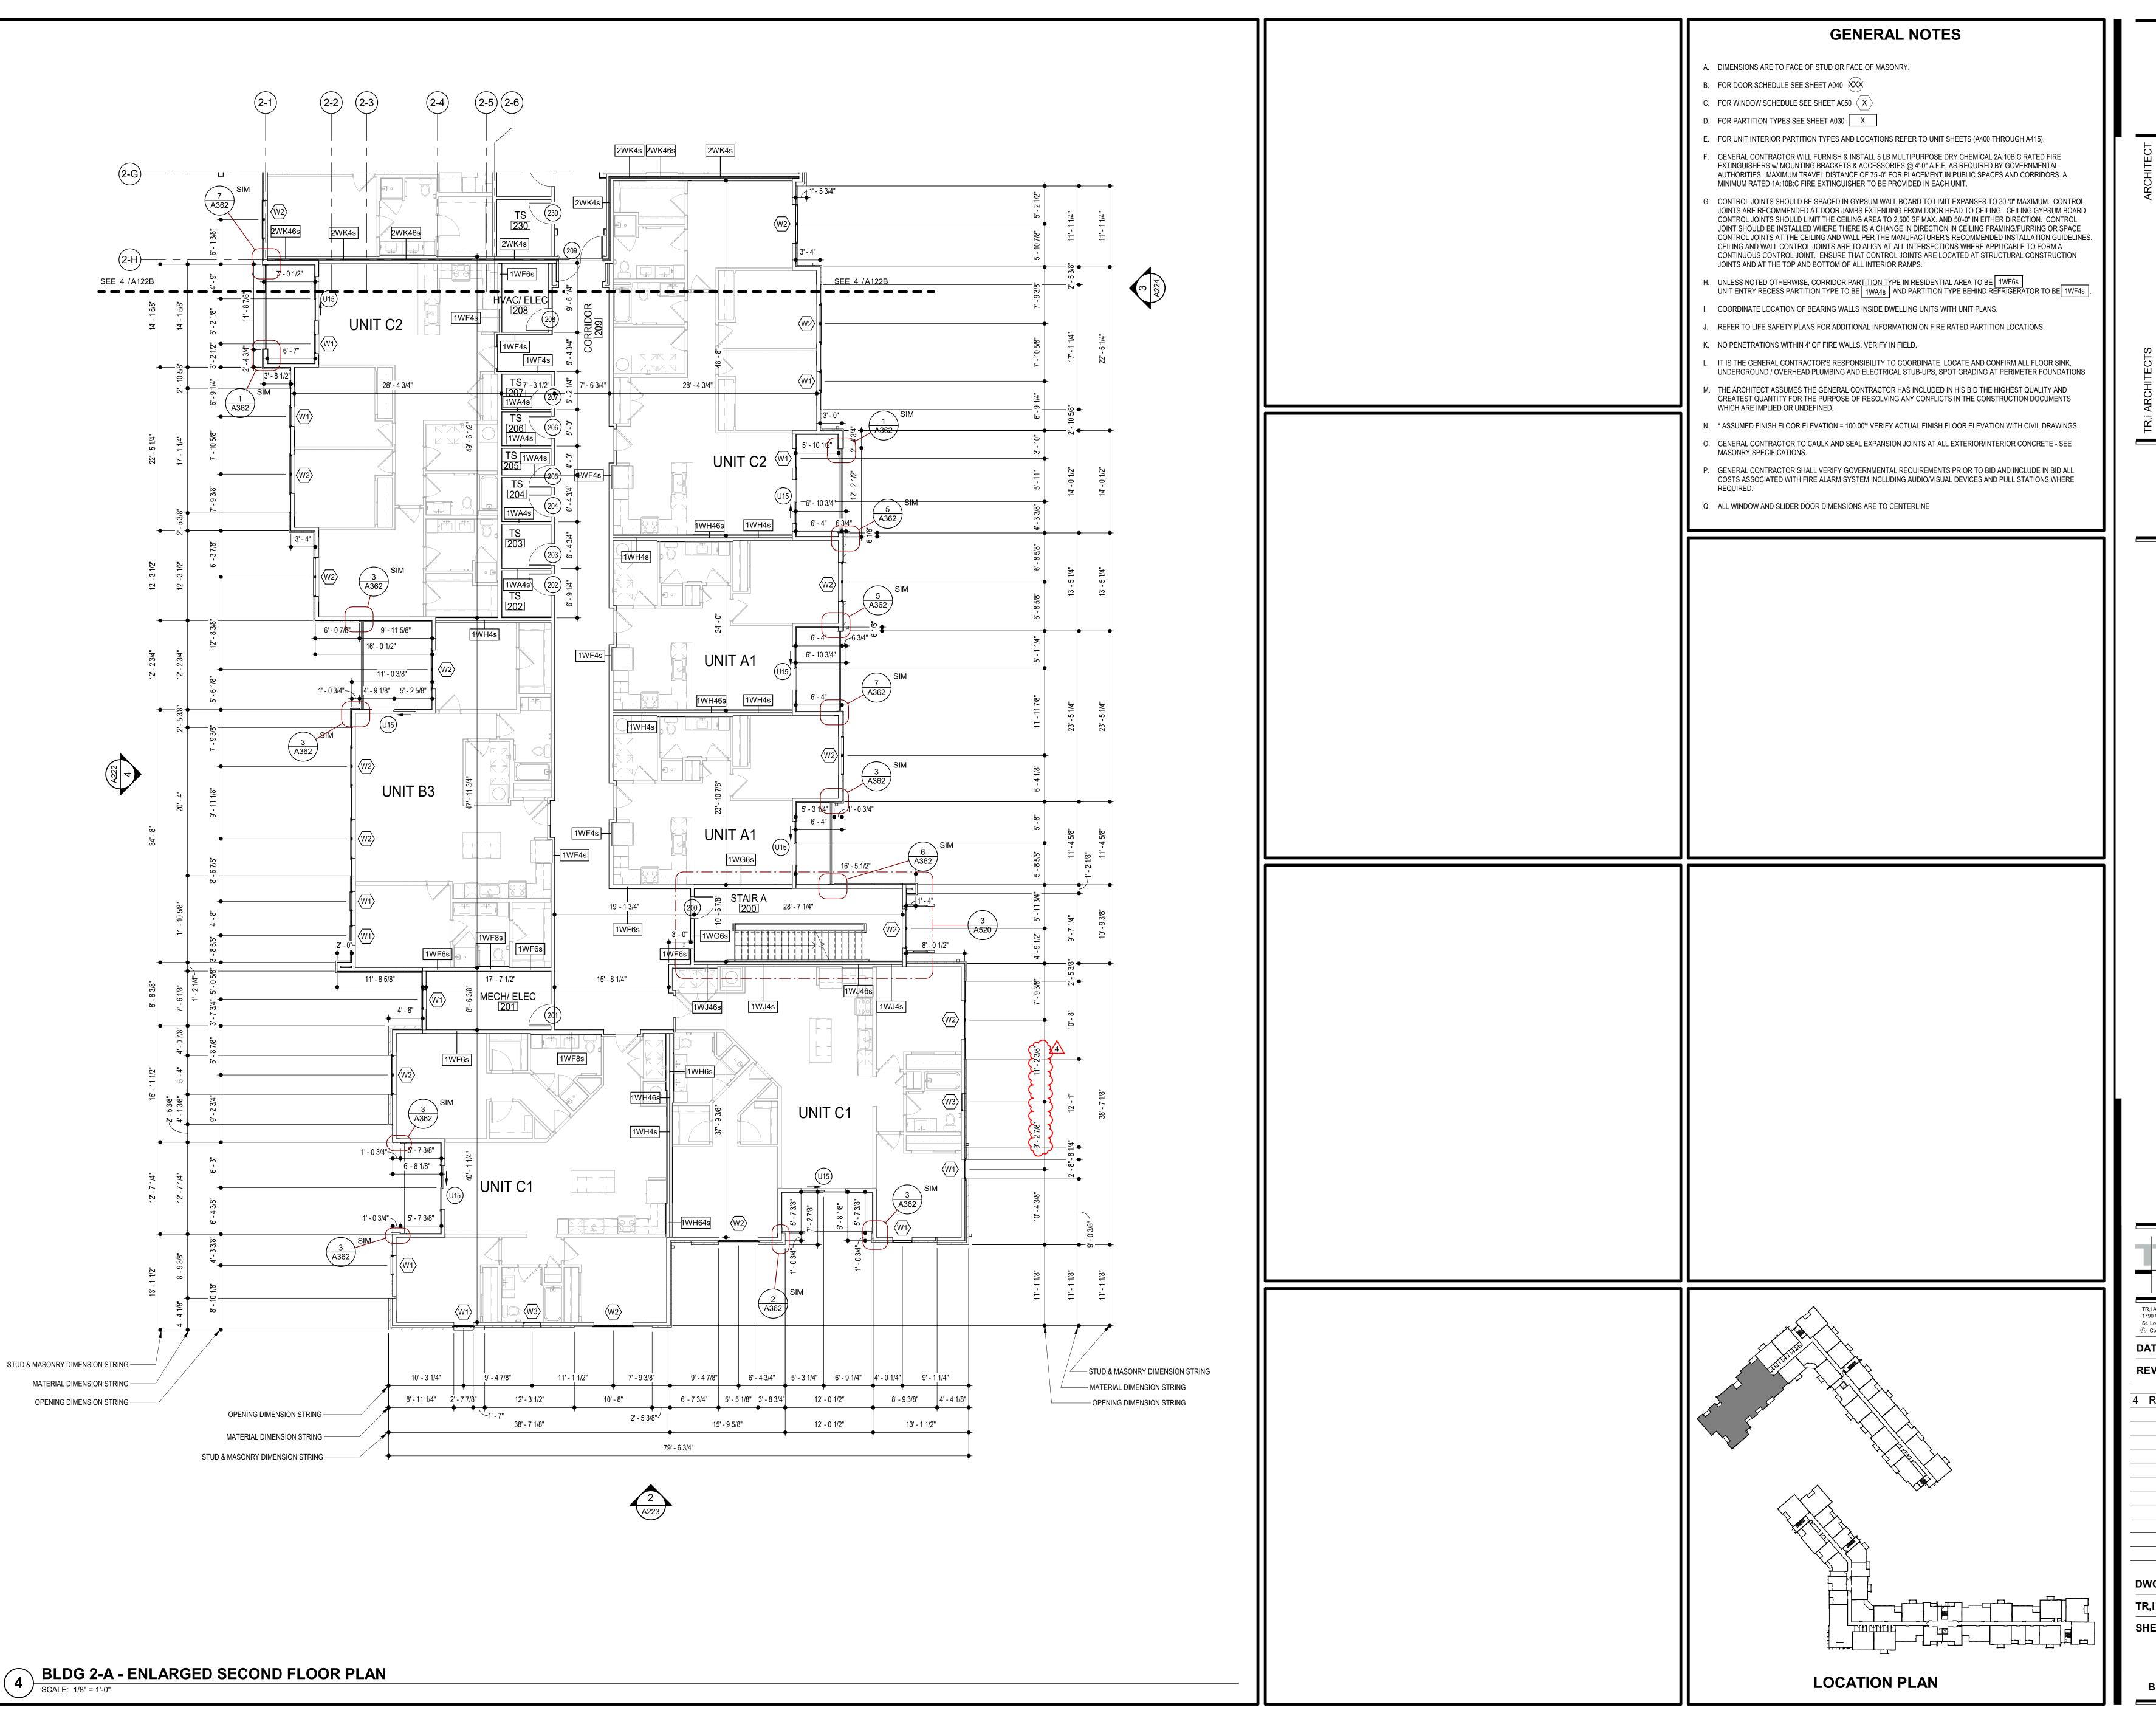
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SHEET NO.

A121A

BLDG 2-A - ENLARGED FIRST FLO



RICHARD A.

BERTINO A.

NUMBER

A. MODO 10143

A. MODO 10143

3.1.2022

ENERAL CONTRACTOR
ECHANICAL ENGINEER
ECHANICAL ENGINEER

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BRINKMANN C
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ASSOCIATES
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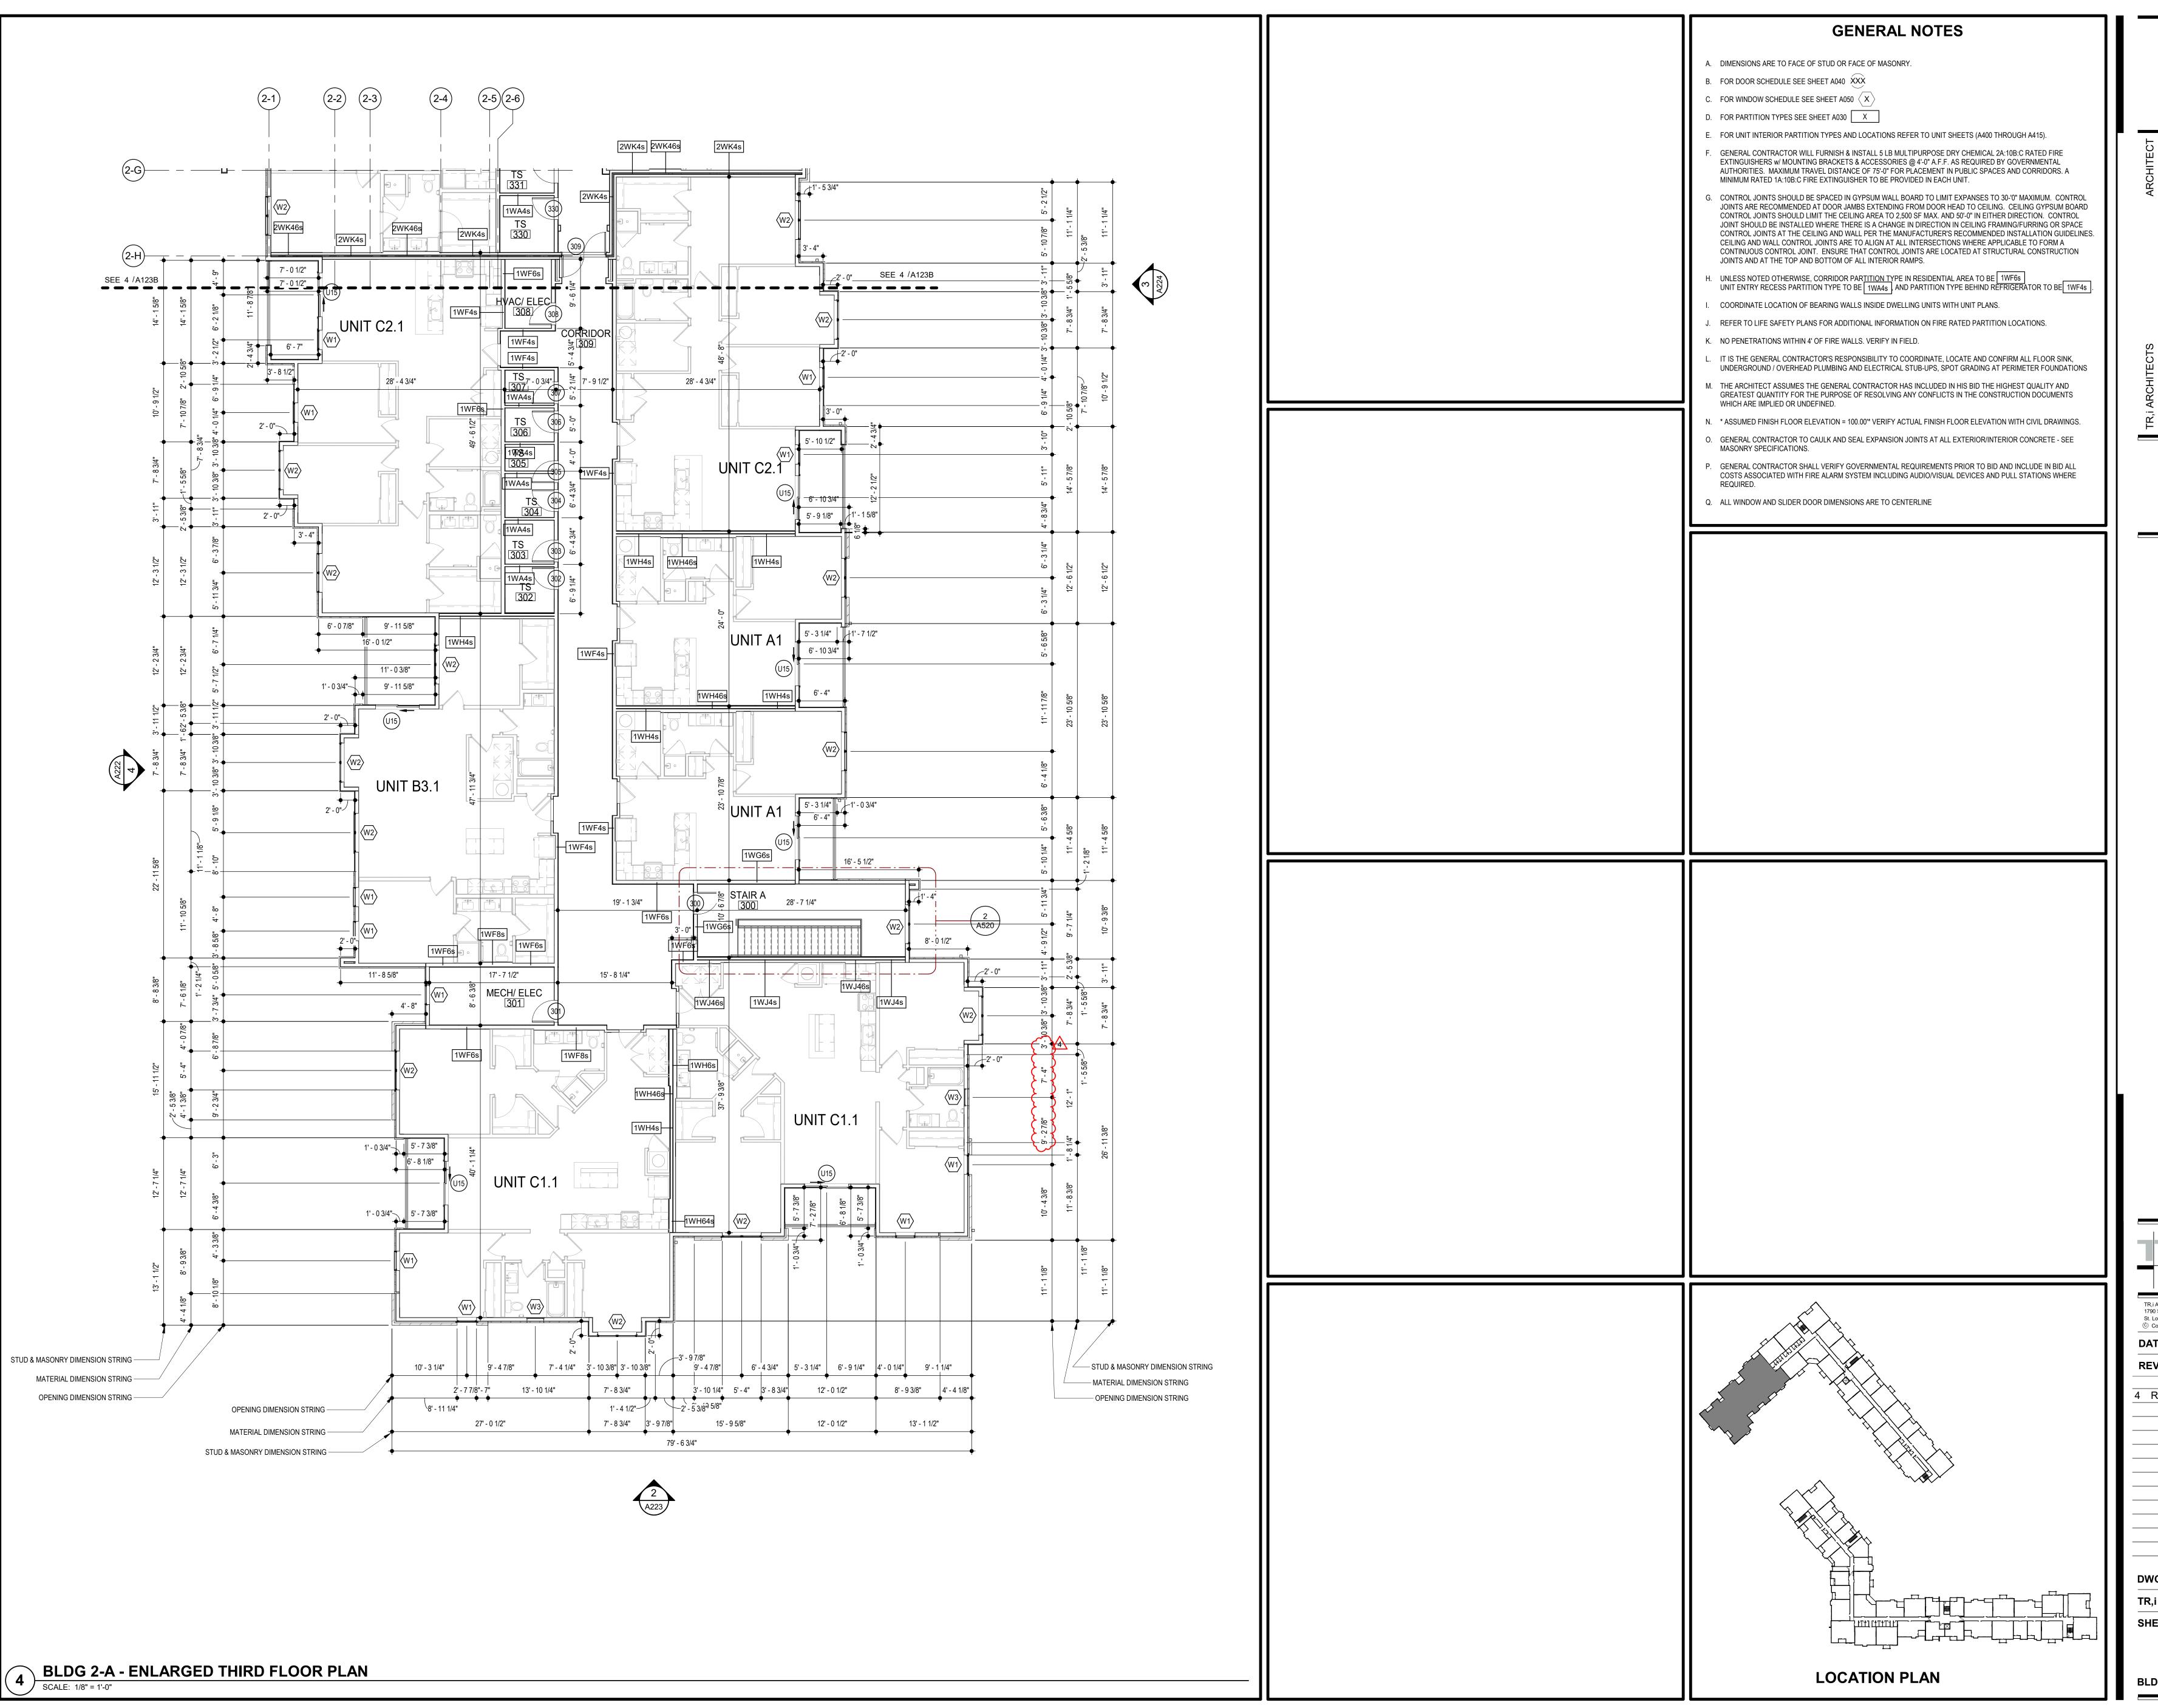
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SHEET NO.

BLDG 2-A - ENLARGED SECO





CIVIL ENGINEER

CIVIL ENGINEER

CHANICAL ENGINEER

PLUMBING ENGINEER

RING
CONSTRUCTORS
GENERA
MMERS & MECHAN
MMERS & PLUMI

BRINKMANN CONS
LATIMER SOMMER
ASSOCIATES
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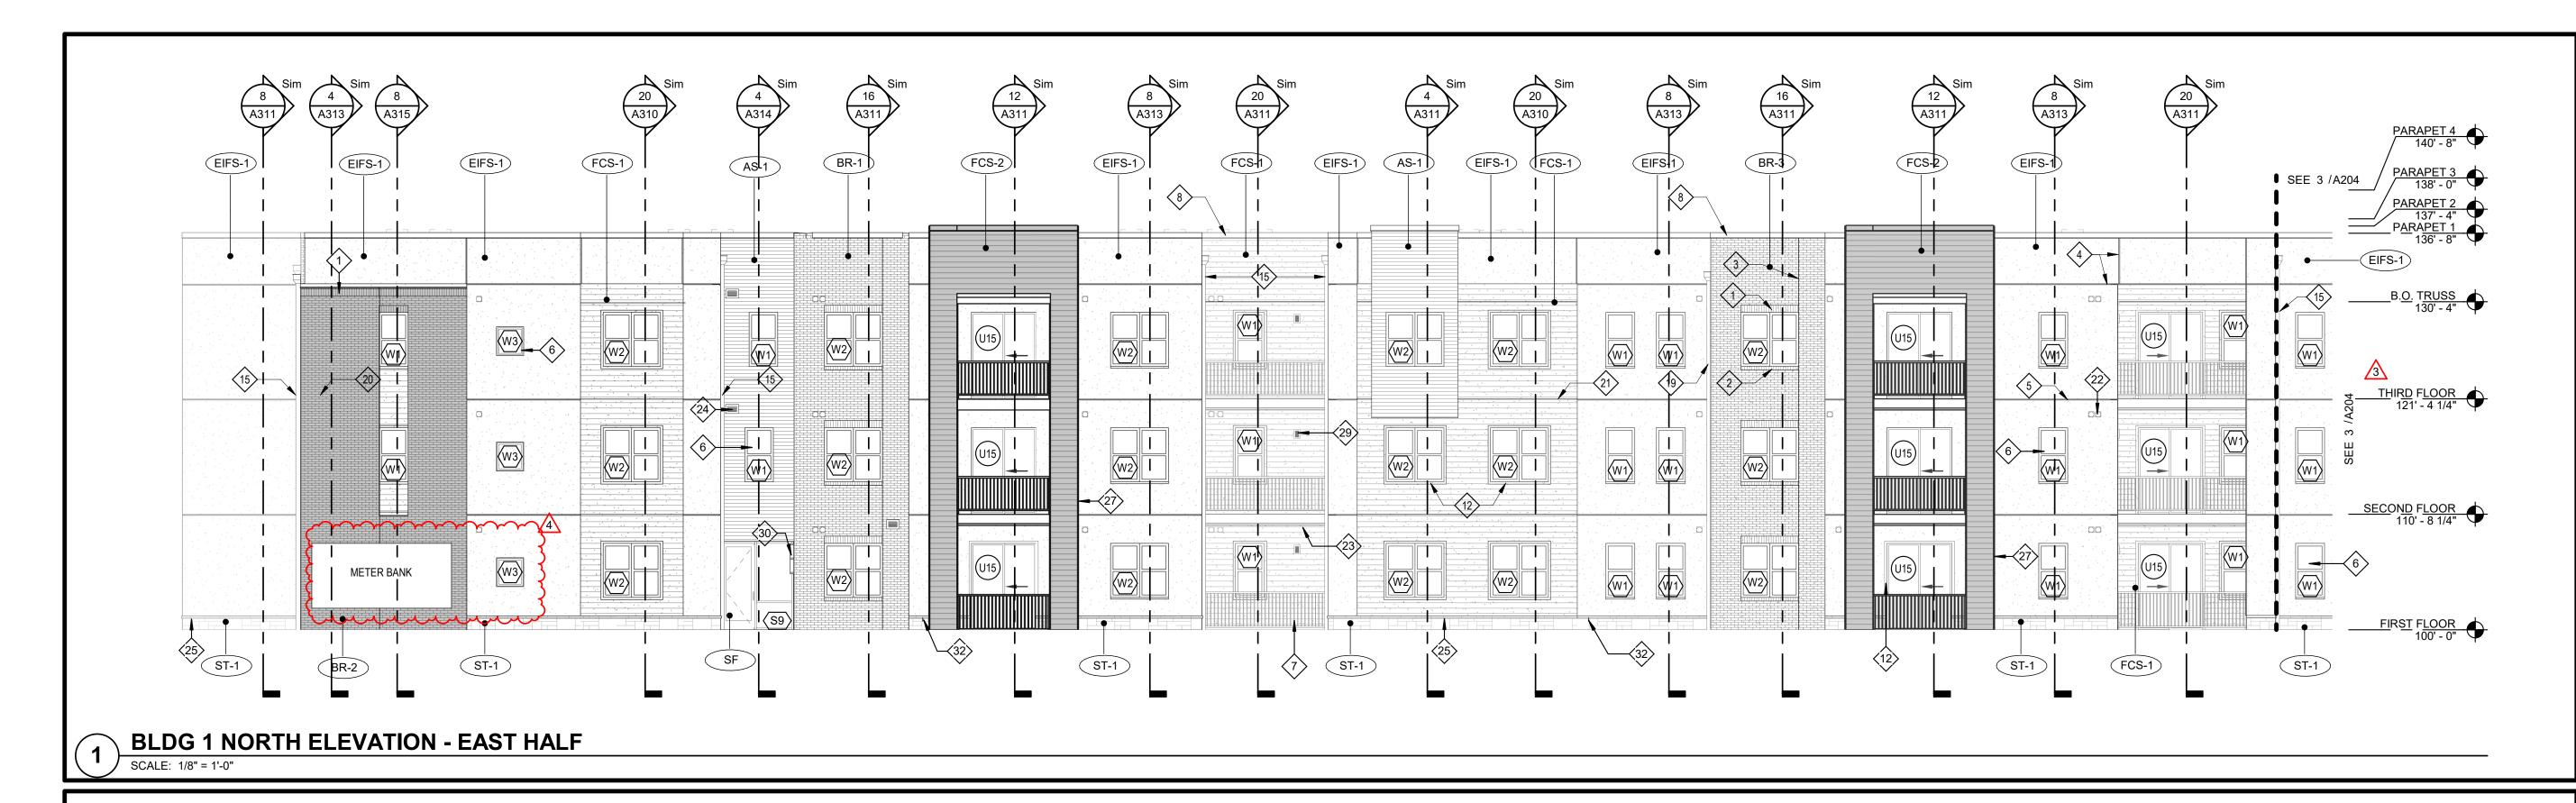
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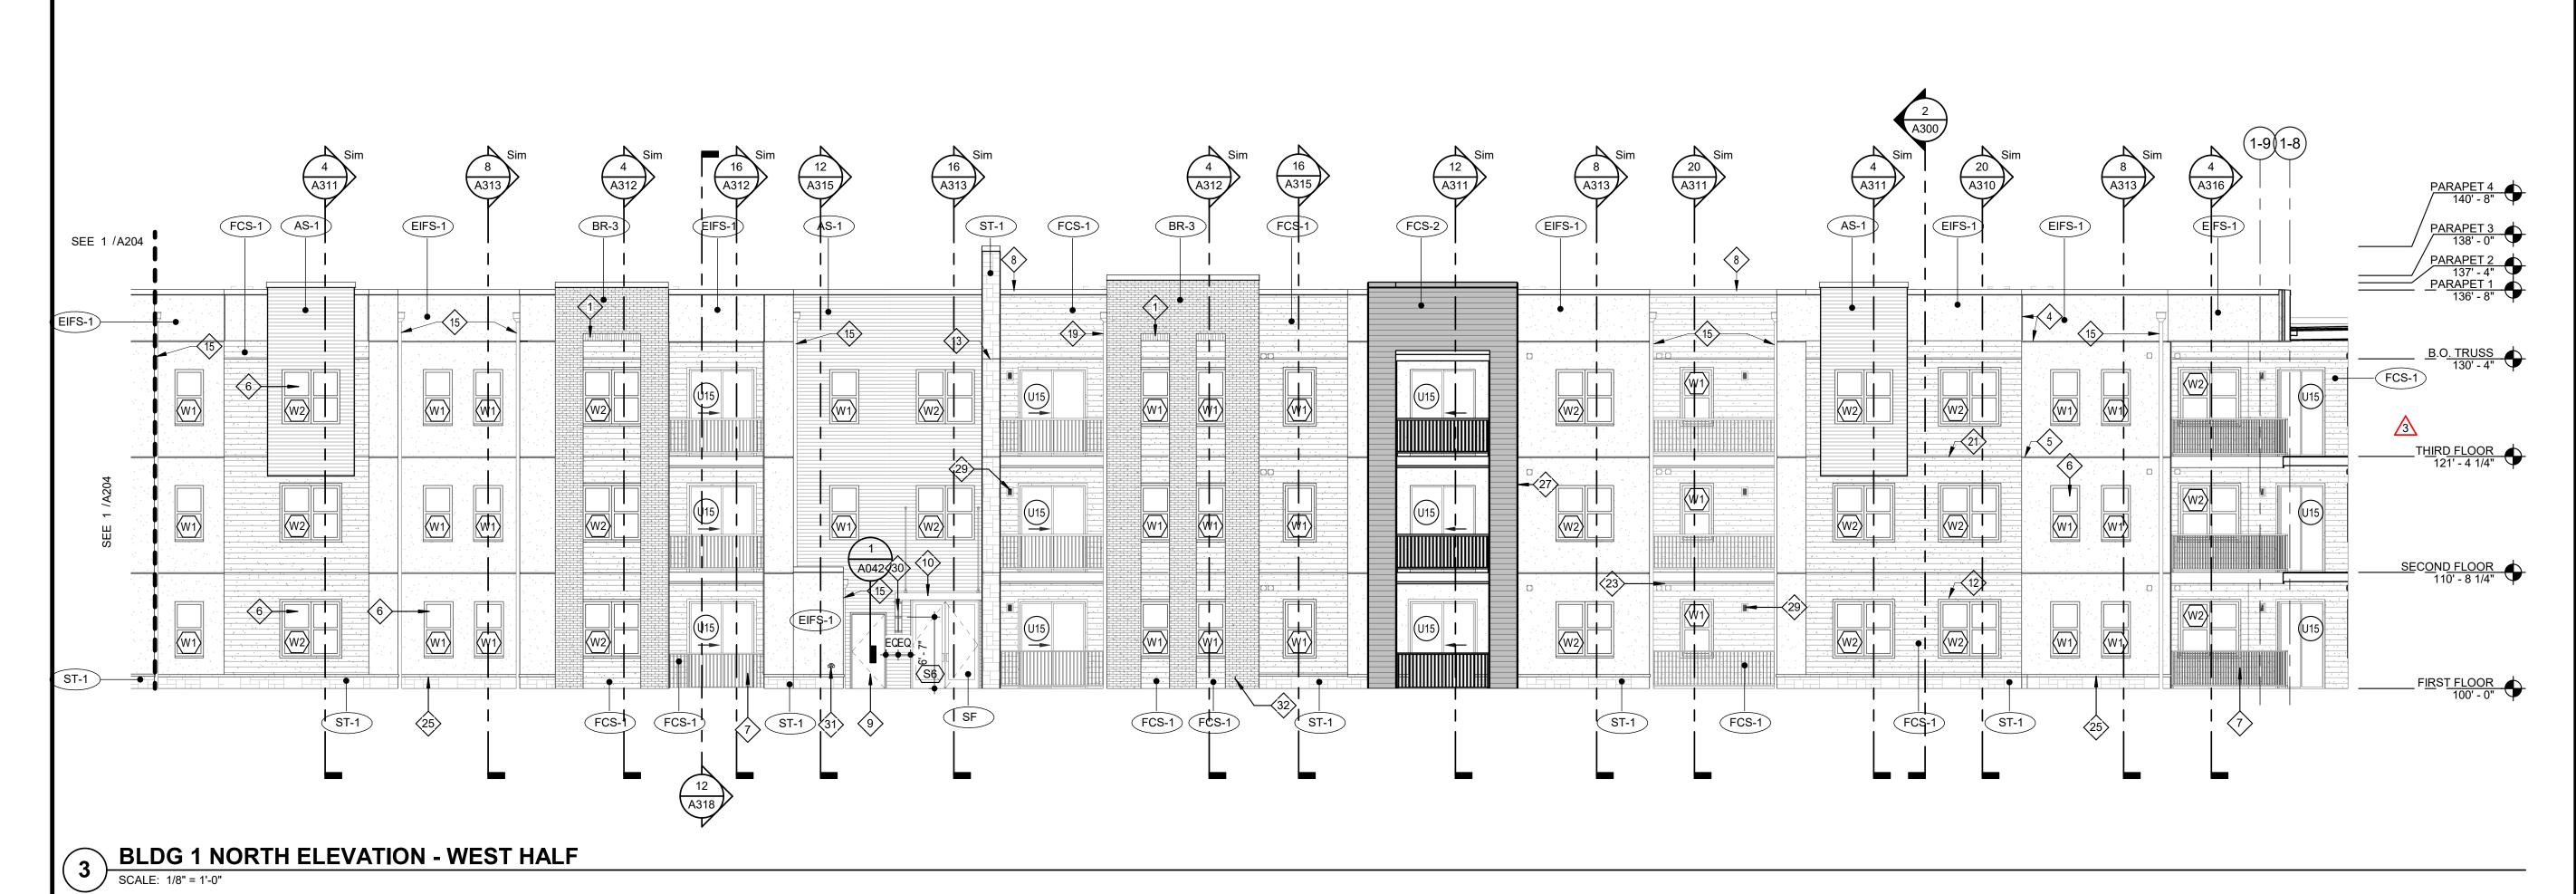
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SHEET NO.

A123A

LDG 2-A - ENLARGED THIRD FLO







		VIATERIAL LEGEND
EIFS-1	EIFS	MFR: DRYVIT, COLOR: MOONLIGHT, TEXTURE: SAND PEBBLE
AS-1	ALUMINUM SIDING	MFR: FASTPLANK, COLOR: DARK WALNUT
FCS-1	FIBER CEMENT SIDING	MFR: JAMES HARDIE, <u>SIZE:</u> 5" <u>COLOR:</u> AGED PEWTER FCT-1: <u>TRIM_THICKNESS:</u> 1" - <u>WIDTH:</u> 3 1/2"
FCS-2	FIBER CEMENT SIDING	MFR: JAMES HARDIE, <u>SIZE:</u> 5" <u>COLOR:</u> IRON GRAY FCT-2: <u>TRIM THICKNESS:</u> 1" - <u>WIDTH:</u> 3 1/2"
FCT-3	FIBER CEMENT TRIM	MFR: JAMES HARDIE, <u>THICKNESS:</u> 1", <u>WIDTH:</u> 3 1/2" COLOR: ARTIC WHITE
BR-1	BRICK	MFR: HEBRON, COLOR: SEA GRAY #6, SIZE: MODULAR
BR-2	BRICK	MFR: ENDICOTT, COLOR: DARK IRONSPOT, SIZE: MODULAR
BR-3	BRICK	MFR: HEBRON, COLOR: MAROON, SIZE: MODULAR, TEXTURE: SMOOTH
ST-1	STONE VENEER	MFR: ELDORADO STONE, <u>SERIES:</u> LEDGECUT, <u>COLOR:</u> BIRCH
SF	STOREFRONT	COLOR: BLACK GLASS: 1" CLEAR LOW-E GLASS, RE: SPEC
	EIFS-1 AS-1 FCS-1 FCS-2 FCT-3 BR-1 BR-2 ST-1	EIFS EIFS ALUMINUM SIDING FIBER CEMENT SIDING FIBER CEMENT SIDING FIBER CEMENT SIDING FIBER CEMENT SIDING BRICK BR-1 BRICK BRICK BRICK BRICK STONE VENEER STOREFRONT

KEYED NOTES 🏶

- BRICK SOLDIER COURSE PROJECTED 1/2".
- BRICK ROWLOCK COURSE.
- MASONRY VENEER CONTROL JOINT
- EIFS REVEAL.
- EIFS EXPANSION JOINT AT EACH FLOOR LEVEL, COORDINATE WITH MANUF. DETAILS AND REQUIREMENTS.
- VINYL WINDOW SYSTEM (BLACK).
- PREFINISHED GUARDRAIL (BLACK).
- PRE-FINISHED SHEET METAL COPING. COLOR TO MATCH ADJACENT MATERIAL (EIFS, FIBER CEMENT SIDING, STONE, ALUMINUM SIDING).
- HOLLOW METAL DOOR AND FRAMES TO BE PAINTED TO MATCH ADJACENT FINISH.
- PREMANUFACTURED ALUM. CANOPY COLOR BLACK.
- 11. BRAKE METAL TO MATCH STOREFRONT.
- 12. 3 1/2" WIDE HARDIE TRIM, TO MATCH ADJACENT FIBER CEMENT SIDING. TRIM AT SLIDER DOORS IN EIFS TO BE FCT-3
 - STONE VENEER EXPANSION JOINT AT EACH FLOOR LEVEL
- 14. 9 1/4" WIDE HARDIE TRIM TO MATCH ADJACENT FIBER CEMENT SIDING
- 6. PREFINISHED SCUPPER AND/OR DOWNSPOUT COLOR TO MATCH FCS-1
- 7. PREFINISHED SCUPPER AND/OR DOWNSPOUT COLOR TO MATCH FCS-2
- PREFINISHED SCUPPER AND/OR DOWNSPOUT COLOR TO MATCH AS-1

PREFINISHED SCUPPER AND/OR DOWNSPOUT COLOR TO MATCH BR-2

- 9. PREFINISHED SCUPPER AND/OR DOWNSPOUT COLOR TO MATCH BR-1
- 21. SIDING EXPANSION JOINT AT EACH FLOOR LEVEL, COORDINATE WITH MFG. DETAILS AND
- UNIT VENT CAP HEIGHTS PER DETAILS ON A230. TO MATCH ADJACENT MATERIAL
- 1X12 TREX FASCIA
- . LOUVER TO MATCH ADJACENT MATERIAL
- . STONE WATERTABLE
- METAL PANEL SYSTEM TO MATCH STOREFRONT
- 11 1/4" WIDE HARDIE TRIM TO MATCH ADJACENT FIBER CEMENT SIDING
- 9. PREFINISHED SCUPPER AND/OR DOWNSPOUT COLOR TO MATCH BR-39. UNIT PATIO LIGHT RE: UNIT LIGHTING SCHEDULE ON UNIT SHEETS
- EXTERIOR SCONCE RE: LIGHTING SCHEDULE ON UNIT SI
- EXTERIOR SCONCE RE: LIGHTING SCHEDULE
- FIRE DEPARTMENT CONNECTION

 WALL HYDRANT AT 11" ABOVE GRADE

The Signature at West Pryor

2100 AND 2150 NW LOWENSTEIN D LEE'S SUMMIT, MISSOURI 64081

ARCHITECTS

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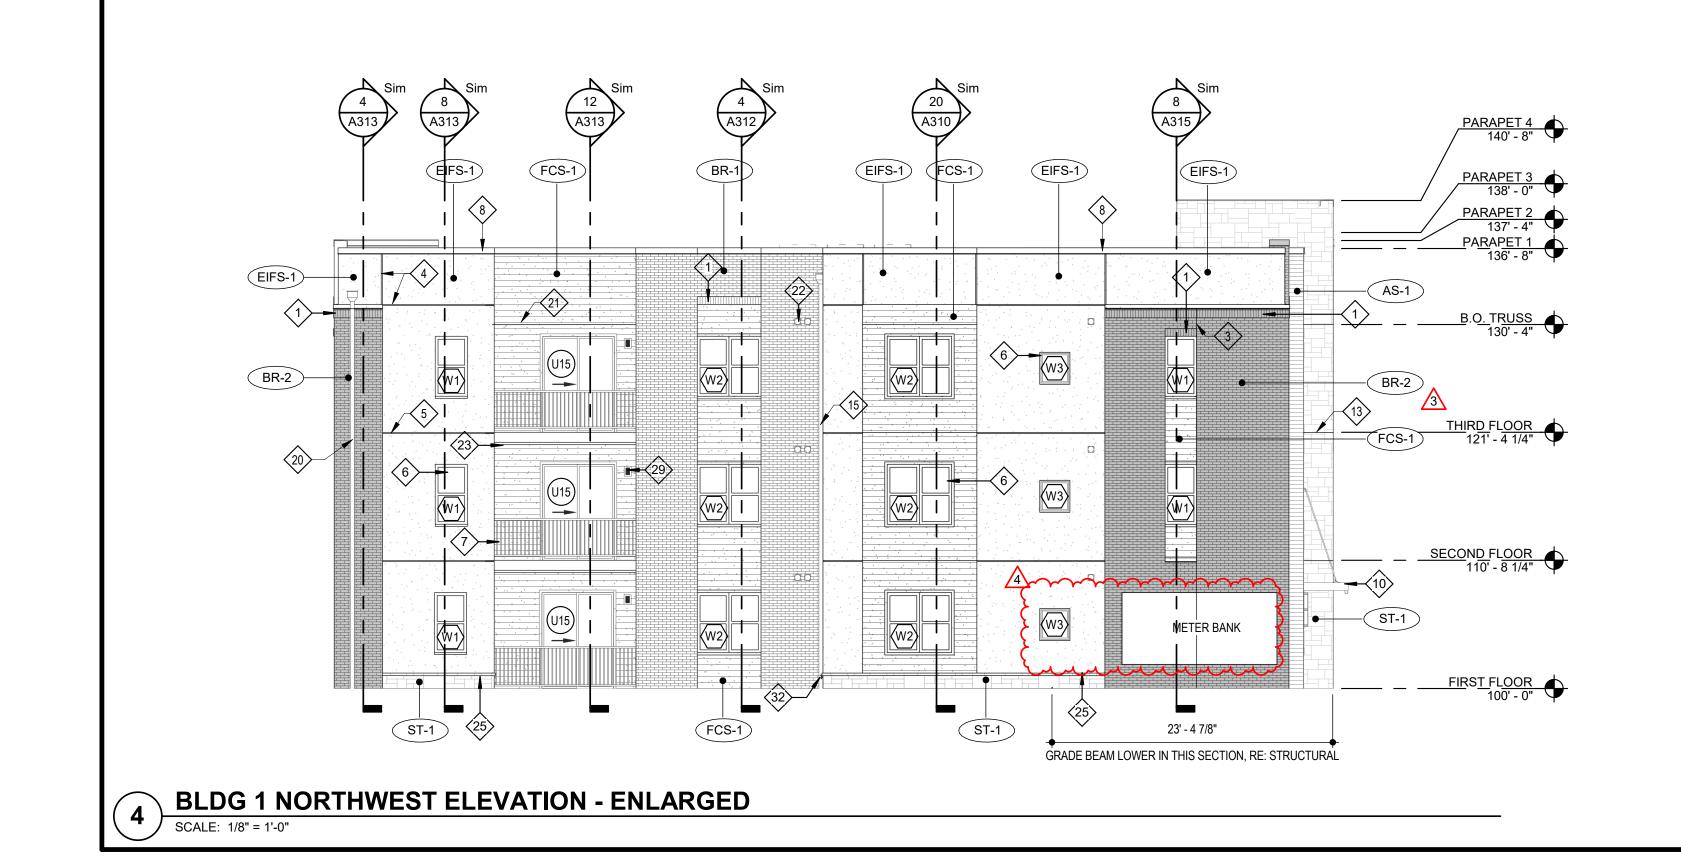
3 Revision 14 Revision 2

3.1.2022

DWG BYMKSSTR,i PROJECT NO.20-001

A204

SHEET NO.







The

2100 AND 2150 NW LOWENSTEIN L LEE'S SUMMIT, MISSOURI 64081

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1790 S. Brentwood Blvd. T: 314-395-9750 www.triarchitects.com 7.15.2021


Revision 1

2.11.2022

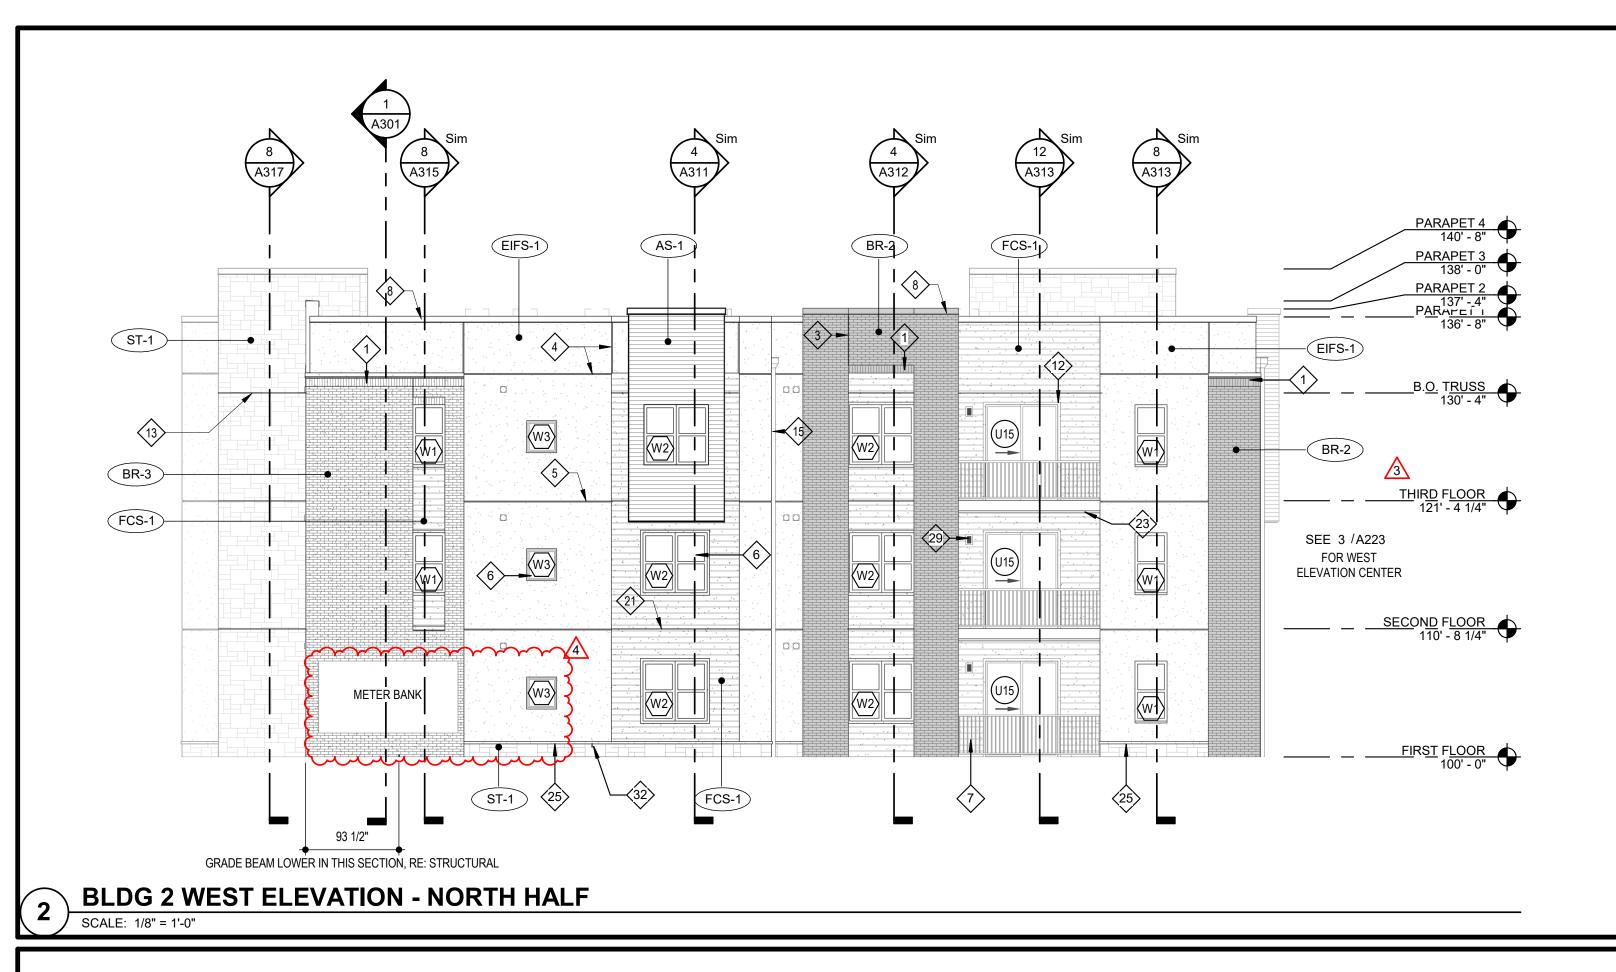3.1.2022

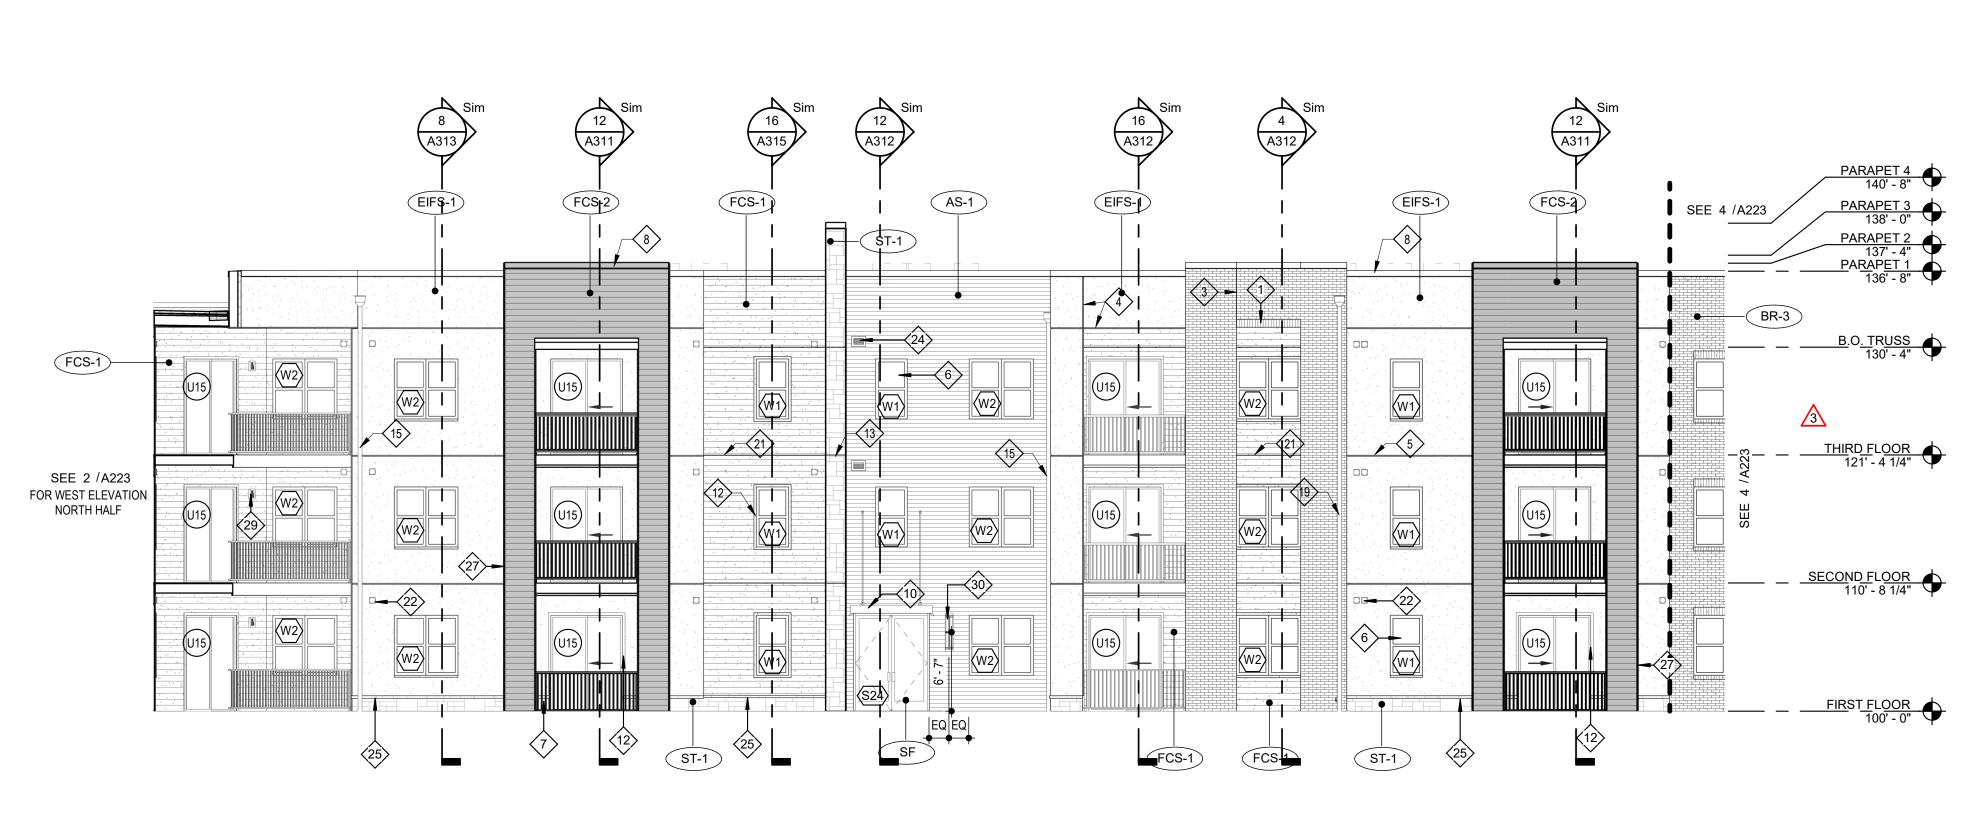
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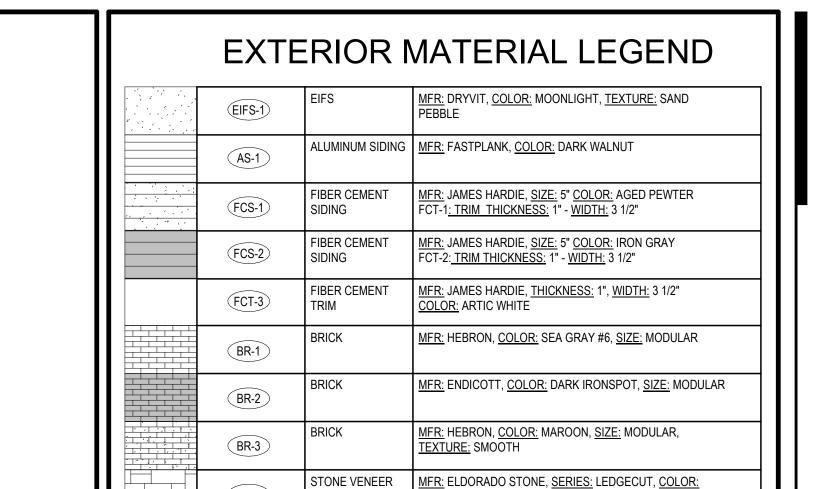
BLDG 2 - ENLARGED EAST



→ BLDG 2 WEST ELEVATION - SOUTH HALF

SCALE: 1/8" = 1'-0"





KEYED NOTES 🏵

COLOR: BLACK

GLASS: 1" CLEAR LOW-E GLASS, RE: SPEC

- 1. BRICK SOLDIER COURSE PROJECTED 1/2".
- BRICK ROWLOCK COURSE.
- MASONRY VENEER CONTROL JOINT
- EIFS REVEAL.
- REQUIREMENTS.
- . VINYL WINDOW SYSTEM (BLACK).
- 8. PRE-FINISHED SHEET METAL COPING. COLOR TO MATCH ADJACENT MATERIAL (EIFS, FIBER CEMENT SIDING, STONE, ALUMINUM SIDING).

EIFS EXPANSION JOINT AT EACH FLOOR LEVEL, COORDINATE WITH MANUF. DETAILS AND

- HOLLOW METAL DOOR AND FRAMES TO BE PAINTED TO MATCH ADJACENT FINISH.
- 10. PREMANUFACTURED ALUM. CANOPY COLOR BLACK.

PREFINISHED GUARDRAIL (BLACK).

- 11. BRAKE METAL TO MATCH STOREFRONT.
- 12. 3 1/2" WIDE HARDIE TRIM, TO MATCH ADJACENT FIBER CEMENT SIDING. TRIM AT SLIDER DOORS IN EIFS TO BE FCT-3
- 13. STONE VENEER EXPANSION JOINT AT EACH FLOOR LEVEL
- 9 1/4" WIDE HARDIE TRIM TO MATCH ADJACENT FIBER CEMENT SIDING
- PREFINISHED SCUPPER AND/OR DOWNSPOUT COLOR TO MATCH EIFS-1
- PREFINISHED SCUPPER AND/OR DOWNSPOUT COLOR TO MATCH FCS-1
- PREFINISHED SCUPPER AND/OR DOWNSPOUT COLOR TO MATCH FCS-2
- PREFINISHED SCUPPER AND/OR DOWNSPOUT COLOR TO MATCH AS-1
- PREFINISHED SCUPPER AND/OR DOWNSPOUT COLOR TO MATCH BR-1
 PREFINISHED SCUPPER AND/OR DOWNSPOUT COLOR TO MATCH BR-2
- SIDING EXPANSION JOINT AT EACH FLOOR LEVEL, COORDINATE WITH MFG. DETAILS AND REQUIREMENTS
- UNIT VENT CAP HEIGHTS PER DETAILS ON A230. TO MATCH ADJACENT MATERIAL
- 1X12 TREX FASCIA
- 24. LOUVER TO MATCH ADJACENT MATERIAL
- 25. STONE WATERTABLE
 - METAL PANEL SYSTEM TO MATCH STOREFRONT
 - 11 1/4" WIDE HARDIE TRIM TO MATCH ADJACENT FIBER CEMENT SIDING
 - PREFINISHED SCUPPER AND/OR DOWNSPOUT COLOR TO MATCH BR-3
 UNIT PATIO LIGHT RE: UNIT LIGHTING SCHEDULE ON UNIT SHEETS
- EXTERIOR SCONCE RE: LIGHTING SCHEDULE
- FIRE DEPARTMENT CONNECTION
- 32. WALL HYDRANT AT 11" ABOVE GRADE

The Signature at West Pryor

2100 AND 2150 NW LOWENSTEIN D LEE'S SUMMIT, MISSOURI 64081

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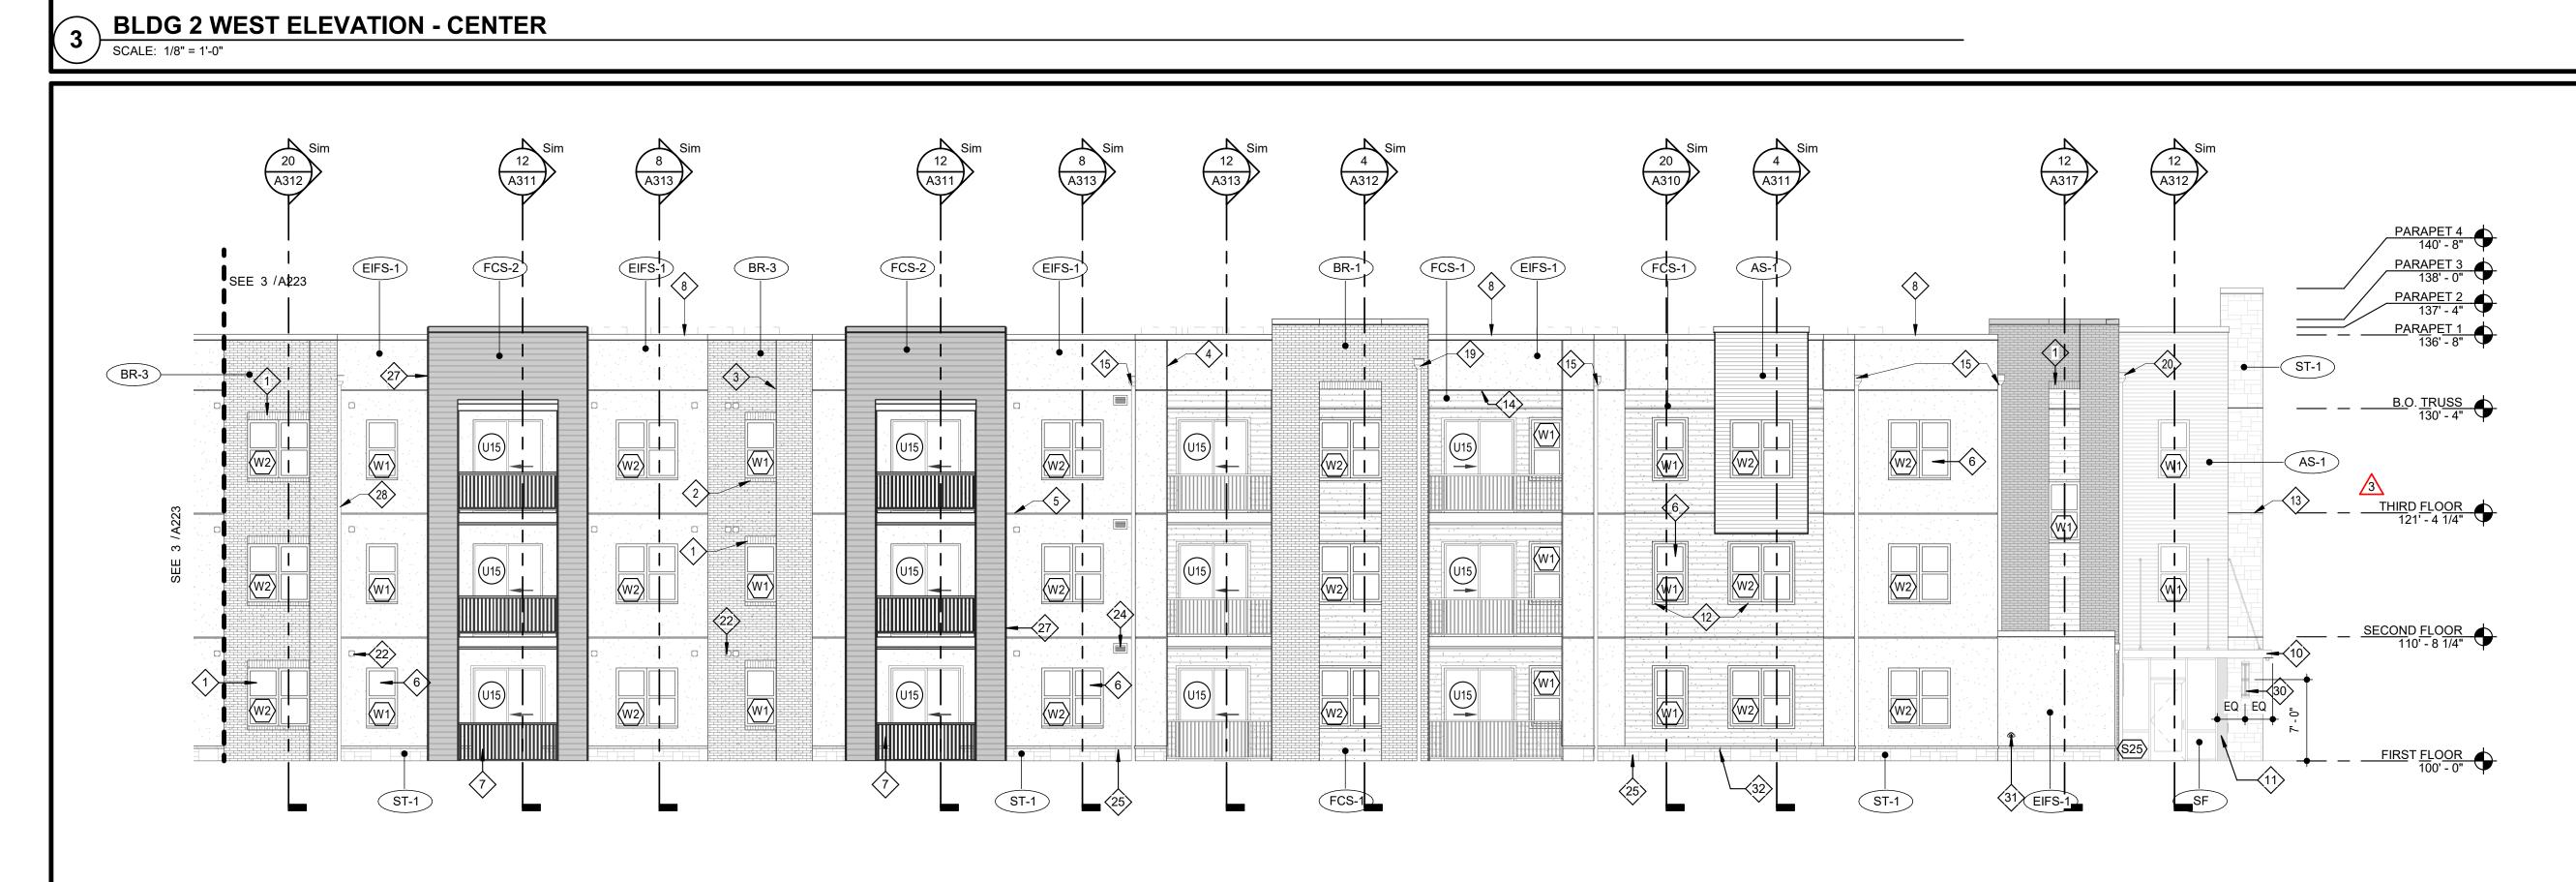
T: 314-395-9750 www.triarchitects.com

DATE:
7.15.2021

3 Revision 1 2.11.2022 4 Revision 2 3.1.2022

TR,i PROJECT NO. 20-0
SHEET NO.

BLDG 2 - ENLARGED WEST
ELEVATIONS





00 AND 2150 NW LOWENSTEIN DIEE'S SUMMIT, MISSOURI 64081

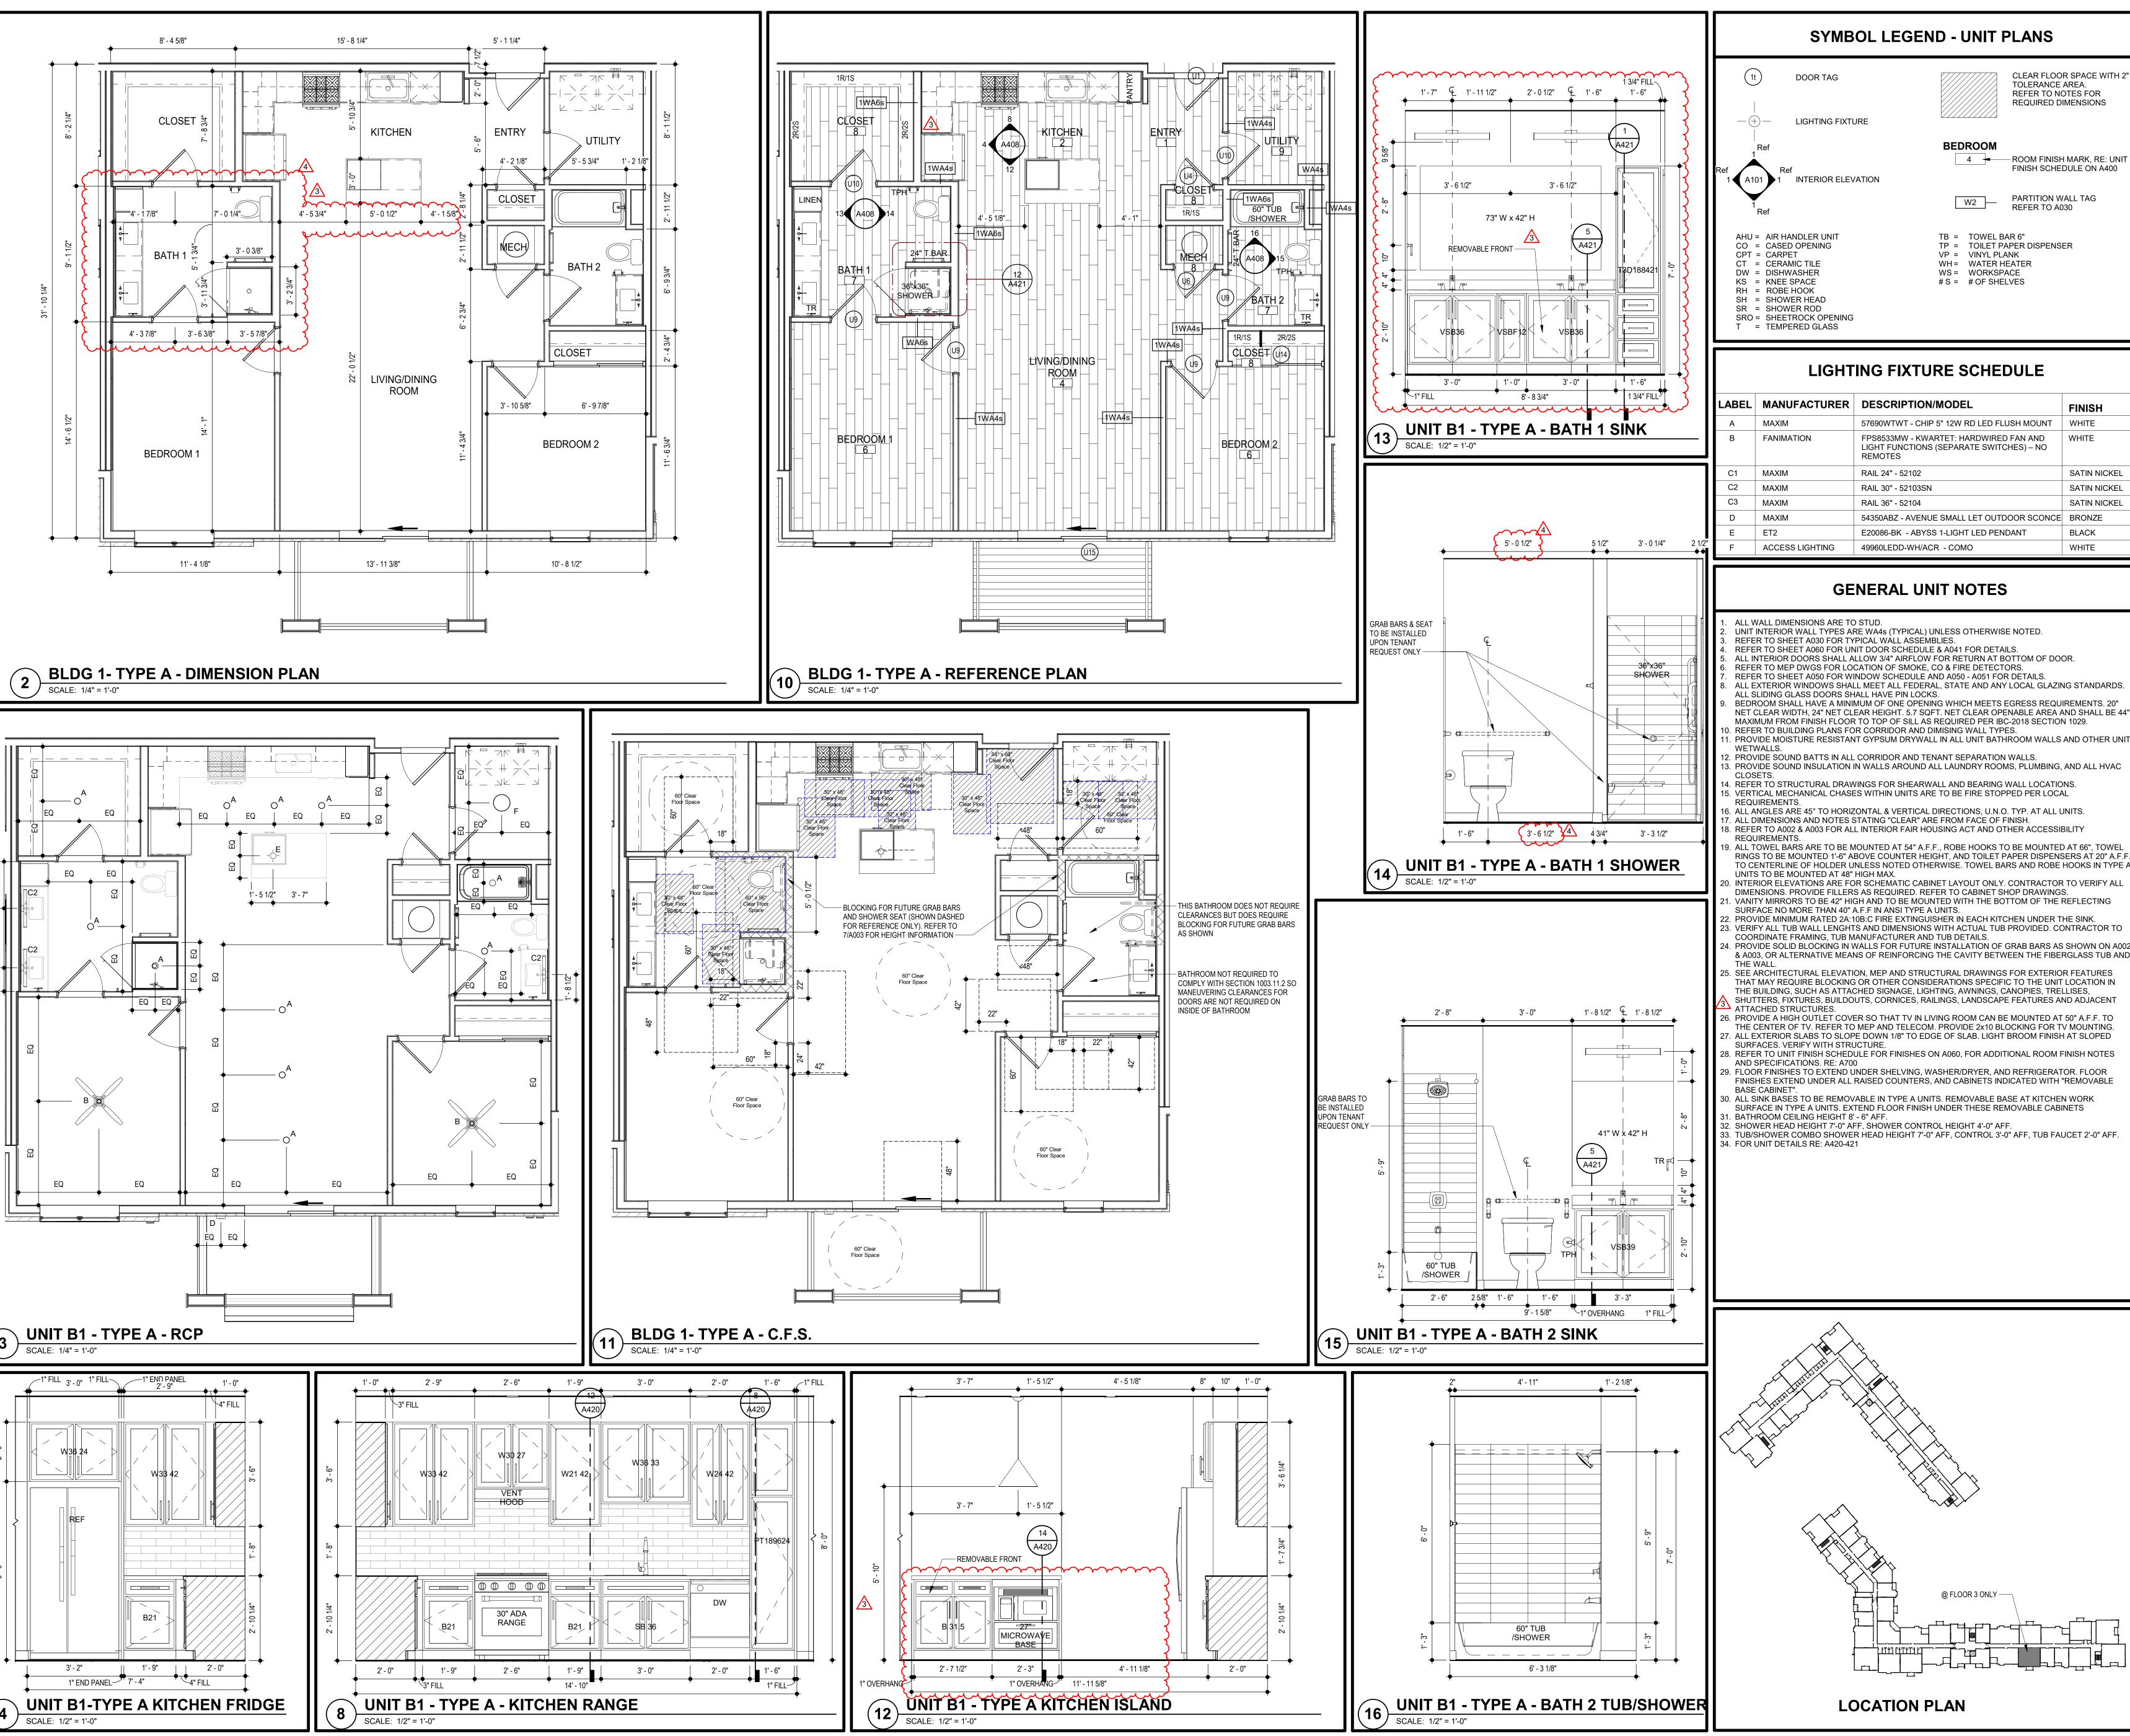
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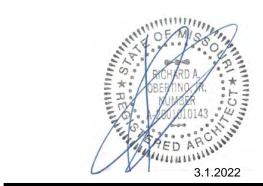
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DWG BY TR,i PROJECT NO. SHEET NO.

UNIT A4-TYPE A - PLANS AND





00 AND 2150 NW LOWENSTEIN DIEE'S SUMMIT, MISSOURI 64081

GENERAL UNIT NOTES

E20086-BK - ABYSS 1-LIGHT LED PENDANT

LIGHTING FIXTURE SCHEDULE

SYMBOL LEGEND - UNIT PLANS

BEDROOM

TB = TOWEL BAR 6"

VP = VINYL PLANK

WS = WORKSPACE #S = #OF SHELVES

57690WTWT - CHIP 5" 12W RD LED FLUSH MOUNT WHITE

54350ABZ - AVENUE SMALL LET OUTDOOR SCONCE BRONZE

FPS8533MW - KWARTET: HARDWIRED FAN AND

LIGHT FUNCTIONS (SEPARATE SWITCHES) - NO

WH = WATER HEATER

TP = TOILET PAPER DISPENSER

CLEAR FLOOR SPACE WITH 2"

FINISH SCHEDULE ON A400

FINISH

SATIN NICKEL

SATIN NICKEL

SATIN NICKEL

BLACK

WHITE

PARTITION WALL TAG REFER TO A030

TOLERANCE AREA.

4 ROOM FINISH MARK, RE: UNIT

REFER TO NOTES FOR REQUIRED DIMENSIONS

ALL WALL DIMENSIONS ARE TO STUD.

DOOR TAG

LIGHTING FIXTURE

UNIT INTERIOR WALL TYPES ARE WA4s (TYPICAL) UNLESS OTHERWISE NOTED. REFER TO SHEET A030 FOR TYPICAL WALL ASSEMBLIES.

REMOTES

RAIL 24" - 52102

RAIL 36" - 52104

RAIL 30" - 52103SN

REFER TO SHEET A060 FOR UNIT DOOR SCHEDULE & A041 FOR DETAILS. ALL INTERIOR DOORS SHALL ALLOW 3/4" AIRFLOW FOR RETURN AT BOTTOM OF DOOR. . REFER TO MEP DWGS FOR LOCATION OF SMOKE, CO & FIRE DETECTORS.

49960LEDD-WH/ACR - COMO

. REFER TO SHEET A050 FOR WINDOW SCHEDULE AND A050 - A051 FOR DETAILS. . ALL EXTERIOR WINDOWS SHALL MEET ALL FEDERAL, STATE AND ANY LOCAL GLAZING STANDARDS

ALL SLIDING GLASS DOORS SHALL HAVE PIN LOCKS. BEDROOM SHALL HAVE A MINIMUM OF ONE OPENING WHICH MEETS EGRESS REQUIREMENTS. 20"

NET CLEAR WIDTH, 24" NET CLEAR HEIGHT. 5.7 SQFT. NET CLEAR OPENABLE AREA AND SHALL BE 44" MAXIMUM FROM FINISH FLOOR TO TOP OF SILL AS REQUIRED PER IBC-2018 SECTION 1029. D. REFER TO BUILDING PLANS FOR CORRIDOR AND DIMISING WALL TYPES.

. PROVIDE MOISTURE RESISTANT GYPSUM DRYWALL IN ALL UNIT BATHROOM WALLS AND OTHER UNIT 2. PROVIDE SOUND BATTS IN ALL CORRIDOR AND TENANT SEPARATION WALLS.

3. PROVIDE SOUND INSULATION IN WALLS AROUND ALL LAUNDRY ROOMS, PLUMBING, AND ALL HVAC

14. REFER TO STRUCTURAL DRAWINGS FOR SHEARWALL AND BEARING WALL LOCATIONS. 5. VERTICAL MECHANICAL CHASES WITHIN UNITS ARE TO BE FIRE STOPPED PER LOCAL

6. ALL ANGLES ARE 45° TO HORIZONTAL & VERTICAL DIRECTIONS, U.N.O. TYP. AT ALL UNITS.

7. ALL DIMENSIONS AND NOTES STATING "CLEAR" ARE FROM FACE OF FINISH 18. REFER TO A002 & A003 FOR ALL INTERIOR FAIR HOUSING ACT AND OTHER ACCESSIBILITY 9. ALL TOWEL BARS ARE TO BE MOUNTED AT 54" A.F.F., ROBE HOOKS TO BE MOUNTED AT 66", TOWEL RINGS TO BE MOUNTED 1'-6" ABOVE COUNTER HEIGHT, AND TOILET PAPER DISPENSERS AT 20" A.F.F.

TO CENTERLINE OF HOLDER UNLESS NOTED OTHERWISE. TOWEL BARS AND ROBE HOOKS IN TYPE A UNITS TO BE MOUNTED AT 48" HIGH MAX. INTERIOR ELEVATIONS ARE FOR SCHEMATIC CABINET LAYOUT ONLY. CONTRACTOR TO VERIFY ALL

DIMENSIONS. PROVIDE FILLERS AS REQUIRED. REFER TO CABINET SHOP DRAWINGS. VANITY MIRRORS TO BE 42" HIGH AND TO BE MOUNTED WITH THE BOTTOM OF THE REFLECTING SURFACE NO MORE THAN 40" A.F.F IN ANSI TYPE A UNITS.

PROVIDE MINIMUM RATED 2A:10B:C FIRE EXTINGUISHER IN EACH KITCHEN UNDER THE SINK. . VERIFY ALL TUB WALL LENGHTS AND DIMENSIONS WITH ACTUAL TUB PROVIDED. CONTRACTOR TO

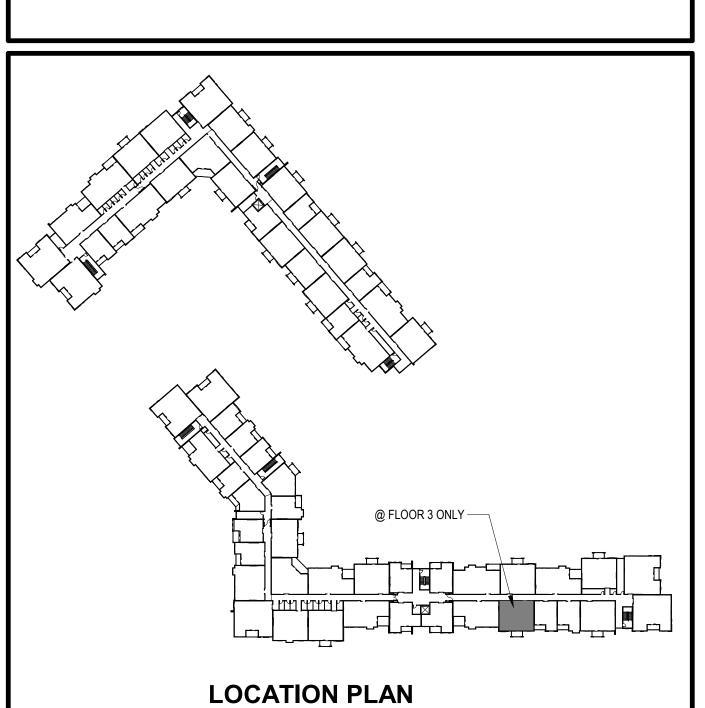
COORDINATE FRAMING, TUB MANUFACTURER AND TUB DETAILS. PROVIDE SOLID BLOCKING IN WALLS FOR FUTURE INSTALLATION OF GRAB BARS AS SHOWN ON A002

THAT MAY REQUIRE BLOCKING OR OTHER CONSIDERATIONS SPECIFIC TO THE UNIT LOCATION IN THE BUILDING, SUCH AS ATTACHED SIGNAGE, LIGHTING, AWNINGS, CANOPIES, TRELLISES,

SHUTTERS, FIXTURES, BUILDOUTS, CORNICES, RAILINGS, LANDSCAPE FEATURES AND ADJACENT ATTACHED STRUCTURES. 26. PROVIDE A HIGH OUTLET COVER SO THAT TV IN LIVING ROOM CAN BE MOUNTED AT 50" A.F.F. TO THE CENTER OF TV. REFER TO MEP AND TELECOM. PROVIDE 2x10 BLOCKING FOR TV MOUNTING. 7. ALL EXTERIOR SLABS TO SLOPE DOWN 1/8" TO EDGE OF SLAB. LIGHT BROOM FINISH AT SLOPED

SURFACES. VERIFY WITH STRUCTURE. 8. REFER TO UNIT FINISH SCHEDULE FOR FINISHES ON A060, FOR ADDITIONAL ROOM FINISH NOTES AND SPECIFICATIONS. RE: A700 9. FLOOR FINISHES TO EXTEND UNDER SHELVING, WASHER/DRYER, AND REFRIGERATOR. FLOOR

30. ALL SINK BASES TO BE REMOVABLE IN TYPE A UNITS. REMOVABLE BASE AT KITCHEN WORK SURFACE IN TYPE A UNITS. EXTEND FLOOR FINISH UNDER THESE REMOVABLE CABINETS
31. BATHROOM CEILING HEIGHT 8' - 6" AFF.
32. SHOWER HEAD HEIGHT 7'-0" AFF, SHOWER CONTROL HEIGHT 4'-0" AFF.



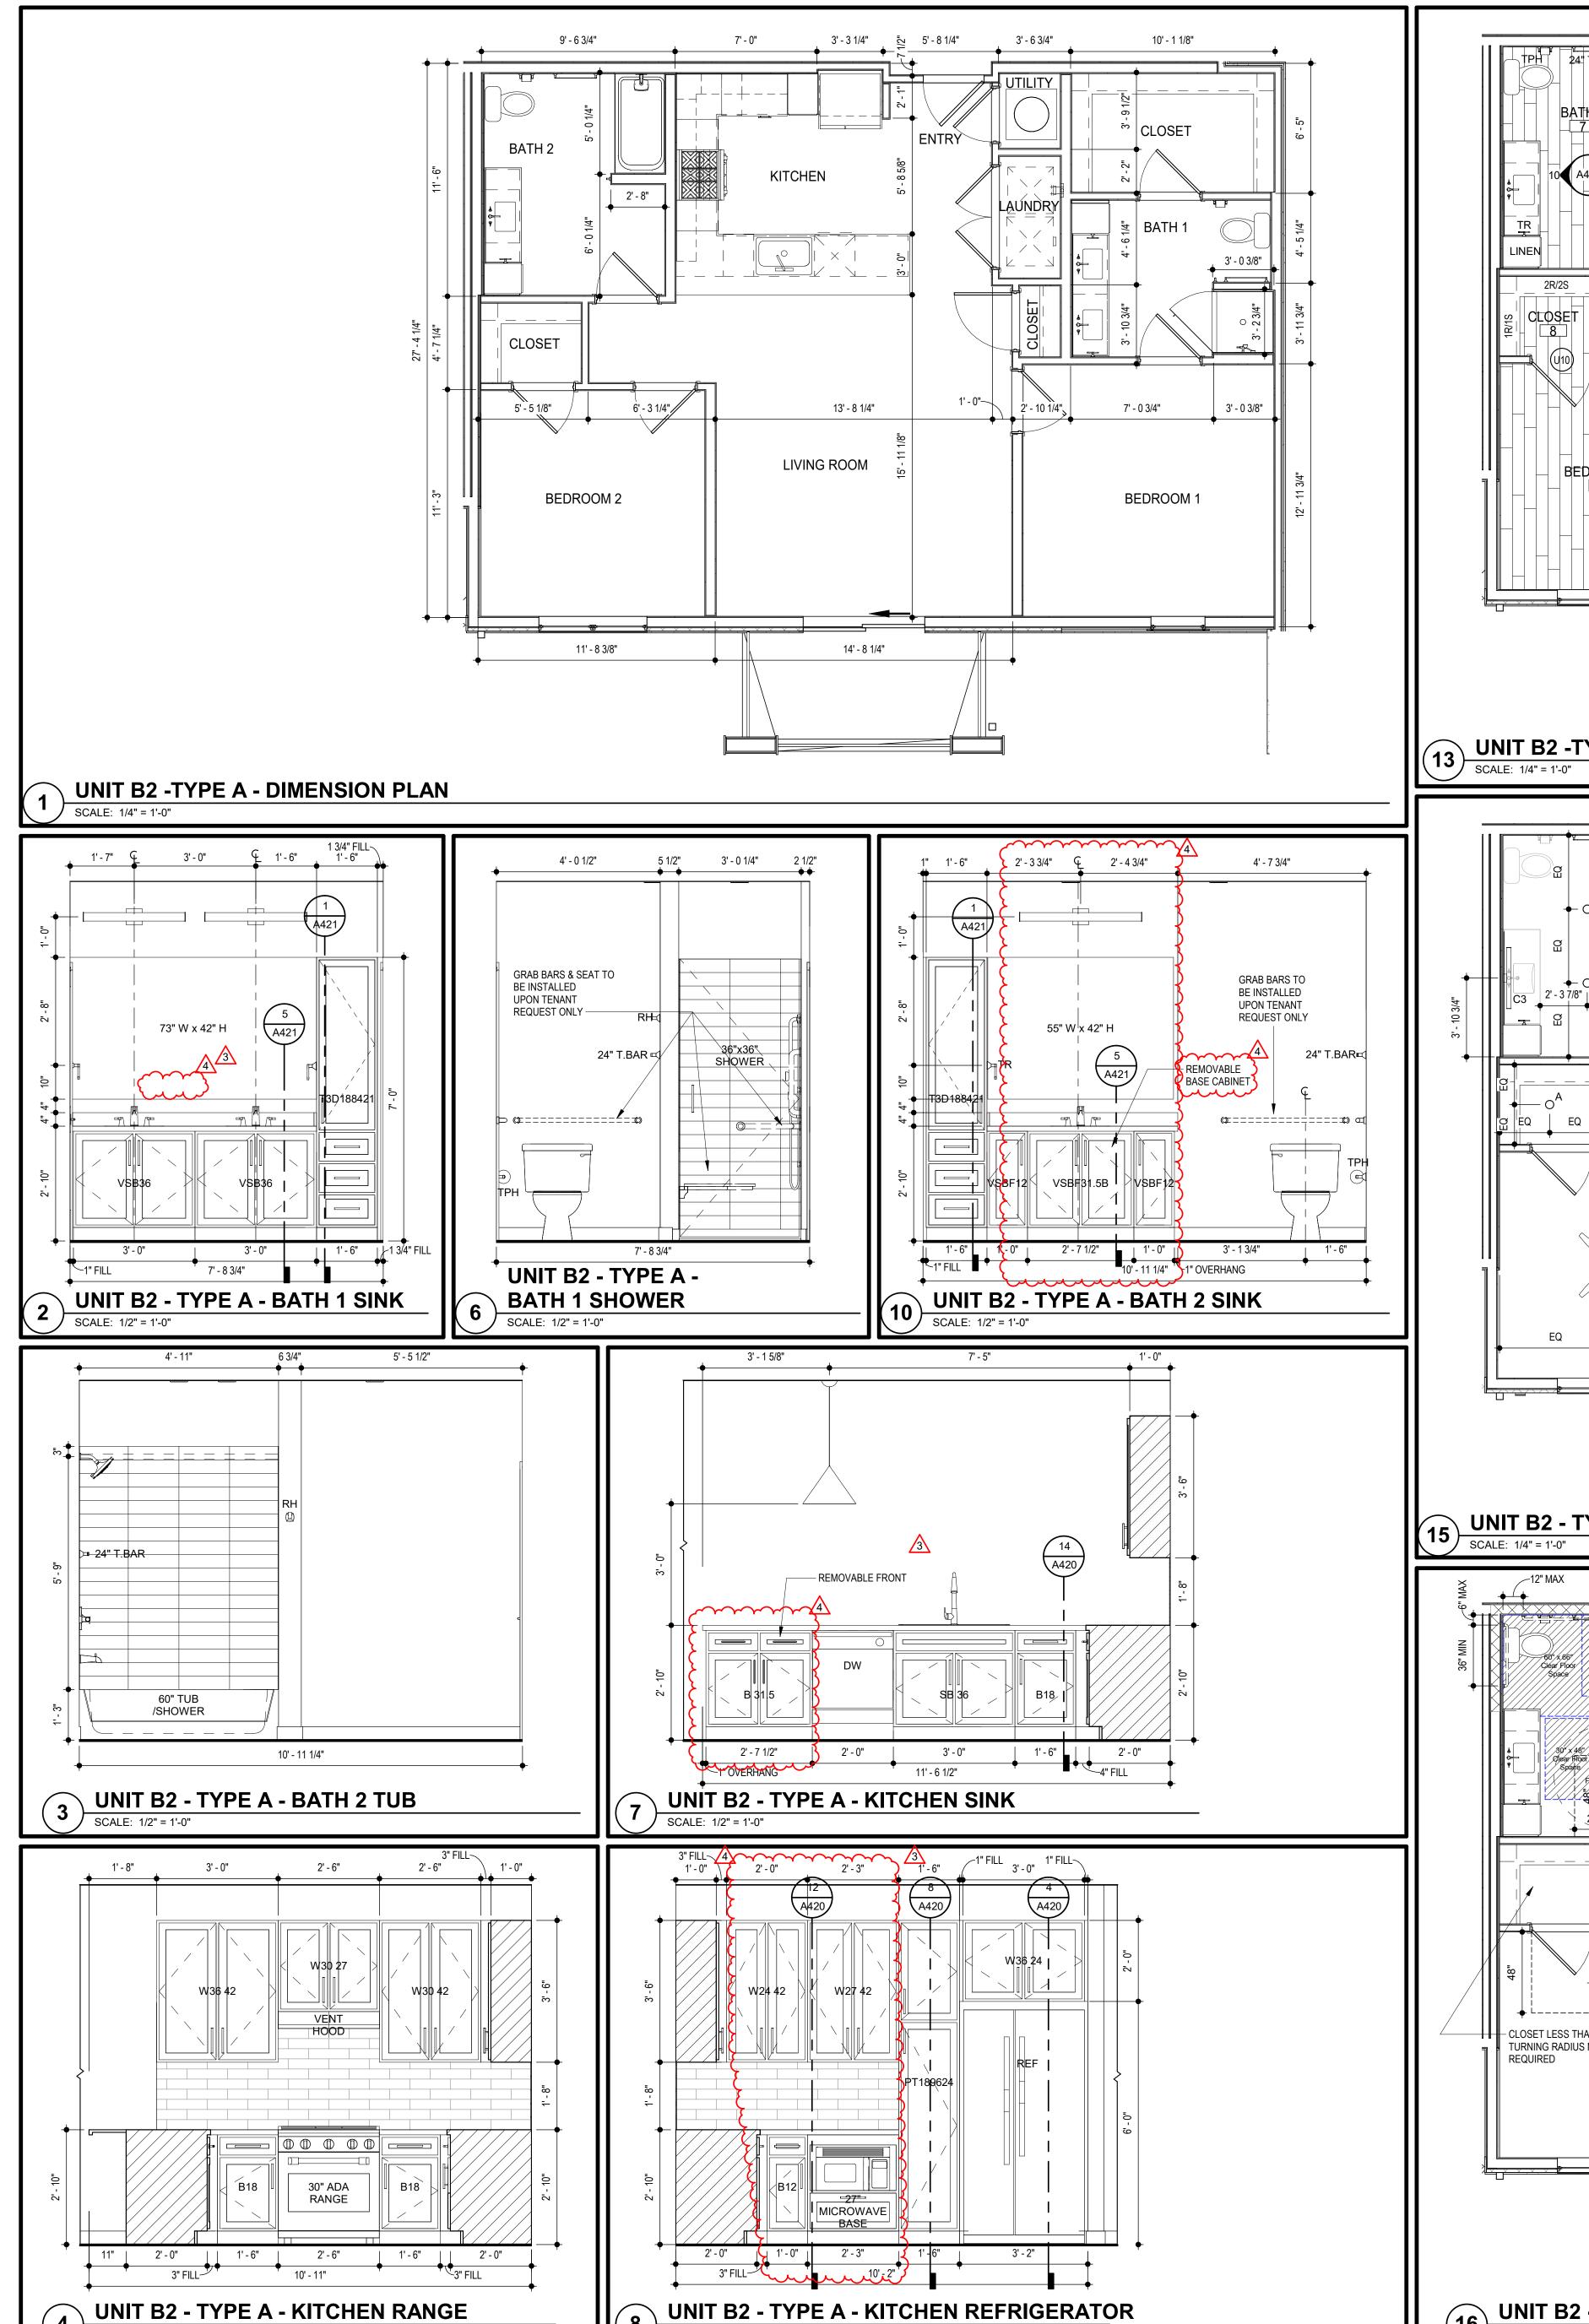


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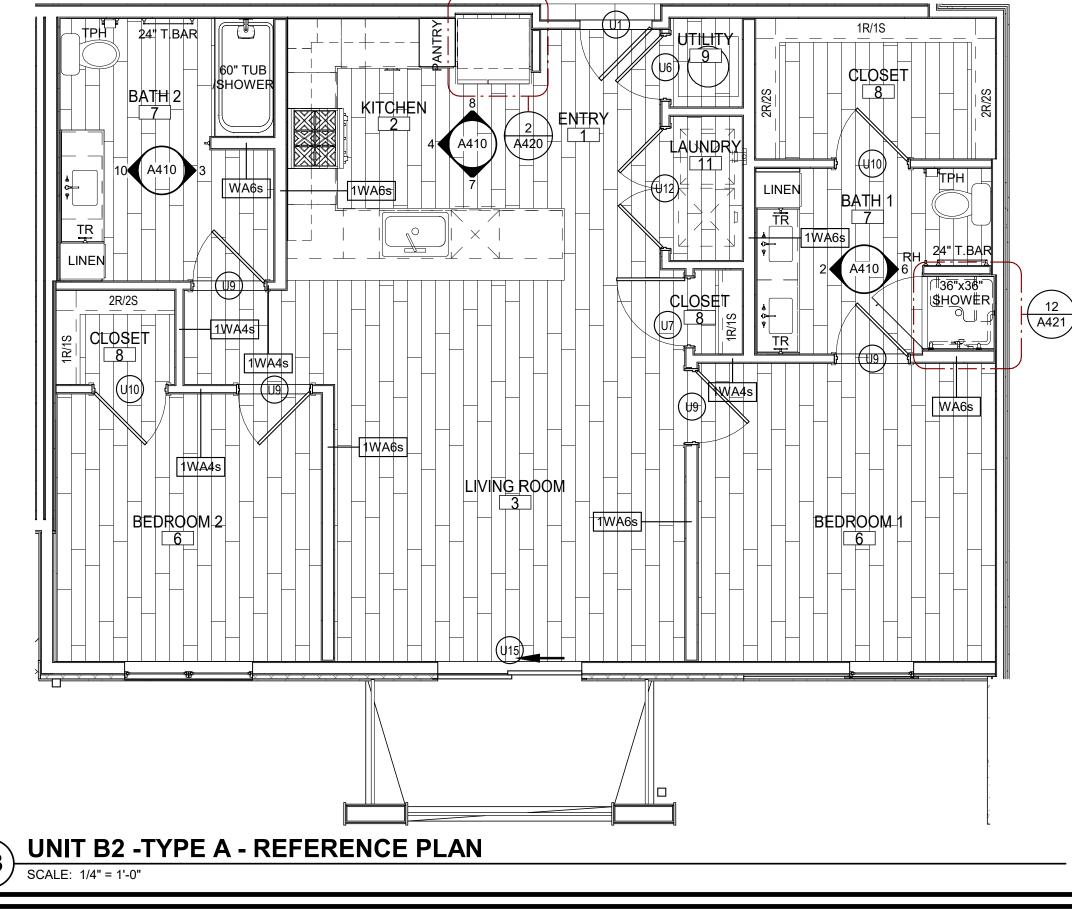
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D	ATE:	7.15.2021
R	EVISIONS #	
3	Revision 1	2.11.202
4	Revision 2	3.1.202

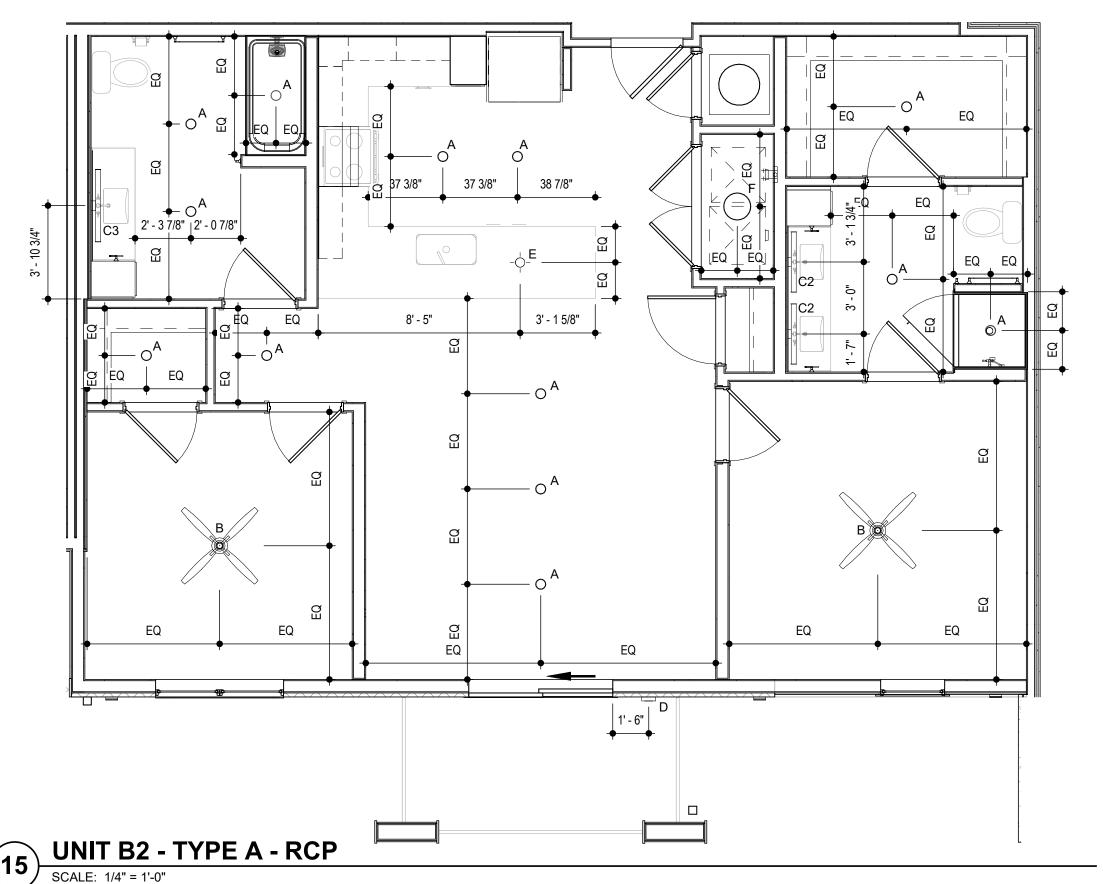
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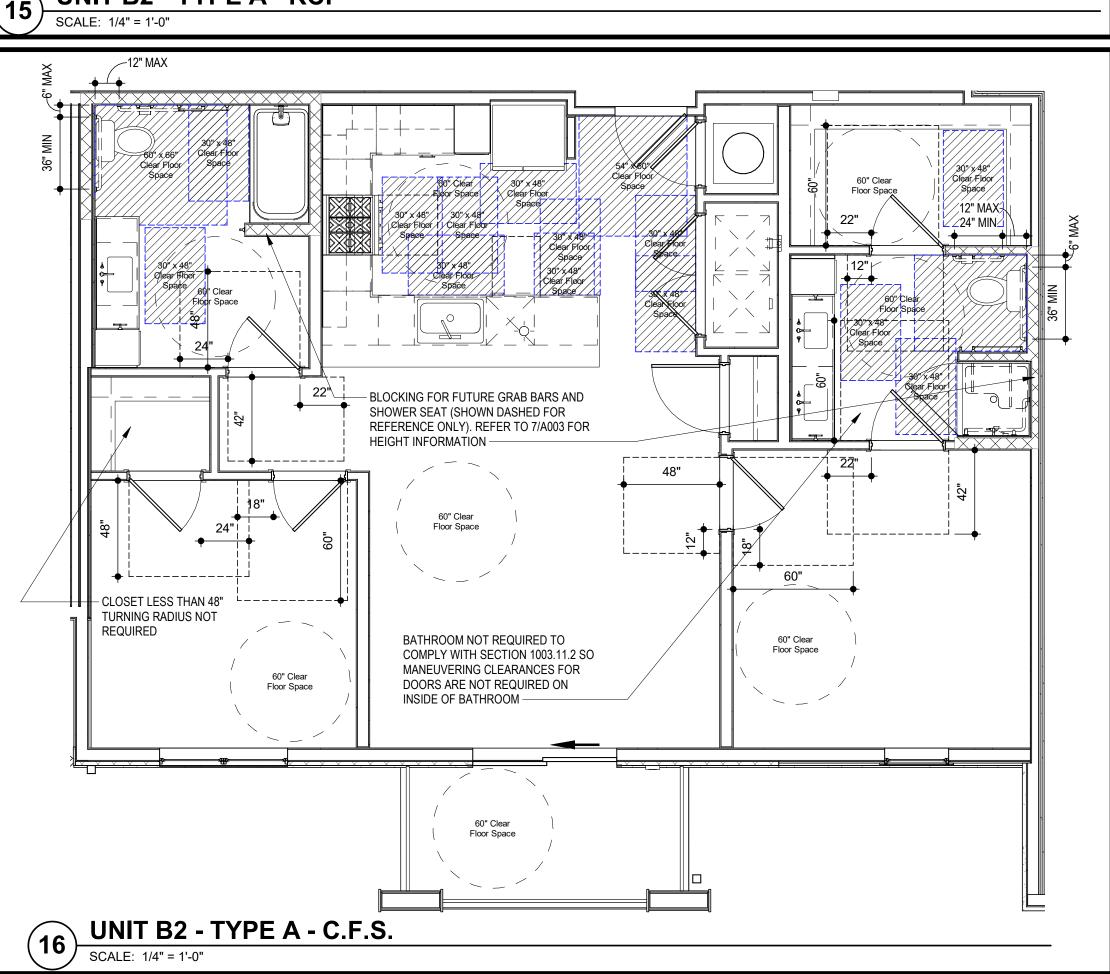
UNIT B1 - TYPE A - PLANS AND ELEVATIONS




SCALE: 1/2" = 1'-0"







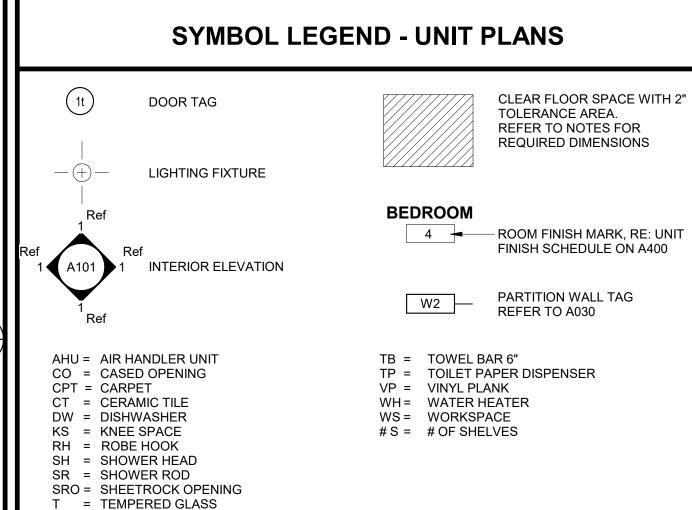

LIGHTING FIXTURE SCHEDULE									
LABEL	MANUFACTURER	DESCRIPTION/MODEL	FINISH						
А	MAXIM	57690WTWT - CHIP 5" 12W RD LED FLUSH MOUNT	WHITE						
В	FANIMATION	FPS8533MW - KWARTET: HARDWIRED FAN AND LIGHT FUNCTIONS (SEPARATE SWITCHES) – NO REMOTES	WHITE						
C1	MAXIM	RAIL 24" - 52102	SATIN NICKEL						
C2	MAXIM	RAIL 30" - 52103SN	SATIN NICKEL						
C3	MAXIM	RAIL 36" - 52104	SATIN NICKEL						
D	MAXIM	54350ABZ - AVENUE SMALL LET OUTDOOR SCONCE	BRONZE						
Е	ET2	E20086-BK - ABYSS 1-LIGHT LED PENDANT	BLACK						
F	ACCESS LIGHTING	49960LEDD-WH/ACR - COMO	WHITE						

GENERAL UNIT NOTES

ALL WALL DIMENSIONS ARE TO STUD. UNIT INTERIOR WALL TYPES ARE WA4s (TYPICAL) UNLESS OTHERWISE NOTED.

REFER TO SHEET A030 FOR TYPICAL WALL ASSEMBLIES.

REFER TO SHEET A060 FOR UNIT DOOR SCHEDULE & A041 FOR DETAILS. ALL INTERIOR DOORS SHALL ALLOW 3/4" AIRFLOW FOR RETURN AT BOTTOM OF DOOR. . REFER TO MEP DWGS FOR LOCATION OF SMOKE, CO & FIRE DETECTORS.

REFER TO SHEET A050 FOR WINDOW SCHEDULE AND A050 - A051 FOR DETAILS. ALL EXTERIOR WINDOWS SHALL MEET ALL FEDERAL, STATE AND ANY LOCAL GLAZING STANDARDS

ALL SLIDING GLASS DOORS SHALL HAVE PIN LOCKS. . BEDROOM SHALL HAVE A MINIMUM OF ONE OPENING WHICH MEETS EGRESS REQUIREMENTS. 20" NET CLEAR WIDTH, 24" NET CLEAR HEIGHT. 5.7 SQFT. NET CLEAR OPENABLE AREA AND SHALL BE 44"

MAXIMUM FROM FINISH FLOOR TO TOP OF SILL AS REQUIRED PER IBC-2018 SECTION 1029. 0. REFER TO BUILDING PLANS FOR CORRIDOR AND DIMISING WALL TYPES. 1. PROVIDE MOISTURE RESISTANT GYPSUM DRYWALL IN ALL UNIT BATHROOM WALLS AND OTHER UNIT

2. PROVIDE SOUND BATTS IN ALL CORRIDOR AND TENANT SEPARATION WALLS. 13. PROVIDE SOUND INSULATION IN WALLS AROUND ALL LAUNDRY ROOMS, PLUMBING, AND ALL HVAC

14. REFER TO STRUCTURAL DRAWINGS FOR SHEARWALL AND BEARING WALL LOCATIONS. 5. VERTICAL MECHANICAL CHASES WITHIN UNITS ARE TO BE FIRE STOPPED PER LOCAL

16. ALL ANGLES ARE 45° TO HORIZONTAL & VERTICAL DIRECTIONS, U.N.O. TYP. AT ALL UNITS.

17. ALL DIMENSIONS AND NOTES STATING "CLEAR" ARE FROM FACE OF FINISH.

18. REFER TO A002 & A003 FOR ALL INTERIOR FAIR HOUSING ACT AND OTHER ACCESSIBILITY 9. ALL TOWEL BARS ARE TO BE MOUNTED AT 54" A.F.F., ROBE HOOKS TO BE MOUNTED AT 66", TOWEL

RINGS TO BE MOUNTED 1'-6" ABOVE COUNTER HEIGHT, AND TOILET PAPER DISPENSERS AT 20" A.F.F. TO CENTERLINE OF HOLDER UNLESS NOTED OTHERWISE. TOWEL BARS AND ROBE HOOKS IN TYPE A

INTERIOR ELEVATIONS ARE FOR SCHEMATIC CABINET LAYOUT ONLY. CONTRACTOR TO VERIFY ALL DIMENSIONS, PROVIDE FILLERS AS REQUIRED, REFER TO CABINET SHOP DRAWINGS. VANITY MIRRORS TO BE 42" HIGH AND TO BE MOUNTED WITH THE BOTTOM OF THE REFLECTING

SURFACE NO MORE THAN 40" A.F.F IN ANSI TYPE A UNITS. PROVIDE MINIMUM RATED 2A:10B:C FIRE EXTINGUISHER IN EACH KITCHEN UNDER THE SINK.

3. VERIFY ALL TUB WALL LENGHTS AND DIMENSIONS WITH ACTUAL TUB PROVIDED. CONTRACTOR TO COORDINATE FRAMING, TUB MANUFACTURER AND TUB DETAILS. . PROVIDE SOLID BLOCKING IN WALLS FOR FUTURE INSTALLATION OF GRAB BARS AS SHOWN ON A002

& A003, OR ALTERNATIVE MEANS OF REINFORCING THE CAVITY BETWEEN THE FIBERGLASS TUB AND

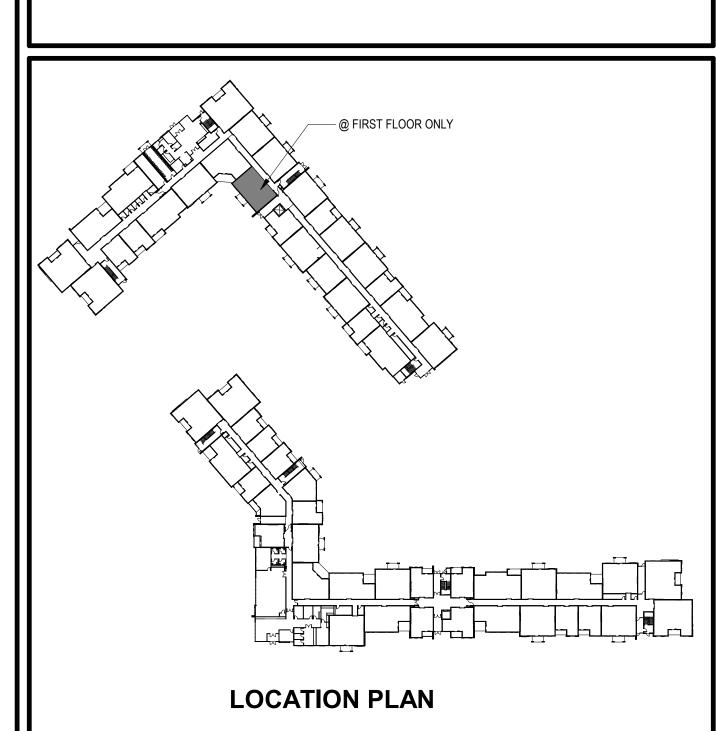
THAT MAY REQUIRE BLOCKING OR OTHER CONSIDERATIONS SPECIFIC TO THE UNIT LOCATION IN THE BUILDING, SUCH AS ATTACHED SIGNAGE, LIGHTING, AWNINGS, CANOPIES, TRELLISES, SHUTTERS, FIXTURES, BUILDOUTS, CORNICES, RAILINGS, LANDSCAPE FEATURES AND ADJACENT ATTACHED STRUCTURES.

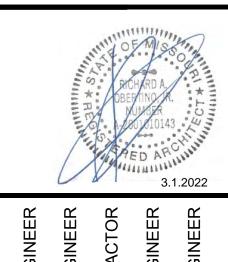
26. PROVIDE A HIGH OUTLET COVER SO THAT TV IN LIVING ROOM CAN BE MOUNTED AT 50" A.F.F. TO THE CENTER OF TV. REFER TO MEP AND TELECOM. PROVIDE 2x10 BLOCKING FOR TV MOUNTING. . ALL EXTERIOR SLABS TO SLOPE DOWN 1/8" TO EDGE OF SLAB. LIGHT BROOM FINISH AT SLOPED SURFACES. VERIFY WITH STRUCTURE.

3. REFER TO UNIT FINISH SCHEDULE FOR FINISHES ON A060, FOR ADDITIONAL ROOM FINISH NOTES AND SPECIFICATIONS. RE: A700 . FLOOR FINISHES TO EXTEND UNDER SHELVING, WASHER/DRYER, AND REFRIGERATOR. FLOOR FINISHES EXTEND UNDER ALL RAISED COUNTERS, AND CABINETS INDICATED WITH "REMOVABLE

D. ALL SINK BASES TO BE REMOVABLE IN TYPE A UNITS. REMOVABLE BASE AT KITCHEN WORK SURFACE IN TYPE A UNITS. EXTEND FLOOR FINISH UNDER THESE REMOVABLE CABINETS 1. BATHROOM CEILING HEIGHT 8' - 6" AFF.

32. SHOWER HEAD HEIGHT 7'-0" AFF, SHOWER CONTROL HEIGHT 4'-0" AFF. 33. TUB/SHOWER COMBO SHOWER HEAD HEIGHT 7'-0" AFF, CONTROL 3'-0" AFF, TUB FAUCET 2'-0" AFF. 34. FOR UNIT DETAILS RE: A420-421







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SHEET NO. **UNIT B2-TYPE A - PLANS AND**





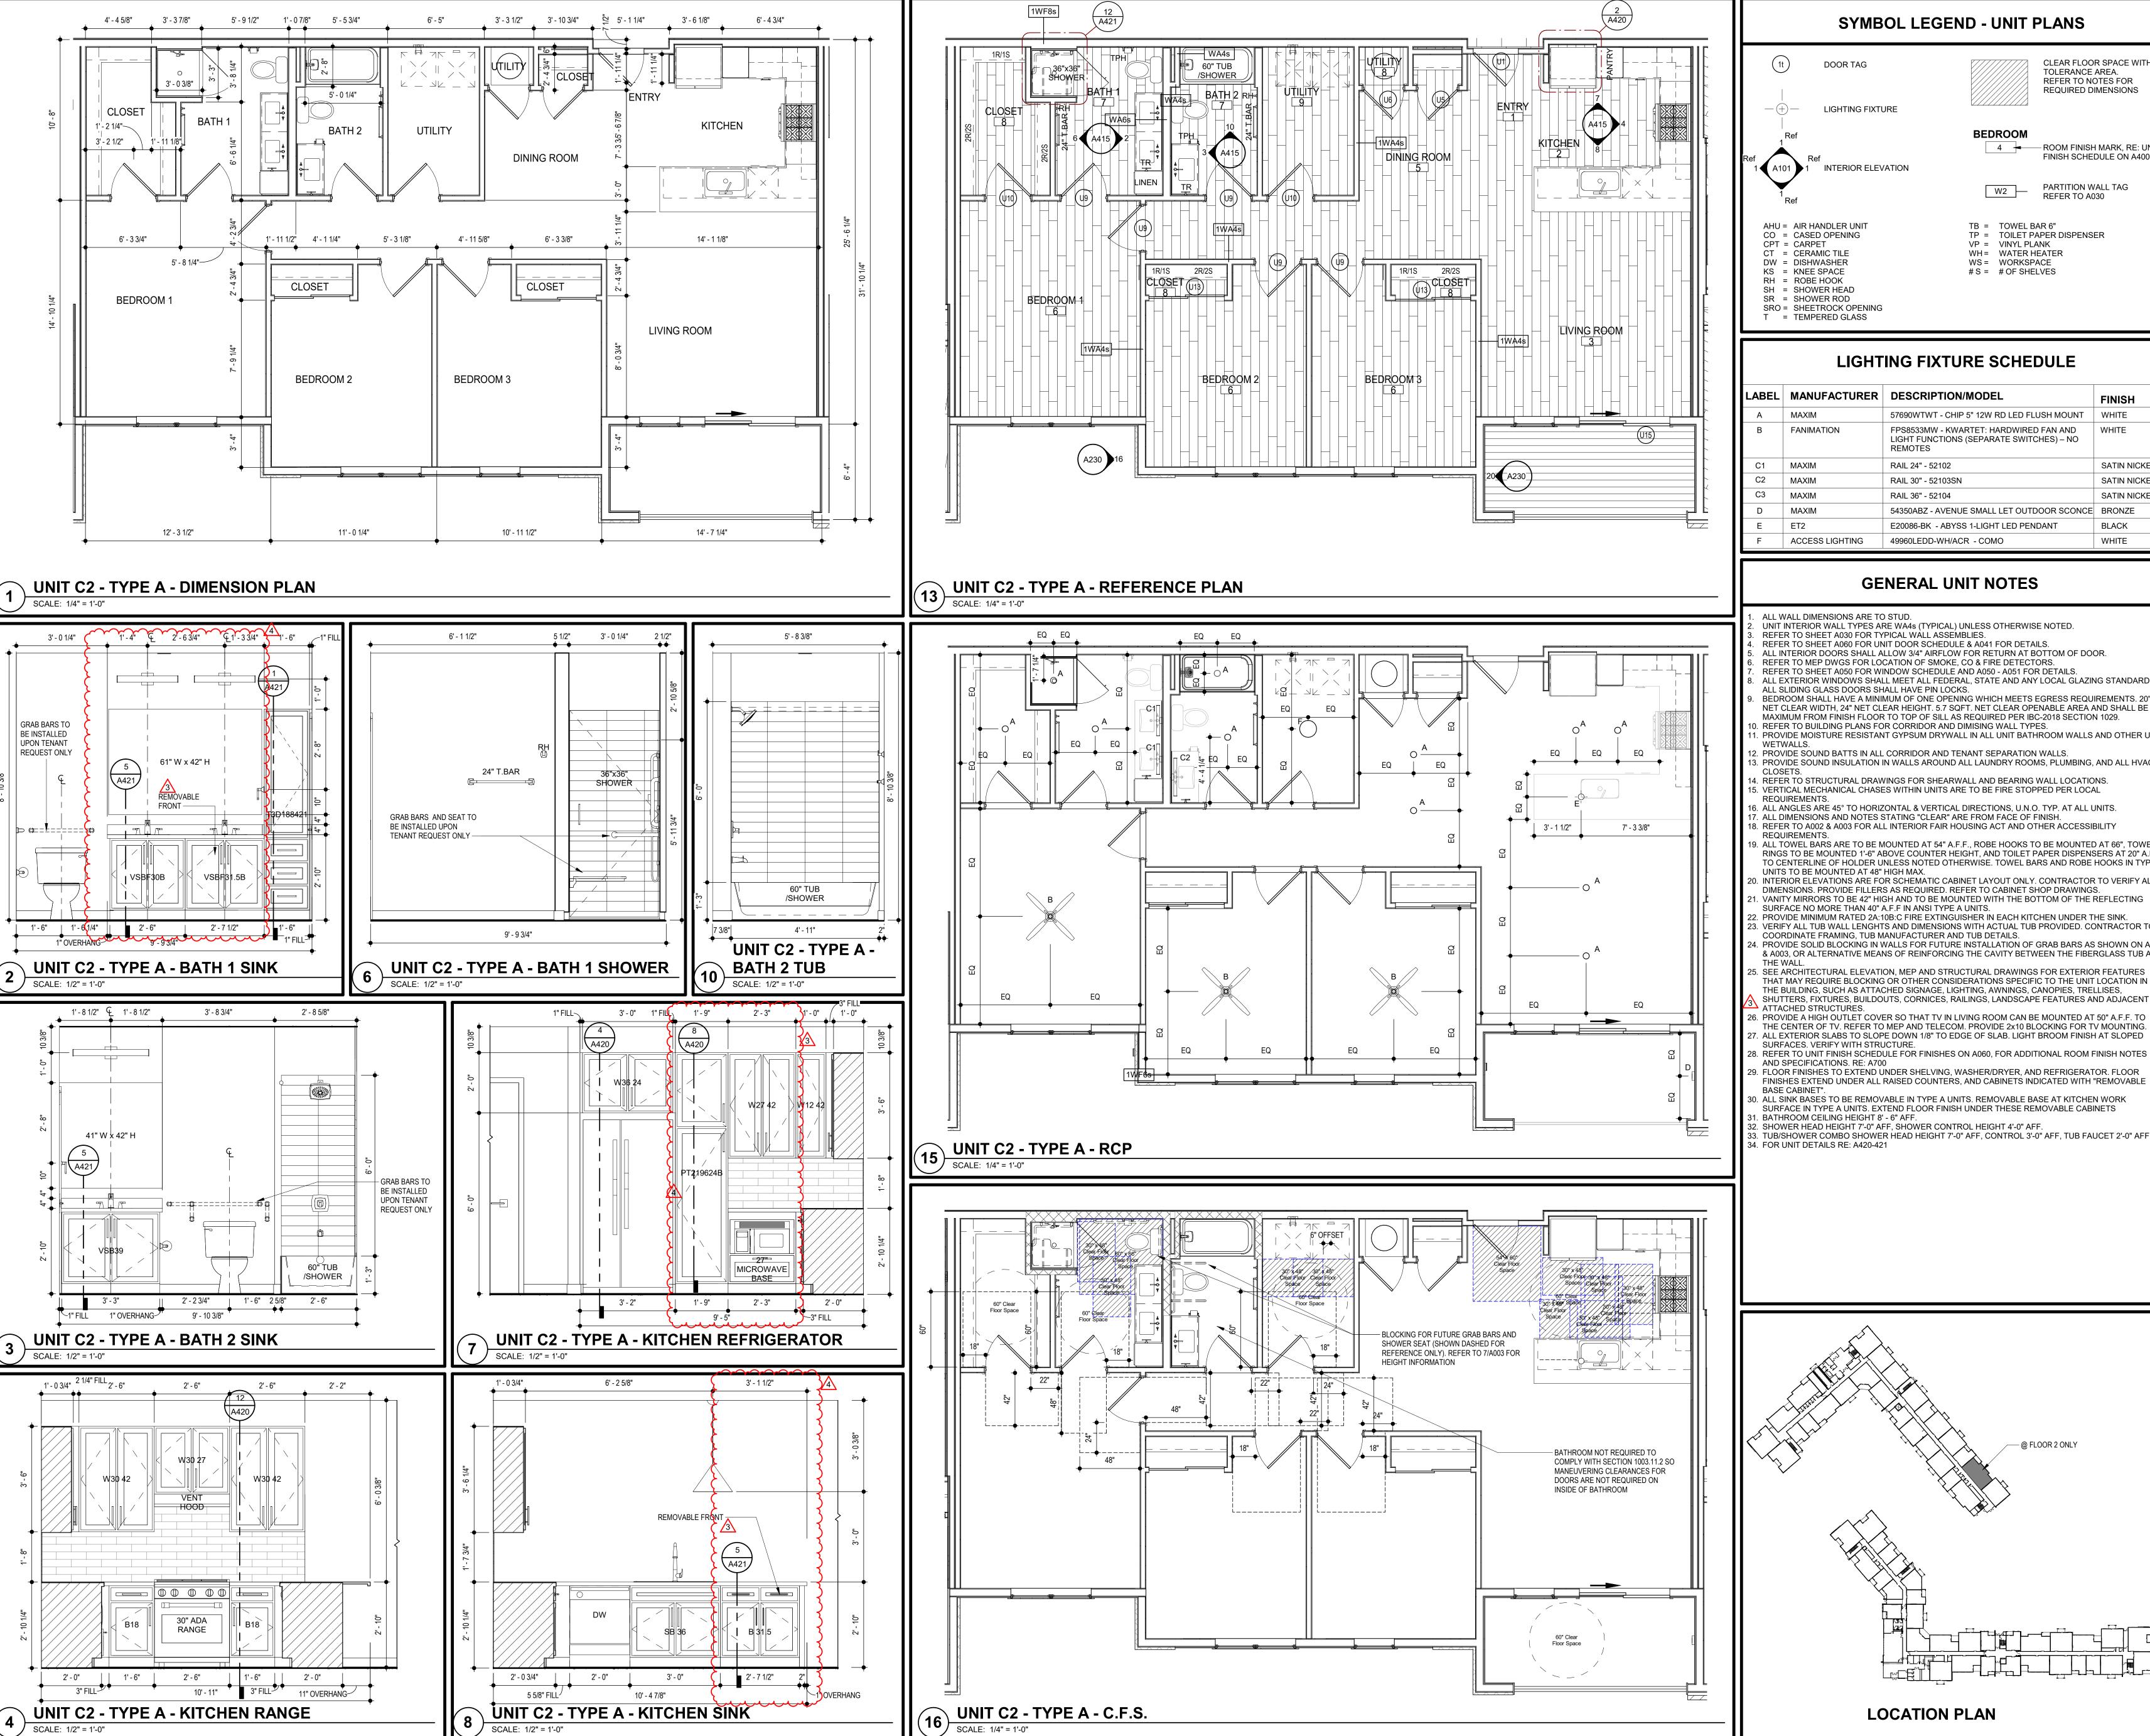LIGHTING FIXTURE SCHEDULE LABEL MANUFACTURER DESCRIPTION/MODEL **FINISH** 57690WTWT - CHIP 5" 12W RD LED FLUSH MOUNT WHITE **FANIMATION** FPS8533MW - KWARTET: HARDWIRED FAN AND LIGHT FUNCTIONS (SEPARATE SWITCHES) - NO REMOTES SATIN NICKEL RAIL 24" - 52102 MAXIM RAIL 30" - 52103SN SATIN NICKEL MAXIM RAIL 36" - 52104 SATIN NICKEL MAXIM 54350ABZ - AVENUE SMALL LET OUTDOOR SCONCE BRONZE ET2 **BLACK** E20086-BK - ABYSS 1-LIGHT LED PENDANT

GENERAL UNIT NOTES

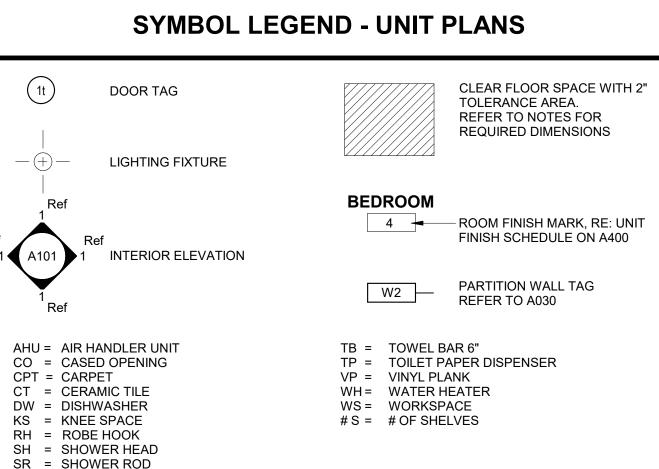WHITE

49960LEDD-WH/ACR - COMO

ALL WALL DIMENSIONS ARE TO STUD. UNIT INTERIOR WALL TYPES ARE WA4s (TYPICAL) UNLESS OTHERWISE NOTED.

REFER TO SHEET A030 FOR TYPICAL WALL ASSEMBLIES. REFER TO SHEET A060 FOR UNIT DOOR SCHEDULE & A041 FOR DETAILS.

ALL INTERIOR DOORS SHALL ALLOW 3/4" AIRFLOW FOR RETURN AT BOTTOM OF DOOR.

REFER TO MEP DWGS FOR LOCATION OF SMOKE, CO & FIRE DETECTORS. REFER TO SHEET A050 FOR WINDOW SCHEDULE AND A050 - A051 FOR DETAILS.

ALL EXTERIOR WINDOWS SHALL MEET ALL FEDERAL, STATE AND ANY LOCAL GLAZING STANDARDS ALL SLIDING GLASS DOORS SHALL HAVE PIN LOCKS. BEDROOM SHALL HAVE A MINIMUM OF ONE OPENING WHICH MEETS EGRESS REQUIREMENTS. 20"

NET CLEAR WIDTH, 24" NET CLEAR HEIGHT. 5.7 SQFT. NET CLEAR OPENABLE AREA AND SHALL BE 44" MAXIMUM FROM FINISH FLOOR TO TOP OF SILL AS REQUIRED PER IBC-2018 SECTION 1029.

1. PROVIDE MOISTURE RESISTANT GYPSUM DRYWALL IN ALL UNIT BATHROOM WALLS AND OTHER UNIT

2. PROVIDE SOUND BATTS IN ALL CORRIDOR AND TENANT SEPARATION WALLS. 3. PROVIDE SOUND INSULATION IN WALLS AROUND ALL LAUNDRY ROOMS, PLUMBING, AND ALL HVAC

4. REFER TO STRUCTURAL DRAWINGS FOR SHEARWALL AND BEARING WALL LOCATIONS.

5. VERTICAL MECHANICAL CHASES WITHIN UNITS ARE TO BE FIRE STOPPED PER LOCAL

6. ALL ANGLES ARE 45° TO HORIZONTAL & VERTICAL DIRECTIONS, U.N.O. TYP. AT ALL UNITS.

17. ALL DIMENSIONS AND NOTES STATING "CLEAR" ARE FROM FACE OF FINISH.

18. REFER TO A002 & A003 FOR ALL INTERIOR FAIR HOUSING ACT AND OTHER ACCESSIBILITY

9. ALL TOWEL BARS ARE TO BE MOUNTED AT 54" A.F.F., ROBE HOOKS TO BE MOUNTED AT 66", TOWEL RINGS TO BE MOUNTED 1'-6" ABOVE COUNTER HEIGHT, AND TOILET PAPER DISPENSERS AT 20" A.F.F. TO CENTERLINE OF HOLDER UNLESS NOTED OTHERWISE. TOWEL BARS AND ROBE HOOKS IN TYPE A UNITS TO BE MOUNTED AT 48" HIGH MAX.

INTERIOR ELEVATIONS ARE FOR SCHEMATIC CABINET LAYOUT ONLY. CONTRACTOR TO VERIFY ALL DIMENSIONS. PROVIDE FILLERS AS REQUIRED. REFER TO CABINET SHOP DRAWINGS. VANITY MIRRORS TO BE 42" HIGH AND TO BE MOUNTED WITH THE BOTTOM OF THE REFLECTING

SURFACE NO MORE THAN 40" A.F.F IN ANSI TYPE A UNITS. PROVIDE MINIMUM RATED 2A:10B:C FIRE EXTINGUISHER IN EACH KITCHEN UNDER THE SINK.

3. VERIFY ALL TUB WALL LENGHTS AND DIMENSIONS WITH ACTUAL TUB PROVIDED. CONTRACTOR TO COORDINATE FRAMING, TUB MANUFACTURER AND TUB DETAILS. PROVIDE SOLID BLOCKING IN WALLS FOR FUTURE INSTALLATION OF GRAB BARS AS SHOWN ON A002

& A003, OR ALTERNATIVE MEANS OF REINFORCING THE CAVITY BETWEEN THE FIBERGLASS TUB AND 5. SEE ARCHITECTURAL ELEVATION, MEP AND STRUCTURAL DRAWINGS FOR EXTERIOR FEATURES

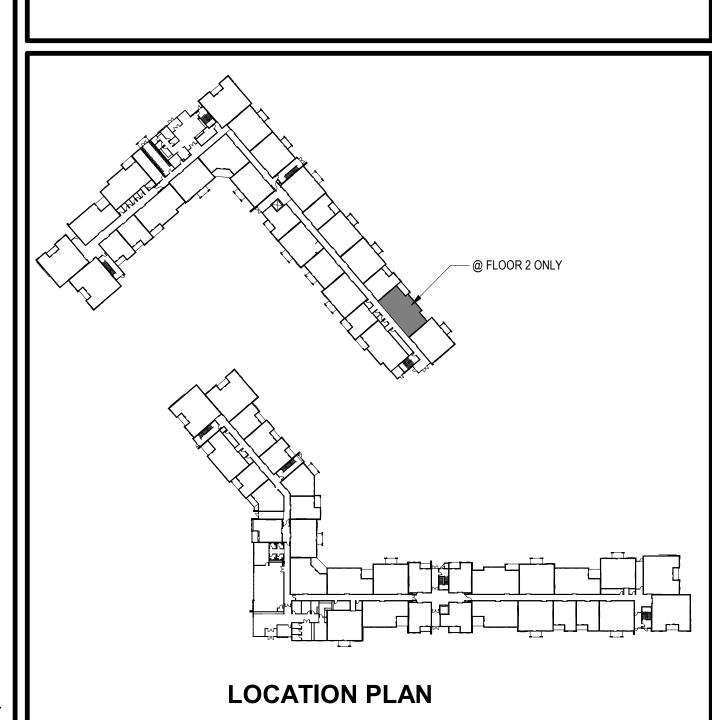
THAT MAY REQUIRE BLOCKING OR OTHER CONSIDERATIONS SPECIFIC TO THE UNIT LOCATION IN THE BUILDING, SUCH AS ATTACHED SIGNAGE, LIGHTING, AWNINGS, CANOPIES, TRELLISES, SHUTTERS, FIXTURES, BUILDOUTS, CORNICES, RAILINGS, LANDSCAPE FEATURES AND ADJACENT

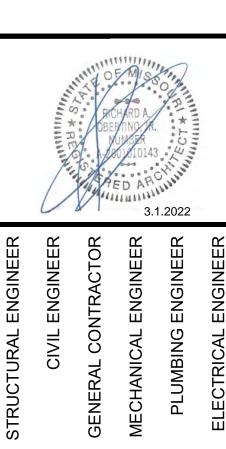
6. PROVIDE A HIGH OUTLET COVER SO THAT TV IN LIVING ROOM CAN BE MOUNTED AT 50" A.F.F. TO THE CENTER OF TV. REFER TO MEP AND TELECOM. PROVIDE 2x10 BLOCKING FOR TV MOUNTING. ALL EXTERIOR SLABS TO SLOPE DOWN 1/8" TO EDGE OF SLAB. LIGHT BROOM FINISH AT SLOPED SURFACES. VERIFY WITH STRUCTURE.

AND SPECIFICATIONS. RE: A700 9. FLOOR FINISHES TO EXTEND UNDER SHELVING, WASHER/DRYER, AND REFRIGERATOR. FLOOR

30. ALL SINK BASES TO BE REMOVABLE IN TYPE A UNITS. REMOVABLE BASE AT KITCHEN WORK SURFACE IN TYPE A UNITS. EXTEND FLOOR FINISH UNDER THESE REMOVABLE CABINETS
31. BATHROOM CEILING HEIGHT 8' - 6" AFF.

32. SHOWER HEAD HEIGHT 7'-0" AFF, SHOWER CONTROL HEIGHT 4'-0" AFF. 33. TUB/SHOWER COMBO SHOWER HEAD HEIGHT 7'-0" AFF, CONTROL 3'-0" AFF, TUB FAUCET 2'-0" AFF.





The

00 AND 2150 NW LOWENSTEIN DIEE'S SUMMIT, MISSOURI 64081


ARCHITECTS 1790 S. Brentwood Blvd. St. Louis, Missouri 63144 T: 314-395-9750 Copyright 2021 www.triarchitects.com 7.15.2021 REVISIONS /#\ Revision 1 2.11.2022

Revision 2

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3.1.2022

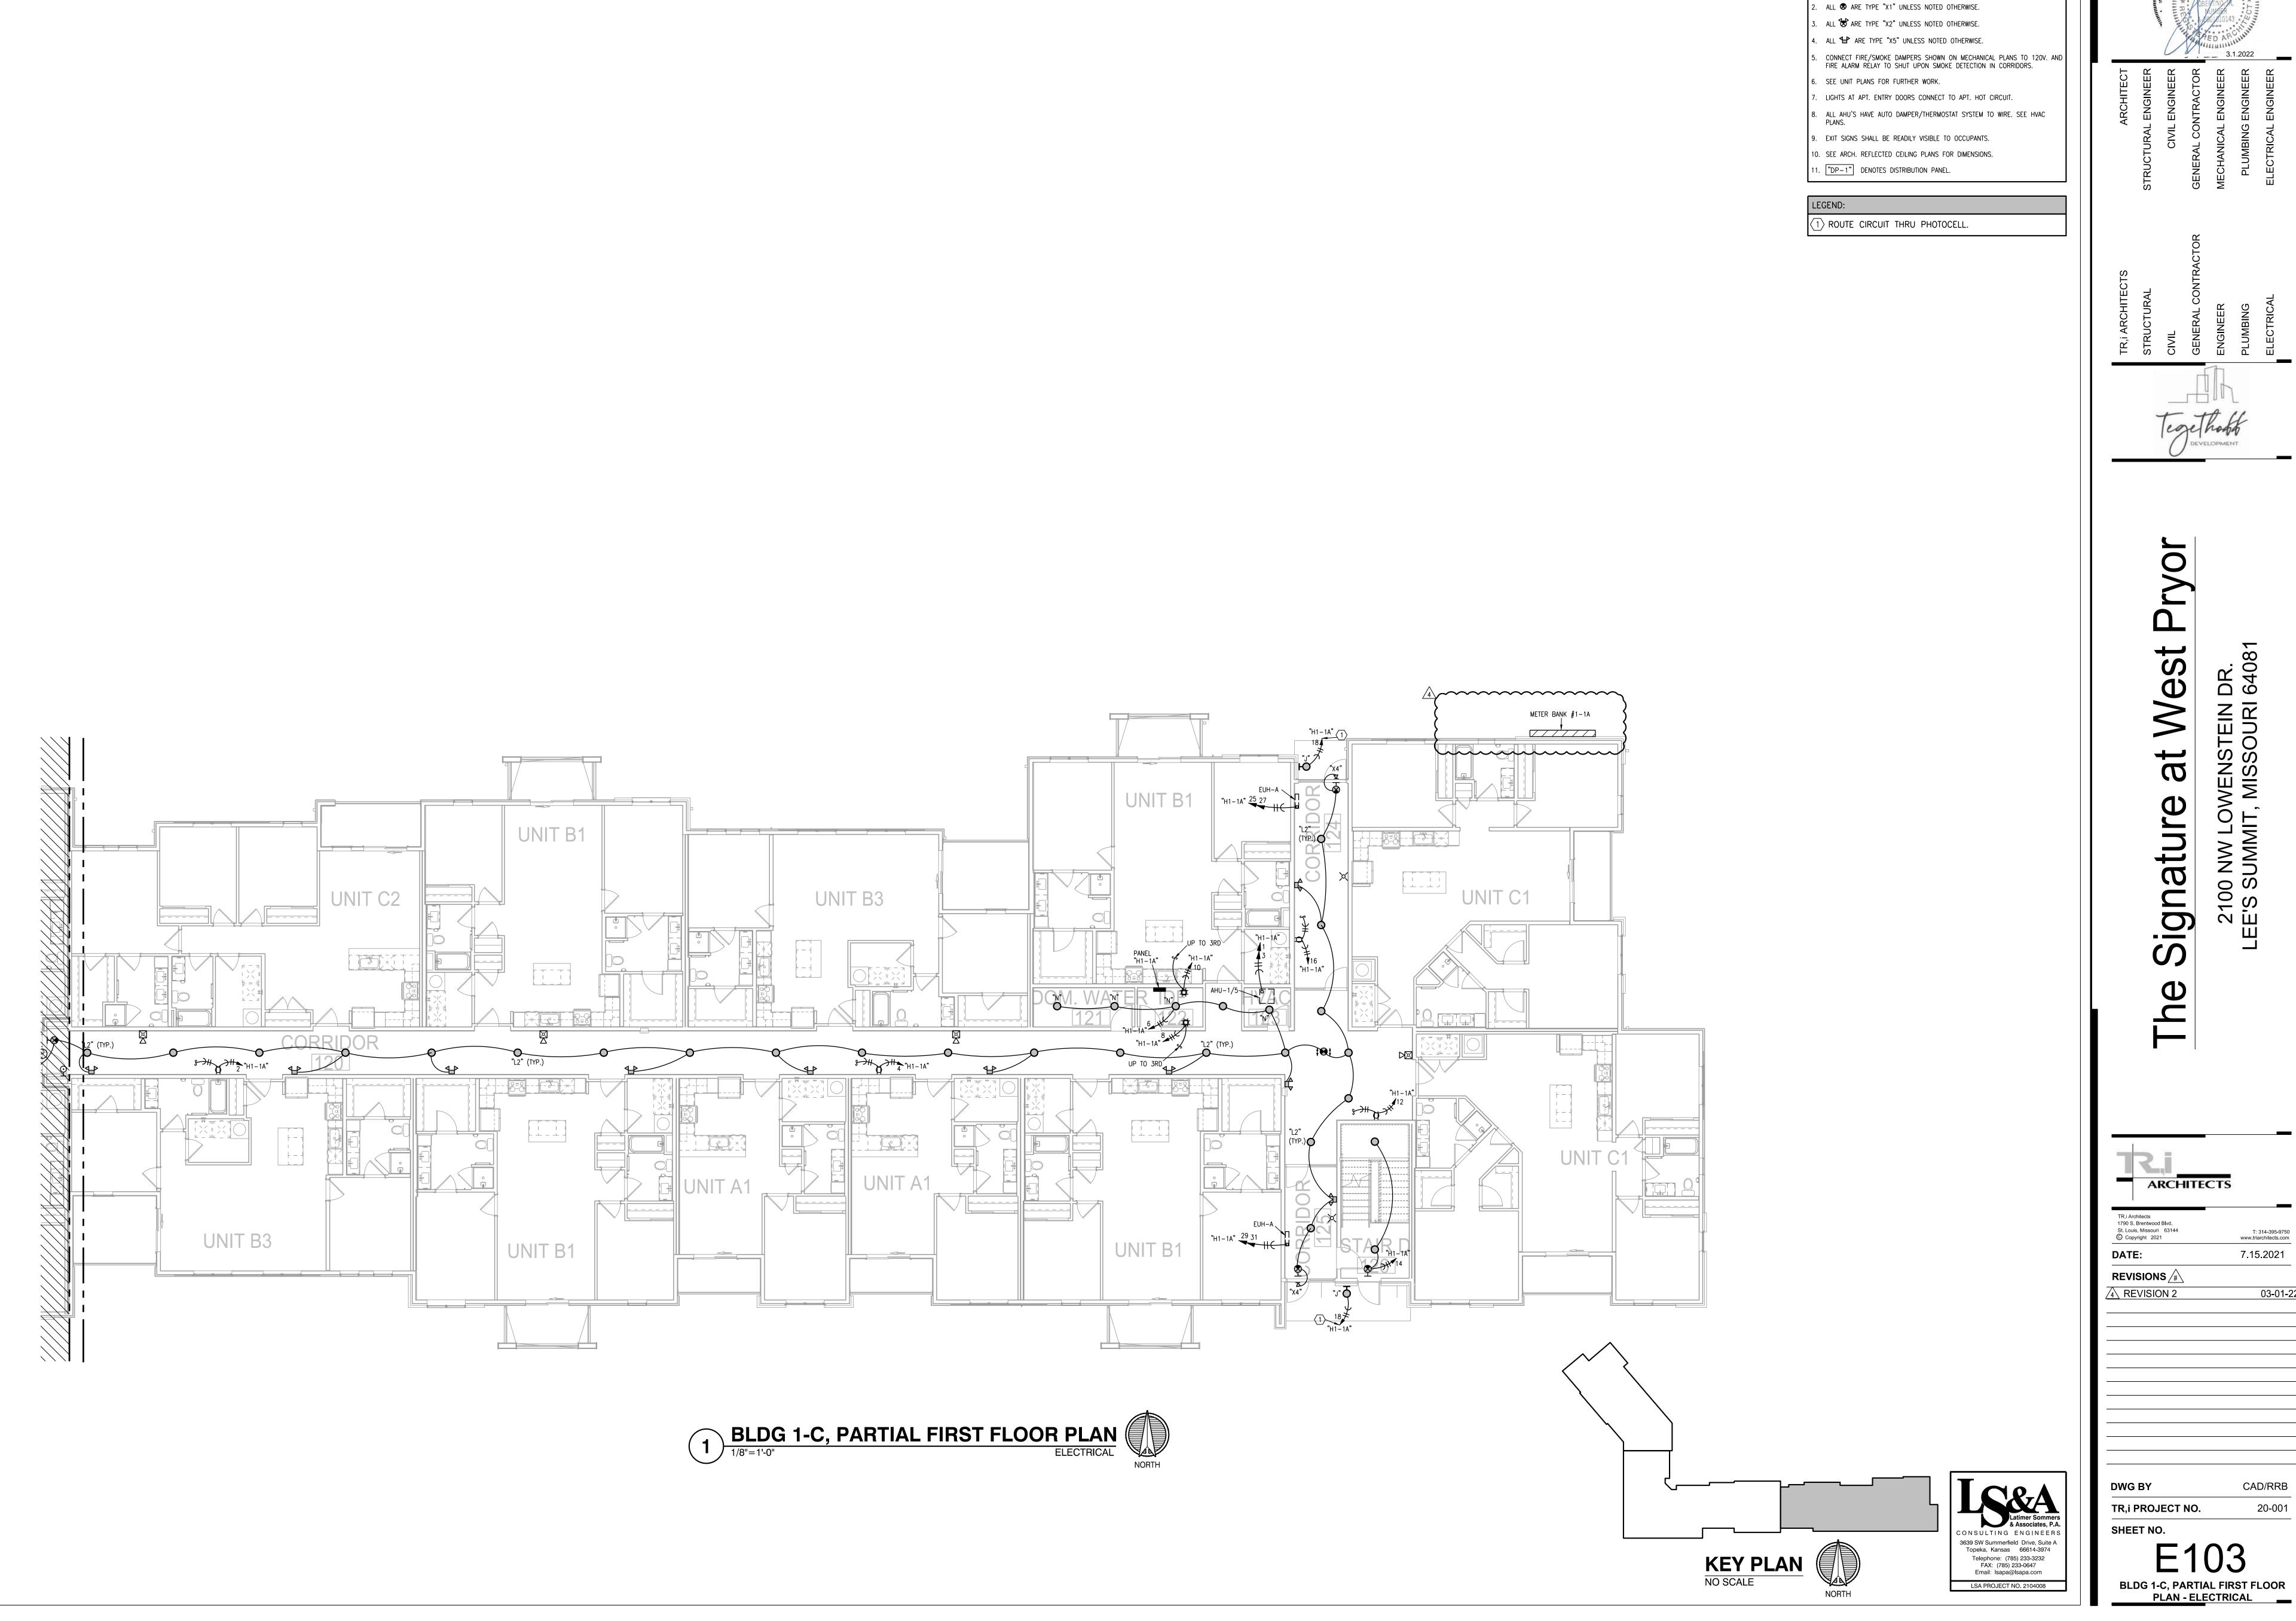SHEET NO. UNIT C2 -TYPE A - PLANS AND ELEVATIONS




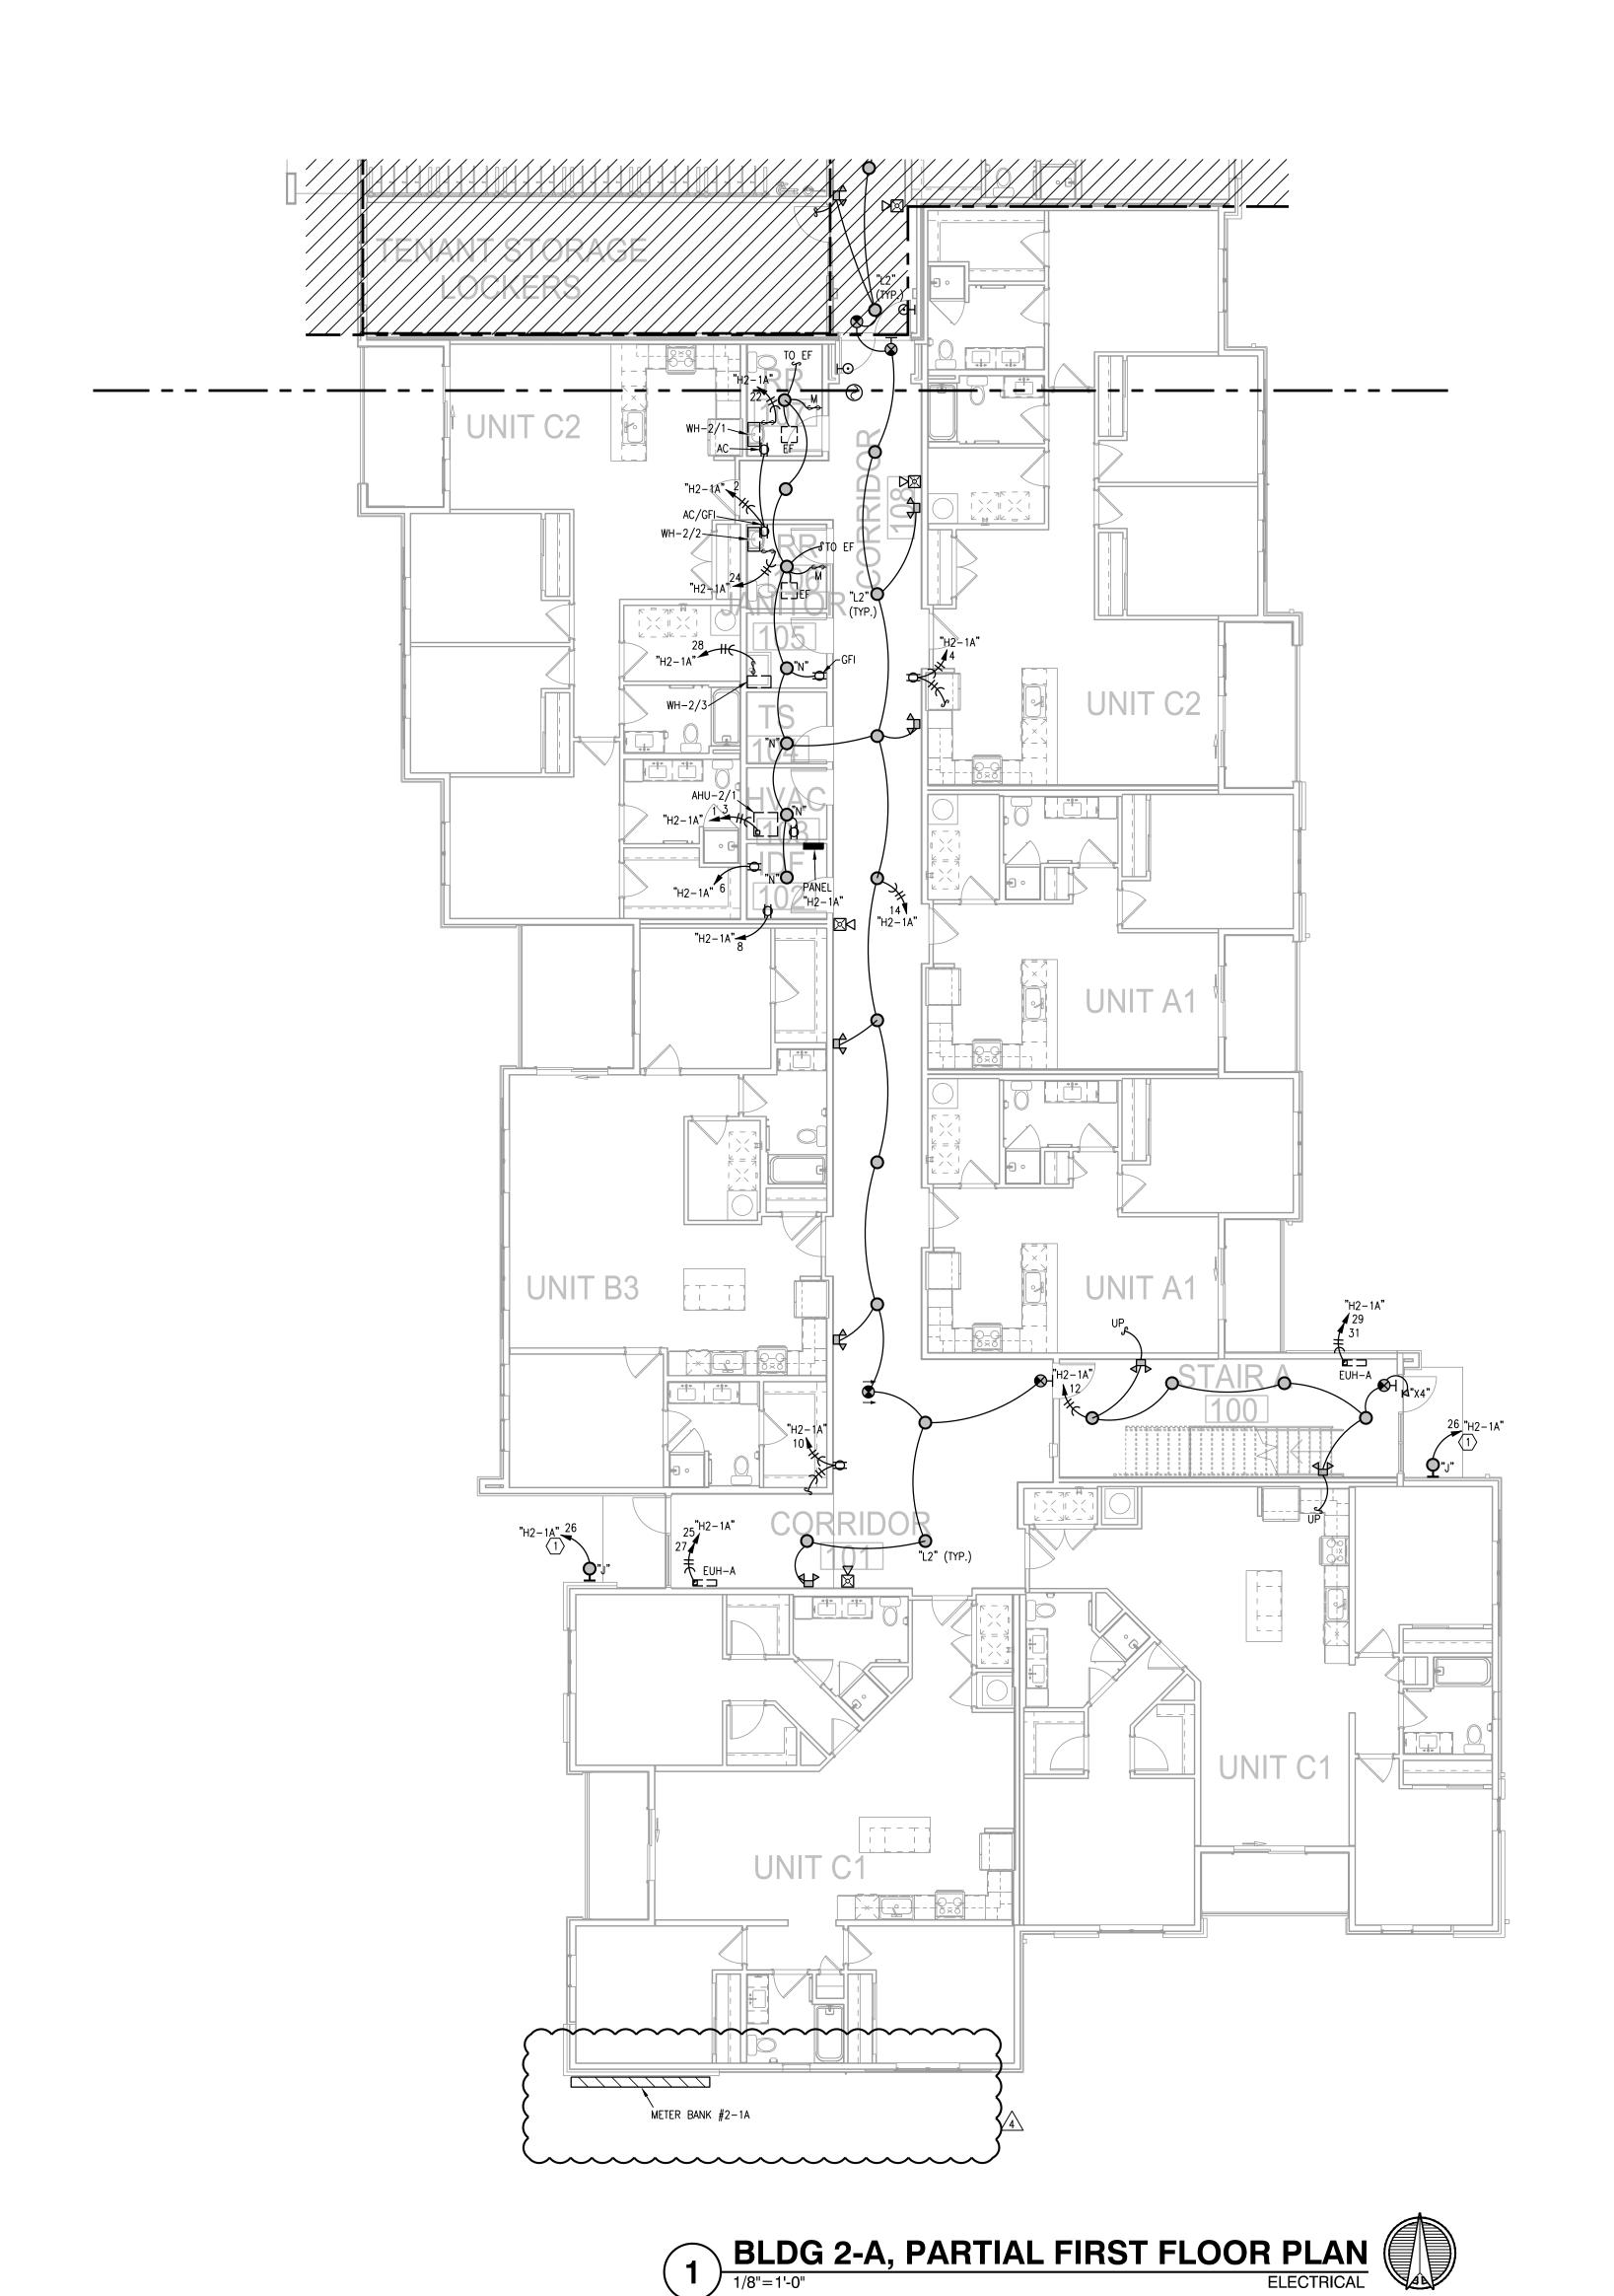ALL STAIR LIGHTS ARE TYPE "A2" UNLESS NOTED OTHERWISE.

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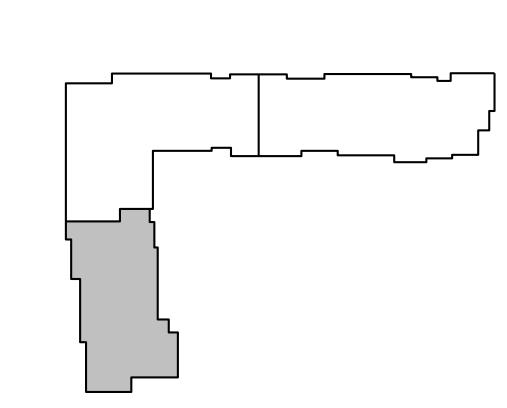
03-01-22



- ALL O ARE TYPE "A2" UNLESS NOTED OTHERWISE.
- . ALL STAIR LIGHTS ARE TYPE "A" UNLESS NOTED OTHERWISE.
- ALL 🐼 ARE TYPE "X1" UNLESS NOTED OTHERWISE.
- . ALL 😸 ARE TYPE "X2" UNLESS NOTED OTHERWISE.
- ALL 🛨 ARE TYPE "X5" UNLESS NOTED OTHERWISE.
- ALL STAIR LIGHTS ARE TYPE "P" U.N.O.
- . CONNECT FIRE/SMOKE DAMPERS SHOWN ON MECHANICAL PLANS TO 120V. AND FIRE ALARM RELAY TO SHUT UPON SMOKE DETECTION IN CORRIDORS.
 - SEE UNIT PLANS FOR FURTHER WORK.
- . LIGHTS AT APT. ENTRY DOORS CONNECT TO APT. HOT CIRCUIT. 10. ALL AHU'S HAVE AUTO DAMPER/THERMOSTAT SYSTEM TO WIRE. SEE HVAC
- 11. EXIT SIGNS SHALL BE READILY VISIBLE TO OCCUPANTS. 12. EXTERIOR LIGHTING TO BE ROUTED THRU PHOTOCELL.

13. "DP-1" DENOTES DISTRIBUTION PANEL.

1 TO LIGHTING CONTROL PANEL.





REVISIONS # REVISION 2 03-01-22


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TYPICAL APARTMENT FEEDERS BASED ON ALUM SE TYPE CABLE									
MAIN BREAKER	SIZE COND. MAX LENGTH (FT)								
100A.	2-2-2-6	100							
100A.	2-2-2-6	100							
100A.	1-1-1-4	125							
100A.	0-0-0-4	155							
110A.	1-1-1-4	115							
110A.	0-0-0-4	140							
110A.	2/0-2/0-2/0-3	180							
125A.	0-0-0-4	125							
125A.	2/0-2/0-2/0-3	155							
125A.	3/0-3/0-3/0-3	200							

NOTES:
1. SEE NEC TABLE 310.15 (B)(7)




NOTE: ALL GEAR TO BE 65 KAC SERIES

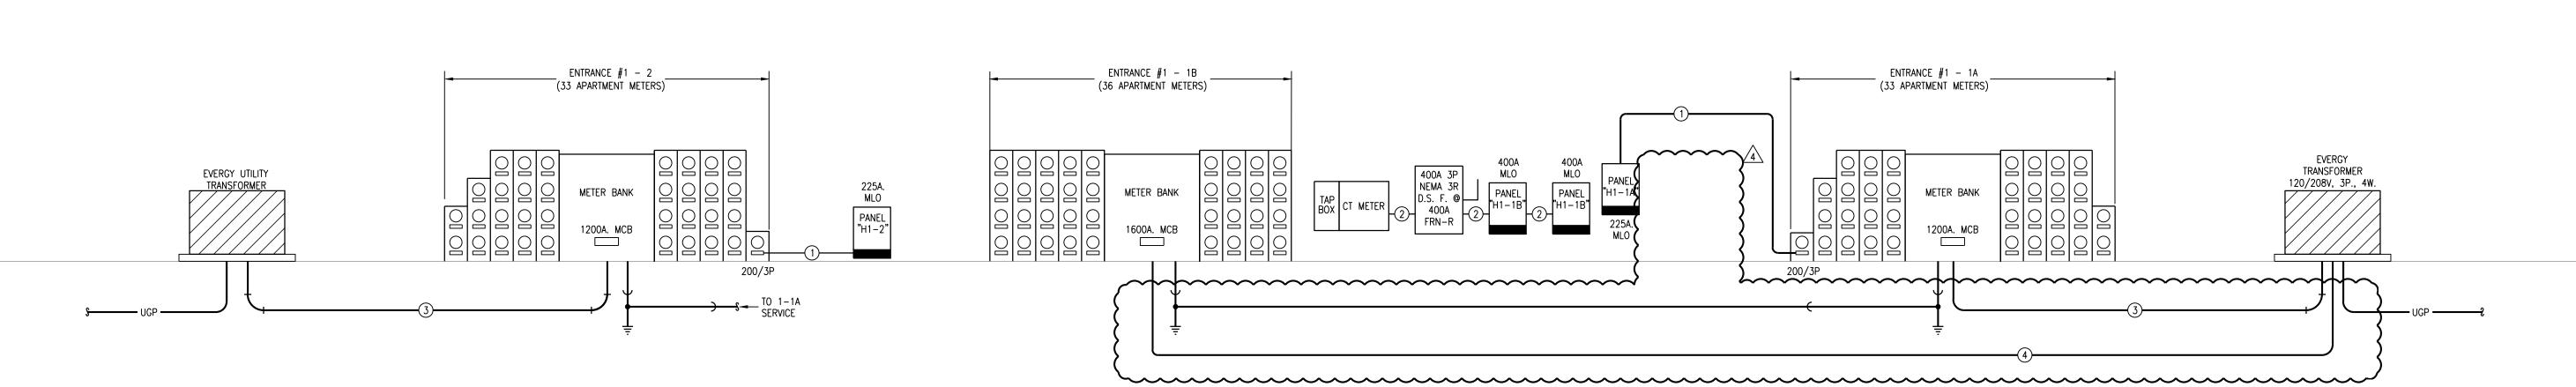RATED. KAIC TO BE VERIFIED WHEN POWER COMPANY DESIGN IS COMPLETE. ALL GEAR TO

HAVE PERMANENT VISUAL PLAQUES NOTING DISCONNECT POINTS ON FOR EACH BUILDING.

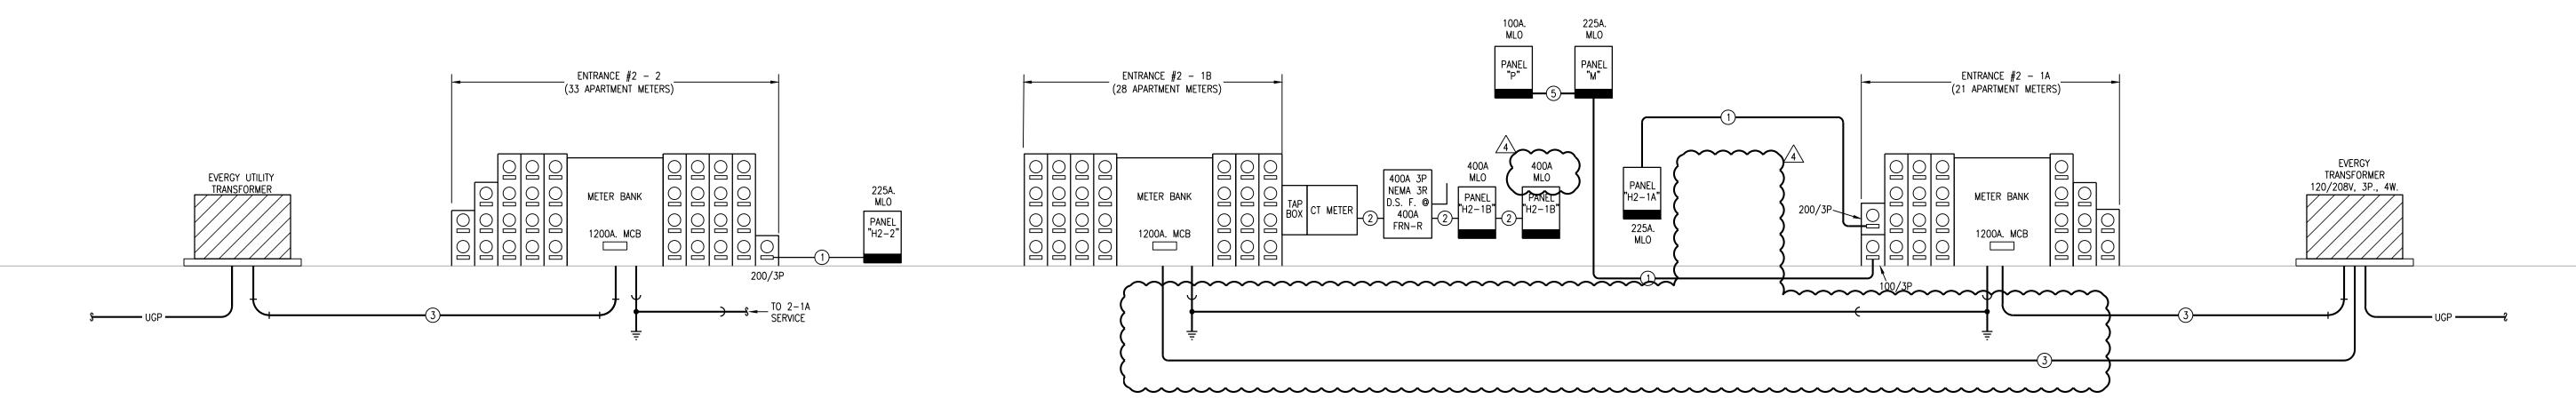BUILDING NO. 1 ELECTRICAL DISTRIBUTION RISER DIAGRAM NO SCALE



BUILDING NO. 2
ELECTRICAL DISTRIBUTION RISER DIAGRAM
NO SCALE



The Signature at West Pryor

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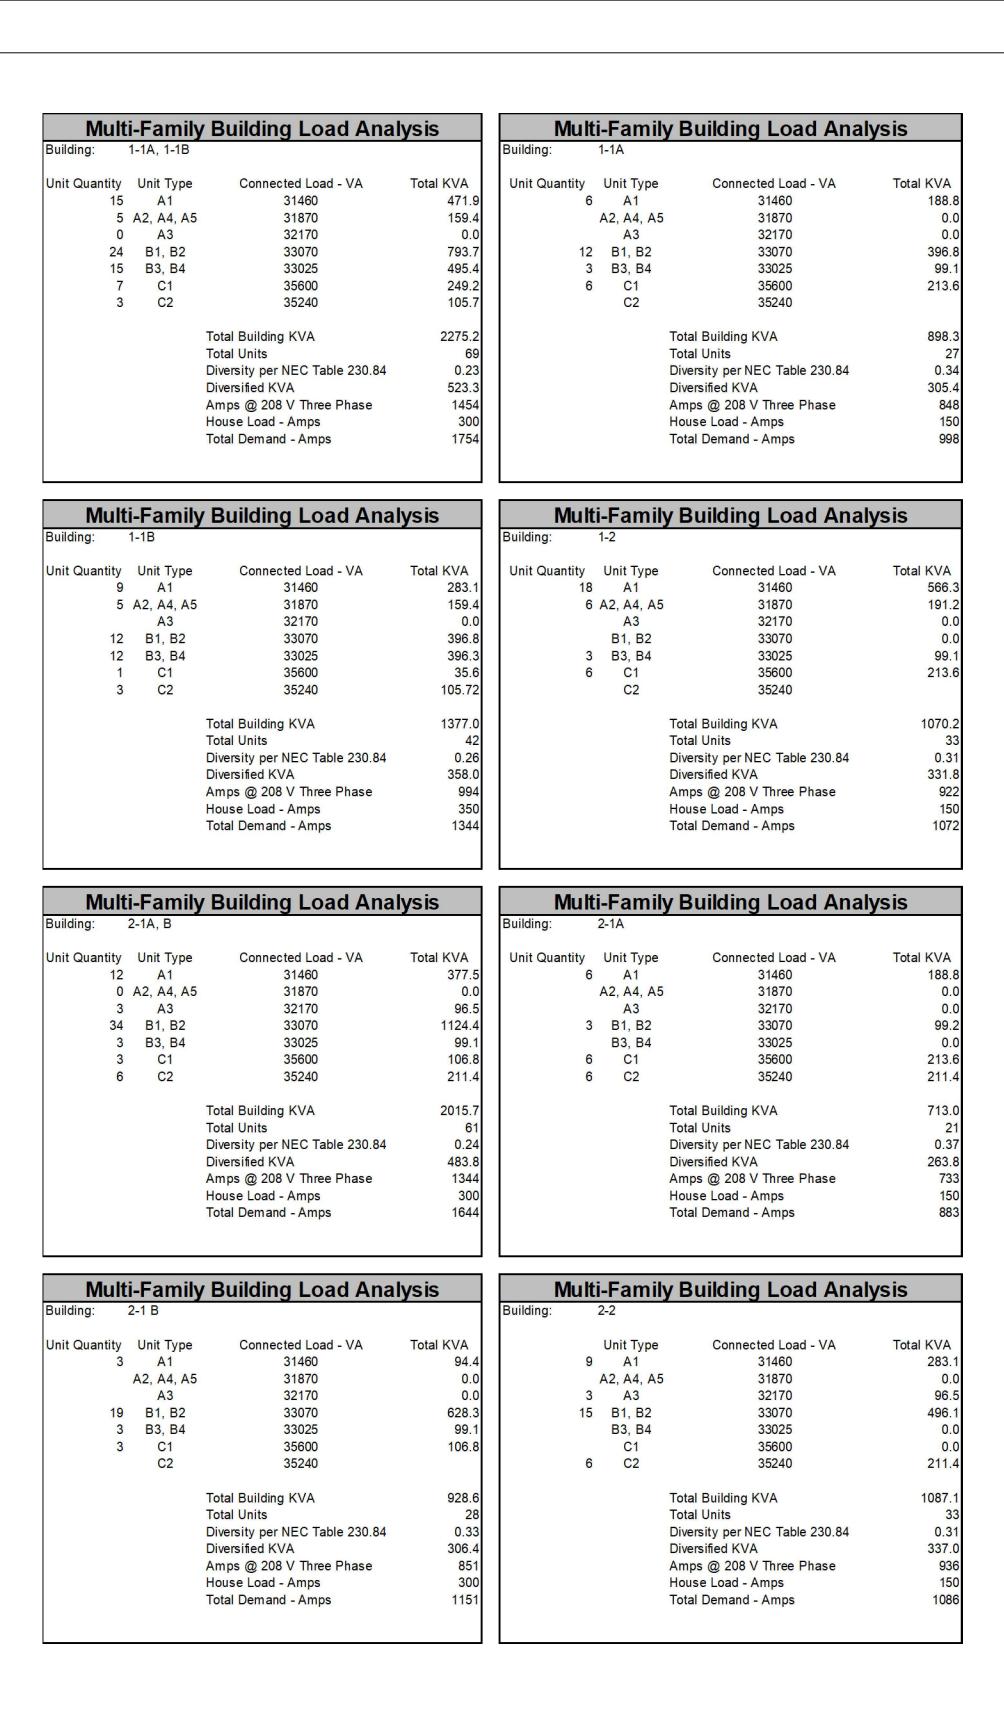
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SHEET NO.

ELECTRICAL DISTRIBUTION RISER DIAGRAMS



Unit Load Calculation		Unit Load Calculation		Unit Load Calculation			
Unit: A1	VA	Unit: A2, A4, A5	VA	Unit: A3	VA		
630 square feet at 3 VA per sq. ft.	1890	760 square feet at 3 VA per sq. ft.	2280	860 square feet at 3 VA per sq. ft.	2580		
2 small appliance circuits	3000	2 small appliance circuits	3000	2 small appliance circuits	300		
Range	8000	Range	8000	Range	800		
Varige Microwave	1000	Microwave	1000	Microwave	100		
Washer Vasher	1500	Washer	1500	Washer	150		
Dryer	4400	Dryer	4400	Dryer	440		
Nater Heater	4500	Water Heater		Water Heater	450		
	740	Dishwasher	4500	Dishwasher	74		
Dishwasher			740				
Disposer	850	Disposer	850	Disposer	850		
Total general load	25880	Total general load	26270	Total general load	26570		
NEC 220-84 Calculation		NEC 220-84 Calculation	Acres and a second	NEC 220-84 Calculation			
First 10 KVA at 100%	10000	First 10 KVA at 100%	10000	First 10 KVA at 100%	1000		
Remainder at 40%	6352	Remainder at 40%	6508	Remainder at 40%	6628		
Heater Load 5600 65%	3640	Heater Load 5600 65%	3640	Heater Load 5600 65%	364		
Total load	19992	Total load	20148	Total load	20268		
Load for unit service Amp @ 208 volt/1	96	Load for unit service Amp @ 208 volt/1	97	Load for unit service Amp @ 208 volt/1	97		
Connected Load	31480	Connected Load	31870	Connected Load	32170		
Unit Load Calculation		Unit Load Calculation		Unit Load Calculation			
Unit: B1, B2	VA	Unit: B3, B4	VA	Unit: C1	VA		
1160 square feet at 3 VA per sq. ft.	3480	1145 square feet at 3 VA per sq. ft.	3435	1370 square feet at 3 VA per sq. ft.	4110		
2 small appliance circuits	3000	2 small appliance circuits	3000	2 small appliance circuits	3000		
Range	8000	Range	8000	Range	8000		
Microwave	1000	Microwave	1000	Microwave	1000		
Washer	1500	Washer	1500	Washer	1500		
Dryer	4400	Dryer	4400	Dryer	4400		
Water Heater	4500	Water Heater	4500	Water Heater	4500		
Dishwasher	740	Dishwasher	740	Dishwasher	740		
Disposer	850	Disposer	850	Disposer	850		
Total general load	27470	Total general load	27425	Total general load	28100		
NEC 220-84 Calculation		NEC 220-84 Calculation		NEC 220-84 Calculation			
First 10 KVA at 100%	10000	First 10 KVA at 100%	10000	First 10 KVA at 100%	10000		
Remainder at 40%	6988	Remainder at 40%	6970	Remainder at 40%	7240		
Heater Load 5600 65%	3640	Heater Load 5600 65%	3640	Heater Load 7500 65%	487		
Total load	20628	Total load	20610	Total load	2211		
Load for unit conice. Amn @ 200 unit/1	99	Load for unit service Amp @ 208 volt/1	99	Load for unit service Amp @ 208 volt/1	100		
LOAU IOI UIIL SEIVICE AIIID (a). 200 VOIV I				Connected Load	35600		
	33070	Connected Load	33025	Connected Load			
Connected Load	33070	Connected Load	33023	Connected Load			
Unit Load Calculation Unit: C2	VA	Connected Load	33025	Connected Load			
Unit Load Calculation Unit: C2 1250 square feet at 3 VA per sq. ft.	VA 3750	Connected Load	33025	Connected Load			
Unit Load Calculation Unit: C2 1250 square feet at 3 VA per sq. ft.	VA 3750 3000	Connected Load	33025	Connected Load			
Unit Load Calculation Unit: C2 1250 square feet at 3 VA per sq. ft. 2 small appliance circuits	VA 3750	Connected Load	33025	Connected Load			
Unit Load Calculation Unit: C2	VA 3750 3000	Connected Load	33025	Connected Load			

Water Heater

Dishwasher

Total general load

NEC 220-84 Calculation

7500

Load for unit service Amp @ 208 volt/1

First 10 KVA at 100%

Remainder at 40%

Connected Load

Heater Load

Total load

Disposer

Common Space Luminaire Schedule									
MFGR	MODEL	MOUNTING	FINISH	LAMPS	NOTES				
MAXIM	57690WTWT-CHIP 5"	recessed	white	12W LED					
_iton	LCMPD5R	jb/surface	white	ELV Dimming (120V)					
FANIMATION	FPS8533MW - KWARTET	surface	white						
MIXAN	52102	surface	satin nickel						
MIXAN	52103SN	surface	satin nickel						
MIXAN	52104	surface	satin nickel						
MIXAN	54350ABZ - Avenue	wall	bronze						
ET2	E20086-BK - ABYSS	pendant	black						
ACCESS LIGHTING	49960LEDD-WH/ACR - COMO	surface	white						
by others		wall							
Progress	P563000-020-30K	wall	black	12W LED					
Honeywell	48' LED Indoor/Outdoor Stringlight	surface		24W LED 1872 Lumens					
_ithonia	MNSL-L46 1LL MVOLT 40k	surface	white	20W 4000K LED	W/ BATTERY				
Matteo	X8311BKOP	surface							
Maxim	57690 WTWT	recessed							
Maxim	COCOON 12190WTPC	pendant							
Access Lighting	24891LEDD-MWH/ACR	surface							
Matteo	W83010BKOP 40" AFF	wall							
Matteo	C81704BKOP	surface							
Matteo	C8311BKOP	surface							
Matteo	C79611AL	recessed							
Satco	62/1312	surface	white	16.5W LED 4000K 1050LM					
Royal Pacific	RXL-5-RW	surface	white/red	1.5W LED	remote capable				
Royal Pacific	RXEL39 - RW	surface	white/red	1.5W LED					
_ithonia	ELA-LED	surface	std	1W LED					
_ithonia	WLTE W 1 R	surface	std	1W LED					
Lithonia	ELM4L	surface	std	640 lumen					

DESCRIPTION

D OUTDOOR SCONCE/PATIO
E PENDANT

A DISK LIGHT

A2 Stair Puck

B FAN/LIGHT

C1 24" RAIL

C2 30" RAIL

C3 36" RAIL

F GLOBE

J Wall wash
K String Lights

L2 Disk 1

L4 Linear 1

L5 Sconce

L8 Disk 2 M NOT USED

X2 Exit w/heads

X3 Remote Head
X4 Weatherproof Exit

X5 Dual-Head Emergency

H Enrty Door Sconce


L1 Decorative Globe 1

L3 Decorative Pendant 1

L6 Linear 2 L7 Decorative Globe 1

N Closet disk with built in motion

			ELE	CIR	ICAL	۲/	AN	ELS	CHE	DULE			
PANEL: M				LOCAT	ION:						MOUNTING:	SURFACE	
BUS: 225 A	MAINS:	MLO		VOLTA	GE:	120/	208		PHASE	WIRE:	3/4		KAIC: 10
		WATTS				PO	LE			WA	iTTS		
DESCRIPTION	A	В	С	BRKR	WIRE			WIRE	BRKR	A	В	С	DESCRIPTION
DRYER	2200			30	8	1	2	12	20	50		_	LTG
		2200		2P	8	3	4	12	20		500		LTG
DRYER		_	2200	30	8	5	6	12	20		_		RECEPT
	2200		_	2P	8	7	8	12	20	500		_	WASHER
WH-M		2200		30	8	9	10	12	20		500		WASHER
			2200	2P	8	11	12	12	20			1000	RECEPT
EUH-D	1000			20	12	13	14	12	20	1000			RECEPT
EUH-D		1000		20	12	15	16	12	20		400		RECEPT
AHU-MAINT			5930	70	6	17	18	12	20			400	RECEPT
	5930			2P	6	19	20	12	20	400		_	RECEPT
CU-MA INT		2200		45	8	21	22	12	20		800		RECEPT
			2200	2P	8	23	24	12	20			400	RECEPT
EUH-B	4370			60	6	25	26	12	20	200			RECEPT
		4370		2P	6	27	28	12	20		400		RECEPT
RECEPT			400	20	12	29	30	12	20			400	RECEPT
SITE LIGHTING	800		-	20	10	31	32	12	20	500		_	MOTOR
						33	34	12	20		400		RECEPT
						35	36	12	20			400	RECEPT
PANEL P	4000					37	38	12	20	400			RECEPT
		1950				39	40	12	20		400		RECEPT
		\	1750			41	42		20		1	400	RECEPT
CONNECTED LOAD-WATTS	23550	17320	17680							FEEDER LO	AD-WATTS		
CONNECTED LOAD-AMPS	196	144	147							FEEDER LO	AD-AMPS		
CONTINUOUS LOAD										FEEDER WI	RE		
RECEPTA CLES										FEEDER OC	;P		
NON-CONTINUOUS LOAD													
OTHER DIVERSIFIED LOAD				@	0.5								

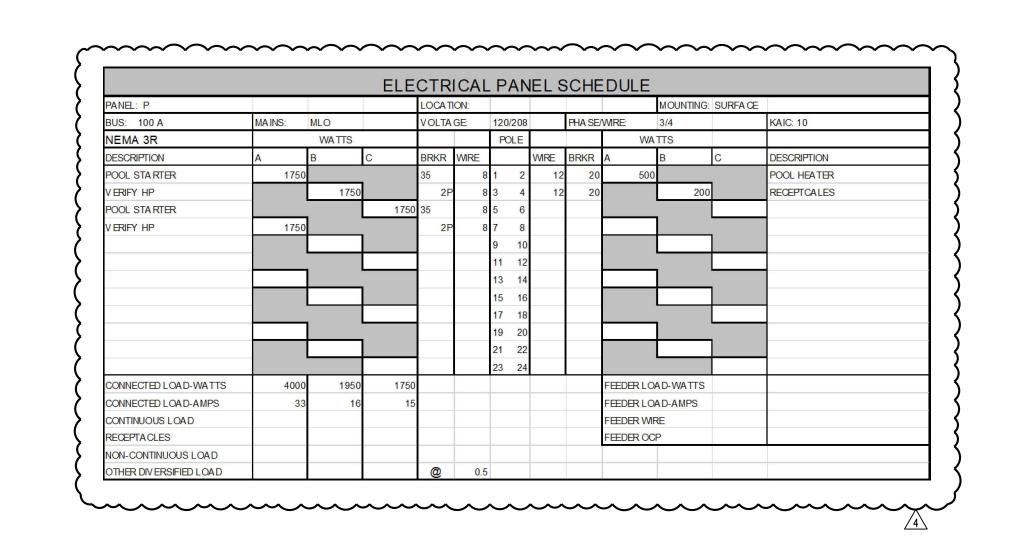

ELECTRICAL PANEL SCHEDULE

MOUNTING: FLUSH

MOUNTING: FLUSH

VOLTAGE 120/240 PHASE/WIRE 1 Ph 3 Wire KAIC:10K

VOLTAGE: 120/240 PHASE/WIRE: 1 Ph 3 Wire KAIC:10K

VOLTAGE: 120/240 PHASE/WIRE: 1 Ph 3 Wire KAIC:10K

VOLTAGE 120/240 PHASE/WIRE 1 Ph 3 Wire KAIC:10K

VOLTAGE: 120/240 PHASE/WIRE 1 Ph 3 Wire KAIC:10K

POLES

MOUNTING: FLUSH

PANEL: A1, A2, A4

CIRCUIT NUMBERS

THRU 18 EVEN

CIRCUIT NUMBERS

THRU 20 EVEN

CIRCUIT NUMBERS

THRU 18 EVEN

CIRCUIT NUMBERS

THRU 20 EVEN

, 7, 13, 15

4 THRU 20 EVEN, 21

CIRCUIT NUMBERS DESCRIPTION

5, 7, 13, 15

5, 7, 13, 15

5, 7, 13, 15

5, 7, 13, 15

ESCRIPTION

WATER HEATER, DRY ER

MAINS: MLO

WATER HEATER, DRYER

LIGHTS AND RECEPTACLES

MAINS: MLO

WATER HEATER, DRYER

LIGHTS AND RECEPTACLES

ARC-FAULT LIGHTS AND RECEPTACLES

CONDENSING UNIT

DESCRIPTION

WATER HEATER, DRY ER

WATER HEATER, DRY ER

LIGHTS AND RECEPTACLES

ARC-FAULT LIGHTS AND RECEPTACLES

CONDENSING UNIT

LIGHTS AND RECEPTACLES

ARC-FAULT LIGHTS AND RECEPTACLES

CONDENSING UNIT

DESCRIPTION

ARC-FAULT LIGHTS AND RECEPTACLES

CONDENSING UNIT

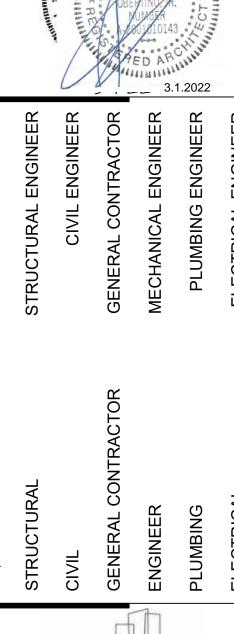
DESCRIPTION

IGHTS AND RECEPTACLES

ARC-FAULT LIGHTS AND RECEPTACLES

CONDENSING UNIT





t West Pryor STEIN DR.

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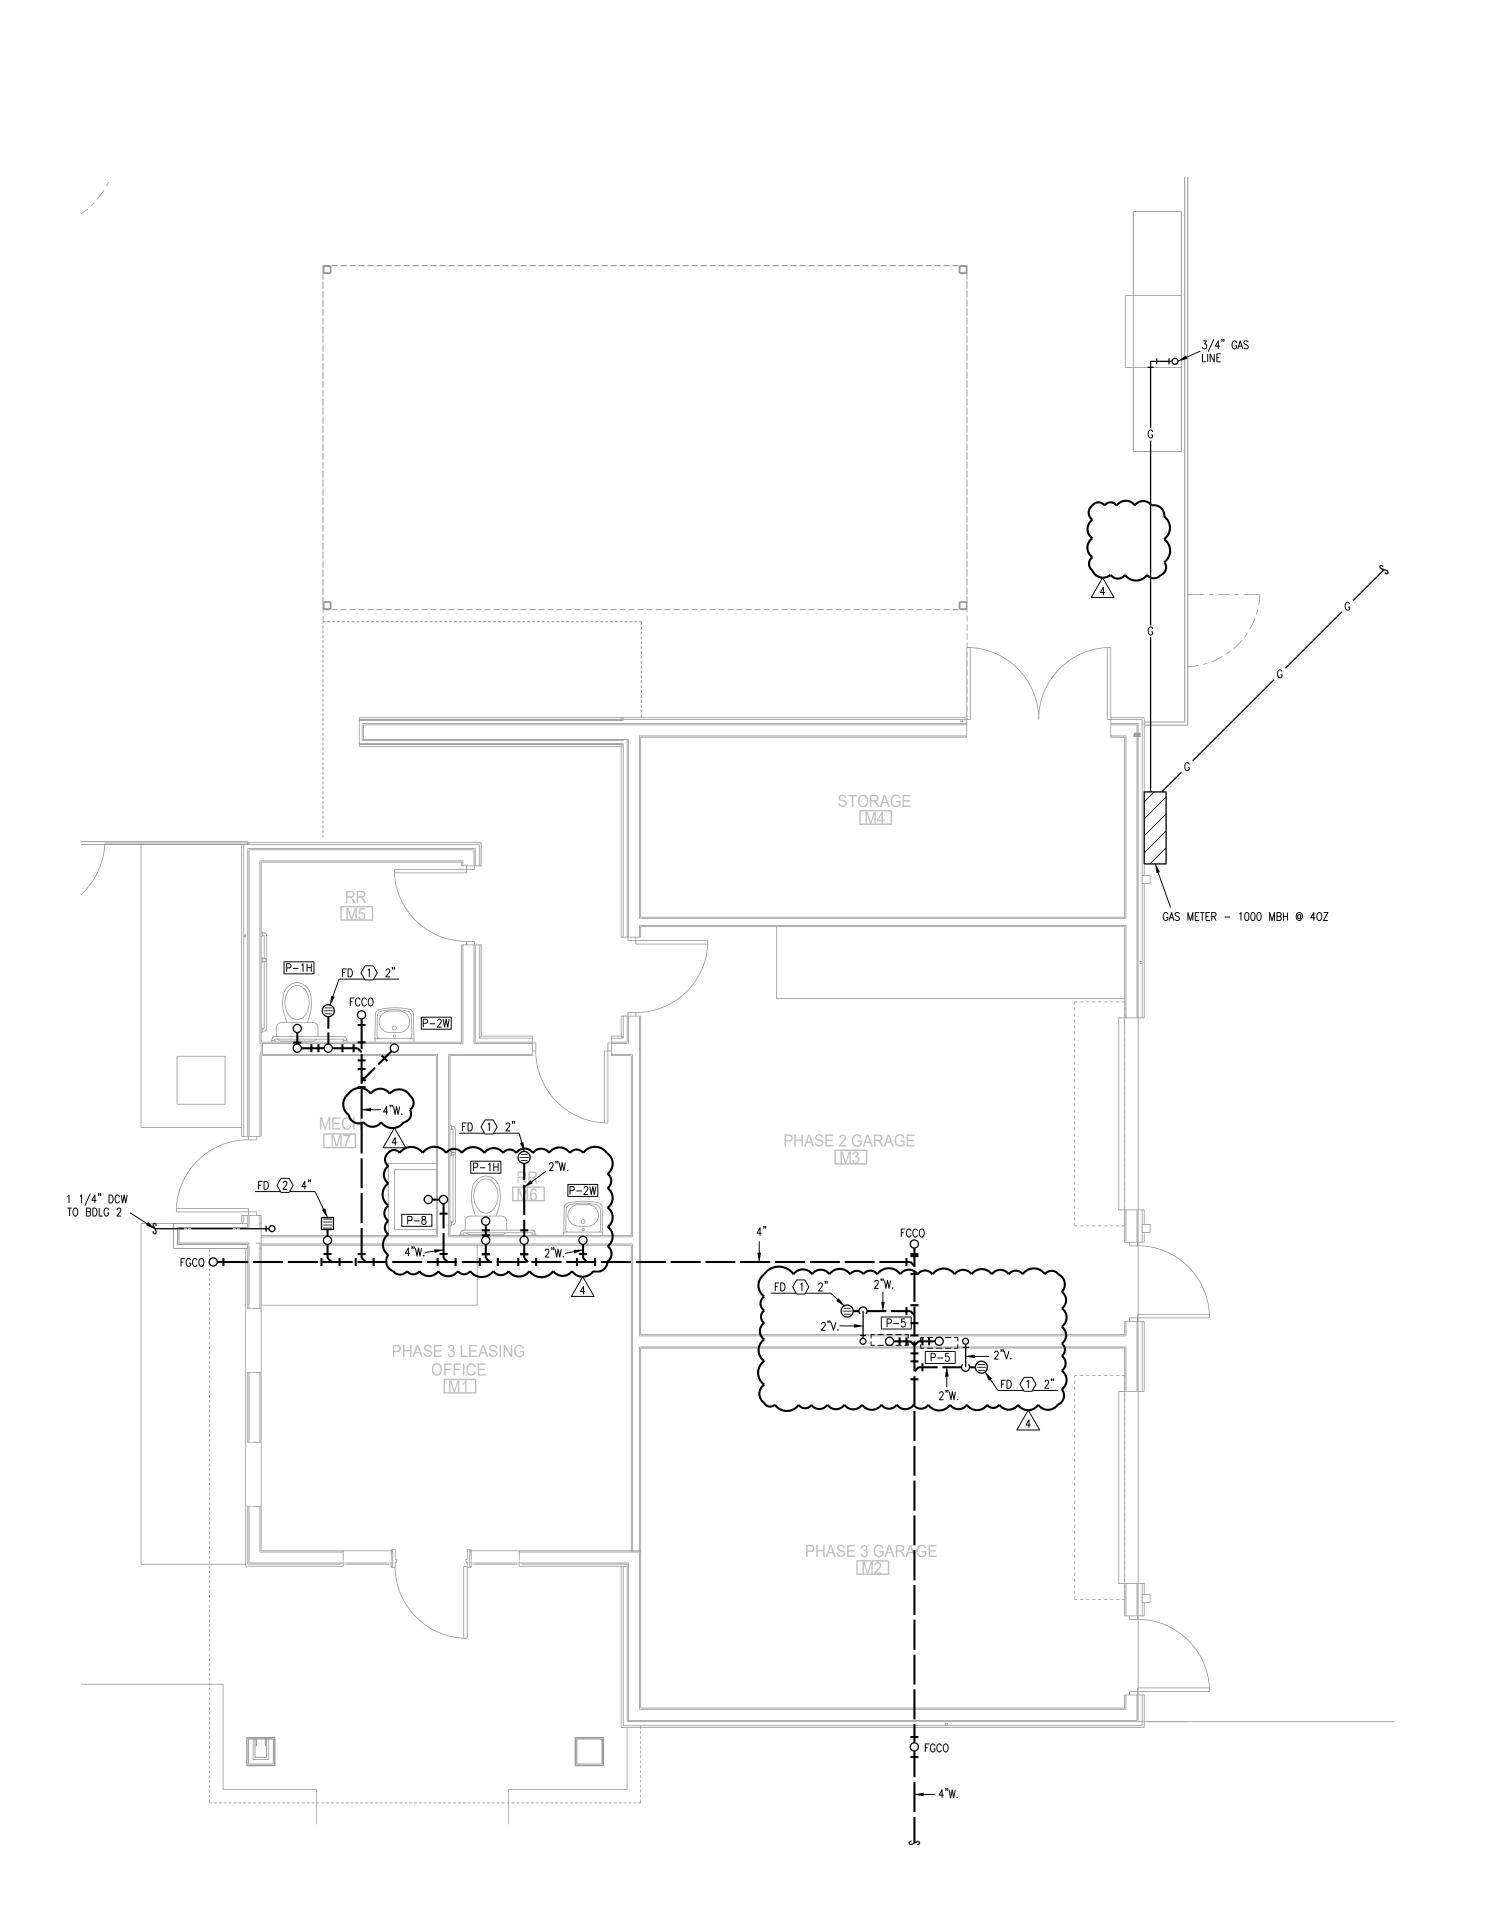
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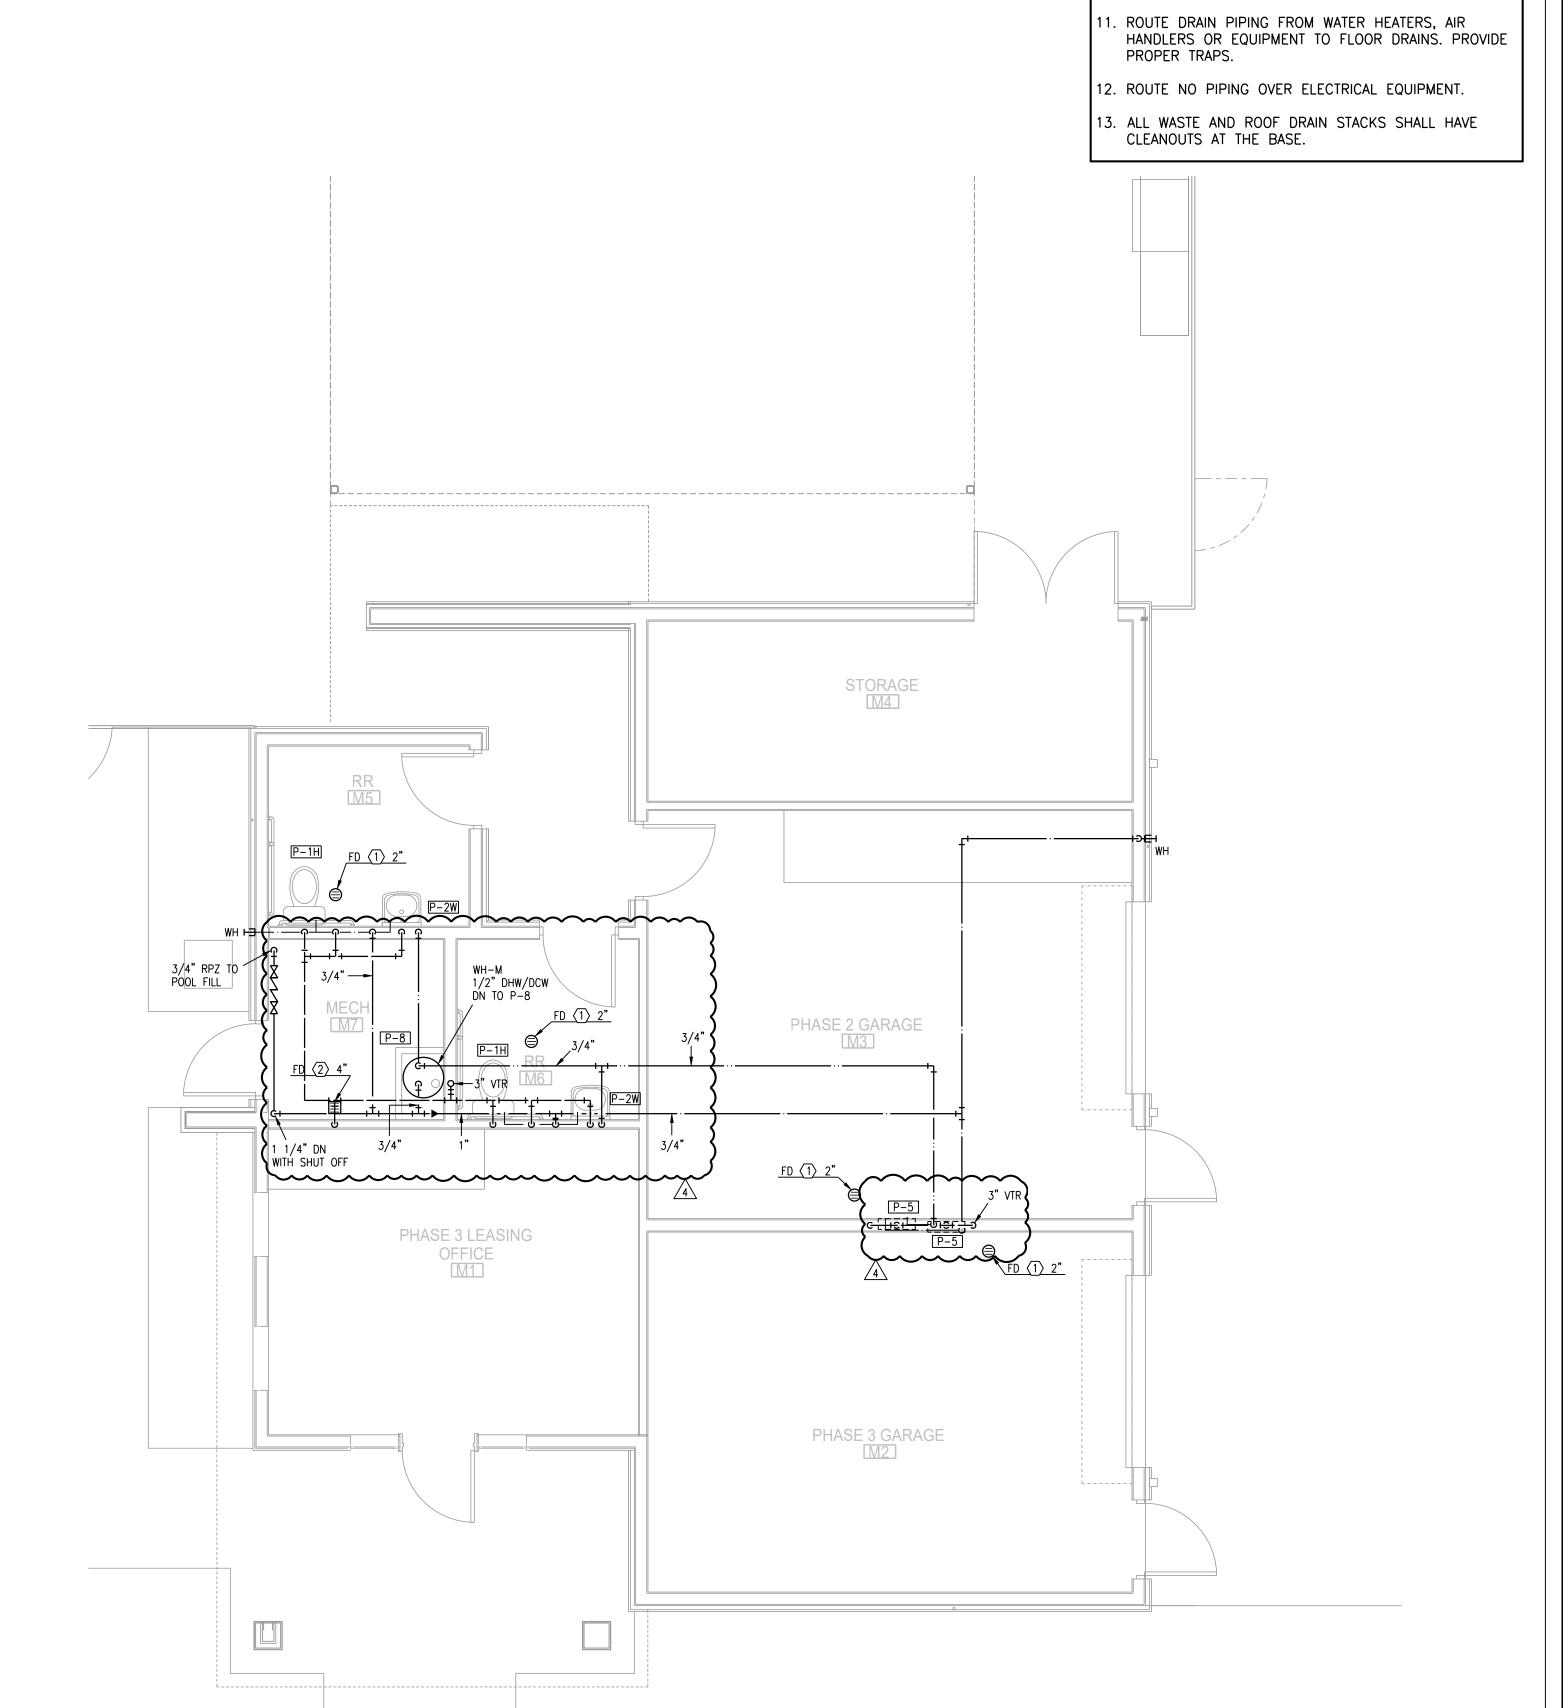
ELECTRICAL SCHEDULES



MAINTENANCE BLDG FLOOR PLAN

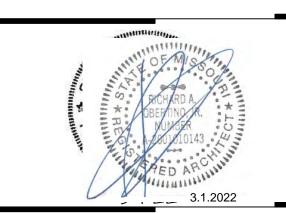
1/4"=1'-0"

BELOW-GRADE PLUMBING









ALL DRAIN, WASTE AND VENT PIPING IS 2" UNLESS

. ALL BELOW SLAB SUPPLY PIPING SHALL BE PEX WITH NO JOINTS. DHW BELOW SLAB TO BE INSULATED TO

5. DHW PIPING 3/4" AND LARGER TO BE INSULATED TO

. ALL SUPPLY PIPING IS 1/2" UNLESS NOTED

MANUFACTURERS INSTRUCTIONS.

OPENINGS OR INTAKE.

CONNECT ALL APPLIANCES OR EQUIPMENT PER

ALL PLUMBING VENTS SHALL BE 10 FEET FROM

THERE SHALL BE NO PVC WITHIN RETURN AIR

ALL FIXTURES WITH QUICK CLOSING VALVES SHALL HAVE BLADDER OR TYPE SHOCK SUPPRESSORS FOR

. SEE ARCHITECTURAL DRAWINGS FOR ALL MOUNTING

10. REFER TO THE ARCHITECTURAL DRAWINGS FOR FLOOR DRAIN LOCATIONS AND FLOOR SLOPES IF PRESENT.

NOTED OTHERWISE.

R-3 MINIMUM

OTHERWISE.

PLENUMS.

EACH CHASE.

HEIGHTS.

UIL

CIVIL ENGINEER

ENERAL CONTRACTOR

GENERAL CONTRACTOR

IGINEER

MECHANICAL ENGINEER

CIVIL CIVIL GENERAL GENERAL ENGINEER ENGINEER

gnature at West P

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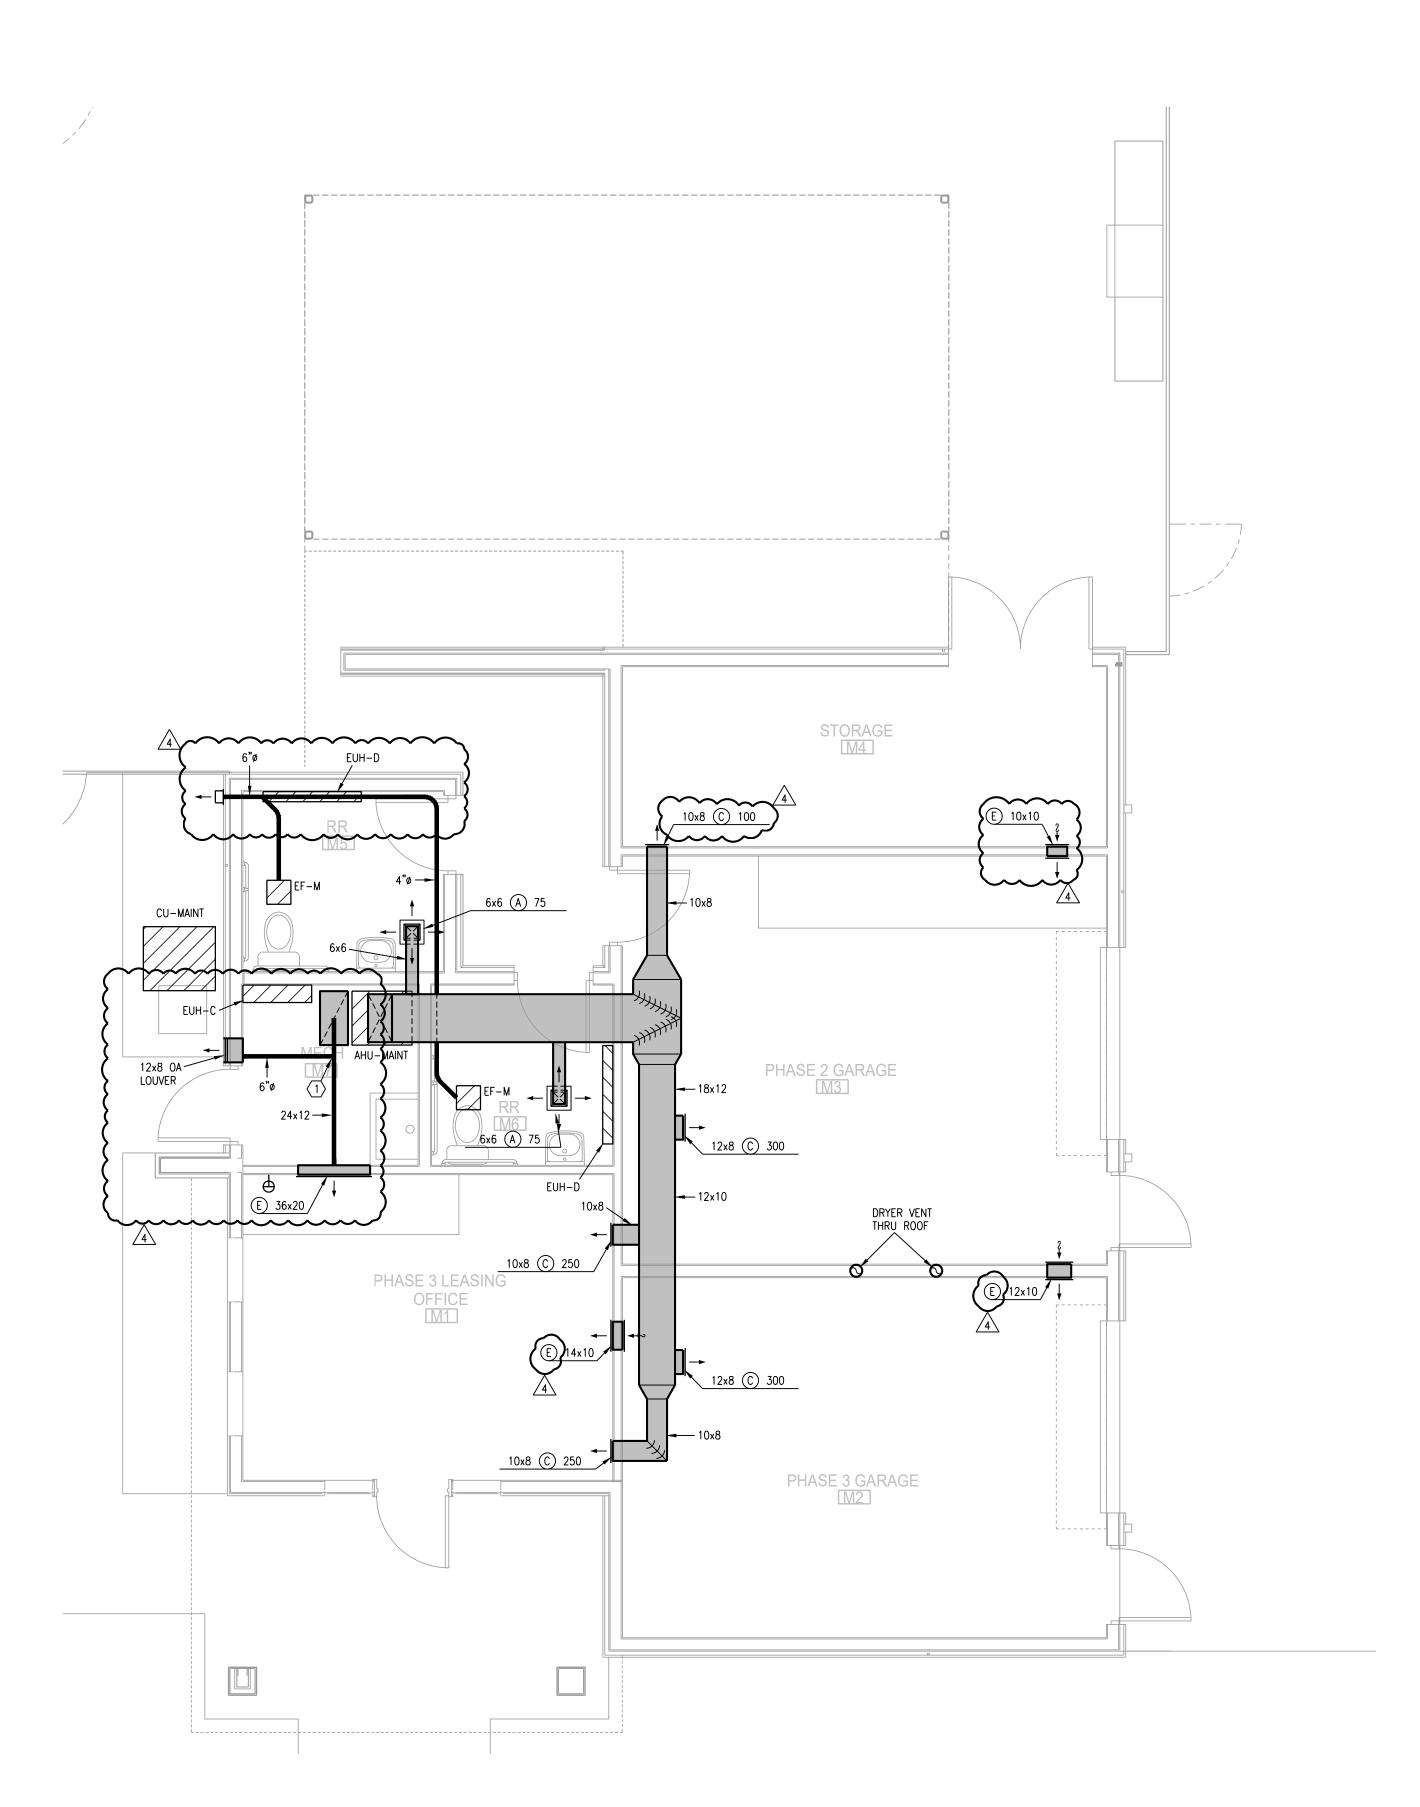
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ME201
MAINTENANCE BLDG - PLUMBING









ALL INDIVIDUAL BRANCH DUCTS ARE THE SIZE OF THE DIFFUSER NECK LISTED AND HAVE A MANUAL BALANCING DAMPER WHERE NOT INTEGRAL WITH THE DIFFUSER.

. SEE THE ARCHITECTURAL, LIGHTING AND STRUCTURAL DRAWINGS FOR CLEARANCES.

. MAINTAIN 3 FEET CLEARANCE FROM EXHAUST DUCTS TO

BUILDING OPENINGS AND 10 FEET TO AIR INTAKES.

4. ROUTE NO DUCTS OVER ELECTRICAL EQUIPMENT.

5. FLEXIBLE DUCT LENGTHS SHALL NOT EXCEED 8 FEET AND SHALL BE AS STRAIGHT AS POSSIBLE AND NOT KINKED AT DIFFUSER OR TAKE-OFF.

1 OUTSIDE AIR CONTROL AND BALANCING DAMPER. 2 DUCT WITH CRD AT RATED MEMBRANE.

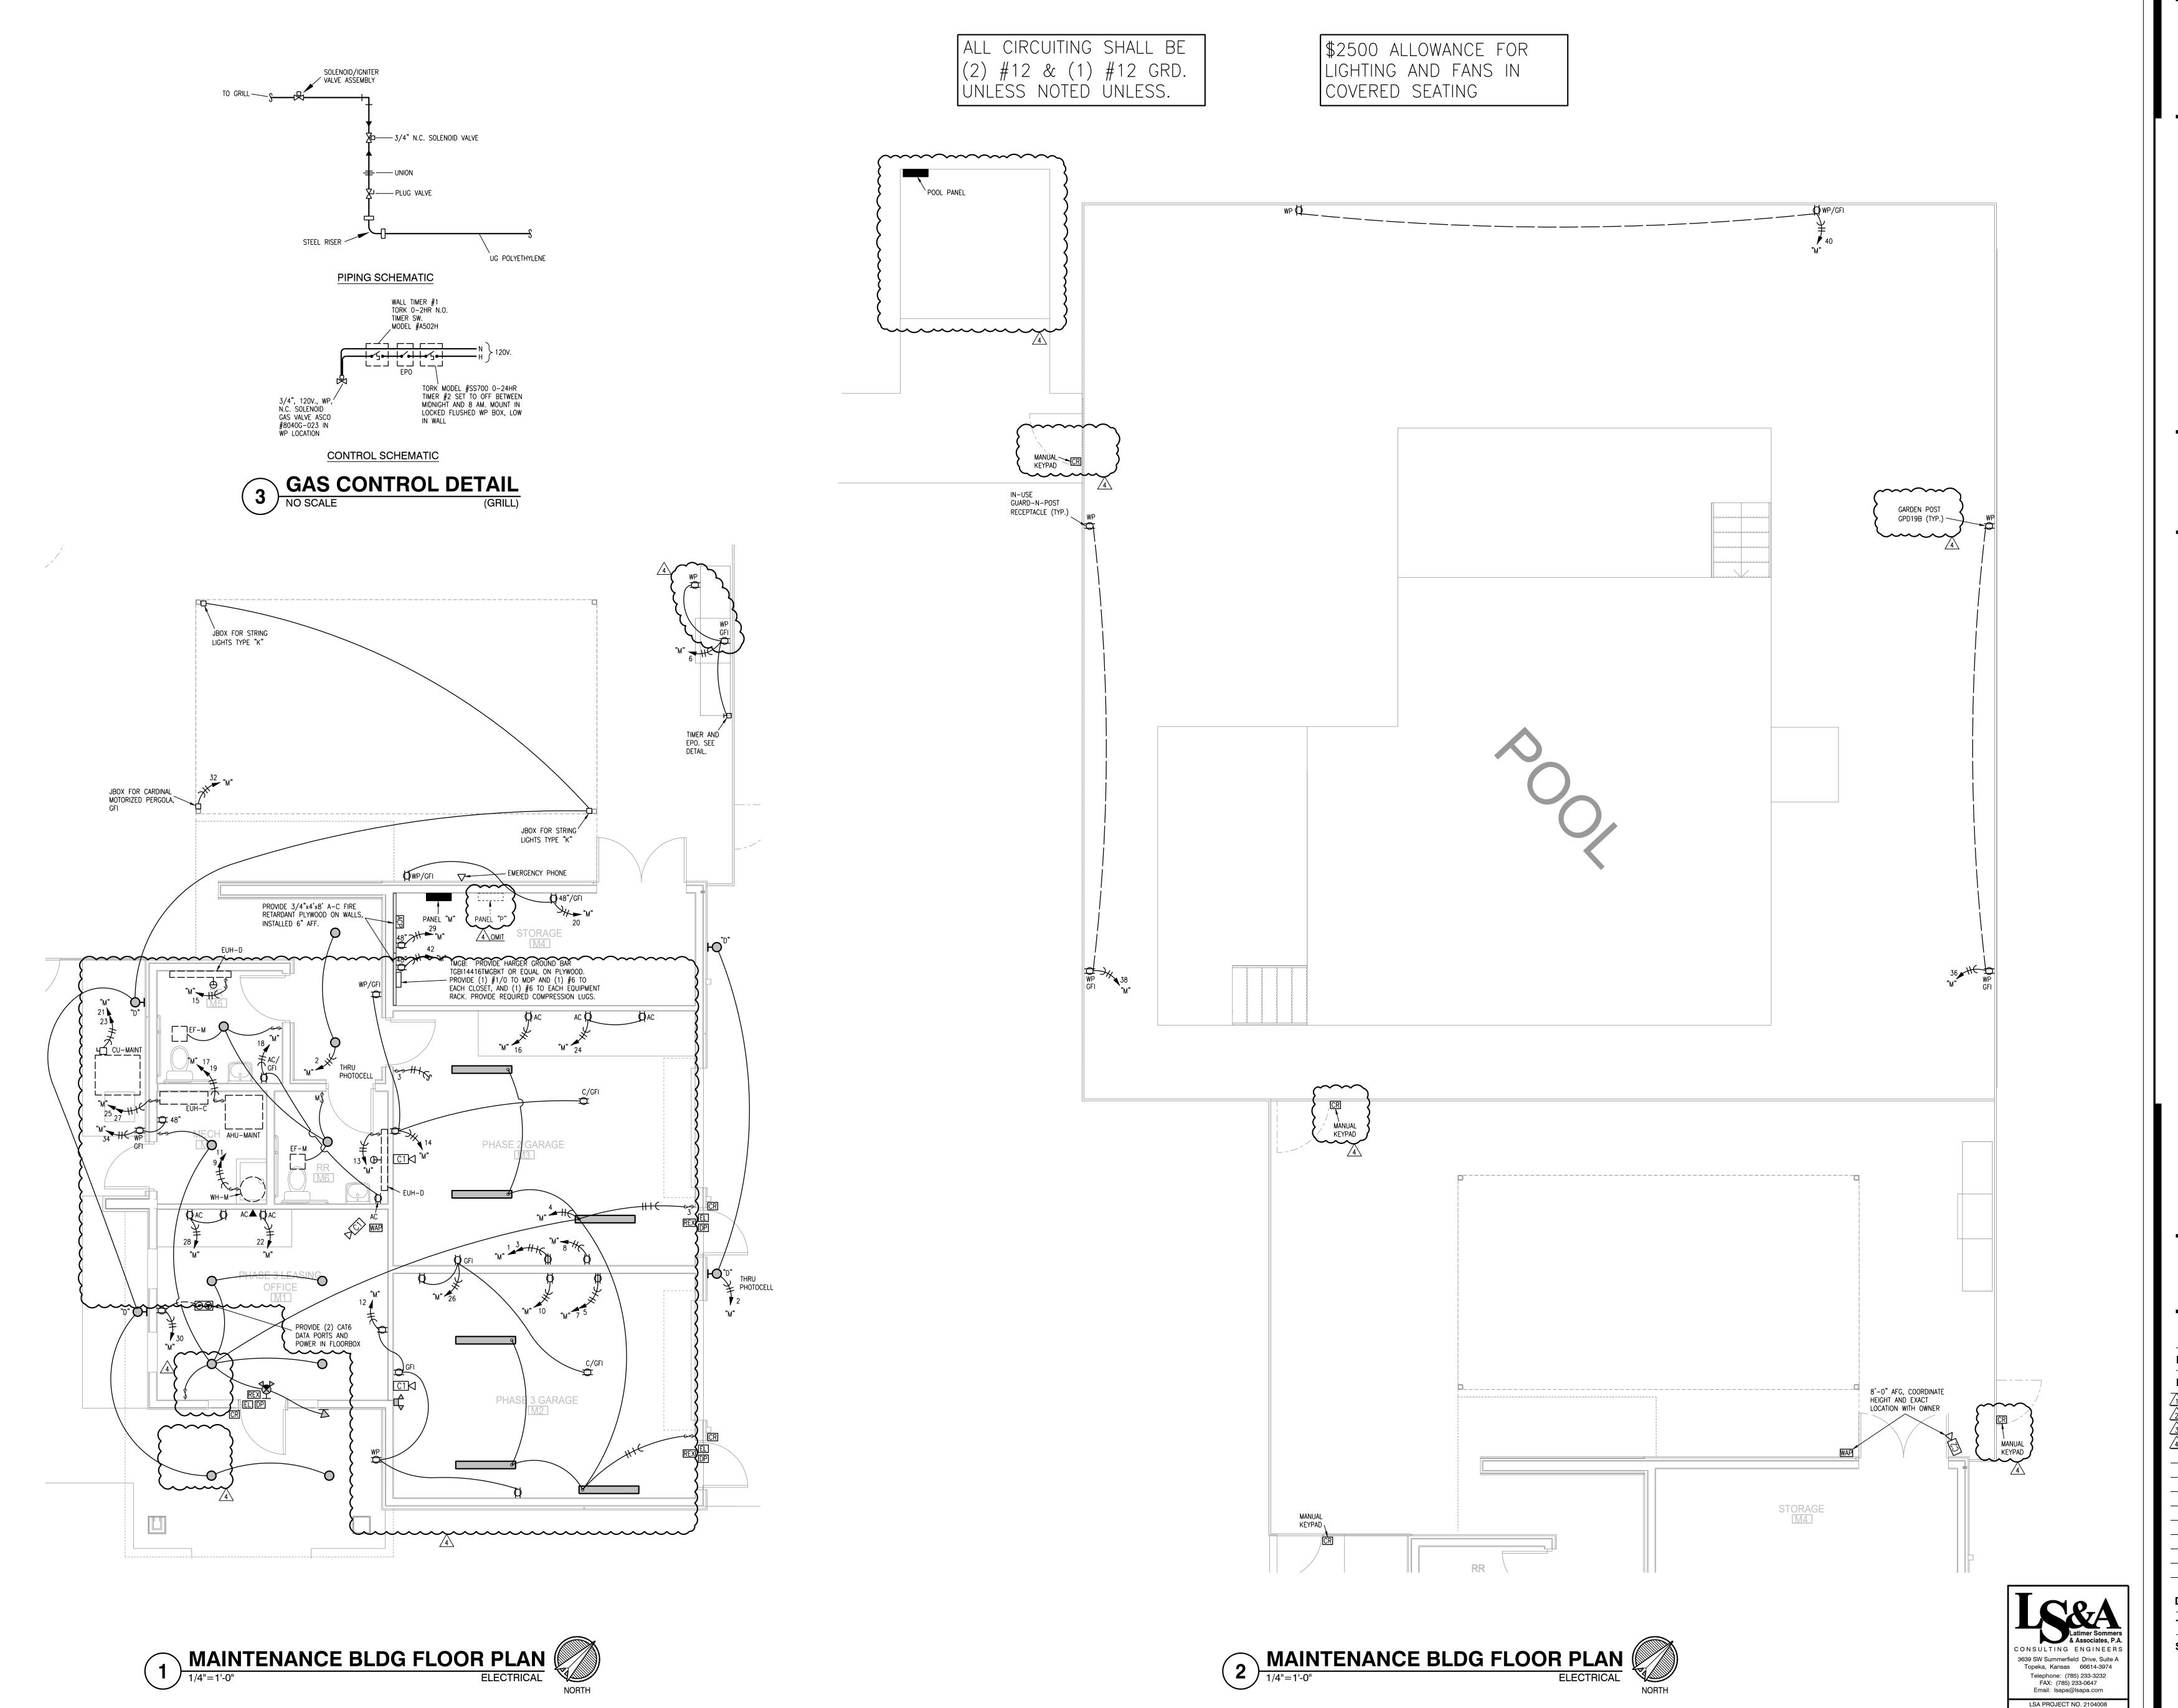
3 ROUTE COND. TO LAV TAILPIECE OR WASHER BOX.

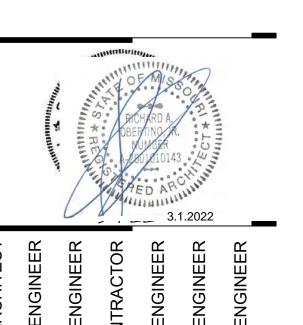
4 16x8 TYPE 'E' GRILLES, ONE HIGH, ONE LOW FOR RA PATH IN STUD SPACE. LINE SPACE WITH METAL.

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MAINTENANCE BLDG ELECTRICAL