



# PELLA

BUILDING SYSTEMS

906 West 9th Street Pella, IA 50219  
(800) 225-0481 www.pellabuildings.com

### BUILDING LOADS / DESCRIPTION:

WIDTH: 60 LENGTH: 83.5 HEIGHT: 15.88 / 15.88  
(BUILDING DIMENSIONS ARE NOMINAL. REFER TO PLANS).

SITE CLASS: \_\_\_\_\_

THIS STRUCTURE IS DESIGNED UTILIZING THE LOADS INDICATED AND APPLIED AS REQUIRED BY : IBC 18

OCCUPANCY CATEGORY: \_\_\_\_\_

SEISMIC DESIGN CATEGORY: \_\_\_\_\_

THE CONTRACTOR IS TO CONFIRM THAT THESE LOADS COMPLY WITH THE REQUIREMENTS OF THE LOCAL BUILDING DEPARTMENT.

ROOF DEAD LOAD: 2.000 PSF (ROOF PANELS & PURLINS)

COLLATERAL LOAD: 0.5 PSF SNOW EXPOSURE: \_\_\_\_\_

ROOF LIVE LOAD: 20.00 PSF WIND EXPOSURE: C

ROOF SNOW LOAD: 14 PSF INTERNAL PRESSURE COEFF.: \_\_\_\_\_

GROUND SNOW LOAD: \_\_\_\_\_ PSF \_\_\_\_\_ / \_\_\_\_\_

BASIC WIND SPEED: 110 MPH SPECTRAL RESPONSE COEFF. \_\_\_\_\_

MAPPED SPECTRAL RESPONSE ACC. \_\_\_\_\_

SEISMIC ZONE: B Sds \_\_\_\_\_

Ss \_\_\_\_\_

THERMAL FACTOR: \_\_\_\_\_ Sd1 \_\_\_\_\_

St \_\_\_\_\_

IMPORTANCE FACTORS: DESIGN BASE SHEAR, V: \_\_\_\_\_

WIND LOAD	_____	1.00	EXPANDED FORMULA	_____
SNOW LOAD	_____	_____	LONGITUDINAL	1.00
SEISMIC LOAD	_____	1.00	TRANSVERSE	0.98

### GENERAL NOTES:

1) MATERIALS : MINIMUM YIELD:

HOT ROLLED BAR	Fy =	ksi MIN.
STRUCTURAL STEEL SHEET	Fy =	ksi MIN.
STRUCTURAL STEEL PLATE	Fy =	ksi MIN.
COLD FORMED SHAPES	Fy =	ksi MIN.
WALL SHEETING	Fy =	ksi MIN.
ROOF SHEETING	Fy =	ksi MIN.
BOLTS	A307 & A325	

THE METAL BUILDING MANUFACTURER RESERVES THE RIGHT TO SUBSTITUTE THE ABOVE MATERIALS WITH EQUAL OR BETTER MATERIAL.

### 2) BOLT TIGHTENING REQUIREMENTS:

ALL HIGH STRENGTH BOLTS ARE A325 UNLESS NOTED OTHERWISE. HIGH STRENGTH BOLTS SHALL BE TIGHTENED BY THE TURN OF THE NUT METHOD IN ACCORDANCE WITH THE LATEST EDITION AISC "SPECIFICATION FOR STRUCTURAL JOINTS USING ASTM A325 OR A490 BOLTS". A325 BOLTS SHALL BE INSTALLED WITH OUT WASHERS WHEN TIGHTENED BY THE "TURN OF THE NUT" METHOD. ALL BOLTED CONNECTIONS, FOR SHEAR/BEARING CONNECTION TYPE WITH BOLT THREADS EXCLUDED FROM THE SHEAR PLANE SHALL BE SNUG TIGHT ONLY.

3) ALL STRUCTURAL STEEL TO RECEIVE A RUST INHIBITIVE PRIMER. THIS PAINT IS NOT INTENDED FOR LONG TERM EXPOSURE TO THE ELEMENTS.

### ROOF PANELS:

COLOR: \_\_\_\_\_ Galvalume+ w/ Drip Stop

### WALL PANELS:

COLOR: \_\_\_\_\_ NEED SIG 200

### TRIM COLORS:

CABLE: \_\_\_\_\_ NEED SIG 200

CORNER: \_\_\_\_\_ NEED SIG 200

EAVE: \_\_\_\_\_ NEED SIG 200

FRAMED OPENINGS: \_\_\_\_\_ NEED SIG 200

### LINER PANELS:

COLOR: \_\_\_\_\_ N/A

### LINER TRIM:

COLOR: \_\_\_\_\_ N/A

### DEFLECTION LIMTS:

EW COL:	180
EW RAF LIVE:	180
EW RAF WIND:	180
WALL GIRT:	90
PURL LIVE:	180
PURL WIND:	150
WALL PANEL:	60
ROOF PANEL LIVE:	60
ROOF PANEL WIND:	60
RF HORIZONTAL:	180
RF VERTICAL:	60
WIND BENT:	60
RF CRANE:	0
RF SEIS:	0
WIND BENT SEIS:	0

### APPROVAL NOTES

THE FOLLOWING CONDITIONS APPLY IN THE EVENT THAT THESE DRAWINGS ARE USED AS APPROVAL DRAWINGS: IT IS IMPERATIVE THAT ANY CHANGES TO THESE DRAWINGS BE MADE IN CONTRASTING INK (PREFERABLY RED INK), HAVE ALL INSTANCES OF CHANGE CLEARLY INDICATED, AND BE LEGIBLE AND UNAMBIGUOUS. A SIGNATURE AND DATE IS REQUIRED ON ALL PAGES. MANUFACTURER RESERVES THE RIGHT TO RE-SUBMIT DRAWINGS WITH EXTENSIVE OR COMPLEX CHANGES REQUIRED TO AVOID MISFABRICATION. THIS MAY IMPACT THE DELIVERY SCHEDULE. APPROVAL OF THESE DRAWINGS INDICATES CONCLUSIVELY THAT THE METAL BUILDING SYSTEM MANUFACTURER HAS CORRECTLY INTERPRETED THE CONTRACT REQUIREMENTS, AND FURTHER CONSTITUTES AGREEMENT THAT THE BUILDING AS DRAWN WITH INDICATED CHANGES REPRESENTS THE TOTAL OF THE MATERIALS TO BE SUPPLIED BY MANUFACTURER. ANY CHANGES NOTED ON THE DRAWINGS NOT IN COMFORMANCE WITH THE TERMS AND REQUIREMENTS OF THE CONTRACT BETWEEN MANUFACTURER AND ITS CUSTOMER ARE NOT BINDING ON MANUFACTURER UNLESS SUBSEQUENTLY SPECIFICALLY ACKNOWLEDGED AND AGREED TO IN WRITING BY CHANGE ORDER OR SEPARATE DOCUMENTATION. MANUFACTURER RECONGNIZES THAT RUBBER STAMPS ARE ROUTINELY USED FOR INDICATING APPROVAL, DISAPPROVAL, REJECTION, OR MERE REVIEW OF THE DRAWINGS SUBMITTED. HOWEVER, MANUFACTURER DOES NOT ACCEPT CHANGES OR ADDITIONS TO CONTRACTUAL TERMS AND CONDITIONS THAT MAY APPEAR WITH USE OF A STAMP OR SIMILIAR INDICATIOIN OF APPROVAL, DISAPPROVAL, ETC. SUCH LANGUAGE APPLIED TO MANUFACTURER'S DRAWINGS BY THE CUSTOMER, ARCHITECT, ENGINEER, OR ANY OTHER PARTY WILL BE CONSIDERED AS UNACCEPTABLE ALTERNATIONS TO THESE DRAWING NOTES, AND WILL NOT ALTER THE CONTRACTUAL RIGHTS AND OBLIGATIONS EXISTING BETWEEN MANUFACTURER AND ITS CUSTOMER.

**IMPORTANT NOTE: FINAL DETAILING, FABRICATION, AND DELIVERY DATE OF THIS PROJECT CANNOT BE COMPLETED UNTIL THE SIGNED APPROVALS ARE RETURNED TO THE METAL BUILDING MANUFACTURER.**

△		
△		
△		
△		
△	..J..	FOR CONSTRUCTION
△	..J..	FOR APPROVAL
REV.	DATE	REVISION

PURCHASER: DLR

PROJECT: MEGA STORAGE LEES SUMMIT


JOB NUMBER: MEGASTORAGELEESUMMIT#8#13#14#15

**DOOR SCHEDULE**

ID	QUAN	DESCRIPTION	COLOR
1	6	Janus 1214 M1950 Rollup	Silhouette Gray
2	6	Janus 1214 M1950 Rollup	WHITE

**COMPARTMENT TABLE**


ID	QUAN	WIDTH	LENGTH
1	12	13'-11"	30'-0"

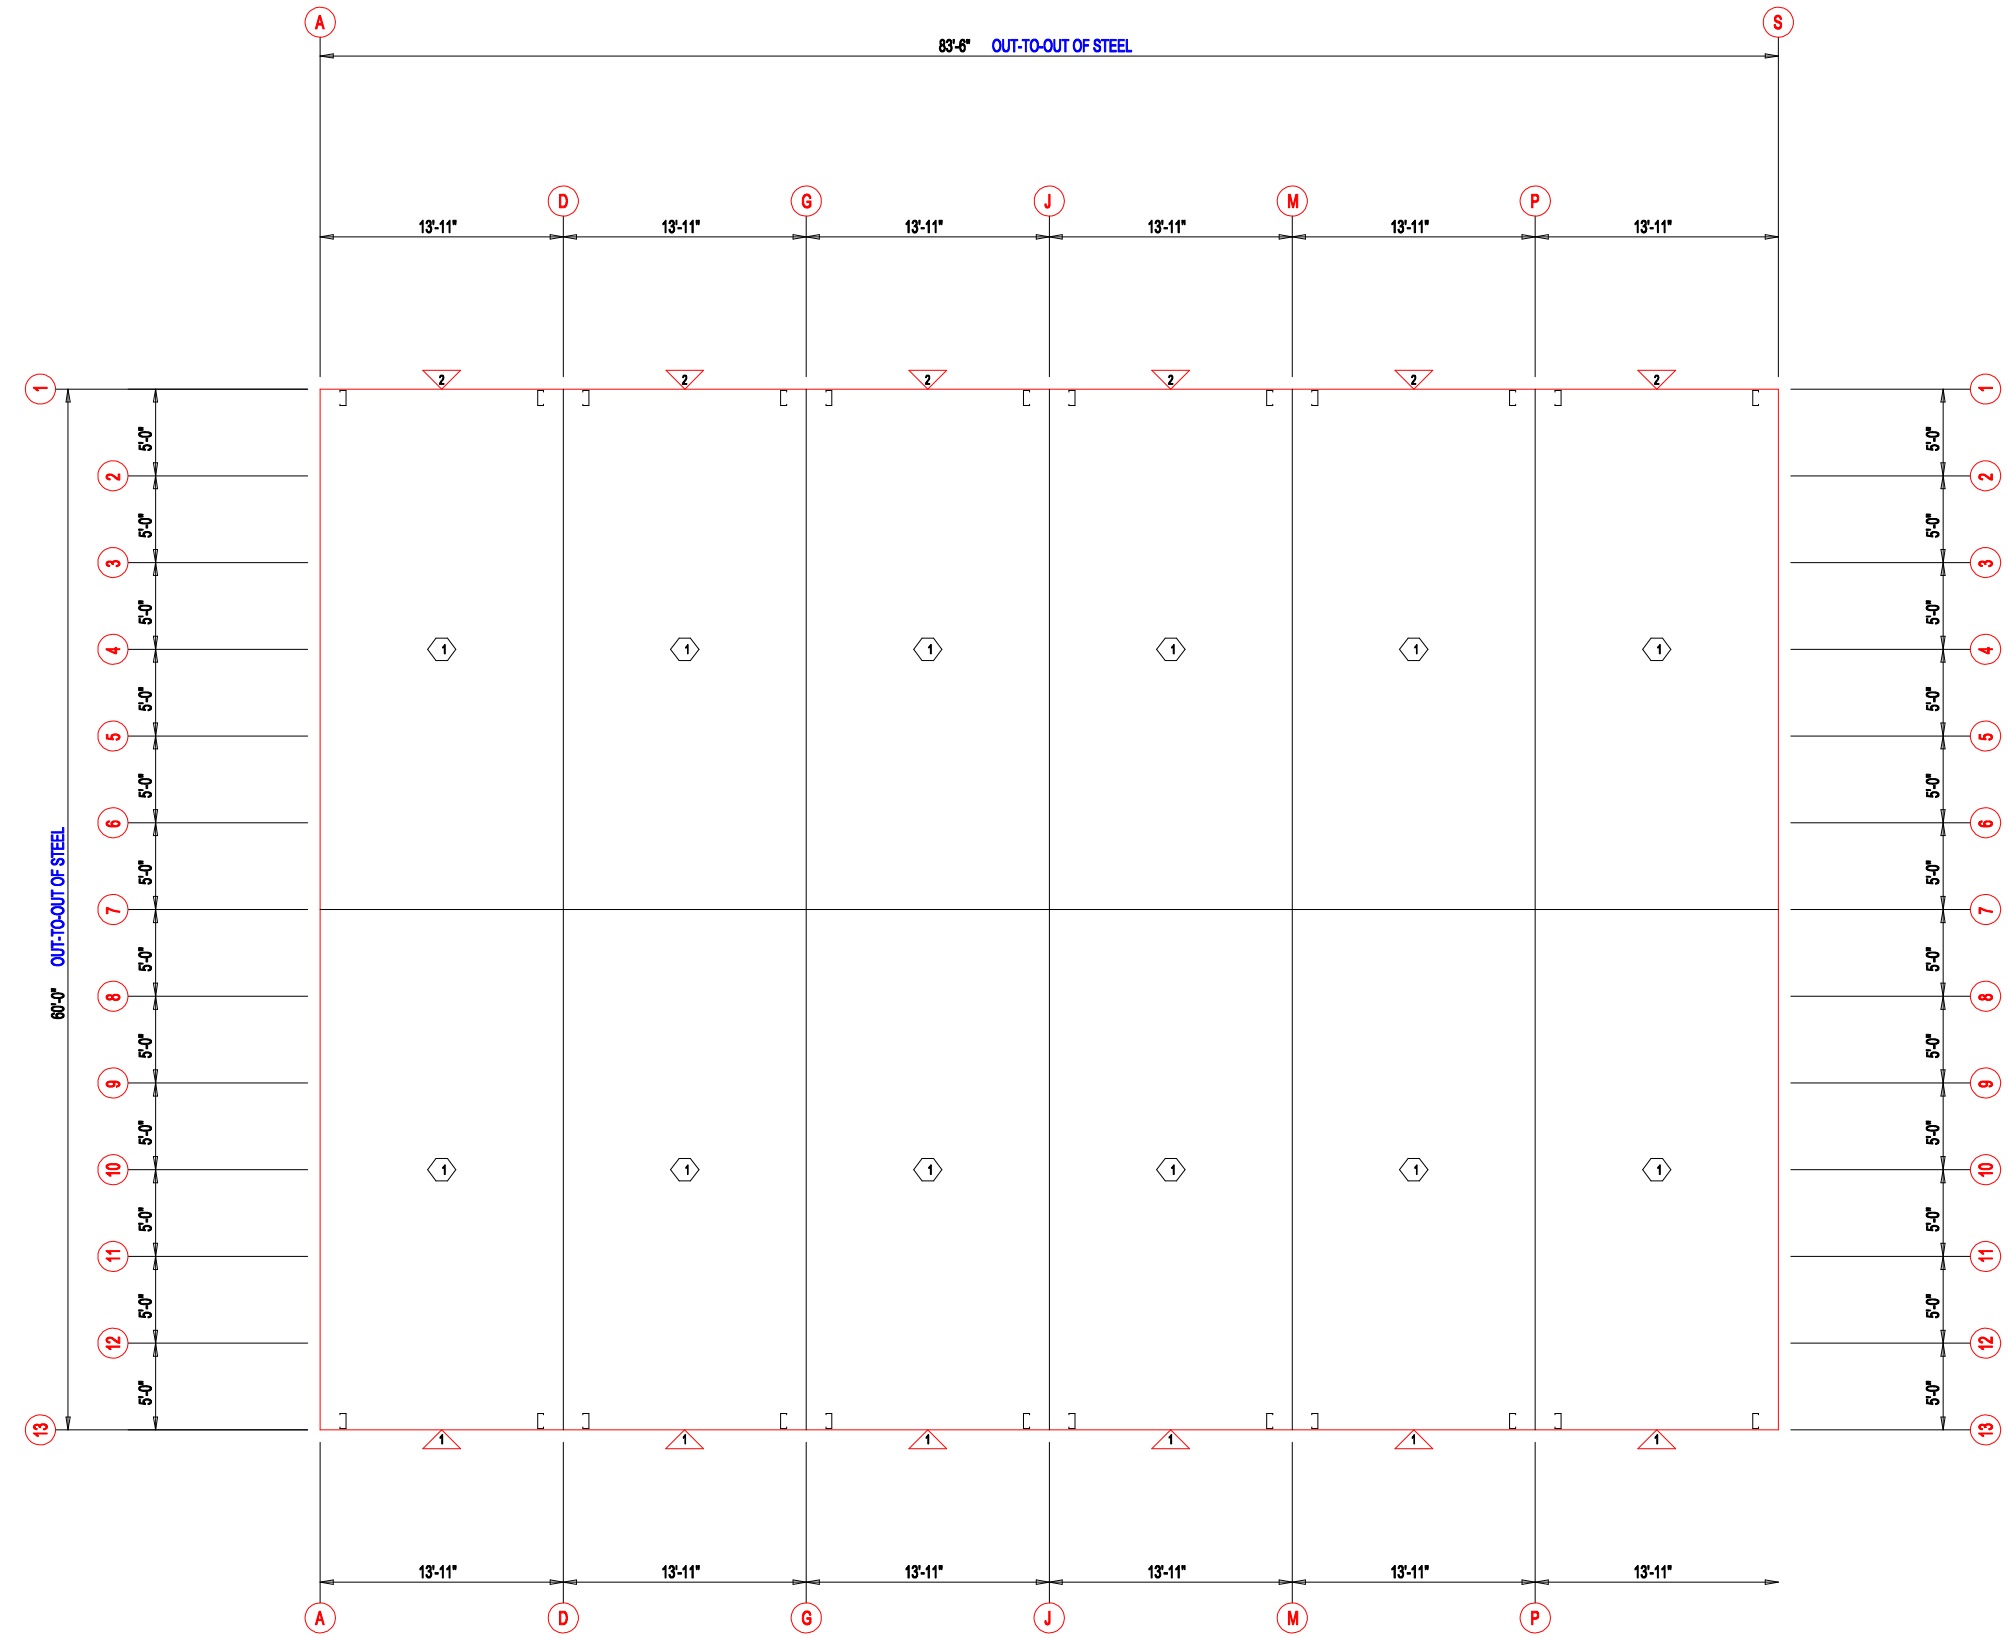

**FLOOR PLAN**



DESCRIPTION: FLOOR PLAN		PROJECT: MEGA STORAGE LEES SUMMIT	
CUSTOMER: DLR		LOCATION: LEE'S SUMMIT	
DRN. BY: JB	CK'D BY: DES	DATE: 1/17/22	SCALE: N.T.S.
REV: 00	QUOTATION NO. MEGASTORAGELEESUMMIT#824#14#15	SHEET NO. 14#15	

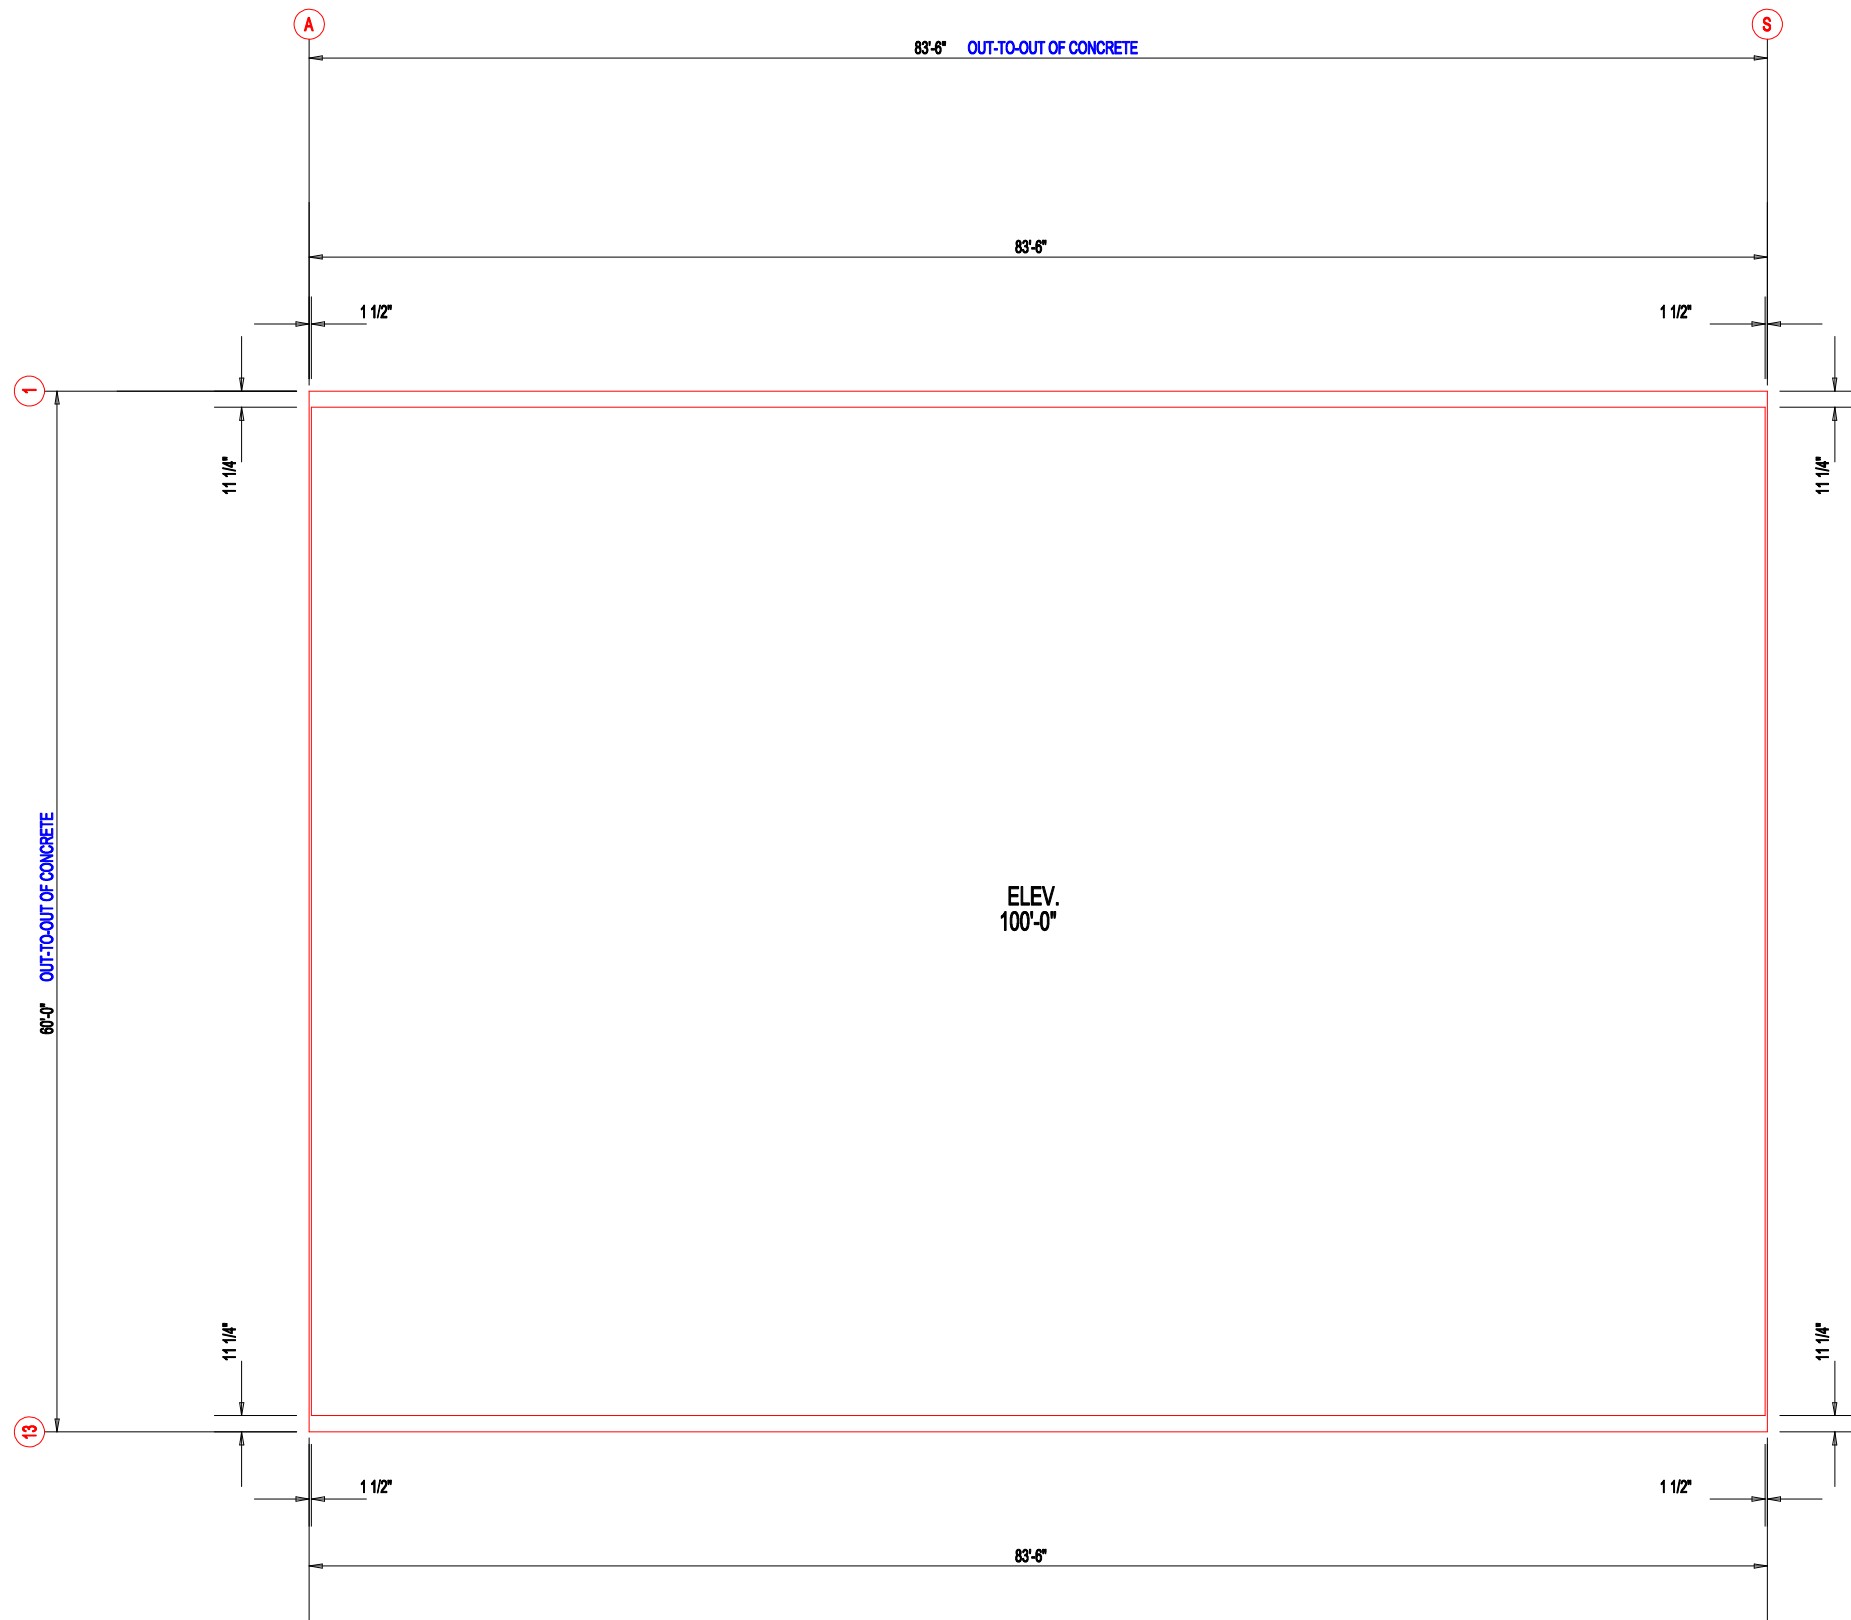


ANCHOR PLAN



DESCRIPTION: ANCHOR PLAN						
CUSTOMER: DLR				PROJECT: MEGA STORAGE LEES SUMMIT		
LOCATION: LEE'S SUMMIT						
DRN. BY JB	CK'D BY DES	DATE 1/17/22	SCALE N.T.S.	REV. 00	QUOTATION NO. MEGASTORAGELEESUMMIT#824#14#15	SHEET NO. #24#14#15


MEMBER TABLE		
MARK	PART	LENGTH
S-1	6X2C16	16'-0"
S-2	6X2C16	16'-1"
S-3	6X2C16	16'-3 1/2"
S-4	6X2C16	16'-6"
S-5	6X2C16	16'-8 1/2"
S-6	6X2C16	16'-11"
S-7	6X2C16	17'-1 1/2"

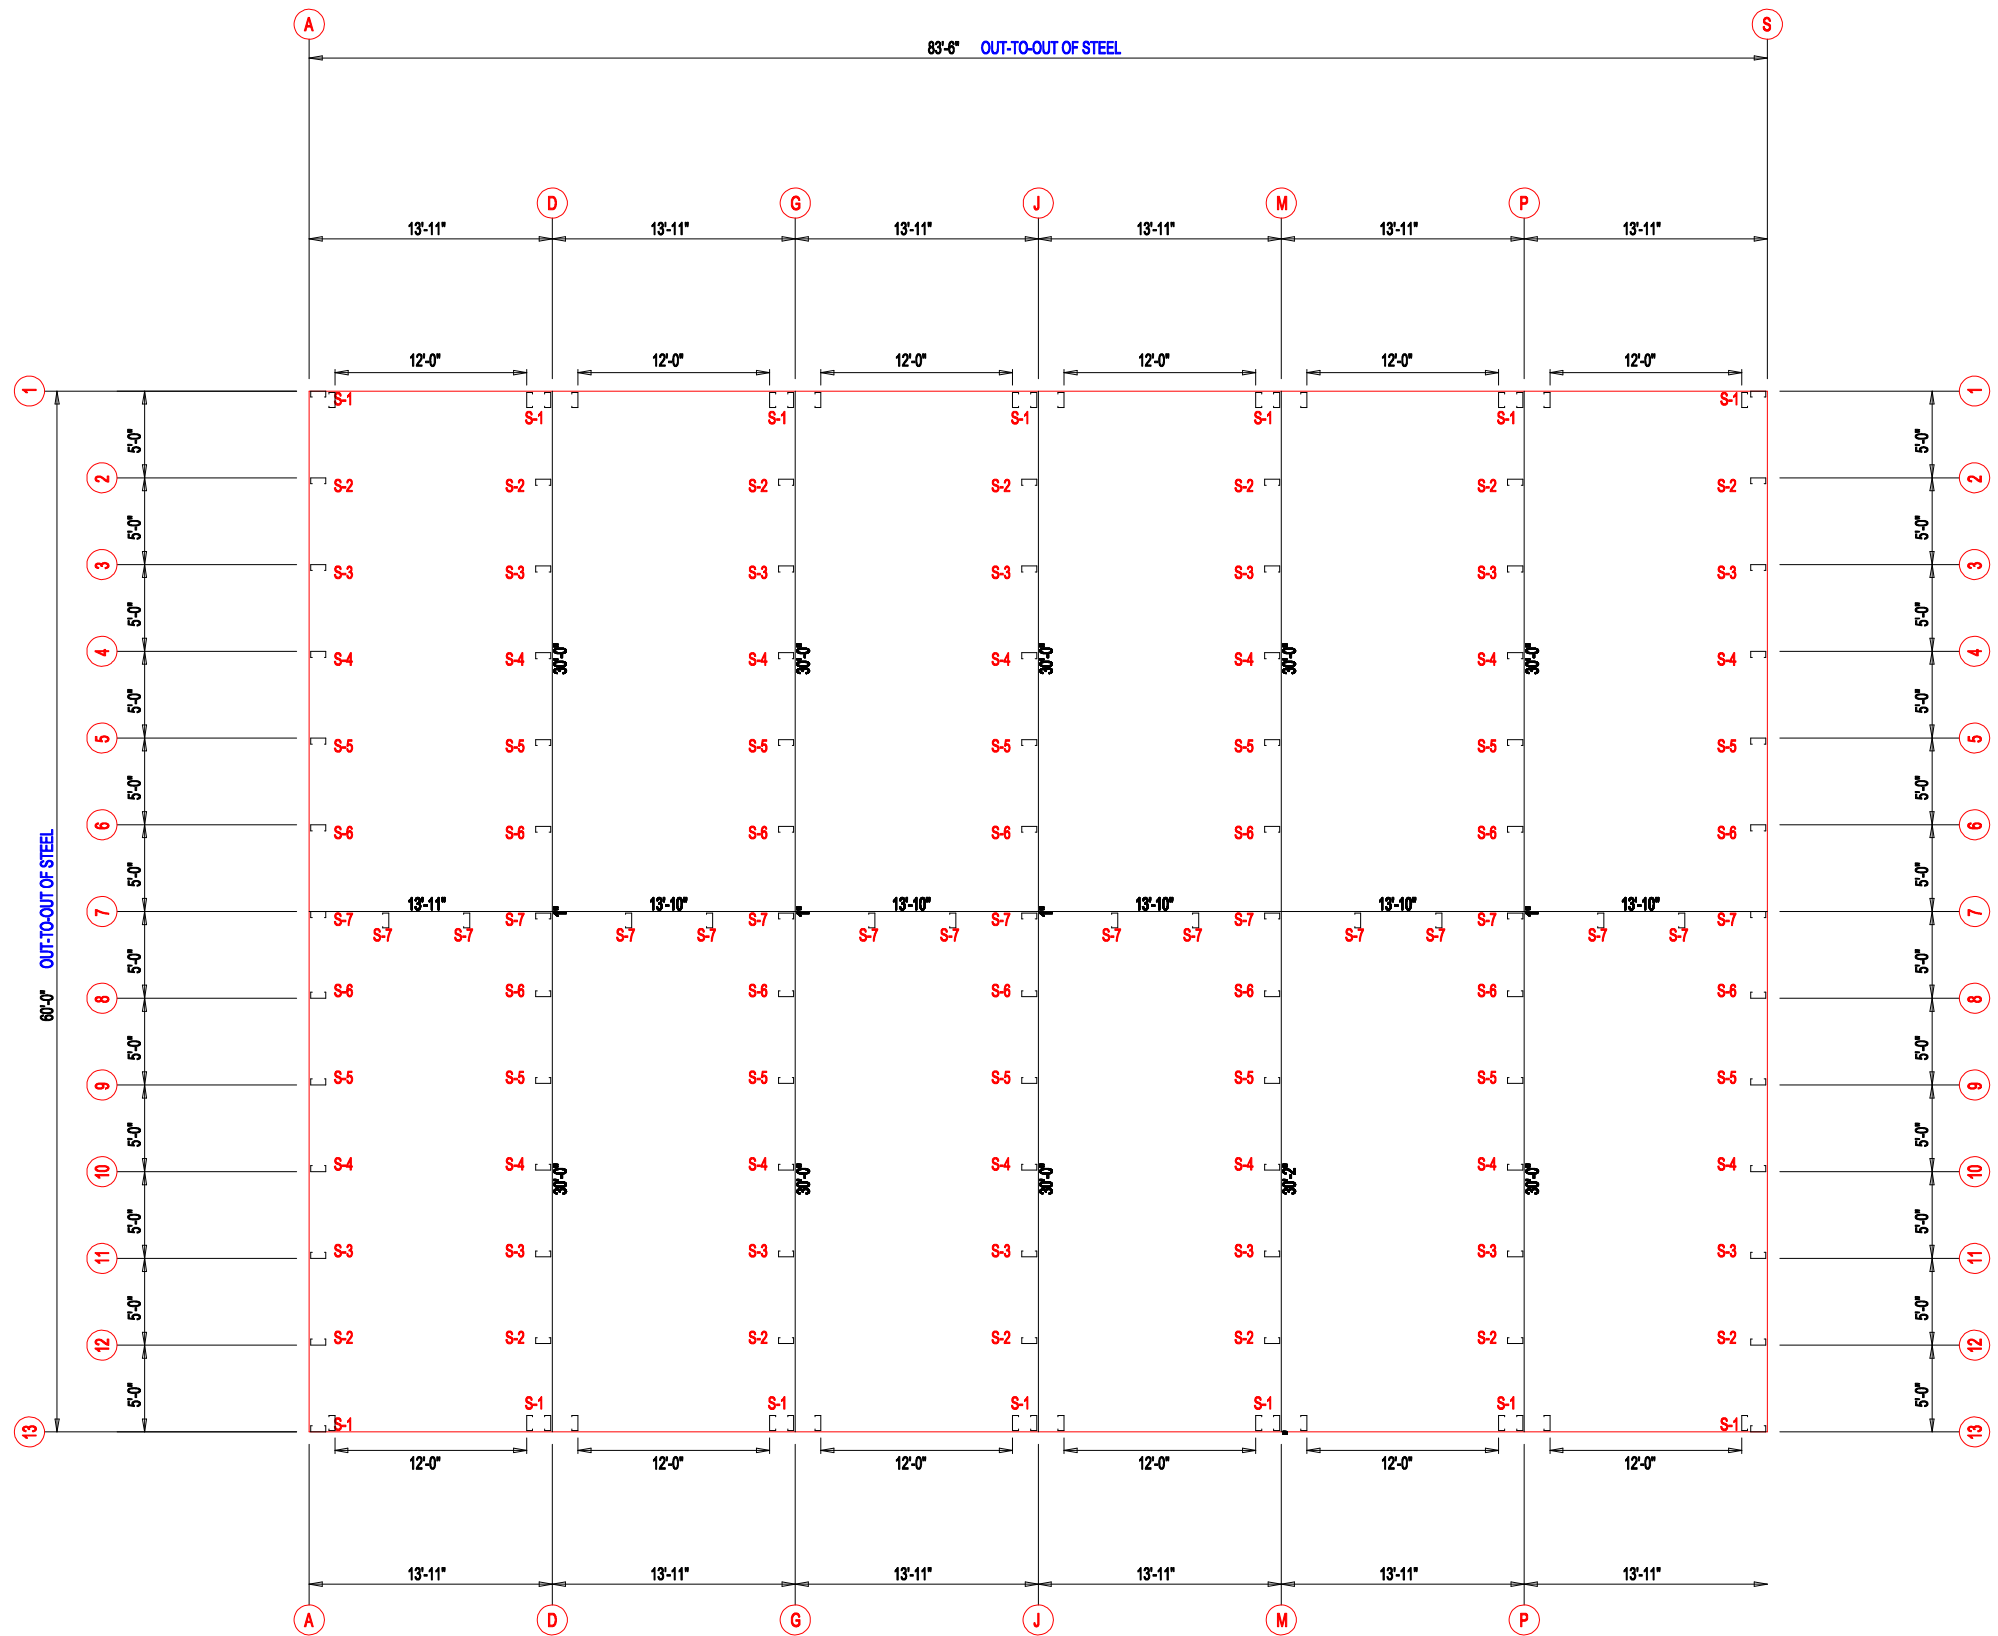


FLOOR PLAN



DESCRIPTION:		FLOOR PLAN	
CUSTOMER:		DLR	PROJECT: MEGA STORAGE LEES SUMMIT
LOCATION: LEE'S SUMMIT			
DRN. BY	CK'D BY	DATE	SCALE
JB	DES	1/17/22	N.T.S.
REV.	00	QUOTATION NO.	SHEET NO.
		MEGASTORAGELEESUMMIT#824#14#15	

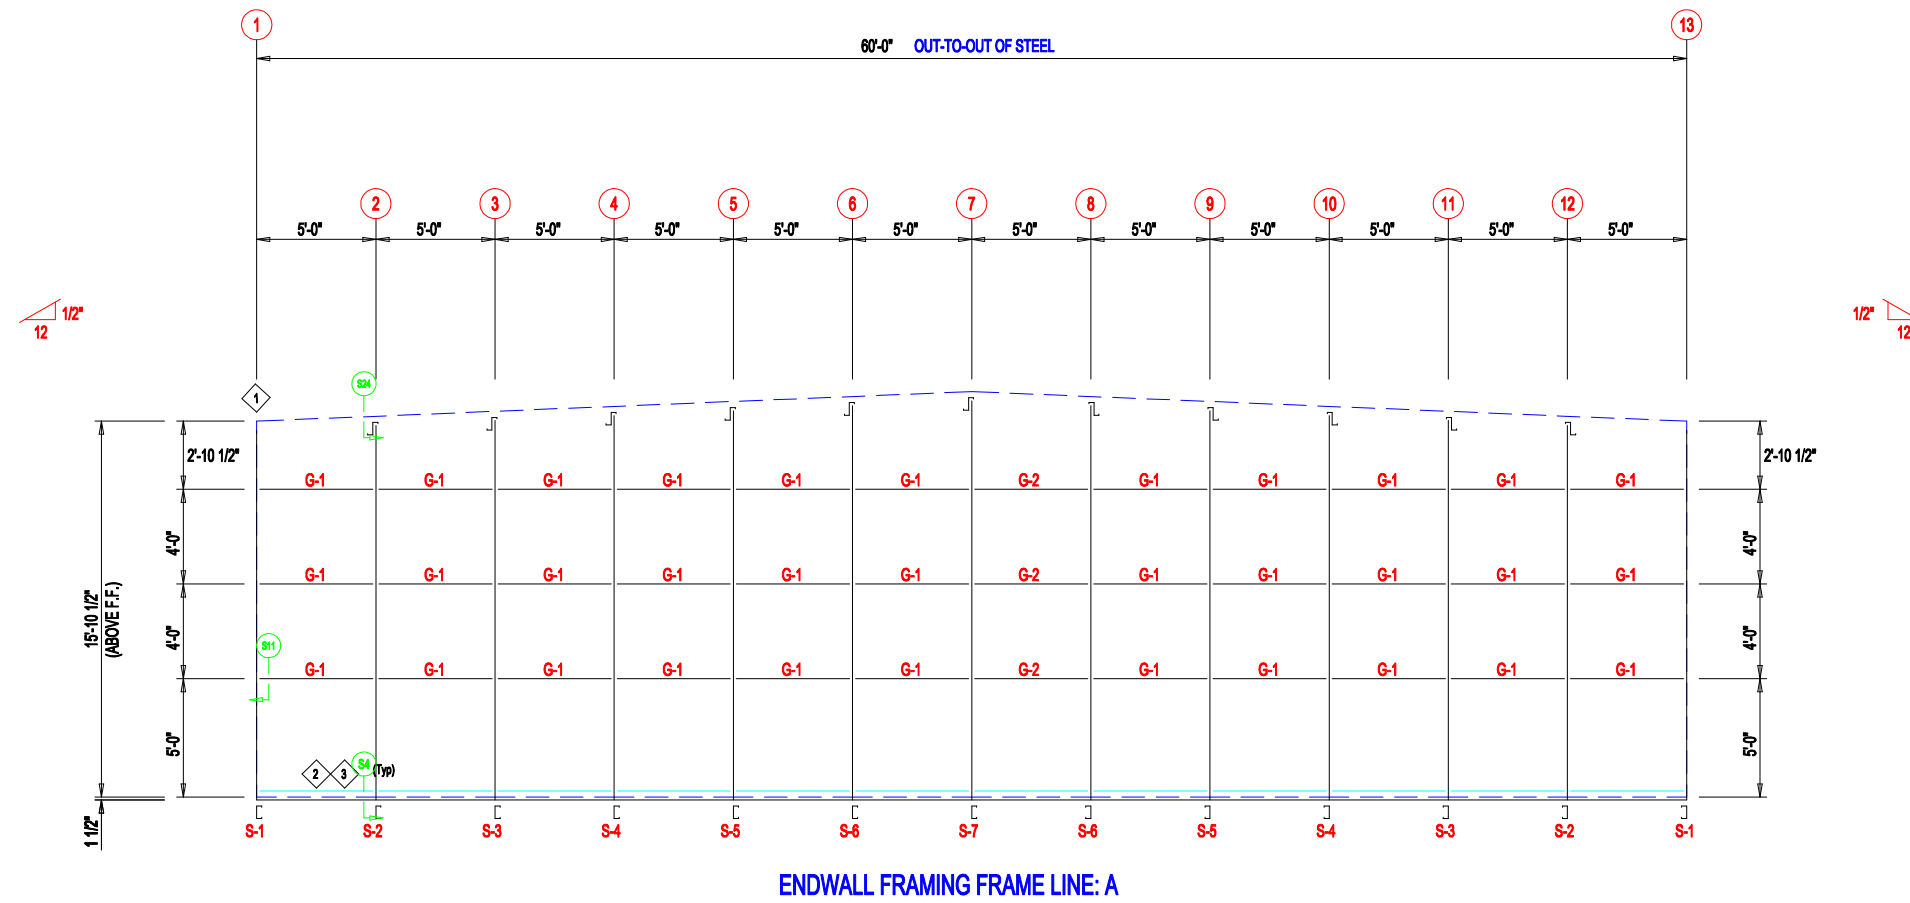

ENDWALL FRAMING FRAME LINE: A

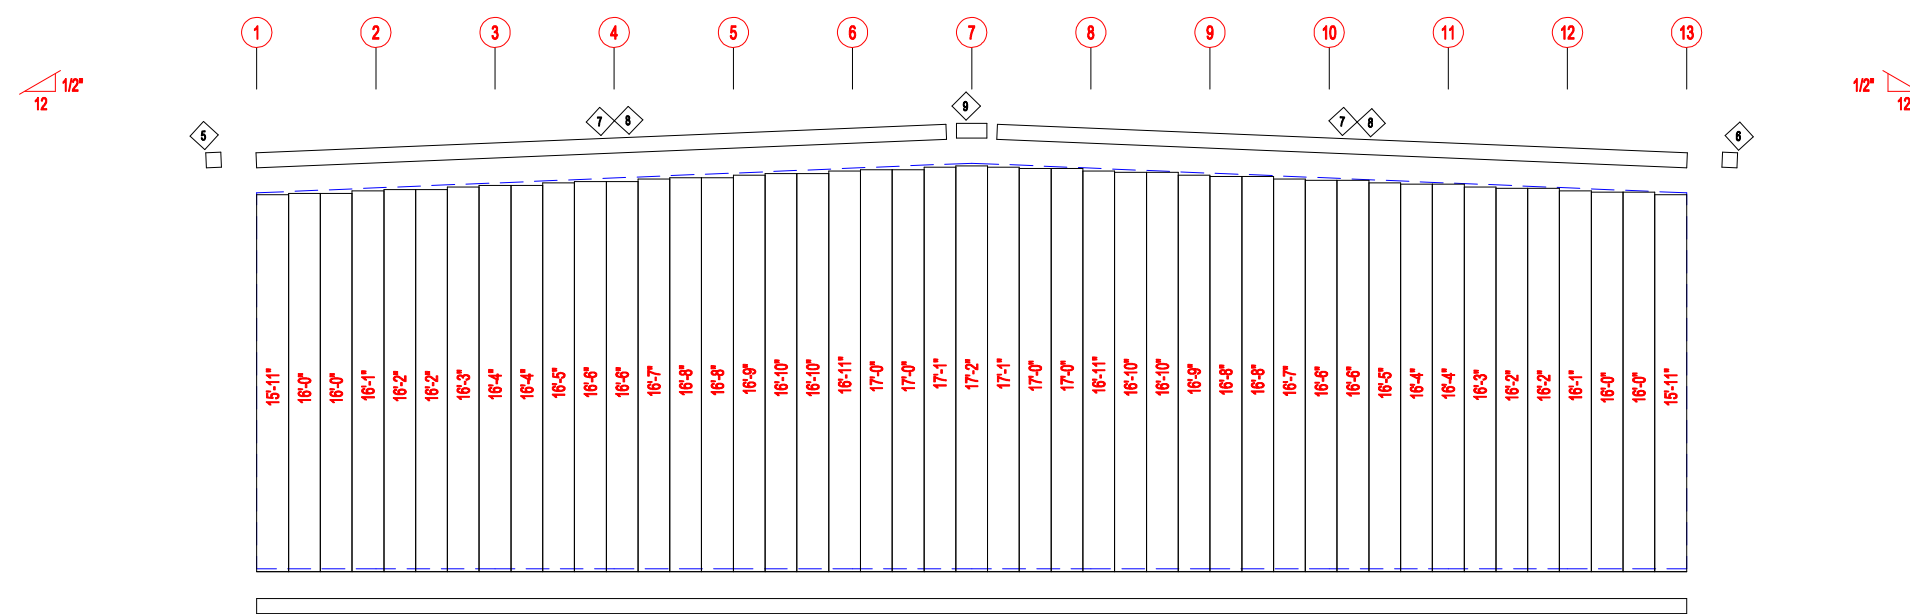

ENDWALL SHEETING & TRIM FRAME LINE: A  
PANELS: 20 Ga. CP - NEED SIG 200

ID	PART	LENGTH	DETAIL
4	FL72	10'-2"	TRIM_74
5	FL16A	6"	
6	FL16A	6"	
7	FL16	10'-2"	TRIM_229
8	FL16D	20'-2"	TRIM_229
9	FL16B	1'-4"	


MARK	PART	LENGTH
S-1	6X2C16	16'-0"
S-2	6X2C16	16'-1"
S-3	6X2C16	16'-3 1/2"
S-4	6X2C16	16'-6"
S-5	6X2C16	16'-8 1/2"
S-6	6X2C16	16'-11"
S-7	6X2C16	17'-1 1/2"
G-1	4X20C16	4'-9 1/2"
G-2	4X20C16	4'-7 1/2"

ID	MARK	LENGTH
1	L3x3	20'-0"
2	BC-6	20'-0"
3	BC-6	SCRAP




DESCRIPTION: ENDWALL DRAWING					
CUSTOMER: DLR			PROJECT: MEGA STORAGE LEES SUMMIT		
LOCATION: LEE'S SUMMIT					
DRN. BY: JB	CK'D BY: DES	DATE: 1/17/22	SCALE: N.T.S.	REV.: 00	QUOTATION NO. MEGASTORAGELEESUMMIT#824#14#15
					SHEET NO.



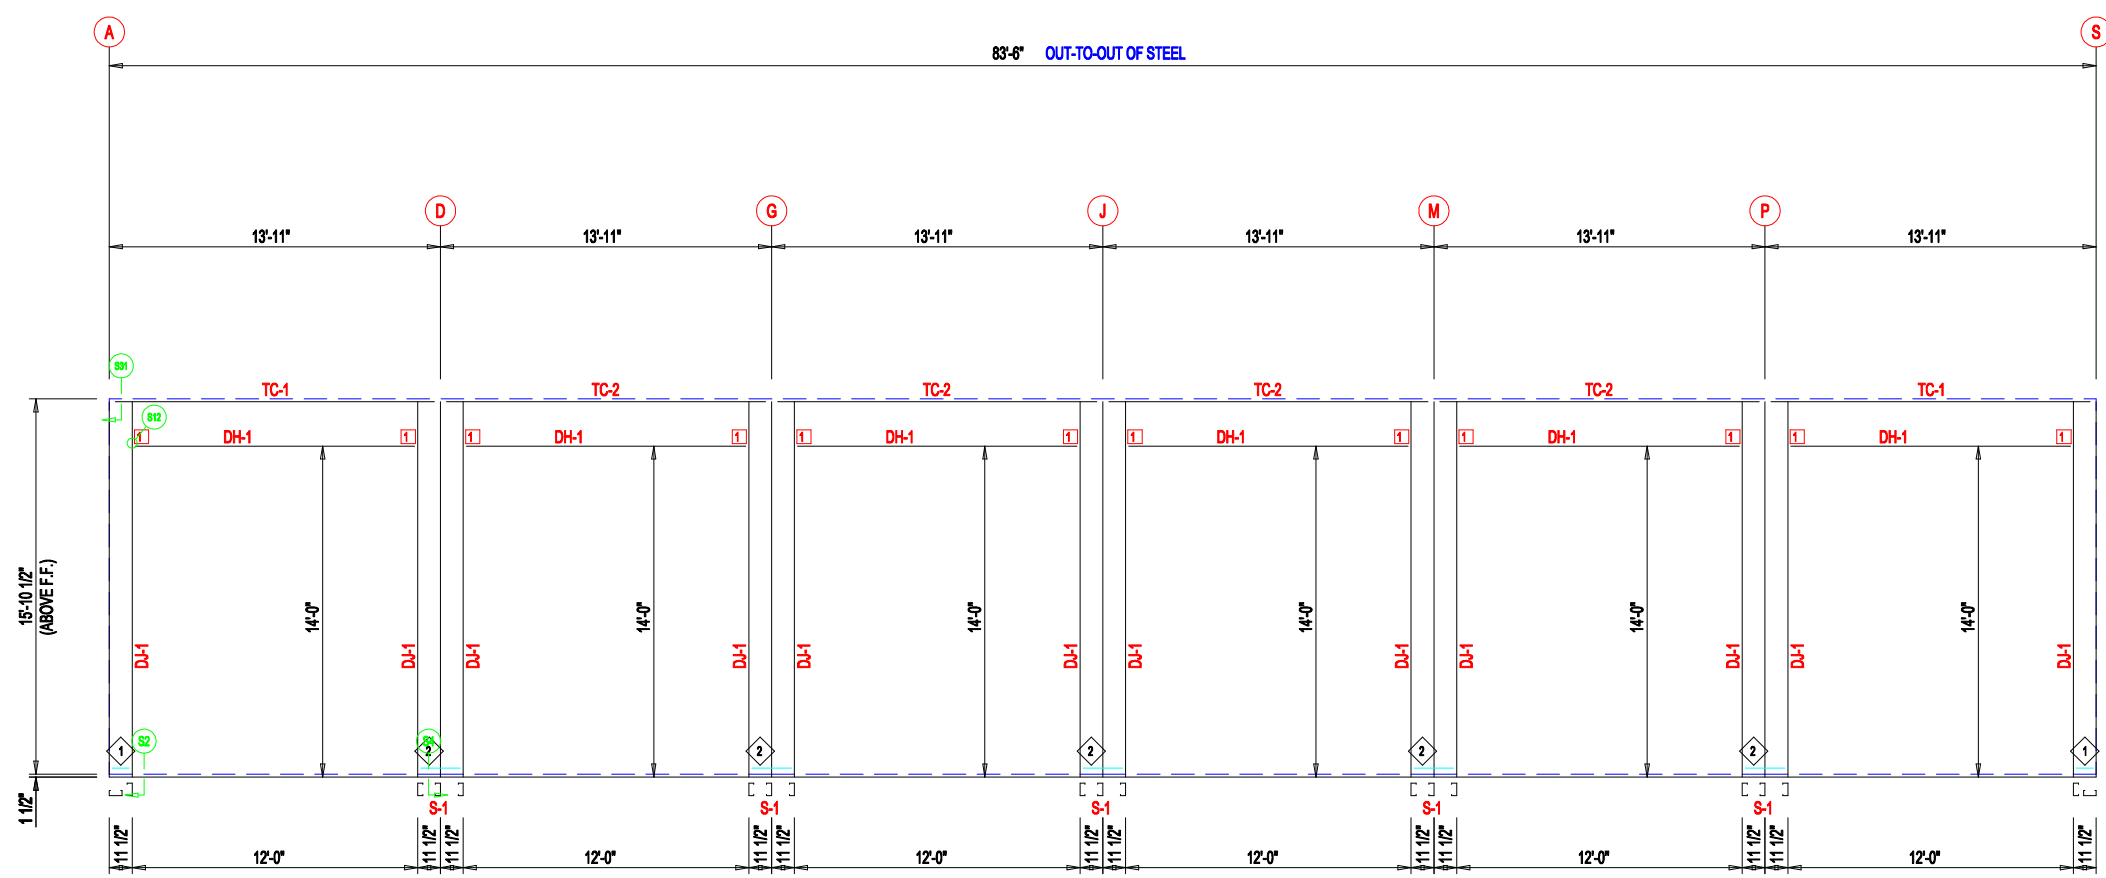

**SIDEWALL FRAMING FRAME LINE: 13**

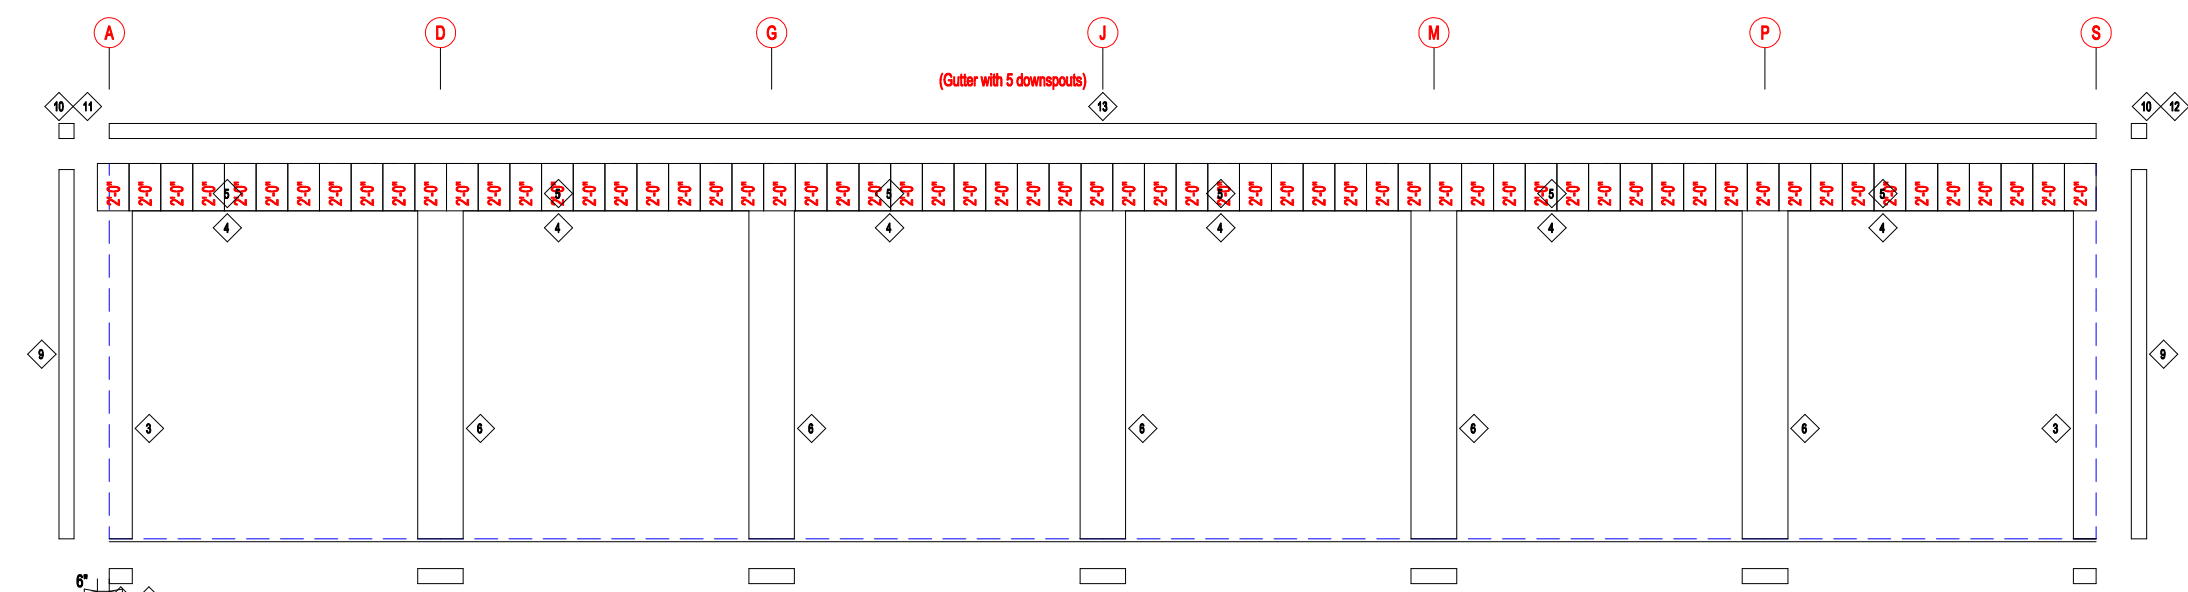

**SIDEWALL SHEETING & TRIM FRAME LINE: 13**

PANELS: 20 Ga. CP - NEED SIG 200

ID	PART	LENGTH	DETAIL
3	6MCE12	14'-1"	
4	FL-HC6	12'-1"	TRIM_235
5	FL26B	20'-2"	TRIM_232
6	6MC23	14'-1"	
7	FL72	10'-2"	TRIM_74
8	FL72	SCRAP	TRIM_74
9	FL835x	16'-0"	TRIM_198
10	FL16C	6"	
11	FL18A	6"	
12	FL18A	6"	
13	FL18D	20'-2"	


MARK	PART	LENGTH
S-1	6X2C16	16'-0"
DJ-1	6X40C14	16'-0"
TC-1	6X2CH16	13'-10 3/4"
TC-2	6X2CH16	13'-11"
DH-1	6X25C16	11'-11 1/2"

ID	MARK	LENGTH
1	MB611	10 3/4"
2	MB623	1'-10 3/4"


ID	MARK/PART
1	MCLP



DESCRIPTION: <b>SIDEWALL DRAWING</b>		PROJECT: <b>MEGA STORAGE LEES SUMMIT</b>	
CUSTOMER: <b>DLR</b>		LOCATION: <b>LEE'S SUMMIT</b>	
DRN. BY: <b>JB</b>	CK'D BY: <b>DES</b>	DATE: <b>1/17/22</b>	SCALE: <b>N.T.S.</b>
REV: <b>00</b>	QUOTATION NO.: <b>MEGASTORAGELEESUMMIT#824#14#15</b>	SHEET NO.: <b>13</b>	

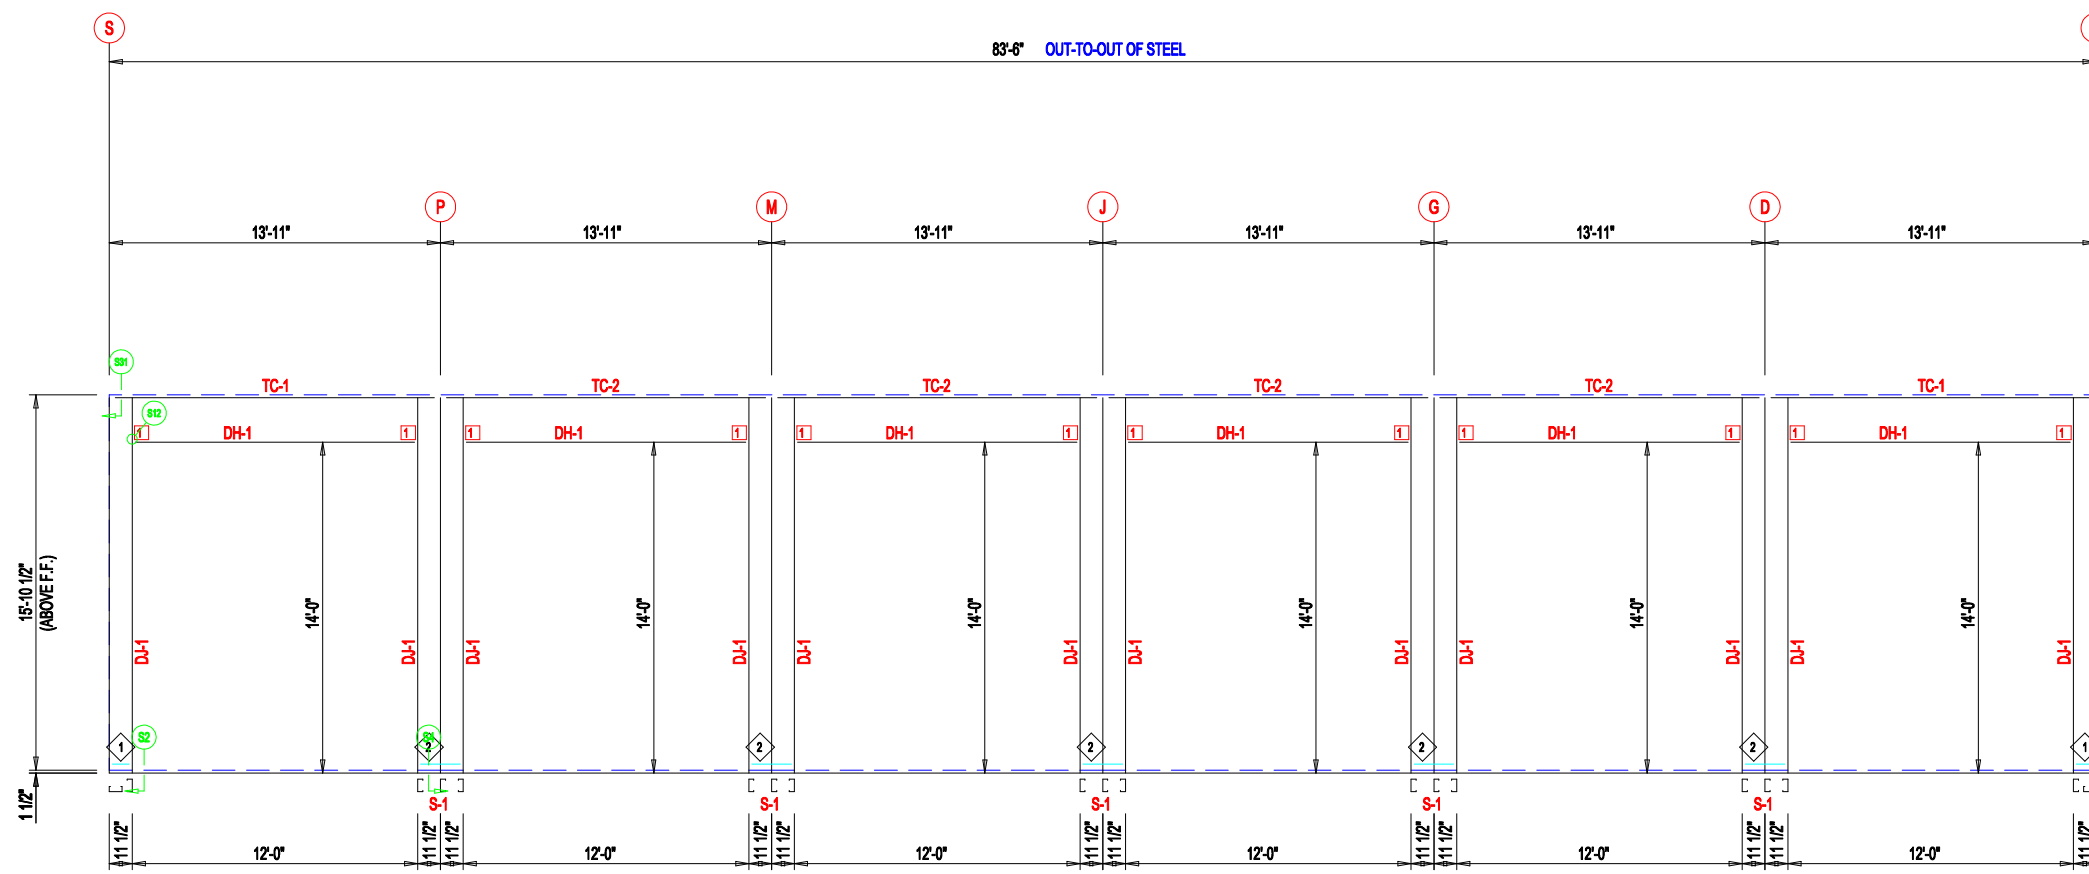

**SIDEWALL FRAMING FRAME LINE: 1**

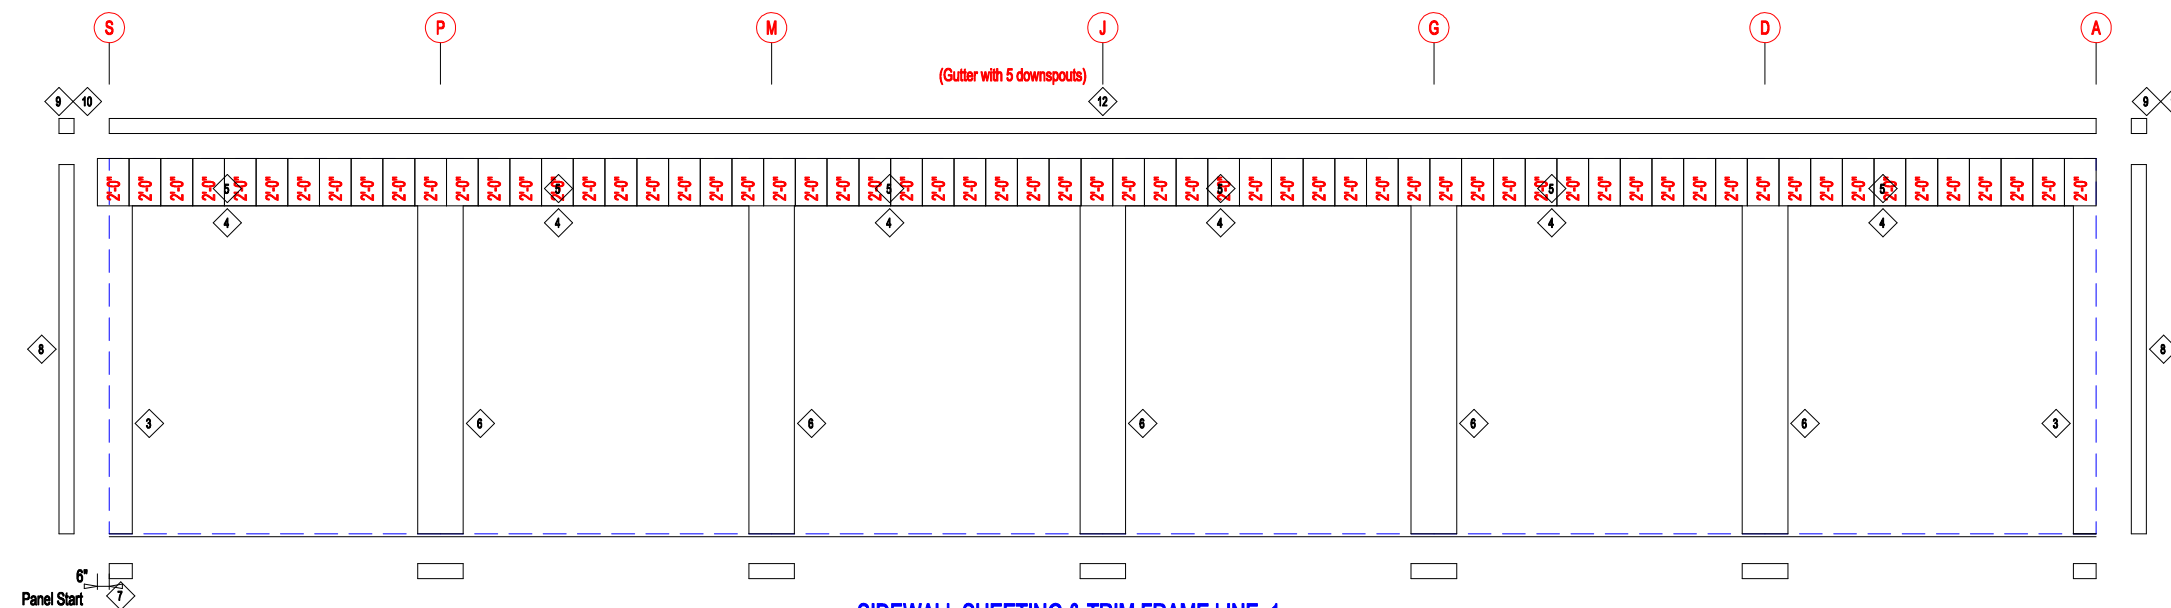

**SIDEWALL SHEETING & TRIM FRAME LINE: 1**

PANELS: 20 Ga. CP - NEED SIG 200

ID	PART	LENGTH	DETAIL
3	6MCE12	14'-1"	
4	FL-HC6	12'-1"	TRIM_235
5	FL26B	20'-2"	TRIM_232
6	6MC23	14'-1"	
7	FL72	10'-2"	TRIM_74
8	FL835x	16'-0"	TRIM_198
9	FL16C	6"	
10	FL18A	6"	
11	FL18A	6"	
12	FL18D	20'-2"	

MARK	PART	LENGTH
S-1	6X2C16	16'-0"
DJ-1	6X40C14	16'-0"
TC-1	6X2CH16	13'-10 3/4"
TC-2	6X2CH16	13'-11"
DH-1	6X25C16	11'-11 1/2"

ID	MARK	LENGTH
1	MB611	10 3/4"
2	MB623	1'-10 3/4"


ID	MARK/PART
1	MCLP



DESCRIPTION: <b>SIDEWALL DRAWING</b>					
CUSTOMER: DLR			PROJECT: MEGA STORAGE LEES SUMMIT		
LOCATION: LEE'S SUMMIT					
DRN. BY JB	CK'D BY DES	DATE 1/17/22	SCALE N.T.S.	REV. 00	QUOTATION NO. MEGASTORAGELEESUMMIT#824#14#15
					SHEET NO. 1



MEMBER TABLE		
MARK	PART	LENGTH
TC-1	6X2CH16	13'-10 3/4"
TC-2	6X2CH16	13'-11"
P-1	6X25Z14	28'-10"
P-2	6X25Z14	29'-10"

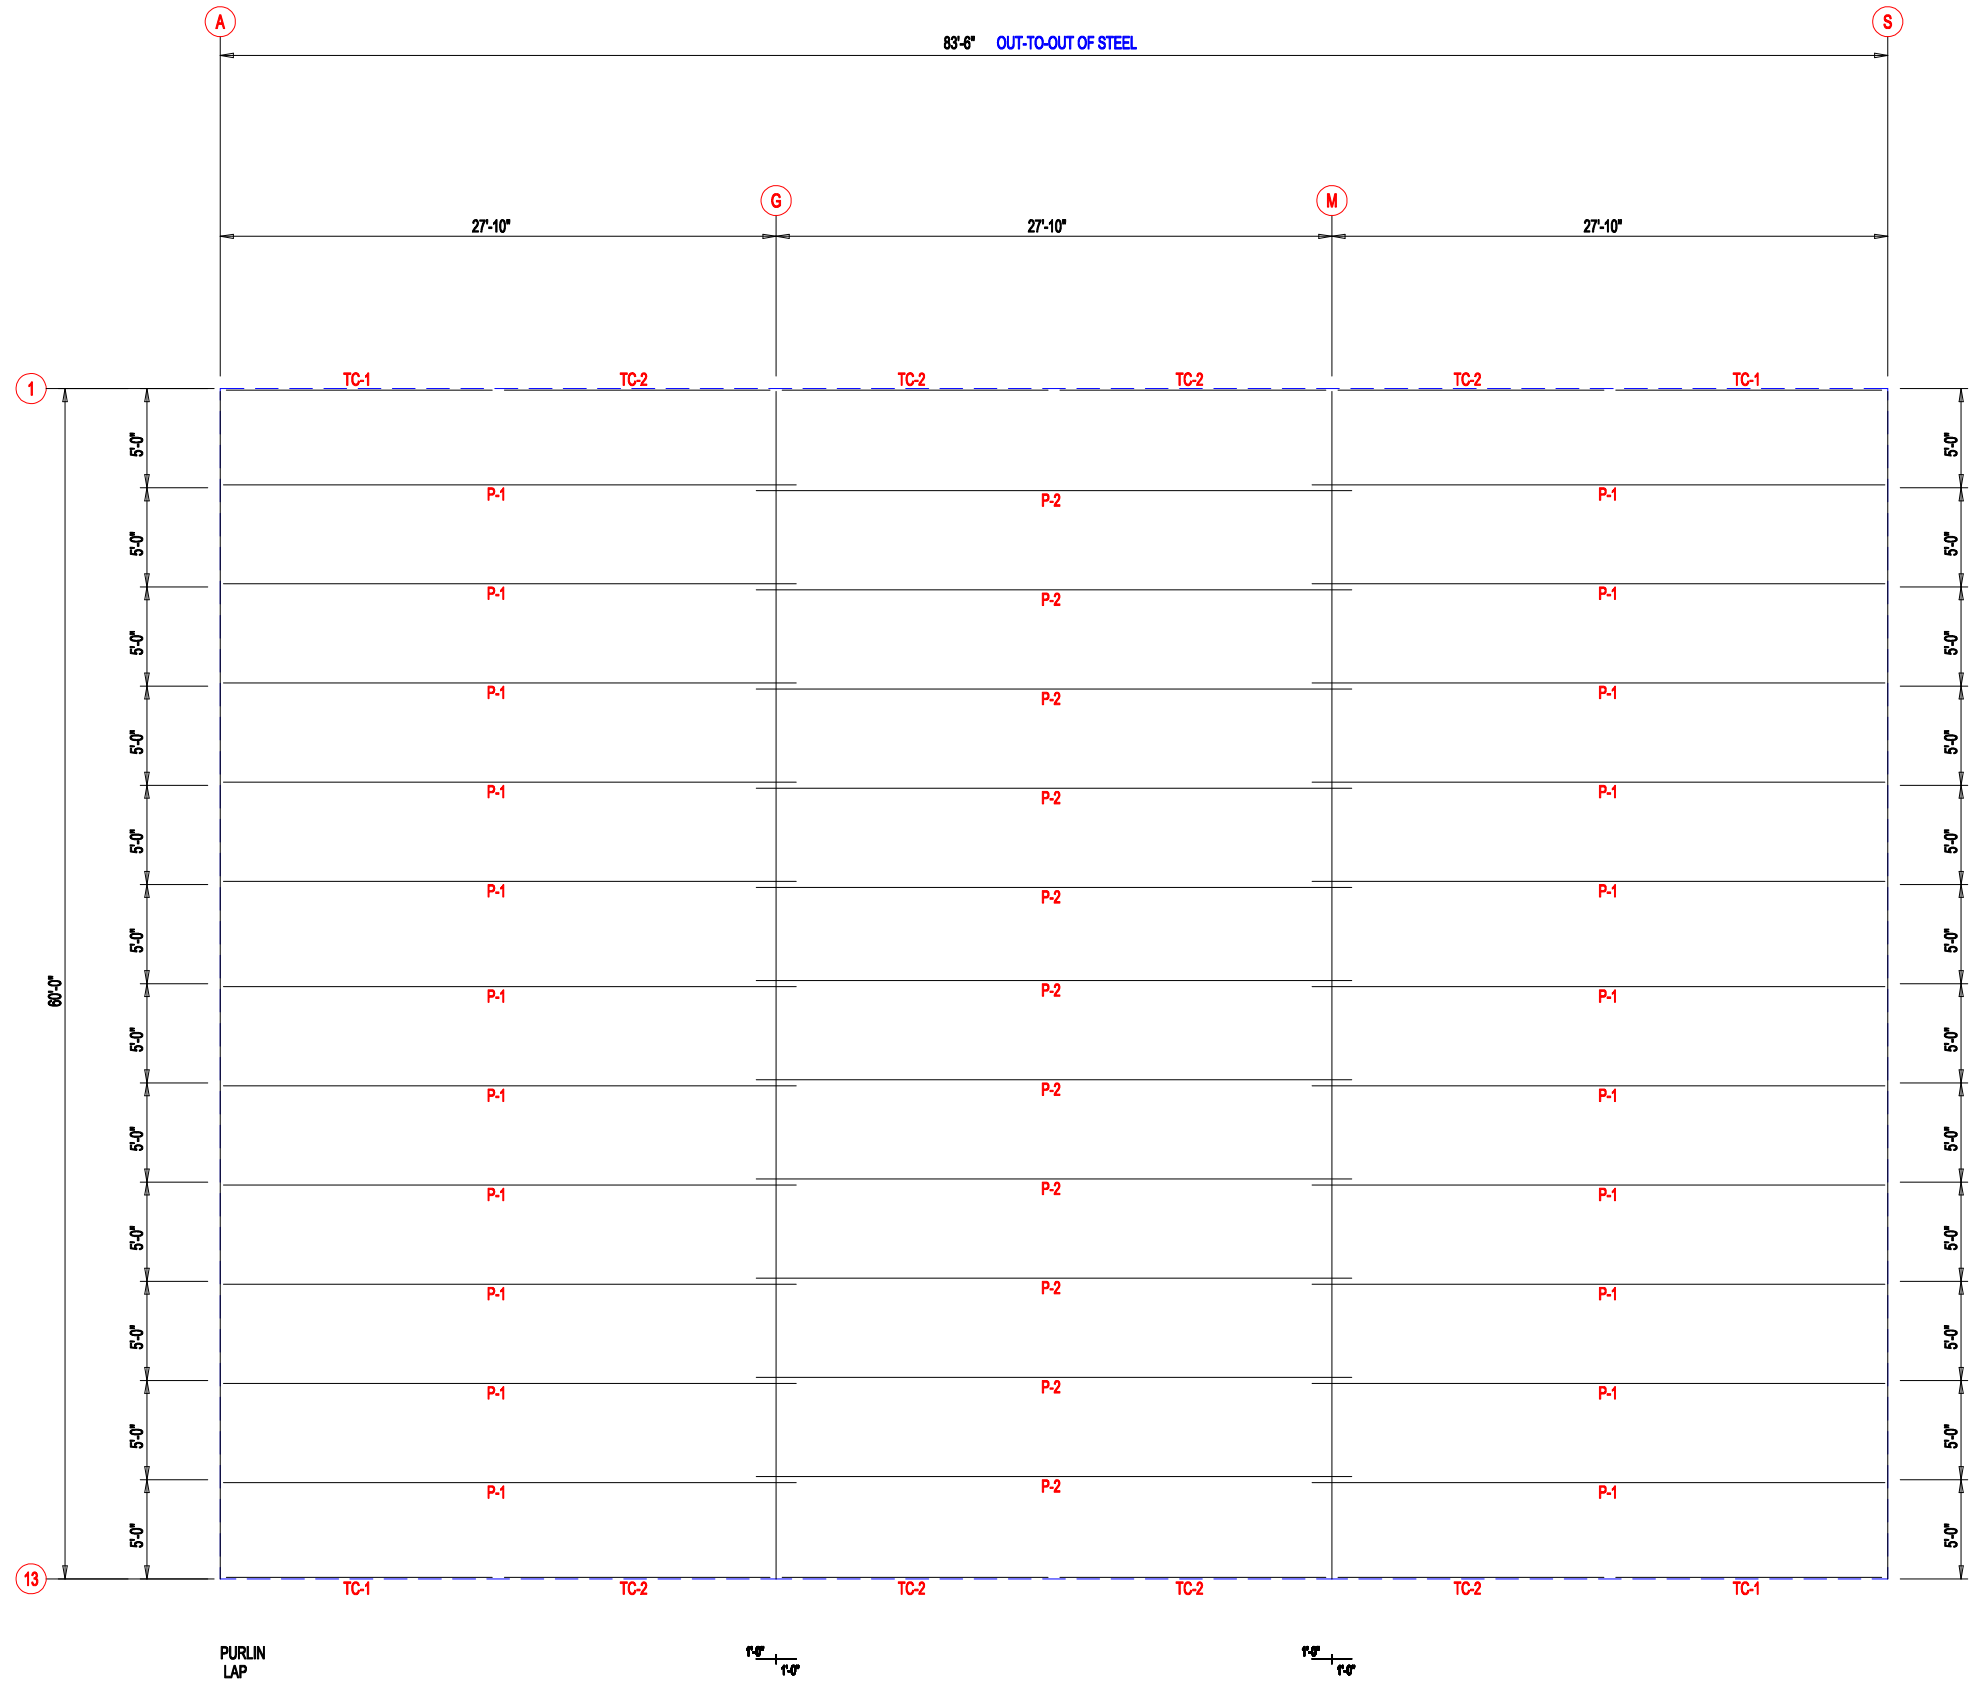

PURLIN  
LAP


1" = 1'-0"

1" = 1'-0"

ROOF FRAMING



DESCRIPTION: ROOF FRAMING					
CUSTOMER: DLR			PROJECT: MEGA STORAGE LEES SUMMIT		
LOCATION: LEE'S SUMMIT					
DRN. BY JB	CK'D BY DES	DATE 1/17/22	SCALE N.T.S.	REV. 00	QUOTATION NO. MEGASTORAGELEESUMMIT#824#14#15
					SHEET NO.

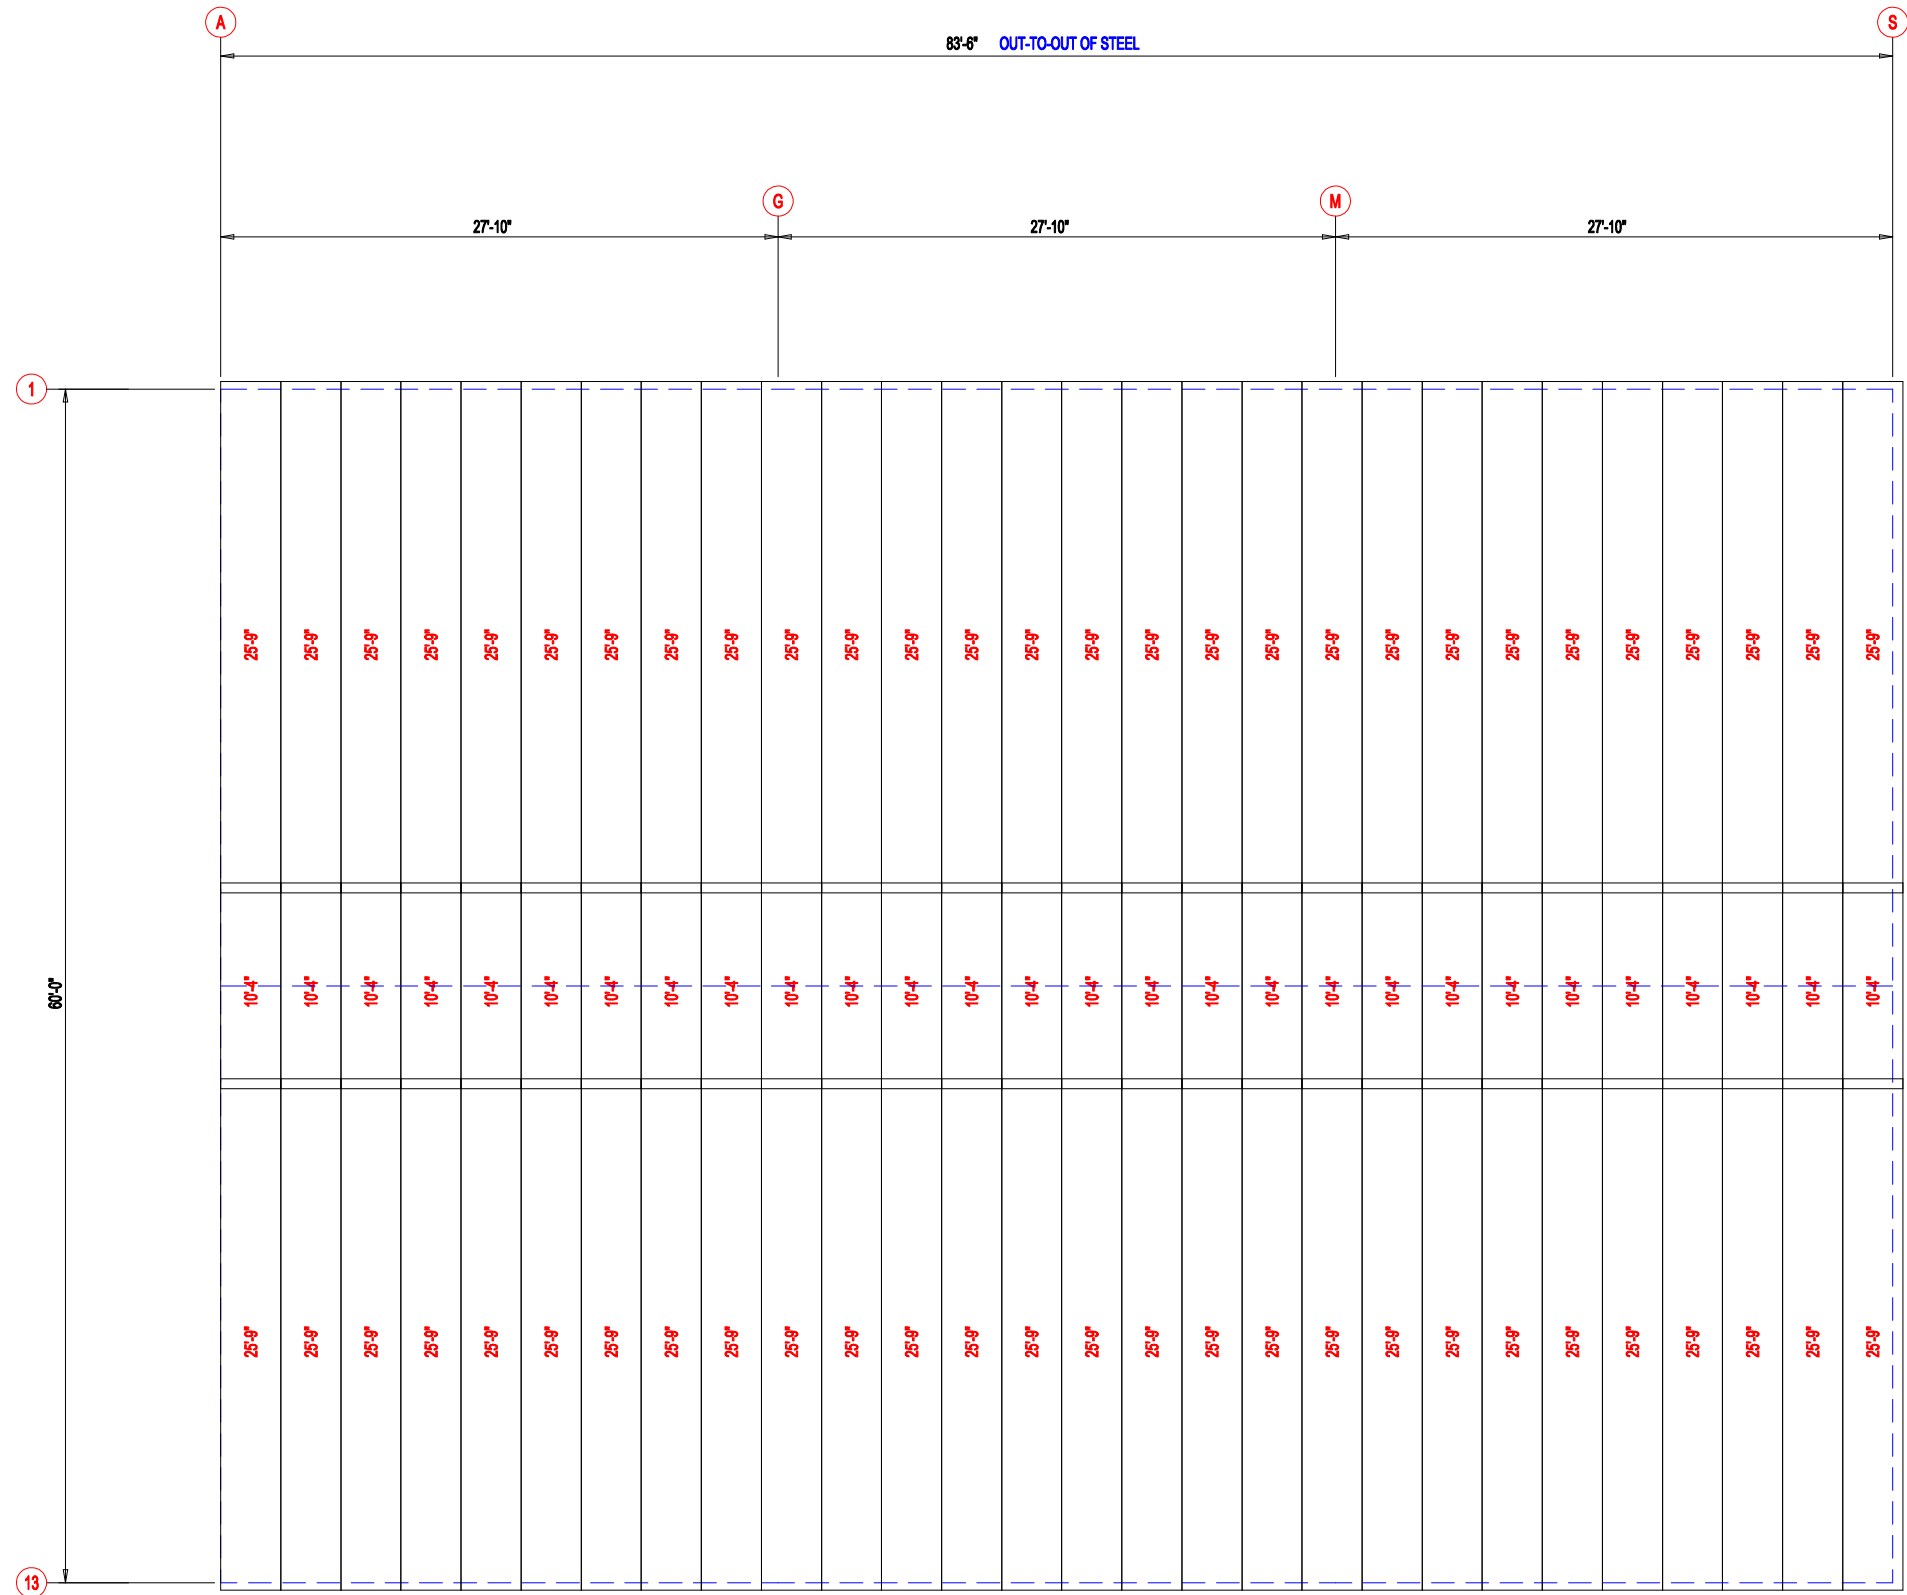

**ROOF SHEETING & TRIM**

PANELS: 26 Ga. PR - Galvalume+ w/ Drip Stop



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DESCRIPTION: <b>ROOF SHEETING</b>						
CUSTOMER: DLR				PROJECT: MEGA STORAGE LEES SUMMIT		
LOCATION: <b>LEE'S SUMMIT</b>						
DRN. BY JB	CK'D BY DES	DATE 1/17/22	SCALE N.T.S.	REV. 00	QUOTATION NO. MEGASTORAGELEESUMMIT#824#14#15	SHEET NO. 14


MEMBER TABLE		
MARK	PART	LENGTH
S-7	6X2C16	17'-1 1/2"


ANGLE TABLE		
ID	MARK	LENGTH
1	STUD	10'-0"

CONNECTION PLATES	
ID	MARK/PART
1	FC



WALL FRAMING FRAME LINE: 7 (Typ of 3)  
GRID LINES: (G-J, P-S, M-P)

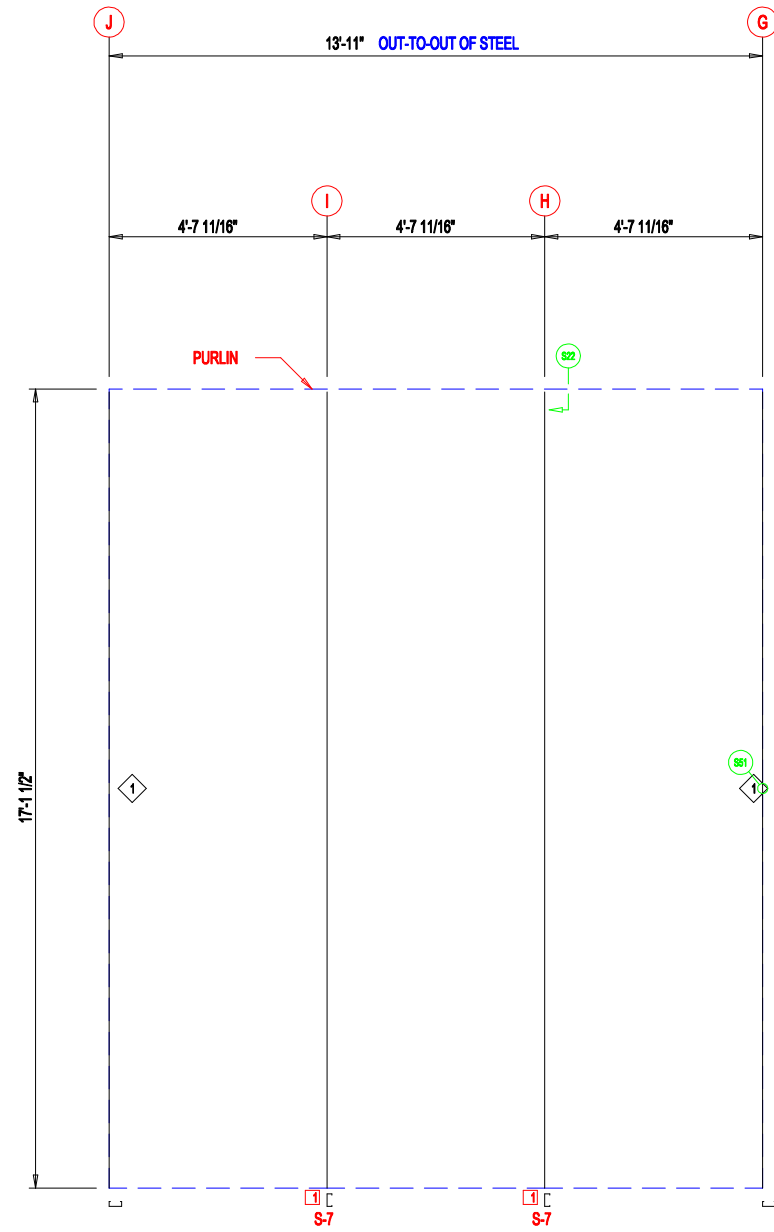

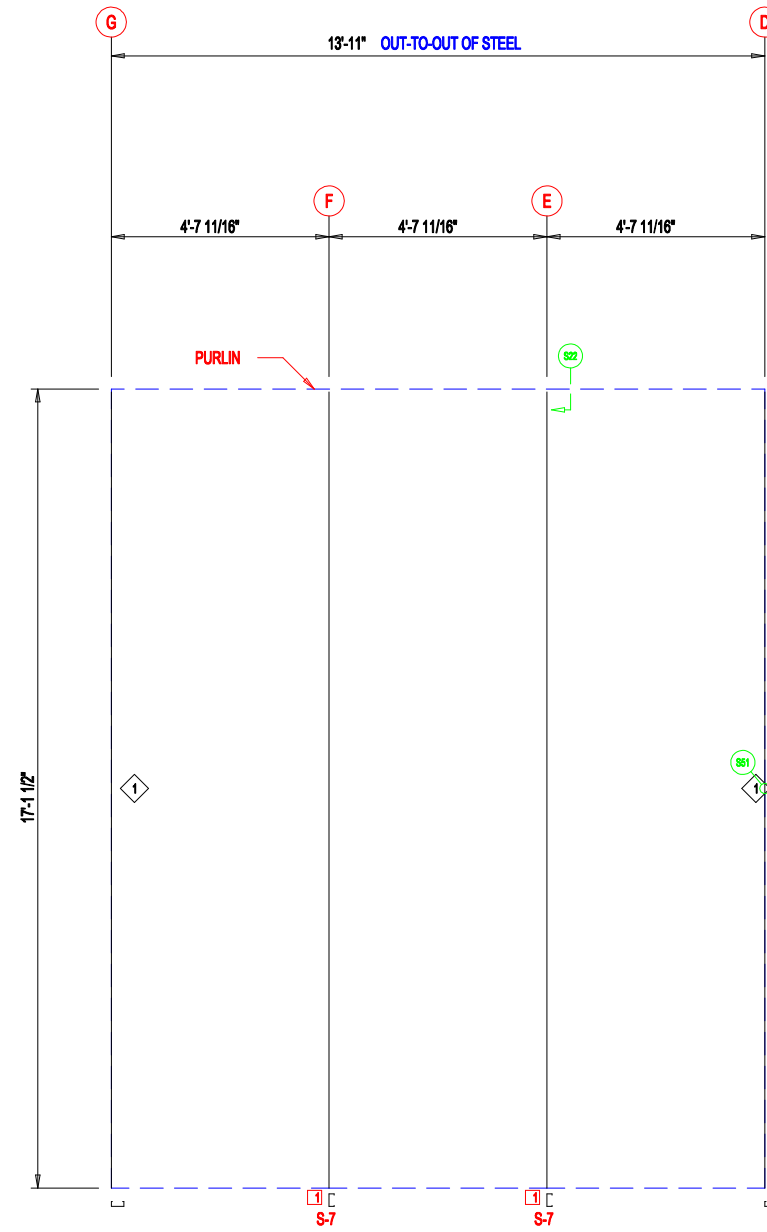WALL FRAMING FRAME LINE: 7 (Typ of 2)  
GRID LINES: (D-G, J-M)




DESCRIPTION:		PARTITION FRAMING					
CUSTOMER:		DLR			PROJECT: MEGA STORAGE LEES SUMMIT		
LOCATION:		LEE'S SUMMIT					
DRN. BY	CK'D BY	DATE	SCALE	REV.	QUOTATION NO.	SHEET NO.	
JB	DES	1/17/22	N.T.S.	00	MEGASTORAGELEESUMMIT#824#14#15	14#15	


MEMBER TABLE		
MARK	PART	LENGTH
S-7	6X2C16	17'-1 1/2"

CONNECTION PLATES	
ID	MARK/PART
1	FC

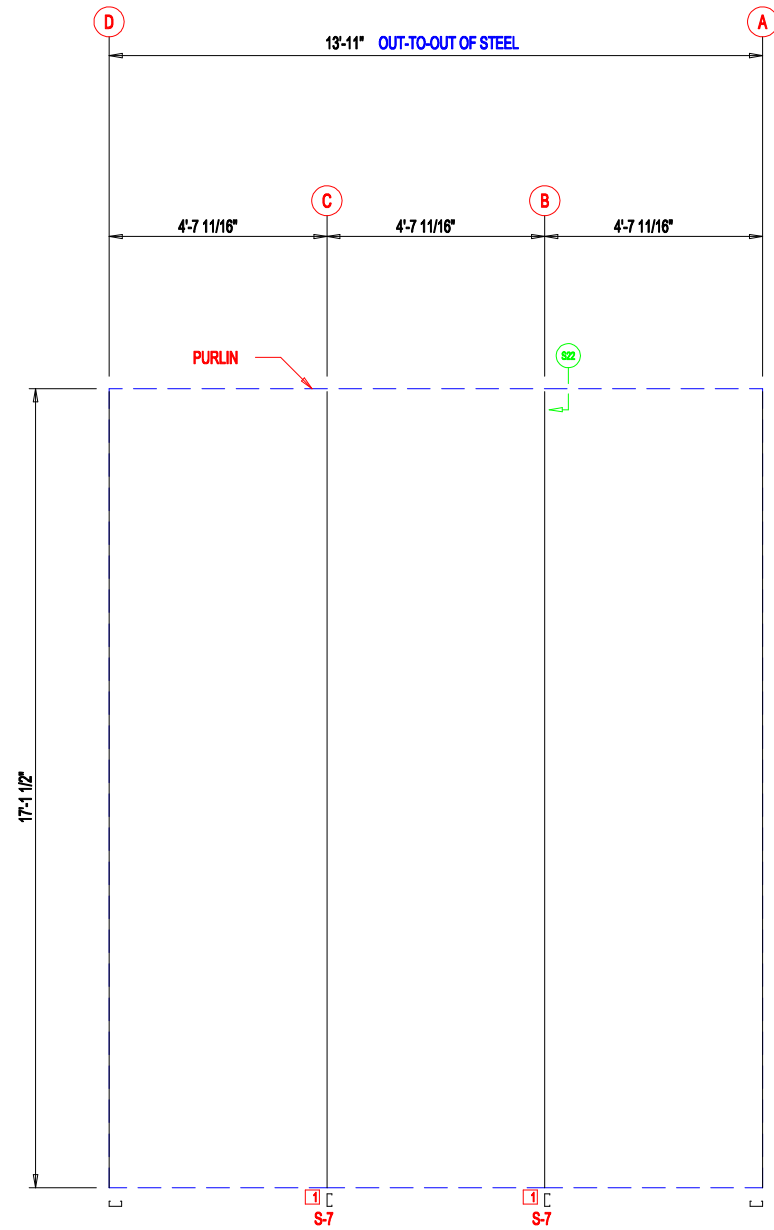

WALL FRAMING FRAME LINE: 7

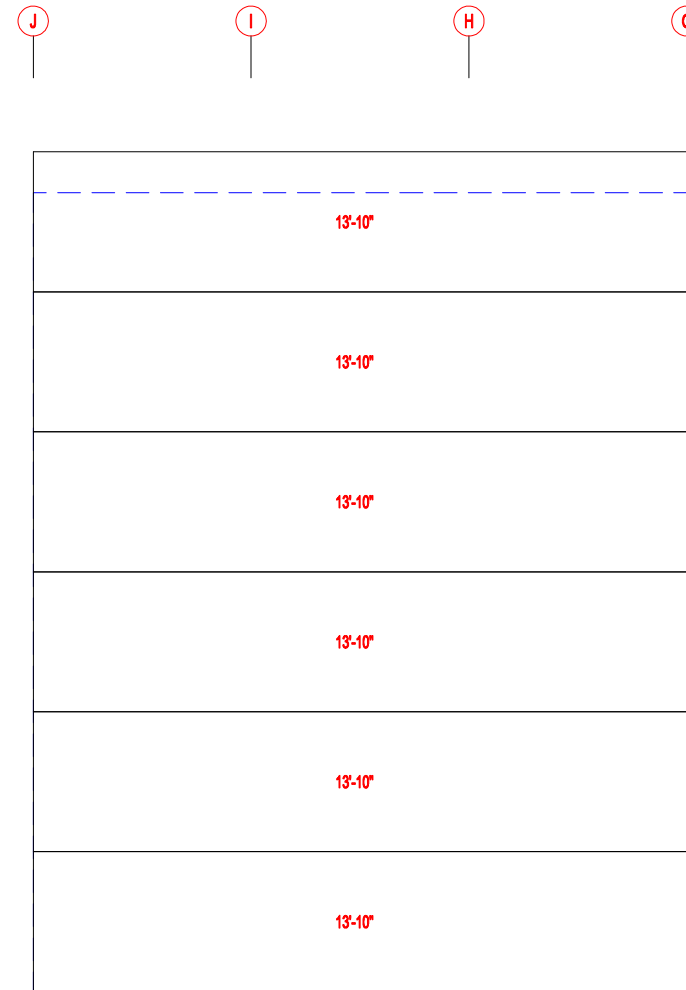


WALL SHEETING & TRIM FRAME LINE: 7 (Typ of 3)  
 GRID LINES: (G-J, P-S, M-P)  
 PANELS: 29 Ga. PR - Galvalume +



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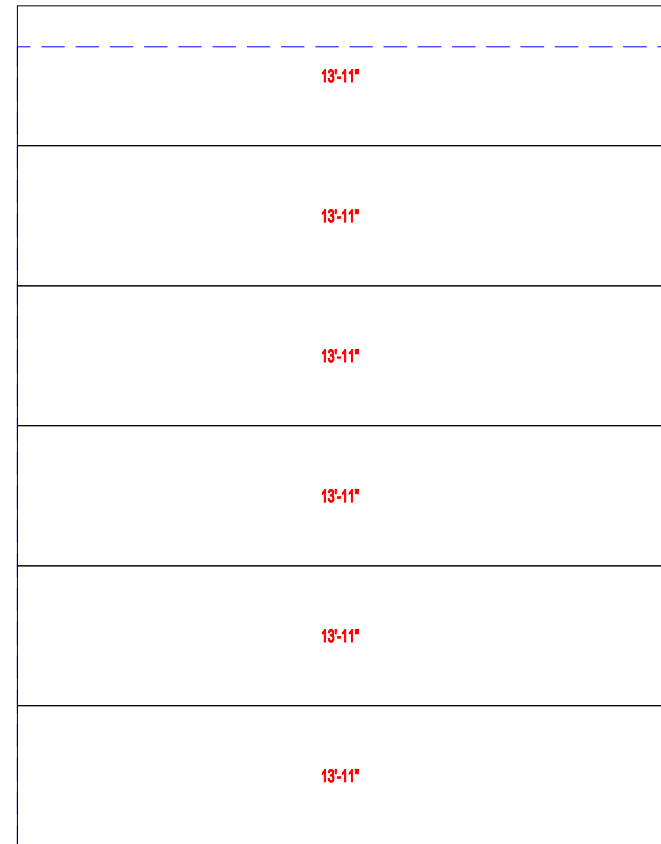
DESCRIPTION: PARTITION DRAWING					
CUSTOMER: DLR			PROJECT: MEGA STORAGE LEES SUMMIT		
LOCATION: LEE'S SUMMIT					
DRN. BY JB	CK'D BY DES	DATE 1/17/22	SCALE N.T.S.	REV. 00	QUOTATION NO. MEGASTORAGELEESUMMIT#824#14#15
					SHEET NO. #14#15

G F E D

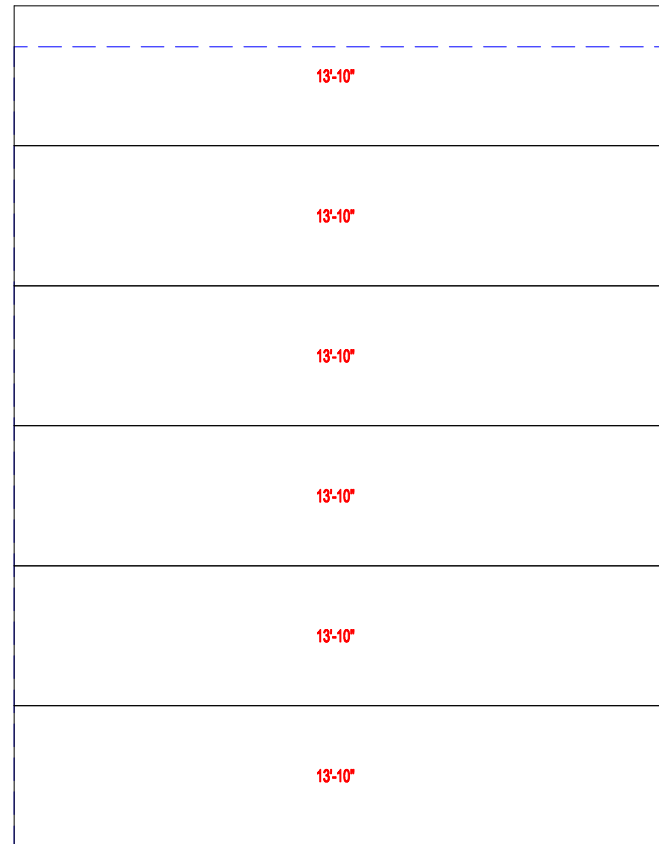

WALL SHEETING & TRIM FRAME LINE: 7 (Typ of 2)  
 GRID LINES: (D-G, J-M)  
 PANELS: 29 Ga. PR - Galvalume +

D C B A



WALL SHEETING & TRIM FRAME LINE: 7  
 PANELS: 29 Ga. PR - Galvalume +




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DESCRIPTION: PARTITION SHEETING						
CUSTOMER: DLR				PROJECT: MEGA STORAGE LEES SUMMIT		
LOCATION: LEE'S SUMMIT						
DRN. BY JB	CK'D BY DES	DATE 1/17/22	SCALE N.T.S.	REV. 00	QUOTATION NO. MEGASTORAGELEESUMMIT#824#14#15	SHEET NO. #15

MEMBER TABLE		
MARK	PART	LENGTH
S-2	6X2C16	16'-1"
S-3	6X2C16	16'-3 1/2"
S-4	6X2C16	16'-6"
S-5	6X2C16	16'-8 1/2"
S-6	6X2C16	16'-11"
S-7	6X2C16	17'-1 1/2"


CONNECTION PLATES	
ID	MARK/PART
1	FC

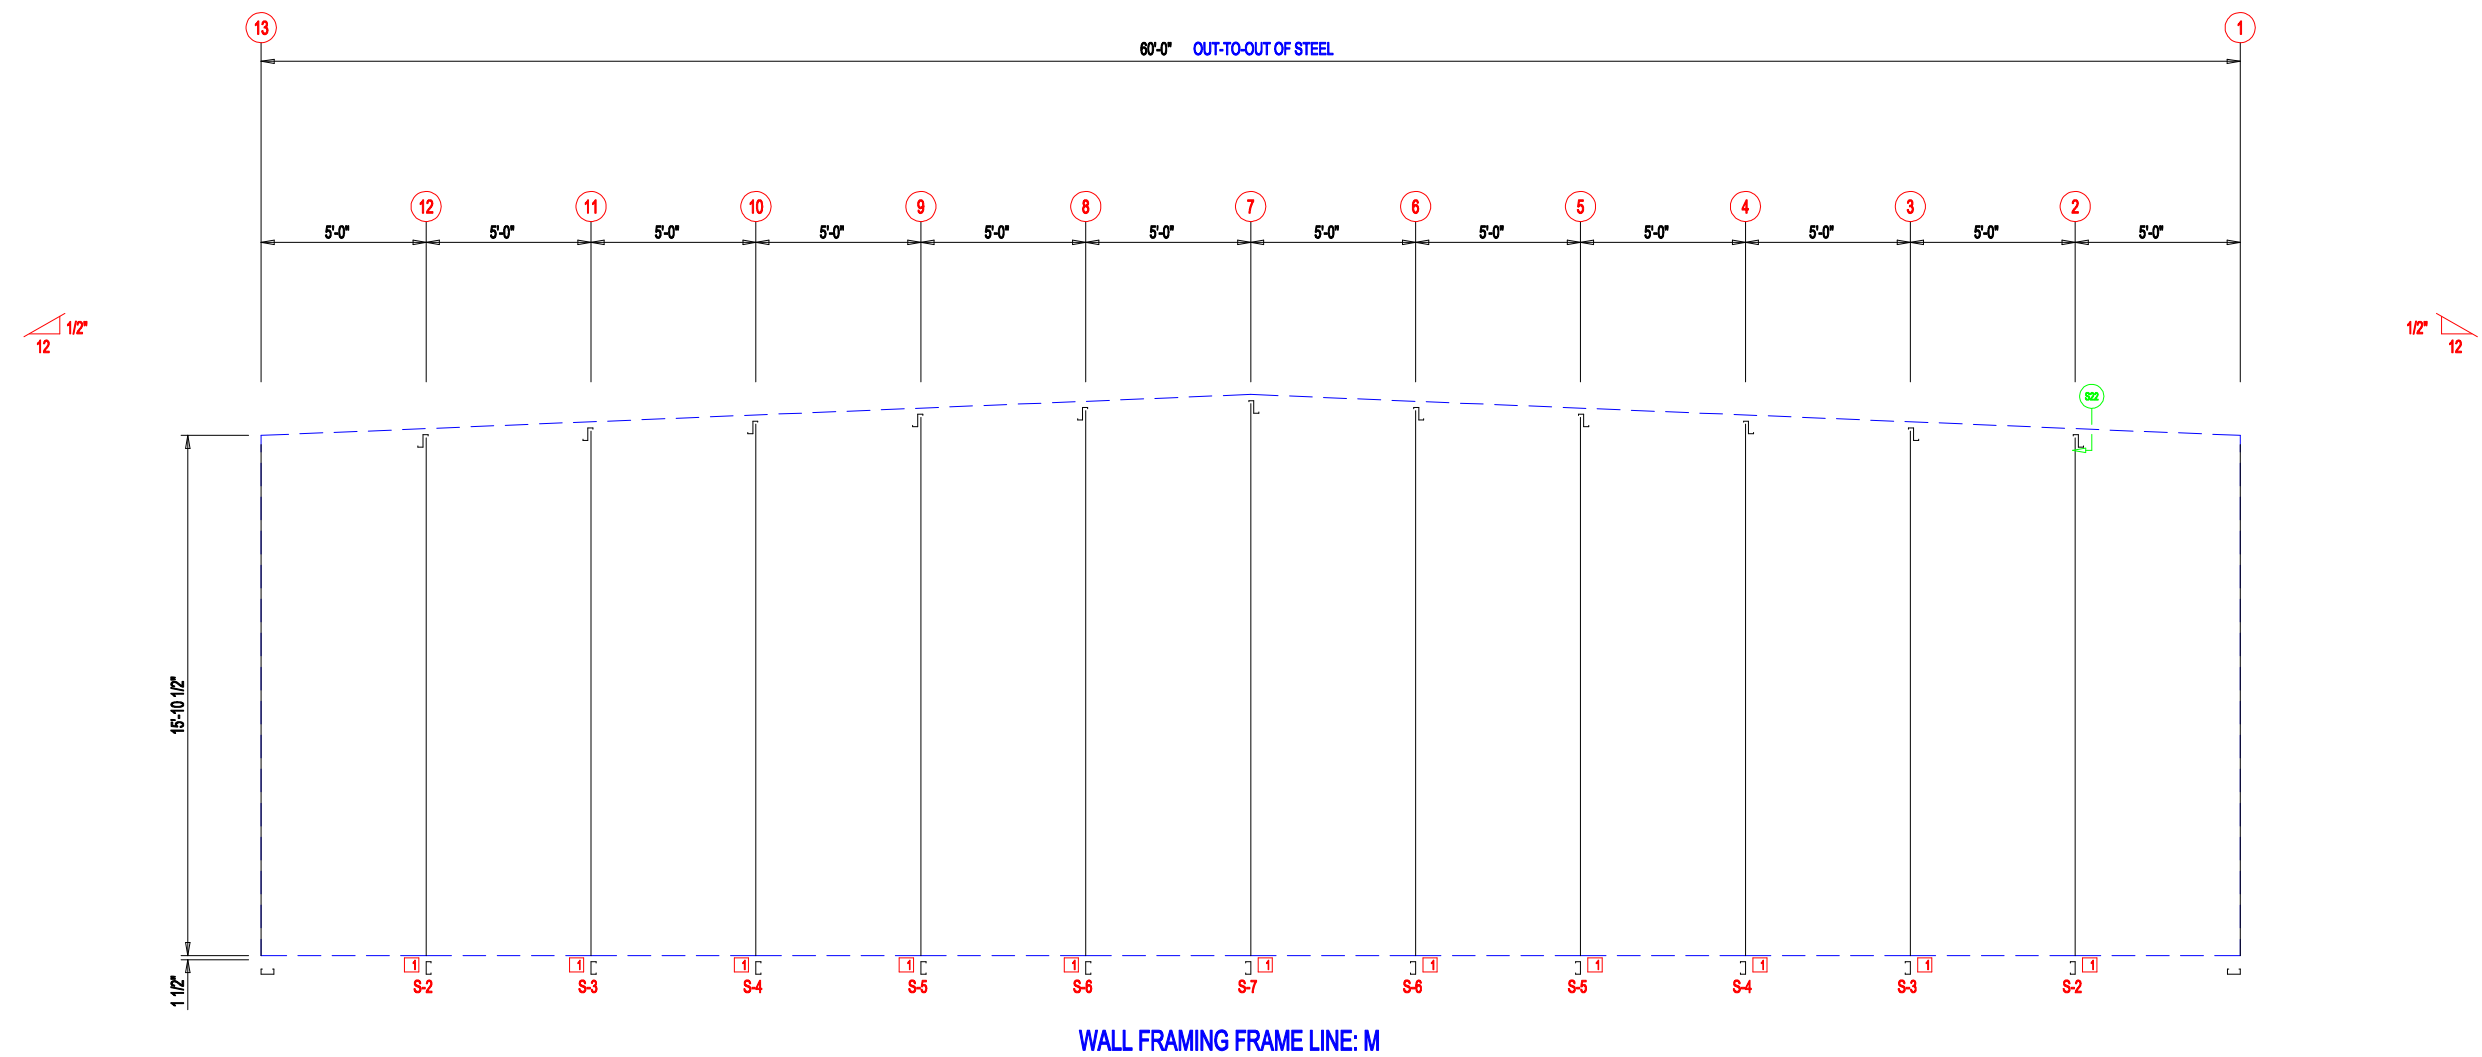

DESCRIPTION: PARTITION FRAMING		CUSTOMER: DLR		PROJECT: MEGA STORAGE LEES SUMMIT	
LOCATION: LEE'S SUMMIT		DRN. BY: JB		CK'D BY: DES	
DATE: 1/17/22	SCALE: N.T.S.	REV.: 00	QUOTATION NO.: MEGASTORAGELEESUMMIT#824#14#15	SHEET NO.: 14#15	

MEMBER TABLE		
MARK	PART	LENGTH
S-2	6X2C16	16'-1"
S-3	6X2C16	16'-3 1/2"
S-4	6X2C16	16'-6"
S-5	6X2C16	16'-8 1/2"
S-6	6X2C16	16'-11"
S-7	6X2C16	17'-1 1/2"

CONNECTION PLATES	
ID	MARK/PART
1	FC

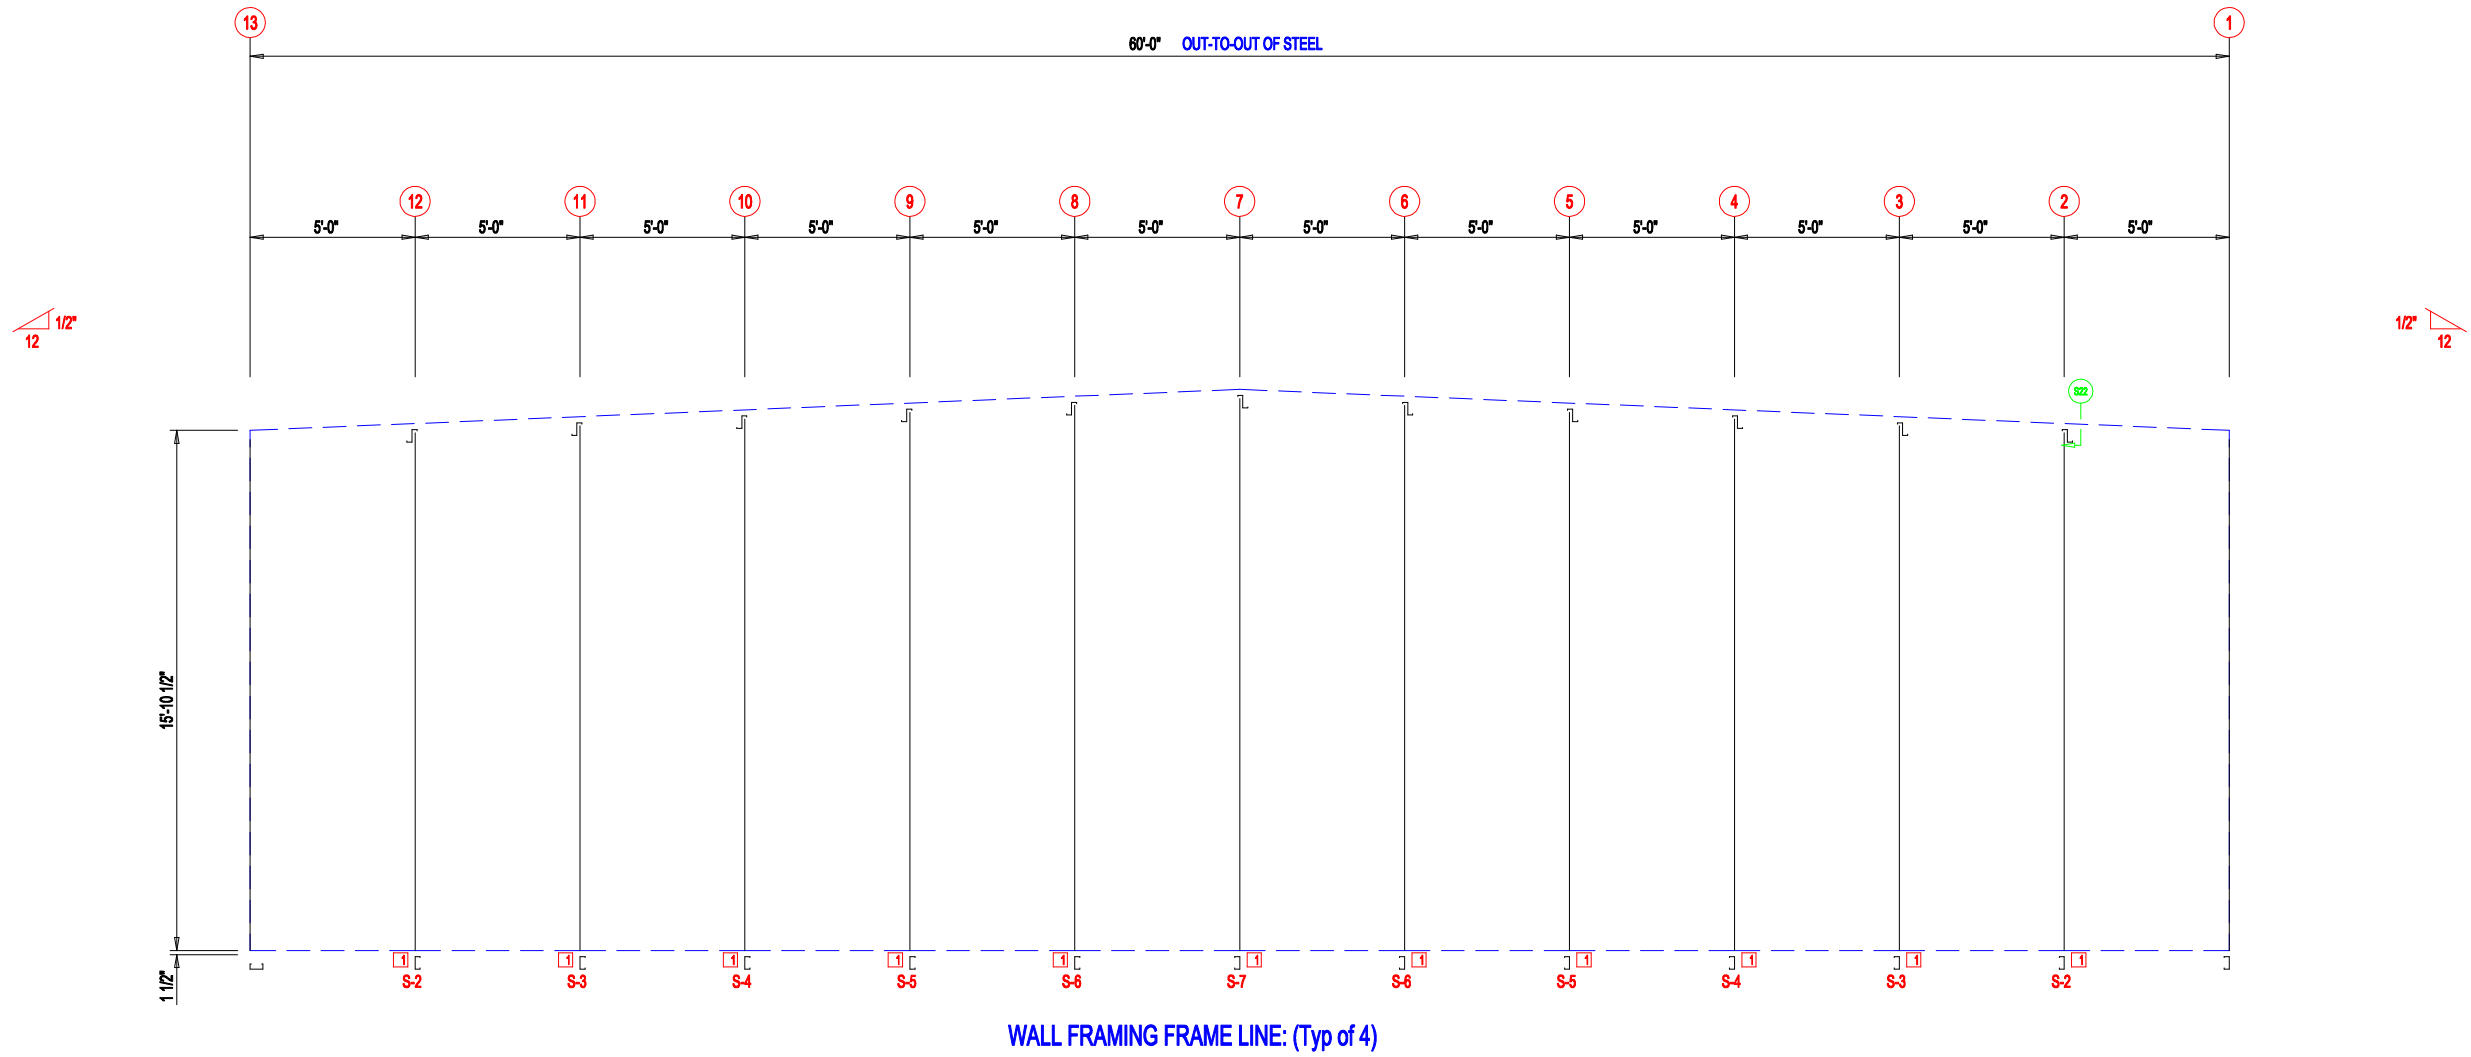

DESCRIPTION:		PARTITION FRAMING			
CUSTOMER:		DLR		PROJECT: MEGA STORAGE LEES SUMMIT	
LOCATION:		LEE'S SUMMIT			
DRN. BY	CK'D BY	DATE	SCALE	REV.	QUOTATION NO.
JB	DES	1/17/22	N.T.S.	00	MEGASTORAGELEESUMMIT#824#14#15
					SHEET NO.
					MEGASTORAGELEESUMMIT#824#14#15

- 13
- 12
- 11
- 10
- 9
- 8
- 7
- 6
- 5
- 4
- 3
- 2
- 1

1/2"  
12

1/2"  
12

30'-2"	30'-0"
30'-2"	30'-0"
30'-2"	30'-0"
30'-2"	30'-0"
30'-2"	30'-0"
30'-2"	30'-0"

**WALL SHEETING & TRIM FRAME LINE: M**  
 PANELS: 29 Ga. PR - Calvalume +



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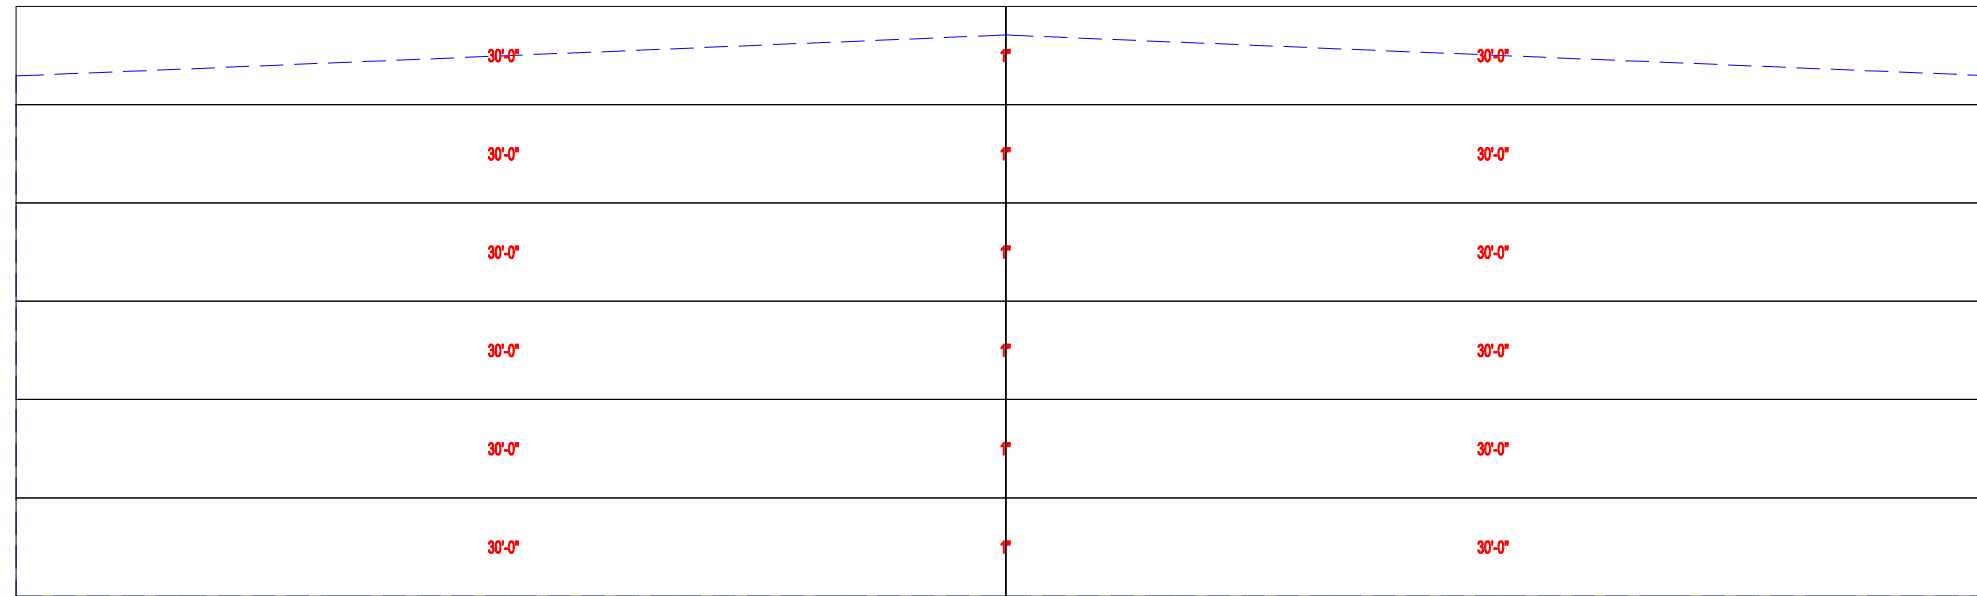
DESCRIPTION: <b>PARTITION SHEETING</b>					
CUSTOMER: DLR			PROJECT: MEGA STORAGE LEES SUMMIT		
LOCATION: <b>LEE'S SUMMIT</b>					
DRN. BY JB	CK'D BY DES	DATE 1/17/22	SCALE N.T.S.	REV. 00	QUOTATION NO. MEGASTORAGELEESUMMIT#824#14#15
					SHEET NO. #14#15





1/2"  
12

1/2"  
12




**WALL SHEETING & TRIM FRAME LINE: (Typ of 4)**

PANELS: 29 Ga. PR - Galvalume +



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DESCRIPTION: PARTITION SHEETING						
CUSTOMER: DLR				PROJECT: MEGA STORAGE LEES SUMMIT		
LOCATION: LEE'S SUMMIT						
DRN. BY JB	CK'D BY DES	DATE 1/17/22	SCALE N.T.S.	REV. 00	QUOTATION NO. MEGASTORAGELEESUMMIT#824#14#15	SHEET NO. #15

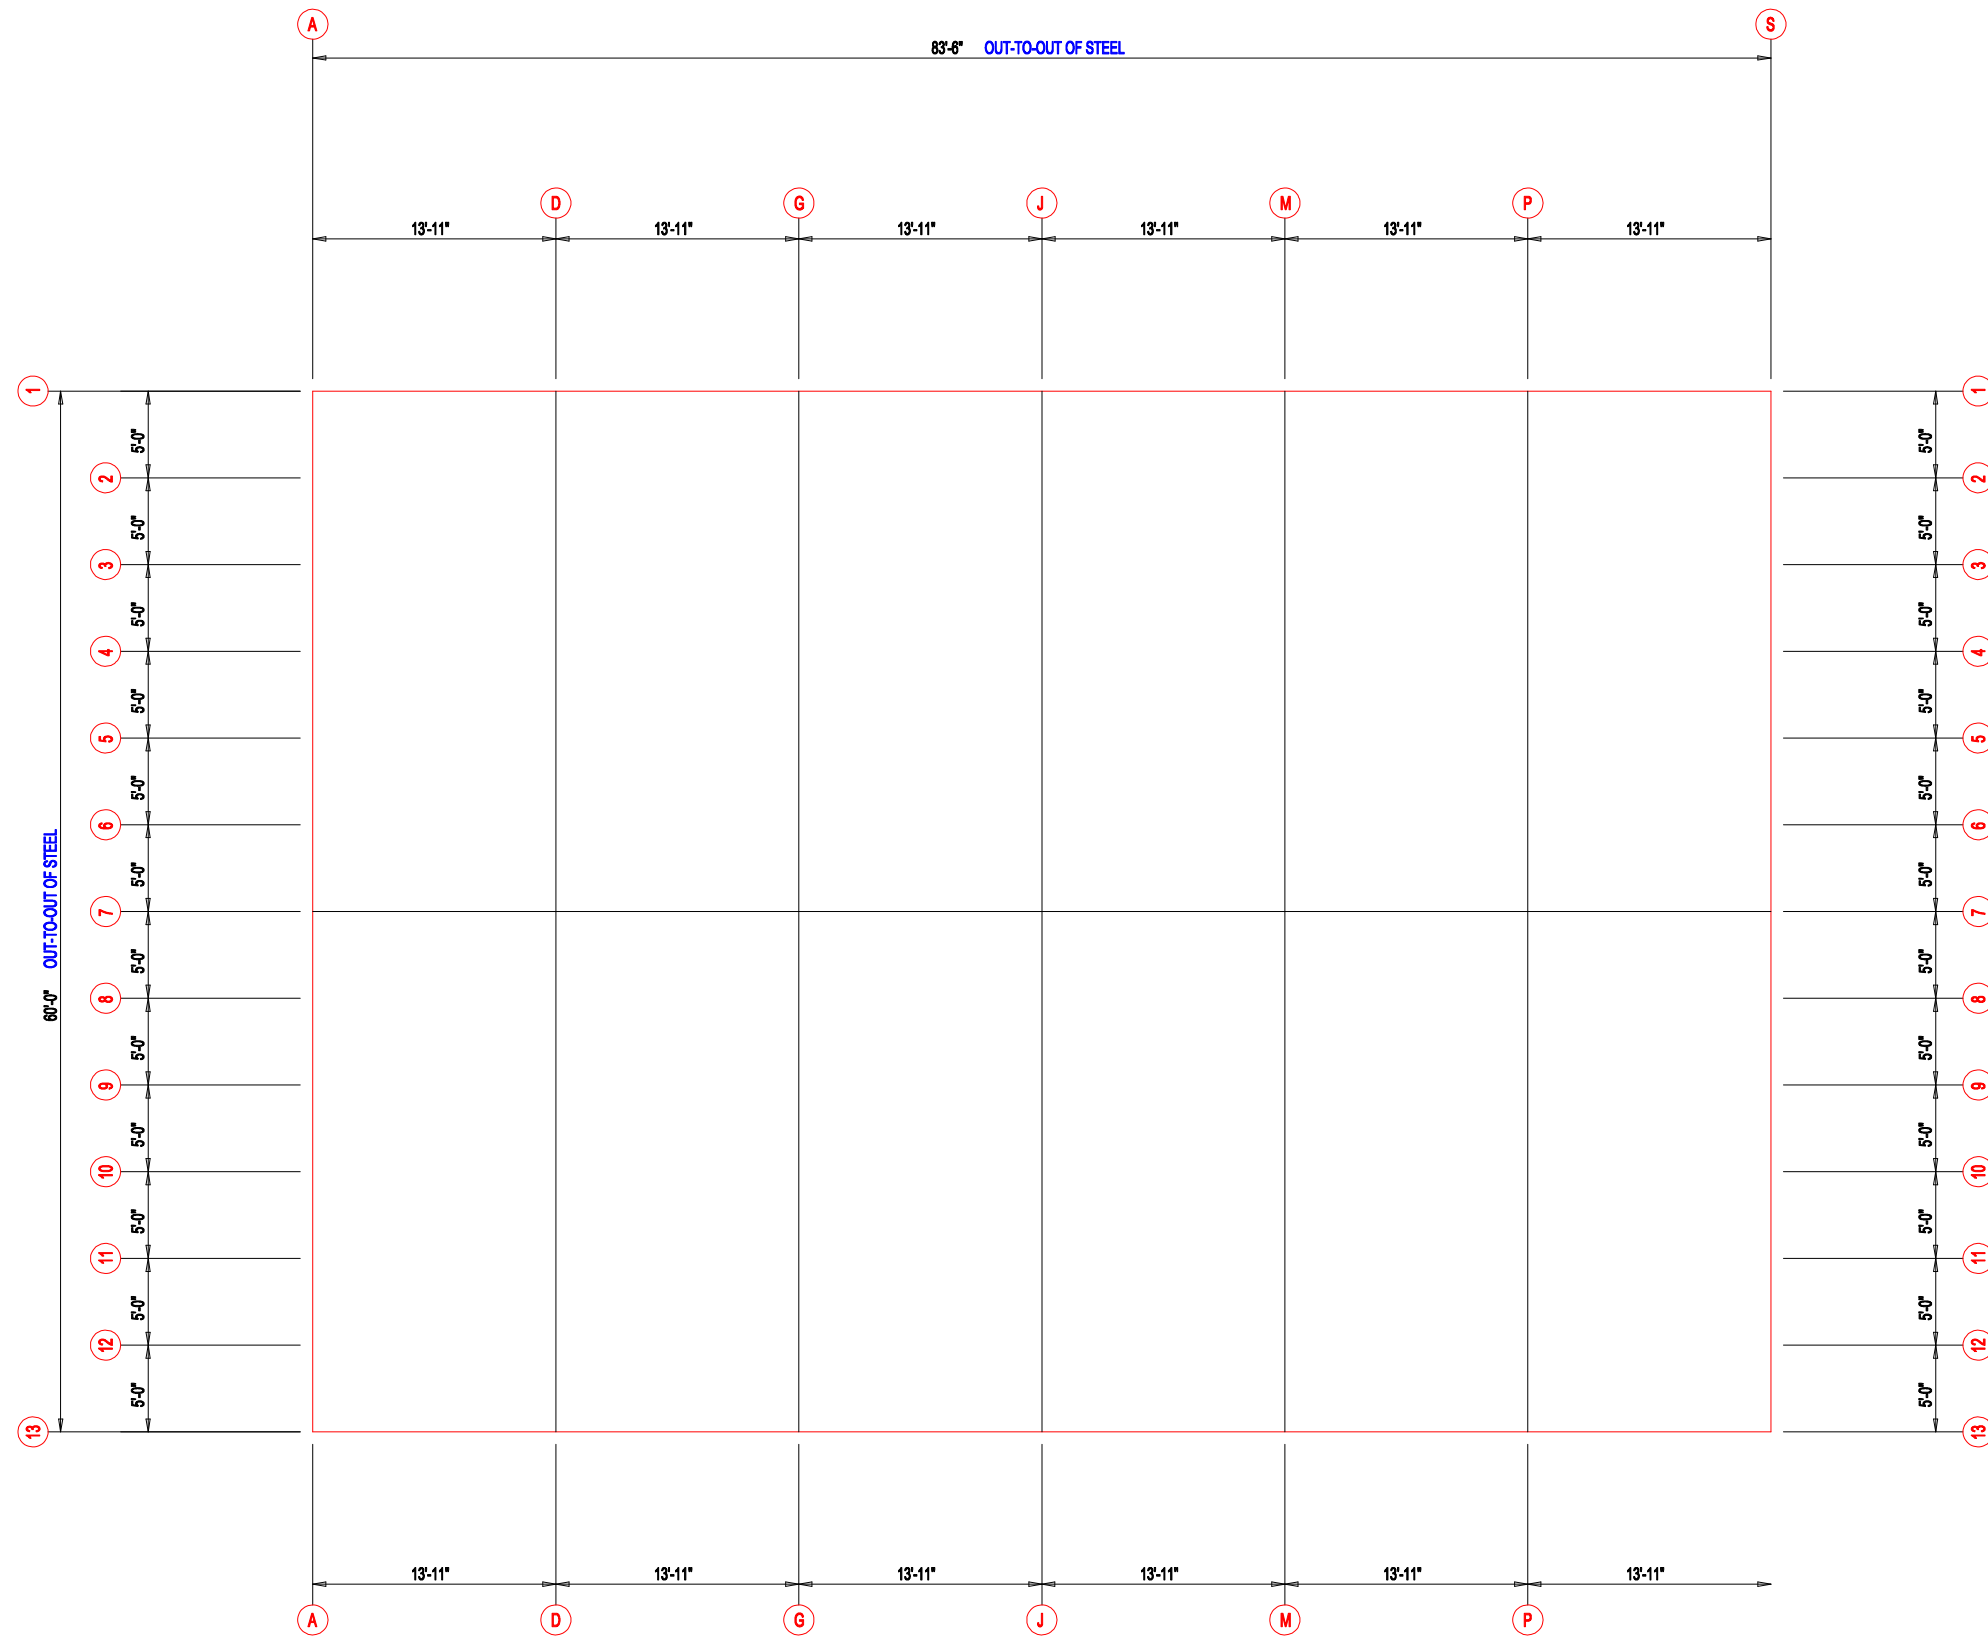


FLOOR PLAN




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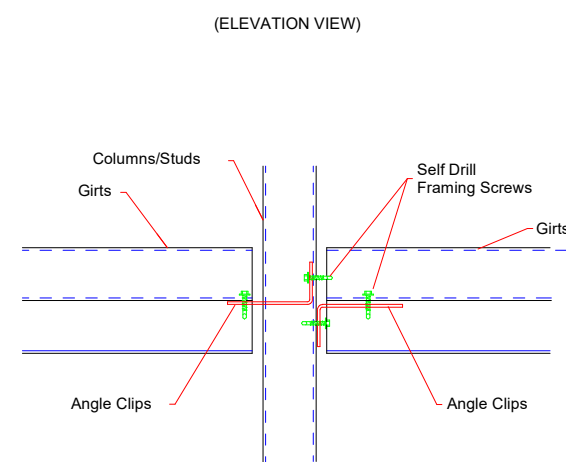
DESCRIPTION:		FLOOR PLAN			
CUSTOMER:		DLR		PROJECT: MEGA STORAGE LEES SUMMIT	
LOCATION:		LEE'S SUMMIT			
DRN. BY	CK'D BY	DATE	SCALE	REV.	QUOTATION NO.
JB	DES	1/17/22	N.T.S.	00	MEGASTORAGELEESUMMIT#824#14#15
					SHEET NO.
					14

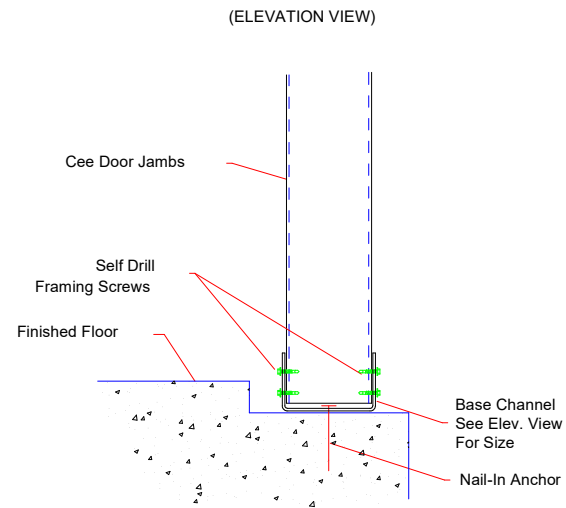


**S2** BASE @ DOOR JAMB

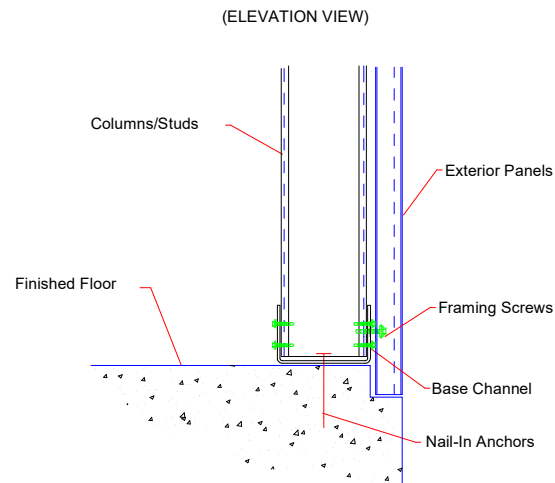


**S4** COLUMN BASE @ SHEETED WALL




**S11** GIRT CONNECTION

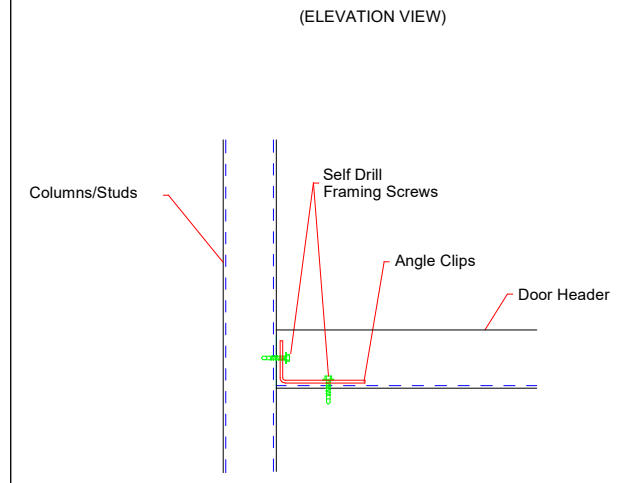


**S12** DOOR HEADER TO JAMB

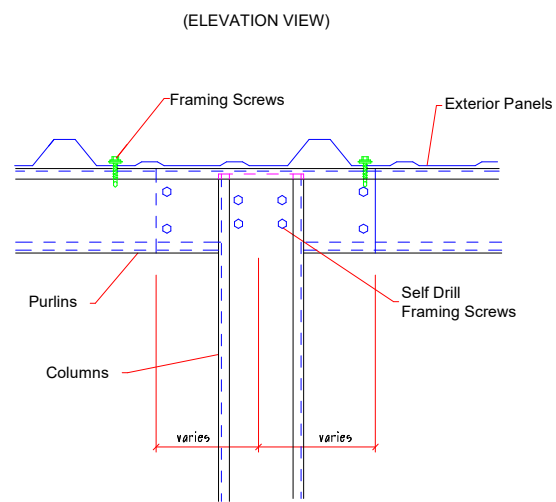


**S22** COLUMN TO PURLIN @ LAP

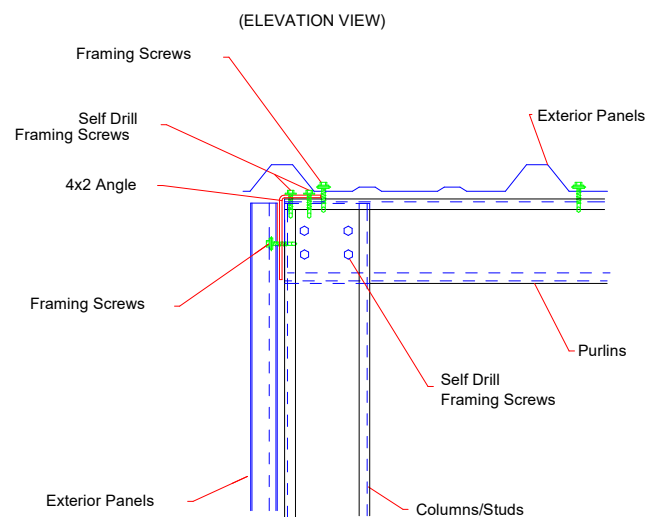

**S24** RAKE @ SHEETED ENDWALL

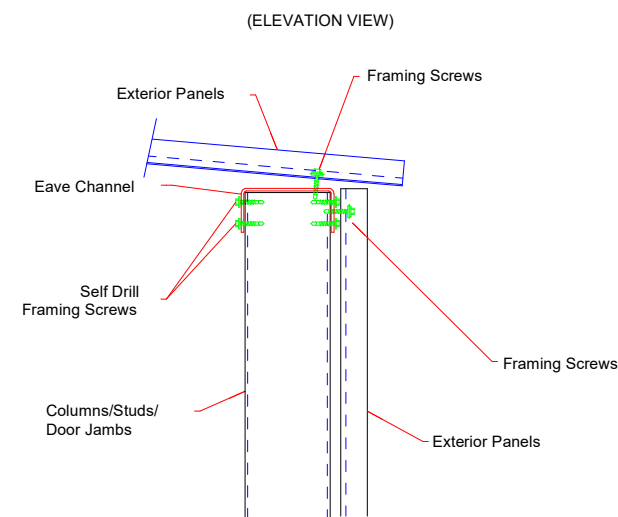

**S31** EAVE

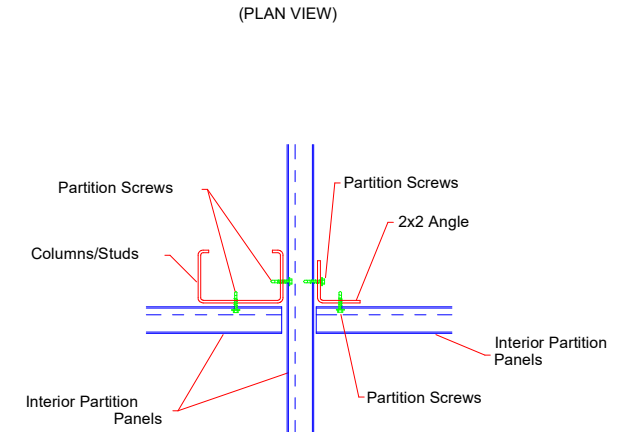


**S51** PARTITION




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DESCRIPTION: <b>DETAIL DRAWINGS</b>						
CUSTOMER: <b>DLR</b>				PROJECT: <b>MEGA STORAGE LEES SUMMIT</b>		
LOCATION: <b>LEE'S SUMMIT</b>						
DRN. BY <b>JB</b>	CK'D BY <b>DES</b>	DATE <b>1/17/22</b>	SCALE <b>N.T.S.</b>	REV. <b>00</b>	QUOTATION NO. <b>MEGASTORAGELEESUMMIT#824#14#15</b>	SHEET NO. <b>15</b>

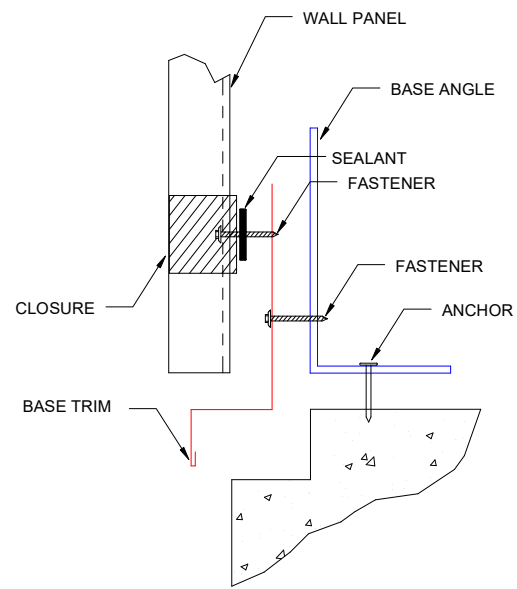

**BASE SEAL**


**TRIM\_74**

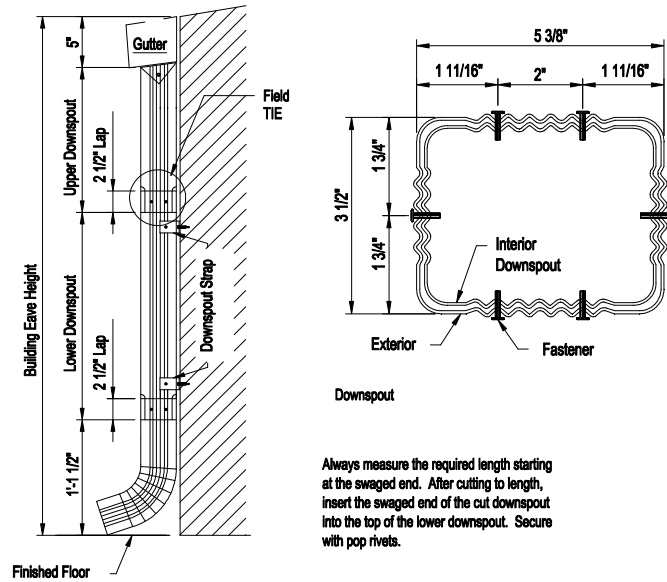

**3 1/2" x 5 3/8" Roll Form Downspout Elevation**


**TRIM\_175**

1. A Downspout Strap is required at all Downspout Splices.

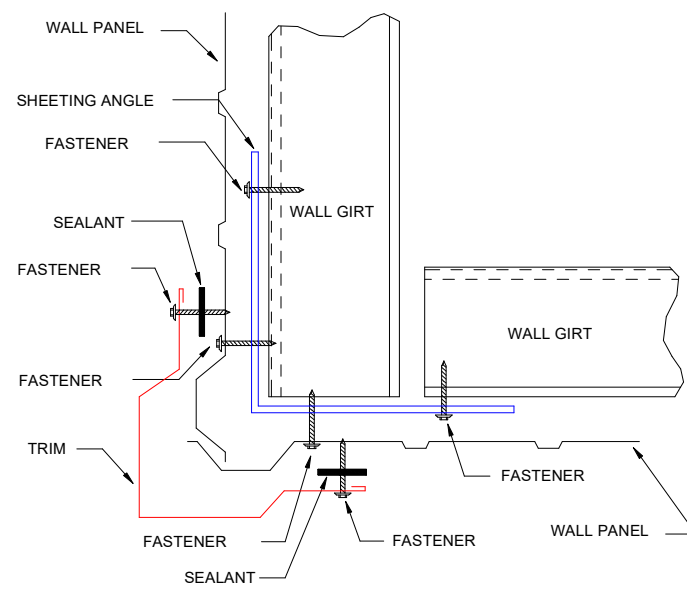


**OUTSIDE CORNER**

**TRIM\_198**

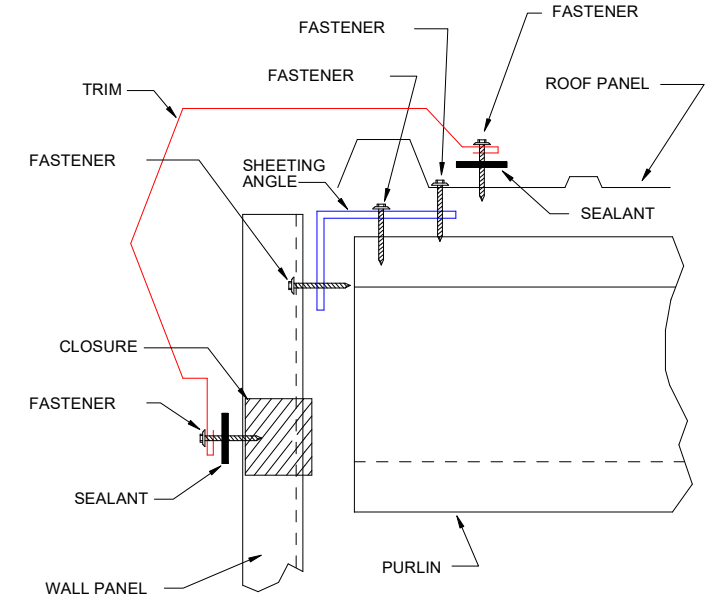


**GABLE**

**TRIM\_229**

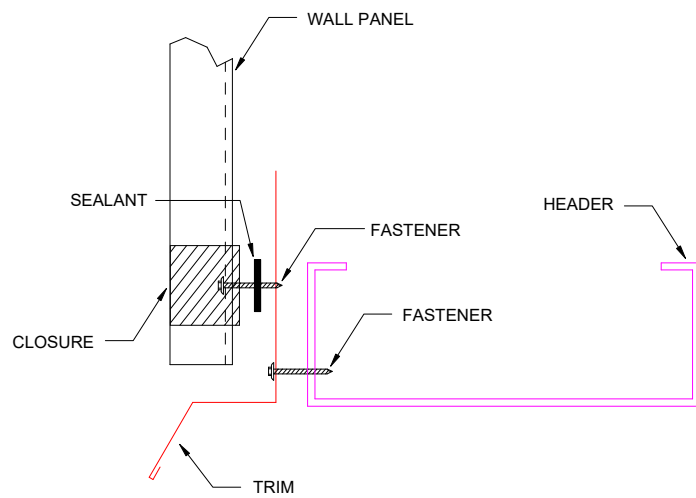

**HEADER**

**TRIM\_232**

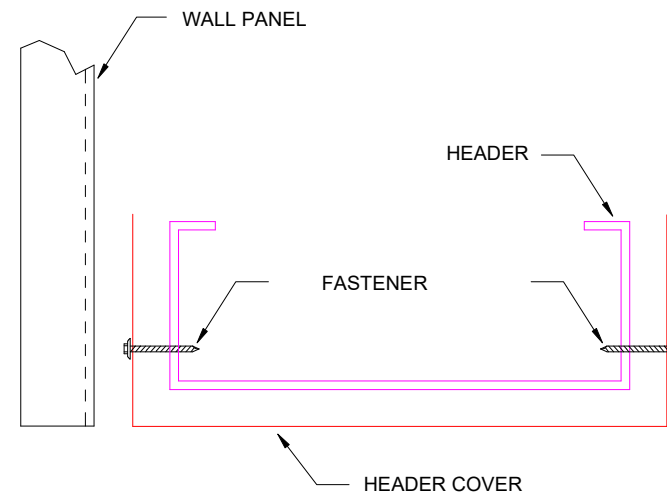

**HEADER COVER**

**TRIM\_235**



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DESCRIPTION: <b>DETAIL DRAWINGS</b>						
CUSTOMER: <b>DLR</b>				PROJECT: <b>MEGA STORAGE LEES SUMMIT</b>		
LOCATION: <b>LEE'S SUMMIT</b>						
DRN. BY <b>JB</b>	CK'D BY <b>DES</b>	DATE <b>1/17/22</b>	SCALE <b>N.T.S.</b>	REV. <b>00</b>	QUOTATION NO. <b>MEGASTORAGELEESUMMIT#824#14#15</b>	SHEET NO. <b>15</b>