



# PELLA

BUILDING SYSTEMS

906 West 9th Street Pella, IA 50219  
(800) 225-0481 www.pellabuildings.com

**BUILDING LOADS / DESCRIPTION:**

WIDTH: 40 LENGTH: 112 HEIGHT: 14.79 / 16.46  
(BUILDING DIMENSIONS ARE NOMINAL. REFER TO PLANS).

SITE CLASS: \_\_\_\_\_

THIS STRUCTURE IS DESIGNED UTILIZING THE LOADS INDICATED AND APPLIED AS REQUIRED BY : IBC 18

OCCUPANCY CATEGORY: \_\_\_\_\_

SEISMIC DESIGN CATEGORY: \_\_\_\_\_

THE CONTRACTOR IS TO CONFIRM THAT THESE LOADS COMPLY WITH THE REQUIREMENTS OF THE LOCAL BUILDING DEPARTMENT.

<b>ROOF DEAD LOAD:</b>	<u>2.000</u> PSF (ROOF PANELS & PURLINS)		
<b>COLLATERAL LOAD:</b>	<u>0.5</u> PSF	<b>SNOW EXPOSURE:</b>	_____
<b>ROOF LIVE LOAD:</b>	<u>20.00</u> PSF	<b>WIND EXPOSURE:</b>	<u>C</u>
<b>ROOF SNOW LOAD:</b>	<u>14</u> PSF	<b>INTERNAL PRESSURE COEFF.:</b>	_____
<b>GROUND SNOW LOAD:</b>	_____ PSF		_____ / _____
<b>BASIC WIND SPEED:</b>	<u>110</u> MPH	<b>SPECTRAL RESPONSE COEFF.</b>	_____
<b>SEISMIC ZONE:</b>	<u>B</u>	Sds	_____
<b>THERMAL FACTOR:</b>	_____	Sd1	_____
<b>IMPORTANCE FACTORS:</b>		<b>DESIGN BASE SHEAR, V:</b>	_____
WIND LOAD	_____ 1.00	EXPANDED FORMULA	
SNOW LOAD	_____	LONGITUDINAL	<u>0.87</u>
SEISMIC LOAD	_____ 1.00	TRANSVERSE	<u>0.87</u>

**GENERAL NOTES:**

- 1) MATERIALS : MINIMUM YIELD:
- |                        |             |          |
|------------------------|-------------|----------|
| HOT ROLLED BAR         | Fy =        | ksi MIN. |
| STRUCTURAL STEEL SHEET | Fy =        | ksi MIN. |
| STRUCTURAL STEEL PLATE | Fy =        | ksi MIN. |
| COLD FORMED SHAPES     | Fy =        | ksi MIN. |
| WALL SHEETING          | Fy =        | ksi MIN. |
| ROOF SHEETING          | Fy =        | ksi MIN. |
| BOLTS                  | A307 & A325 |          |
- THE METAL BUILDING MANUFACTURER RESERVES THE RIGHT TO SUBSTITUTE THE ABOVE MATERIALS WITH EQUAL OR BETTER MATERIAL.

- 2) BOLT TIGHTENING REQUIREMENTS:
- ALL HIGH STRENGTH BOLTS ARE A325 UNLESS NOTED OTHERWISE. HIGH STRENGTH BOLTS SHALL BE TIGHTENED BY THE TURN OF THE NUT METHOD IN ACCORDANCE WITH THE LATEST EDITION AISC "SPECIFICATION FOR STRUCTURAL JOINTS USING ASTM A325 OR A490 BOLTS". A325 BOLTS SHALL BE INSTALLED WITH OUT WASHERS WHEN TIGHTENED BY THE "TURN OF THE NUT" METHOD. ALL BOLTED CONNECTIONS, FOR SHEAR/BEARING CONNECTION TYPE WITH BOLT THREADS EXCLUDED FROM THE SHEAR PLANE SHALL BE SNUG TIGHT ONLY.

- 3) ALL STRUCTURAL STEEL TO RECEIVE A RUST INHIBITIVE PRIMER. THIS PAINT IS NOT INTENDED FOR LONG TERM EXPOSURE TO THE ELEMENTS.

**ROOF PANELS:**

COLOR: \_\_\_\_\_ Galvalume+ w/ Drip Stop

**WALL PANELS:**

COLOR: \_\_\_\_\_ NEED SIG 200

**TRIM COLORS:**

CABLE: \_\_\_\_\_ NEED SIG 200

CORNER: \_\_\_\_\_ NEED SIG 200

EAVE: \_\_\_\_\_ NEED SIG 200

FRAMED OPENINGS: \_\_\_\_\_ NEED SIG 200

**LINER PANELS:**

COLOR: \_\_\_\_\_ N/A

**LINER TRIM:**

COLOR: \_\_\_\_\_ N/A

**DEFLECTION LIMTS:**

EW COL:	180
EW RAF LIVE:	180
EW RAF WIND:	180
WALL GIRT:	90
PURL LIVE:	180
PURL WIND:	150
WALL PANEL:	60
ROOF PANEL LIVE:	60
ROOF PANEL WIND:	60
RF HORIZONTAL:	180
RF VERTICAL:	60
WIND BENT:	60
RF CRANE:	0
RF SEIS:	0
WIND BENT SEIS:	0

**APPROVAL NOTES**

THE FOLLOWING CONDITIONS APPLY IN THE EVENT THAT THESE DRAWINGS ARE USED AS APPROVAL DRAWINGS: IT IS IMPERATIVE THAT ANY CHANGES TO THESE DRAWINGS BE MADE IN CONTRASTING INK (PREFERABLY RED INK), HAVE ALL INSTANCES OF CHANGE CLEARLY INDICATED, AND BE LEGIBLE AND UNAMBIGUOUS. A SIGNATURE AND DATE IS REQUIRED ON ALL PAGES. MANUFACTURER RESERVES THE RIGHT TO RE-SUBMIT DRAWINGS WITH EXTENSIVE OR COMPLEX CHANGES REQUIRED TO AVOID MISFABRICATION. THIS MAY IMPACT THE DELIVERY SCHEDULE. APPROVAL OF THESE DRAWINGS INDICATES CONCLUSIVELY THAT THE METAL BUILDING SYSTEM MANUFACTURER HAS CORRECTLY INTERPRETED THE CONTRACT REQUIREMENTS, AND FURTHER CONSTITUTES AGREEMENT THAT THE BUILDING AS DRAWN WITH INDICATED CHANGES REPRESENTS THE TOTAL OF THE MATERIALS TO BE SUPPLIED BY MANUFACTURER. ANY CHANGES NOTED ON THE DRAWINGS NOT IN COMFORMANCE WITH THE TERMS AND REQUIREMENTS OF THE CONTRACT BETWEEN MANUFACTURER AND ITS CUSTOMER ARE NOT BINDING ON MANUFACTURER UNLESS SUBSEQUENTLY SPECIFICALLY ACKNOWLEDGED AND AGREED TO IN WRITING BY CHANGE ORDER OR SEPARATE DOCUMENTATION. MANUFACTURER RECONGNIZES THAT RUBBER STAMPS ARE ROUTINELY USED FOR INDICATING APPROVAL, DISAPPROVAL, REJECTION, OR MERE REVIEW OF THE DRAWINGS SUBMITTED. HOWEVER, MANUFACTURER DOES NOT ACCEPT CHANGES OR ADDITIONS TO CONTRACTUAL TERMS AND CONDITIONS THAT MAY APPEAR WITH USE OF A STAMP OR SIMILIAR INDICATIOIN OF APPROVAL, DISAPPROVAL, ETC. SUCH LANGUAGE APPLIED TO MANUFACTURER'S DRAWINGS BY THE CUSTOMER, ARCHITECT, ENGINEER, OR ANY OTHER PARTY WILL BE CONSIDERED AS UNACCEPTABLE ALTERNATIONS TO THESE DRAWING NOTES, AND WILL NOT ALTER THE CONTRACTUAL RIGHTS AND OBLIGATIONS EXISTING BETWEEN MANUFACTURER AND ITS CUSTOMER.


**IMPORTANT NOTE: FINAL DETAILING, FABRICATION, AND DELIVERY DATE OF THIS PROJECT CANNOT BE COMPLETED UNTIL THE SIGNED APPROVALS ARE RETURNED TO THE METAL BUILDING MANUFACTURER.**

△		
△		
△		
△		
△	..J..	FOR CONSTRUCTION
△	..J..	FOR APPROVAL
REV.	DATE	REVISION


PURCHASER: DLR  
PROJECT: MEGA STORAGE LEE SUMMIT 4,5  
JOB NUMBER: MEGASTORAGELEESUMMITBUILDING#4#5


DOOR SCHEDULE			
ID	QUAN	DESCRIPTION	COLOR
1	8	Janus 1214 M1950 Rollup	Silhouette Gray

COMPARTMENT TABLE			
ID	QUAN	WIDTH	LENGTH
1	8	14'-0"	40'-0"

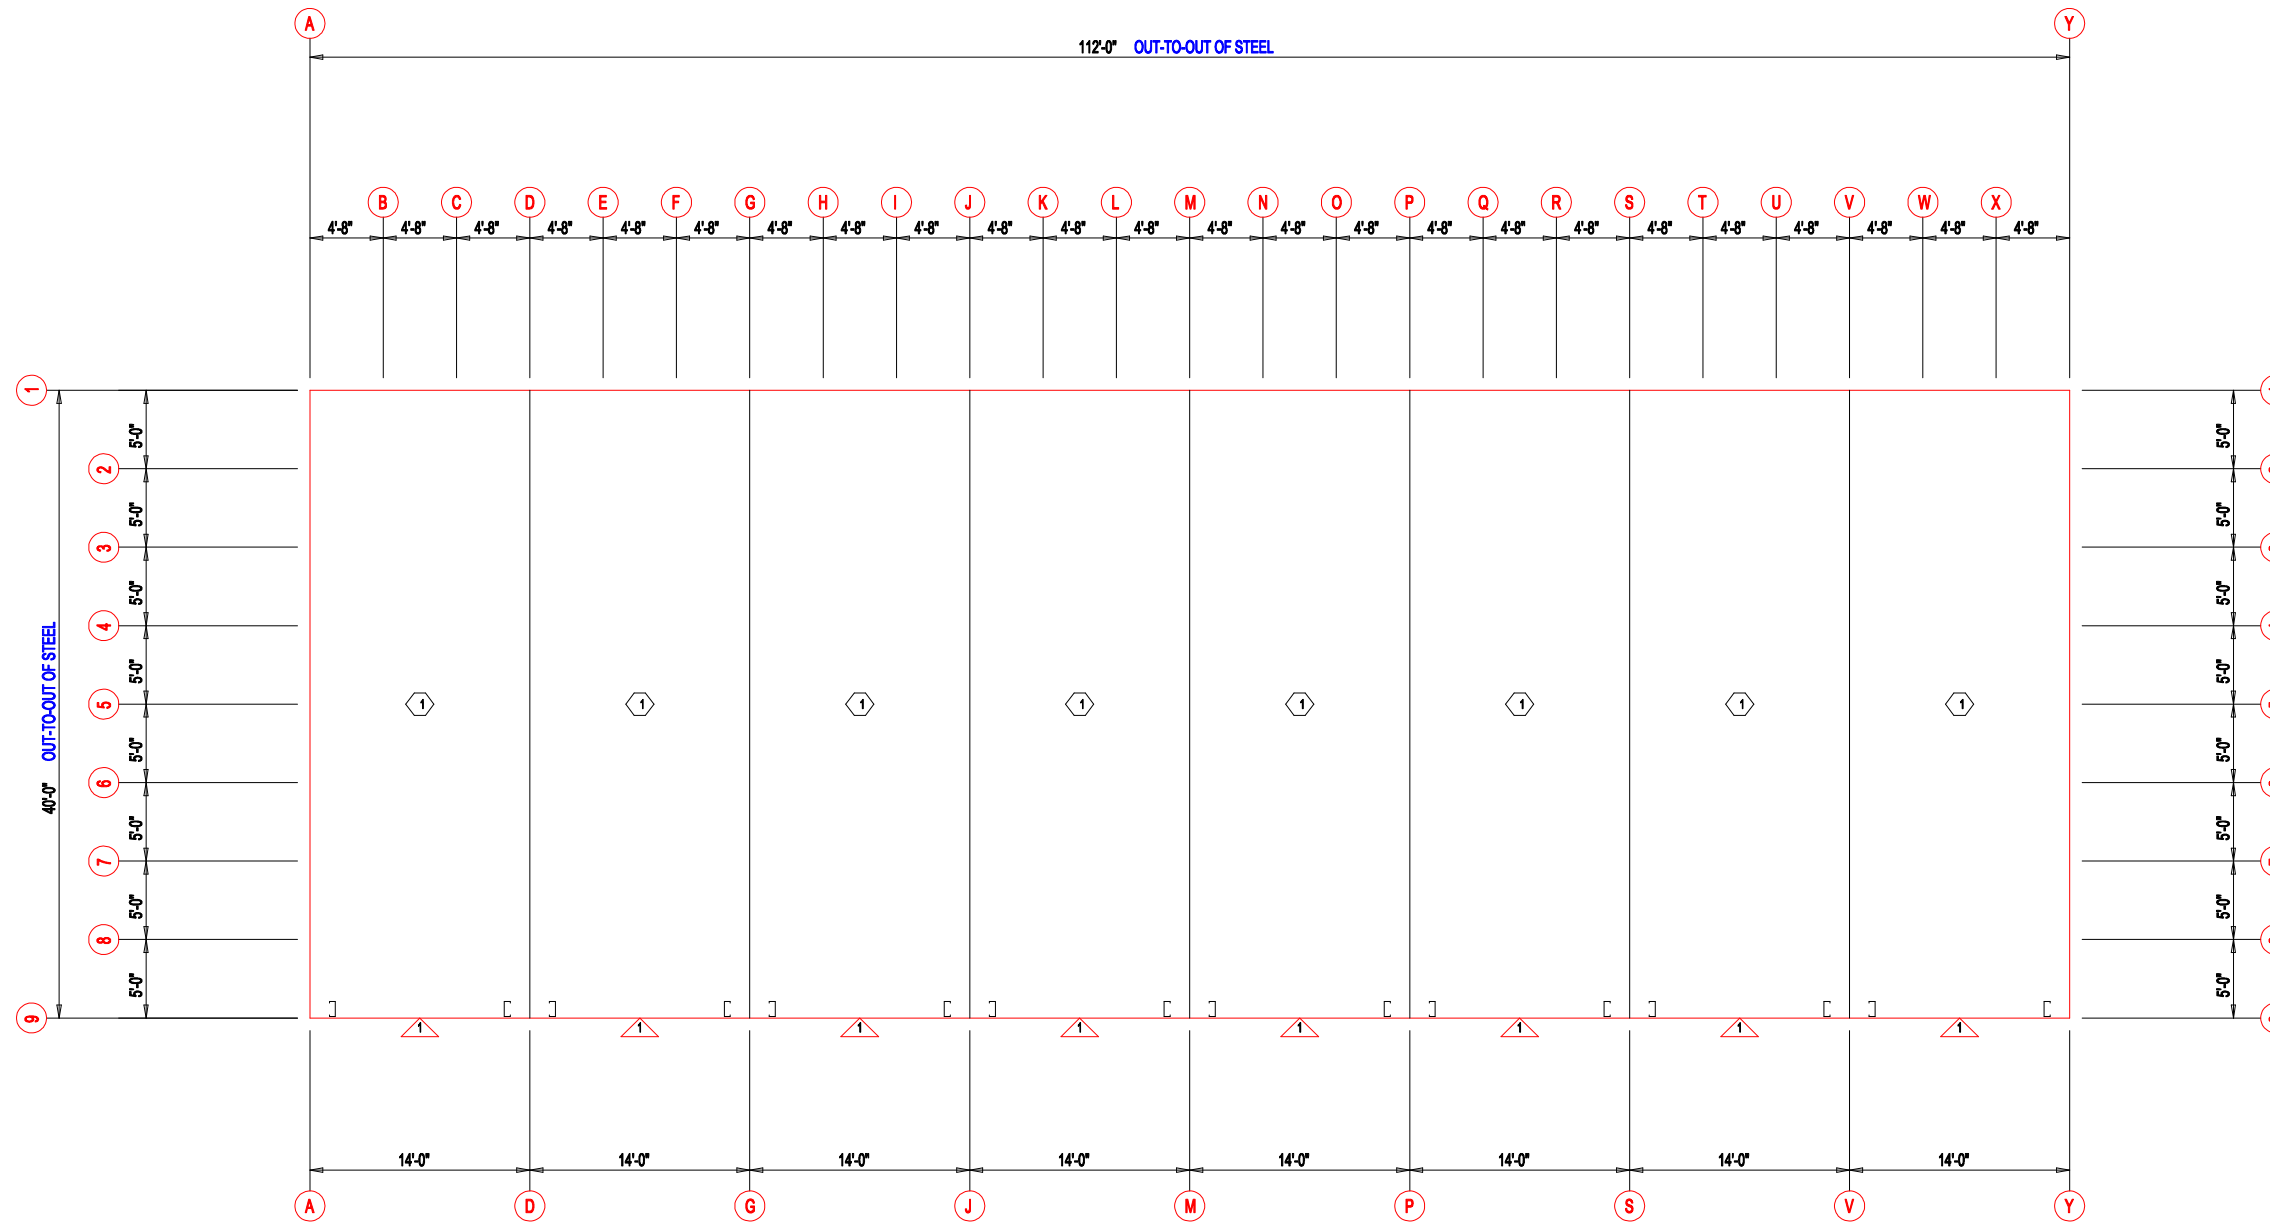

FLOOR PLAN

 <p>906 West 9th Street Pella, IA 50219 (800) 225-0481 www.pellabuildings.com</p>	DESCRIPTION: FLOOR PLAN		PROJECT: MEGA STORAGE LEE SUMMIT 4,5		
	CUSTOMER: DLR		LOCATION: LEES SUMMIT MO		
	DRN. BY: JB	CK'D BY: DES	DATE: 1/17/22	SCALE: N.T.S.	REV. 00
	QUOTATION NO. MEGASTORAGELEESUMMITBUILDING#4#5		SHEET NO.		

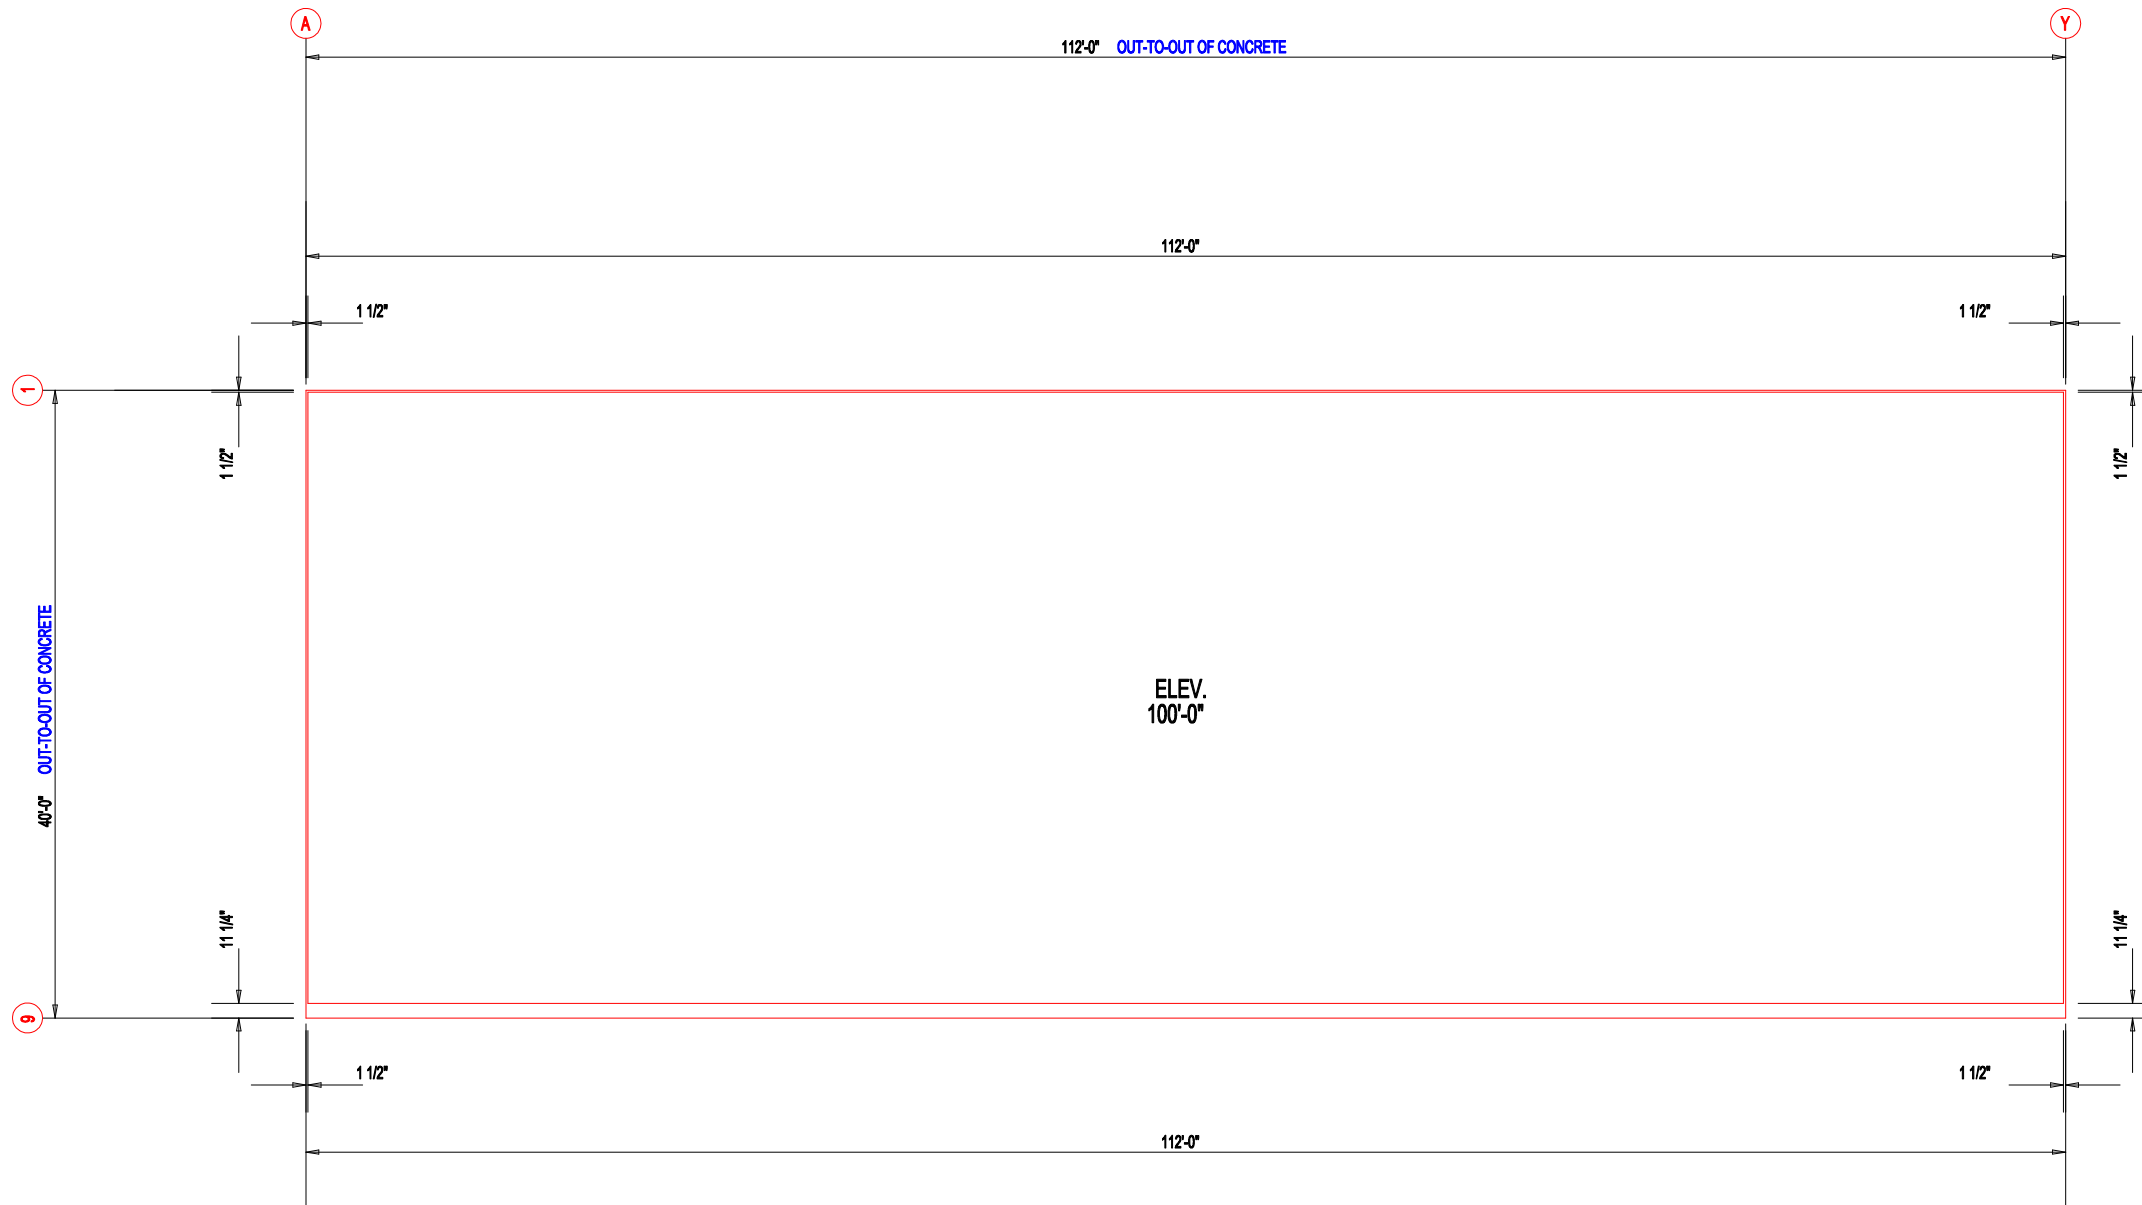


ANCHOR PLAN



906 West 9th Street Pella, IA 50219  
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DESCRIPTION: ANCHOR PLAN					
CUSTOMER: DLR			PROJECT: MEGA STORAGE LEE SUMMIT 4,5		
LOCATION: LEES SUMMIT MO					
DRN. BY	CK'D BY	DATE	SCALE	REV.	QUOTATION NO.
JB	DES	1/17/22	N.T.S.	00	MEGASTORAGELEESUMMITBUILDING#4#5
					SHEET NO.
					4#5

MEMBER TABLE		
MARK	PART	LENGTH
S-1	6X2C16	14'-9 1/2"
S-2	6X2C16	15'-0"
S-3	6X2C16	15'-2 1/2"
S-4	6X2C16	15'-5"
S-5	6X2C16	15'-7 1/2"
S-6	6X2C16	15'-10"
S-7	6X2C16	16'-0 1/2"
S-8	6X2C16	16'-3"
S-9	6X2C16	16'-7"

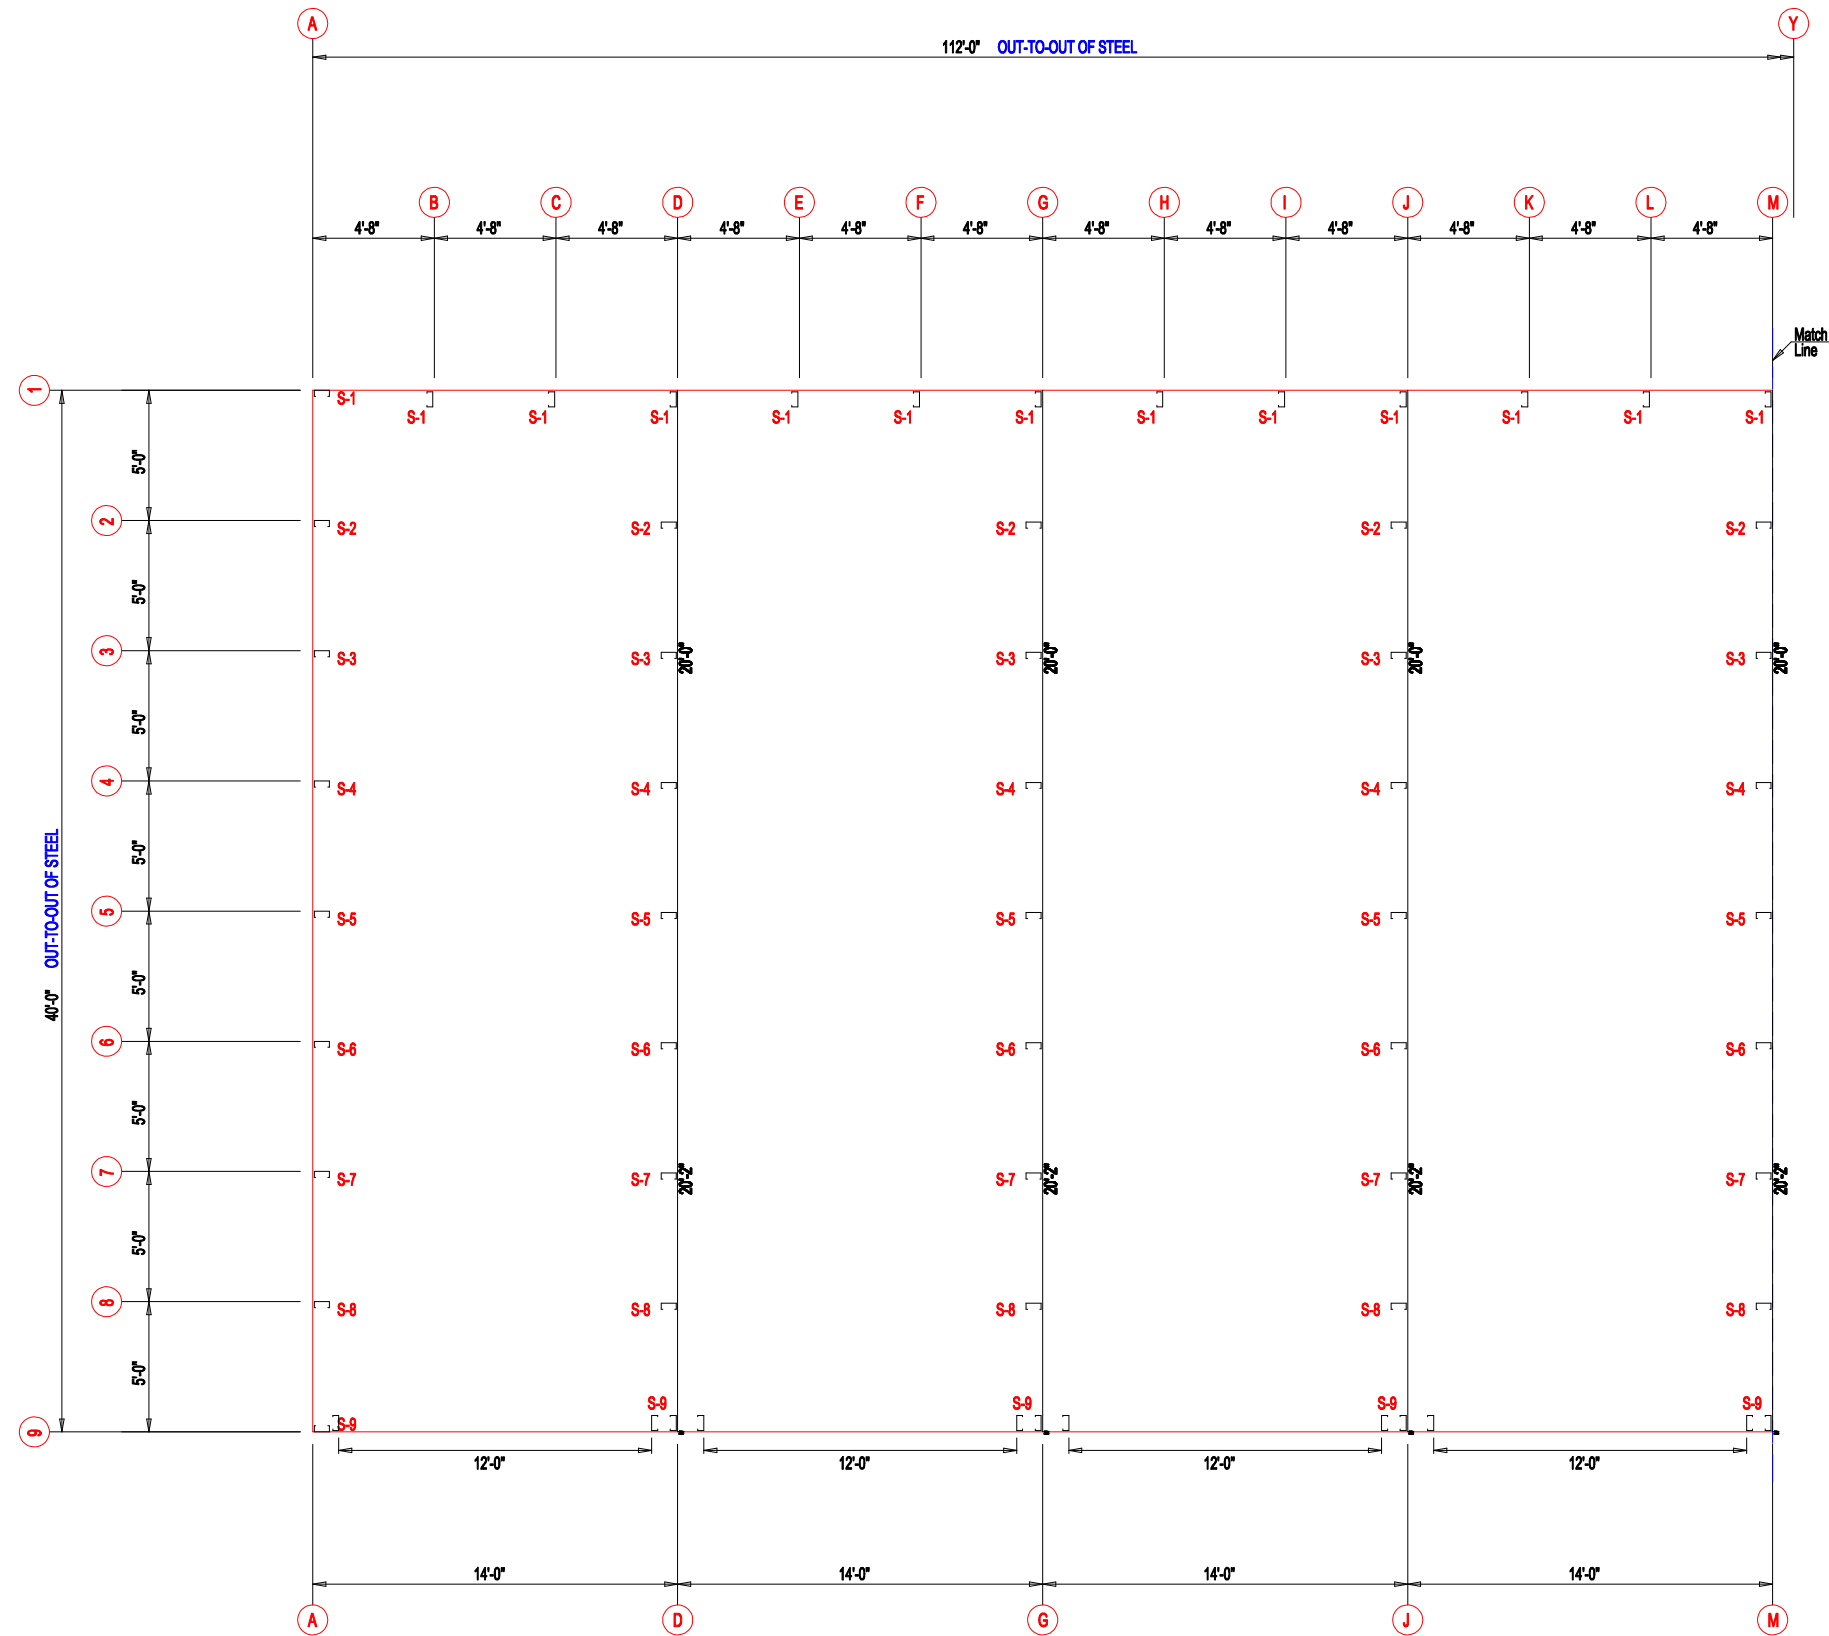


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LOCATION: LEES SUMMIT MO					
DRN. BY JB	CK'D BY DES	DATE 1/17/22	SCALE N.T.S.	REV. 00	QUOTATION NO. MEGASTORAGELEESUMMITBUILDING#4#5
					SHEET NO.




FLOOR PLAN


MEMBER TABLE		
MARK	PART	LENGTH
S-1	6X2C16	14'-9 1/2"
S-2	6X2C16	15'-0"
S-3	6X2C16	15'-2 1/2"
S-4	6X2C16	15'-5"
S-5	6X2C16	15'-7 1/2"
S-6	6X2C16	15'-10"
S-7	6X2C16	16'-0 1/2"
S-8	6X2C16	16'-3"
S-9	6X2C16	16'-7"
S-10	6X25C14	14'-9 1/2"

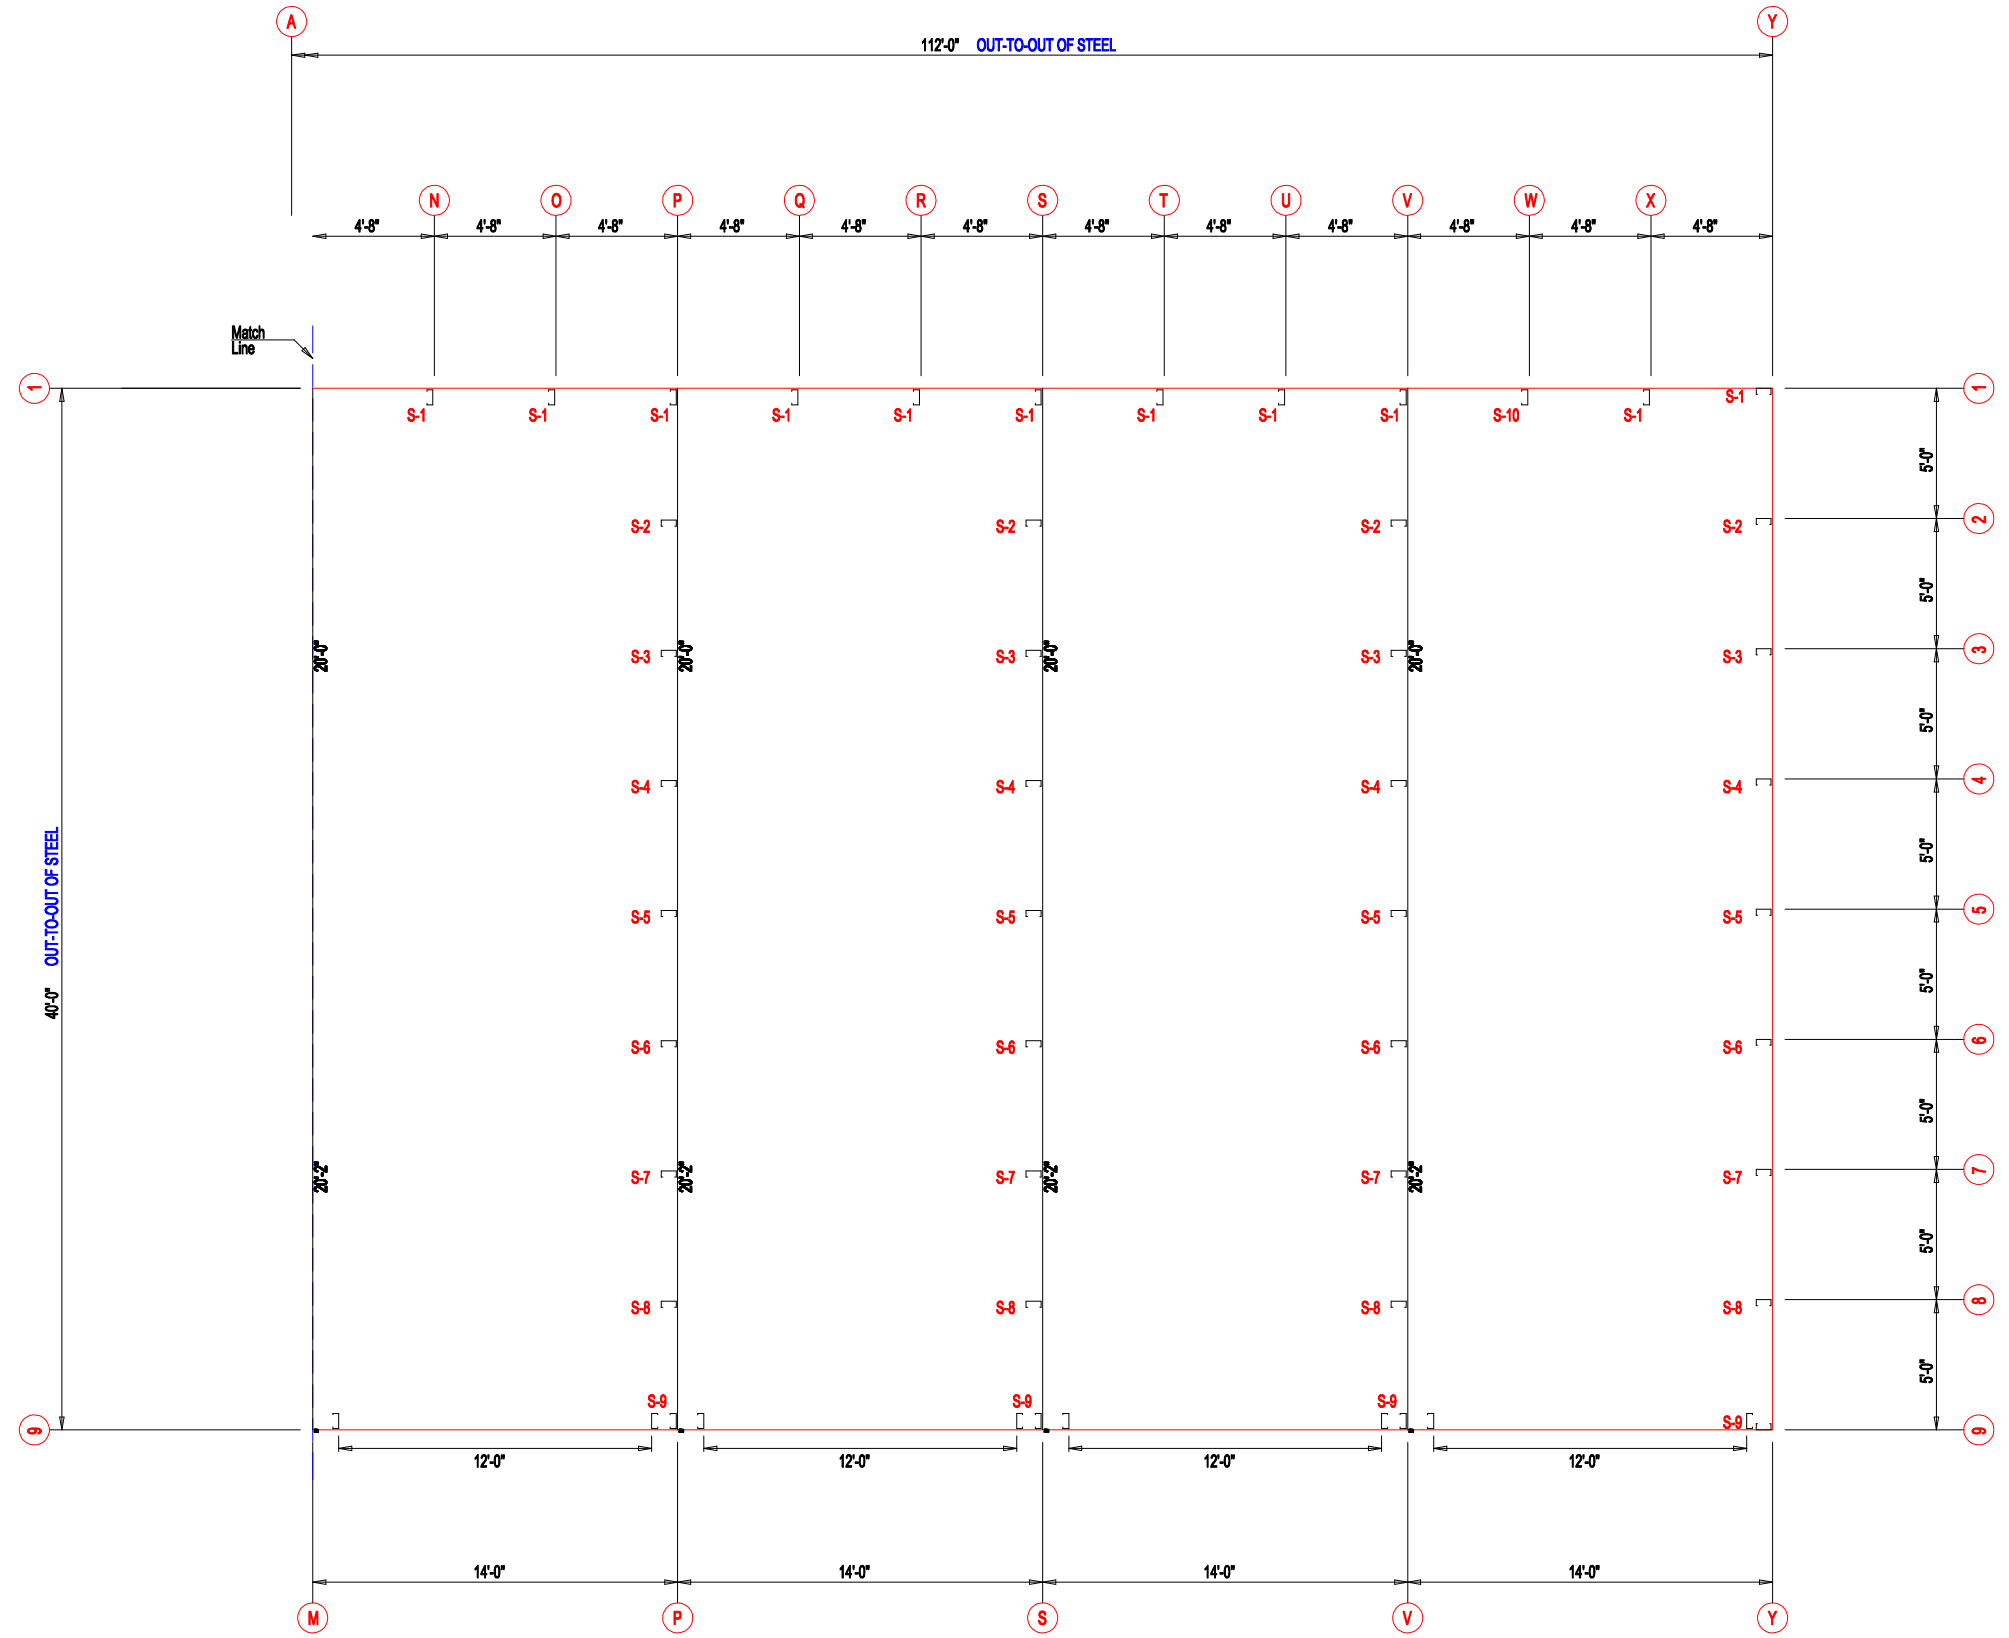

DESCRIPTION: FLOOR PLAN					
CUSTOMER: DLR			PROJECT: MEGA STORAGE LEE SUMMIT 4,5		
LOCATION: LEES SUMMIT MO					
DRN. BY	CK'D BY	DATE	SCALE	REV.	QUOTATION NO.
JB	DES	1/17/22	N.T.S.	00	MEGASTORAGELEESUMMITBUILDING#4,5
					SHEET NO.
					MEGASTORAGELEESUMMITBUILDING#4,5

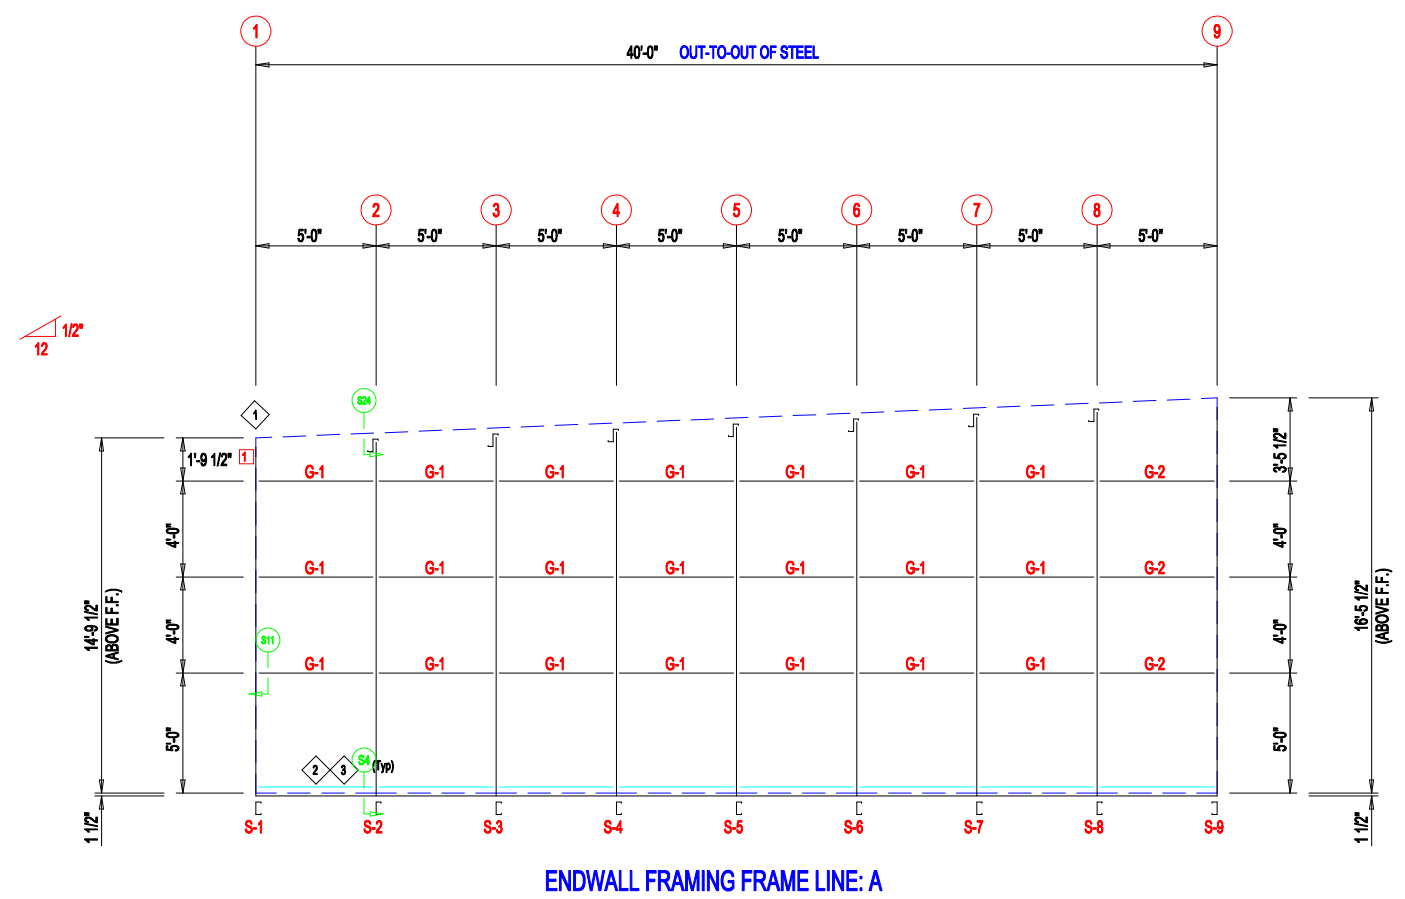

ENDWALL FRAMING FRAME LINE: A

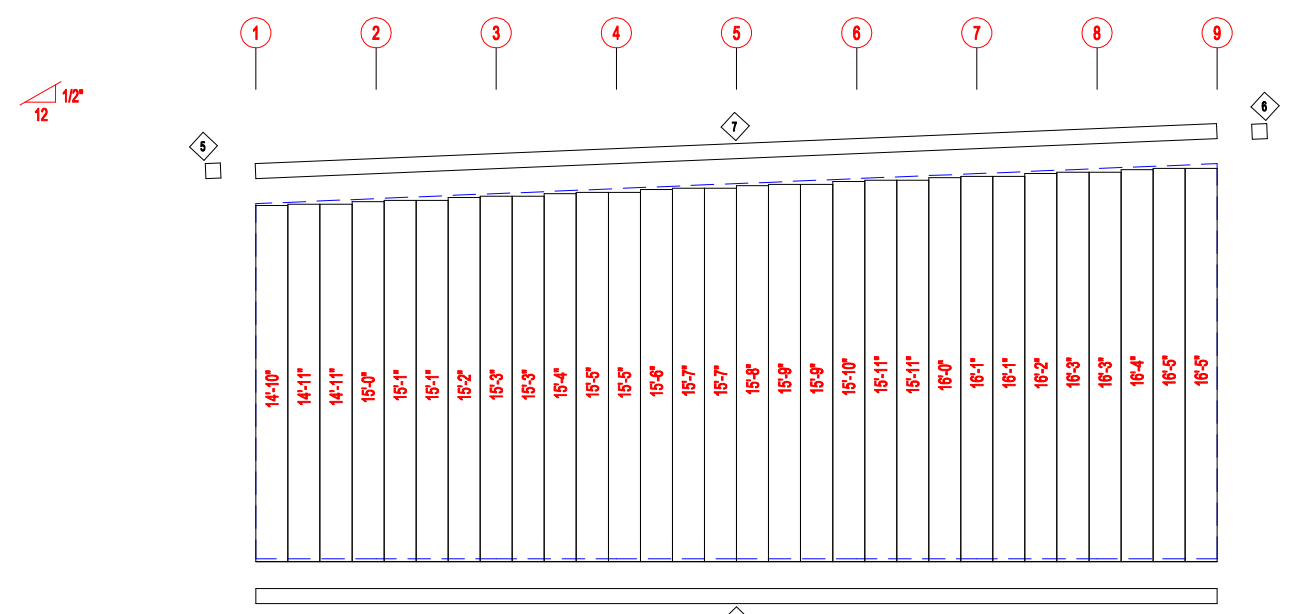

ENDWALL SHEETING & TRIM FRAME LINE: A

PANELS: 20 Ga. CP - NEED SIG 200

TRIM TABLE			
ID	PART	LENGTH	DETAIL
4	FL72	10'-2"	TRIM_74
5	FL16A	6"	
6	FL16A	6"	
7	FL16D	20'-2"	TRIM_229


MEMBER TABLE		
MARK	PART	LENGTH
S-1	6X2C16	14'-9 1/2"
S-2	6X2C16	15'-0"
S-3	6X2C16	15'-2 1/2"
S-4	6X2C16	15'-5"
S-5	6X2C16	15'-7 1/2"
S-6	6X2C16	15'-10"
S-7	6X2C16	16'-0 1/2"
S-8	6X2C16	16'-3"
S-9	6X2C16	16'-7"
G-1	4X25Z16	4'-9 1/2"
G-2	4X25Z16	4'-7 1/2"

ANGLE TABLE		
ID	MARK	LENGTH
1	L3x3	20'-0"
2	BC-6	20'-0"
3	BC-6	SCRAP


CONNECTION PLATES	
ID	MARK/PART
1	MCLP



DESCRIPTION: ENDWALL DRAWING		PROJECT: MEGA STORAGE LEE SUMMIT 4,5	
CUSTOMER: DLR		LOCATION: LEES SUMMIT MO	
DRN. BY: JB	CKD BY: DES	DATE: 1/17/22	SCALE: N.T.S.
REV: 00	QUOTATION NO. MEGASTORAGELEESUMMITBUILDING#4#5	SHEET NO.	

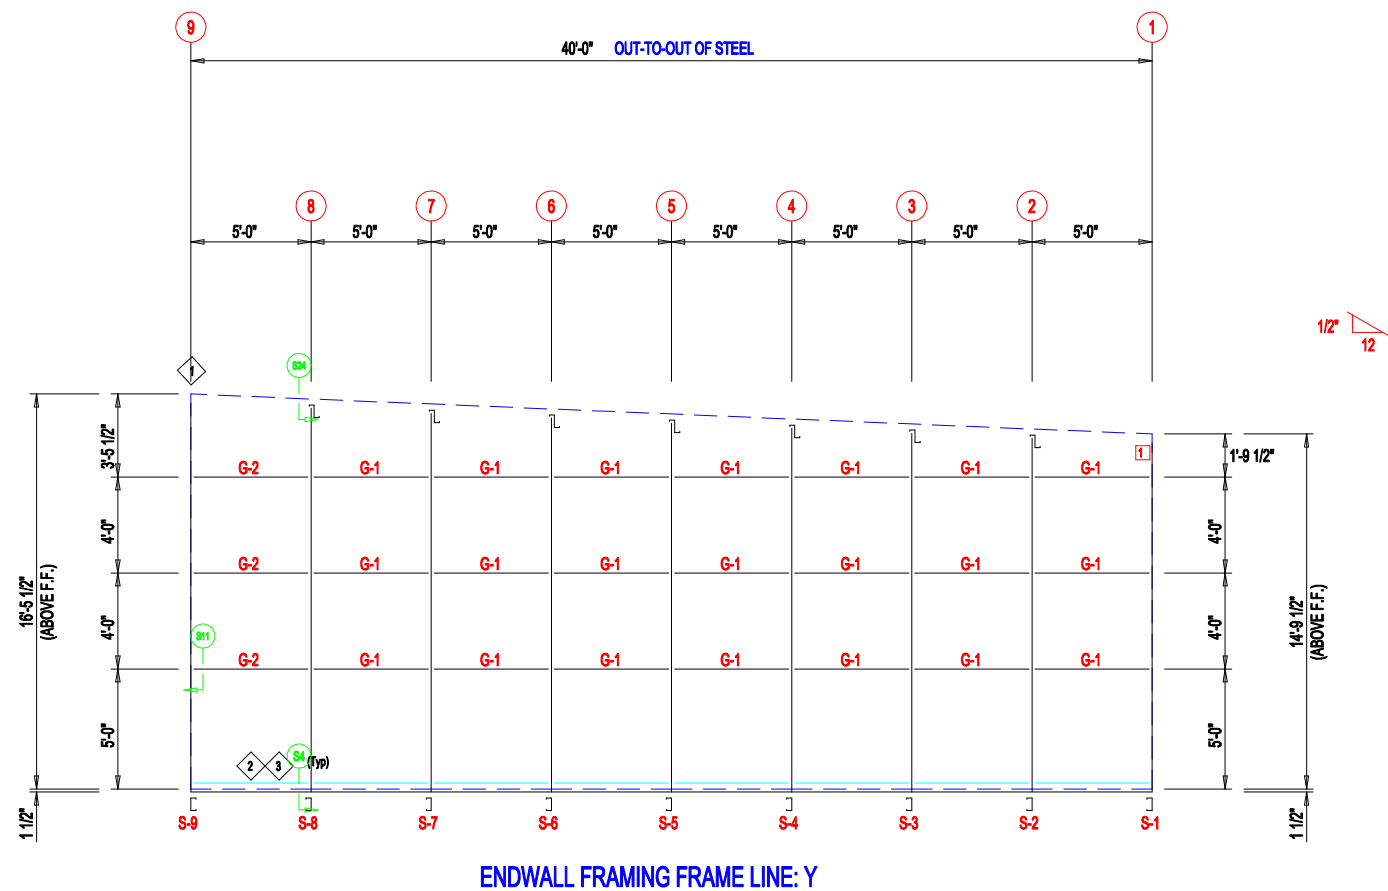

ENDWALL FRAMING FRAME LINE: Y

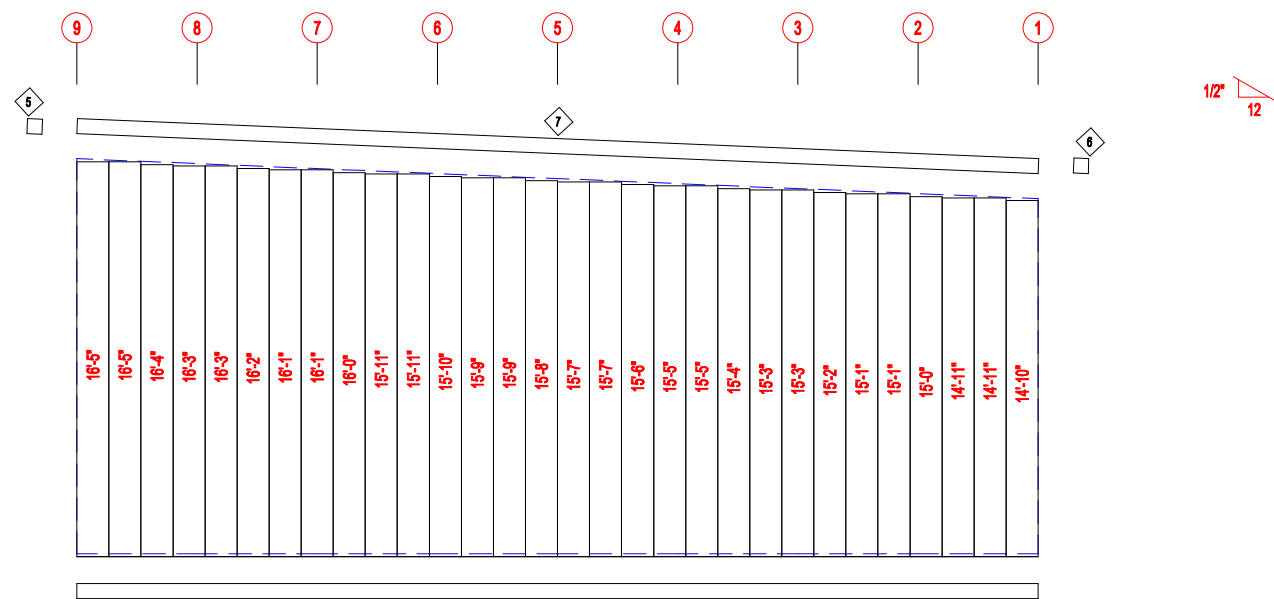

ENDWALL SHEETING & TRIM FRAME LINE: Y

PANELS: 20 Ga. CP - NEED SIG 200

TRIM TABLE			
ID	PART	LENGTH	DETAIL
4	FL72	10'-2"	TRIM_74
5	FL16A	6"	
6	FL16A	6"	
7	FL16D	20'-2"	TRIM_229

MEMBER TABLE		
MARK	PART	LENGTH
S-1	6X2C16	14'-9 1/2"
S-2	6X2C16	15'-0"
S-3	6X2C16	15'-2 1/2"
S-4	6X2C16	15'-5"
S-5	6X2C16	15'-7 1/2"
S-6	6X2C16	15'-10"
S-7	6X2C16	16'-0 1/2"
S-8	6X2C16	16'-3"
S-9	6X2C16	16'-7"
G-1	4X25Z16	4'-9 1/2"
G-2	4X25Z16	4'-7 1/2"

ANGLE TABLE		
ID	MARK	LENGTH
1	L3x3	20'-0"
2	BC-6	20'-0"
3	BC-6	SCRAP

CONNECTION PLATES	
ID	MARK/PART
1	MCLP




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DESCRIPTION: ENDWALL DRAWING					
CUSTOMER: DLR			PROJECT: MEGA STORAGE LEE SUMMIT 4,5		
LOCATION: LEES SUMMIT MO					
DRN. BY	CKD BY	DATE	SCALE	REV.	QUOTATION NO.
JB	DES	1/17/22	N.T.S.	00	MEGASTORAGELEESUMMITBUILDING#4#5
					SHEET NO.

MEMBER TABLE		
MARK	PART	LENGTH
S-9	6X2C16	16'-7"
DJ-1	6X35C16	16'-7"
TC-1	6X2CH16	13'-11 3/4"
TC-2	6X2CH16	14'-0"
DH-1	6X25C16	11'-11 1/2"

ANGLE TABLE		
◇ ID	MARK	LENGTH
1	MB612	11 3/4"
2	MB624	1'-11 3/4"

CONNECTION PLATES		
□ ID	MARK/PART	
1	MCLP	

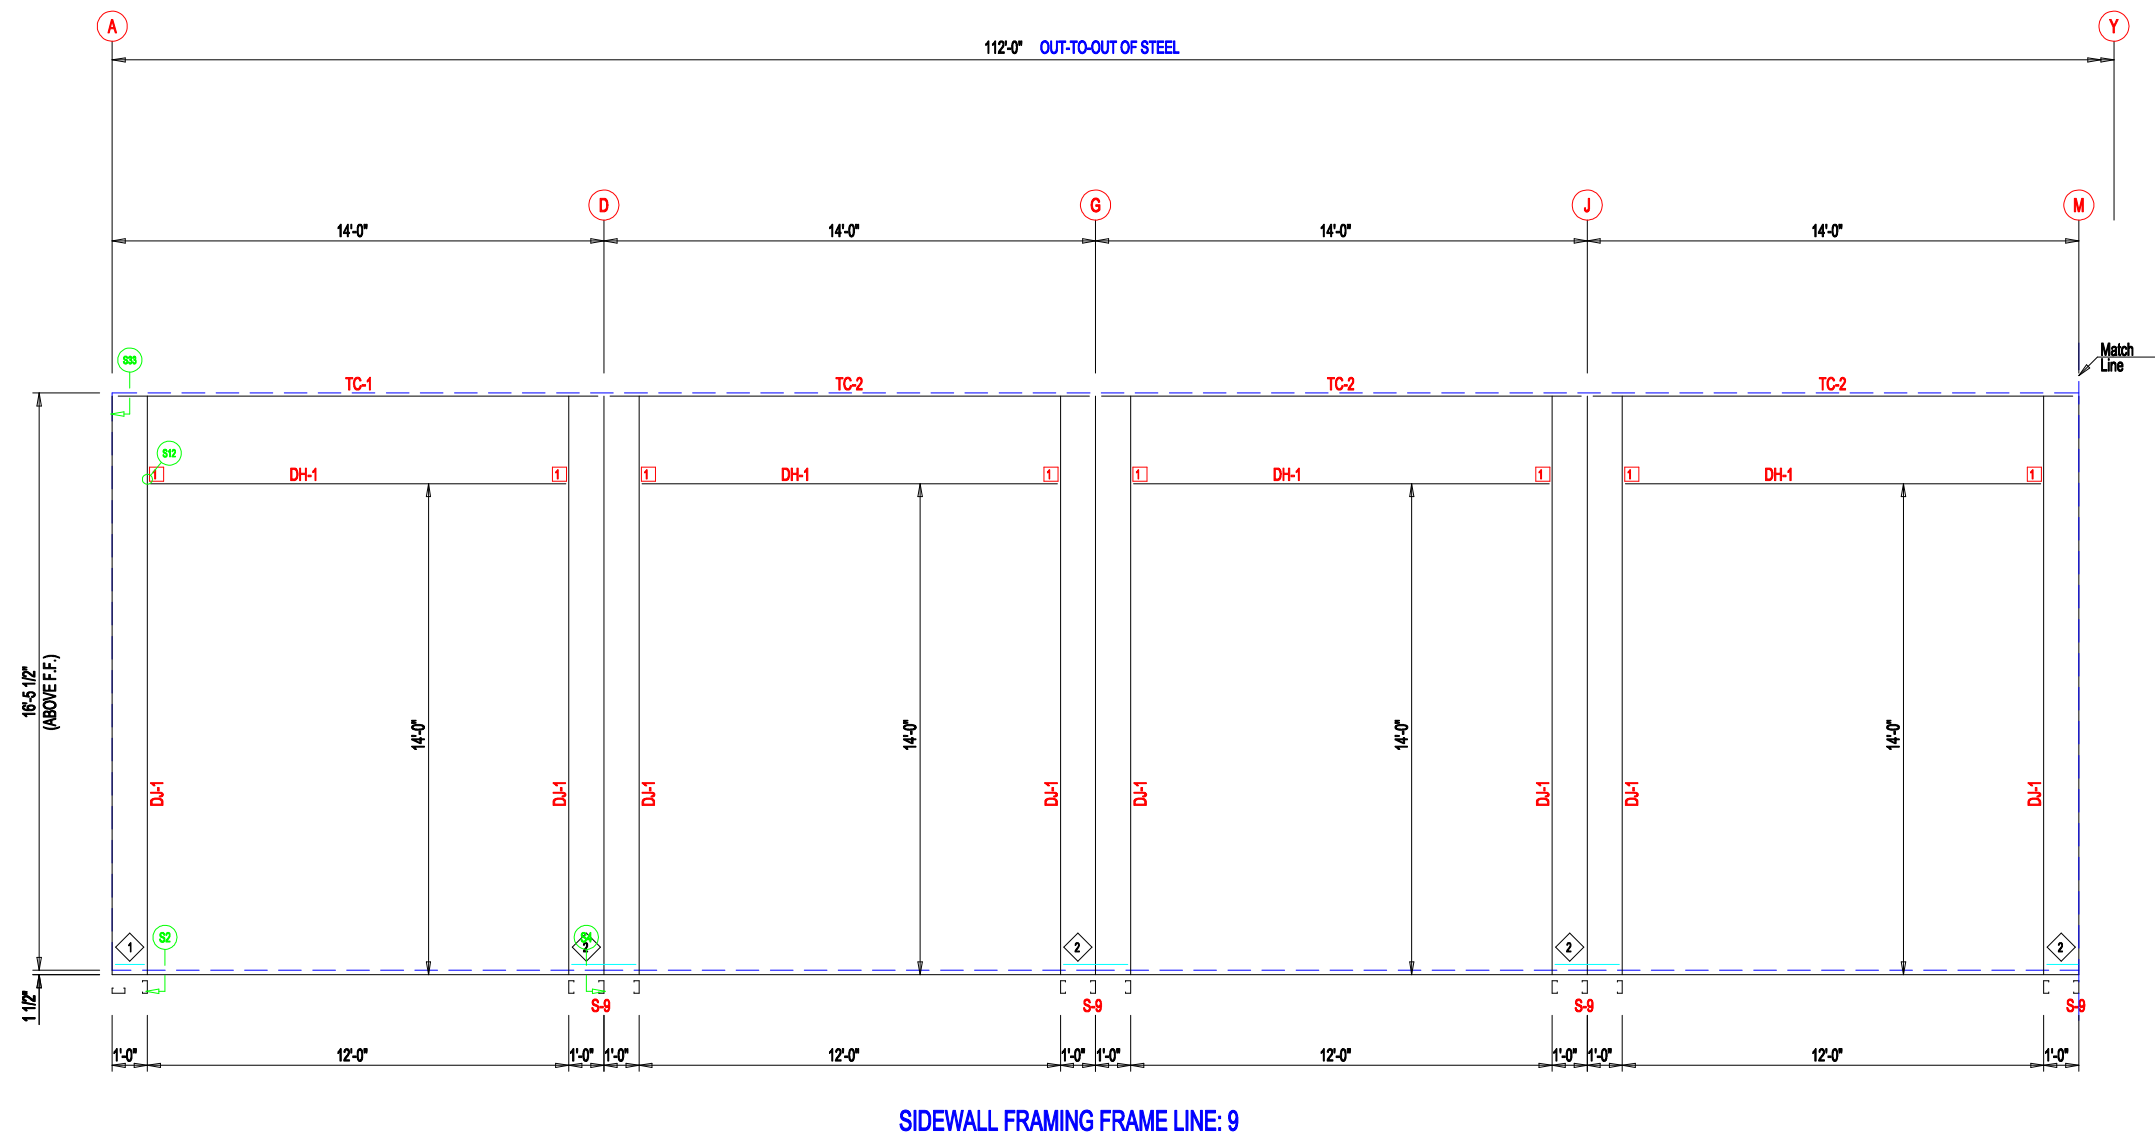

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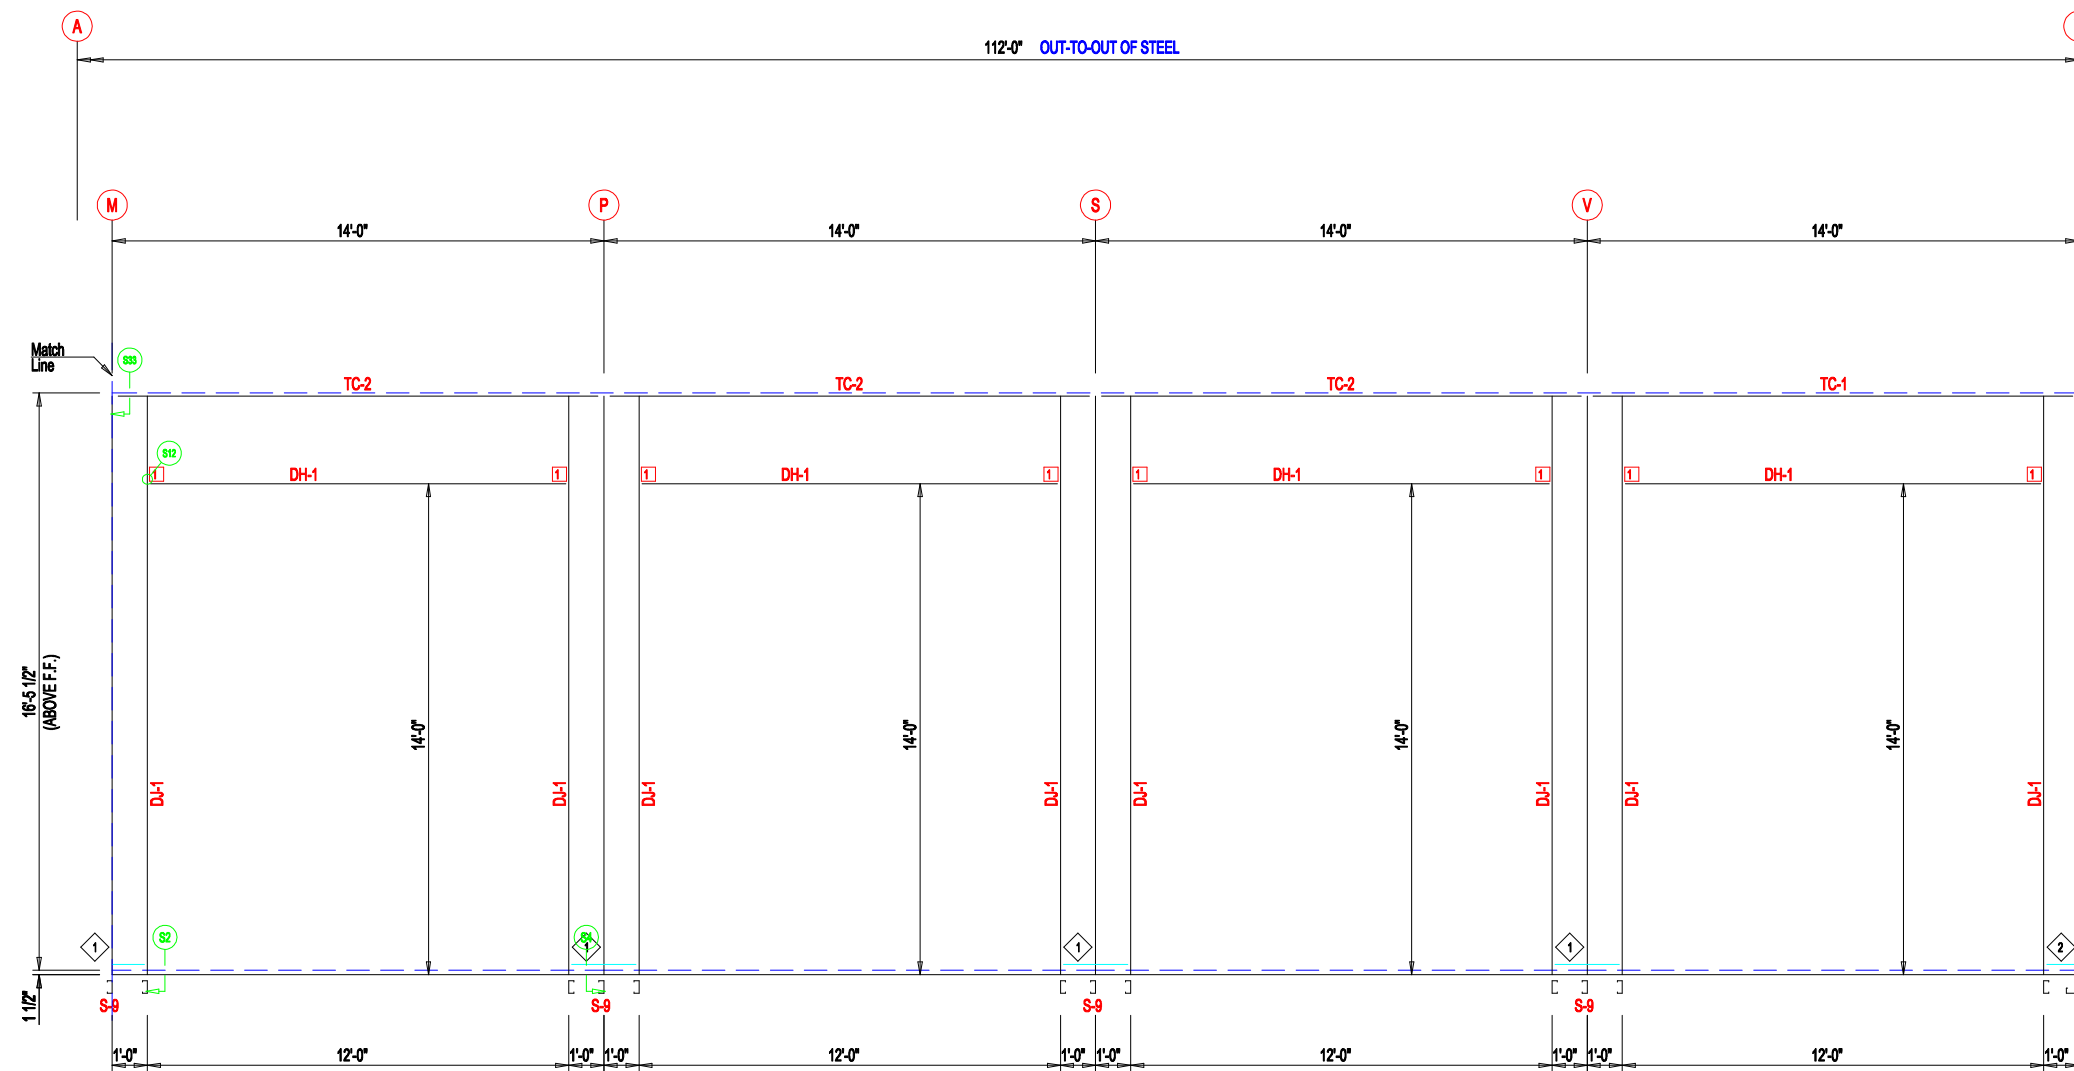
DESCRIPTION: <b>SIDEWALL FRAMING</b>					
CUSTOMER: DLR			PROJECT: MEGA STORAGE LEE SUMMIT 4,5		
LOCATION: LEES SUMMIT MO					
DRN. BY	CKD BY	DATE	SCALE	REV.	QUOTATION NO.
JB	DES	1/17/22	N.T.S.	00	MEGASTORAGELEESUMMITBUILDING#4#5
					SHEET NO.
					MEGASTORAGELEESUMMITBUILDING#4#5



MEMBER TABLE		
MARK	PART	LENGTH
S-9	6X2C16	16'-7"
DJ-1	6X35C16	16'-7"
TC-1	6X2CH16	13'-11 3/4"
TC-2	6X2CH16	14'-0"
DH-1	6X25C16	11'-11 1/2"

ANGLE TABLE		
◇ ID	MARK	LENGTH
1	MB624	1'-11 3/4"
2	MB612	11 3/4"


CONNECTION PLATES		
□ ID	MARK/PART	
1	MCLP	




SIDEWALL FRAMING FRAME LINE: 9



DESCRIPTION: SIDEWALL FRAMING					
CUSTOMER: DLR			PROJECT: MEGA STORAGE LEE SUMMIT 4,5		
LOCATION: LEES SUMMIT MO					
DRN. BY JB	CKD BY DES	DATE 1/17/22	SCALE N.T.S.	REV. 00	QUOTATION NO. MEGASTORAGELEESUMMITBUILDING#4#5
					SHEET NO.

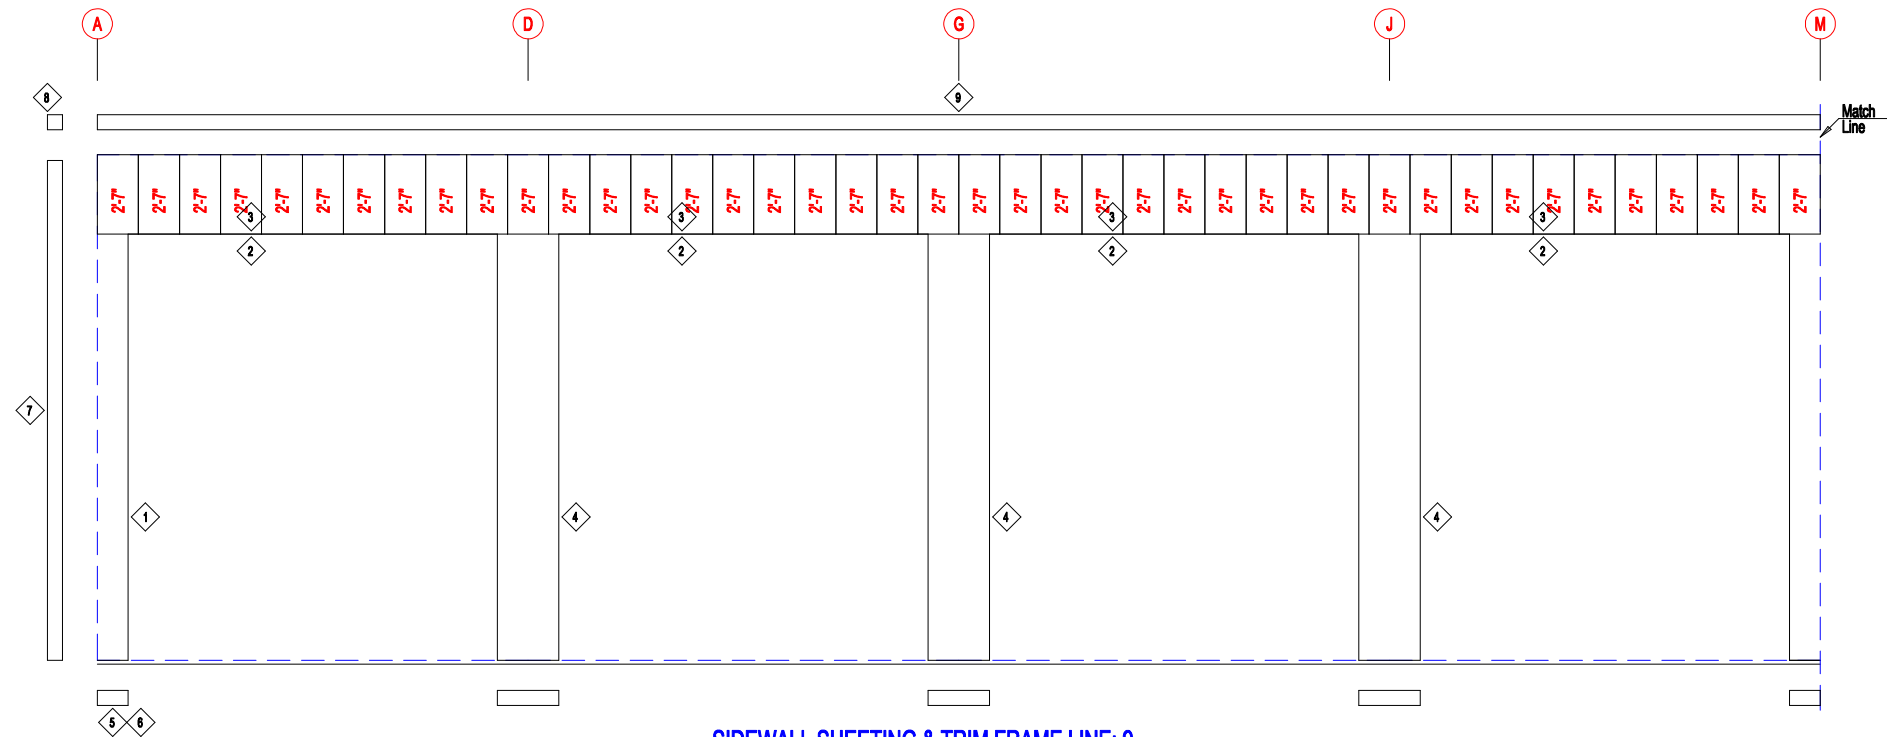

**SIDEWALL SHEETING & TRIM FRAME LINE: 9**  
 PANELS: 20 Ga. CP - NEED SIG 200

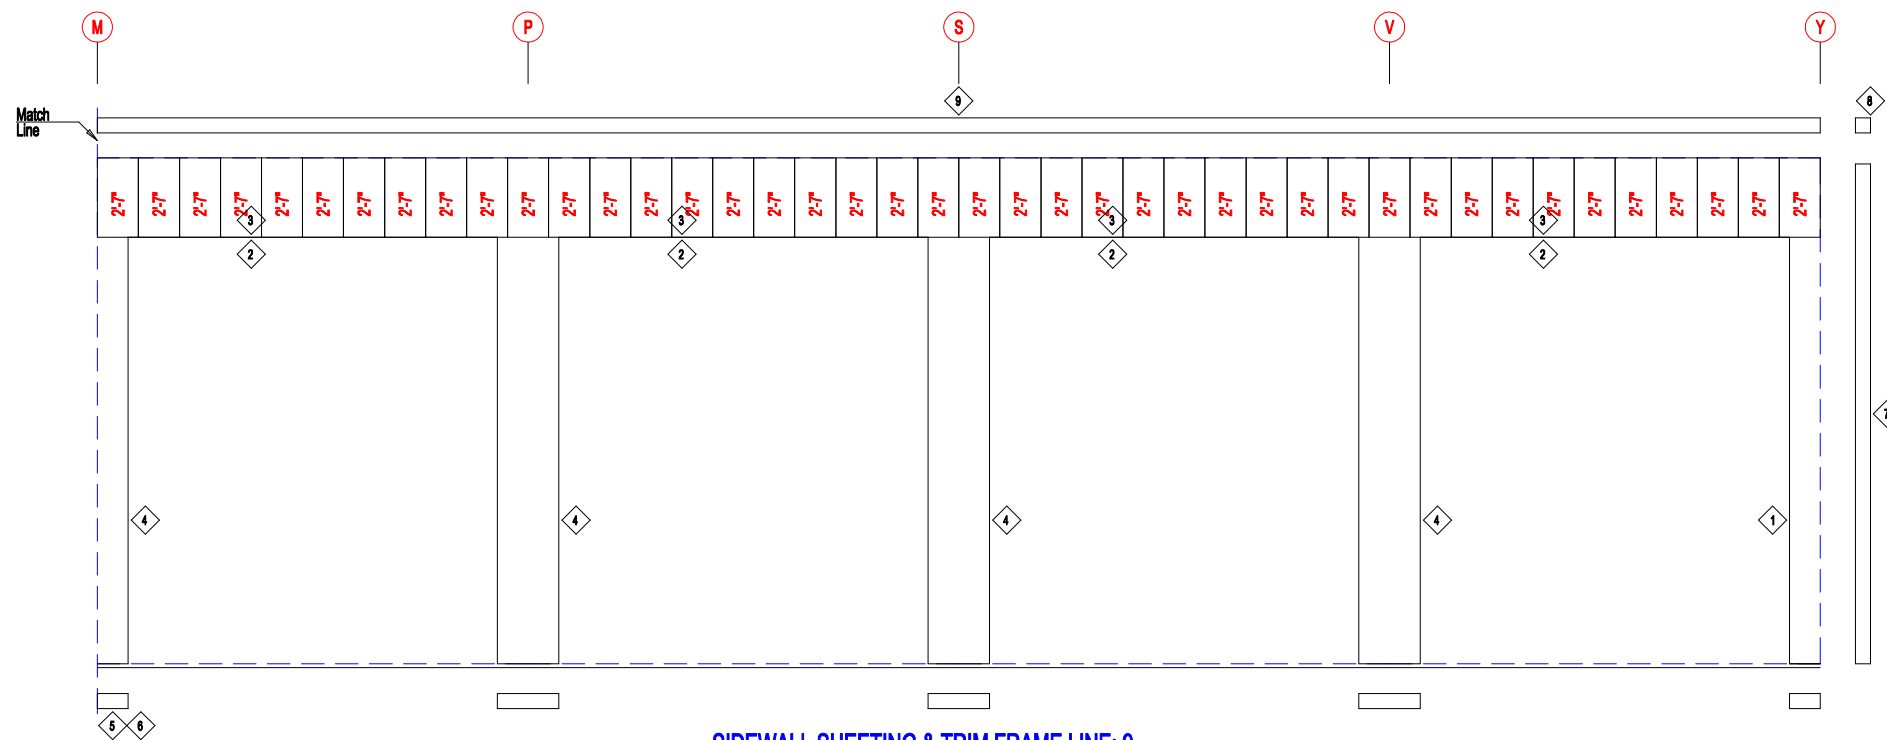


**SIDEWALL SHEETING & TRIM FRAME LINE: 9**  
 PANELS: 20 Ga. CP - NEED SIG 200


TRIM TABLE			
ID	PART	LENGTH	DETAIL
1	6MCE12	14'-1"	
2	FL-HC6	12'-1"	TRIM_235
3	FL26B	20'-2"	TRIM_232
4	6MC24	14'-1"	
5	FL72	10'-2"	TRIM_74
6	FL72	SCRAP	TRIM_74
7	FL835x	16'-7"	TRIM_198
8	FL16C	6"	
9	FL17A	20'-2"	TRIM_322



DESCRIPTION: <b>SIDEWALL SHEETING</b>					
CUSTOMER: DLR			PROJECT: MEGA STORAGE LEE SUMMIT 4,5		
LOCATION: LEES SUMMIT MO					
DRN. BY	CK'D BY	DATE	SCALE	REV.	QUOTATION NO.
JB	DES	1/17/22	N.T.S.	00	MEGASTORAGELEESUMMITBUILDING#4#5
					SHEET NO.

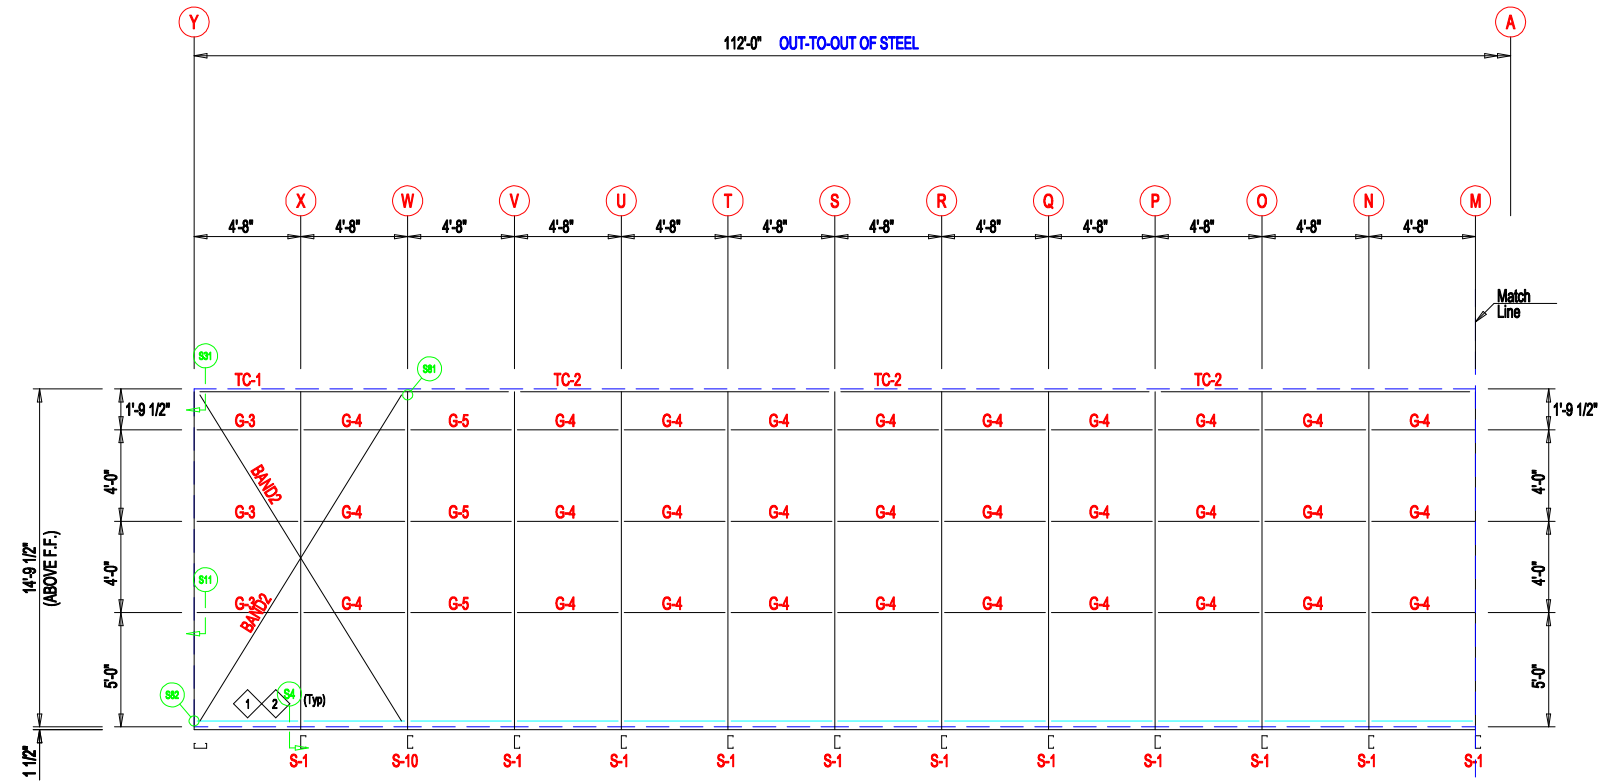

SIDEWALL FRAMING FRAME LINE: 1

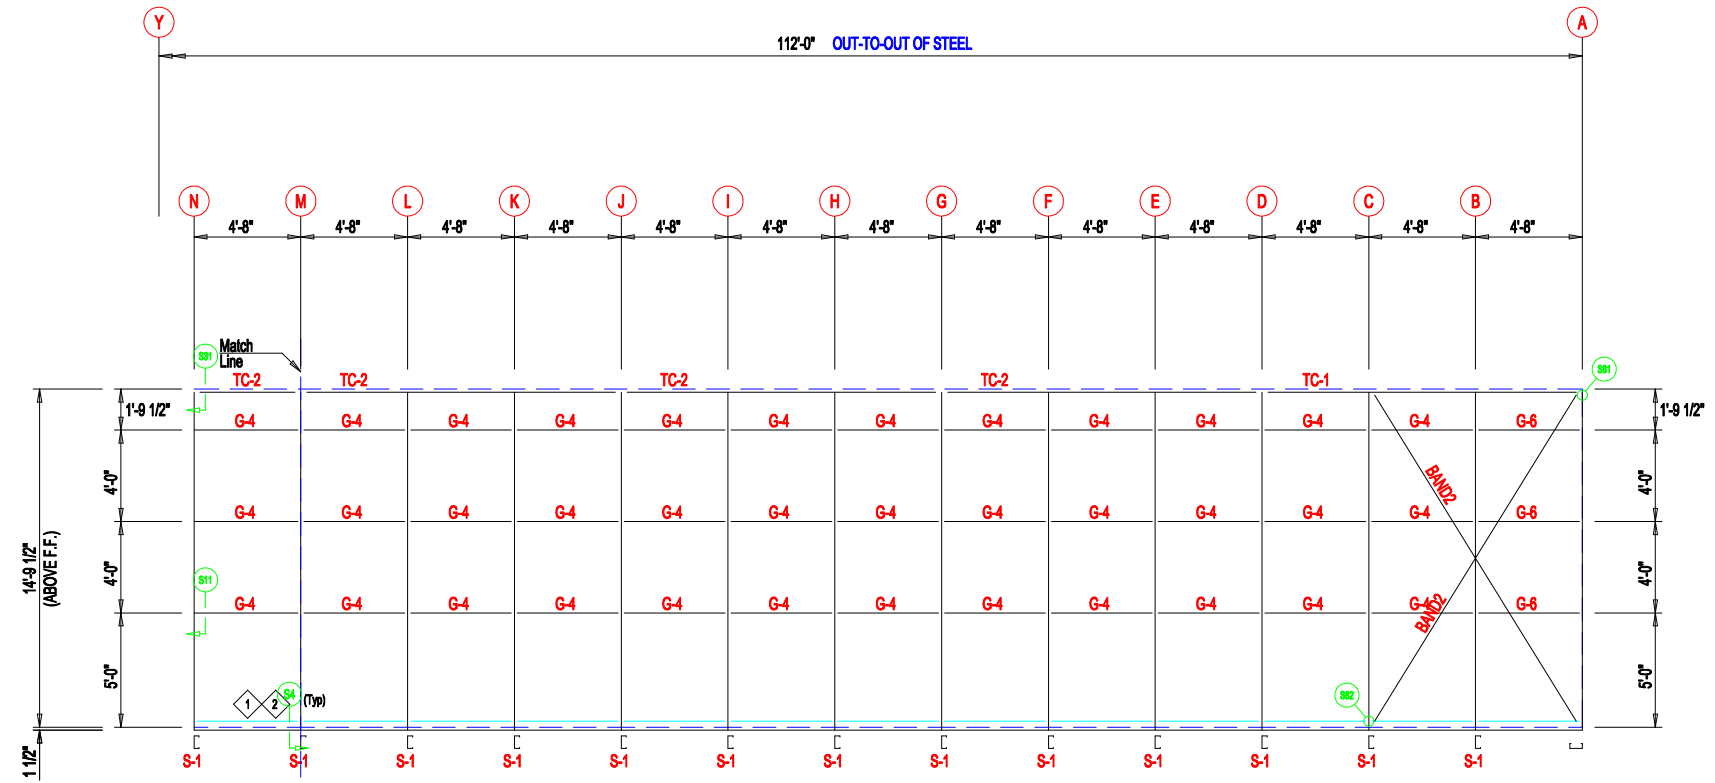

SIDEWALL FRAMING FRAME LINE: 1


MEMBER TABLE		
MARK	PART	LENGTH
S-1	6X2C16	14'-9 1/2"
S-10	6X25C14	14'-9 1/2"
TC-1	6X2CH16	13'-11 3/4"
TC-2	6X2CH16	14'-0"
G-3	4X25Z16	4'-1 3/4"
G-4	4X25Z16	4'-5 1/2"
G-5	4X25Z16	4'-5"
G-6	4X25Z16	3'-11 3/4"

ANGLE TABLE		
ID	MARK	LENGTH
1	BC-6	20'-0"
2	BC-6	SCRAP




DESCRIPTION: <b>SIDEWALL FRAMING</b>		PROJECT: <b>MEGA STORAGE LEE SUMMIT 4,5</b>	
CUSTOMER: <b>DLR</b>		LOCATION: <b>LEES SUMMIT MO</b>	
DRN. BY: <b>JB</b>	CKD BY: <b>DES</b>	DATE: <b>1/17/22</b>	SCALE: <b>N.T.S.</b>
REV: <b>00</b>	QUOTATION NO.: <b>MEGASTORAGELEESUMMITBUILDING#4#5</b>	SHEET NO. <b>#4#5</b>	

TRIM TABLE			
ID	PART	LENGTH	DETAIL
1	FL72	10'-2"	TRIM_74
2	FL835x	14'-11"	TRIM_198
3	FL16C	6"	
4	FL18A	6"	
5	FL18D	20'-2"	
6	FL18A	6"	

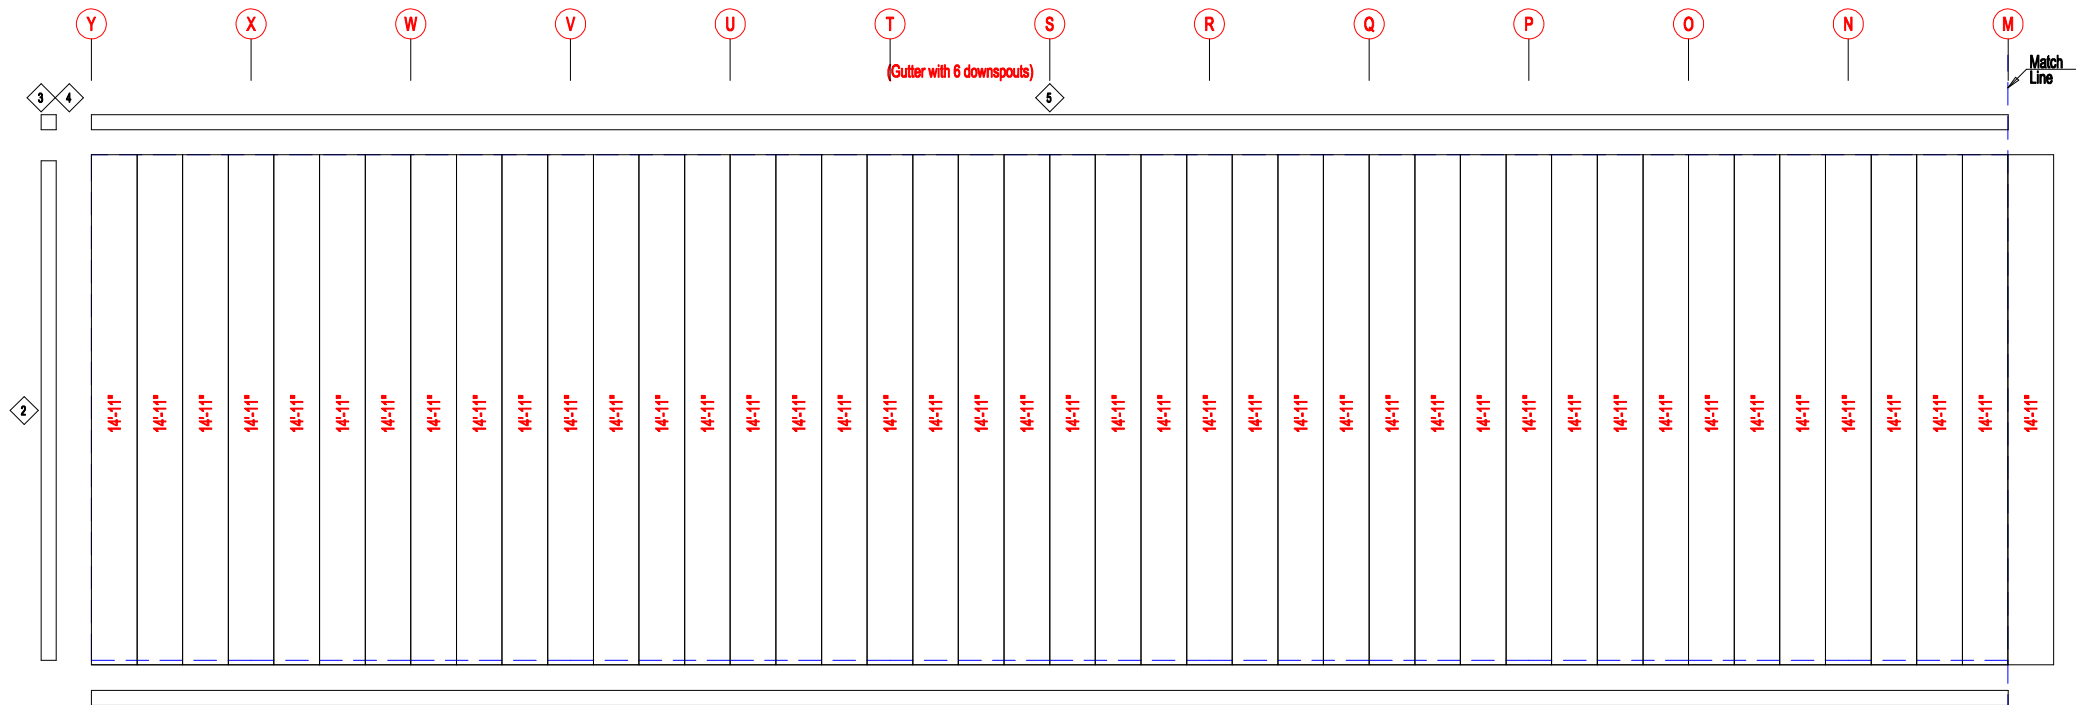

**SIDEWALL SHEETING & TRIM FRAME LINE: 1**  
 PANELS: 20 Ga. CP - NEED SIG 200

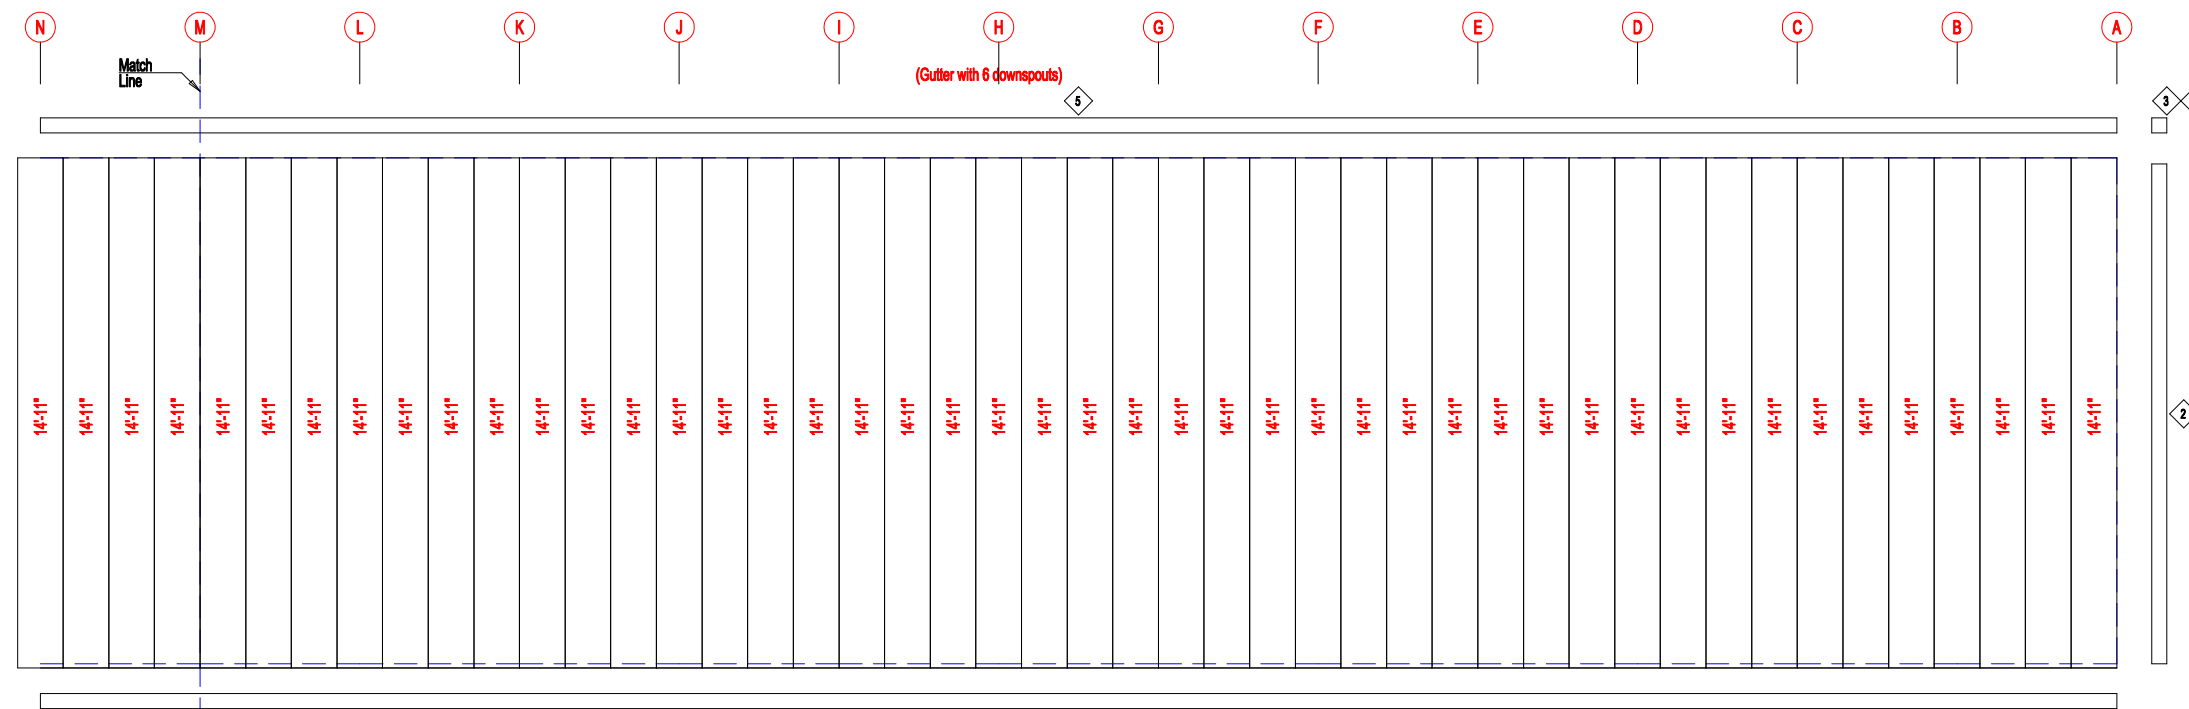


**SIDEWALL SHEETING & TRIM FRAME LINE: 1**  
 PANELS: 20 Ga. CP - NEED SIG 200



DESCRIPTION: <b>SIDEWALL SHEETING</b>					
CUSTOMER: DLR			PROJECT: MEGA STORAGE LEE SUMMIT 4,5		
LOCATION: LEES SUMMIT MO					
DRN. BY	CKD BY	DATE	SCALE	REV.	QUOTATION NO.
JB	DES	1/17/22	N.T.S.	00	MEGASTORAGELEESUMMITBUILDING#4#5
					SHEET NO.
					MEGASTORAGELEESUMMITBUILDING#4#5

MEMBER TABLE		
MARK	PART	LENGTH
TC-1	6X2CH16	13'-11 3/4"
TC-2	6X2CH16	14'-0"
P-1	6X25Z14	29'-0"
P-2	6X25Z16	30'-0"

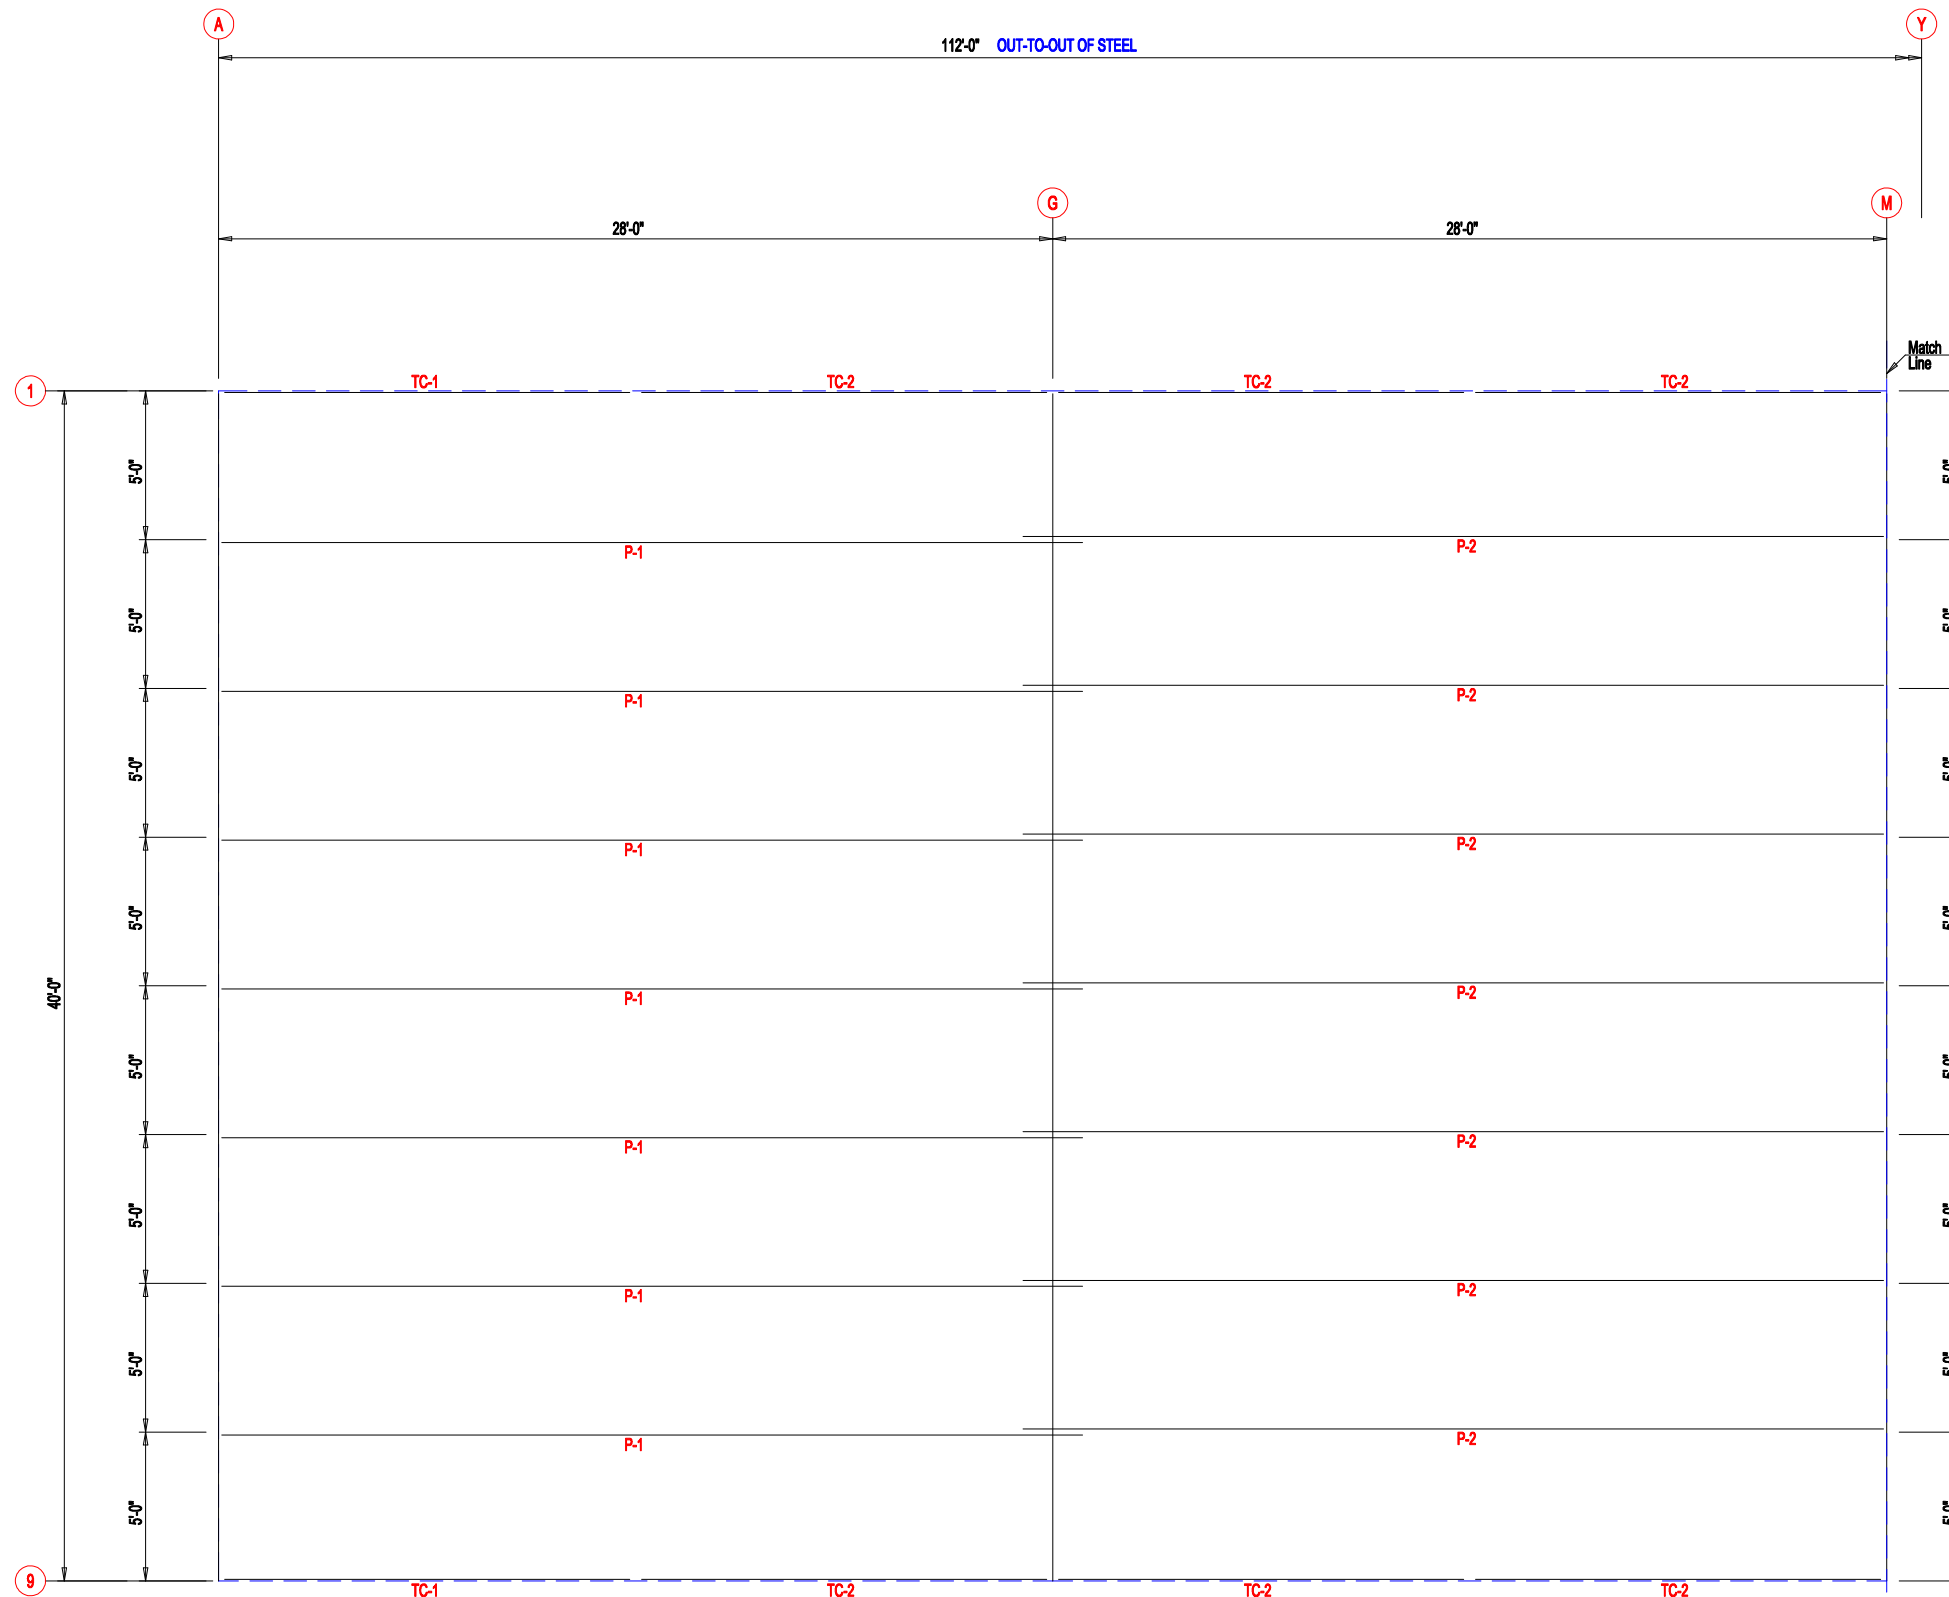

PURLIN  
LAP


ROOF FRAMING



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					SHEET NO.

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MARK	PART	LENGTH
TC-1	6X2CH16	13'-11 3/4"
TC-2	6X2CH16	14'-0"
P-1	6X25Z14	29'-0"
P-2	6X25Z16	30'-0"

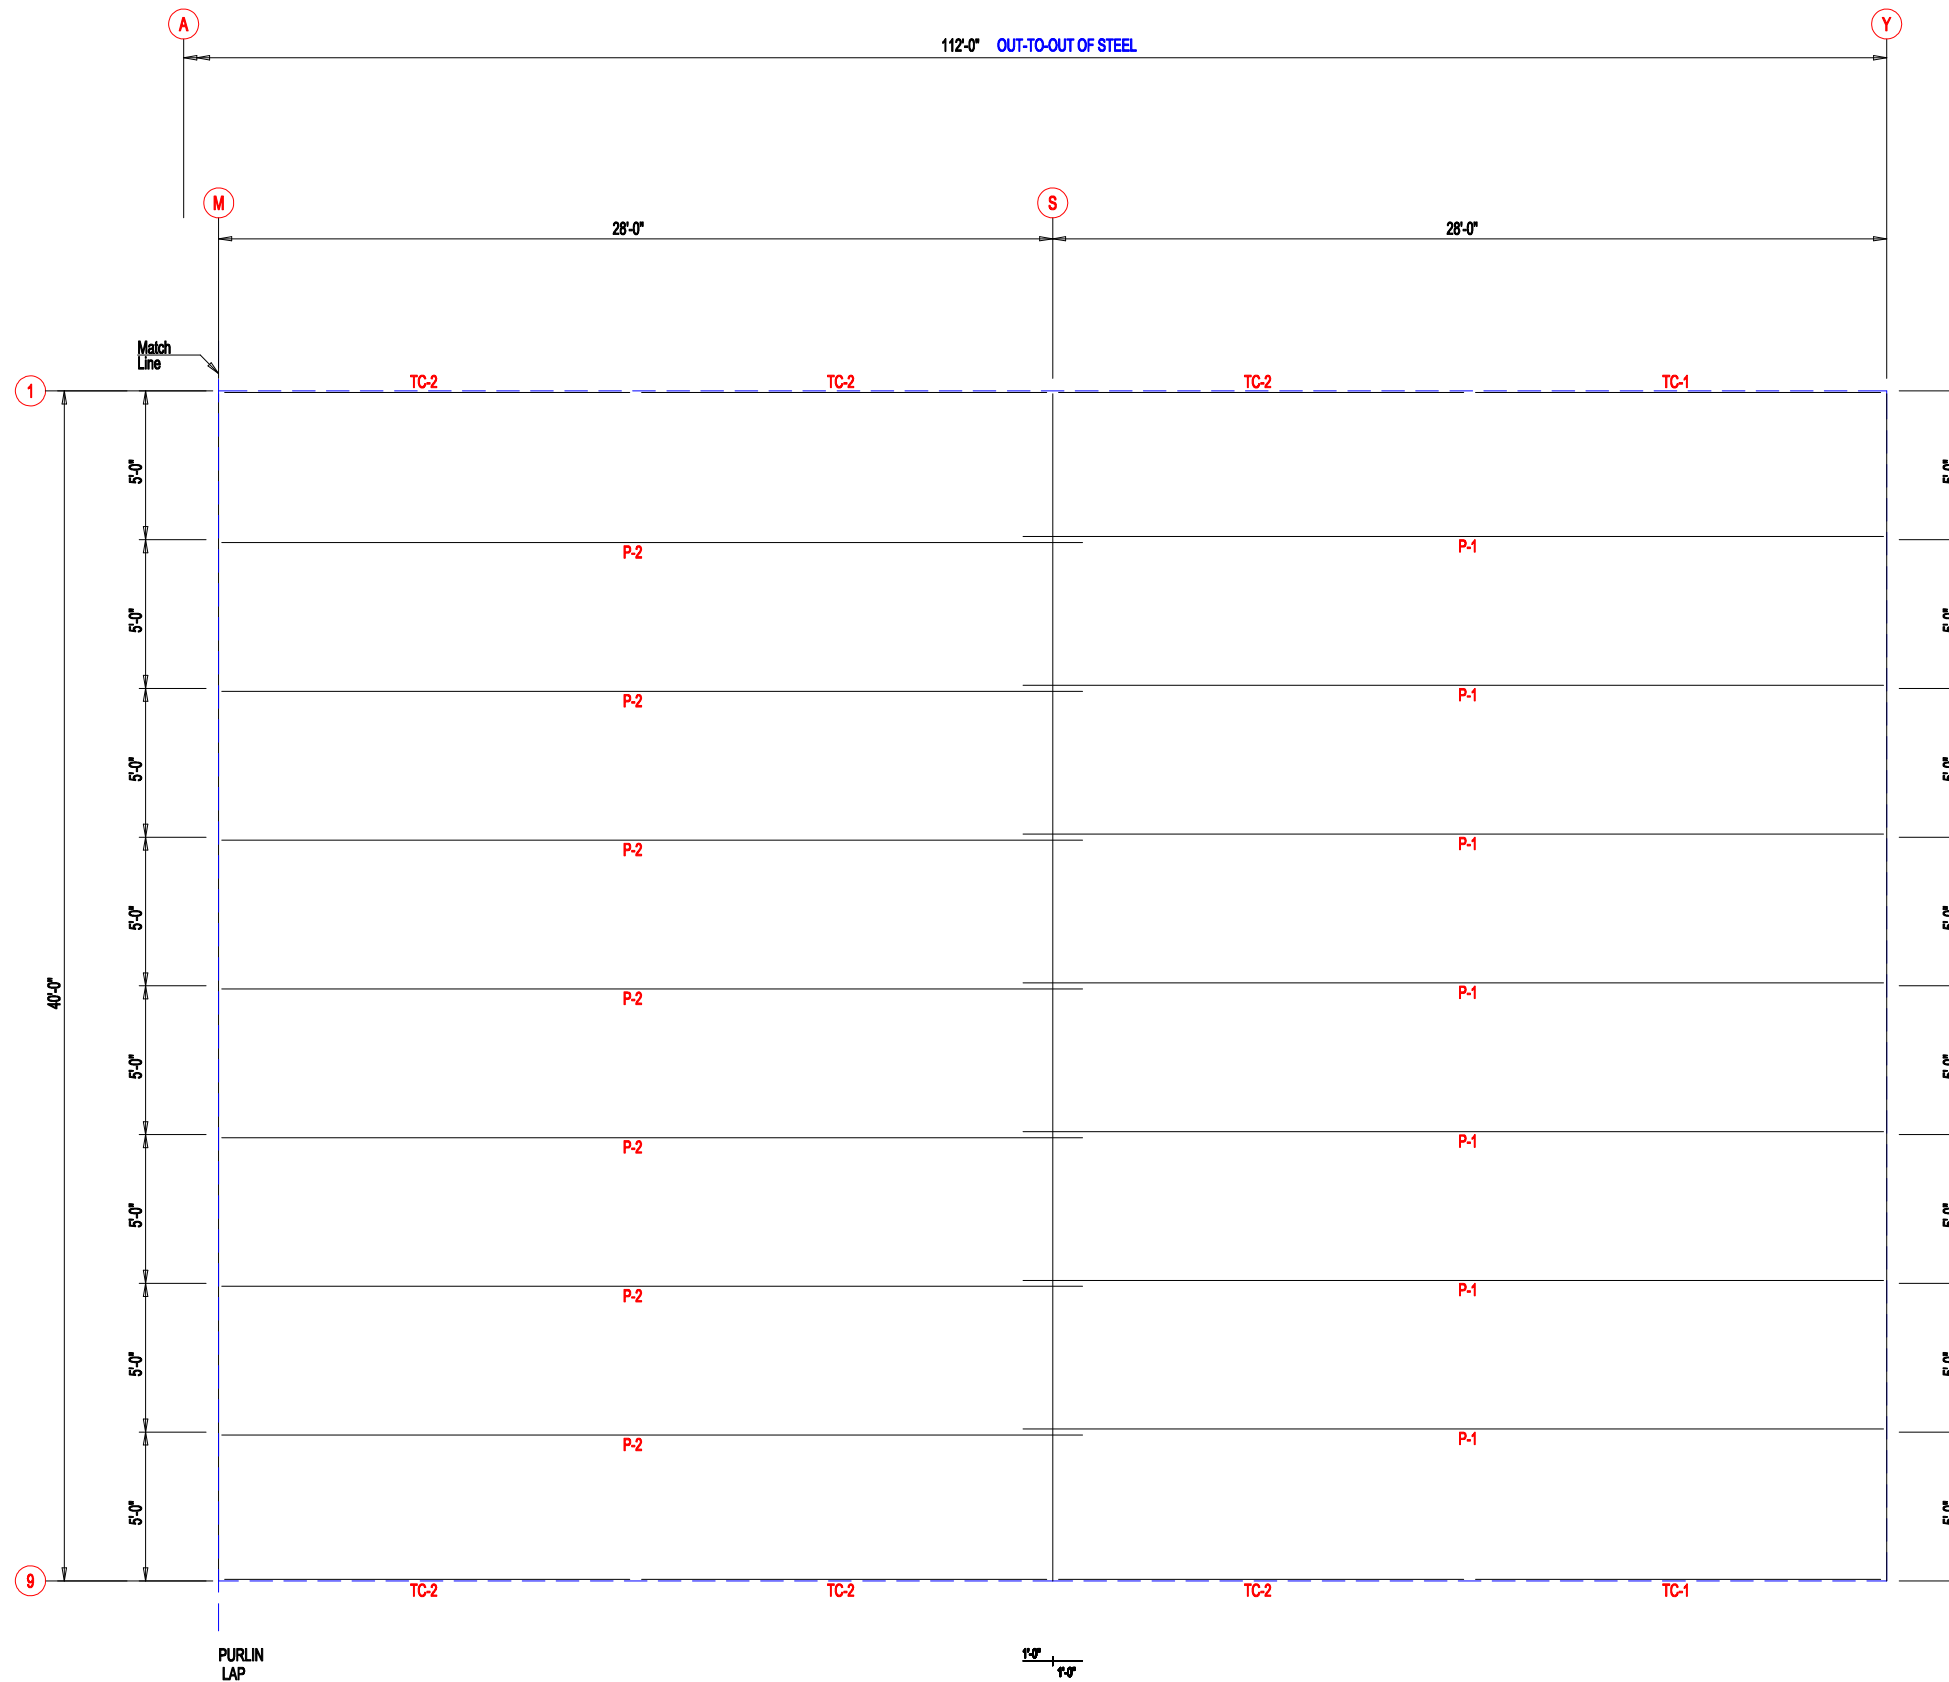


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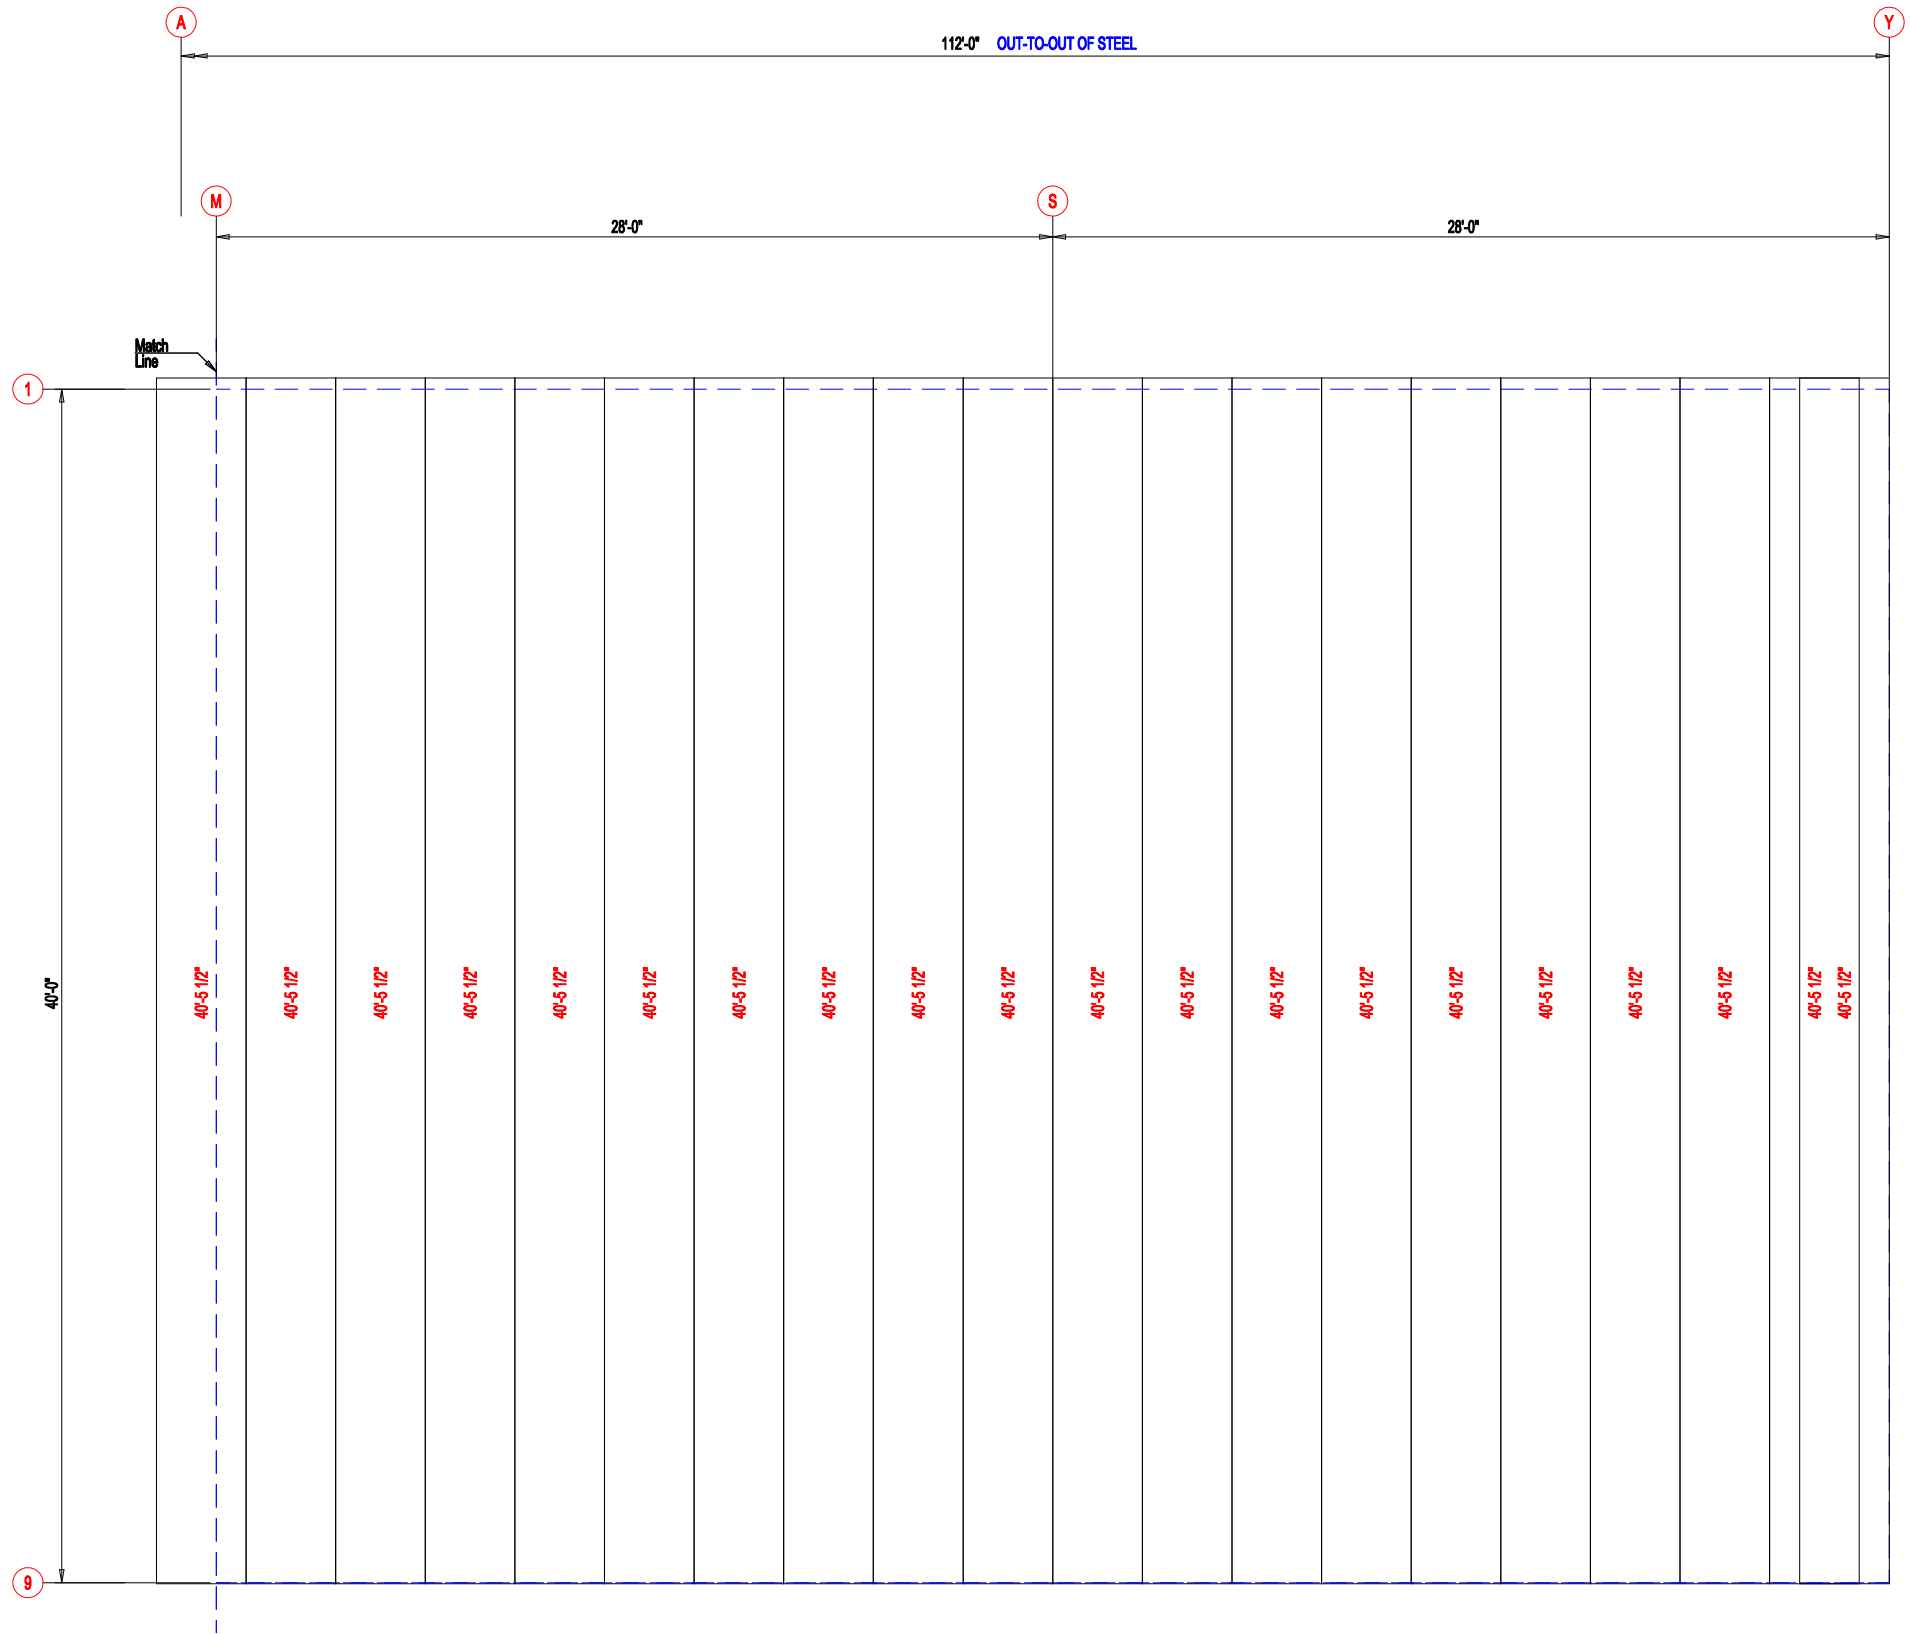
DESCRIPTION: ROOF FRAMING					
CUSTOMER: DLR			PROJECT: MEGA STORAGE LEE SUMMIT 4,5		
LOCATION: LEES SUMMIT MO					
DRN. BY	CKD BY	DATE	SCALE	REV.	QUOTATION NO.
JB	DES	1/17/22	N.T.S.	00	MEGASTORAGELEESUMMITBUILDING#4#5
					SHEET NO.



**ROOF SHEETING & TRIM**  
 PANELS: 26 Ga. PR - Galvalume+ w/ Drip Stop

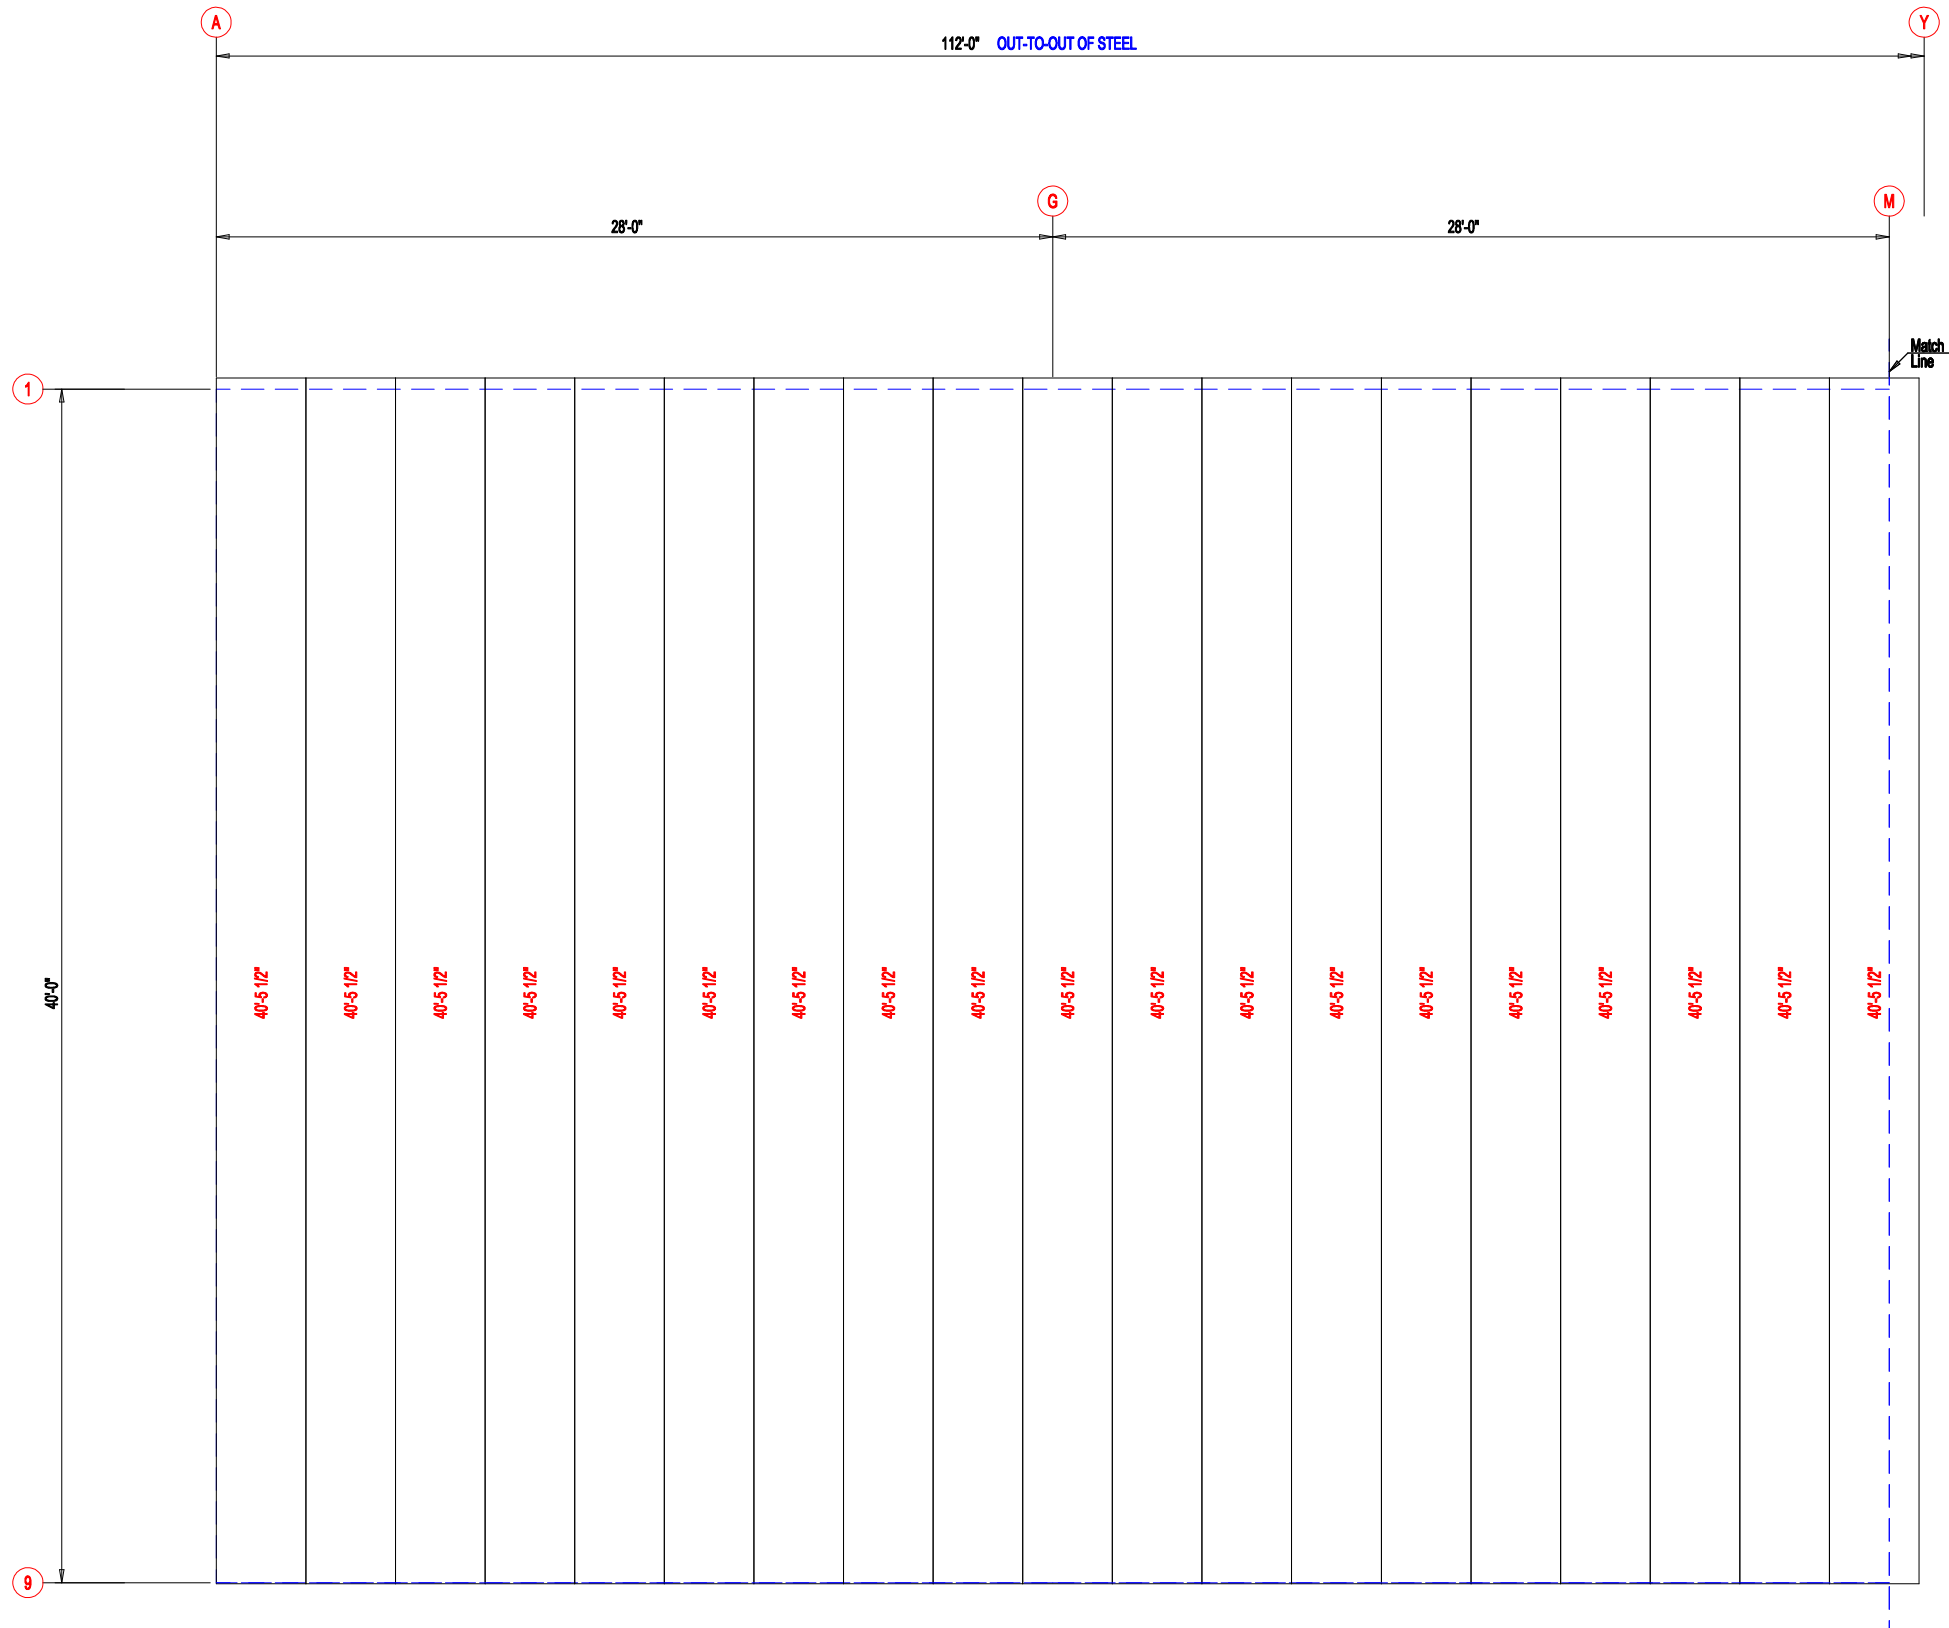

DESCRIPTION: <b>ROOF SHEETING</b>					
CUSTOMER: DLR			PROJECT: MEGA STORAGE LEE SUMMIT 4,5		
LOCATION: LEES SUMMIT MO					
DRN. BY JB	CK'D BY DES	DATE 1/17/22	SCALE N.T.S.	REV. 00	QUOTATION NO. MEGASTORAGELEESUMMITBUILDING#4#5
					SHEET NO.



**ROOF SHEETING & TRIM**  
 PANELS: 26 Ga. PR - Galvalume+ w/ Drip Stop




DESCRIPTION: <b>ROOF SHEETING</b>					
CUSTOMER: DLR			PROJECT: MEGA STORAGE LEE SUMMIT 4,5		
LOCATION: LEES SUMMIT MO					
DRN. BY JB	CK'D BY DES	DATE 1/17/22	SCALE N.T.S.	REV. 00	QUOTATION NO. MEGASTORAGELEESUMMITBUILDING#4#5
					SHEET NO.




MEMBER TABLE		
MARK	PART	LENGTH
S-2	6X2C16	15'-0"
S-3	6X2C16	15'-2 1/2"
S-4	6X2C16	15'-5"
S-5	6X2C16	15'-7 1/2"
S-6	6X2C16	15'-10"
S-7	6X2C16	16'-0 1/2"
S-8	6X2C16	16'-3"

CONNECTION PLATES

ID	MARK/PART
1	FC

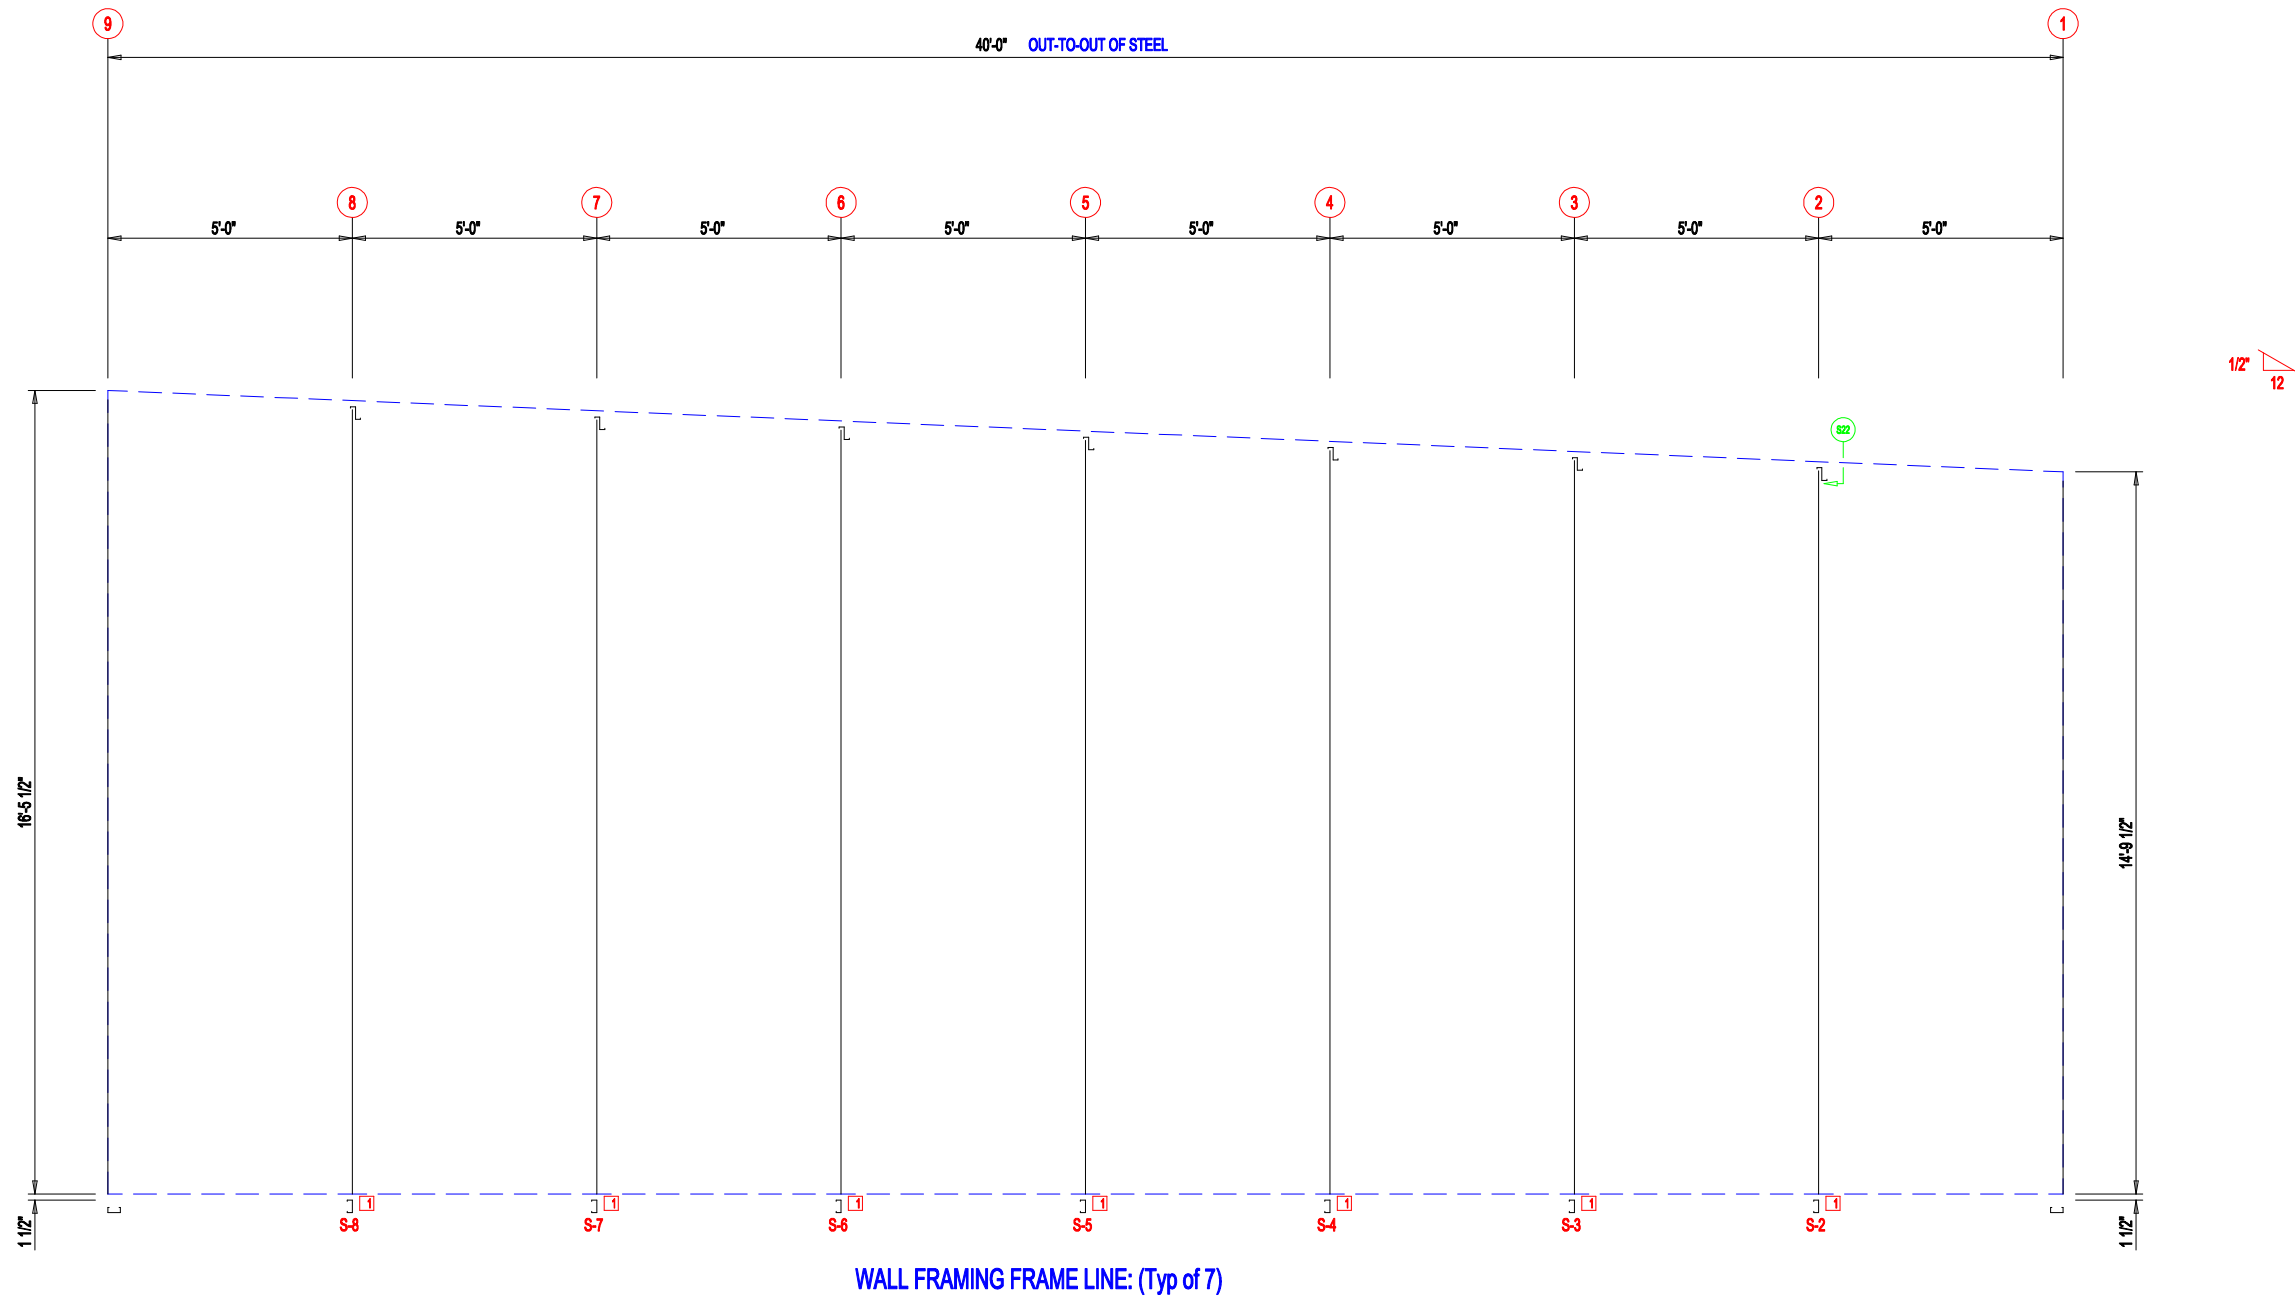

DESCRIPTION: PARTITION FRAMING		PROJECT: MEGA STORAGE LEE SUMMIT 4,5	
CUSTOMER: DLR		LOCATION: LEES SUMMIT MO	
DRN. BY: JB	CK'D BY: DES	DATE: 1/17/22	SCALE: N.T.S.
REV: 00	QUOTATION NO. MEGASTORAGELEESUMMITBUILDING#4#5	SHEET NO.	

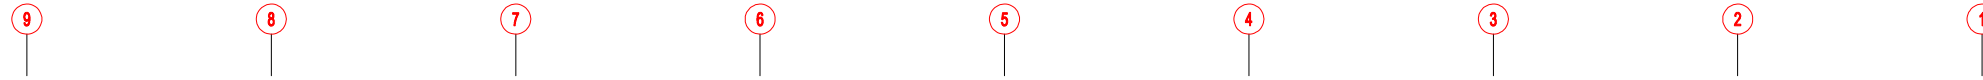

20'-2"	20'-0"
20'-2"	20'-0"
20'-2"	20'-0"
20'-2"	20'-0"
20'-2"	20'-0"


**WALL SHEETING & TRIM FRAME LINE: (Typ of 7)**

PANELS: 29 Ga. PR - Galvalume +



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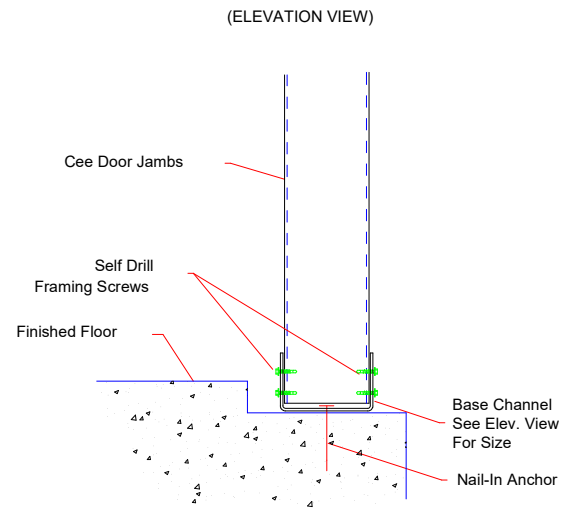
DESCRIPTION: PARTITION SHEETING					
CUSTOMER: DLR			PROJECT: MEGA STORAGE LEE SUMMIT 4,5		
LOCATION: LEES SUMMIT MO					
DRN. BY JB	CKD BY DES	DATE 1/17/22	SCALE N.T.S.	REV. 00	QUOTATION NO. MEGASTORAGELEESUMMITBUILDING#4#5
					SHEET NO. 4#5

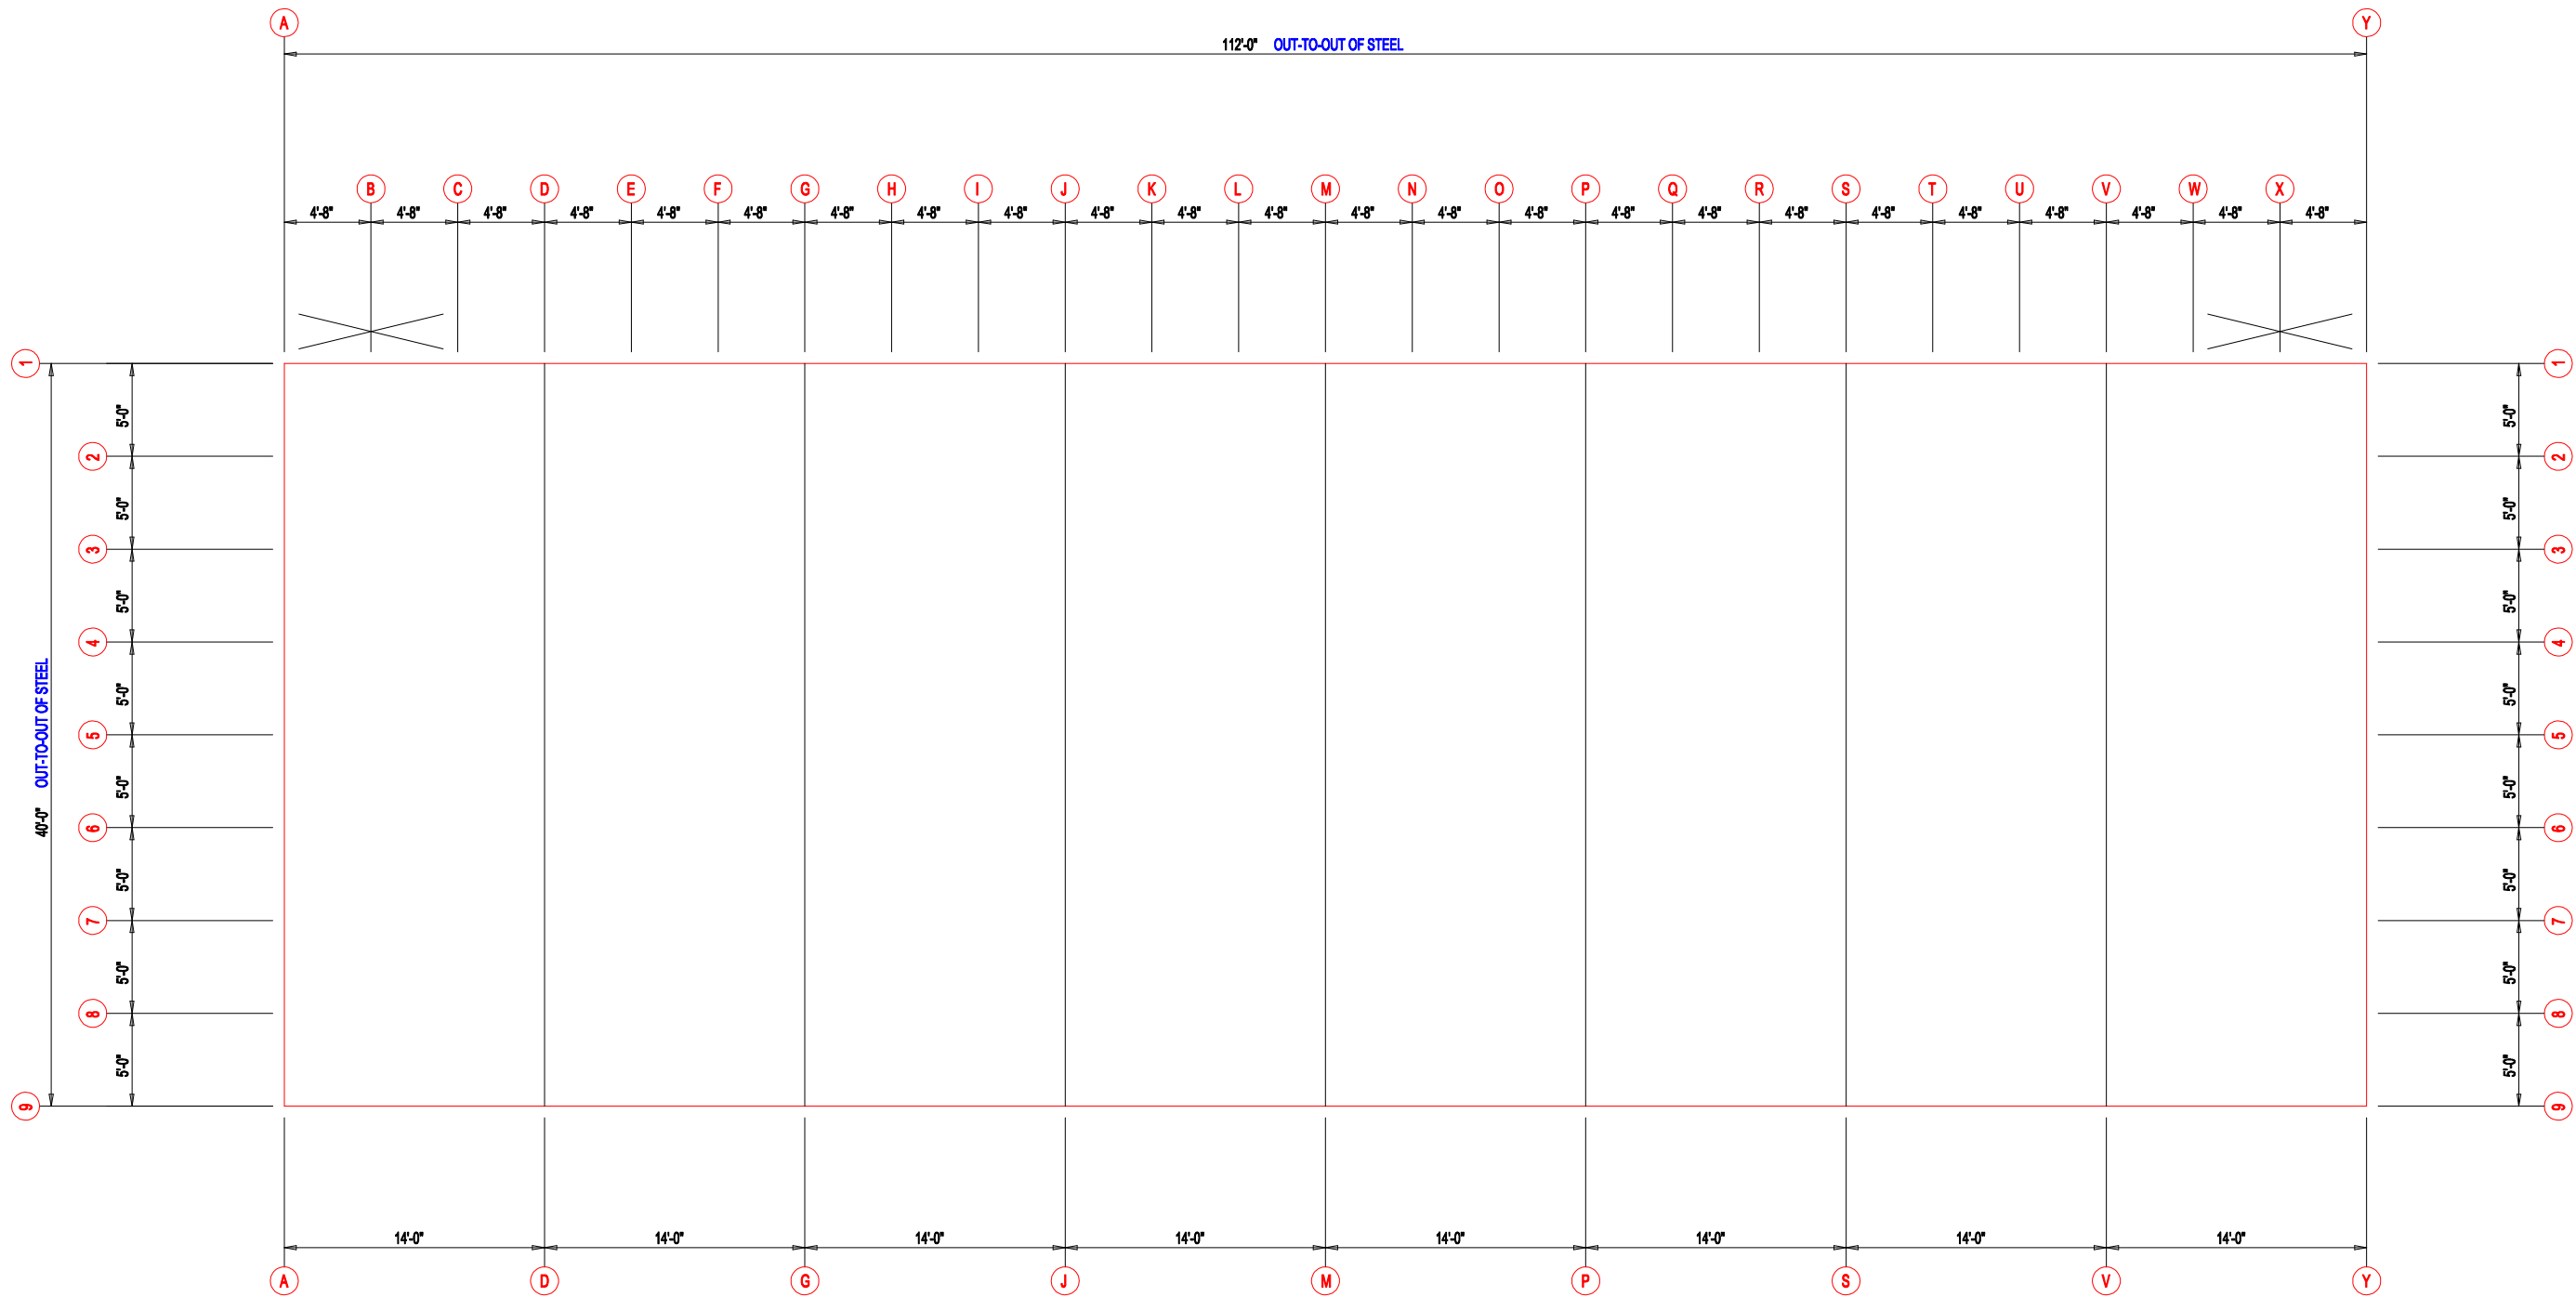


FLOOR PLAN




DESCRIPTION: FLOOR PLAN					
CUSTOMER: DLR			PROJECT: MEGA STORAGE LEE SUMMIT 4,5		
LOCATION: LEES SUMMIT MO					
DRN. BY JB	CK'D BY DES	DATE 1/17/22	SCALE N.T.S.	REV. 00	QUOTATION NO. MEGASTORAGELEESUMMITBUILDING#4#5
					SHEET NO.




S2 BASE @ DOOR JAMB

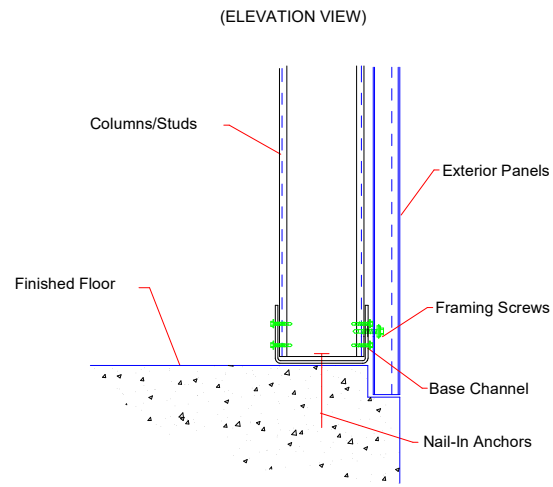


S4 COLUMN BASE @ SHEETED WALL

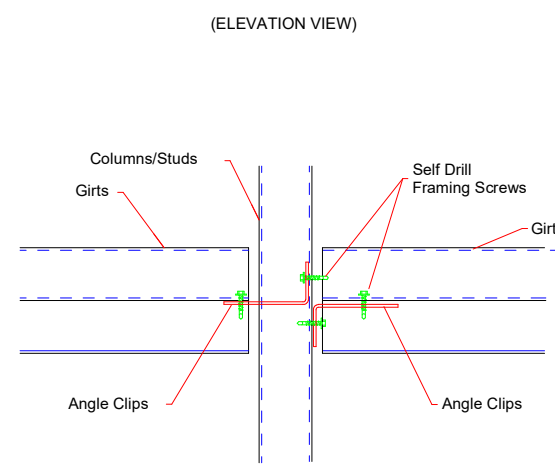


S11 GIRT CONNECTION

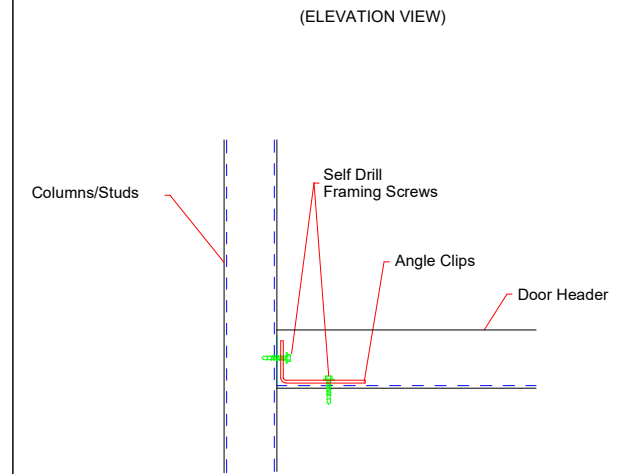


S12 DOOR HEADER TO JAMB

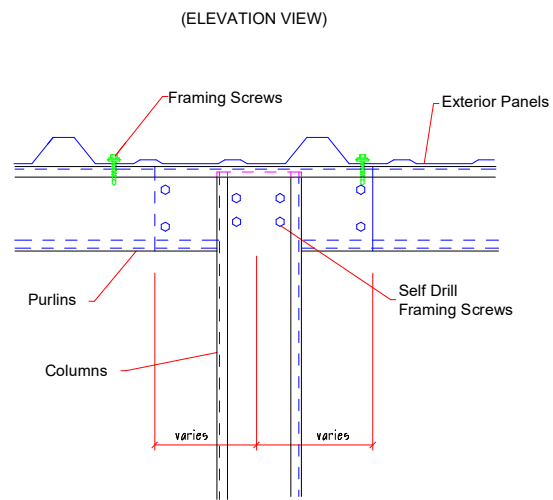


S22 COLUMN TO PURLIN @ LAP

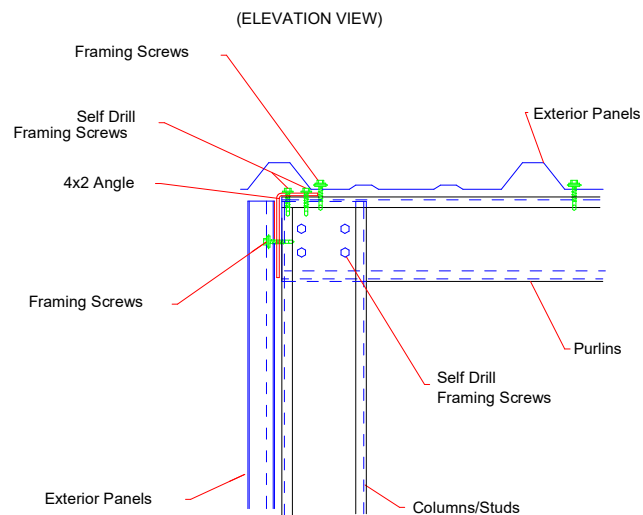

S24 RAKE @ SHEETED ENDWALL

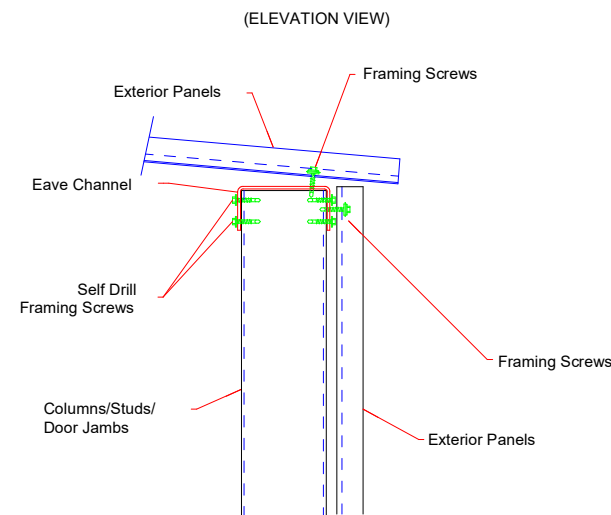


S31 EAVE

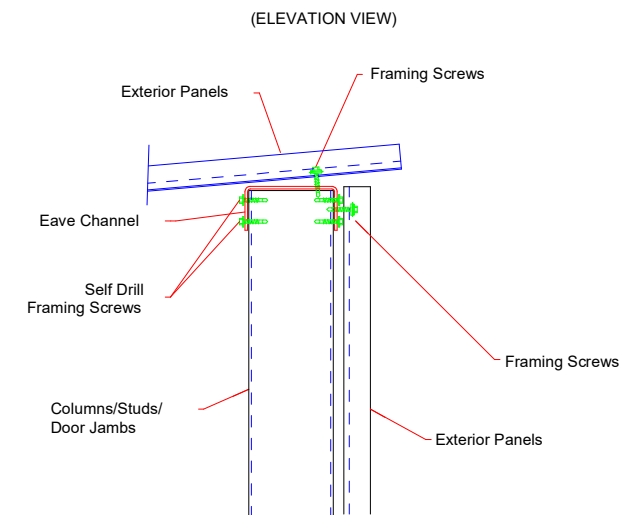


S33 EAVE




DESCRIPTION: <b>DETAIL DRAWINGS</b>					
CUSTOMER: DLR			PROJECT: MEGA STORAGE LEE SUMMIT 4,5		
LOCATION: LEES SUMMIT MO					
DRN. BY JB	CK'D BY DES	DATE 1/17/22	SCALE N.T.S.	REV. 00	QUOTATION NO. MEGASTORAGELEESUMMITBUILDING#4#5
					SHEET NO.

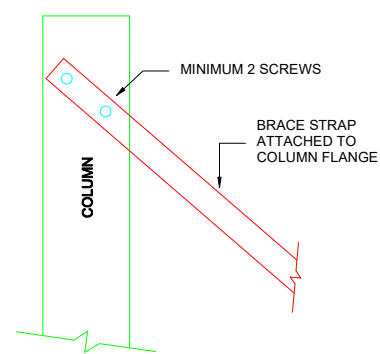


**S81** BRACE STRAP TO COLUMN TOP

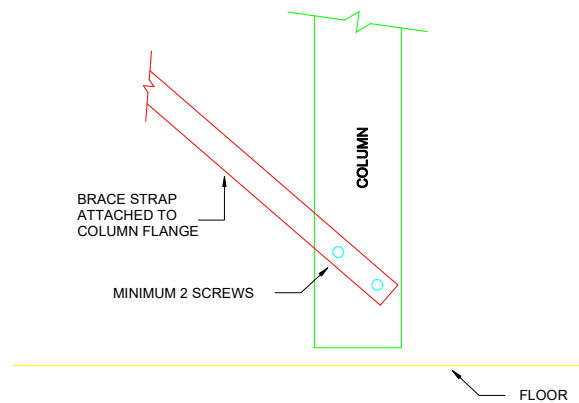


**S82** BRACE STRAP TO COLUMN BOTTOM

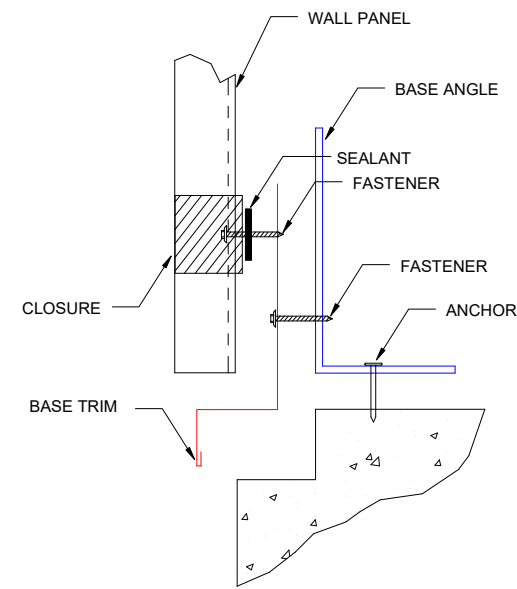


**TRIM\_74** BASE SEAL

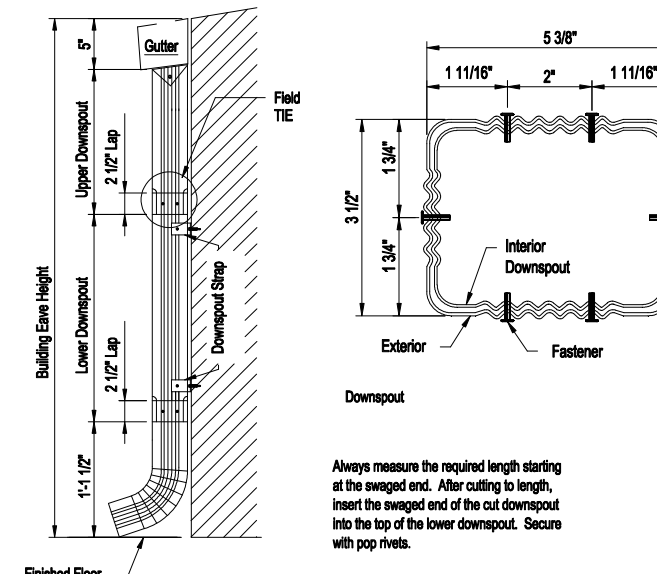


**TRIM\_175** 3 1/2" x 5 3/8" Roll Form Downspout Elevation  
1. A Downspout Strap is required at all Downspout Splices.

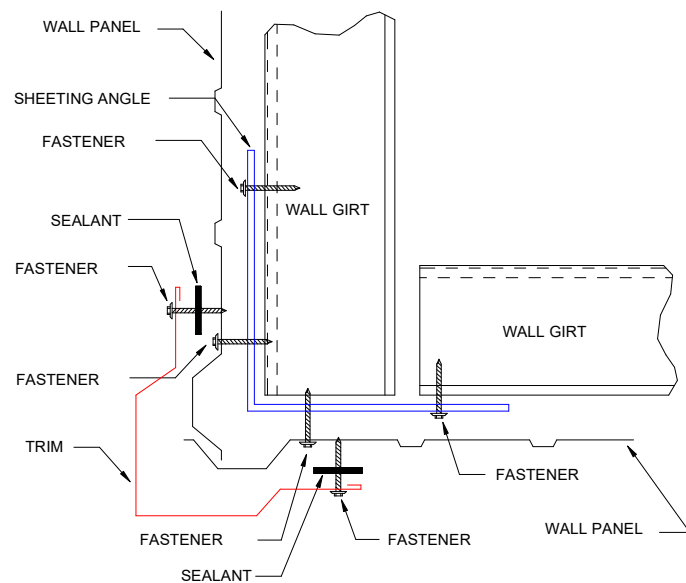


**TRIM\_198** OUTSIDE CORNER

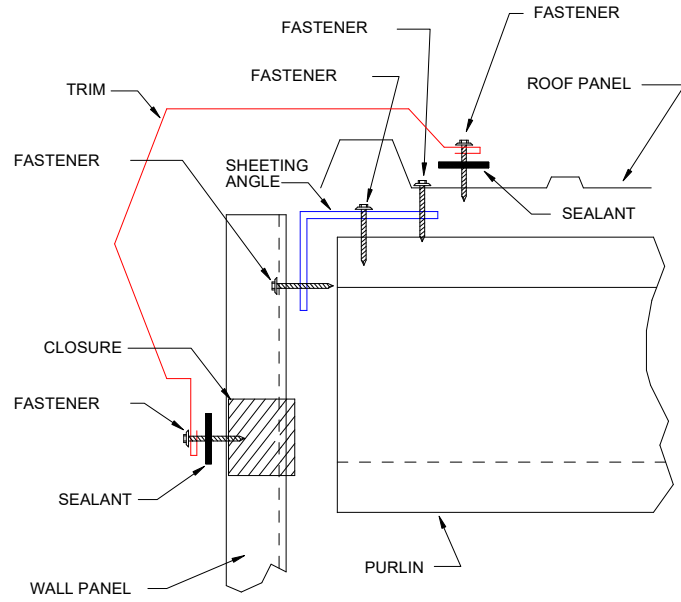

**TRIM\_229** GABLE

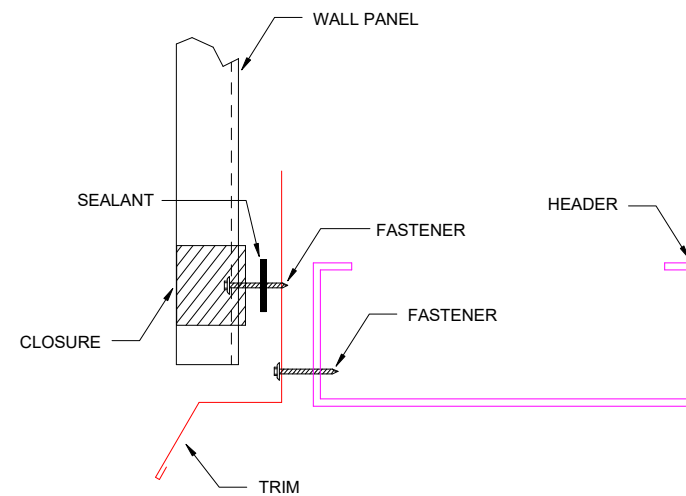

**TRIM\_232** HEADER

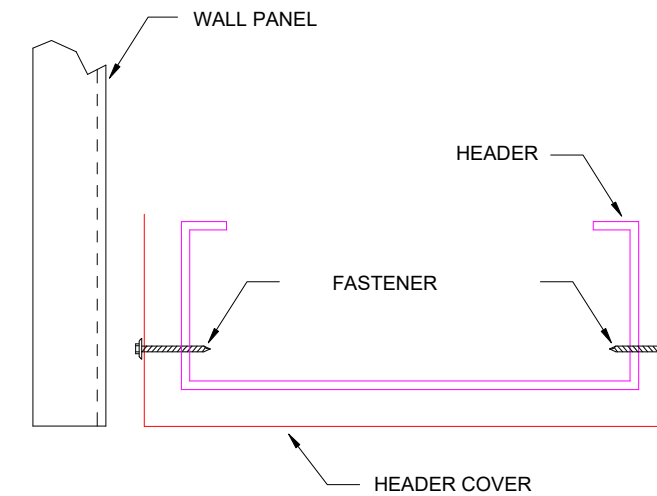


**TRIM\_235** HEADER COVER



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DESCRIPTION: <b>DETAIL DRAWINGS</b>					
CUSTOMER: <b>DLR</b>			PROJECT: <b>MEGA STORAGE LEE SUMMIT 4,5</b>		
LOCATION: <b>LEES SUMMIT MO</b>					
DRN. BY <b>JB</b>	CK'D BY <b>DES</b>	DATE <b>1/17/22</b>	SCALE <b>N.T.S.</b>	REV. <b>00</b>	QUOTATION NO. <b>MEGASTORAGELEESUMMITBUILDING#4#5</b> SHEET NO.

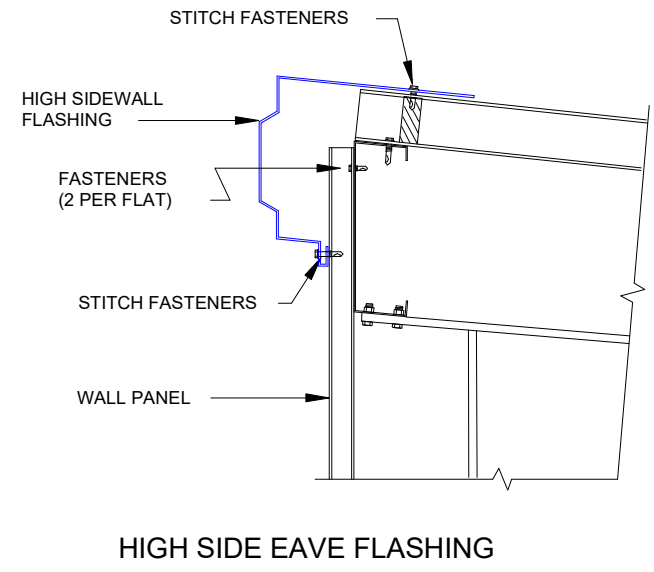

TRIM\_322



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DESCRIPTION: <b>DETAIL DRAWINGS</b>						
CUSTOMER: DLR				PROJECT: MEGA STORAGE LEE SUMMIT 4,5		
LOCATION: LEES SUMMIT MO						
DRN. BY	CK'D BY	DATE	SCALE	REV.	QUOTATION NO.	SHEET NO.
JB	DES	1/17/22	N.T.S.	00	MEGASTORAGELEESUMMITBUILDING#4#5	4#5