

RENDERINGS FOR CONCEPTUAL REFERENCE ONLY; IMAGE MAY NOT REFLECT LATEST DESIGN. REFERENCE ELEVATIONS AND SCHEDULES FOR FINISHES.



DRAWING INDEX

GENERAL

A0.00G GARAGE COVER

ARCHITECTURAL

A0.01G LEGENDS & GEN. NOTES
A0.03 CODE
A0.10 ARCHITECTURAL SITE PLAN & DETAILS
A1.70G GARAGE FIRST FLOOR PLAN AT GRADE
A1.71G GARAGE FIRST FLOOR PLAN
A1.72G GARAGE SECOND FLOOR PLAN
A1.73G GARAGE THIRD FLOOR PLAN
A1.74G GARAGE FOURTH FLOOR PLAN
A1.75G GARAGE FIFTH FLOOR PLAN
A1.76G GARAGE SECTIONS
A1.77G GARAGE STAIRS
A1.78G GARAGE STAIRS AND SECTIONS
A8.01G DOOR SCHEDULE AND DETAILS

STRUCTURAL

S0.01 GENERAL NOTES
S0.05 CMJ DETAILS
S1.71G GARAGE FOUNDATION PLAN
S1.72G GARAGE SECOND FLOOR FRAMING PLAN
S1.73G GARAGE THIRD FLOOR FRAMING PLAN
S1.74G GARAGE FOURTH FLOOR FRAMING PLAN
S1.75G GARAGE FIFTH FLOOR FRAMING PLAN
S1.76G GARAGE SNOW LOADING PLAN
S3.00 TYPICAL FOUNDATION DETAILS
S3.01 GARAGE FOUNDATION DETAILS
S3.02 PILE & PODIUM FOUNDATION DETAILS
S3.50 PRECAST GARAGE FRAMING DETAILS
S3.51 PRECAST GARAGE FRAMING DETAILS

MECHANICAL

ME-001 COVER SHEET

PLUMBING

MP1.71G GARAGE FIRST FLOOR- PLUMBING
MP1.72G GARAGE SECOND FLOOR- PLUMBING
MP1.73G GARAGE THIRD FLOOR- PLUMBING
MP1.74G GARAGE FOURTH FLOOR- PLUMBING
MP1.75G GARAGE FIFTH FLOOR- PLUMBING
MP2.01 MECHANICAL DETAILS/SCHEDULES

ELECTRICAL

E1.71G GARAGE FIRST FLOOR PLAN- ELECTRICAL
E1.72G GARAGE SECOND FLOOR PLAN- ELECTRICAL
E1.73G GARAGE THIRD FLOOR PLAN- ELECTRICAL
E1.74G GARAGE FOURTH FLOOR PLAN- ELECTRICAL
E1.75G GARAGE FIFTH FLOOR PLAN- ELECTRICAL
E3.01 ELECTRICAL DETAILS/SCHEDULES

PROJECT TEAM

ARCHITECT
FINKLE + WILLIAMS ARCHITECTURE
8787 Renner Blvd., Suite 100
Lenexa, Kansas 66219
PH. 913.498.1550

CIVIL

GBA
9801 Renner Blvd., Suite 300
Lenexa, Kansas 66219
PH. 913.492.0400

LANDSCAPE

TBD

STRUCTURAL

BOB D. CAMPBELL & CO., INC.
4338 Bellview
Kansas City, Missouri 64111
PH. 816.531.4144 F. 816.531.8572

PRECAST CONTRACTOR

CORES LAB STRUCTURES, INC.
759 S. 65th St.
Kansas City, Kansas 66111
PH. 913.297-5725

CONTRACTOR
BRINKMANN CONSTRUCTORS
11101 Switzer Rd., Suite 310
Overland Park, Kansas 66210
PH. 913.717.9007 F. 913.717.9407

MECHANICAL

LS&A, P.A.
8625 College Blvd., Suite 102
Overland Park, Kansas 66210
PH. 785.233.0647 F. 785.233.0647

PLUMBING

LS&A, P.A.
8625 College Blvd., Suite 102
Overland Park, Kansas 66210
PH. 785.233.0647 F. 785.233.0647

ELECTRICAL

LS&A, P.A.
8625 College Blvd., Suite 102
Overland Park, Kansas 66210
PH. 785.233.0647 F. 785.233.0647

FIRE PROTECTION

TBD



FINKLE + WILLIAMS
ARCHITECTURE

PROJECT ADDRESS
3200 NW PARAGON PKWY
LEE'S SUMMIT, MO 64081


PARAGON STAR NORTH VILLAGE

CURRENT REVISION


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RELEASE DATE
02.04.22


PROJECT NUMBER
18017,19050.07,19050.08

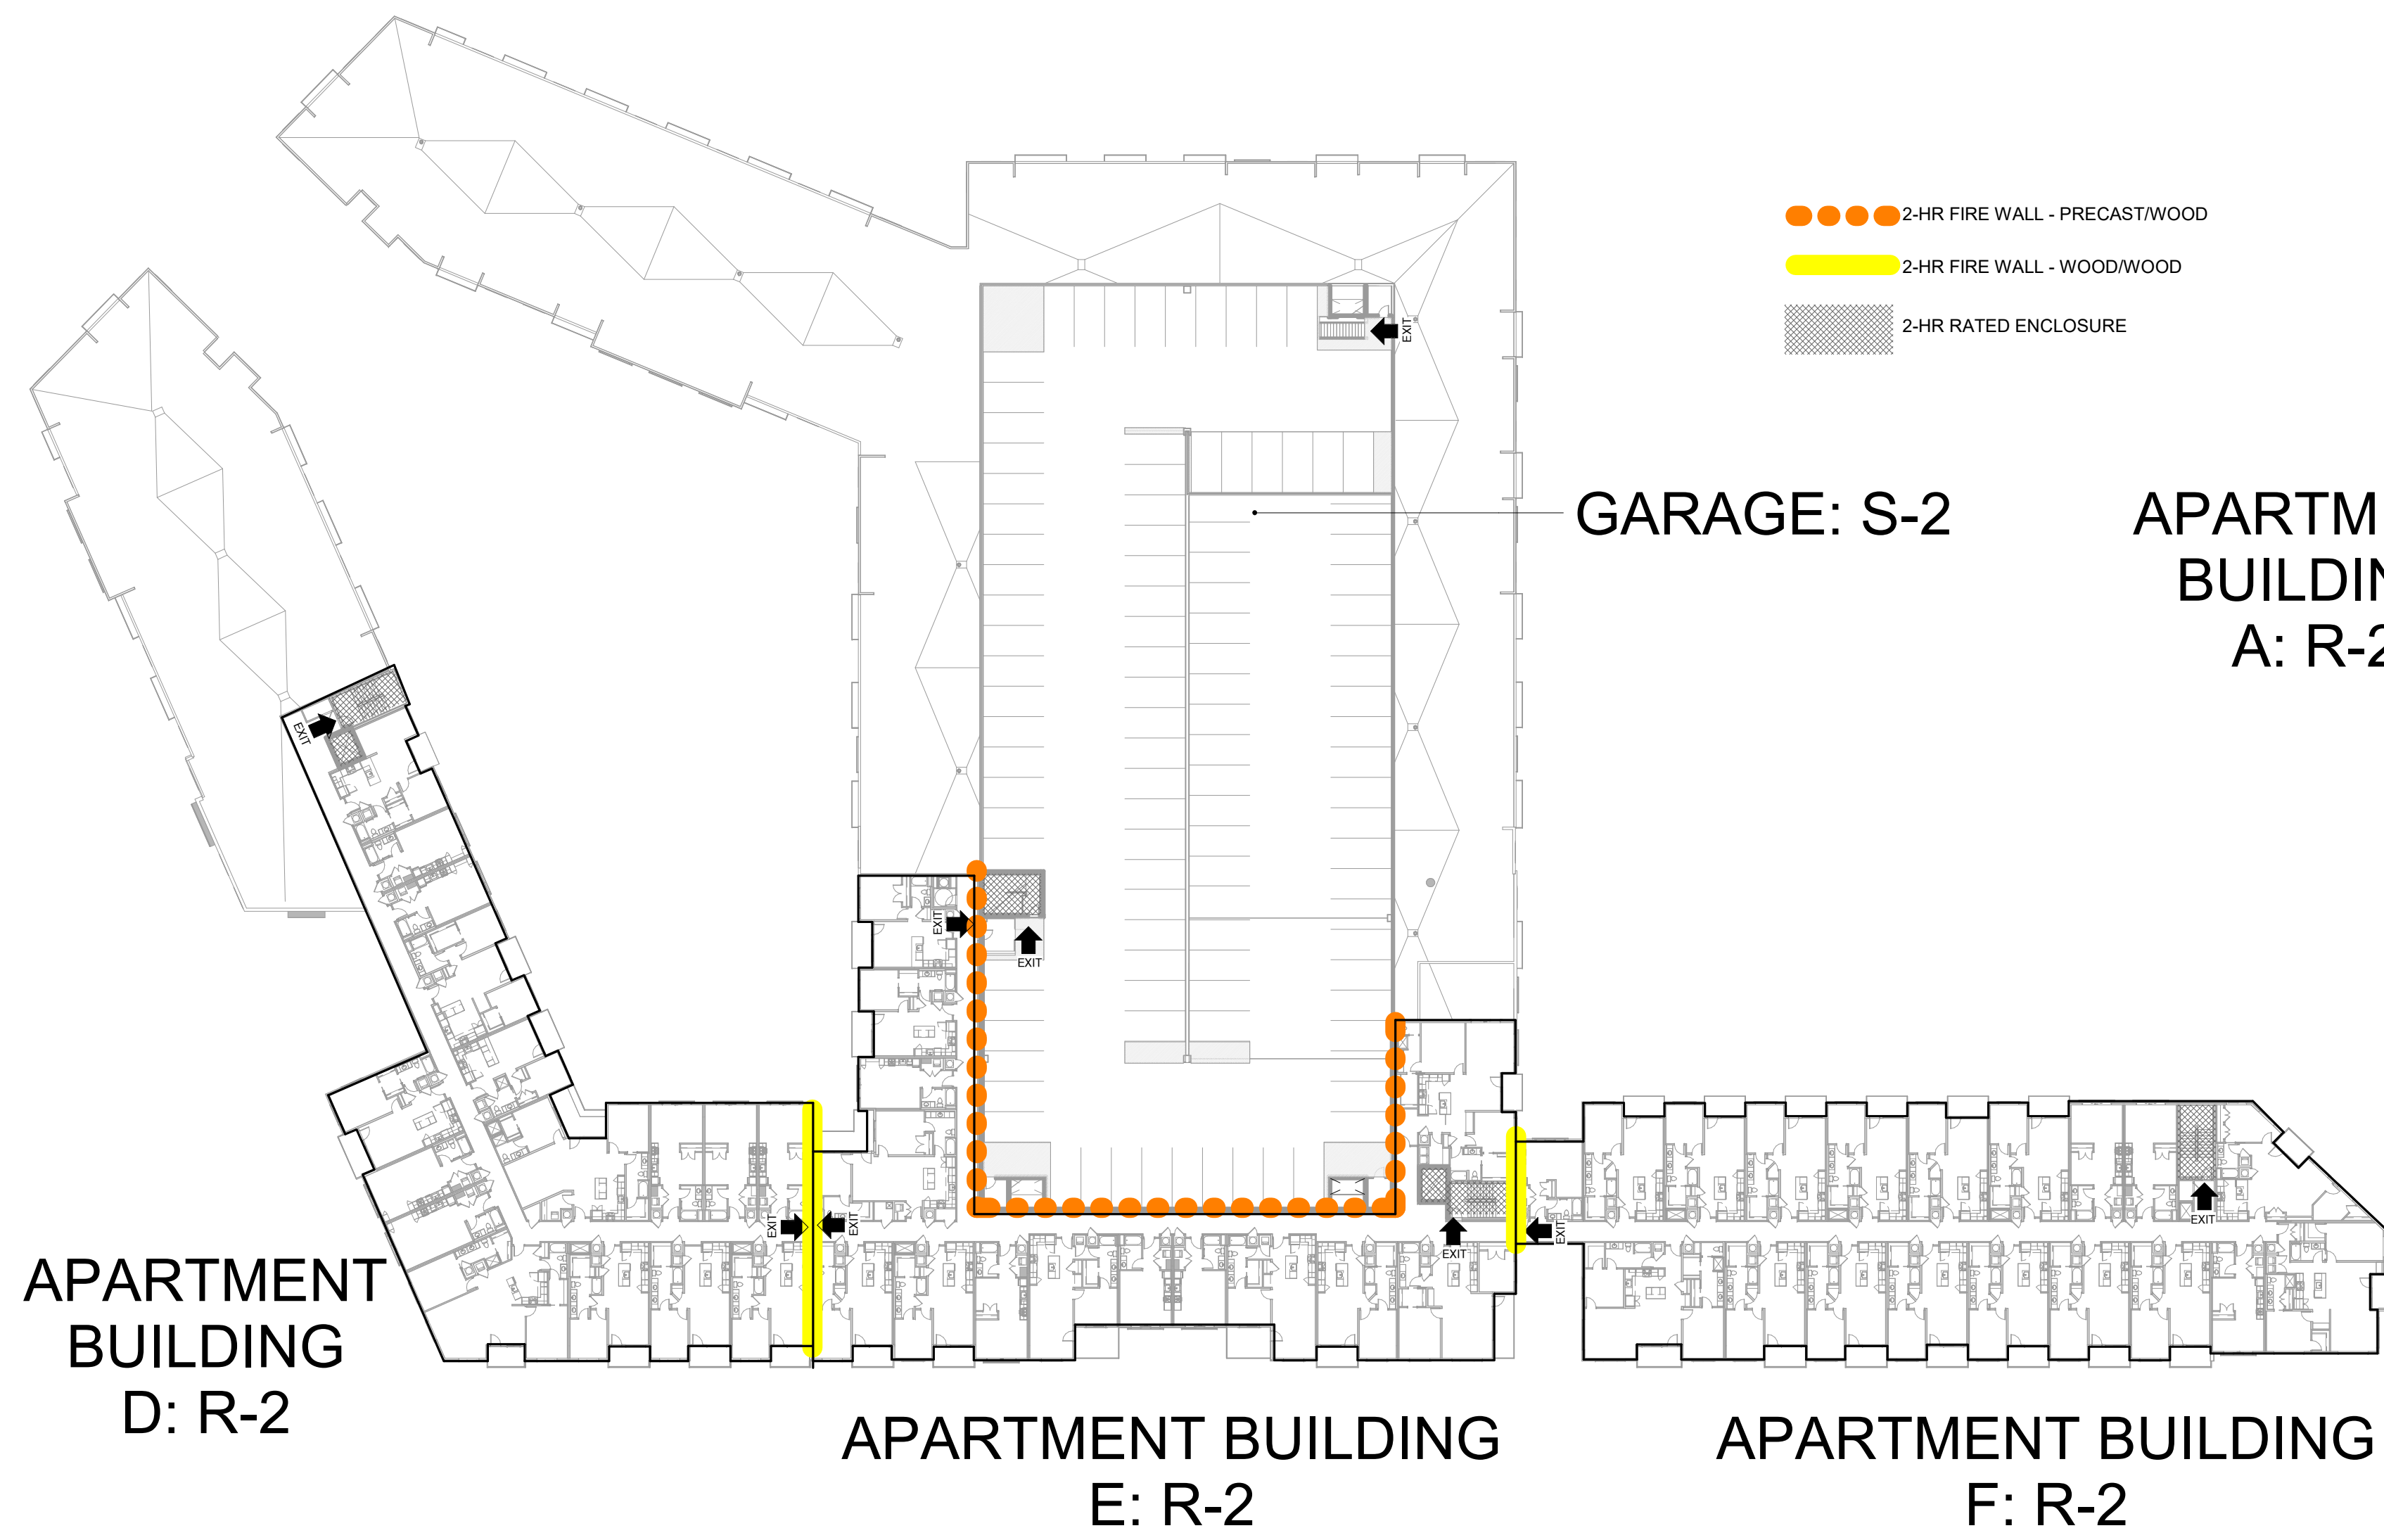


3 | CODEPLAN - 5
1" = 40'-0"

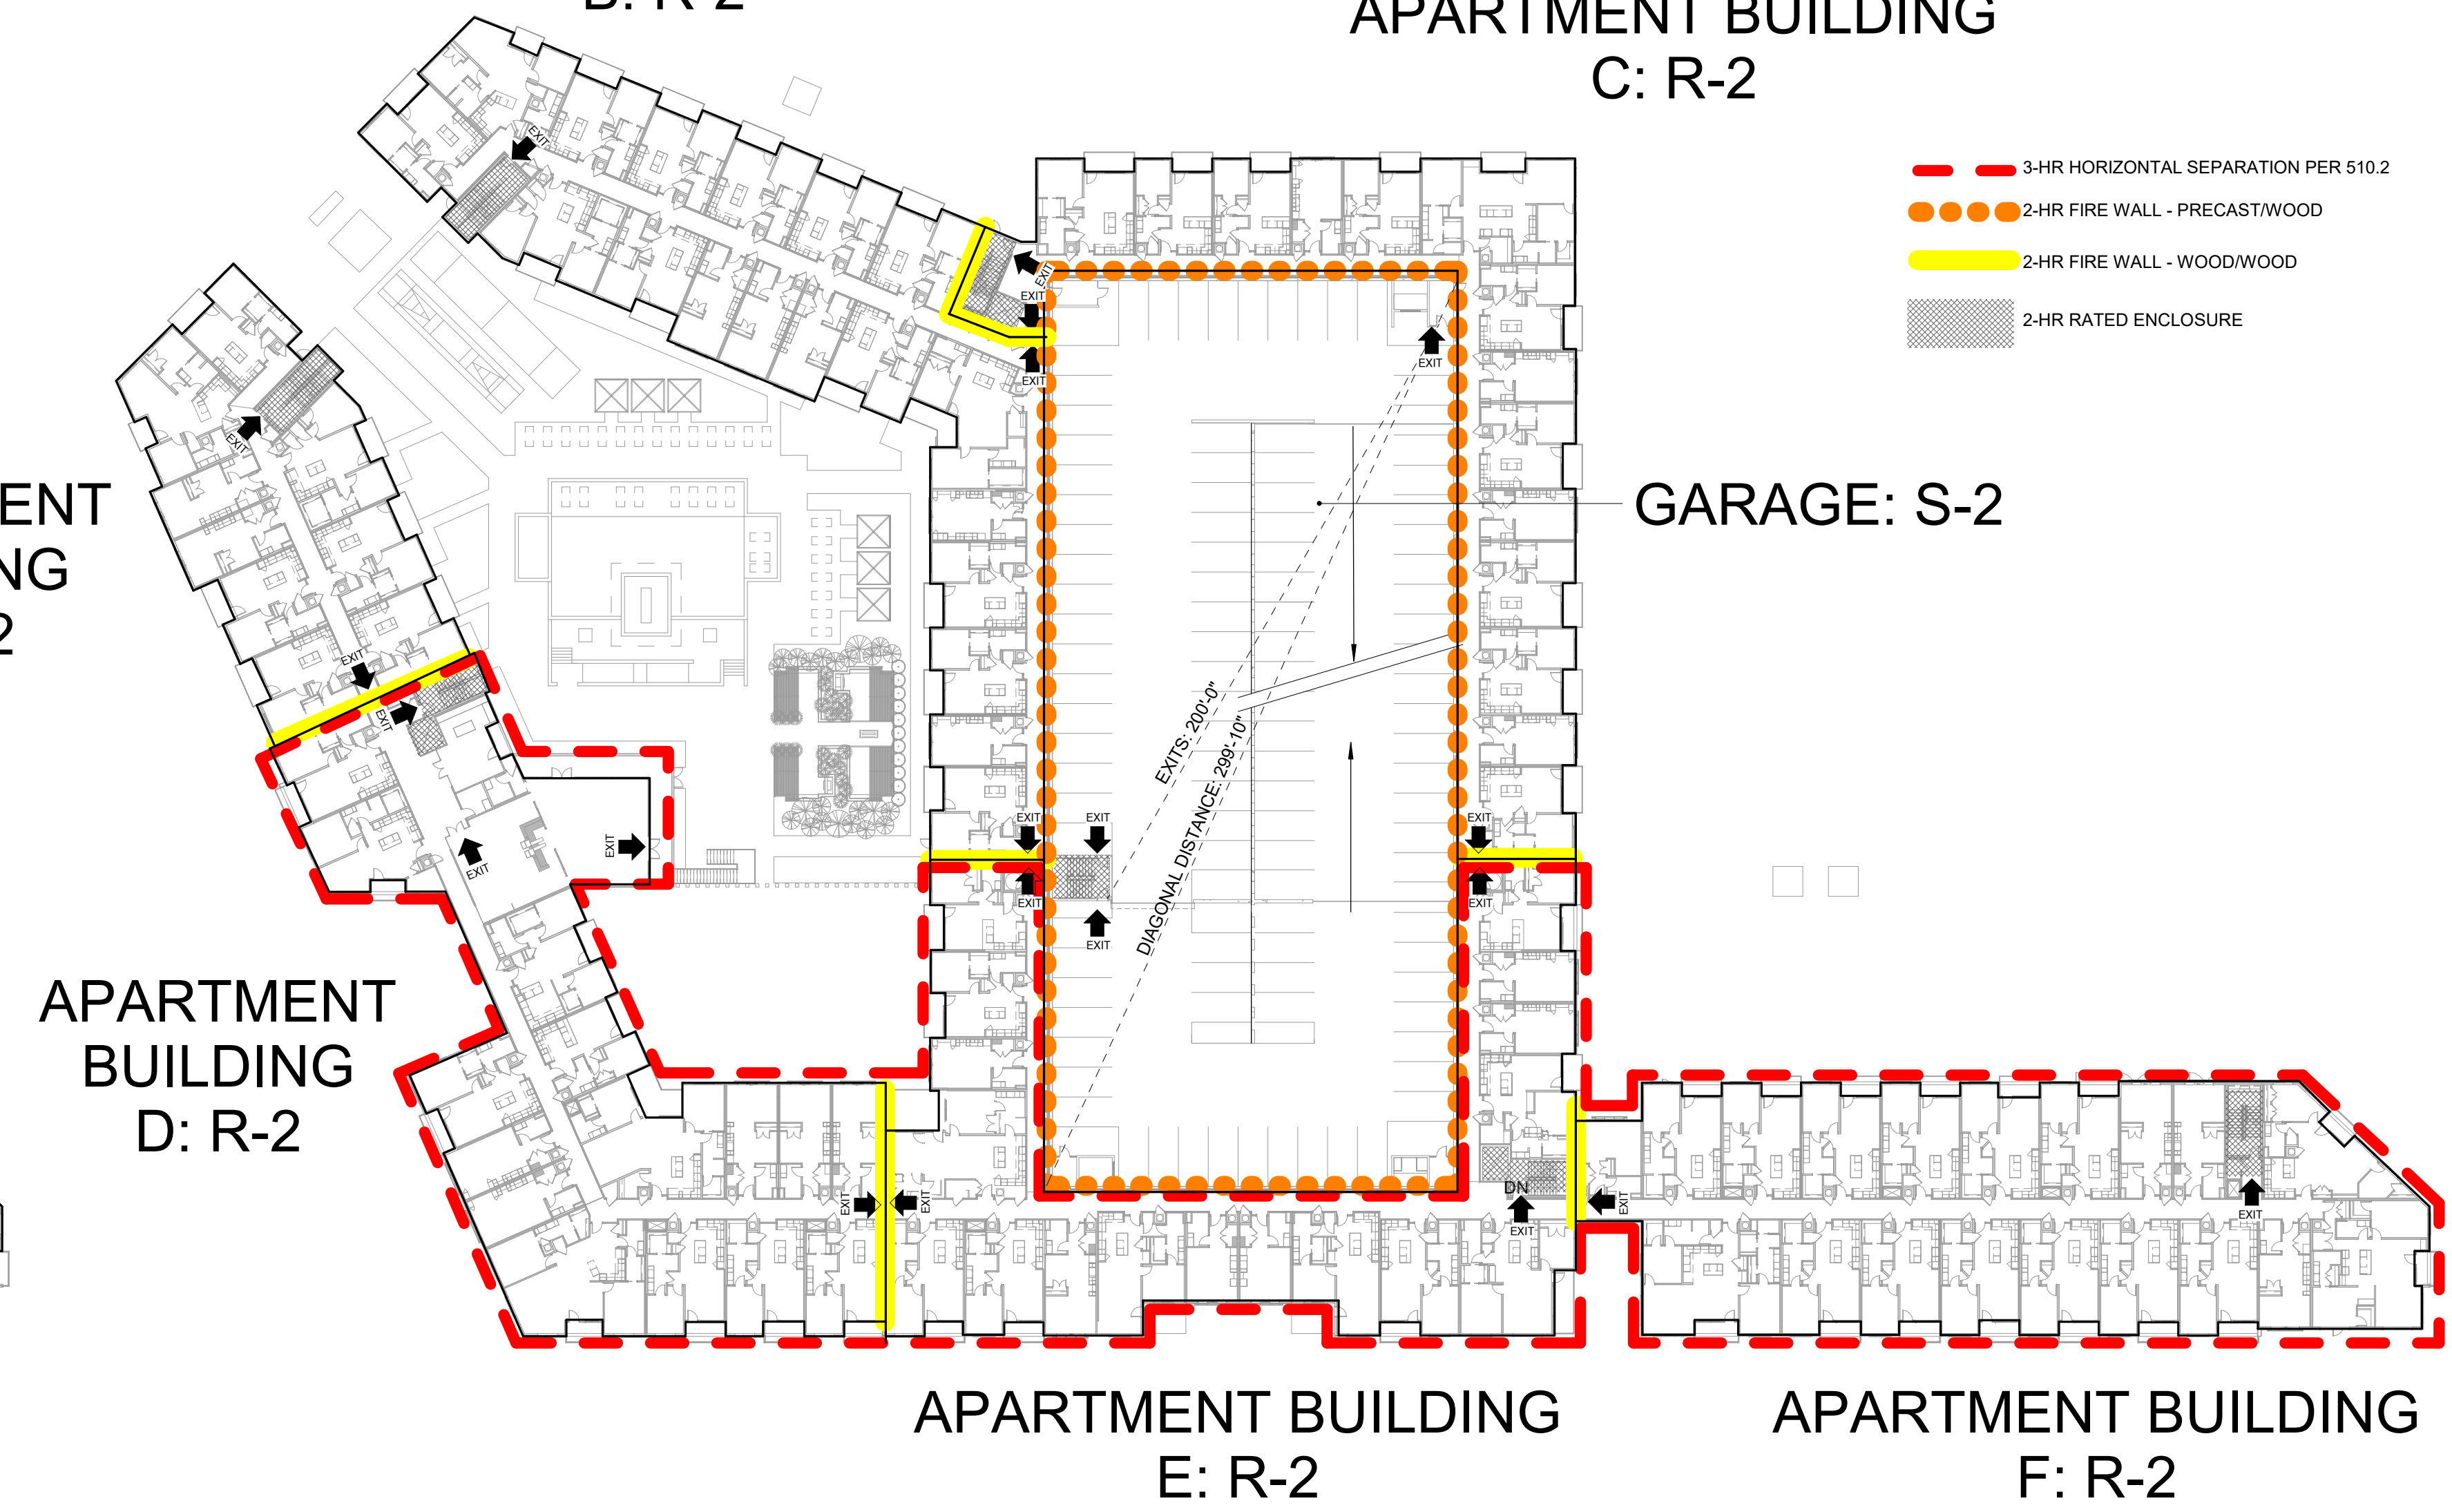

2 | CODEPLAN - 2
1" = 40'-0"

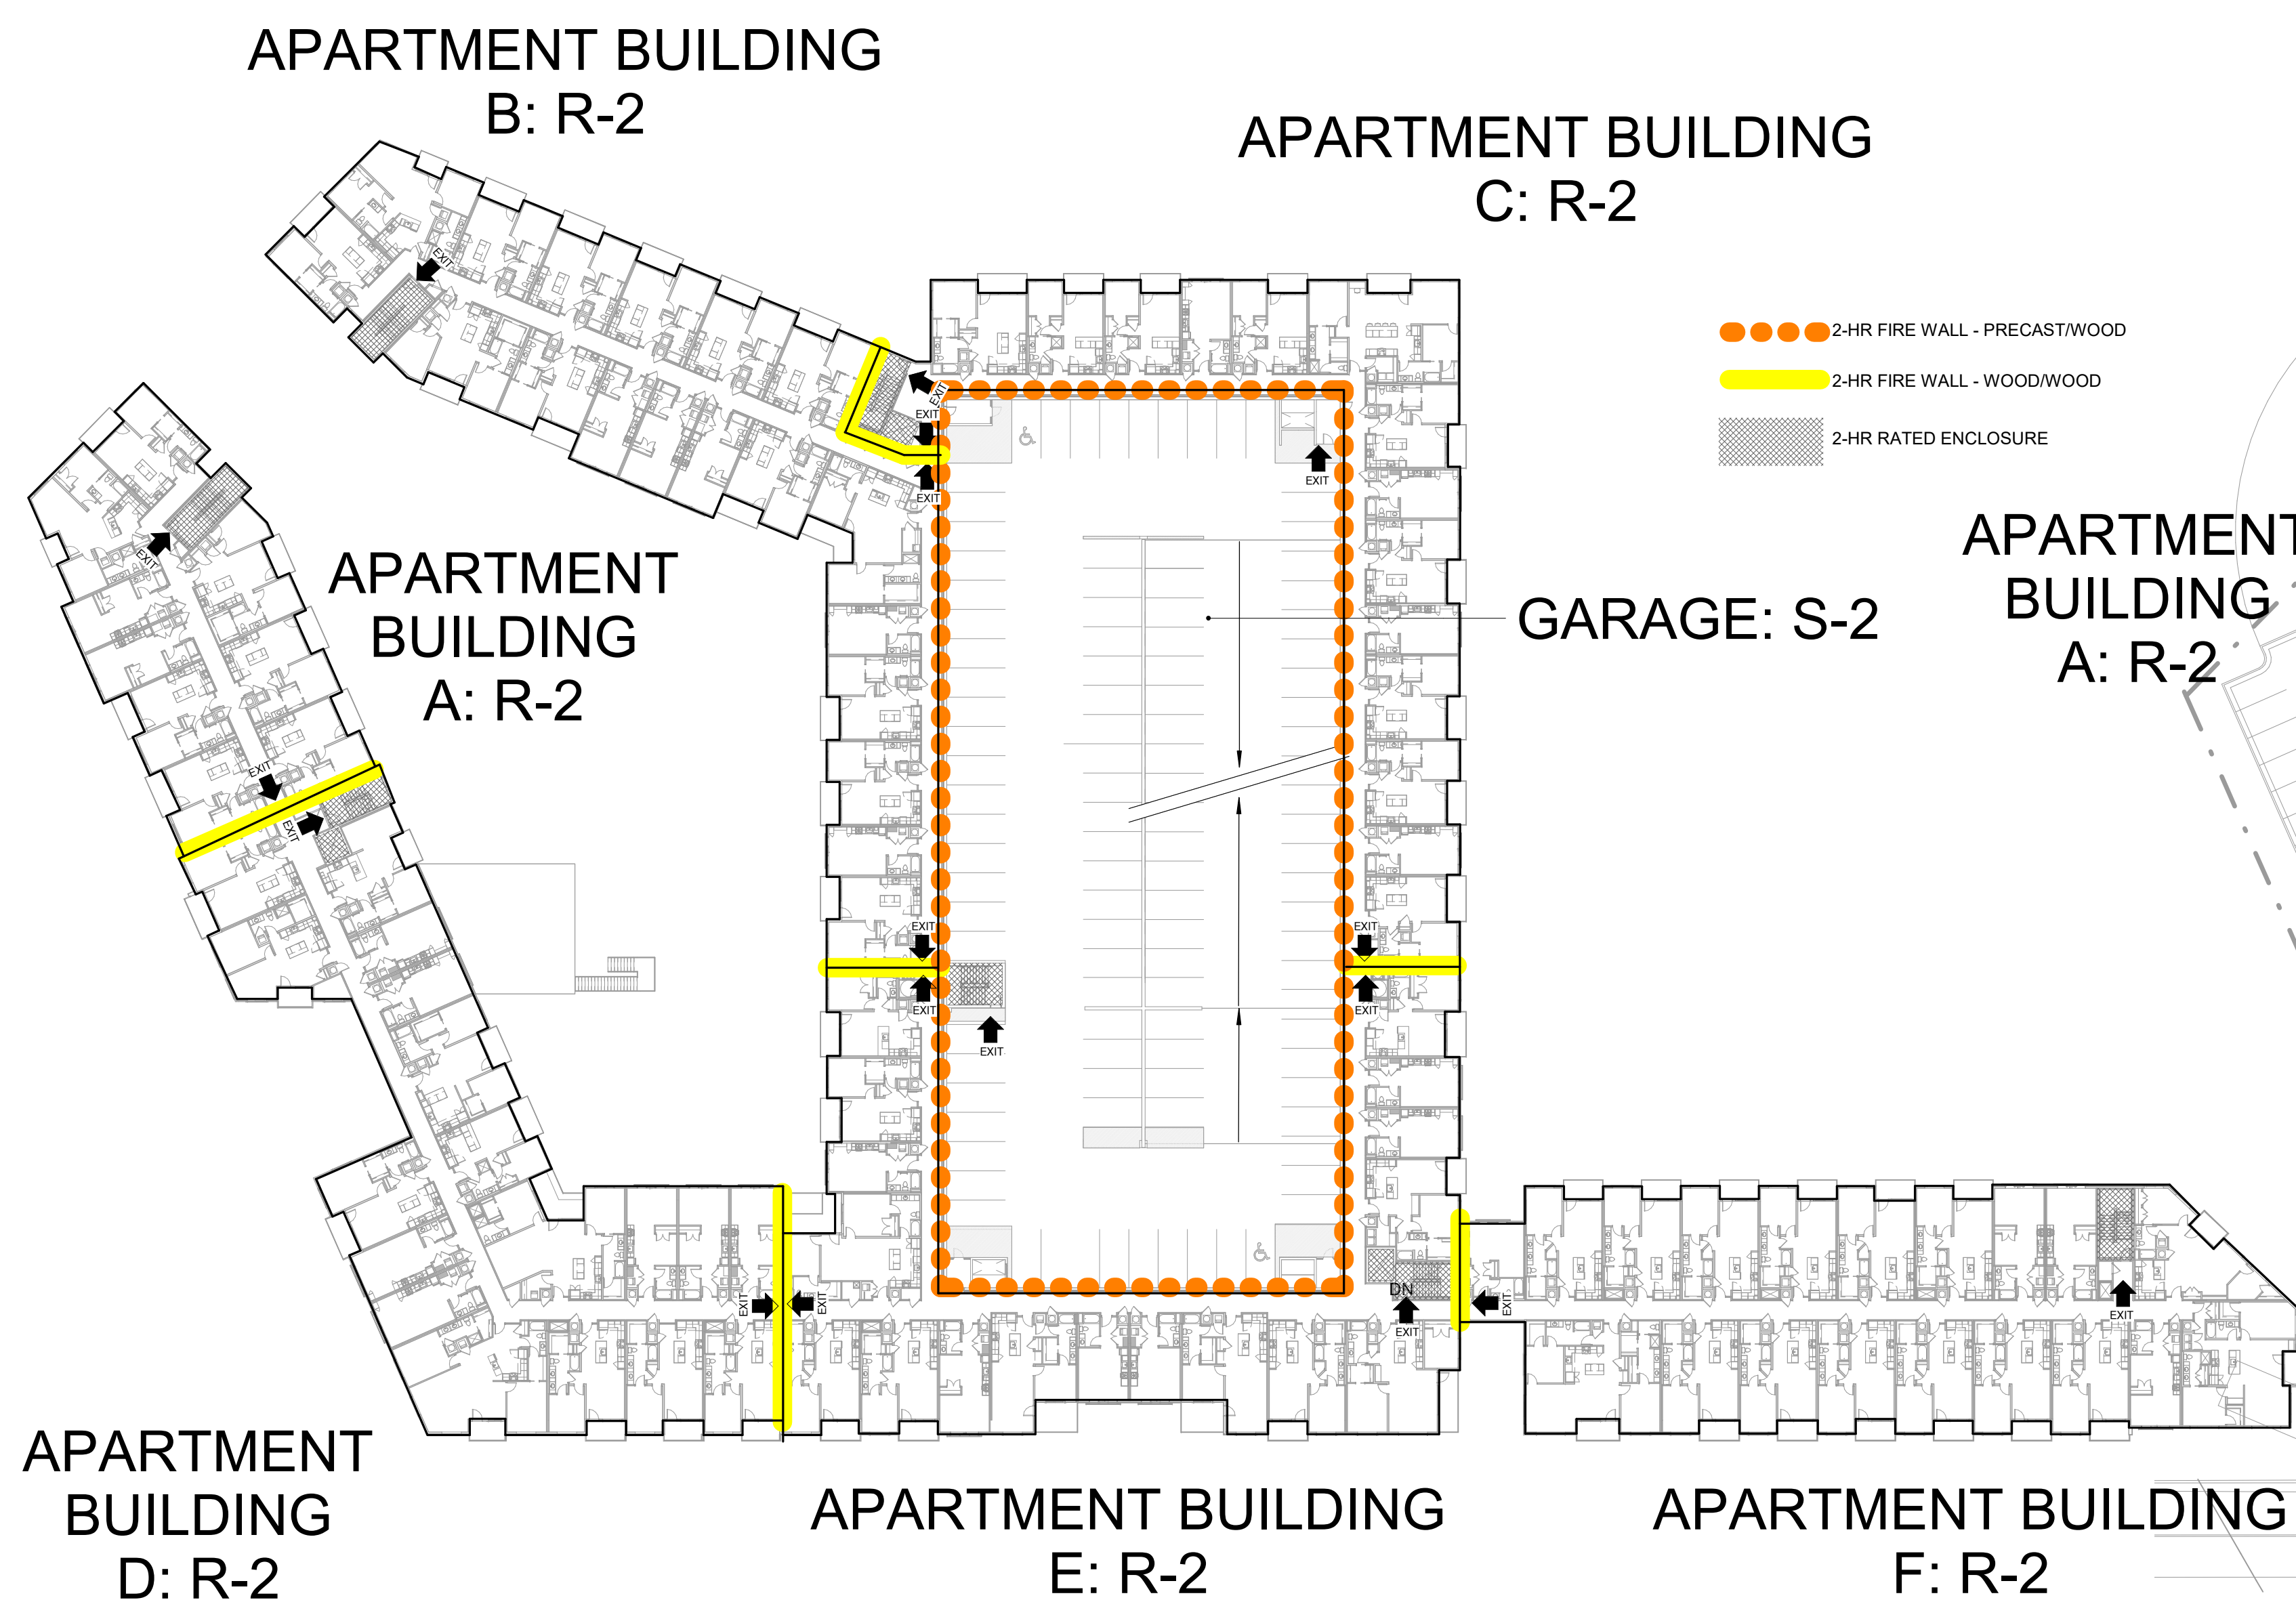

4 | CODEPLAN - 38.4
1" = 40'-0"

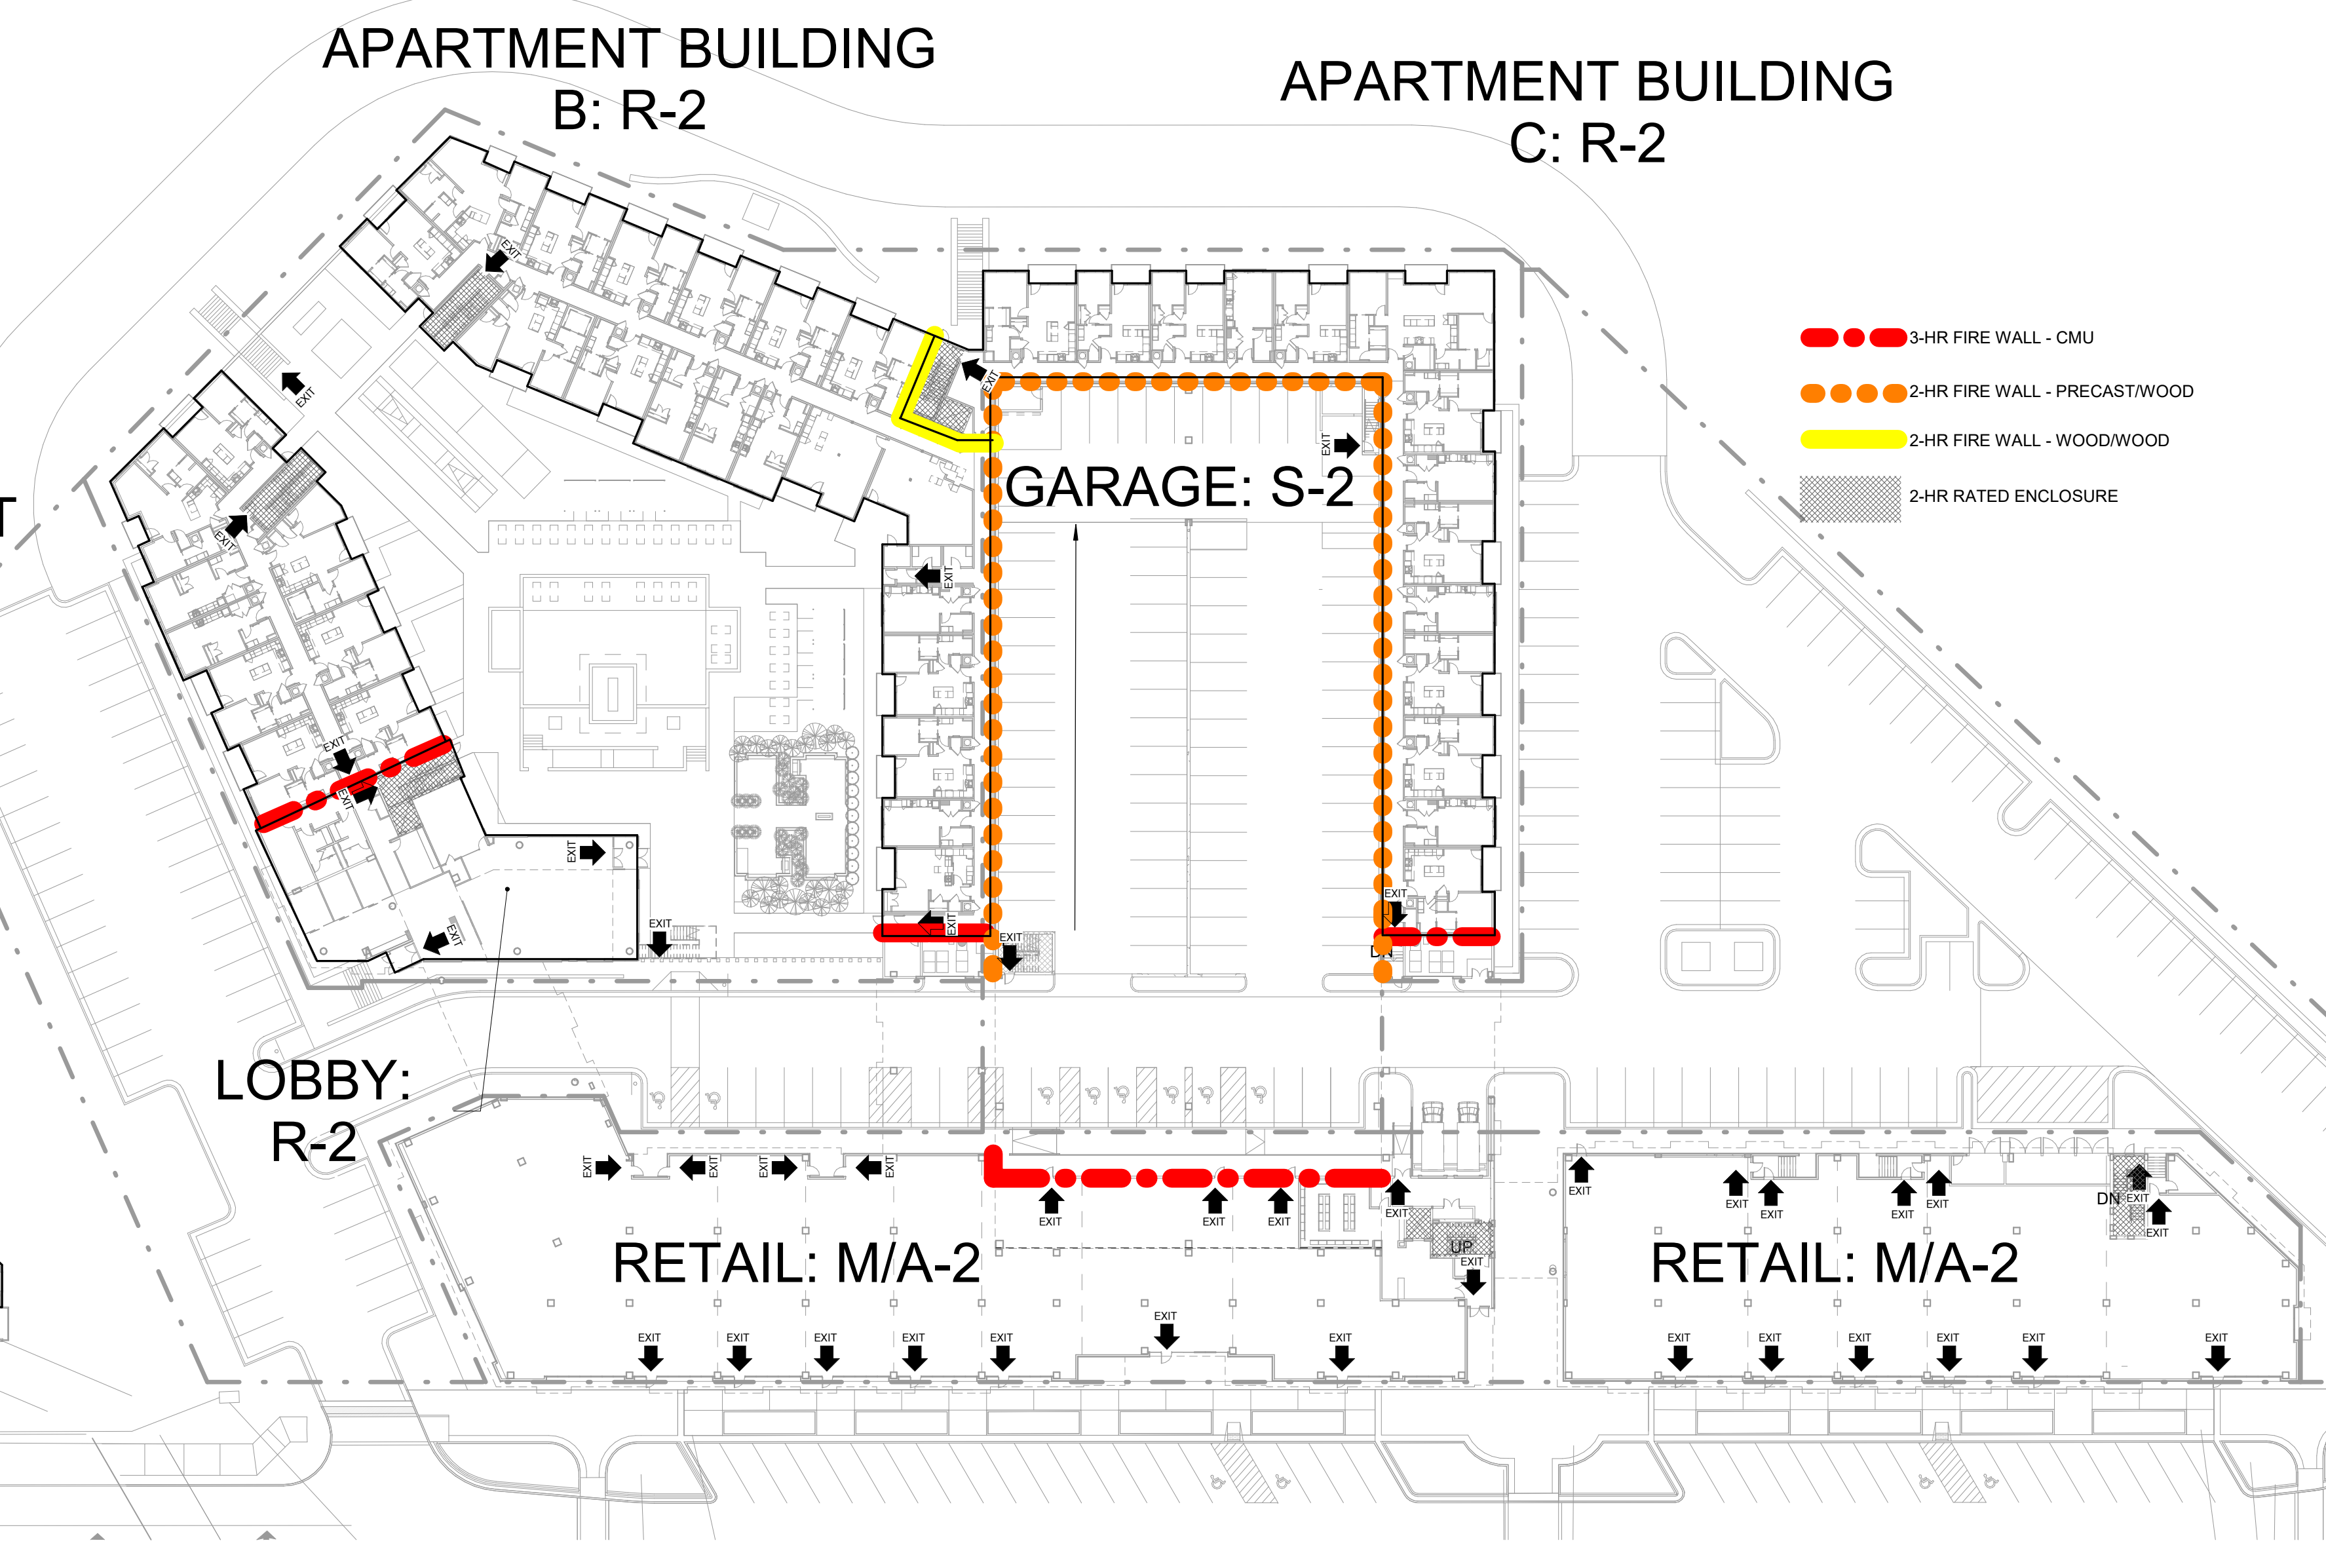

1 | CODEPLAN - 1
1" = 40'-0"



PARAGON STAR
NORTH VILLAGE

3200 NW PARAGON PKWY
LEE'S SUMMIT, MO 64081

Project No.: 18017.19050.07, 19050.08
Date: 02.04.22
Issued For: GARAGE PERMIT

REVISIONS		
No.	Date	Description

REGISTRATION



PROJECT TEAM

ARCHITECT	FINKLE+WILLIAMS ARCHITECTURE
CIVIL	GBA ENGINEERS
LANDSCAPE	LAND 3
STRUCTURAL	BOB D. CAMPBELL
PLUMBING	LATIMER SOMMERS
MECHANICAL	LATIMER SOMMERS
ELECTRICAL	LATIMER SOMMERS
FIRE PROTECTION	LATIMER SOMMERS
CONTRACTOR	BRINKMANN CONSTRUCTORS



FINKLE + WILLIAMS
ARCHITECTURE
8787 RENNER BLVD., SUITE 100
LENEXA, KANSAS 66219
913.498.1550
www.finklewilliams.com

SHEET TITLE

CODE

SHEET NUMBER

A0.03

C:\Users\Katie.Kerner\Documents\Paragon Star_MultiFamily_R21\Central_Kelsier\Garage.rvt



3200 NW PARAGON PKWY
LEE'S SUMMIT, MO 64081


Project No.: 18017,19050.07,19050.08

Date: 02.04.22

Issued For: GARAGE PERMIT

[illegible]

REGISTRATION

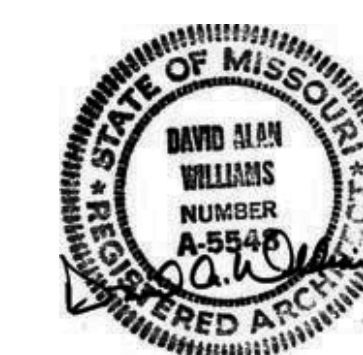

PROJECT TEAM

ARCHITECT FINKLE+WILLIAMS
ARCHITECTURE

CIVIL GBA ENGINEERS

LANDSCAPE LAND 3

STRUCTURAL BOB D. CAMPBELL

PLUMBING LATIMER SOMMERS

MECHANICAL LATIMER SOMMERS

ELECTRICAL LATIMER SOMMERS

FIRE PROTECTION LATIMER SOMMERS

CONTRACTOR BRINKMANN
CONSTRUCTORS

FINKLE + WILLIAMS
ARCHITECTURE


8787 RENNER BLVD., SUITE 100
LENEXA, KANSAS 66219
913.498.1550
www.finklewilliams.com

SHEET TITLE

ARCHITECTURAL SITE PLAN & DETAILS

SHEET NUMBER

A0.10

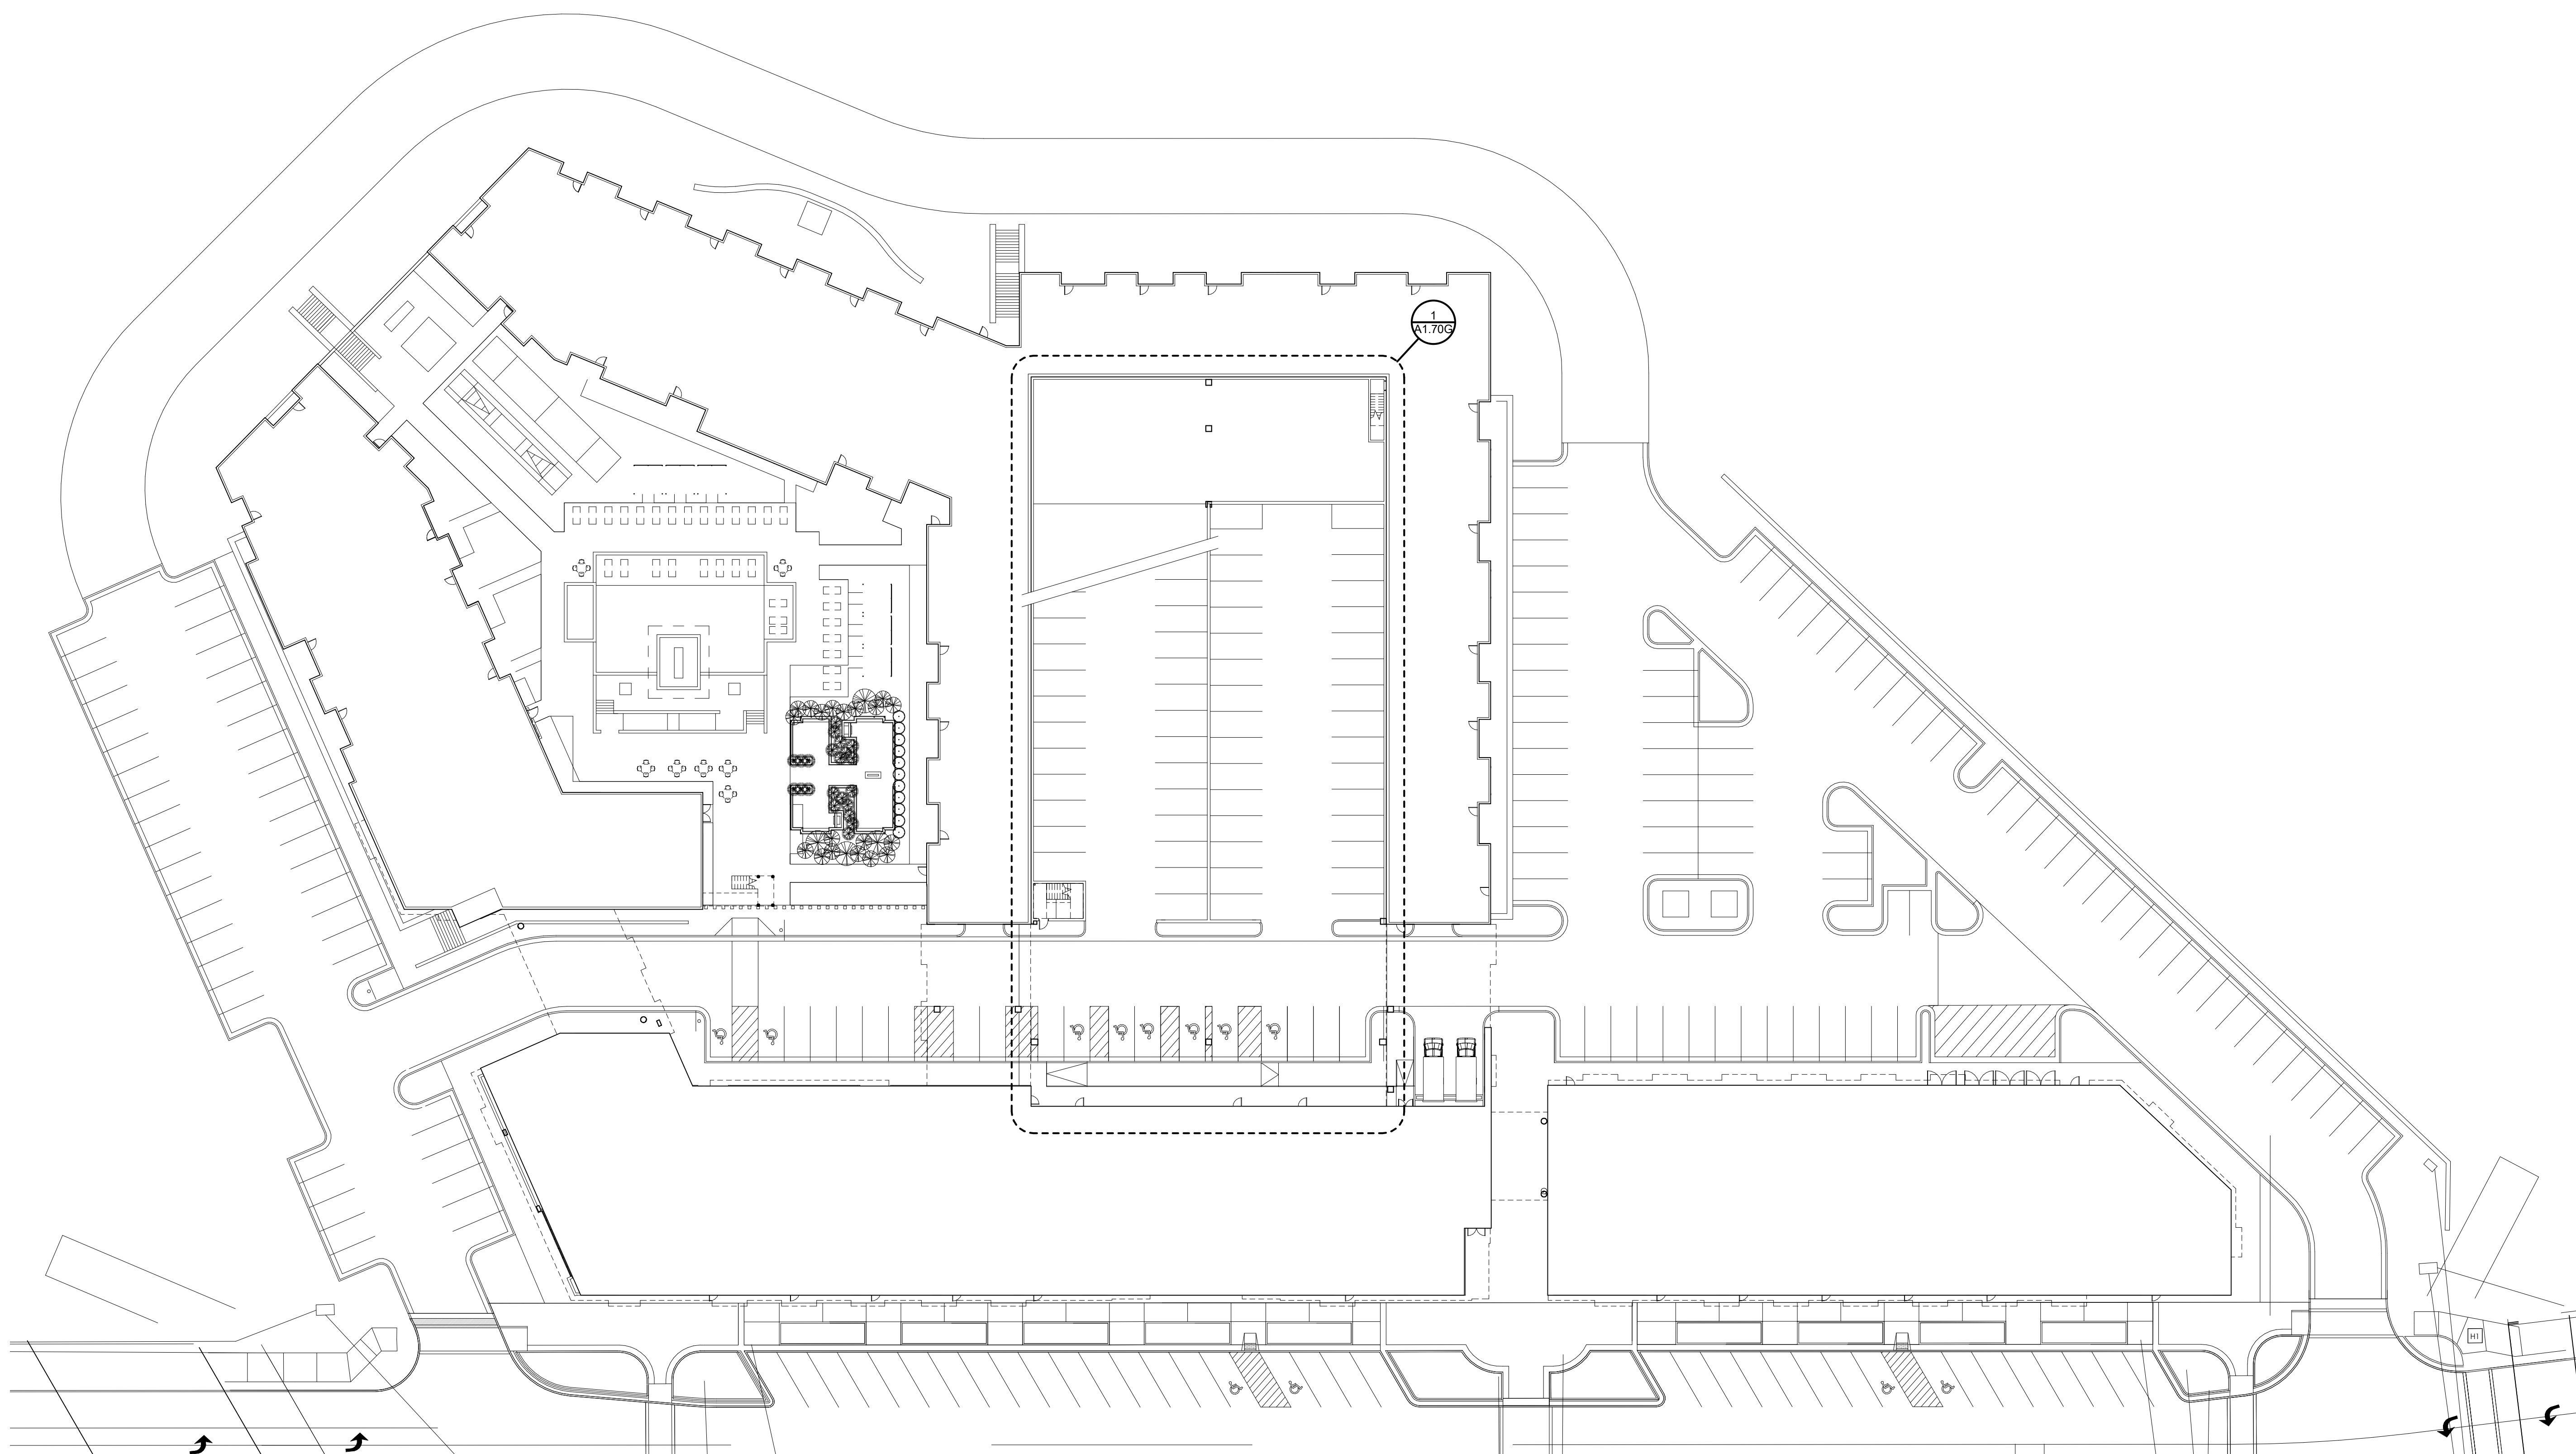


SITE PLAN GENERAL NOTES

1. CONTROL JOINT SEALANT FOR CONCRETE PAVING AND BETWEEN BUILDING AND PAVING TO BE GRAY COLOR TO MATCH CONCRETE.

2

ARCHITECTURAL SITE PLAN

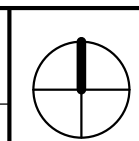

SCALE : 1" = 30'-0"



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LEE'S SUMMIT, MO 64081


Project No.: 18017,19050.07,19050.08

Date: 02.04.22

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REGISTRATION



PROJECT TEAM

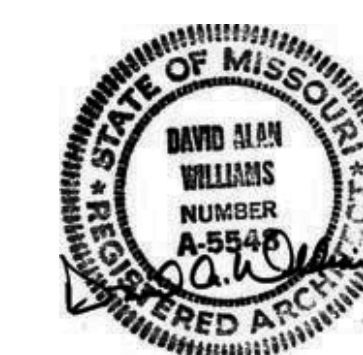ARCHITECT	FINKLE-WILLIAMS ARCHITECTURE
CIVIL	GBA ENGINEERS
LANDSCAPE	LAND 3
STRUCTURAL	BOB D. CAMPBELL
PLUMBING	LATIMER SOMMERS
MECHANICAL	LATIMER SOMMERS
ELECTRICAL	LATIMER SOMMERS
FIRE PROTECTION	LATIMER SOMMERS
CONTRACTOR	BRINKMANN CONSTRUCTORS

FINKLE + WILLIAMS
ARCHITECTURE


8787 RENNER BLVD., SUITE 100
LENEXA, KANSAS 66219
913.498.1550
www.finklewilliams.com

SHEET TITLE

GARAGE FIRST
FLOOR PLAN AT
GRADE

SHEET NUMBER

A1.70G

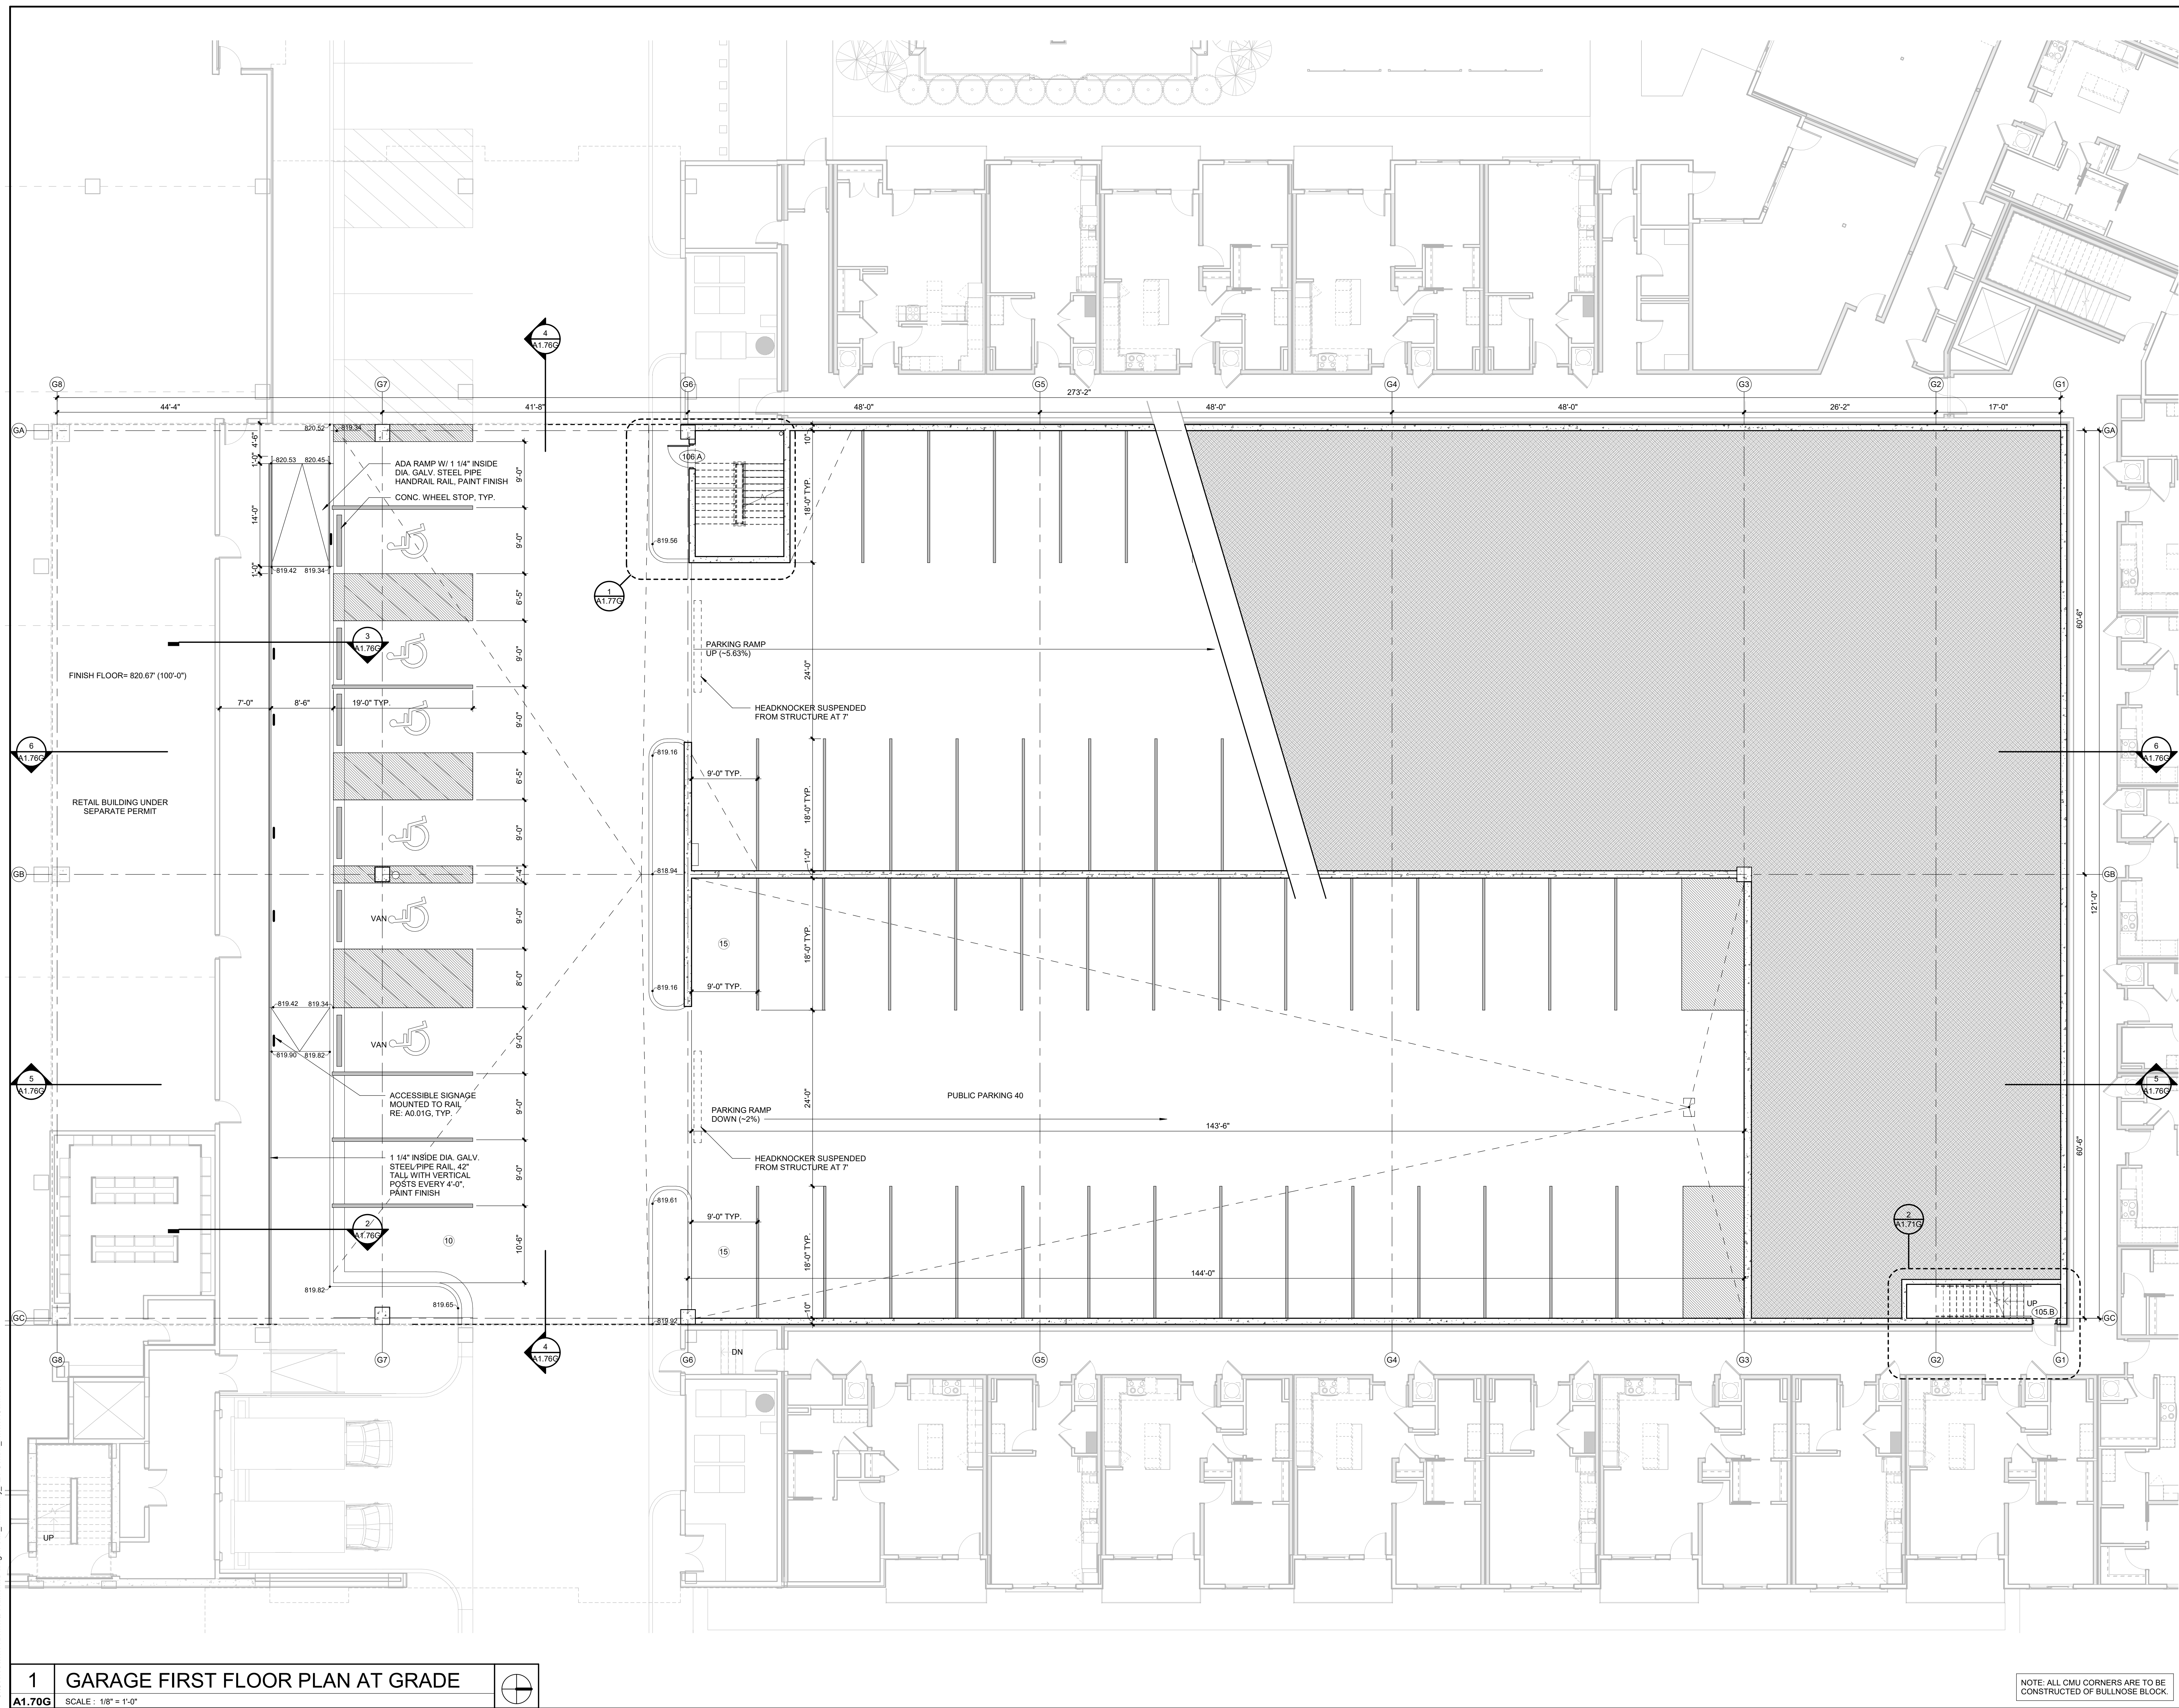



00 NW PARAGON PKWY
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No.:	18017,19050.07,19050.0
	02.04.22
For:	GARAGE PERMIT

[illegible]

REGISTRATION



PROJECT TEAM	
PROJECT	FINKLE+WILLIAM ARCHITECTURE GBA ENGINEERING
SCOPE	LAND 3
CULTURAL	BOB D. CAMPBELL
PLANNING	LATIMER SOMMER
MECHANICAL	LATIMER SOMMER
ELECTRICAL	LATIMER SOMMER
PROTECTION	LATIMER SOMMER
TRACTOR	BRINKMANN CONSTRUCTORS

KLE + WILLIAM
ARCHITECTS


RENNER BLVD., SUITE 10
ENEXA, KANSAS 66219
913.498.1550
www.finklewilliams.com

SHEET TITLE

GARAGE FIRST FLOOR PLAN

SHEET NUMBER

A1.71G

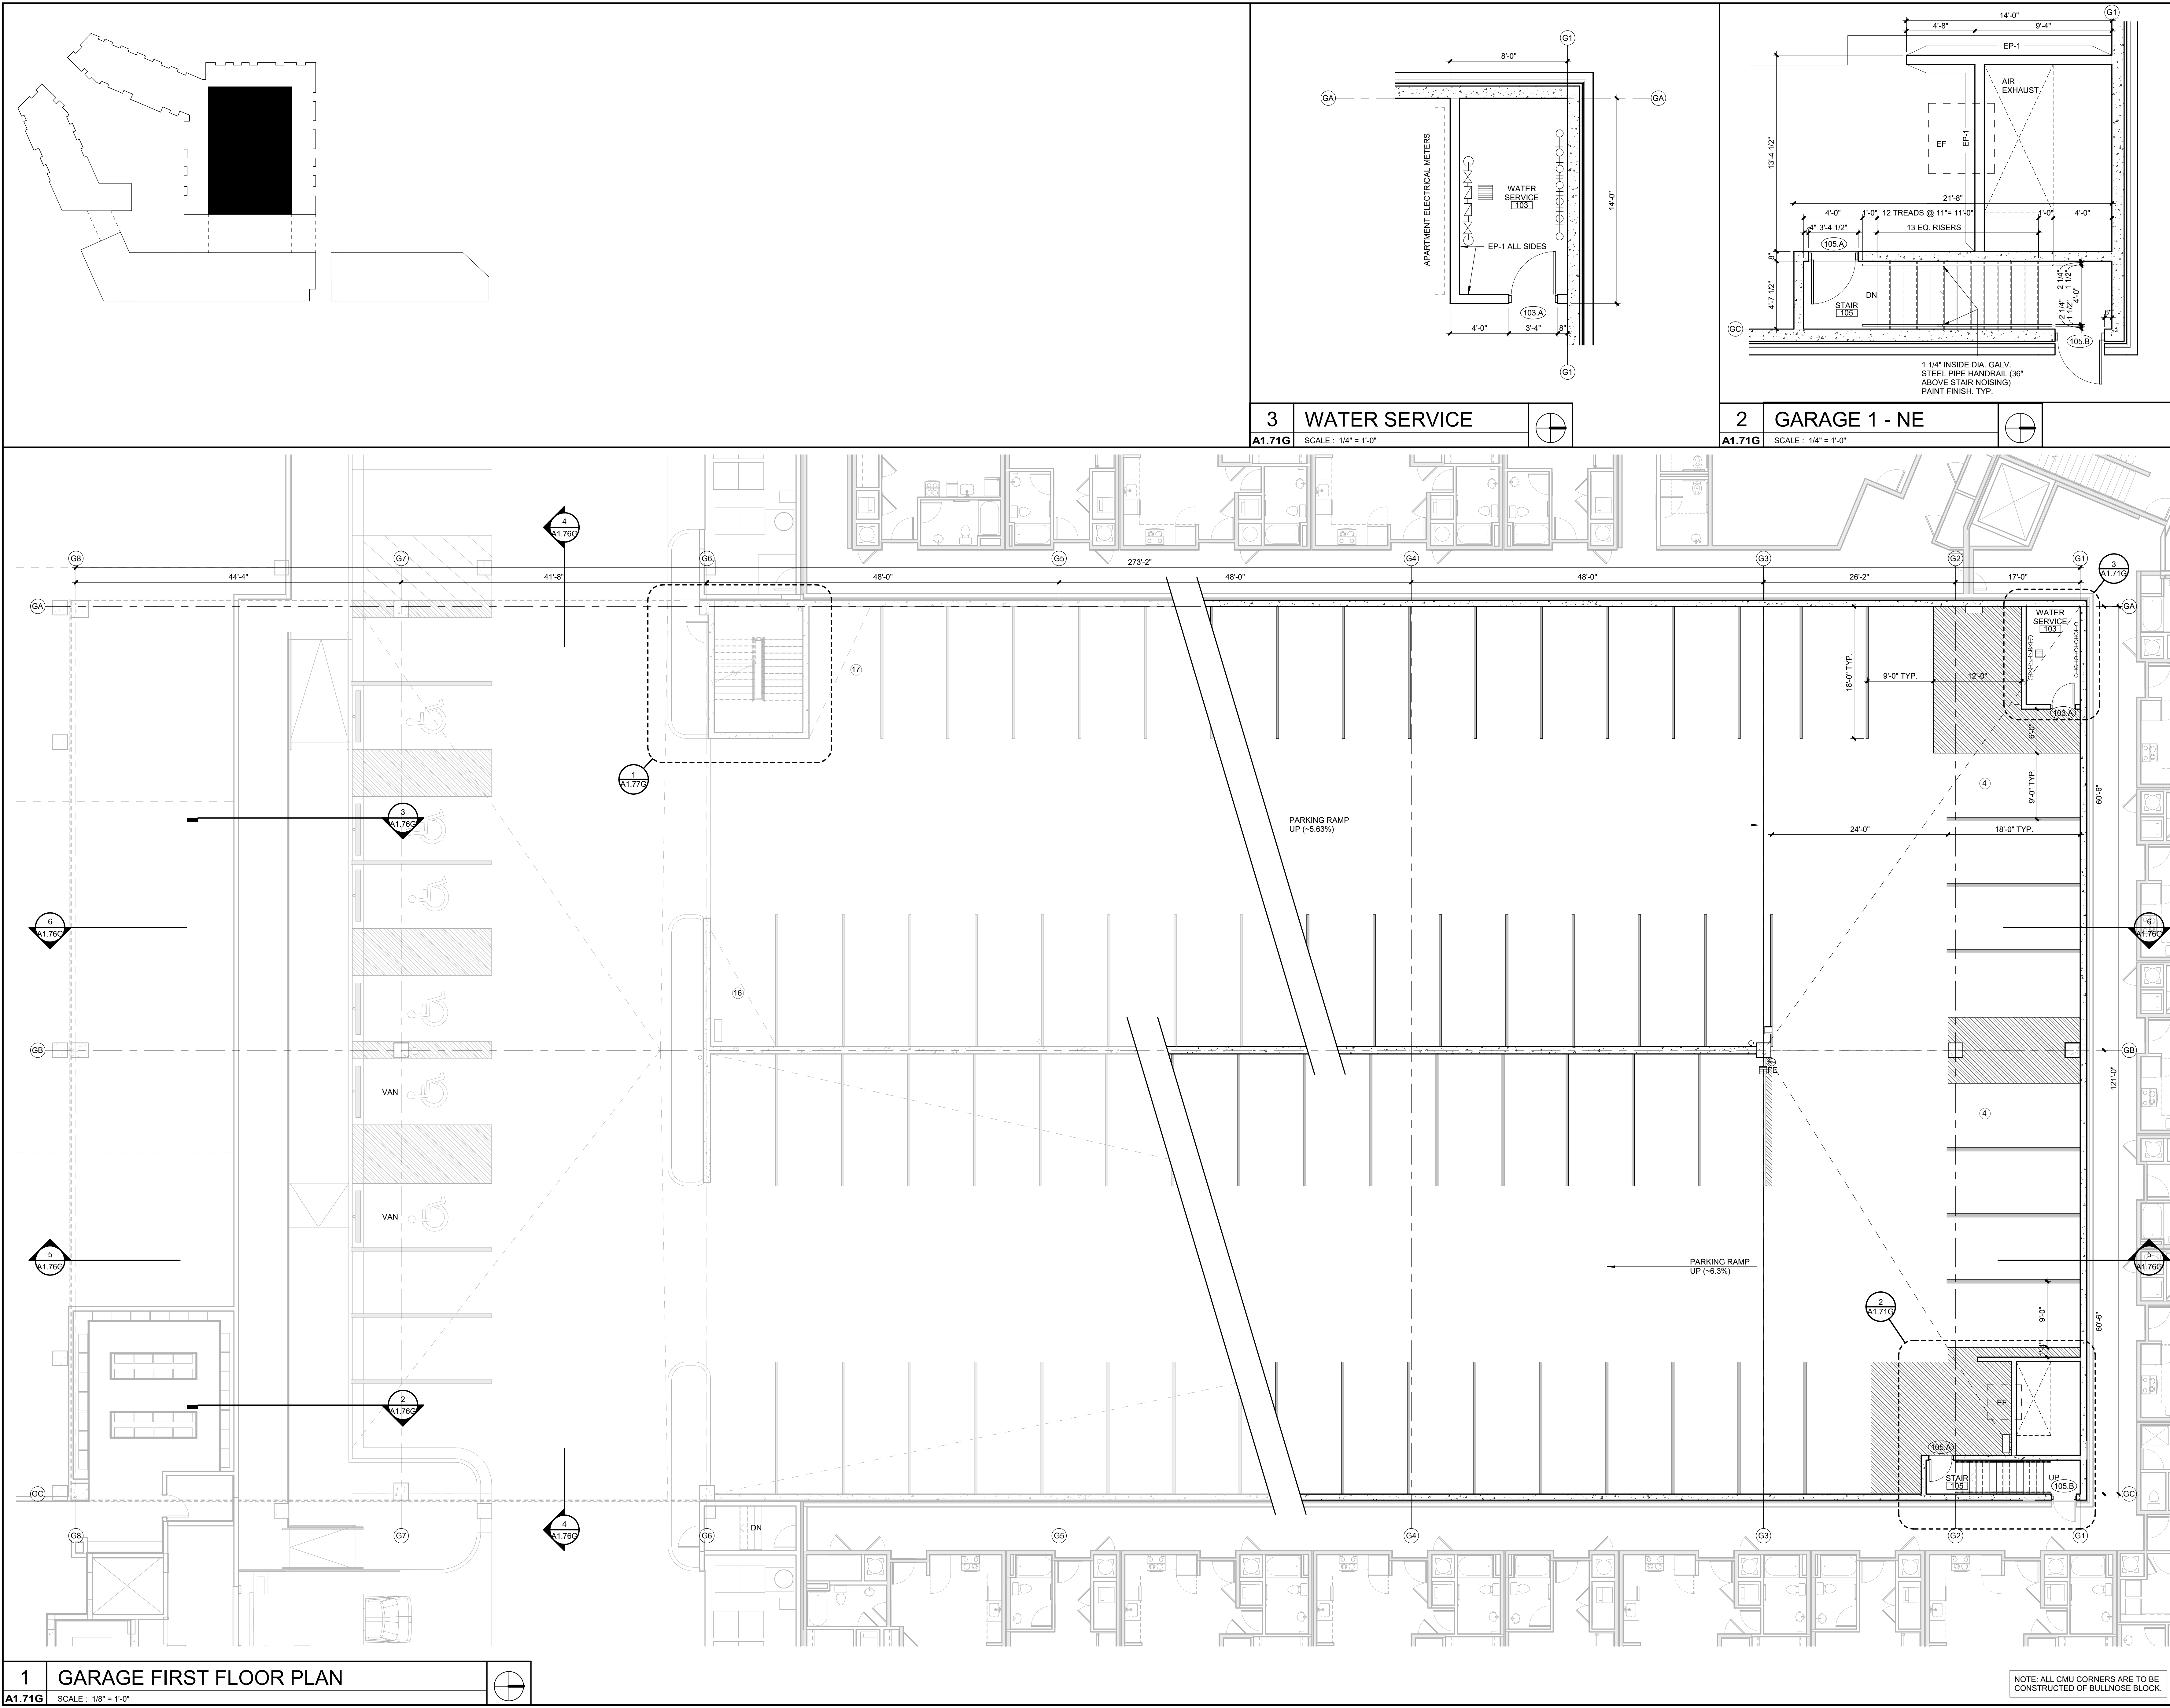



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REGISTRATION



PROJECT TEAM

TECT	FINKLE-WILLIAM ARCHITECTURE	GBA ENGINEERS
CAPE	LAND 3	
TURAL	BOB D. CAMPBELL	
ING	LATIMER SOMMER	
ICAL	LATIMER SOMMER	
ICAL	LATIMER SOMMER	
PROTECTION	LATIMER SOMMER	
FACTOR	BRINKMANN CONSTRUCTORS	

KLE + WILLIAM
ARCHITECTS


RENNER BLVD., SUITE 10
ENEXA, KANSAS 66219
913.498.1550
www.finklewilliams.com

SHEET TITLE

GARAGE
 SECOND FLOOR
 PLAN

SHEET NUMBER

A1.72G

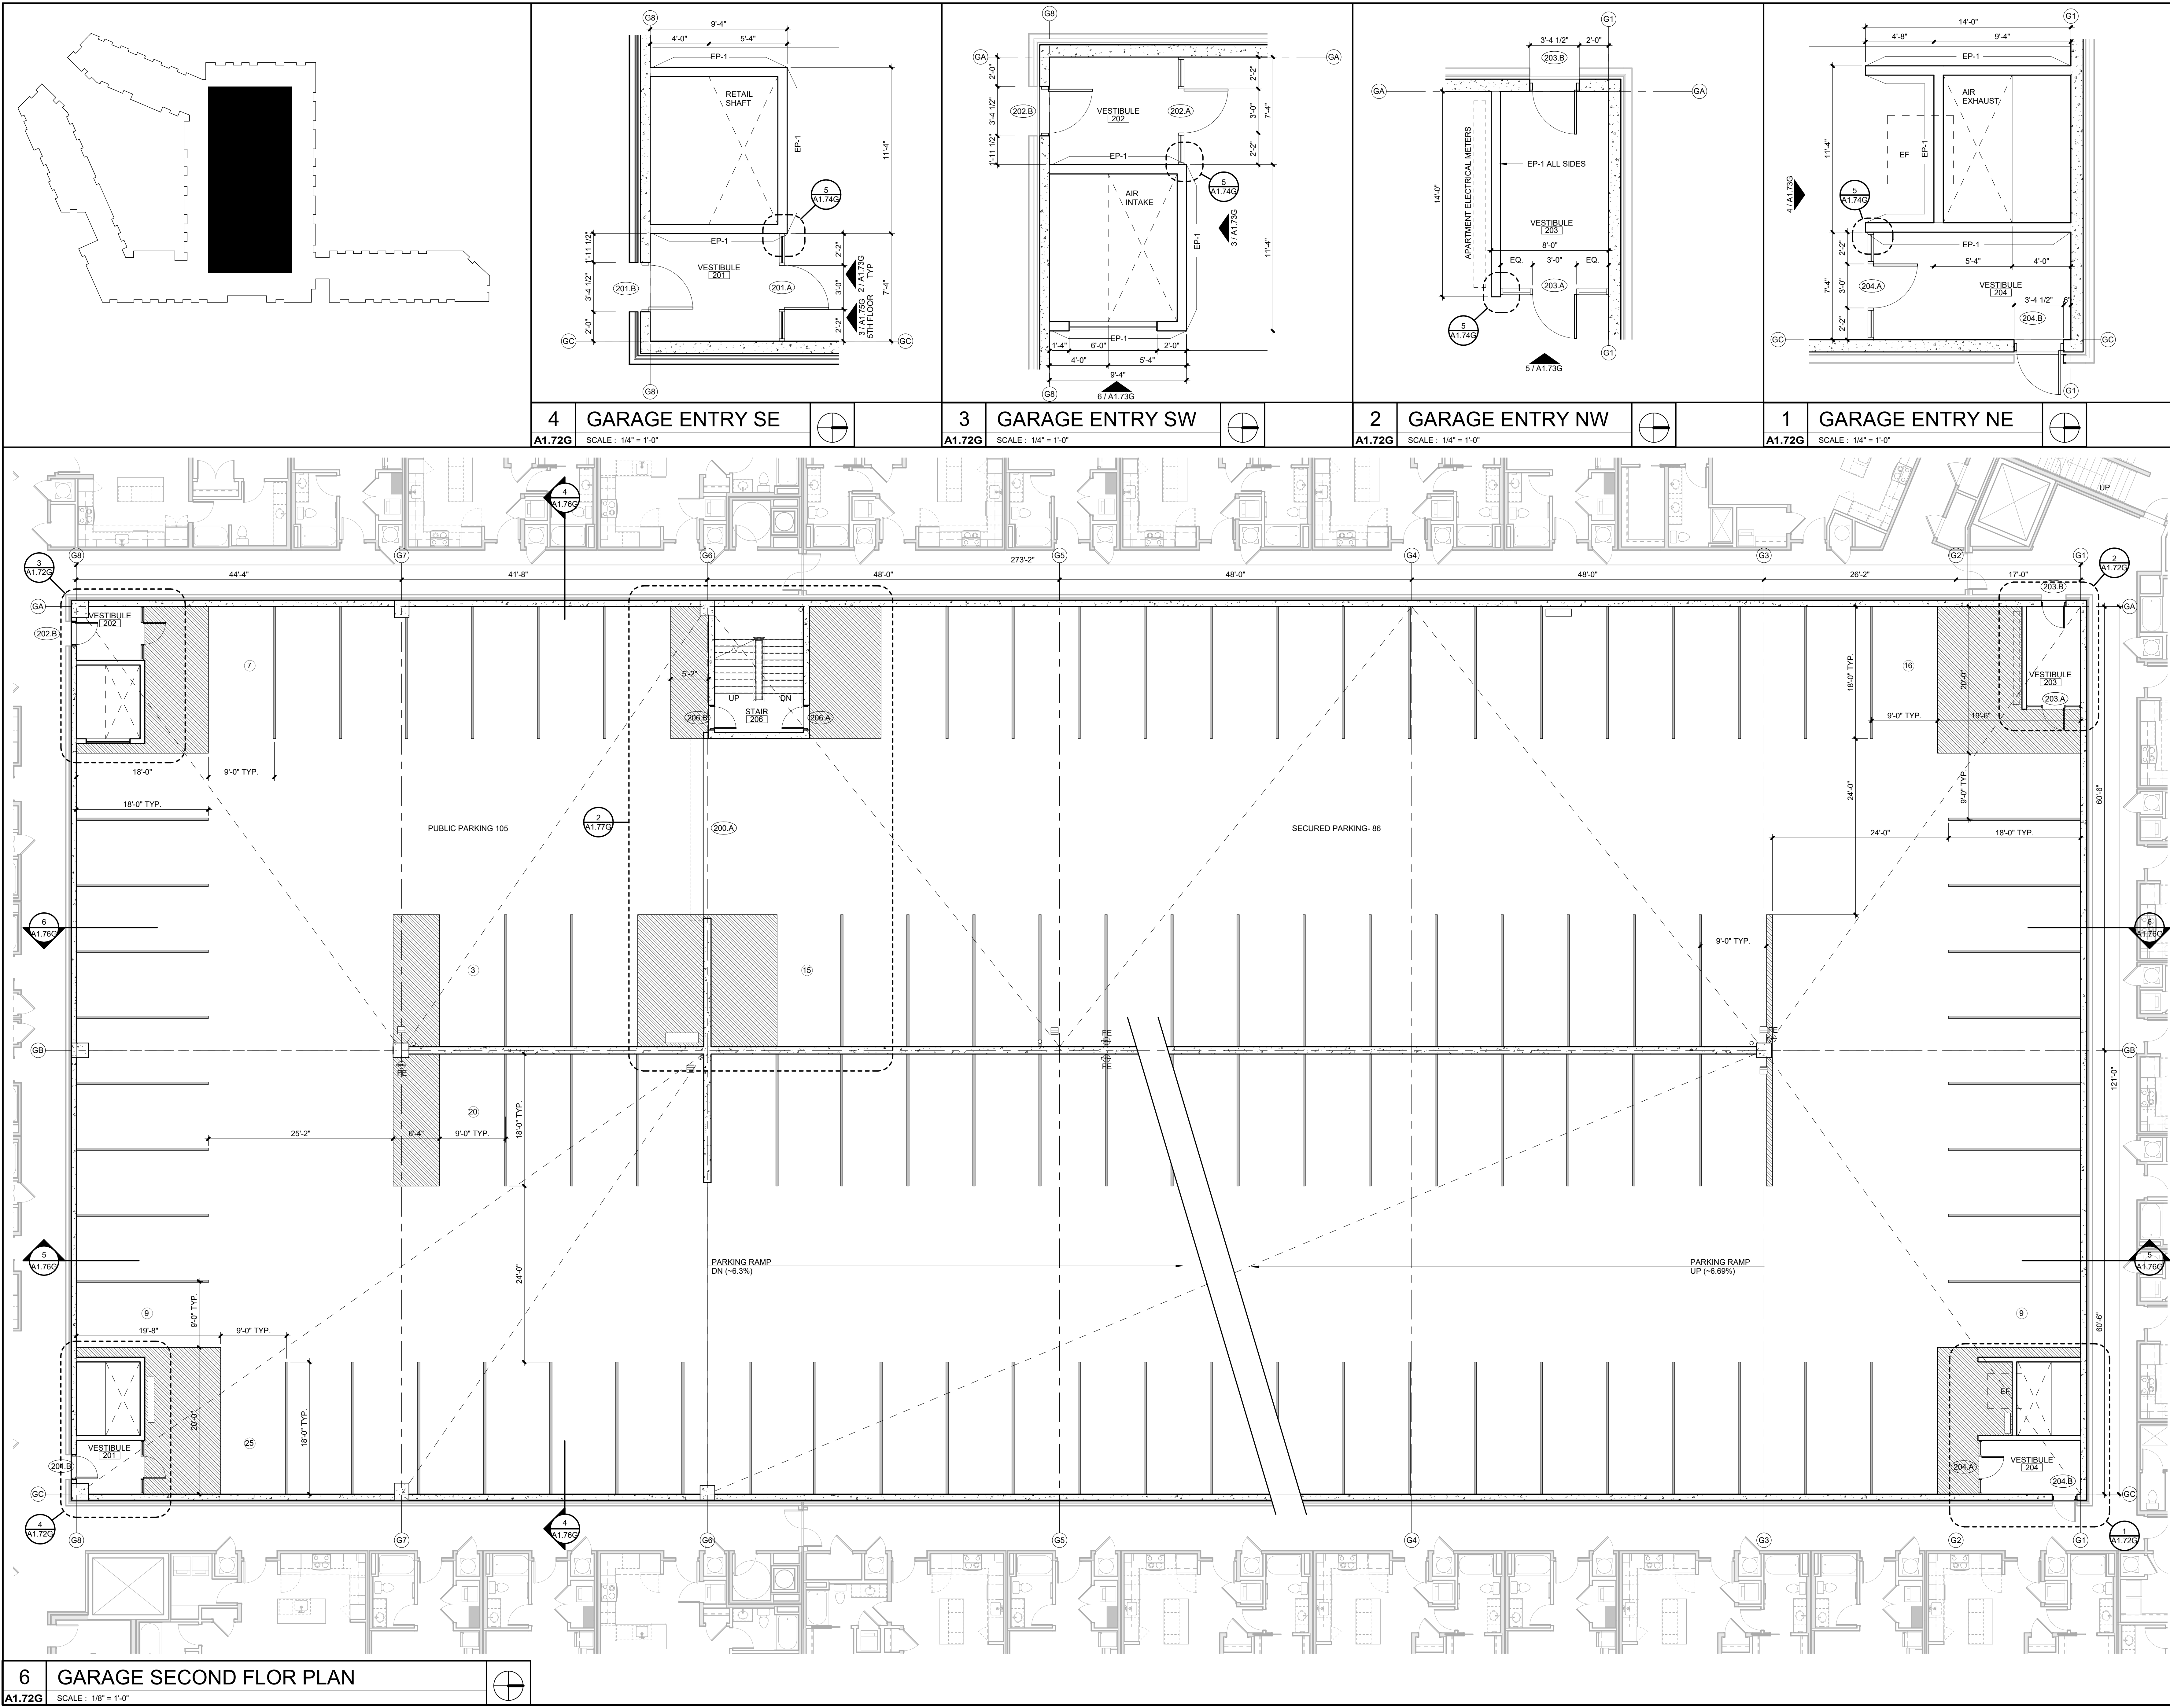

C:\Users\Kelsie Kremer\Documents\Paragon Star Multifamily R21-Central KelsieRCares.mt



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No.:	18017,19050.07,19050.08
	02.04.22
For:	GARAGE PERMIT

[illegible]

REGISTRATION



PROJECT TEAM

TECT	FINKLE+WILLIAMS ARCHITECTURE	GBA ENGINEERS
CAPE	LAND 3	
TURAL	BOB D. CAMPBELL	
ING	LATIMER SOMMERS	
MINICAL	LATIMER SOMMERS	
IRICAL	LATIMER SOMMERS	
ROTECTION	LATIMER SOMMERS	
FACTOR	BRINKMANN CONSTRUCTORS	

KLE + WILLIAMS
ARCHITECTURE


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913.498.1550
www.finklewilliams.com

SHEET TITLE

PARAGE THIRD FLOOR PLAN

SHEET NUMBER

A1.73G

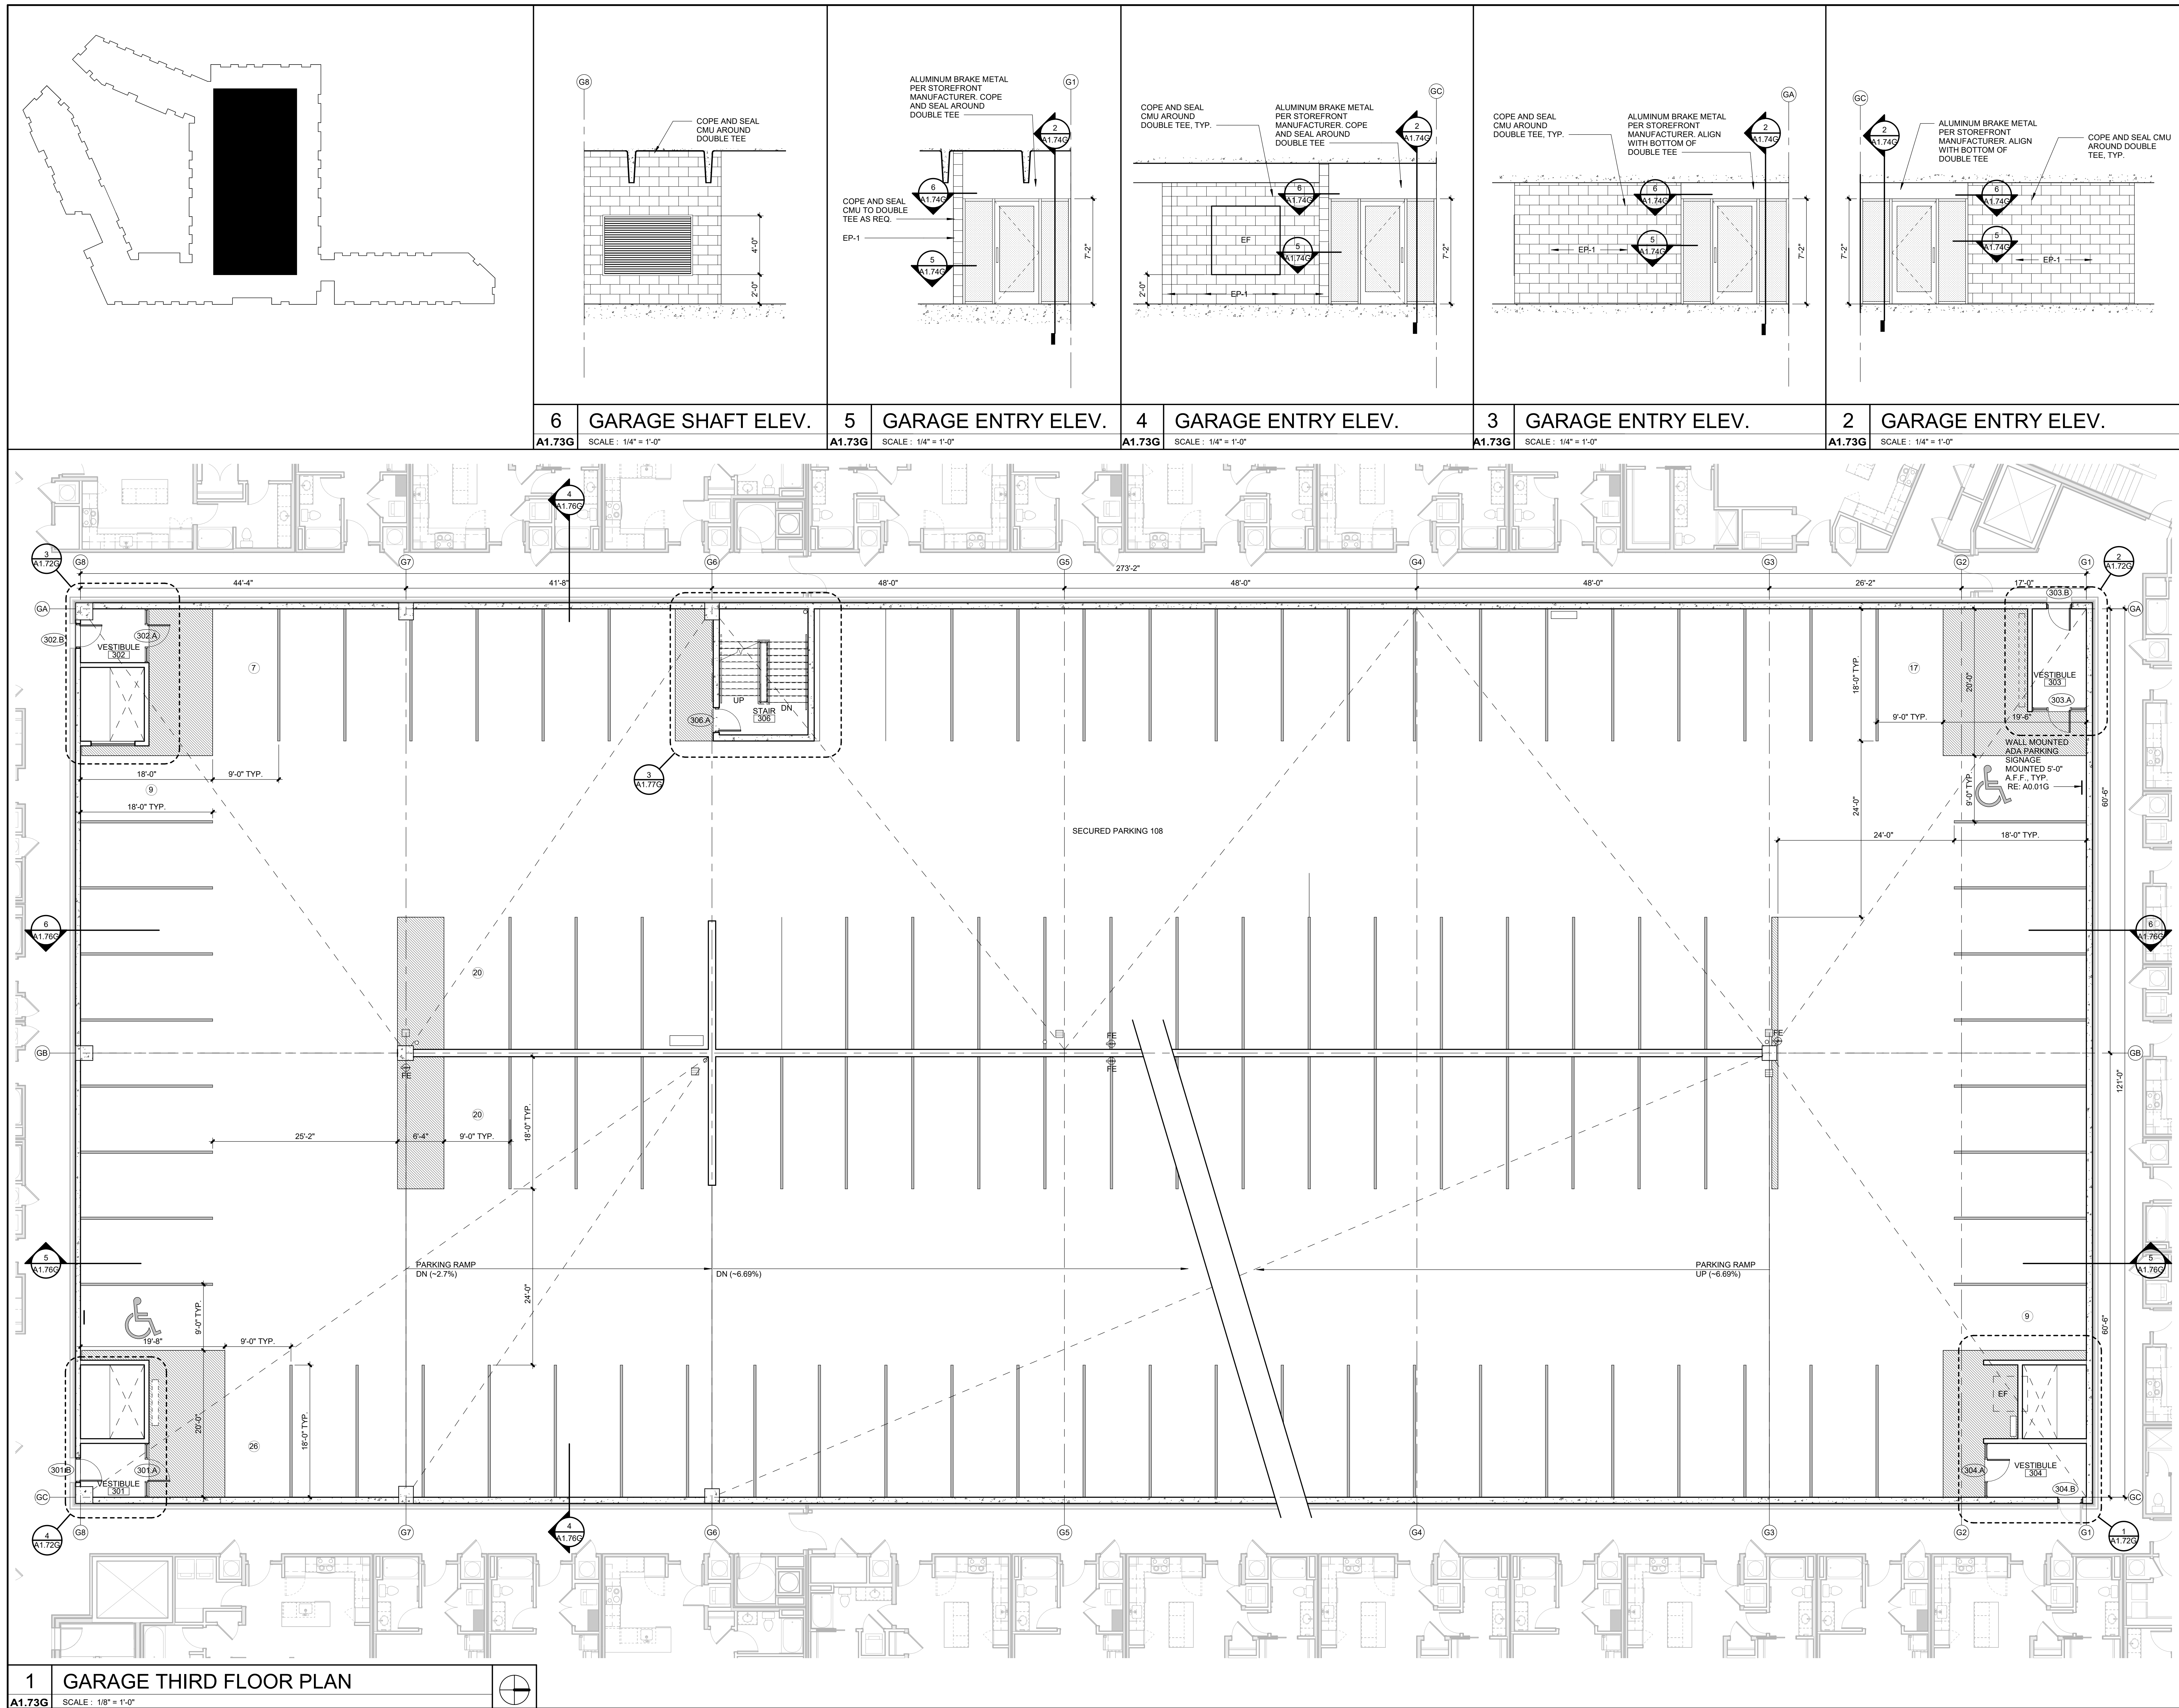



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	02.04.22
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REGISTRATION



PROJECT TEAM

TECT	FINKLE-WILLIAM ARCHITECTURE	GBA ENGINEERS
CAPE	LAND 3	
TURAL	BOB D. CAMPBELL	
ING	LATIMER SOMMER	
ICAL	LATIMER SOMMER	
ICAL	LATIMER SOMMER	
PROTECTION	LATIMER SOMMER	
FACTOR	BRINKMANN CONSTRUCTORS	

KLE + WILLIAM
ARCHITECTS


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ENEXA, KANSAS 66219
913.498.1550
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SHEET TITLE

GARAGE
 FOURTH FLOOR
 PLAN

SHEET NUMBER

A1.74G



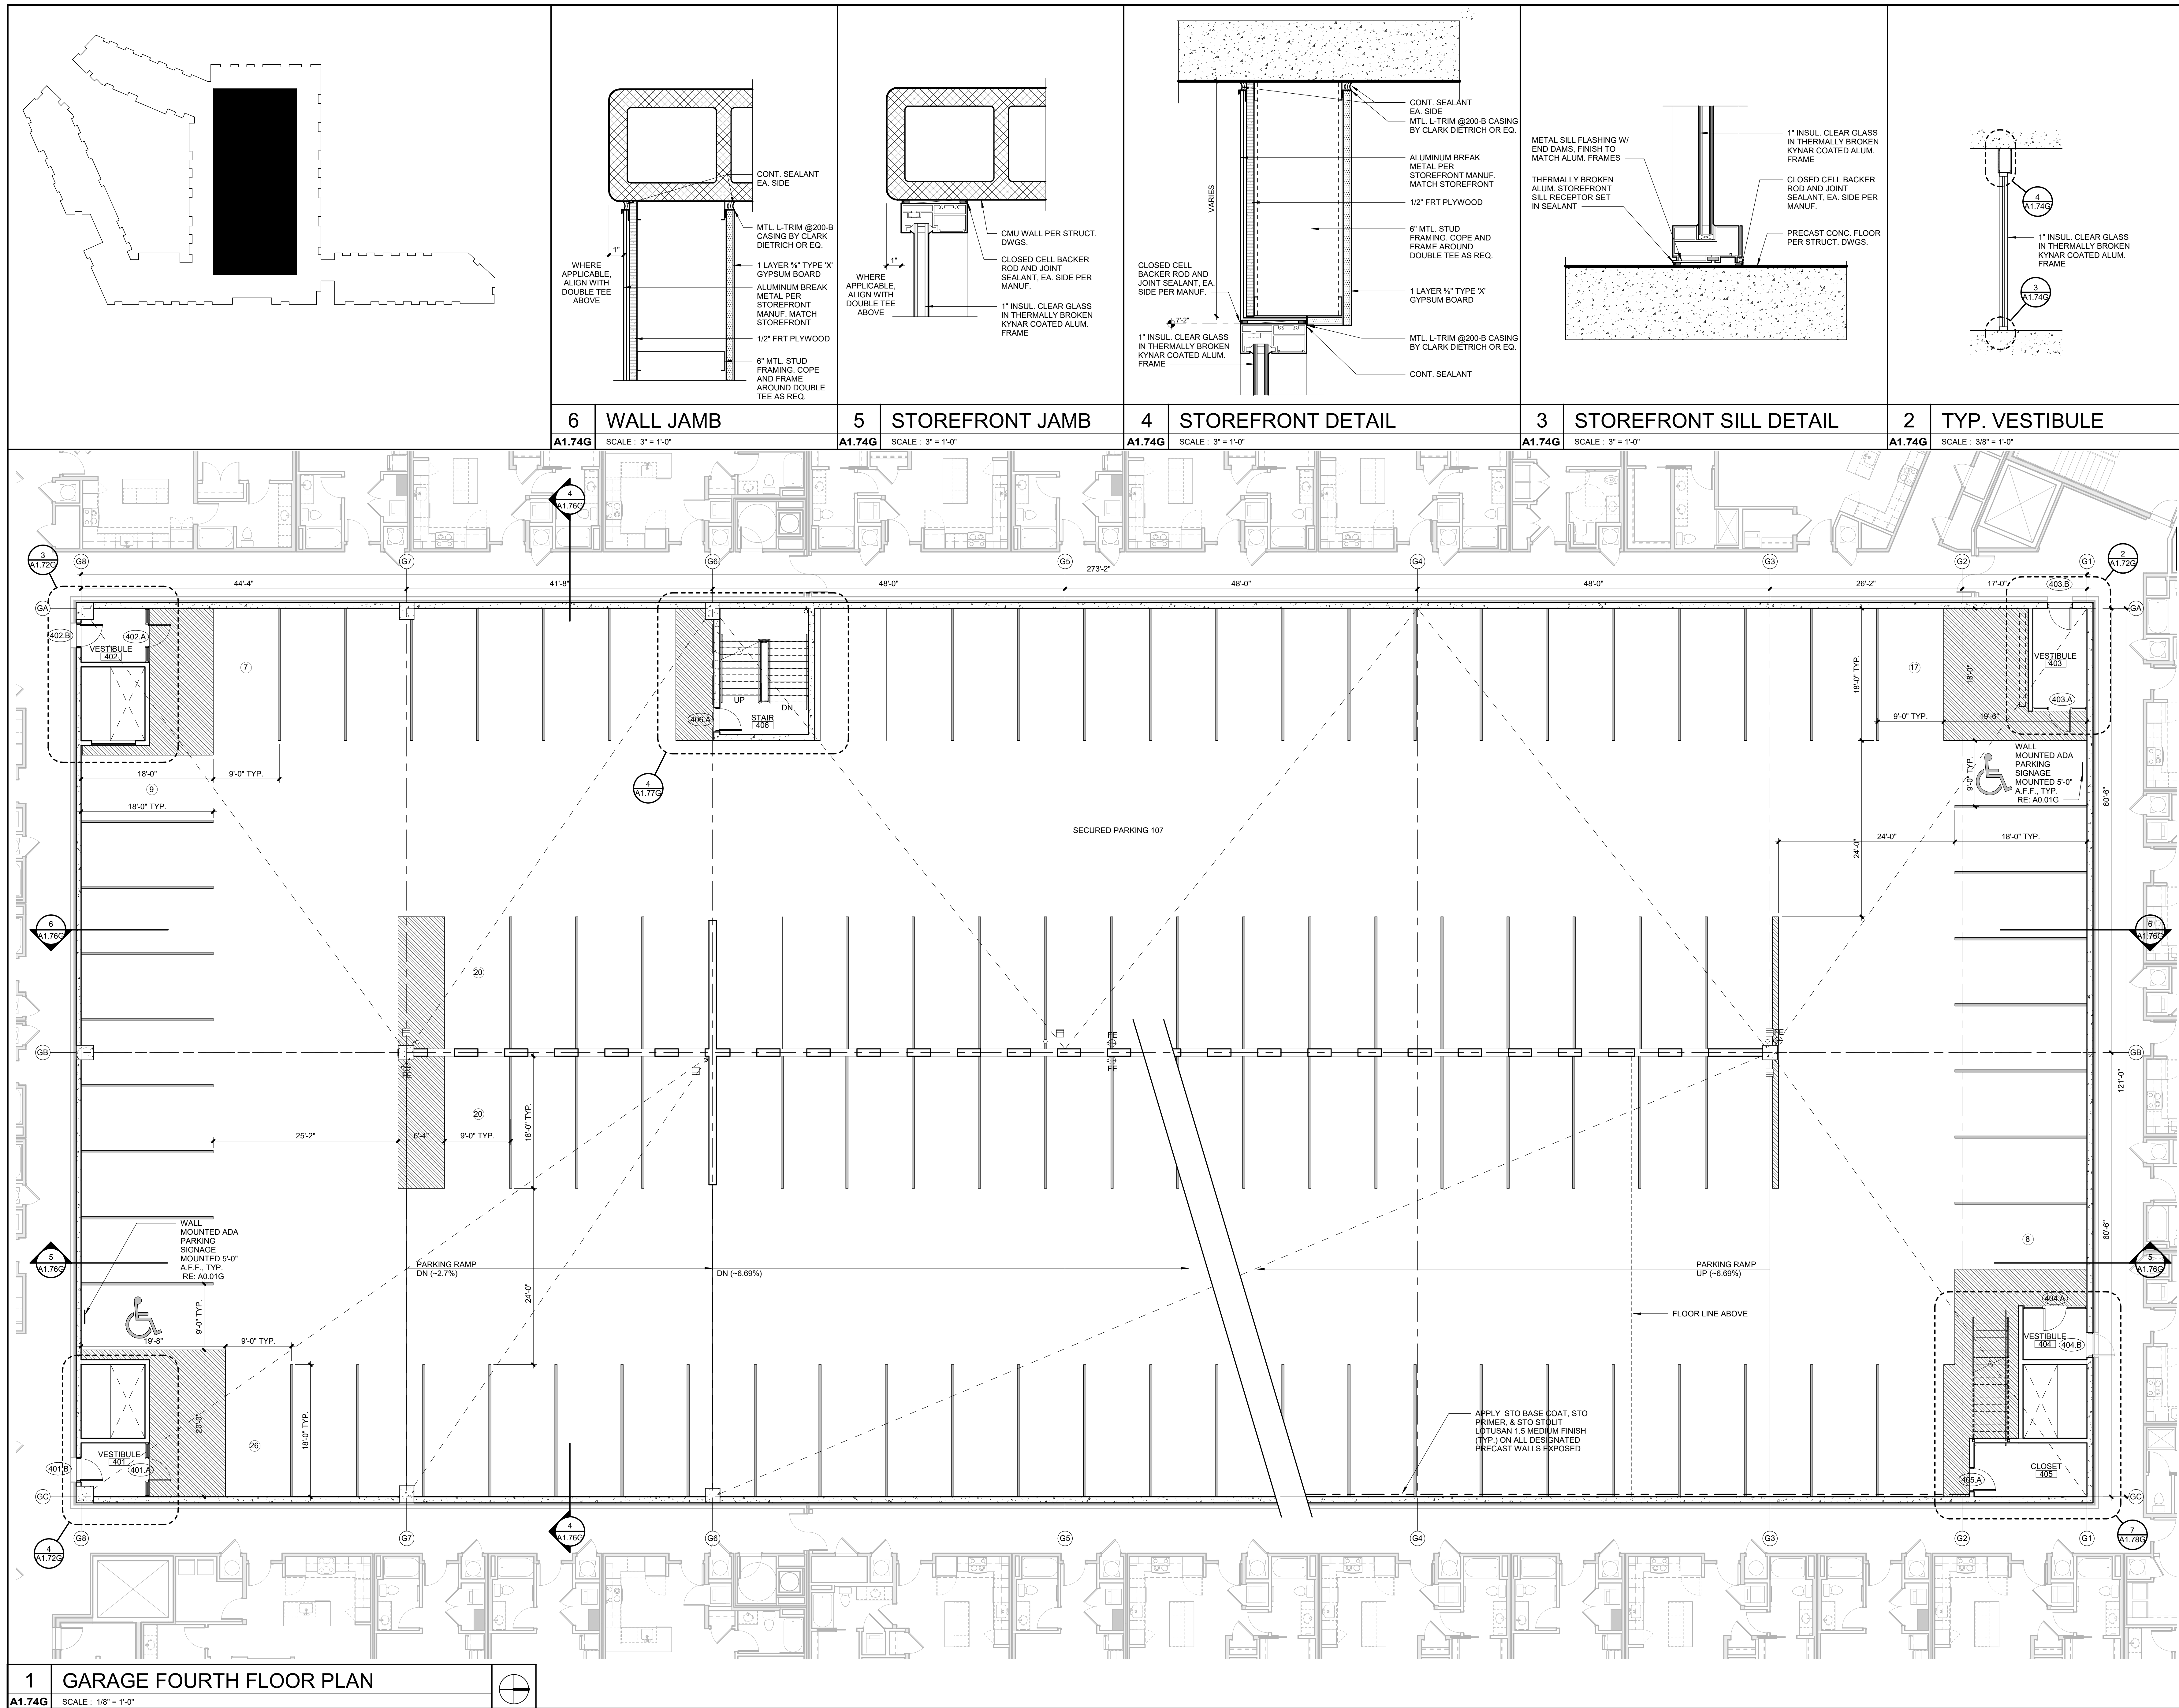

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E'S SUMMIT, MO 64081

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	02.04.22
For:	GARAGE PERMIT

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REGISTRATION



PROJECT TEAM

TECT	FINKLE-WILLIAM ARCHITECTURE	GBA ENGINEERS
CAPE	LAND 3	
TURAL	BOB D. CAMPBELL	
ING	LATIMER SOMMER	
ICAL	LATIMER SOMMER	
ICAL	LATIMER SOMMER	
PROTECTION	LATIMER SOMMER	
FACTOR	BRINKMANN CONSTRUCTORS	

KLE + WILLIAM
ARCHITECTS


RENNER BLVD., SUITE 10
ENEXA, KANSAS 66219
913.498.1550
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SHEET TITLE

PARAGE FIFTH FLOOR PLAN

SHEET NUMBER

A1.75G



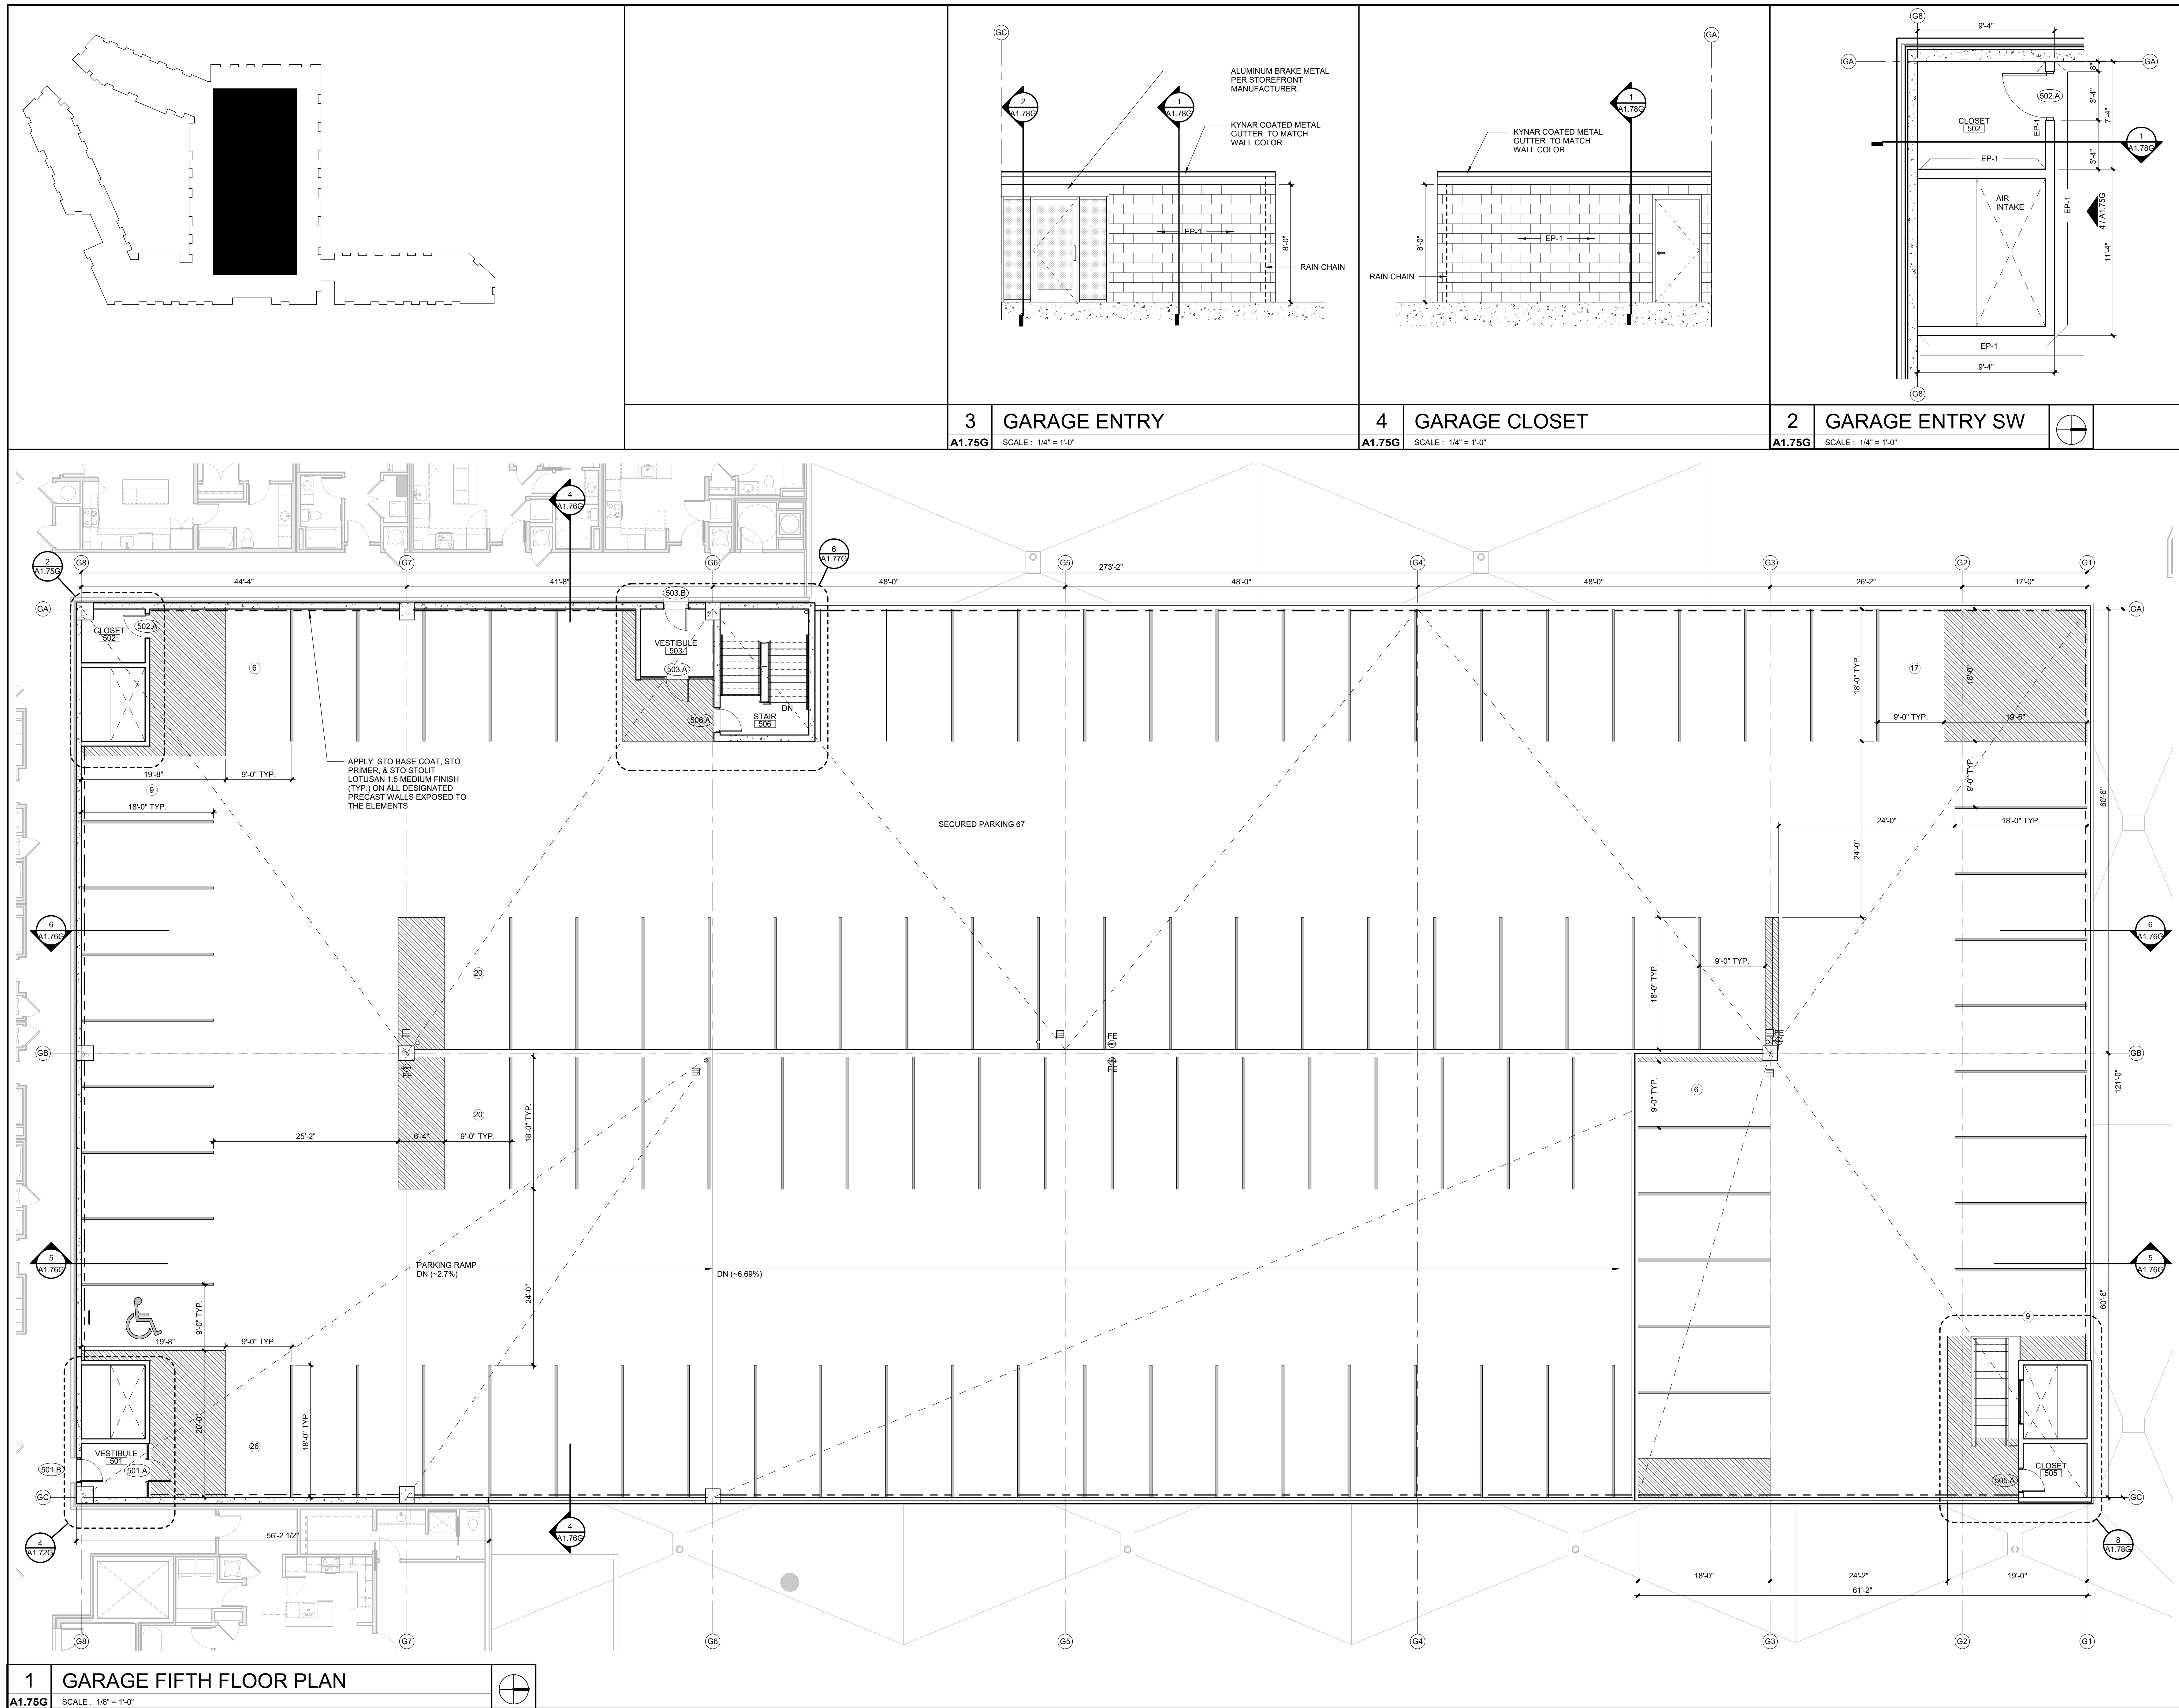

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No.:	18017,19050.07,19050.08
	02.04.22
For:	GARAGE PERMIT

[illegible]

REGISTRATION



PROJECT TEAM

TECT FINKLE+WILLIAMS
ARCHITECTURE

GBA ENGINEERS

CAPE LAND 3

TURAL BOB D. CAMPBELL

ING LATIMER SOMMERS

ANICAL LATIMER SOMMERS

RICAL LATIMER SOMMERS

PROTECTION LATIMER SOMMERS

BRINKMANN
CONSTRUCTORS

KLE + WILLIAMS
ARCHITECTURE


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ENEXA, KANSAS 66219
913.498.1550
www.finklewilliams.com

SHEET TITLE

GARAGE SECTIONS

SHEET NUMBER


A1.76G

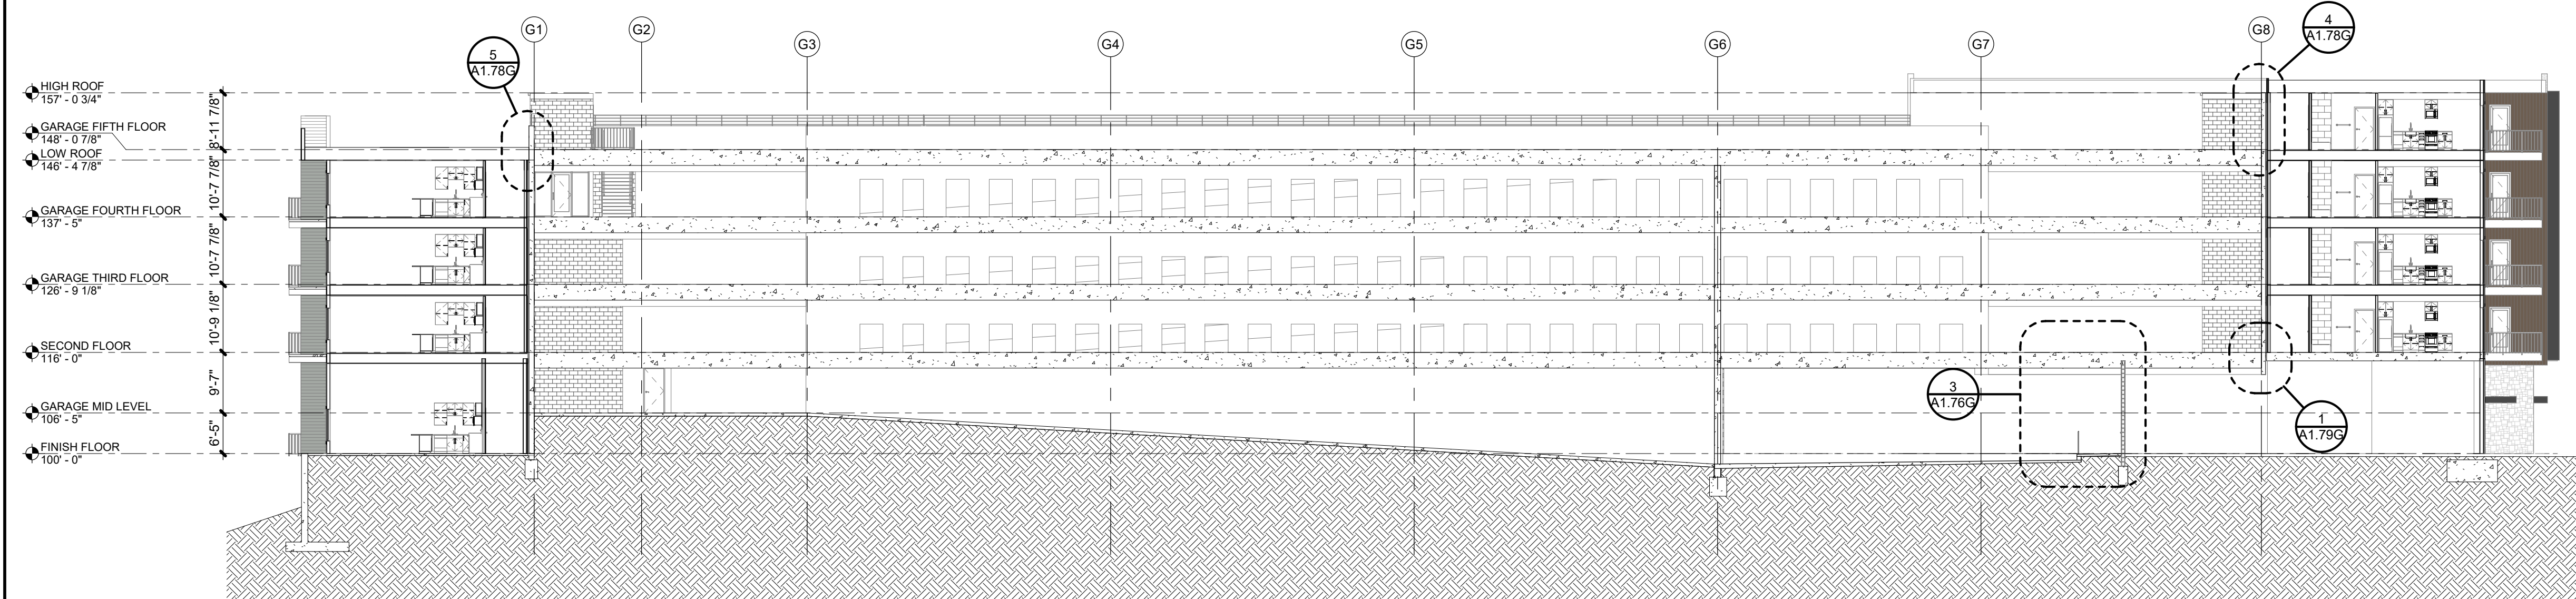

NOTE: REF. STRUCTURAL PLANS
FOR SPOT ELEVATIONS AND
CROSS SLOPES

6	SECTION THRU GARAGE - WEST1
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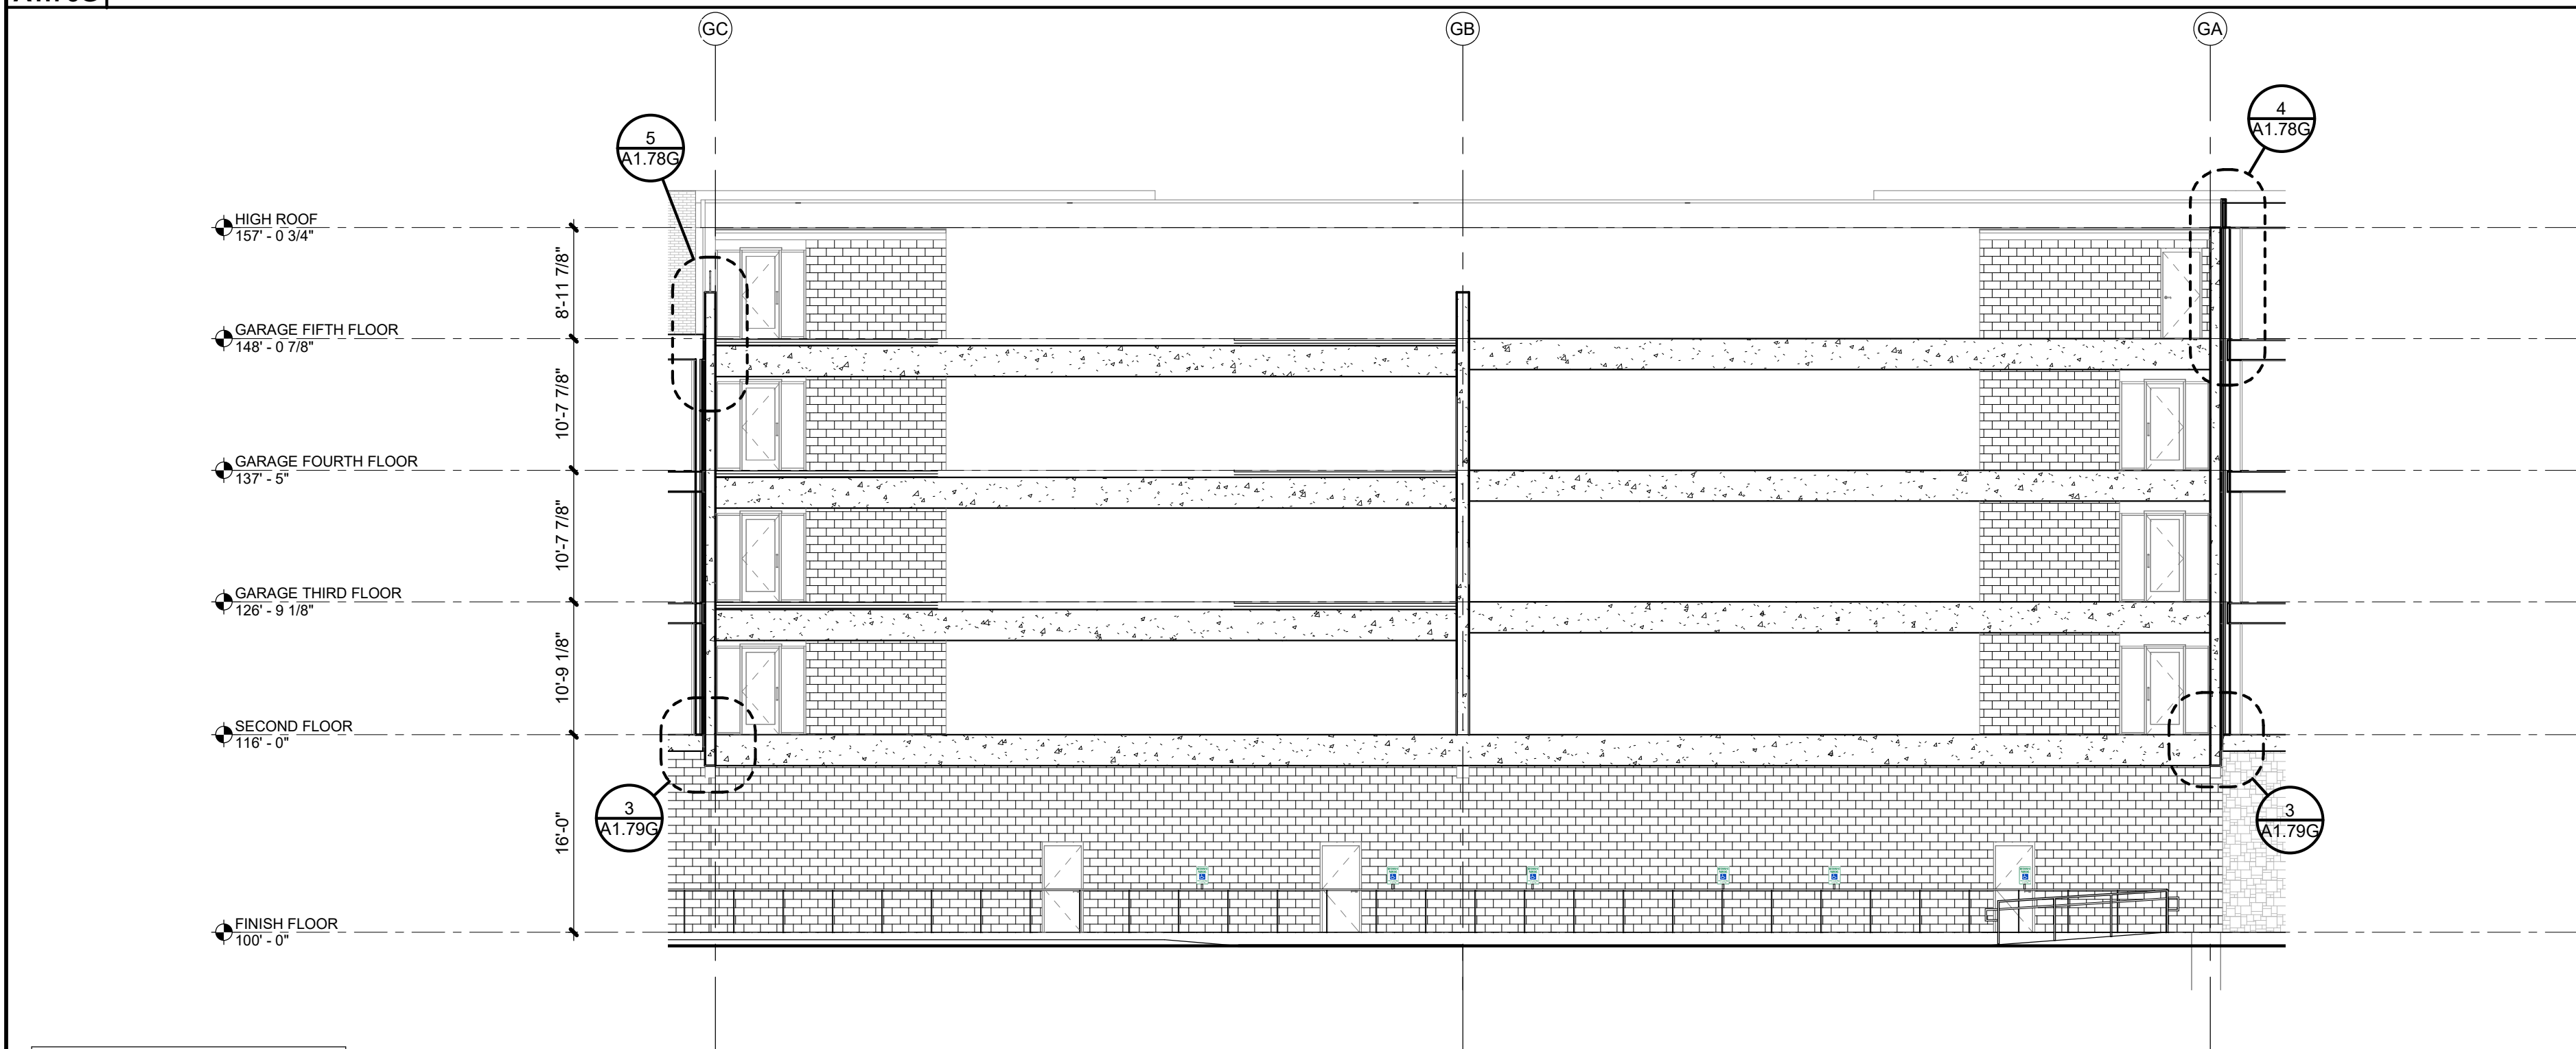
A1.76G	SCALE : 1/16" = 1'-0"
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NOTE: REF. STRUCTURAL PLANS
FOR SPOT ELEVATIONS AND
CROSS SLOPES

5	SECTION THRU GARAGE - EAST
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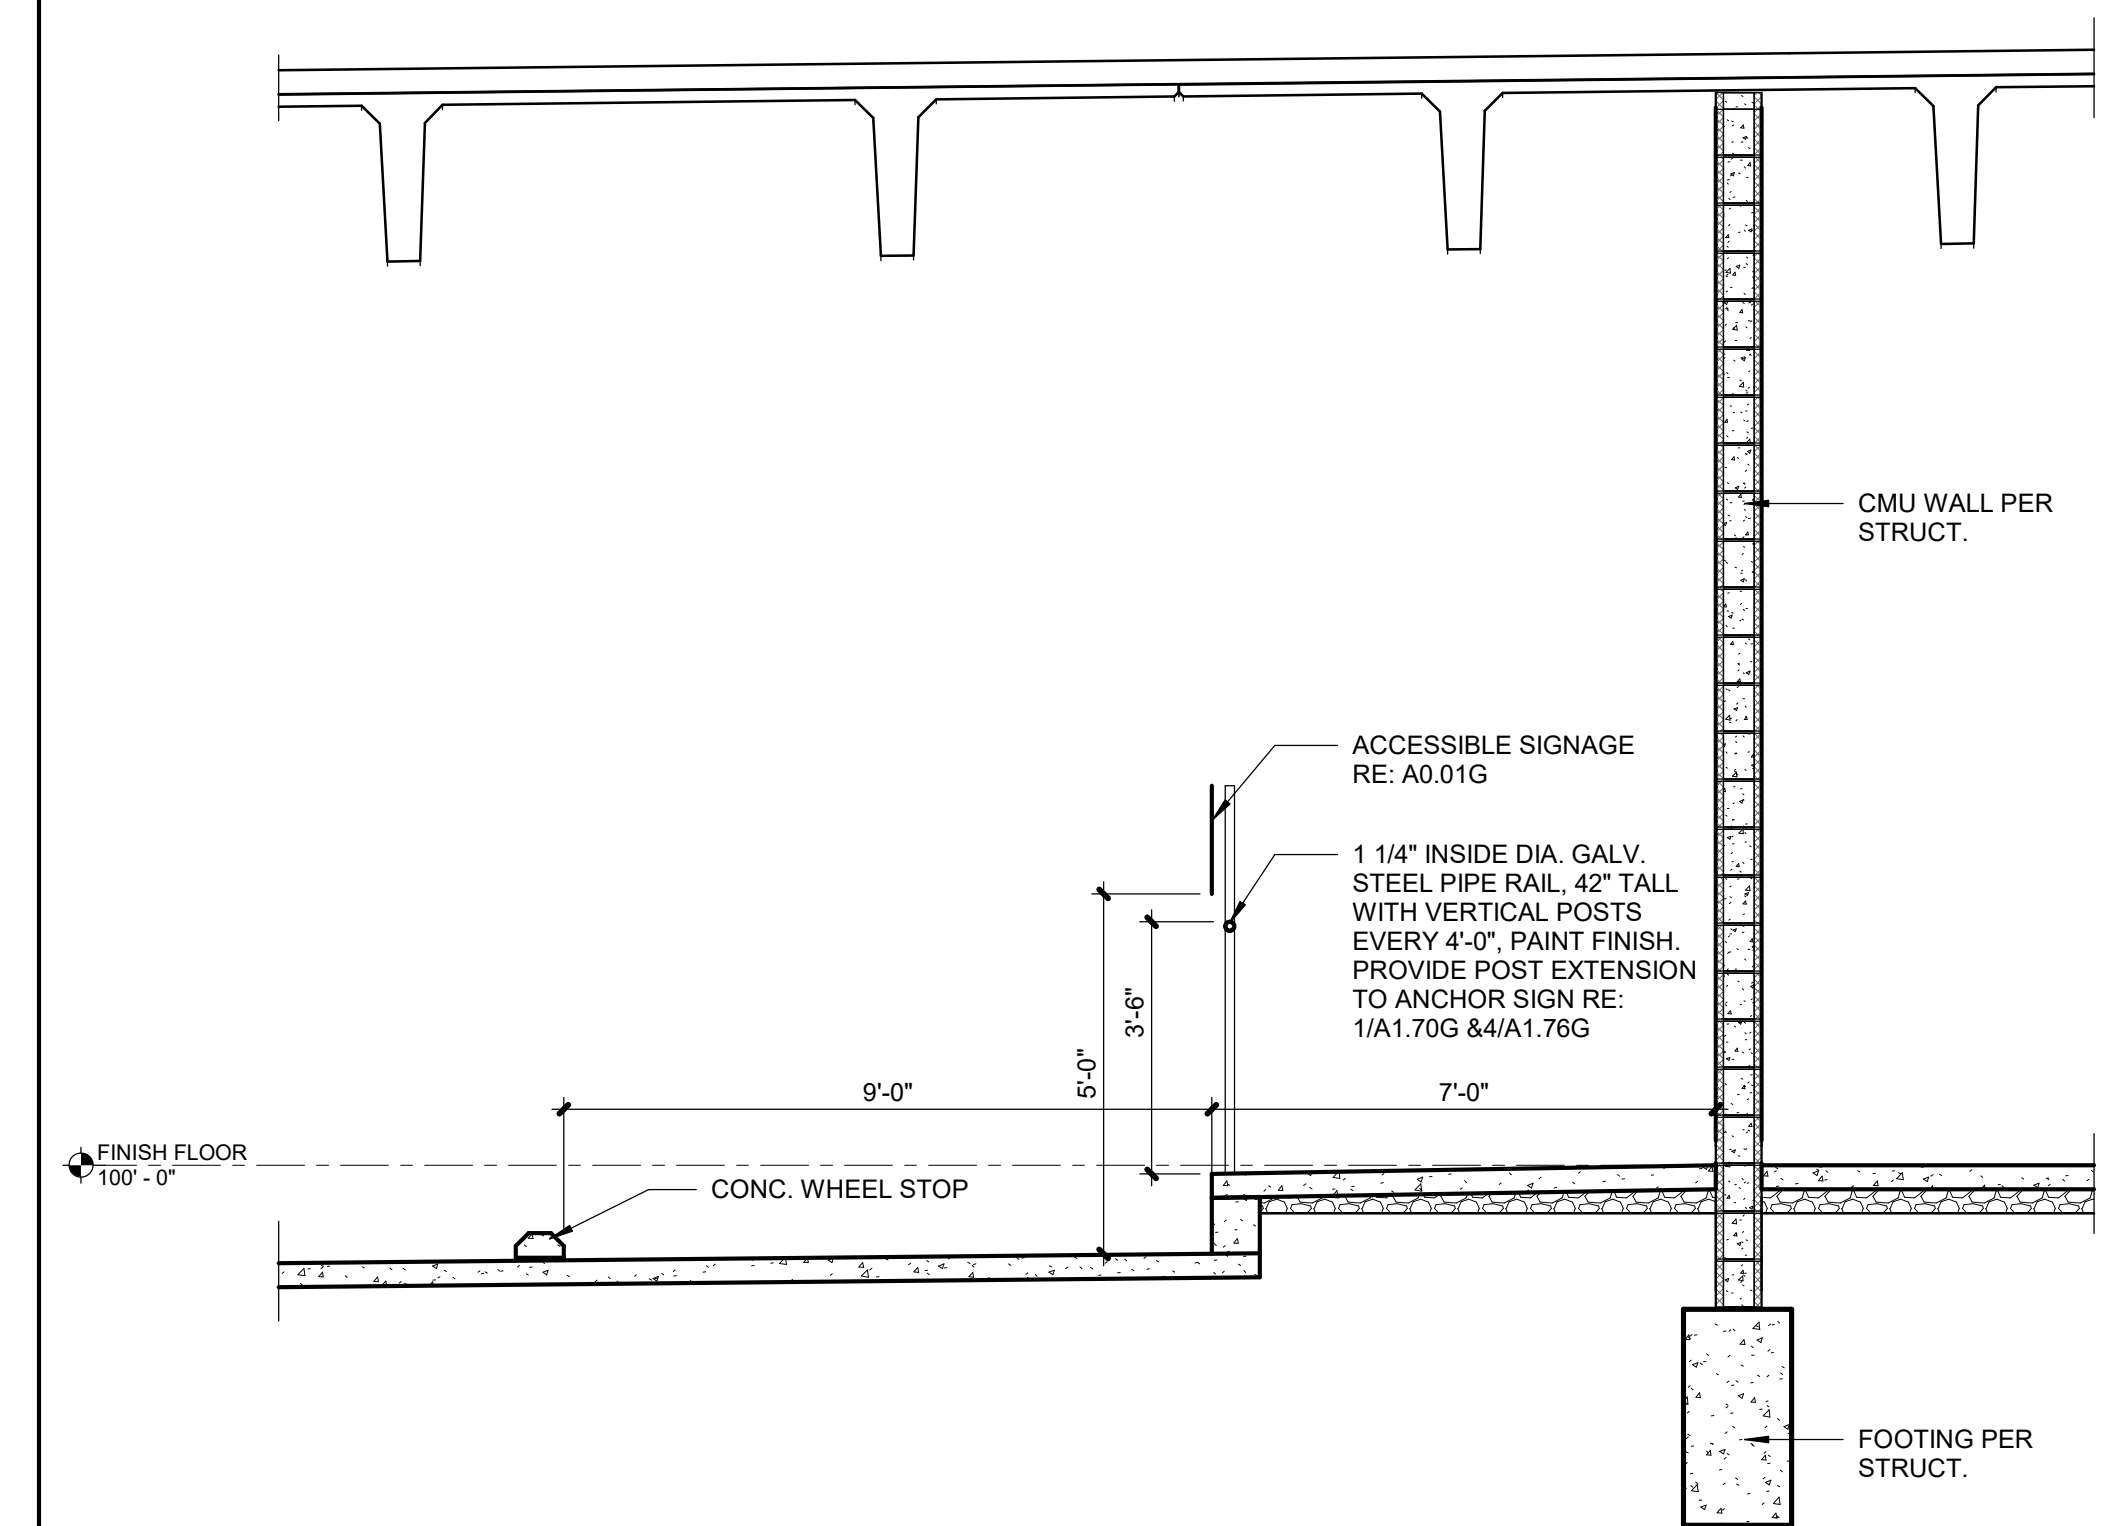
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NOTE: REF. STRUCTURAL PLANS
FOR SPOT ELEVATIONS AND
CROSS SLOPES

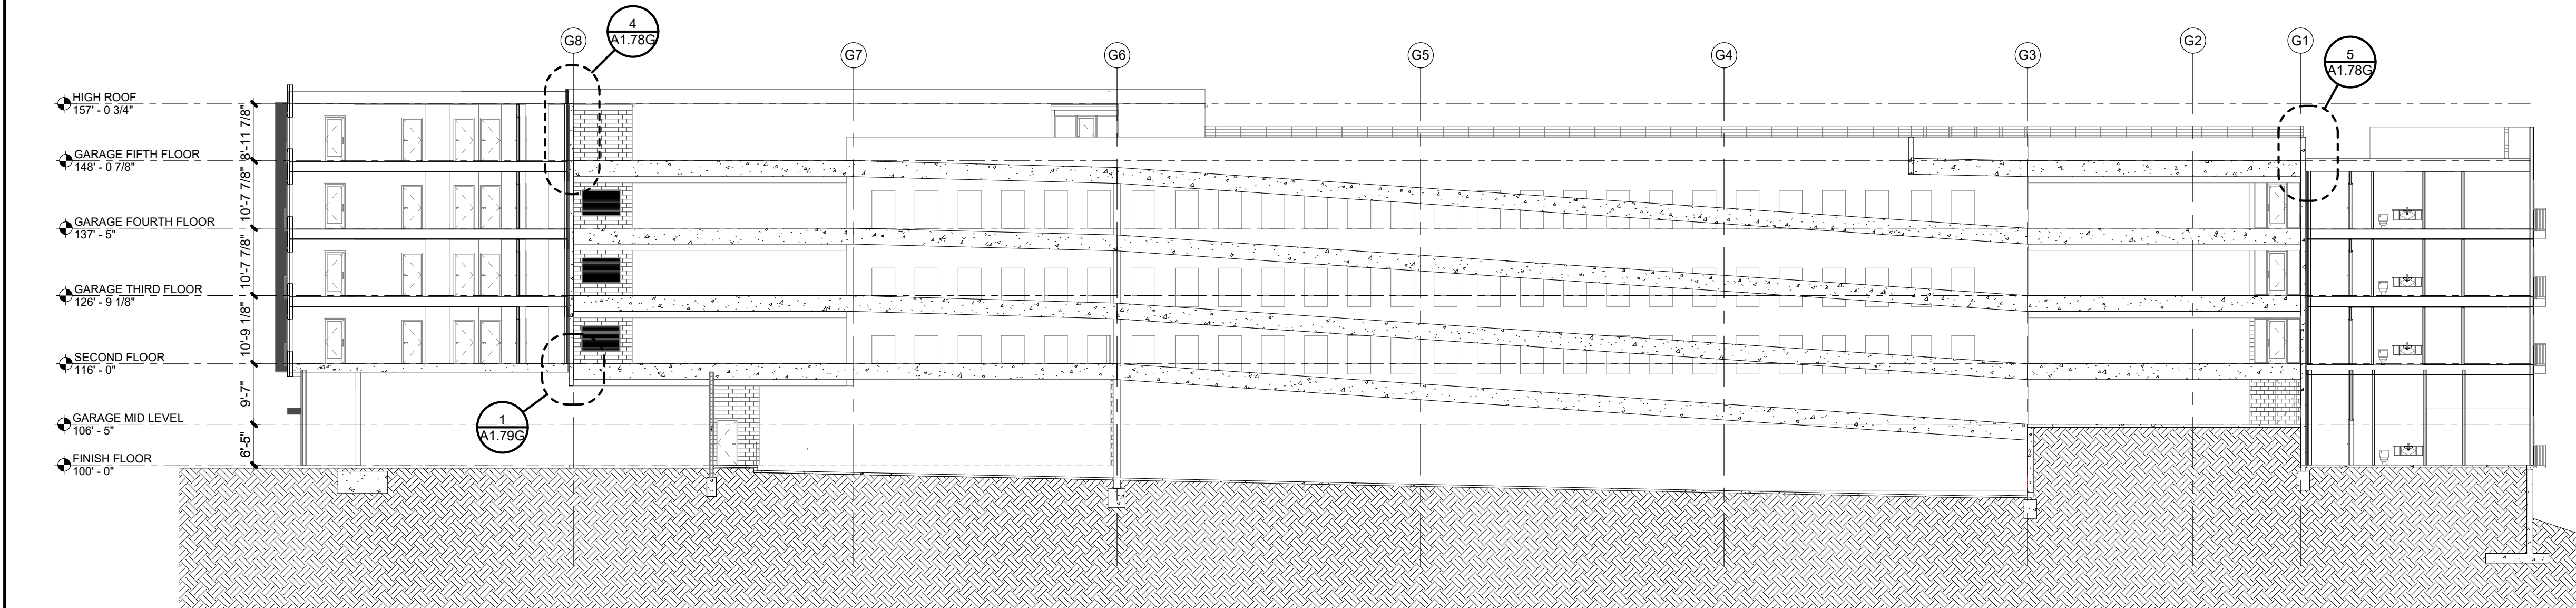
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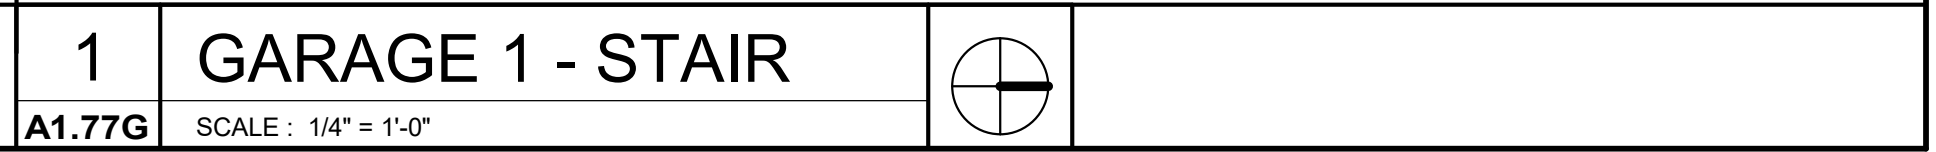
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A1.76G	SCALE : 3/8" = 1'-0"
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2	SECTION @ADA PARKING1
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A1.76G	SCALE : 3/8" = 1'-0"
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No.:	18017,19050.07,19050.08
	02.04.22
For:	GARAGE PERMIT


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BRINKMANN
CONSTRUCTORS


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913.498.1550
www.finklewilliams.com

STAIRS AND SECTIONS



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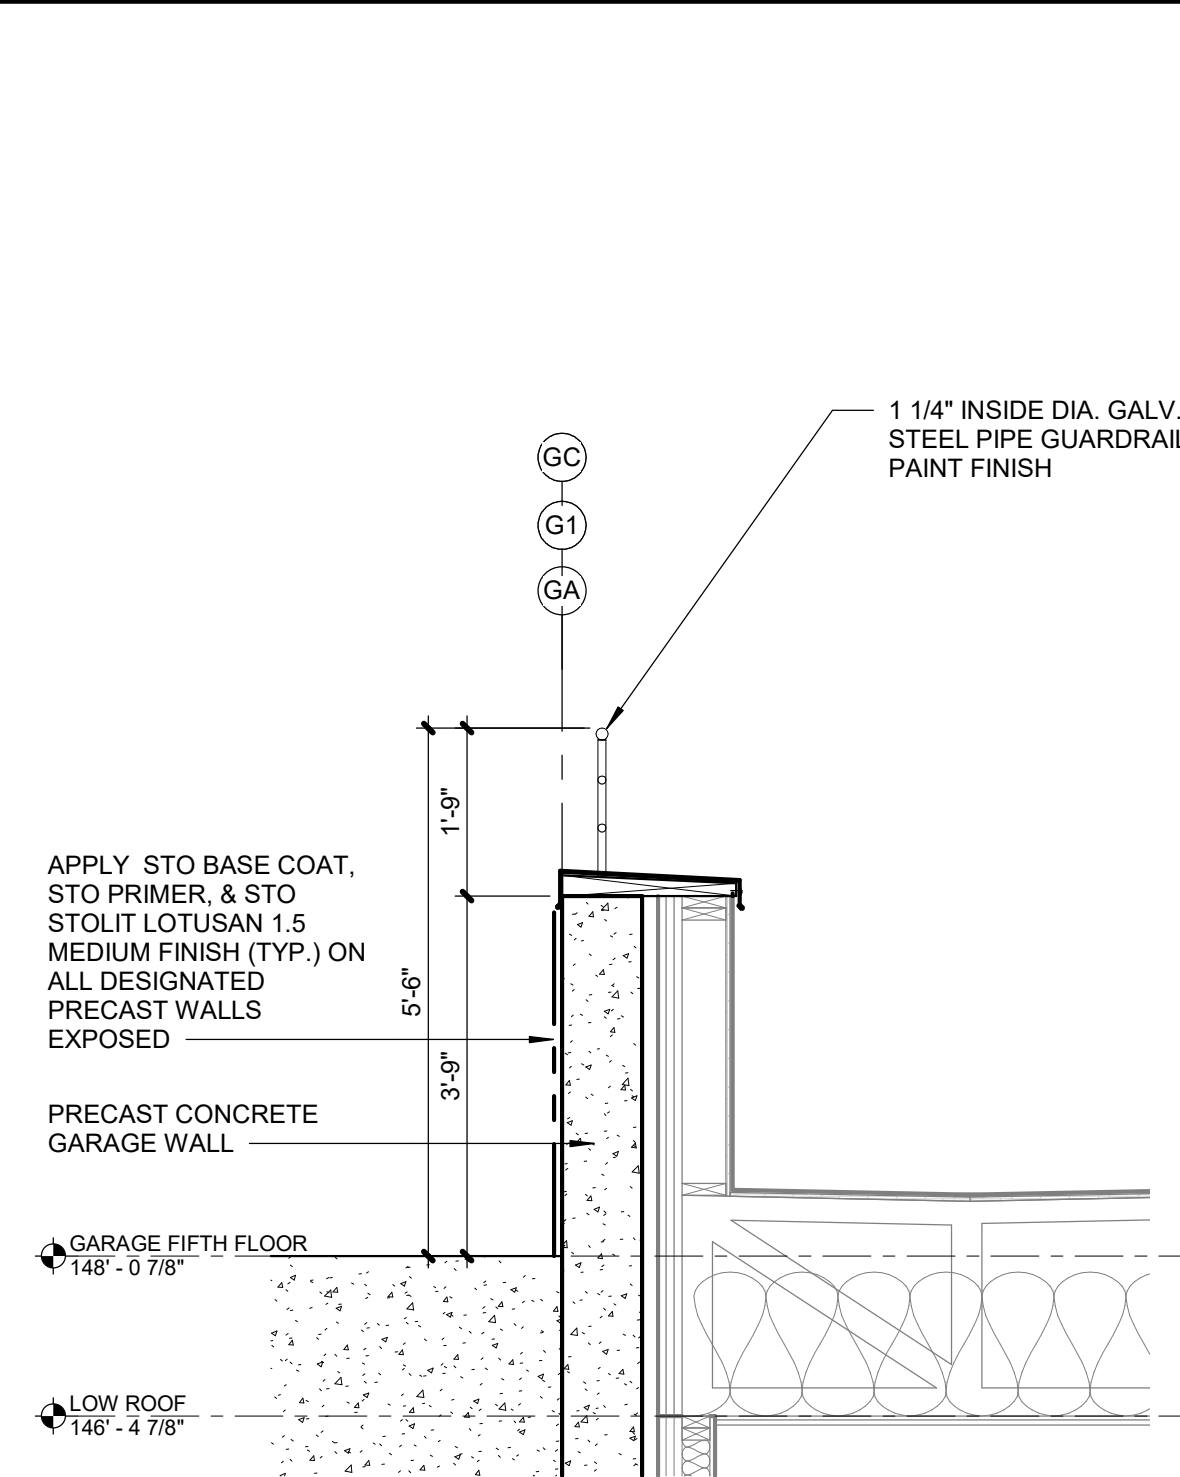
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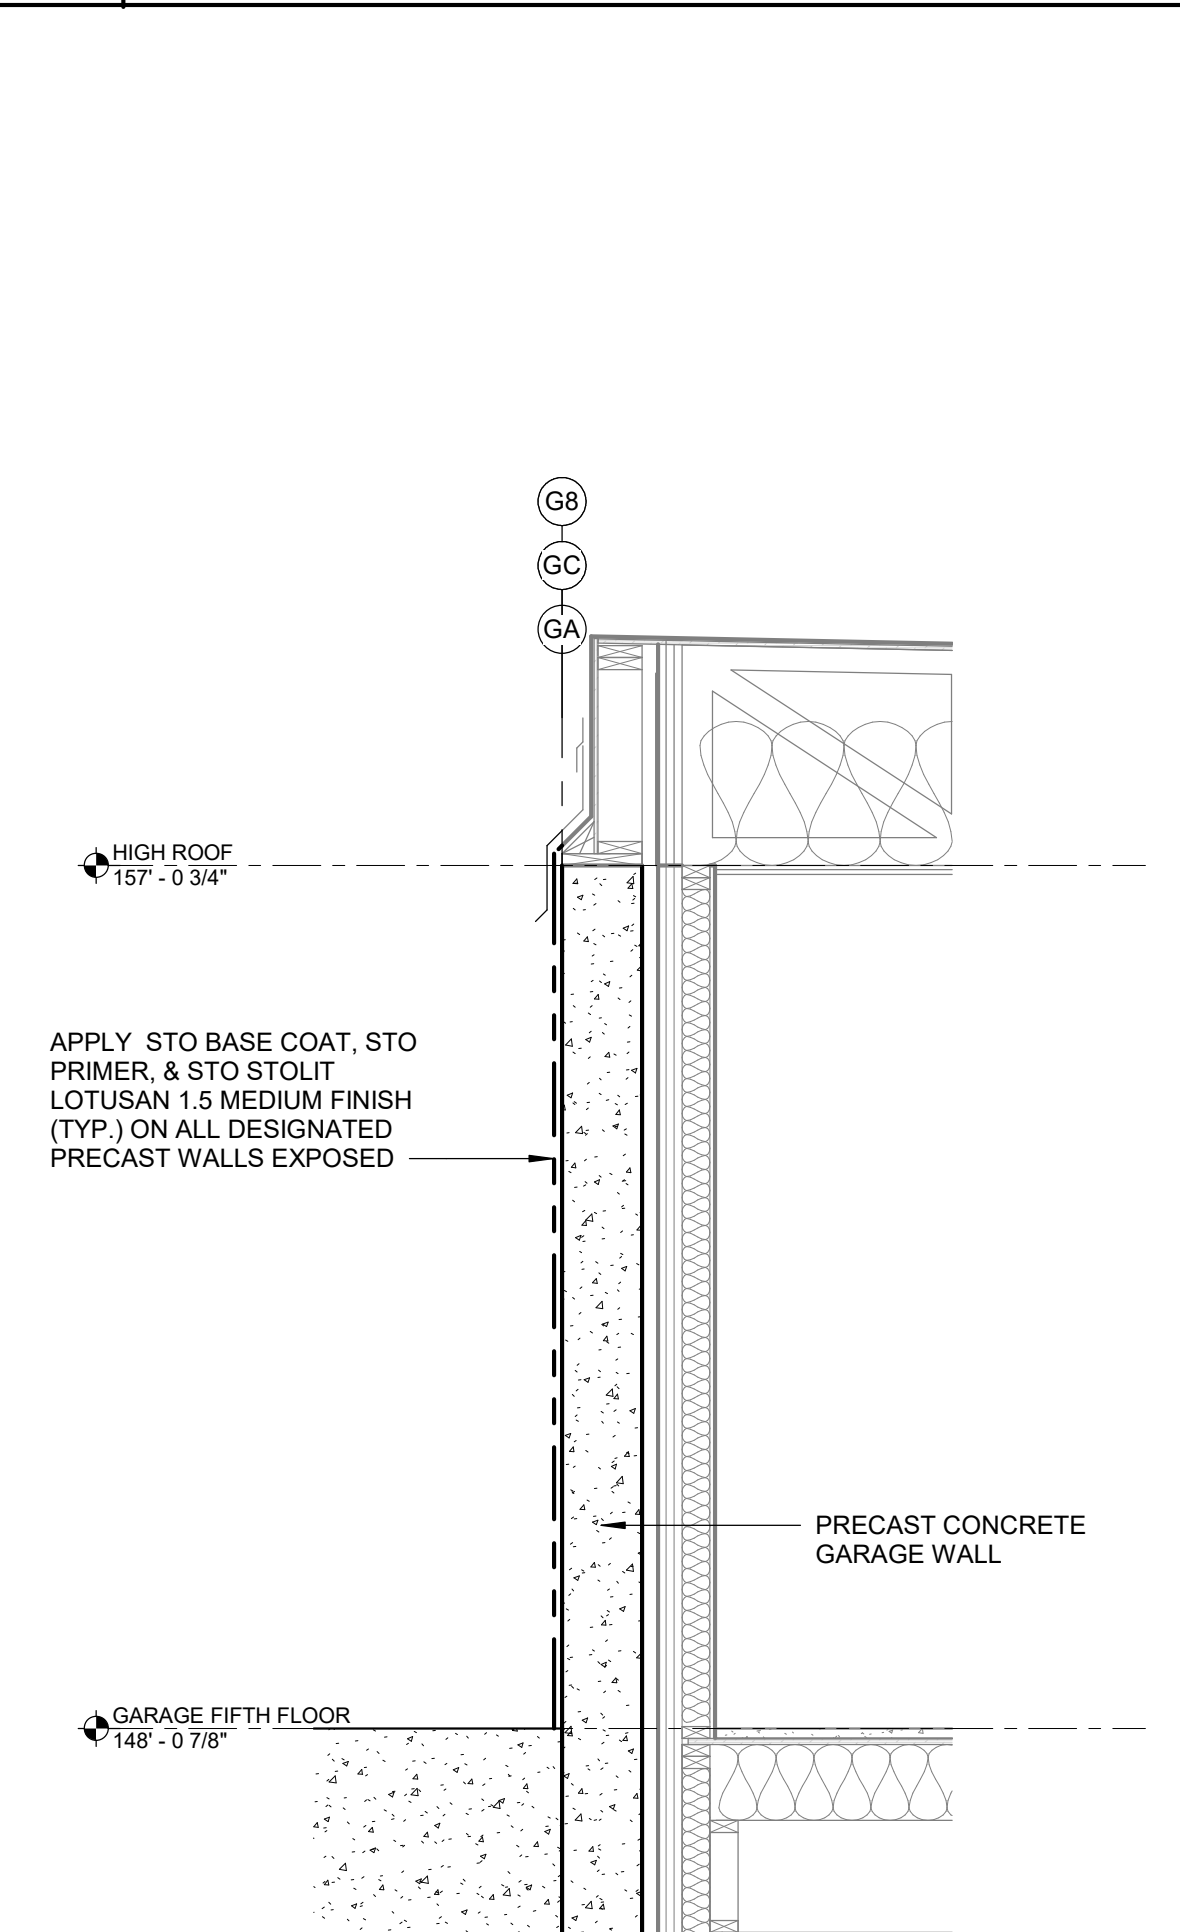
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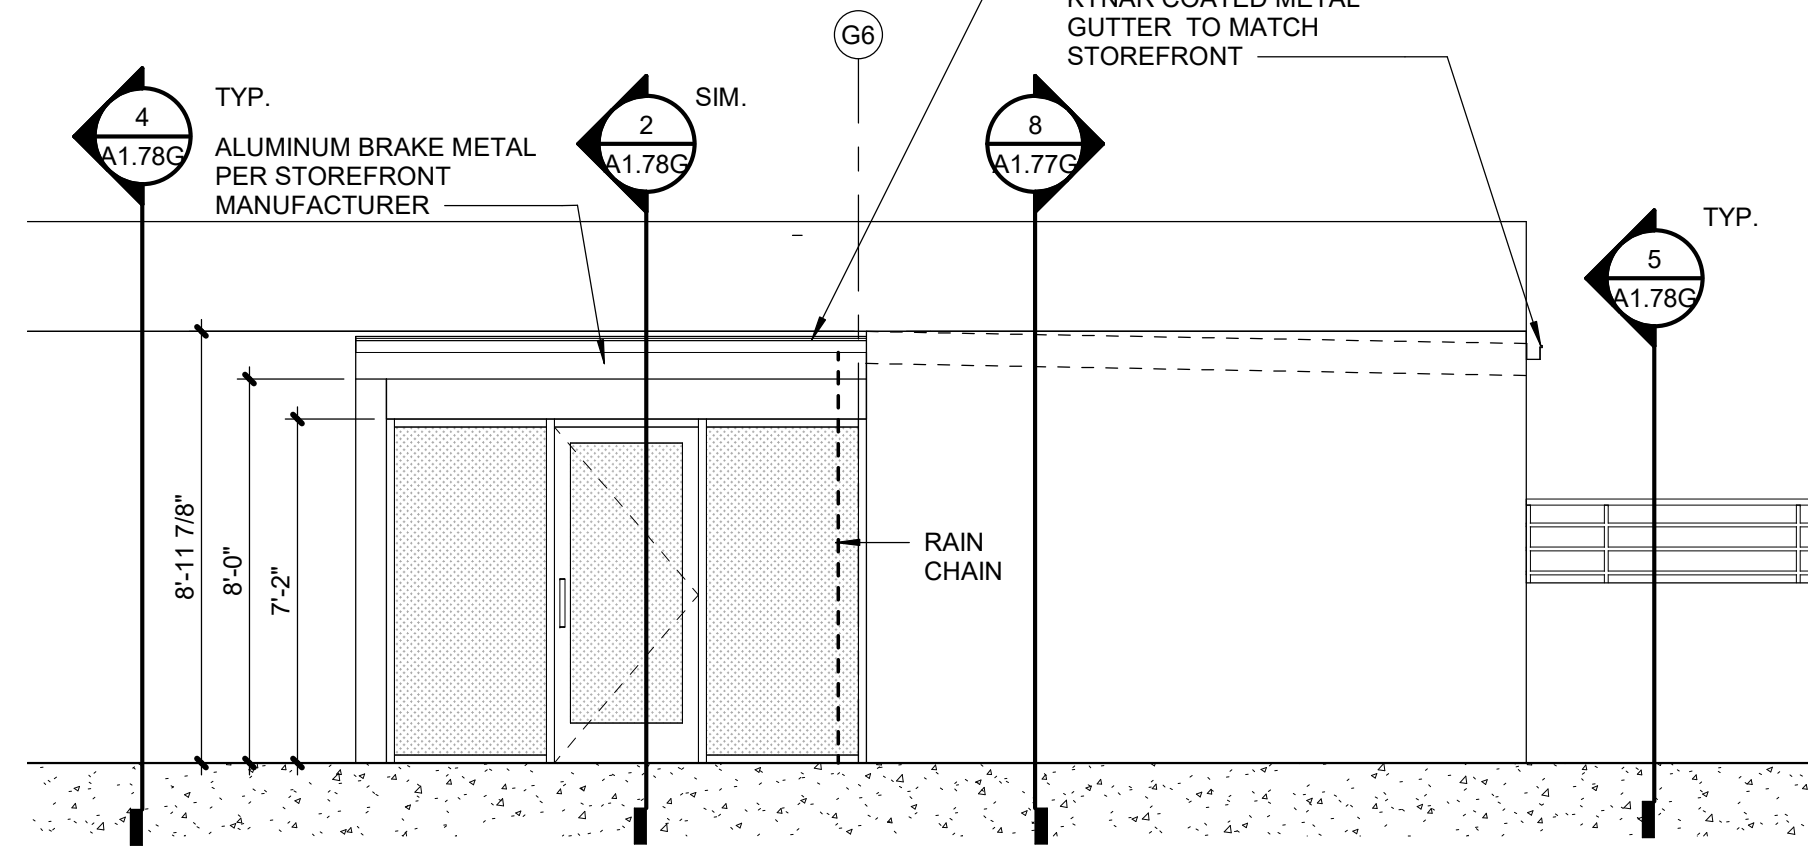
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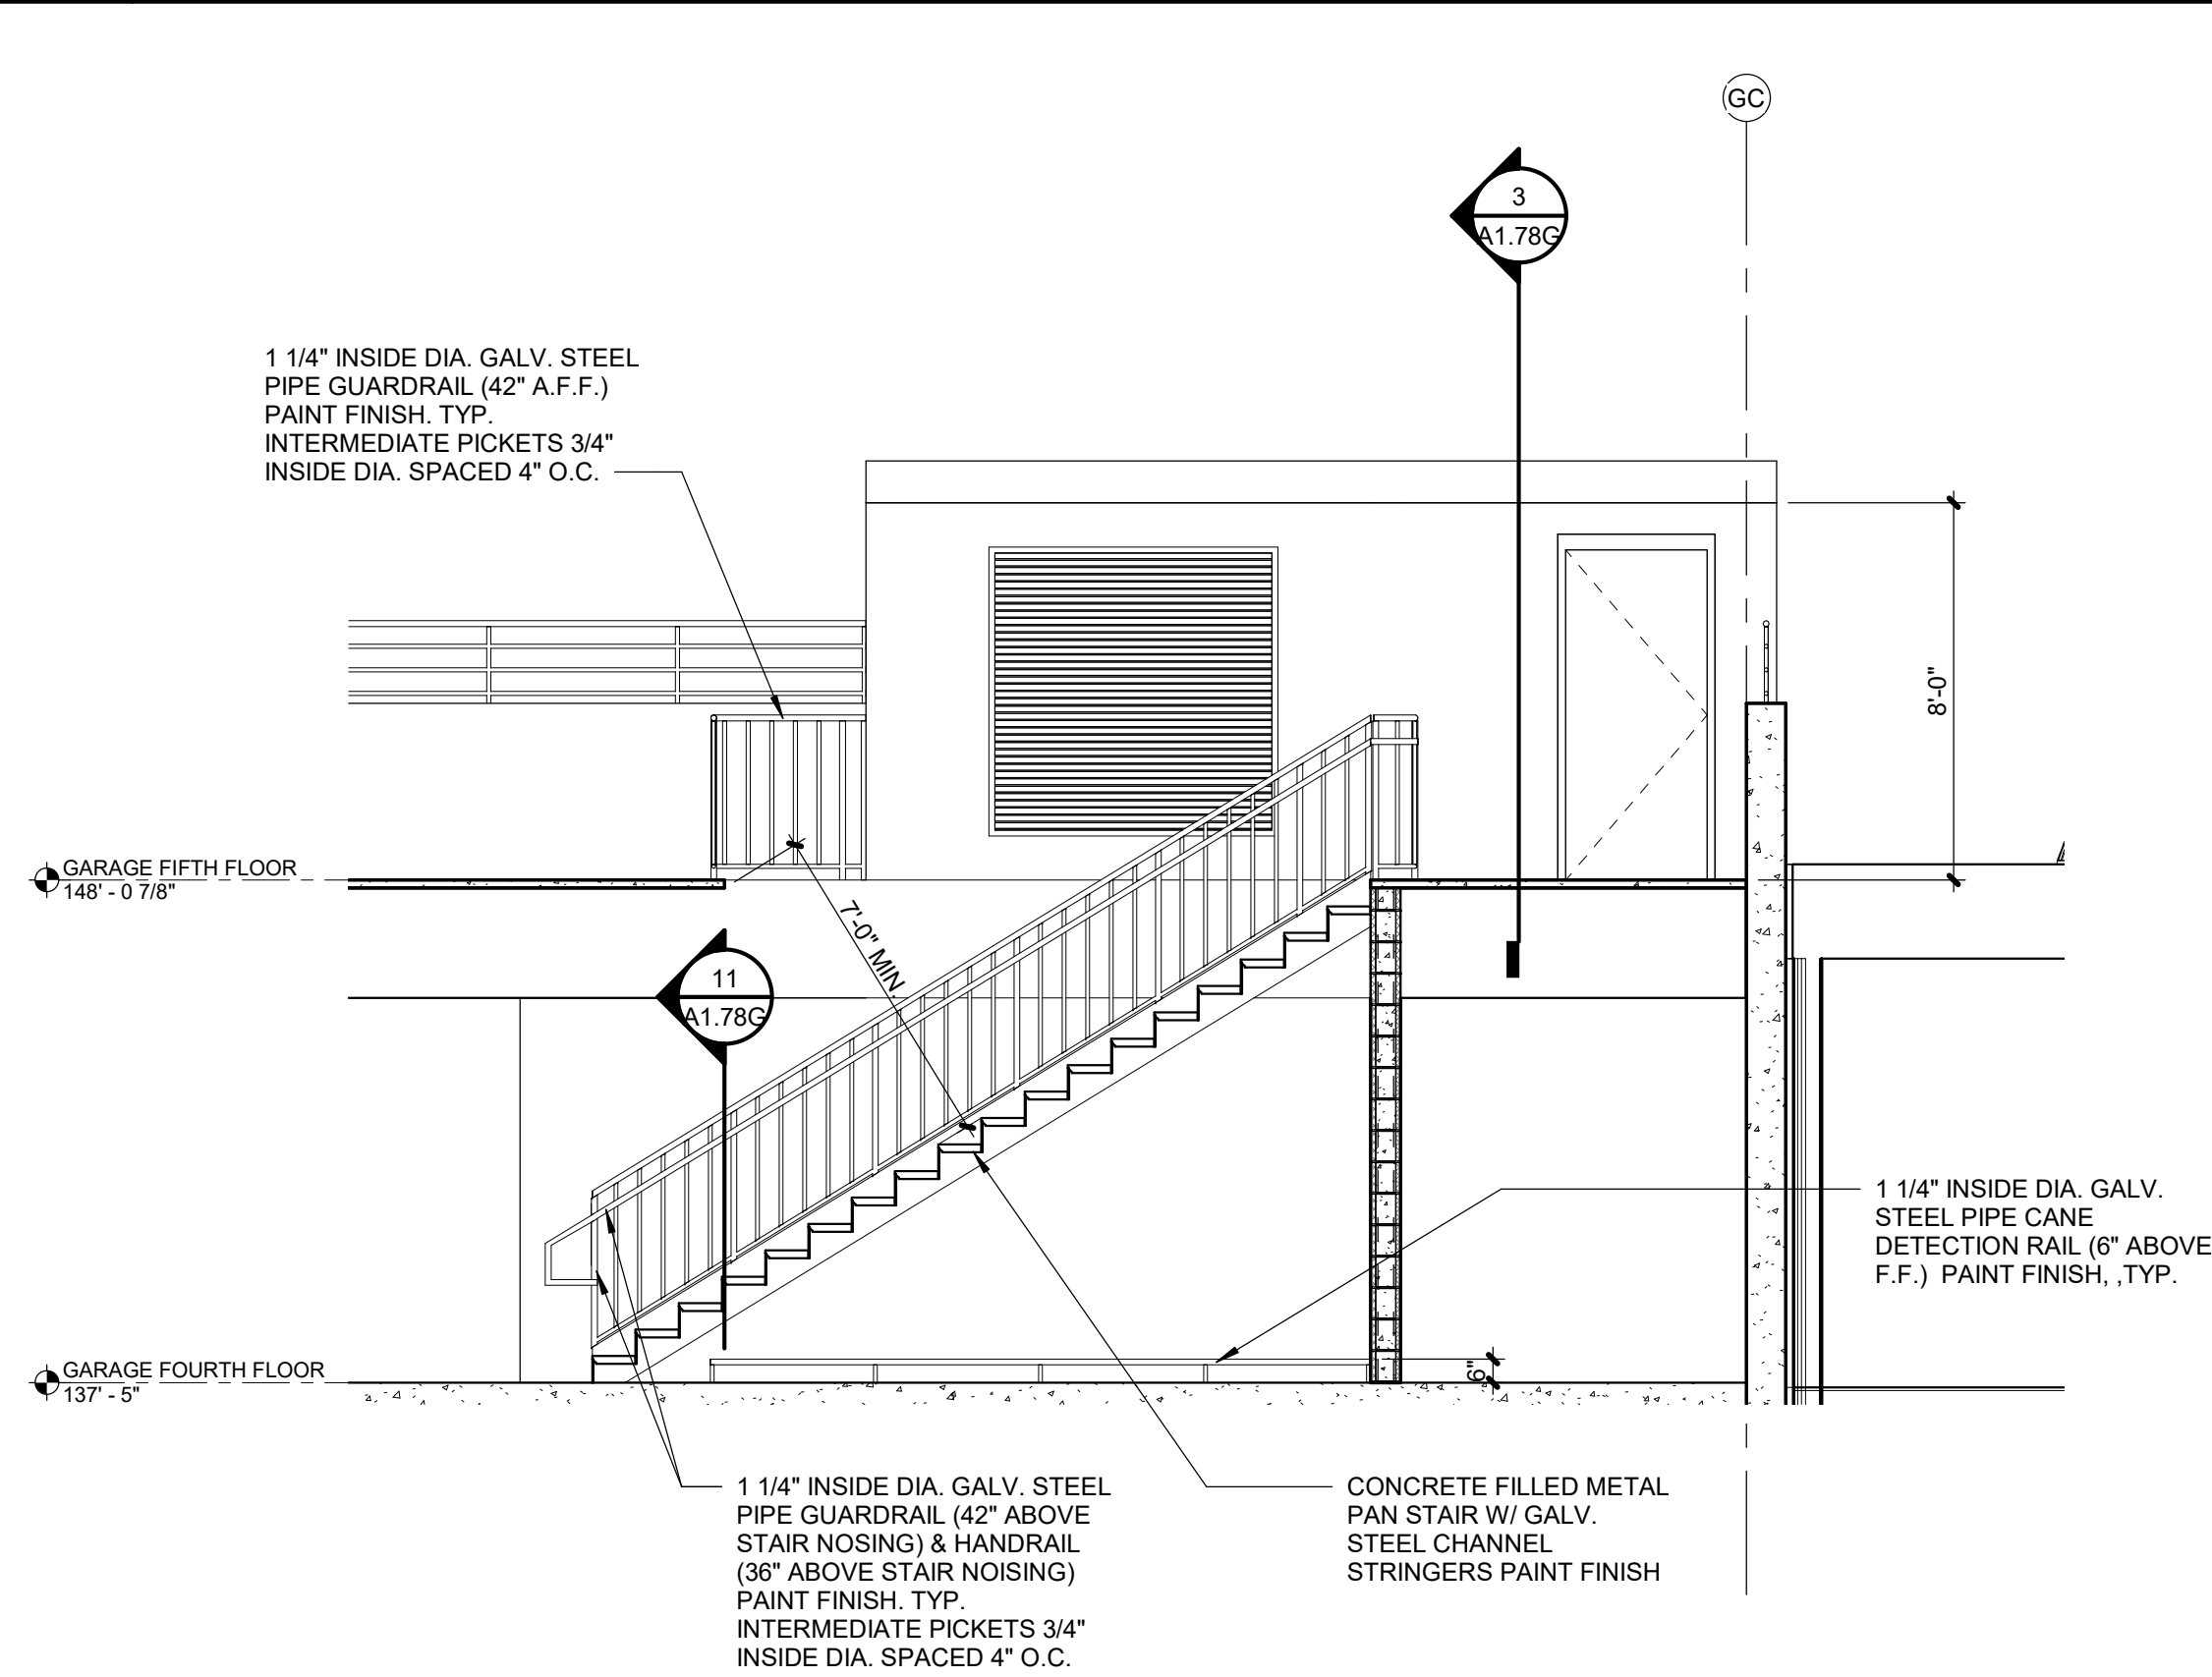
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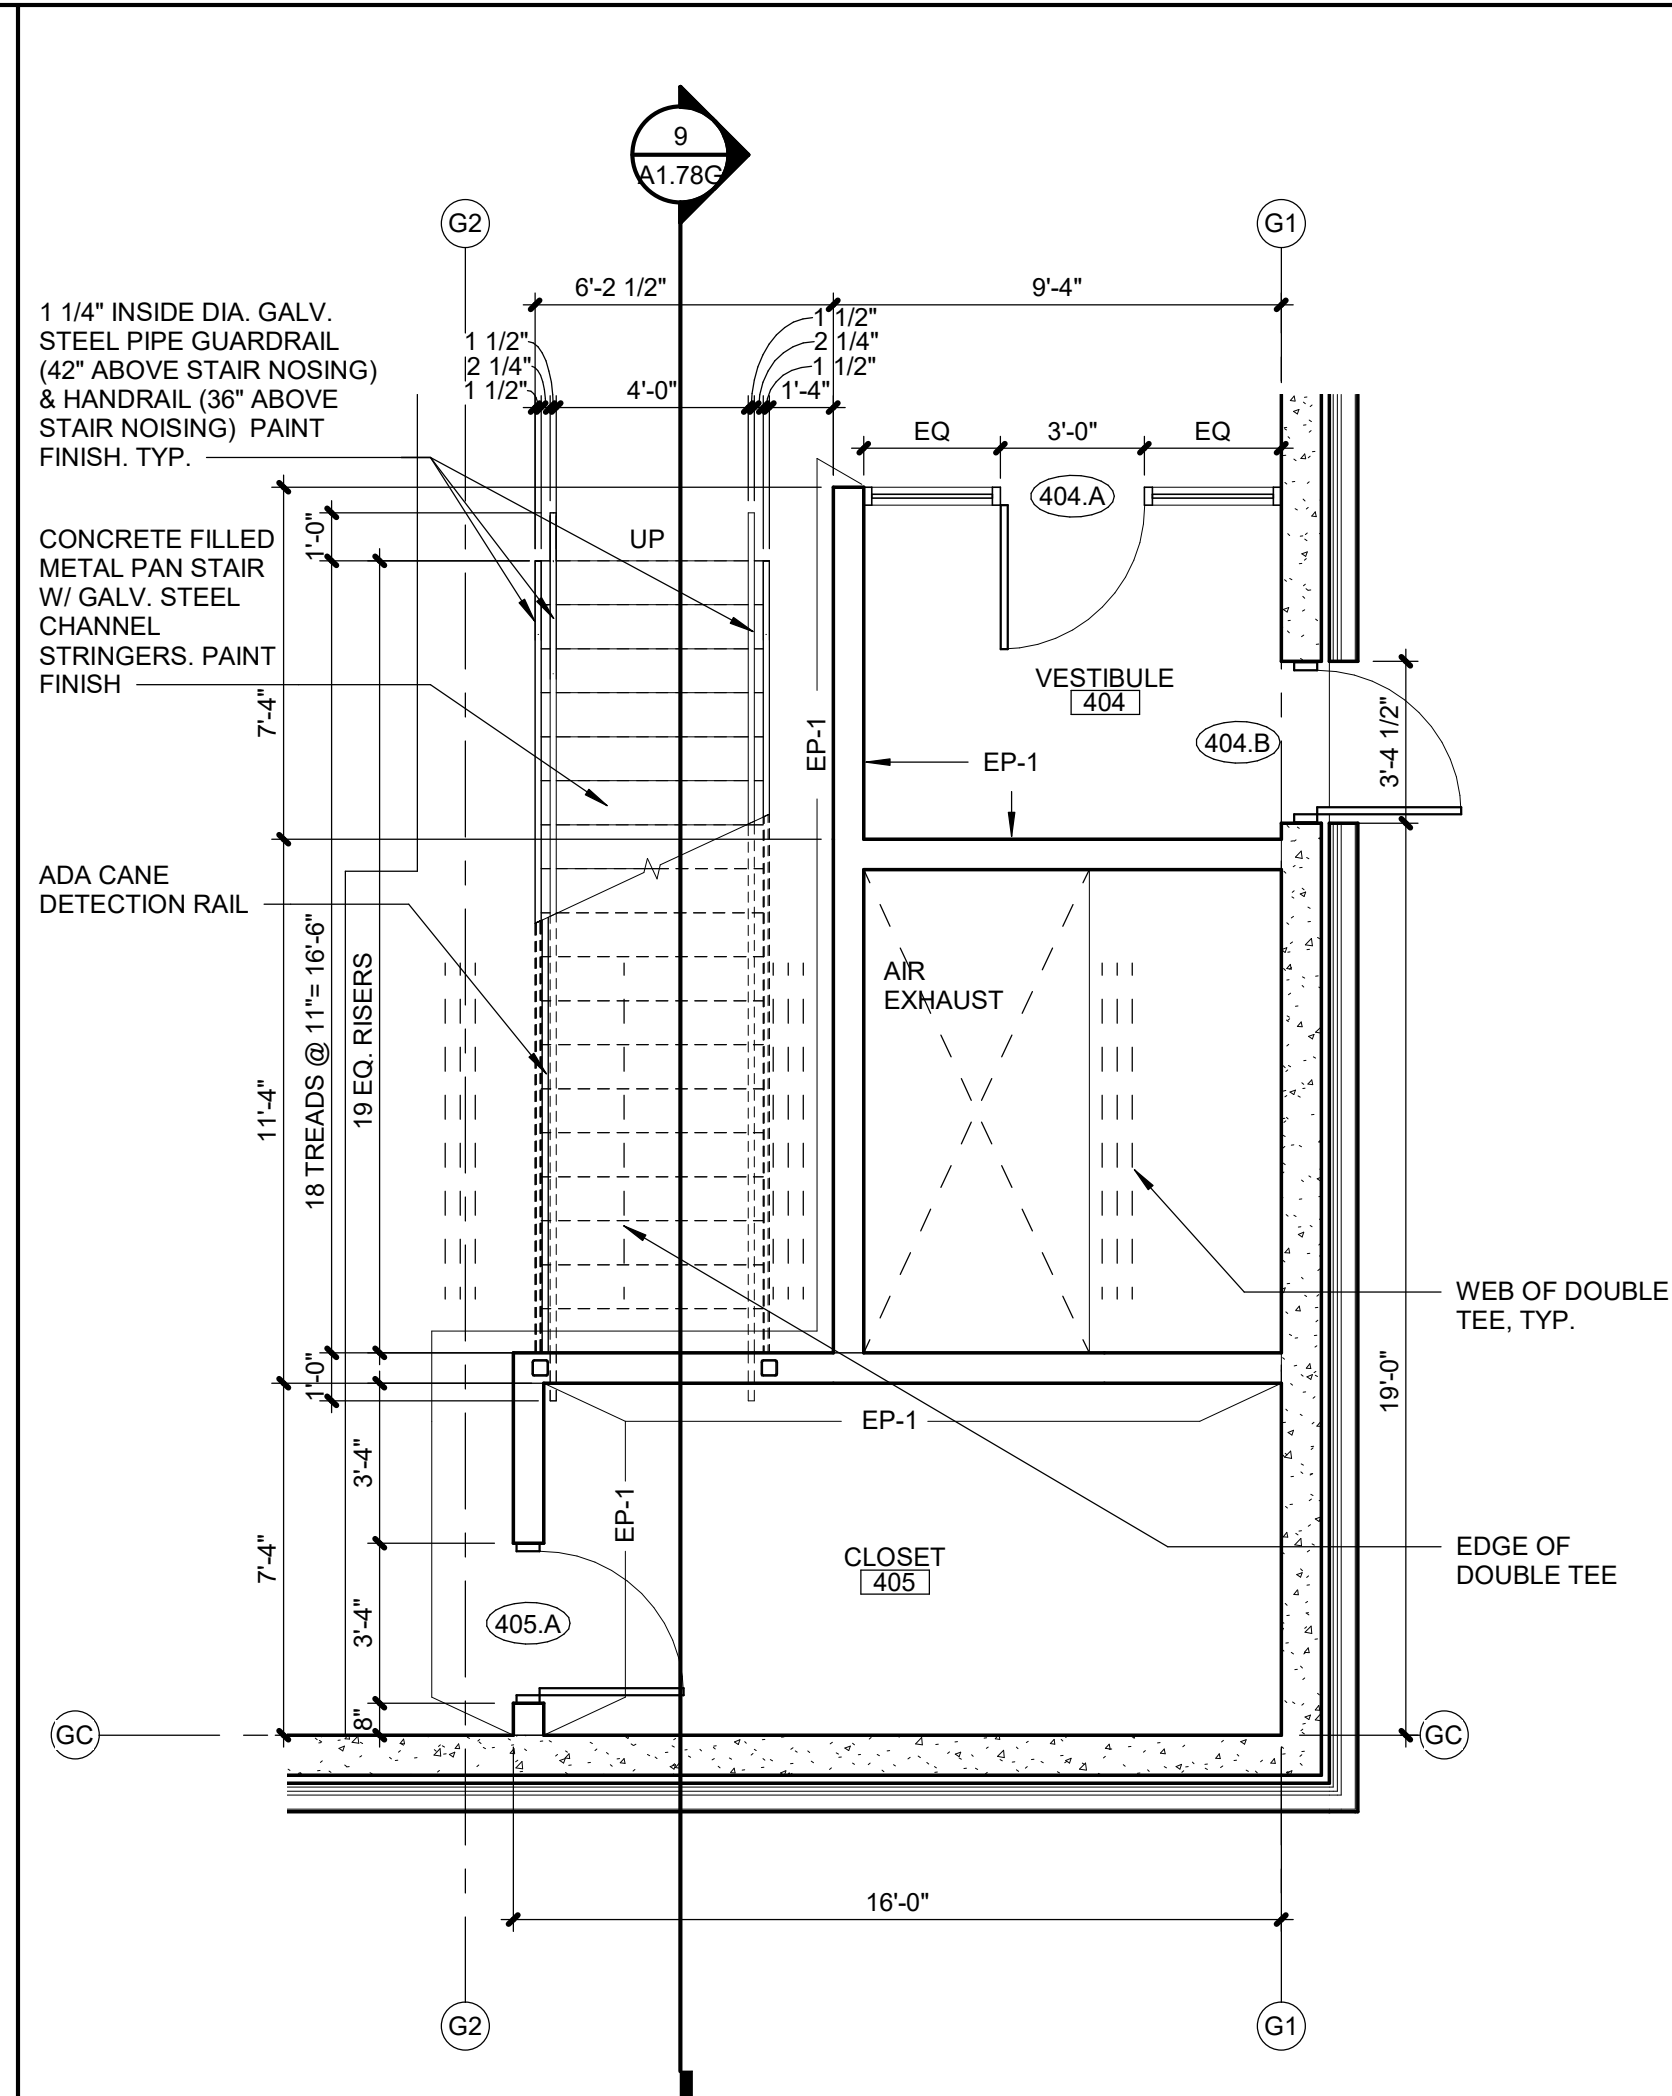
A1.78G SCALE : 1/2" = 1'-0"

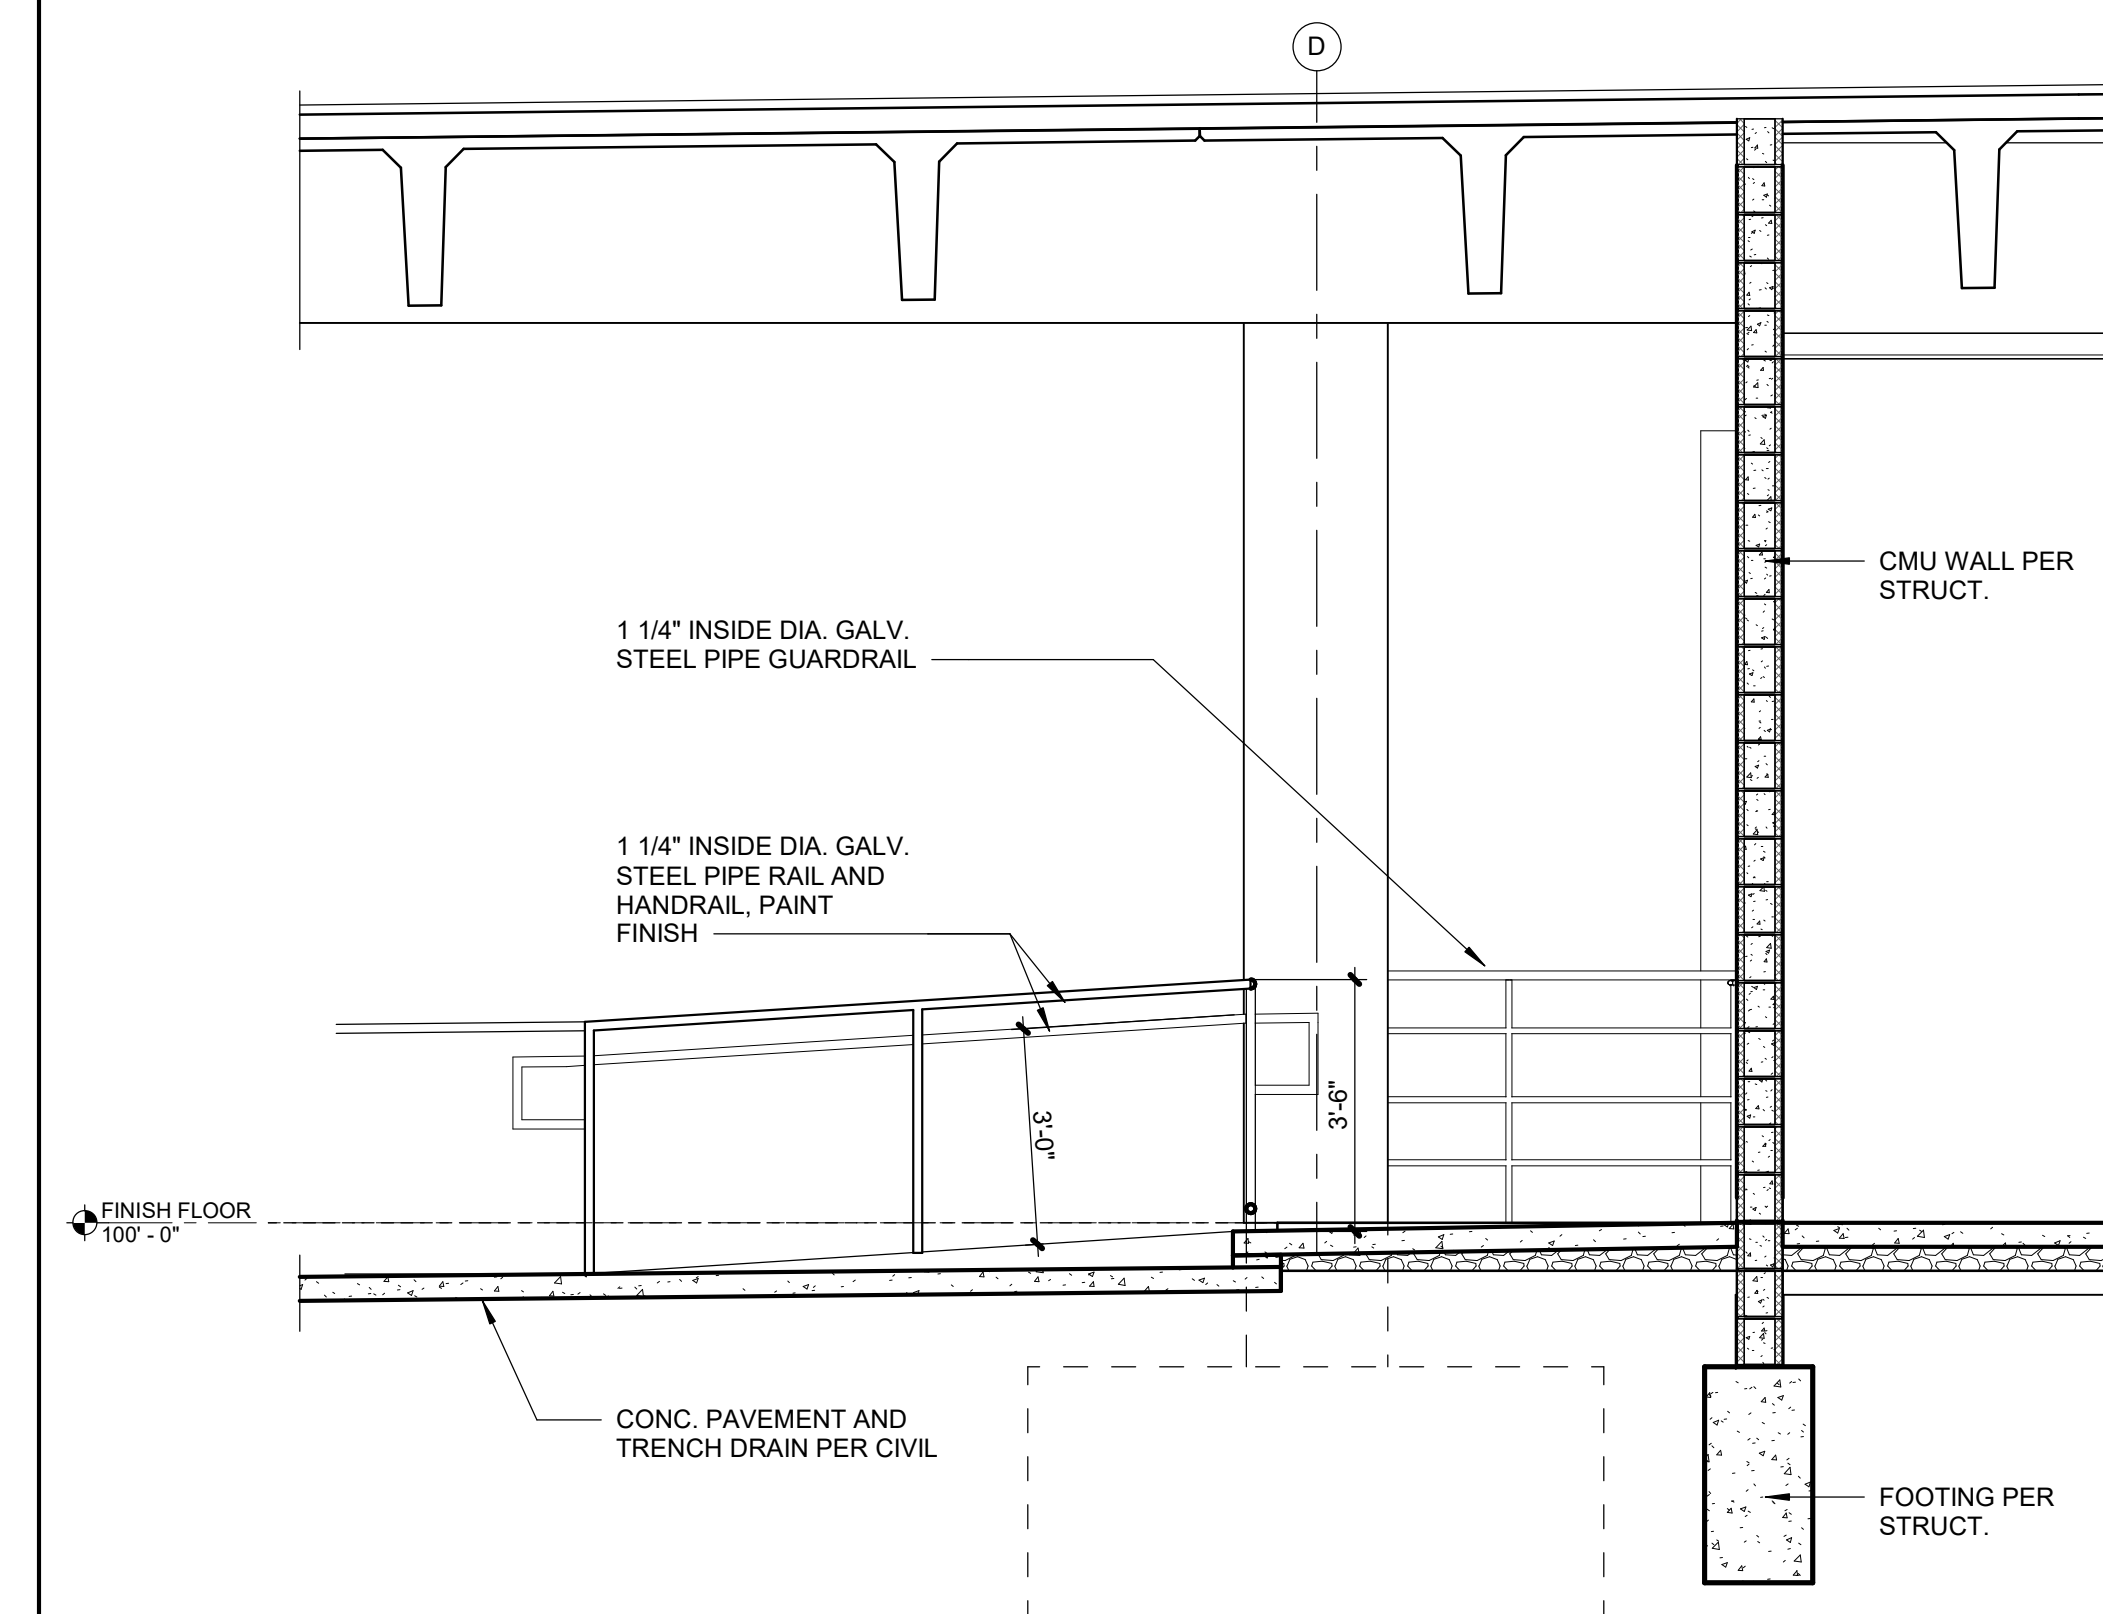

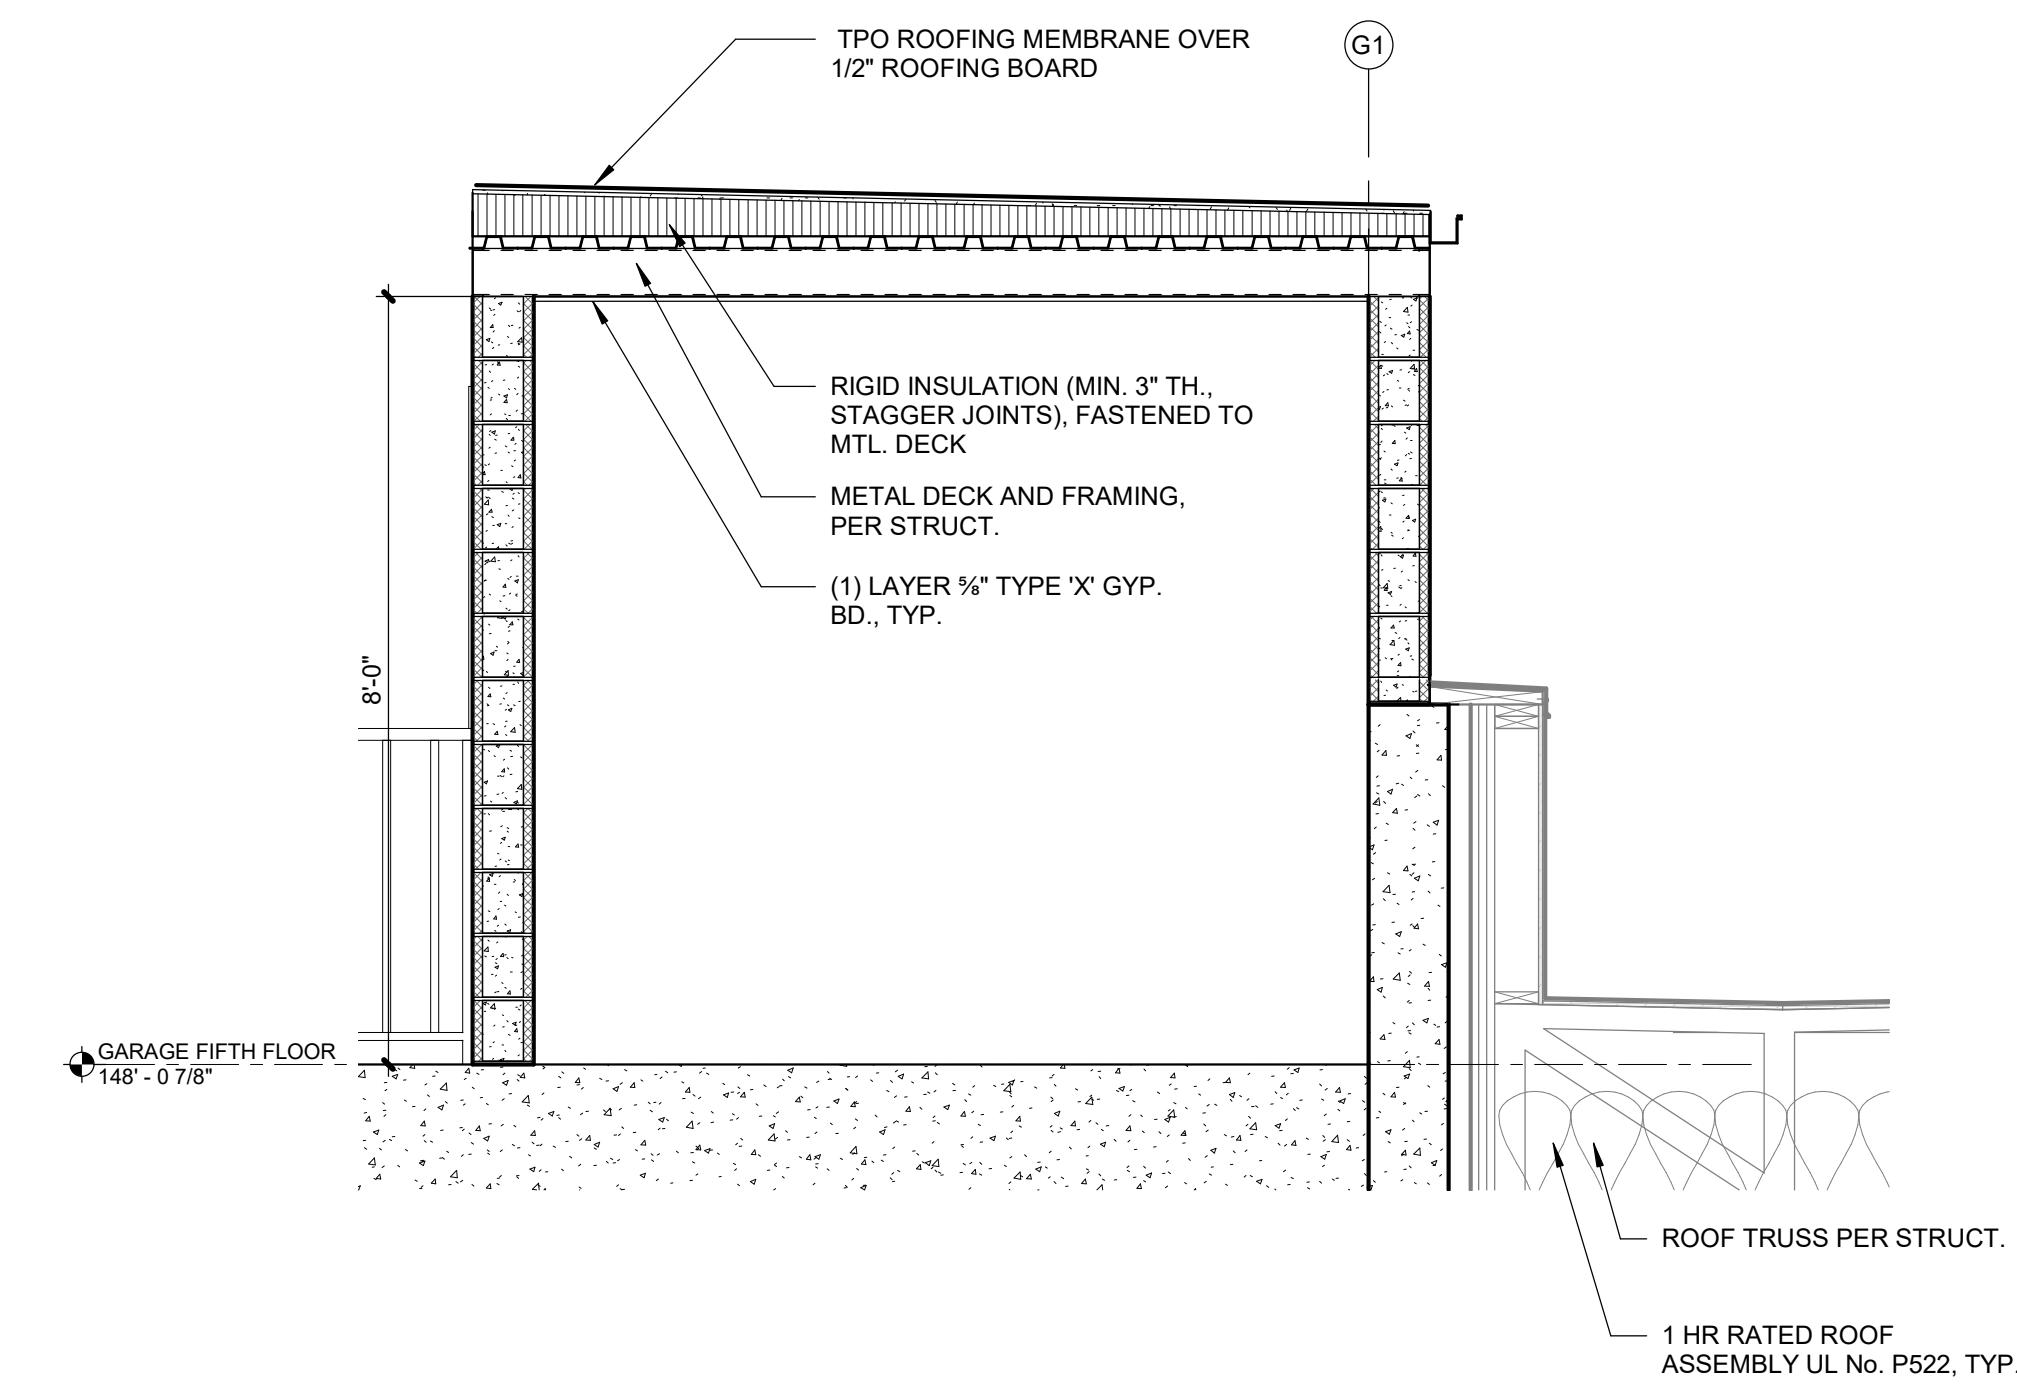
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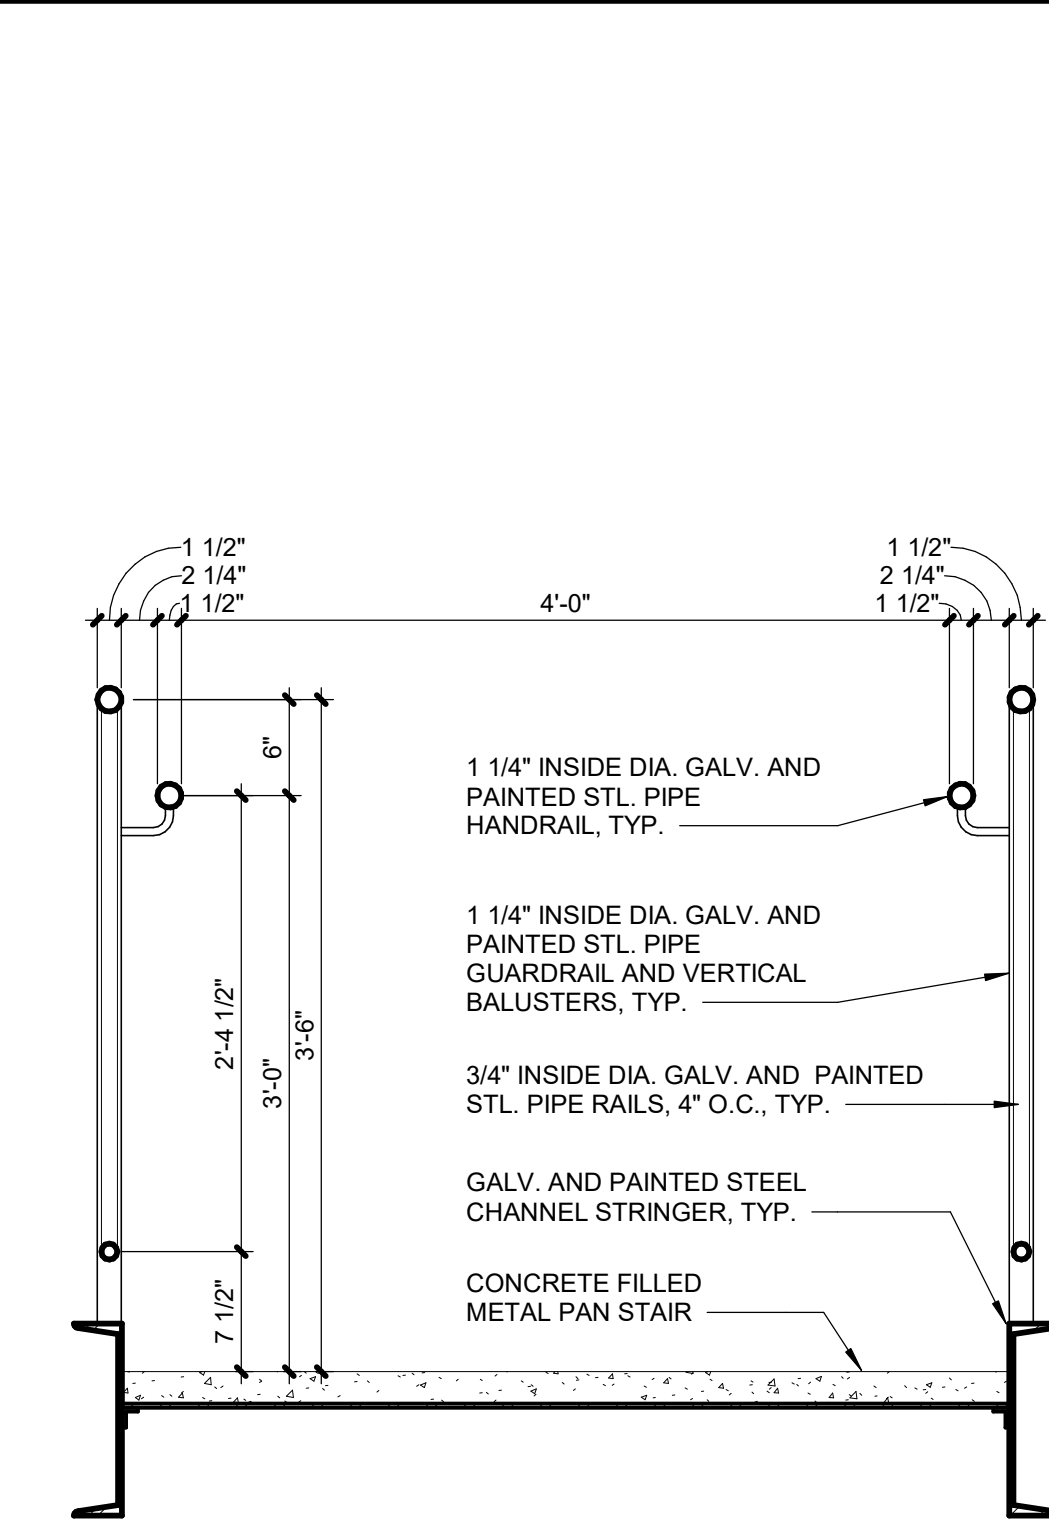
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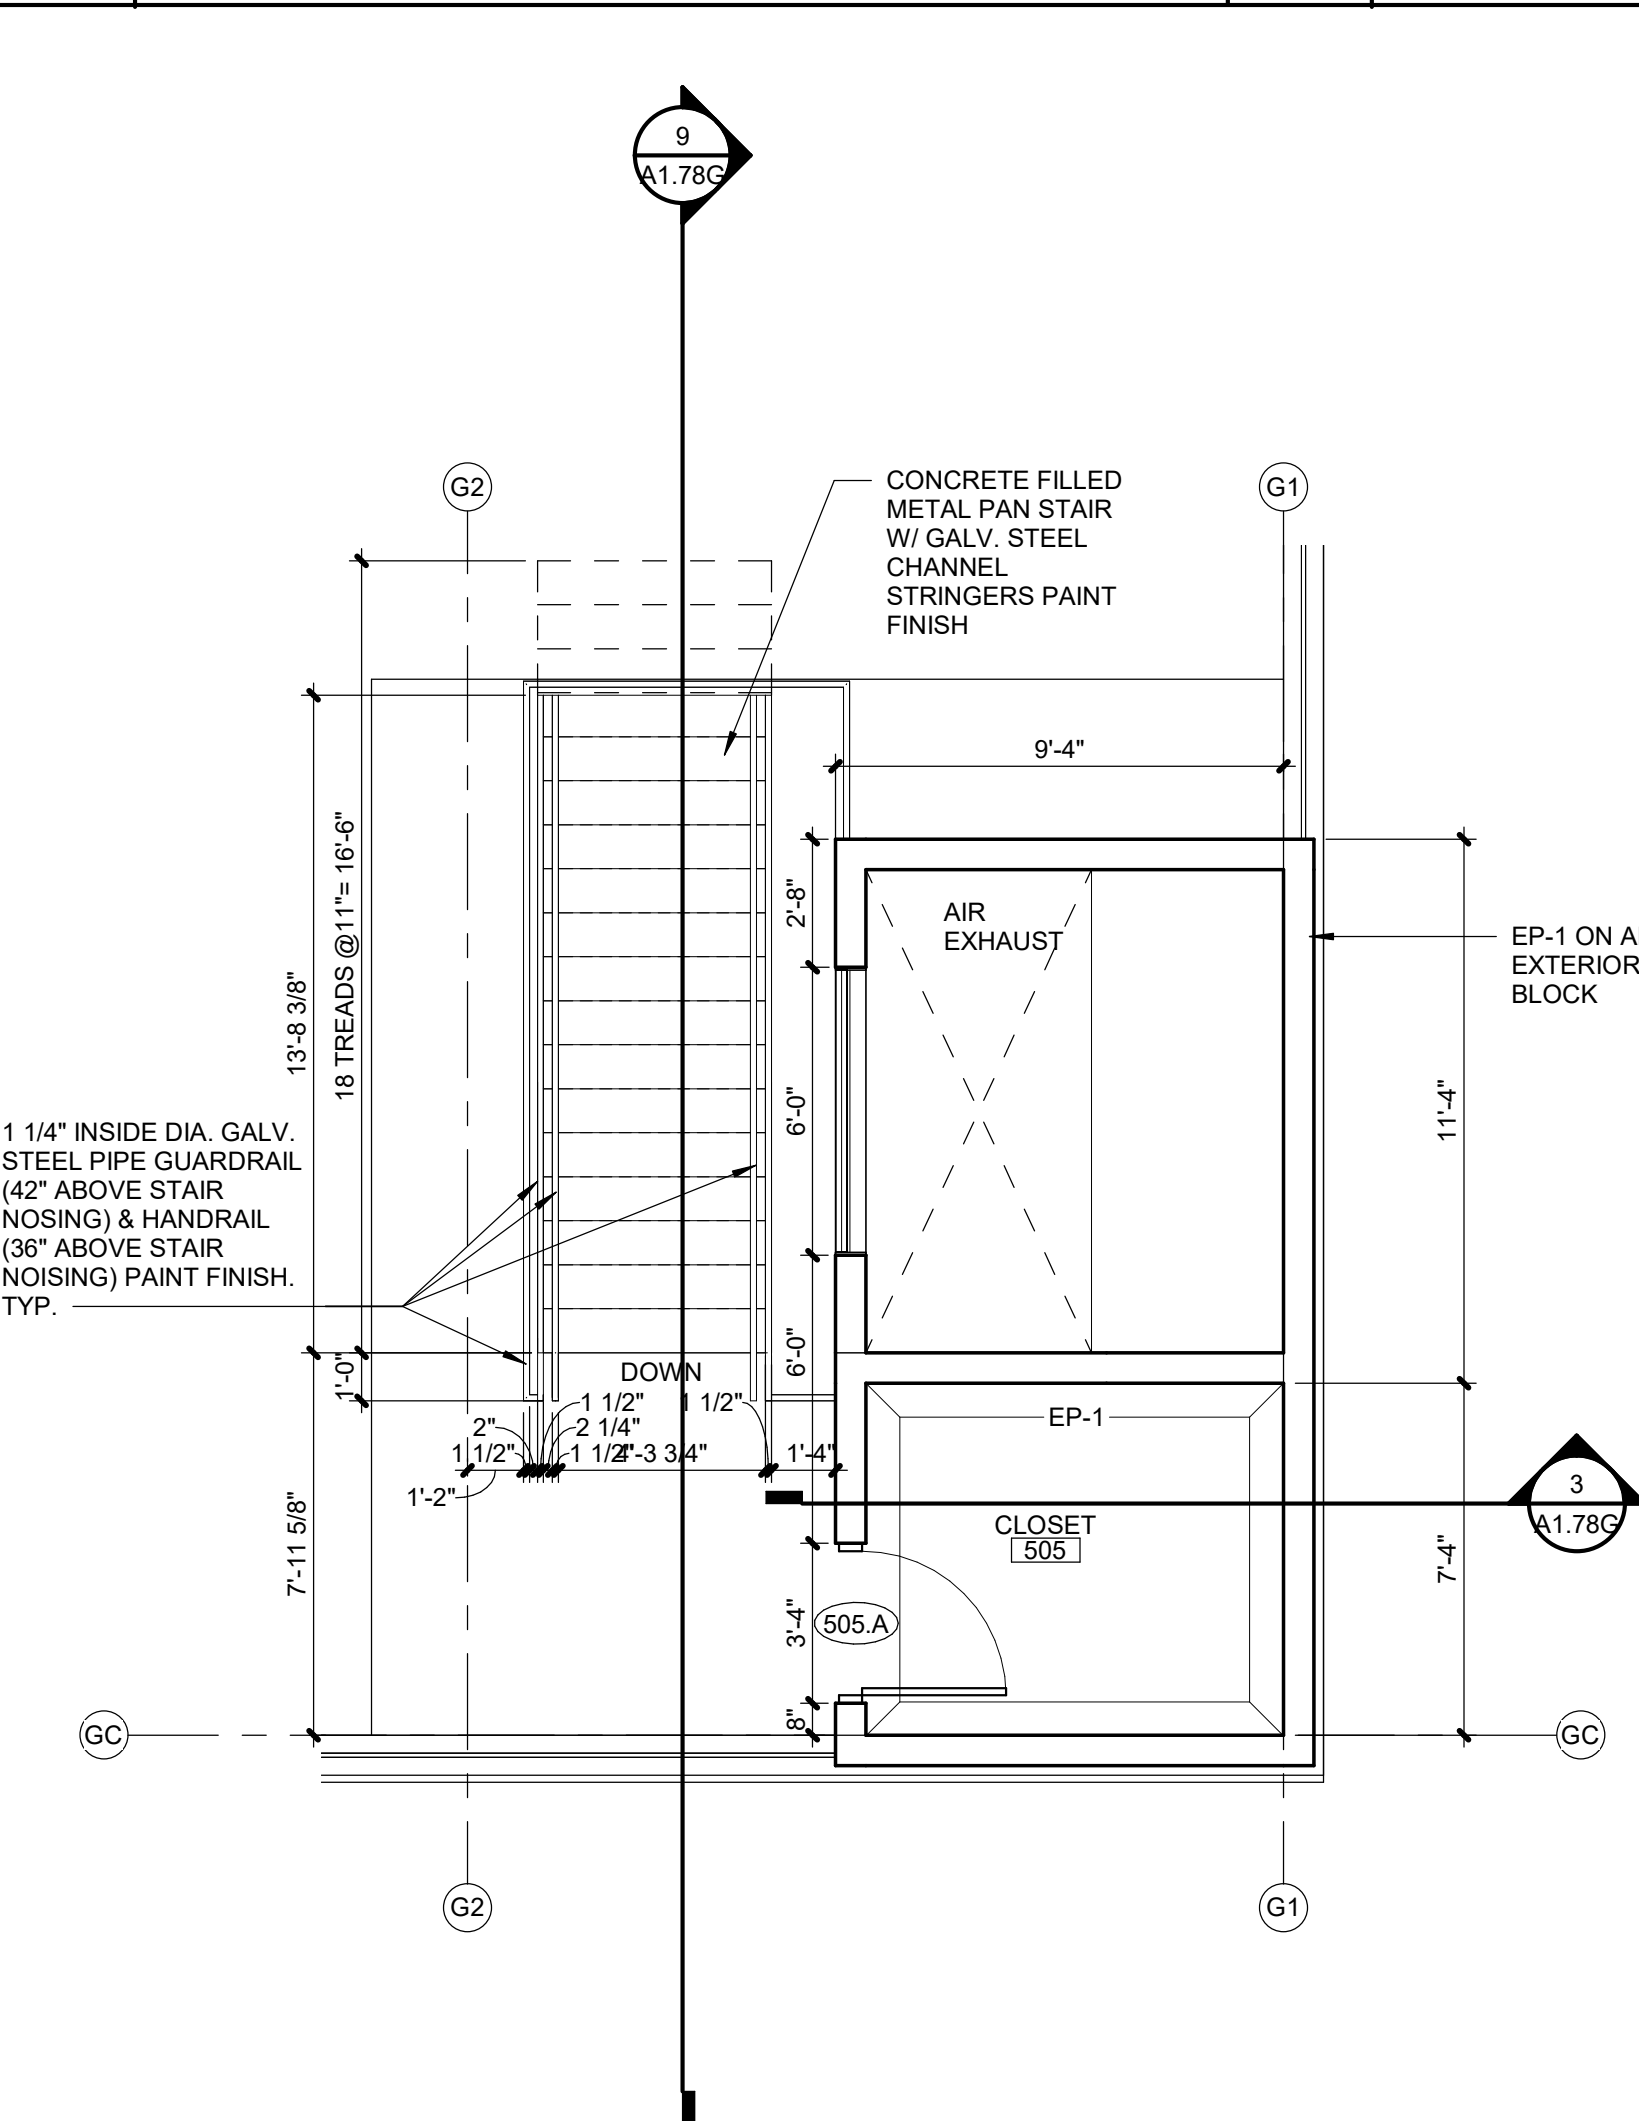
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A1.78G SCALE : 1/4" = 1'-0"

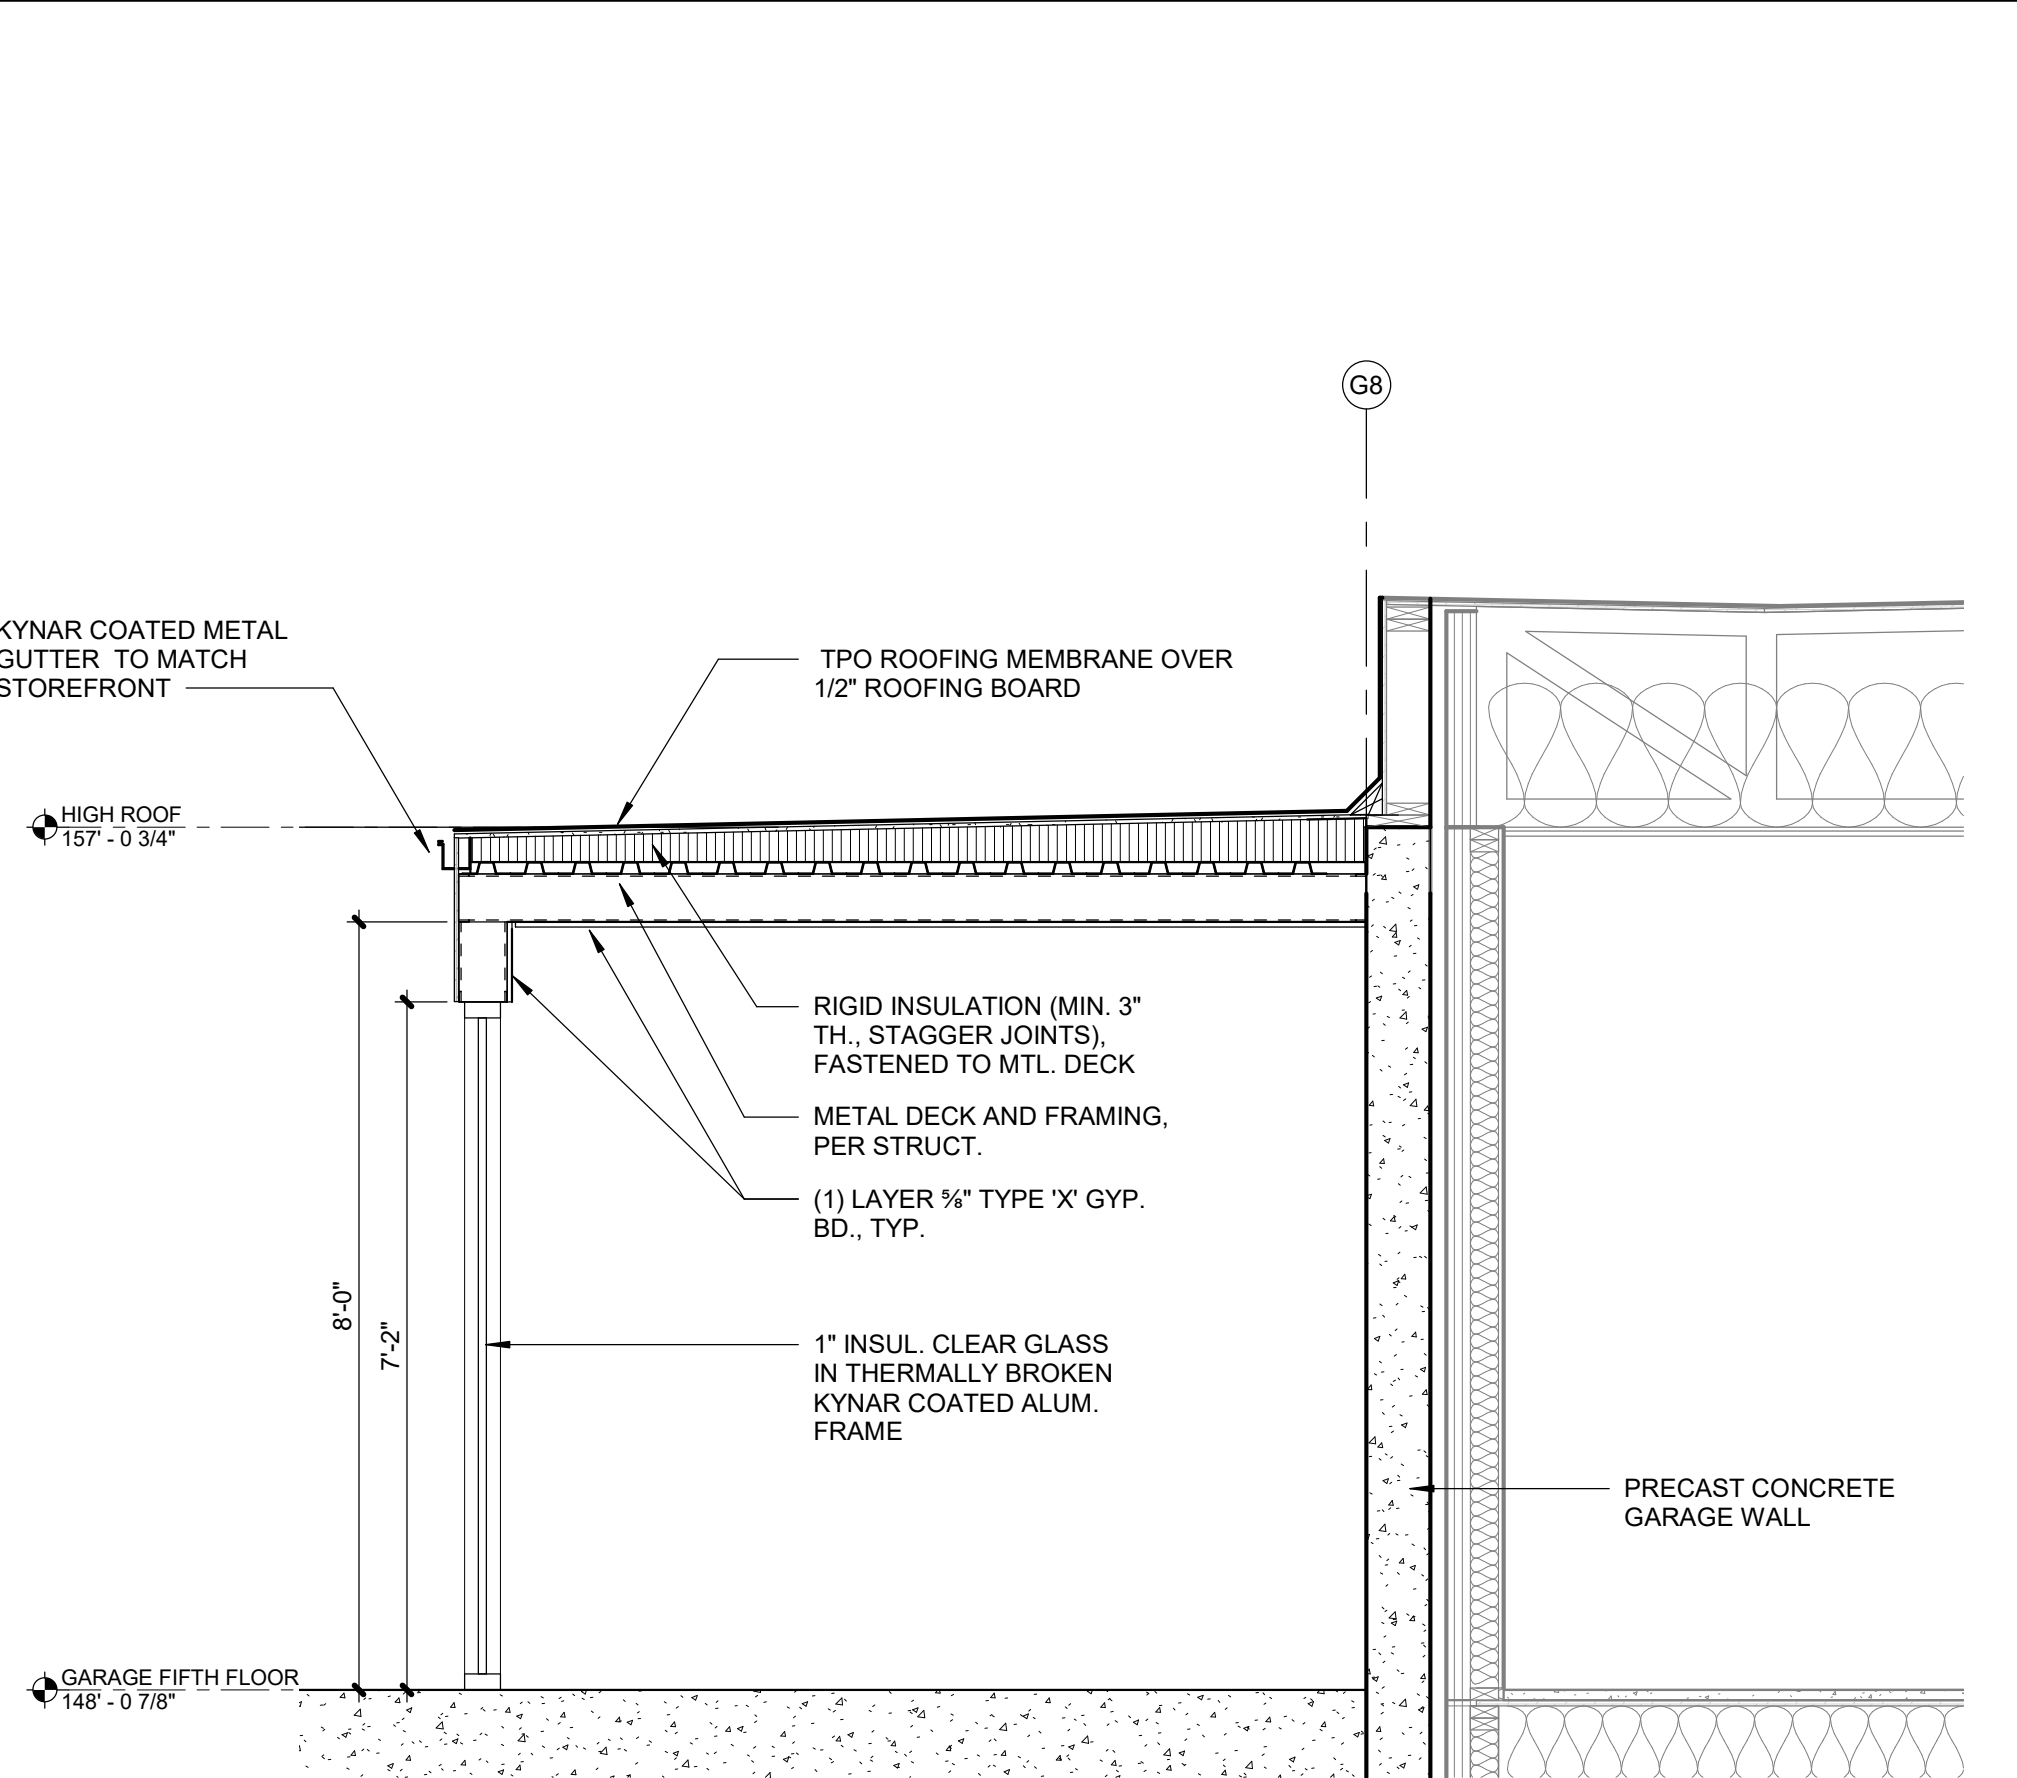

A1.78G SCALE : 1" = 1'-0"

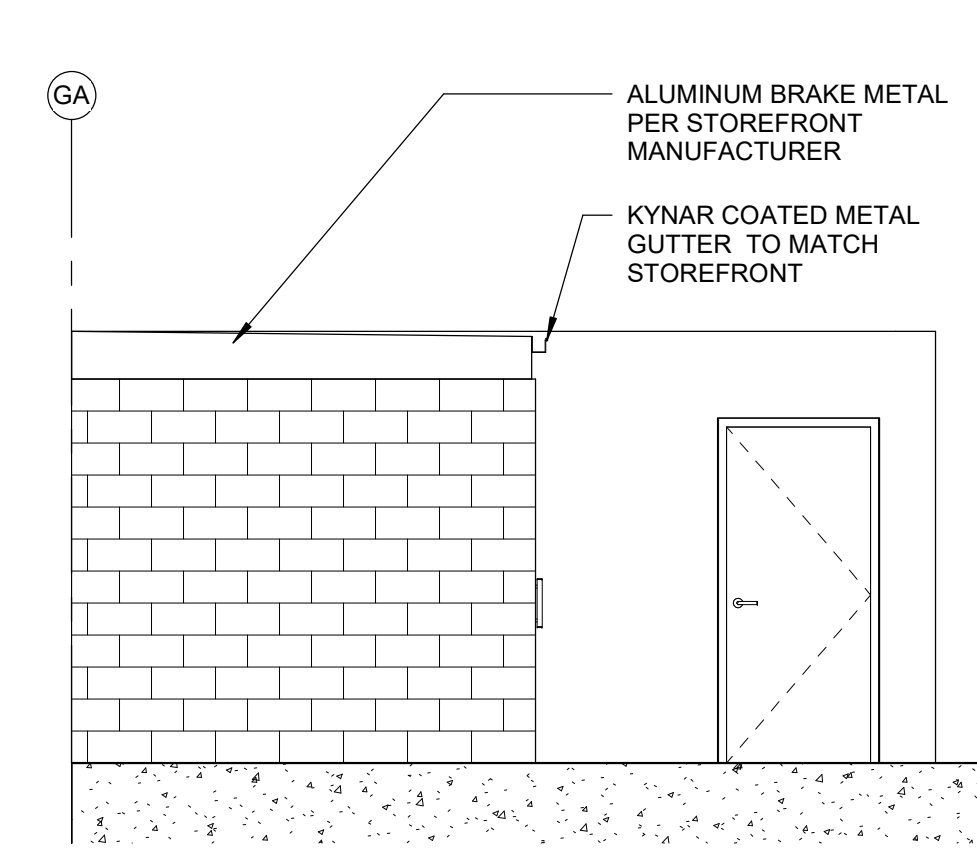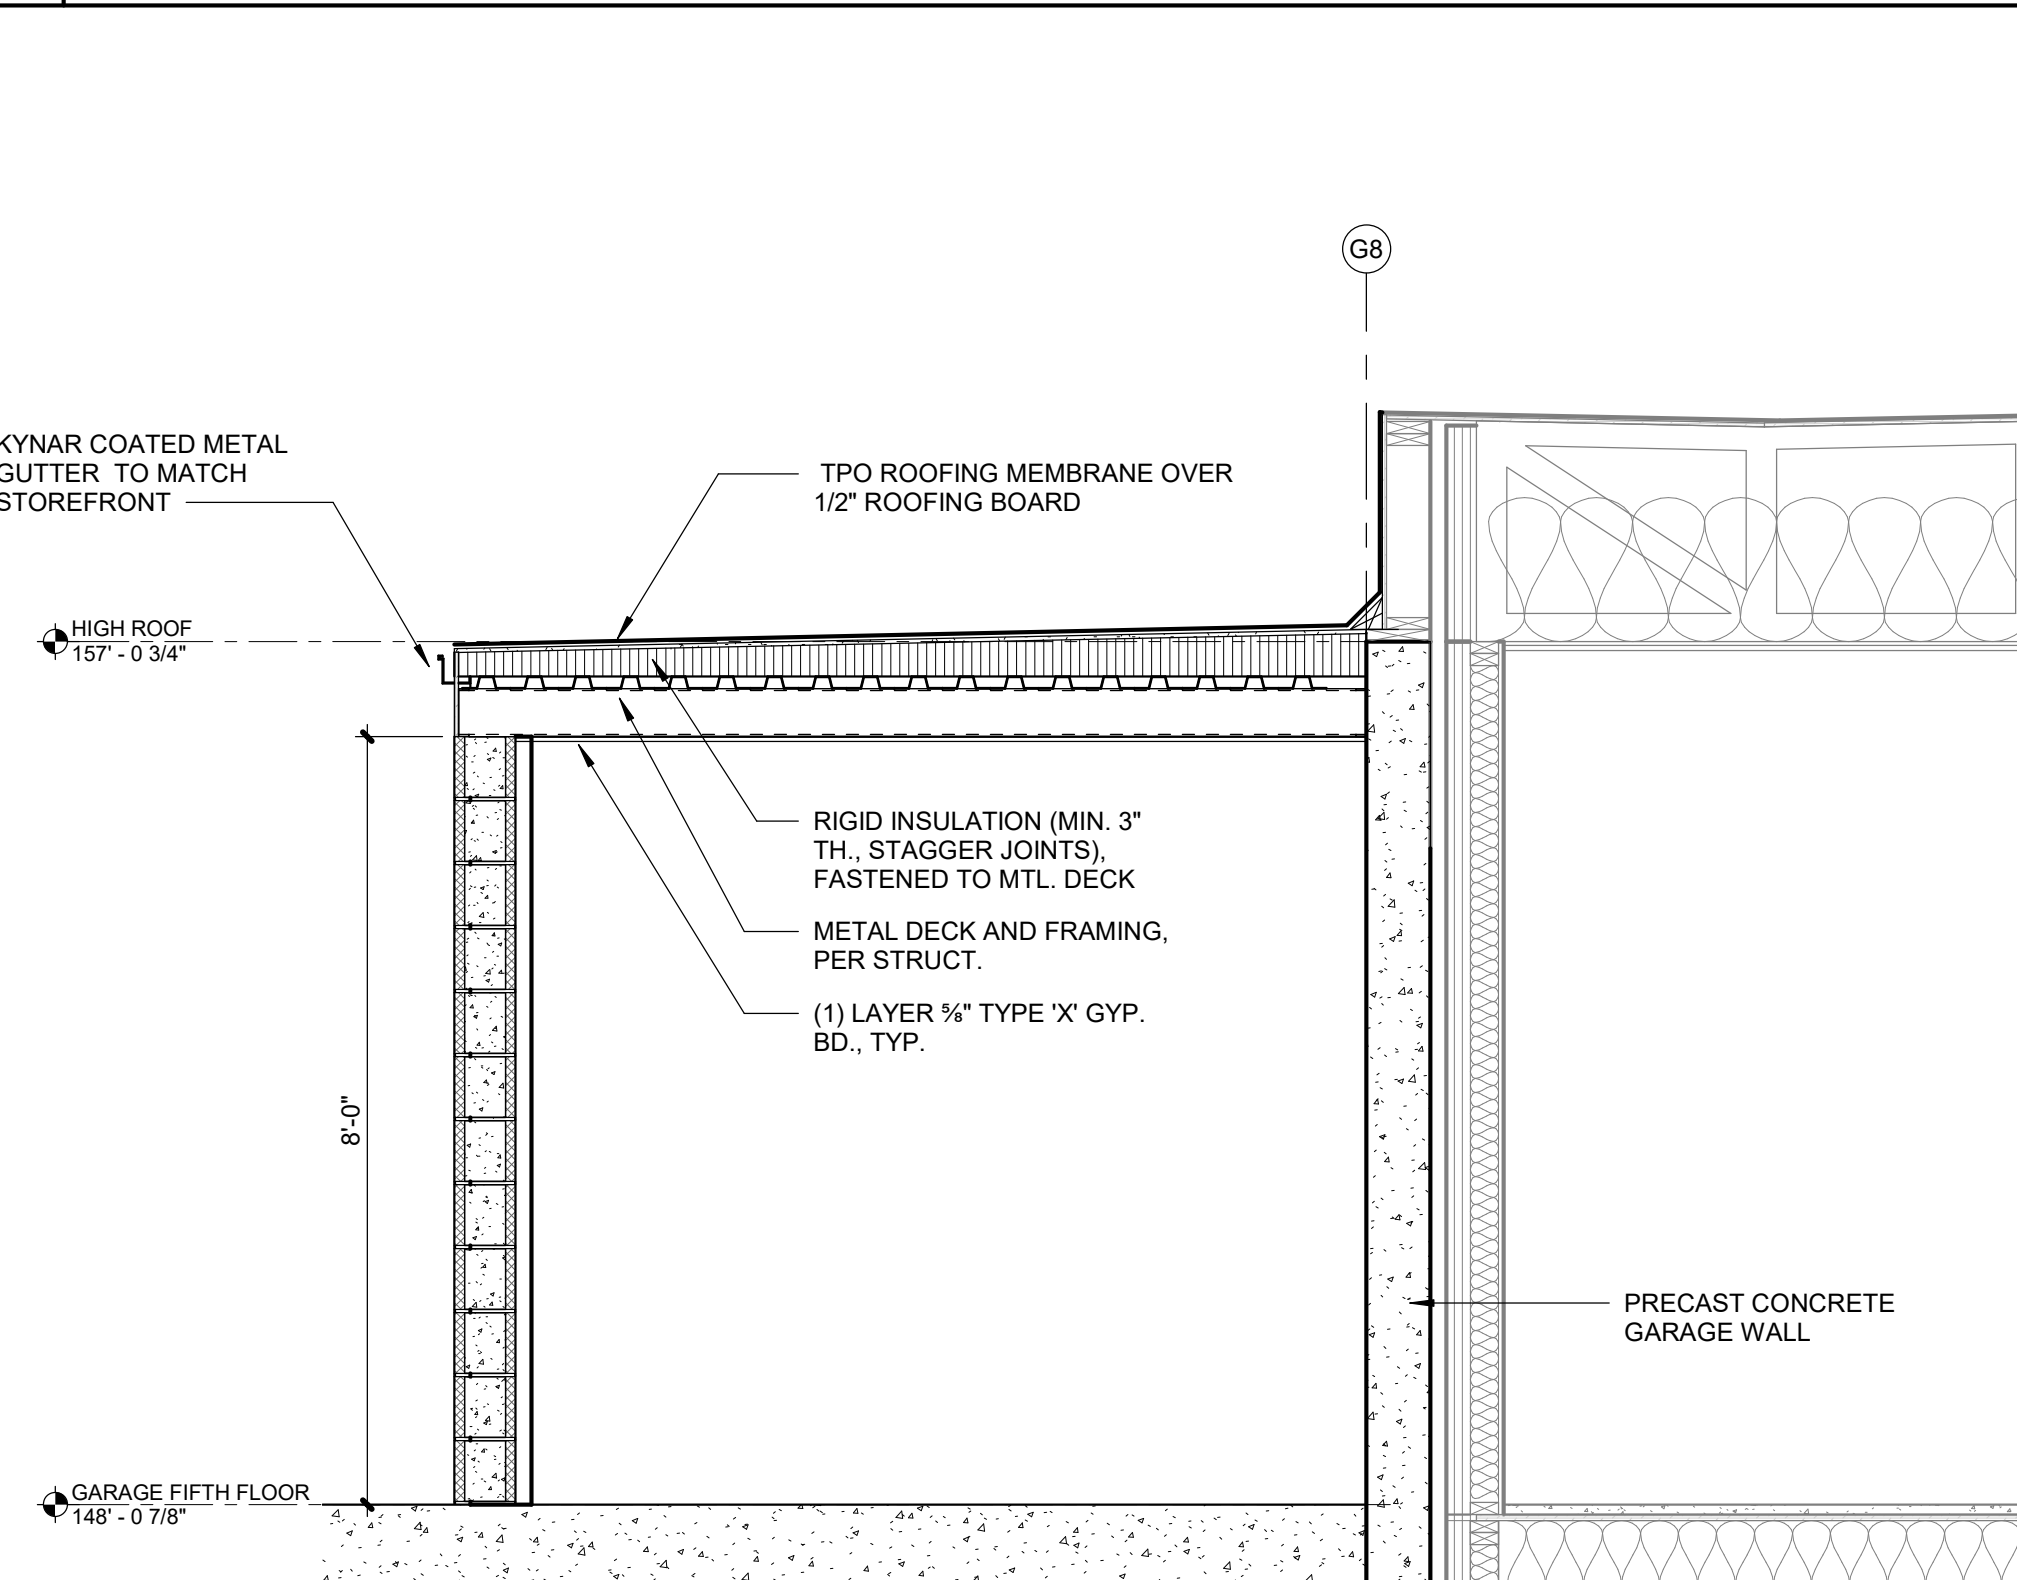

A1.78G SCALE : 1/4" = 1'-0"

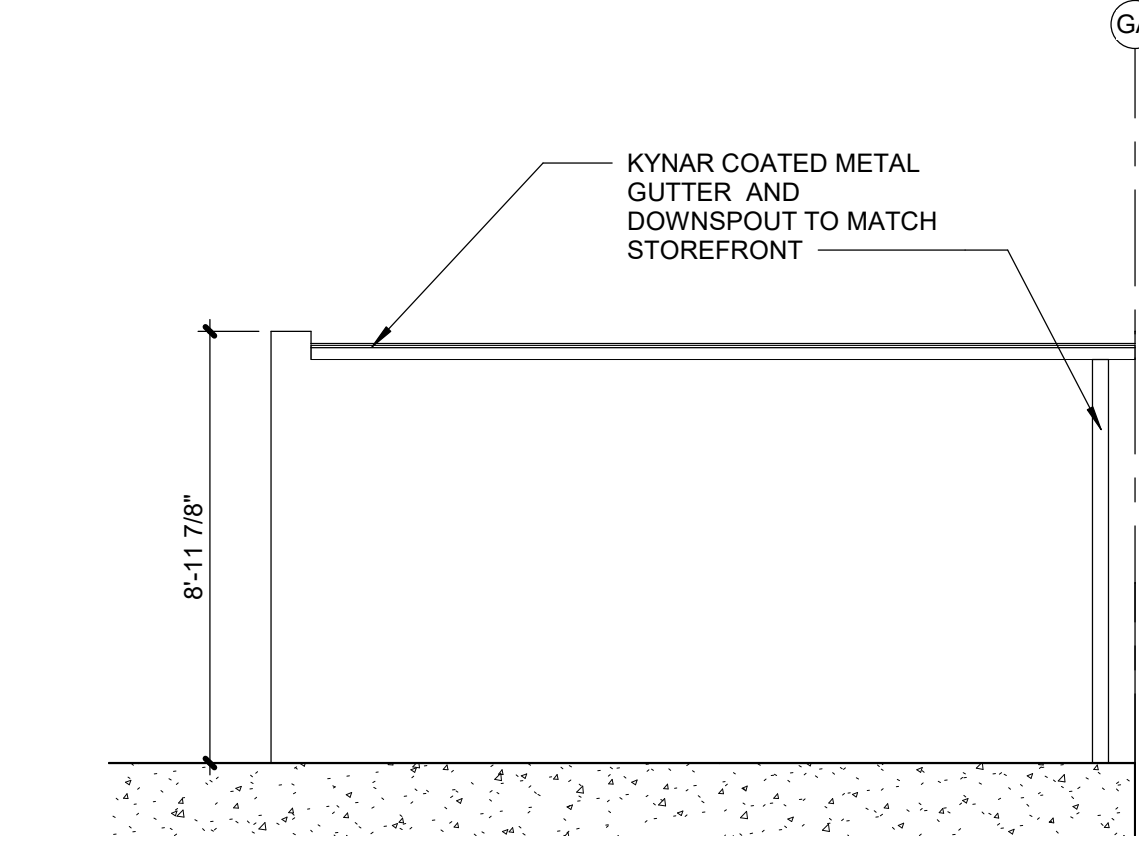8G SCALE : 1/2" = 1'-0"




00 NW PARAGON PKWY
E'S SUMMIT, MO 64081

No.:	18017,19050.07,19050.08
	02.04.22
For:	GARAGE PERMIT

[illegible]

REGISTRATION

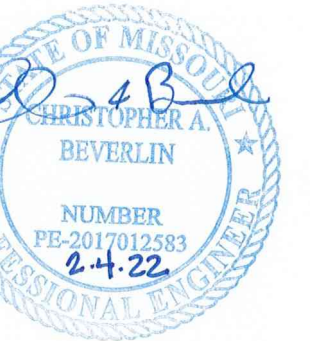

PROJECT TEAM

PROJECT	FINKLE+WILLIAMS ARCHITECTURE
	GBA ENGINEERS
SCAPE	LAND 3
CULTURAL	BOB D. CAMPBELL
ENGINEERING	LATIMER SOMMERS
Mechanical	LATIMER SOMMERS
Electrical	LATIMER SOMMERS
PROTECTION	LATIMER SOMMERS
MECHANICAL CONTRACTOR	BRINKMANN CONSTRUCTORS

SHEET TITLE

CMU DETAILS

SHEET NUMBER

SHEET NUMBER

S0.05



LEGEND:

- 1 FULL HEIGHT VERTICAL BARS AS JAMB REINFORCING IN FIRST 2 CELLS ADJACENT TO OPENING. REINFORCE EACH CELL WITH SIZE & QUANTITY OF BAR TO MATCH WALL REINFORCING (1 BAR TYPICAL IN 8" WALLS AND 2 BARS TYPICAL IN 12" WALLS).
- 2 LINTEL REINFORCE PER SECTION C. EXTEND 2'-0" PAST EDGE OF OPENING ON EACH SIDE (TYPICAL).
- 3 2#5 CONTINUOUS HORIZONTAL BARS AS SILL REINFORCING IN 8" COURSE BELOW OPENING (U.O.O.). EXTEND 2'-0" PAST EDGE OF OPENING ON EACH SIDE (TYPICAL).
- 4 FULL HEIGHT VERTICAL BARS PER MASONRY WALL REINFORCING SCHEDULE LOCATED IN END CELL AT EACH SIDE OF VERTICAL WALL. CONTROL JOINTS.


GENERAL CRITERIA: (SECTION A CONTINUED):

1. VERTICAL REINFORCING BARS SHALL BE DOWELED TO FOUNDATION WITH A DOWEL OF MATCHING SIZE AND SPACING.
2. CONTRACTOR SHALL COORDINATE AND VERIFY OPENINGS IN MASONRY WALLS. OPENINGS SHALL BE DETAILED ON REINFORCING STEEL SHOP DRAWING ELEVATIONS.
3. VERTICAL CONTROL JOINTS IN MASONRY WALLS SHALL BE 3/8" WIDE, FULL HEIGHT OF WALL. JOINTS SHALL BE SPACED AT A MAXIMUM OF 24'-0" ON CENTER AND NOT LESS THAN 2'-0" FROM THE EDGE OF ANY OPENING. HORIZONTAL JOINT REINFORCING SHALL BE CONTINUOUS THROUGH CONTROL JOINTS. ALL BOND BEAM HORIZONTAL REINFORCING SHALL BE CONTINUOUS THROUGH CONTROL JOINTS.
- CONTRACTOR SHALL COORDINATE AND VERIFY ALL CONTROL JOINT LOCATIONS.


MASONRY VERTICAL REINFORCING SCHEDULE			
FOR LOAD BEARING MASONRY (CMU) WALLS			
WALL THICKNESS	LOCATION	VERTICAL REINF. (IN GROUTED CELLS)	SPACING
8"	GARAGE ATOP PRECAST	1-#5	48"oc
8"	BTWN GARAGE & RETAIL	1-#5	32"oc
8"	ELEVATOR	1-#5	32"oc

$$1\frac{1}{2}'' = 1'-0''$$


3/4" = 1'-0"

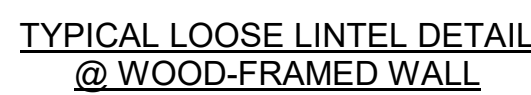

3/4" = 1'-0"

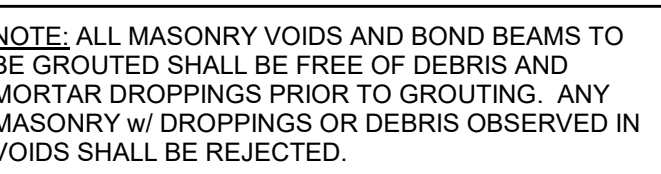

TYPICAL REBAR POSITIONING DETAIL

1 1/2" = 1'-0"




$3/4" = 1'-0"$

LOOSE LINTEL SCHEDULE	
FOR OPENINGS:	GALV. ANGLE
LESS THAN 6'-0"	L5"x3 1/2"x5/16" (LLV)
6'-0" < OPENING < 9'-0"	L6"x3 1/2"x5/16" (LLV)
9'-0" < OPENING < 9'-6"	L8"x4"x1/2" (LLV)

TYPICAL MASONRY REINFORCING NOTE:


ALL INTERIOR & EXTERIOR MASONRY WALLS SHOWN ON ARCHITECTURAL AND STRUCTURAL DRAWINGS ARE TO BE REINFORCED HORIZONTALLY WITH BOND BEAMS (2 - #5 BOTTOM) AT BOTTOM COURSE, TOP COURSE, JOIST BEARING ELEVATION AND AT 8'-0" MAXIMUM O.C. AND VERTICALLY AS INDICATED ON DRAWINGS. THESE WALLS ARE TO BE ANCHORED TOP AND BOTTOM TO THE FOUNDATION, FLOOR, OR ROOF PER TYPICAL DETAILS. THE VERTICAL REINFORCING IS CONTINUOUS (IN 6'-6" MAXIMUM LENGTHS, LAPPED 2'-6" MINIMUM). FILL BLOCK CELLS AND BOND BEAMS WITH 2,500psi GROUT. RE: DETAILS "A" THROUGH "E" ON THIS SHEET.

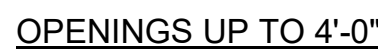


OPENINGS 4'-0" TO 7'-4"

TYPICAL LINTELS AT ALL CMU WALLS (U.N.O.)


1 1/2" = 1'-0"

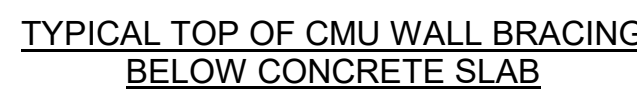

$3/4" = 1'-0"$

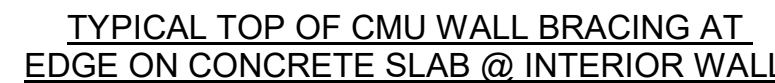

$3/4" = 1'-0"$

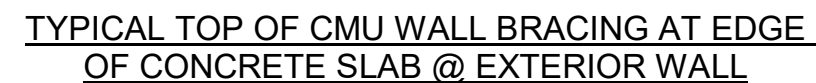
$$\frac{3}{4}'' = 1'-0''$$

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3200 NW PARAGON PKWY
LEE'S SUMMIT, MO 64081

Project No.: 18017,19050.07,19050.08

Date: 02.04.22

Issued For: GARAGE PERMIT

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REGISTRATION



PROJECT TEAM

ARCHITECT	FINKLE+WILLIAMS ARCHITECTURE
CIVIL	GBA ENGINEERS
LANDSCAPE	LAND 3
STRUCTURAL	BOB D. CAMPBELL
PLUMBING	LATIMER SOMMERS
MECHANICAL	LATIMER SOMMERS
ELECTRICAL	LATIMER SOMMERS
FIRE PROTECTION	LATIMER SOMMERS
CONTRACTOR	BRINKMANN CONSTRUCTORS


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SHEET TITLE

GARAGE
 FOUNDATION
 PLAN

SHEET NUMBER

S1.71G

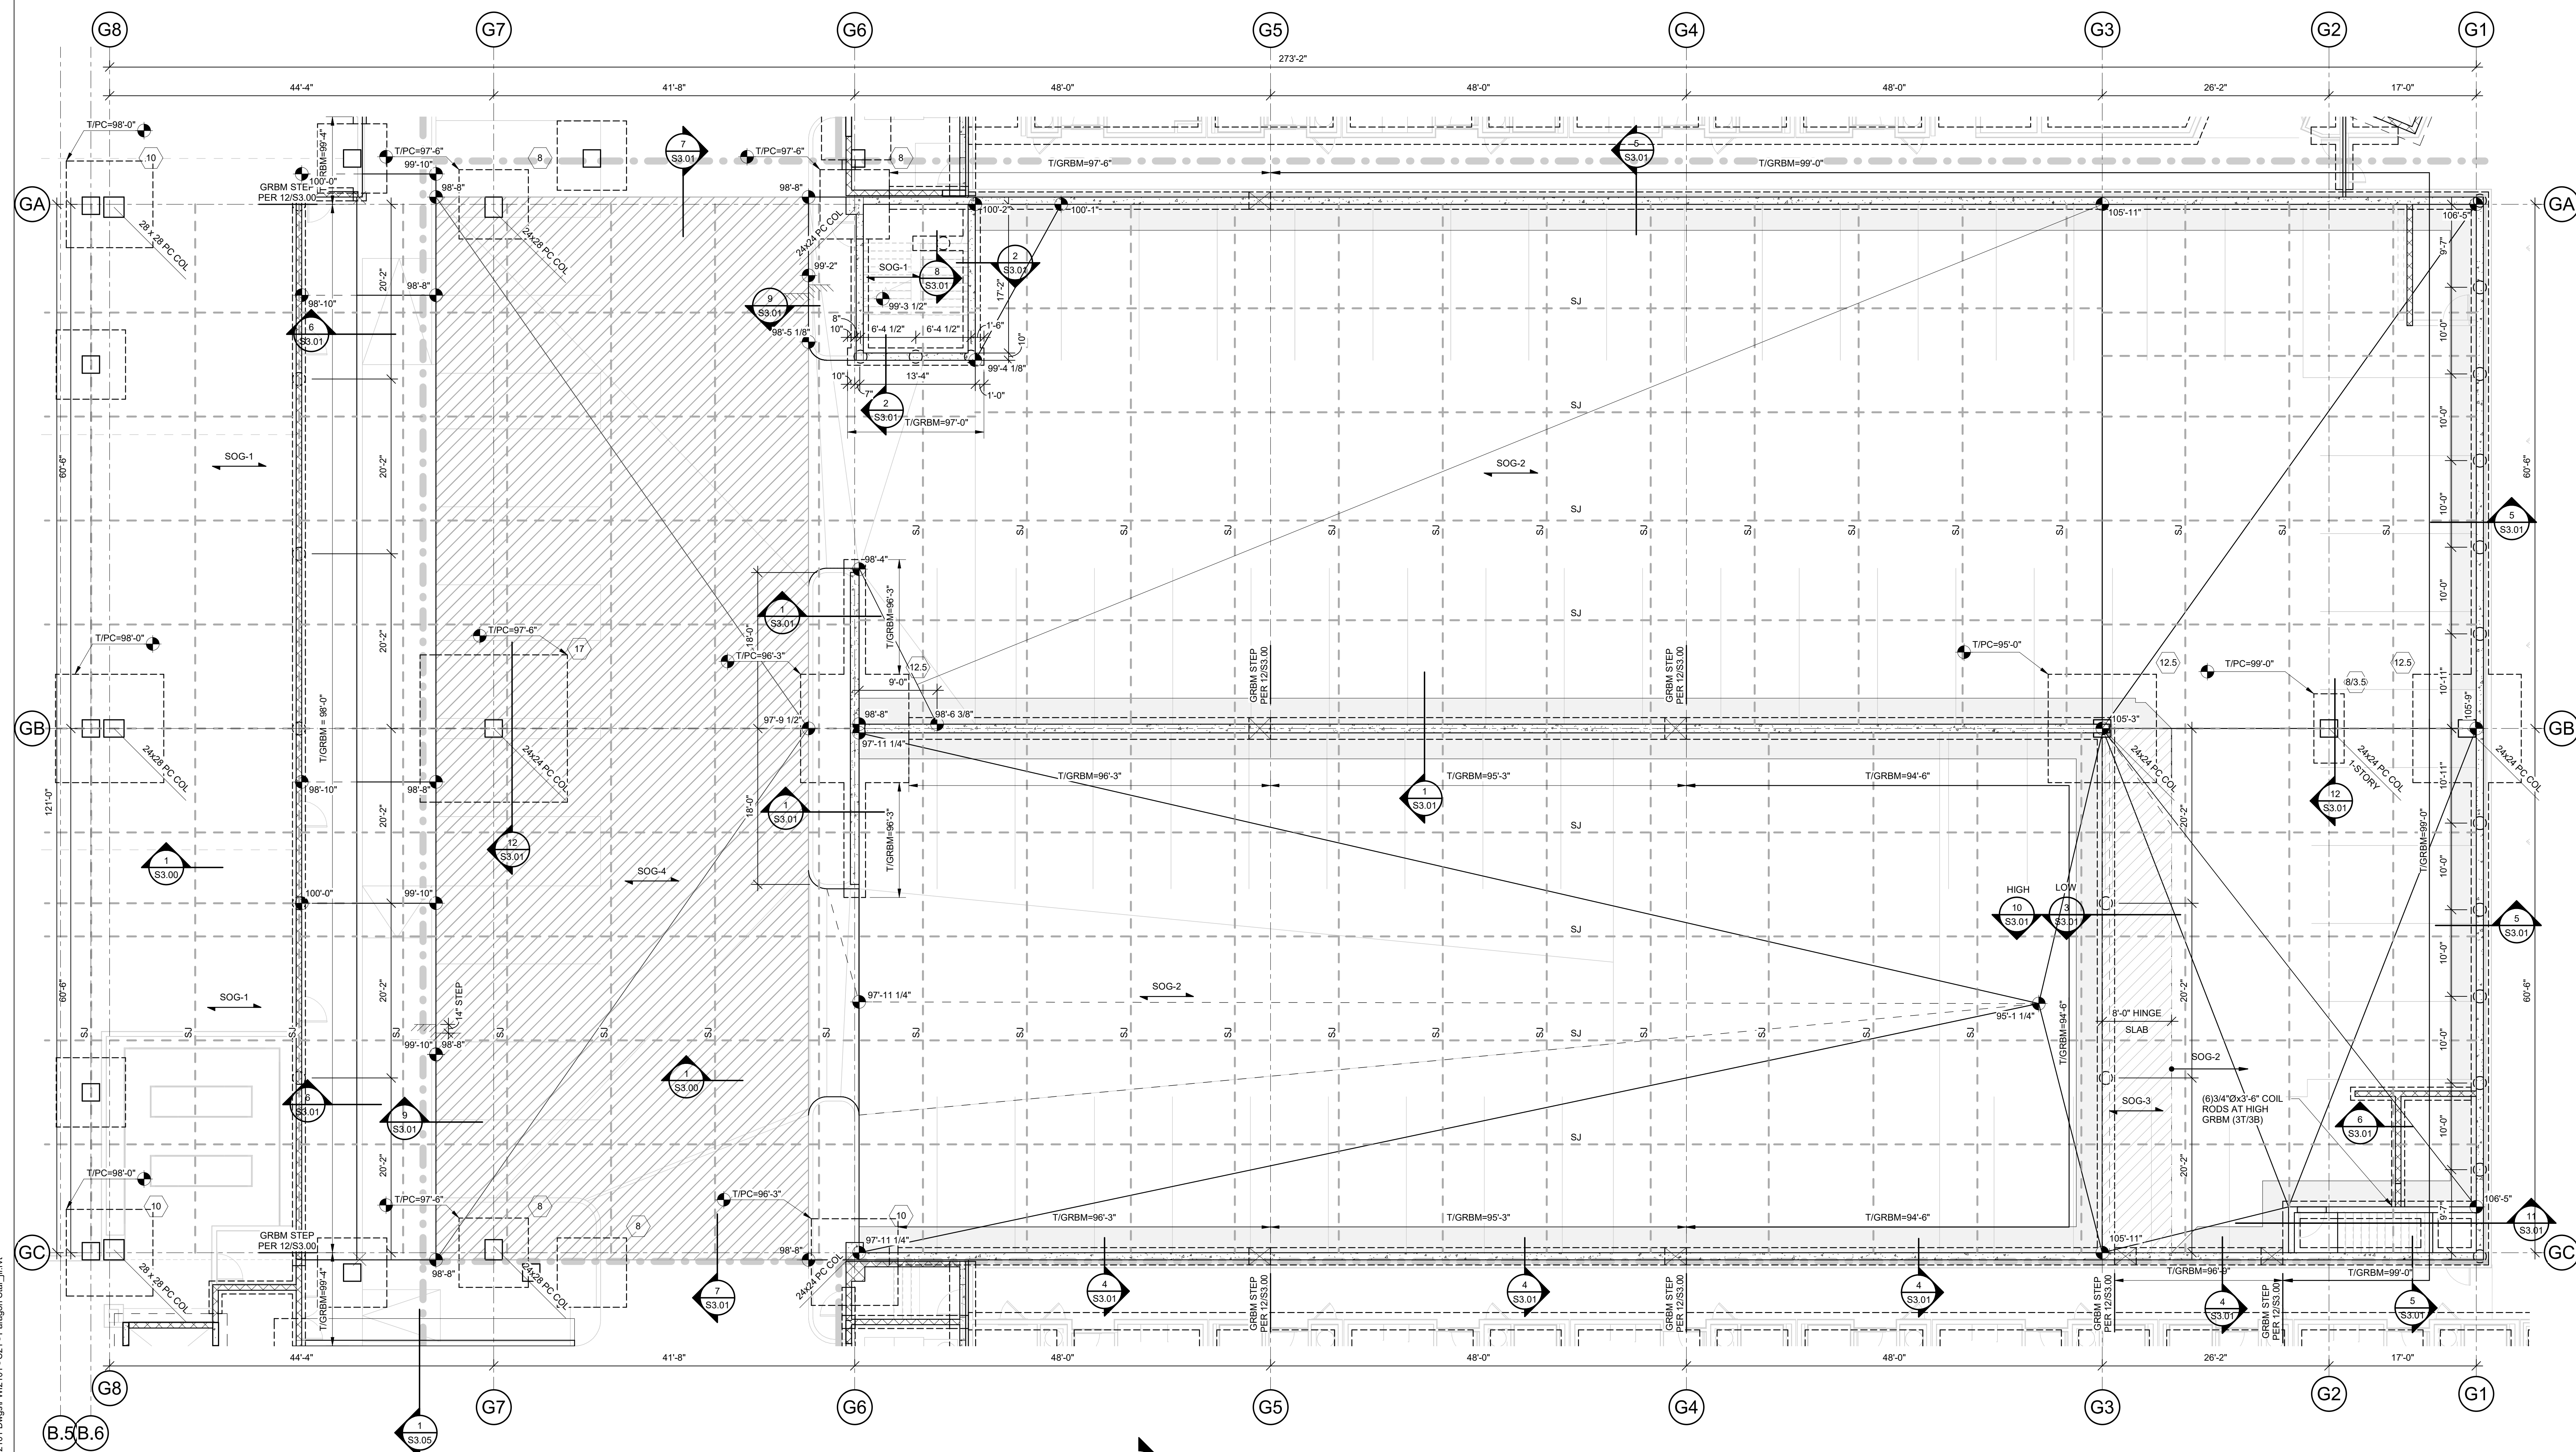

N **1 GARAGE FOUNDATION PLAN**
1/8" = 1'-0"

FOUNDATION NOTES - GARAGE

1. REFER TO GENERAL NOTES ON SHEET SO.01.
2. REFER TO PILE CAP SCHEDULE ON S3.02.
3. REFER TO CIVIL AND ARCH DRAWING FOR SLAB ELEVATIONS.
4. ELEVATION 100'-0" EALS CIVIL DATUM ELEVATION 820.67.
5. TOP OF EXTERIOR FOOTINGS = 99'-0" UNO
6. TOP OF INTERIOR PILE CAPS = 98'-4" UNO
7. REFER TO ARCHITECTURAL AND MECHANICAL DRAWINGS FOR LOCATIONS OF SPOT AND TRENCH DRAINS
8. REFER TO S3.00-SERIES DRAWINGS FOR TYPICAL FOUNDATION DETAILS.

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CIVIL GBA ENGINEERS

LANDSCAPE LAND 3

STRUCTURAL BOB D. CAMPBELL

PLUMBING LATIMER SOMMERS

MECHANICAL LATIMER SOMMERS

ELECTRICAL LATIMER SOMMERS

FIRE PROTECTION LATIMER SOMMERS

CONTRACTOR	CONSTRUCTORS
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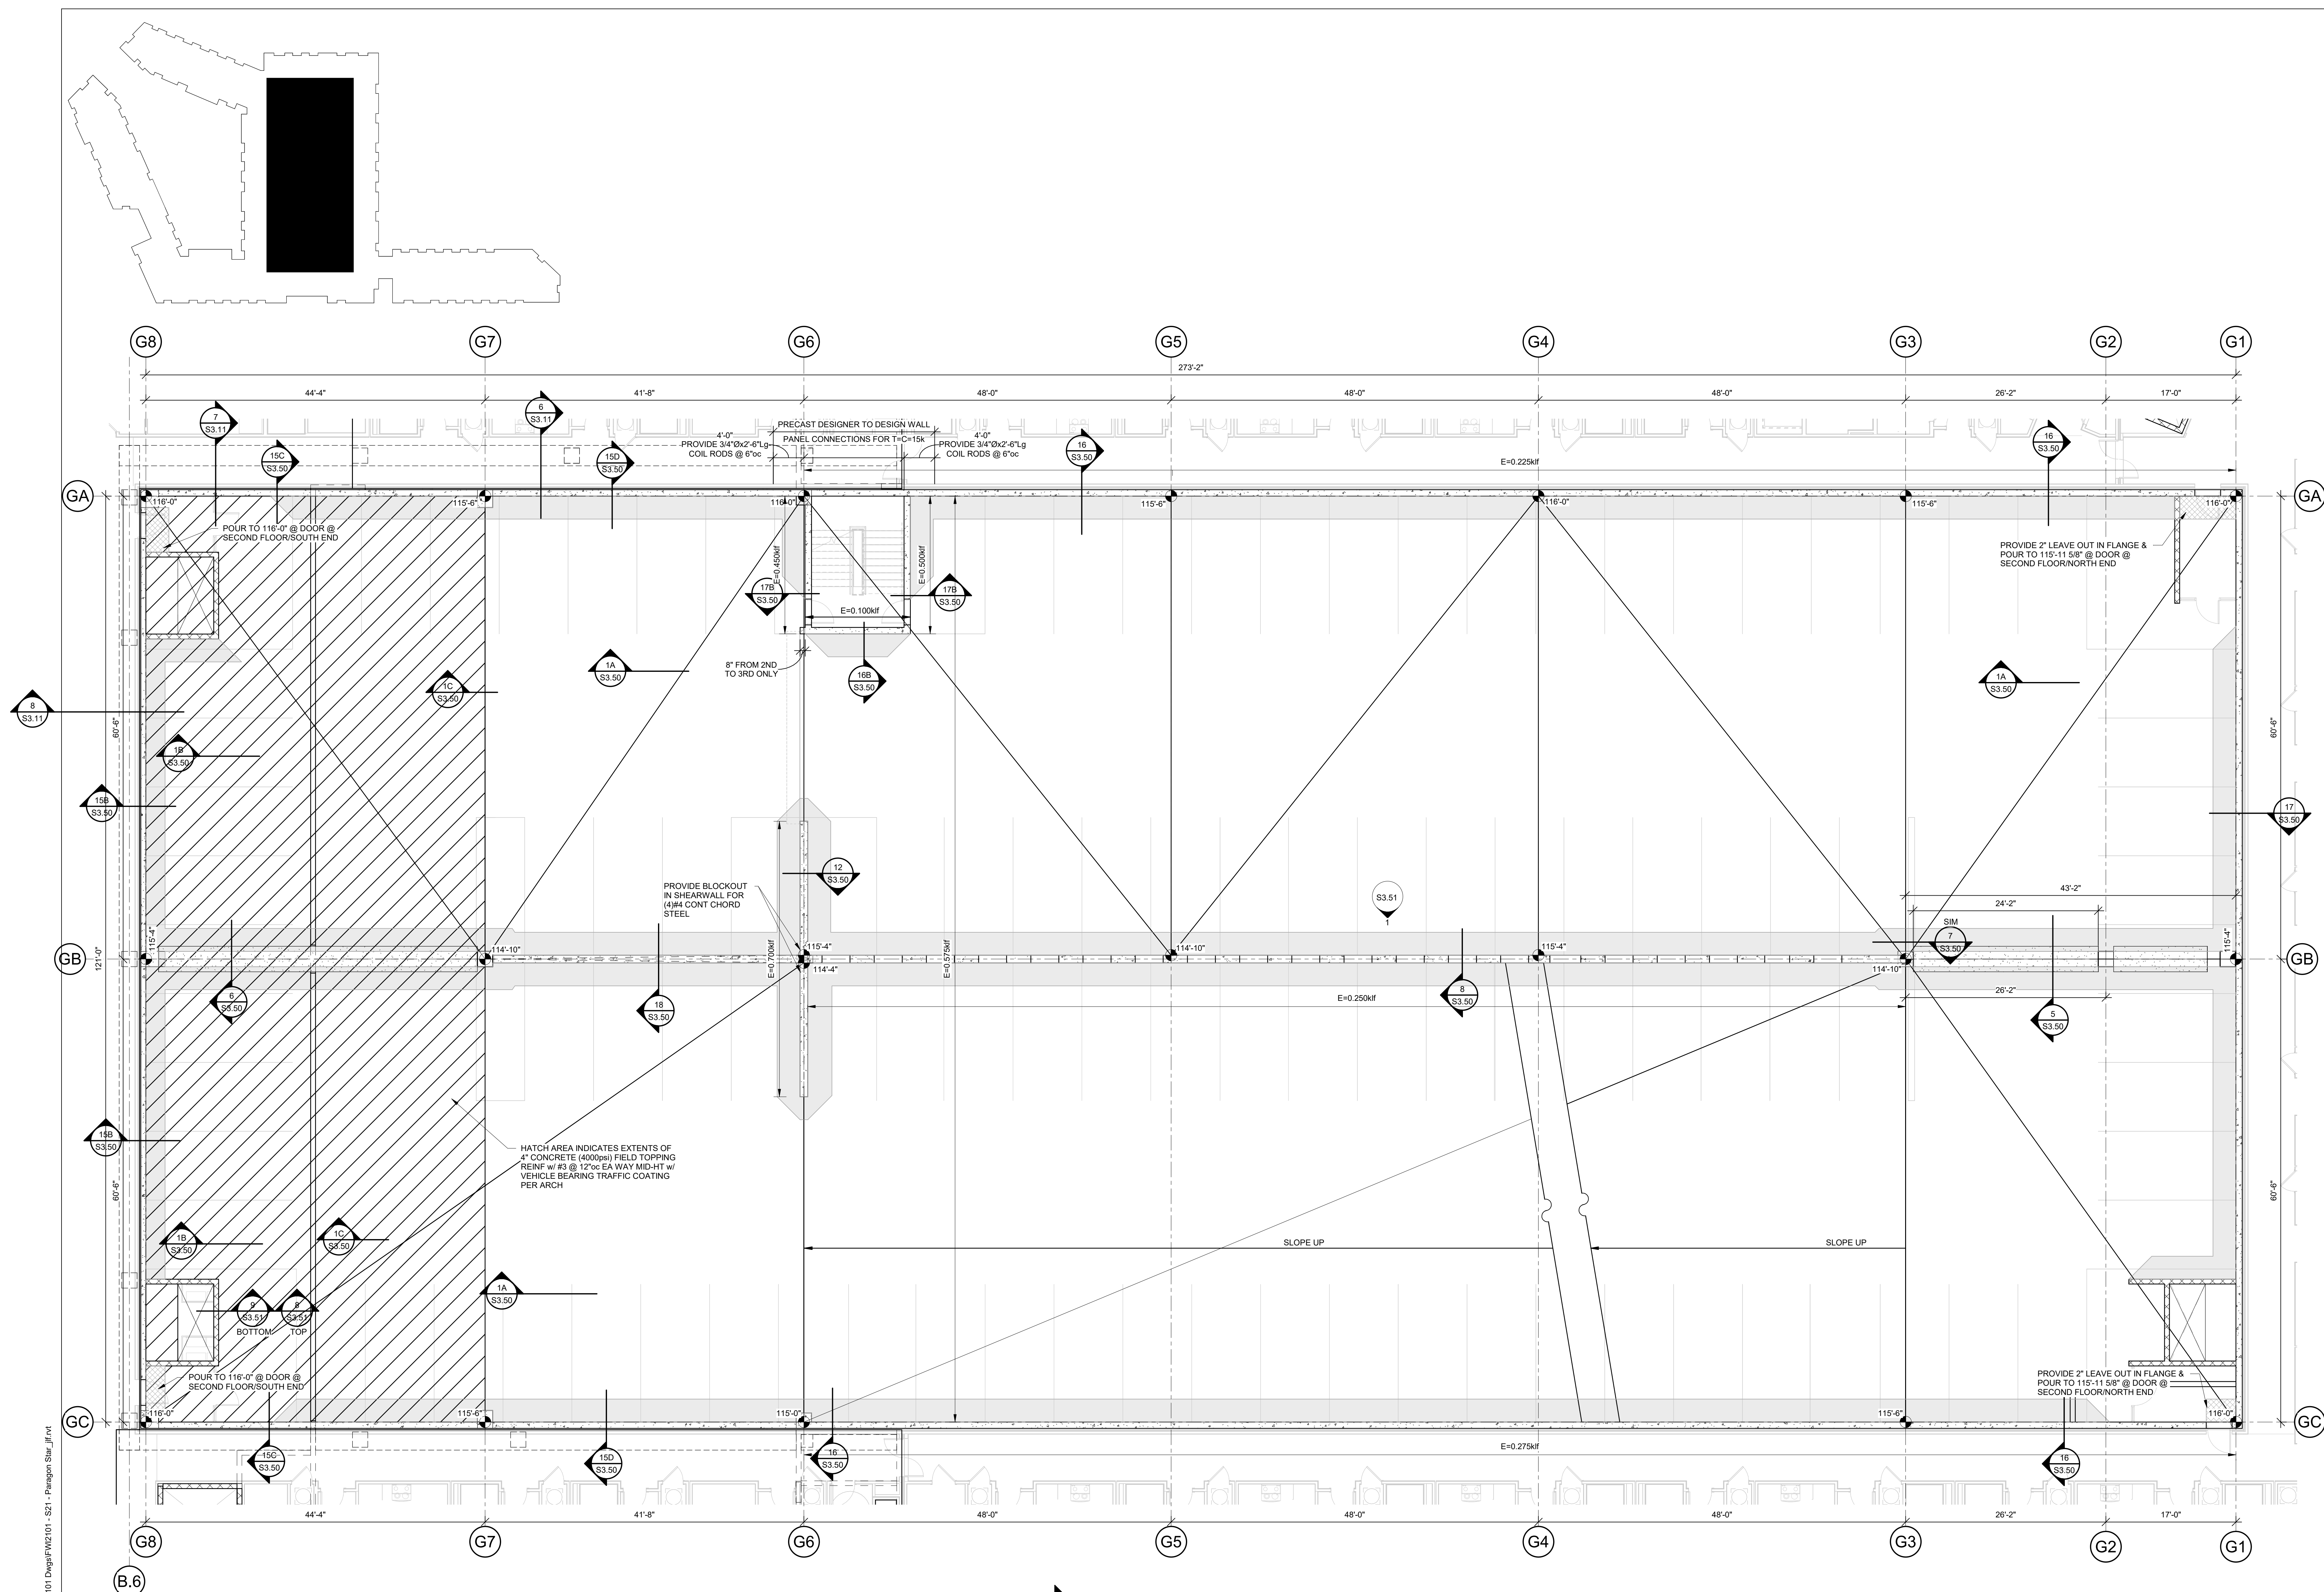
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SHEET TITLE

GARAGE SECOND FLOOR FRAMING PLAN

SHEET NUMBER

S1.72G



N 1 **GARAGE SECOND FLOOR FRAMING PLAN**
1/8" = 1'-0"

FRAMING NOTES - GARAGE

1. REFER TO GENERAL NOTES ON SHEET S01.
2. REFER TO CIVIL AND ARCH DRAWING FOR SLAB ELEVATIONS.
3. REFER TO ARCHITECTURAL AND MECHANICAL DRAWINGS FOR LOCATIONS OF SPOUT DRAINS.
4. REFS 1, 2, 3, 5, 6, 7, 824, 825

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PROJECT TEAM

ARCHITECT	FINKLE+WILLIAMS ARCHITECTURE
CIVIL	GBA ENGINEERS
LANDSCAPE	LAND 3
STRUCTURAL	BOB D. CAMPBELL
PLUMBING	LATIMER SOMMERS
MECHANICAL	LATIMER SOMMERS
ELECTRICAL	LATIMER SOMMERS
FIRE PROTECTION	LATIMER SOMMERS
CONTRACTOR	BRINKMANN CONSTRUCTORS


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SHEET TITLE

GARAGE THIRD FLOOR FRAMING PLAN

SHEET NUMBER

S1.73G

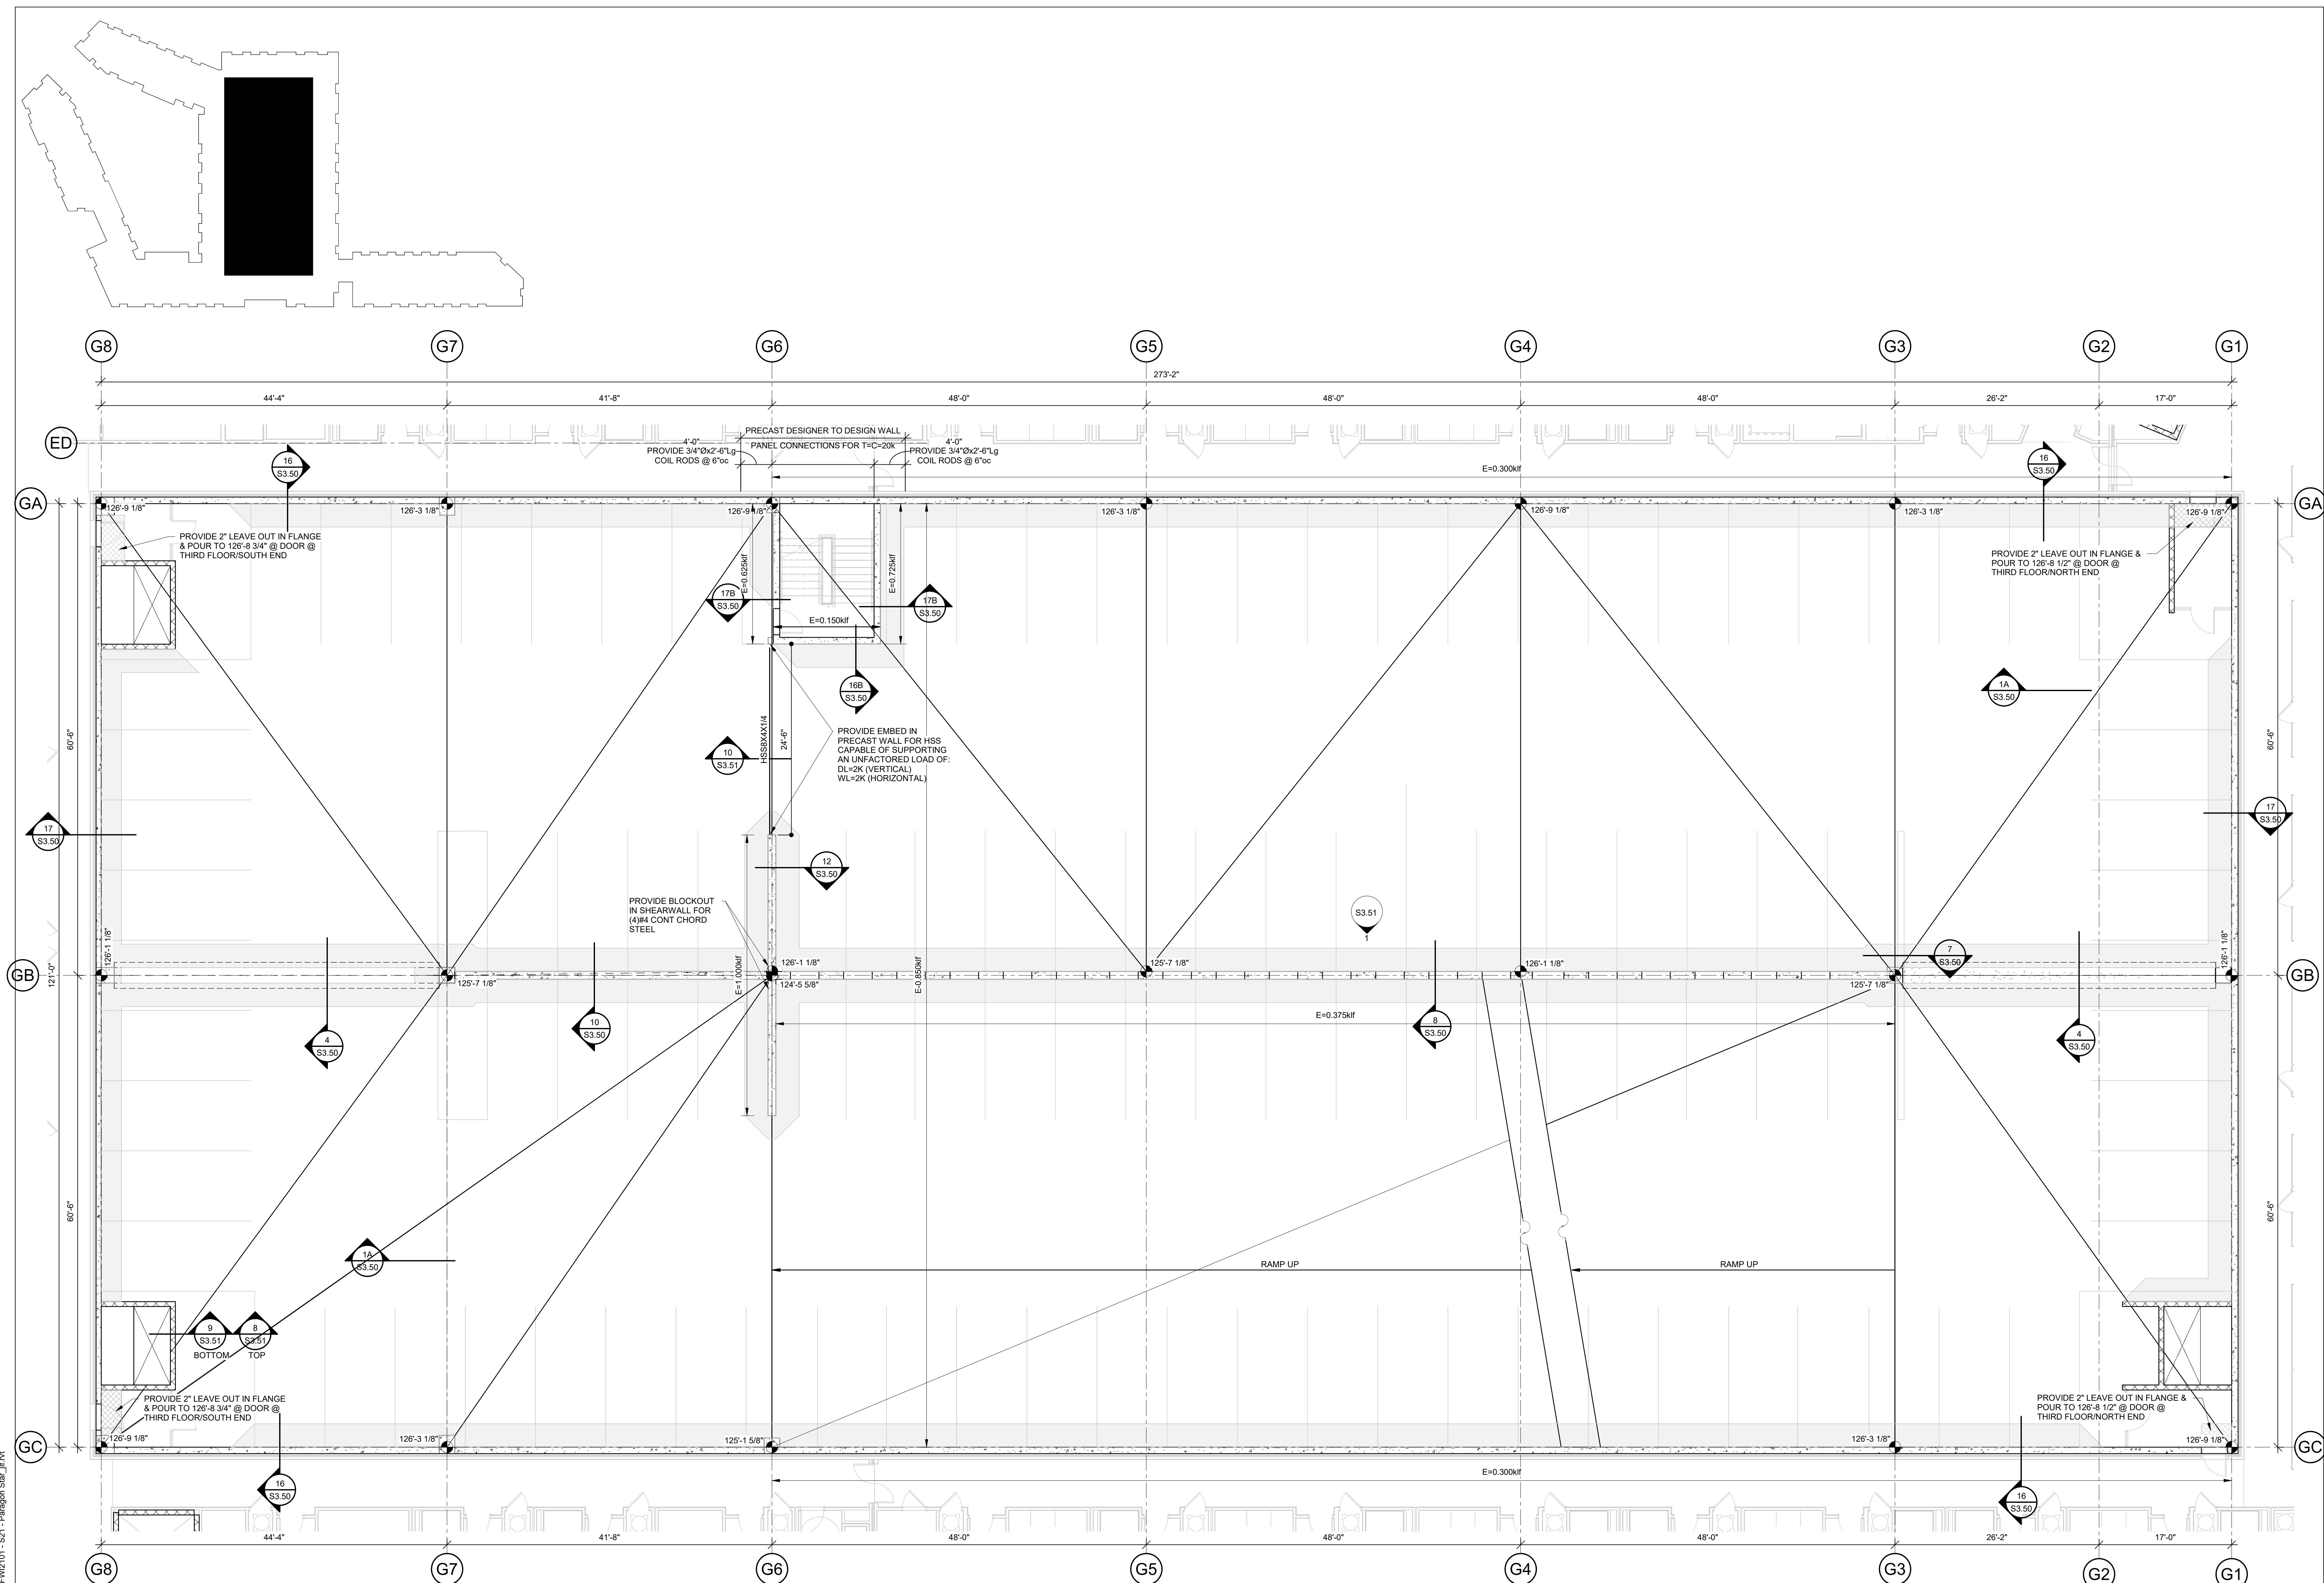

N 1 GARAGE THIRD FLOOR FRAMING PLAN

- FRAMING NOTES - GARAGE:**
1. REFER TO GENERAL NOTES ON SHEET S0.01.
 2. REFER TO CIVIL AND ARCH DRAWINGS FOR SLAB ELEVATIONS.
 3. REFER TO ARCHITECTURAL AND MECHANICAL DRAWINGS FOR LOCATIONS OF SPOT DRAINS.
 4. REFER TO S3.50-SERIES DRAWINGS FOR TYPICAL GARAGE FRAMING DETAILS.
 5. ELEVATIONS INDICATED ARE TO TOP OF PRECAST AND DO NOT INCLUDE THE WASH.
 6. FLOOR FINISH TO BE 1" THICK FRC CONCRETE. FINISH TO MATCH THE NOMINAL FLOOR ELEVATION OF THE APARTMENT. FEATHER WASH/TOPPING AT DOOR TO 14" MAX SLOPE.
 7. PROVIDE ALLOWANCE OF 700psi DEAD LOAD IN PRECAST DESIGN AT ALL CMU WALLS SHOWN IN GARAGE.
 8. TYPICAL PIPE PROTECTION PER SECTION 7/3.51

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STRUCTURAL BOB D. CAMPBELL

LUMBING LATIMER SOMMER:

MECHANICAL LATIMER SOMMER

ELECTRICAL LATIMER SOMMER

FIRE PROTECTION LATIMER SOMMER

CONTRACTOR
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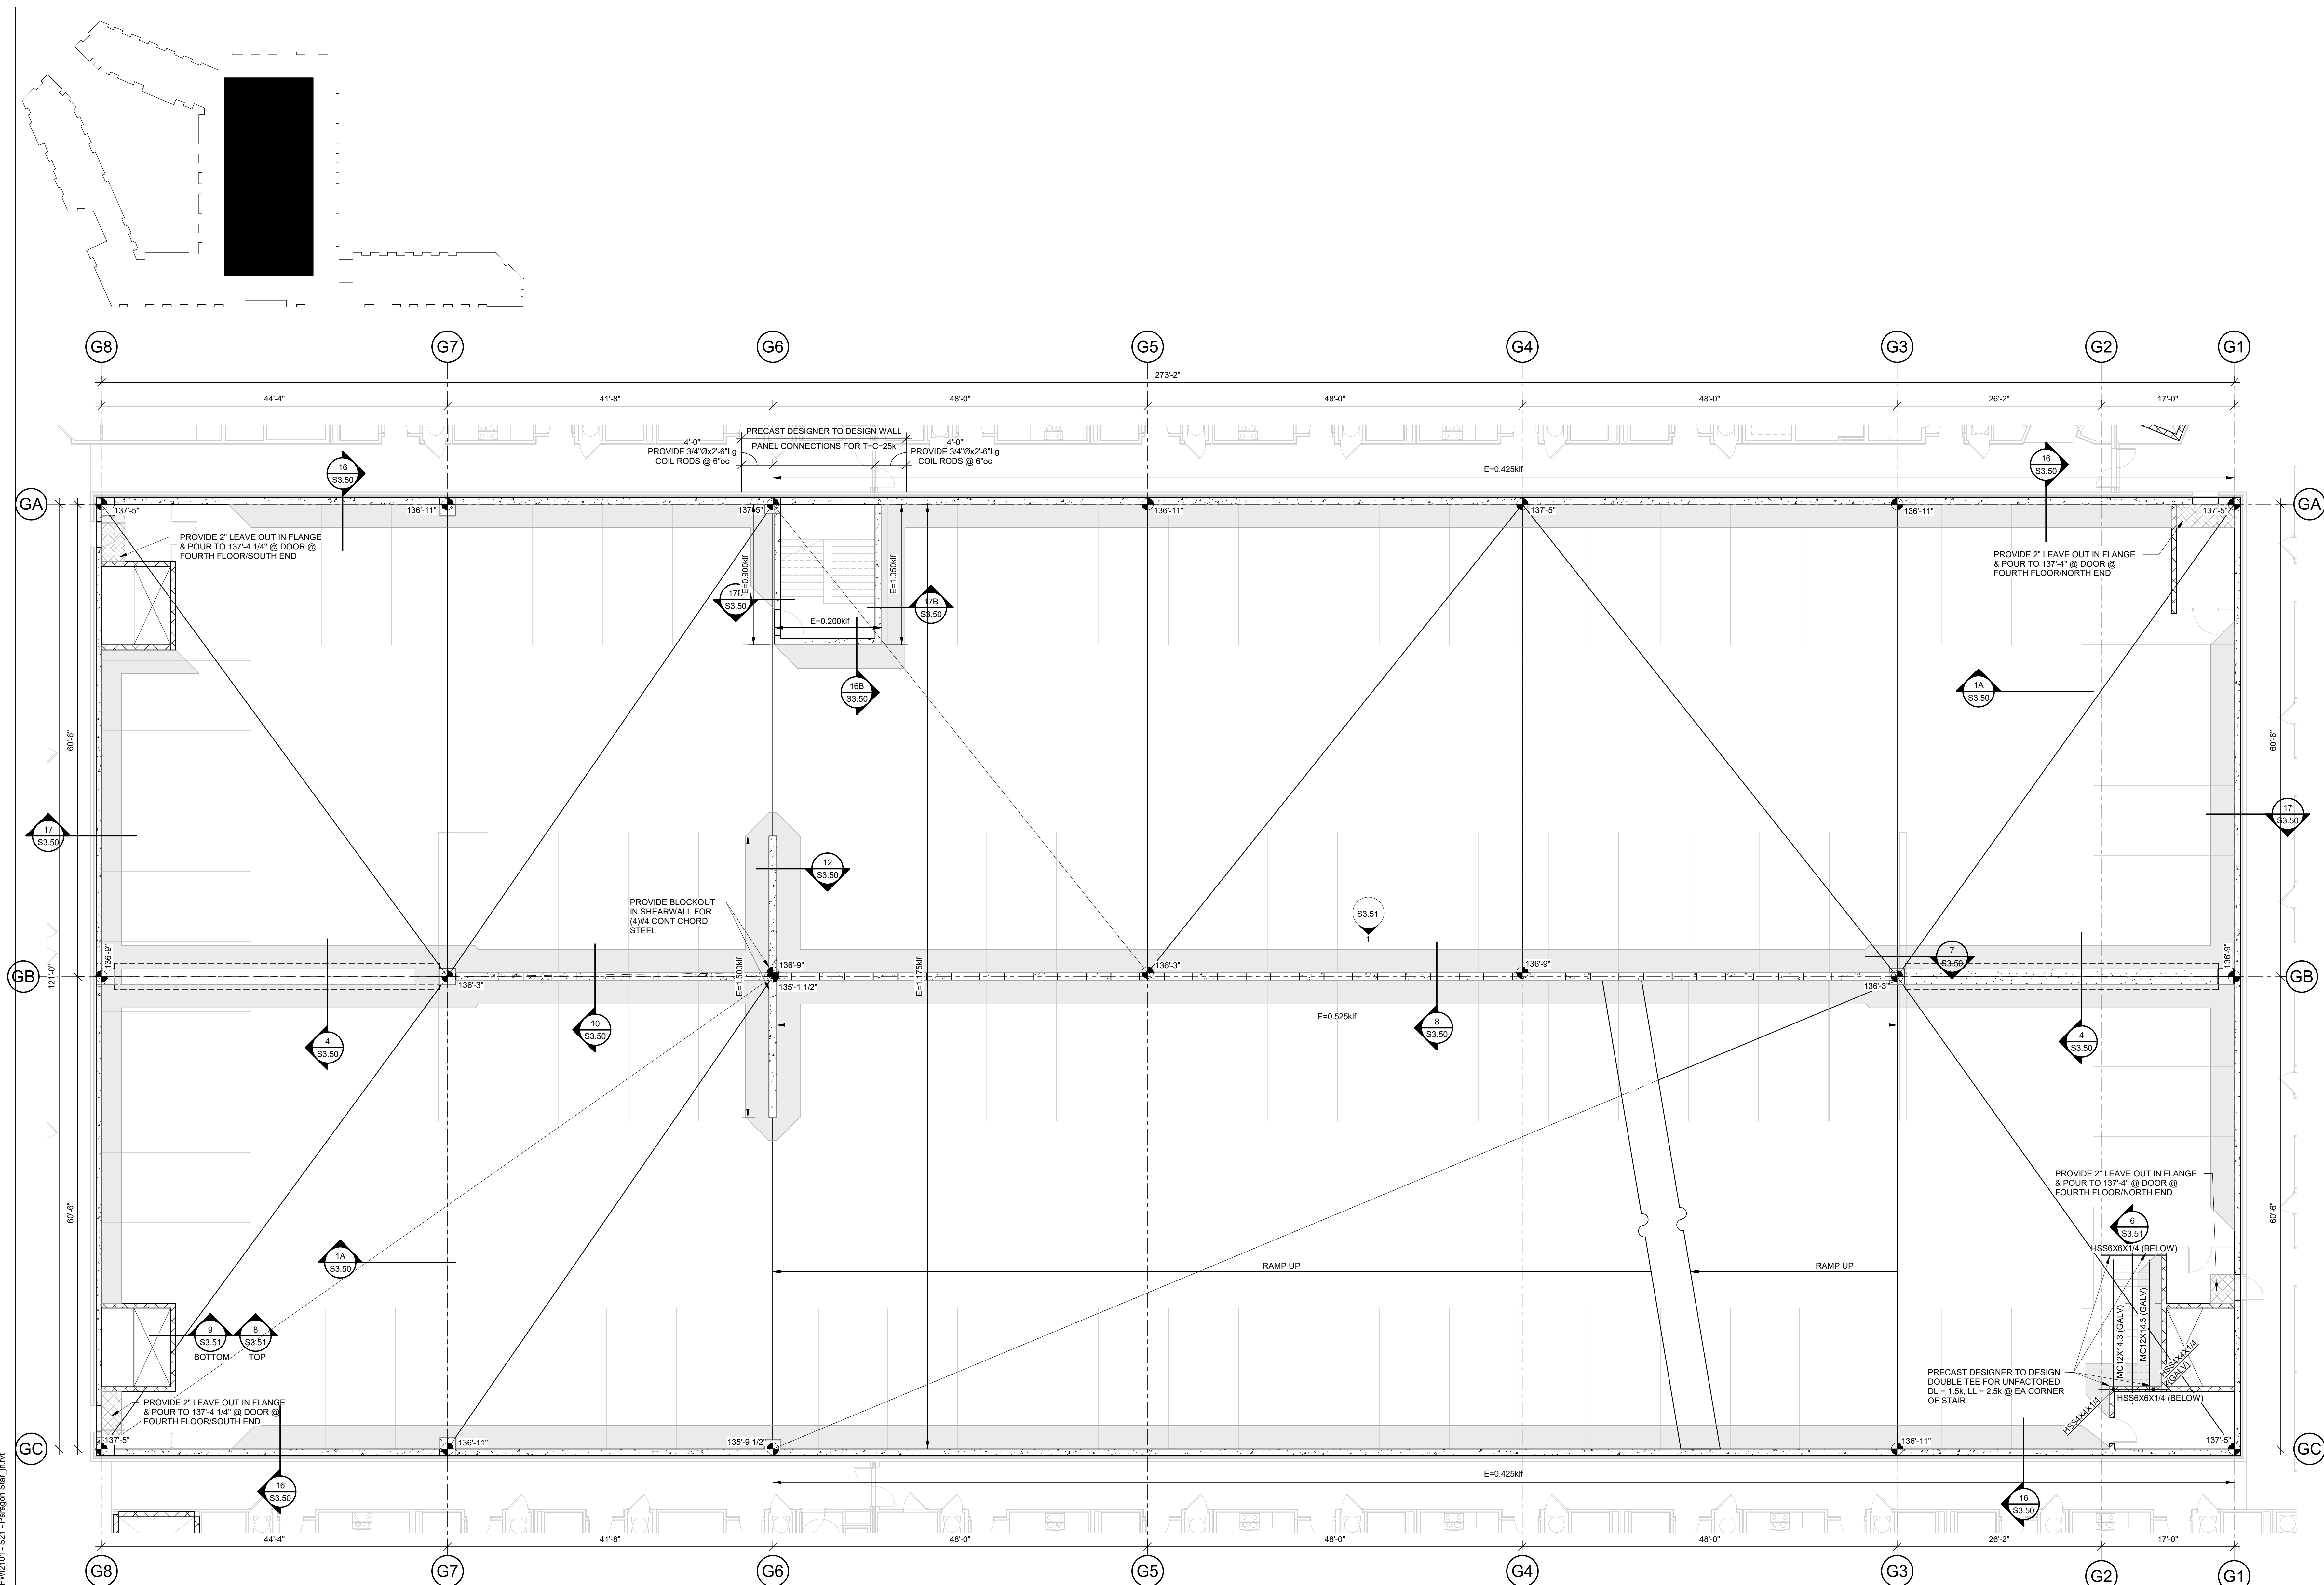
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SHEET TITLE

GARAGE FOURTH FLOOR FRAMING PLAN

SHEET NUMBER

S1.74G



N **1** **GARAGE FOURTH FLOOR FRAMING PLAN**
1/8" = 1'-0"

FRAMING NOTES - GARAGE:

1. REFER TO GENERAL NOTES ON SHEET 50.01.
2. REFER TO CIVIL AND ARCH DRAWINGS FOR SLAB ELEVATIONS.
3. REFER TO ARCHITECTURAL AND MECHANICAL DRAWINGS FOR LOCATIONS OF SPOT DRAINS.
4. REFER TO 33-50-SERIES DRAWINGS FOR TYPICAL GARAGE FRAMING DETAILS.
5. ELEVATIONS INDICATED ARE TO TOP OF PRECAST AND DO NOT INCLUDE THE WASH.
6. PROVIDE ALLOWANCE FOR 2" DROPS FROM DOORS FROM TOP OF PRECAST TO FINISH FLOOR ELEVATION OF THE APARTMENT. FEATHER WASH/TOPPING AT DOOR TO 1/4" MAX SLOPE.
7. PROVIDE ALLOWANCE OF 700psi DEAD LOAD IN PRECAST DESIGN AT ALL CMU WALLS SHOWN IN GARAGE.
8. TYPICAL PIPE PROTECTION PER SECTION 7/33.51

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ARCHITECTURE

CIVIL GBA ENGINEERS

LANDSCAPE LAND 3

STRUCTURAL BOB D. CAMPBELL


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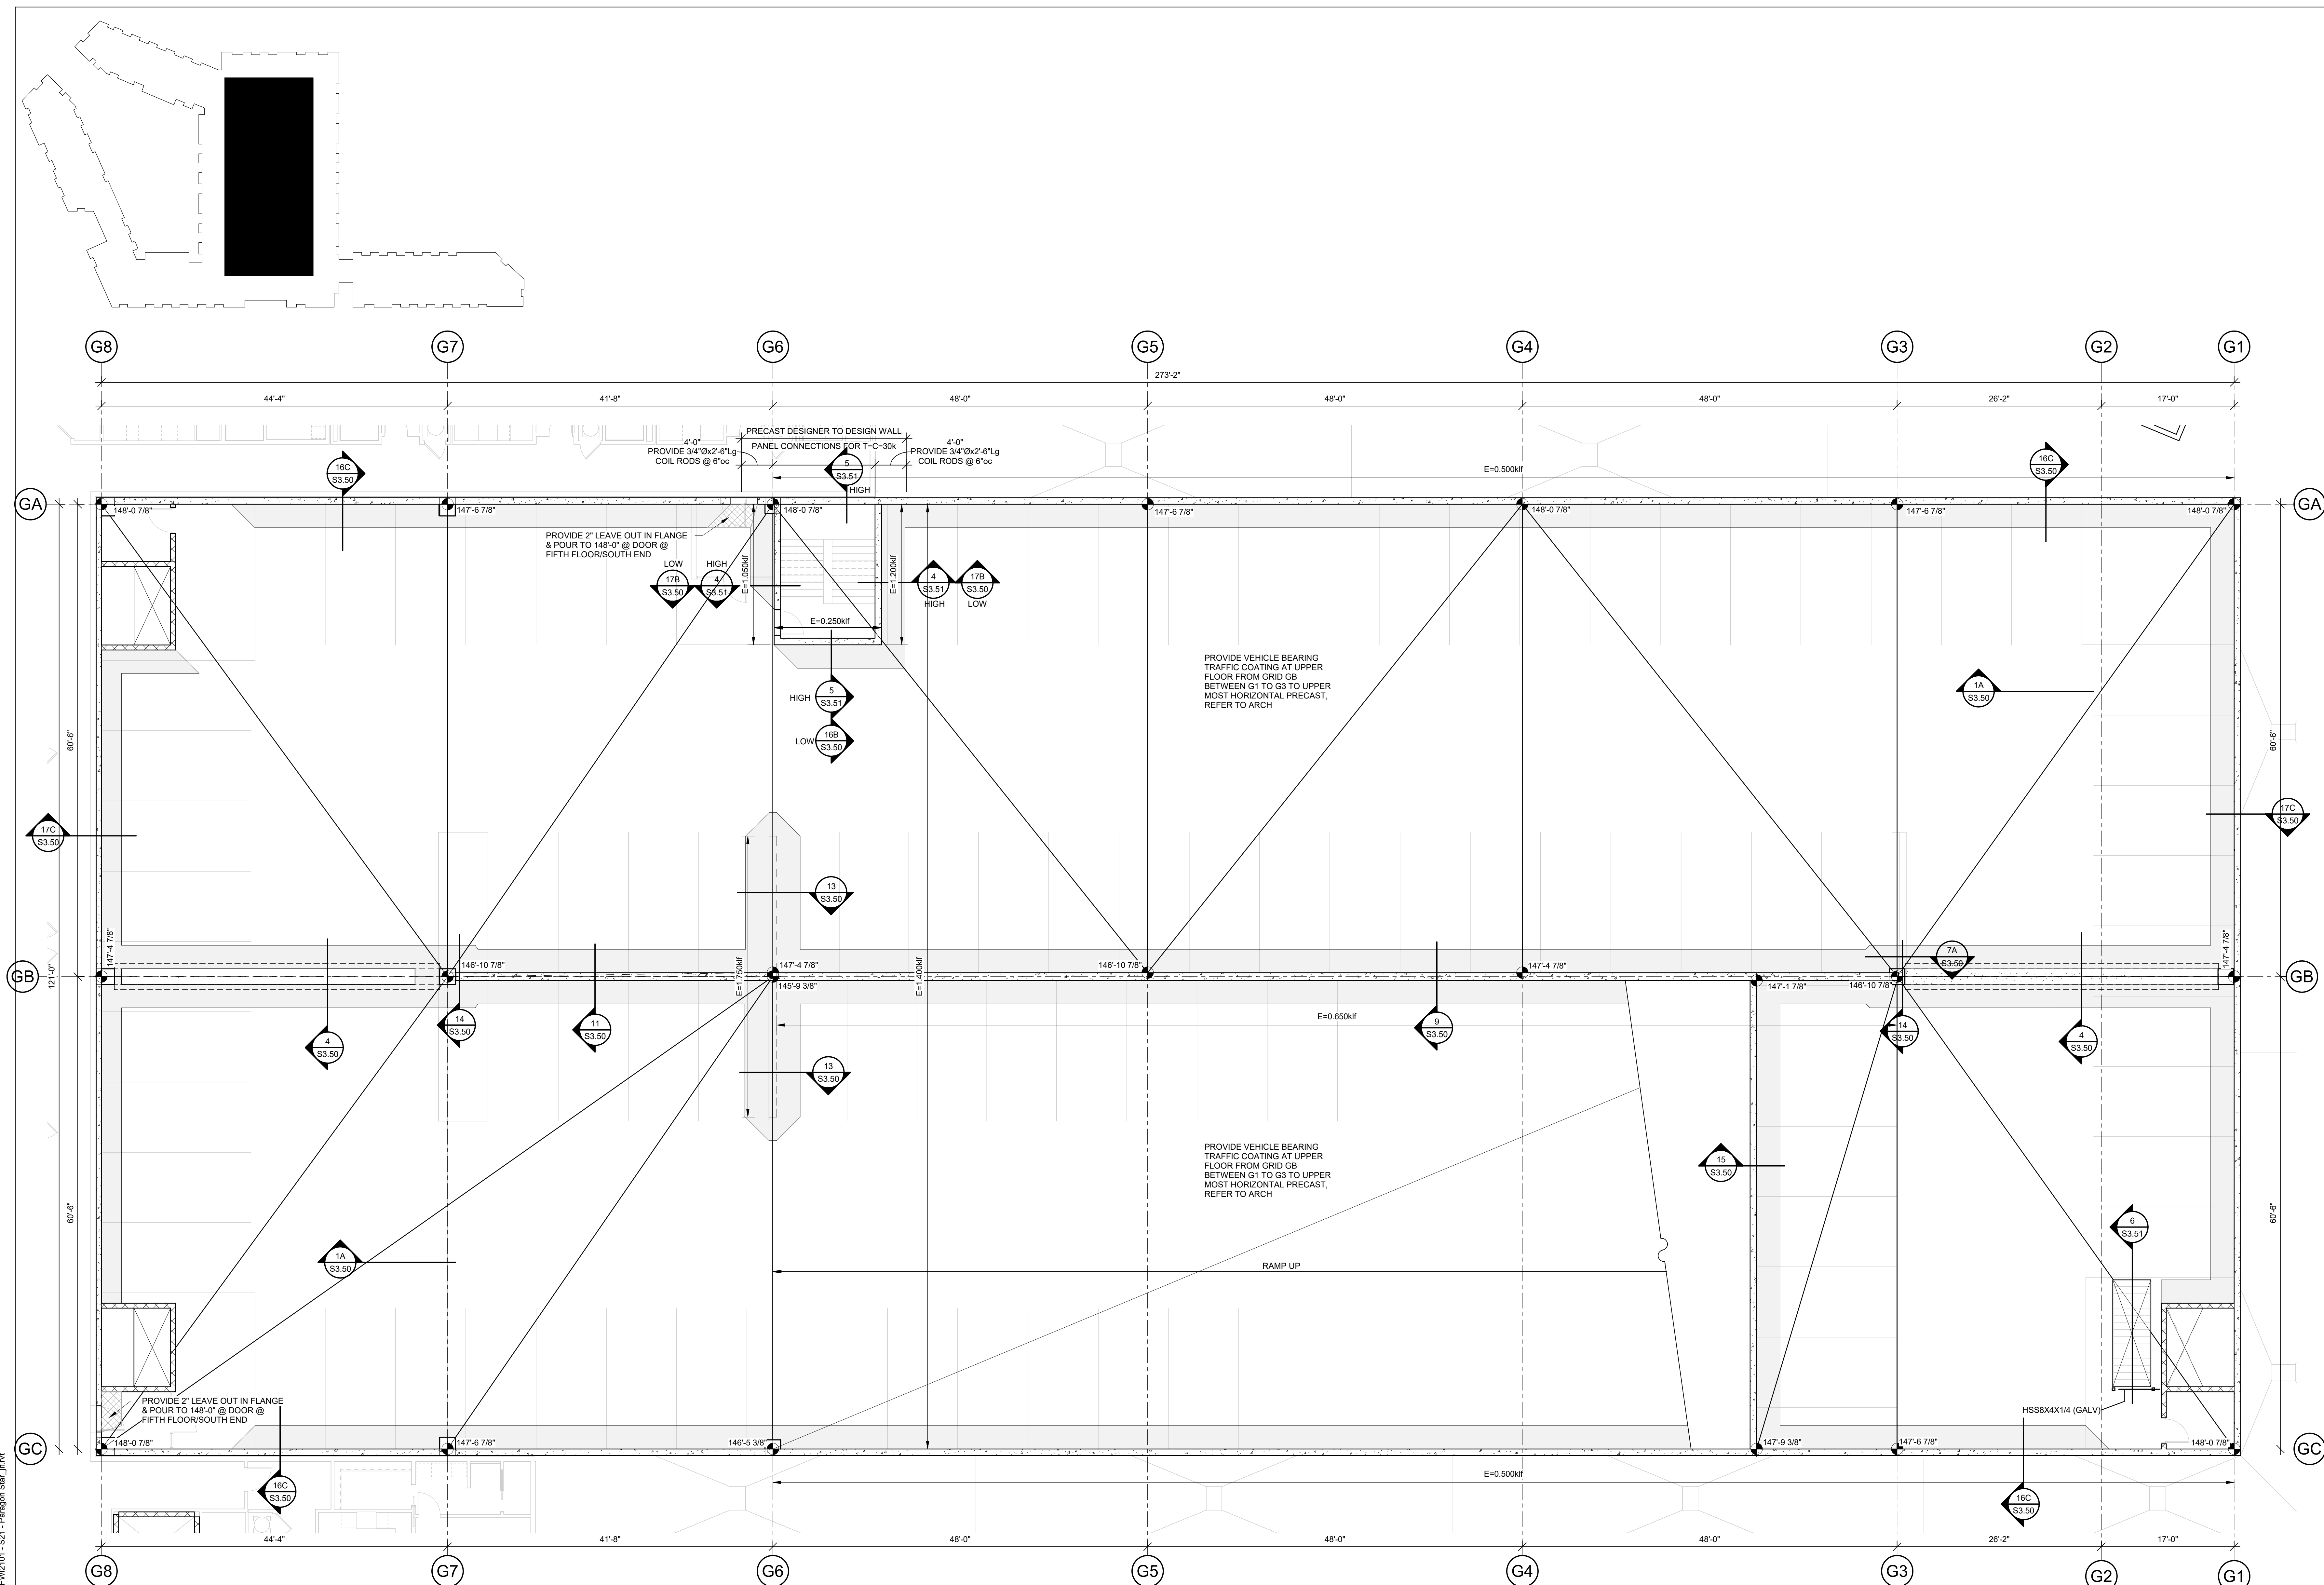
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SHEET TITLE

GARAGE FIFTH FLOOR FRAMING PLAN

SHEET NUMBER

S1.75G



N **1 GARAGE FIFTH FLOOR FRAMING PLAN**
1/8" = 1'-0"

FRAMING NOTES - GARAGE

1. REFER TO GENERAL NOTES ON SHEET 00.01.
2. REFER TO CIVIL AND ARCH DRAWING FOR SLAB ELEVATIONS.
3. REFER TO ARCHITECTURAL AND MECHANICAL DRAWINGS FOR LOCATIONS OF SPOT DRAINS.
4. REFER TO \$3.50-SERIES DRAWINGS FOR TYPICAL GARAGE FRAMING DETAILS.
5. ELEVATIONS INDICATED ARE TO TOP OF PRECAST AND DO NOT INCLUDE THE WASH.
6. TOP OF SLAB ELEVATION AT DOORS FROM GARAGE TO APARTMENT SHALL EQUAL THE NOMINAL FLOOR ELEVATION OF THE APARTMENT. FEATHER WASH/TOPPING AT DOOR TO 1:48 MAX SLOPE.
7. PROVIDE ALLOWANCE OF 700psf DEAD LOAD IN PRECAST DESIGN AT ALL CMU WALLS SHOWN IN GARAGE.
8. TYPICAL PIPE PROTECTION PER SECTION 7/3.51.5

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
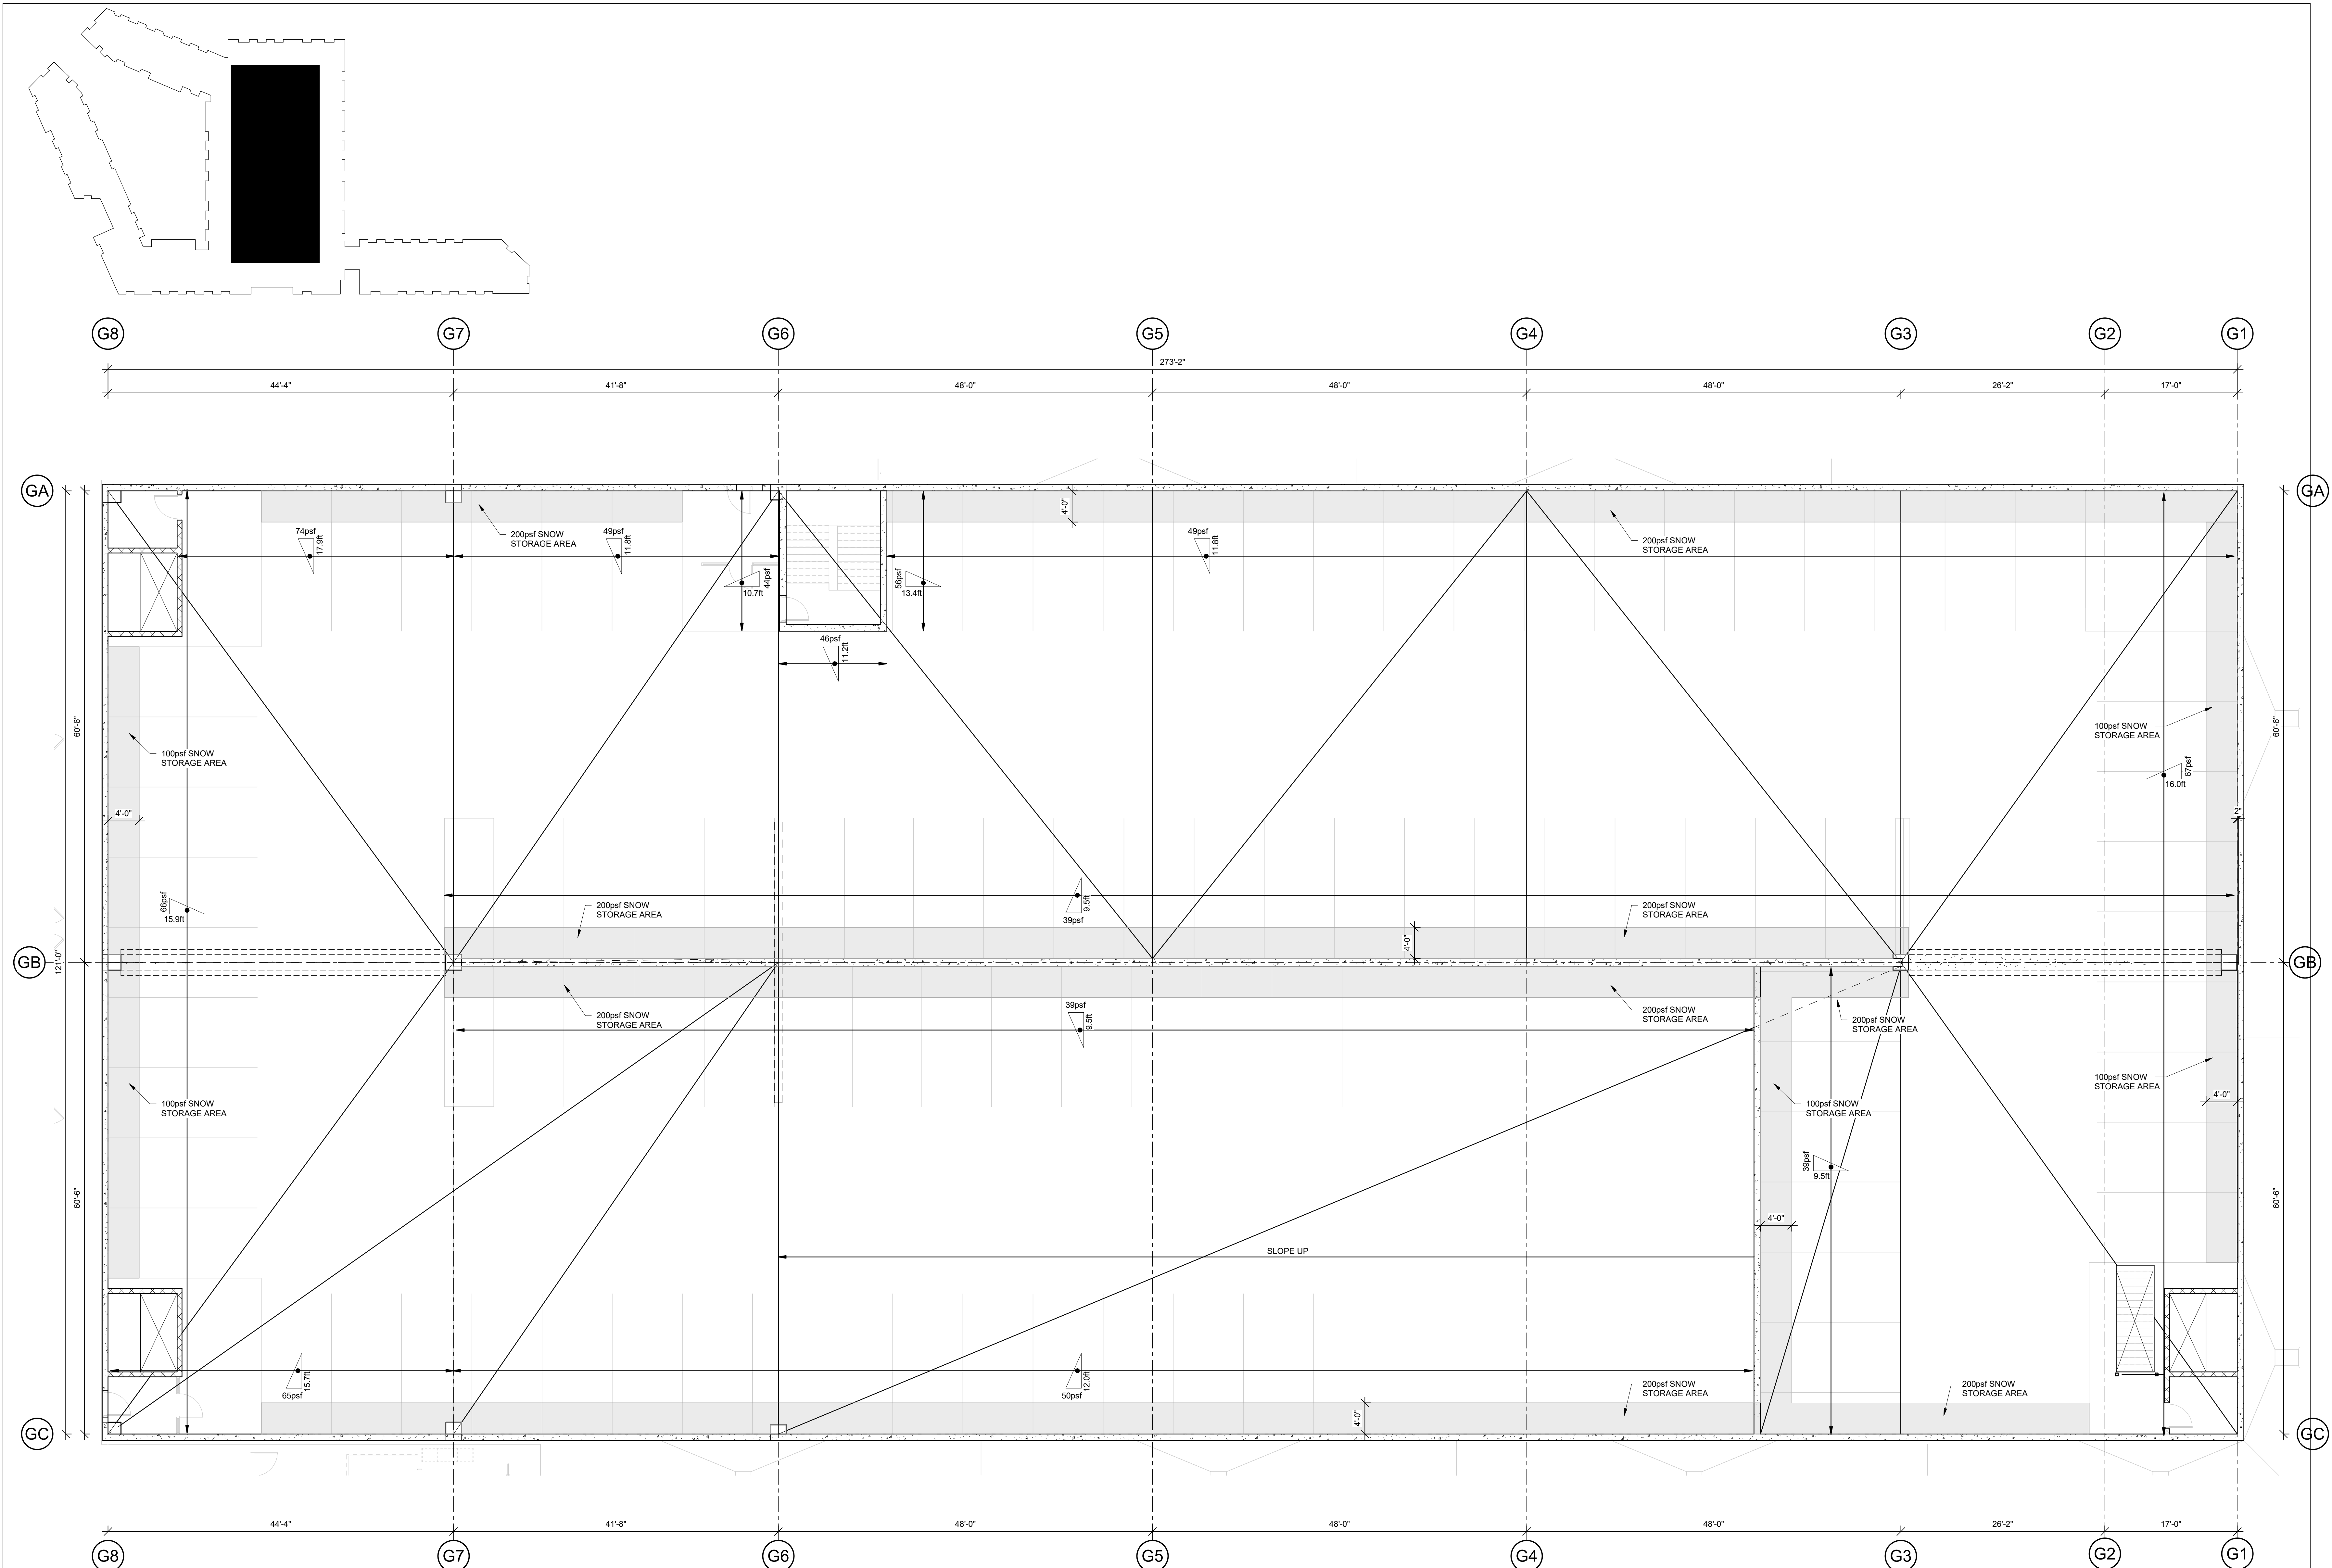
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SHEET TITLE

GARAGE SNOW LOADING PLAN

SHEET NUMBER

S1.76G



GARAGE SNOW LOADING PLAN AT TOP FLOOR

$$\frac{1}{8}'' = 1'-0''$$

- NOTES:**
1. SNOW STORAGE SHOWN IN HATCH IS ADDITIONAL TO SNOW DRIFT SHOWN WITH TRIANGULAR LOADING SYMBOL.
2. PROVIDE ALLOWANCE OF 700psf DEAD LOAD IN PRECAST DESIGN AT ALL CMU WALLS SHOWN IN GARAGE.

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MECHANICAL	LATIMER SOMMER
ELECTRICAL	LATIMER SOMMER
FIRE PROTECTION	LATIMER SOMMER
CONTRACTOR	BRINKMANN CONSTRUCTORS


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SHEET TITLE

TYPICAL FOUNDATION DETAILS

SHEET NUMBER

S3.00



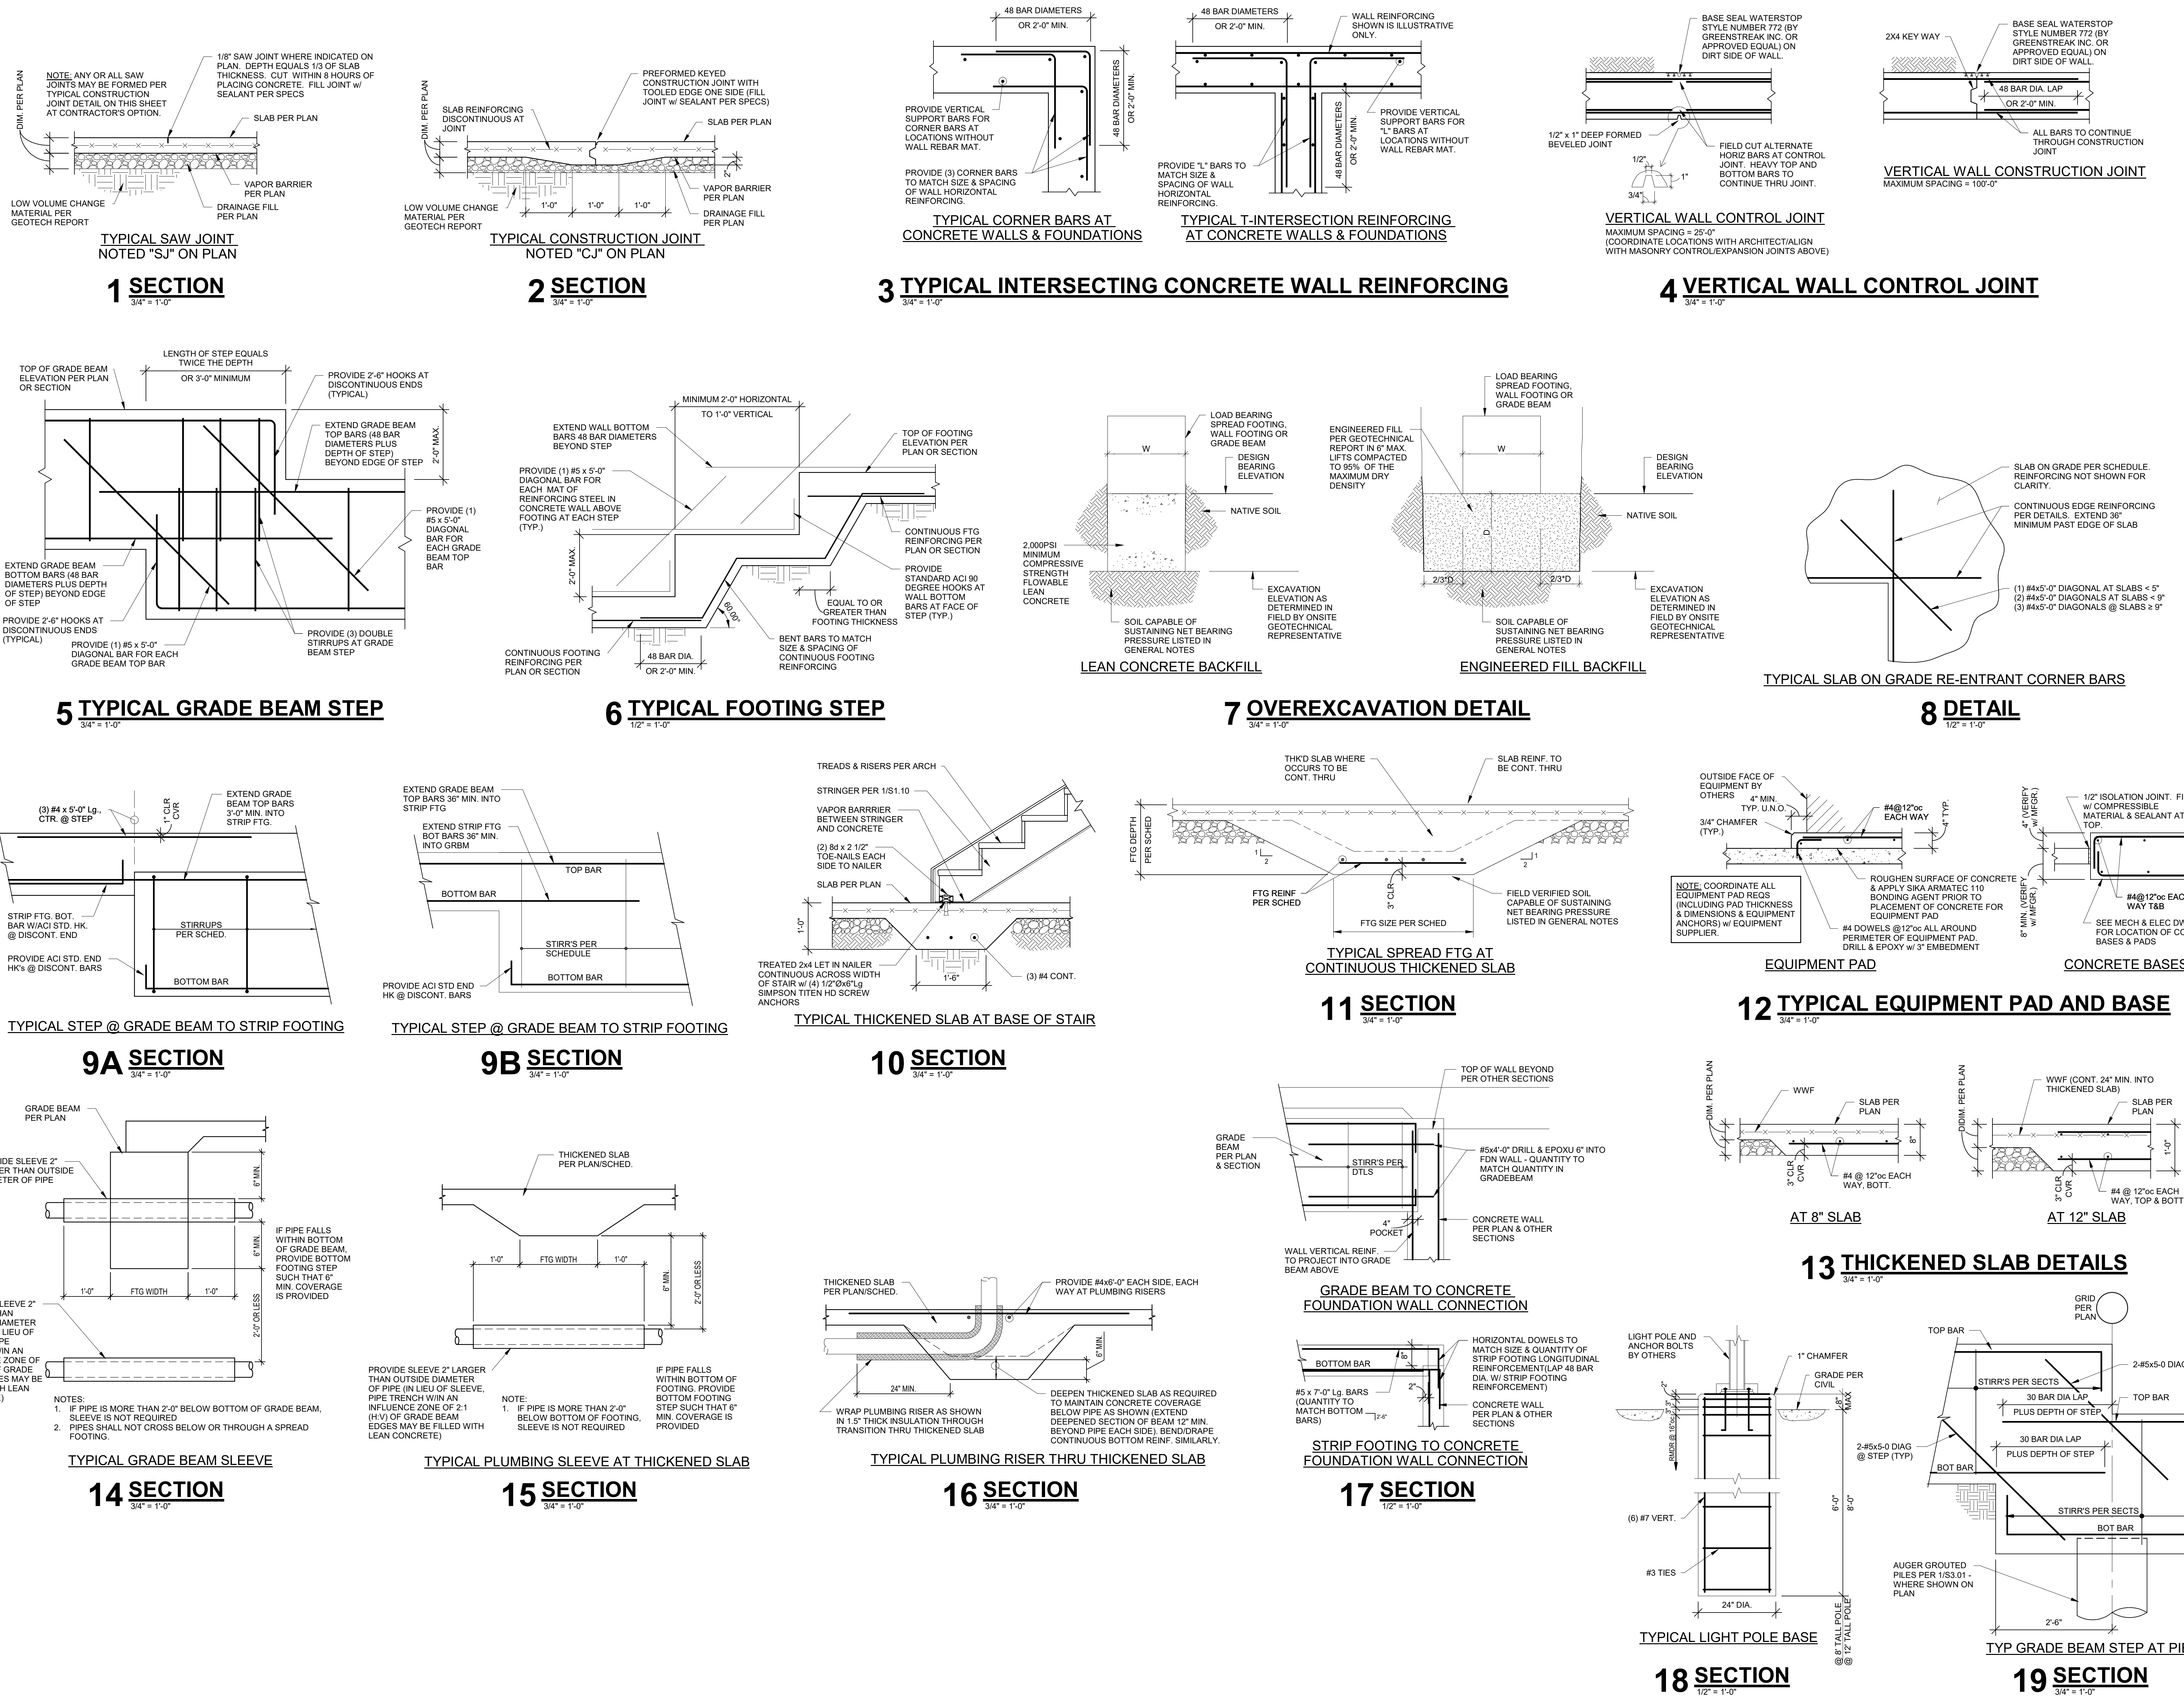

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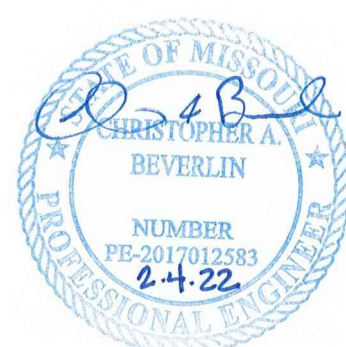
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REVISIONS

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STRUCTURAL	BOB D. CAMPBELL
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MECHANICAL	LATIMER SOMMER
ELECTRICAL	LATIMER SOMMER
FIRE PROTECTION	LATIMER SOMMER
CONTRACTOR	BRINKMANN CONSTRUCTORS


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SHEET TITLE

GARAGE FOUNDATION DETAILS

SHEET NUMBER

S3.01



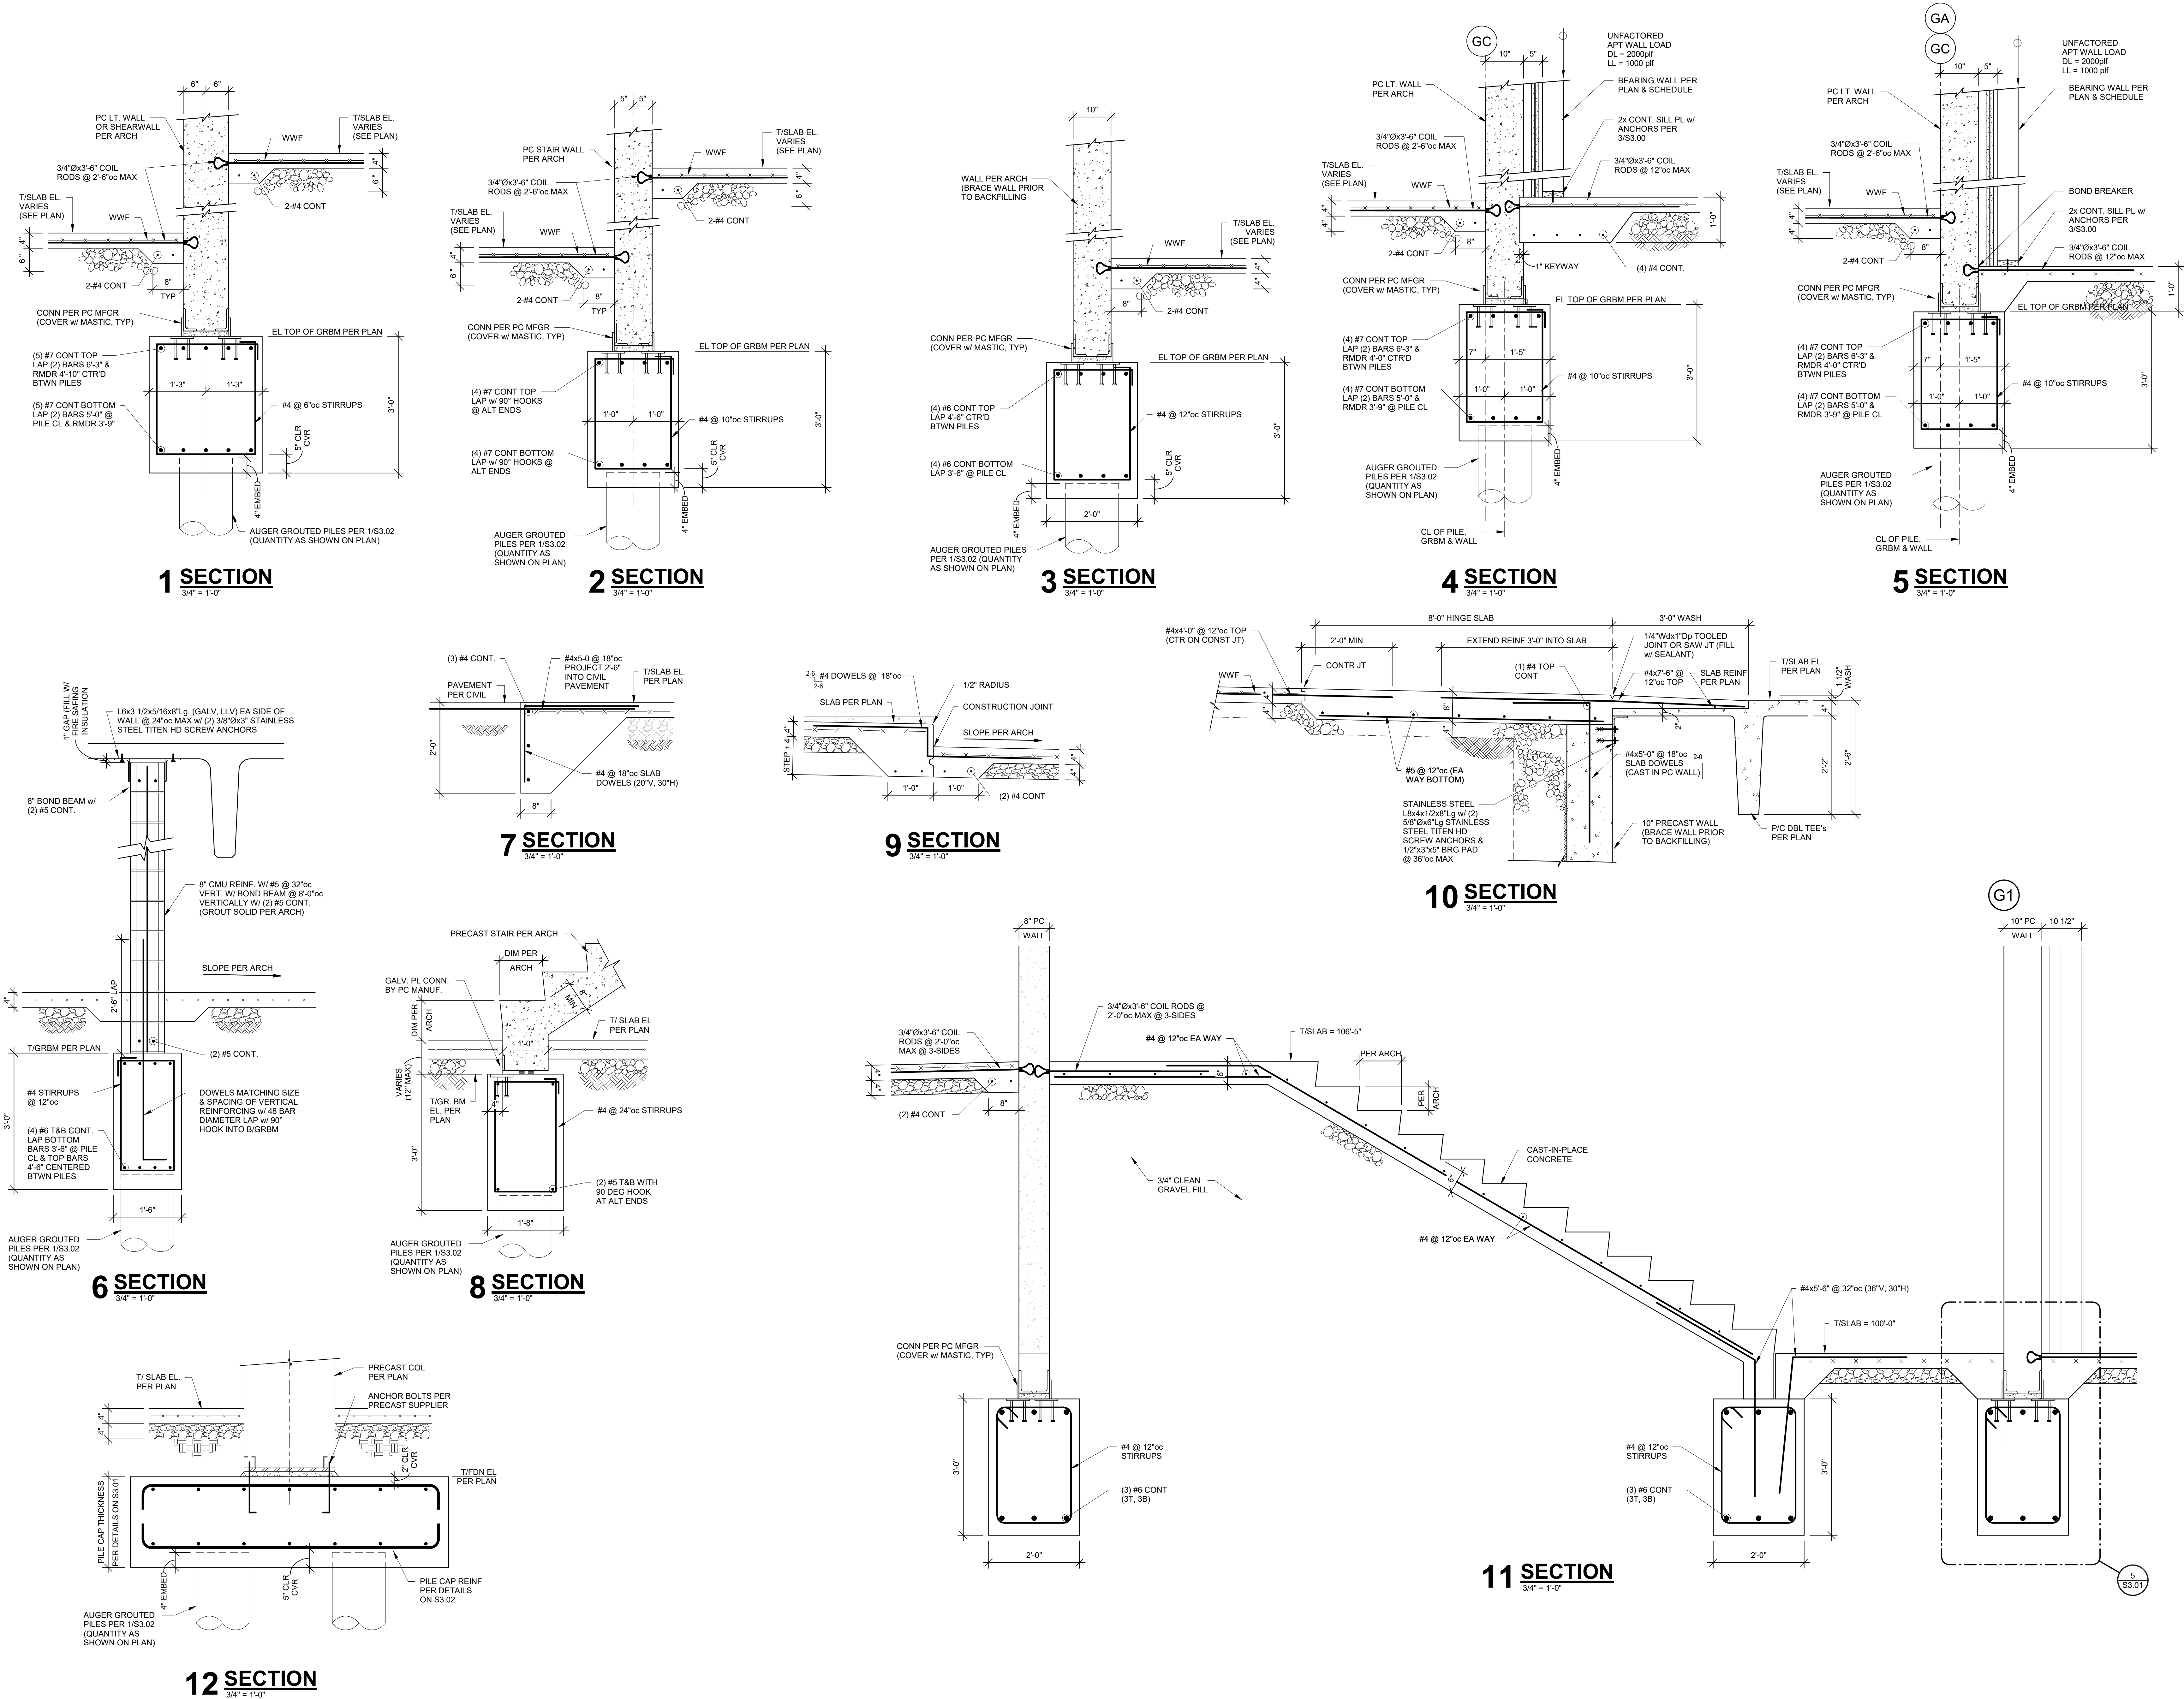

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STRUCTURAL	BOB D. CAMPBELL
PLUMBING	LATIMER SOMMERS
MECHANICAL	LATIMER SOMMERS
ELECTRICAL	LATIMER SOMMERS
FIRE PROTECTION	LATIMER SOMMERS
CONTRACTOR	BRINKMANN CONSTRUCTORS



BOB D. CAMPBELL & CO.
Structural Engineers Since 1957
4338 Belleview Ave.
Kansas City, MO 64111 816.531.4144
www.bdc-engineers.com

SHEET TITLE

PILE & PODIUM FOUNDATION DETAILS

SHEET NUMBER

S3.02

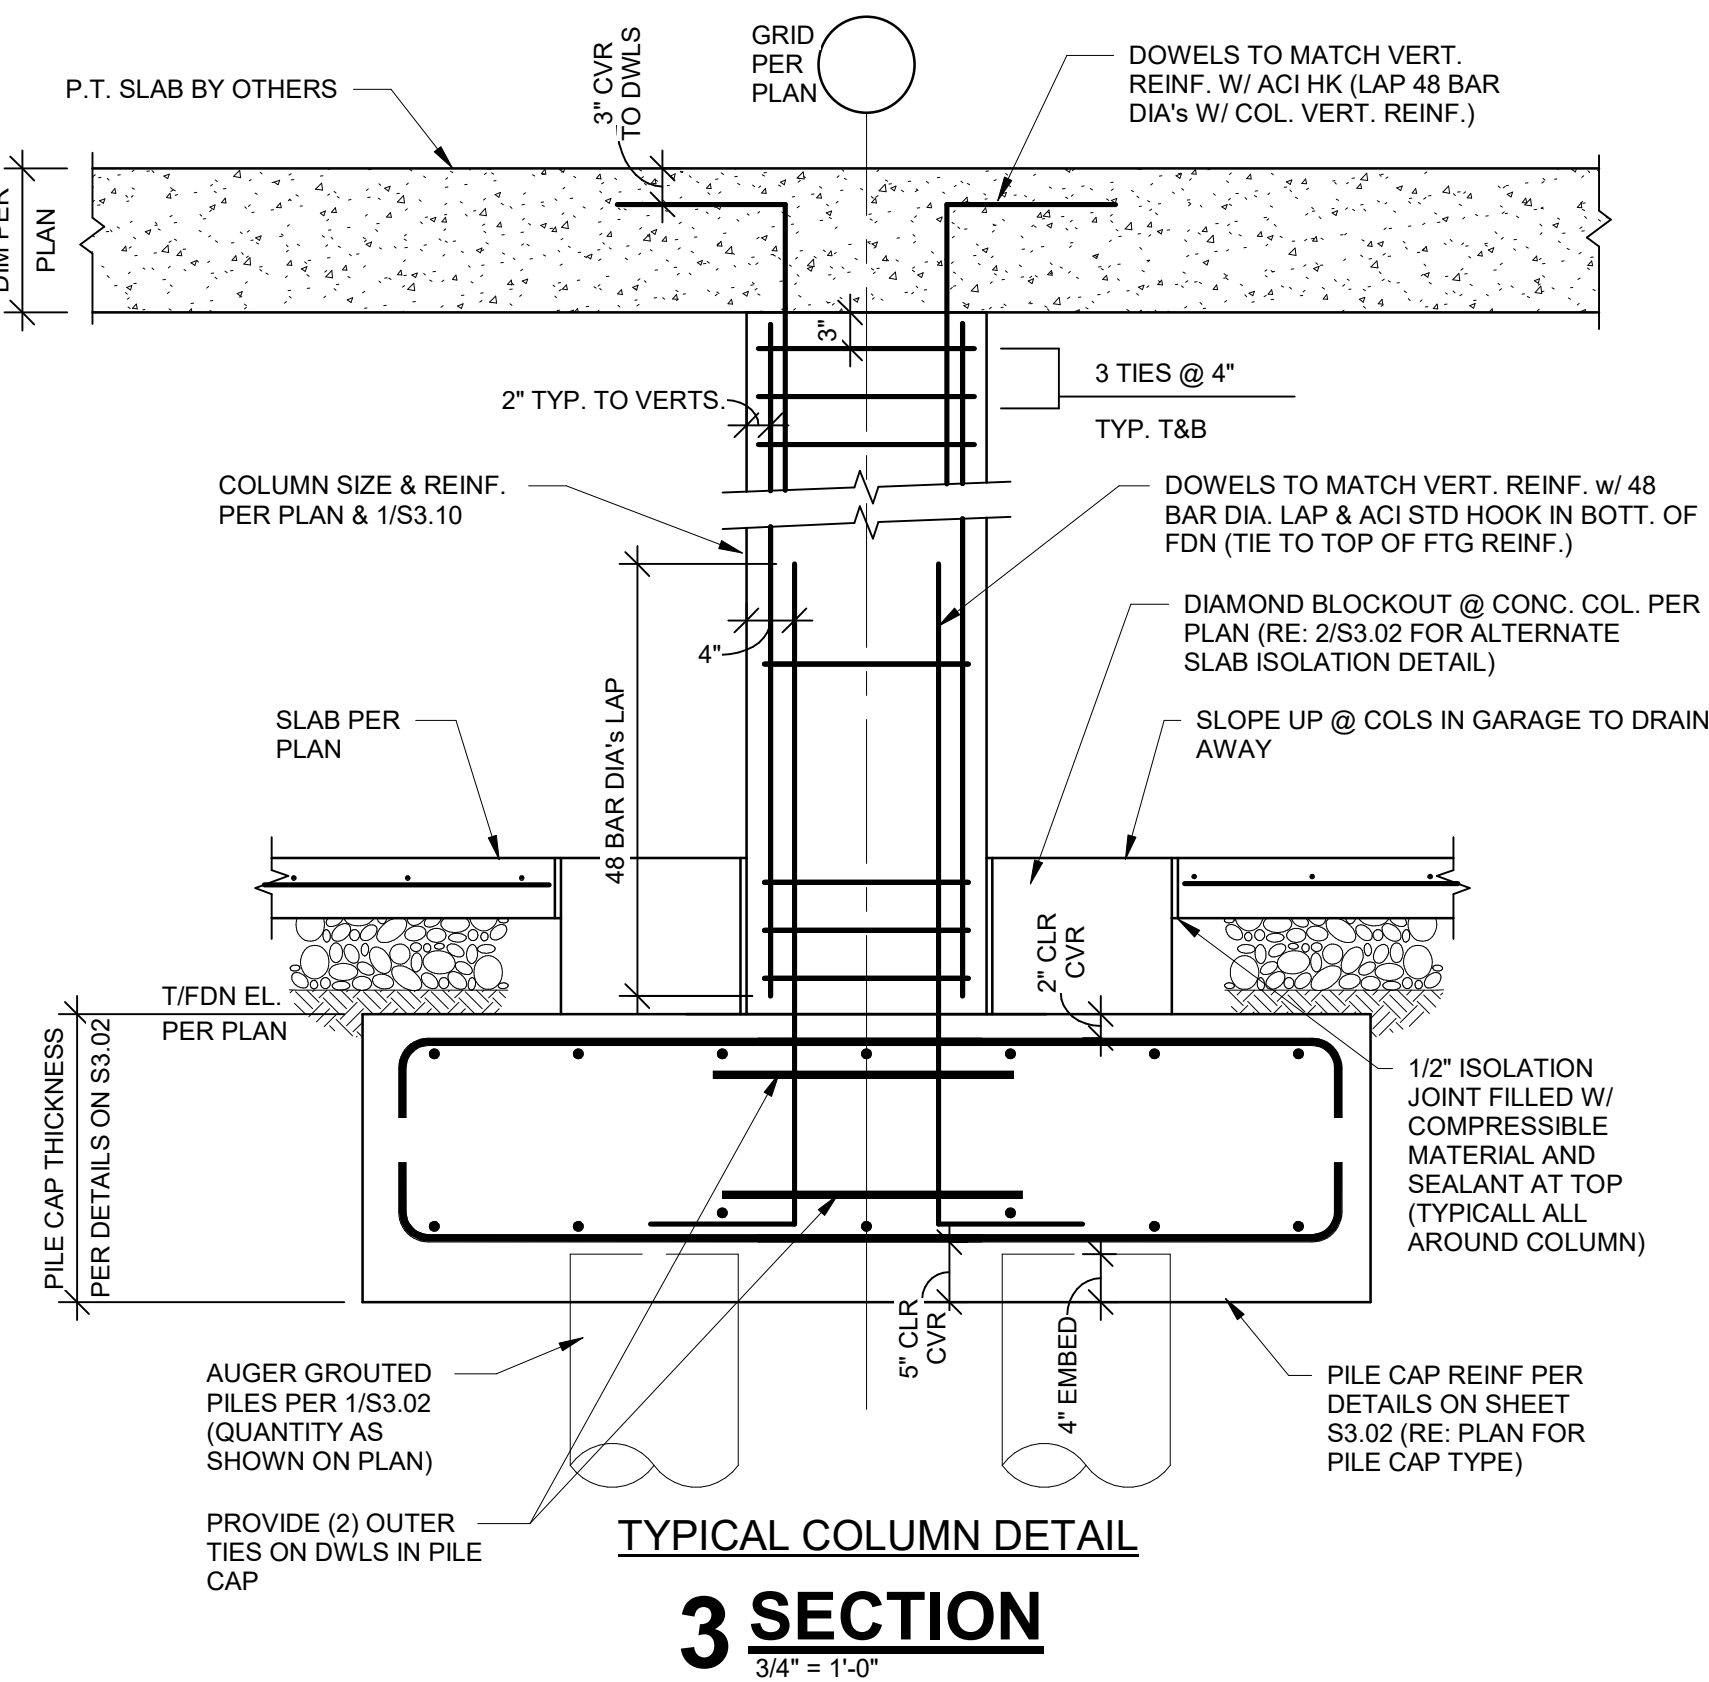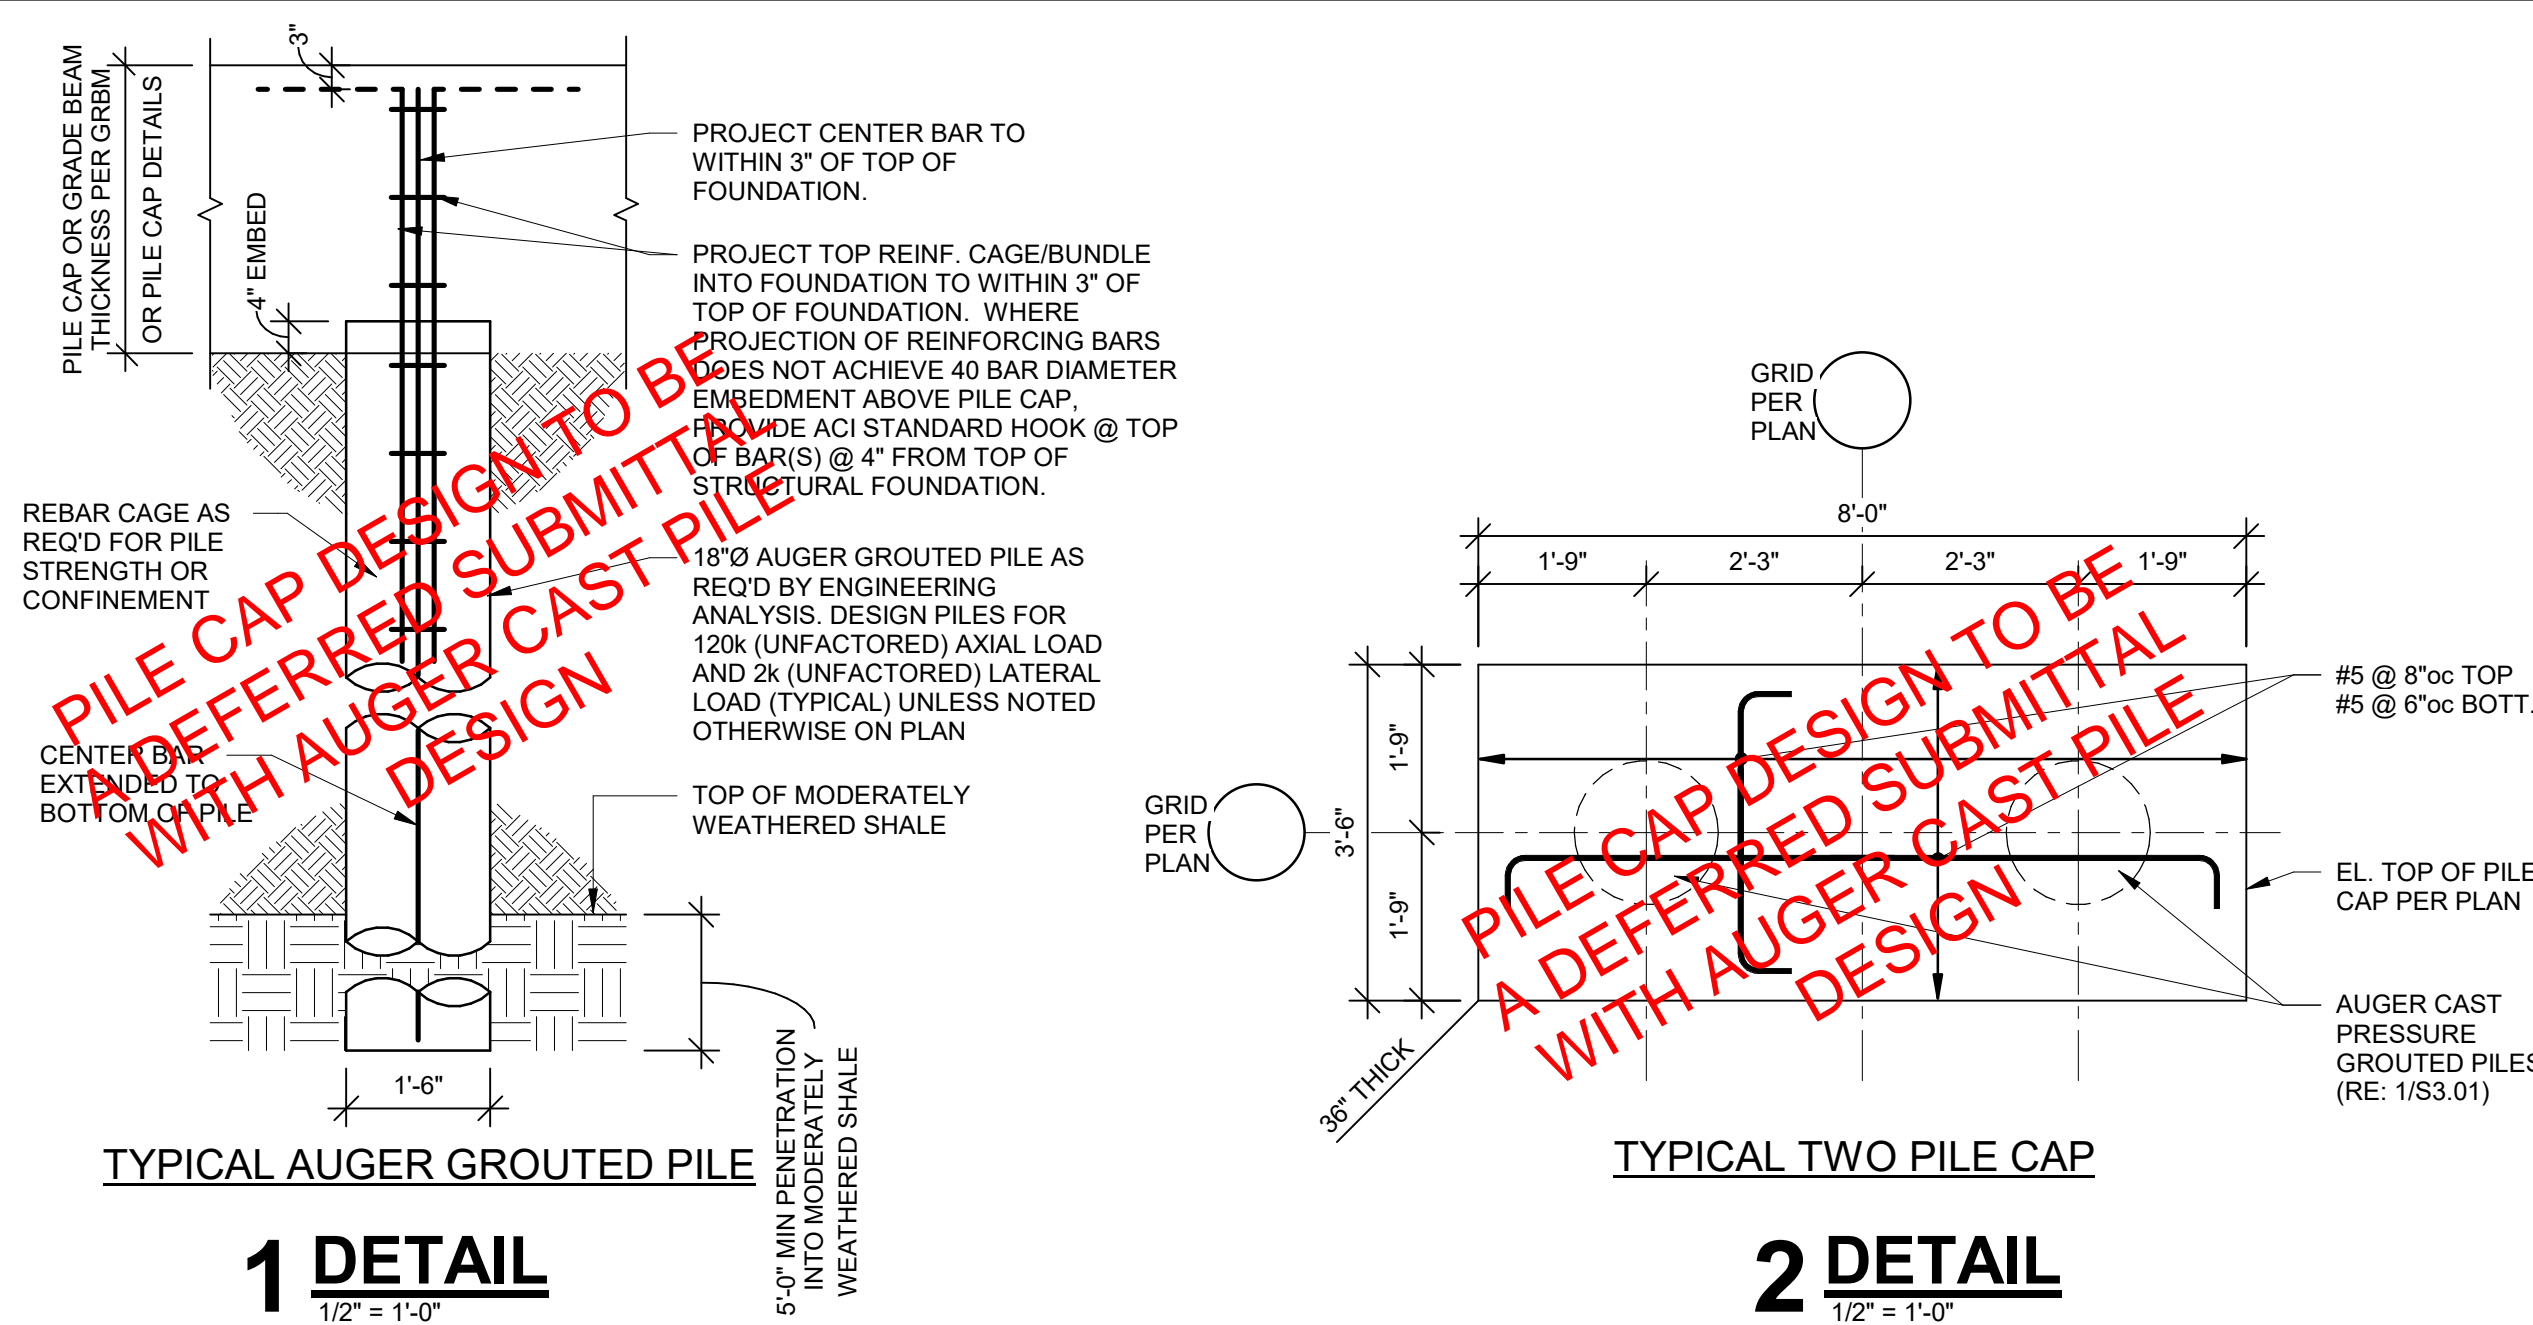

PILE CAP SCHEDULE		
ROCK BRG PRESSURE (PSF): 25000	CONCRETE (PSI): 5000	REBAR (KSI): 60
TYPE	FOOTING SIZE (FT.) THICKNESS (IN.)	OTOP OF BARS OTBWM BOTTOM
3.0	3'-0" x 3'-0" x 16"	(6) #4
3.5	3'-6" x 3'-6" x 18"	(8) #5
3.5A	3'-6" x 3'-6" x 18"	(7) #5 TOP & BOTTOM
4.0	4'-0" x 4'-0" x 20"	(7) #5
5.0	4'-6" x 5'-0" x 24"	(8) #4
6x3.3	6'-0" x 6'-0" x 42"	
8	8'-0" x 8'-0" x 42"	
12.5	12'-6" x 12'-6" x 48"	
17	17'-0" x 17'-0" x 54"	

NOTE:

- 1) EXTERIOR FOOTINGS OR FOOTING AT GRADE BEAM SHALL MATCH GRADE BEAM DEPTH AND BE PLACED WITH GRADE BEAM. PROVIDE SPECIFIED REBAR TOP AND BOTTOM WITH 4 STANDEES TO SUPPORT MATS.
- 2) PROVIDE #4 @ 12" o.c. EACH WAY IN TOP OF FTG. AT ALL MOMENT FRAMES AND AT BRG. BAY.
- 3) CENTER FOOTINGS ON COLUMNS AND/OR WALL CENTER LINES PER PLAN, UNLESS OTHERWISE NOTED.
- 4) PROVIDE ACI STANDARD HOOK AT EACH END OF BARS.



3200 NW PARAGON PKWY
LEE'S SUMMIT, MO 64081

Project No.: 18017,19050.07,19050.08

Date: 02.04.22

Issued For: GARAGE PERMIT

[illegible]

REGISTRATION



PROJECT TEAM

ARCHITECT	FINKLE+WILLIAMS ARCHITECTURE
CIVIL	GBA ENGINEERS
LANDSCAPE	LAND 3
STRUCTURAL	BOB D. CAMPBELL
PLUMBING	LATIMER SOMMER
MECHANICAL	LATIMER SOMMER
ELECTRICAL	LATIMER SOMMER
FIRE PROTECTION	LATIMER SOMMER
CONTRACTOR	BRINKMANN CONSTRUCTORS


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Kansas City, MO 64111 www.bdc-engrs.com

SHEET TITLE

PRECAST GARAGE FRAMING DETAILS


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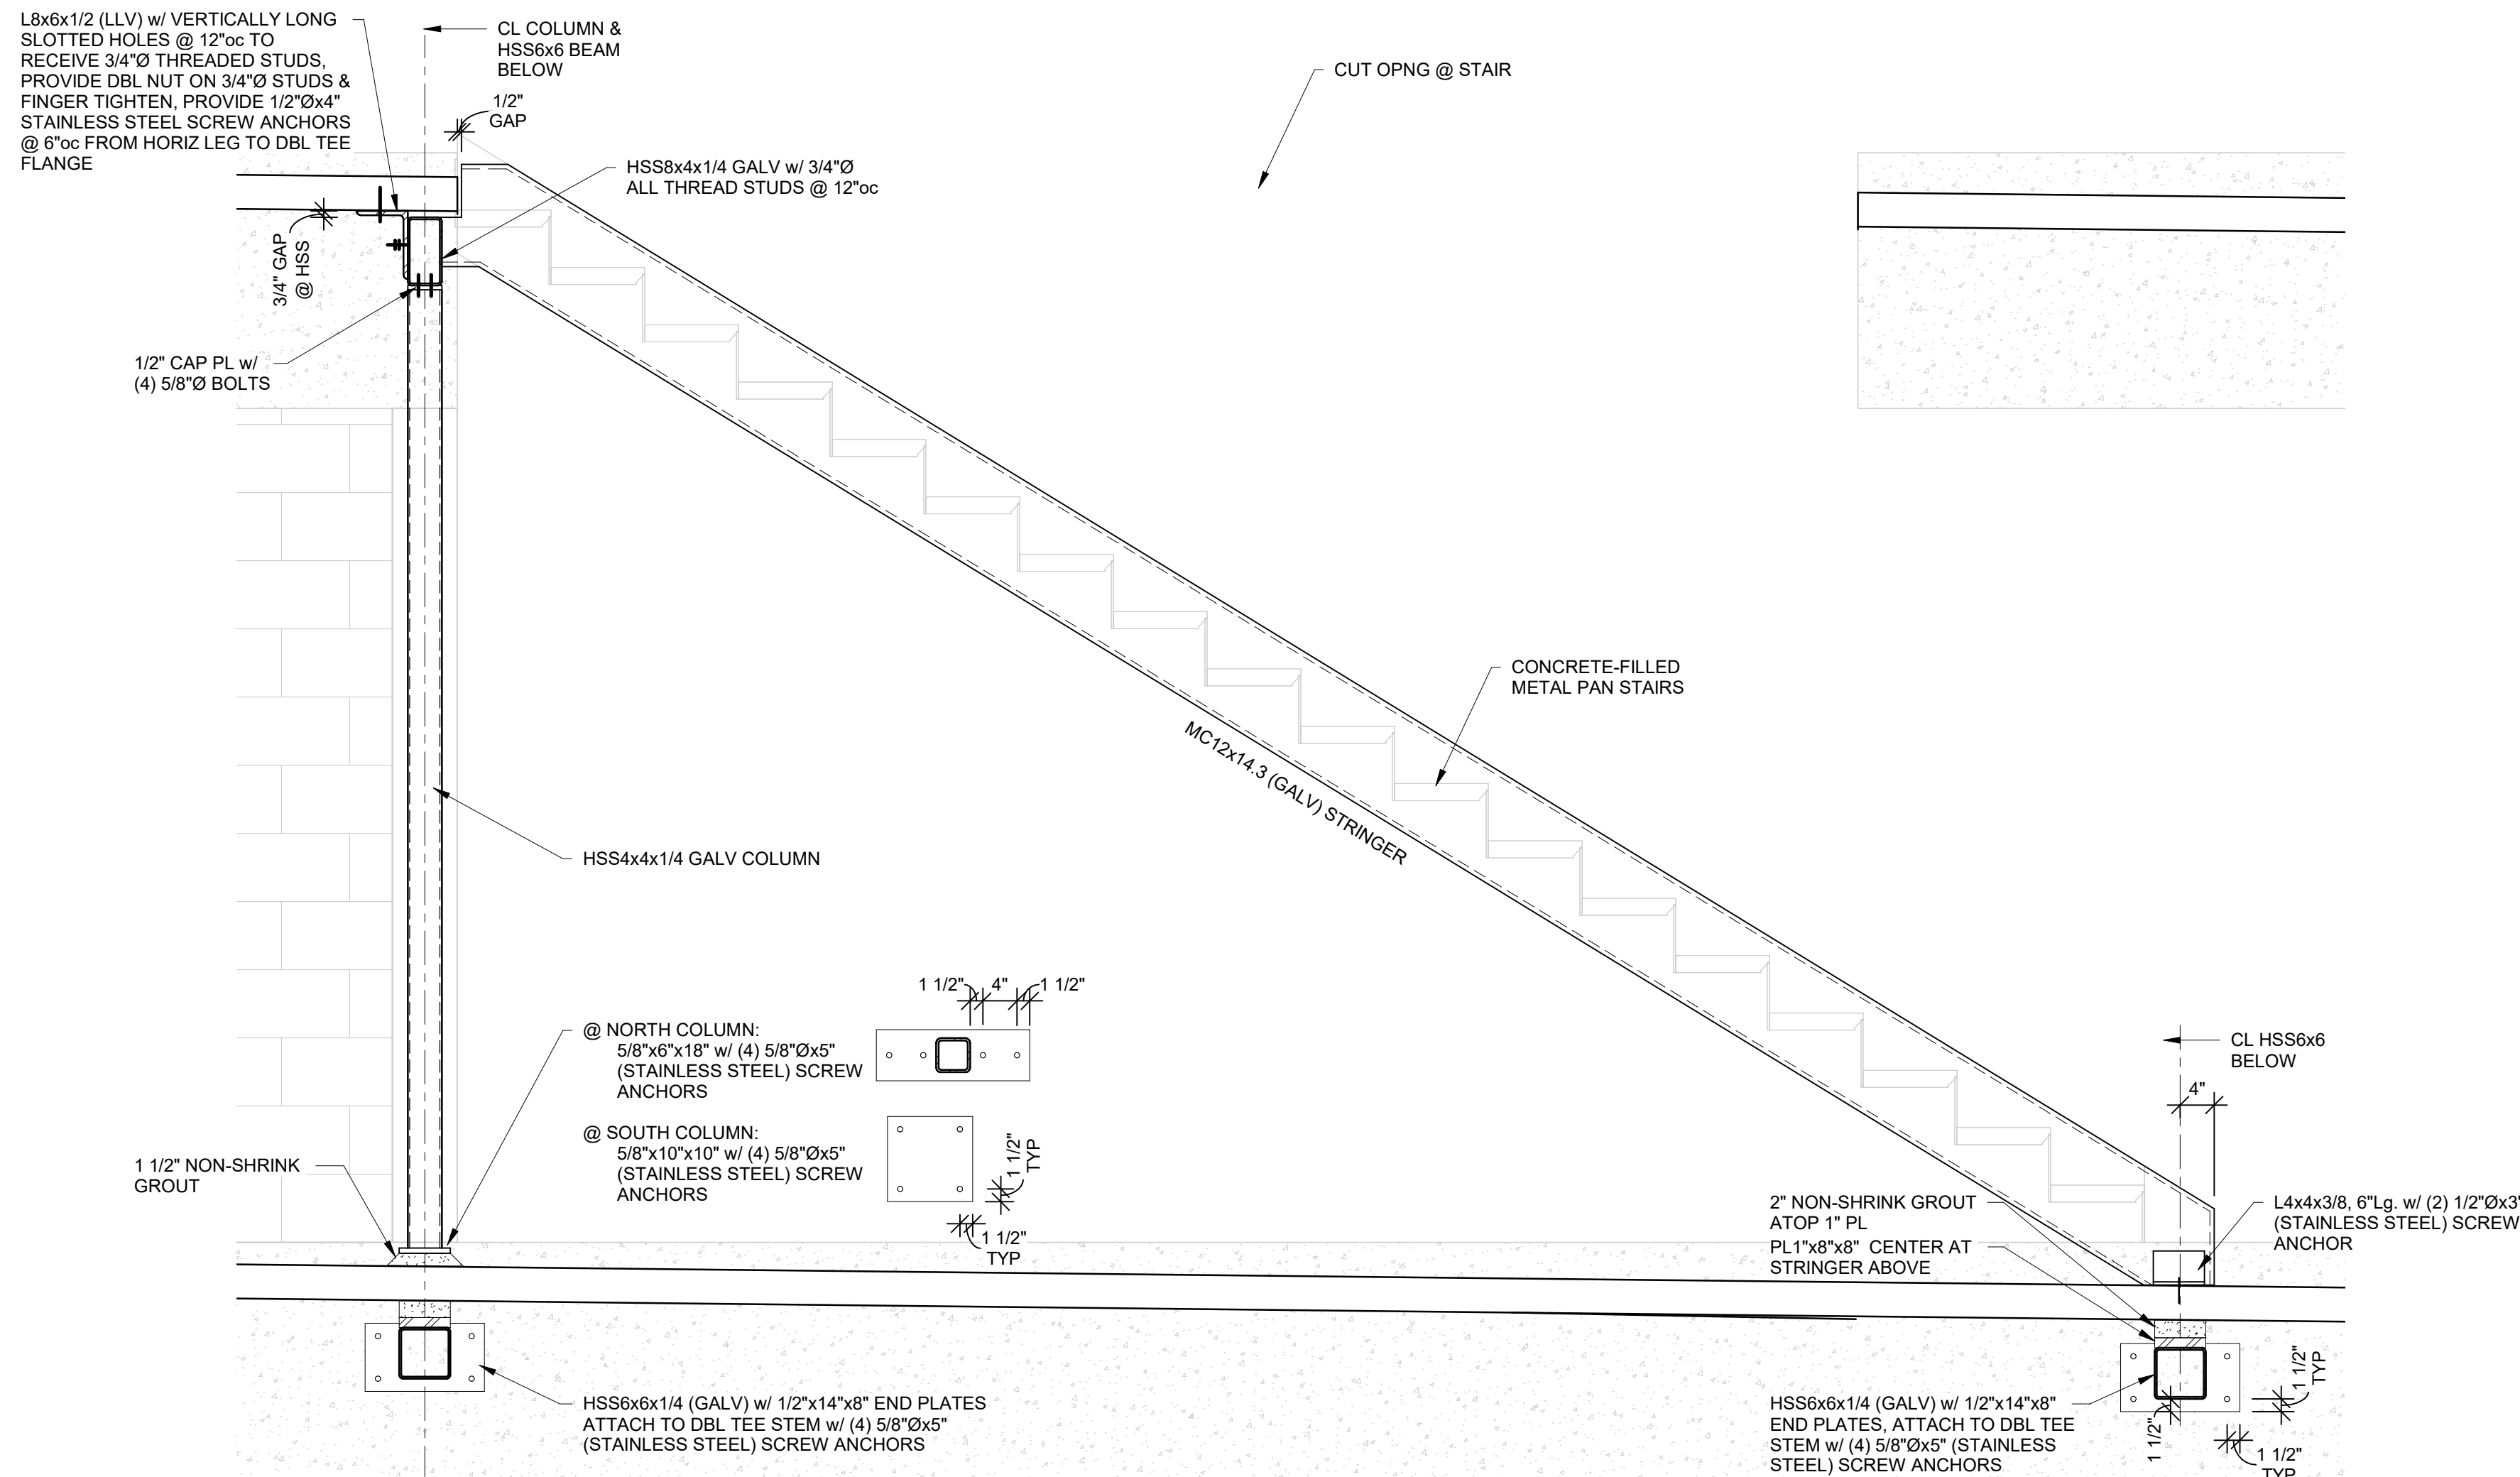
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TYP LT. WALL

1 ELEVATION

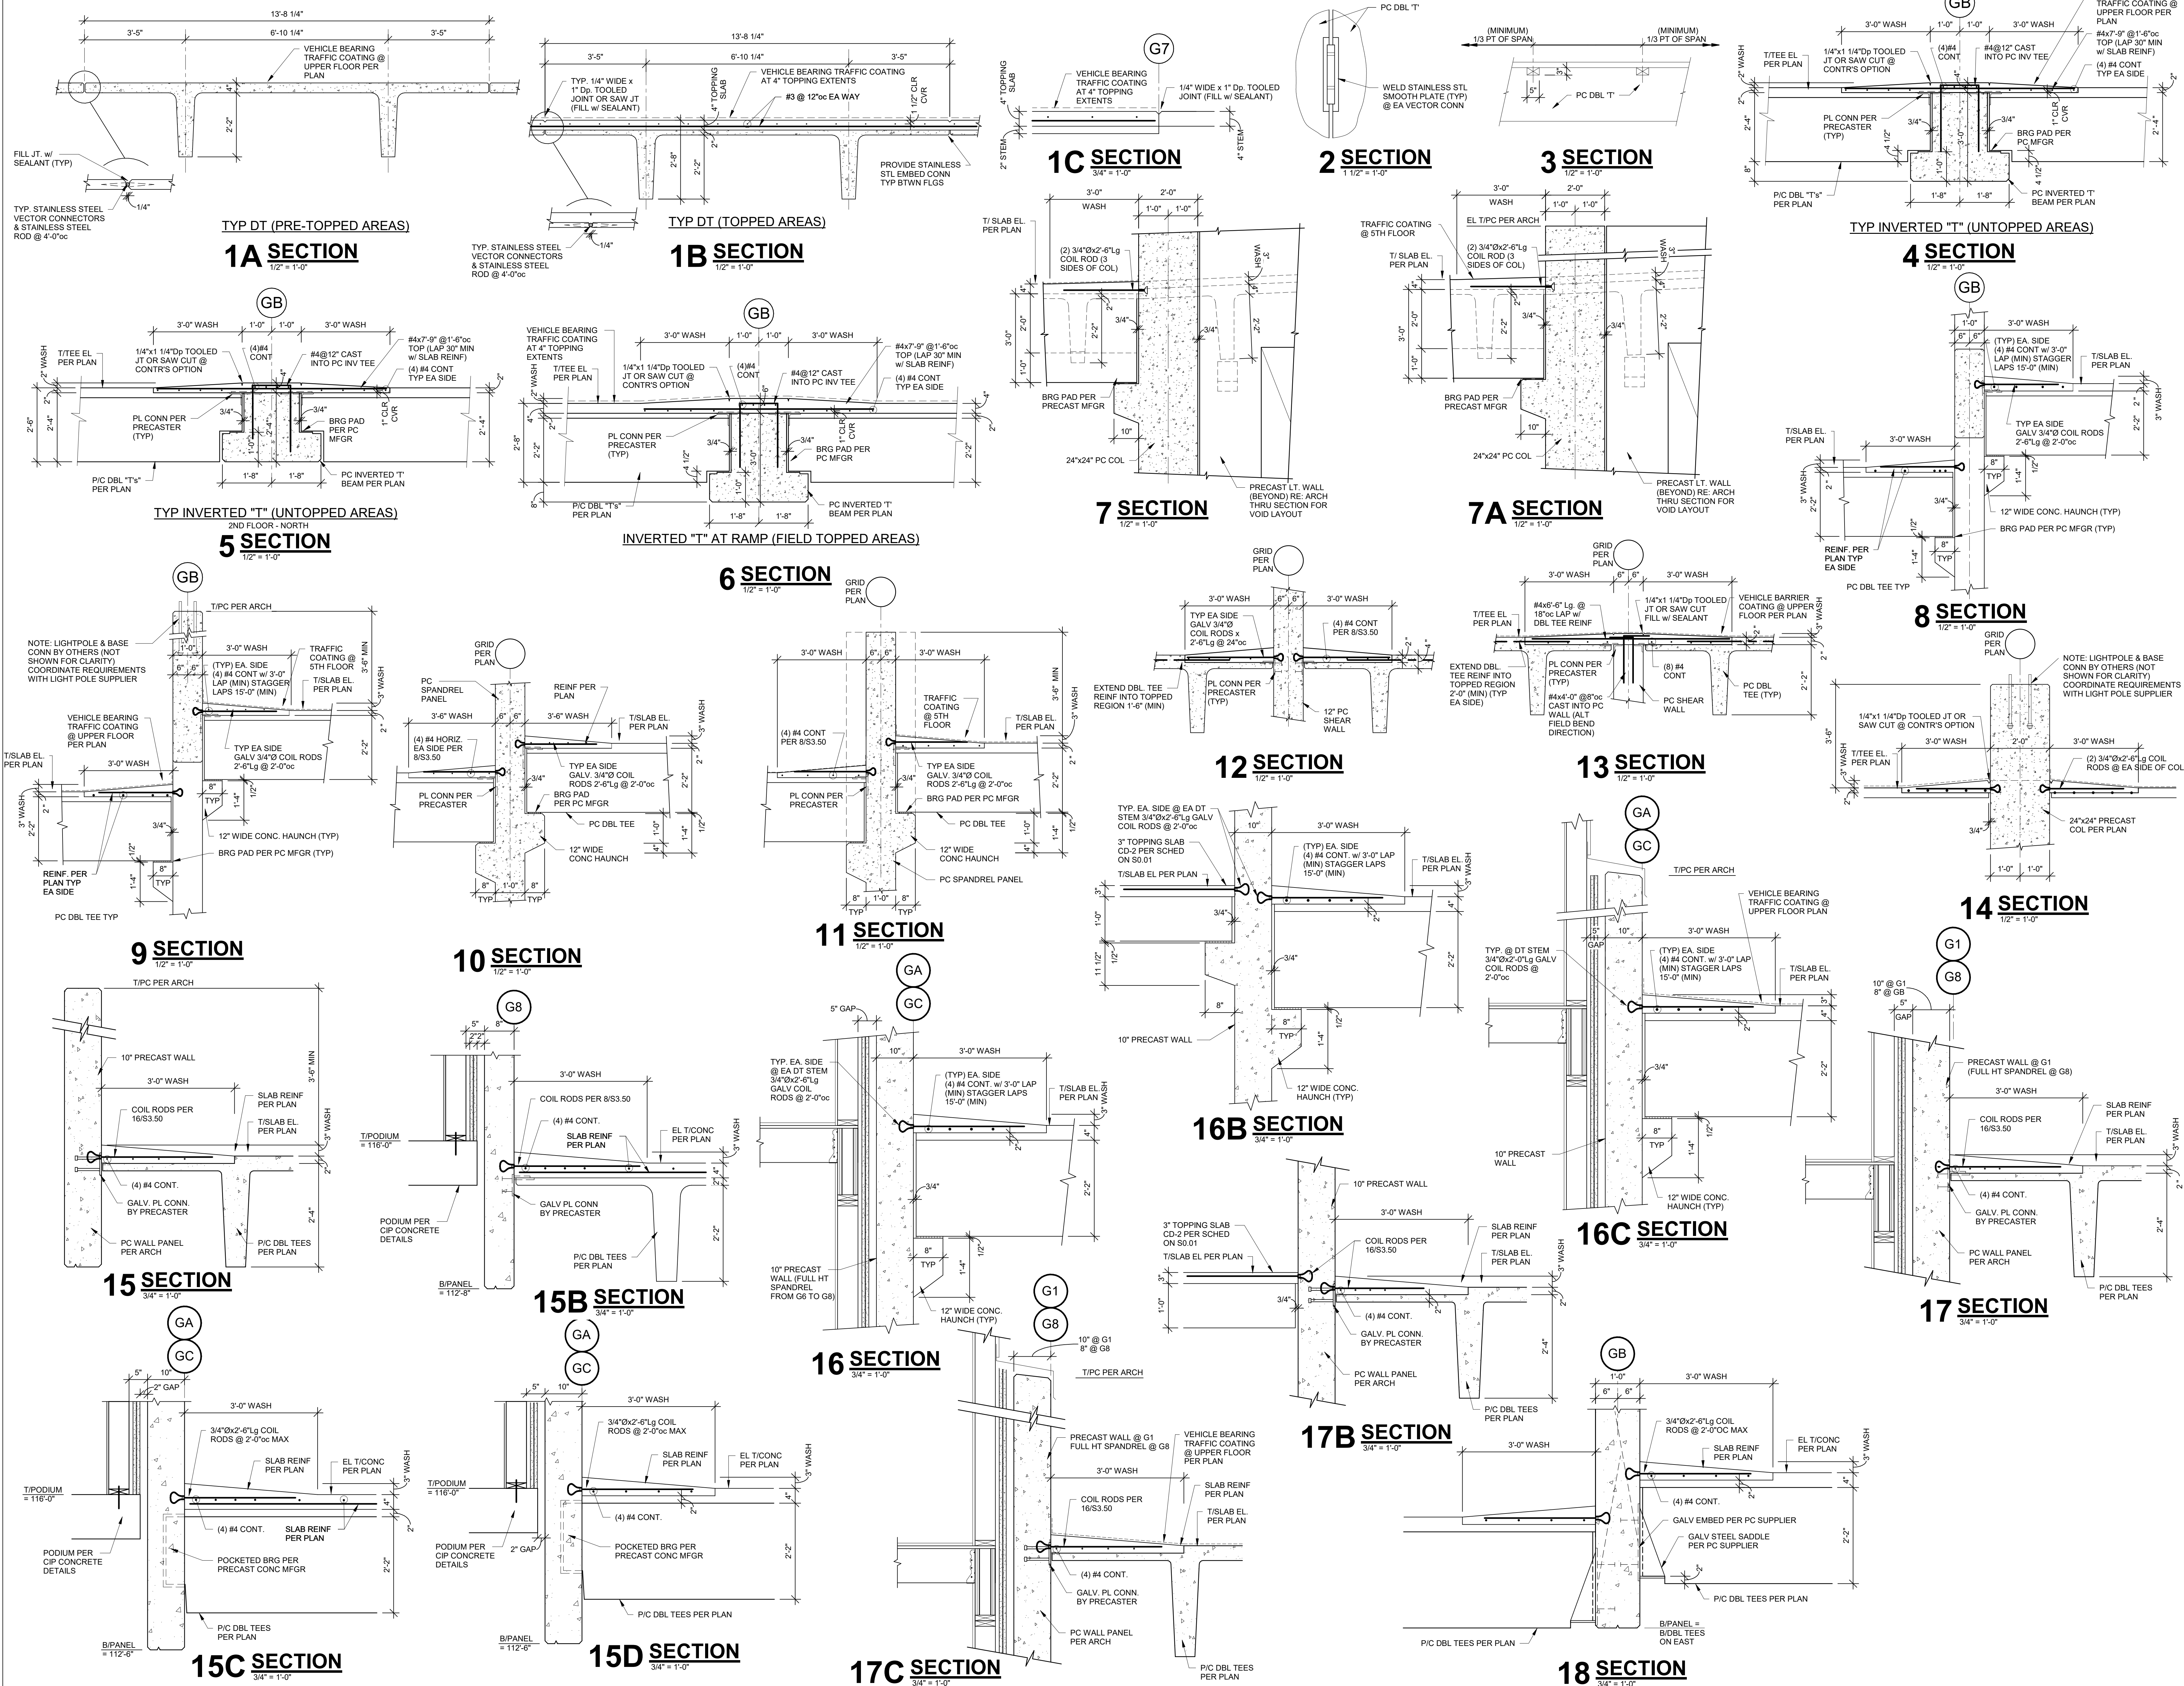
1/4" = 1'-0"



TYPICAL CABLE SUPPORT DETAIL

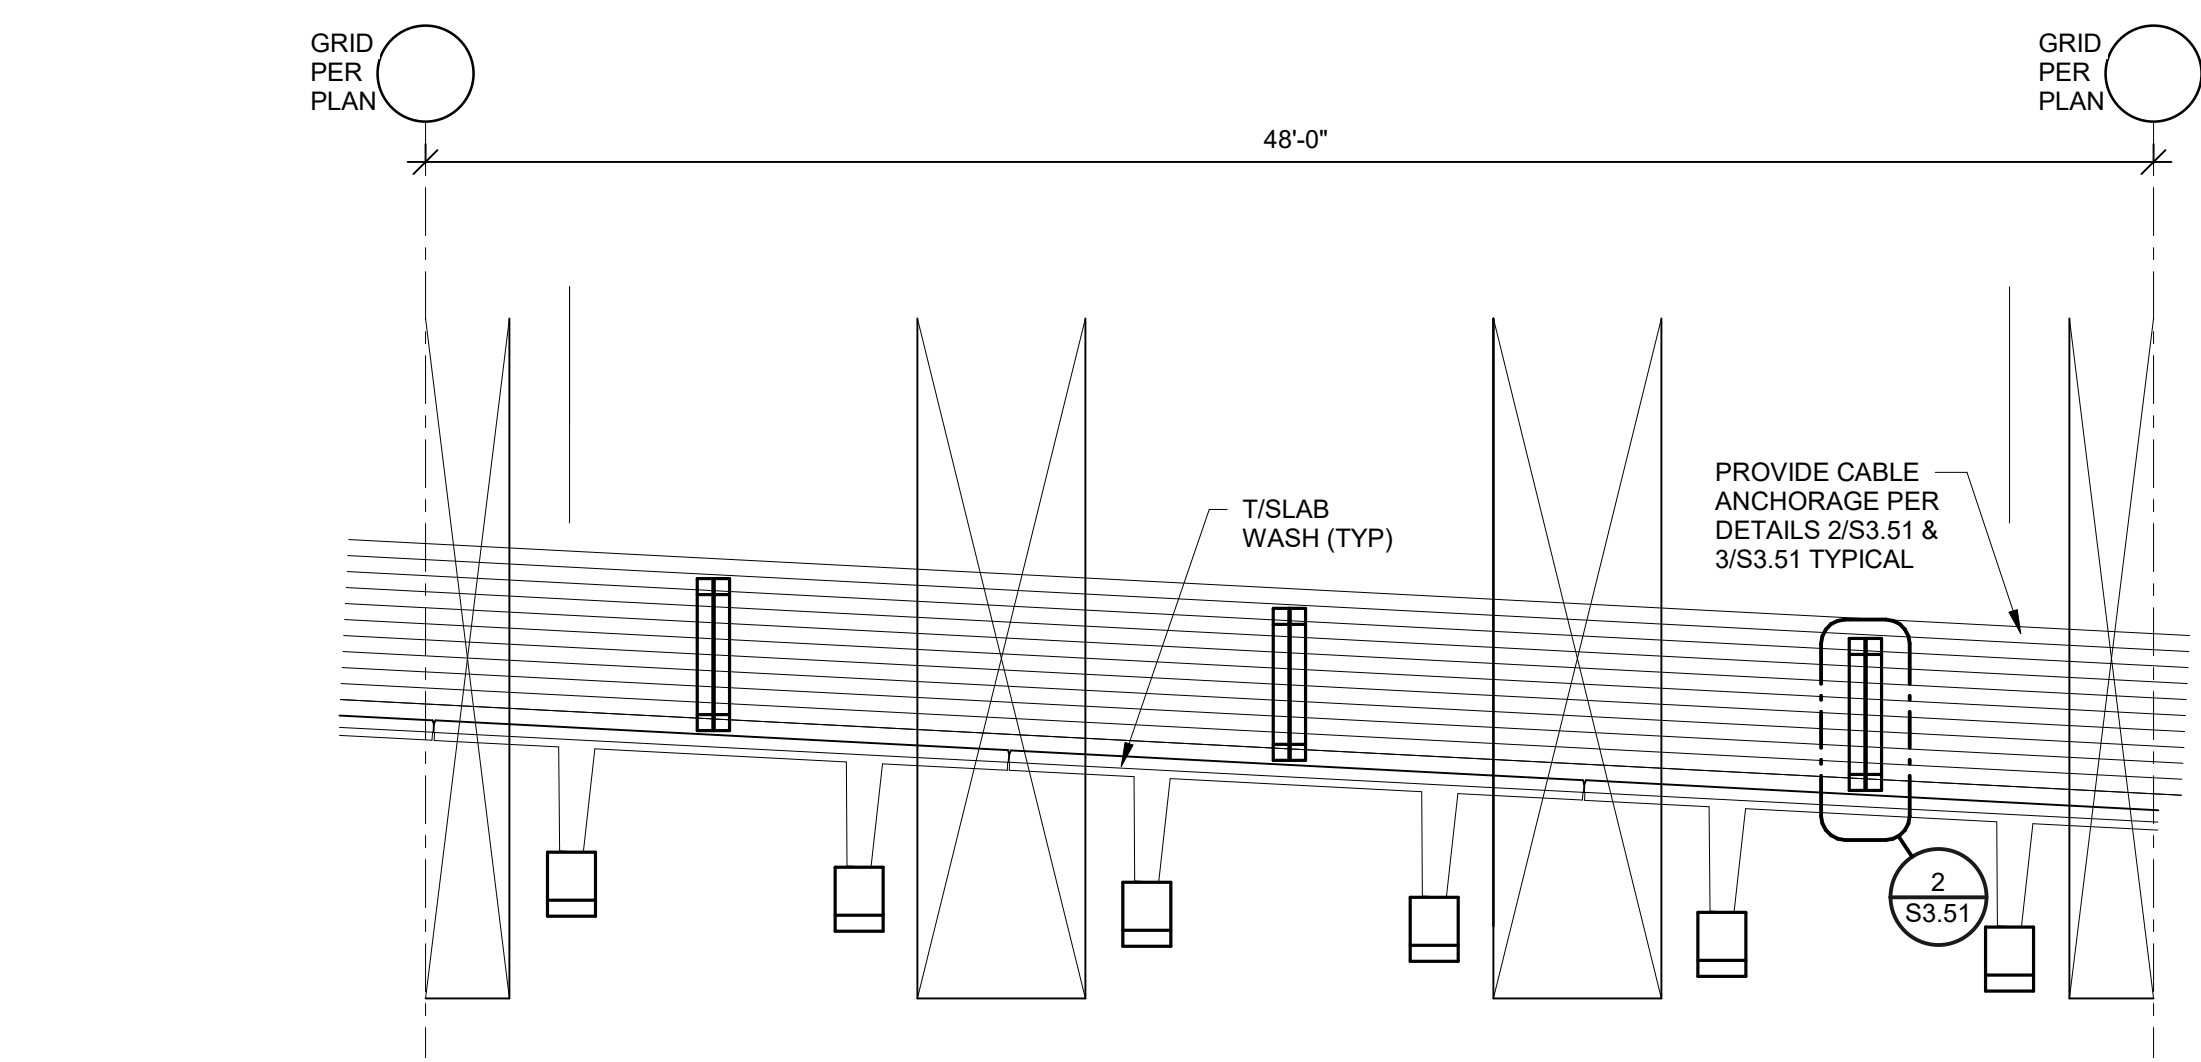2 SECTION

3/4" = 1'-0"

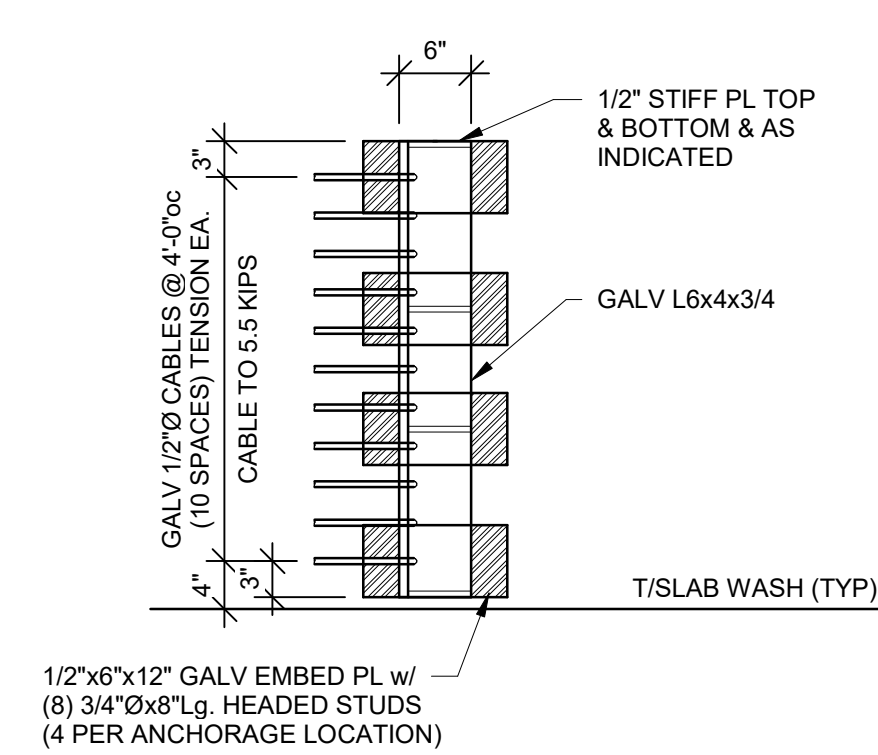


TYPICAL CABLE END ANCHORAGE DETAIL

NOTE: TENSION EA CABLE TO 5.5kips


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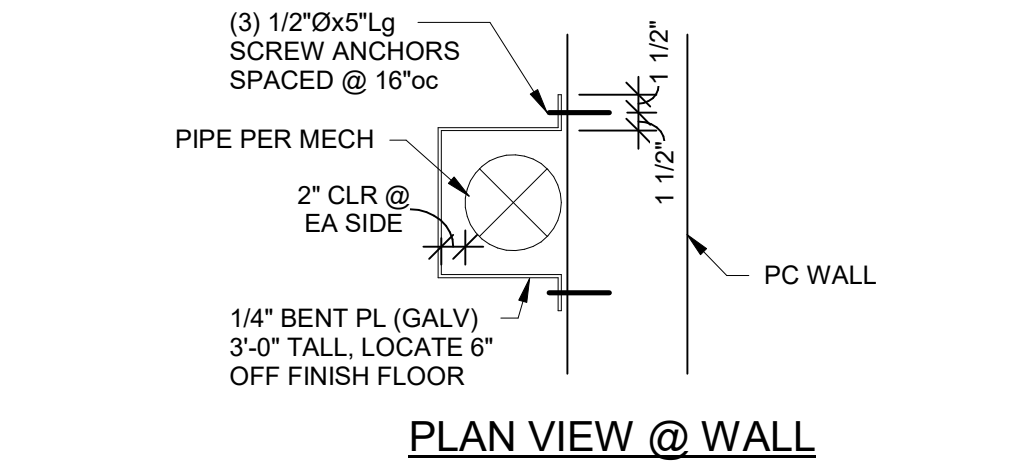
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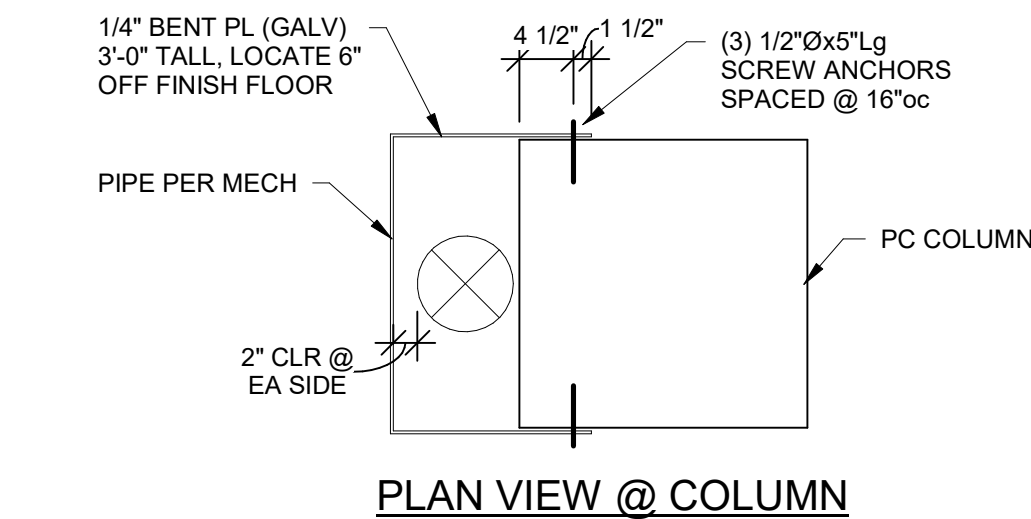


5 SECTION

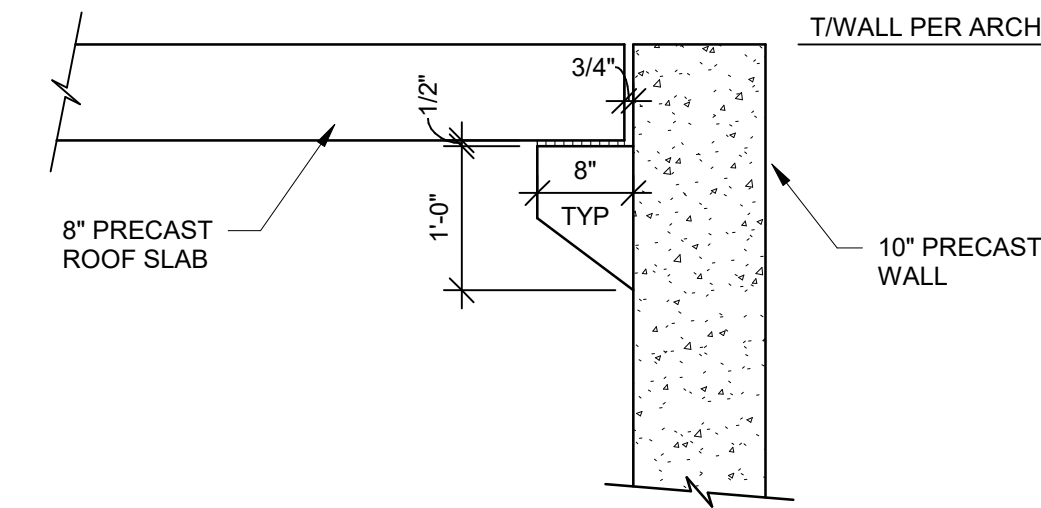3/4" = 1'-0"




PLAN VIEW @ WALL

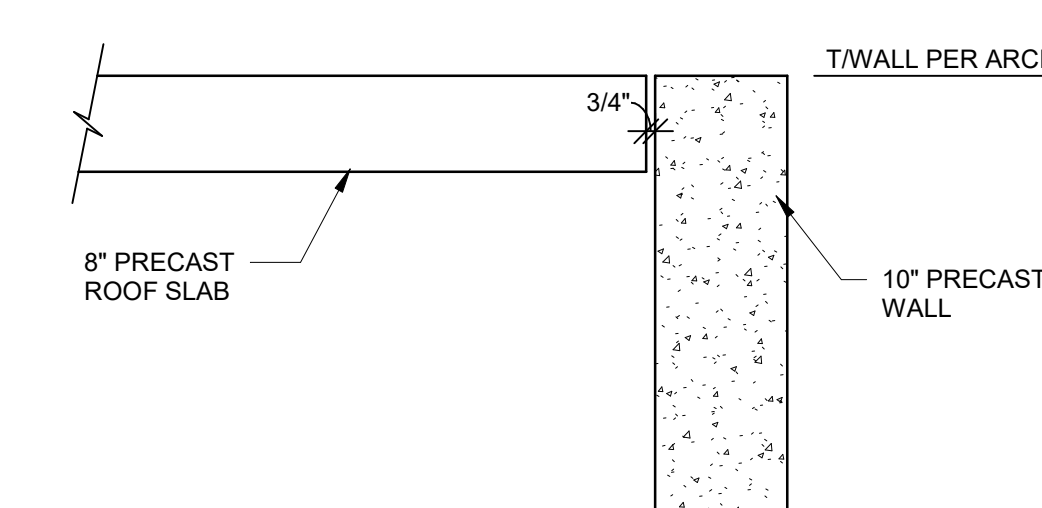

PLAN VIEW @ COLUMN

7 TYPICAL PIPE PROTECTION DETAIL


3/4" = 1'-0"

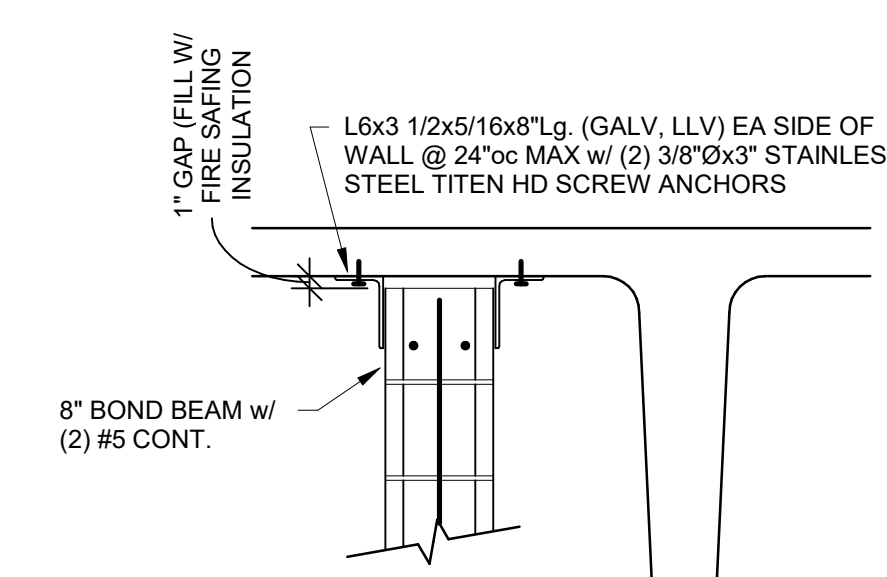

TYPICAL TOP CMU TO PRECAST

8 SECTION


3/4" = 1'-0"

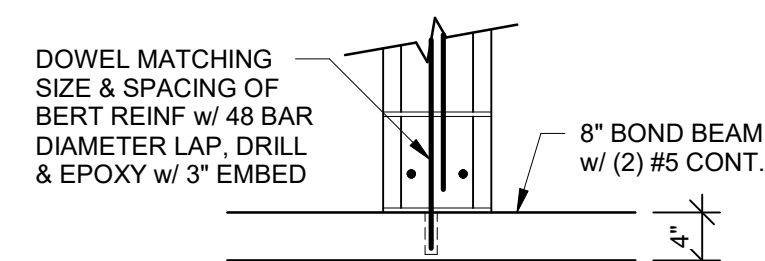

TYPICAL BOTTOM CMU TO PRECAST

9 SECTION

3/4" = 1'-0"

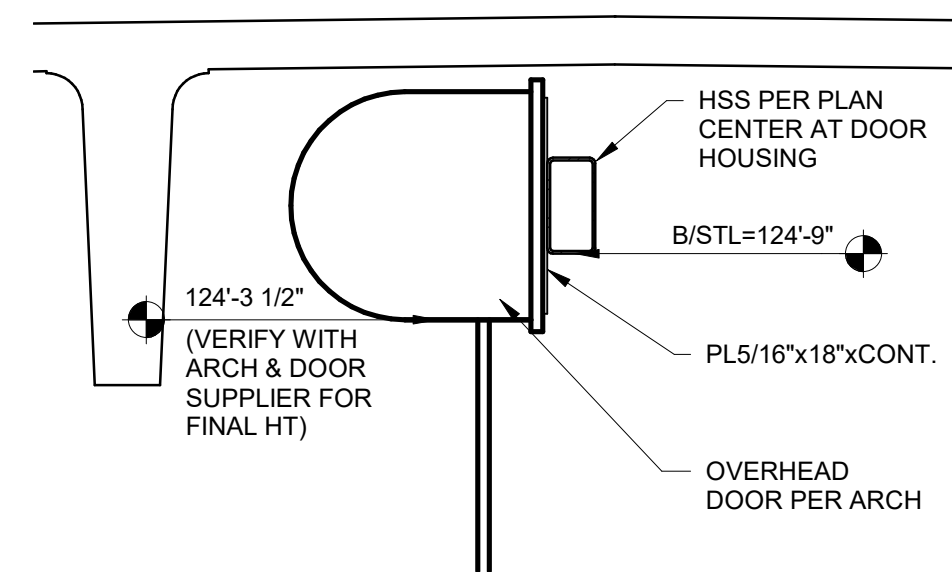

10 SECTION

3/4" = 1'-0"



PARAGON STAR NORTH VILLAGE

3200 NW PARAGON PKWY.
LEE'S SUMMIT, MO 64081

Project No.: 18017.19050.07,19050.08
Date: 02.04.22
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REVISIONS		
No.	Date	Description

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MECHANICAL	LATIMER SOMMERS
ELECTRICAL	LATIMER SOMMERS
FIRE PROTECTION	LATIMER SOMMERS
CONTRACTOR	BRINKMANN CONSTRUCTORS



SHEET TITLE

PRECAST GARAGE FRAMING DETAILS

SHEET NUMBER

S3.51

GENERAL NOTES:
1. ABC



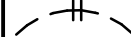
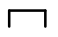
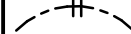
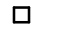



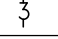
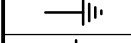
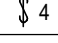
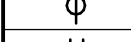

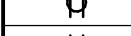

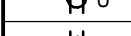

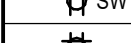



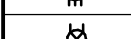
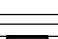

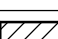
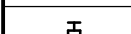
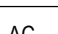

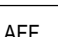

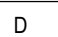
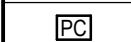
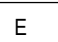



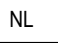
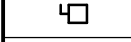
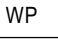




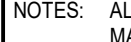

NFAA SYMBOLS LEGEND	
	SMOKE DETECTOR
	SMOKE DETECTOR WITH SOUNDER BASE
	SMOKE DETECTOR WITH ISOLATOR BASE
	HEAT DETECTOR
	DUCT DETECTOR
	ADDRESSABLE MANUAL PULL STATION
	DOOR HOLDER
	FLOW DETECTOR/SWITCH
	TAMPER DETECTOR
	TEST STATION
	MR101C SHUTDOWN RELAY, SPDT WIRED
	AV (WALL MOUNTED) 24 VDC
	STROBE
	BELL ANNUNCIATOR
	HORN/SPEAKER
	FIRE ALARM CONTROL PANEL
	FIREMAN'S PHONE
	AREA RESCUE CALL STATION
	AREA RESCUE MASTER STATION
	SIGNAL ZAM
	CONTROL ZAM
	DETECTOR ZAM
	MONITOR MODULE
	RELAY IAM
	GRAPHIC COMMAND CENTER
	REMOTE FIRE ALARM AUDIO
	REMOTE ANNUNCIATOR WITH AUDIO
	ANNUNCIATOR
	FIRE SMOKE DAMPER
	NAC POWER EXTENDER

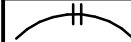* ALL SYMBOLS SHOWN ABOVE MAY NOT APPEAR ON PLANS

MECHANICAL SYMBOLS LEGEND		
	— CHS —	CHILLED HOT SUPPLY
	— CHR —	CHILLED HOT RETURN
		UNION
— CO —		FLEXIBLE PIPE CONNECTION
FFCO		MANUAL DAMPER
FGCO		BACKDRAFT DAMPER
Z (1) FD		AUTOMATIC DAMPER
— RD —		FIRE DAMPER
— ORD —		FIRE/SMOKE DAMPER
Z (1) RD		SMOKE DAMPER
— V —		GRILLE, REGISTER OR DIFFUSER, SIZE, TYPE, & CFM
— C —		VOLUME EXTRACTOR AND TURNING VANES
— R —		RETURN, EXHAUST OR FRESH AIR DUCT SECTION UP & DOWN
— HBS* —		SUPPLY AIR DUCT SECTION UP AND DOWN
— EH WH —		FLEXIBLE DUCT CONNECTION
— F —		ROUND OR RECTANGULAR DUCT
— D —		FLEXIBLE DUCT
— G —		THERMOSTAT
	— R —	REFRIGERANT LIQUID/SUCTION
	AD	ACCESS DOOR
	AFF	ABOVE FINISHED FLOOR
	EA	EXHAUST AIR
	QA	OUTSIDE AIR
	RA	RETURN AIR
	SA	SUPPLY AIR
	VBS	VENT BELOW SLAB
	VTR	VENT THRU ROOF
		CONNECT NEW TO EXISTING
— CWS —		LOCKABLE GUARD
— CWR —	VFD	VARIABLE FREQUENCY DRIVE
— HWS —		
— HWR —		

NOTES: ALL SYMBOLS SHOWN ABOVE MAY NOT APPEAR ON PLANS.

TELECOMMUNICATIONS SYMBOLS LEGEND:		
SYMBOL	DESCRIPTION	REMARKS
▼ D201A	TELECOMMUNICATIONS OUTLET WITH ROOM AND TYPE IDENTIFIER	
▼ _N	TELECOMMUNICATIONS OUTLET WALL PHONE PLATE	2
▼ _{AV}	AUDIO/VISUAL OUTLET	3
TV	TELEVISION OUTLET	1
— — — — —	EMT CONDUIT BY EIC (1" 1/4" UNLESS NOTED OTHERWISE)	4
← — — — — →	EMT SLEEVE BY EIC (2" UNLESS NOTED OTHERWISE)	4
AFB	ABOVE FINISHED FLOOR	
TIC	TELECOMMUNICATIONS CONTRACTOR	
EIC	ELECTRICAL CONTRACTOR	
GC	GENERAL CONTRACTOR	
AC	DEVICE LOCATED ABOVE COUNTER	
TMBB	TELECOMMUNICATIONS MAIN GROUNDING BUSBAR	
TGB	TELECOMMUNICATIONS GROUNDING BUSBAR	
— — — — —	TELECOMMUNICATIONS CABLEING	5
[FACP]	FIRE ALARM CONTROL PANEL	
SM	SINGLEMODE FIBER	
MM	MULTIMODE FIBER	
[WAP]	WIRELESS ACCESS POINT	6
TELECOMMUNICATIONS CABLEING IDENTIFIER		
TELECOM ROOM — D201A — OUTLET TYPE		

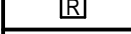ELECTRICAL SYMBOLS LEGEND			
	CONDUIT CONCEALED IN CEILING OR WALL		THERMOSTAT
	CONDUIT CONCEALED IN FLOOR SLAB		LOCKABLE GUARD
	EXPOSED CONDUIT		JUNCTION BOX
	HOMERUN - ARROW INDICATES OKT. LINES INDICATE WIRES		SWITCH - SINGLE POLE
	GROUND WIRE		SWITCH - 3-WAY
	GROUNDING ROD		SWITCH - 4-WAY
	SINGLE RECEPTACLE		LIGHT FIXTURE AND TYPE
	DUPLEX RECEPTACLE (20 AMP UNLESS NOTED)		EMERGENCY LIGHT FIXTURE WITH BATTERY PACK
	DUPLEX RECEPTACLE WITH USB OUTLETS		FIXTURE ON LIFE SAFETY BRANCH OF EMERGENCY SYSTEM
	SWITCHED DUPLEX RECEPTACLE		LIGHT FIXTURE (WALL MOUNTED)
	FOURPLEX RECEPTACLE		EXIT LIGHT (CEILING OR WALL MOUNTED)
	208 OR 240 VOLT VOLTAGE (20 AMP UNLESS NOTED)		FLUSH PANELBOARD (LIGHT & RECEPTACLES)
	GROUND FAULT INTERRUPTER (GFI) DUPLEX RECEPTACLE		SURFACE PANELBOARD (LIGHT & RECEPTACLES)
	TELEDATA OUTLET		DISTRIBUTION PANEL OR SWITCHBOARD
	PUSHBUTTON		AC DEVICE LOCATED ABOVE COUNTER
	VARIABLE FREQUENCY DRIVE		AFF ABOVE FINISHED FLOOR
	OVERRIDE TIMER		D DIMMER
	PHOTOCCELL		E INDICATES EXISTING DEVICE
	MOTOR		EDF ELECTRIC DRINKING FOUNTAIN
	FUSIBLE SWITCH (RUSSMAN SSU)		NL NIGHTLIGHT FIXTURE, WIRED HOT
	DISCONNECT SWITCH (D.S.)		WP WEATHERPROOF
	COMBINATION MOTOR STARTER (CMS)		AFCI ARC FAULT CIRCUIT INTERRUPTER
	RELAY		Q CONNECT NEW TO EXISTING

NOTES

ALL SYMBOLS SHOWN ABOVE MAY NOT APPEAR ON PLANS

REFER TO MECHANICAL SYMBOLS LEGEND FOR MECHANICAL SYMBOLS THAT MAY BE SHOWN ON ELECTRICAL PLANS

4x4 BOXCOX WITH SINGLE GANG PLASTER BING AND A 1 1/4" CONDUIT TO ABOVE ACCESSIBLE CEILING

PARAGON STAR
NORTH VILLAGE

3200 NW PARAGON PKWY
LEE'S SUMMIT, MO 64081

Project No.: 18017,19050.07,19050.08

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FIRE PROTECTION	LATIMER SOMMERS
CONTRACTOR	BRINKMANN CONSTRUCTORS




SHEET TITLE

COVER SHEET

SHEET NUMBER

ME-001

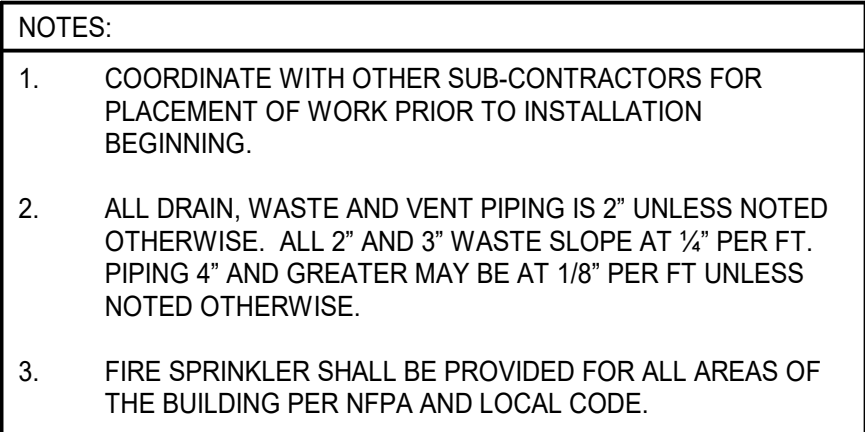

Project No.:	18017,19050.07,19050.08
Date:	02.04.22
Issued For:	GARAGE PERMIT

[illegible]

REGISTRATION



PROJECT TEAM	
ARCHITECT	FINKLE+WILLIAMS ARCHITECTURE
CIVIL	GBA ENGINEERS
LANDSCAPE	LAND 3
STRUCTURAL	BOB D. CAMPBELL
DRAINAGING	LATIMER SOMMER
MECHANICAL	LATIMER SOMMER
ELECTRICAL	LATIMER SOMMER
EROSION PROTECTION	LATIMER SOMMER
CONTRACTOR	BRINKMANN CONSTRUCTORS




SHEET TITLE

GARAGE FIRST
FLOOR -
PLUMBING

SHEET NUMBER

MP1.71C

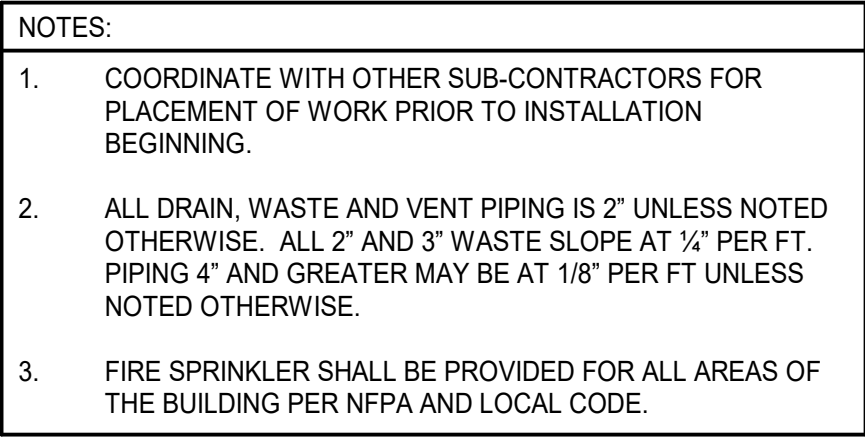

Project No.:	18017,19050.07,19050.08
Date:	02.04.22
Issued For:	GARAGE PERMIT

[illegible]

REGISTRATION



PROJECT TEAM	
ARCHITECT	FINKLE+WILLIAMS ARCHITECTURE
CIVIL	GBA ENGINEERS
LANDSCAPE	LAND 3
STRUCTURAL	BOB D. CAMPBELL
PLUMBING	LATIMER SOMMER
MECHANICAL	LATIMER SOMMER
ELECTRICAL	LATIMER SOMMER
EROSION PROTECTION	LATIMER SOMMER
CONTRACTOR	BRINKMANN CONSTRUCTORS




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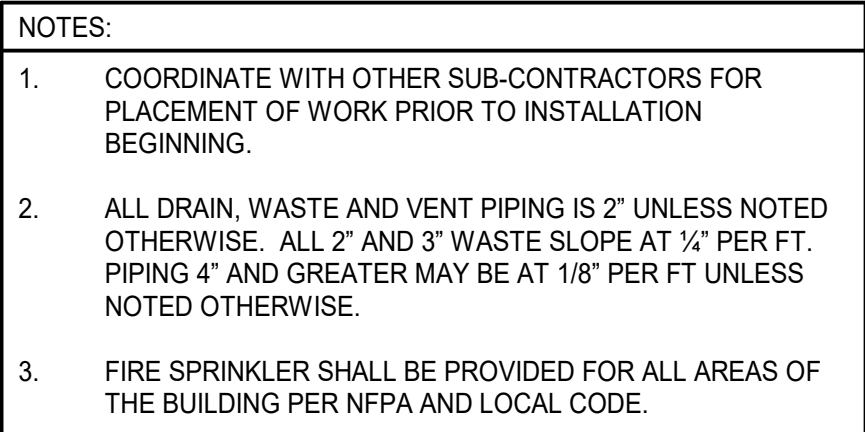
GARAGE SECOND FLOOR - PLUMBING

SHEET NUMBER

MP1.72G

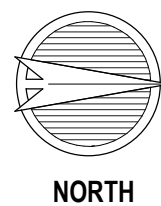

1 GARAGE 2
PLUMBING
1/8" = 1'-0"



Issued For: GARAGE PERMIT

[illegible]

REGISTRATION



PROJECT TEAM


ARCHITECT	FINKLE+WILLIAMS ARCHITECTURE
CIVIL	GBA ENGINEERS
LANDSCAPE	LAND 3
STRUCTURAL	BOB D. CAMPBELL
PLUMBING	LATIMER SOMMER
MECHANICAL	LATIMER SOMMER
ELECTRICAL	LATIMER SOMMER
FIRE PROTECTION	LATIMER SOMMER
CONTRACTOR	BRINKMANN CONSTRUCTORS




SHEET TITLE

SHEET NUMBER

MP1.73C

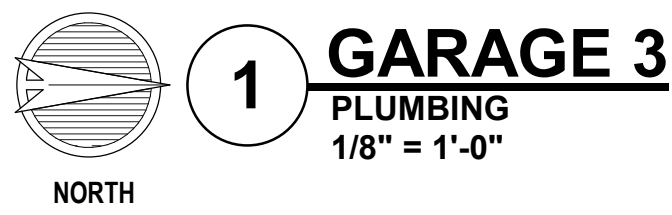

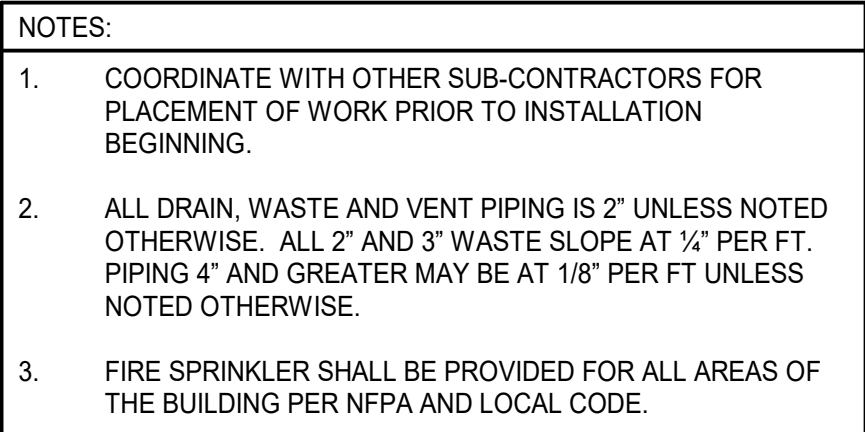

Project No.:	18017,19050.07,19050.08
Date:	02.04.22
Issued For:	GARAGE PERMIT

[illegible]

REGISTRATION



PROJECT TEAM	
ARCHITECT	FINKLE+WILLIAMS ARCHITECTURE
CIVIL	GBA ENGINEERS
LANDSCAPE	LAND 3
STRUCTURAL	BOB D. CAMPBELL
PLUMBING	LATIMER SOMMER
MECHANICAL	LATIMER SOMMER
ELECTRICAL	LATIMER SOMMER
FIRE PROTECTION	LATIMER SOMMER
CONTRACTOR	BRINKMANN CONSTRUCTORS




SHEET TITLE

GARAGE
 FOURTH FLOOR
 - PLUMBING


SHEET NUMBER

MP1.74G

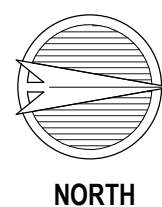

1

GARAGE 4
PLUMBING
1/8" = 1'-0"

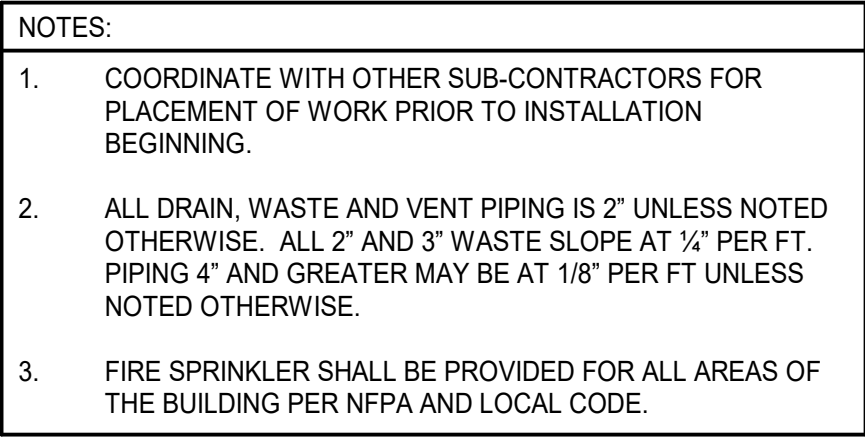

Project No.:	18017,19050.07,19050.08
Date:	02.04.22
Issued For:	GARAGE PERMIT

[illegible]

REGISTRATION



PROJECT TEAM


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CIVIL	GBA ENGINEERS
LANDSCAPE	LAND 3
STRUCTURAL	BOB D. CAMPBELL
PLUMBING	LATIMER SOMMER
MECHANICAL	LATIMER SOMMER
ELECTRICAL	LATIMER SOMMER
FIRE PROTECTION	LATIMER SOMMER
CONTRACTOR	BRINKMANN CONSTRUCTORS




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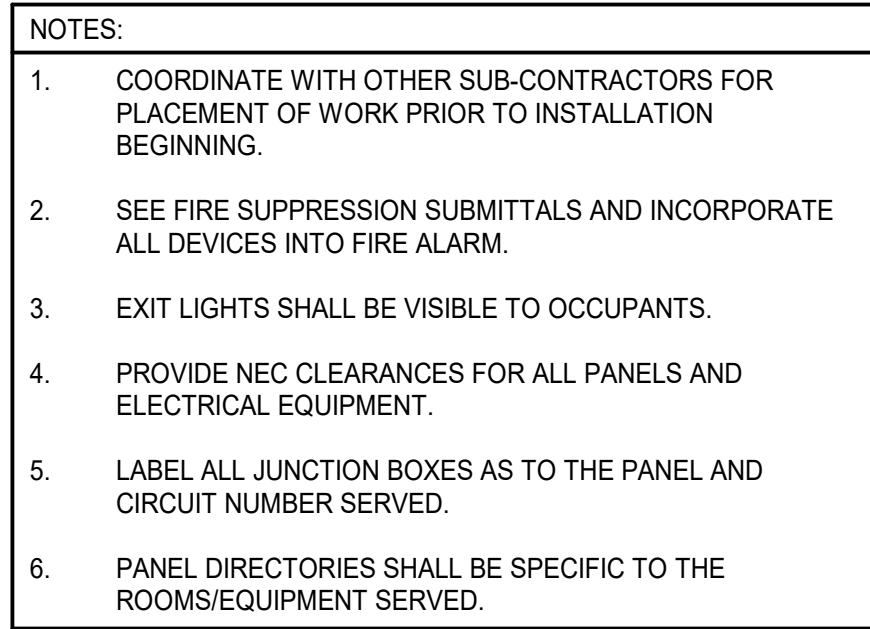
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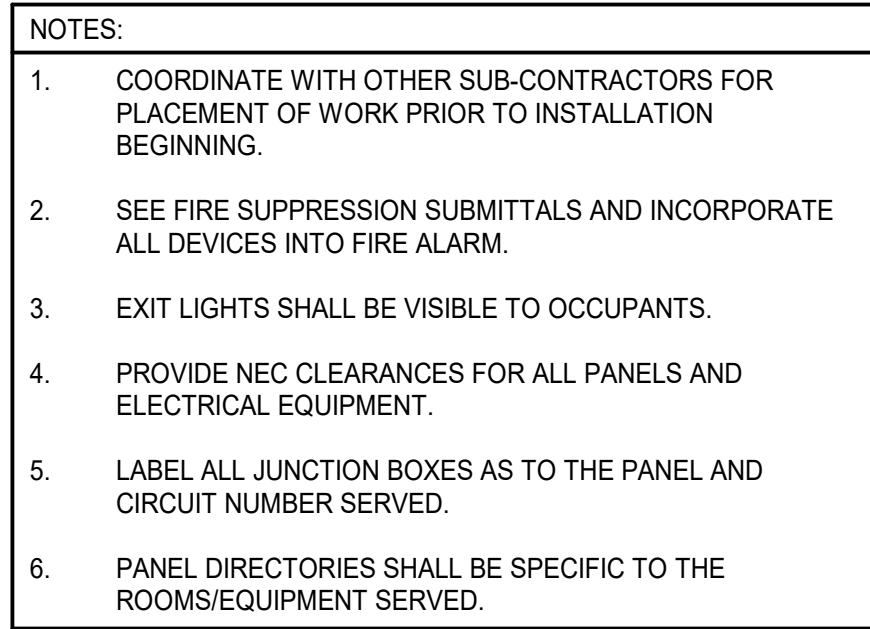
MP1.75G



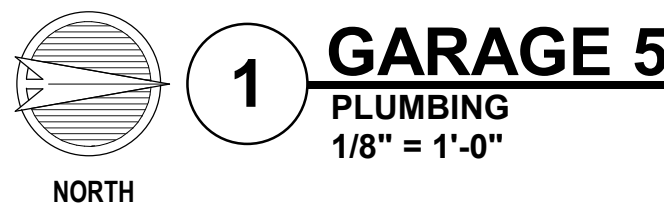

- E1.71G

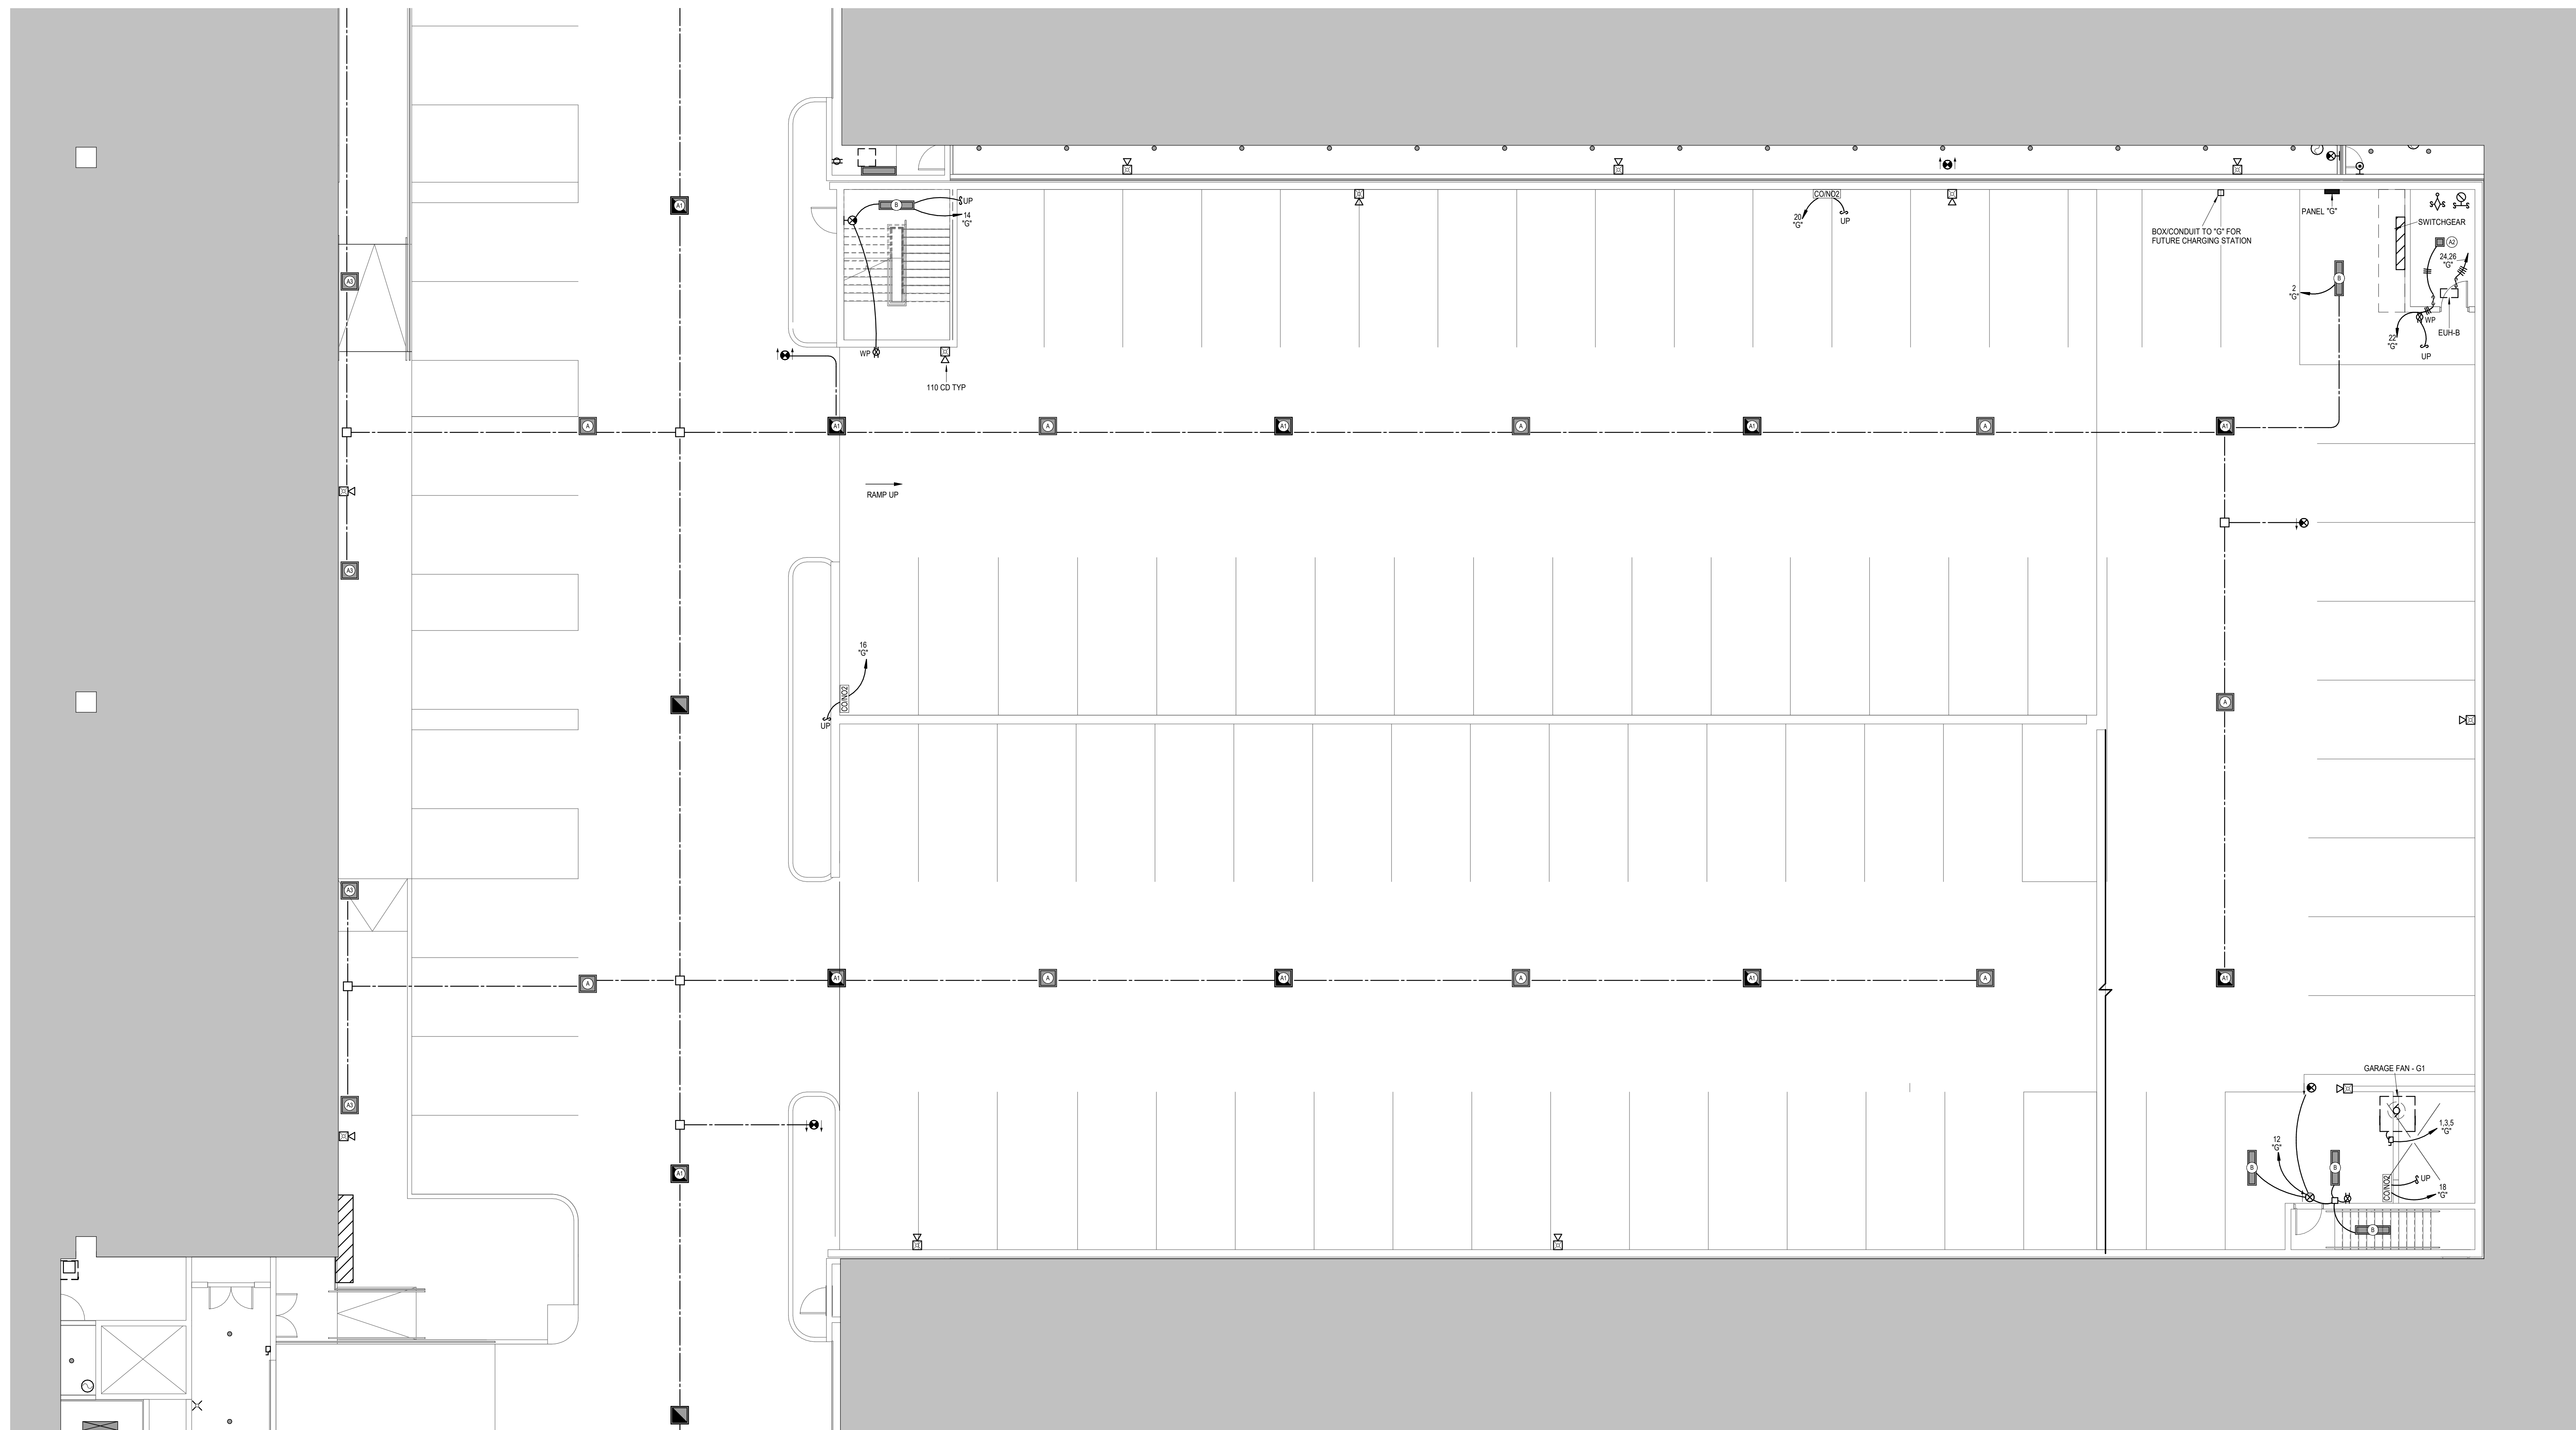



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[illegible]

REGISTRATION



PROJECT TEAM	
ARCHITECT	FINKLE+WILLIAMS ARCHITECTURE
CIVIL	GBA ENGINEERS
LANDSCAPE	LAND 3
STRUCTURAL	BOB D. CAMPBELL
PLUMBING	LATIMER SOMMER
MECHANICAL	LATIMER SOMMER
ELECTRICAL	LATIMER SOMMER
EROSION PROTECTION	LATIMER SOMMER
CONTRACTOR	BRINKMANN CONSTRUCTORS



SHEET TITLE


GARAGE THIRD FLOOR PLAN - ELECTRICAL

SHEET NUMBER

E1.73G



1 GARAGE 3
POWER
1/8" = 1'-0"

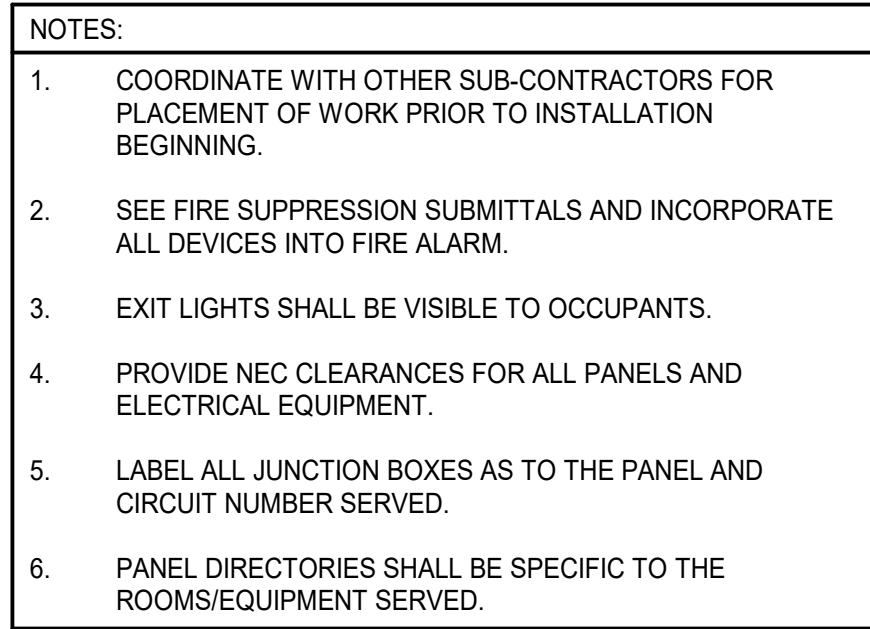

Project No.:	18017,19050.07,19050.08
Date:	02.04.22
Issued For:	GARAGE PERMIT

[illegible]

REGISTRATION



PROJECT TEAM


ARCHITECT	FINKLE+WILLIAMS ARCHITECTURE
ENVIRONMENTAL	GBA ENGINEERS
LANDSCAPE	LAND 3
STRUCTURAL	BOB D. CAMPBELL
PLUMBING	LATIMER SOMMER
MECHANICAL	LATIMER SOMMER
ELECTRICAL	LATIMER SOMMER
FIRE PROTECTION	LATIMER SOMMER
CONTRACTOR	BRINKMANN CONSTRUCTORS



SHEET NUMBER

E1.74G



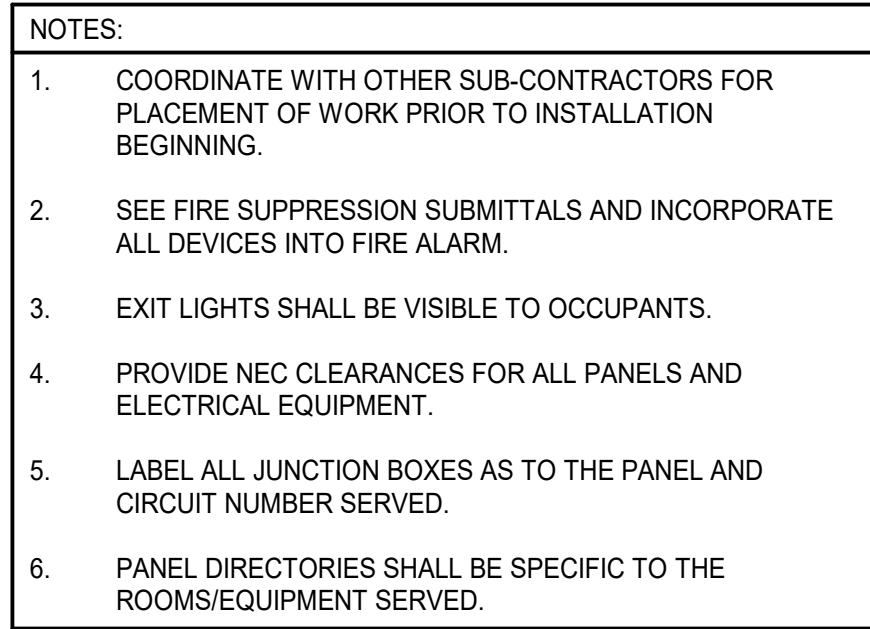

Project No.:	18017,19050.07,19050.08
Date:	02.04.22
Issued For:	GARAGE PERMIT

[illegible]

REGISTRATION



PROJECT TEAM





ARCHITECT	FINKLE+WILLIAMS ARCHITECTURE
ENVIRONMENTAL	GBA ENGINEERS
LANDSCAPE	LAND 3
STRUCTURAL	BOB D. CAMPBELL
PLUMBING	LATIMER SOMMERS
MECHANICAL	LATIMER SOMMERS
ELECTRICAL	LATIMER SOMMERS
FIRE PROTECTION	LATIMER SOMMERS
CONTRACTOR	BRINKMANN CONSTRUCTORS




MEET TITLE

SHEET NUMBER

 **1** **GARAGE 5**
POWER
1/8" = 1'-0"

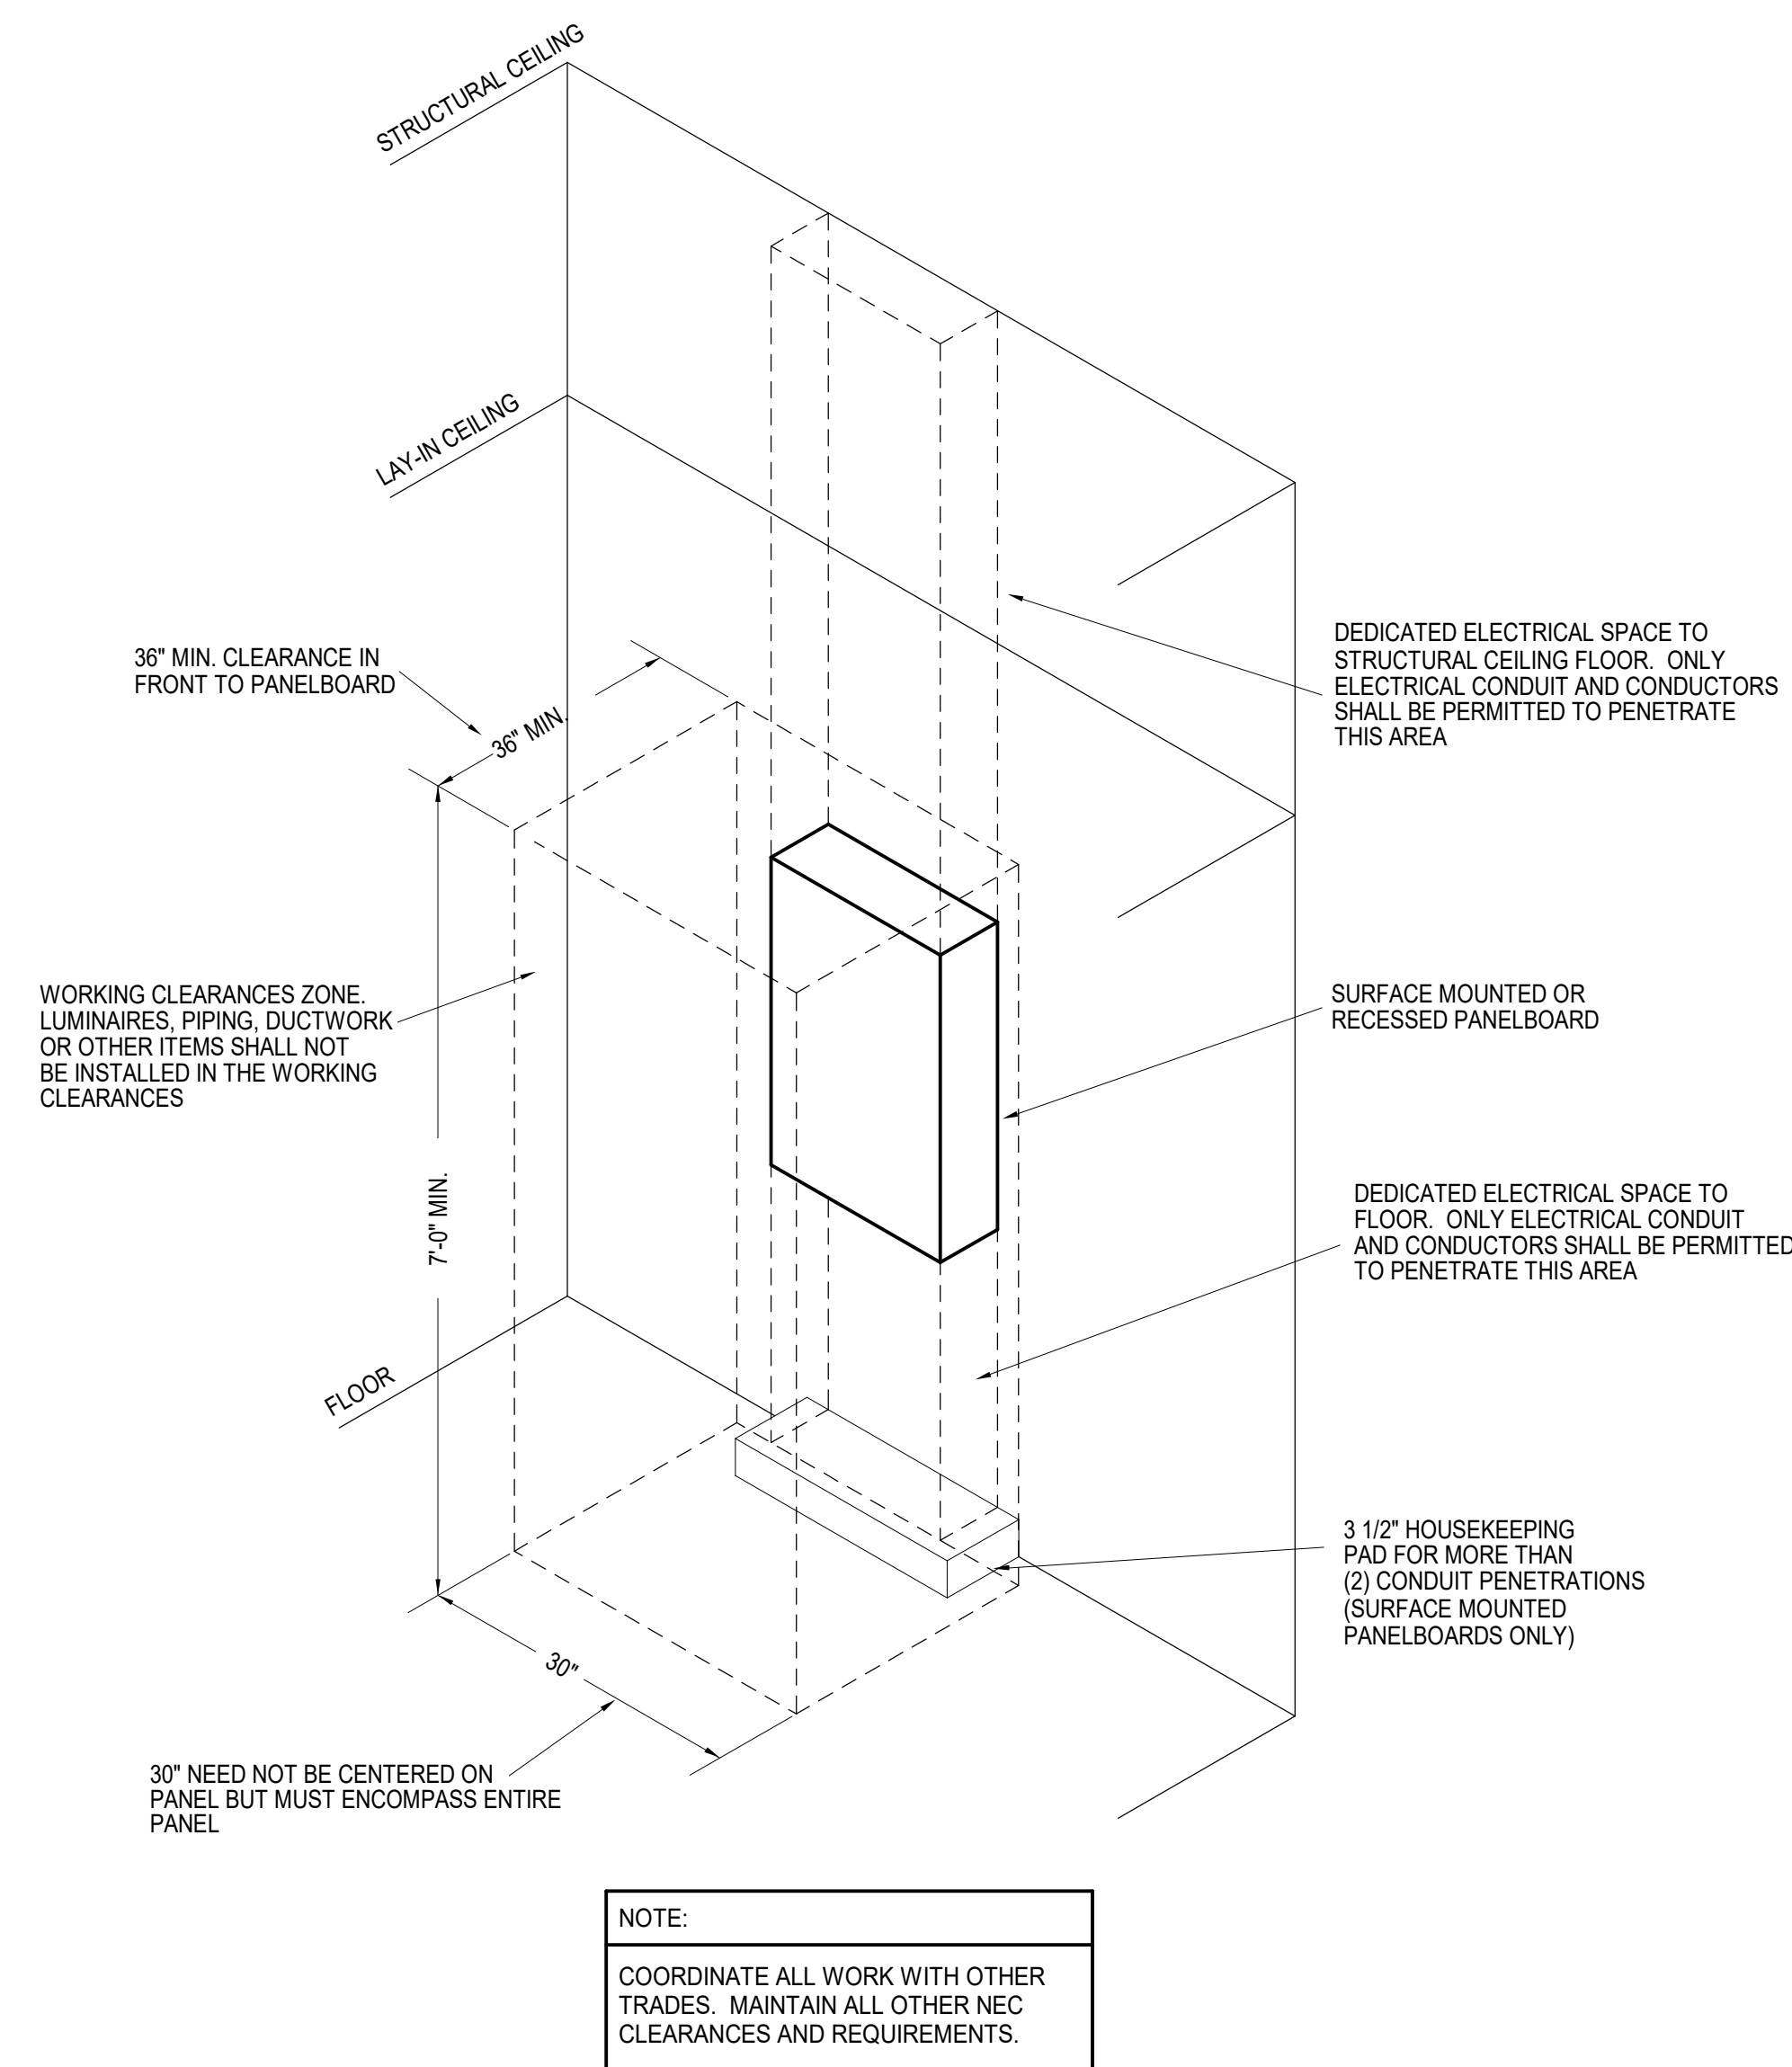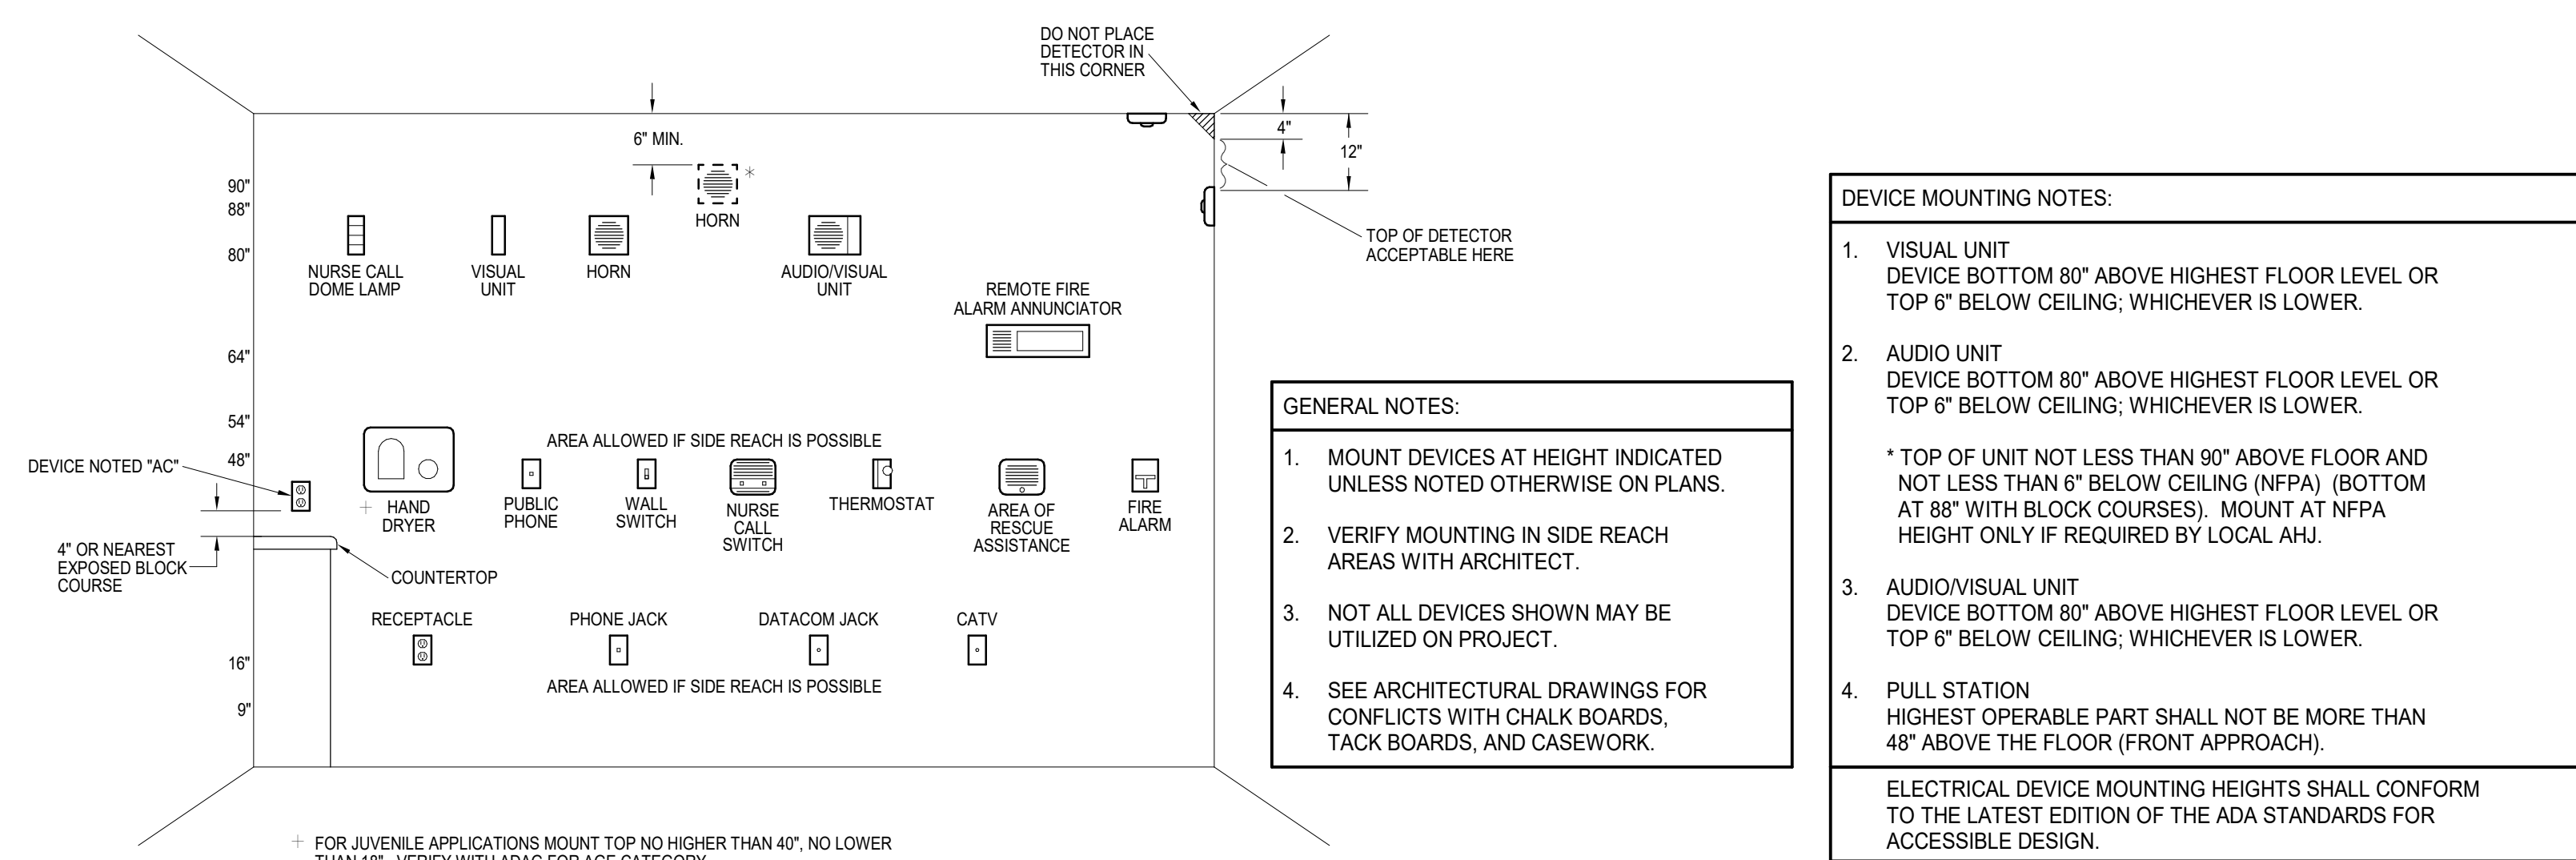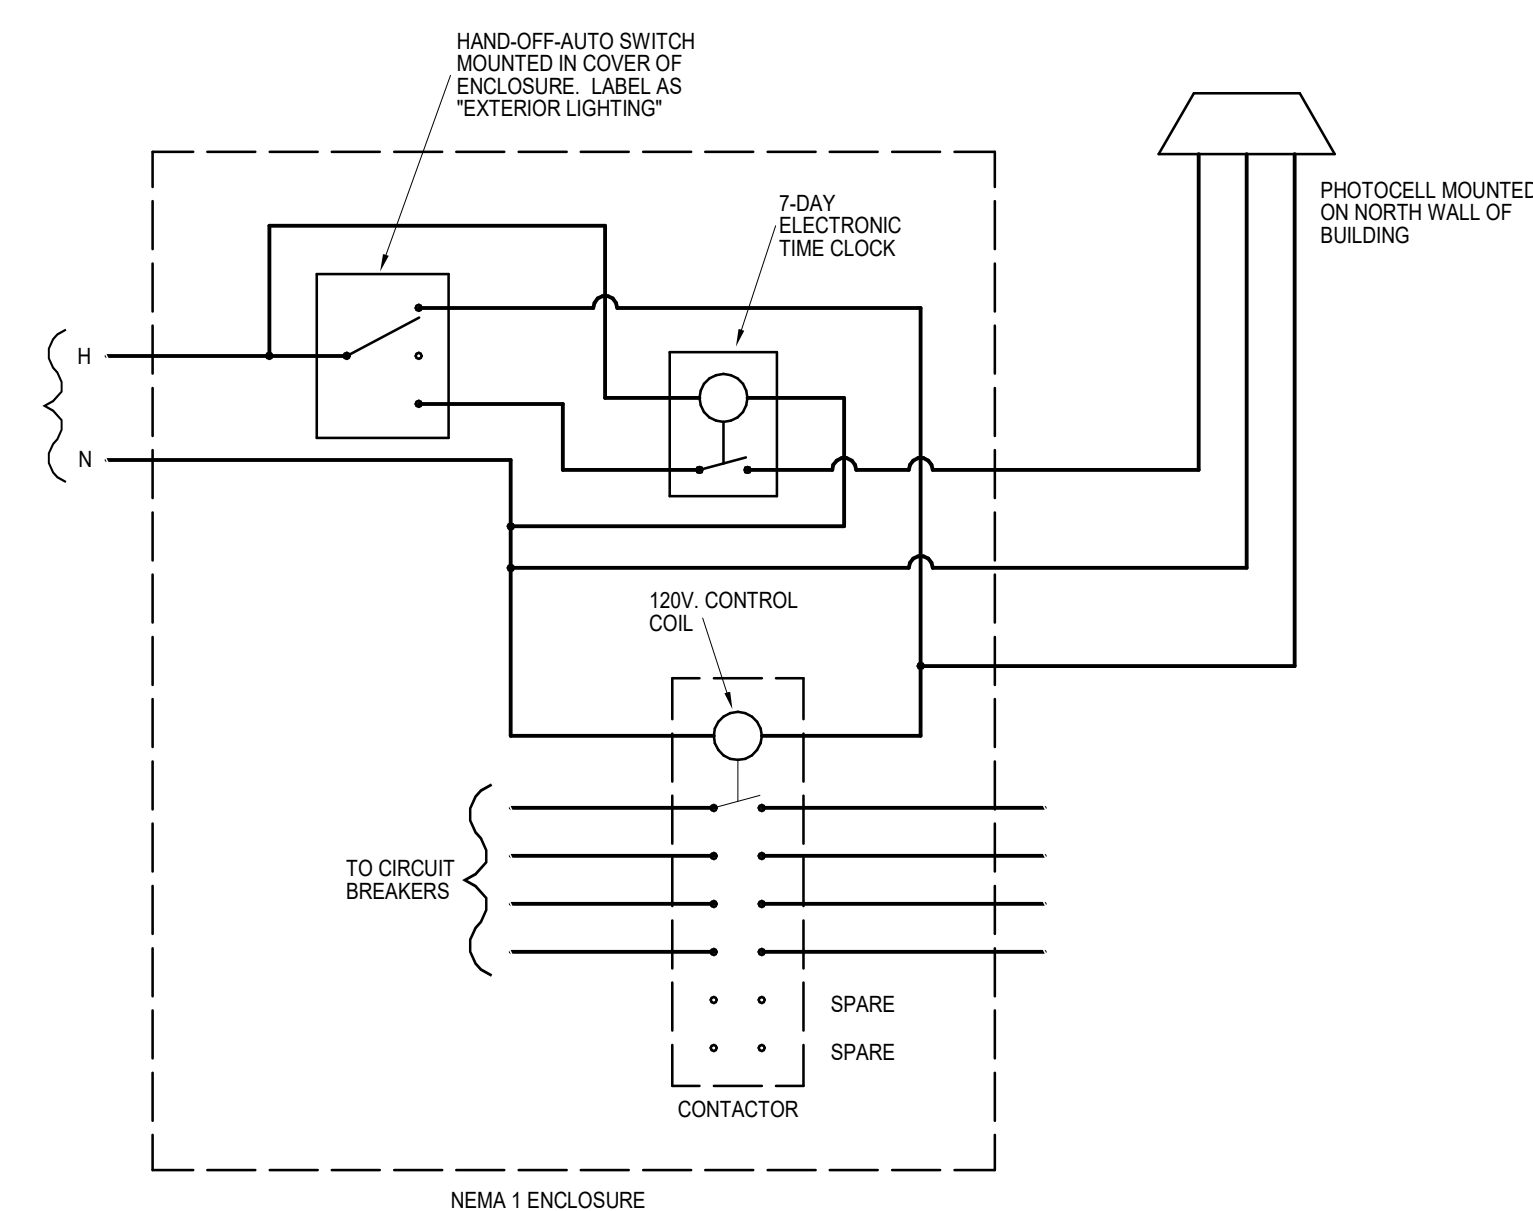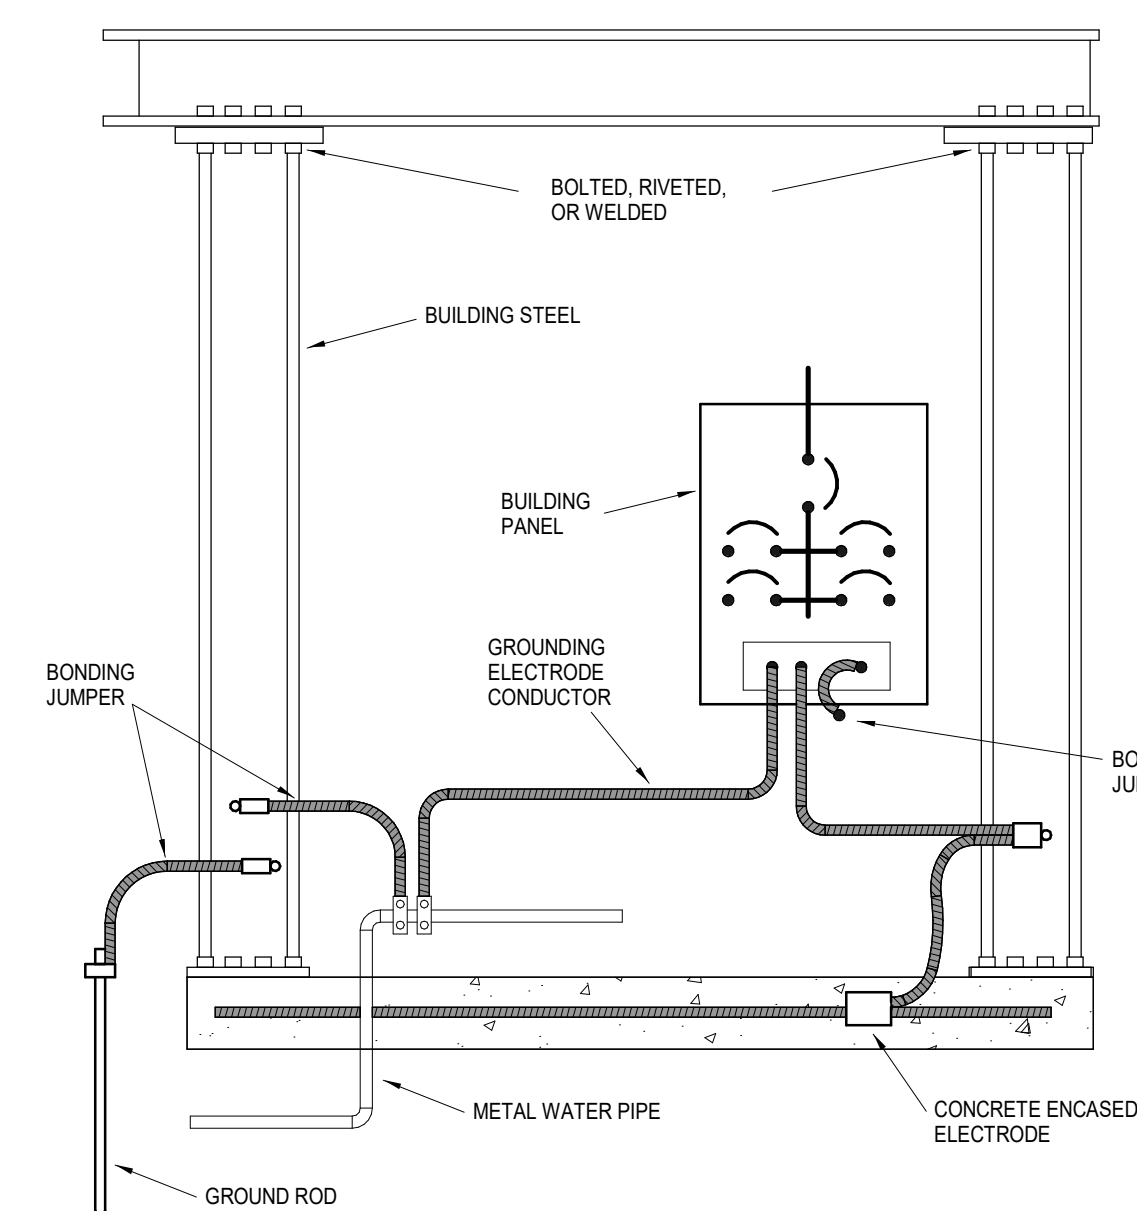

Luminaire Schedule							
MARK	DESCRIPTION	MFR	MODEL	MOUNTING	FINISH	LAMPS	NOTES
A	Garage Light	Royal Pacific	44310B-60-MS	surface	standard	60W 4000K	with 50% motion dimming
A1	Garage Light	Royal Pacific	44310B-60-MS	surface	standard	60W 4000K	with 50% motion dimming/battery
A2	Strip	Lithonia	LQMS4C-400/40WARS/SS/1cm	surface	white	1000 Lumens 4000K 15W	
B	Strip	Lithonia	MNSL4-14 11L MVOLI 40K	surface	white	20W 4000K LED	with battery
C	Double head Pole	McGraw Edison	(2) GLEON-SR42-740-U-SWQ	pr/surface	white	15,200 Lumens 4000K 115W LED	16 ft pole
X1	Exit	Lithonia	LQM SW3R	surface	white/red	LED	
X2	Exit - waterproof	Lithonia	WLTE-W-1R-LEL	surface	white/red	LED	

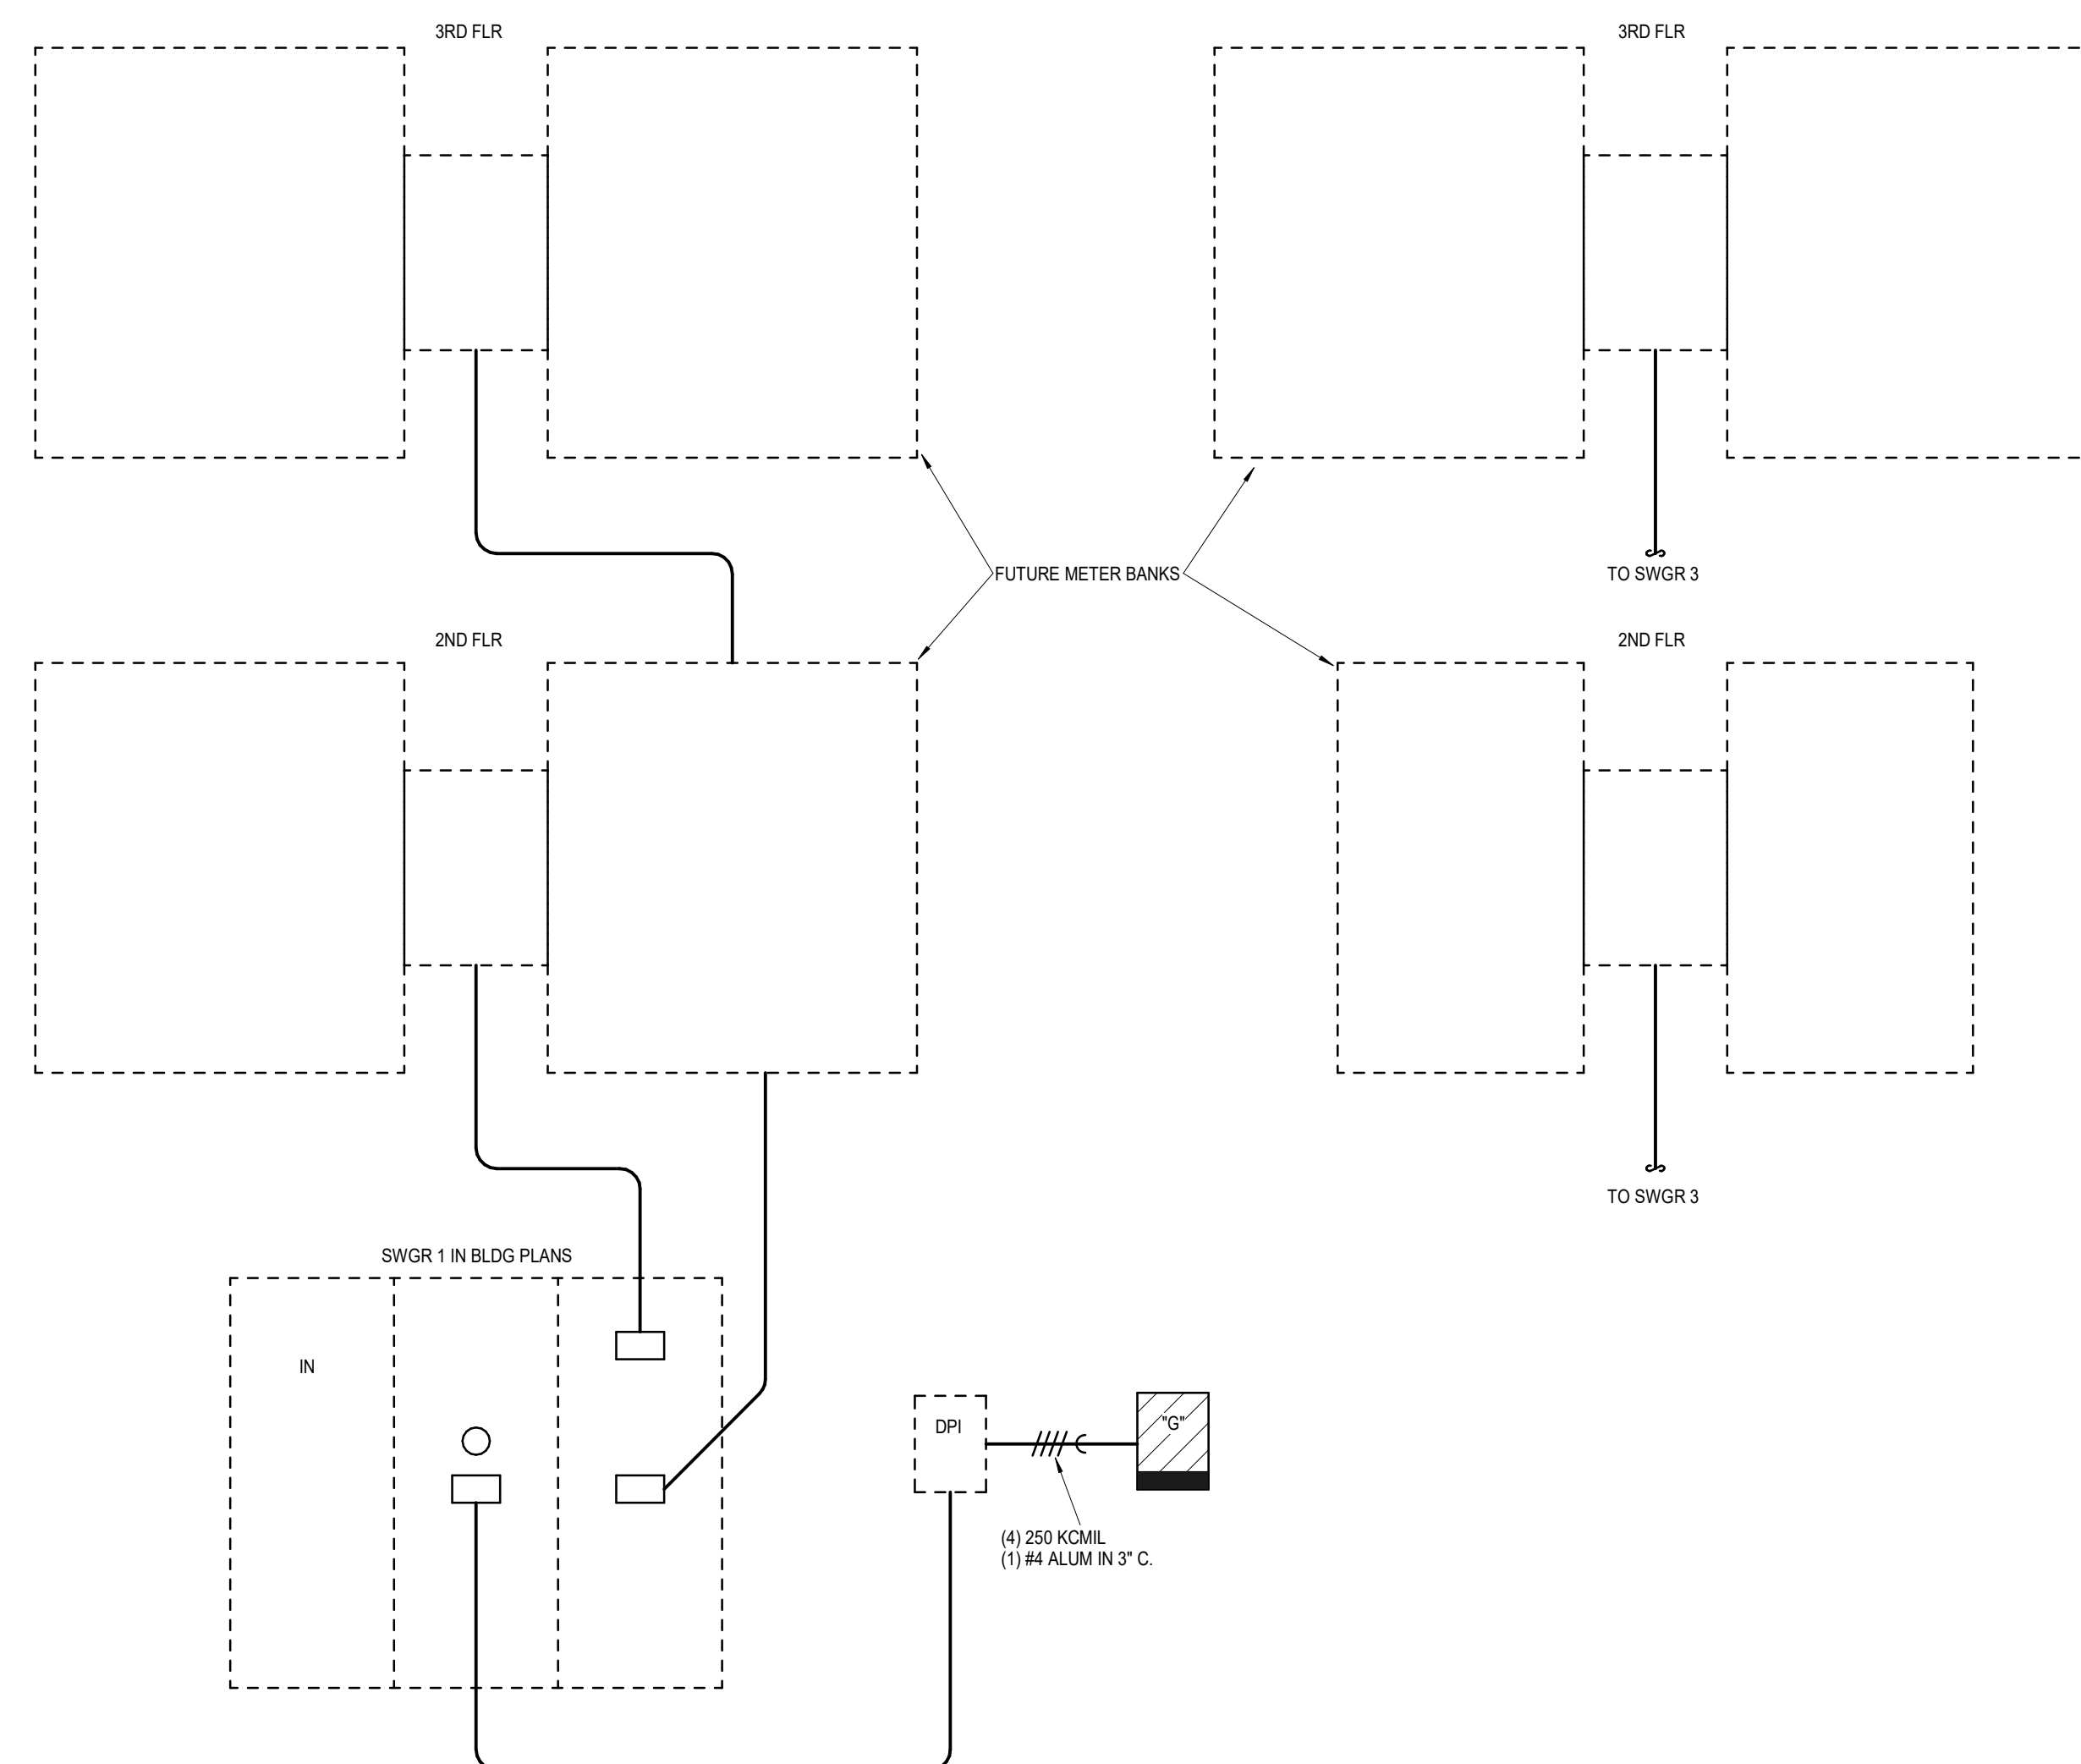[illegible]

PARAGON STAR
NORTH VILLAGE

3200 NW PARAGON PKWY
LEE'S SUMMIT, MO 64081

Project No.:	18017,19050.07,19050.08
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Issued For:	GARAGE PERMIT

[illegible]

ELECTRICAL DEVICE MOUNTING HEIGHTS SHALL CONFORM TO THE LATEST EDITION OF THE ADA STANDARDS FOR ACCESSIBLE DESIGN.

REGISTRATION



PROJECT TEAM

ARCHITECT FINKLE+WILLIAMS
ARCHITECTURE

CIVIL GBA ENGINEERS

LANDSCAPE LAND 3

STRUCTURAL BOB D. C.

PLUMBING LATIMER SOMMERS

MECHANICAL LATIMER SOMMERS

ELECTRICAL LATIMER SOMMERS

FIRE PROTECTION LATIMER SOMMERS

CONTRACTOR BRINKMANN
CONSTRUCTORS



SHEET TITLE

ELECTRICAL DETAILS/SCHEDULES

SHEET NUMBER

E3.01