




1 SITE PLAN
SCALE: 1" = 30'-0"

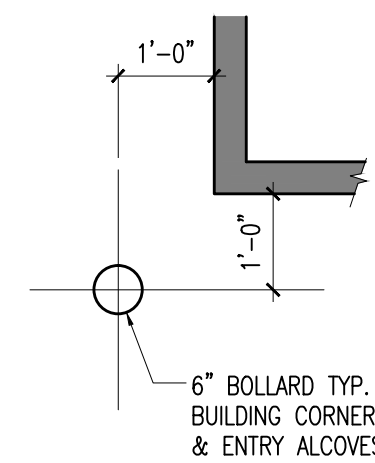

2 BOLLARD DETAIL
SCALE: 1/2" = 1'-0"

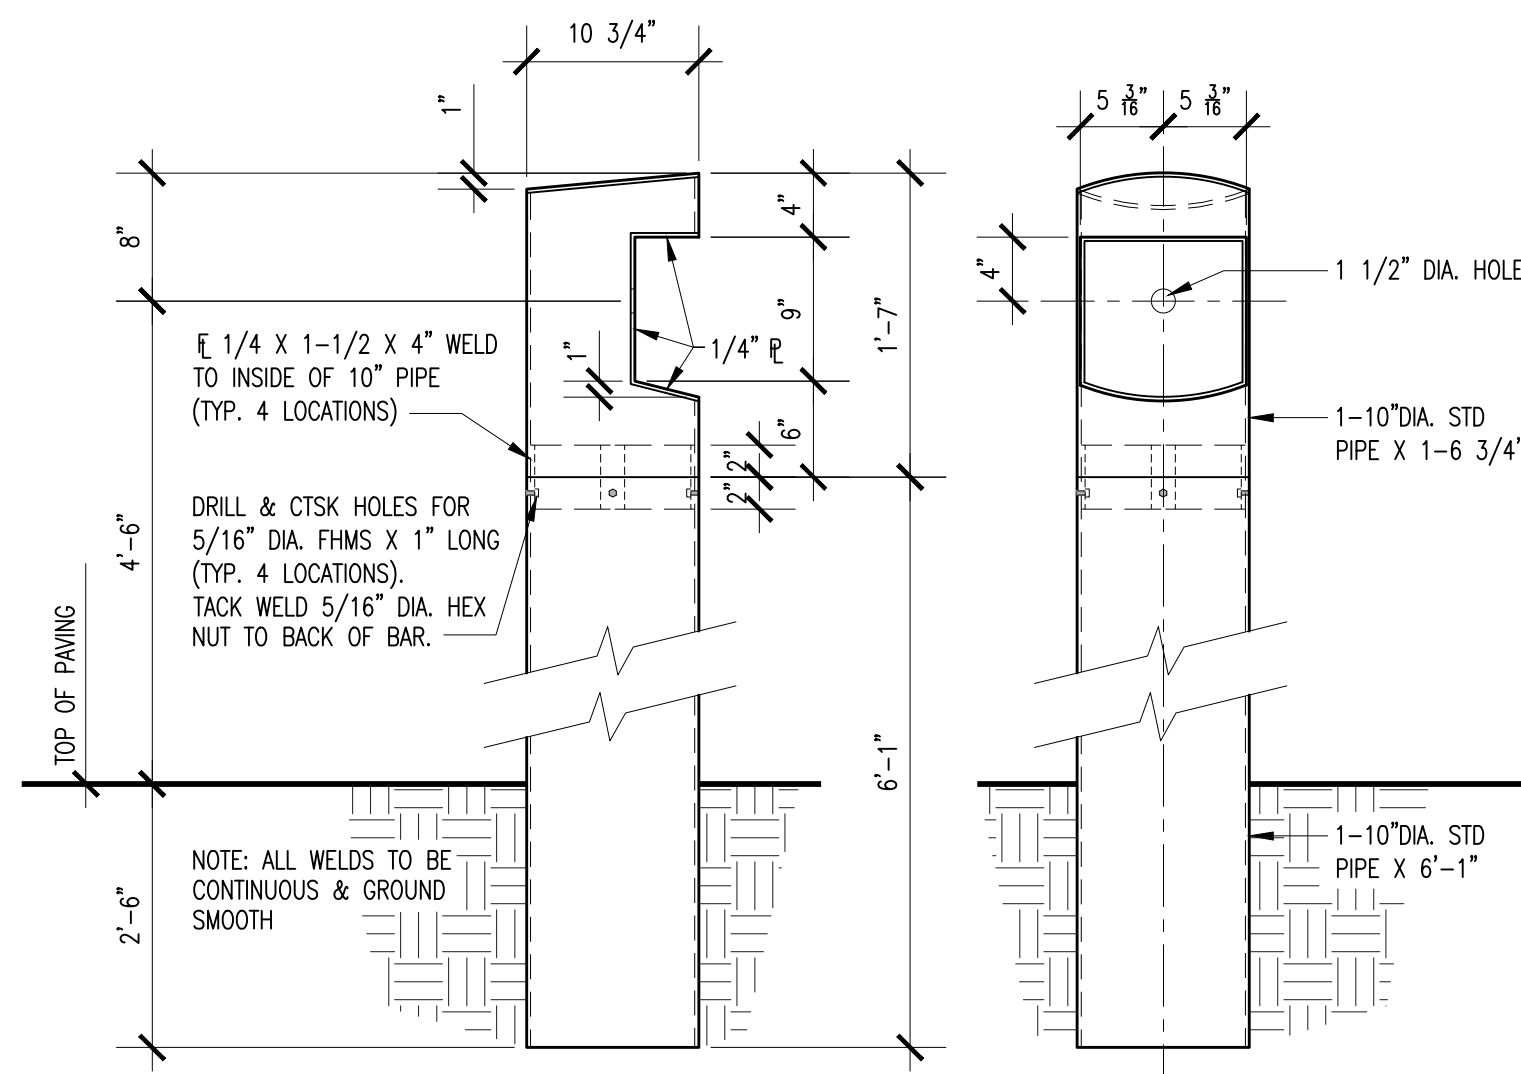

3 KEYPAD BOLLARD DETAIL
SCALE: 1/2" = 1'-0"

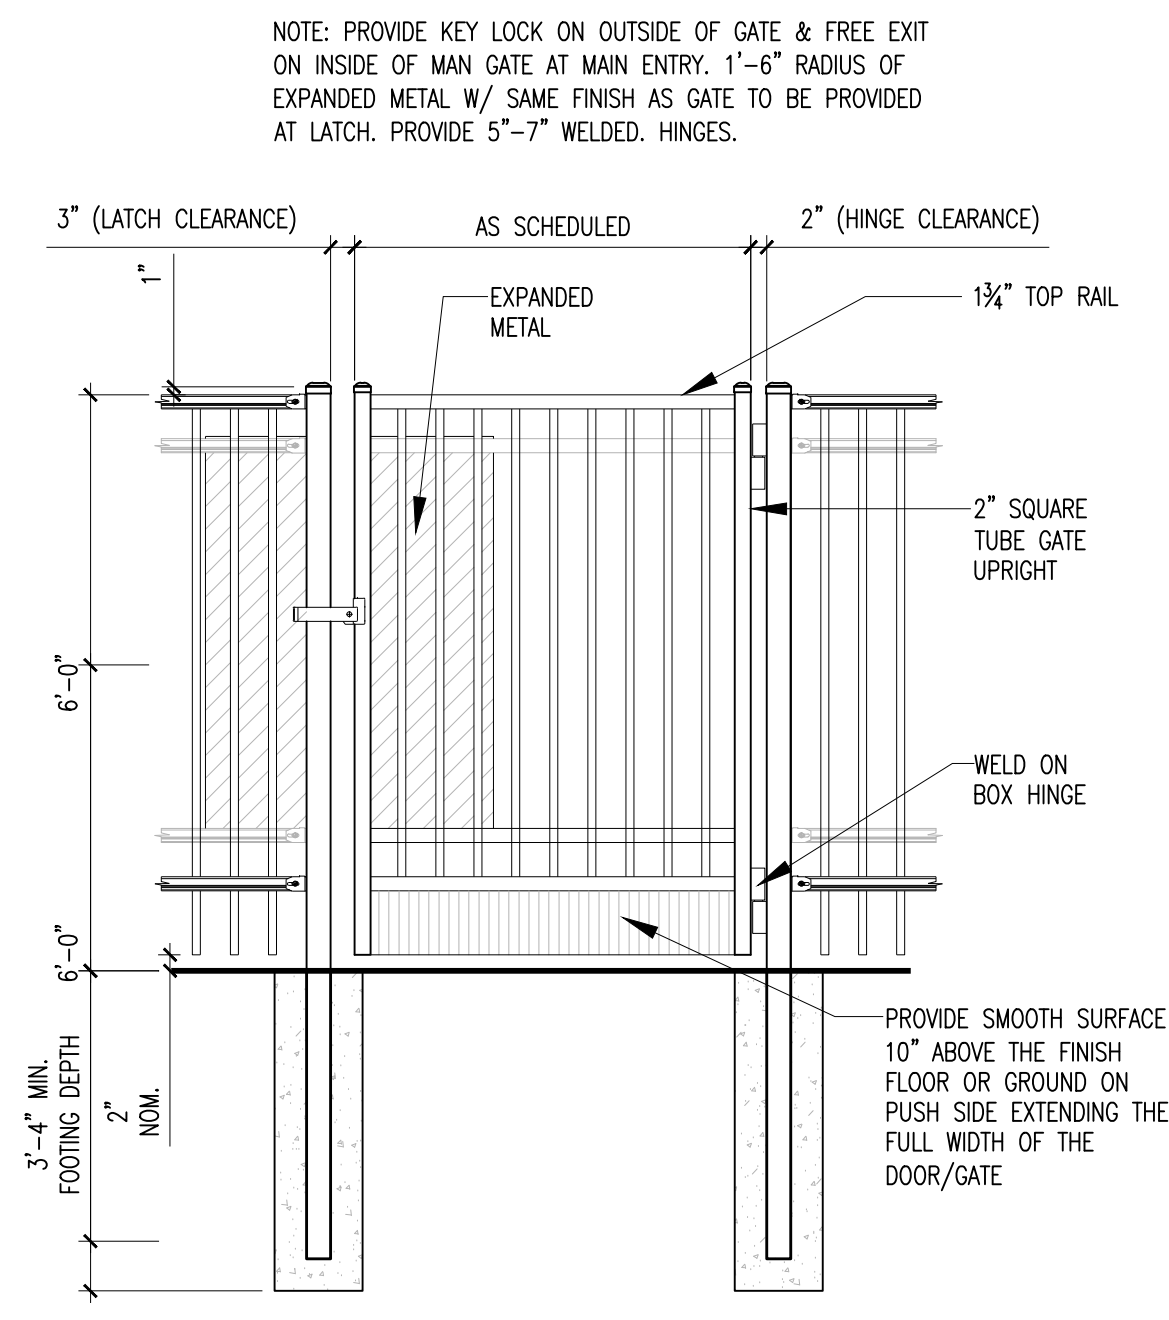

4 IRON MAN GATE ELEVATIONS
SCALE: 1/2" = 1'-0"

SITE PLAN LEGEND	
	BUFFERS/ EASEMENTS
	PROPERTY LINES
	6'-0" HIGH, ORNAMENTAL IRON FENCE
	LARGE STONE BORDER -REF. CIVIL DRAWINGS
	CONCRETE PAVING -REF. CIVIL DWGS.
	LANDSCAPE AREA -REF. LANDSCAPE DRAWINGS
	6" STEEL PIPE BOLLARD -REF. 2/A1.1
	4" STRIPES PAINTED ON PAVING AT 2'-0" O.C.
	KNOX BOX - MODEL #3261 PER CITY REQUIREMENTS
SITE PLAN NOTES	
1. REFER CIVIL DRAWINGS FOR RECORDED PLAT/SURVEY FOR PROPERTY BOUNDARIES, EASEMENTS, SETBACKS, ETC. REPORT ANY DISCREPANCIES TO ARCHITECT PRIOR TO CONSTRUCTION.	
2. REFER CIVIL DRAWINGS FOR ALL DRIVE, PARKING, AND CURB LOCATIONS, DETAILS, AND DIMENSIONAL INFORMATION.	
3. NOT USED.	
4. PROVIDE CONCRETE FILLED STEEL TUBE BOLLARD AT BUILDING CORNERS AND BUILDING ENTRIES AT DRIVE AREAS (REF. DETAIL 2/A1.1 FOR LOCATIONS, CIVIL FOR DETAIL).	
5. REFER LANDSCAPE DRAWINGS FOR EXTENTS OF REQUIRED LANDSCAPING.	
6. SECURITY CONTRACTOR TO PROVIDE MANUAL FAIL SAFE OPERATION, KEY BOX, AND 20'-0" GATE OPENING FOR ELECTRICAL GATE PER FIRE MARSHALL REQUIREMENTS.	

LAKEWOOD STORAGE

NE PORT DRIVE
LEE'S SUMMIT, MISSOURI 64064

PROJECT NO. 2035
DATE: 12.16.2021
DRAWN: VP

REVISIONS:
CITY COMMENTS
01.20.2022


SITE PLAN


SHEET NO.

A1.1


DALLENBACH•COLE
ARCHITECTURE

315 NINTH STREET, SUITE 1
DALLAS, TEXAS 75204
WWW.DALLENBACHCOLE.COM
P 210.493.2234

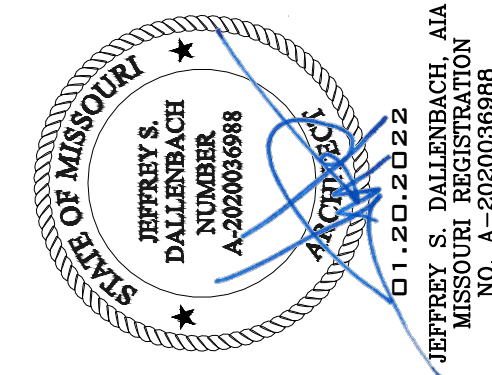


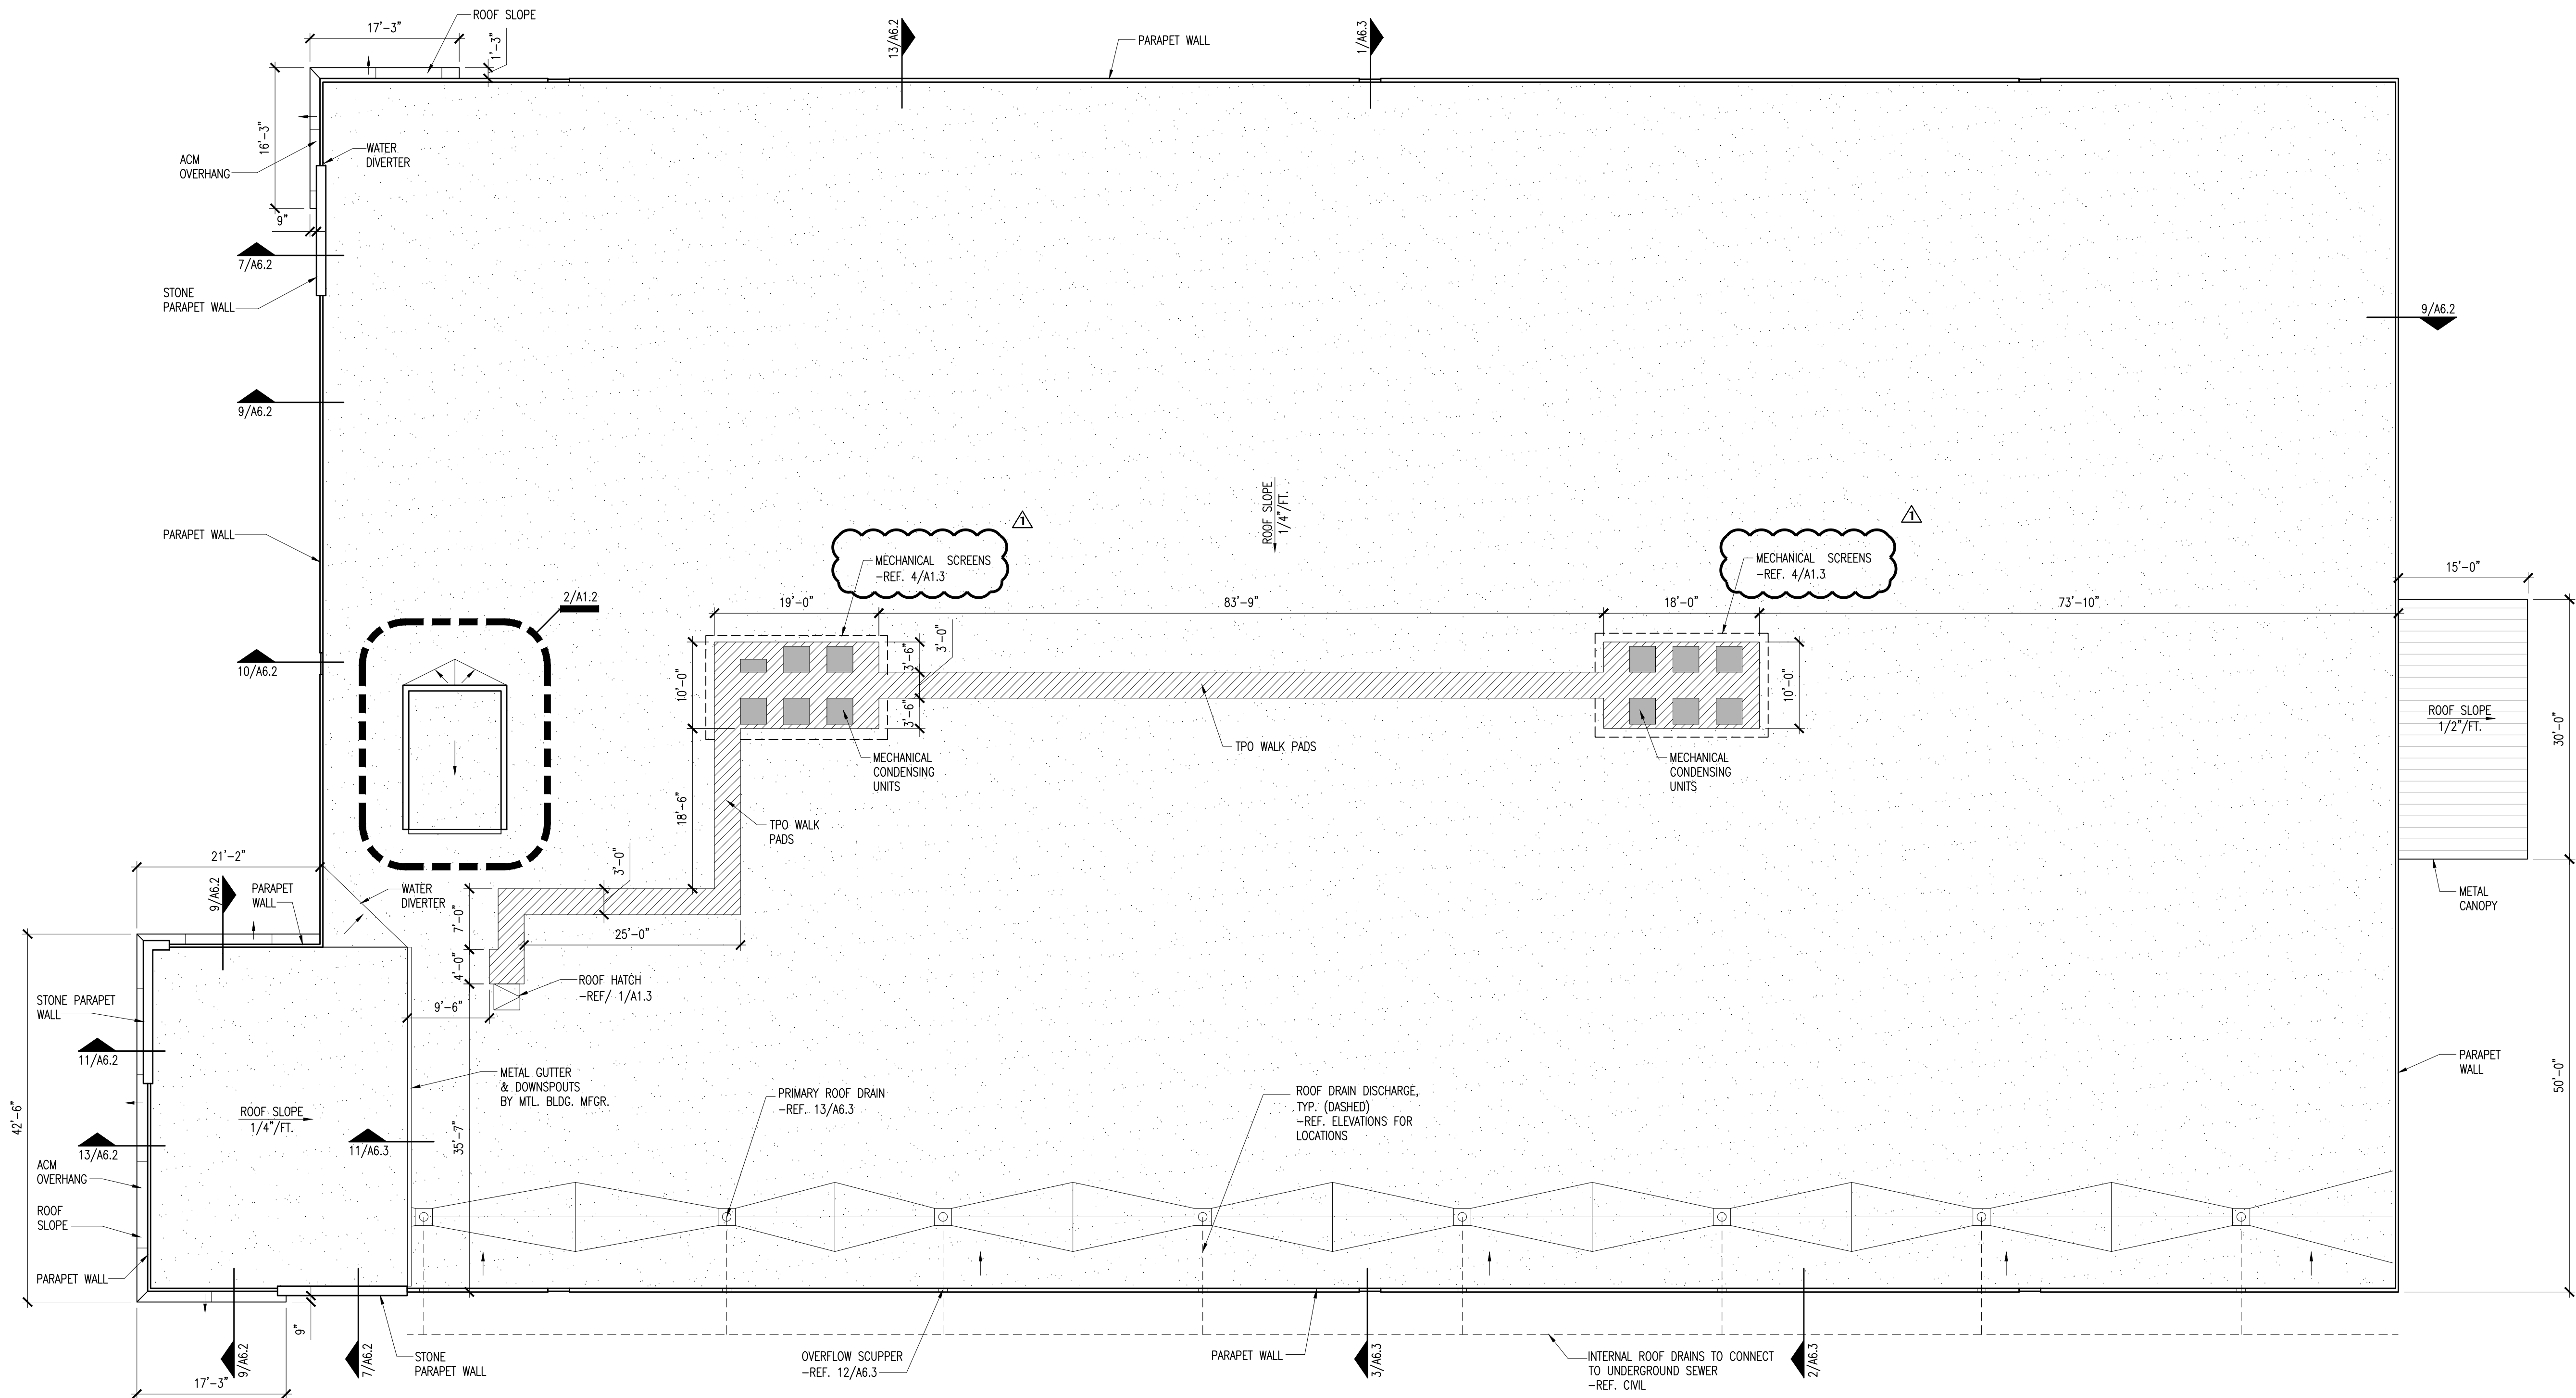


1 ROOF PLAN
SCALE: 3/32" = 1'-0"
PLAN NORTH

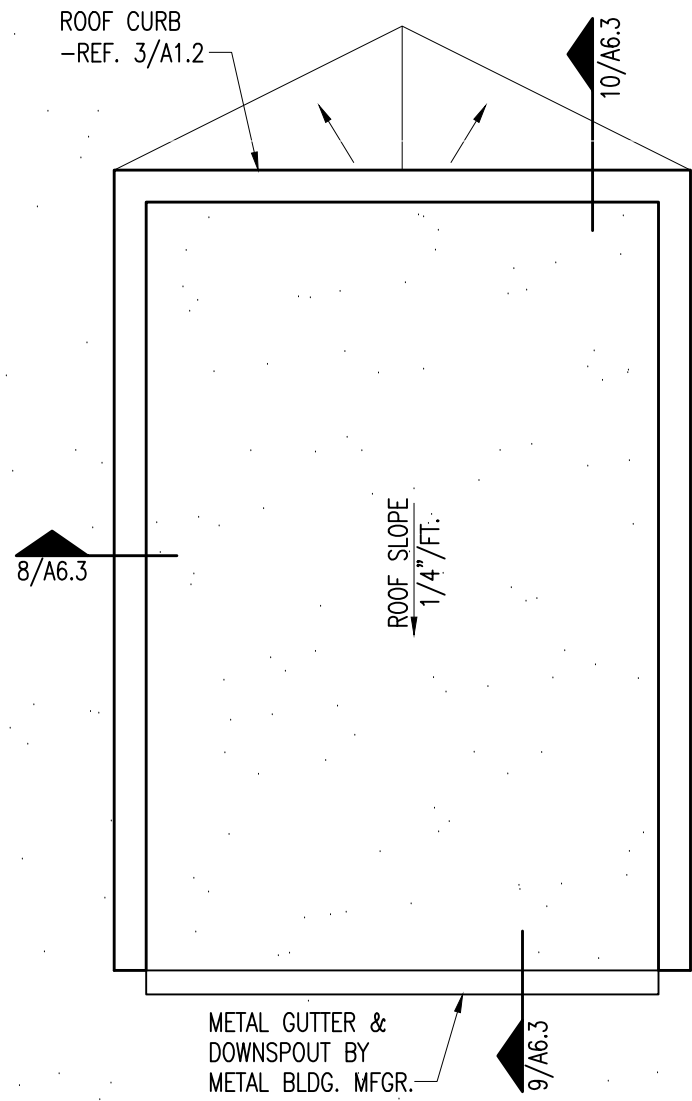

2 ENLARGED ROOF CURB PLAN @ ELEV.
SCALE: 1/4" = 1'-0"
NORTH








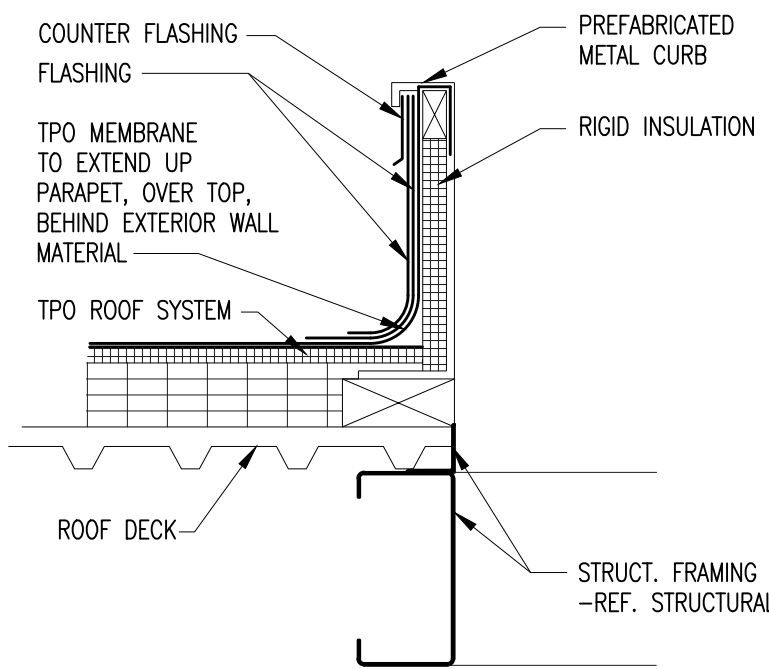


3 ROOF CURB DETAIL
SCALE: NTS

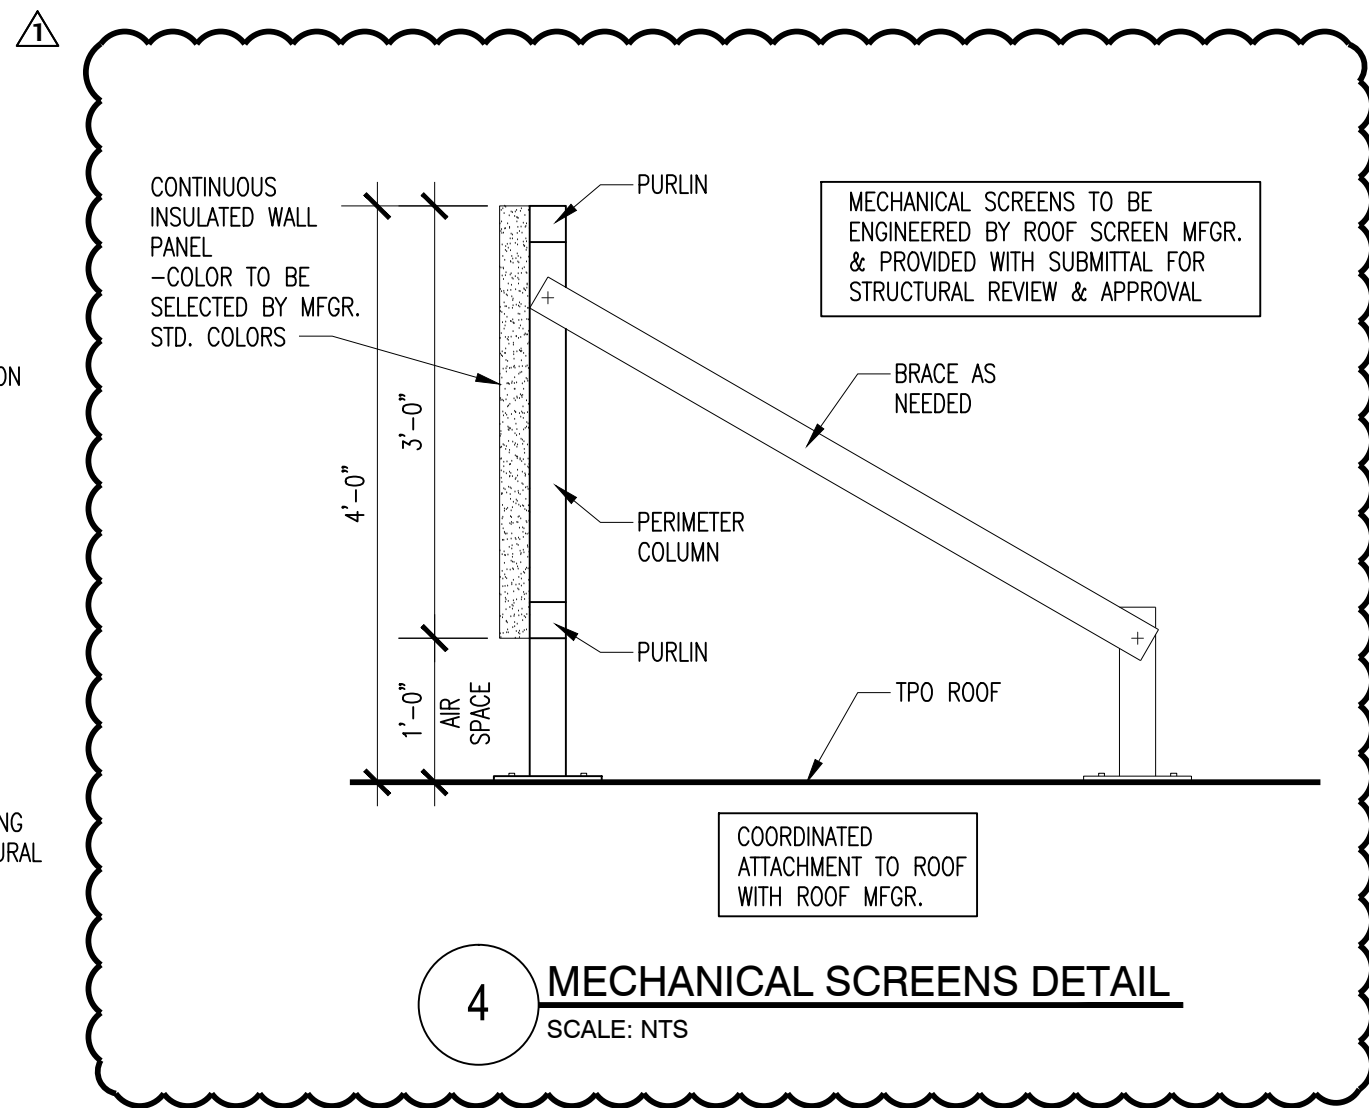

4 MECHANICAL SCREENS DETAIL
SCALE: NTS

ROOF PLAN LEGEND	
	TPO ROOF
	TPO WALK PAD
	MBI BATTENLOK ROOF 24 GA.
ROOF PLAN NOTES	
1. ROOF INSULATION - REFER TO SHEETS A6.1 - A6.5 FOR GENERAL NOTES FOR ROOF INSULATION VALUES.	
2. PRIMARY & SECONDARY INTERNAL ROOF DRAINS TO CONNECT TO UNDERGROUND SEWER & TO BE SIZED/SPACED BY TPO ROOF CONTRACTOR. -REF. CIVIL	
3. TPO ROOF CONTRACTOR TO CONFIRM/EXPAND ON TAPER PATTERN.	
4. MECHANICAL CONDENSING UNITS TO BE BUILT UP SO THAT RACK DOES NOT IMPEDE WATER FLOW.	

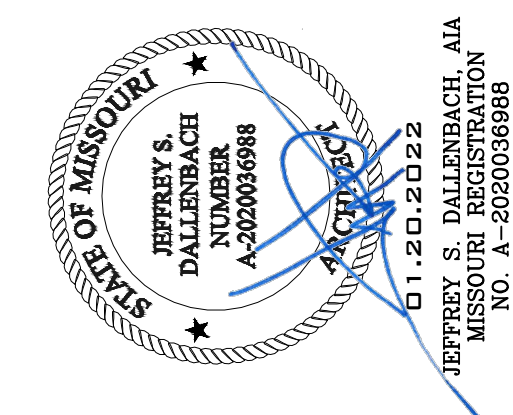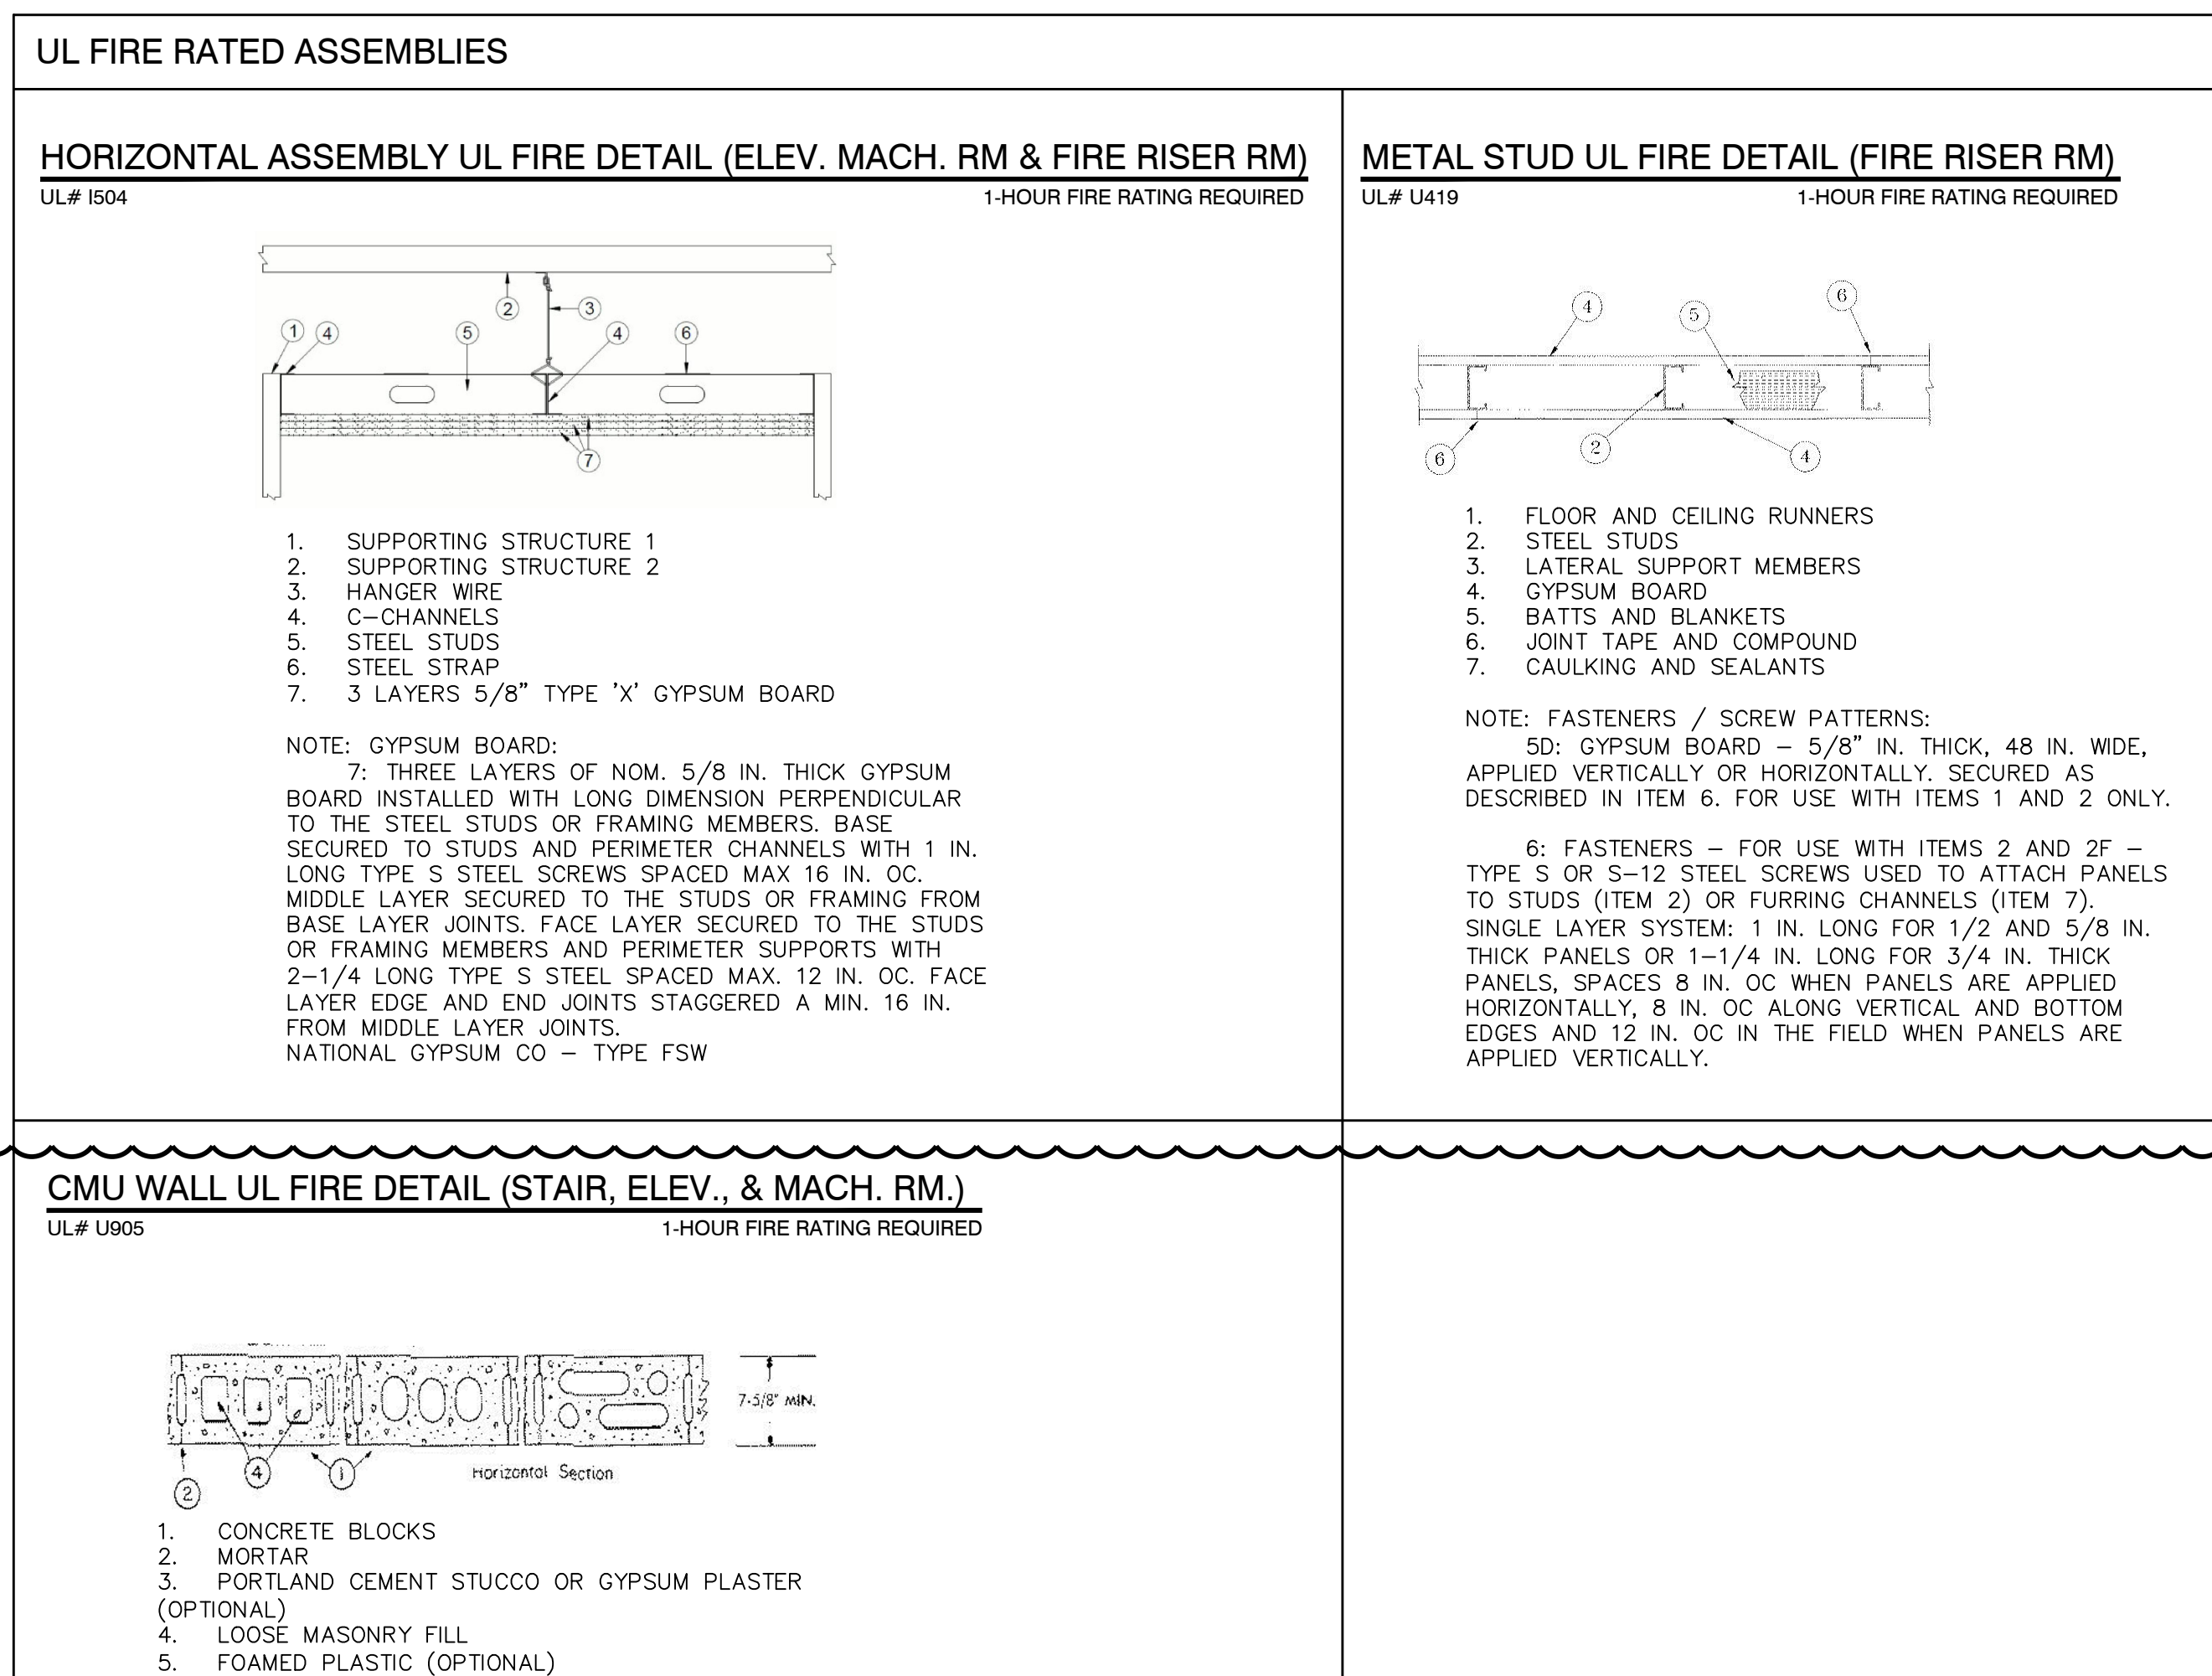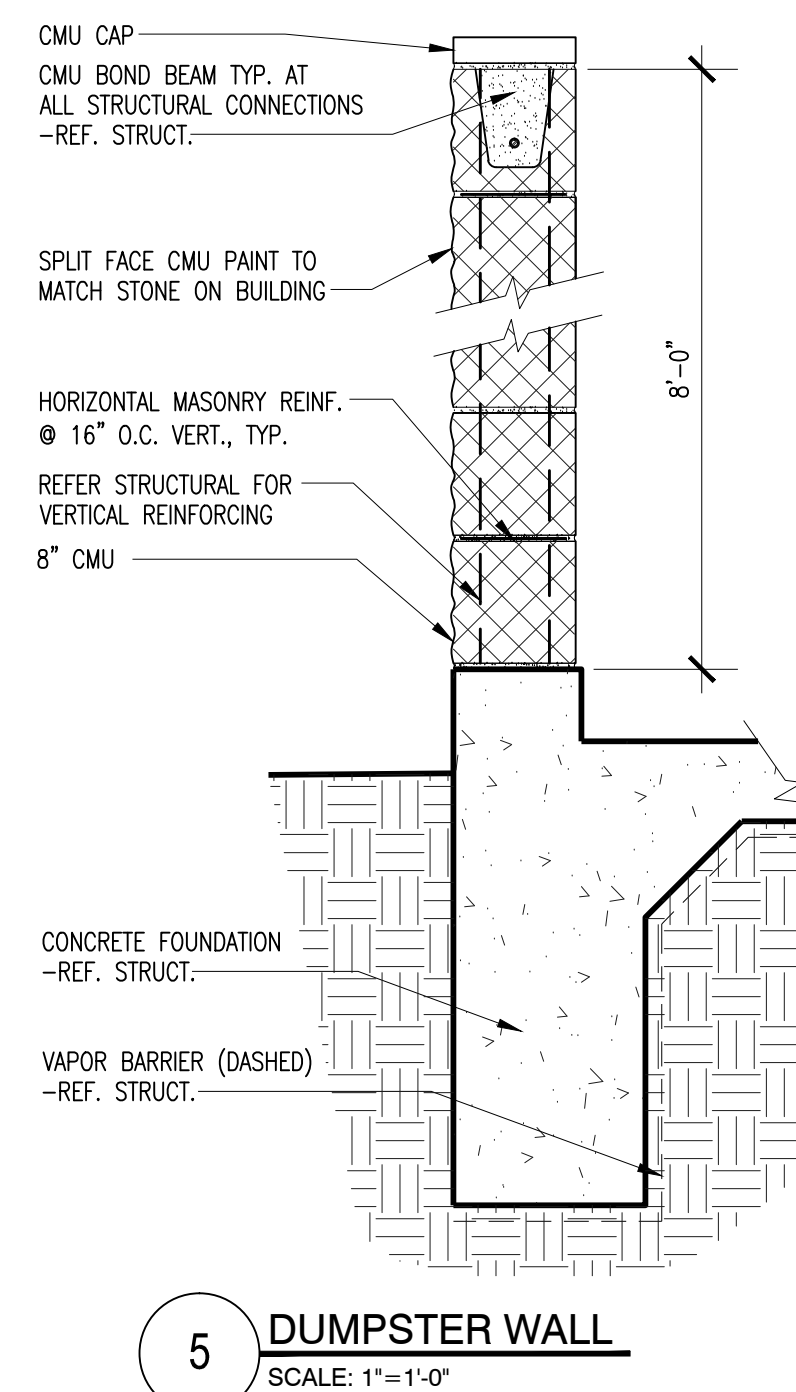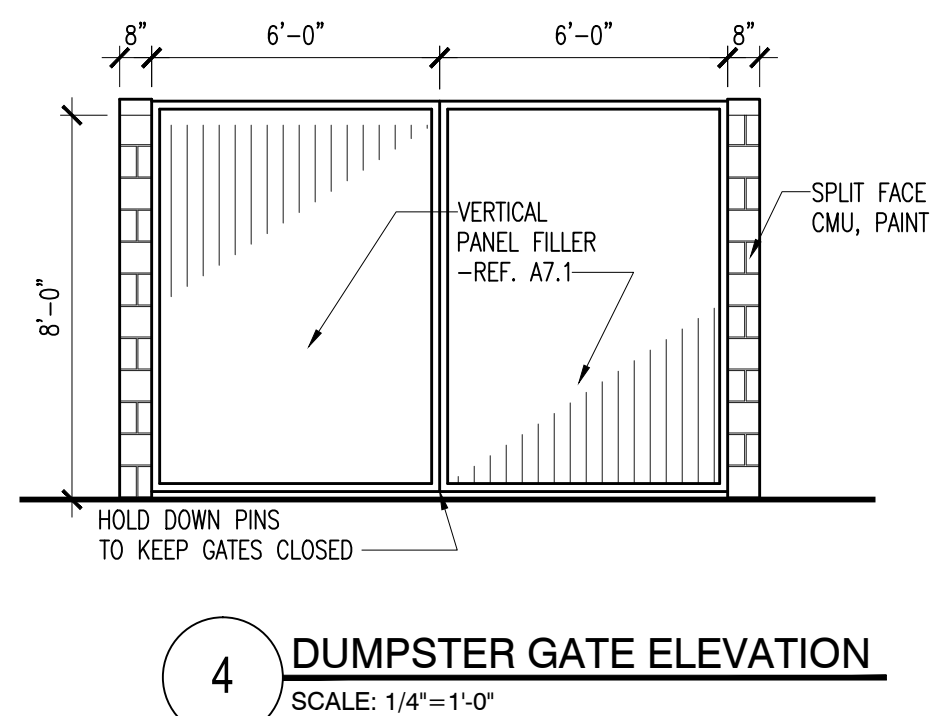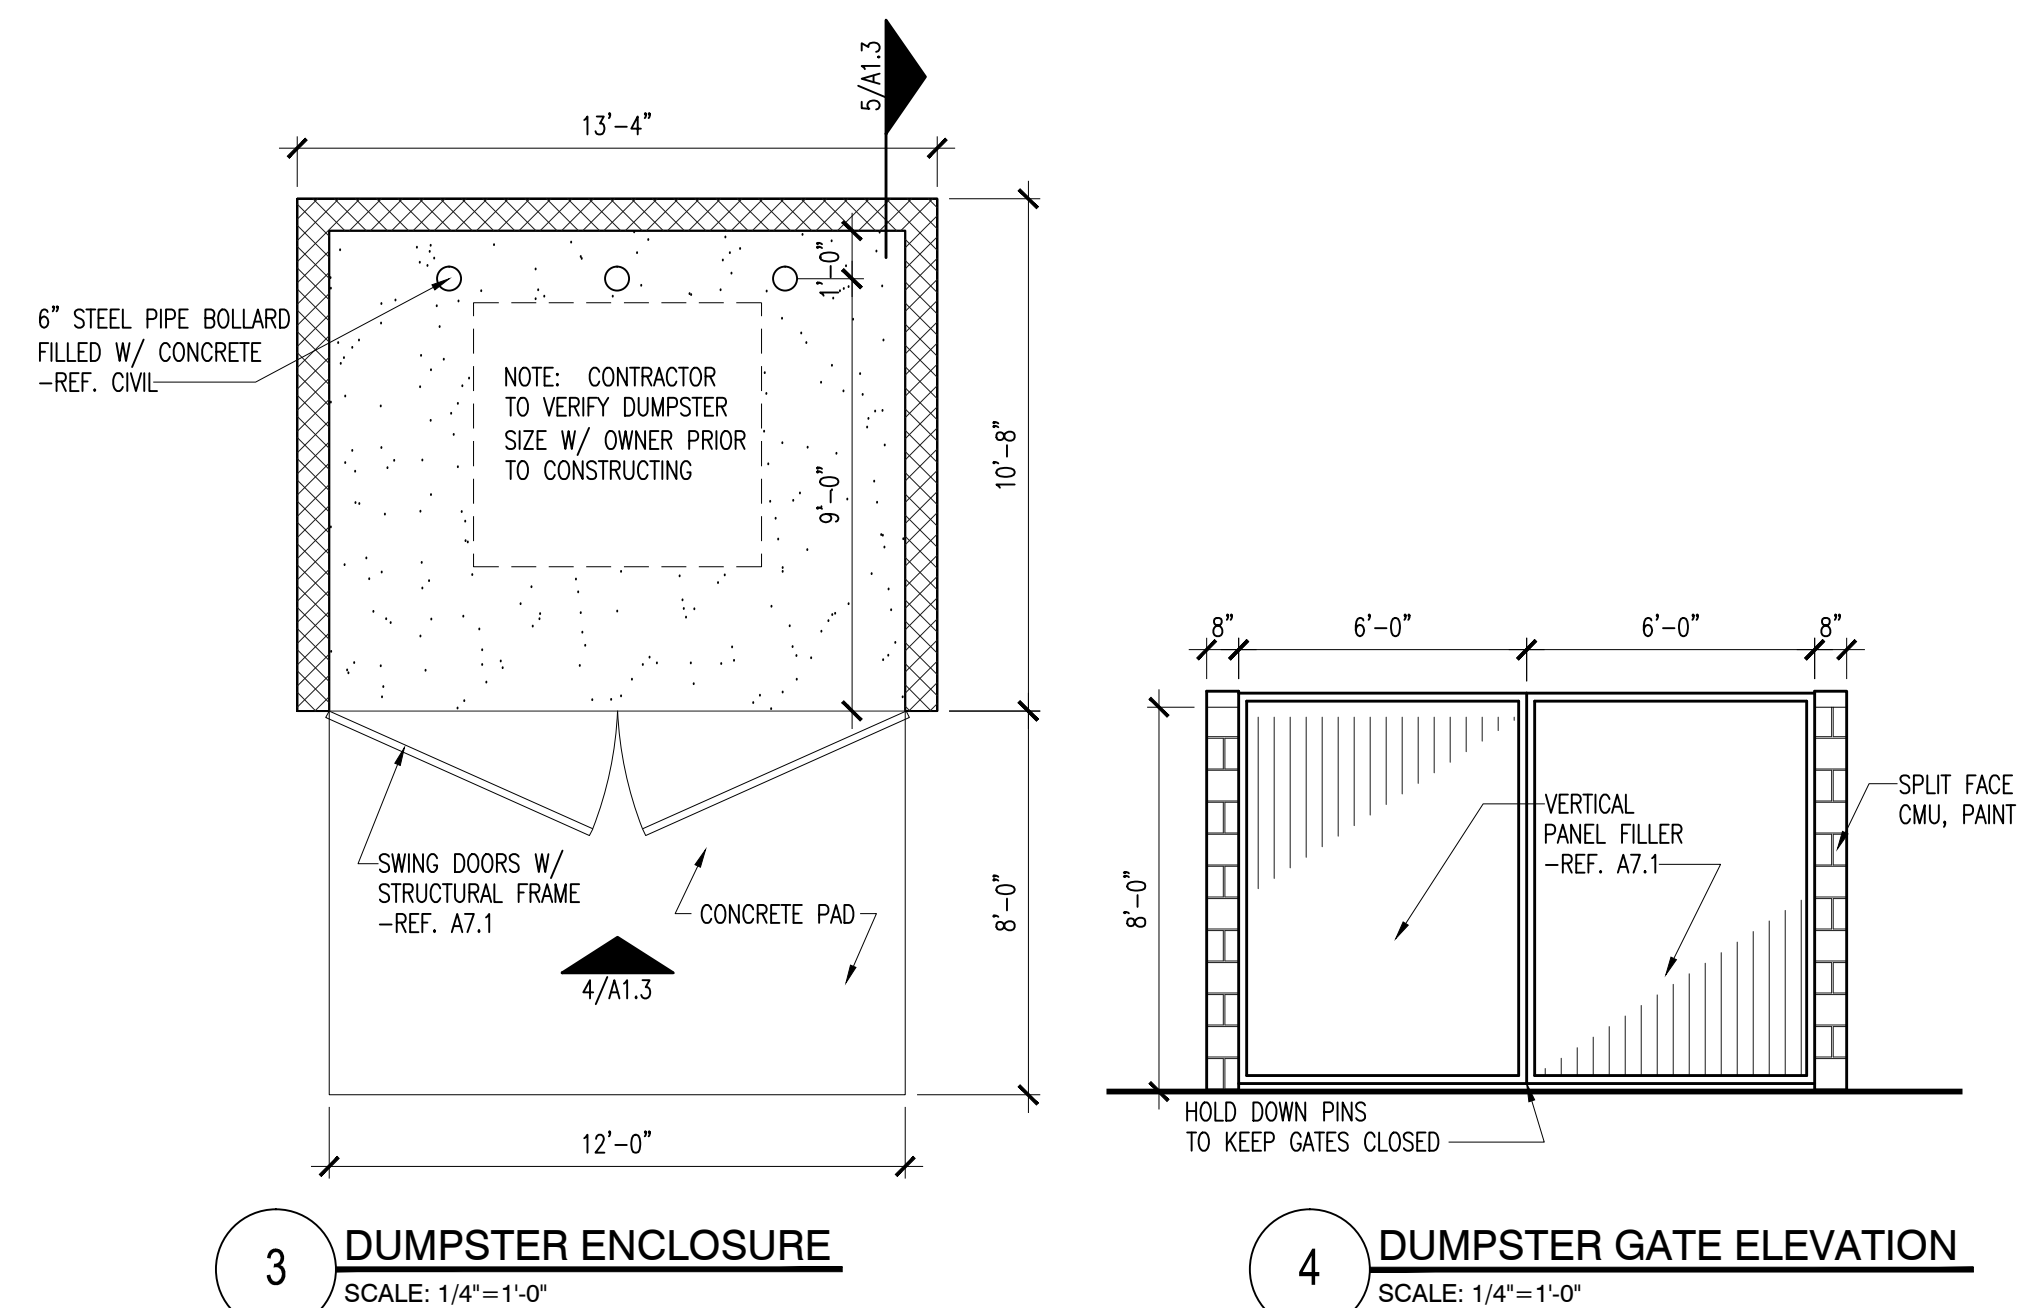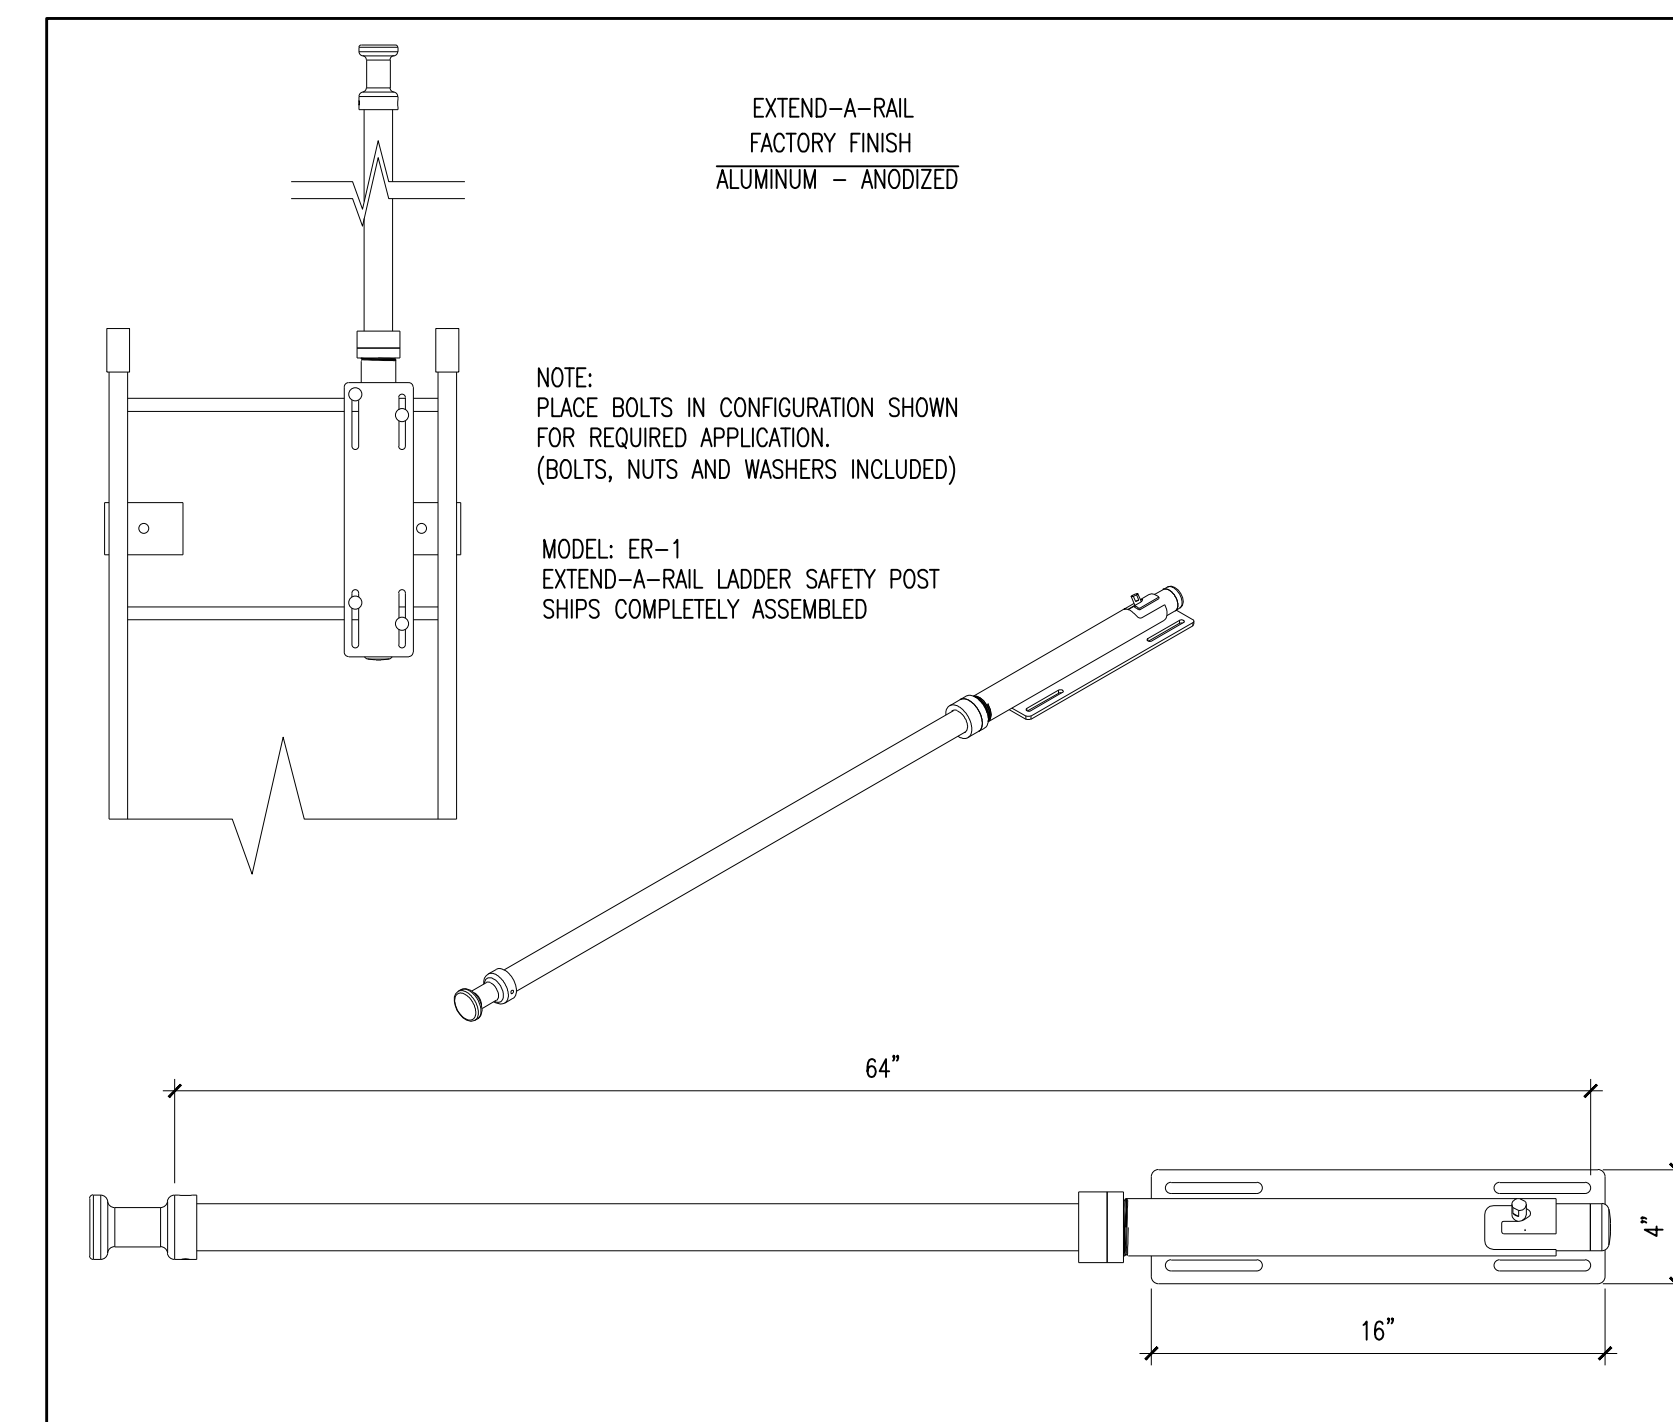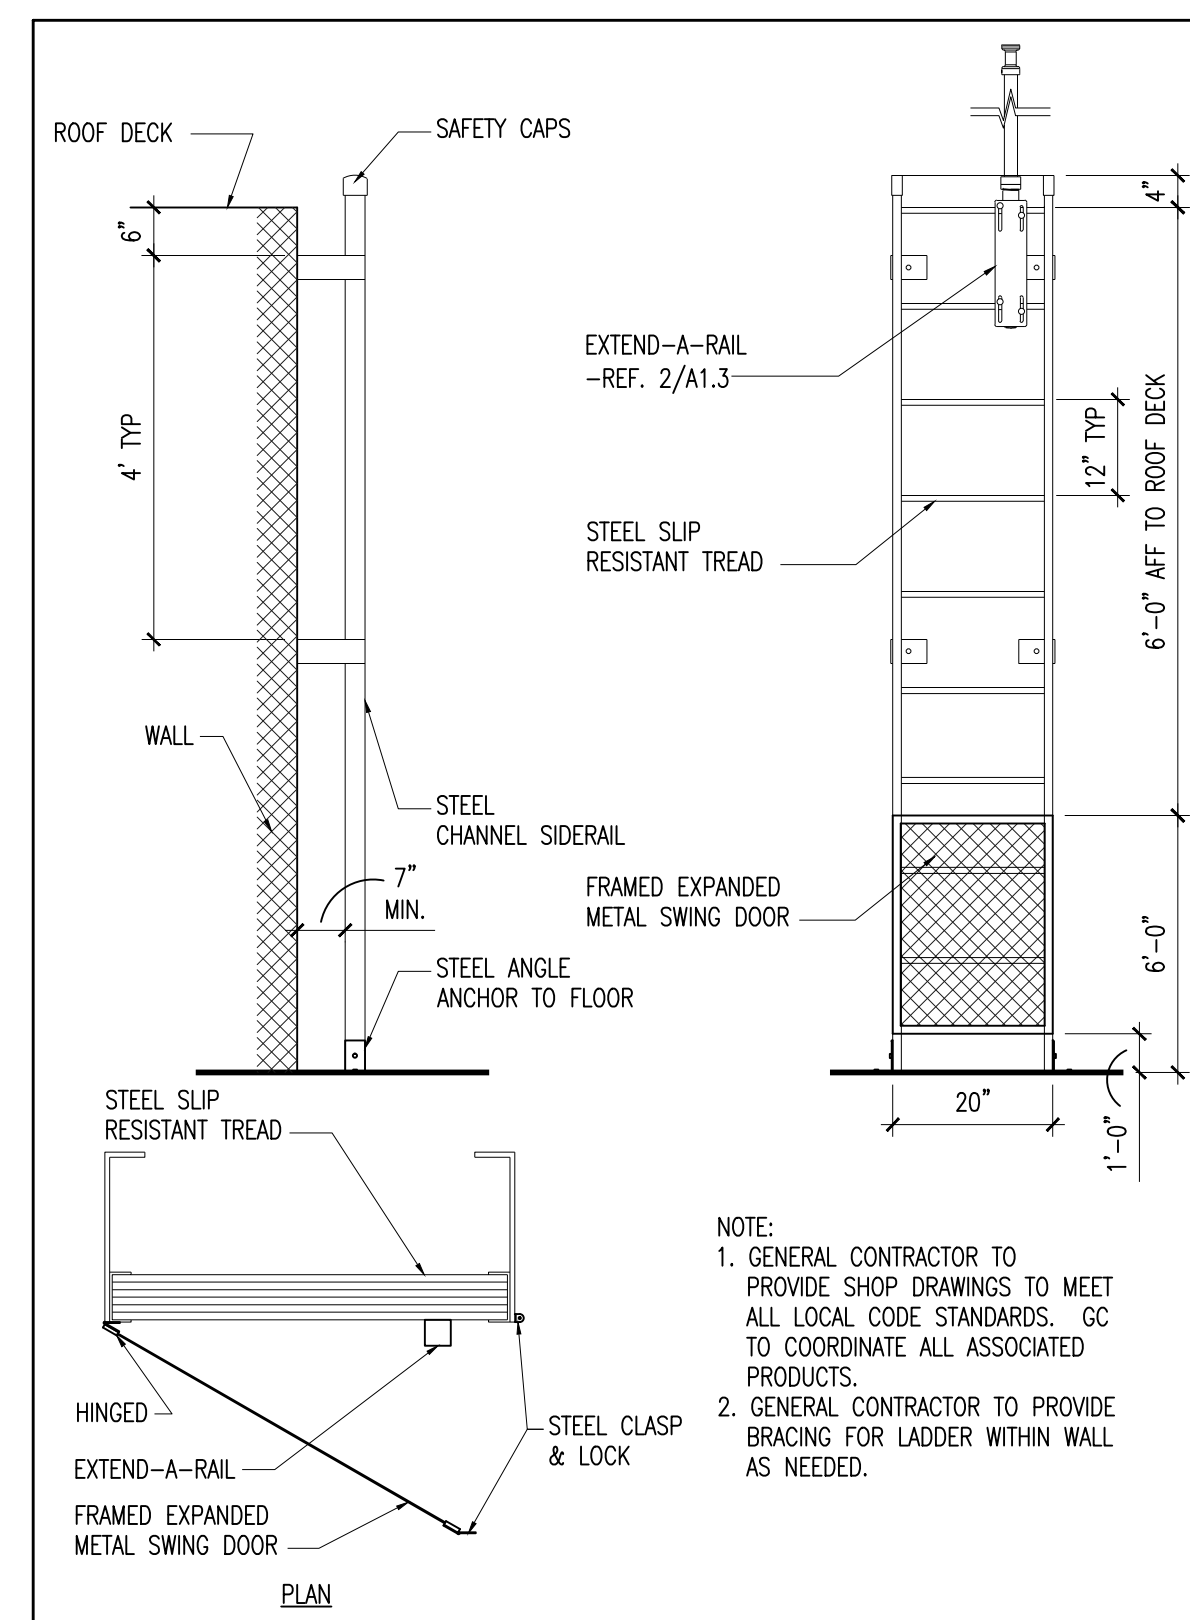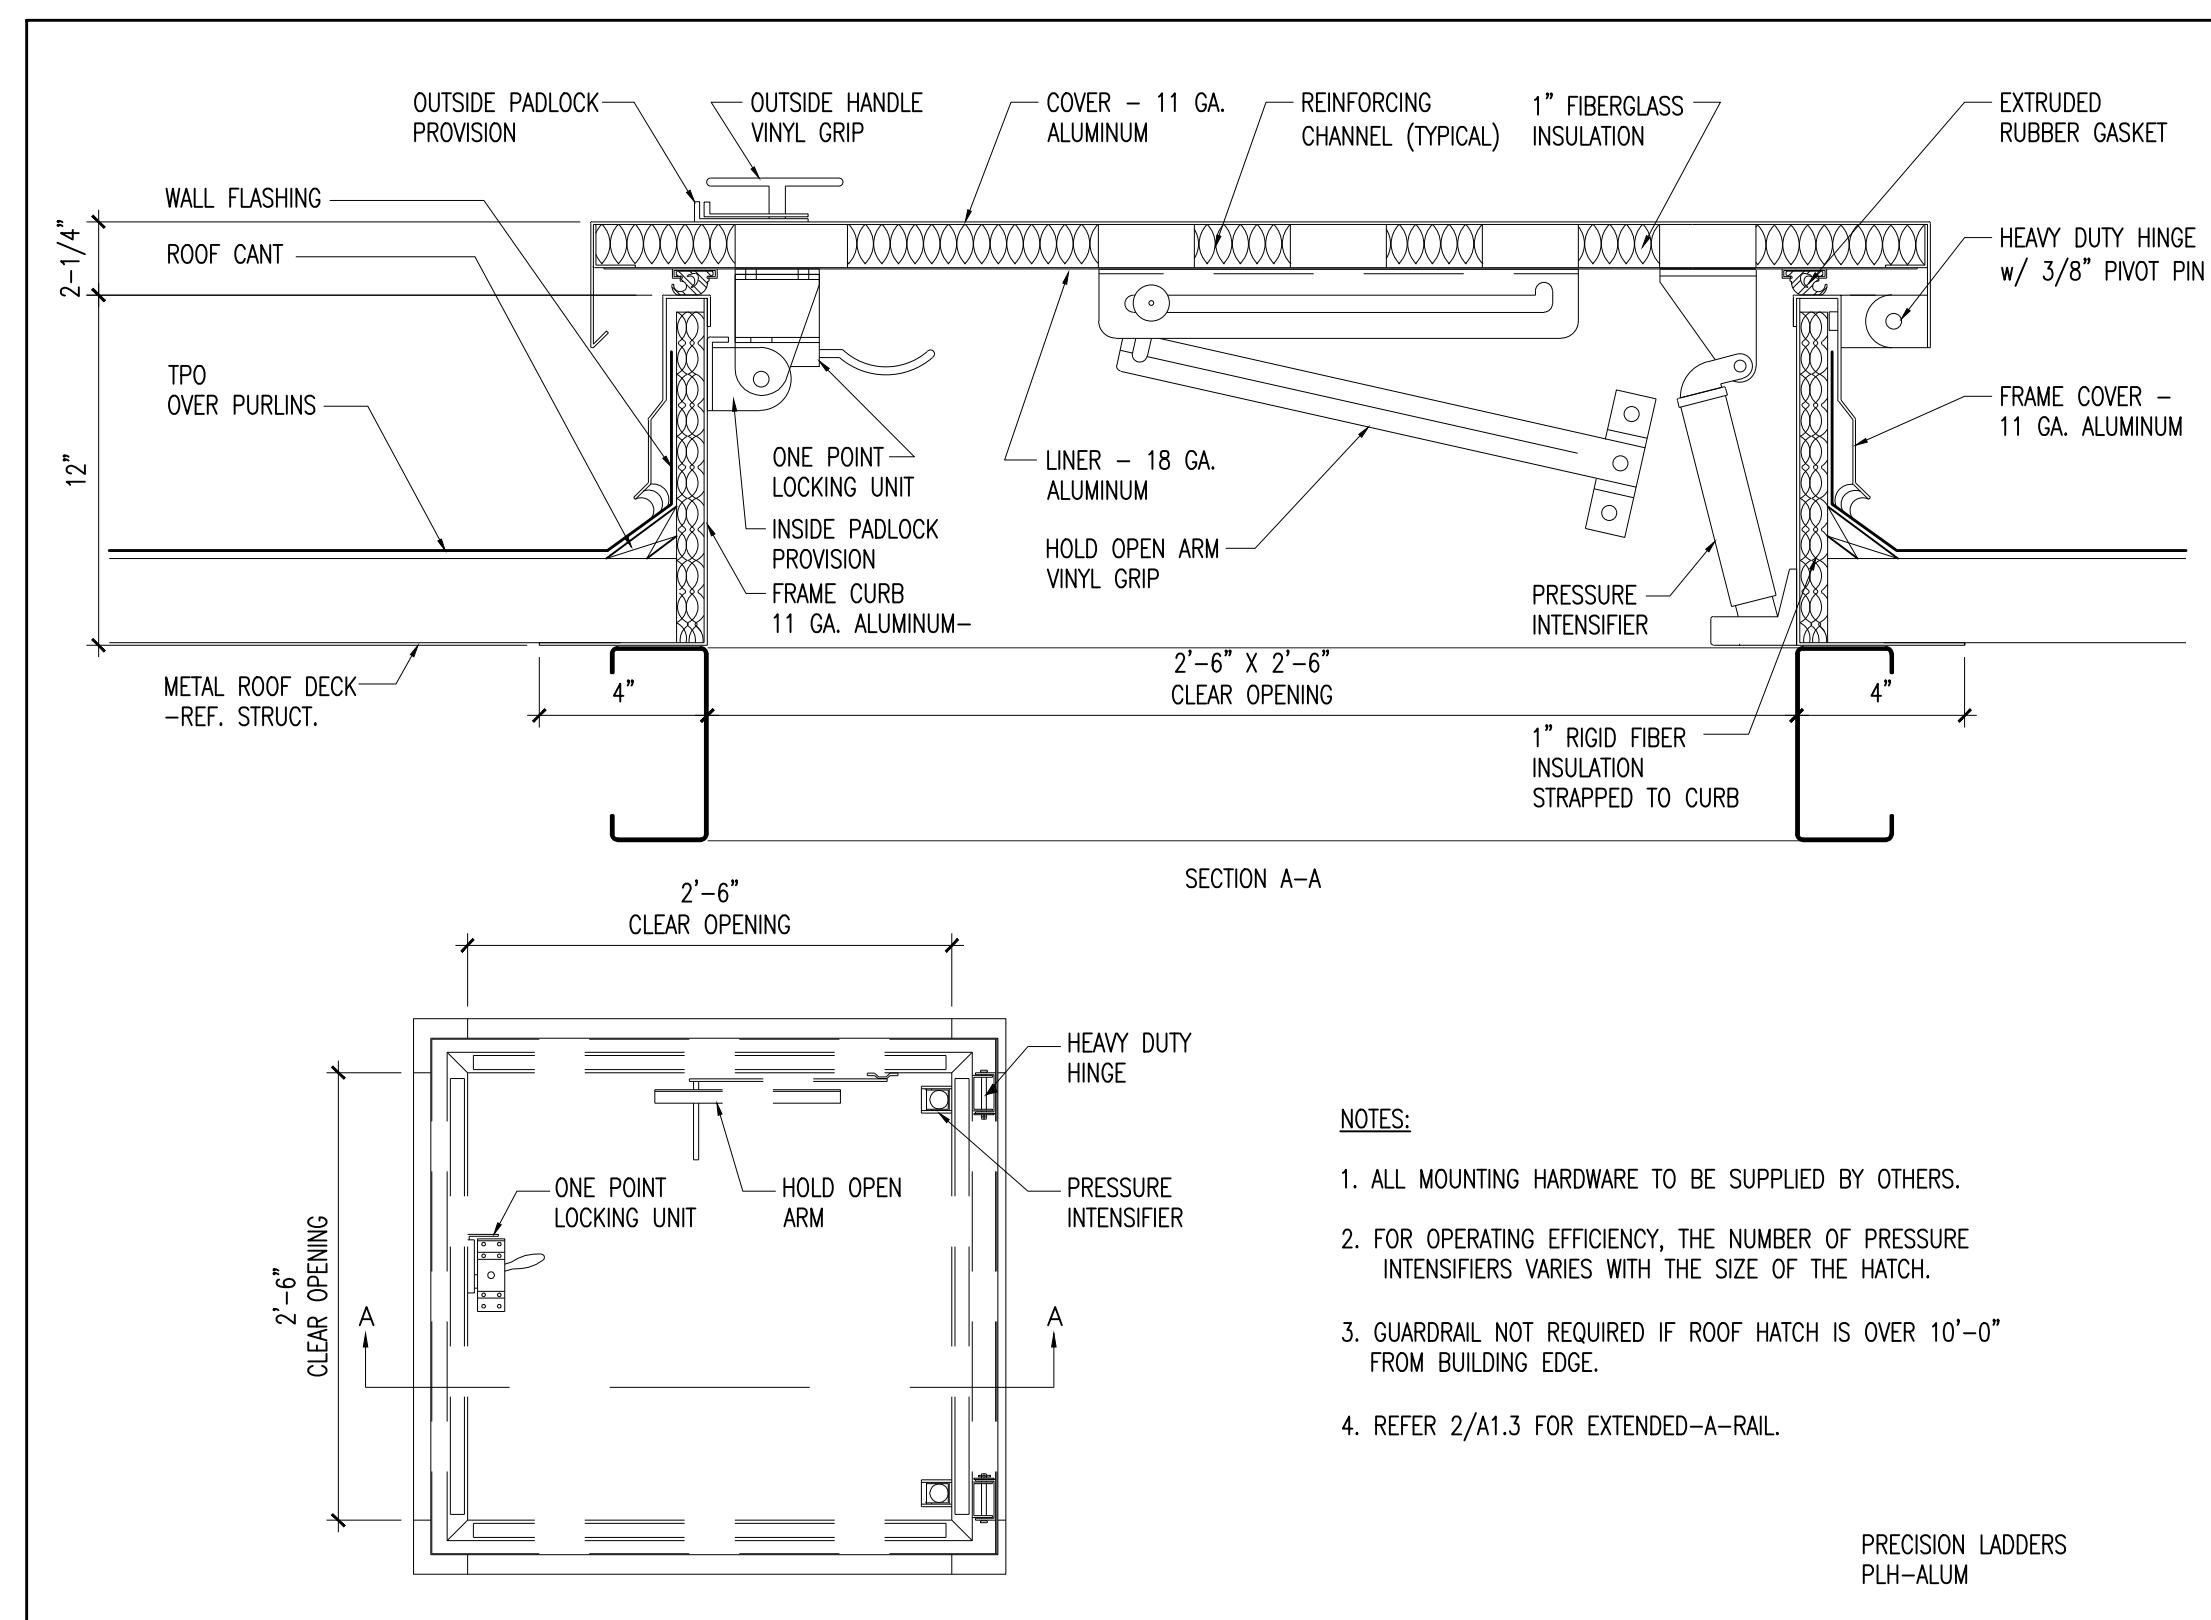

2010 - ADA STANDARDS FOR ACCESSIBLE DESIGN

