

#### FINAL DEVELOPMENT PLAN TRACT D, SUMMIT VIEW FARMS 4TH PLAT 3132 SW SUMMIT VIEW TRL **NEIGHBORHOOD SWIMMING POOL**

**LEGEND:** 

DRIVEWAY CONCRETE PAVEMENT

ASPHALTIC CONCRETE PAVEMENT

SIDEWALK CONCRETE PAVEMENT

**RELEASED FOR** CONSTRUCTION As Noted on Plans Review

LAMP

RYNEARSON

LAMPRYNEARSON.COM

OMAHA, NEBRASKA 14710 W. DODGE RD, STE. 100 (402)496.2498

FORT COLLINS, COLORADO

KANSAS CITY, MISSOURI

9001 STATE LINE RD., STE. 200 (816)361.044

PE - 2008019568

PLAT POOL SSOURI VIEW LEE SUMMIT CITY OF

12-10-2021 - PER CITY COMMENTS

DESIGNER / DRAFTER

OCTOBER 2021 PROJECT NUMBER 0318050.02 BOOK AND PAGE

SHEET

MISSOURI AUTHORIZATION NUMBER F01294734

APPLICANT CONTACT

BILL KENNEY

SUMMIT VIEW FARMS

DEVELOPMENT GROUP, LLC

LEE'S SUMMIT, MO 64063

BILLKENNEY9@GMAIL.COM

(816) 838-0552

P.O. BOX 291

**CONSULTANT CONTACT** DAN MCGHEE LAMP RYNEARSON 9001 STATE LINE ROAD, SUITE 200 KANSAS CITY, MO 64114 DAN.MCGHEE@LAMPRYNEARSON.COM (816) 361-0440

- 1. ALL IMPROVEMENTS SHALL BE CONSTRUCTED IN ACCORDANCE WITH THE CITY'S DESIGN AND CONSTRUCTION MANUAL, AS STATED IN ORDINANCE NO. 5813.
- 2. THE CONTRACTOR SHALL CONTACT THE CITY'S DEVELOPMENT ENGINEERING FIELD ENGINEERING INSPECTORS AT 816-969-1200 PRIOR TO ANY LAND
- 3. THE CONTRACTOR SHALL CONTACT THE CITY'S RIGHT-OF-WAY INSPECTOR AT 816-969-1800 PRIOR TO ANY LAND DISTURBANCE ACTIVITIES WITHIN THE RIGHT-OF-WAY. THESE ACTIVITIES MAY REQUIRE A PERMIT.
- PERMITS ARE ISSUED BY THE DEVELOPMENT ENGINEERING DIVISION AFTER PLANS ARE APPROVED FOR PERMITTING AND FEES ARE PAID.
- WATER MAIN TAPS, 2-IN DIAMETER AND SMALLER, WILL BE MADE BY WATER UTILITIES, OPERATIONS DEPARTMENT 816-969-1900 WITH A FOURTY-EIGHT (48) HOUR PRIOR NOTICE TO SCHEDULE THE TAP.
- 6. ALL PERMANENT CONCRETE CURB SHALL BE STRAIGHT BACK CURB AND GUTTER (TYPE CG-1), WET OR DRY AS INDICATED, UNLESS SHOWN OTHERWISE.
- 7. ALL PRIVATE SANITARY SEWER LATERALS SHALL BE 4-IN PVC, SDR 26, AT 2.0% MINIMUM SLOPE UNLESS NOTED OTHERWISE.
- 8. ALL WATER LINES SHALL HORIZONTALLY CLEAR STORM SEWER STRUCTURES BY 5-FT, SANITARY SEWER STRUCTURES BY 10-FT, AND PIPES BY 18-IN VERTICALLY.
- AT THE HEAD OF EACH ACCESSIBLE PARKING SPACE, PROVIDE A SIGN MEETING THE REQUIREMENTS SET FORTH IN THE MANUAL ON UNIFORM TRAFFIC CONTROL DEVICES (MUTCD). THE SIGN SHALL BE MOUNTED 60-IN (5-FT) ABOVE THE GROUND MEASURED FROM THE BOTTOM OF THE SIGN. THE SIGN SHALL BE 12-IN X 18-IN IN AREA.
- 10. THE SUBJECT SITE LIES WITHIN ZONE "X" (AREAS DETERMINED TO BE OUTSIDE THE 0.2% ANNUAL CHANCE FLOOD) AS DETERMINED BY FEMA FLOOD INSURANCE RATE MAP NUMBER 29095C0531G, WITH A REVISED MAP DATE OF JANUARY 20, 2017.
- THERE ARE NO ABANDONED OIL AND/OR GAS WELLS PRESENT WITHIN THE LIMITS OF THE TRACT, PER THE APPROXIMATE LOCATIONS GIVEN IN THE ONLINE MDNR OIL AND GAS DATABASE UPDATED NOVEMBER 7, 2019.
- 12. THE SUBJECT SITE IS ZONED R-1. THIS USE IS ALLOWED BY THE SINGLE
- 13. ALL SIDEWALK PAVEMENT SURFACES AND CURB SHALL BE KCMMB4K CONCRETE.
- 14. ALL EROSION AND SEDIMENT CONTROL MEASURES SHALL BE IN ACCORDANCE WITH THE CITY'S DESIGN AND CONSTRUCTION MANUAL, SECTION 5100, AS STATED IN ORDINANCE NO. 5813.
- THE UTILITY LOCATIONS SHOWN ON THESE DRAWINGS ARE DESIGN SUMMIT VIEW FARMS 41H PLAT LOCATIONS. IT IS THE CONTRACTOR'S RESPONSIBILITY TO VERIFY THE LOCATION OF ALL UTILITIES (PUBLIC AND PRIVATE, WHETHER SHOWN OR NOT) AND PROTECT SAID UTILITIES FROM ANY DAMAGE.
- 16. SUMMIT VIEW FARMS 4<sup>TH</sup> PLAT PRIVATE INFRASTRUCTURE HAS NOT BEEN CONSTRUCTED. CONTRACTOR SHALL COORDINATE FINAL DEVELOPMENT PLAN IMPROVEMENTS WITH 4<sup>TH</sup> PLAT CONSTRUCTION.

SITE PLAN INFORMATION				
SITE AREA (SF), (AC)	49,874 SF 1.15 AC	TOTAL BUILDING AREA (SF)	1,220 SF	
FLOOR AREA RATIO	0.015	IMPERVIOUS COVERAGE (SF), (%)	19,400 SF 38.9 %	

PARKING TABLE						
USE PARKING LEE'S SUMMIT CODE REQUIREMENT LOTS REQUIRED PROVIDED						
SUBDIVISION POOL	1 PER 16 SUBDIVISION LOTS	120	8	18		
* 1	* 1 ACCESSIBLE PARKING SPACE REQUIRED AND PROVIDED					

#### **GENERAL NOTES:**

- 1. CONTRACTOR IS RESPONSIBLE FOR KEEPING ALL PUBLIC ROADWAYS ADJACENT TO THE CONSTRUCTION SITE FREE OF DIRT AND DEBRIS RESULTING FROM ACTIVITIES RELATED TO THE CONSTRUCTION OF THIS PROJECT.
- 2. ALL WASTE MATERIAL RESULTING FROM THE PROJECT SHALL BE DISPOSED OF OFF-SITE BY THE CONTRACTOR, OR AS DIRECTED BY THE OWNER.
- 3. CONTRACTOR SHALL UTILIZE TEMPORARY CONSTRUCTION ENTRANCE(S) FOR ACCESS TO THE PROJECT AREA.
- 4. CONTRACTOR SHALL REFER TO THE SPECIFIC SWPPP AND MDNR LAND DISTURBANCE PERMIT FOR ADDITIONAL REQUIREMENTS AND BEST MANAGEMENT PRACTICES.
- 5. CONTRACTOR IS TO MAINTAIN ALL EROSION CONTROL INSTALLATIONS.

#### **EROSION AND SEDIMENT CONTROL SEQUENCING:**

- 1. IMPLEMENT PRE-CLEARING: ALL STRUCTURAL BMPS MUST BE IN PLACE BEFORE GENERAL CLEARING OPERATIONS. CLEARING NECESSARY TO PLACE STRUCTURAL BMPS IS THE MINIMUM REQUIRED FOR INSTALLATION. COORDINATE CLEARING NECESSARY TO PLACE STRUCTURAL BMPS WITH LOCAL WEATHER FORECAST SO THAT CLEARING AND PLACEMENT MAY BE COMPLETED WITHIN A FORECAST DRY PERIOD. STABILIZE ALL DIVERSION BERMS AND SEDIMENT TRAPS WITHIN 5 DAYS AFTER INSTALLATION.
- 2. CLEAR AND STABILIZE WORK AREAS: GRADE PARKING AND CONTRACTOR AREAS AND PLACE ALL-WEATHER SURFACE ON CONTRACTOR AREAS.
- 3. BUILDING TOP-OUT: COMPLETE BUILDING FOUNDATION, FRAMING, SEEDING AND ROOF INSTALLATION INCLUDING UTILITY SERVICES
- 4. IMPLEMENT STEEP SLOPE PROTECTION (AS APPLICABLE). DURING GRADING OPERATIONS, PLACE STEEP SLOPE PROTECTION AS SOON AS PRACTICABLE.
- 5. STABILIZE INACTIVE AREAS: THE GROUND COVER AND OTHER STRUCTURAL BMPS MUST BE PLACED WITHIN 14 DAYS OF CESSATION OF GROUND DISTURBING ACTIVITY AT THE LOCATION OF THE BMP. IN DETERMINING THE INACTIVE STATUS OF THE GROUND, EVALUATE EACH PORTION FOR THE SITE SEPARATELY. THE NEED FOR SUBSEQUENT PLACEMENT OF TRENCHED UTILITIES OR OTHER CONSTRUCTION IN AN OTHERWISE INACTIVE AREA IS NOT JUSTIFICATION FOR DELAY OF STABILIZATION.
- 6. COMPLETE PAVEMENT AND STORMWATER IMPROVEMENTS DEPICTED ON THE CONSTRUCTION PLANS.
- 7. IMPLEMENT FINAL STABILIZATION: COORDINATE REMOVAL OF CONSTRUCTION PHASE BMPS NECESSARY TO PLACE FINAL STABILIZATION WITH LOCAL WEATHER FORECAST SO THAT REMOVAL AND PLACEMENT MAY BE COMPLETED WITHIN A FORECAST DRY PERIOD. DOWN—SLOPE PERIMETER CONTROLS SHALL NOT BE REMOVED UNTIL FINAL STABILIZATION IS PLACED AND VEGETATIVE COVER IS ESTABLISHED OVER THE REMAINDER OF THE SITE.
- 8. ESTABLISHMENT AND FINAL CONSTRUCTION: ONCE THE REMAINDER OF THE SITE IS STABILIZED INCLUDING ESTABLISHMENT OF SEEDED COVER TYPES, REMOVE THE SEDIMENT CONTROLS AND THE REMAINING ACCESS CONTROLS. RESTORE AREA DISTURBED BY REMOVAL OF SEDIMENT CONTROLS.
- 9. PLAN MODIFICATION: THE CONTRACTOR MUST MODIFY THE PLAN IF THE PLAN FAILS TO SUBSTANTIALLY CONTROL EROSION AND OFFSITE SEDIMENTATION. THE CONTRACTOR MAY MODIFY THE PLAN OR CONSTRUCTION SEQUENCE IF IMPLEMENTATION IS INFEASIBLE FOR SITE CONDITIONS OR CONTRACTOR METHODS. ANY SUCH MODIFICATIONS SHALL CONTROL EROSION AND OFFSITE SEDIMENTATION TO THE MAXIMUM EXTENT PRACTICABLE. ANY SUCH MODIFICATIONS SHALL REQUIRE THE PRIOR APPROVAL OF THE PERMITTING AUTHORITY.

#### <u>LEGEND</u>

TEMPORARY CONSTRUCTION

SILT FENCE —SF----SF----

INLET FILTERS

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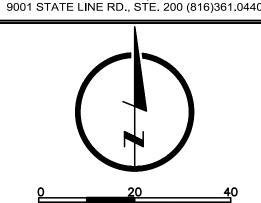
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MARK DANIEL MCGHEE JR. PE - 2008019568

ITROL PLAN SHEET

SUMMIT VIEW FARMS 4TH PLAT POOL



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PE - 2008019568

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ALL UTILITIES ARE SHOWN
BASED ON THE INFORMATION
AVAILABLE TO THE ENGINEER.
THERE IS NO GUARANTEE ALL
FACILITIES ARE SHOWN OR THAT
THE LOCATION, DEPTH, AND
SIZE OF EACH FACILITY IS
CORRECT. THE CONTRACTOR IS
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LINES PRIOR TO CONSTRUCTION.

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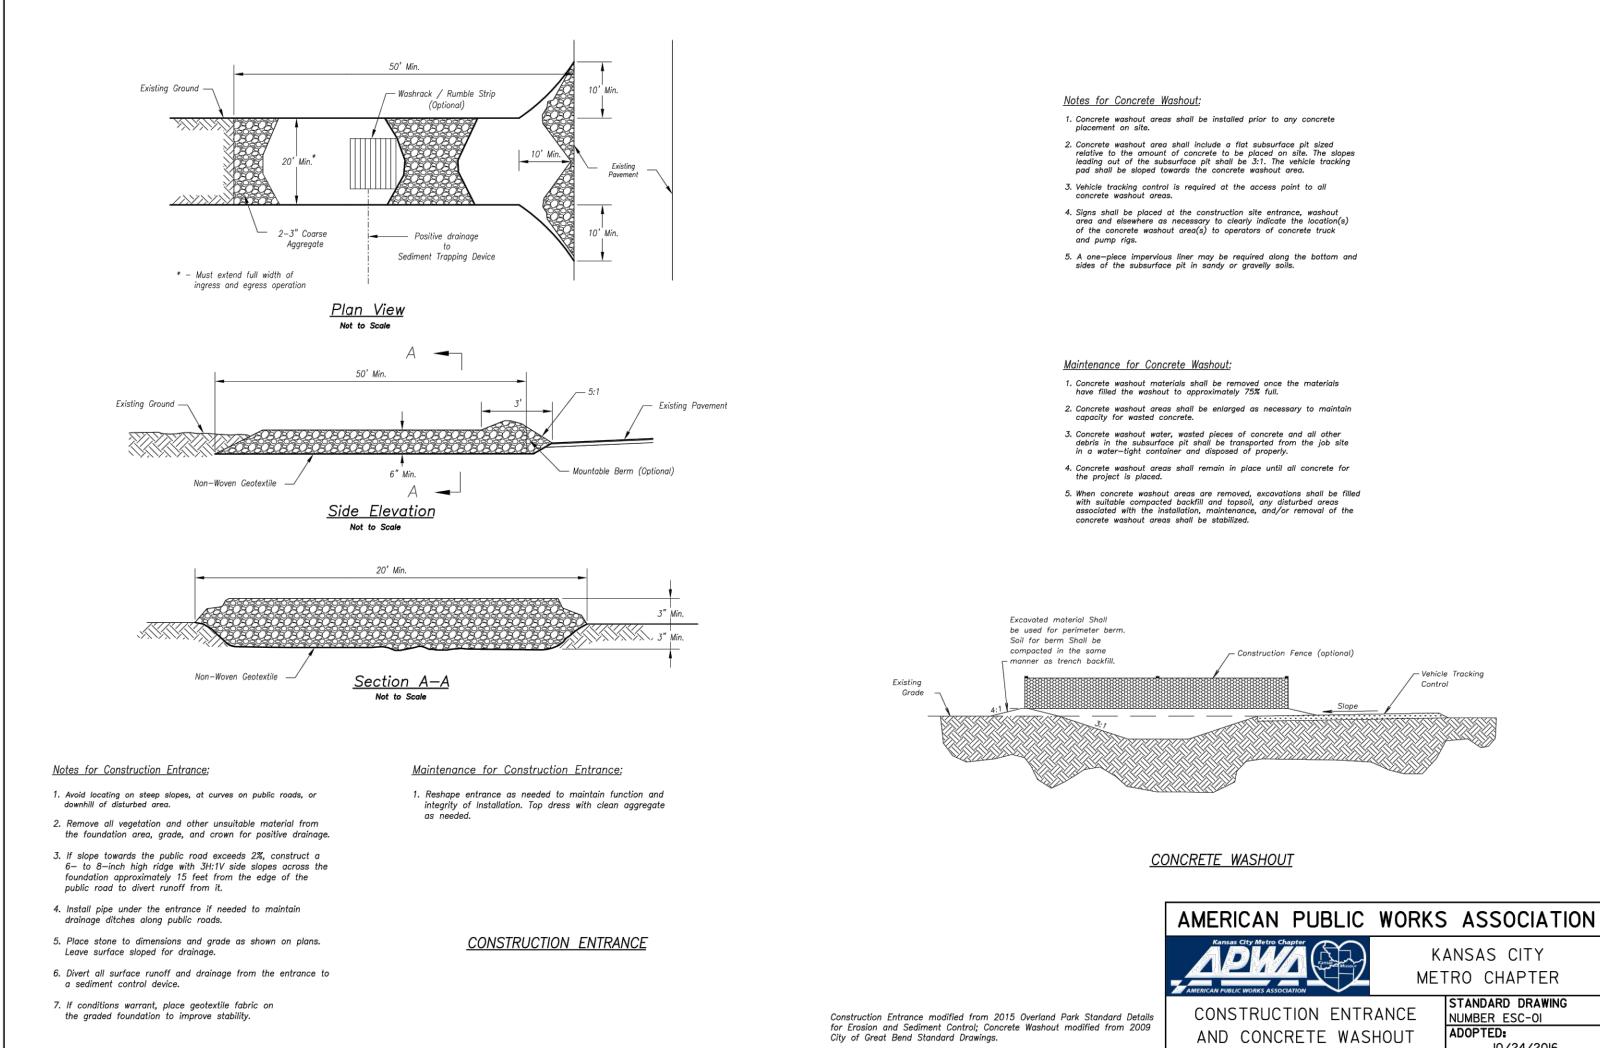
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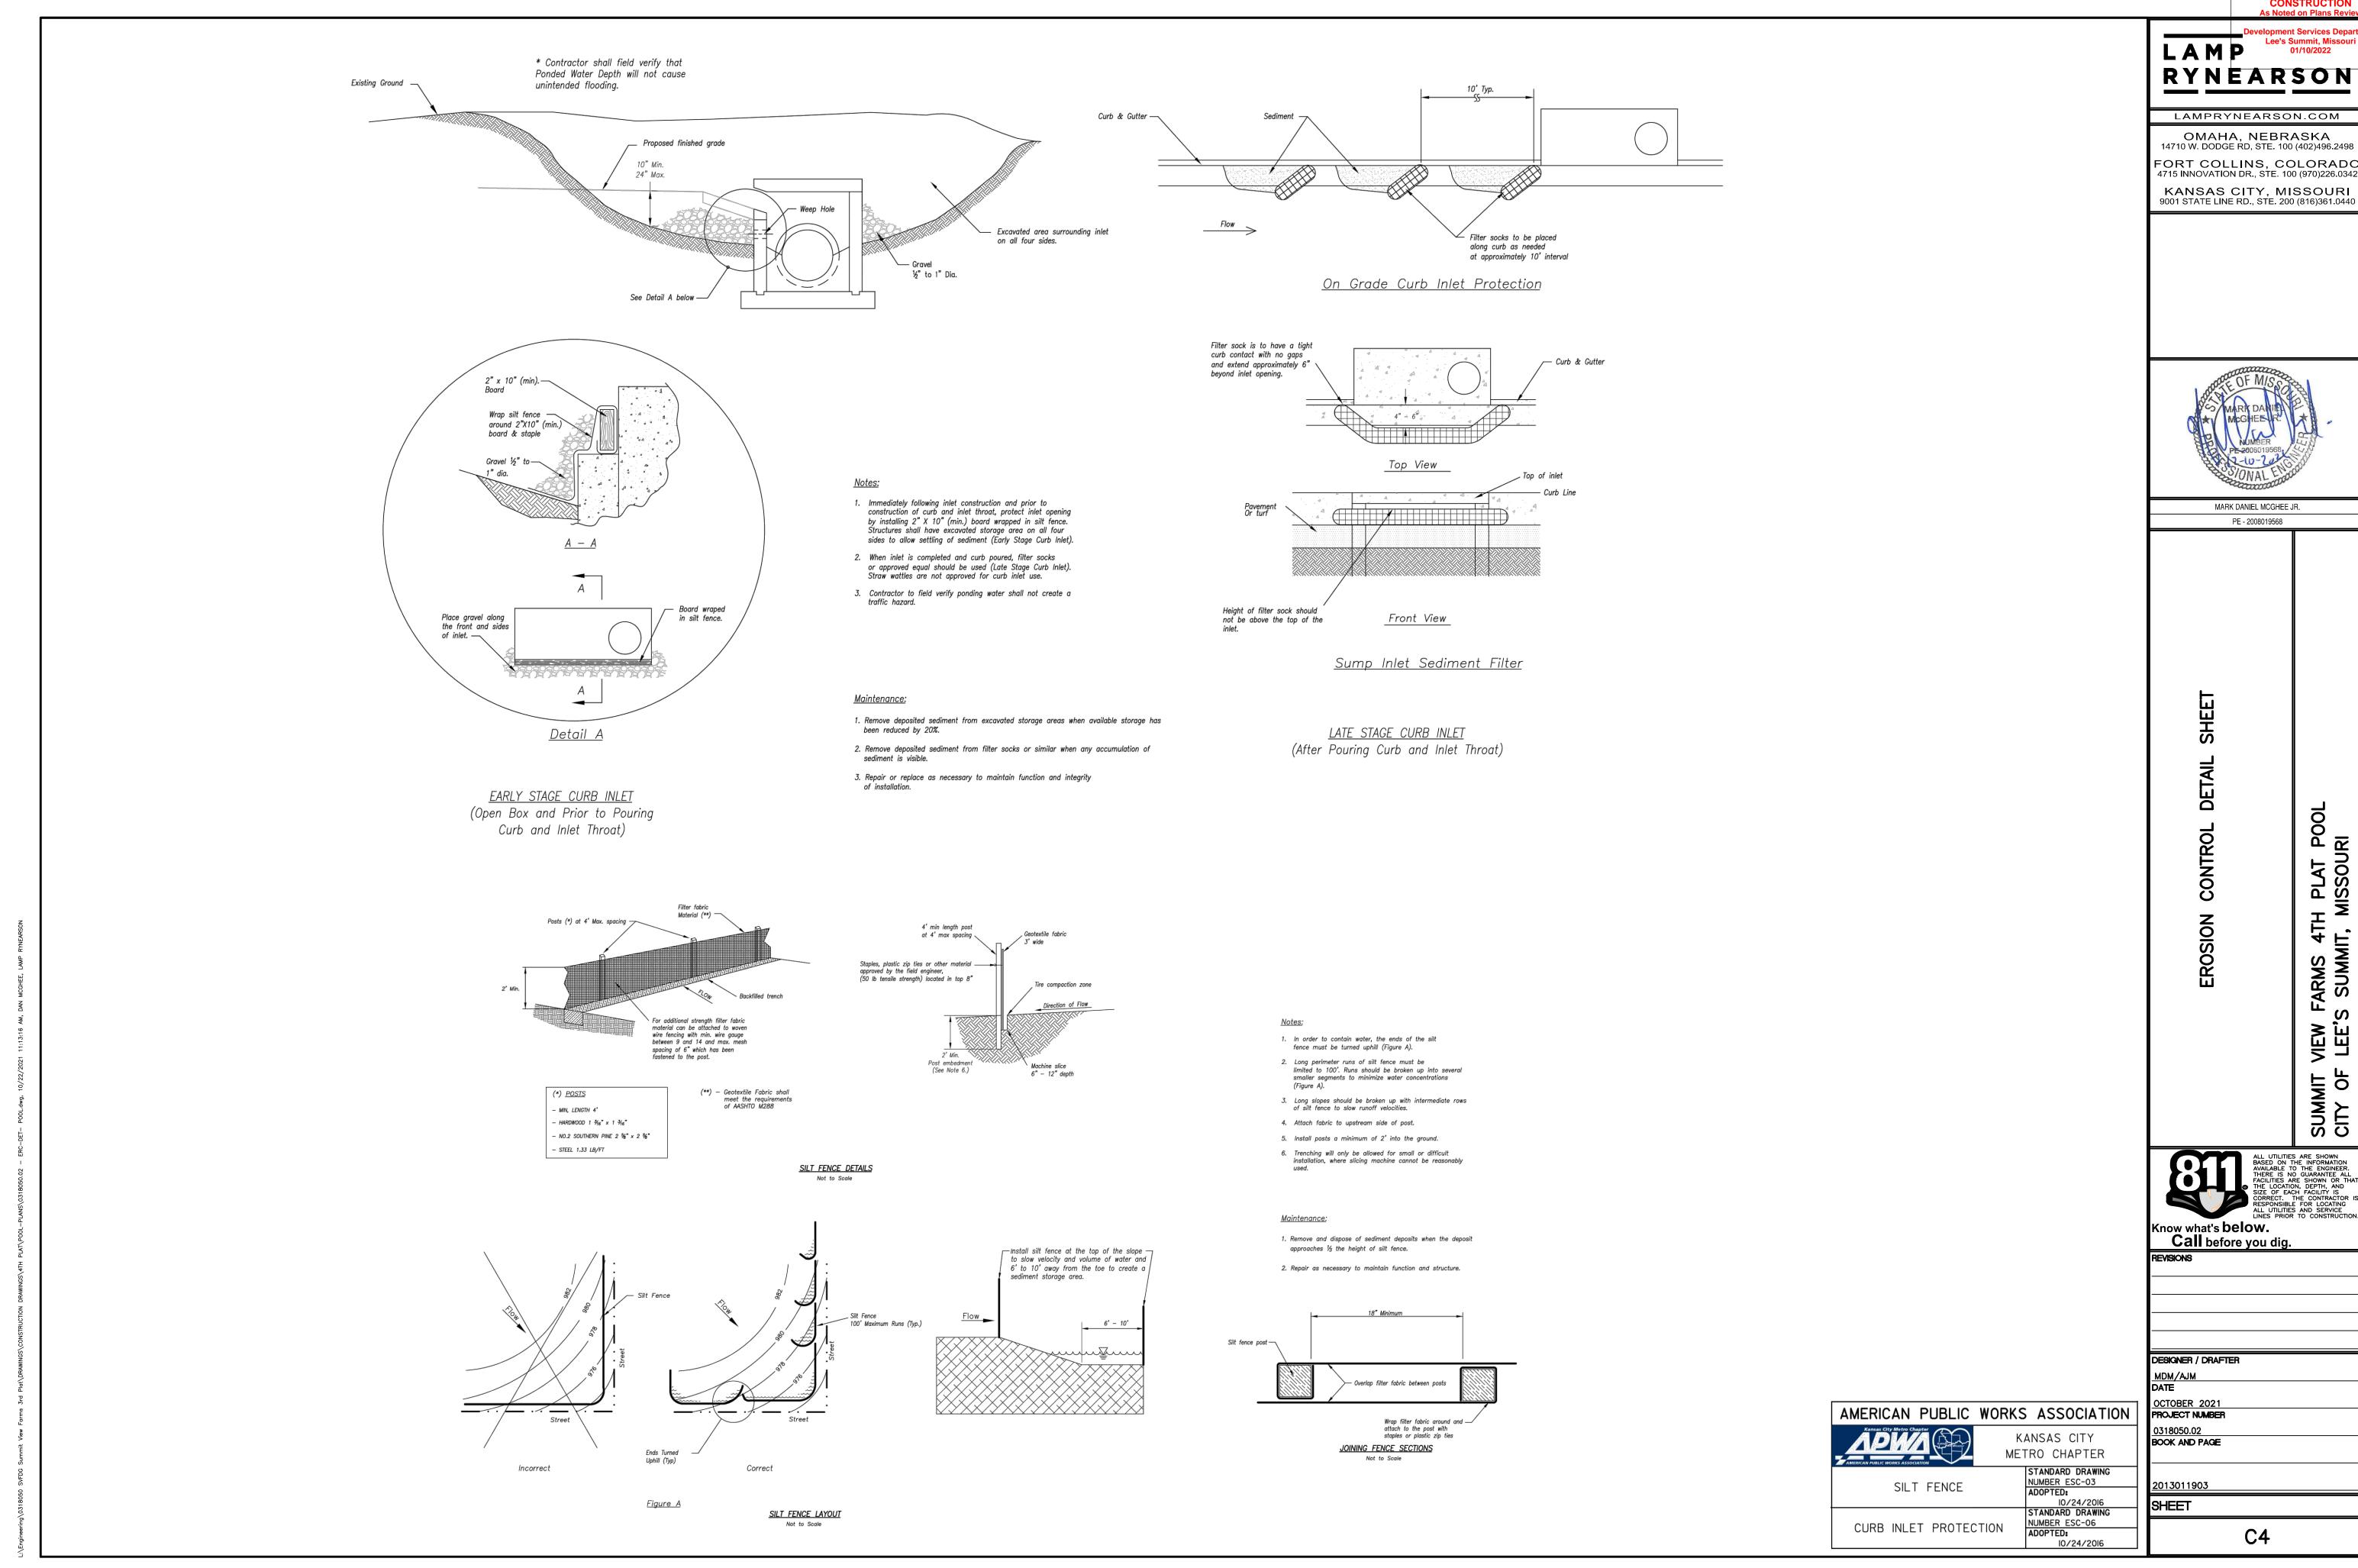
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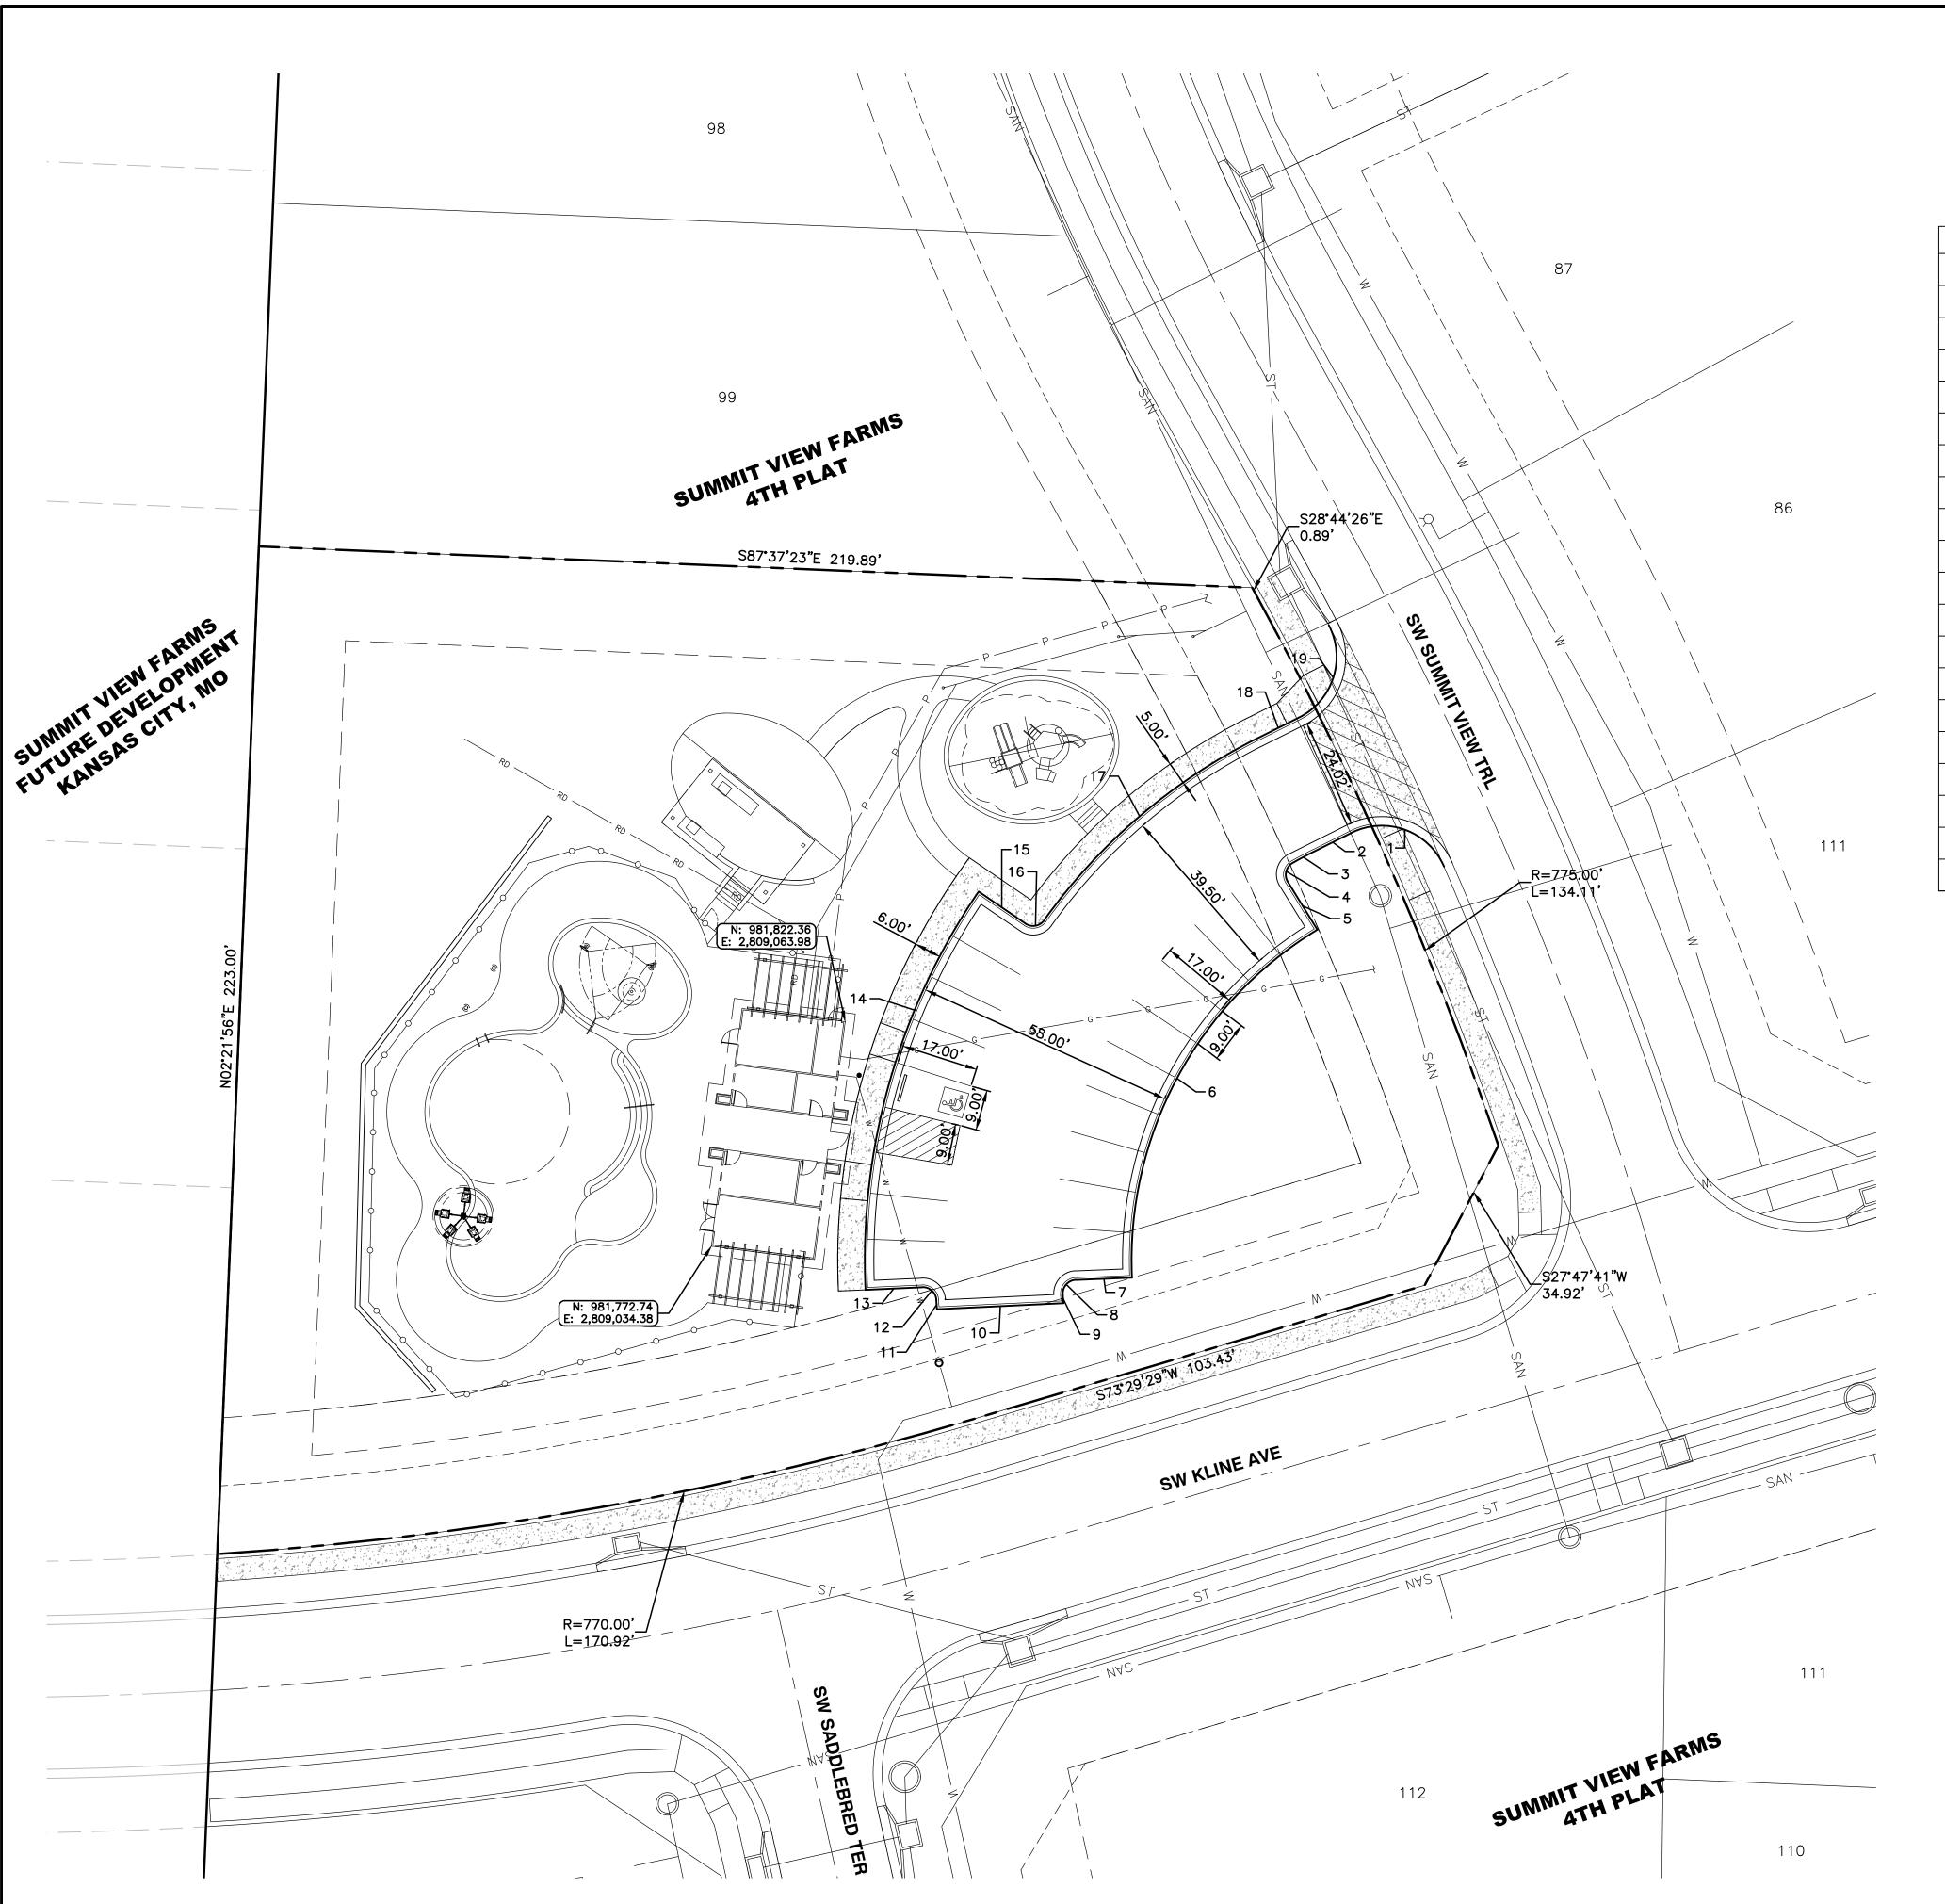
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FARMS 4TH F VIEW LEE SUMMIT CITY OF



#### **GENERAL NOTES:**

- 1. ALL BUILDING DIMENSIONS SHOWN ON THIS SHEET ARE LOCATED AT OUTSIDE FACE OF WALL.
- 2. VERIFY BUILDING DIMENSIONS WITH ARCHITECTURAL PLANS.
- REFER TO POOL AND ASSOCIATED HARDSCAPE IMPROVEMENT PLANS PREPARED BY LORAX DESIGN GROUP, FOR DIMENSIONS, ELEVATIONS AND DETAILS.

BACK OF CURB TABLE					
LINE #/CURVE #	LENGTH	DIRECTION/DELTA	RADIUS	NORTHING/EASTING	
1	24.40	93.20	15.00	N=981856.66/E=2809196.423	
2	9.26	S63° 26' 02.43"W		N=981864.13/E=2809175.95	
3	5.34	3.03	101.00	N=981859.99/E=2809167.665	
4	4.82	92.05	3.00	N=981857.48/E=2809162.955	
5	12.44	S31° 38' 29.61"E		N=981853.29/E=2809161.88	
6	91.47	61.30	85.50	N=981842.70/E=2809168.408	
7	12.44	S87° 43' 53.44"W		N=981765.77/E=2809127.42	
8	4.82	92.05	3.00	N=981765.28/E=2809114.994	
9	1.92	S04° 51' 33.48"E		N=981762.05/E=2809112.12	
10	28.02	S87° 16' 49.60"W		N=981760.14/E=2809112.28	
11	2.06	NO4° 21' 47.53"W		N=981758.81/E=2809084.29	
12	4.63	87.78	3.02	N=981760.86/E=2809084.135	
13	12.53	S87° 23' 47.21"W		N=981763.66/E=2809081.01	
14	93.14	36.93	144.50	N=981763.09/E=2809068.484	
15	12.53	S55° 40' 17.03"E		N=981851.14/E=2809093.50	
16	4.64	88.70	3.00	N=981844.07/E=2809103.855	
17	62.60	27.80	129.00	N=981844.80/E=2809107.986	
18	10.31	N63° 26' 02.43"E		N=981885.03/E=2809155.14	
19	23.85	91.11	15.00	N=981889.64/E=2809164.366	

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Development Services Departs
Lee's Summit, Missouri
01/10/2022

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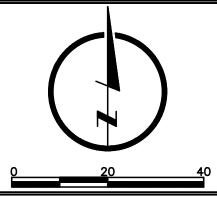
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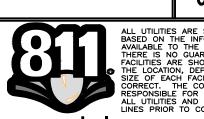




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SUMMIT VIEW FARMS 4TH PLAT POOL CITY OF LEE'S SUMMIT, MISSOURI



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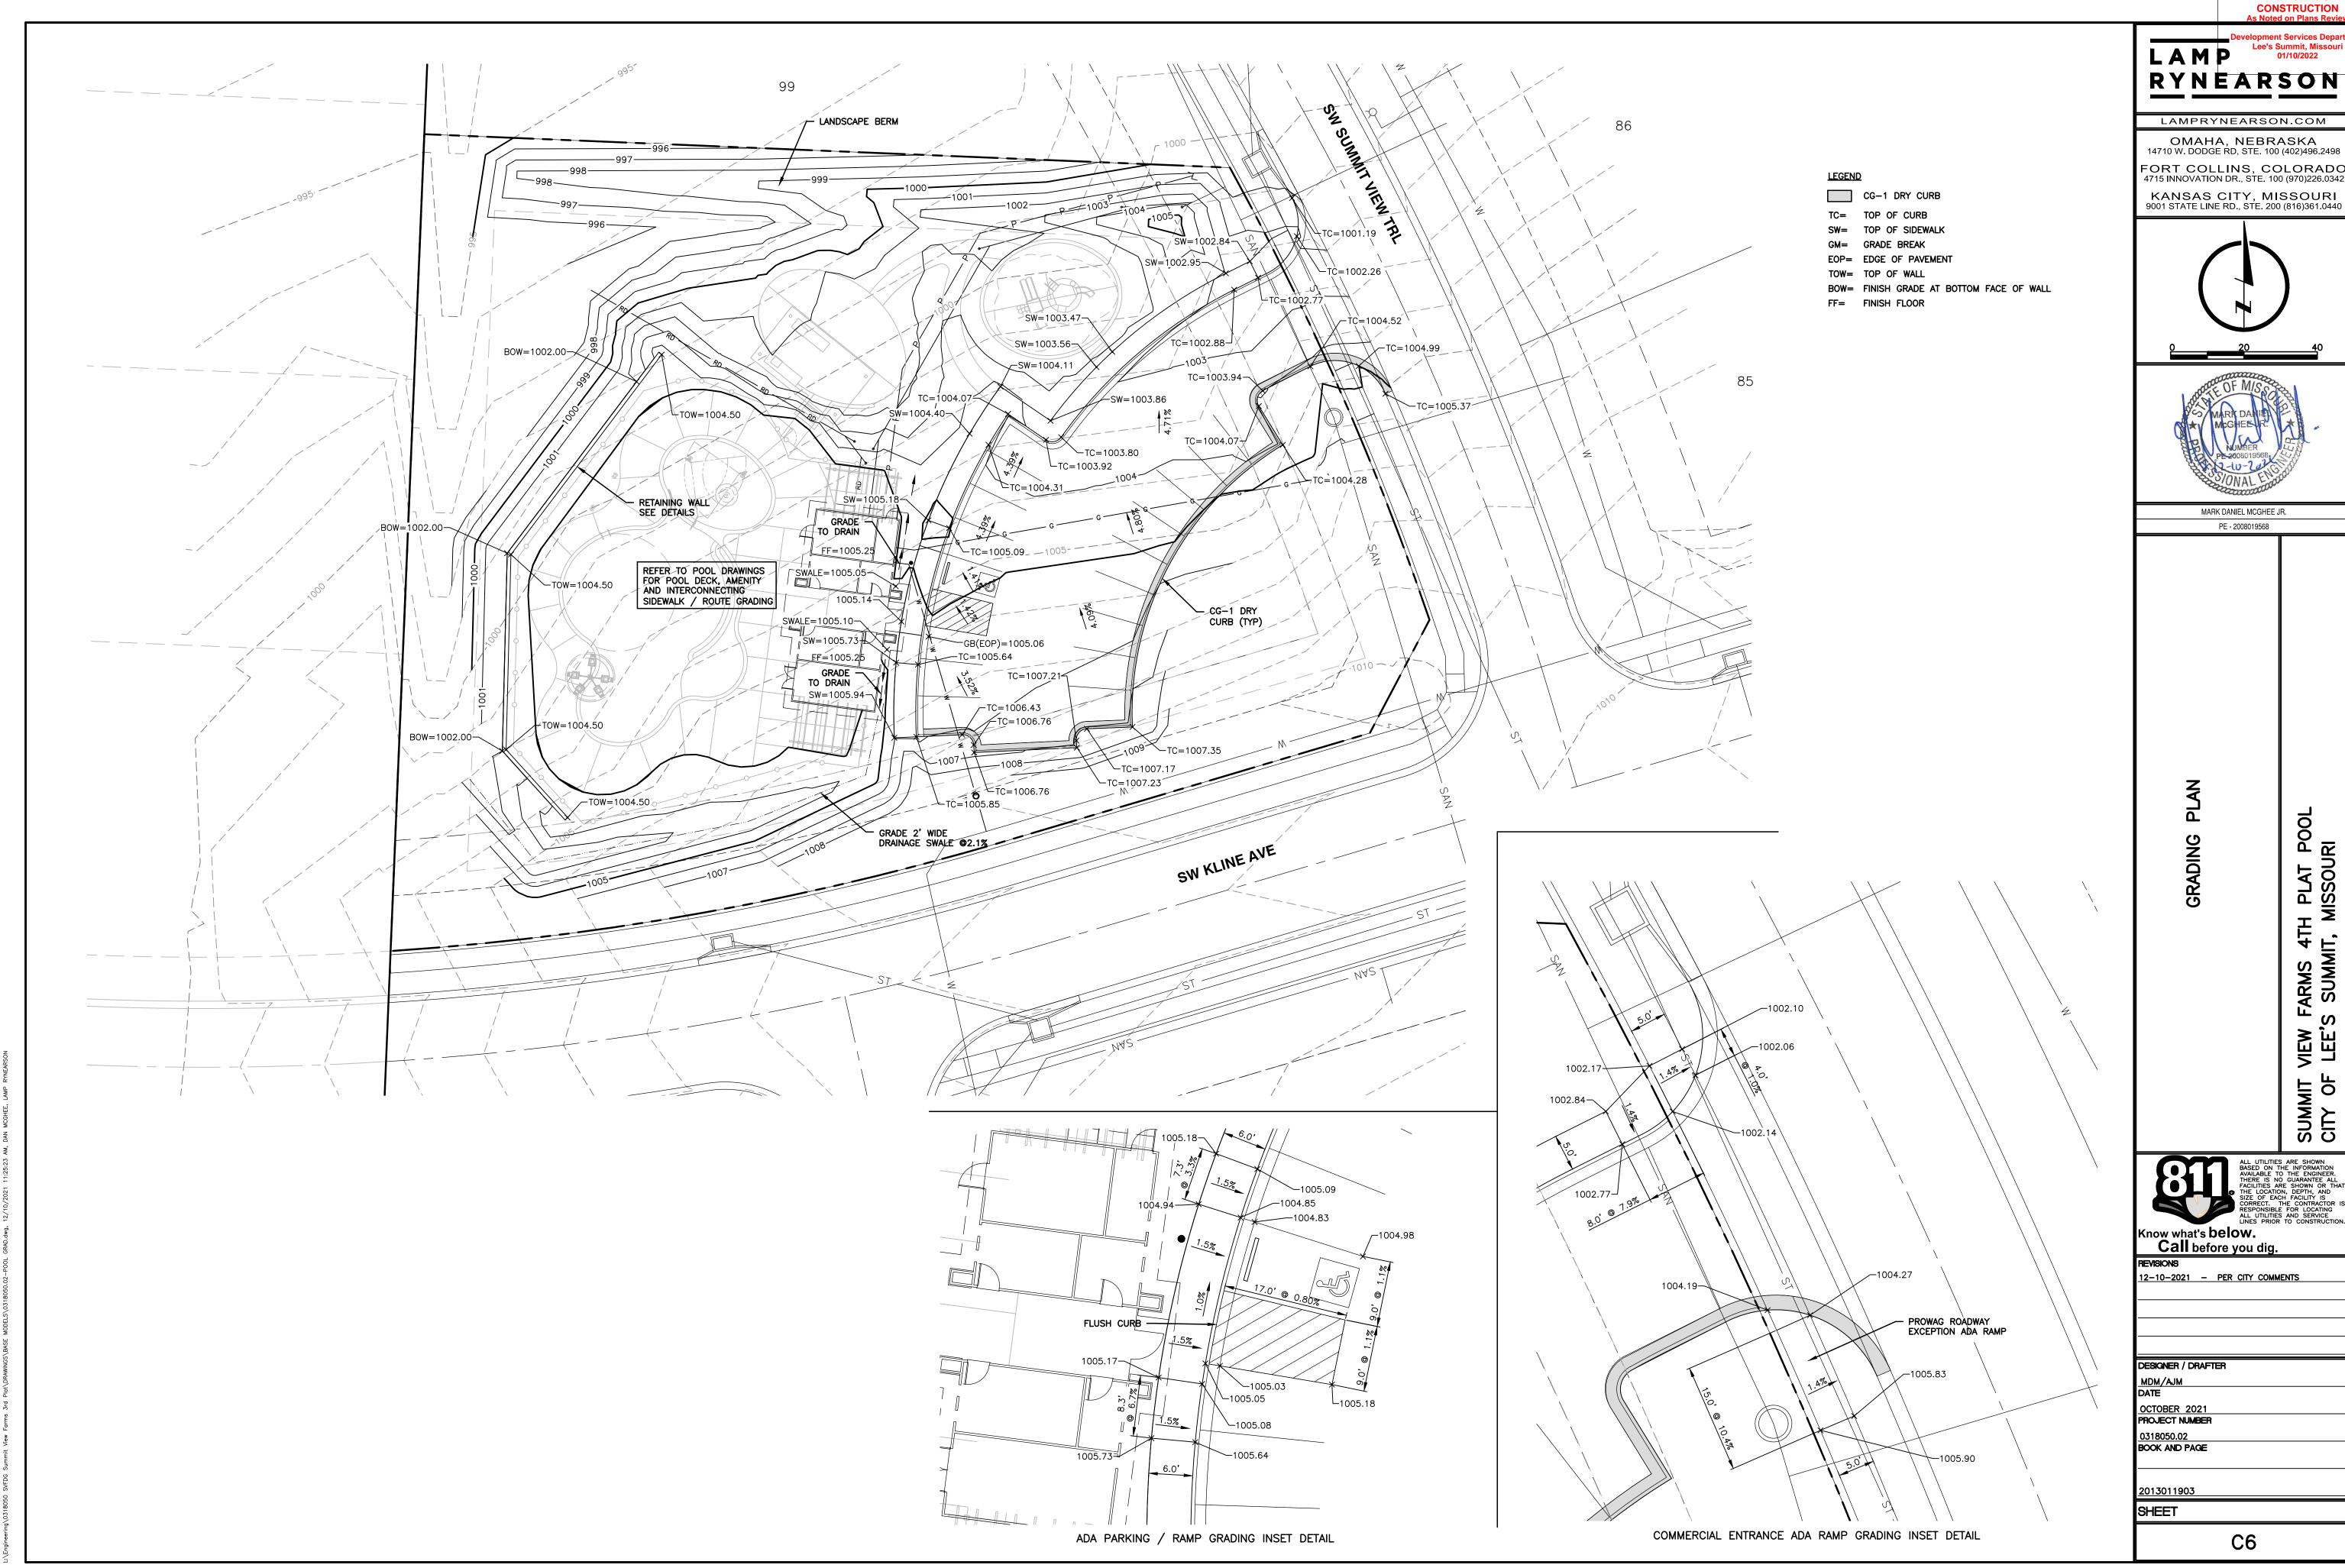
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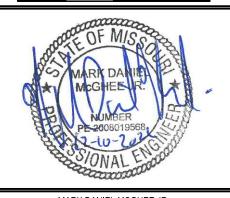
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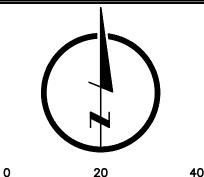



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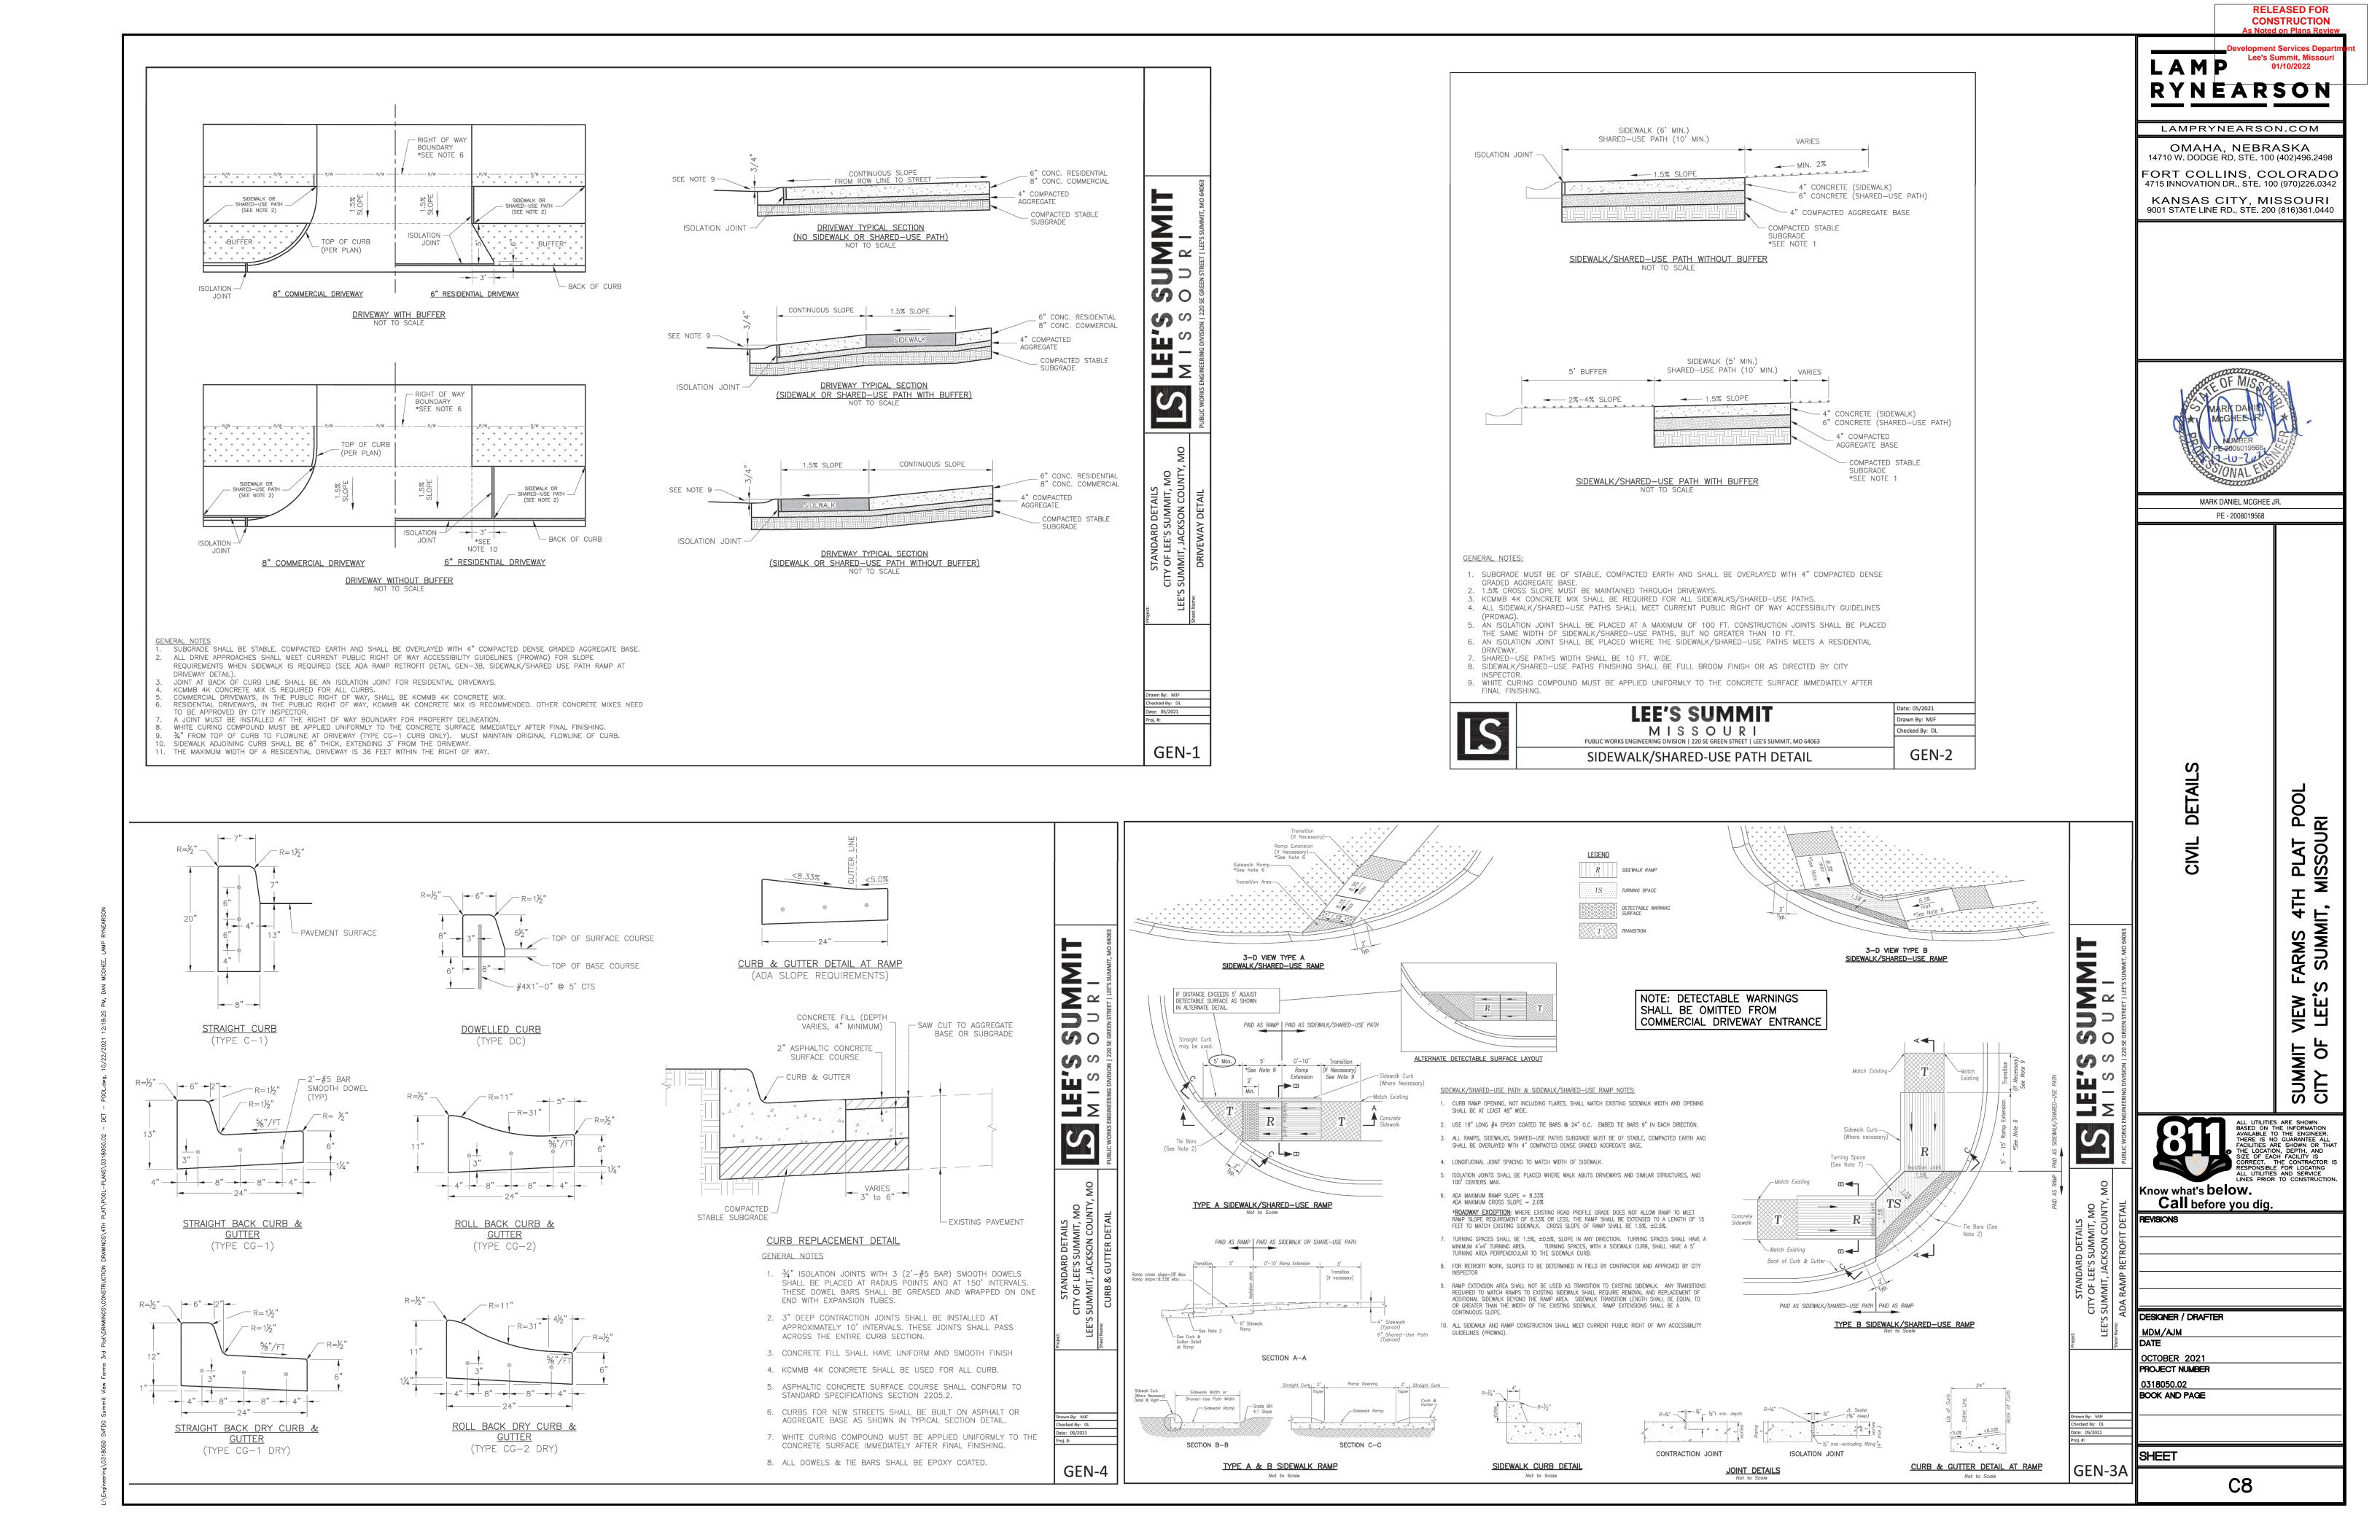
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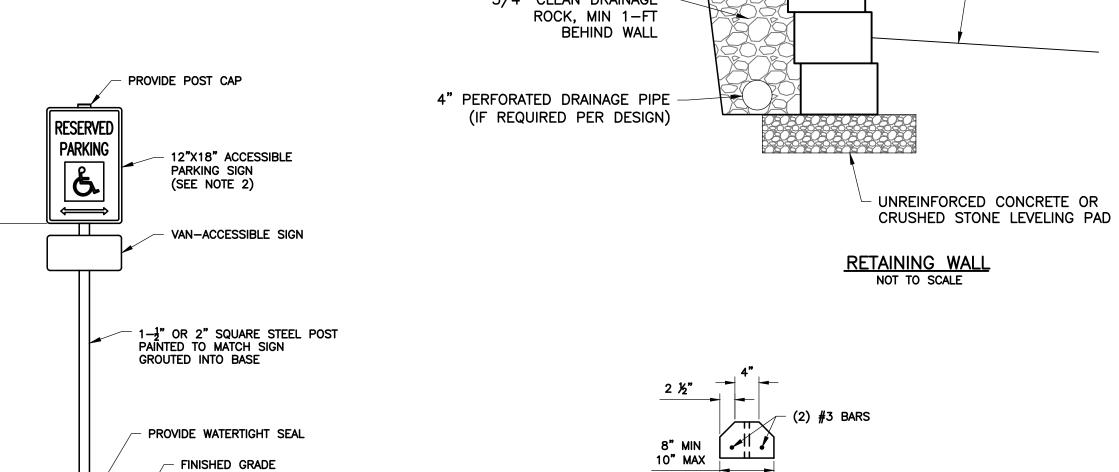
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VIEW LEE SUMMIT CITY OF





SECTION A-A
NOT TO SCALE

6'-0"

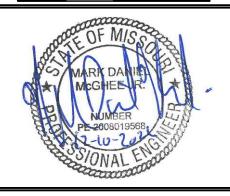3:1 SAND AND CEMENT

NON-SHRINK GROUT 1"

**ELEVATION** 

PRECAST CONCRETE WHEEL STOP

NO SCALE

- (2) #6 BARS TYP

CL. TYP



#### SIGN NOTES:


1. THE CONTRACTOR SHALL PROVIDE AN ACCESSIBLE PARKING SIGN FOR EACH ACCESSIBLE PARKING SPACE IN ACCORDANCE WITH CITY AND FEDERAL REGULATIONS.

NOT TO SCALE

CONCRETE SURFACE

3"ø GALVINIZED STEEL

- 2. THE ACCESSIBLE PARKING SIGNS PROVIDED SHALL CONFORM TO TYPE "R7-8" IN ACCORDANCE WITH THE "MANUAL ON UNIFORM TRAFFIC CONTROL DEVICES".
- THE CONTRACTOR SHALL PLACE SIGNS AS DIRECTED BY THE OWNERS REPRESENTATIVE.

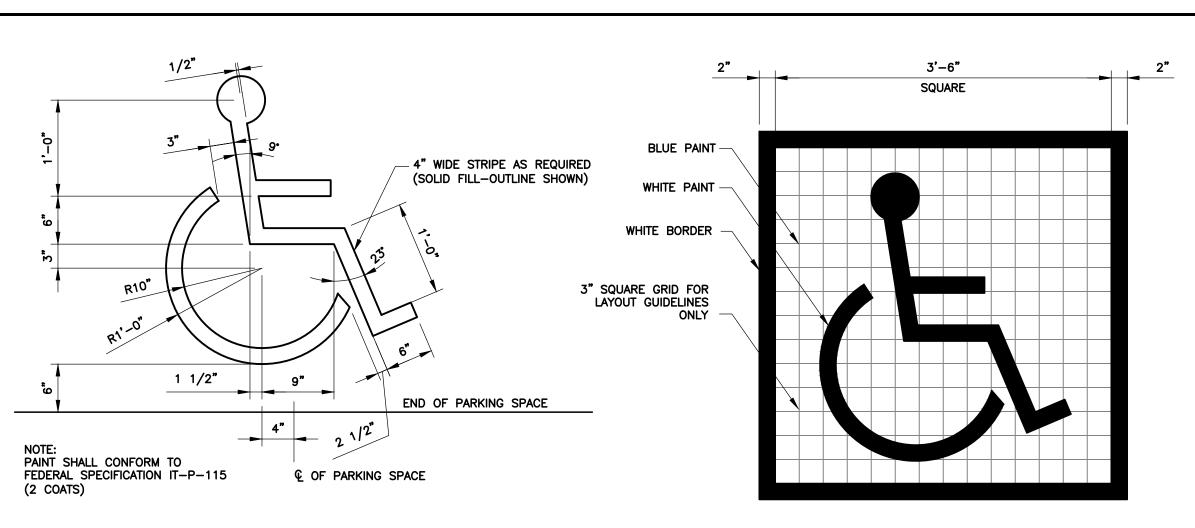

PROVIDE PAINTED SYMBOL AT EACH DESIGNATED ACCESSIBLE PARKING STALL.


#### ACCESSIBLE PARKING SYMBOL NOT TO SCALE

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#### RETAINING WALL NOTES:


- 1. THE RETAINING WALL DETAILS PROVIDED HERE ARE FOR GENERAL GUIDANCE ONLY. IF WALL HEIGHT MEASURED FROM TOP OF WALL TO BOTTOM OF FOOTING EXCEEDS 4—FEET, CONTRACTOR SHALL SUBMIT AN ENGINEERED WALL DESIGN FOR PERMITTING / APPROVAL.
- 2. THE MODULAR WALL UNITS SHALL HAVE A STRAIGHT FACE. FACE FINISH AND COLOR SHALL BE APPROVED BY THE LANDSCAPE ARCHITECT AND OWNER.
- 3. SHOULD AN ENGINEERED WALL DESIGN BE REQUIRED, THE WALL SHALL BE DESIGNED BY THE INSTALLER ACCORDING TO THE WALL UNIT MANUFACTURER'S DESIGN CRITERIA. THE DESIGN SHALL BE SUBMITTED TO THE LANDSCAPE ARCHITECT/ENGINEER AS A SHOP DRAWING FOR REVIEW. ALL DESIGN CALCULATIONS AND DESIGN CRITERIA, INCLUDING ANGLE OF FRICTION, SOIL WEIGHT, ETC., SHALL BE SUBMITTED WITH THE SHOP DRAWING. THE DESIGN MUST BE SEALED BY A QUALIFIED PROFESSIONAL ENGINEER REGISTERED IN THE STATE OF MISSOURI.
  - WALL DESIGN SHALL INCLUDE GLOBAL STABILITY.
  - FACTORS OF SAFETY SHALL BE AS FOLLOWS:
     1.5 AGAINST REINFORCEMENT GRID PULLOUT OR
     RUPTURE (IF APPLICABLE)
     1.5 AGAINST EXTERNAL SLIDING FAILURE
     2.0 AGAINST OVERTURNING
- 4. THE DESIGN, DIMENSIONS, AND MATERIAL SHOWN IN THIS DETAIL ARE GENERAL IN NATURE. THE AGGREGATE MATERIALS, GEOGRID (IF APPLICABLE), AND INSTALLATION SHALL BE PER WALL UNIT MANUFACTURER'S REQUIREMENTS.
- 5. RETAINING WALL SHALL PROVIDE POSITIVE INTERLOCKING BETWEEN BLOCKS AND GEOGRID (IF APPLICABLE).

THREADED PLUG -

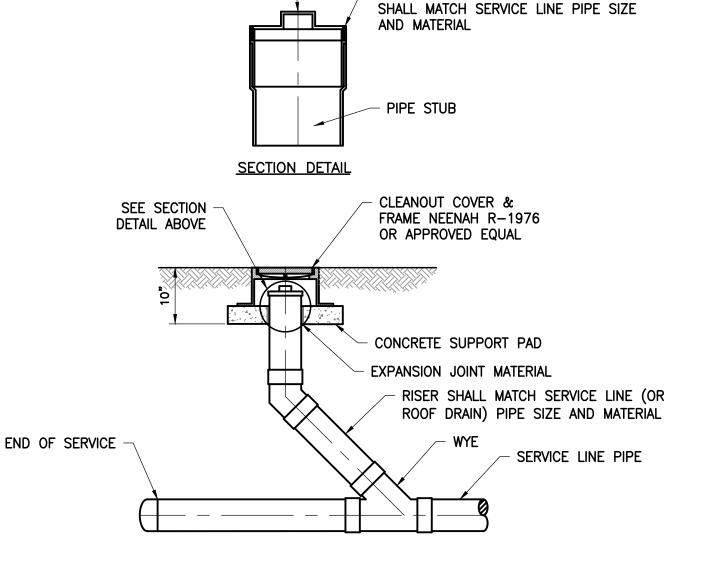


**CLEANOUT DETAIL** 

THREADED CLEANOUT ADAPTER, FITTING

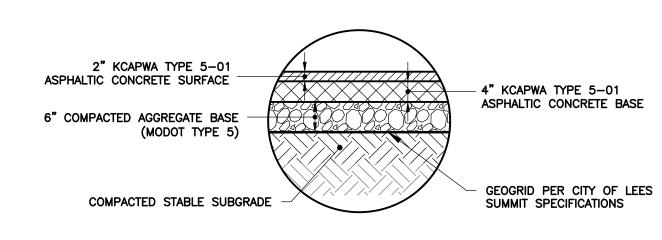

#### ASPHALTIC CONCRETE PAVEMENT SECTION

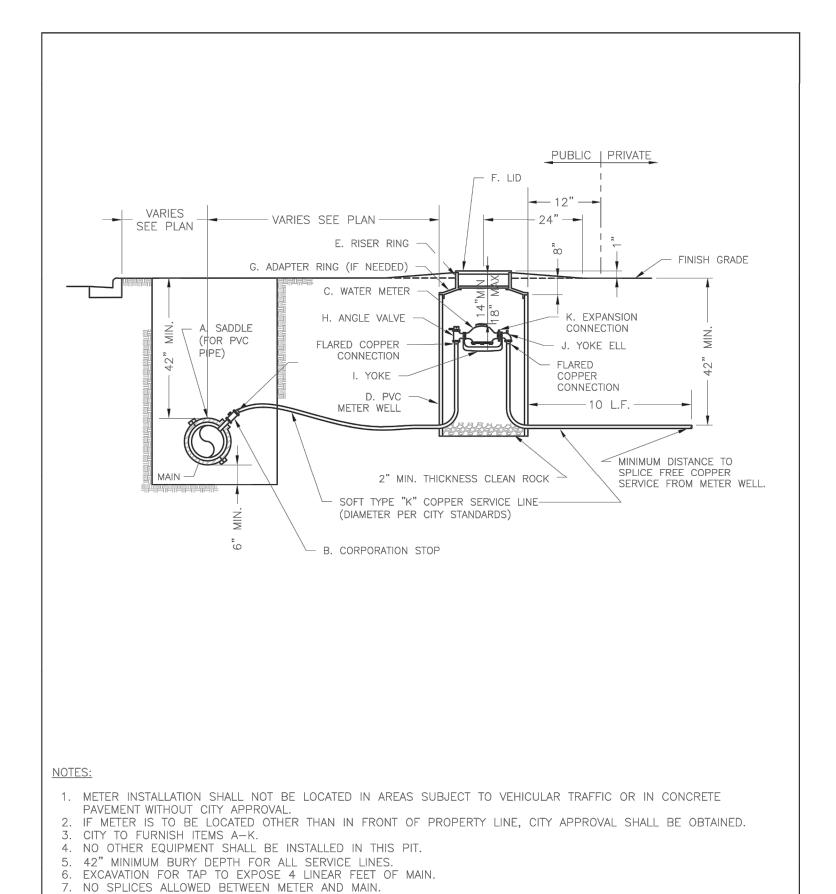

***********	LEE'S SUMMIT	Date: 06/2015
	ree 3 30 MIMIL	Drawn By: JN
	MISSOURI	Checked By: DL
	PUBLIC WORKS ENGINEERING DIVISION   220 SE GREEN STREET   LEE'S SUMMIT, MO 64063	
	SERVICE CONNECTION WITH METER WELL	WAT-11

9 LID AND RISER RING SHALL BE SET SO THAT GROUND WATER WILL DRAIN AWAY FROM THE WELL.

8. SERVICE CONNECTION TAP AT APPROXIMATELY 45 DEGREES.

Development Services Department, Missour 01/10/2022

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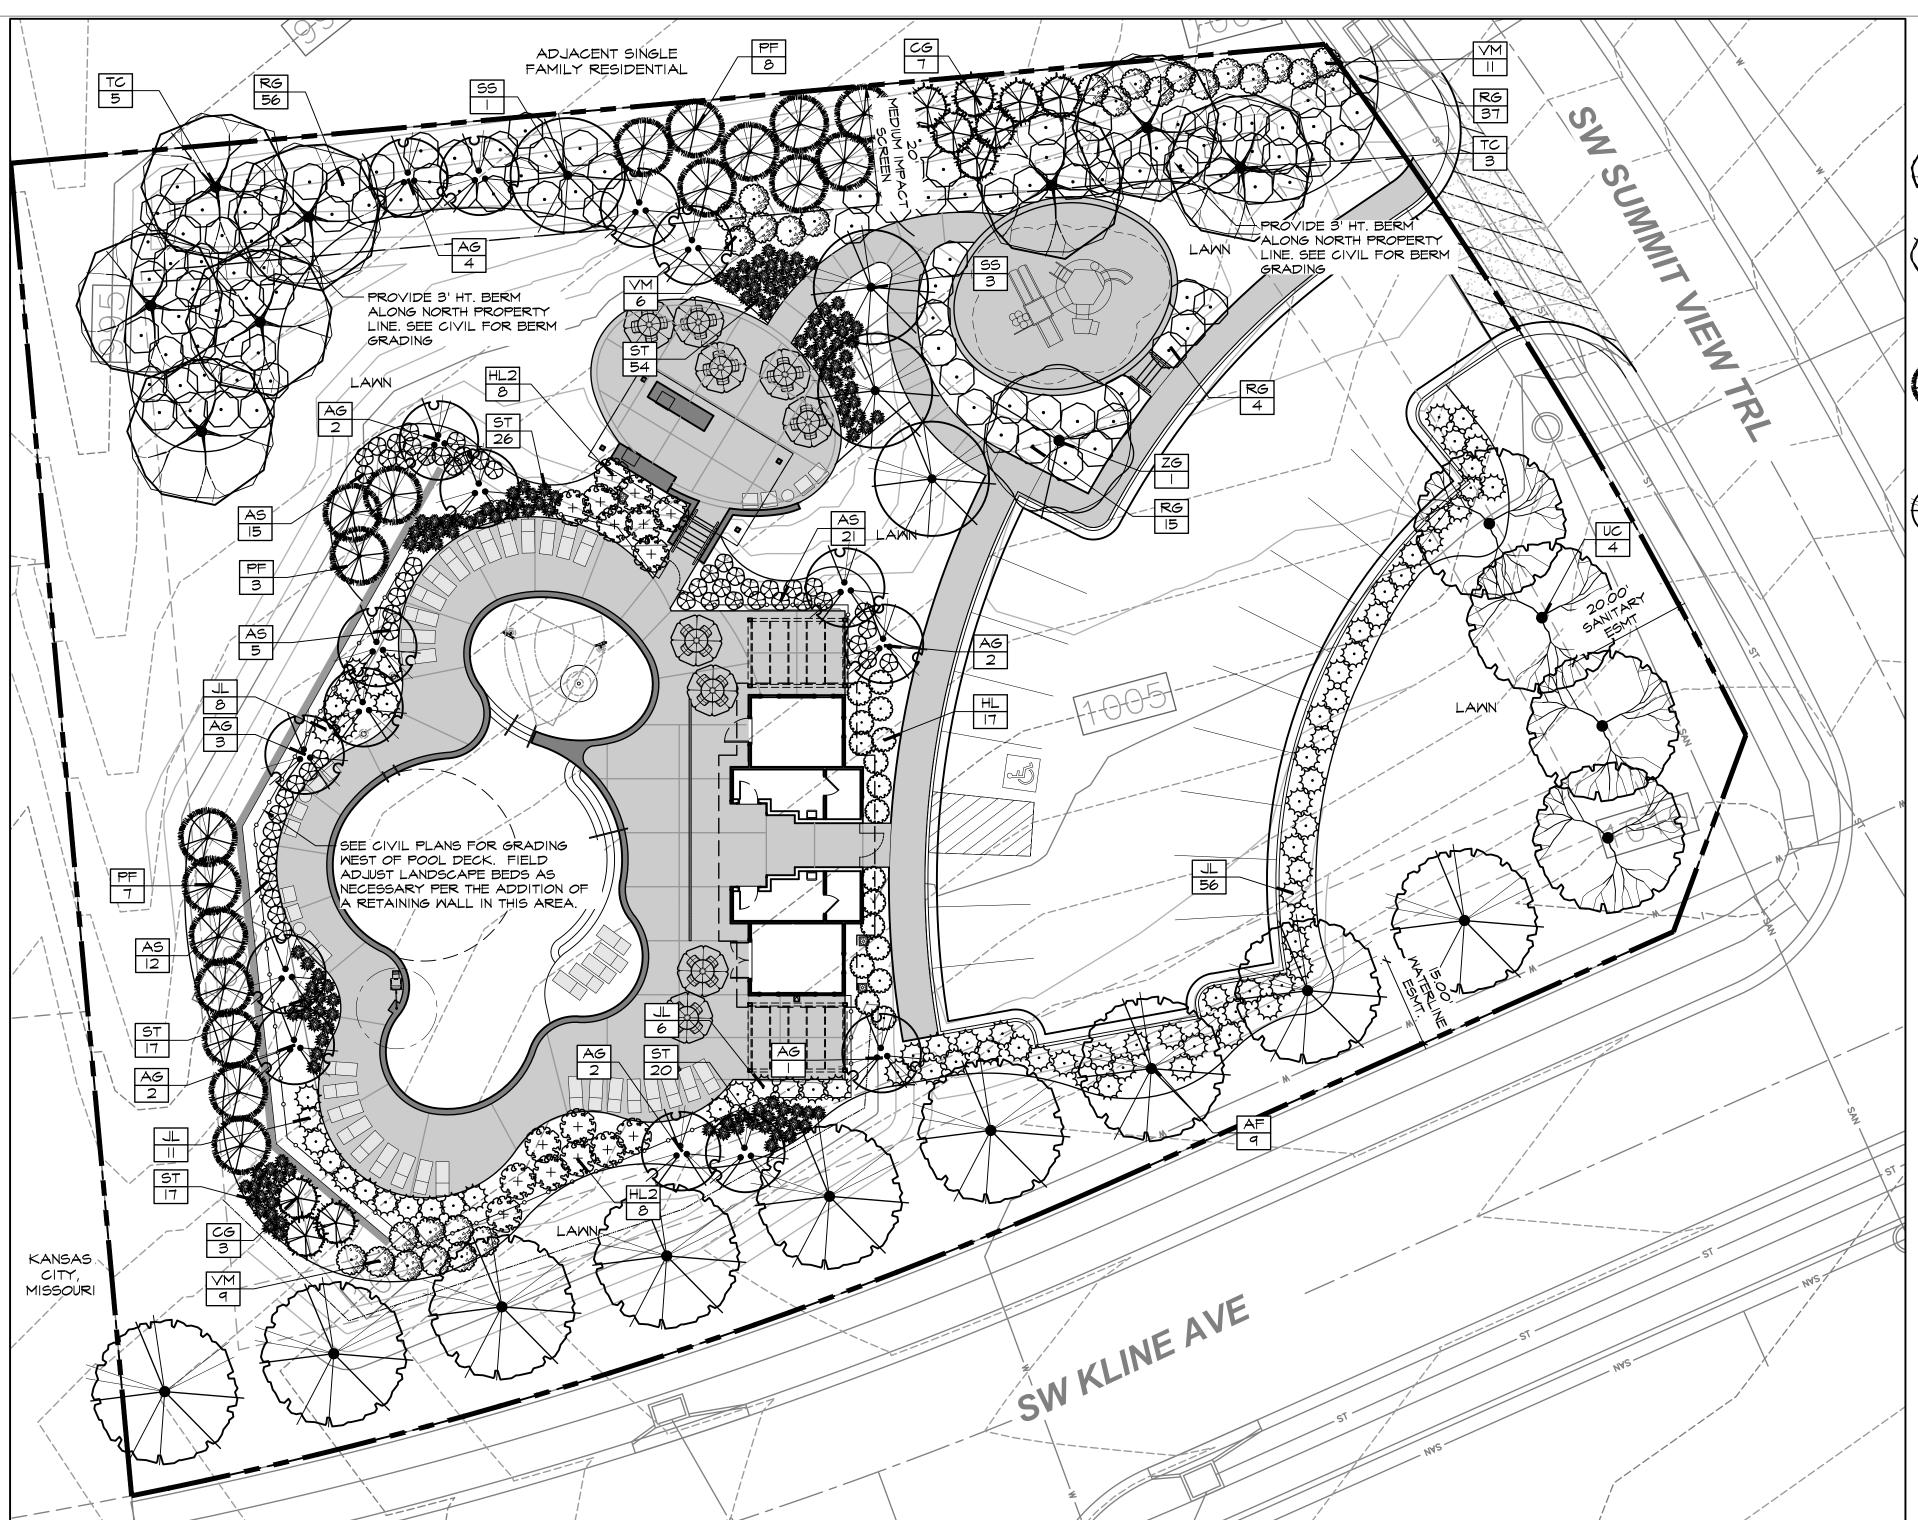
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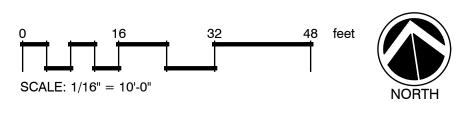
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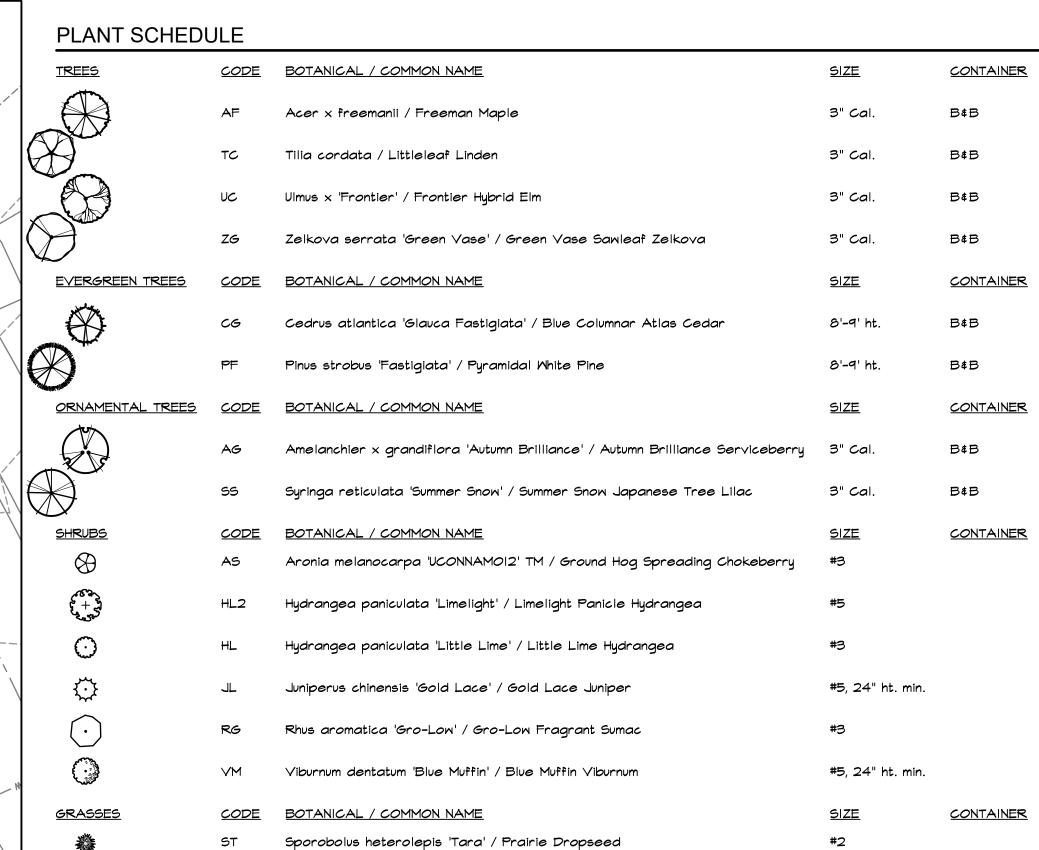


# LANDSCAPE PLAN SCALE: 1/16"=1'-0"



PLANT SIZE REQUIREMENTS (FOR THOSE PLANTS SATISFYING LEE'S SUMMIT REQUIREMENTS)			
LANDSCAPE MATERIAL	SIZE REQUIREMENT (AT TIME OF PLANTING)		
MEDIUM SHRUBS	18"-24" B\$B OR 2-GAL. CONTAINER		
LARGE SHRUBS	24"-30" B&B OR 5-GAL. CONTAINER		
GROUNDCOVER	2½" PEA POT		
DECIDUOUS TREES	3" CALIPER		
EVERGREEN TREES	8' HT. MIN.		

LEE'S SUMMIT	LANDSCAPE REC	QUIREMENTS	
CODE REQUIREMENT	SECTION 8.790(A) - PROVIDE I STREET TREE P	ER 30 LF OF STREET FRONTAGE	
DESCRIPTION	CALCULATION	PLANTING REQUIRED	PLANTING PROVIDED
- PROVIDE I TREE / 30 LF OF STREET FRONTAGE	- 275 LF FRONTAGE ALONG SM KLINE AVE / 30 = 9.2 - 135 LF FRONTAGE ALONG SM SUMMIT VIEW TRL / 30 = 4.5	- 10 STREET TREES REQUIRED ALONG SW KLINE AVE - 5 STREET TREES REQUIRED ALONG SW SUMMIT VIEW TRL	- 10 STREET TREES PROVIDED ALONG SW KLINE AVE - 5 STREET TREES PROVIDED ALONG SW SUMMIT VIEW TRL
CODE REQUIREMENT	SECTION 8.790(B) - PROVIDE 2 SHRUBS PER 5, COVERED BY BUILDINGS OR STRUCTURES	000 SF OF TOTAL LOT AREA AND I TREE	PER 5,000 SF OF LOT AREA NOT
DESCRIPTION	CALCULATION	PLANTING REQUIRED	PLANTING PROVIDED
PROVIDE 2 SHRUBS PER 5,000 SF OF TOTAL LOT AREA AND I TREE PER 5,000 SF OF LOT AREA NOT COVERED BY BUILDINGS OR STRUCTURES	49,892-963 SF BUILDING = 48,956 SF (48,956 SF SITE / 5,000) =9.79 (48,956 SF SITE / 5,000) × 2 = 19.58	IO OPEN SPACE TREES REQUIRED 20 OPEN SPACE SHRUBS REQUIRED	10 OPEN SPACE TREES PROVIDED 68 OPEN SPACE SHRUBS PROVIDED
CODE REQUIREMENT	SECTION 8.820 - PROVIDE SCREENING OF THE CONSIST OF A HEDGE PLANTED WITH 12 SHRUBS		
DESCRIPTION	CALCULATION	PLANTING REQUIRED	PLANTING PROVIDED
PROVIDE 12 SHRUBS/40 LF ALONG PARKING FACING SM KLINE AVE & SM SUMMIT VIEM TRL	(175 LF PARKING LOT FRONTAGE / 40) x 12 = 53	53 SHRUBS REQUIRED	56 SHRUBS PROVIDED
CODE REQUIREMENT	SECTION 6.510 - PROVIDE A MEDIUM IMPACT S SHARED WITH A RESIDENTIAL DWELLING. PROV AND I SHRUB/200 SF		
DESCRIPTION	CALCULATION	PLANTING REQUIRED	PLANTING PROVIDED
PROVIDE I SHADE TREE/500 SF, I ORNAMENTAL TREE/750 SF, I EVERGREEN TREE/300 SF, I SHRUB/200 SF ALONG NORTH PROPERTY LINE	4,522 SF BUFFER / 500 = 9.04 4,522 SF BUFFER / 750 = 6.03 4,522 SF BUFFER / 300 = 15.07 4,522 SF BUFFER / 200 = 22.61	9 SHADE TREES REQUIRED 6 ORNAMENTAL TREES REQUIRED 15 EVERGREEN TREES REQUIRED 22 SHRUBS REQUIRED	9 SHADE TREES PROVIDED 6 ORNAMENTAL TREES PROVIDED 15 EVERGREEN TREES PROVIDED 26 SHRUBS PROVIDED





# SUMMII VIEW FARN POOL CONSTRUCTION DOCUMENTS

**REVISION:** 

DECEMBER 2, 2021 LANDSCAPE PLAN

L101

#### **GENERAL NOTES**

NURSERY, PRIOR TO SELECTION OR DIGGING.

- I. THE LANDSCAPE CONTRACTOR SHALL READ ALL LANDSCAPE PLANS, SPECIFICATIONS AND VISIT THE PROJECT SITE TO BECOME FAMILIAR WITH EXISTING CONDITIONS PRIOR TO BIDDING THIS PROJECT.
- 2. ANY AND ALL QUESTIONS CONCERNING THE LANDSCAPE PLANS AND SPECIFICATIONS SHALL BE DIRECTED TO THE LANDSCAPE ARCHITECT.
- 3. THE LANDSCAPE CONTRACTOR IS TO VERIFY THE LOCATION OF ALL UNDERGROUND UTILITIES (INCLUDING THOSE INDICATED ON THE PLAN) PRIOR TO INSTALLATION OF PLANT MATERIAL.
- 4. THE LANDSCAPE CONTRACTOR SHALL BE RESPONSIBLE FOR WATERING, MULCHING, AND OTHER REQUIREMENTS OF PLANT MATERIALS WHILE THEY ARE TEMPORARILY STORED ON OR OFF SITE.
- 5. THE LANDSCAPE CONTRACTOR SHALL COORDINATE LAYOUT OF PLANTING BEDS, PLANT MASSING, STAKED LOCATION OF TREES AND INSTALLATION OF PLANT MATERIAL WITH LANDSCAPE ARCHITECT PRIOR TO COMMENCEMENT OF WORK.
- 6. ALL PLANT MATERIAL (EXCEPT SHADE TREES) IS DELINEATED AT MATURE SIZE OF PLANT MATERIAL. SHADE TREES ARE DELINEATED AT 85% OF ACTUAL MATURE SIZE.
- 7. ALL LANDSCAPE MATERIAL SHALL MEET THE AMERICAN STANDARD FOR NURSERY STOCK (ANSI Z60.1-1996) PER THE
- AMERICAN ASSOCIATION OF NURSERYMEN.


8. PER OWNER'S DIRECTION, THE LANDSCAPE ARCHITECT RESERVES THE RIGHT TO INSPECT ALL PLANT MATERIAL AT THE

- 9. CONDUCT PLANTING UNDER FAVORABLE MEATHER CONDITIONS DURING EITHER THE SPRING PLANTING SEASON, MARCH I TO JUNE I, OR THE FALL PLANTING SEASON, SEPTEMBER 30 UNTIL FREEZING OF THE GROUND. DURING THE FALL PLANTING SEASON, CONIFEROUS MATERIAL PLANTING SHALL BE CONDUCTED AUGUST 15 TO OCTOBER I. DEVIATION FROM THE ABOVE PLANTING DATES WILL ONLY BE PERMITTED WITH APPROVAL IN WRITING BY THE LANDSCAPE ARCHITECT.°°
- IO.THE PLANTING SOIL MIXTURE FOR ALL TREE PLANTINGS SHALL INCLUDE SOIL EXCAVATED FROM THE HOLE. RATIO: 50% VIRGIN SOIL + 50% AMENDED TOP SOIL.
- I. ROOT STIMULATOR SHALL BE APPLIED TO ALL PLANT MATERIALS WITH THE EXCEPTION OF LAWN AREAS. APPLY AS PER THE MANUFACTURERS SPECIFICATIONS.
- 12.THE LANDSCAPE CONTRACTOR SHALL RESTORE FINISH GRADES IN ALL PLANTING AREAS (PER GRADING PLANS) WHICH MAY HAVE BEEN DISTURBED DURING PLANTING OPERATIONS.
- 13. ALL TREE SAUCERS AND PLANTING BEDS ARE TO BE MULCHED WITH A MINIMUM OF 3" DOUBLE-GROUND HARDWOOD MULCH (COLOR DYED DARK BROWN). LANDSCAPE CONTRACTOR TO PROVIDE MULCH SAMPLE TO LANDSCAPE ARCHITECT FOR REVIEW PRIOR TO INSTALLATION. WHERE PLANTING BEDS ARE ADJACENT TO WALKS AND CURBS THE SOIL LEVEL SHALL BE 3" LOWER TO ALLOW FOR MULCH LAYER. WHERE SOD IS INDICATED, ITS THICKNESS SHALL ALSO BE ACCOUNTED FOR SO THAT THE SOIL SURFACE IN THE SOD IS 1/2" BELOW THE HARDSCAPE SURFACE.
- 14.ALL SHRUB/PERENNIAL PLANTING BEDS SHALL BE TREATED WITH A PRE-EMERGENT HERBICIDE SUCH AS TREFLAN OR EQUAL. APPLY PER MANUFACTURER'S SPECIFICATIONS. THE PRE-EMERGENT SHALL NOT BE APPLIED UNTIL AFTER ALL PLANTING WITHIN THESE AREAS IS COMPLETE, BUT BEFORE THESE AREAS ARE MULCHED. DO NOT DISTURB AREAS AFTER APPLICATION. WATER IN AS DIRECTED.
- 15. MULCH, STAKES, GUY WIRE, PRE-EMERGENT HERBICIDES, ETC. SHALL BE SUBSIDIARY TO INDIVIDUAL PLANTS.
- 16.ALL SLOPES THAT EXCEED A 3:1 GRADE SHALL BE PROTECTED WITH AN EROSION CONTROL BLANKET WITH NORTH AMERICAN GREEN SI50. INSTALL PER THE MANUFACTURER'S SPECIFICATIONS.
- 17. LABEL EACH TREE AND SHRUB WITH A SECURELY ATTACHED, WATERPROOF TAG BEARING LEGIBLE DESIGNATION OF BOTH BOTANICAL AND COMMON NAME. LABEL EACH ORNAMENTAL GRASS, GROUNDCOVER, PERENNIAL AND ANNUAL WITH THE LABEL PROVIDED BY THE ORIGINAL GROWER OF THE PLANT. LABELS SHALL NOT BE REMOVED UNTIL AFTER PROVISIONAL ACCEPTANCE BY LANDSCAPE ARCHITECT.
- 18.STAKES AND GUY WIRES SHALL BE REMOVED AT THE END OF ONE FULL GROWING SEASON.
- 19. LOOSEN SOIL FOR ALL PLANTING ISLANDS AND SHRUB/PERENNIAL BEDS TO A DEPTH OF 12". ALL AREAS DENOTED AS SOD (LAWN AREAS) SHALL HAVE A 6" MINIMUM TOPSOIL LAYER. TOPSOIL SHALL BE LAID IN 3" LIFTS. IN AREAS WHERE CONSTRUCTION GRADING HAS NOT OCCURRED AND THE VIRGIN GRADES YET EXIST, THE TOPSOIL LAYER MAY NOT BE REQUIRED BASED ON THE DECISION OF THE LANDSCAPE ARCHITECT.
- 20. TOPSOIL SHALL BE FERTILE NATURAL TOPSOIL, TYPICAL OF THE LOCALITY, OBTAINED FROM WELL DRAINED AREAS.

  STOCKPILED TOPSOIL MAY BE USED. IT SHALL BE WITHOUT ADMIXTURE OF SUBSOIL OR SLAG AND SHALL BE FREE OF

  STONES, LUMPS, STICKS, PLANTS OR THEIR ROOTS, TOXIC SUBSTANCES OR OTHER EXTRANEOUS MATTER THAT MAY BE

  HARMFUL TO PLANT GROWTH OR WOULD INTERFERE WITH FUTURE MAINTENANCE. TOPSOIL PH RANGE SHALL BE 5.5 TO 7.0.
- 21.THERE SHALL BE NO ADDITIONS, DELETIONS OR SUBSTITUTION OF PLANT MATERIAL SPECIES WITHOUT THE WRITTEN APPROVAL BY THE OWNER OR LANDSCAPE ARCHITECT. ANY SUBSTITUTION THAT HAS NOT BEEN APPROVED SHALL BE REMOVED AND REPLACED WITH THE CORRECT PLANT AT LANDSCAPE CONTRACTOR'S EXPENSE.
- 22. IN THE CONDITION WHERE THE PLANT MATERIAL HAS BEEN SUPPLIED BY THE OWNER THROUGH A PLANT PROCUREMENT PROGRAM WITH A MYKE PRO 2-YEAR WARRANTY, THE LANDSCAPE CONTRACTOR'S WARRANTY OF PLANT MATERIAL SHALL BEGIN FROM THE TIME OF HANDLING PLANT MATERIAL AT TIME OF DELIVERY THROUGH INSTALLATION AND END AFTER SUBSTANTIAL COMPLETION AND FINAL PUNCH-LIST APPROVAL BY LANDSCAPE ARCHITECT.
- 23. THE LANDSCAPE CONTRACTOR WILL BE RESPONSIBLE FOR THE COLLECTION, REMOVAL, AND PROPER DISPOSAL OF ANY AND ALL DEBRIS GENERATED DURING THE INSTALLATION OF THE LANDSCAPE CONSTRUCTION.
- 24. IRRIGATION SYSTEM SHALL UTILIZE A RAIN SENSOR. DRIP IRRIGATION SHALL BE UTILIZED AT LANDSCAPE BEDS.
- 25. COORDINATE WITH THE OWNER AND GENERAL CONTRACTOR FOR SLEEVE LOCATIONS AND TIMING OF SLEEVE INSTALLATION. ALL SLEEVING REQUIRED UNDER HARDSCAPE SURFACES FOR THE IRRIGATION SYSTEM SHALL BE THE RESPONSIBILITY OF THE IRRIGATION CONTRACTOR.
- 26. COORDINATE LANDSCAPE PLANTING WITH IRRIGATION CONTRACTOR. THE TREE PLANTINGS SHALL BE IN PLACE BEFORE IRRIGATION LINE ROUTING BEGINS. WATER TREES BY HAND UNTIL IRRIGATION SYSTEM IS FULLY FUNCTIONAL. SHRUBS AND PERENNIALS SHALL NOT BE INSTALLED UNTIL THE IRRIGATION SYSTEM IS FULLY FUNCTIONAL. THE IRRIGATION SYSTEM SHALL BE COMPLETE AND FULLY FUNCTIONAL BEFORE SOD IS PLACED.

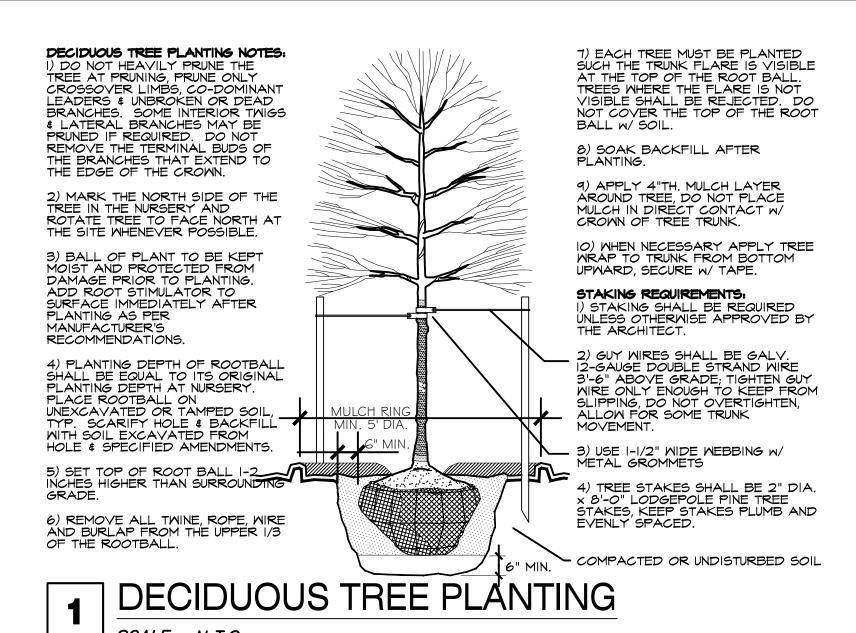

SCALE: N. 1.S.

NEW SOD AREA

PVMT.

FINISHED

GRADE

G'MN.

CULTIVATED SOIL

3) ADD ADDITIVES (AS PER SOIL TEST RECOMMENDATIONS) AND TILL INTO SOIL.

4) LAY AND ROLL SOD. WATER THOROUGHLY.

SOD INSTALLATION

SHRUB PLANTING NOTES:

I) SET SHRUB AT SAME DEPTH AT WHICH IT GREW IN THE FIELD OR CONTAINER.

2) PRUNE, THIN & SHAPE SHRUBS IN ACCORDANCE W/ STANDARD HORTICULTURAL PRACTICE

3) BALL OF PLANT TO BE KEPT MOIST AND PROTECTED FROM DAMAGE PRIOR TO PLANTING. ADD ROOT STIMULATOR TO SURFACE IMMEDIATELY AFTER PLANTING AS PER MANUFACTURER'S RECOMMENDATIONS.

4) WHEN BACKFILL IS 2/3 COMPLETE, WATER THOROUGHLY UNTIL NO MORE IS ABSORBED.

SCALE: N.T.S.

PLACE PLANT IN VERTICAL PLUMB
POSITION

PRUNE BROKEN AND DAMAGED
TWIGS AFTER PLANTING


4" TH LAYER MULCH

PEEL BACK BURLAP FROM TOP OF
ROOTBALL OR REMOVE CONTAINER

BACKFILL WITH EXCAVATED SOIL \$
SPECIFIED ADDITIVES


COMPACTED OR UNDISTURBED SOIL

SHRUB PLANTING

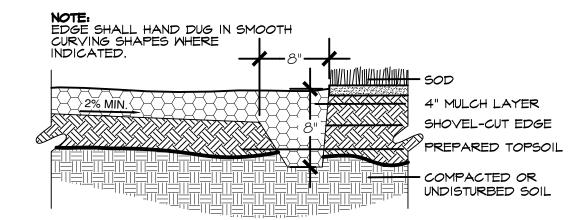


6 SHOVEL-CUT EDGING

SCALE: N.T.S.

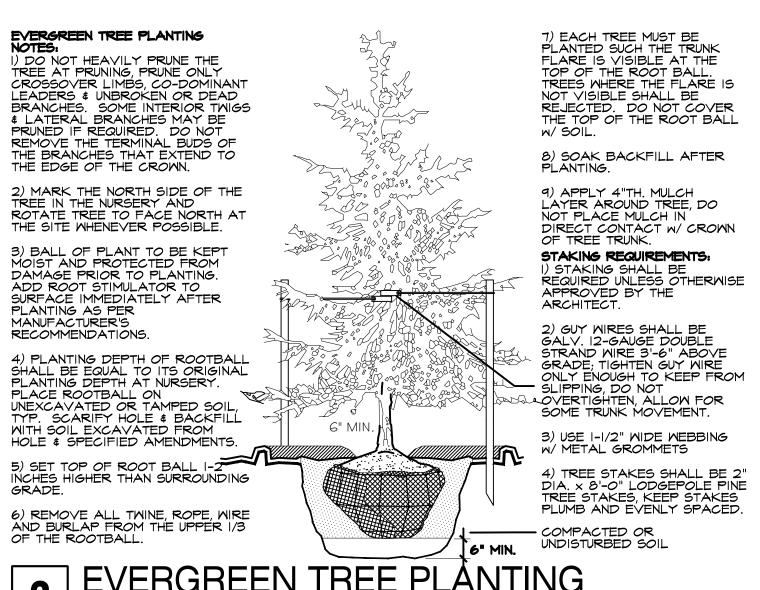

**2** EVERGREEN TREE PLÂNTING

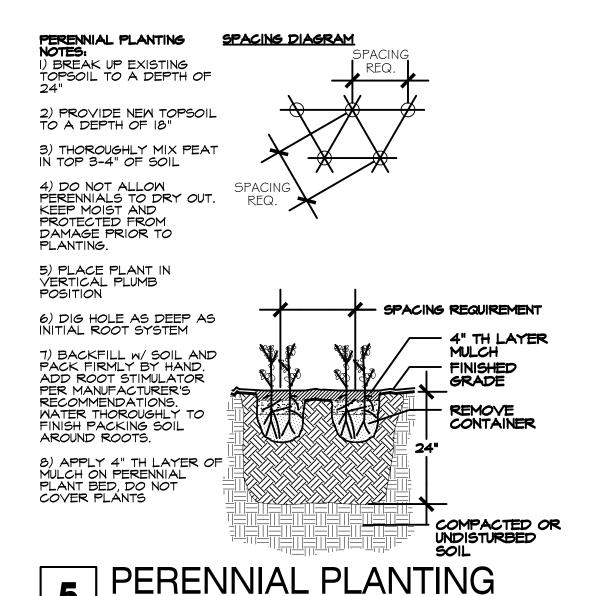

SUMMIT VIEW FA
POOL CONSTRUCTION DOCUM

~

RELEASED FOR CONSTRUCTION

**DESIGN GROUP** 

8021 SANTA FE DRIVE

**OVERLAND PARK, KS 66204** 

WWW.LORAXDESIGNGROUP.COM

NUMBER


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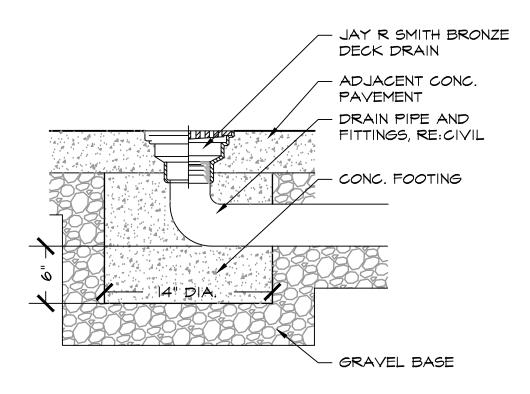
REVISION:

DECEMBER 2, 2021 LANDSCAPE NOTES & DETAILS


\_102

## SCALE: 1-1/2" = 1'-0"




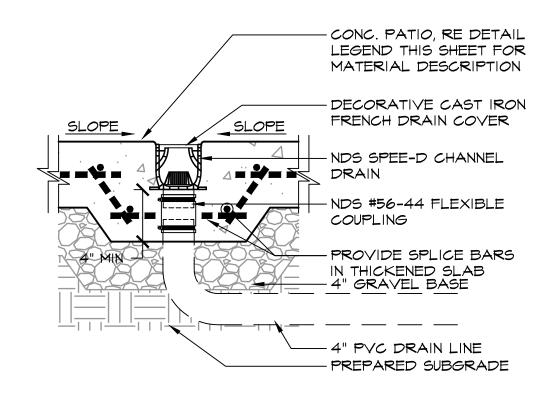

# POOL DECK AREA DRAIN SCALE: NTS

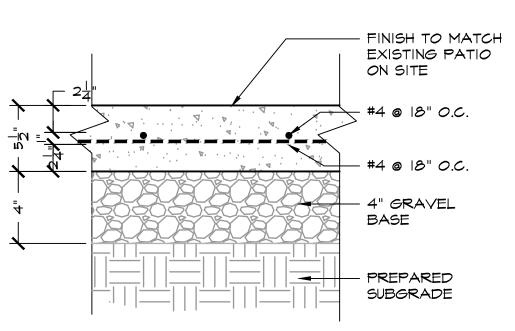

CONTINUOUS HIGH CHAIRS USED TO SET REBAR, CENTERED IN CONCRETE SLAB

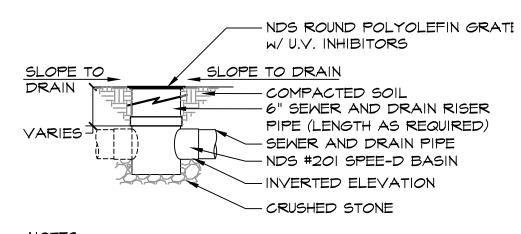


I.INSTALLATION TO BE COMPLETED IN ACCORDANCE W/ MANUFACTURER'S SPECIFICATIONS.


2. DO NOT SCALE DRAWING.

3. THIS DRAWING IS INTENDED FOR USE BY ARCHITECTS, ENGINEERS, CONTRACTORS, CONSULTANTS AND DESIGN PROFESSIONALS FOR PLANNING PURPOSES ONLY.


4. ALL INFORMATION CONTAINED HEREIN WAS CURRENT AT THE TIME OF DEVELOPMENT BUT MUST BE REVIEWED AND APPROVED BY THE PRODUCT MANUFACTURER TO BE CONSIDERED ACCURATE.

# $\int SCALE: 1-1/2" = 1'-0"$

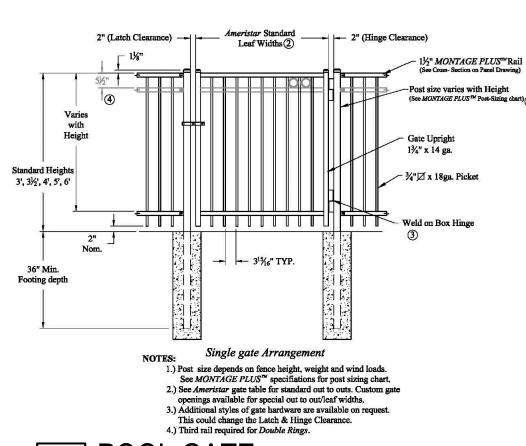

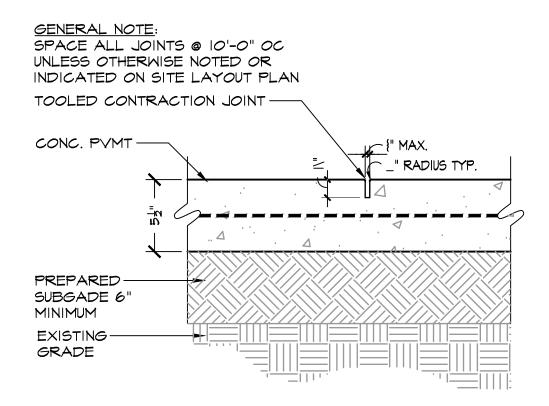


#### CONCRETE CONTRACTION JOINT SCALE: 1-1/2" = 1'-0"

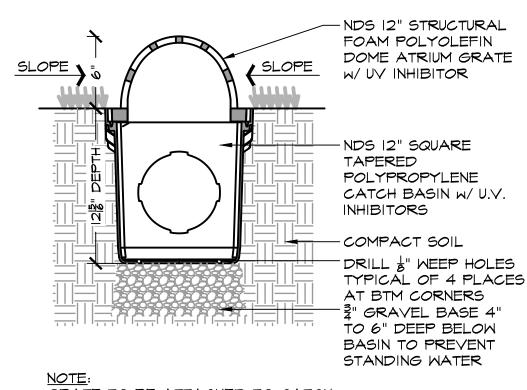


GRATE TO BE ATTACHED TO CATCH BASIN W/ SCREW PROVIDED AT TIME OF INSTALLATION

## CATCH BASIN @ LANDSCAPE AREAS

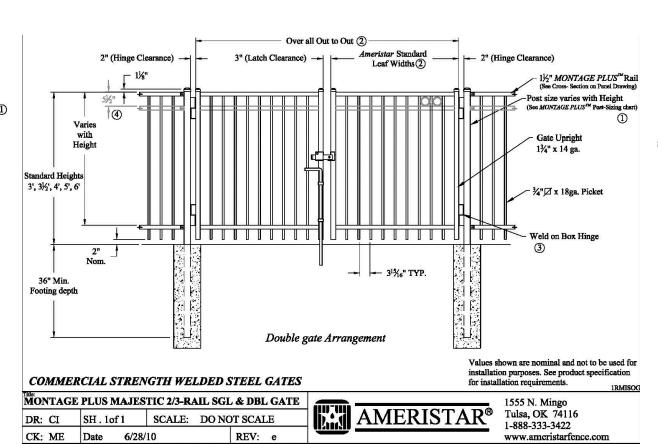


OUTWARD OPENING AWAY FROM POOL. SELF-CLOSING, SELF-LATCHING. DOUBLE GATE SHALL BE INSTALLED, 5' HT.

#### GENERAL NOTE: SPACE ALL JOINTS @ 10'-0" OC UNLESS OTHERWISE NOTED OR INDICATED ON SITE LAYOUT PLAN

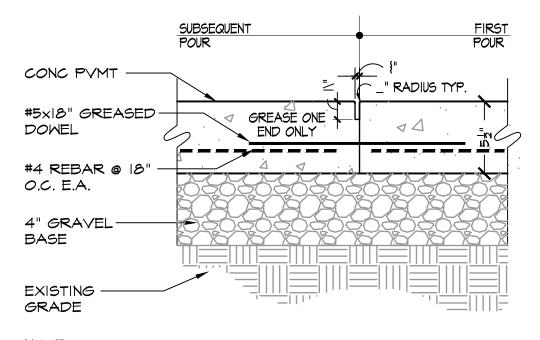


NOTE: FINISHED PATIO MATERIAL NOT SHOWN

# SCALE: 1-1/2" = 1'-0"

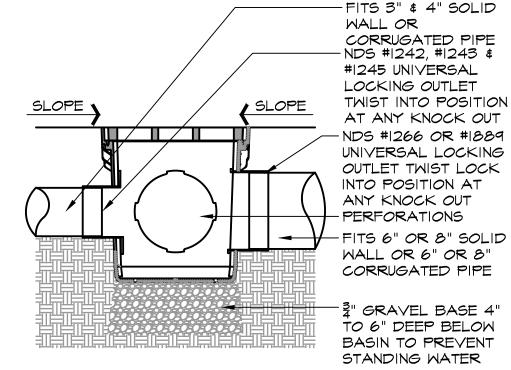



 NDS ADAPTERS THAT FIT THIS BASIN AREA AS FOLLOWS. #1242, #1243, #1245, #1266 \$ #1889 USE #1206 IF PLUGGING AN OUTLET

• PERFORATIONS ON NON OPEN SIDES AND BTM. TO BE CUT OUT WHEN ADDING EXTRA OUTLETS

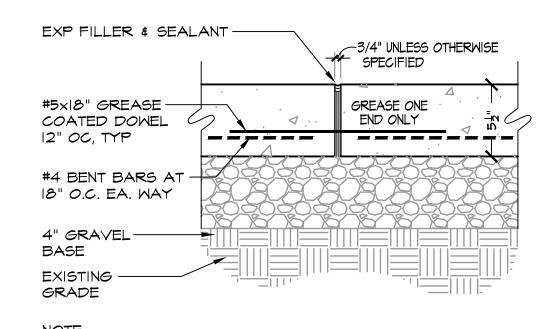


NOTE: FINISHED PATIO MATERIAL NOT SHOWN

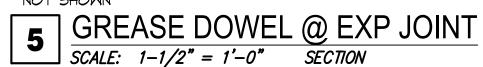

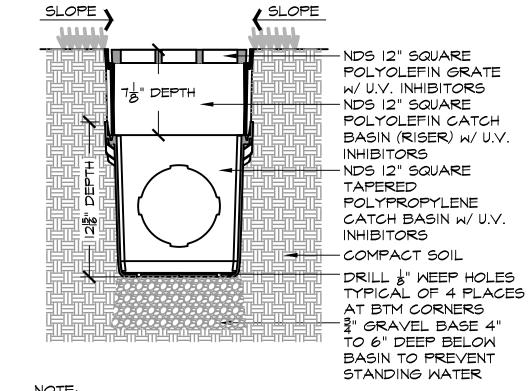

• GRATE TO BE ATTACHED TO BASIN W/ SCREW PROVIDED AT TIME OF INSTALLATION RISER CAN BE CUT TO ACHIEVE EXACT ELEVATION DO NOT USE OVER 5 RISERS W/ CATCH BASIN

# SCALE: 1-1/2" = 1'-0"

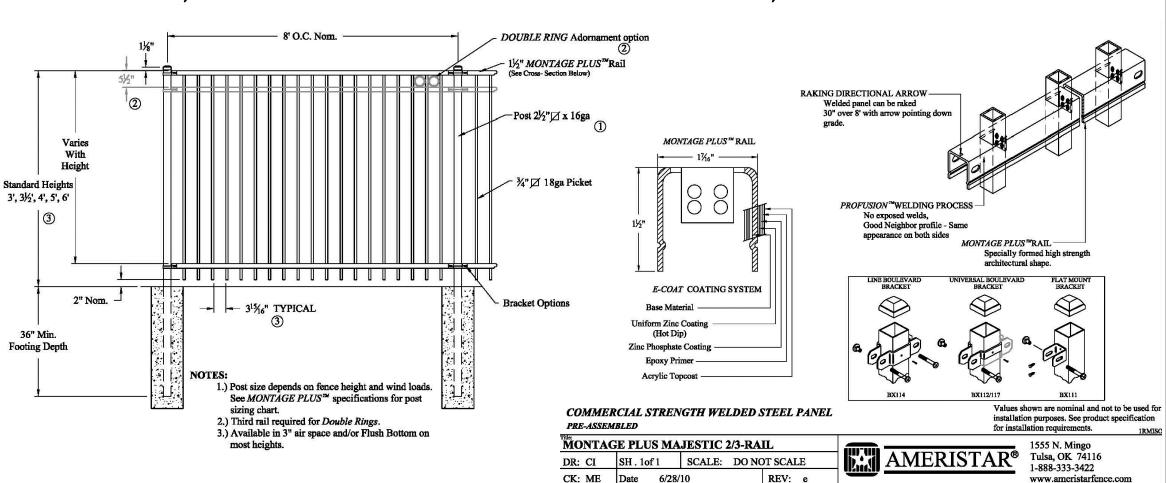

13 POOL FENCING

CK: ME Date 6/28/10 5' HT. BLACK FENCE SUITABLE FOR POOL ENCLOSURE SHALL BE USED AT POOL DECK **DESIGN GROUP** 8021 SANTA FE DRIVE OVERLAND PARK, KS 66204 WWW.LORAXDESIGNGROUP.COM JAMES M. GRANICH NUMBER PE-2014023909 2/22/2021 Missouri COA #001268

RELEASED FOR CONSTRUCTION

J R S

**REVISION:** 

www.ameristarfence.com

**FEBRUARY 23, 2021** SITE DETAILS

 $^{+}$ 0.0




# elswood smith

carlson architects, p.a.

7133 west 95th street suite 200 overland park, ks 66212 ph: 913-649-7557 www.escarchitects.com

elswood smith carlson architects, pa.

reported immediately to the designer. A failure to coope by a simple notice to the designer shall relieve the designer from responsibility for all consequences. Changes mad from the plans without the consent of the designer are unauthorized, and shall relieve the designer or respons for all consequences arriving out of such changes. Contractor shall check and verify all dimensions.

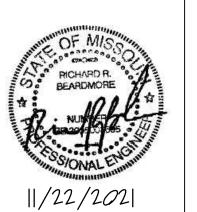

**FARMS** VIEW SUMMIT, I

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SUMMIT,

copyright © elswood smith carlson architects, p.a.

2 CITY REVIEW 11-22-21

Weston E. Coble


Architect KS# 6705 MO# A-2016011206

01/14/2021 revised

design by RRB drawn by CAD struct. by APEX Site Photometric

Plan sheet no.

CONSULTING ENGINEER 3639 SW Summerfield Drive, Suite A Topeka, Kansas 66614-3974 8625 College Boulevard, Suite 102 Overland Park, Kansas 66210 Telephone: (785) 233-3232 Email: Isapa@Isapa.com LSA PROJECT NO. 2004036

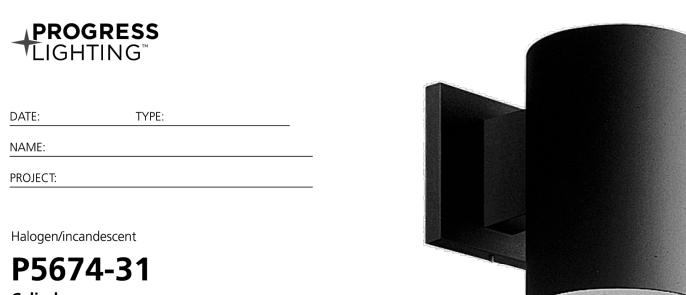

#### Halogen/incandescent

#### Cylinder

5" wall cylinder. The P5674 Series are ideal for a wide variety of interior and exterior applications including residential and commercial. This modular approach results in an encapsulated luminaire that unites performance, cost and safety benefits.

- Black finish.
- Powder coat finish.
- Ideal for a wide variety of interior and exterior applications. Die-cast aluminum wall brackets and heavy duty aluminum framing.

#### Category: Outdoor

Finish: Black (powder coat paint) Construction: Aluminum Construction

Construction: Aluminum Construction
Glass/Shade: Metal shade

MOUNTING	ELECTRICAL	LAMPING	ADDITIONAL INFORMATION
Wall mounted	Pre-wired	Quantity:	UL-CUL Wet location listed
Mounting plate for outlet box included  Back plate covers a standard 4" octagonal recessed outlet box  4.5" W.	6" of wire supplied 120 V	One 75w max. PAR-30 or BR-30 E26 base porcelain socket	1 year warranty

### PROGRESS LIGHTING™

DATE:	TYPE: <b>"E"</b>	
NAME:		
PROJECT:		

#### Halogen/incandescent

#### P5641-20

#### Cylinder

6" downlight wall cylinders are ideal for a wide variety of interior and exterior applications including residential and commercial. The aluminum Cylinders offers a contemporary design with its sleek cylindrical form and elegant Antique Bronze finish, perfect for today's inspired exteriors. Modern details feature a die-cast aluminum wall bracket and heavy-duty aluminum framing - resulting in an impeccable modern accent that adds panache and H/CTR: 4-1/2" sophistication to your outdoor spaces.

Width: 6" Height: 12" Depth: 8-7/8"

- Antique Bronze finish.
- Interior finish matches exterior finish. Ideal for a wide variety of interior and exterior applications.
- One 250w PAR-38 or 150w BR-40.

#### Category: Outdoor Finish: Antique Bronze (powder coat paint)

Construction: Cast aluminum Construction

MOUNTING	ELECTRICAL	LAMPING	ADDITIONAL INFORMATION
Wall mounted	Pre-wired	Quantity:	UL-CUL Wet location listed
Mounting strap for outlet box included  Back plate covers a standard 4" octagonal recessed outlet box	6" of wire supplied 120 V	One 250w max. PAR-38 E26 base porcelain socket	1 year warranty
4.5" W., 4.5" ht., 2.93" depth			

701 Millennium Blvd. Greenville, South Carolina 29607

www.progresslighting.com

Width: 5"

Depth: 8"

Height: 7-1/4"

H/CTR: 2-1/2"

Rev. 05/19

701 Millennium Blvd. Greenville, South Carolina 29607

www.progresslighting.com

Rev. 05/19

Project	Catalog #	Туре	"SL1", "SL2", "SL3", "SL4"
Prepared by	Notes	Date	



#### **McGraw-Edison GLEON Galleon**

Area / Site Luminaire

**Product Features** 

















**Quick Facts** 

**№** Interactive Menu

Ordering Information page 2

Optical Distributions page 4

• Product Specifications page 4


Mounting Details page 3

Control Options page 9

 Lumen packages range from 4,200 - 80,800 (34W - 640W) • Efficacy up to 156 lumens per watt

• Energy and Performance Data page 4

**Dimensional Details** 

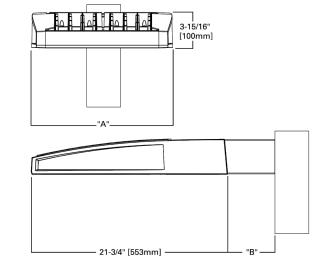

#### WaveLinx Enlighted

Number of Light Squares	"A" Width	"B" Standard Arm Length	"B" Extended Arm Length <sup>1</sup>	"B" Quick Mount Arm Length	"B" Quick Mount Extended Arm Length
1-4	15-1/2"	7"	10"	10-5/8"	16-9/16"
5-6	21-5/8"	7"	10"	10-5/8"	16-9/16"
7-8	27-5/8"	7"	13"	10-5/8"	-
9-10	33-3/4"	7"	16"	-	-
NOTES: For arm selection requirements and additional line art, see Mounting Details section.					

NOTES:

1. Visit <a href="https://www.designlights.org/search/">https://www.designlights.org/search/</a> to confirm qualification. Not all product variations are DLC qualified.

2. IDA Certified for 3000K CCT and warmer only.

**COOPER** PS500020EN page 1 August 2, 2021 5:15 PM

Project	Catalog #	Туре	
Prepared by	Notes	Date	



## **McGraw-Edison BRT6 Bollard** Round LED Pedestrian Luminaire

#### Interactive Menu

- Ordering Information page 2 Product Specifications page 2
- Optical Distributions page 2 • Energy and Performance Data page 3








#### **Quick Facts**

- 4 Optical Distributions Available in 30", 36", and 42"
- Lumen packages range from 560 4400 (5W 49W) Efficacy up to 122 lumens per watt
- Zero uplight on all configurations
- **Dimensional Details**

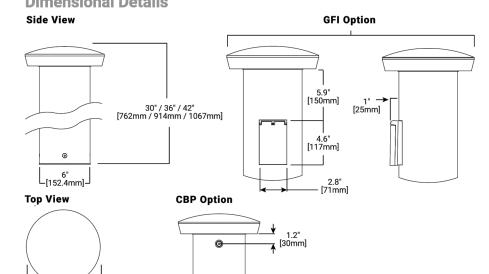


30"	7.2lb (3.3kg)	
36"	8.7lb (4.0kg)	
42"	10.3lb (4.7kg)	
* Base model without option	s or controls	

PS500048EN page 1 October 8, 2021 6:48 PM

COOPER

SL2	Exterior Pole	McGraw Edison	GLEON-AF-01-LED-E1-SL4	pole	bro	nze	(2) 59W 5922 Lumen 4000K led	provide with 15 ft pole
SL3	Exterior Pole	McGraw Edison	GLEON-AF-01-LED-E1-T3	pole	bro	nze	59W 6235 Lumen 4000K led	provide with 15 ft pole
SL4	Bollard	McGraw Edison	BRT6-A2-740-U-T3	bollard	bro	nze	11W 1075 Lumen 4000K led	3 FT w/ WP-GFI receptacle
			CTATICTICS					

SITE 1.1 FC 16.4 FC 0.0 FC N/A N/A

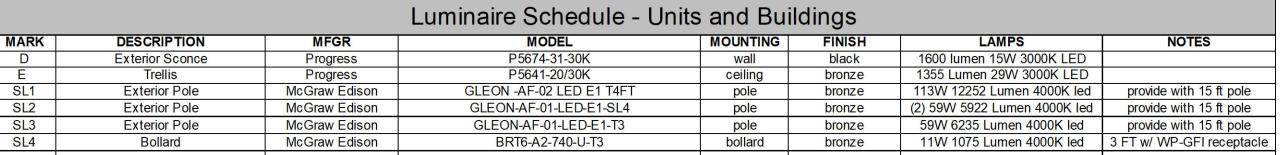







**RELEASED FOR** CONSTRUCTION
As Noted on Plans Review

architects, p.a.

7133 west 95th street suite 200 overland park, ks 66212 ph: 913-649-7557 www.escarchitects.com

elswood smith carlson architects, pa. Kansas state certificate of authority # A-142
Missouri state certificate of authority # 000338

NOTICE DUTY OF COOPERATION
Release of these plans contemplates further cooperation among the owner, his contractor, and the designer. Design and construction are complex. Although the designer and his consultants have performed their service with due care and diligence, they cannot guarantee perfection. Communication is imperfect and every contingency cannot be anticipated. Any ambiguity or discrepancy discovered by the use of these plans shall be reported immediately to the designer. A failure to cooperat by a simple notice to the designer shall relieve the designer from responsibility for all consequences. Changes made from the plans without the consent of the designer of responsibility and shall relieve the designer of responsibility all consequences arriving out of such changes. Contractor shall check and verify all dimensions.



ARMS VIEW SUMMIT POOL HOUSE

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SUMMIT,


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2 CITY REVIEW 11-22-21

Weston E. Coble KS# 6705 MO# A-2016011206 The Professional Architects seal affixed to this sheet applies only to material and items shown on this sheet. All drawings, instruments, or other documents not exhibiting this seal shall not be considered prepared by this architect, and this architect expressly disclaims any and all responsibility for such plan, drawings or document not exhibiting this seal.

project no. 20091 01/14/2021 revised design by RRB drawn by CAD

struct. by APEX **Site Details and Schedules** 

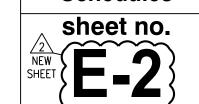

#### CONTRACT DOCUMENTS

ALL CONTRACT DOCUMENTS INCLUDING DRAWINGS, ALTERNATES, ADDENDA AND MODIFICATIONS PRECEDING THIS SPECIFICATION DIVISION ARE APPLICABLE TO MECHANICAL CONTRACTOR AND HIS SUB-CONTRACTORS, AND MATERIAL SUPPLIERS.

#### SPECIFICATION FORM AND DEFINITIONS

THESE SPECIFICATIONS ARE ABBREVIATED FORM AND CONTAIN INCOMPLETE SENTENCES. OMISSIONS OF WORDS OR PHRASES SUCH AS "THE CONTRACTOR SHALL", "SHALL BE", "AS NOTED ON THE DRAWINGS", "ACCORDING TO THE DRAWINGS", "A". "AN". "THE" AND "ALL" ARE INTENTIONAL, OMITTED WORDS AND PHRASES SHALL BE SUPPLIED BY INFERENCE.

- ENGINEER WHEREVER USED IN THESE SPECIFICATIONS, SHALL MEAN LATIMER, SOMMERS & ASSOCIATES, P.A., 3639 SW SUMMERFIELD DRIVE, SUITE A, TOPEKA, KANSAS 66614, PHONE 785-233-3232.
- CONTRACTOR, WHEREVER USED IN THESE SPECIFICATIONS, SHALL MEAN ANY TRADE CONTRACTOR THAT ENTERS INTO CONTRACT WITH THE OWNER TO PERFORM THIS SECTION OF
- WHEN A WORD, SUCH AS "PROPER", "SATISFACTORY", "EQUIVALENT", AND "AS DIRECTED", IS USED, IT REQUIRES ENGINEER'S REVIEW. "PROVIDE" MEANS FURNISH AND INSTALL.

#### QUALIFICATIONS

THE CONTRACTOR(S) RESPONSIBLE FOR WORK UNDER THIS SECTION SHALL HAVE COMPLETED A JOB OF SIMILAR SCOPE AND MAGNITUDE WITHIN THE LAST 3 YEARS AND BE ABLE TO DOCUMENT SUCH WORK UPON REQUEST. THE CONTRACTOR(S) SHALL EMPLOY AN EXPERIENCED, COMPETENT AND ADEQUATE WORK FORCE LICENSED IN THEIR SPECIFIC TRADE AND PROPERLY SUPERVISED AT ALL TIMES. MECHANICAL CONTRACTING SHALL BE THE COMPANY'S PRIMARY NATURE OF BUSINESS. UNLICENSED WORKERS AND GENERAL LABORERS SHALL BE ADEQUATELY SUPERVISED TO INSURE COMPETENT AND QUALITY WORK AND WORKMANSHIP REQUIRED BY THIS CONTRACT AND ALL OTHER REGULATIONS, CODES AND PRACTICES. AT ALL TIMES THE CONTRACTOR(S) SHALL COMPLY WITH ALL APPLICABLE LOCAL, STATE AND FEDERAL GUIDELINES, PRACTICES AND REGULATIONS. CONTRACTOR MAY BE REQUIRED TO SUBMIT A STATEMENT OF QUALIFICATIONS, PERTAINING TO THE TYPE OF WORK TO BE PERFORMED, UPON REQUEST BEFORE ANY FINAL APPROVAL AND SELECTION. FAILURE TO BE ABLE TO COMPLY WITH THESE REQUIREMENTS IS SUITABLE REASON FOR REJECTION OF A BID WHETHER ACTING AS A PRIME OR SUBCONTRACTOR.

#### LOCAL CONDITIONS

VISIT SITE AND DETERMINE EXISTING LOCAL CONDITIONS AFFECTING WORK IN CONTRACT. FAILURE TO DETERMINE SITE CONDITIONS OR NATURE OF EXISTING OR NEW CONSTRUCTION WILL NOT BE CONSIDERED A BASIS FOR GRANTING ADDITIONAL COMPENSATION.

#### CONTRACT CHANGES

CHANGES OR DEVIATIONS FROM CONTRACT, INCLUDING THOSE FOR EXTRA OR ADDITIONAL WORK MUST BE SUBMITTED IN WRITING FOR REVIEW OF ARCHITECT-ENGINEER. NO VERBAL ORDERS WILL BE RECOGNIZED.

#### LOCATIONS AND INTERFERENCES

A. LOCATIONS OF EQUIPMENT, PIPING AND OTHER MECHANICAL WORK IS INDICATED DIAGRAMMATICALLY BY MECHANICAL DRAWINGS. DETERMINE EXACT LOCATIONS ON JOB, SUBJECT TO STRUCTURAL CONDITIONS, WORK OF OTHER CONTRACTORS, ACCESS REQUIREMENTS FOR INSTALLATION AND MAINTENANCE TO APPROVAL OF ARCHITECT-ENGINEER.

#### EXTENT OF CONTRACT WORK AND CODES - MECHANICAL

PROVIDE MECHANICAL SYSTEMS INDICATED ON DRAWINGS. SPECIFIED OR REASONABLY IMPLIED. PROVIDE EVERY DEVICE AND ACCESSORY NECESSARY FOR PROPER OPERATION AND COMPLETION OF MECHANICAL SYSTEMS. IN NO CASE WILL CLAIMS FOR "EXTRA WORK" BE ALLOWED FOR WORK ABOUT WHICH CONTRACTOR COULD HAVE BEEN INFORMED BEFORE BIDS WERE TAKEN.

DRAWINGS AND SPECIFICATIONS INDICATE MINIMUM CONSTRUCTION STANDARD. SHOULD ANY WORK INDICATED BE SUB-STANDARD TO ANY ORDINANCES, LAWS, CODES, RULES OR REGULATIONS BEARING ON WORK, CONTRACTOR SHALL PROMPTLY NOTIFY ARCHITECT-ENGINEER IN WRITING BEFORE PROCEEDING WITH WORK SO THAT NECESSARY CHANGES CAN BE MADE. HOWEVER, IF CONTRACTOR PROCEEDS WITH WORK KNOWING IT TO BE CONTRARY TO ANY ORDINANCES, LAWS, RULES, AND REGULATIONS, CONTRACTOR SHALL THEREBY HAVE ASSUMED FULL RESPONSIBILITY FOR AND SHALL BEAR ALL COSTS REQUIRED TO CORRECT NON-COMPLYING WORK.

#### PIPE HANGERS AND SUPPORTS

PROVIDE AND BE RESPONSIBLE FOR LOCATIONS OF PIPING HANGERS, SUPPORTS AND INSERTS, ETC., REQUIRED FOR INSTALLATION OF PIPING DESIGN OF HANGERS AND SUPPORTS SHALL CONFORM TO CURRENT ISSUE OF MANUFACTURERS STANDARDIZATION SOCIETY SPECIFICATION (MSS) SP-58.

PIPE HANGERS SHALL BE CAPABLE OF SUPPORTING PIPING IN ALL CONDITIONS OF OPERATION. THEY SHALL ALLOW FREE EXPANSION AND CONTRACTION OF PIPING, AND PREVENT EXCESSIVE STRESS RESULTING FROM TRANSFERRED WEIGHT BEING INDUCED INTO PIPE OR CONNECTED EQUIPMENT. SUPPORT HORIZONTAL OR VERTICAL PIPES AT LOCATIONS OF LEAST VERTICAL MOVEMENT.

PROVIDE SUFFICIENT HANGERS TO ADEQUATELY SUPPORT PIPING SYSTEM AT CHANGES IN PIPING DIRECTION AND AT CONCENTRATED LOADS. HANGERS SHALL PROVIDE FOR VERTICAL ADJUSTMENT TO MAINTAIN PITCH REQUIRED FOR PROPER DRAINAGE, AND FOR LONGITUDINAL TRAVEL DUE TO EXPANSION AND CONTRACTION OF PIPING.

#### PIPING AND FITTINGS

PIPING AND FITTINGS USED THROUGHOUT PROJECT SHALL BE AS INDICATED IN SCHEDULE ON PLANS. PIPING SHALL BE PLAINLY MARKED WITH MANUFACTURERS NAME AND WEIGHT. ALL MATERIALS LISTED MAY NOT BE REQUIRED ON THIS PROJECT. SEE PIPING MATERIAL SCHEDULE AT END OF THIS SECTION FOR MATERIALS TO BE USED FOR EACH PIPING SYSTEM. PIPING MATERIALS SHALL BE AS FOLLOWS:

- 1)CONDENSATE DRAIN SCH 40 PVC
- 2)DOM. WATER <2" PEX/CPVC 3)DWV BELOW GRADE - SCH 40 SOLID PVC
- 4)DWV ABOVE GRADE SCH 40 PVC
- 5)GAS ABOVE GRADE SCH 40 BLACK STEEL 6)GAS BELOW GRADE - POLYPROPYLENE
- 7)REFRIGERANT COPPER/SILVER SOLDER

INSTALL NECESSARY VALVES WITHIN PIPING SYSTEMS TO PROVIDE REQUIRED FLOW CONTROL AND TO ALLOW ISOLATION FOR INSPECTION, MAINTENANCE AND REPAIR OF EACH PIECE OF EQUIPMENT OR FIXTURE, AND ON EACH MAIN AND BRANCH SERVICE LOOP.

VALVES INSTALLED IN PIPING SYSTEMS SHALL BE AS SCHEDULED ON PLANS AND SHALL BE COMPATIBLE WITH SYSTEM MAXIMUM TEST PRESSURE, PIPE MATERIALS, PIPE JOINING METHOD, AND FLUID OR GAS CONVEYED IN SYSTEM.

SCHEDULE STOP CHECK BALANCE

1) DOM. WATER <2.5" BRONZE BALL BRONZE SWING AUTO FLOW 2)GAS BRONZE/IRON PLUG

PROVIDE UNIONS IN EACH LINE PRECEDING CONNECTIONS TO EQUIPMENT OR VALVES REQUIRING MAINTENANCE. PROVIDE STOCKHAM BRONZE TO IRON GROUND SEAT UNIONS O MATERIAL AND PRESSURE RATING REQUIRED BY PIPING SYSTEM.

WHERE PIPING SYSTEMS OF DISSIMILAR MATERIALS ARE JOINTED TOGETHER PROVIDE PROPER INSULATING UNION AS SPECIFIED UNDER THIS SPECIFICATION.

#### STRAINERS

INSTALL STRAINERS WHERE SHOWN ON PLANS. STRAINERS SHALL BE SAME SIZE AS PIPING. PROVIDE STRAINERS WITH PROPER ISOLATION AND BLOW DOWN VALVES TO ALLOW BASKET REMOVAL FOR CLEANING. STRAINER SHALL BE SELF CLEANING WITH SCREWED AND GASKETED CAPS AND SCREWED

#### PIPE INSULATION

PROVIDE NECESSARY MATERIALS AND ACCESSORIES FOR INSTALLATION OF INSULATION MECHANICAL SYSTEMS. PROVIDE INSULATION MATERIALS MANUFACTURED BY ARMSTRONG INDUSTRIES, DOW CHEMICAL, SCHULLER.

#### SCHEDULE

1) REFRIGERANT - 3/4" ARMAFLEX DUCTWORK INSULATION

A. PROVIDE NECESSARY MATERIALS AND ACCESSORIES FOR INSTALLATION OF INTERIOR AND EXTERIOR DUCTWORK INSULATION AS SPECIFIED AND/OR DETAILED ON DRAWINGS. PROVIDE INSULATION MATERIALS MANUFACTURED BY SCHULLER, KNAUF FIBERGLASS, CERTAIN/TEED, OR OWENS-CORNING FIBERGLASS.

C. PROVIDE ROUND SHEET METAL DUCTWORK WITH EXTERIOR THERMAL INSULATION OF TYPE AND THICKNESS LISTED IN INSULATION SCHEDULE, APPLY INSULATION WITH JOINTS TIGHTLY BUTTED TOGETHER WITH LONGITUDINAL AND END JOINT STRIPS SEALED WITH VAPOR BARRIER ADHESIVE. INSULATE FITTINGS WITH INSULATION THICKNESS EQUAL TO ADJOINING INSULATION WITH COVER OVERLAPPING 2" ONTO ADJACENT COVERING.

D. DUCT INSULATION MATERIALS BY TYPE SHALL BE AS FOLLOWS:

TYPE 2-DEW: EXTERNAL THERMAL INSULATION SHALL BE 1.0 LB. DENSITY STANDARD DUCT INSULATION TYPE IV WITH FOIL-SCRIM-CRAFT FACING AND .27 BTUH THERMAL CONDUCTIVITY AT 75 DEGREES MEAN TEMPERATURE.

E. SPECIFIC INSULATION MATERIALS AND INSTALLATION

METHODS FOR DUCTWORK SYSTEMS SHALL BE AS FOLLOWS:

INSULATION

TYPE DUCTWORK SYSTEM THICKNESS

ROUND/RECTANGULAR SUPPLY 2-DEW 1-1/2" EXHAUST -NONE

#### DUCTWORK

A. CONSTRUCT DUCTWORK AS DETAILED ON DRAWINGS AND AS DETAILED IN THE LATEST EDITION OF THE SHEET METAL AND AIR CONDITIONING CONTRACTOR'S ASSOCIATION (SMACNA) DUCT

B. CONSTRUCT AND INSTALL DUCTWORK TO BE COMPLETELY FREE FROM VIBRATION UNDER ALL CONDITIONS OF OPERATION. SUPPORT AND SECURELY ANCHOR DUCTWORK AND EQUIPMENT FROM STRUCTURAL FRAMING OF BUILDING. PROVIDE SUITABLE INTERMEDIATE METAL FRAMING WHERE REQUIRED BETWEEN BUILDING STRUCTURAL FRAMING.

C. SEALING OF DUCTWORK SHALL BE WITH CLASS 'C' CAULK.

#### GRILLES, REGISTERS AND DIFFUSERS

PROVIDE GRILLES, REGISTERS AND DIFFUSERS AS SHOWN ON THE DRAWINGS AND HEREINAFTER SPECIFIED. SET ALL UNITS WITH RUBBER GASKETS FOR AIR TIGHT CONNECTION WITH MOUNTING SURFACE, SEE DRAWINGS FOR TYPES, SIZES, AIR FLOW AND QUANTITY.

B. INSTALL ALL REGISTERS WITH CURVE OF LOUVER AWAY FROM LINE OF SIGHT. UNLESS NOTED OTHERWISE, PROVIDE DUCT MOUNTED DIFFUSERS AND REGISTERS WITH STANDARD MARGINS. FINISH SHALL BE OFF WHITE WHEN MOUNTED IN CEILING, PRIME COAT WHEN MOUNTED ON WALL FINISH.

#### SPLIT SYSTEMS - AIR HANDLERS

A. AIR HANDLING UNITS SHALL BE COMPLETELY FACTORY ASSEMBLED INCLUDING COIL, CONDENSATE DRAIN PAN, FAN MOTOR(S), FILTERS AND CONTROLS IN AN INSULATED CASING THAT CAN BE APPLIED IN EITHER VERTICAL OR HORIZONTAL CONFIGURATION. UNITS SHALL BE RATED AND TESTED IN ACCORDANCE WITH ARI STANDARD 210/240, 340/360. UNITS SHALL BE UL LISTED AND LABELED IN ACCORDANCE WITH UL 465/1995 FOR INDOOR BLOWER COIL UNITS.

B. UNIT CASING SHALL BE CONSTRUCTED OF ZINC COATED. HEAVY GAUGE, GALVANIZED STEEL. CASING SHALL BE COMPLETELY INSULATED WITH CLEANABLE, FOIL-FACED, FIRE-RETARDANT, PERMANENT, ODORLESS GLASS FIBER MATERIAL. ALL INSULATION EDGES SHALL BE EITHER CAPTURED OR SEALED. KNOCKOUTS SHALL BE PROVIDED FOR UNIT ELECTRICAL POWER AND REFRIGERANT PIPING CONNECTIONS.

CAPTIVE SCREWS SHALL BE STANDARD ON ALL ACCESS PANELS. C. EVAPORATOR COIL TO HAVE CONFIGURED ALUMINUM FIN SURFACE, MECHANICALLY BONDED TO 3/8" INTERNALLY ENHANCED COPPER TUBING AND FACTORY PRESSURE AND LEAK TESTED AT 365 PSIG. COIL IS ARRANGED FOR DRAW-THROUGH AIRFLOW AND SHALL PROVIDE A DOUBLE SLOPED CONDENSATE DRAIN PAN CONSTRUCTED OF PVC PLASTIC.

D. EVAPORATOR FAN SHALL BE DOUBLE INLET, DOUBLE WIDTH, FORWARD CURVED, DIRECT DRIVE CENTRIFUGAL-TYPE FAN(S). THERMAL OVERLOAD PROTECTION SHALL BE STANDARD ON MOTOR. FAN AND MOTOR BEARINGS SHALL BE PERMANENTLY LUBRICATED.

E. MAGNETIC EVAPORATOR FAN CONTACTOR, LOW VOLTAGE TERMINAL STRIP, CHECK VALVE(S), AND SINGLE POINT POWER ENTRY AND DISCONNECT SHALL BE INCLUDED. ALL CONTROLS SHALL BE FACTORY-INSTALLED AND WIRED. EVAPORATOR DEFROST CONTROL SHALL BE INCLUDED TO PREVENT COMPRESSOR SLUGGING BY TEMPORARILY INTERRUPTING COMPRESSOR OPERATION WHEN LOW EVAPORATOR COIL TEMPERATURES ARE ENCOUNTERED.

F. FILTERS SHALL BE ONE INCH MERV-8 THROWAWAY. FILTERS SHALL BE ACCESSIBLE FROM THE FRONT OF THE UNIT. G. PROVIDE MANUAL CHANGEOVER 7-DAY (NOT 5/2) PROGRAMMABLE HEATING/COOLING THERMOSTAT.

SPLIT SYSTEMS - OUTDOOR UNITS

CASING SHALL BE GALVANIZED STEEL WITH WEATHER RESISTANT POWDER PAINT. REFRIGERANT CONTROLS TO INCLUDE CONDENSER FAN AND COMPRESSOR CONTACTOR AND CONTROL SYSTEM.

COMPRESSOR OVERLOAD PROTECTION, AND SERVICE VALVES ARE

TO BE PROVIDED. HERMETIC COMPRESSOR TO HAVE OVER TEMPERATURE/PRESSURE PROTECTION, EPOXY-DIPPED WINDINGS. A 5 YEAR LIMITED COMPRESSOR WARRANTY TO BE

INCLUDED.

CONDENSER COIL TO BE COPPER TUBES, ALUMINUM FINS WITH BRAZED JOINTS PROTECTED BY LOUVERED PANELS. PROVIDE ALL ACCESSORIES FOR PROPER SYSTEM OPERATION TAKING INTO CONSIDERATION REFRIGERANT PIPE LENGTH, EXPOSURE AND POSITION FROM AHU TO ACCOUNT FOR EACH SPECIFIC UNIT INSTALLATION. REVIEW DRAWINGS WITH SUPPLIER.

F AIR HANDLERS TO BE PIPED TO APPROPRIATE DRAIN, MOUNTED WITH ACCESS FOR SERVICE, WITH FLEXIBLE DUCT CONNECTIONS. OUTDOOR UNITS SHALL BE MOUNTED ON MONOLITHIC CONCRETE PADS. STRAP DOWN CONDUITS AND SECURE DX PIPING TO WALL OR SLAB WHERE OVER 3 FEET IN LENGTH. INSTALL WITH CLEARANCES PER MANUFACTURER'S RECOMMENDATIONS.

#### ELECTRICAL SPECIFICATIONS

#### ELECTRICAL

#### EXTENT OF CONTRACT WORK AND CODES

PROVIDE ELECTRICAL SYSTEMS INDICATED ON DRAWINGS, SPECIFIED OR REASONABLY IMPLIED. PROVIDE EVERY DEVICE AND ACCESSORY NECESSARY FOR PROPER OPERATION AND COMPLETION OF ELECTRICAL SYSTEMS. IN NO CASE WILL CLAIMS FOR "EXTRA WORK" BE ALLOWED FOR WORK ABOUT WHICH ELECTRICAL CONTRACTOR COULD HAVE BEEN INFORMED BEFORE BIDS WERE TAKEN.

DRAWINGS AND SPECIFICATIONS INDICATE MINIMUM CONSTRUCTION STANDARD, SHOULD ANY WORK INDICATED BE SUB-STANDARD TO ANY ORDINANCES, LAWS, CODES, RULES OR REGULATIONS BEARING ON WORK, CONTRACTOR SHALL PROMPTLY NOTIFY ARCHITECT/ENGINEER IN WRITING BEFORE PROCEEDING WITH WORK SO THAT NECESSARY CHANGES CAN BE MADE. HOWEVER, IF ELECTRICAL CONTRACTOR PROCEEDS WITH WORK KNOWING IT TO BE CONTRARY TO ANY ORDINANCES, LAWS, RULES, AND REGULATIONS HE SHALL THEREBY HAVE ASSUMED FULL RESPONSIBILITY FOR AND SHALL BEAR ALL COSTS REQUIRED TO CORRECT NON-COMPLYING

#### BASIC MATERIALS AND METHODS

#### IDENTIFICATION OF WIRING

ALL WIRES FOR BRANCH CIRCUIT WORK SHALL BE COLOR CODED. IDENTIFY THE SAME PHASE CONDUCTOR OF SAME VOLTAGE SYSTEM WITH SAME COLOR THROUGHOUT.

ALL BRANCH CIRCUITS SHALL HAVE DEDICATED HOT, NEUTRAL, GROUND. COMMON NEUTRALS SHALL NOT BE UTILIZED. ONE GROUNDING CONDUCTOR CAN BE PROVIDED FOR A MAXIMUM OF (3) SINGLE PHASE CIRCUITS, EACH ON A SEPARATE PANEL PHASE IN A COMMON CONDUIT.

#### CONDUCTORS

PROVIDE CODE GRADE SOFT ANNEALED COPPER CONDUCTORS WITH SPECIFIED COLORED INSULATION TO CONFORM WITH COLOR CODING SPECIFIED. COMPACT ALUMINUM MAY BE USED FOR FEEDERS LARGER THAN #2 AS PER CODE AND LOCAL JURISDICTION. PROVIDE CONDUCTORS NO. 8 GAUGE AND LARGER STRANDED AND CONDUCTORS NO. 10 GAUGE AND SMALLER SHALL BE SOLID.

USE NO CONDUCTORS SMALLER THAN NO. 12 GAUGE UNLESS SPECIFICALLY CALLED FOR OR APPROVED BY

#### PROVIDE CONDUCTORS FOR LISTED APPLICATIONS AS

LIGHTING AND RECEPTACLE CIRCUITS: TYPE THWN, OR THWN/THHN 600 VOLT, 75 DEGREES C (1670F) HERMOPLASTIC INSULATED BUILDING CONDUCTOR OR BETTER. TYPE NM MAY BE USED WHERE ALLOWED BY LOCAL CODE AND THE NEC. NO EXTERIOR CIRCUITS MAY BE TYPE NM.

LIGHTING AND RECEPTACLES CIRCUITS WITH NO. 8 OR ARGER CONDUCTORS, MOTOR CIRCUITS, POWER AND FEEDER CIRCUITS AND BUILDING SERVICE FEEDERS: TYPE THHN/THWN 600 VOLTS, 75 DEGREES C (1670F) THERMOPLASTIC INSULATED BUILDING CONDUCTOR

#### CONDUCTOR INSTALLATION

RUN CONDUCTORS IN CONDUIT CONTINUOUS BETWEEN OUTLETS AND JUNCTION BOXES WITH NO SPLICES OR TAPS PULLED INTO CONDUITS.

NEATLY ROUTE, TIE AND SUPPORT CONDUCTORS TERMINATING AT SWITCHBOARDS, MOTOR CONTROL CENTERS, PANELBOARDS, SOUND EQUIPMENT, ETC., WITH THOMAS & BETTS TY-RAP CABLE TIES AND CLAMPS OR EQUIVALENT BY LECTROVERT OR PANDUIT.

#### GROUNDING

SUPPLEMENT GROUNDED NEUTRAL OF SECONDARY DISTRIBUTION SYSTEM WITH EQUIPMENT GROUNDING SYSTEM, INSTALLED SO THAT METALLIC STRUCTURES, ENCLOSURES, RACEWAYS, JUNCTION BOXES, OUTLET BOXES, CABINETS, MACHINE FRAMES, PORTABLE EQUIPMENT AND OTHER CONDUCTIVE ITEMS OPERATE CONTINUOUSLY AT GROUND POTENTIAL AND PROVIDE LOW IMPEDANCE PATH FOR GROUND FAULT CURRENTS.

SYSTEM SHALL COMPLY WITH NATIONAL ELECTRICAL CODE AND AS SPECIFIED.

#### GROUNDING CONNECTIONS

EQUIPMENT GROUNDING CONDUCTORS FOR BRANCH CIRCUIT HOME RUNS SHOWN ON THE DRAWINGS SHALL INDICATE AN INDIVIDUAL AND SEPARATE GROUND CONDUCTOR FOR THAT BRANCH CIRCUIT WHICH SHALL BE TERMINATED AT THE BRANCH CIRCUIT PANELBOARD, SWITCHBOARD, OR OTHER DISTRIBUTION EQUIPMENT. GROUNDING CONDUCTORS SIZED ACCORDING TO THE SIZE OF THE OVERCURRENT DEVICE AND NEC TABLE 250-95 SHALL BE ALLOWED.

REQUIRED EQUIPMENT GROUNDING CONDUCTORS AND STRAPS SHALL BE SIZED IN COMPLIANCE WITH N.E.C. TABLE 250-95. EQUIPMENT GROUNDING CONDUCTORS SHALL BE PROVIDED WITH GREEN TYPE TW 600 VOLT INSULATION. RELATED FEEDER AND BRANCH CIRCUIT GROUNDING CONDUCTORS SHALL BE CONNECTED TO GROUND BUS WITH APPROVED PRESSURE CONNECTORS.

PROVIDE LOW VOLTAGE DISTRIBUTION SYSTEM WITH A SEPARATE GREEN INSULATED EQUIPMENT GROUNDING CONDUCTOR FOR EACH SINGLE-PHASE FEEDER. SINGLE PHASE 120 VOLT BRANCH CIRCUITS FOR LIGHTING AND POWER SHALL CONSIST OF PHASE AND NEUTRAL CONDUCTORS AND A GREEN GROUND CONDUCTOR INSTALLED IN COMMON METALLIC CONDUIT WHICH SHALL SERVE AS GROUNDING CONDUCTOR. PROVIDE FLEXIBLE METALLIC CONDUIT UTILIZED IN CONJUNCTION WITH ABOVE SINGLE PHASE BRANCH CIRCUITS WITH SUITABLE GREEN INSULATED GROUNDING CONDUCTORS CONNECTED TO APPROVED GROUNDING TERMINALS AT EACH END OF FLEXIBLE CONDUIT. SINGLE PHASE BRANCH CIRCUIT INSTALLED IN NONMETALLIC CONDUITS SHALL BE PROVIDED WITH SEPARATE GROUNDING CONDUCTOR. INSTALL GROUNDING CONDUCTOR IN COMMON CONDUIT WITH RELATED PHASE AND/OR NEUTRAL CONDUCTORS. WHERE PARALLEL FEEDERS ARE INSTALLED IN MORE THAN ONE RACEWAY, EACH RACEWAY SHALL HAVE A GREEN INSULATED EQUIPMENT GROUNDING CONDUCTOR.

D. GROUNDING CONDUCTORS SHALL BE AS SHOWN ON PLANS OR IF NOT SPECIFICALLY SHOWN SHALL BE NO SMALLER THAN THAT REQUIRED BY THE NEC.

#### CONDUITS

CONDUIT

CONDUIT OR GALVANIZED RIGID STEEL TUBING: (EMT)

CONDUIT SHALL BE GALVANIZED STEEL ELECTRICAL METALLIC TUBING AND BEAR AND UNDERWRITERS' LABORATORY LABEL. CONDUIT SHALL CONFORM TO FEDERAL SPECIFICATION WWC-563 AND ANSI SPECIFICATION C80.3.

B. MC CABLE AND FLEXIBLE METAL CONDUIT: WHERE ALLOWABLE BY CODE, MC CABLE AND FLEXIBLE METAL CONDUIT (FMC) WITH CONDUCTORS AND GROUND MAY BE USED ONLY IN THE FORM OF 8' WHIPS (OR LESS) FOR BRANCH CIRCUIT DROPS FROM JBS TO INDIVIDUAL LIGHTING FIXTURES, VAV BOXES, SMALL EXHAUST FANS, AND OTHER FRACTIONAL HP EQUIPMENT. IN ALL CASES, THE FLEXIBLE CONDUIT AND/OR MC CABLE SHALL CONTAIN A DEDICATED EQUIPMENT GROUNDING CONDUCTOR.

C. RIGID SCH. 40 PVC MAY BE USED BELOW SLAB/GRADE.

#### CONDUIT FITTINGS

A. EMT CONDUIT: COUPLINGS AND BOX CONNECTORS SHALL BE DIE CAST SET SCREW TYPE. UNILETS SHALL BE MALLEABLE IRON WITH BLANK COVER.

B. FLEXIBLE CONDUIT: CONNECTORS SHALL BE THREADED TYPE IRON WITH INSULATED THROAT.

C. PROVIDE GROUNDING BUSHINGS WHERE FEEDER CONDUIT ATTACHES TO PANELBOARD BACKBOX. BOND GROUNDING BUSHING TO GROUND BUS.

#### CONDUIT INSTALLATION

A. ALIGN CONDUIT TERMINATIONS AT PANELBOARDS, SWITCHBOARDS, MOTOR CONTROL EQUIPMENT, JUNCTION BOXES, ETC. AND INSTALL TRUE AND PLUMB. PROVIDE SUPPORTS OR TEMPLATES TO HOLD CONDUIT ALIGNMENT DURING ROUGH-IN STAGE OF WORK.

B. INSTALL CONDUIT CONTINUOUS BETWEEN OUTLET BOXES, CABINETS AND EQUIPMENT. MAKE BENDS SMOOTH AND EVEN WITHOUT FLATTENING OR FLAKING CONDUIT. RADIUS OF BENDS SHALL NOT BE SHORTER THAN RADIUS LISTED IN THE NEC. LONG RADIUS ELBOWS MAY BE USED WHERE NECESSARY.

C. INSTALL NO CONDUITS OR OTHER RACEWAYS SIZED SMALLER THAN PERMITTED IN APPLICABLE NEC TABLES. WHERE CONDUIT SIZES SHOWN ON DRAWINGS ARE SMALLER THAN PERMITTED BY CODE, CONTRACTOR SHALL INCLUDE COST FOR PROPER SIZE CONDUIT IN HIS BASE BID. IN NO CASE REDUCE CONDUIT SIZES INDICATED ON DRAWINGS OR SPECIFIED WITHOUT WRITTEN APPROVAL OF ENGINEER.

#### OUTLET BOXES

PROVIDE ELECTRICAL SERVICE OUTLETS, INCLUDING PLUG RECEPTACLES, LAMP RECEPTACLES, LIGHTING FIXTURES AND SWITCHES WITH STEEL CITY, RACO, OR EQUIVALENT FOUR INCH CODE GAUGE STEEL KNOCKOUT BOXES GALVANIZED OR SHERADIZED OF REQUIRED DEPTH FOR SERVICE OR DEVICE.

B. PVC BOXES MAY BE USED WHERE NOT EXPOSED.

#### SWITCHES, RECEPTACLES AND COVER PLATES

PROVIDE WHERE SHOWN ON PLANS WIRING DEVICES. PART NUMBERS SHALL BE AS LISTED FOR EACH DEVICE SPECIFIED. EQUIVALENT DEVICES BY HUBBELL, PASS & SEYMOUR.

#### INDUSTRY REFERENCES

A. UNDERWRITER'S LABORATORIES (UL)

SWITCHES (UL 20) RECEPTACLES, PLUGS & CONNECTORS (UL 498) PIN & SLEEVE CONNECTORS (UL 1286) DEVICE PLATES (UL 514) GFC1'S (UL 943)

B. NATIONAL ELECTRIC MANUFACTURERS ASSOCIATION (NEMA) WD-1 (DEVICES, PLATES, COLORS) WD-6

A. GENERAL: PROVIDE FACTORY-FABRICATED WIRING DEVICES IN TYPES, COLORS, AND ELECTRICAL RATINGS FOR APPLICATIONS INDICATED. WHEREVER POSSIBLE, DEVICES SHALL BE BACK AND SIDE WIRED. ALL SWITCHES AND RECEPTACLES SHALL INCORPORATE A METAL MOUNTING STRAP: NON-METALLIC MOUNTING STRAPS ARE NOT ACCEPTABLE. SWITCHES SHALL BE SPEC GRADE AND LISTED PER UL 20 AND CERTIFIED BY UL TO FED SPEC. WS-596E. RECEPTACLES SHALL BE SPEC GRADE AND LISTED PER UL 498 AND CERTIFIED BY UL TO FED. SPEC. WS-896E. BOTH SWITCHES AND RECEPTACLES SHALL BE VISIBLY MARKED WITH THE "UL-FS" MARK TO CONFIRM CERTIFICATION. ALL DEVICES SHALL BE FROM THE SAME MANUFACTURER. ALL DEVICES SHALL BE GRAY UNLESS OTHERWISE ON PLANS. ALL SURFACE RACEWAY SHALL BE SATIN ALUMINUM UNLESS NOTED OTHERWISE ON PLANS.

B. EACH CONVENIENCE RECEPTACLE OUTLET SHALL BE EQUIPPED WITH A 20 AMPERE DUPLEX PLUG RECEPTACLES EXCEPT WHERE NOT ON A CODE-REQUIRED DWELLING UNIT 20-AMP CIRCUIT AND THEN MAY BE 15 AMP. RECEPTACLES SHALL BE 3 WIRE GROUNDING TYPE. RECEPTACLES SHALL BE RESIDENTIAL GRADE, TAMPER-RESISTANT PER CODE WHERE IN DWELLING UNITS AND SPEC GRADE ELSEWHERE.

#### SWITCH AND RECEPTACLE FLUSH WALL PLATES

WALL PLATES: WALL PLATES FOR ALL FLUSH OUTLETS AND SWITCHES SHALL BE SMOOTH STAINLESS STEEL. ALL PLATES SHALL OF THE SAME MANUFACTURER AS THE DEVICES. PLATES FOR SURFACE MOUNTED DEVICE OUTLETS SHALL BE DRAWN GALVANIZED STEEL FOR STEEL BOXES AND CAST FOR CAST BOXES.

#### LIGHTING FIXTURES

A. PROVIDE LIGHTING FIXTURES COMPLETE WITH NOTED LAMP SOURCES AND ACCESSORIES REQUIRED FOR INSTALLATION. CONTRACTOR SHALL INSURE THAT FIXTURES ARE CLEAN AT TIME OF FINAL INSPECTION. MOUNT RECESSED FIXTURES WITH TRIM FLUSH TO CEILINGS, FREE OF GAPS OR CRACKS.

B. COORDINATE MOUNTING OF CEILING MOUNTED LIGHTING FIXTURES WITH GENERAL CONTRACTOR. WHERE ADDITIONAL FIXTURE SUPPORTS ARE REQUIRED DUE TO LIGHTING FIXTURE LOCATION OR WEIGHT, SUPPORTS SHALL BE PROVIDED BY ELECTRICAL CONTRACTOR, UNLESS OTHERWISE SPECIFIED UNDER CEILING SPECIFICATIONS.

#### CIRCUIT BREAKER PANELBOARDS

PROVIDE DEAD\_FRONT PANELBOARDS WITH MOLDED CASE CIRCUIT BREAKERS AS LISTED IN SCHEDULE. PANELBOARDS SHALL CONFORM TO NEMA STANDARD PUBLICATION NO. PB $_{-1}$  AND UL STANDARDS NO. 50 & 67 FOR PANELBOARDS.

BOXES SHALL BE GALVANIZED STEEL STANDARD WIDTH AND DEPTH EXCEPT WHERE SCHEDULED OTHERWISE. FRONTS SHALL BE CODE GAUGE STEEL FINISHED WITH RUST\_INHIBITING PRIMER AND BAKED ENAMEL FINISH. FRONTS SHALL HAVE FLUSH DOORS WITH FLUSH CYLINDER TUMBLER TYPE LOCKS, SPRING\_LOADED DOOR PULLS, CONCEALED DOOR HINGES. PROVIDE DOORS HIGHER THAN 48" WITH THREE POINT CATCH.

PROVIDE TIN\_FINISHED ALUMINUM BARS FULL LENGTH OF PANEL WITH RATING LISTED IN SCHEDULE. BUS BAR CONNECTION TO BRANCH CIRCUIT BREAKERS SHALL BE "PHASE SEQUENCE" TYPE DESIGNED AND ASSEMBLED SO CIRCUIT BREAKERS CAN BE REPLACED WITHOUT DISTURBING ADJACENT BREAKERS OR REMOVING MAIN BUS OR BRANCH CIRCUIT CONNECTORS. PROVIDE BUS BARS WITH WIRE LUGS SUITABLE FOR COPPER OR ALUMINUM CONDUCTORS. PROVIDE EACH PANEL WITH EQUIPMENT GROUNDING BUS GROUNDED TO BOX AND NEUTRAL BUS INSULATED FROM BOX.

BRANCH CIRCUIT BREAKERS SHALL BE QUICK\_MAKE, QUICK\_BREAK WITH TRIP INDICATION. CIRCUIT BREAKERS SHALL OPERATE BOTH MANUALLY FOR NORMAL SWITCH FUNCTIONS AND AUTOMATICALLY UNDER OVERLOAD AND SHORT CIRCUIT CONDITIONS. OPERATING HANDLE OF CIRCUIT BREAKER SHALL OPEN AND CLOSE ALL POLES OF A MULTI-POLE BREAKER SIMULTANEOUSLY AND CONFORM TO NEMA STANDARDS PUBLICATIONS NO. PB\_1 AND BE APPROVED BY UL. CIRCUIT BREAKER SHALL HAVE A THERMAL MAGNETIC TRIP UNIT FOR EACH POLE FOR INVERSE TIME DELAYED OVERLOAD PROTECTION AND AN INSTANTANEOUS MAGNETIC ELEMENT FOR SHORT CIRCUIT PROTECTION.

E. PANELS SHALL HAVE BRANCH CIRCUIT DIRECTORY HOLDERS WITH CLEAR PLASTIC COVER. PROVIDE NEATLY TYPED LIST OF BRANCH CIRCUIT LOADS CORRESPONDING INDICATING EQUIPMENT SERVED AND SPECIFIC LOCATION TO BRANCH CIRCUIT NUMBERS.

PANELBOARDS FOR APARTMENTS SHALL BE SQUARE "D" NOOD FOR 400 A AND LESS.

#### DISCONNECT SWITCHES

PROVIDE HEAVY DUTY HORSEPOWER RATED SAFETY SWITCHES RATED IN ACCORDANCE WITH NEMA ENCLOSED SWITCH STANDARD KS 1\_1969 AND L98 STANDARD.

ENCLOSURE SHALL BE NEMA TYPE REQUIRED BY

SWITCH LOCATION AND ENVIRONMENT, ENCLOSURE DOOR SHALL LATCH WITH MEANS FOR PADLOCKING AND COVER INTERLOCK WITH DEFEATER TO PREVENT OPENING DOOR WHEN SWITCH IS ENERGIZED OR CLOSING SWITCH WITH DOOR OPEN. FUSE HOLDERS SHALL BE HIGH PRESSURE SUITABLE

FOR USE WITH DUAL ELEMENT FUSES OR REJECTION TYPE

CURRENT LIMITING FUSES WHERE REQUIRED. FUSE HOLDERS

SHALL BE COMPLETELY ACCESSIBLE FROM FRONT OF SWITCH.

**RELEASED FOR** CONSTRUCTION As Noted on Plans Revie

carlson

|architects, p.a.

overland park, ks 66212

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unauthorized, and shall relieve the designer or responsibil
for all consequences arriving out of such changes.

for all consequences arriving out of such changes. Contractor shall check and verify all dimensions.

RICHARD R.

BEARDMORE

elswood smith carlson architects, pa

Kansas state certificate of authority # A-142 Missouri state certificate of authority # 000338

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ph: 913-649-7557

suite 200

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Weston E. Coble

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revised

drawn by CAD struct. by APEX Mech/Elec **Specifications** 

design by RRB

sheet no.

ONSULTING ENGINEER 3639 SW Summerfield Drive, Suite A Topeka, Kansas 66614-3974 8625 College Boulevard, Suite 102 Overland Park, Kansas 66210 Telephone: (785) 233-3232 Email: lsapa@lsapa.com LSA PROJECT NO. 2004036

- SEE CIVIL, ARCHITECTURAL AND LANDSCAPE DRAWING FOR FURTHER INFORMATION AND WORK.
- NOTIFY UTILITY PROVIDERS PRIOR TO ANY EXCAVATION, TRENCHING OR GRADING TO MARK UTILITIES.
- PROVIDE ALL UTILITY PROVIDER REQUIREMENTS WITH REGARDS TO INTERFACING WITH THEIR WORK AND INCLUDE ALL ITEMS REQUIRED FOR PROPER INSTALLATION.
- TRANSFORMER AND PRIMARY LOCATIONS ARE TO BE VERIFIED WITH THE PROVIDER AS TO FINAL LOCATIONS BASED ON THEIR DESIGN AND CONTRACTOR REQUIREMENTS.
- ALL SITE LIGHTING CIRCUITS ROUTE THROUGH PHOTOCELL/TIME CLOCK AND HAVE (3) #10 WIRES UNLESS NOTED OTHERWISE.
- POLE FIXTURES SHALL HAVE SCREW IN BASE, FLUSH WITH GRADE. POLE SHALL BE 15' AND FIXTURE AT TOP SHALL NOT EXTEND ABOVE TOP OF THE POLE.

#### LEGEND:

- 1) THRU PHOTOCELL/TIMECLOCK.
- 2 6" POOL BACKWASH TO SITE DRAIN. SEE CIVIL, CONFORM TO CITY STANDARDS.

Pevelopment Services Depart Swinning Missouri


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11/22/2021

# **FARMS** LEE'S SUMMIT, I SUMMIT POOL HOUSE

MISSOU

1 UPDATES
2 CITY REVIEW 11-22-21

Weston E. Coble Architect KS# 6705

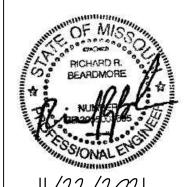design by RRB drawn by CAD struct. by APEX


Site Plan -

Mech/Elec sheet no.

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NOTES: PLUMBING

- COORDINATE WITH OTHER SUB-CONTRACTORS FOR PLACEMENT OF WORK PRIOR TO INSTALLATION BEGINNING.
- ALL DRAIN, WASTE AND VENT PIPING IS 2" UNLESS NOTED OTHERWISE. ALL 2" AND 3" WASTE SLOPE AT 1/4" PER FT. PIPING 4" AND GREATER MAY BE AT 1/8" PER FT UNLESS NOTED OTHERWISE.
- ANY BELOW SLAB SUPPLY PIPING SHALL BE PEX WITH NO JOINTS.
- ALL SUPPLY PIPING IS 1/2" UNLESS NOTED OTHERWISE OR REQUIRED BY THE PLUMBING CODE.
- CONNECT ALL APPLIANCES OR EQUIPMENT PER
- ALL PLUMBING VENTS SHALL BE 10 FEET FROM OPENINGS OR INTAKES.

MANUFACTURER'S INSTRUCTIONS.

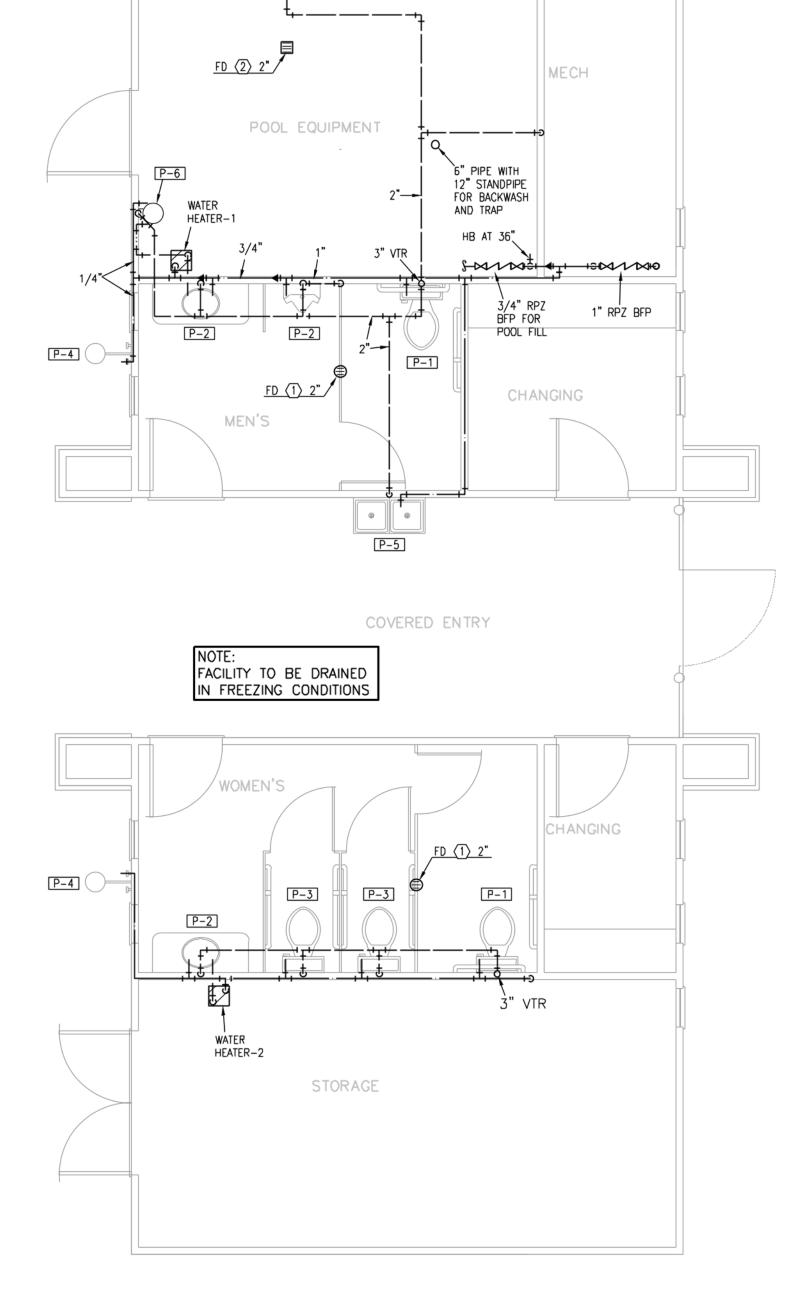- ALL FIXTURES SHALL HAVE AIR CHAMBERS OR BLADDER TYPE SHOCK SUPPRESSORS FOR EACH CHASE.
- SEE THE ARCHITECTURAL DRAWINGS FOR ALL MOUNTING HEIGHTS.
- REFER TO THE ARCHITECTURAL DRAWINGS FOR FLOOR DRAIN LOCATIONS AND FLOOR SLOPES IF PRESENT. ALL FLOOR DRAINS ARE 2" TYPE 1 UNLESS NOTED OTHERWISE.
- O. ROUTE DRAIN PIPING FROM WATER HEATERS, AIR HANDLERS OR EQUIPMENT TO FLOOR DRAINS. PROVIDE PROPER TRAPS.
- 1. ROUTE NO PIPING OVER ELECTRICAL EQUIPMENT.



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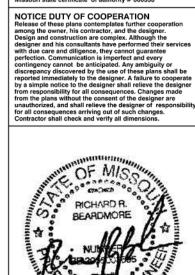
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01/14/2021

**FARMS** VIEW

SUMMIT POOL HOUSE
-----LEE'S SUMMIT, I

MISSOU

Weston E. Coble
Architect
KS# 6705

project no. 20091
date 01/14/2021

revised design by RRB
drawn by CAD
struct. by APEX

First Floor Plan - Mech/Elec

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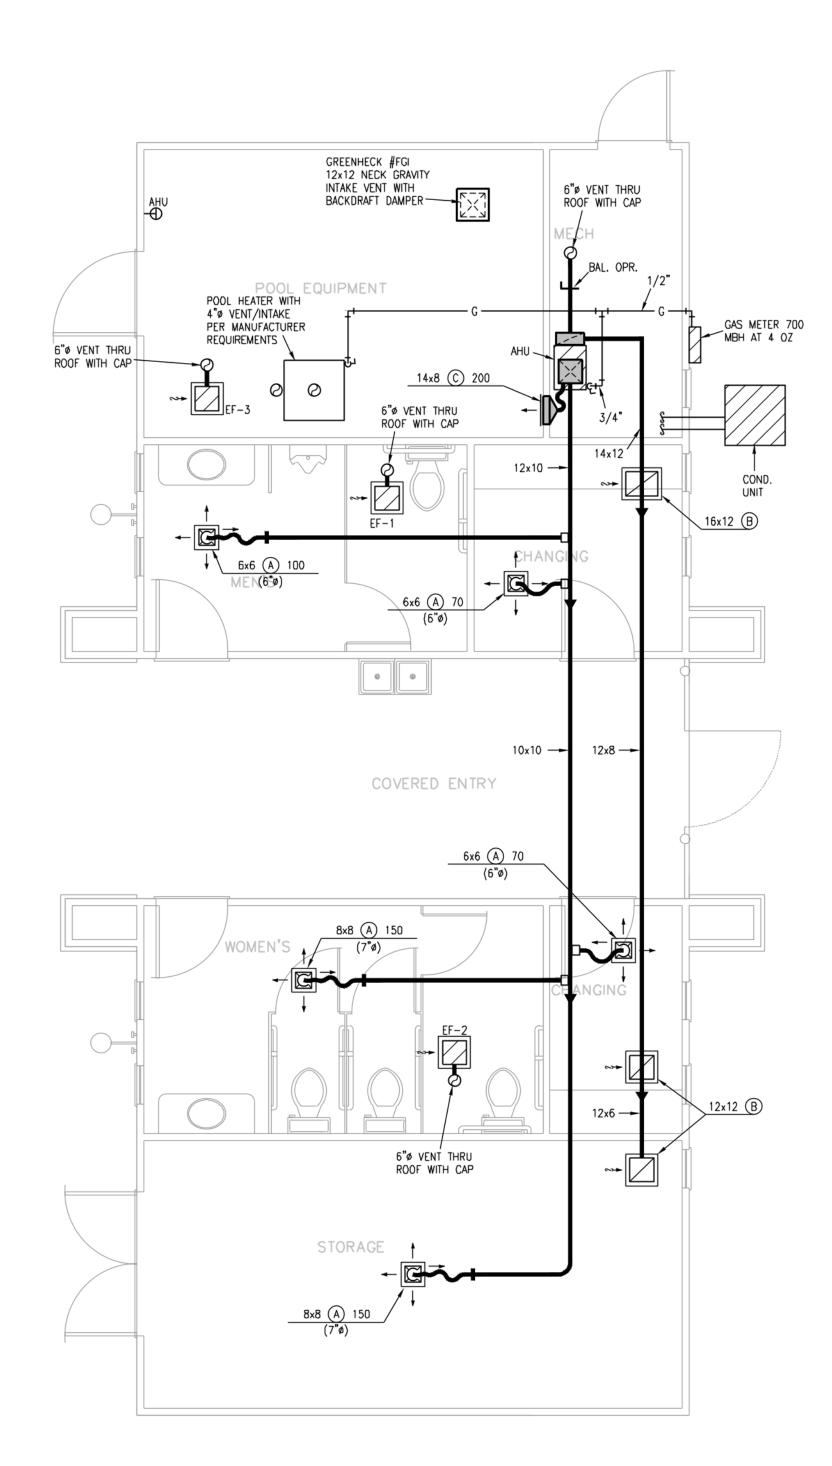
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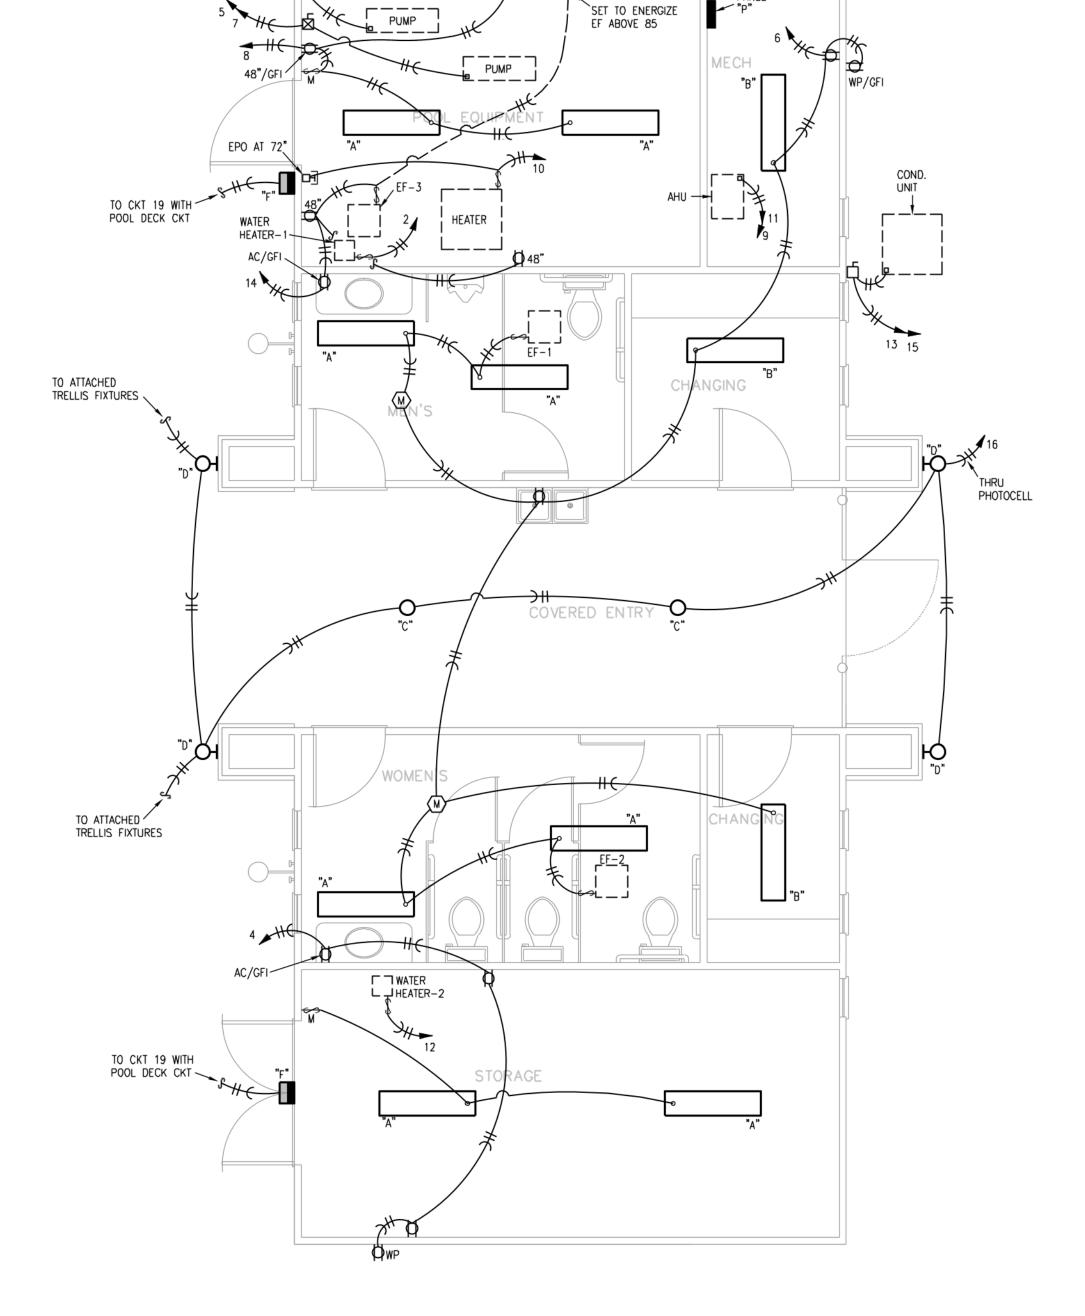
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sheet no.

#### NOTES: HVAC

- COORDINATE WITH OTHER SUB-CONTRACTORS FOR PLACEMENT OF WORK PRIOR TO INSTALLATION BEGINNING.
- ALL INDIVIDUAL BRANCH DUCTS ARE THE SIZE OF THE DIFFUSER NECK LISTED AND HAVE A MANUAL BALANCING DAMPER WHERE NOT INTEGRAL WITH THE DIFFUSER.
- 3. SEE THE ARCHITECTURAL, LIGHTING AND STRUCTURAL DRAWINGS FOR CLEARANCES.
- . MAINTAIN 3 FEET CLEARANCE FROM EXHAUST DUCTS TO BUILDING OPENINGS AND 10 FEET TO AIR INTAKES.
- . ROUTE NO DUCTS OVER ELECTRICAL EQUIPMENT.
- FLEXIBLE DUCT LENGTHS SHALL NOT EXCEED 15 FEET AND SHALL BE AS STRAIGHT AS POSSIBLE AND NOT KINKED AT DIFFUSER OR TAKE-OFF.
- 7. RECTANGULAR DUCT RUNS MAY BE CONVERTED TO EQUIVALENT ROUND WITH THE SAME STATIC LOSS PER 100 FT.





NOTES: ELECTRICAL

EQUIPMENT.

DETAILS.

NUMBER SERVED.

ROOMS/EQUIPMENT SERVED.

COORDINATE WITH OTHER SUB-CONTRACTORS FOR PLACEMENT OF WORK PRIOR TO INSTALLATION BEGINNING.

PROVIDE NEC CLEARANCES FOR ALL PANELS AND ELECTRICAL

LABEL ALL JUNCTION BOXES AS TO THE PANEL AND CIRCUIT

SEE ARCHITECTURAL DRAWINGS FOR MOUNTING HEIGHTS AND

PANEL DIRECTORIES SHALL BE SPECIFIC TO THE





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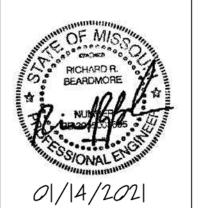
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Contractor shall check and verify all dimensions.



SUMMIT VIEW FARMS
POOL HOUSE
LEE'S SUMMIT, MISSOURI

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Project no. 20091

date 01/14/2021

date 01/14/20
revised design by RRB drawn by CAD struct. by APEX

drawn by CAD struct. by APEX

First Floor Plan

- Mech/Elec sheet no.

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Overland Park, Kansas 66210
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**ME-3** 

#### CLEARANCES SHALL BE MAINTAINED – WALL FOR ALL DISCONNECTING MEANS AND SERVICING PER CODE >12" FOR NON-AIRFLOW SIDE AND BETWEEN UNITS \* SUPPORT FLEX CONDUIT OR HVAC PULL-OUT-TYPE DS LINE SETS OVER 48" LONG EXPOSED WALL CAP/BOOT FOR-DX LINE SETS/T'STAT CONDUI WIRE (SEE DETAIL) PRE-MANUFACTURED SYNTHETIC PAD WP/GFCI -RECEPTACLE

# GROUND-MOUNTED CONDENSING UNIT DETAIL

TURN ROOFING AND FLASHING

SECONDARY

DRAIN

RECEIVER

DECK

CLAMP

INSULATE WITH VAPOR/ BARRIER AND SEAL AT

FLASHING AS REQUIRED

BY ROOFING MANUFACTURER

FLASHING CLAMP

DOWN UNDER CLAMPING FLANGE

#### **ELECTRICAL SYMBOLS LEGEND** SWITCH - SINGLE POLE CONDUIT CONCEALED IN CEILING OR WALL CONDUIT CONCEALED IN FLOOR SLAB 3-WAY, 4-WAY LIGHT FIXTURE AND TYPE EXPOSED CONDUIT $\otimes \otimes$ HOMERUN - ARROW INDICATES CKT., LINES INDICATE WIRES EXIT LIGHT (CEILING OR WALL MOUNTED) FLUSH PANELBOARD GROUND WIRE GROUNDING ROD SURFACE PANELBOARD SINGLE RECEPTACLE DISTRIBUTION PANEL OR SWITCHBOARD DUPLEX RECEPTACLE (20 AMP UNLESS NOTED) DEVICE LOCATED ABOVE COUNTER FOURPLEX RECEPTACLE ABOVE FINISHED FLOOR 208 OR 240 VOLT RECEPTACLE (20 AMP UNLESS NOTED) DIMMER EDF ELECTRIC DRINKING FOUNTAIN PUSHBUTTON MOTOR GROUND FAULT INTERRUPTER GFI NIGHTLIGHT FIXTURE, WIRED HOT FUSIBLE SWITCH (BUSSMAN SSU) О **WEATHERPROOF** DISCONNECT SWITCH (D.S.) 4⊠ LOCKABLE GUARD COMBINATION MOTOR STARTER (CMS) R RELAY CEILING MOTION SENSOR JUNCTION BOX WALL MOTION SENSOR THERMOSTAT NOTES: ALL SYMBOLS SHOWN ABOVE

MECHANICAL SYMBOLS LEGEND

— s -

VBS

VTR

REFER TO ELECTRICAL SYMBOLS LEGEND FOR ELECTRICAL

SYMBOLS THAT MAY BE SHOWN ON MECHANICAL PLANS.

MAY NOT APPEAR ON PLANS.

WATER CLOSET & TYPE (TYP. FOR ALL PLUMBING FIXTURES)

WASTE LINE ABOVE EARTH (W.)

WASTE LINE IN EARTH (W.)

FLUSH FLOOR CLEAN OUT

FLUSH GRADE CLEAN OUT

FLOOR DRAIN AND TYPE

DOMESTIC COLD WATER SUPPLY (DCW)

DOMESTIC HOT WATER SUPPLY (DHW)

RISE & DROP IN PIPE WITH CUT-OFF VALVE

HOSE BIBB AND MOUNTING HEIGHT

VENT LINE (V.)

WALL HYDRANT

NATURAL GAS LINE

DRAIN LINE

CHECK VALVE

STOP VALVE

PLUG VALVE

MAY NOT APPEAR ON PLANS.

UNION

PRESSURE REDUCING VALVE

FLEXIBLE PIPE CONNECTION

CLEAN OUT

|+ --- +

**—**II CO

FFCO O

FGCO C

→ HB/36

——— w⊦

 $-\bowtie$ 

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			PICHARD R. BEARDMORE
REFER TO MECHANICAL SYMBOLS LEGEND SYMBOLS THAT MAY BE SHOWN ON ELECT		· · · · · · · · · · · · · · · · · · ·	R. Nulland
			MAN SONAL ENGINEER
			01/14/2021

GRILLE, REGISTER OR DIFFUSER, SIZE, TYPE & CFM

RETURN, EXHAUST OR FRESH AIR DUCT SECTION UP & DOWN

VOLUME EXTRACTOR AND TURNING VANES

SUPPLY AIR DUCT SECTION UP AND DOWN

ROUND OR RECTANGULAR RIGID DUCT

MANUAL DAMPER

BACKDRAFT DAMPER

AUTOMATIC DAMPER

FLEXIBLE DUCT

REFRIGERANT LIQUID

REFRIGERANT SUCTION

ABOVE FINISHED FLOOR

THERMOSTAT

ACCESS DOOR

EXHAUST AIR

OUTSIDE AIR

RETURN AIR

SUPPLY AIR

VENT BELOW SLAB

VENT THRU ROOF

LOCKABLE GUARD

# STREET OF MISS

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ph: 913-649-7557

suite 200

ARM VIEV NAMIT HOUSE

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POOL

Weston E. Coble KS# 6705 MO# A-2016011206

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design by RRB drawn by CAD struct. by APEX

MECH./ELEC. **DETAILS** 

sheet no.

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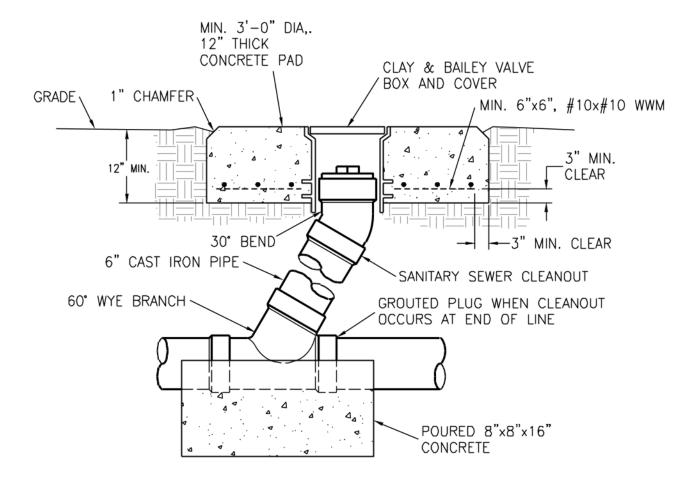
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DOMESTIC WATER ENTRANCE RISER


ALL WATER SERVICE INSTALLATIONS INCLUDING BACKFLOW DEVICES ARE SUBJECT TO FIELD VERIFICATION AND APPROVAL BY THE WATER DEPARTMENT INSPECTOR.



# 3 FLUSH GRADE CLEANOUT DETAIL NO SCALE

LIGHT POLE FOUNDATION

CAT. NO. C11242NG4VP

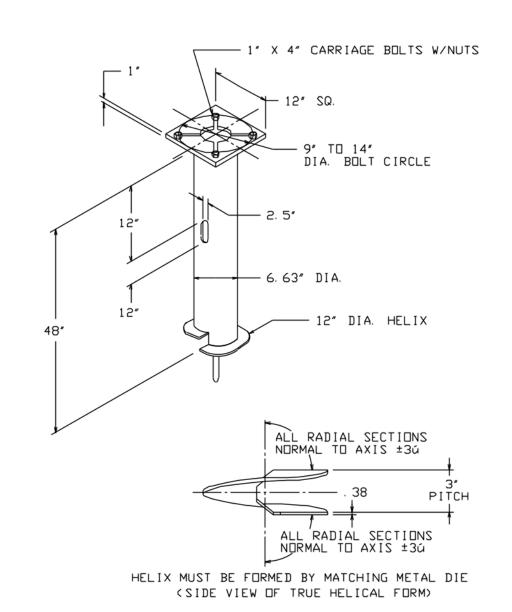

-NOTES-FINISH: HOT DIP GALVANIZE PER ASTM-A153 (LATEST REVISION).
BASEPLATE TO BE PERPENDICULAR TO SHAFT AXIS (±1ú) AND HOLE
CENTERLINE CONCENTRIC (±.188) TO SHAFT AXIS.
STENCIL MIN. 1/2 IN. LETTERS MANUFACTURER'S NUMBER AFTER GALVANIZING.

4. PILOT POINT AND SHAFT AXES TO BE CONCENTRIC (±. 125 FIM) AND I. PILOT POINT AND SHAFT AXES TO BE CONCENTRIC (±.125 FIM) AND IN LINE (±20).

5. FLAME CUT SLOT PERPENDICULAR TO THE BASEPLATE.

6. PREHEAT, TUMBLEBLAST, HANDGRIND, AND CLEAN BASEPLATE, HELIX, AND PILOT POINT ON ALL WELDED AREAS.

7. FLAMECUT IRREGULARITIES PERMISSIBLE: (1) VALLEYS NOT TO EXCEED 3/32 IN. BELOW NOMINAL SURFACE LEVEL, (2) PEAKS OR POSITIVE IRREGULARITIES NOT TO EXCEED 1/32 IN. ABOVE NOMINAL SURFACE LEVEL OR INTERSECTIONS OF NOMINAL SURFACES.

8. MANUFACTURER TO HAVE IN EFFECT INDUSTRY RECOGNIZED WRITTEN QUALITY CONTROL FOR ALL MATERIALS AND MANUFACTURING PROCESSES.

9. ALL MATERIAL IS TO BE NEW, UNUSED AND MILL TRACEABLE MEETING THE FOLLOWING SPECIFICATIONS: BASEPLATE: ASTM A36-(LATEST REVISION) HOT ROLLED STEEL PLATE, (CONFORM TO AASHTO TECH. BUL. #270)

STEEL PIPE PILES, SEAMLESS OR STRAIGHT WELDED, GRADE-2 PER ASTM A252. ALT. MATERIAL: STEEL PIPE TYPE E OR S, GRADE-B PER ASTM A53. HELIX: ASTM A635 (LATEST REVISION) HOT ROLLED STEEL.

PILOT POINT: ASTM A575 (LATEST REVISION) STEEL BAR. BOLTS: CARR BOLT PER ANSI B-18. 2. 1, SAE J429 GRADE-5. 10. BASEPLATE IS PERMANENTLY STAMPED WITH MANUFACTURER'S IDENTIFICATION "ABC" IN 1/2" LETTERS AND DATE CODE IN 1/4" LETTERS.

NEMA 1 ENCLOSURE

#### HAND-OFF-AUTO SWITCH MOUNTED IN COVER OF ENCLOSURE. LABEL AS "EXTERIOR LIGHTING" PHOTOCELL MOUNTED 7-DAYON NORTH WALL OF ELECTRONIC BUILDING TIME CLOCK 120V. CONTROL COIL \ TO SITE TO CIRCUI BREAKERS LIGHTS SPARE • • SPARE

CONTACTOR

ROOF DRAIN

SEE PLANS FOR PIPE

SIZE AND LOCATION

**ROOF DRAIN DETAIL** 


ROOFING

INSULATION


STRUCTURE


**ROOF-DRN** 



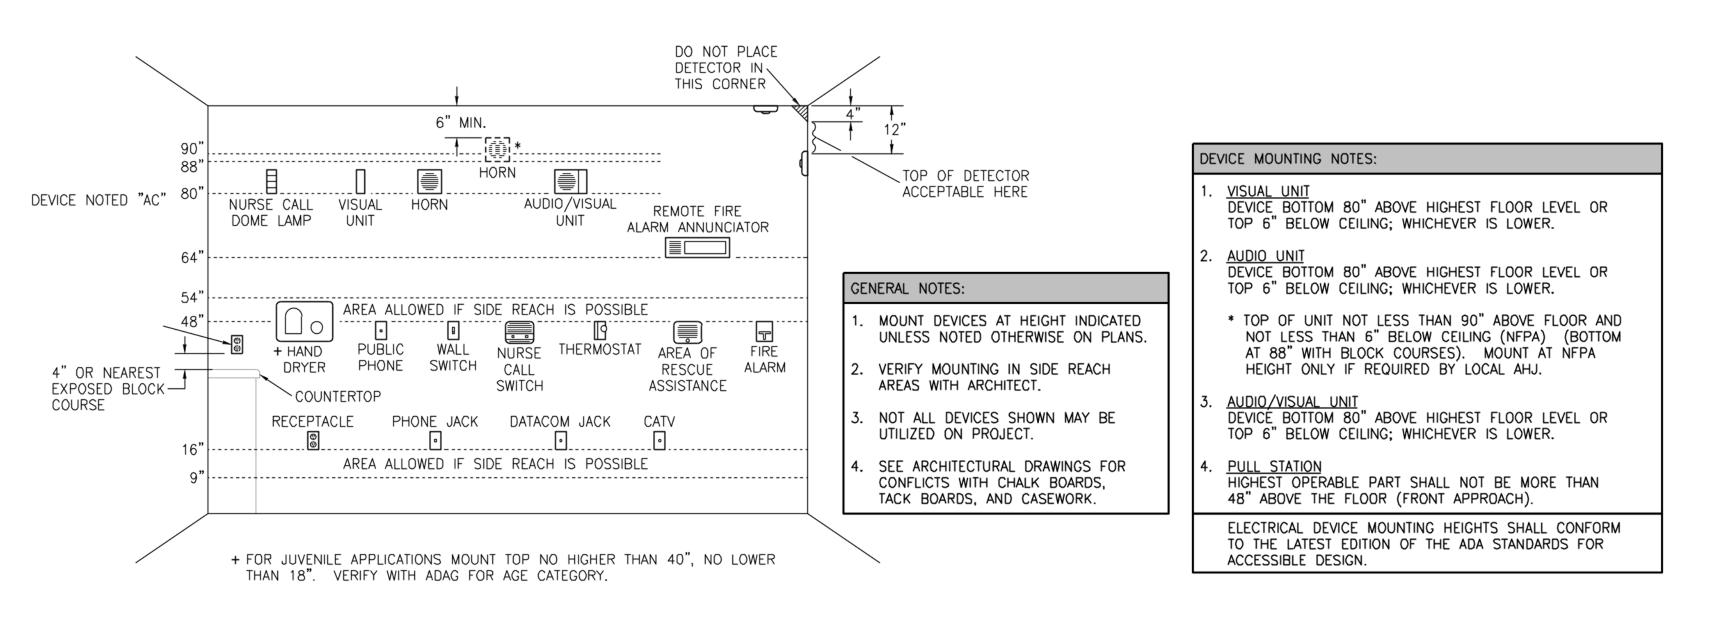


## ELECTRICAL DEVICE MOUNTING HEIGHTS

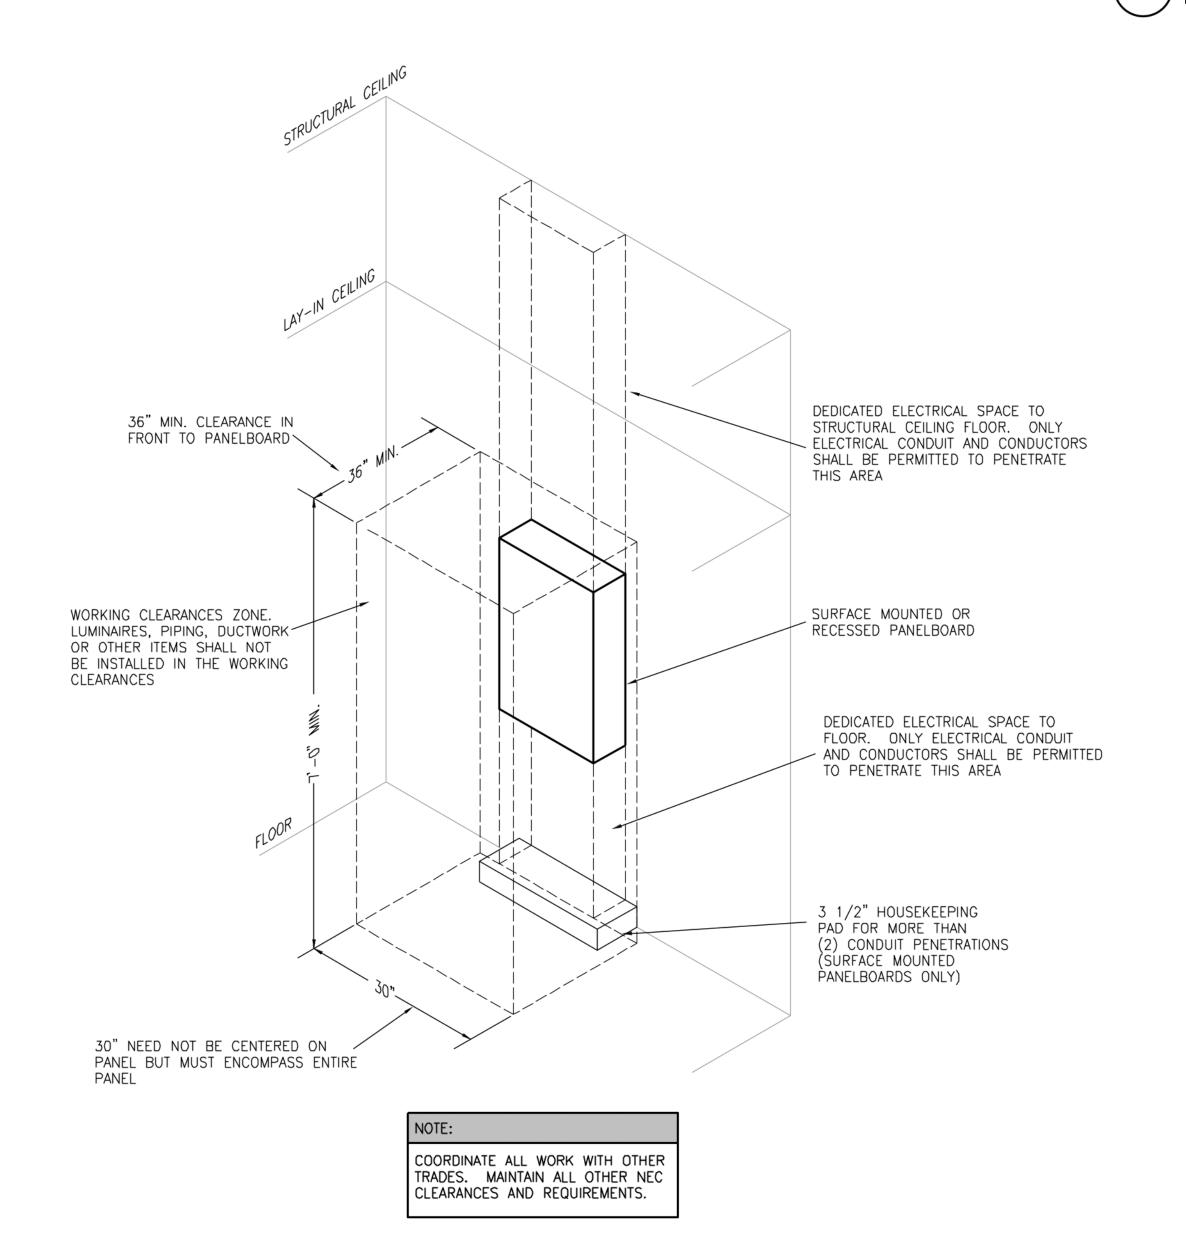

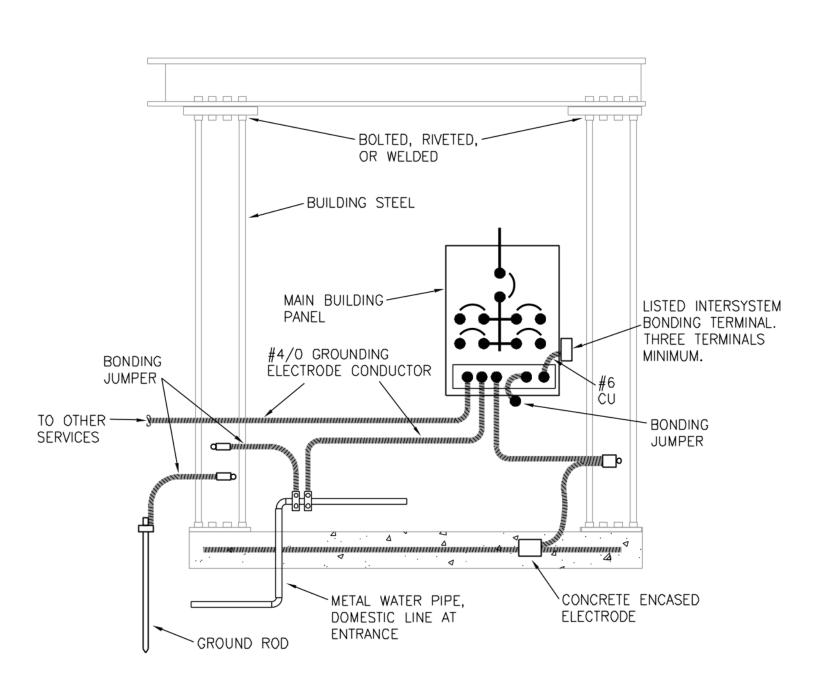

**GROUNDING ELECTRODE SYSTEM DETAIL** 

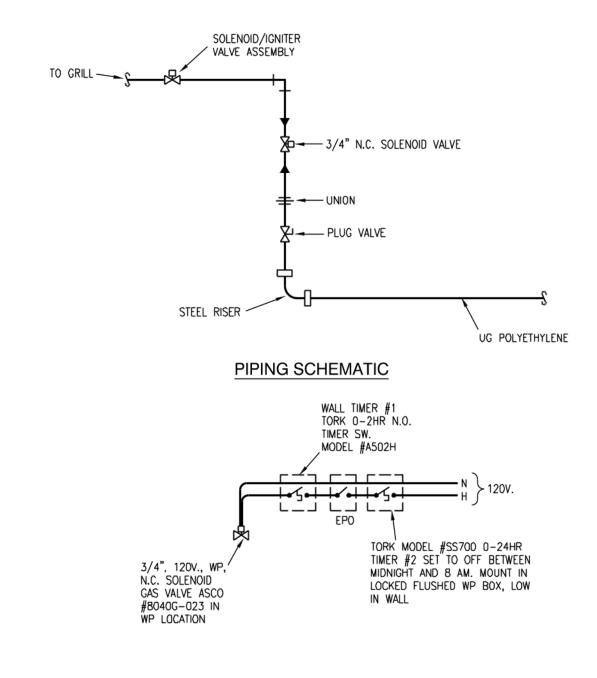

CONTROL SCHEMATIC



TYPICAL PANELBOARD INSTALLATION DETAIL
NO SCALE



CONSTRUCTION
As Noted on Plans Review elswood smith


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**ARMS** VIEW SUMMIT POOL HOUSE

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Weston E. Coble

MO# A-2016011206 project no. 20091

01/14/2021 revised design by RRB
drawn by CAD
struct. by APEX

MECH./ELEC. **DETAILS** sheet no.

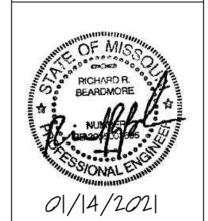			PLUMBING FIXTURE SCI	HEDU	LE								
1 ork	Item	Model	Description		Individual (	Connection	•			Access	orioo		
// ark	item	Wodel	Description	W	V	CW	HW	Supplies	Stops			Drain	Othe
·-1	Accessible Water Closet, Tank	Proflo #1203WH with PFTS2000wh	Floor-mounted ADA height white vitreous china elongated bowl 1.6 gpf gravity type with Fluidmaster 400A flush mechanicsm and bolt covers. Provide solid plastic open front elongated white heavy duty seat with integral bumpers, external check hinges with stainless steel posts.	3" or 4"	2"	1/2"		2	1		·		3
	Туре	Proflo #PF20174BS with Peerless	20" x 17" oval vitreous china countertop lavatory with overflow. Faucet is 4" o.c. single lever ADA				1/0"						
P-2 P-3	Accessible Lavatory, Countertop  Water Closet, Tank Type	Proflo #1201WH	handle, copper waterways, chrome finish. Floor-mounted standard height white vitreous china elongated bowl 1.6 gpf gravity type with Fluidmaster 400A flush mechanicsm and bolt covers. Provide solid plastic open front elongated white heavy duty seat with integral bumpers, external check hinges with stainless steel posts.	2" 3" or 4"	1 1/2" or 2"	1/2"	1/2"	2, 4	1		1	1	3
	0.1101		Self-closing single temperature metering valve with			4 (0)							
9-4	Outdoor Shower  Accessible Dual Height Water	Halsey Taylor	fixed head ADA compliant dual bowl cooler providing 8 gph of 50 deg water at 90 deg ambient. Provide front and side push bars, lead free, mounted with 27" knee clearance and spout no more than 36" AFF.			1/2"							
P-5	Cooler with Bottle Filler	#HAC8BLFSQ	Provide bottle filler in backsplash.	2"	1 1/2" or 2"	1/2"	1/2"	2	1		1		1
P-6	Eye Wash	Guardian G1814BC	Wall-mounted stainless steel bowl with cover, paddle valve, thermostatic mixing valve. White vitreous china wall hung with 3/4" top spud,	2"	2"	1/2"	1/2"						
P-7	Urinal		1.0 gallon siphon jet flushing action. Mount rim per Architectural elevation.	2"	2"	3/4"		3		1			
Supplies	Flexible braided stainless stee     Flexible braided compression     Sloan Royal 186 1.0 gpf diaph     Provide tempering valve below	hose. ragm type.											
Stops	1 - Angle handle compression												
Carrier	Steel tube floor-mounted in-wa     Cast iron floor mount adjustab		oset										
<sup>o</sup> -Trap	1 - PVC with deep escutcheon 2 - PVC 3 - deep seal PVC trap and 30" s	tandpipe.											
Orain	Metal pop-up with tailpiece     Basket strainers in finish to m     Grown drain cover.	atch faucet, tailpiece											

3 - Chrome drain cover.

1 - Provide trap and supply guard if exposed. 2 - Hose and bracket, mop hanger and hose rack.

4 - Provide Watts Tempering valve, max 110 Deg. F.

3 - Open front seat in public restrooms

						H	IVA	C SY	/STE	EM SCH	HEDU	LE								
							Α	HU							Ol	UTDOOR I	JNIT			
MARK	MFGR	NOM TON	MODEL	CFM	OA CFM	E.S.P.	HP	SMBH	TMBH	HEAT CAP	ELEC	FLA	OCP	MFGR	MODEL	ELEC	FLA	OCP	SEER	NOTES
AHU/CU	GOODMAN	2	ARUF25B14	750	130	0.4	0.33	16.9	23.0	6 KW	240/1	27	40	GOODMAN	GSX14-0241	240/1	8.4	15	14.0	

#### COOLING EAT = 80/67/95

				W	ATER HE	ATER S	CHEDUI	-E				
MARK	MFGR	MODEL	FUEL	VOLTAGE/PH/ AMPS	INPUT	EFFICIENCY /PF	STOPAGE	GPH RECOVERY @ 80° RISE	FLUE TYPE	EXPANSION	CIRCULATOR GPM/HD	NOTES
WH - L1, L2	EEMAX	EMT-1	ELEC	120/1/12	1.4 KW	0.95	1.5	5	N/A			

	DRAIN SCHEDULE													
MARK	APPLICATION	MFGR	MODEL	BODY MATL	DEPTH	GRATE MATL	GRATE SHAPE	ACCESSORIES						
FD-1	FLOOR	ZURN	ZN-415S	COATED CAST IRON	3"	NICKEL BRONZE	6" ROUND	1, 2						
FD-2	FLOOR	ZURN	Z-611-S	COATED CAST IRON	6"	COATED CAST IRON	9" SQUARE	1, 2, 3						

#### ACCESSORIES:

- 1 DEEP TRAP, ADJUSTABLE GRATE 2 - USE WIDE FLANGE MODEL WHERE IN WOOD CONSTRUCTION
- 3 INTERNAL STRAINER

		AIR TER	MINAL DE	VICE S	CHEDULI	E
MARK	MANUFACTURER	MODEL	FINISH	DAMPER	FRAME TYPE	NOTES
Α	AIR MATE	A140, A190	WHITE	YES	GYP BD	
В	AIR MATE	170	WHITE	NO	GYP BD	
С	AIR MATE	240 VO	WHITE	YES	GYP BD	

FAN SCHEDULE											
							ELEC	CTRICA	L		
					FAN	VOLT	FL			CONFIGURATIO	
MARK	MFGR	MODEL	CFM	ESP	HP	S/ PH	Α	OCP	WIRING	N - NOTES	
EF - 1, 2, 3	GREENHECK	SP-A390	210-280	0.25	Fr.	120/1	3	15	(3) #12	ceiling, 1, 2	
NOTES:	1-CEILING GRILL 2-BD DAMPER, [		CONTROL	LER,	WAL	L/ROC	F C	AP		,	

			Luminaire Schedule - Ur	its and Buil	dings		
MARK	DESCRIPTION	MFGR	MODEL	MOUNTING	FINISH	LAMPS	NOTES
D	Exterior Sconce	Progress	P5674-31-30K	wall	black	1600 lumen 15W 3000K LED	
E	Trellis	Progress	P5641-20/30K	ceiling	bronze	1355 Lumen 29W 3000K LED	
SL1	Exterior Pole	McGraw Edison	GLEON -AF-02 LED E1 T4FT	pole	bronze	113W 12252 Lumen 4000K led	provide with 15 ft pole
SL2	Exterior Pole	McGraw Edison	GLEON-AF-01-LED-E1-SL4	pole	bronze	(2) 59W 5922 Lumen 4000K led	provide with 15 ft pole
SL3	Exterior Pole	McGraw Edison	GLEON-AF-01-LED-E1-T3	pole	bronze	59W 6235 Lumen 4000K led	provide with 15 ft pole
SL4	Bollard	McGraw Edison	BRT6-A2-740-U-T3	bollard	bronze	11W 1075 Lumen 4000K led	3 FT w/ WP-GFI receptacle

DA NEL - D			CTR			1				MOLINITINIO:	CLIDEACE
PANEL: P	NAA INIO.	MIC	LOCATIO		400 %	0.40		DIA OF	MDE.	MOUNTING:	SURFACE
BUS: 200 A	MAINS:	MLO	VOLTAG	iE:	120/2	_		PHA SE/V		1 Ph 3 Wire	KAIC: 42
DESCRIPTION	14000	TS L	DDICE	14455	POL	LE	MADE	DDI/D		TTS	DESCRIPTION
DESCRIPTION	A	В	BRKR	WRE		+	WRE		Α	В	DESCRIPTION
POOL PUMP	2200		30	10	1	2	12	20	1500		WH- L1
5 HP - VERIFY		2200	2P	10	3	4	12	20			RECEPTACLES
POOL PUMP	1300		20	12	5	6	12	20	1000		LTS/RECEPTS
3 HP - VERIFY		1300	2P	12	7	8	12	20		600	LTS/RECEPTS
AHU	3200		40	8	9	10	12	20	200		POOL HEATER
		3200	2P	8	11	12	12	20		1500	WH-L2
au	1000		20	12	13	14	12	20	600		RECEPTACLES
		1000	2P	12	15	16	12	20		200	LIGHTING
COOKING STATION	600		20	12	17	18	10	20	1000		LIGHTING
LIGHTING		700	20	10	19	20					SPACE
SPARE			20		21	22					SPACE
SPARE			2P		23	24					SPACE
SPARE			20		25	26					SPACE
SPARE			20		27	28					SPACE
SPARE			20		29	30					SPACE
CONNECTED LOAD-WATTS	12600	11500			FE	EDEF	RLOAD-\	NATTS			
CONNECTED LOAD-AMPS	105	96			FE	EDE	R LOAD-	AMPS			
CONTINUOUS LOAD						FE	EDER WI	RE			
RECEPTACLES						FE	EDER O	CP CP			200 A
NON-CONTINUOUS LOAD											
OTHER DIVERSIFIED LOAD			@	0		$\dashv$					



CONSTRUCTION
As Noted on Plans Review

RELEASED FOR

architects, p.a. 7133 west 95th street suite 200 overland park, ks 66212 ph: 913-649-7557 www.escarchitects.com

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Release of these plans contemplates further cooperation among the owner, his contractor, and the designer. Design and construction are complex. Although the designer and his consultants have performed their services with due care and diligence, they cannot guarantee perfection. Communication is imperfect and every contingency cannot be anticipated. Any ambiguity or discrepancy discovered by the use of these plans shall be reported immediately to the designer. A failure to cooperate by a simple notice to the designer shall relieve the designer from responsibility for all consequences. Changes made from the plans without the consent of the designer or responsibilit for all consequences arriving out of such changes. Contractor shall check and verify all dimensions.



**FARMS** VIEW SUMMIT POOL HOUSE LEE'S SUMMIT, I

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2 CITY REVIEW 11-22-21

Weston E. Coble Architect KS# 6705

MO# A-2016011206

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revised

design by RRB
drawn by CAD
struct. by APEX MECH./ELEC.

**SCHEDULES** 

sheet no.