

SECOND FLOOR PLATE

▲ SECOND FLOOR DECK

FIRST FLOOR PLATE

FIRST FLOOR DECK

TOP OF FOOTING

TOP OF FOUNDATION



2860 SH @ 8' H.

(2)-3050 SH EGRESS

@ 7' H.

(3)-3060 FIX

3050 SH EGRESS

4036 SLIDER

# SQUARE FOOTAGE TABLE

# FINISHED SQUARE FOOTAGE

MAIN LEVEL	1526
UPPER LEVEL	1749
STAIRS TO LOWER LEVEL	34
TOTAL	3309

## **UNFINISHED SQUARE FOOTAGE**

_	
GARAGE	678
BASEMENT - UNFINISHED	1386
COVERED PATIO	196

## SHEET INDEX

- A1. FRONT AND REAR ELEVATION
- A2. LEFT AND RIGHT ELEVATION
- A3. FOUNDATION FLOOR PLAN
- A4. MAIN LEVEL PLAN
- A5. UPPER LEVEL PLAN
- A6. ROOF PLAN

# FRONT ELEVATION SCALE: 1/4' = 1'-0'

## NOTE

\_\_\_\_\_\_\_

@ 7' H.

TW 3060 SH EGRESS

@ 8' H.

3050 SH EGRESS

@ 7' H.

\_-----

. — - — - — - — - — - — - —

ALL CONSTRUCTION SHALL CONFORM TO 2018 INTERNATIONAL RESIDENTIAL CODE OR ATTACHED ENGINEER SPECIFICATIONS WHERE APPLICABLE.

## ELEVATIONS:

- GARAGE DOORS SHALL MEET DASMA FOR ULTIMATE DESIGN WIND SPEED OF 115 MPH REQUIREMENTS. WALL FRAMING SHALL BE DOUGLAS FIR LARCH #2 UNLESS OTHERWISE NOTED.
- IN BEARING WALLS, STUDS WHICH ARE NOT MORE THAN TEN FEET IN LENGTH SHALL BE SPACED NOT MORE THAN IS SPECIFIED BY IRC TABLE R602.3(5) FOR CORRESPONDING STUD SIZE.
- WATER-RESISTIVE EXTERIOR WALL BARRIER IN WALL SECTION SHALL COMPLY WITH IRC R703.2. WHEN APPLICABLE, CONTINUOUS STUDS BETWEEN FLOOR AND ROOF/CEILING DIAPHRAGM SHALL COMPLY WITH IRC R602.3.

ALL UNMARKED HEADERS SHALL BE A MINIMUM #2 DOUGLAS FIR LARCH (2) 2 X 10 ON LOAD BEARING WALLS.

SHIPLAP SIDING MUST BE FASTENED AT BOTH UNDERLAP AND OVERLAP.

## **ELEVATION NOTES**

- 1. MINIMUM ROOFING COMPOSITION— 30 YR. COMPOSITE SHINGLES ON 15# FELT ON  $\frac{1}{2}$ " OSB SHEATHING OR AS REQUIRED BY CODE.
- 2. SIDES AND REAR TO BE LP SMART PANEL SIDING WITH 3/4x4 L.P. SMART TRIM AROUND DOORS, WINDOWS, AND CORNERS UNLESS NOTED OTHERWISE. BOTTOM OF SIDING SHALL BE A MINIMUM OF 6" ABOVE GRADE.
- 3. FRONT FACADE TO BE STUCCO, SHEATHED WITH \(\frac{15}{32}\)
  THICK OSB RATED 24/0 SHEATHING. EXTEND STUCCO TO BE WITHIN 8" OF FINISHED GRADE. 5/4X6 L.P. SMART TRIM AROUND WINDOWS AND DOORS UNLESS NOTED OTHERWISE.
- 4. NOT USED.
- 5. MANUFACTURED STONE VENEER.
- 6. CAST STONE CAP
- 7. CEDAR BRACKETS, RE: 3/A1- INSTALL CEDAR BRACKETS PRIOR TO FASCIA BOARD INSTALLATION.
- 8. 5/4X8" L.P. SMART TRIM. 1 1/2" ARCH ON GARAGE DOOR TRIM UNLESS NOTED OTHERWISE ON ELEVATION. DOUBLE TRIM ADJACENT TO STONE.
- 9. NOT USED.

10. CONCRETE WINDOW WELL FOR EGRESS WITH LADDER. PROVIDE SLEEVE THROUGH WALL FOR FOUNDATION DRAIN. TOP OF WINDOW WELL TO BE 3" BELOW TOP OF FOUNDATION.

11. 2X6 STUD WALL WRAPPED IN STONE ON FRONT AND STUCCO ON SIDES ABOVE FINISHED PORCH. ALLOW MINIMUM 2" FOR STONE/STUCCO TO FIT WITHIN BOUNDARY OF STOOP CONCRETE. SEE PLAN FOR SIZE.

## 12. 6x6 CEDAR POST

13. BUILD CRICKET VALLEY AWAY FROM INTERSECTION FOR POSITIVE DRAINAGE. SEE FRAMING SPECIFICATIONS FOR DETAILS.

### **GENERAL NOTES:**

DIMENSIONAL LUMBER IS LABELED PER INDUSTRY STANDARD TERMINOLOGY. ACTUAL LUMBER SIZING IS EXPECTED TO VARY PER VENDOR.

WINDOW SIZES ARE WRITTEN IN FEET AND INCHES PER INDUSTRY STANDARDS. EX: 3050 SH = 3'-0" X 5'-0" SINGLE HUNG, 3066 FIX = 3'-0" X 6'-6" FIXED.



120 SE 30TH ST. LEE'S SUMMIT, MO 64082 816-246-6700

COPYRIGHT 2017

THIS DRAWING HAS BEEN PREPARED BY SUMMIT HOMES, OR UNDER THEIR DIRECT SUPERVISION AS AN INSTRUMENT OF SERVICE AND IS INTENDED FOR USE ONLY ON THIS PROJECT. ALL DRAWINGS, SPECIFICATIONS, AND DESIGNS, INCLUDING THE OVERALL LAYOUT, FORM, AND COMPOSITION OF SPACES ARE PROTECTED BY COPYRIGHT REGISTERED TO CPG, INC. ANY REPRODUCTION, USE, OR DISCLOSURE OF THE INFORMATION CONTAINED HEREIN WITHOUT THE WRITTEN CONSENT FROM CPG, INC. D/B/A SUMMIT HOMES EXCEPT AS REQUIRED FOR BIDDING AND CONSTRUCTION OF THIS PROJECT IS STRICTLY PROHIBITED.

MEDITERREANEAN WOODSIDE RIDGE 140

PROFESSIONAL SEAL:



RESIDENTIAL ENGINEERING
SERVICES,LLC IS RESPONSIBLE
FOR STRUCTURAL SPECIFICATIONS
ONLY. ARCHITECTURAL PLANS
WERE PRODUCED BY OTHERS.
RESIDENTIAL ENGINEERING
SERVICES, LLC

RESIDENTIAL ENGINEERING SERVICES, LLC 600 SW JEFFERSON SUITE 300 LEE'S SUMMIT, MO 64063 816-399-4901


> ISSUE DATE: 02.10.21

SHEET NUMBER:



BRAC



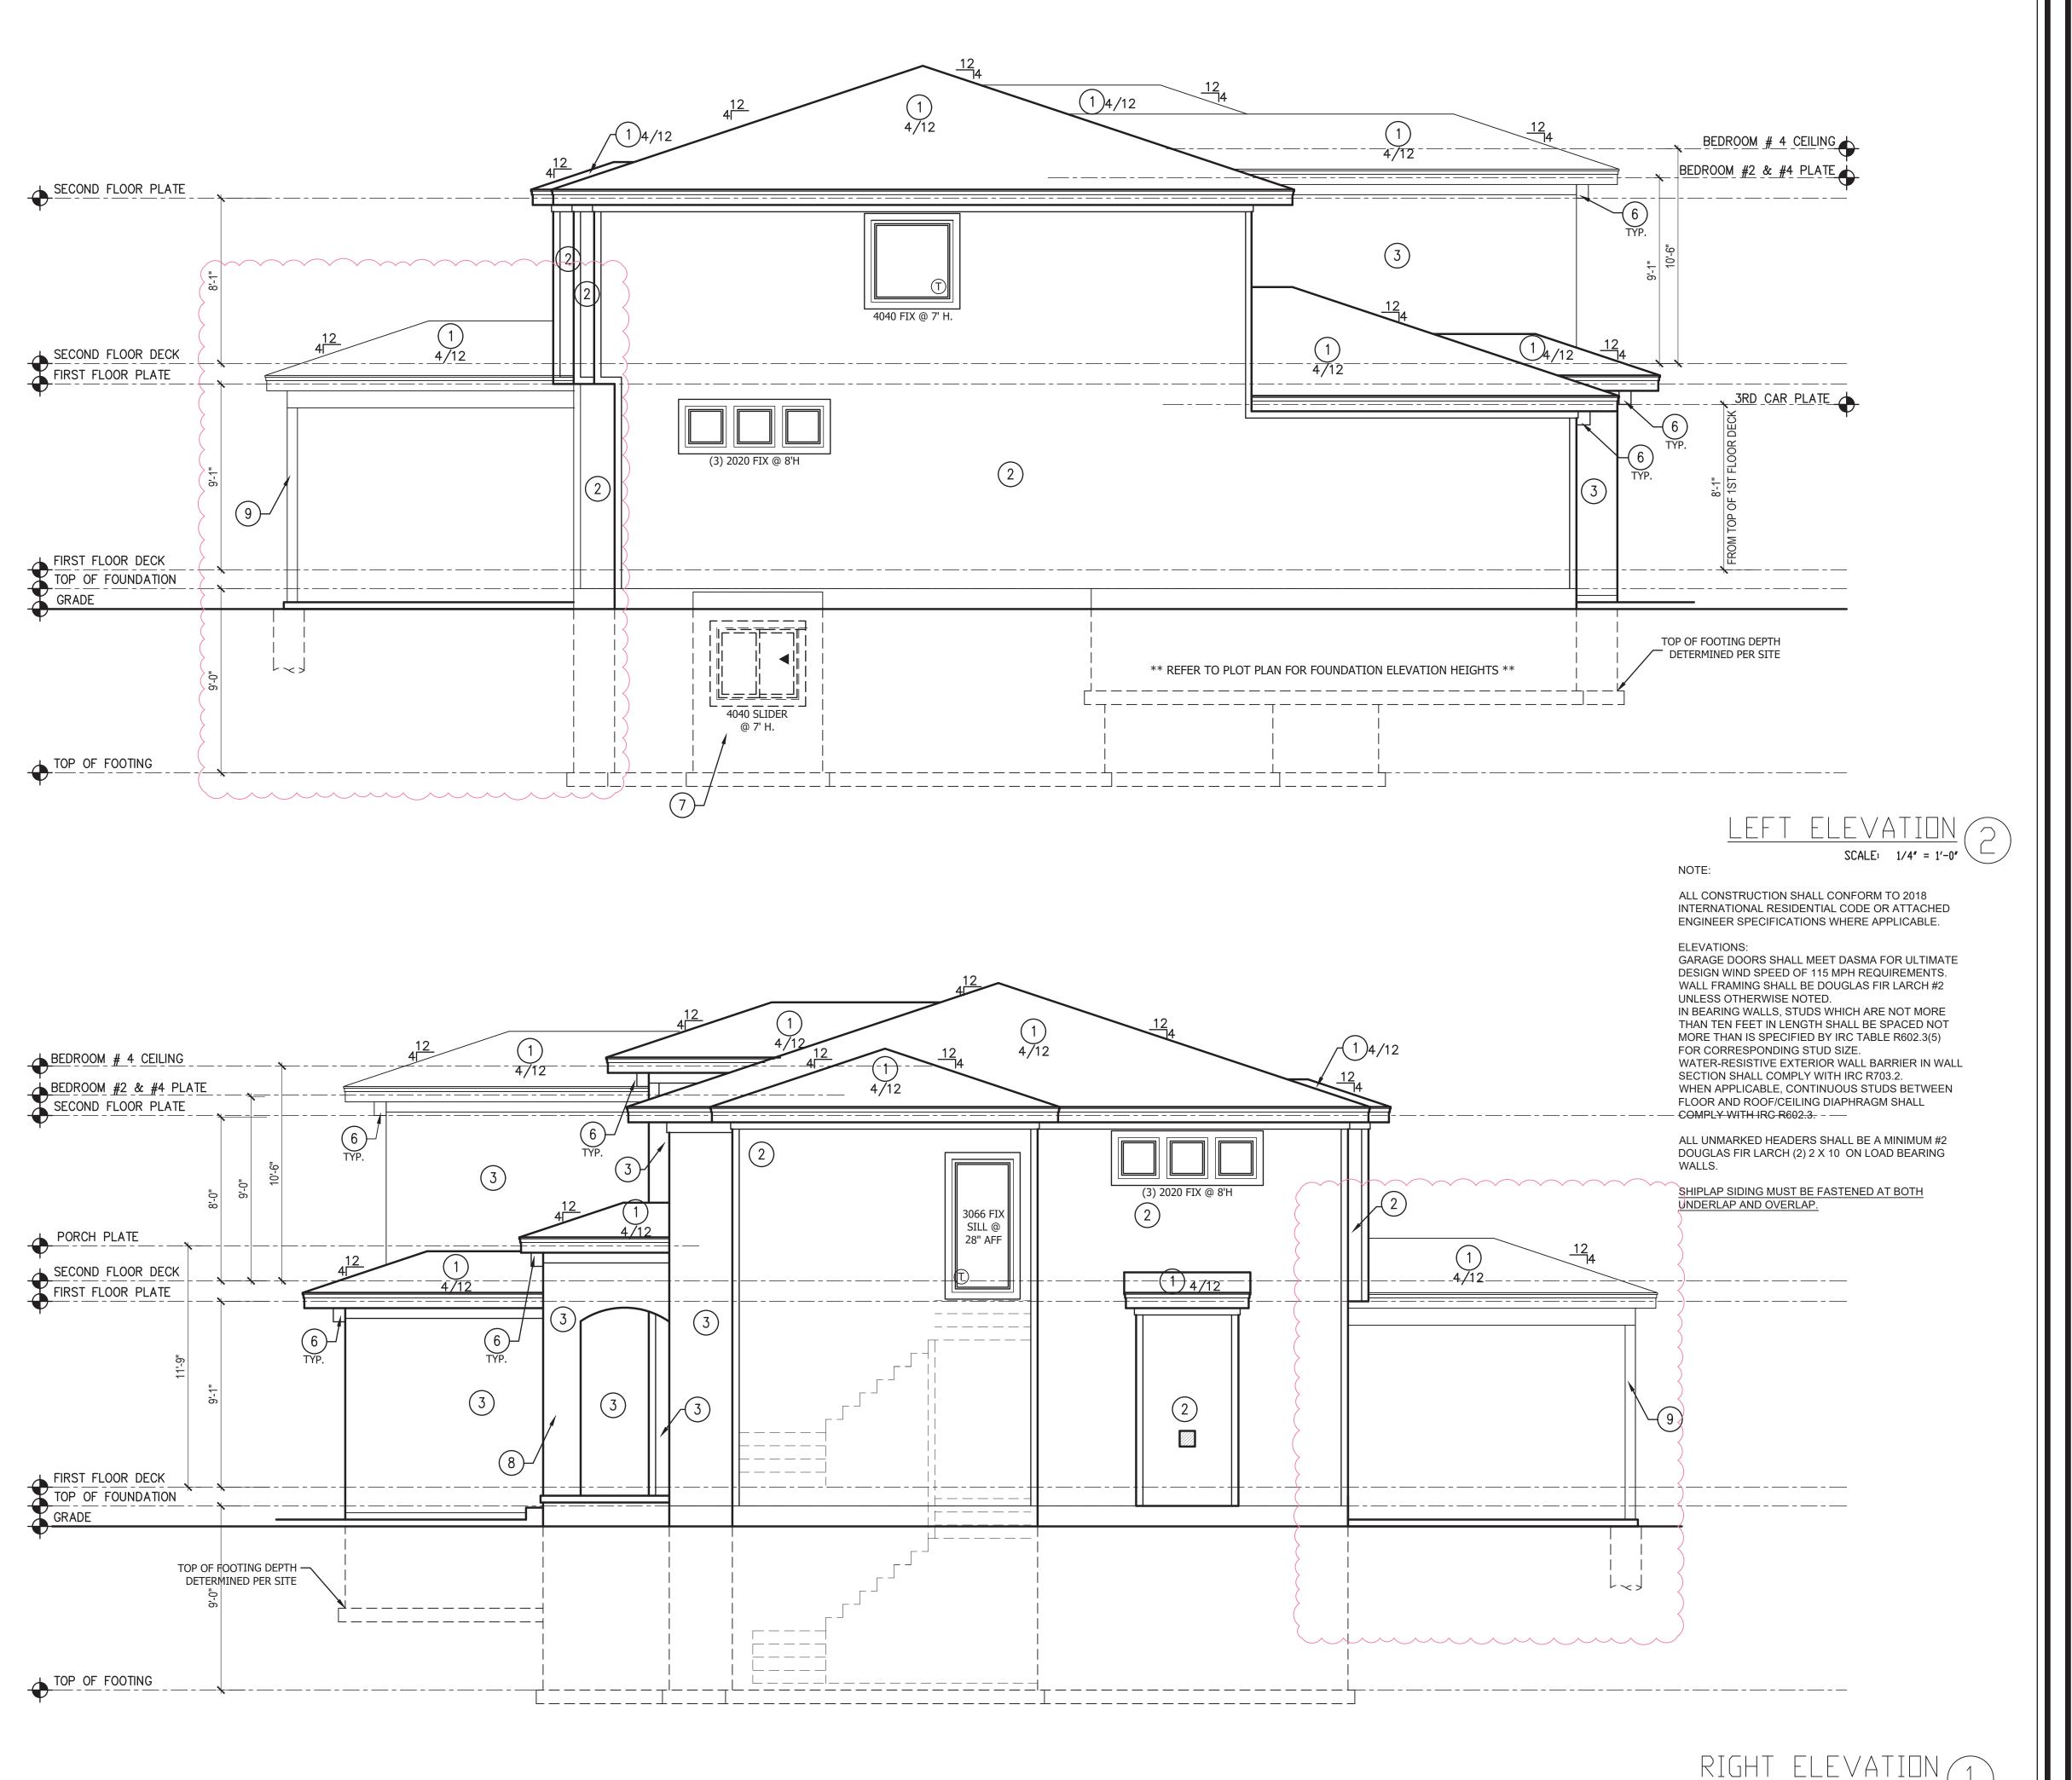

### **ELEVATION NOTES**

MINIMUM ROOFING COMPOSITION- 30 YR. COMPOSITE SHINGLES ON 15# FELT ON  $\frac{1}{2}$ " OSB SHEATHING OR AS REQUIRED BY CODE.

2. SIDES AND REAR TO BE LP SMART PANEL SIDING WITH 3/4x4 L.P. SMART TRIM AROUND DOORS, WINDOWS, AND CORNERS UNLESS NOTED OTHERWISE. BOTTOM OF SIDING SHALL BE A MINIMUM OF 6" ABOVE GRADE.

FRONT FACADE TO BE STUCCO, SHEATHED WITH  $\frac{15}{32}$ " THICK OSB RATED 24/0 SHEATHING. EXTEND STUCCO TO BE WITHIN 8" OF FINISHED GRADE. 3/4X6 L.P. SMART TRIM AROUND WINDOWS AND DOORS UNLESS NOTED OTHERWISE.

- 4. NOT USED.
- 5. NOT USED.

CEDAR BRACKETS, RE: 3/A1- INSTALL CEDAR BRACKETS PRIOR TO FASCIA BOARD INSTALLATION.

7. CONCRETE WINDOW WELL FOR EGRESS WITH LADDER. PROVIDE SLEEVE THROUGH WALL FOR FOUNDATION DRAIN. TOP OF WINDOW WELL TO BE 3" BELOW TOP OF FOUNDATION.

8. 2X6 STUD WALL WRAPPED IN STONE ON FRONT AND STUCCO ON SIDES ABOVE FINISHED PORCH. ALLOW MINIMUM 2" FOR STONE/STUCCO TO FIT WITHIN BOUNDARY OF STOOP CONCRETE. SEE PLAN FOR SIZE.

9. 6X6 CEDAR POST

10. BUILD CRICKET VALLEY AWAY FROM INTERSECTION FOR POSITIVE DRAINAGE. SEE FRAMING SPECIFICATIONS FOR DETAILS

#### **GENERAL NOTES**

DIMENSIONAL LUMBER IS LABELED PER INDUSTRY STANDARD TERMINOLOGY. ACTUAL LUMBER SIZING IS EXPECTED TO VARY PER VENDOR.


WINDOW SIZES ARE WRITTEN IN FEET AND INCHES PER INDUSTRY STANDARDS. EX: 3050 SH = 3'-0" X 5'-0" SINGLE HUNG, 3066 FIX = 3'-0" X 6'-6" FIXED.

CPG DBA HOMES

120 SE 30TH ST. LEE'S SUMMIT, MO 64082 816-246-6700

**COPYRIGHT 2017** DRAWING HAS BEEN PREPARED BY SUMM HOMES, OR UNDER THEIR DIRECT SUPERVISION AS AN NSTRUMENT OF SERVICE AND IS INTENDED FOR USE ONLY ON THIS PROJECT. ALL DRAWINGS SPECIFICATIONS, AND DESIGNS, INCLUDING THE OVERALL LAYOUT, FORM, AND COMPOSITION OF SPACES ARE PROTECTED BY COPYRIGHT REGISTERE O CPG. INC. ANY REPRODUCTION. USE. VITHOUT THE WRITTEN CONSENT FROM CPG. IN D/B/A SUMMIT HOMES EXCEPT AS REQUIRED FO BIDDING AND CONSTRUCTION OF THIS PROJECT

PROFESSIONAL SEAL:

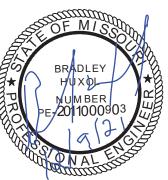

RESIDENTIAL ENGINEERING SERVICES,LLC IS RESPONSIBLE FOR STRUCTURAL SPECIFICATION\$ ONLY. ARCHITECTURAL PLANS WERE PRODUCED BY OTHERS. RESIDENTIAL ENGINEERING SERVICES, LLC

600 SW JEFFERSON SUITE 300 LEE'S SUMMIT, MO 64063 816-399-4901

> ISSUE DATE: 02.10.21

SHEET NUMBER:



- RECESS TOP OF FOUNDATION WALL
- 2. HOLD SILL PLATE BACK 4"

  - NOT USED
  - 4. CONTINUOUS CONCRETE FOOTING
  - 2X4 STUD WALL WITH TREATED SILL PLATE
  - 6. NOT USED
  - '. LINE OF FLOOR ABOVE
  - THERMAL EXPANSION CONTROL DEVICE FOR WATER
  - SUMP PIT AND PUMP. PROVIDE ELECTRICAL GFCI PROTECTION. PROVIDE SLEEVE THROUGH FOOTING.
- 10. 200 AMP ELECTRICAL PANEL. LOCATION TO BE DETERMINED ON SITE.
- DIRECT FURNACE. FUEL BURNING APPLIANCES SHALL BE DIRECT VENTED TO EXTERIOR FOR COMBUSTION
- 12. DRAIN LINE ONLY FOR FUTURE USE. LOCATION TO BE MARKED WITH REBAR AND CUT FLUSH TO FLOOR
- 13. CONCRETE WINDOW WELL WITH LADDER. PROVIDE SLEEVE THROUGH WALL FOR FOUNDATION DRAIN. TOP OF

WELL TO BE 3" BELOW TOP OF FOUNDATION WALL..

- 14. HVAC CHASE ABOVE
- 15. 'UFER' GROUND. VERIFY LOCATION WITH PROJECT MANAGER.
- 16. INSULATE CANTILEVER AS REQUIRED PRIOR TO BLOCKING

#### **GENERAL NOTES:**

BACK WATER VALVES REQUIRED ON ALL BASMENT PLUMBING FIXTURES. PROVIDE MEANS OF CONTROLLING PRESSURE CAUSED BY THERMAL EXPANSION.

SUMP PIT SHALL BE EQUIPPED WITH A PUMP AND RECEPTACLE. IN UNFINISHED PORTIONS OF BASEMENT, RECEPTACLES SHALL HAVE GFI PROTECTION.

ALL SILLS & SLEEPERS SUPPORTED ON CONCRETE OR MASONRY SHALL B OF DECAY-RESISTANT MATERIALS.

DIMENSIONAL LUMBER IS LABELED PER INDUSTRY STANDARD TERMINOLOGY. ACTUAL LUMBER SIZING IS EXPECTED TO VARY PER VENDOR.

NON-BEARING WALLS TO BE BUILT WITH 1" GAP BETWEEN TOP PLATE AND FLOOR JOISTS TO PREVENT HEAVING.

SMOKE AND CARBON MONOXIDE DETECTORS SHOWN ON PLANS ARE TO BE CONSIDERED RECOMMENDATIONS ONLY. FINAL PLACEMENT IS TO BE DETERMINED BY MUNICIPAL REQUIREMENTS.

WINDOW SIZES ARE WRITTEN IN FEET AND INCHES PER INDUSTRY STANDARDS. EX: 3050 SH = 3'-0" X 5'-0" SINGLE HUNG, 3066 FIX = 3'-0" X 6'-6" FIXED.

## ISOLATED FOOTINGS AND COLUMN PADS

SYM	PIER PAD SIZE	DEPTH	MINIMUM REINFORCEMENT GRADE 60 KSI STEEL COLUMN, MIN FY = 35 KSI
<u>*</u>	(ANY :	SIZE PI	IER PAD WITH AN (*) NO COLUMN NEEDED
Â	30″×30″	1'-0"	(5) #4 BAR E.W. 3" DIAMETER
B	36″×36″	1'-0"	(6) #4 BAR E.W. 3" DIAMETER
<u></u>	42″×42″	1′-2″	(7) #4 BAR E.W. 3" DIAMETER
<u></u>	48″×48″	1'-4"	(8) #4 BAR E.W. 3" DIAMETER
É	54″×54″	1'-4"	(9) #4 BAR E.W. 3.5" DIAMETER
F	60″×60″	1'-6"	(10) #4 BAR E.W. 3.5" DIAMETER

# ISOLATED FOOTINGS AND COLUMN PADS

SYM	PIER DIAMETER	DEPTH	MINIMUM REINFORCEMENT GRADE 40 KSI STEEL
	12″	3′-0″	(4) VERTICAL #4
A	16″	3′-0″	(4) VERTICAL #4
$\triangle$	18″	3′-0″	(4) VERTICAL #4
Ŕ	24"	3'-0"	(4) VERTICAL #4
$\triangle$	28″	3′-0″	(4) VERTICAL #4

COLUMN AND PAD SIZES ARE FOR A MAXIMUM COLUMN HEIGHT OF 10'. COLUMNS GREATER THAN 10' REQUIRE A SEPARATE ENGINEERED DESIGN. FOOTINGS A-F SPACING OF 6" O.C. WITH 3" CLEAR COVER.

SCALE: 1/4" = 1'-0"

**FOUNDATION PLAN NOTES** 



120 SE 30TH ST. LEE'S SUMMIT, MO 64082 816-246-6700

COPYRIGHT 2017 DRAWING HAS BEEN PREPARED BY SUMM HOMES. OR UNDER THEIR DIRECT SUPERVISION AS AN INSTRUMENT OF SERVICE AND IS INTENDED FOR USE ONLY ON THIS PROJECT. ALL DRAWING: SPECIFICATIONS, AND DESIGNS, INCLUDING TH SPACES ARE PROTECTED BY COPYRIGHT REGISTERS TO CPG, INC. ANY REPRODUCTION, USE, C SCLOSURE OF THE INFORMATION CONTAINED HER WITHOUT THE WRITTEN CONSENT FROM CPG. II D/B/A SUMMIT HOMES EXCEPT AS REQUIRED FO BIDDING AND CONSTRUCTION OF THIS PROJECT IS TRICTLY PROHIBITED.

PROFESSIONAL SEAL:



RESIDENTIAL ENGINEERING SERVICES,LLC IS RESPONSIBLE FOR STRUCTURAL SPECIFICATION\$ ONLY. ARCHITECTURAL PLANS WERE PRODUCED BY OTHERS. RESIDENTIAL ENGINEERING SERVICES, LLC

600 SW JEFFERSON SUITE 300 LEE'S SUMMIT, MO 64063 816-399-4901

> ISSUE DATE: 02.10.21

SHEET NUMBER: