


RELEASE FOR CONSTRUCTION  
AS NOTED ON PLANS REVIEW  
DEVELOPMENT SERVICES  
LEE'S SUMMIT, MISSOURI  
11/01/2021 4:20:09

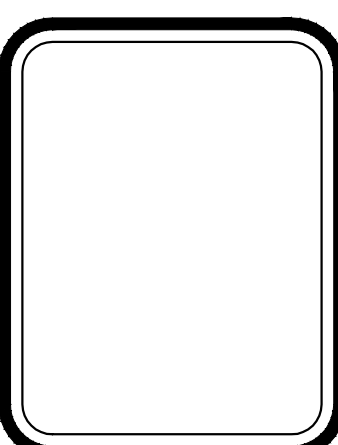

**DRAWING INDEX**

- A0 COVER SHEET
- A1 FOUNDATION PLAN
- A2 1st FLOOR PLAN
- A3 ROOF PLAN
- A4 ELEVATIONS
- A5 ELEVATIONS
- G1 GENERAL NOTES
- G2 GENERAL DETAILS
- G3 GENERAL DETAILS
- G4 BRACED WALL DETAILS



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HOMESTEAD AT HOOK FARMS LOT #1  
2038 SW FARM FIELD LANE  
LEE'S SUMMIT, MO 64081

**I.Q. HOME BUILDERS**  
P.O. BOX 6423  
LEE'S SUMMIT, MO 64064



DRAWN BY: MP, TC  
DATE: 10-26-21  
PROJECT NO: 15-016-06

SHEET NO.  
**A0**

FLOOR PLAN - SYMBOL LEGEND	
DESCRIPTION	SYMBOL
INTERIOR LOAD BEARING WALL	
STONE OR BRICK VENEER	
JOIST SIZE AND DIRECTION	
HEADER/ BEAM	
SIZE OF MEMBER PER SCHEDULE	(A) U
NUMBER OF PLYS	U
"U" IF UPSET	
CENTERLINE POINT LOAD	
APPROX. WINDOW FRAME SIZE IN INCHES (SEE GENERAL NOTES BELOW)	2941 C
SMOKE ALARM	
SMOKE & CARBON MONOXIDE ALARM	

HEADER / BEAM SCHEDULE			
MARK	LUMBER SIZE	CRIPPLE STUDS	TRIMMERS
(A)	2 x 6	1	1
(B)	2 x 8	1	1
(C)	2 x 10	1	1
(D)	2 x 12	2	1
(E)	3/4" x 1 1/4" L.V.L.	2	1
(F)	3/4" x 9/8" L.V.L.	2	1
(G)	3/4" x 1 1/8" L.V.L.	2	1
(H)	3/4" x 1 1/4" L.V.L.	2	1
(J)	3/4" x 1 1/2" L.V.L.	3	1
(K)	3/4" x 1 3/4" L.V.L.	3	1
(L)	3/4" x 9/8" L.S.L.	1	1
(M)	3/4" x 1 1/8" L.S.L.	2	1

1. BEAMS SHALL HAVE TOTAL NUMBER OF CRIPPLES AND TRIMMERS UNDER EACH END. SOLID BLOCK BELOW.  
 2. FOR L.V.L. BEAMS IN 2x10 FLOORS, USE 3/4" L.V.L.

FLOOR JOIST SCHEDULE				
MARK	TYPE	SUB-TYPE	SIZE	SPACING MAX SPAN
FJ-1	"I" JOIST (SEE NOTE)		9 1/2"	PER MANUFACTURER
FJ-2	"I" JOIST (SEE NOTE)		11 7/8"	PER MANUFACTURER
FJ-3	"I" JOIST (SEE NOTE)		14"	PER MANUFACTURER
FJ-4	TRUSS (SEE NOTES)		14"	PER MANUFACTURER
FJ-5	TRUSS (SEE NOTES)		16"	PER MANUFACTURER
FJ-20	LUMBER	ACQ. TREATED	2x10	12" O.C. 16'-2"
FJ-21	LUMBER	ACQ. TREATED	2x10	16" O.C. 14'
FJ-22	LUMBER		2x8	12" O.C. 14'-2"
FJ-23	LUMBER		2x8	16" O.C. 12'-1"
FJ-24	LUMBER		2x10	12" O.C. 11'-9"
FJ-25	LUMBER		2x10	16" O.C. 15'-5"
FJ-26	LUMBER		2-2x10	16" O.C.

NOTE: DESIGN I-JOISTS (LOADED W/ TOTAL LIVE AND DEAD LOAD) WITH A MAX. DEFLECTION OF L/360, EXCEPT BELOW BATHROOMS AND TILED AREAS WHERE THE DEFLECTION SHALL BE L/480 MAX.

CONCRETE WALL SCHEDULE			
MARK	CONCRETE WALL THICKNESS	REINFORCING VERTICAL	GRADE 40 HORIZONTAL
1	8"	4' OR LESS	#4 @ 36" O.C. 2 - #4's
2	8"	4' TO 6'	#4 @ 36" O.C. 3 - #4's
3	8"	6' TO 8'	#4 @ 36" O.C. 4 - #4's
4	8"	8'	#4 @ 36" O.C. 4 - #4's
5	8"	9'	#4 @ 36" O.C. 5 - #4's
6	10"	4'	#4 @ 36" O.C. 2 - #4's
7	10"	8'	#4 @ 36" O.C. 4 - #4's
8	10"	9'	#4 @ 36" O.C. 5 - #4's
9	10"	10'	#4 @ 36" O.C. 6 - #4's

COLUMN & PAD SCHEDULE			
MARK	PAD SIZE	#4 BARS REQ'D EACH WAY	COLUMN SIZE (SCHEDULE 40) MAX. LOAD
A	36" x 36" x 12"	6	3" 15.5 K
B	48" x 48" x 12"	8	3" 24.0 K
C	60" x 60" x 18"	10	3.5" 37.5 K
D	72" x 72" x 18"	12	5" 54.0 K


PIER SCHEDULE		
MARK	PIER DIAMETER	FOOT (ACQ OR CEDAR UNO.) MAX. LOAD
F	12"	6x6 UNO. 11 K
G	18"	6x6 UNO. 2.6 K
H	24"	6x6 UNO. 4.1 K

1) PAD AND PIER SIZES ASSUME 1500 P.S.F. SOIL BEARING CAPACITY.  
 2) 10' MAX STEEL COLUMN HEIGHT FROM BASE PLATE TO TOP OF COLUMN. CONSULT ARCHITECT IF SITE CONDITIONS REQUIRE TALLER COLUMNS.


**GENERAL NOTES:**  
 A. EXTERIOR FRAMED WALLS ARE 2x4 STUDS AT 16" O.C. UNLESS NOTED OTHERWISE.  
 B. FURNACE IS DIRECT VENT AND USES OUTSIDE AIR FOR COMBUSTION.  
 C. FOR COVERED PATIO FRAMING - SEE DETAIL 1/G3

**FOUNDATION PLAN NOTES**  
 1. CONCRETE SLAB, CONCRETE PIER AND PAD - SEE DETAIL 3/G2  
 2. 16" WIDE X 8" DEEP CONCRETE FOOTING W/ 2-#4 BARS CONTINUOUS  
 3. 2x4 STUDS @ 16" O.C. WITH TREATED SILL PLATE.  
 4. EXTEND FLOOR FRAMING AND INSULATE SOFFIT  
 5. FLOOR LINE ABOVE  
 6. 3/8" GAS FIREPLACE

1. PROVIDE THERMAL EXPANSION CONTROL DEVICE.
2. RETURN WALL - SEE DETAIL 8/G2
3. CANTILEVER FLOOR FRAMING
4. 1 STUDS FOR BEARING
5. MANUFACTURED STONE VENEER - SEE ELEVATIONS
6. 4 STUDS FOR BEARING
7. 2x6 STUDS AT 12" O.C. FOR UNINTERRUPTED 11'-8" TALL WALL

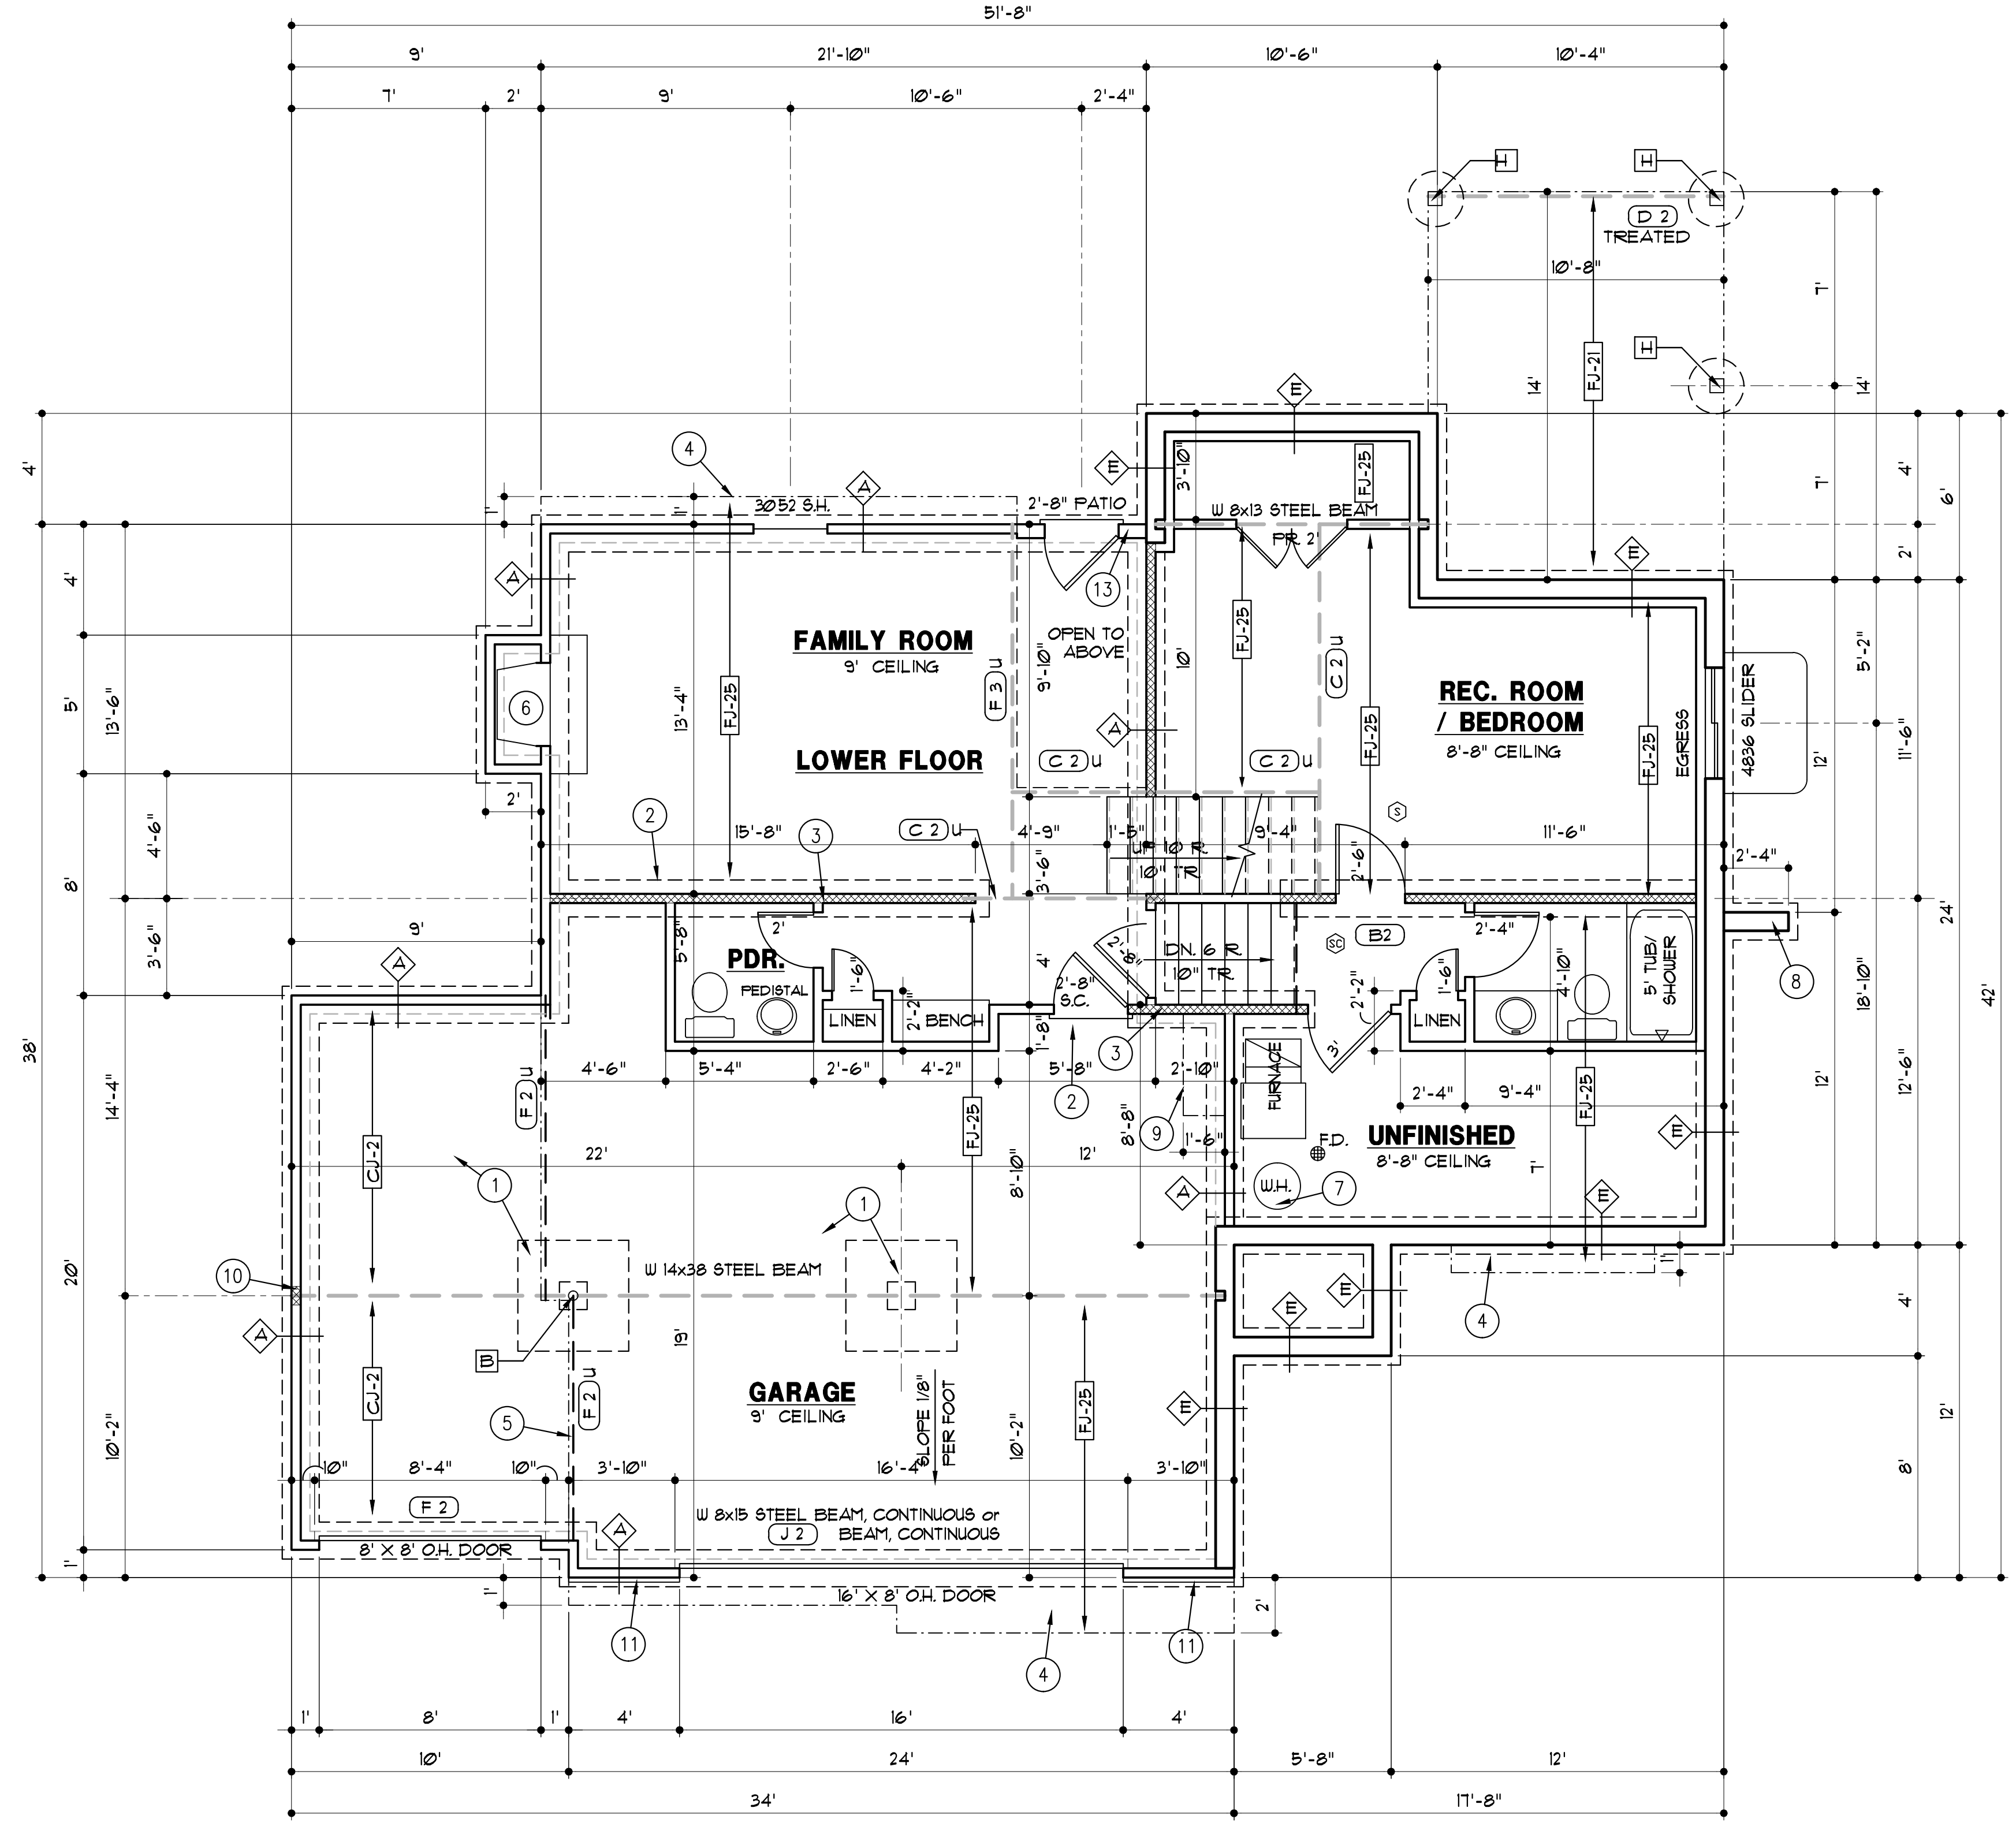

**FOUNDATION PLAN**  
 1/4" = 1'-0"

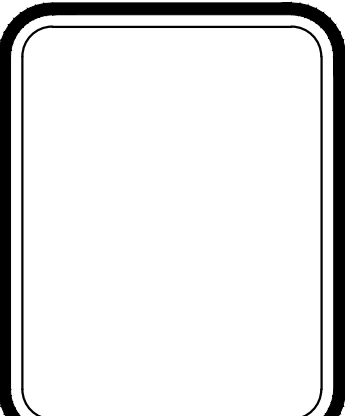

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 LEE'S SUMMIT, MO 64064



DRAWN BY: MP, TC  
 DATE: 10-26-21  
 PROJECT NO: 15-016-06

SHEET NO.  
**A1**

FLOOR PLAN - SYMBOL LEGEND	
DESCRIPTION	SYMBOL
INTERIOR LOAD BEARING WALL	
STONE OR BRICK VENEER	
JOIST SIZE AND DIRECTION	
HEADER/ BEAM SIZE OF MEMBER PER BEAM	
HEADER/ BEAM SCHEDULE NUMBER OF PLYS	
CENTERLINE POINT LOAD	
APPROX. WINDOW FRAME SIZE IN INCHES (SEE GENERAL NOTES BELOW)	
SMOKE ALARM	
SMOKE & CARBON MONOXIDE ALARM	

HEADER / BEAM SCHEDULE			
MARK	LUMBER SIZE	CRIPPLE STUDS	TRIMMERS
(A)	2 x 6	1	1
(B)	2 x 8	1	1
(C)	2 x 10	1	1
(D)	2 x 12	2	1
(E)	3/4" x 1 1/4" L.V.L.	2	1
(F)	3/4" x 1 1/2" L.V.L.	2	1
(G)	3/4" x 1 3/4" L.V.L.	2	1
(H)	3/4" x 1 3/8" L.V.L.	2	1
(J)	3/4" x 1 1/2" L.V.L.	3	1
(K)	3/4" x 1 3/4" L.V.L.	3	1
(L)	3/4" x 1 1/2" L.S.L.	1	1
(M)	3/4" x 1 1/8" L.S.L.	2	1

1. BEAMS SHALL HAVE TOTAL NUMBER OF CRIPPLES AND TRIMMERS UNDER EACH END. SOLID BLOCK BELOW.  
 2. FOR L.V.L. BEAMS IN 2x10 FLOORS, USE 3/4" L.V.L.

FLOOR JOIST SCHEDULE				
MARK	TYPE	SUB-TYPE	SIZE	SPACING MAX SPAN
FJ-1	"I" JOIST (SEE NOTE)		9 1/2"	PER MANUFACTURER
FJ-2	"I" JOIST (SEE NOTE)		11 7/8"	PER MANUFACTURER
FJ-3	"I" JOIST (SEE NOTE)		14"	PER MANUFACTURER
FJ-4	TRUSS (SEE NOTES)		14"	PER MANUFACTURER
FJ-5	TRUSS (SEE NOTES)		16"	PER MANUFACTURER
FJ-20	LUMBER	ACQ. TREATED	2x10	12" O.C. 16'-2"
FJ-21	LUMBER	ACQ. TREATED	2x10	16" O.C. 14'
FJ-22	LUMBER		2x8	12" O.C. 14'-2"
FJ-23	LUMBER		2x8	16" O.C. 12'-1"
FJ-24	LUMBER		2x10	12" O.C. 11'-9"
FJ-25	LUMBER		2x10	16" O.C. 15'-5"
FJ-26	LUMBER		2-2x10	16" O.C.

NOTE: DESIGN I-JOISTS (LOADED W/ TOTAL LIVE AND DEAD LOAD) WITH A MAX. DEFLECTION OF L/360, EXCEPT BELOW BATHROOMS AND TILED AREAS WHERE THE DEFLECTION SHALL BE L/480 MAX.

CEILING JOISTS SCHEDULE - LIVE LOAD 10 P.S.F.			
MARK	SIZE	SPACING	MAXIMUM SPAN - DOUGLAS FIR #2
CJ-1	2x6	12"	19'-6"
CJ-2	2x6	16"	11'-8"
CJ-3	2x8	12"	25'-8"
CJ-4	2x8	16"	23'-0"
CJ-5	2x10	12"	NA
CJ-6	2x10	16"	NA
CJ-7	2x4	24"	9'-10"
CJ-8	2x6	24"	14'-10"
CJ-9	2x8	24"	18'-9"
CJ-10	2x10	24"	22'-11"

SQUARE FOOTAGE TABLE	
LOCATION	AREA (S.F.)
UPPER LEVEL	1433
LOWER LEVEL	392
BASEMENT	351
TOTAL	2176
GARAGE	695
BASEMENT (UNFINISHED)	183

**GENERAL NOTES:**

A. EXTERIOR WALLS ARE 2x4 STUDS AT 16" O.C. UNLESS OTHERWISE NOTED.

B. SOLID BLOCKING BELOW STUDS SUPPORTING BEAMS AND HEADERS.

C. FOR COVERED PATIO FRAMING - SEE DETAIL 1/G3

D. SEE G4 SHEET FOR LOCATION OF HOLD-DOWN TIES FOR BRACED WALL CONSTRUCTION

**FLOOR PLAN NOTES**

1. (4) 2x4 STUDS SOLID BLOCK BELOW


2. INSULATE CANTILEVERED FLOOR

3. 3 STUDS FOR BEARING, SOLID BLOCKING BELOW


4. FURR DOWN CEILING 6" FOR INSULATION.

5. 6 X 6 PRESSURE TREATED OR CEDAR POST.

6. 2x6 STUDS AT 12" O.C. FOR UNINTERRUPTED 11'-8" TALL WALL

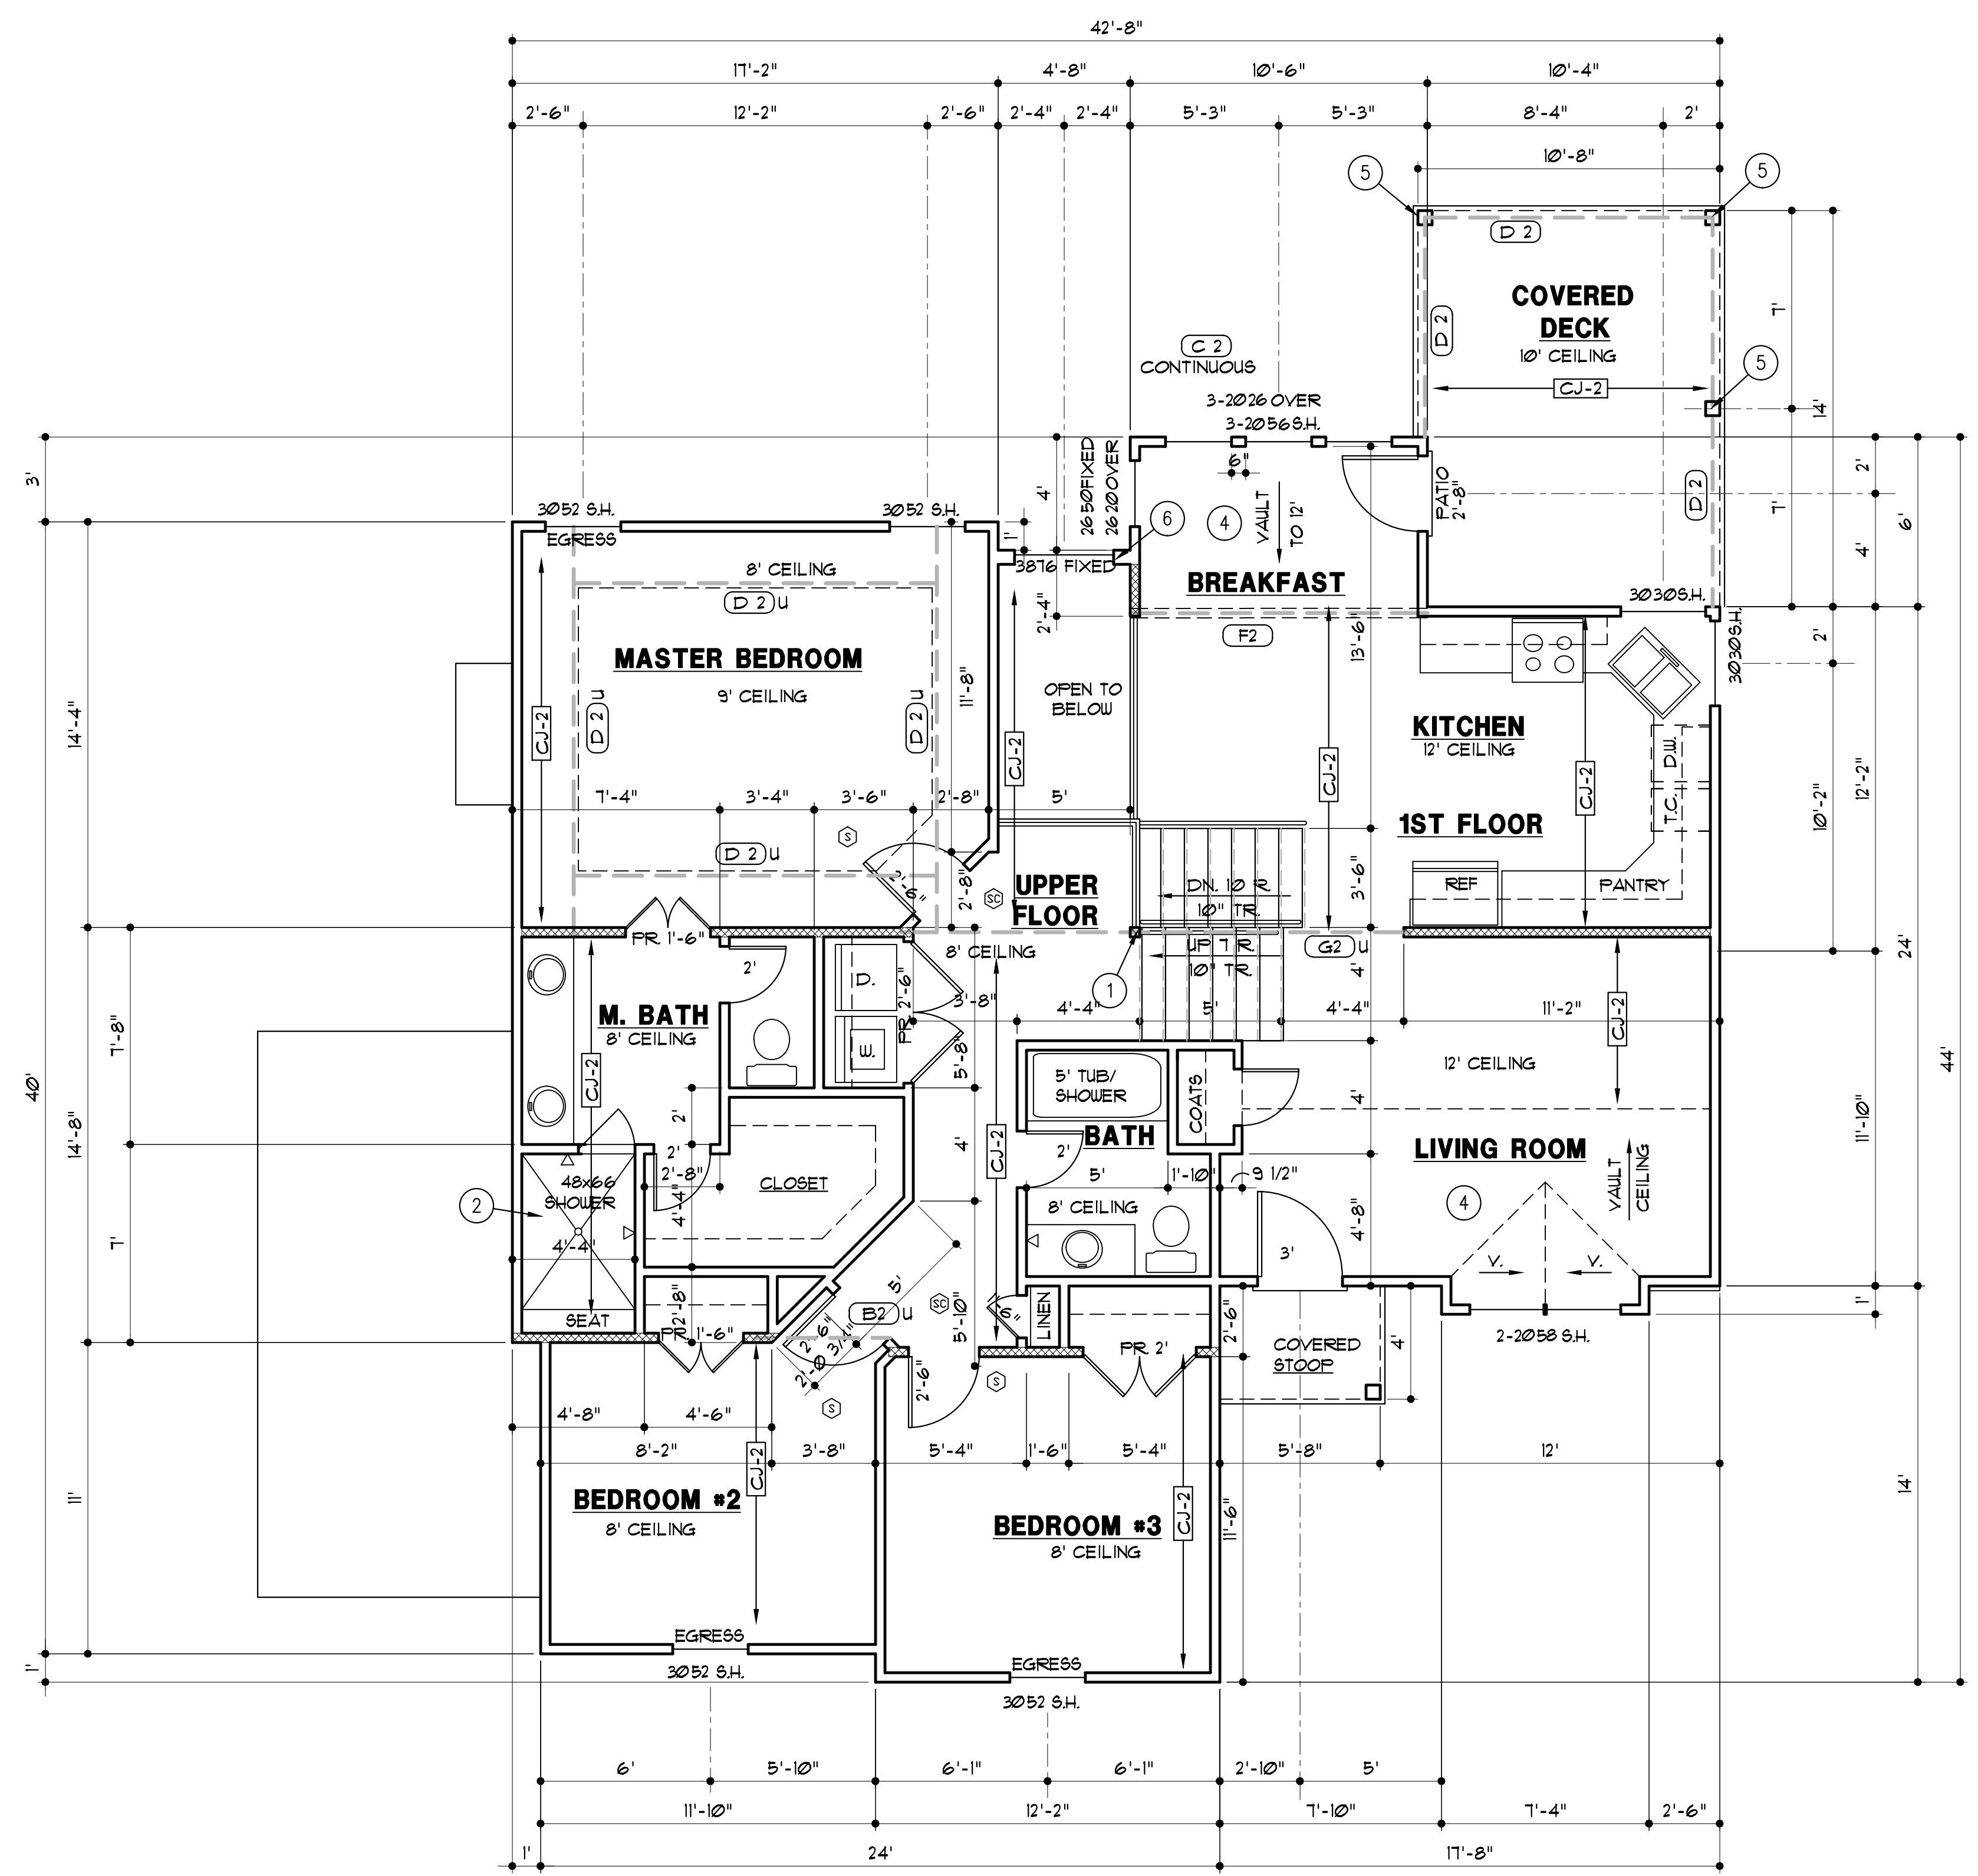

**FIRST FLOOR PLAN**  
 1/4" = 1'-0"

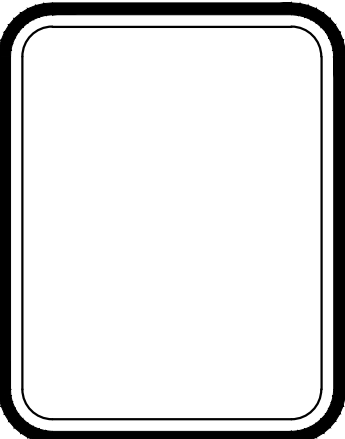

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DRAWN BY: MP, TC  
 DATE: 10-26-21  
 PROJECT NO: 15-016-06

SHEET NO.  
**A2**

ROOF PLAN LEGEND	
DESCRIPTION	SYMBOL
RIDGES AND HIP	—————
VALLEYS	—————
EAVES, RAKE & GABLE	—————
HOUSE WALLS	—————
FURLIN	—————
TOP OF FURLIN STRUT OR RIDGE POLE	○
BOT. OF FURLIN STRUT OR RIDGE POLE	○
JOIST SIZE AND SPACING	RJ-X
UPLIFT VALUE	○○○*


ROOF RAFTER SCHEDULE				
MARK	SIZE	SPACING	MAXIMUM SPAN	
			FLAT CEILING	VAULTED CEILING
RJ-1	2x6	12"	16'-11"	14'-9"
RJ-2	2x6	16"	14'-4"	12'-9"
RJ-3	2x6	24"	11'-9"	10'-5"
RJ-4	2x8	12"	21'-0"	18'-8"
RJ-5	2x8	16"	18'-2"	16'-2"
RJ-6	2x8	24"	14'-10"	13'-2"
RJ-7	2x10	12"	25'-8"	22'-9"
RJ-8	2x10	16"	22'-5"	19'-9"
RJ-9	2x10	24"	18'-2"	16'-11"
RJ-10	2x12	16"	25'-9"	26'-5"
RJ-11	2x12	24"	18'-2"	22'-10"

**GENERAL NOTES:**


A. BRACE ALL RIDGES TO BEARING WALLS OR BEAMS BELOW, AT 4' O.C. UNLESS NOTED OTHERWISE

B. STRUTS TO BEAR ON WALLS AS INDICATED. CONTACT ARCHITECT WITH ANY PROPOSED CHANGE TO STRUT BEARING LOCATIONS. ARCHITECT MAY NEED TO VERIFY THAT BEAMS BELOW NEW STRUT LOCATION CAN SUPPORT ADDED LOADS.

- ROOF PLAN NOTES**
1. BEARING WALL OR BEAM BELOW
  2. 2x8 FURLIN WITH 2x6 1" BRACES AT 4' O.C. TO BEARING WALL/ BEAM BELOW
  3. 2x6 1" BRACE TO BEARING WALL OR BEAM BELOW. BRACE SHALL BE CONNECTED TO STRUCTURE AT ROOF AND CEILING WITH MINIMUM (5) 16d NAILS.
  4. CUT BACK SOFFIT EAVE TO CLEAR WINDOW
  5. BRACE RIDGE TO BEARING WALL WITH 2x6'S AT 4' O.C.
  6. (3) 2x6 STRUT
  7. TIGHT BARGE
  8. OVERFRAME THIS AREA
  9. 4-2x6 RAFTERS
  10. (3) 2x6 BEAM
  11. 2x6 RAFTER TIES AT 32" O.C. INSTALLED 10'-8" FROM DECK TO BOTTOM OF TIE

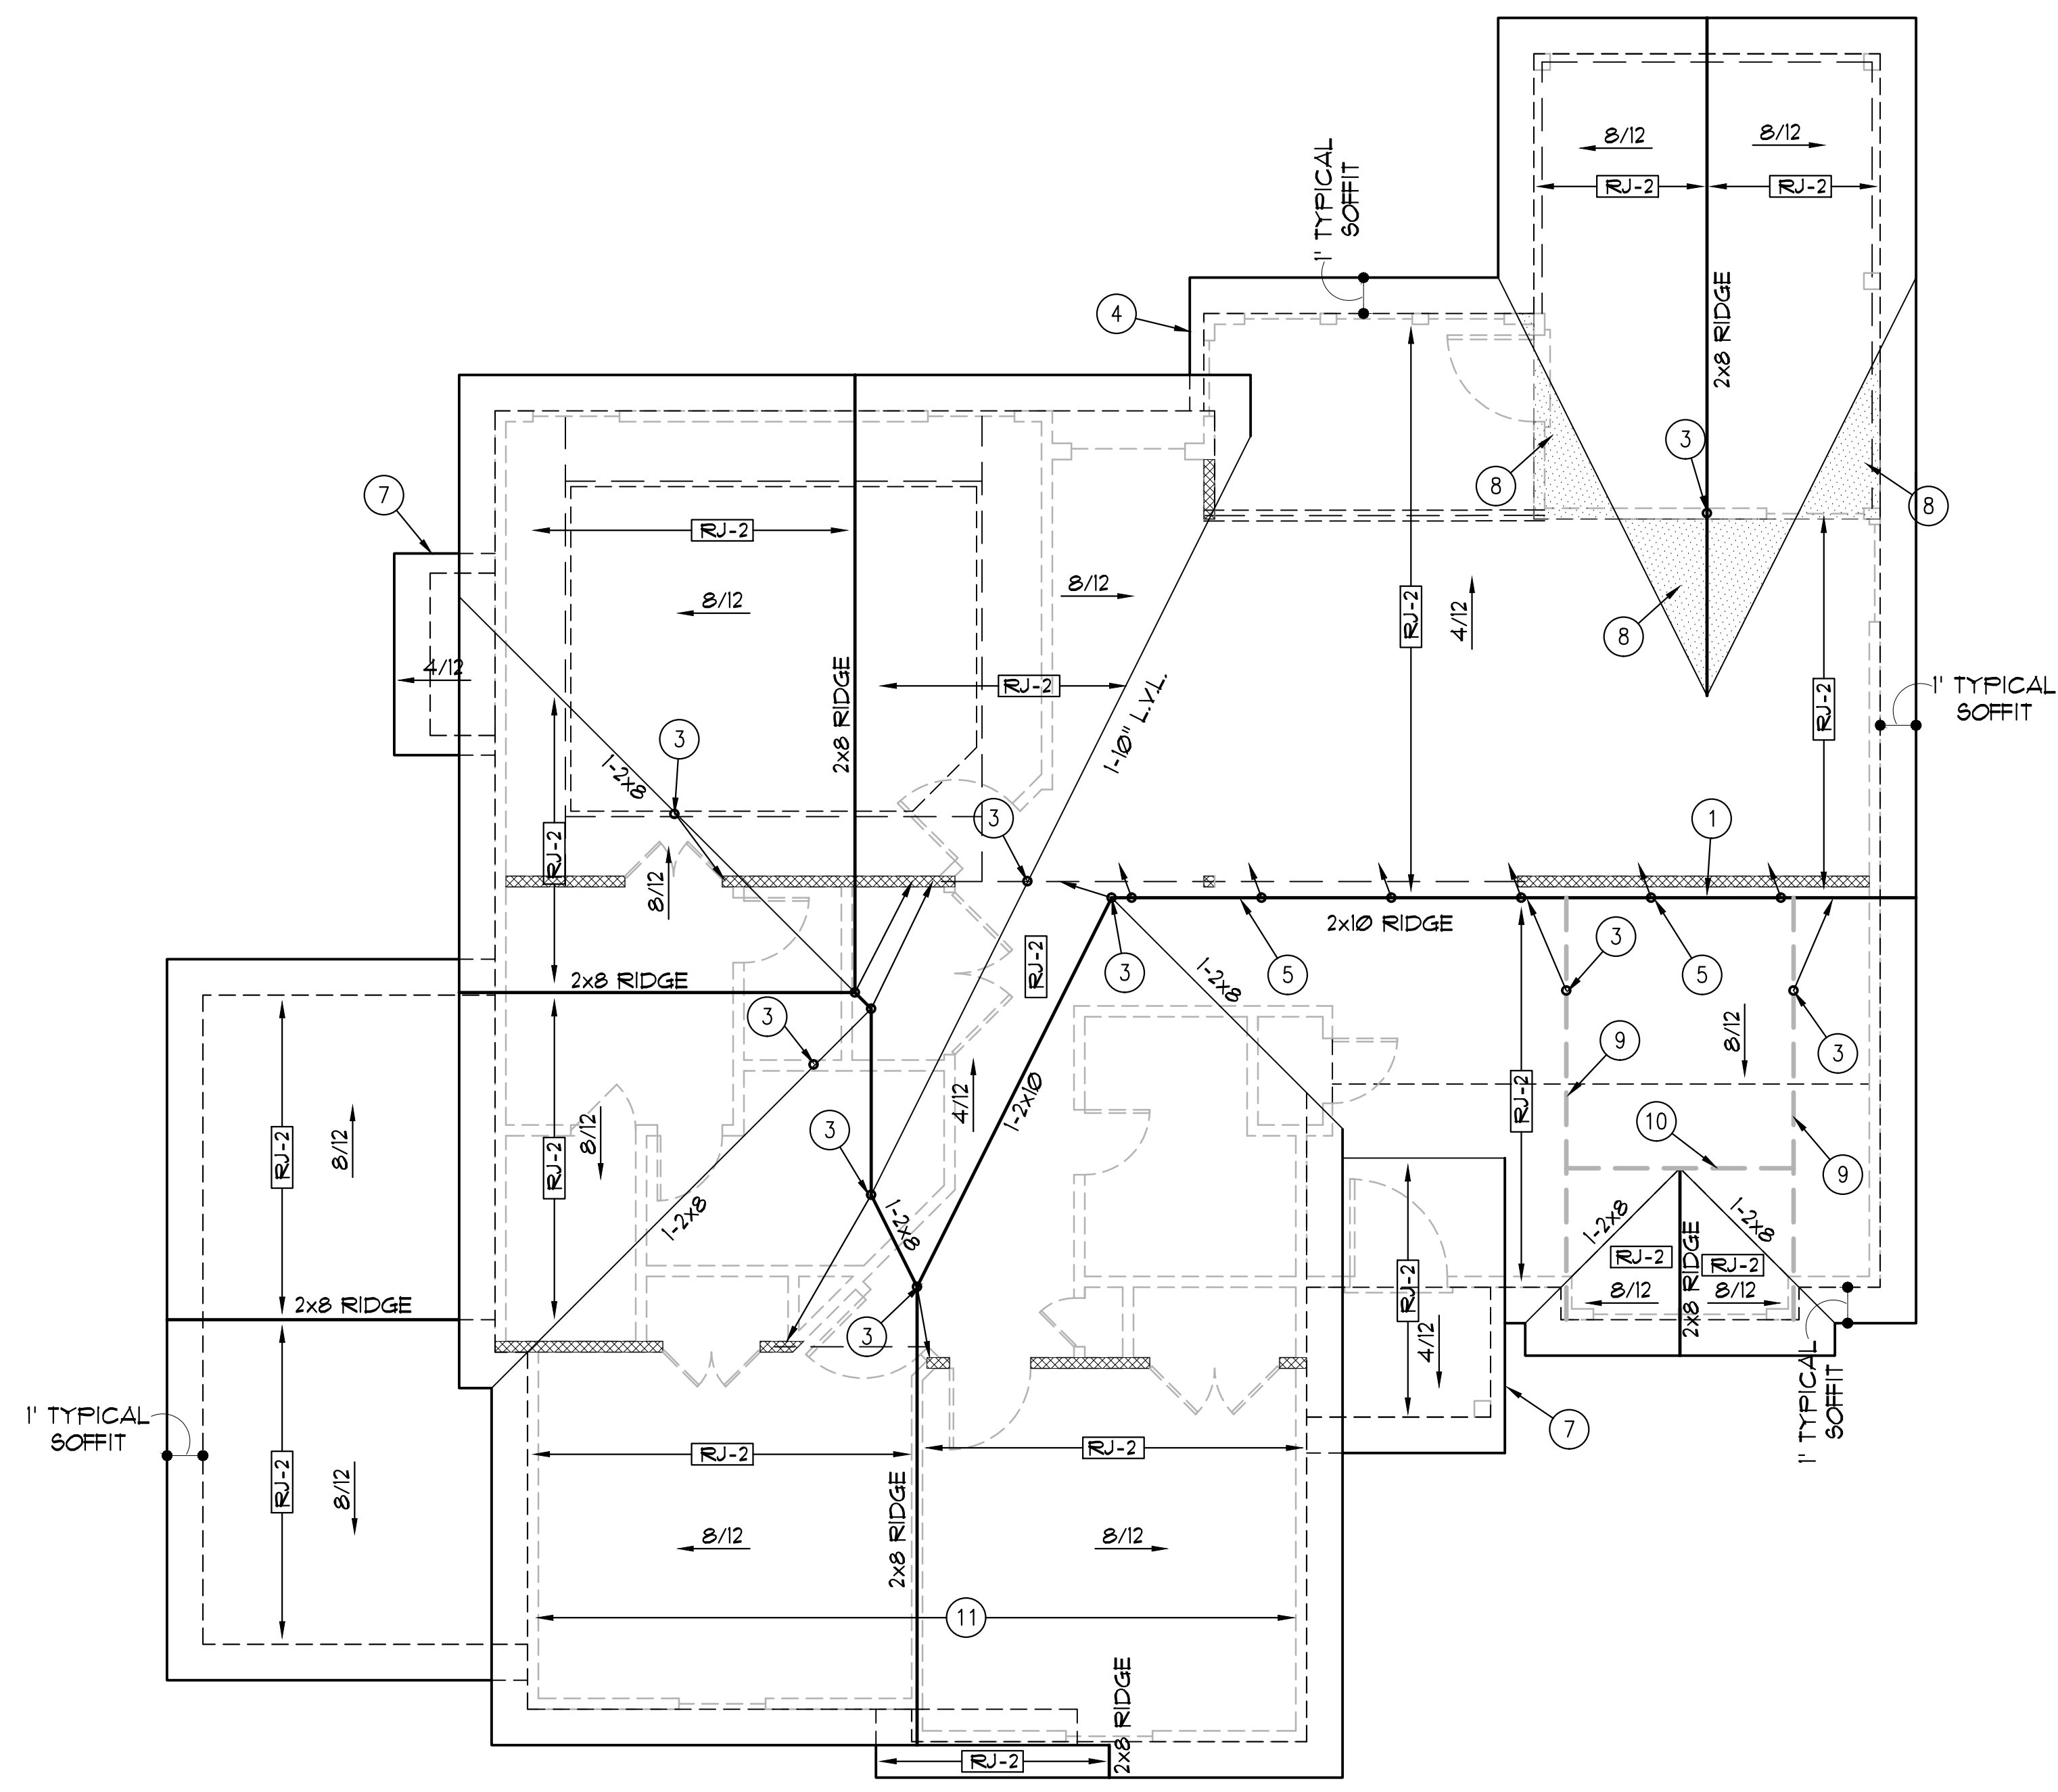

**ROOF PLAN**  
 1/4" = 1'-0"

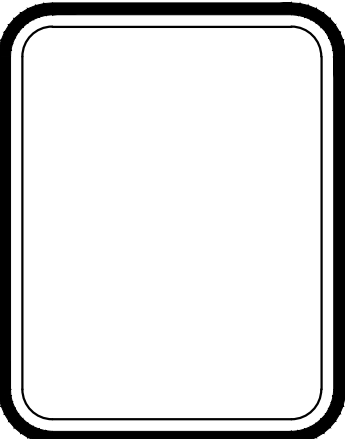

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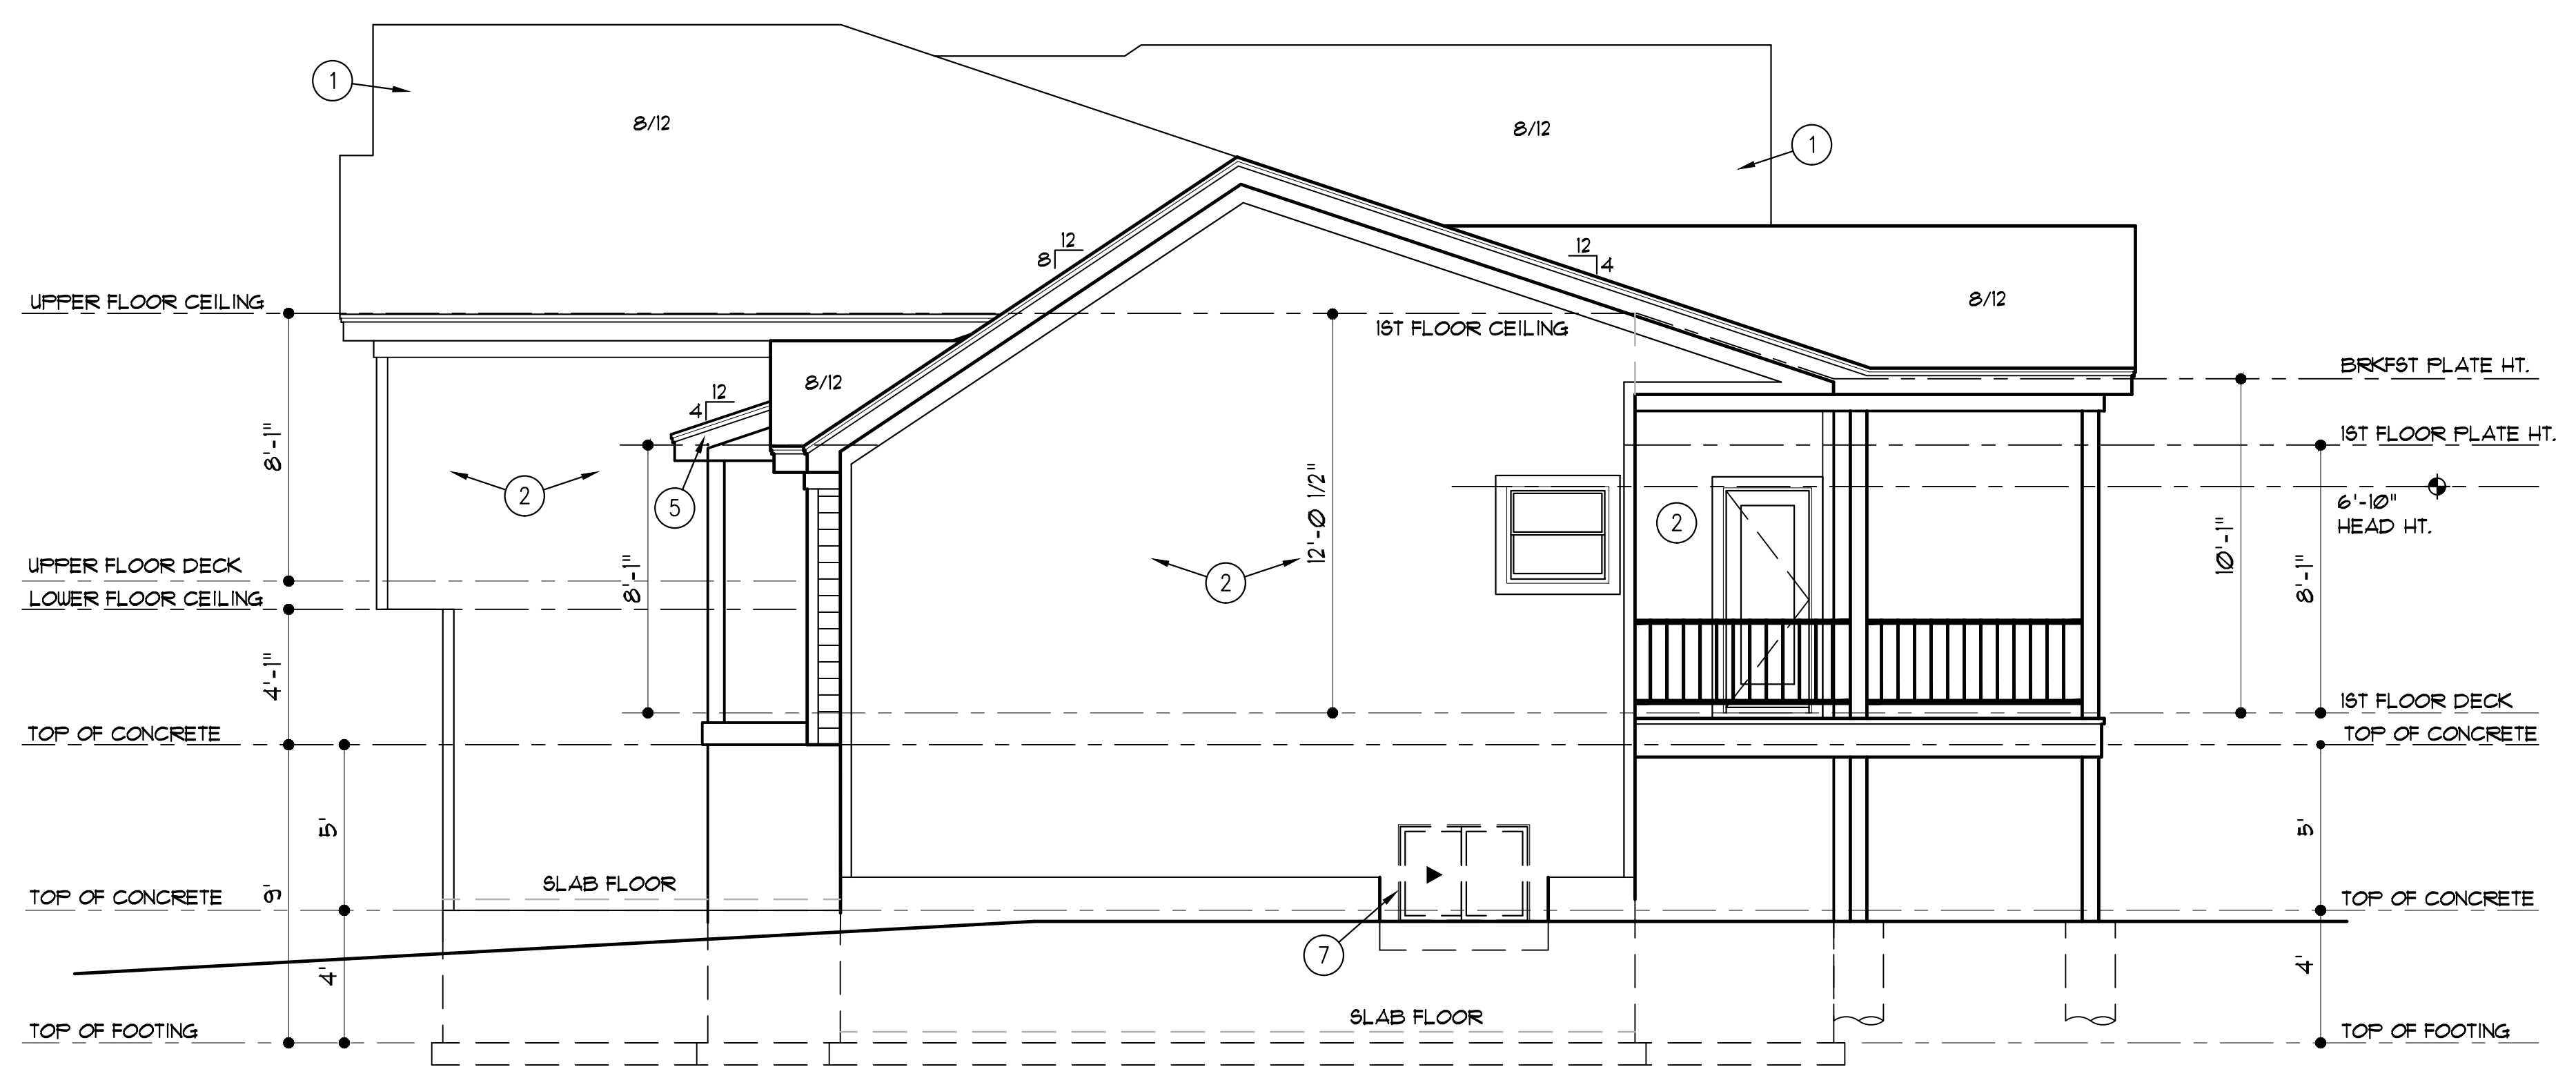
**I.Q. HOME BUILDERS**  
 P.O. BOX 6423  
 LEE'S SUMMIT, MO 64064




DRAWN BY: MP, TC  
 DATE: 10-26-21  
 PROJECT NO: 15-016-06

SHEET NO.  
**A3**


- ELEVATION NOTES**
1. ROOFING TO BE "TIMBERLINE" SHINGLES OR EQUAL ON 1/2" FELT ON 1/16" O.S.B. SHEATHING.
  2. SIDING TO BE 3/8" MIN. STRUCTURAL WOOD PANEL SIDING, "SMART PANEL" SIDING OR EQUAL, INSTALLED PER MANUFACTURER'S INSTRUCTIONS. PROVIDE 1/2" FLASHING BETWEEN VERTICAL PANELS. 1x4 SMART TRIM AT ALL CORNERS AND AROUND WINDOWS.
  3. SMART LAP SIDING WITH 6" EXPOSURE AND 5/4x6 SMART TRIM AT CORNERS, DOORS AND WINDOWS
  4. MANUFACTURED STONE
  5. TIGHT BARGE
  6. BOARD & BATTEN SHUTTERS
  7. METAL EGRESS WINDOW. WINDOW SET AT MAX. 44" FROM FINISH FLOOR TO SILL
  8. SHAKES



**RIGHT SIDE ELEVATION**  
 1/4" = 1'-0"

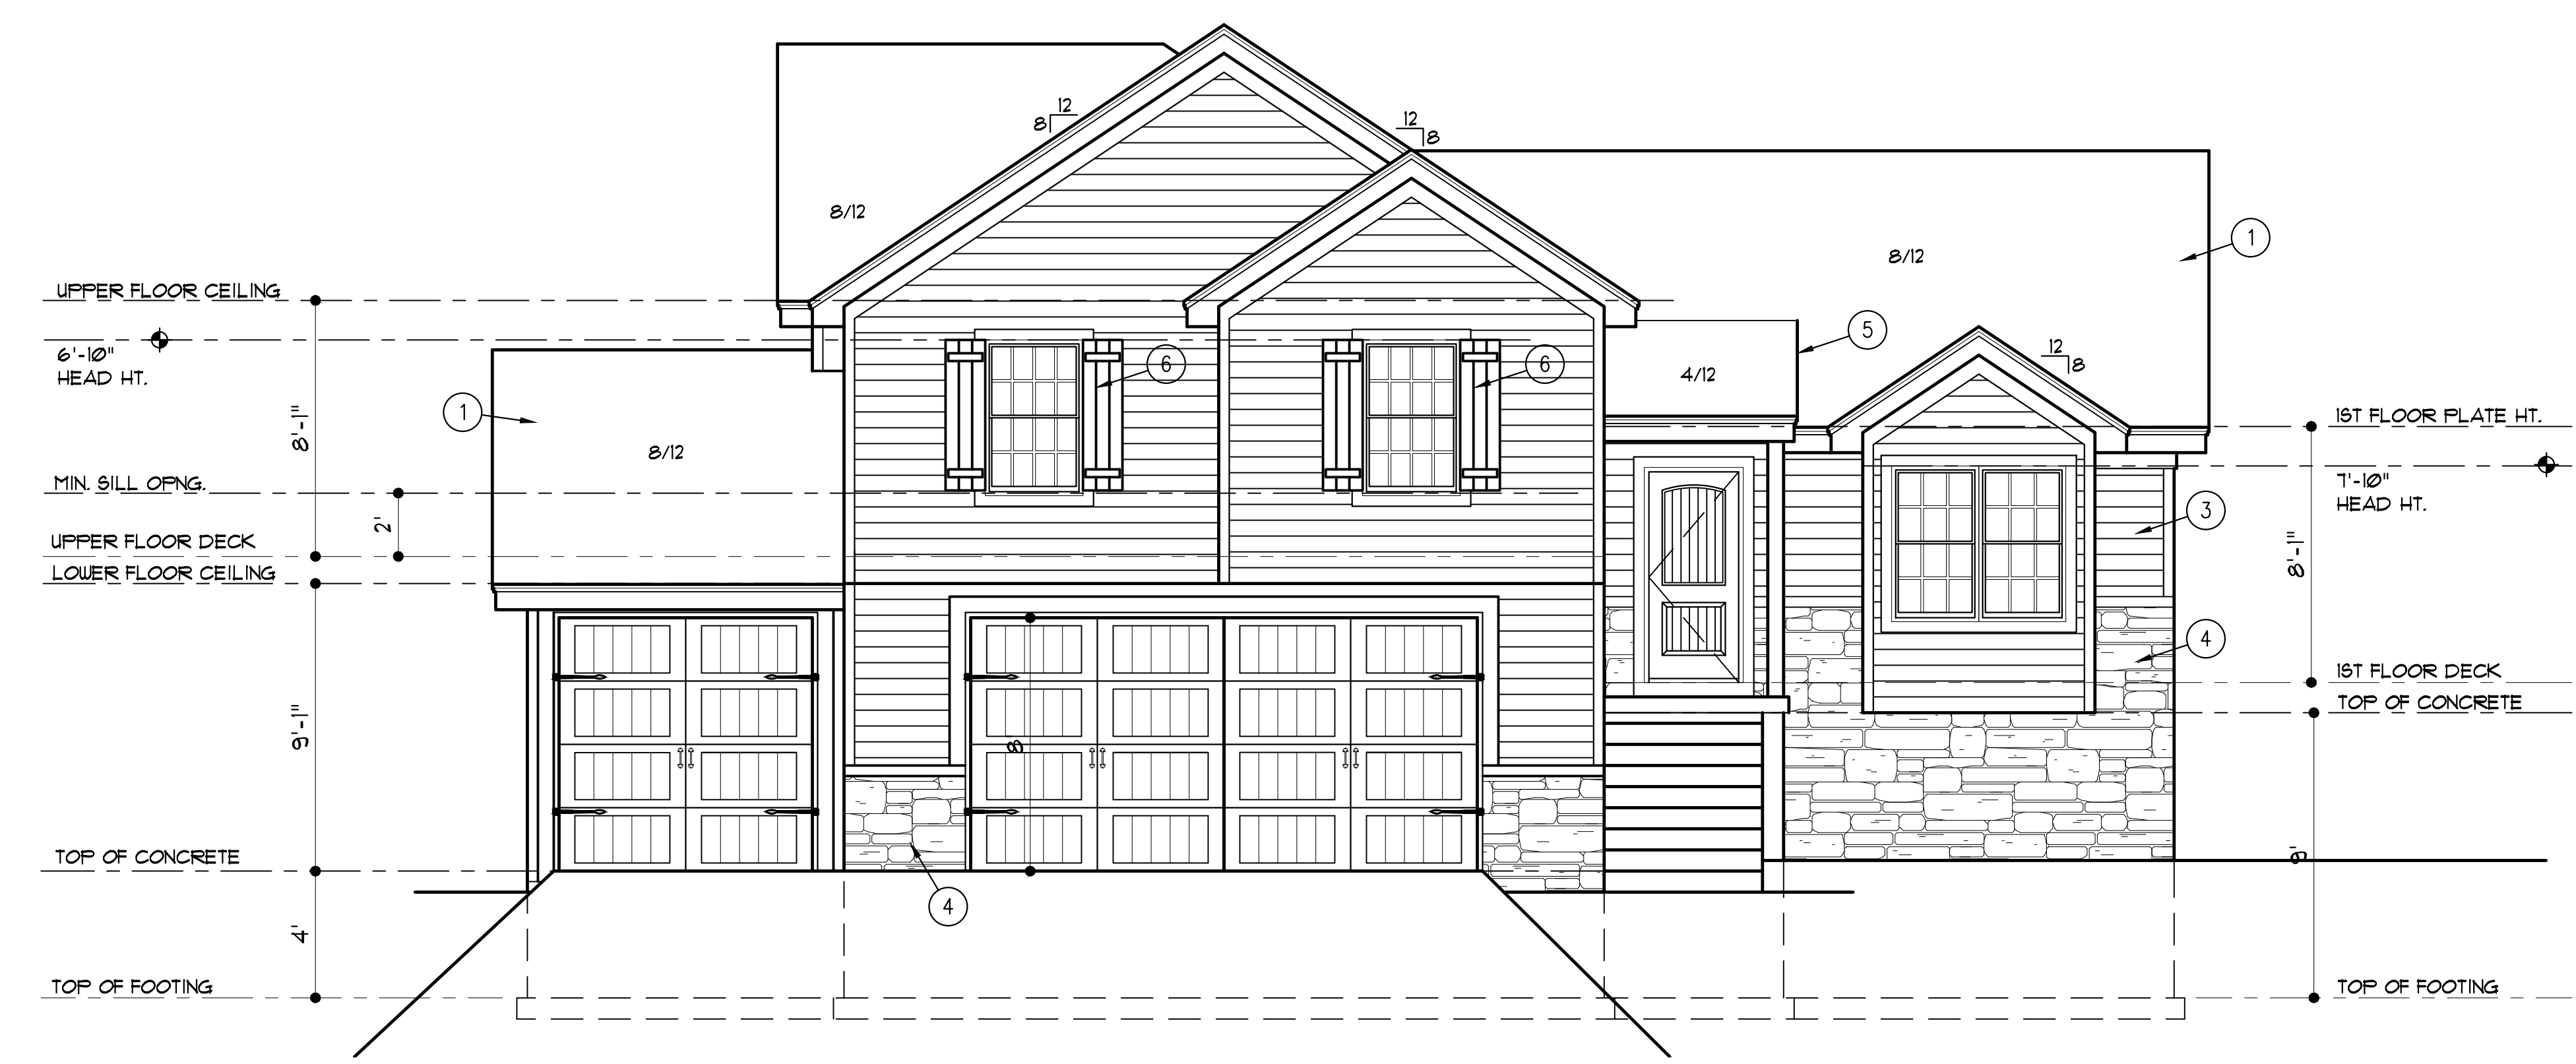

**FRONT ELEVATION**  
 1/4" = 1'-0"

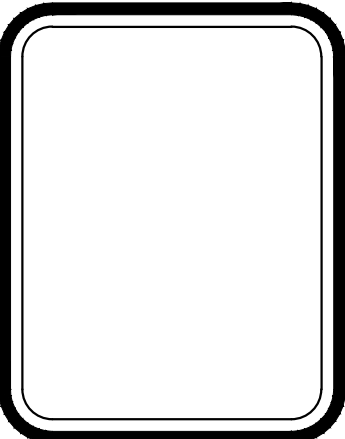

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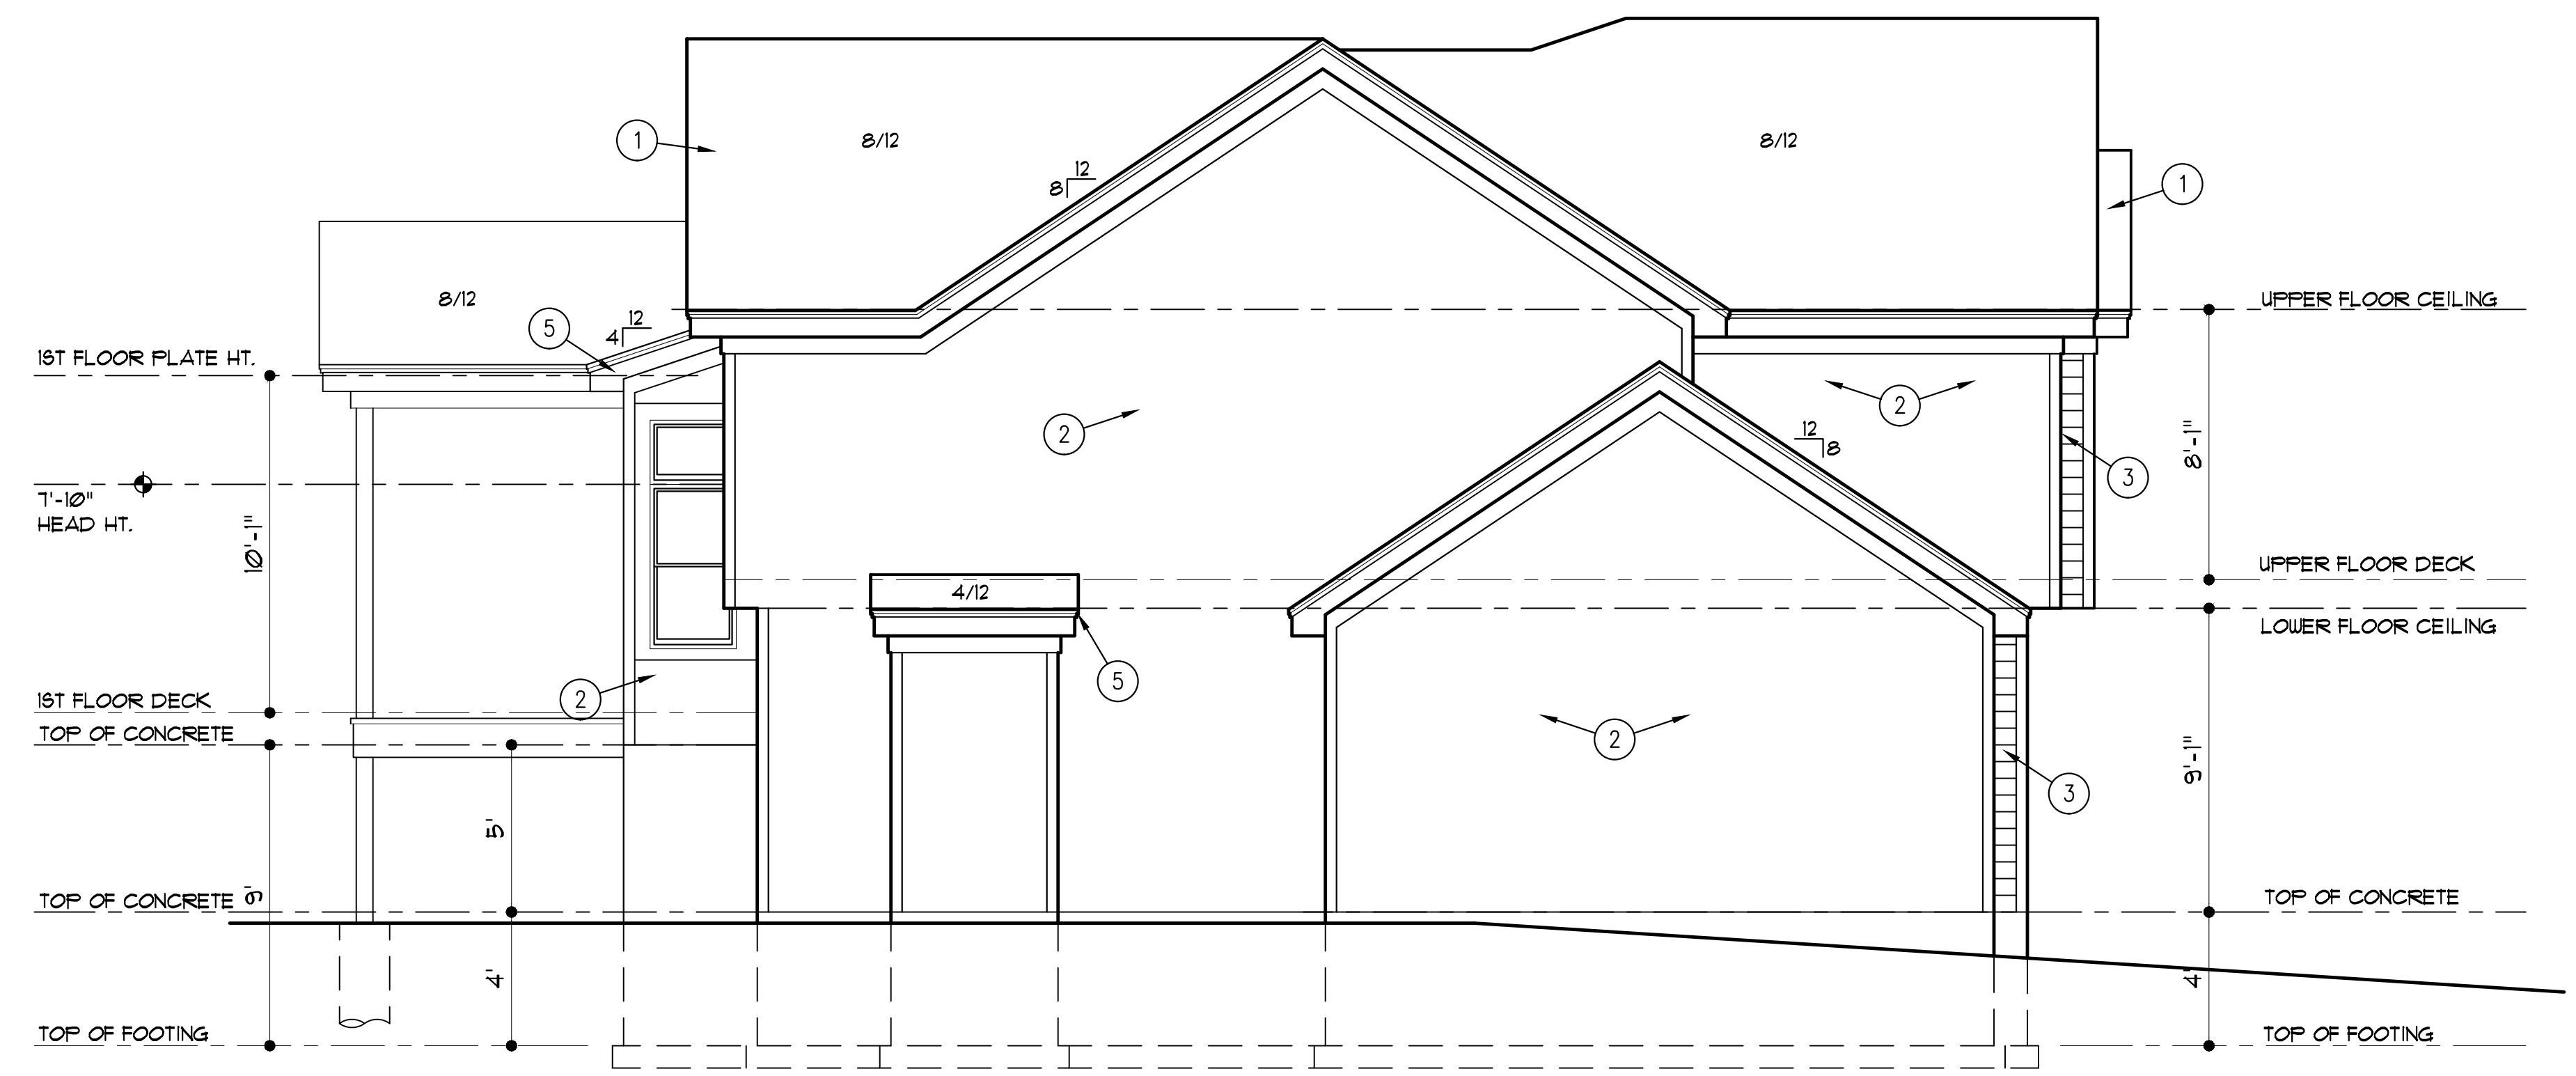
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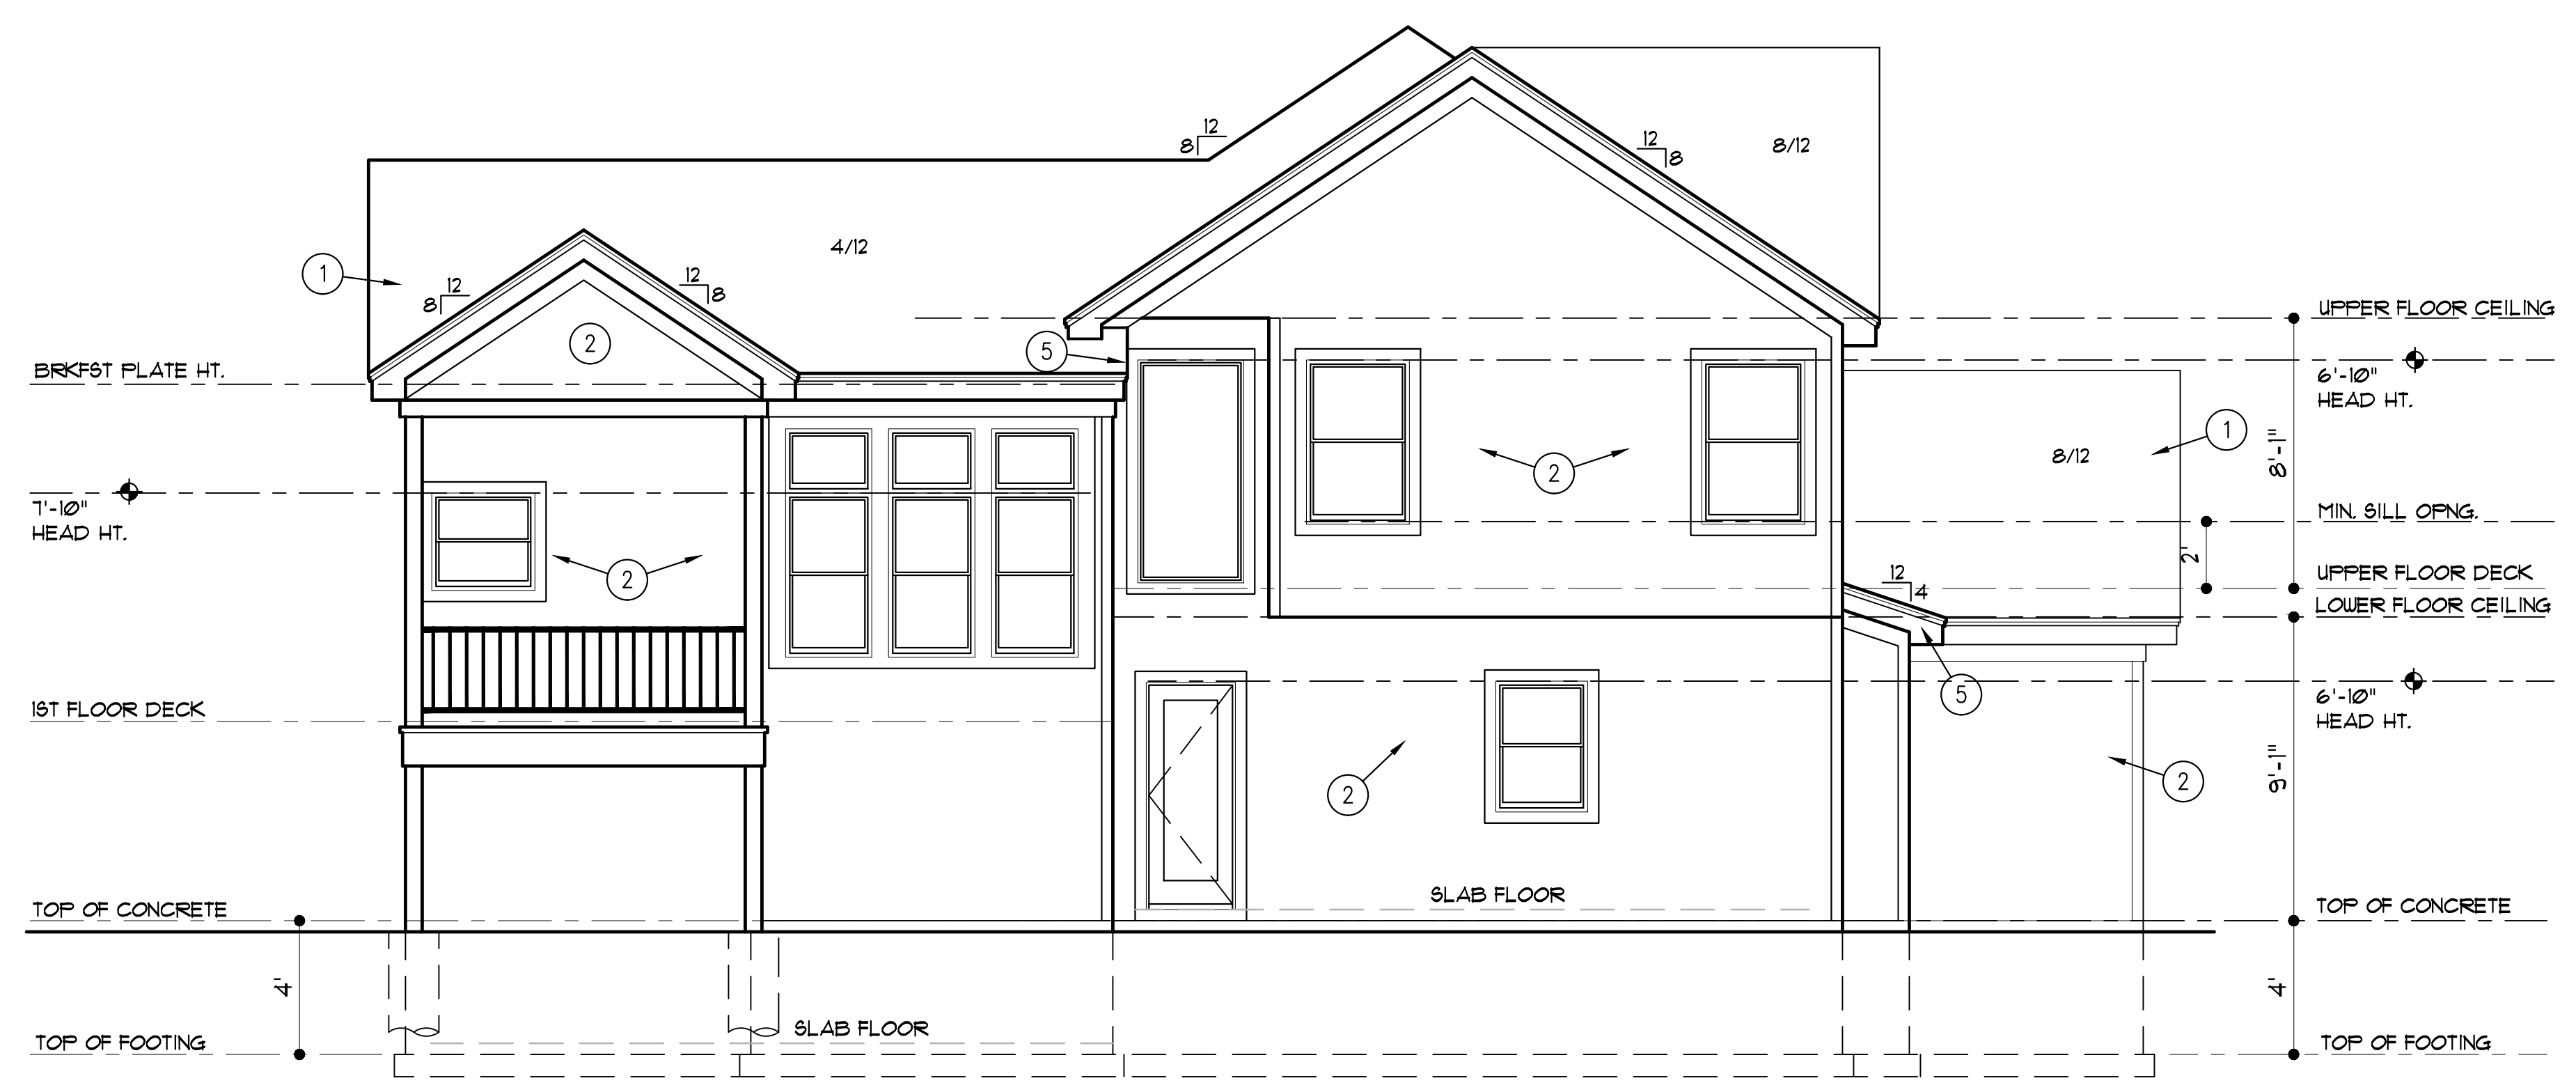
DRAWN BY: MP, TC  
 DATE: 10-26-21  
 PROJECT NO: 15-016-06

SHEET NO.  
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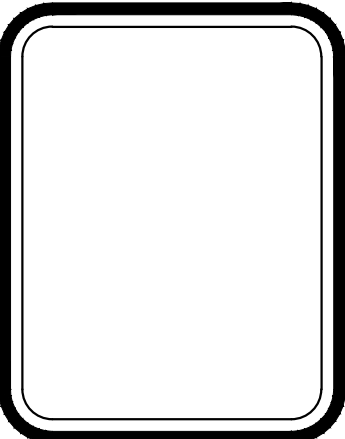
- ELEVATION NOTES**
1. ROOFING TO BE "TIMBERLINE" SHINGLES OR EQUAL ON 1/2" FELT ON 1/16" O.S.B. SHEATHING.
  2. SIDING TO BE 3/8" MIN. STRUCTURAL WOOD PANEL SIDING, "SMART PANEL" SIDING OR EQUAL, INSTALLED PER MANUFACTURER'S INSTRUCTIONS. PROVIDE 1/2" FLASHING BETWEEN VERTICAL PANELS. 1x4 SMART TRIM AT ALL CORNERS AND AROUND WINDOWS.
  3. SMART LAP SIDING WITH 6" EXPOSURE AND 5/4x6 SMART TRIM AT CORNERS, DOORS AND WINDOWS
  4. MANUFACTURED STONE
  5. TIGHT BARGE
  6. BOARD & BATTEN SHUTTERS
1. METAL EGRESS WINDOW. WINDOW SET AT MAX. 44" FROM FINISH FLOOR TO SILL.  
 2. SHAKES



**LEFT SIDE ELEVATION**  
 1/4" = 1'-0"



**REAR ELEVATION**  
 1/4" = 1'-0"



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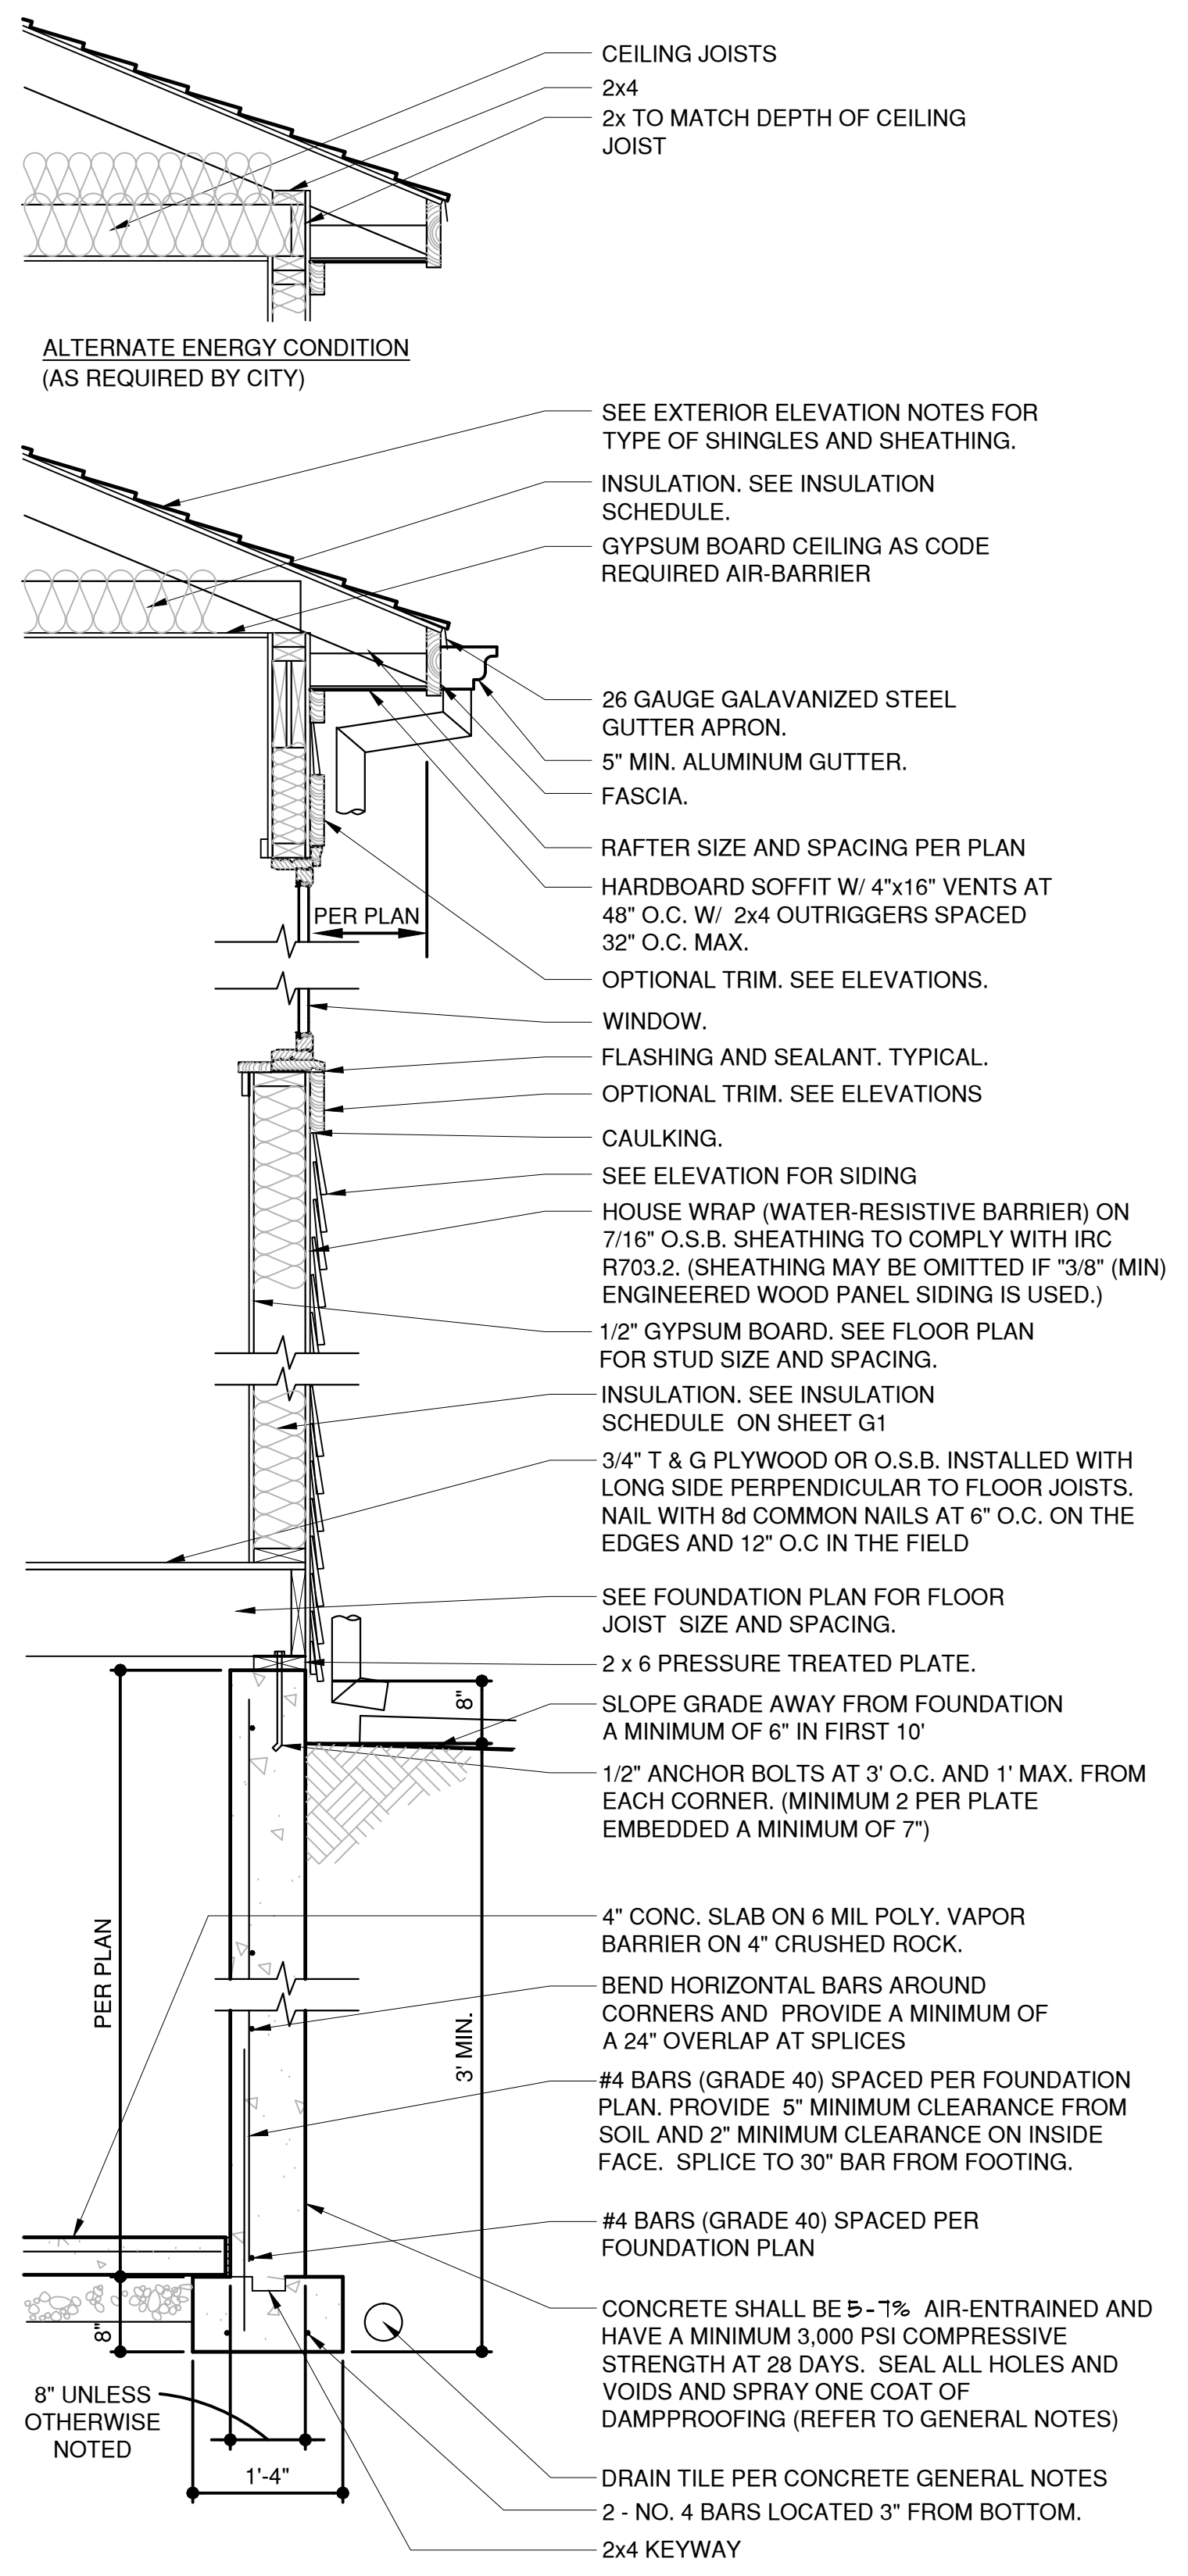
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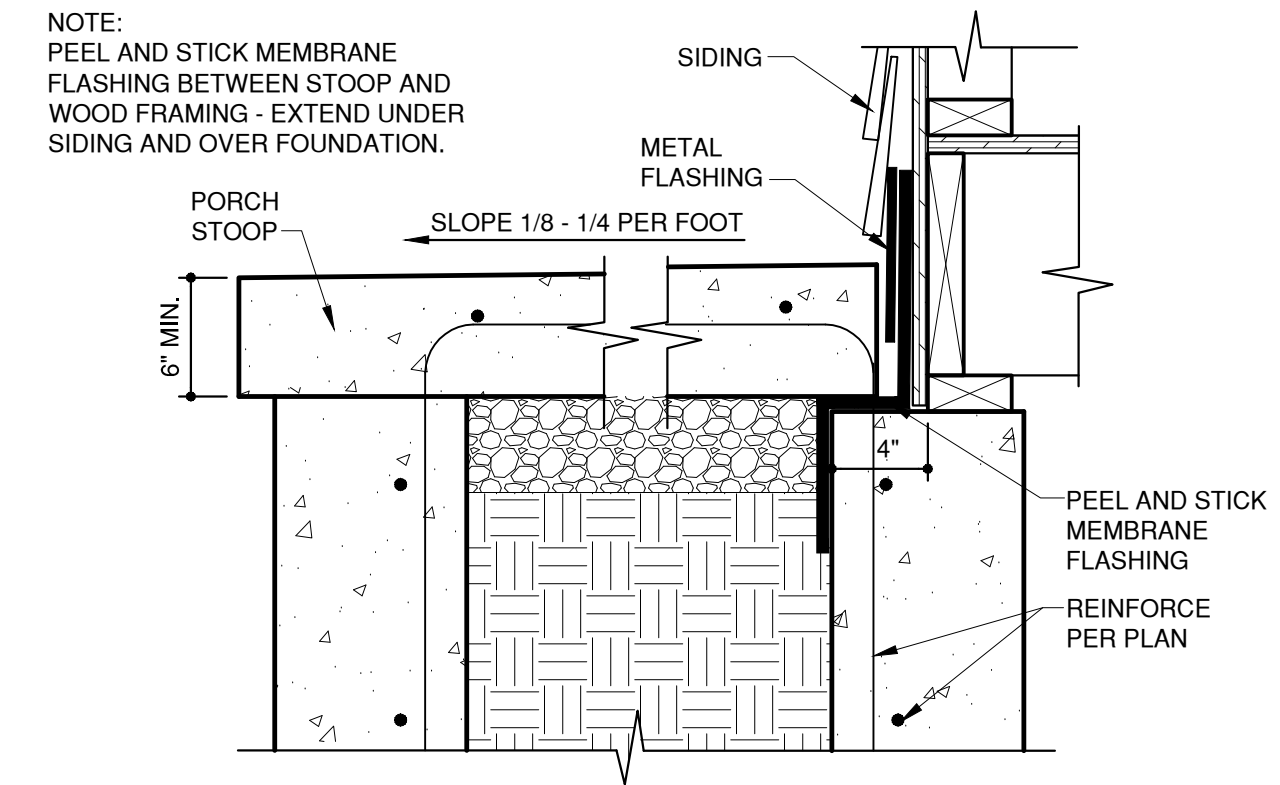
DRAWN BY: MP, TC  
 DATE: 10-26-21  
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SHEET NO. **A5**







**1 WALL SECTION**  
 3/4"=1'-0"  
 A-DTW-06062-19




**4 STOOP DETAIL**  
 1 1/2"=1'-0"  
 A-DTV-03300-35B

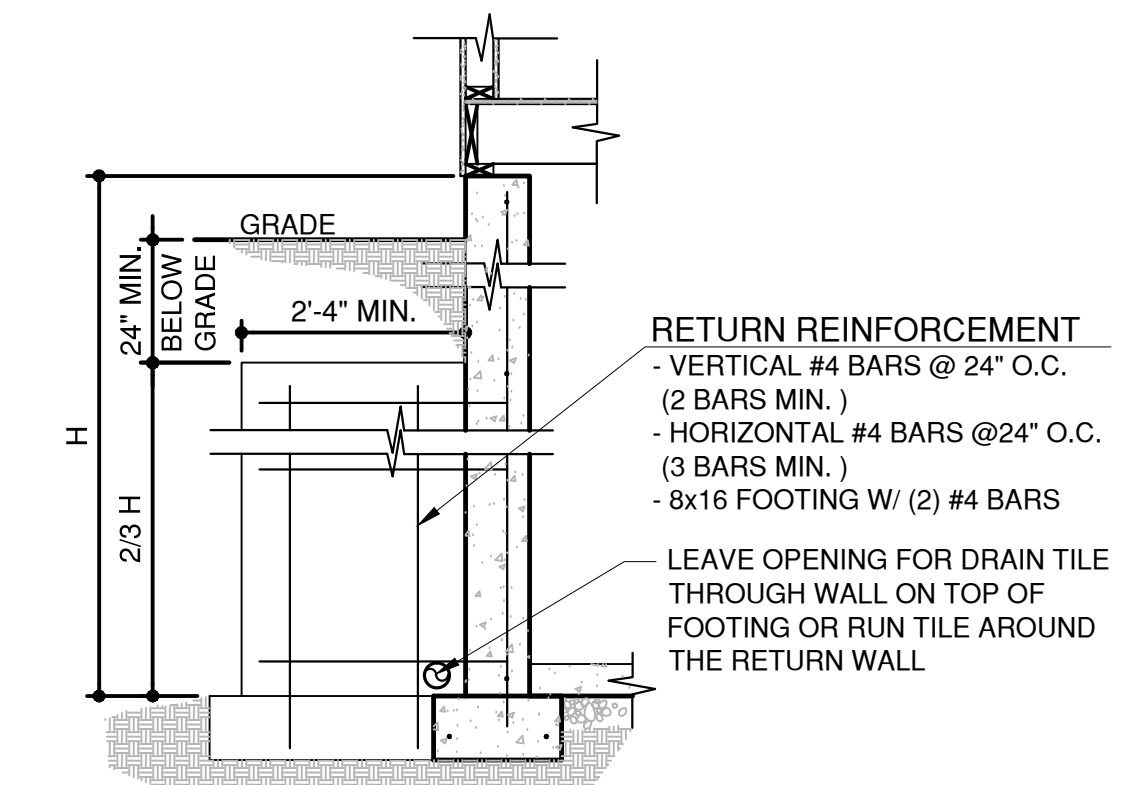

**8 RETURN WALL DETAIL**  
 1/2"=1'-0"  
 A-DTV-03300-34

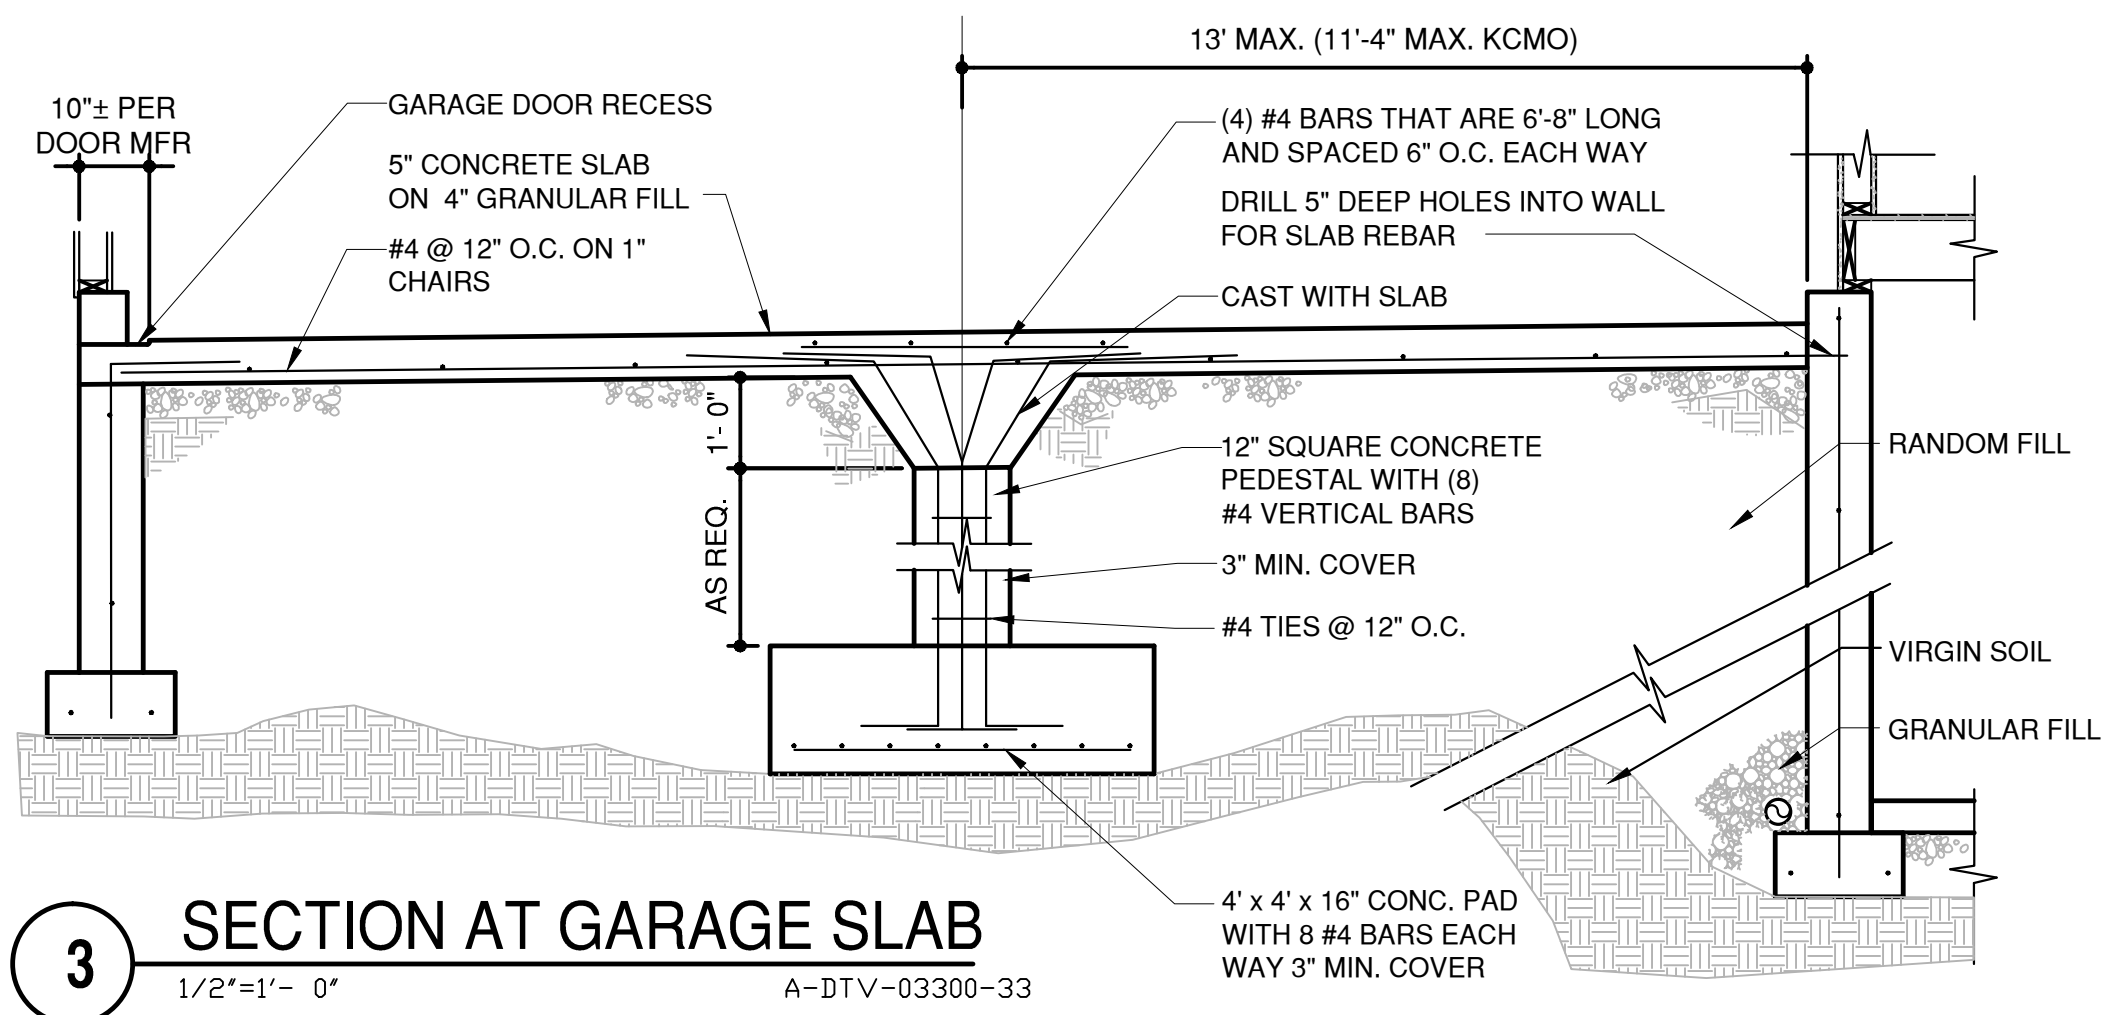

**3 SECTION AT GARAGE SLAB**  
 1/2"=1'-0"  
 A-DTV-03300-33

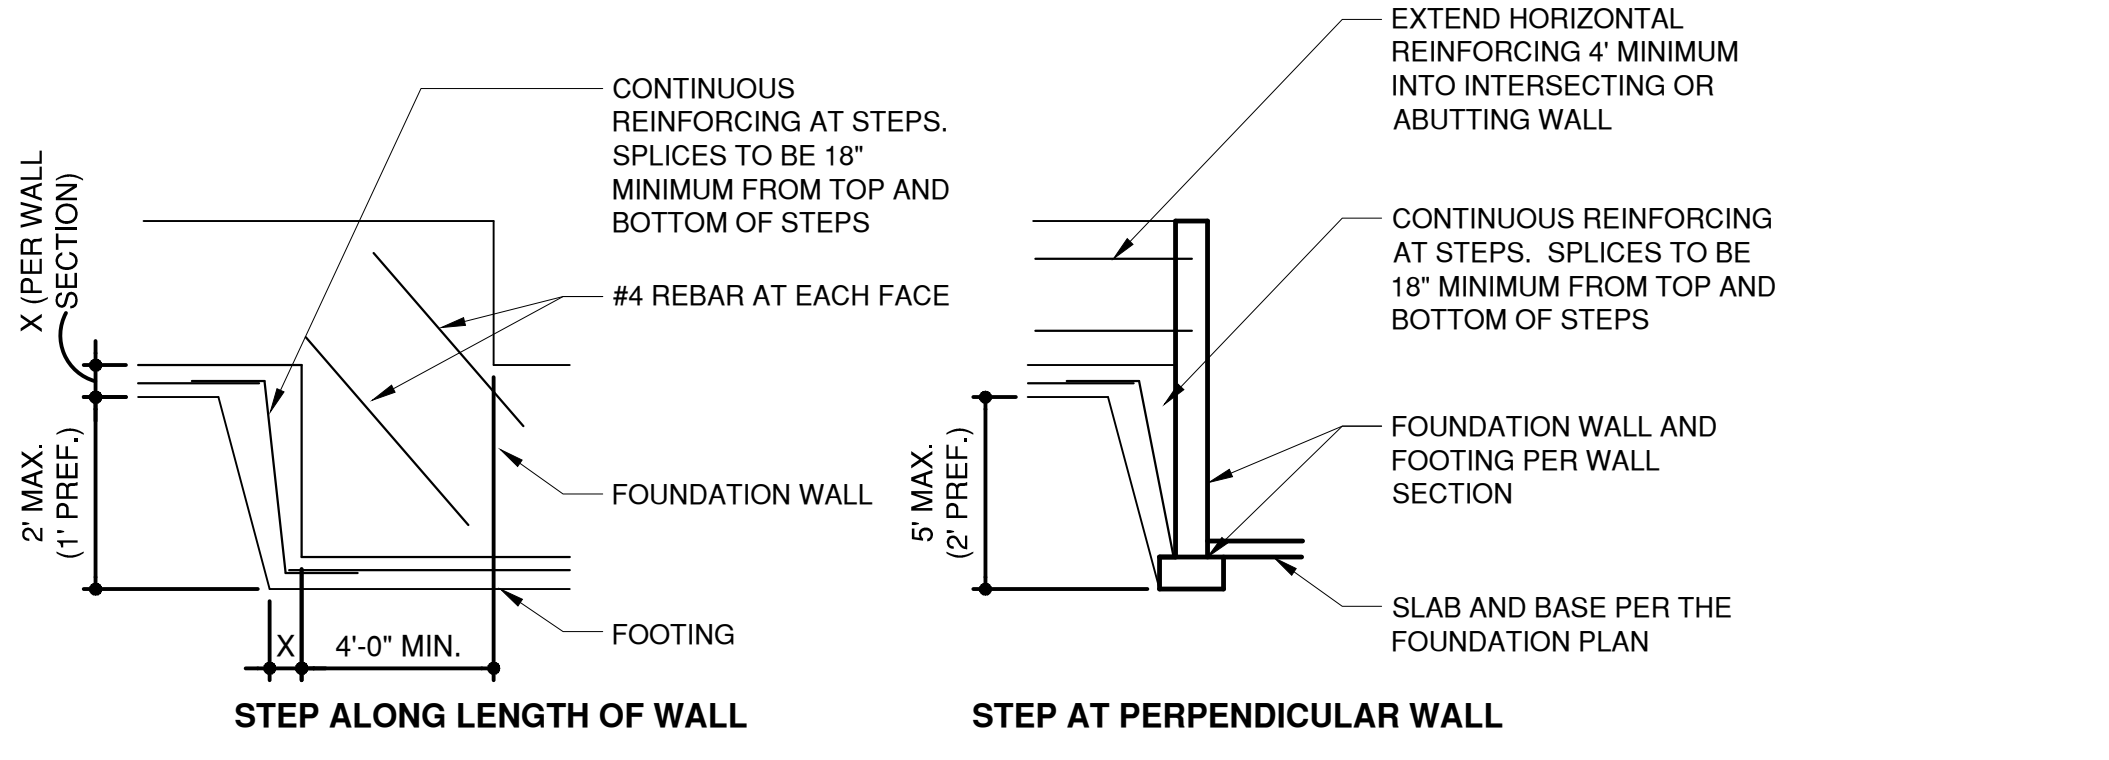

**2 ELEVATION AT FOUNDATION STEP**  
 1/4"=1'-0"  
 A-DTE-03300-01

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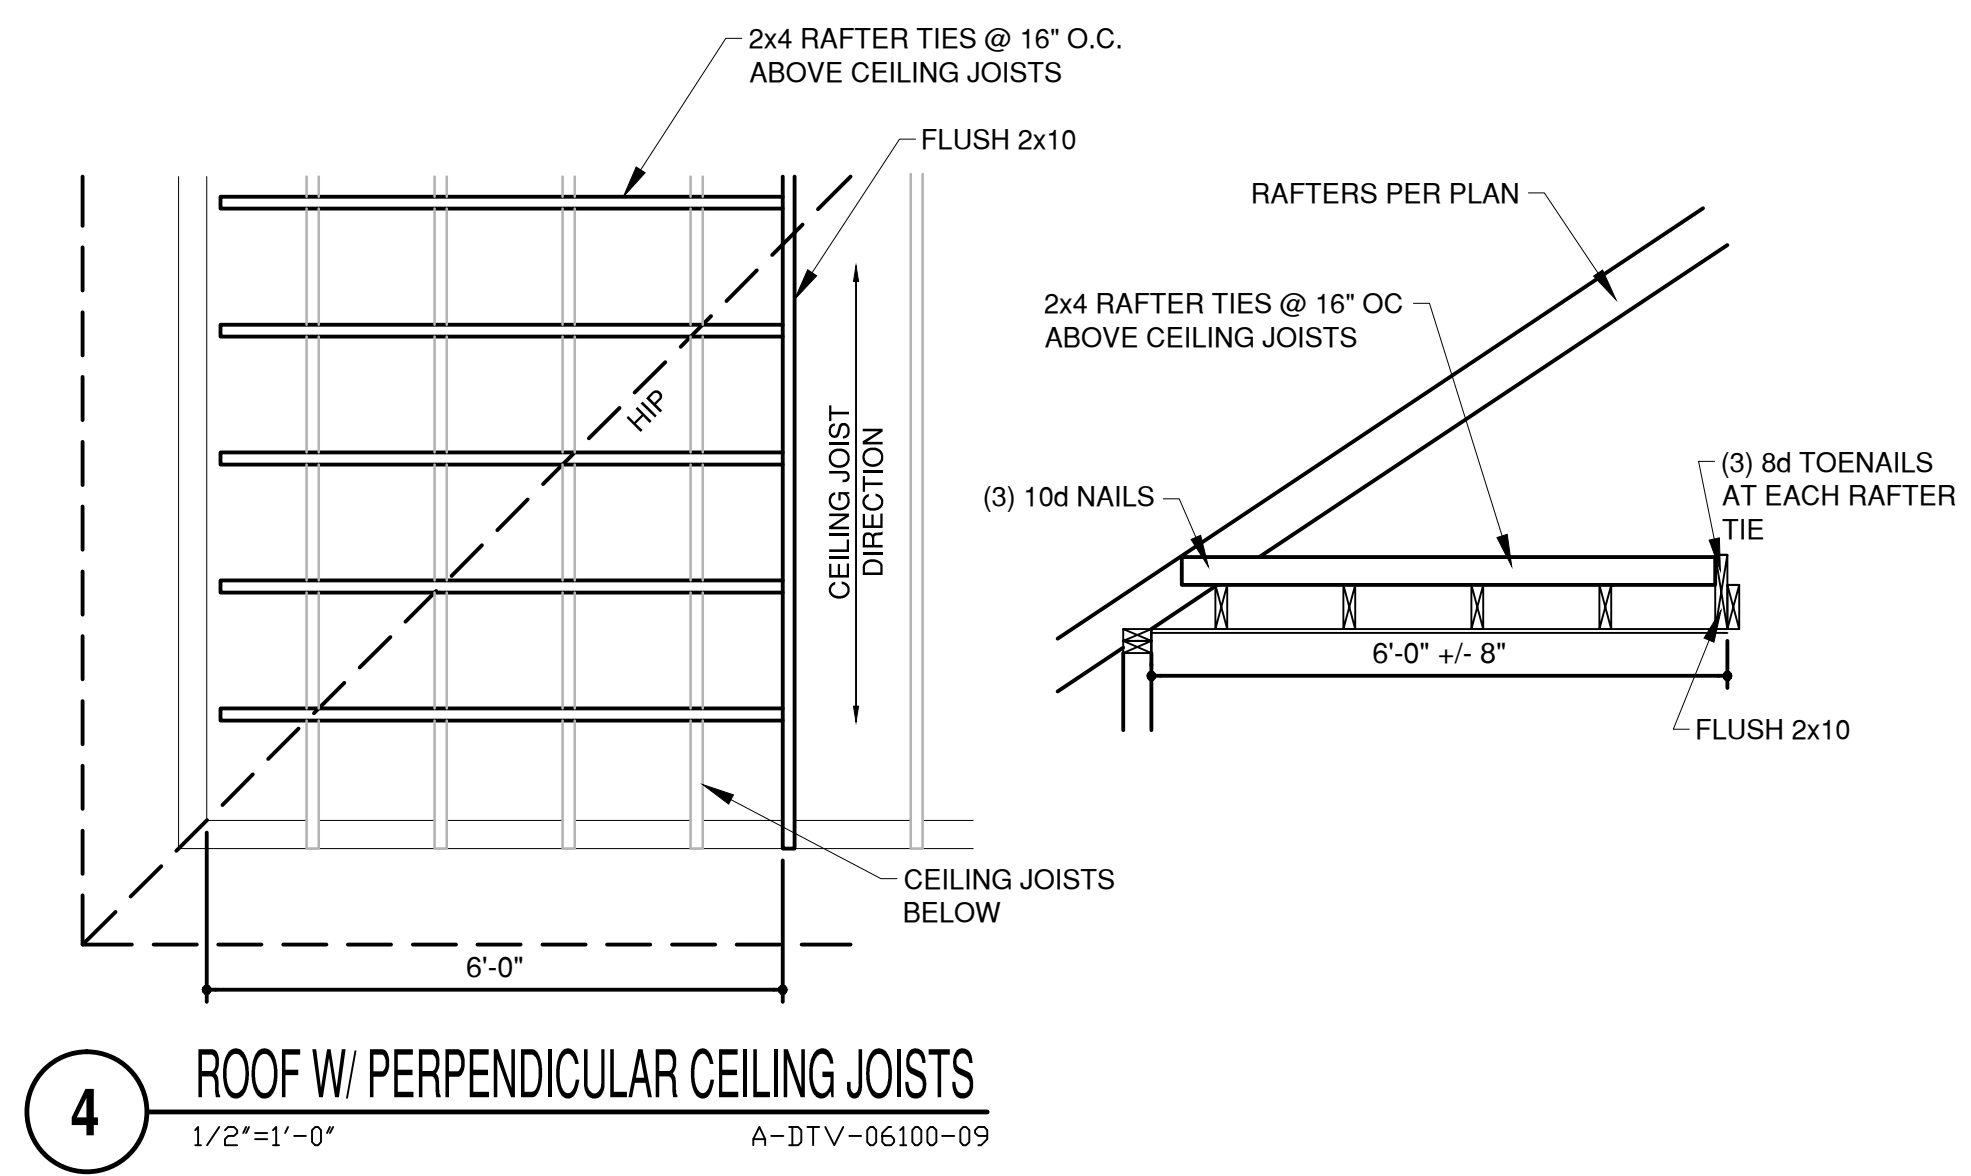
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STATE OF MISSOURI  
 DANIEL J. WEBSTER  
 REGISTERED ARCHITECT  
 NUMBER AS400  
 11/1/2021





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**G2**






**4** ROOF W/ PERPENDICULAR CEILING JOISTS  
 1/2"=1'-0" A-DTV-06100-09

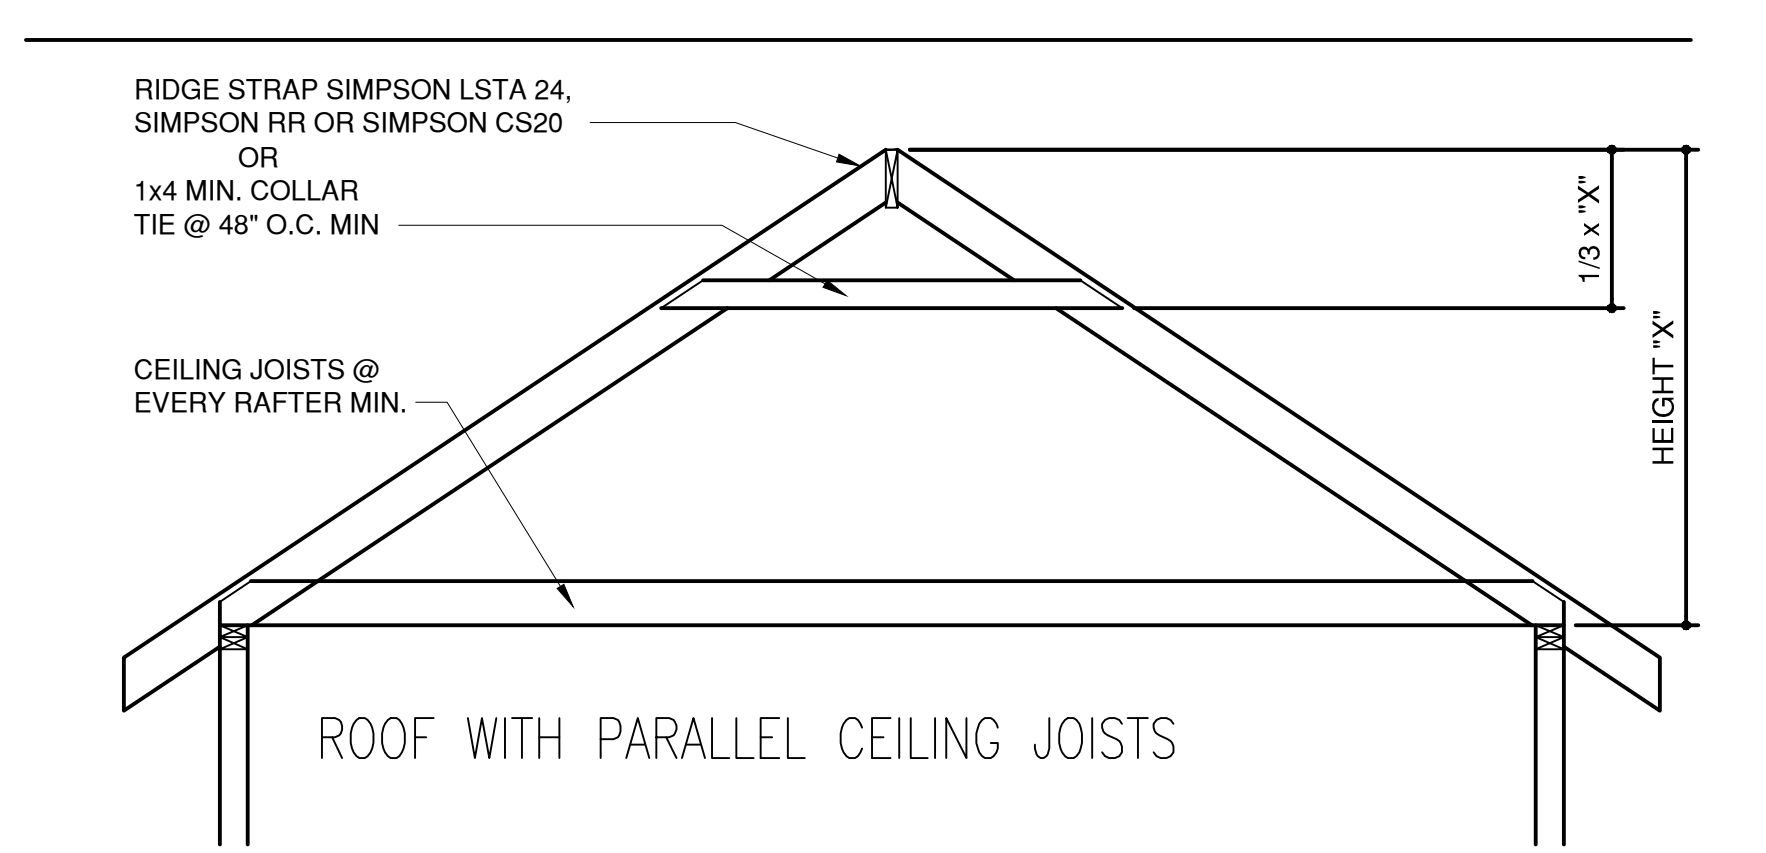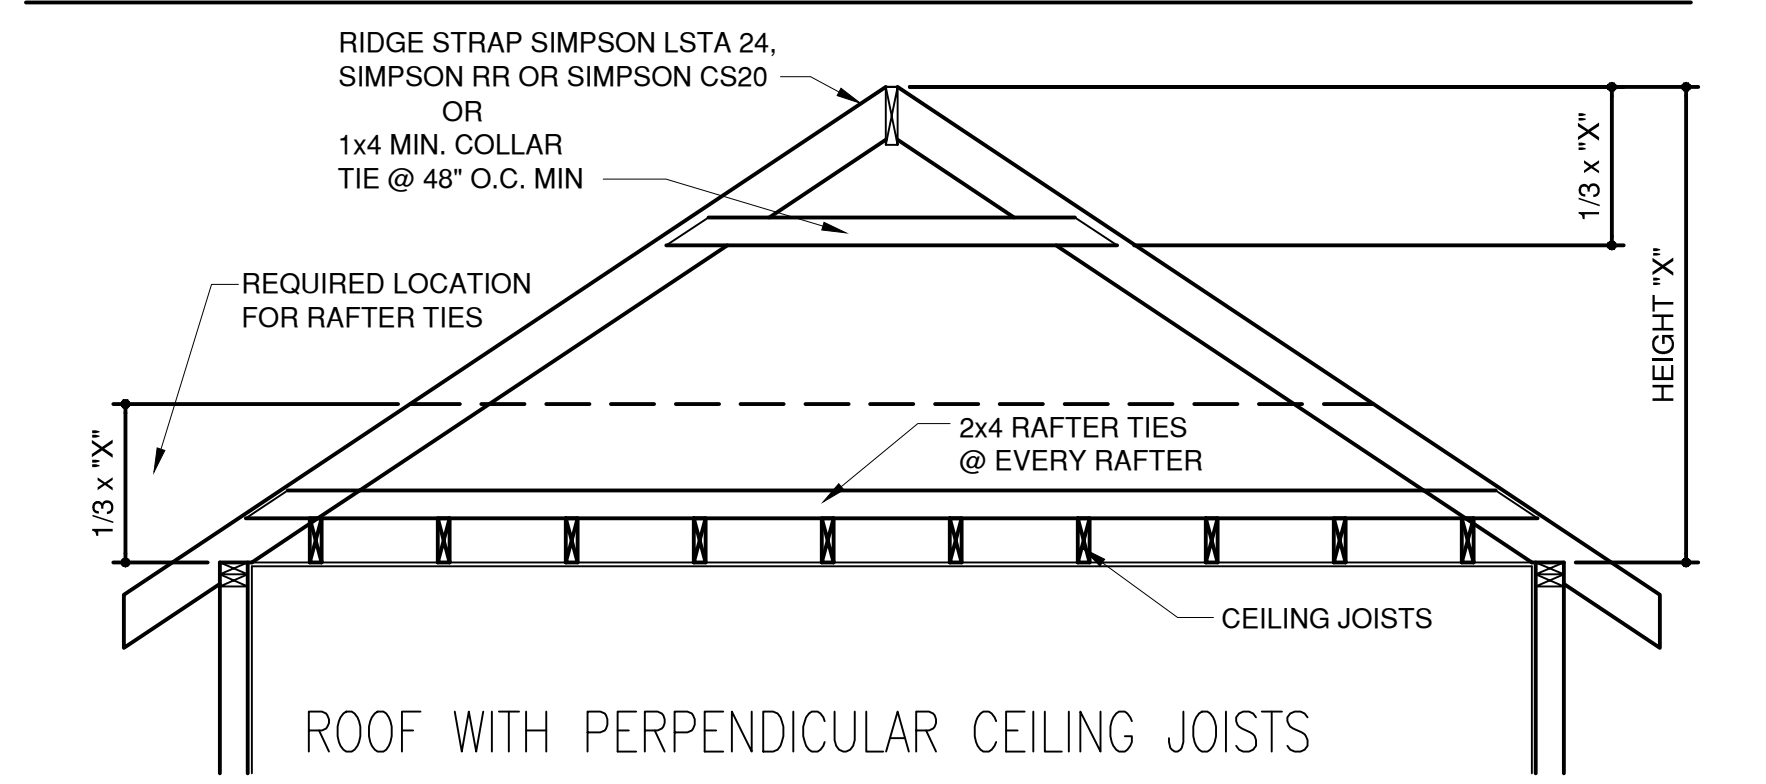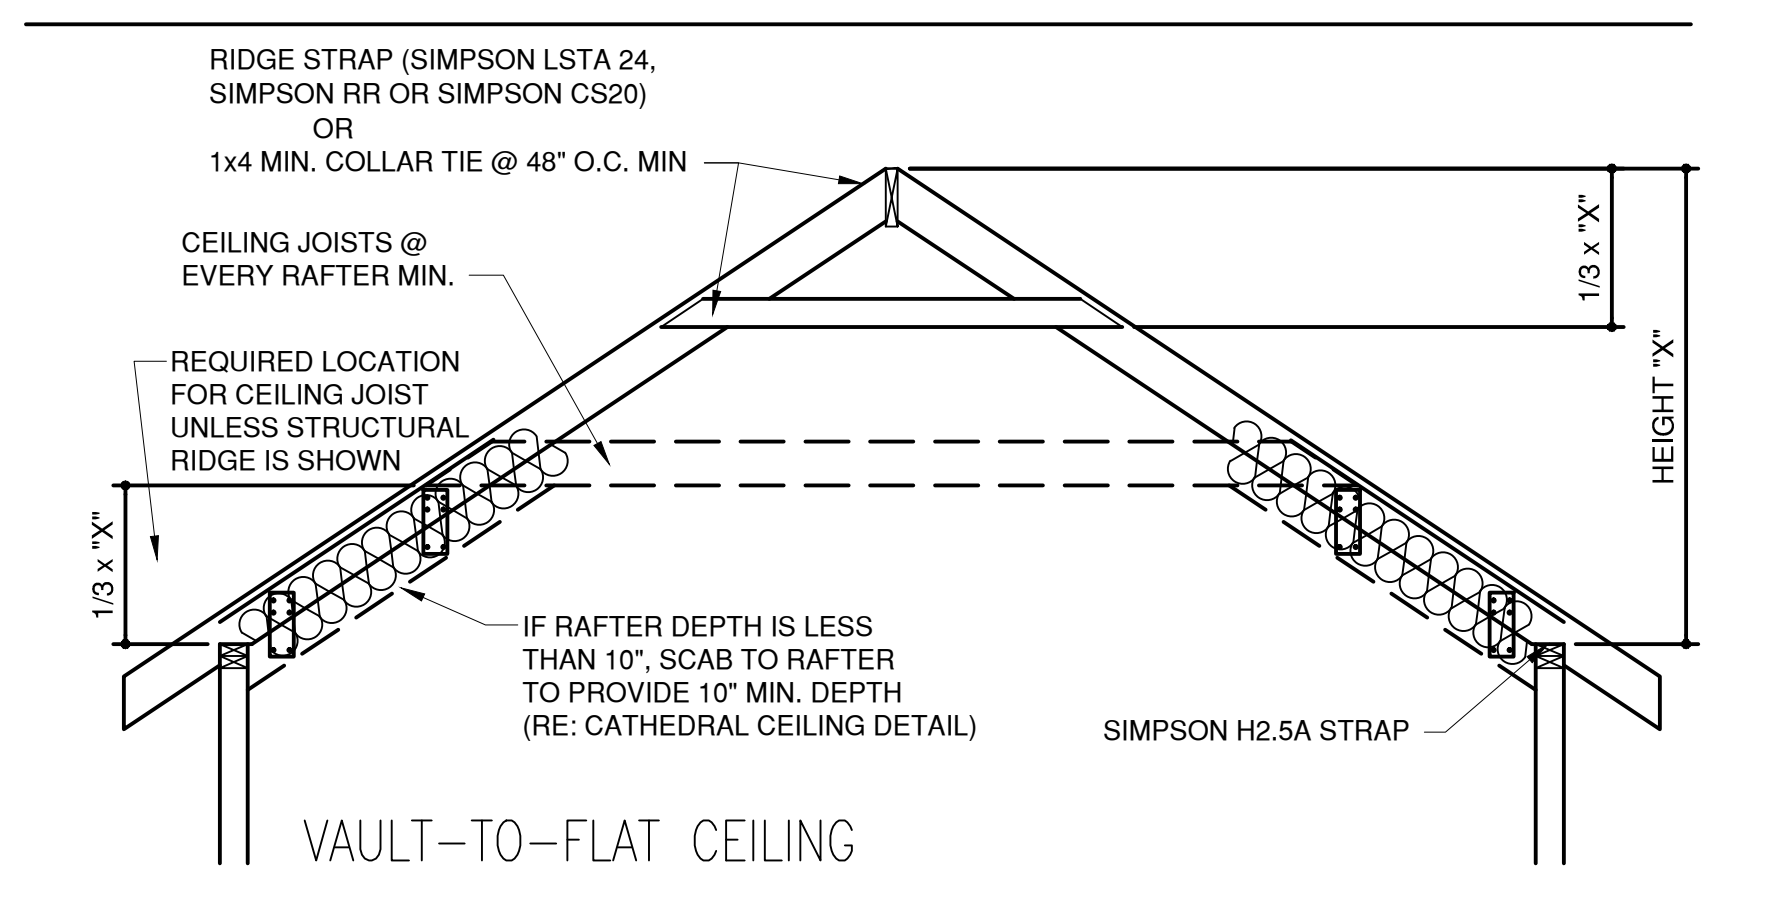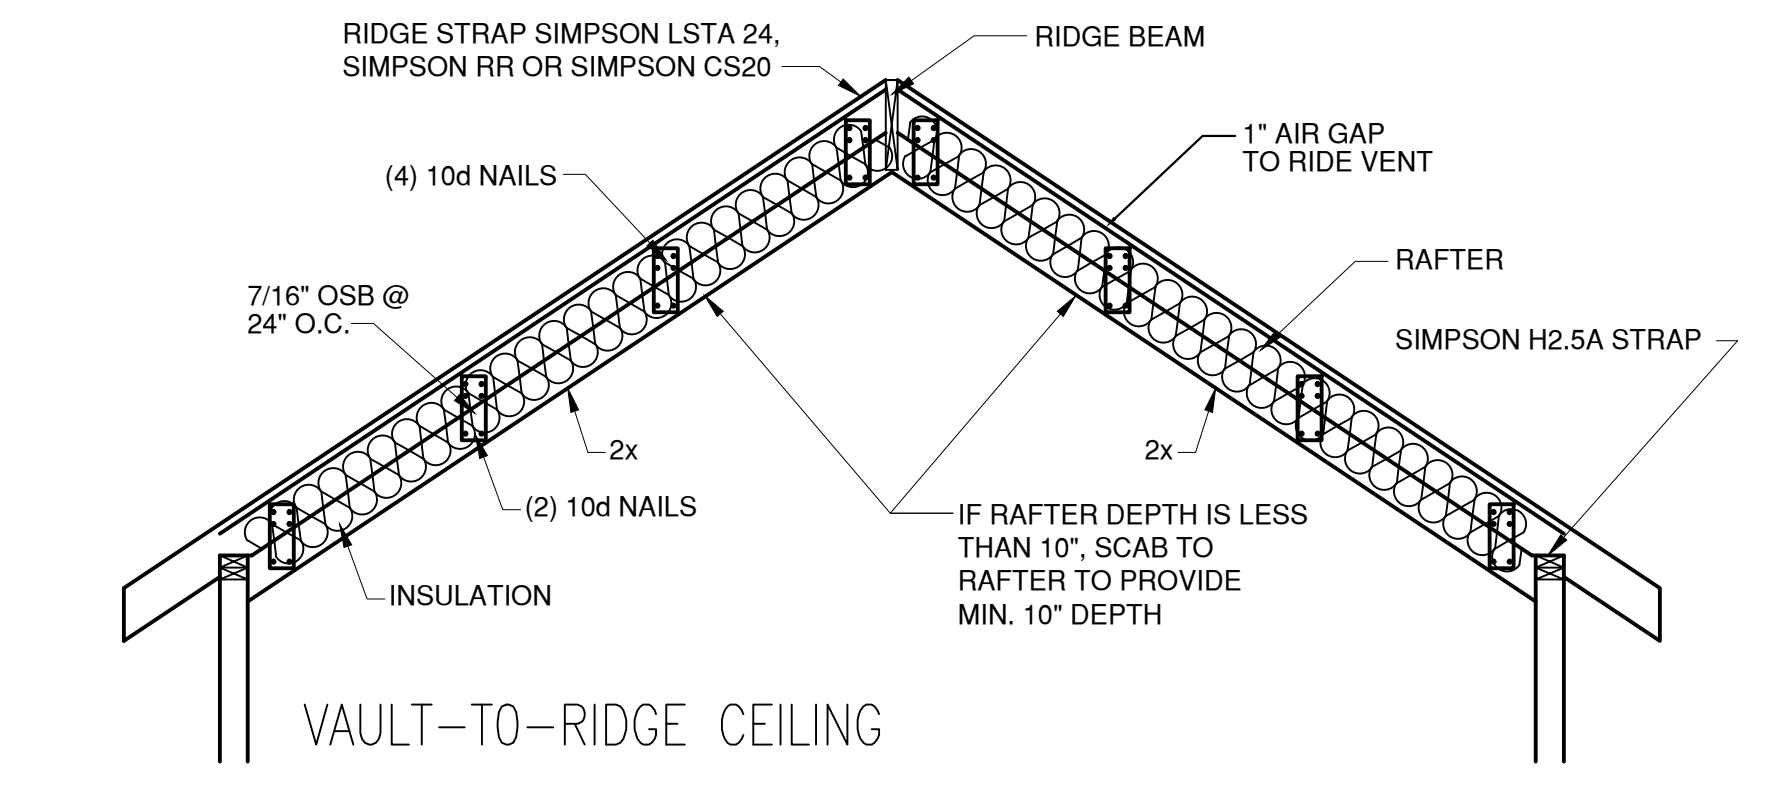


**3** ROOF FRAMING DETAIL  
 1/2"=1'-0" A-DTV-06100-04

NOTE:  
 ROOF FRAMING TO COMPLY WITH SECTIONS  
 R802, R802.3, R802.3.1 AND R802.11

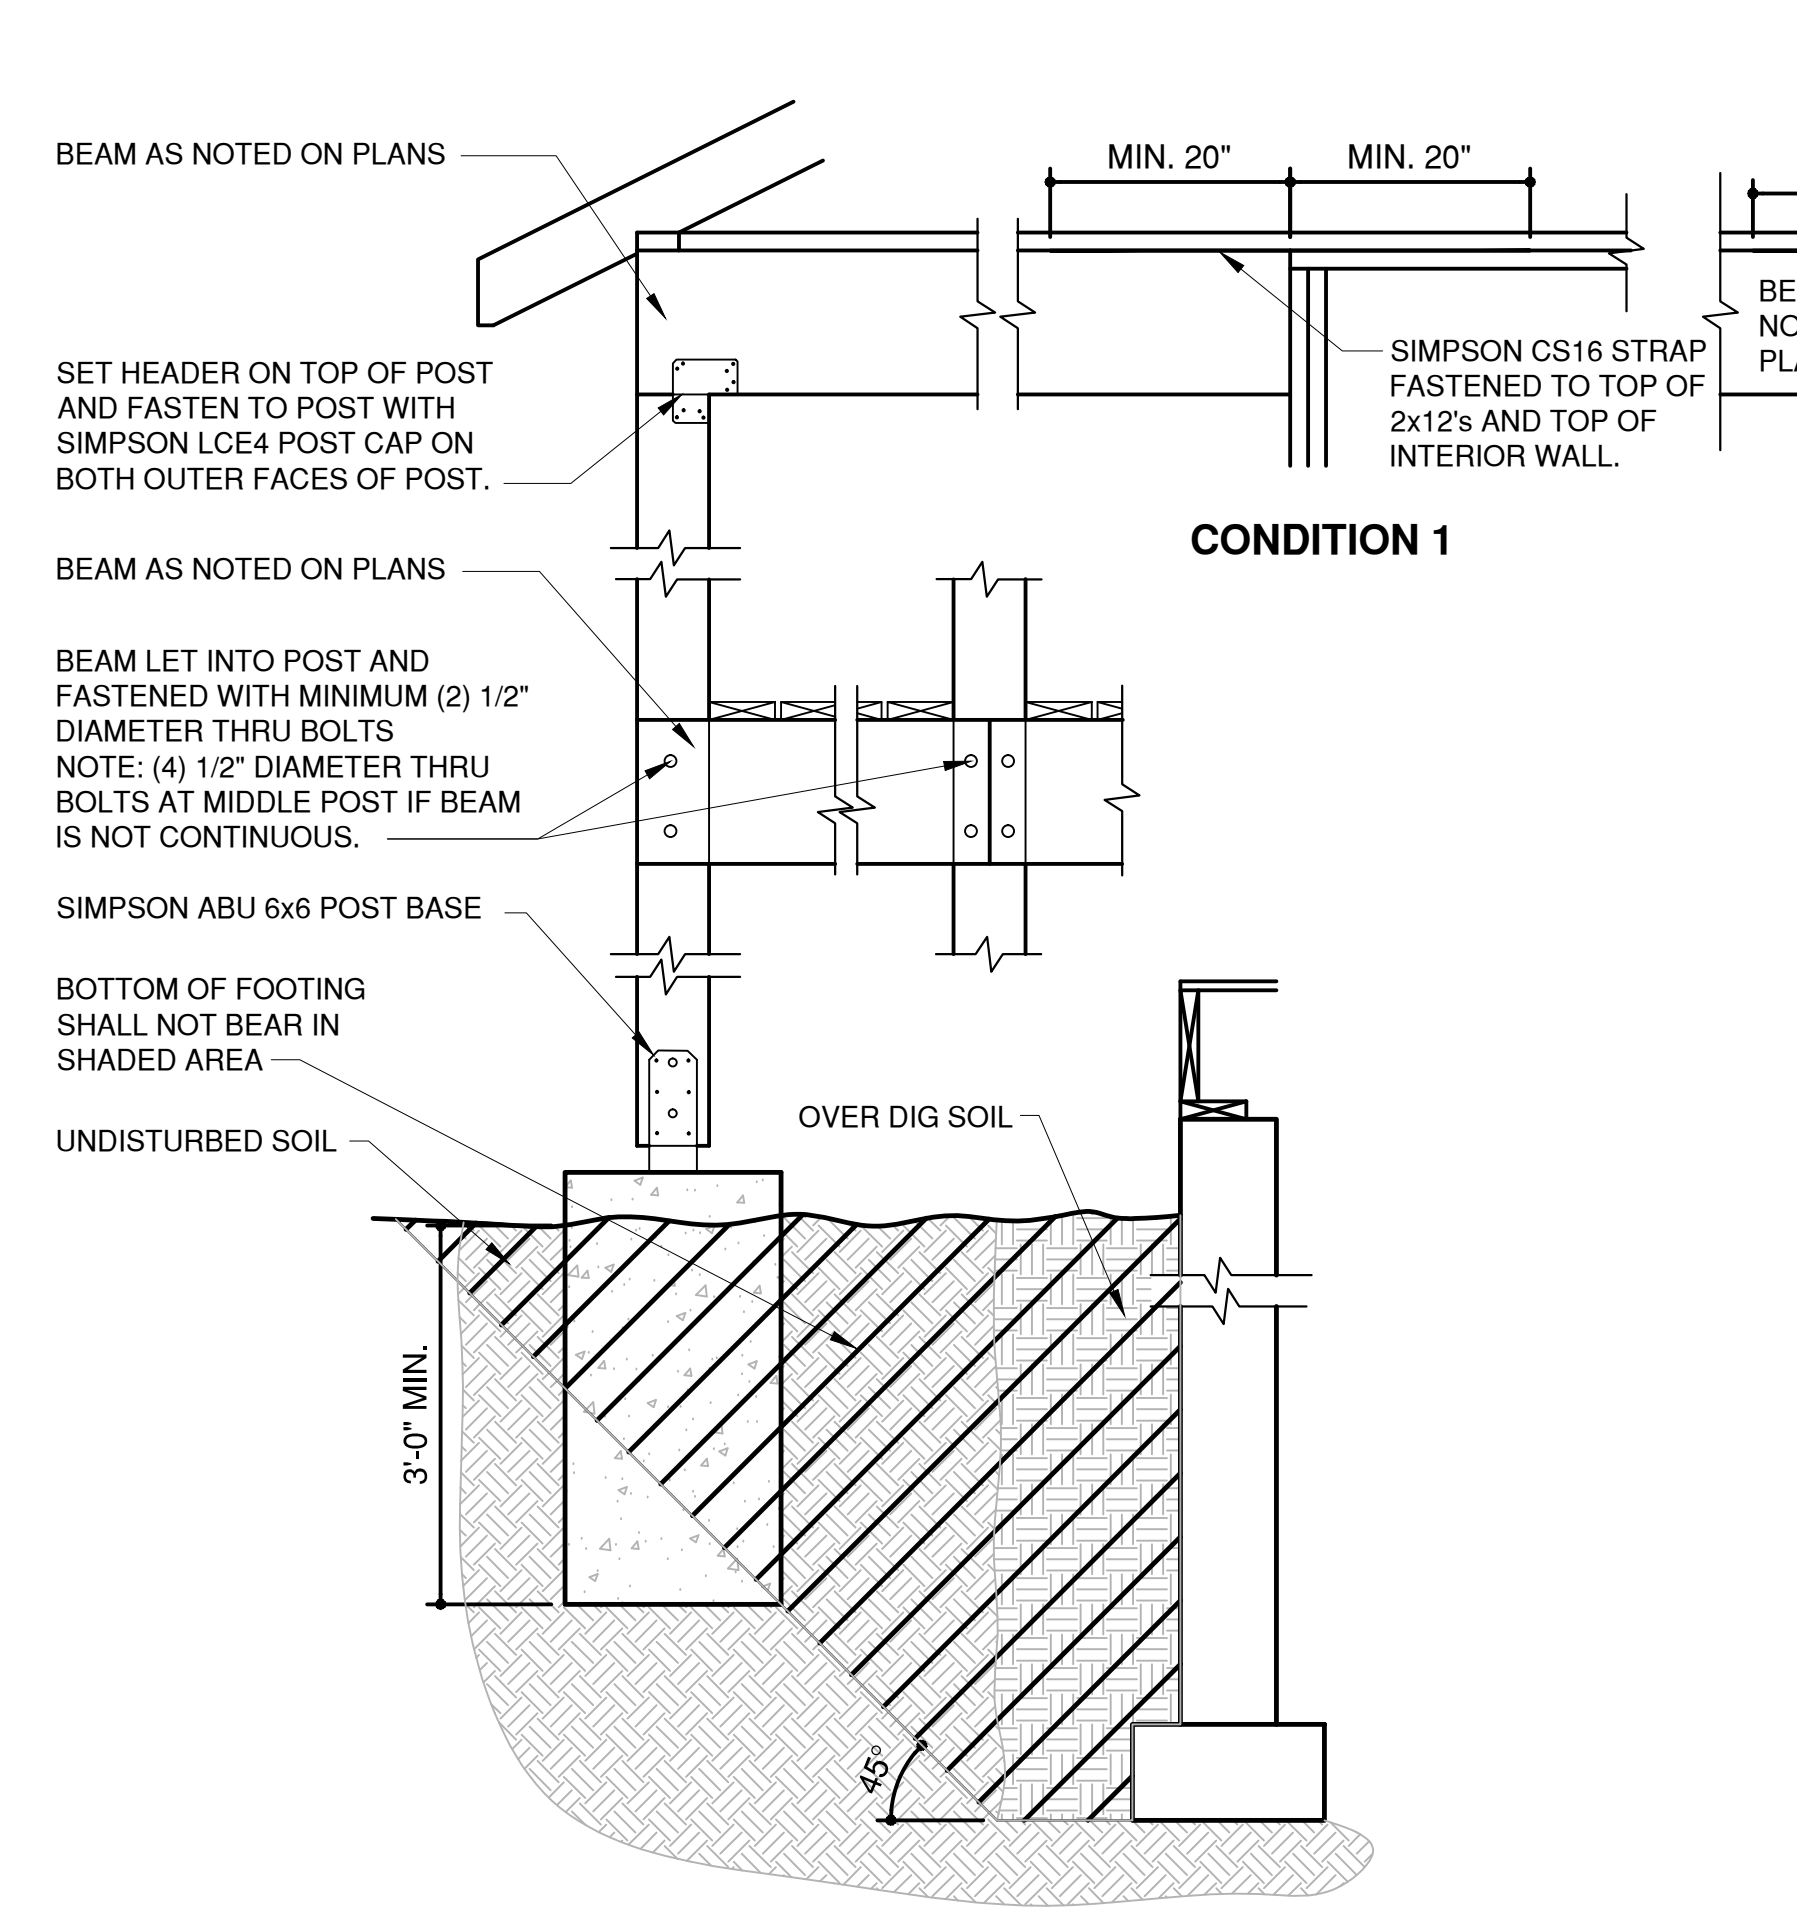

**1** COVERED PORCH DETAIL  
 3/4"=1'-0" A-DTV-06100-07

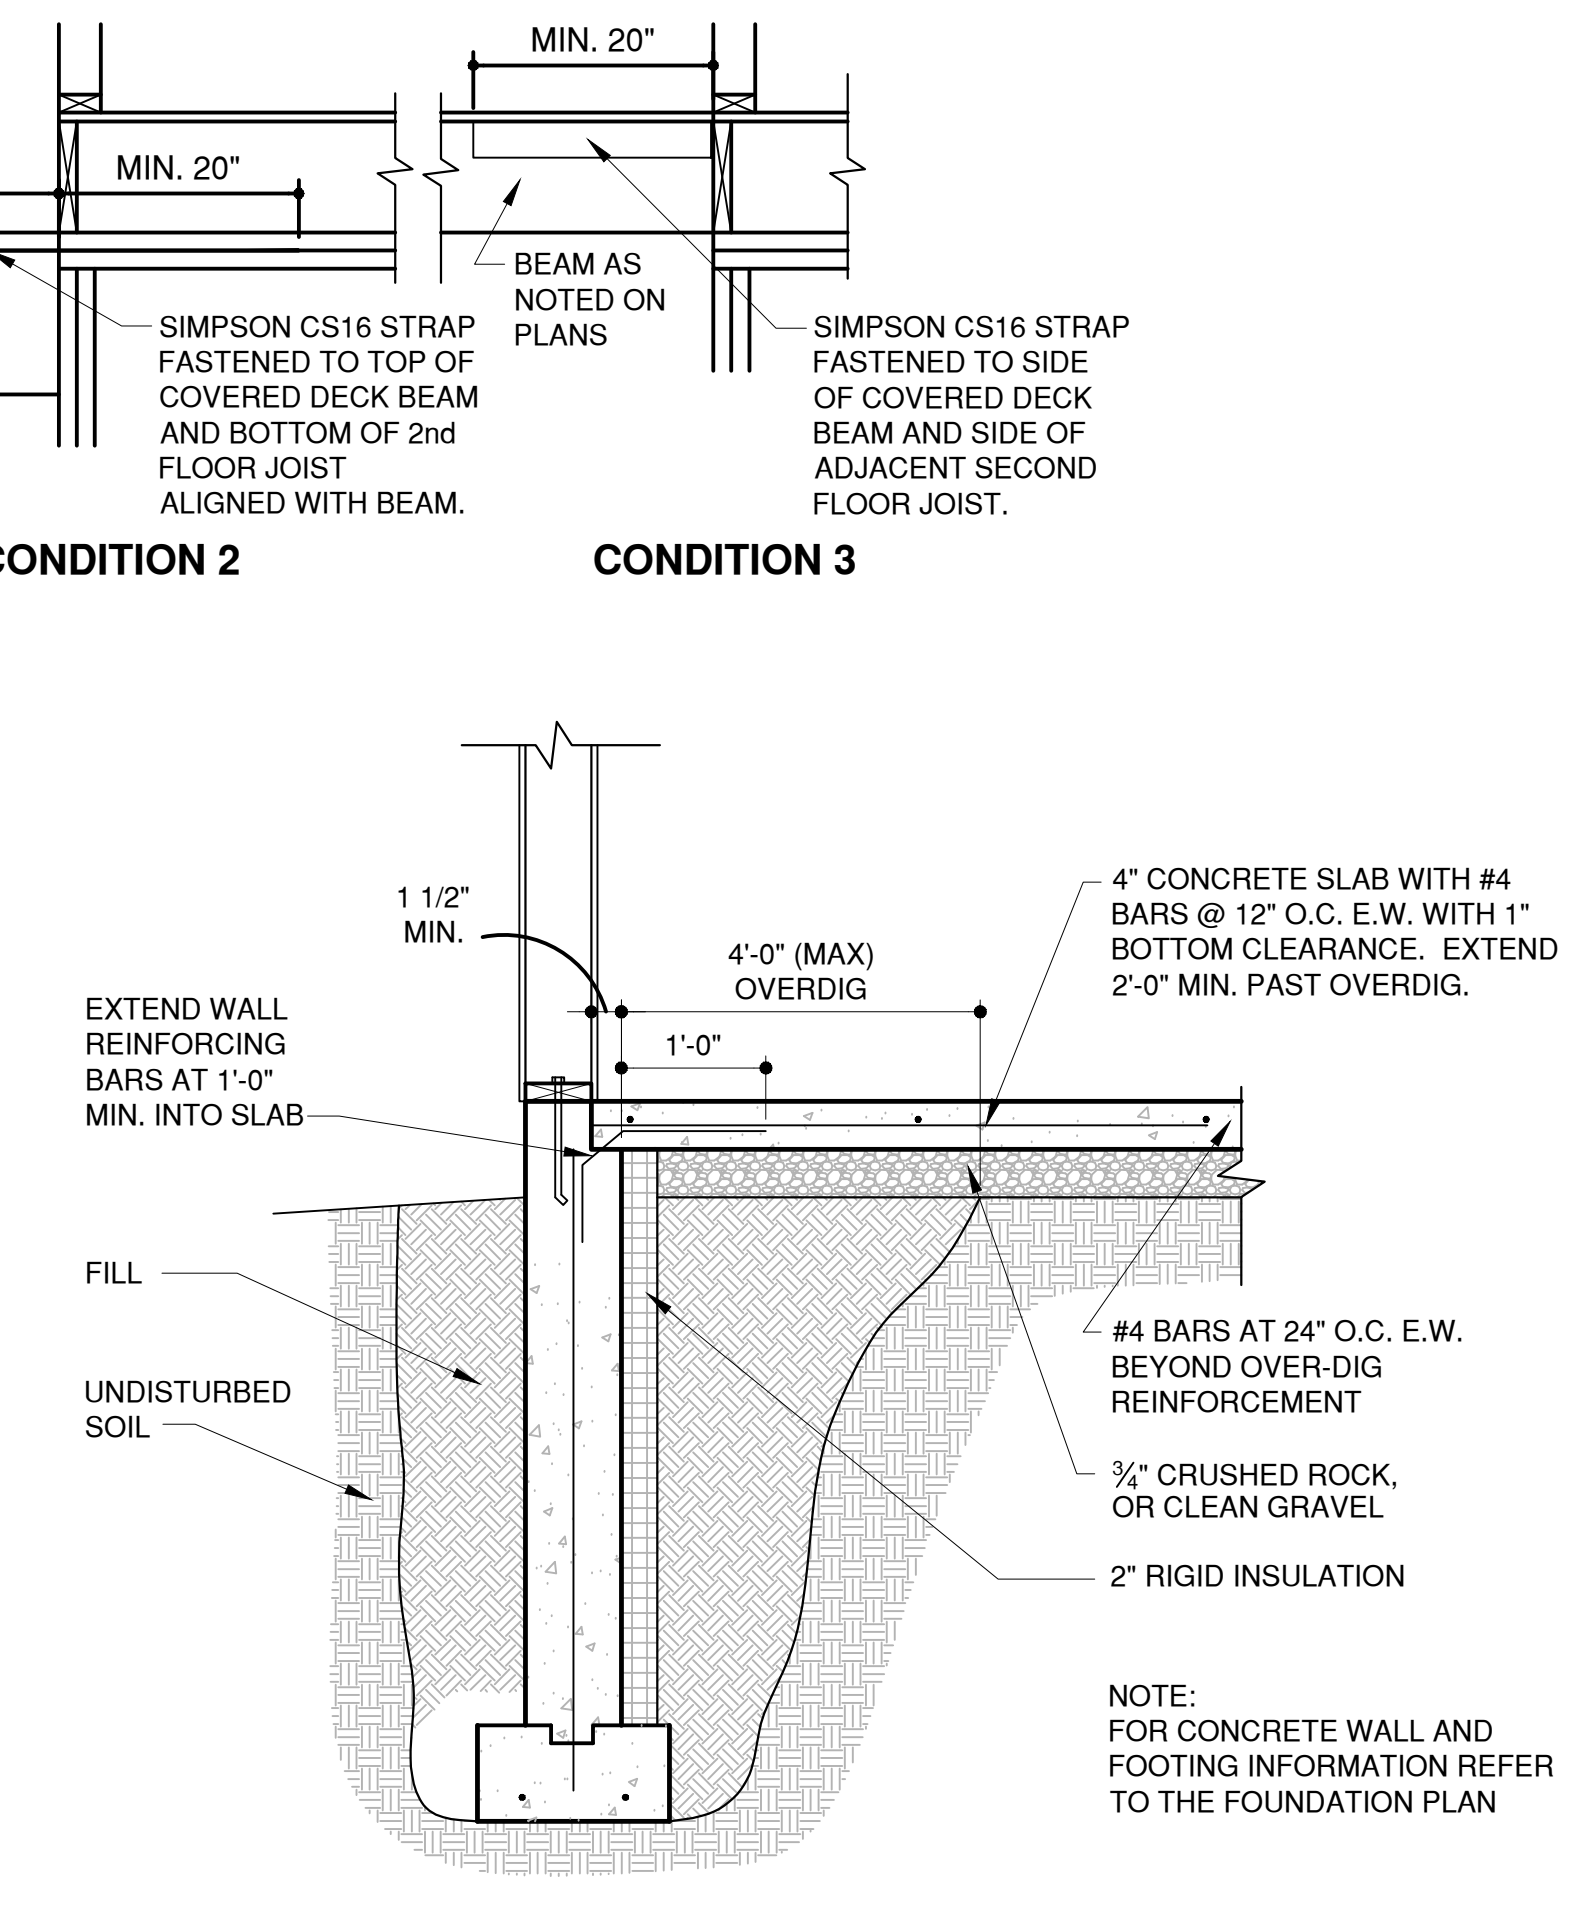

**2** WALKOUT WALL DETAIL  
 3/4"=1'-0" A-DTW-06062-29


NOTE:  
 FOR CONCRETE WALL AND FOOTING INFORMATION REFER TO THE FOUNDATION PLAN

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**G3**

TABLE R602.10.6.4  
 TENSION STRAP CAPACITY REQUIRED FOR RESISTING WIND PRESSURES  
 PERPENDICULAR TO METHOD PFH, PFG, AND CS-PF BRACED WALL PANELS

2-9-21




MINIMUM WALL STUD FRAMING NORMAL SIZE AND GRADE	MAXIMUM PONY WALL HEIGHT (feet)	MAXIMUM TOTAL WALL HEIGHT (feet)	MAXIMUM OPENING WIDTH (feet)	TENSION STRAP CAPACITY REQUIRED (pounds) a,b					
				ULTIMATE DESIGN WIND SPEED (mph)					
				EXPOSURE B			EXPOSURE C		
2 x 4 NO. 2 GRADE	0	10	18	1,000	1,000	1,000	1,000	1,000	1,050
			9	1,000	1,000	1,000	1,000	1,000	1,750
			16	1,000	1,025	2,050	2,075	2,500	3,950
			18	1,200	1,275	2,375	2,400	2,850	DR
			9	1,000	1,000	1,475	1,500	1,875	3,125
			16	1,775	2,175	3,525	3,550	4,125	DR
	2	10	9	1,150	1,500	2,650	2,675	3,175	DR
			16	2,875	3,375	DR	DR	DR	DR
			18	3,425	3,975	DR	DR	DR	DR
			9	2,275	2,750	DR	DR	DR	DR
			12	3,225	3,775	DR	DR	DR	DR
			18	1,000	1,000	1,700	1,700	2,025	3,050
2 x 6 STUD GRADE	2	12	9	1,825	2,150	3,225	3,225	3,675	DR
			16	2,200	2,550	3,725	3,750	DR	DR
			18	2,200	2,550	3,725	3,750	DR	DR
			9	1,450	1,750	2,700	2,725	3,125	DR
			16	2,050	2,400	DR	DR	DR	DR
			18	3,50	3,800	DR	DR	DR	DR

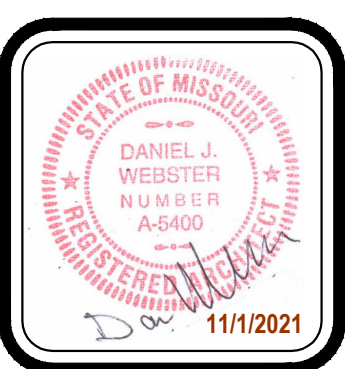a. DR = DESIGN REQUIRED  
 b. STRAP SHALL BE INSTALLED IN ACCORDANCE WITH MANUFACTURER'S RECOMMENDATIONS.


BRACED WALL SCHEDULE 2-9-21

METHOD NUMBER	DESCRIPTION	MINIMUM LENGTH	FASTENERS
LIB	LET-IN BRACING: METAL STRAPS TO FORM "X" OR "V" INSTALLED PER MANUFACTURER (SIMPSON: WB126C, TWB12, WB143C) (USP: RWB114, WBT12)	AS REQUIRED TO ALLOW BRACE TO BE CONTINUOUS FROM PLATE TO PLATE AND AT AN ANGLE BETWEEN 45° TO 60° FROM HORIZONTAL	PER MANUFACTURER'S REQUIREMENTS
WSP	WOOD STRUCTURAL PANEL- 3/8" THICK (MIN.) FOR STUDS AT 16" O.C. (APA EXP. I-PLYWOOD/O.S.B./ETC.)	MIN. 48"	6d COMMON NAILS, 6" O.C. AT EDGES AND 12" O.C. AT INTERMEDIATES
CS-WSP	CONTINUOUS SHEATHING- WOOD STRUCTURAL PANEL: 3/8" THICK (MIN.) (APA EXP. I-PLYWOOD/O.S.B.)	CONTINUOUS ON ALL EXTERIOR WALLS	6d COMMON NAILS, 8d COMMON NAILS - 6" O.C. AT EDGES AND 12" O.C. AT INTERMEDIATES
GB	GYPSUM BOARD: 1/2" THICK MIN.	96" IF GYP. BOARD 1 SIDE 48" IF GYP. BOARD 2 SIDES (STUDS AT 16" O.C. MAX. FOR 48" LONG PANELS)	6d NAILS OR 1-1/4" SCREWS (TYPE W OR S) - 7" O.C. AT EDGES AND 7" O.C. AT INTERMEDIATES (CAN SUBSTITUTE COOLER NAILS)
PFH/PFG	PORTAL FRAME GARAGE: WITH HOLD-DOWNS PFG MIN. 7/16" PFH MIN. 3/8"	SEE DETAIL 1/G3 FOR MIN. WALL LENGTH	PER DETAIL 1/G3
CS-PF	CONTINUOUS SHEATHING- PORTAL FRAME	SEE DETAIL 1/G3 FOR MIN. WALL LENGTH	PER DETAIL 1/G3

NOTES:  
 A. SEE [XXX] ON BRACED WALL PLAN FOR BRACED WALL METHOD.

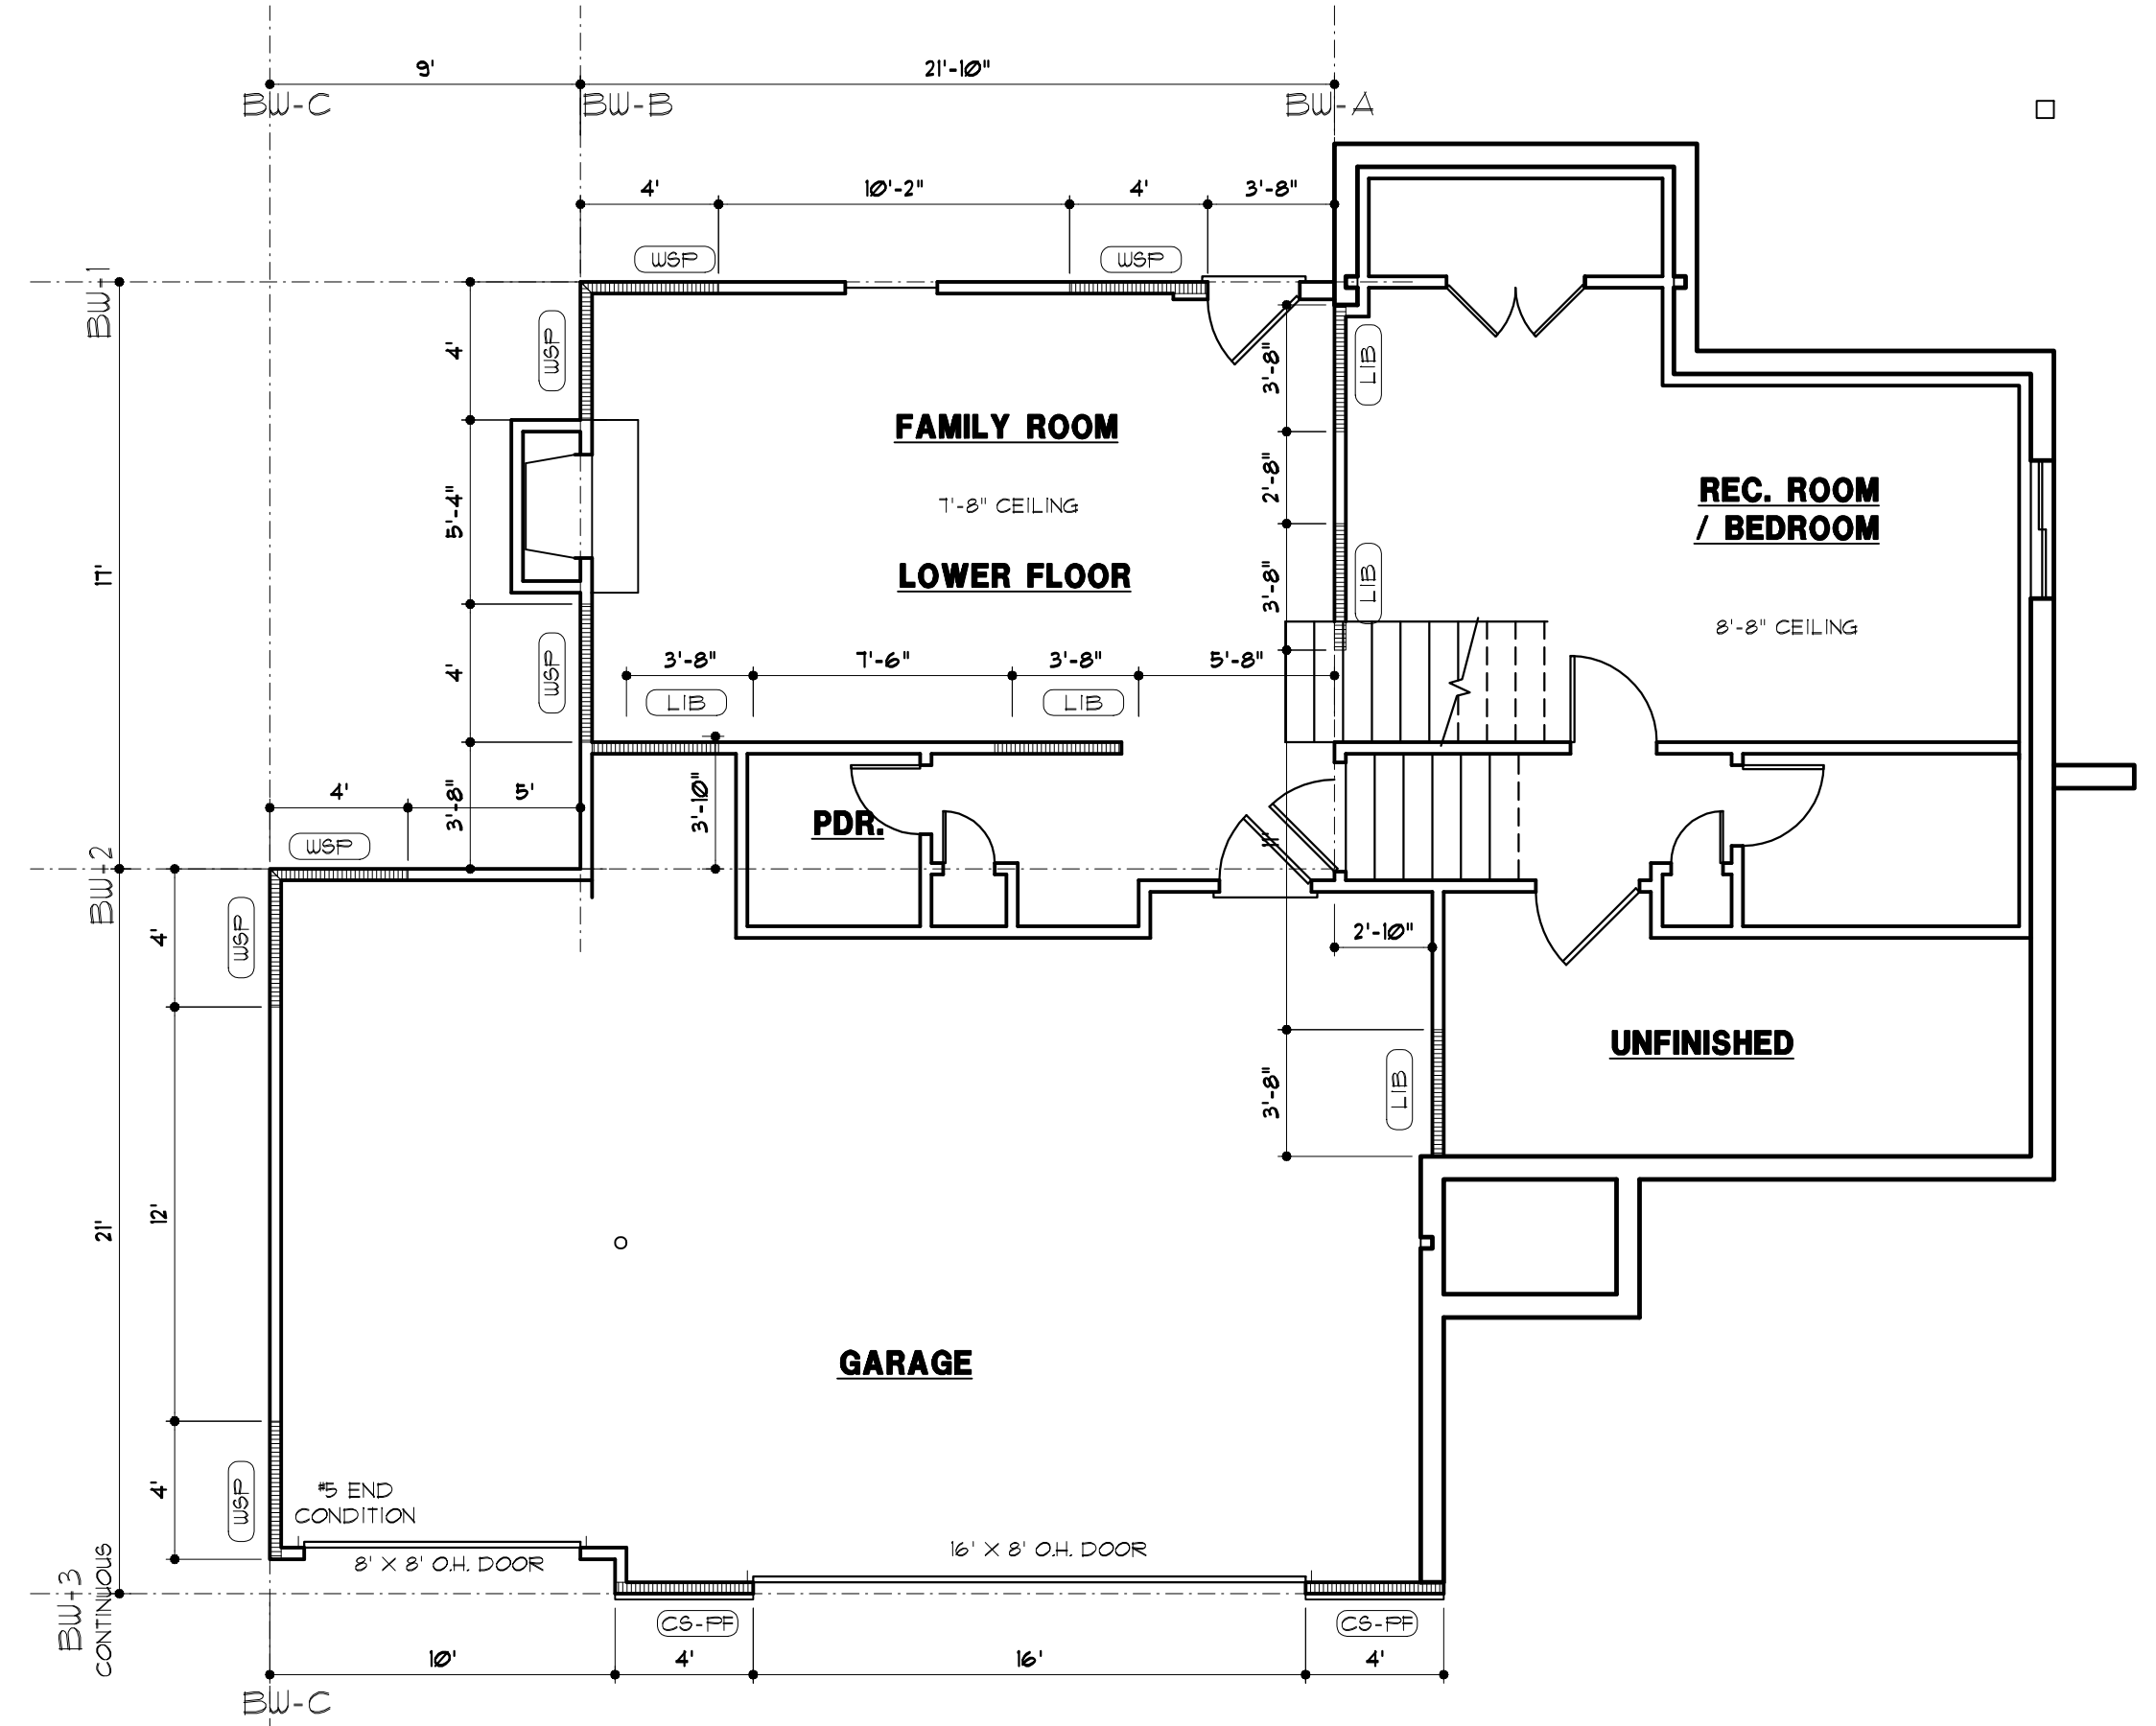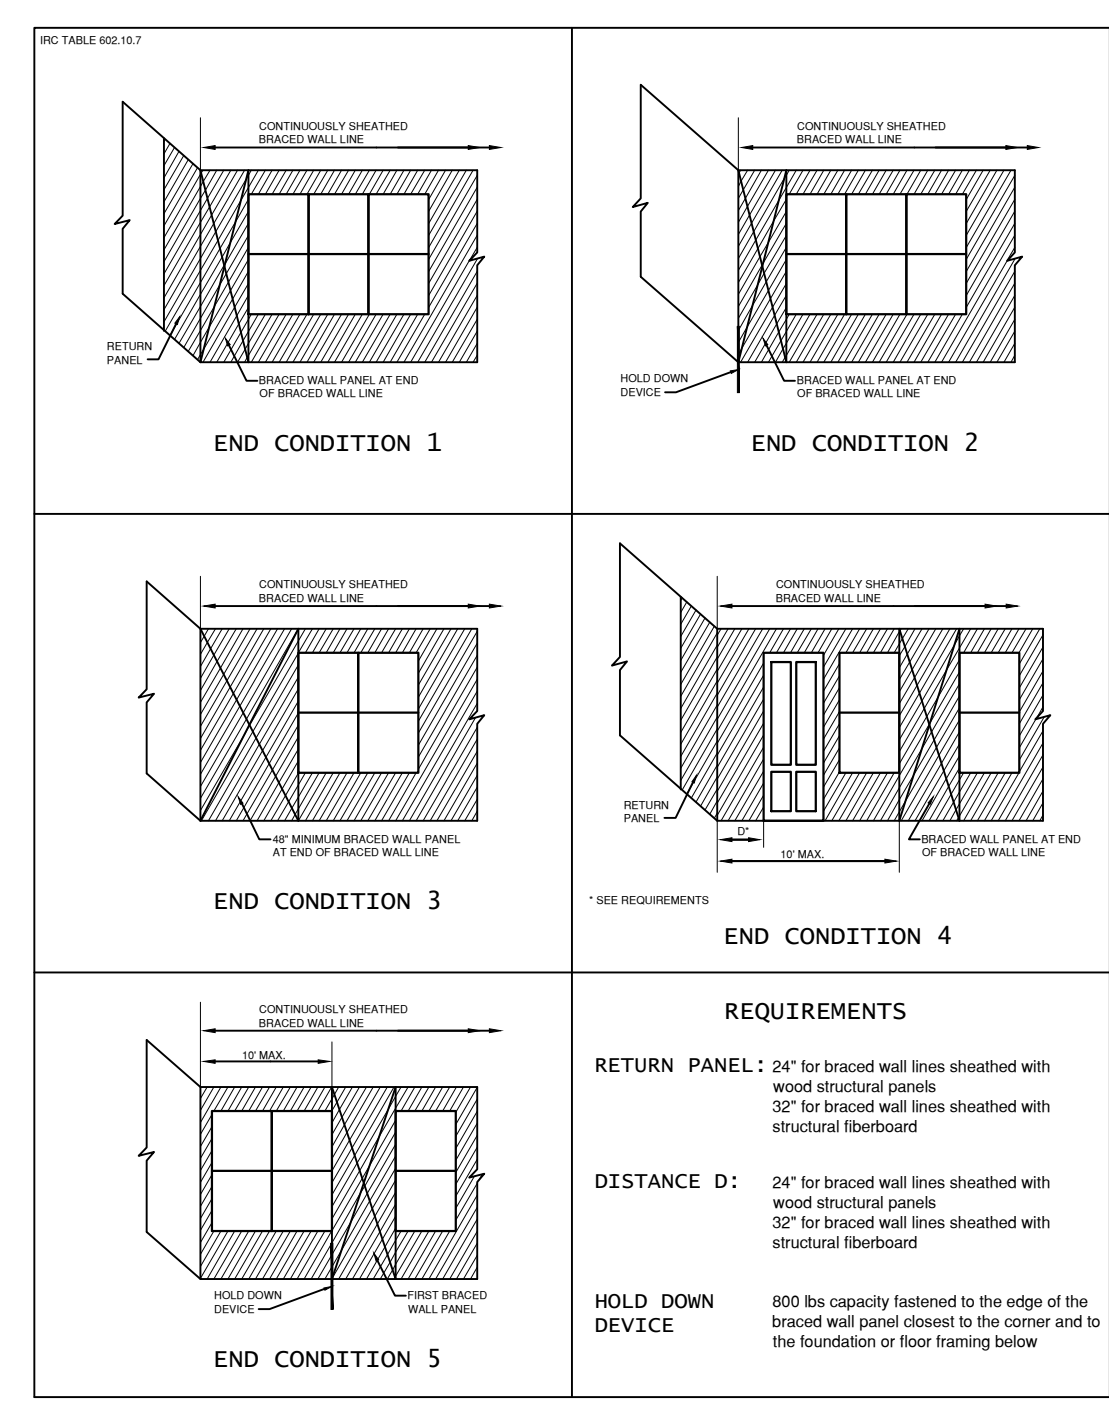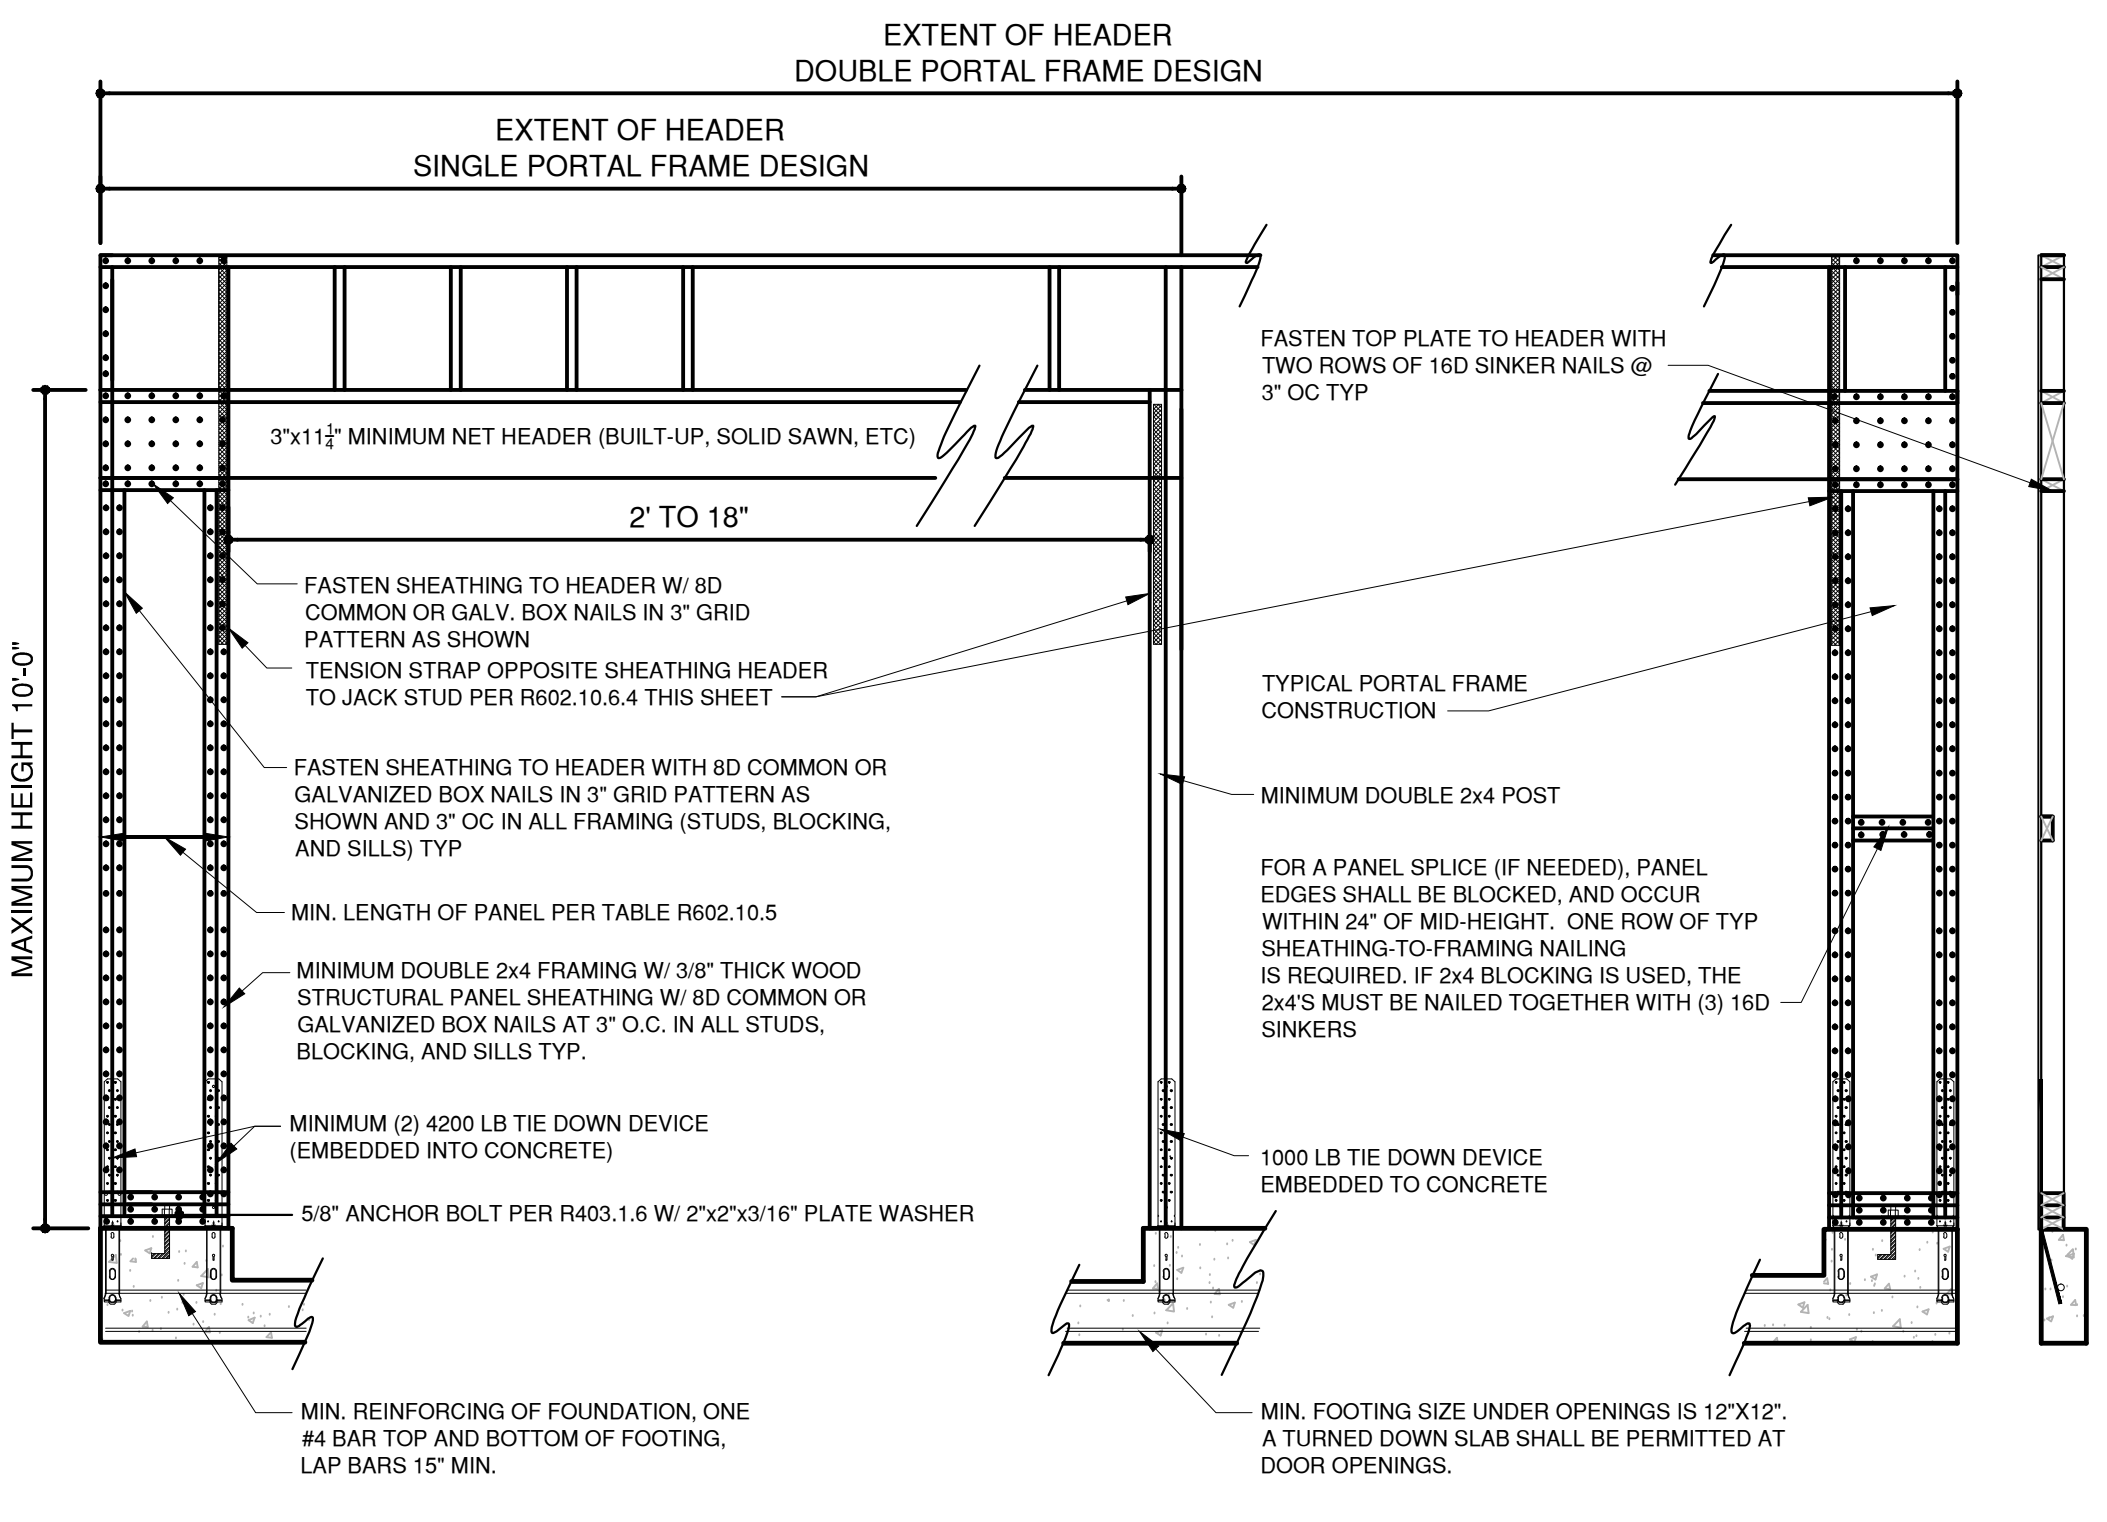

LOWER FLOOR DIAGRAM  
 3/16" = 1'-0"

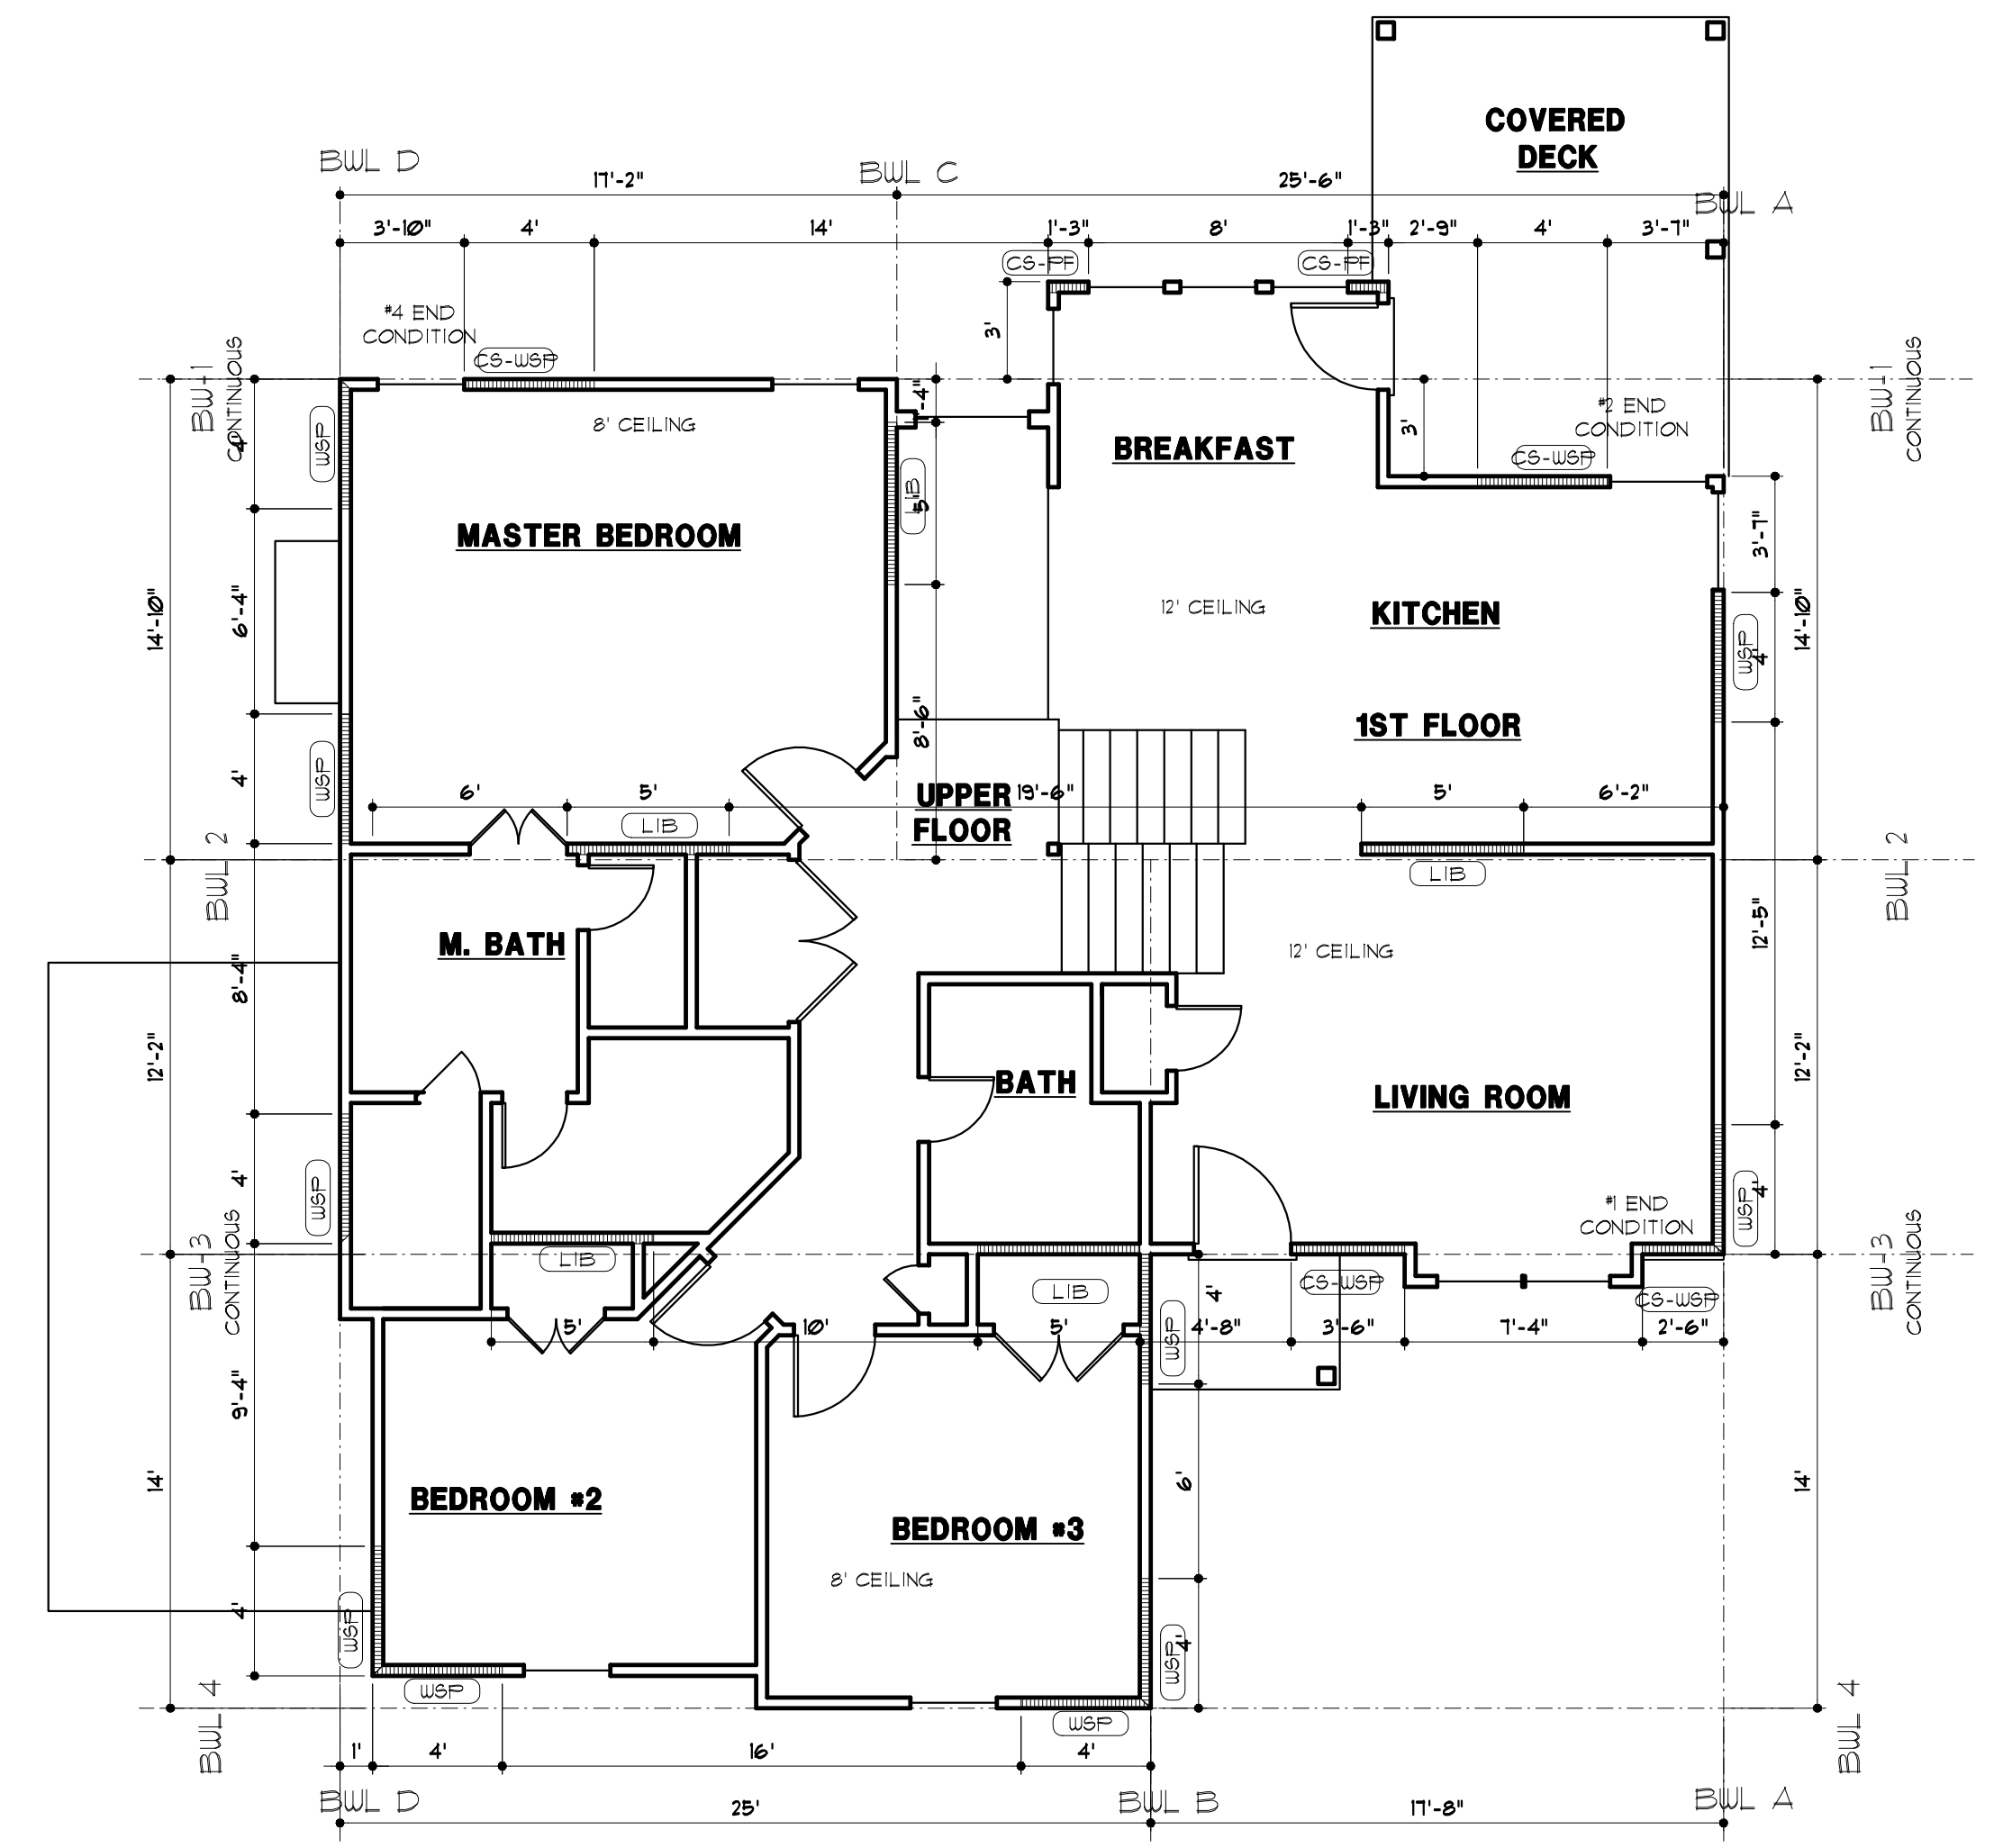

FIRST FLOOR DIAGRAM  
 3/16" = 1'-0"

1 PFH PORTAL FRAME W/ HOLD-DOWNS  
 1/2" = 1'-0" A-DTE-06100-28

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STATE OF MISSOURI  
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 ARCHITECT  
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 11/1/2021

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**G4**