

# DUTCH BROS COFFEE NEW FREESTANDING STORE 500 NW CHIPMAN ROAD, LEE'S SUMMIT, MISSOURI 64086



IMAGE FOR GENERAL ILLUSTRATIVE PURPOSES ONLY - ACTUAL BUILDING DESIGN MAY DIFFER


### SYMBOL LEGEND

SECTION REFERENCE DOOR SCHEDULE REFERENCE CENTERLINE MASTER MATERIAL SCHEDULE REFERENCE

REFERENCE

**EQUIPMENT SCHEDULE** 



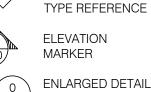


**ELEVATION** MARKER O ENLARGED DETAIL

NOT TO SCALE

WALL ASSEMBLY

(A0.0) REFERENCE

**REVISION TAG REVISION CLOUD** 

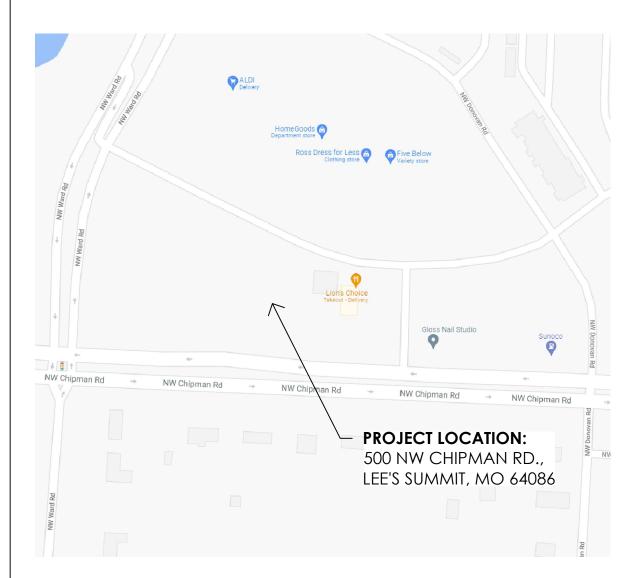



### **GENERAL REQUIREMENTS**

1. ANY DISCREPANCIES IN DRAWINGS OR SPECIFICATIONS SHALL BE BROUGHT TO THE ATTENTION OF THE DUTCH BROS CONSTRUCTION MANAGER PRIOR TO CONSTRUCTION, AND IF NOT CLARIFIED, THE CONTRACTOR SHALL ASSUME THE MOST STRINGENT REQUIREMENTS INDICATED

2. THE CONTRACTOR SHALL PROVIDE THE DUTCH BROS CONSTRUCTION MANAGER/ ARCHITECT WITH SCHEDULING INFORMATION PRIOR TO COMMENCEMENT OF CONSTRUCTION, AND WILL UPDATE THE SCHEDULE AS NECESSARY TO REFLECT ANY CHANGES IN ACTIVITIES AND MILESTONES.

ALL CONSTRUCTION AND MATERIALS SHALL COMPLY WITH ANY AND ALL APPLICABLE CODES. RULES AND LAWS, AS ADOPTED BY THE AUTHORITY HAVING JURISDICTION. ALL DIMENSIONS SHALL BE FIELD VERIFIED. BEFORE PROCEEDING WITH ANY WORK, THE CONTRACTOR SHALL CAREFULLY CHECK AND VERIFY ALL DIMENSIONS. ANY DISCREPANCIES SHALL BE REPORTED TO THE DUTCH BROS

4. SUBMIT FOR APPROVAL, PRIOR TO FABRICATION OR PURCHASE, SHOP DRAWINGS AND/OR SAMPLES FOR ITEMS AS REQUESTED BY THE CONSTRUCTION MANAGER AND/OR ARCHITECT.

5. UNLESS NOTED, EXISTING CONSTRUCTION, MATERIALS AND FINISHES SHALL REMAIN. ANY DAMAGE DONE TO THESE ITEMS SHALL BE REPAIRED TO THE ORIGINAL CONDITION BY A MEANS APPROVED BY

6. ALL WORK SHALL BE IN STRICT ACCORDANCE WITH ALL GOVERNMENTAL CODES, LAWS AND REGULATIONS. ALL MATERIAL SHALL MEET FLAME SPREAD AND SMOKE CONTRIBUTION REQUIREMENTS OF THE LOCALLY ADOPTED BUILDING CODE, AND AS NOTED IN THE CONTRACT DOCUMENTS.

7. THE DRAWINGS SHALL SERVE AS WORKING DRAWINGS FOR THE GENERAL LAYOUT OF THE VARIOUS ITEMS OF EQUIPMENT. HOWEVER, LAYOUT OF EQUIPMENT, ACCESSORIES, SPECIALTIES (INCLUDING FURNITURE), AND CONDUIT SYSTEMS ARE DIAGRAMMATIC UNLESS SPECIFICALLY DIMENSIONED. IF ADDITIONAL JUNCTION BOX, PULL-BOX, OR OTHER DEVICES ARE REQUIRED TO COMPLETE AN INSTALLATION, THE CONTRACTOR SHALL NOTIFY THE CONSTRUCTION MANAGER OF THE ADDITIONA

8. ALL SHOP DRAWINGS PREPARED BY THE MANUFACTURER MUST BE REVIEWED BY THE CONTRACTOR. THE CONTRACTOR'S STAMP OF APPROVAL AND DATE MUST BE INCLUDED ON ALL SUBMITTED MATERIALS ALONG WITH THE PROJECT NAME. SUBMITTALS NOT CONTAINING THE ABOVE INFORMATION WILL BE RETURNED WITHOUT ACTION. THE REVIEW OF SHOP DRAWINGS DOES NOT RELIEVE THE CONTRACTOR FROM RESPONSIBILITY FOR ERRORS. OMISSIONS OR DEVIATIONS FROM THE CONTRACT DOCUMENTS, UNLESS THEY ARE CALLED OUT IN WRITING AT THE TIME OF SUBMISSION AND WRITTEN ACCEPTANCE. THE ENGINEER IS RESPONSIBLE FOR DETAILS. SIZE O MEMBERS AND QUANTITIES IN SHOP DRAWINGS, BASED ON INFORMATION PROVIDED ON THE ENGINEERED PLANS; OMISSIONS OF COMPONENTS OR FITTINGS; AND FOR COORDINATING ITEMS WITH ACTUAL BUILDING CONDITIONS AND ADJACENT WORK. ERRORS AND OMISSIONS DISCOVERED AT A LATER TIME WILL BE CONSIDERED NON CONFORMING WORK.

9. THE CONTRACTOR SHALL MAINTAIN ON THE SITE AN UP-TO-DATE COMPLETE "RECORD" SET OF PRINTS WHICH ARE CORRECTED DAILY WITH ALL CHANGES IN LAYOUT FROM THE ORIGINAL DRAWINGS AND SPECIFICATIONS. CONTRACTOR SHALL DELIVER "RECORD" SET TO CONSTRUCTION MANAGER PRIOR TO FINAL PAYMENT. "RECORD" SET SHALL INCLUDE: ONE FULL PERMIT SET AND ONE SET OF

10. CONTRACTOR IS RESPONSIBLE FOR OBTAINING ALL PERMITS AND INSPECTIONS, DUTCH BROS WILL BE RESPONSIBLE FOR FEES PAYMENT. CONTRACTOR SHALL PROVIDE THE OWNER A COPY OF THE BUILDING PERMIT PRIOR TO COMMENCING ANY WORK. CONTRACTOR WILL NOTIFY THE CONSTRUCTION MANAGER/ ARCHITECT OF ALL PERMIT AND CODE INSPECTIONS. CONTRACTOR SHALL BE RESPONSIBLE FOR OF BUILDING PAD CERTIFICATION PER THE AUTHORITY HAVING JURISDICTION. CONTRACTOR SHALL BE RESPONSIBLE FOR ALL 3RD PARTY INSPECTIONS/ CERTIFICATIONS IN ORDER TO OBTAIN THE CERTIFICATE OF OCCUPANCY.

11. CONTRACTOR IS RESPONSIBLE FOR THE COORDINATION OF THE WORK OF ALL SUBCONTRACTORS, AND WORK RELATED DIRECTLY TO THE PROJECT BEING PERFORMED UNDER SEPARATE CONTRACT. CONTRACTOR SHALL SUBMIT A LIST OF EACH SUBCONTRACTOR'S NAME, CONTACT, ADDRESS AND TELEPHONE NUMBER AS WELL AS EMERGENCY CONTACT INFORMATION TO CONSTRUCTION MANAGER PRIOR TO BEGINNING CONSTRUCTION.

12. CONTRACTOR SHALL MAKE EVERY EFFORT TO KEEP THE BUILDING AREAS CLEAN AND SAFE DURING THE CONSTRUCTION PERIOD. CONTRACTOR SHALL USE WALK-OFF MATS TO PROTECT FLOORING. CONTRACTOR AND ITS SUBCONTRACTORS SHALL PREVENT NOISE, DUST, SMOKE AND ODORS FROM INTERFERING WITH THE NORMAL OPERATIONS OF NEIGHBORING AREAS, INCLUDING

- CONSTRUCTION DEBRIS WILL BE REMOVED FROM THE SITE. THE SITE AREA SHALL BE KEPT CLEAN AND ORGANIZED AT ALL TIMES.

- ALL WALL, FLOOR OR CEILING PENETRATIONS SHALL BE SLEEVED AND ADEQUATELY SEALED TO PREVENT THE SPREAD OF SMOKE, FIRE AND RODENTS PER APPLICABLE CODES. THE CONTRACTOR SHALL PROVIDE TEMPORARY PROTECTION WHEN WORK CANNOT BE COMPLETED IN ONE WORK SHIFT. - THE CONTRACTOR SHALL PROVIDE AN ADEQUATE NUMBER OF FIRE EXTINGUISHERS IN THE WORK AREA THROUGHOUT THE CONSTRUCTION PERIOD. - THE CONTRACTOR SHALL NOTIFY THE OWNER 72 HOURS PRIOR TO ANY ELECTRICAL SHUTDOWNS

WHICH MAY AFFECT EXISTING TENANTS OR NEIGHBORS. - THE CONTRACTOR SHALL PROHIBIT SMOKING ON AND WITHIN 25 FEET OF THE BUILDING AREA.

13. CLEAN-UP - THE PROJECT SITE SHALL BE SWEPT UP AND TRASH SHALL BE REMOVED ON A DAILY BASIS. CARE SHALL BE TAKEN TO KEEP ADJACENT OCCUPIED TENANT AREAS CLEAN DURING CONSTRUCTION ON A DAILY BASIS WHERE WORK REQUIRED BY THIS PROJECT DISTURBS ADJACENT

- THE CONTRACTOR IS RESPONSIBLE FOR REMOVAL OF CONSTRUCTION DEBRIS. LOCATION OF LARGE DUMPSTERS FOR CONTRACTORS MUST BE APPROVED AND PLACED AS DIRECTED BY THE CONSTRUCTION MANAGER. THE CONTRACTOR WILL OBTAIN THE PERMIT FOR THE DUMPSTER. - PRIOR TO OCCUPANCY, SPACE SHALL BE LEFT CLEAN OF ALL DEBRIS. WALL AND OTHER SURFACES SHALL BE WIPED DOWN, GLASS WASHED, BLINDS DUSTED, FLOORS SWEPT AND/OR VACUUMED, TILE

CLEANED AND WOODWORK CLEANED. - CONTRACTOR IS RESPONSIBLE FOR DELIVERING THE PREMISES AT COMPLETION IN A "MOVE-IN" CONDITION.

- CONTRACTOR WILL BE REQUIRED TO LEAVE EXTRA MATERIALS IN THE WORKROOM: TWELVE TILES, ONE BOX OF VINYL FACED CEILING TILE, ONE BOX OF QUARRY TILES, MINIMUM 1/2 GALLON OF EACH PAINT AND BASE PAINT USED, TO BE LEFT IN BATHROOM OR MONOLITH ATTIC SPACE.

### PROJECT STATISTICS

NEW CONSTRUCTION FOR DUTCH BROS COFFEE LOCATED AT 500 NW CHIPMAN RD., LEE'S SUMMIT, MISSOURI 64086. THE BUILDING CONSISTS OF (1) DRIVE-THRU SERVICE WINDOW AND (1) WALK-UP SERVICE WINDOW; NO INDOOR OR OUTDOOR SEATING IS PROVIDED. SITE DEVELOPMENT INCLUDES A SMALL PARKING AREA, (2) DRIVE AISLES, AND A TRASH ENCLOSURE AREA. THE PARCEL IS CURRENTLY VACANT.

### PARCEL DATA:

PARCEL ID # 52-900-03-42-00-0-000 OVERALL SITE AREA: ±0.828 ACRES ZONING: PMIX (PLANNED MIXED USE) CURRENT LAND USE: VACANT COMMERCIAL PROPERTY PROPOSED LAND USE: COMMERCIAL

### CODE SUMMARY

**BUILDING CODE** 2018 IBC MECHANICAL CODE 2018 IMC PLUMBING CODE 2018 IPC **ENERGY CODE** NOT ADOPTED FIRE CODE 2018 IFC ELECTRICAL CODE 2017 NEC ANSI 117.1 ACCESSIBILITY CODE

### BUILDING CONSTRUCTION DATA

**CONSTRUCTION TYPE:** AUTOMATIC SPRINKLER SYSTEM: NO PROPOSED BUILDING HEIGHT: 24'-0" MAXIMUM ALLOWABLE HEIGHT PROPOSED STORIES: MAXIMUM STORIES: TOTAL FLOOR AREA: 950 S.F. GROSS MAXIMUM ALLOWABLE AREA: 9,000 S.F. FIRE-RESISTANCE RATING FOR STRUCTURAL ELEMENTS: 0 HOURS (PER IBC TABLE 601)

### BUILDING OCCUPANCY DATA

OCCUPANCY CLASSIFICATION: GROUP B (BUSINESS)

LOAD FACTOR: 1/150 OCCUPANT LOAD: 6.33

TOTAL OCCUPANT LOAD: 7

### TOTAL EXITS:

7 (OCCUPANT LOAD) X .2" / PERSON: 1.40 INCHES EXIT WIDTH PROVIDED: 40 INCHES MAXIMUM EXIT ACCESS 75 FEET

TRAVEL DISTANCE:

SUBMITTALS BY OTHERS:

THOSE DEFERRED ITEMS.

TOTAL NUMBER OF TOILET FACILITIES: 1 PROVIDED

SIGN VENDOR SHALL BE RESPONSIBLE FOR PREPARING DRAWINGS AND

NOTE: I/ WE UNDERSTAND THAT I/ WE WILL NOT BE AUTHORIZED FOR ANY

OBTAINING SEPARATE SIGNAGE PERMITS AS REQUIRED BY LOCAL

INSPECTION OF THE DEFERRED ITEMS PROPOSED PRIOR TO THE

SUBMITTAL AND APPROVAL OF PLANS AND/ OR CALCULATIONS FOR

### PROJECT DIRECTORY

OWNER / DEVELOPER T.M. CROWLEY & ASSOCIATES 501 PENNSYLVANIA PARKWAY, SUITE 160 INDIANAPOLIS. IN 46280 ATTN: ANDREW GLENSKI - DIRECTOR OF CONSTRUCTION AGLENSKI@TMCROWLEY.COM

G0.1

G1.4

G1.5

CIVIL

C-001

C-100

C-200

C-300

C-402

C-500

C-700

SP1.2

LANDSCAPE:

SITE PLAN:

ARCHITECTURAL:

ACCESSIBILITY INDEX

SPECIFICATIONS

**SPECIFICATIONS** 

SPECIFICATIONS

**SPECIFICATONS** 

**SPECIFICATONS** 

**SPECIFICATIONS** 

**COVER SHEET** 

SITE PLAN

**GENERAL NOTES** 

**GRADING PLAN** 

UTILITY PLAN

INITIAL EROSION CONTROL PLAN

FINAL EROSION CONTROL PLAN

EXISTING DRAINAGE AREA MAP

**EROSION CONTROL DETAILS** 

STORM SEWER PROFILES

CONSTRUCTION DETAILS

CONSTRUCTION DETAILS

STORM MANAGEMENT PLAN

ARCHITECTURAL SITE PLAN

**BUILDING SIGNAGE DETAILS** 

EQUIPMENT/ ENLARGED COOLER/

IT/ LIGHTING/ PLUMBING/ TABLE

SITE SIGNAGE DETAILS

SITE SIGNAGE DETAILS

FIRE LIFE SAFETY PLAN

**EQUIPMENT SCHEDULE** 

PARTITION/ FINISH PLAN

INTERIOR ELEVATIONS

INTERIOR ELEVATIONS -

**BUILDING ELEVATIONS** 

**BUILDING SECTIONS** 

WALL SECTIONS

WALL SECTIONS

**ELEVATIONS** 

**BUILDING DETAILS** 

WINDOW AND DOOR DETAILS TRASH ENCLOSURE PLAN/

TRASH ENCLOSURE DETAILS

REFLECTED CEILING PLAN

AWNING/ CANOPY DETAILS

SCHEDULES

**EQUIPMENT** 

UTILITY DETAILS

LANDSCAPE PLAN

**DUTCH BROS COFFEE** 110 SW 4TH STREET

(913) 568-1998

DWILLIAMS@NANSHEPARTNERS.COM

CORALIC ARCHITECTURE A MISSOURI LIMITED LIABILITY COMPANY 9700 MACKENZIE ROAD, SUITE 222, ST. LOUIS, MO 63123 ATTN: EDIN CORALIC, PRINCIPAL EDIN@CORALICARCHITECTURE.COM

### CIVIL ENGINEER

PREMIER DESIGN GROUP 100 MIDLAND PARK DRIVE WENTZVILLE, MO, 63385

### STRUCTURAL ENGINEER

KREHER ENGINEERING 208 N. MAIN STREET. COLUMBIA, IL 62236

JIMK@KREHERENGINEERING.COM (618) 281-8505

796 MERUS COURT ST. LOUIS, MO 63026

ATTN: DARRELL CASE, PE DCASE@CASEENGINEERINGINC.COM

### **TENANT**

GRANTS PASS, OR 97526

### ARCHITECT OF RECORD

(314) 578-4953

ATTN: JIM KREHER

## ELECTRICAL/ MECHANICAL/ PLUMBING

ATTN: DENNIS WILLIAMS, CONSTRUCTION MANAGER (480) 213-9288

ATTN: MATT FOGARTY, PRINCIPAL ENGINEER MFOGARTY@PREMIERCIVIL.COM (314) 925-7452

CASE ENGINEERING, INC.

(636) 349-1600

DRAV	VING INDEX:							
REVISION:		1	2	3	4	5	REVISION	:
GENER	AL INFORMATION:						STRUC	TURAL
G0.0	COVER SHEET	Х					S1.1	GENER

| X |

| X |

		STRUC	TURAL:		
Х		S1.1	GENERAL NOTES		
		S1.2	GENERAL NOTES/ SPECIAL INSPECTIONS		
		S1.3	TYPICAL DETAILS		
		S1.4	TYPICAL DETAILS		
		S1.5	TYPICAL DETAILS		
		S2.1	FOUNDATION PLAN		
		S2.2	FOUNDATION SECTIONS		
		S2.3	ROOF FRAMING		
1		S2.4	HIGH ROOF PLAN AND DETAILS		
		S2.5	ROOF SECTIONS		
		ELECT	RICAL:	 	
			ELECTRICAL SITE/ PHOTOMETRIC		

E1.01 LIGHTING PLAN E2.01 POWER PLAN E2.02 SPECIAL SYSTEMS FLOOR PLAN E3.01 PANEL SCHEDULES E4.01 SPECIFICATIONS MECHANICAL: MECHANICAL PLAN

MECHANICAL DETAILS

MECHANICAL SPECIFICATIONS PLUMBING: PLUMBING SPECIFICATIONS & SCHEDULE PLUMBING WASTE/ VENT FLOOR P2.0 PLUMBING SUPPLY FLOOR PLAN AND DETAILS PLUMBING ISOMETRICS P4.0 PLUMBING DETAILS

PLUMBING SPECIFICATIONS

SEE PREFERRED VENDOR LIST ON SHEET G0.1

# UTILITY REQUIREMENTS

FULL ELECTRIC DESIGN (NO GAS)	600A, 120/208V, THREE PHASE, 4-WIRE, GROUNDED ELECTRICAL SERVICE
DOMESTIC WATER	3/4" MINIMUM, OR AS REQUIRED PER LOCAL CODE. 50-60 PSI MEASURED AFTER METER.
IRRIGATION WATER	3/4" MINIMUM, OR AS REQUIRED PER LOCAL CODE
SEWER	4" MINIMUM, OR AS REQUIRED PER LOCAL CODE
STORM WATER	AS REQUIRED PER LOCAL CODE
CARLE INTERNET	60 MBPS MINIMUM DOWNLOAD SPEED, 5

MBPS MINIMUM UPLOAD SPEED

CABLE INTERNET





CORALIC, LLC **EDIN CORALIC** 

ST. LOUIS, MO 63123 p: 314.578.4953 e: edin@coralicarchitecture.com

STRUCTURAL ENGINEER JAMES C. KREHER JIM KREHER

9700 MACKENZIE ROAD, STE. 222,


208 N. MAIN STREET COLUMBIA, IL 62236 p: 618.281.8505

1 2 3 4 5

jimk@kreherengineering.com MEP ENGINEER Case Engineering

DARRELL R. CASE 796 MERUS CT., FENTON. MO 63026 T. 636.349.1600 F. 636.349.1730 dcase@caseengineeringinc.com

A-2013031004 - EXP<u>. 12-31-202</u>1

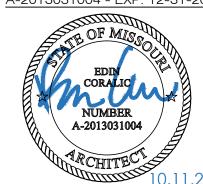


UTHORITY NO. 201304139

S

0 0


for: 110 Gro

ISSUED FOR PERMIT: 10.11.2021

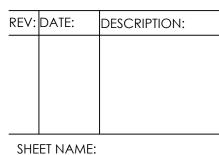

**COVER SHEET** 

SHEET NUMBER:

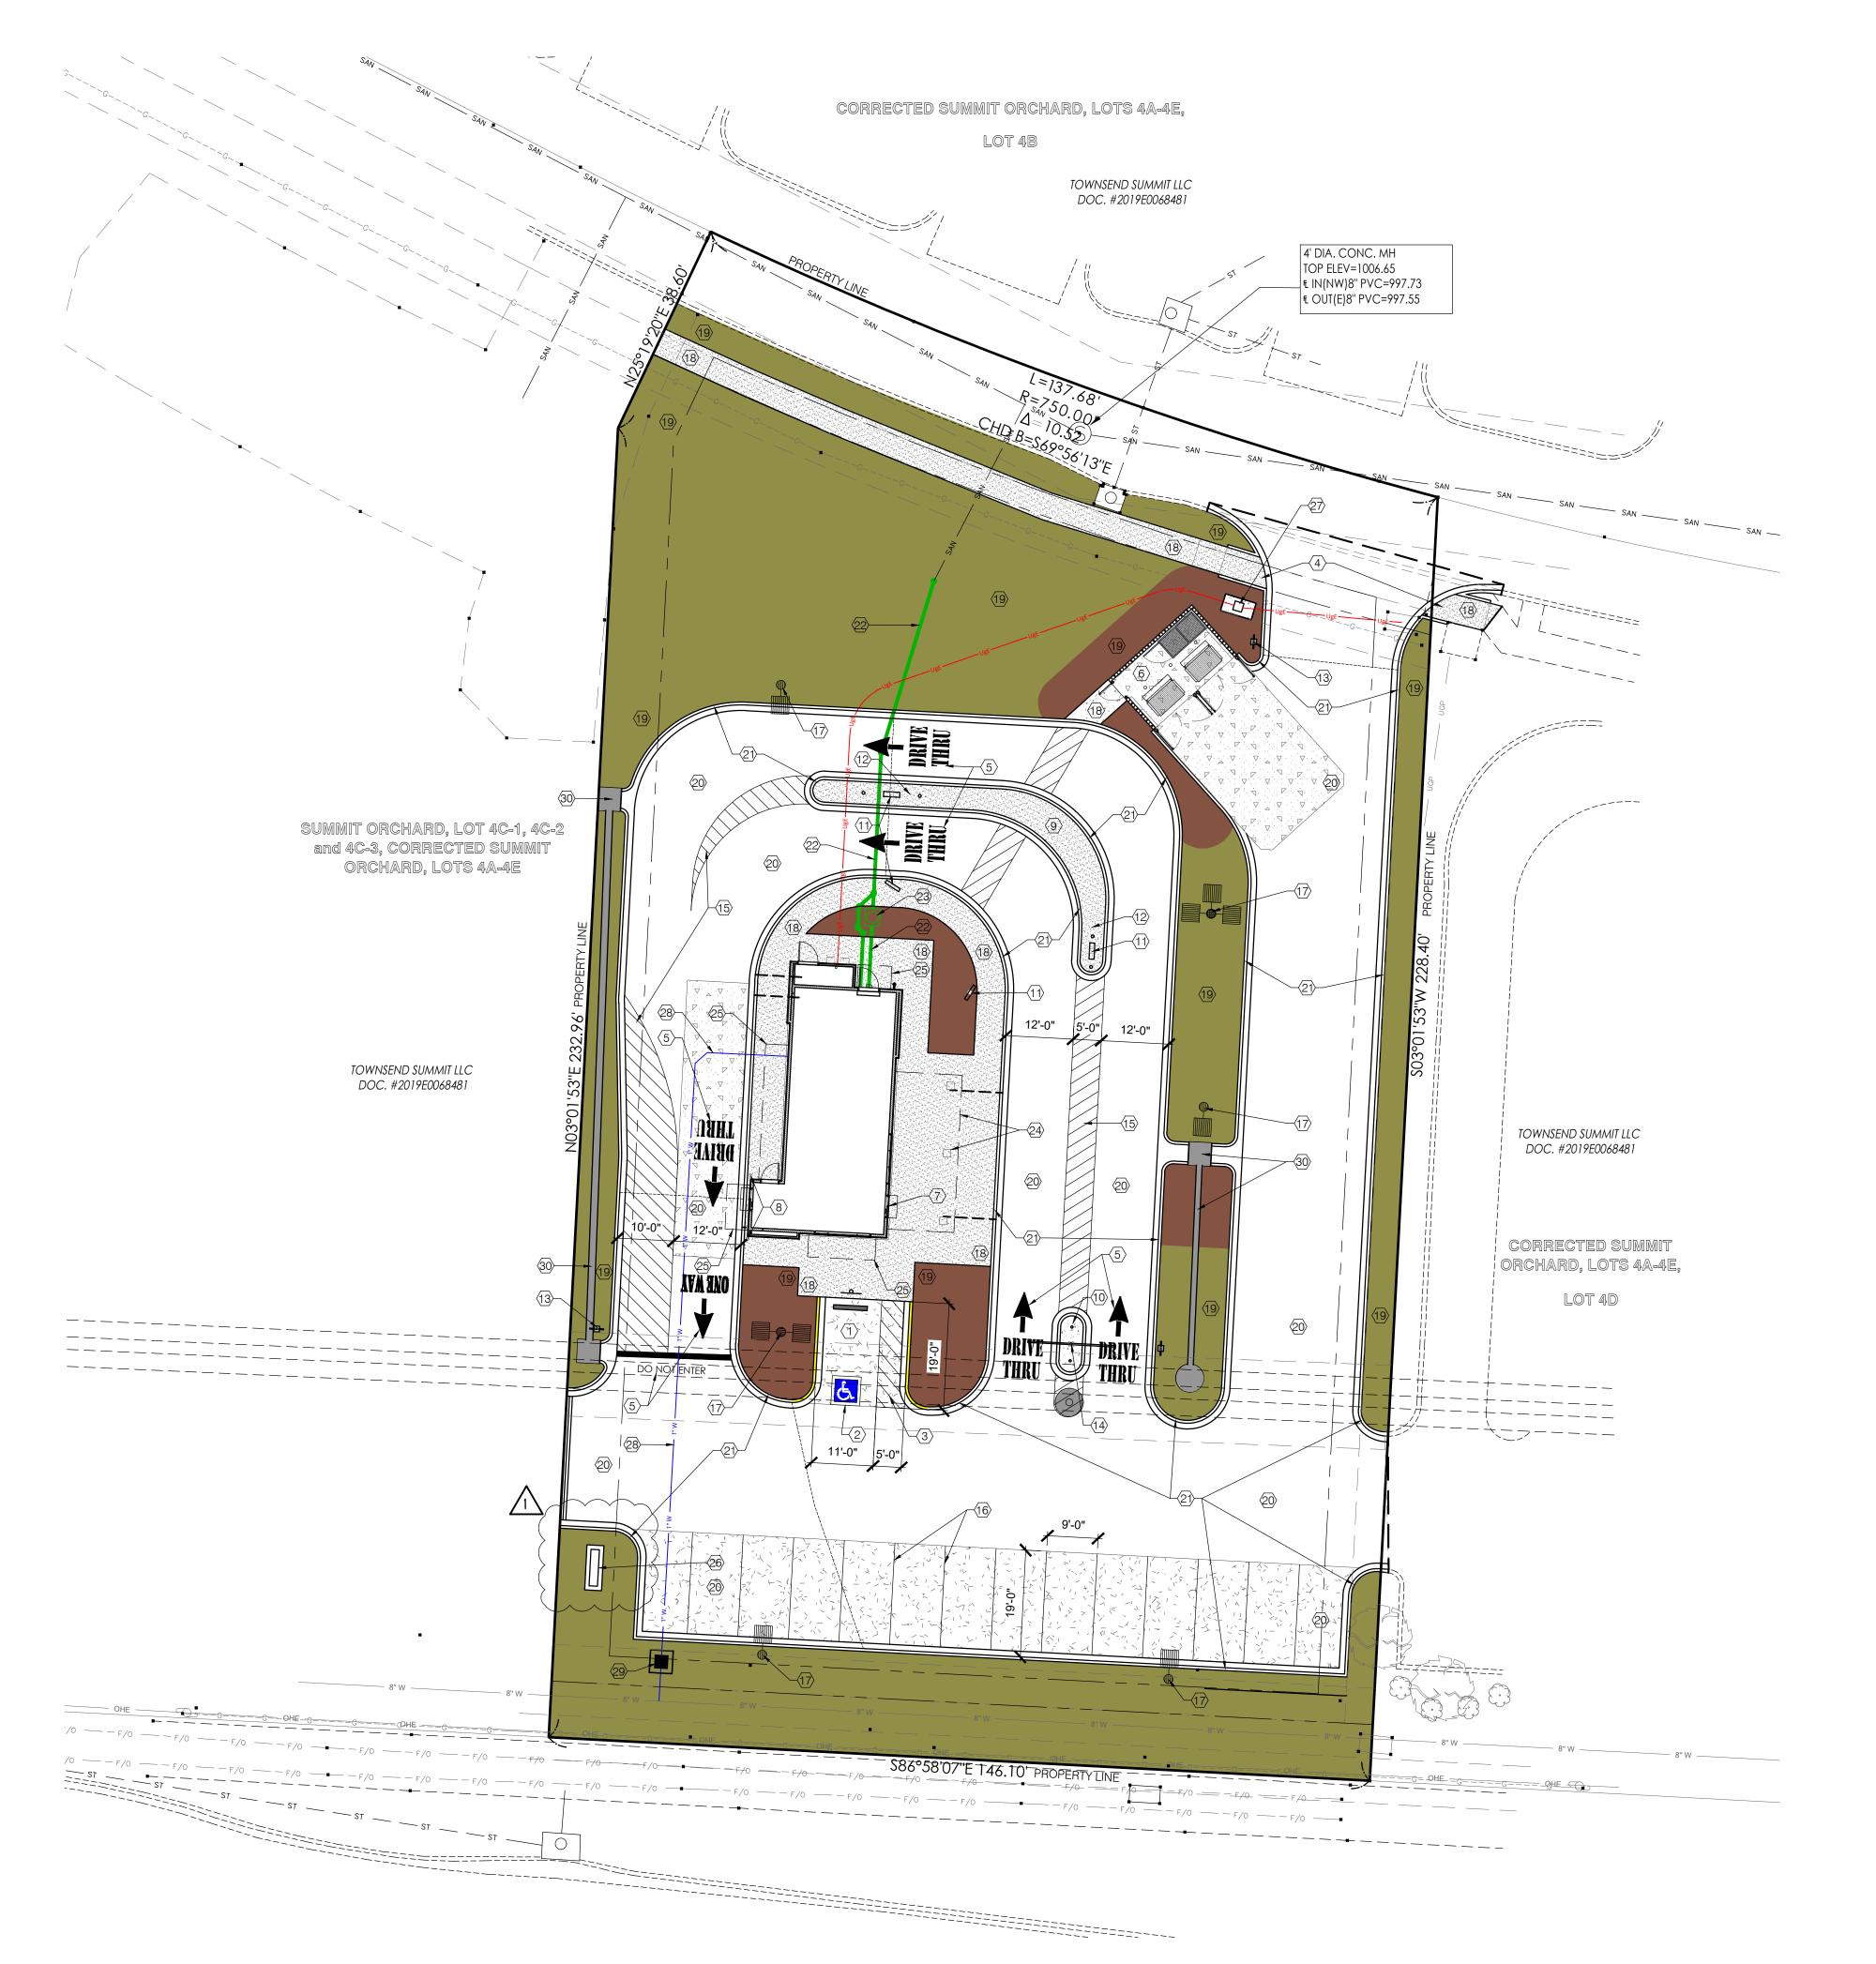

# SCALE: 1/16" = 1'-0"

### SITE PLAN KEYNOTES: 🗵

- 1. ACCESSIBLE PARKING STALL W/ ACCESSIBLE PARKING ONLY VERTICAL SIGN- RE:
- CIVIL PLANS.
- 2. INTERNATIONAL ACCESSIBLE SYMBOL ON PAVEMENT- RE: CIVIL PLANS. 3. PAINTED ACCESSIBLE AISLE- RE: CIVIL PLANS.
- 4. ACCESSIBLE CURB-CUT RAMP, TYP.- RE: CIVIL PLANS.
- 5. PAINTED DIRECTIONAL SIGNAGE- RE: CIVIL PLANS.
- 6. TRASH ENCLOSURE W/ LOCKING GATES. REFER TO SHEETS A9.0-A9.1 FOR DETAILS; COORD. W/ LOCAL REFUSE SERVICE PROVIDER FOR MIN. REQUIREMENTS AND CLEARANCES.
- WALK-UP SERVICE WINDOW
- 8. 6" BOLLARD W/ DB BOLLARD COVERS- SEE FLOOR PLANS.
- 9. CONC. MEDIAN-"RUNNERS" SIDEWALK- RE: CIVIL PLANS.
- 10. PROVIDE 2" CONDUIT W/ PULL STRING TO CHRISTY BOX FOR FUTURE DRIVE-THRU SENSORS.
- 11. POLE MOUNTED STATIC BACKLIT LED MENU BOARD, BY OTHERS, PROVIDE POWER AND DATA IN WEATHERPROOF J-BOX, REFERENCE SHEET SP1.1
- 12. PROVIDE 2" CONDUIT W/ PULL STRING TO CHRISTY BOX, FOR FUTURE DIGITAL MENU BOARD UPGRADE
- 13. POLE MOUNTED DIRECTIONAL SIGNAGE, BY OTHERS, REFERENCE SHEET SP1.2
- 14. CLEARANCE BAR, BY OTHERS, REFERENCE SHEET SP1.2
- 15. PAINT STRIPING, BEFORE AND AFTER CONCRETE MEDIAN AND ESCAPE LANE,
- STRIPES: 4" WIDE, 24" O.C., SAFETY WHITE- RE: CIVIL. 16. PARKING SPACE STRIPING- RE: CIVIL PLANS.
- 17. SITE LIGHT- RE: ELECTRICAL PLANS.
- 18. CONCRETE SIDEWALK- RE: CIVIL PLANS.
- 19. PROPOSED LANDSCAPING AREAS- RE: LANDSCAPE PLANS.
- 20. PROPOSED PAVEMENT- RE: CIVIL PLANS. 21. PROPOSED CONCRETE CURB- RE: CIVIL PLANS.
- 22. PROPOSED SANITARY SEWER- RE: CIVIL PLANS.
- 23. PROPOSED BELOW GROUND GREASE INTERCEPTOR- RE: PLUMBING PLANS.
- 24. PROPOSED FRAMED BUILDING CANOPY AND COLUMNS- RE: FLOOR PLANS, DETAILS, SECTIONS AND STRUCTURAL PLANS.
- 25. SHOWN DASHED, ALUMINUM PREFABRICATED CANOPY.
- 26. NEW MONUMENT SIGN- RE: CIVIL AND SIGNAGE PLANS- SHOWN FOR REFERENCE ONLY- PERMITTED UNDER A SEPARATE PERMIT.
- 27. PROPOSED ELECTRIC TRANSFORMER LOCATION- VERIFY WITH LOCAL ELECTRICAL
- COMPANY. 28. DOMESTIC WATER- RE: CIVIL PLANS.
- 29. DOMESTIC WATER METAR- RE: CIVIL PLANS.
- 30. STORM SEWER- RE: CIVIL PLANS.



**ARCHITECT** CORALIC, LLC **EDIN CORALIC** 

9700 MACKENZIE ROAD, STE. 222, ST. LOUIS, MO 63123

p: 314.578.4953

e: edin@coralicarchitecture.com STRUCTURAL ENGINEER

JAMES C. KREHER JIM KREHER

208 N. MAIN STREET, COLUMBIA, IL 62236 p: 618.281.8505

jimk@kreherengineering.com

MEP ENGINEER Case Engineering DARRELL R. CASE

796 MERUS CT., FENTON, MO 63026 T. 636.349.1600 F. 636.349.1730 dcase@caseengineeringinc.com

EDIN CORALIC ARCHITECT A-2013031004 - EXP. 12-31-2021



MISSOURI CERTIFICATE OF

AUTHORITY NO. 2013041393

Stor 02 00

ISSUED FOR PERMIT:

REV: DATE: DESCRIPTION: 1 | 10/14/21 | CITY COMMENTS


SHEET NAME:

10.11.2021


ARCHITECTURAL SITE PLAN

SHEET NUMBER:

### SCOPE OF WORK: PROVIDE (2) D/F ILLUMINATED MENU SIGNS V5 - PLATE-MOUNTED

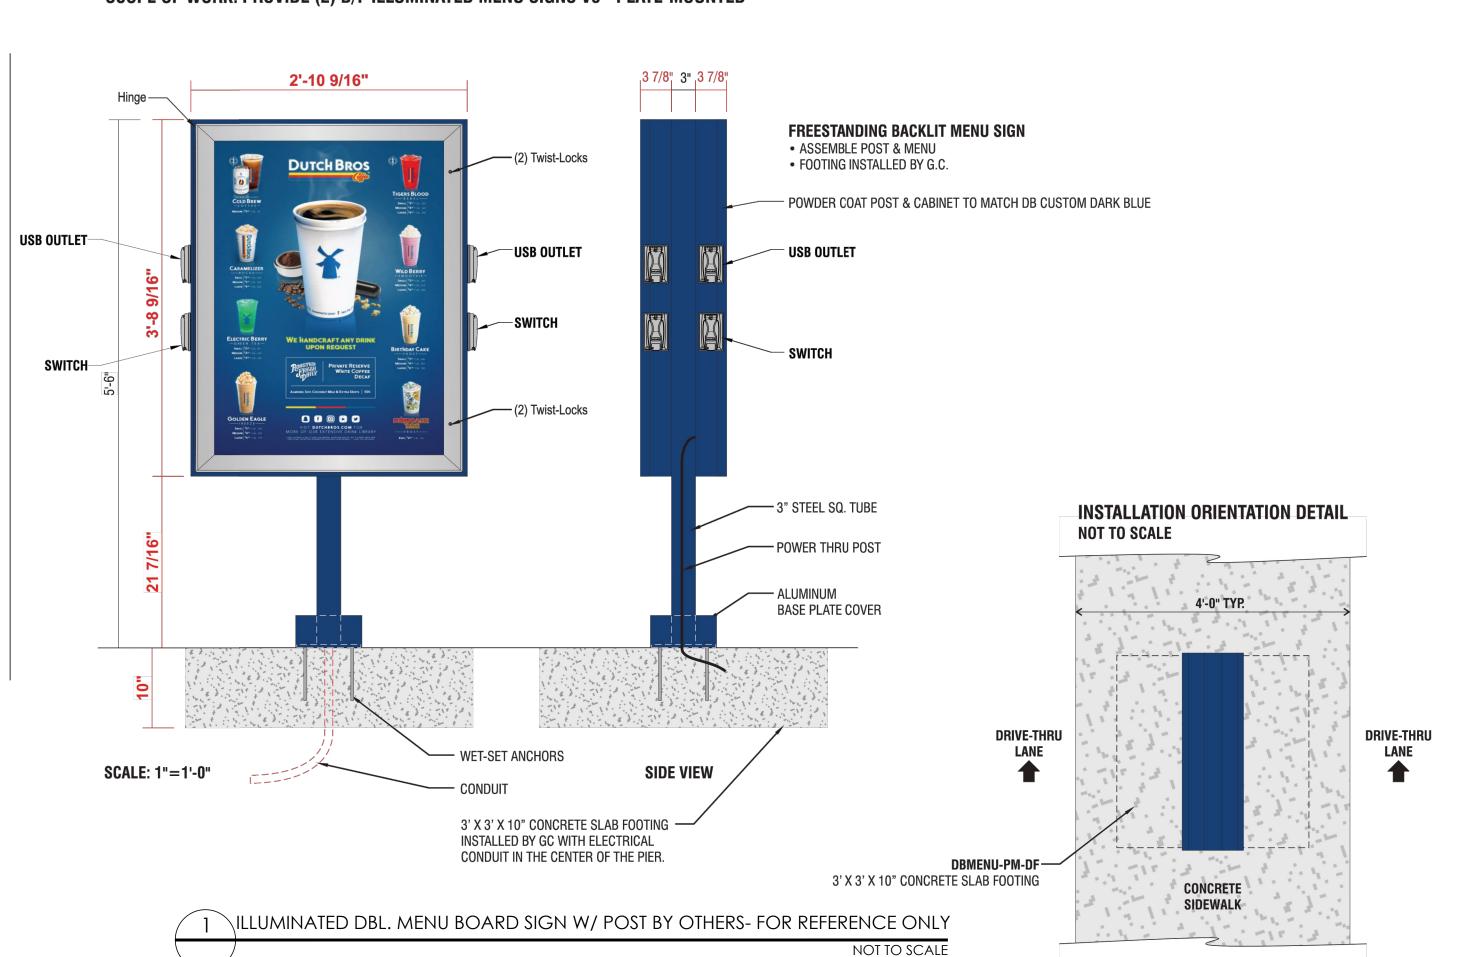


### SCOPE OF WORK: PROVIDE (2) S/F ILLUMINATED MENU SIGNS V5 - PLATE-MOUNTED

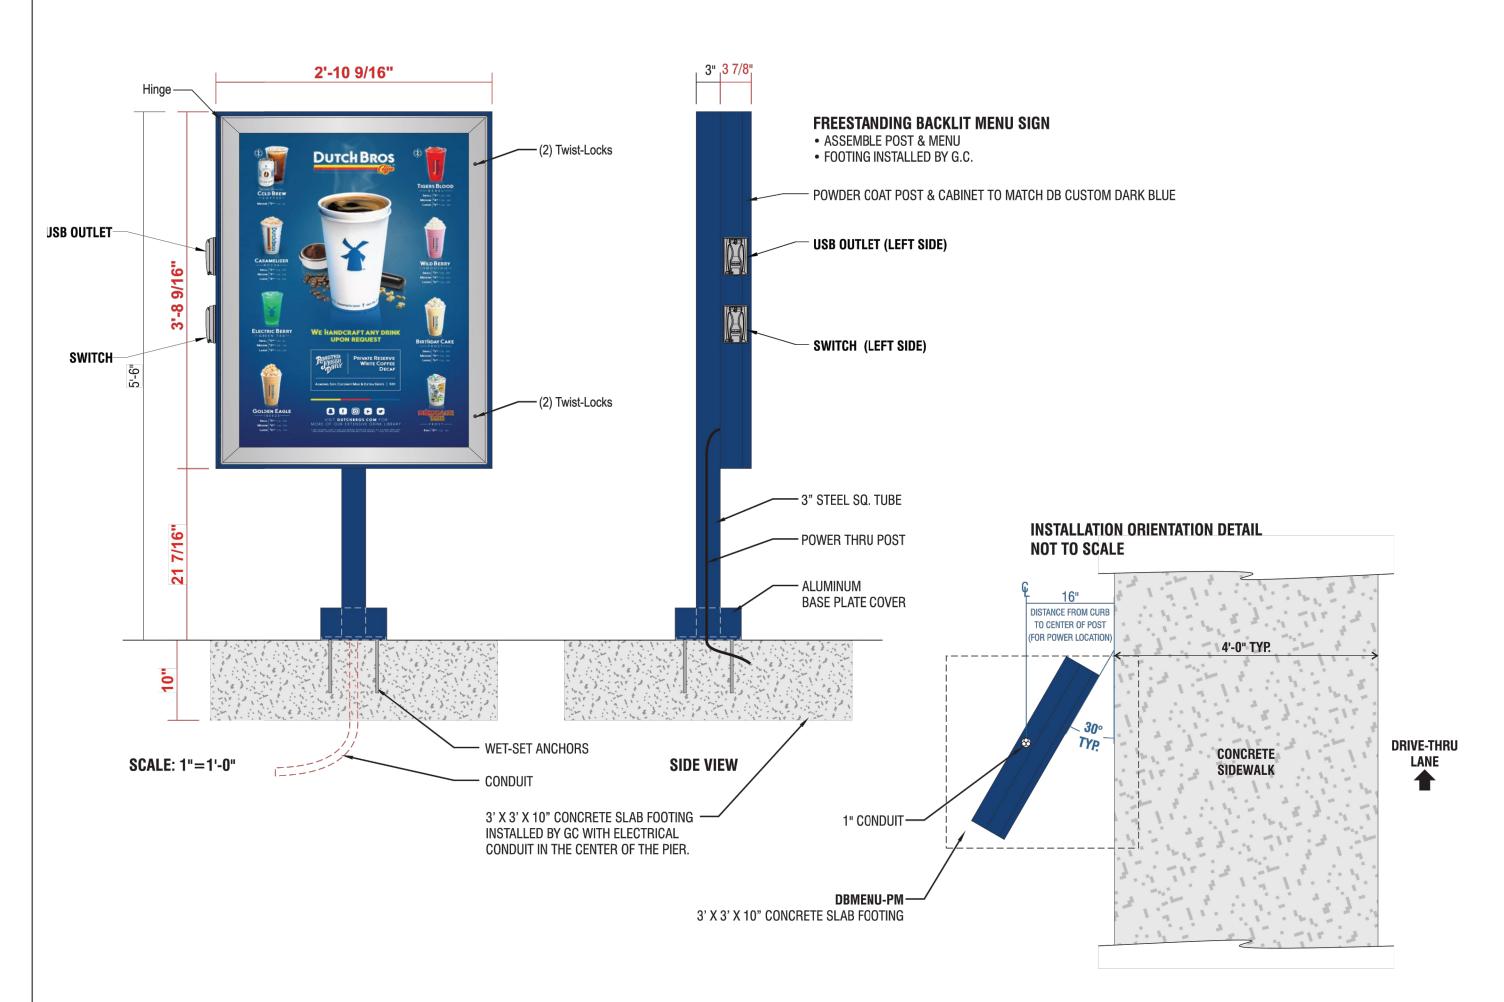


2 ILLUMINATED SINGLE MENU BOARD SIGN W/ POST BY OTHERS- FOR REFERENCE ONLY

### NOTES:

- 1. ALL SIGNAGE IS BY OTHERS/ SEPARATE SUBMITTAL; SHOWN HERE FOR REFERENCE ONLY.
- 2. REFER TO STRUCTURAL AND ELECTRICAL PLANS FOR ADDITIONAL INFO.

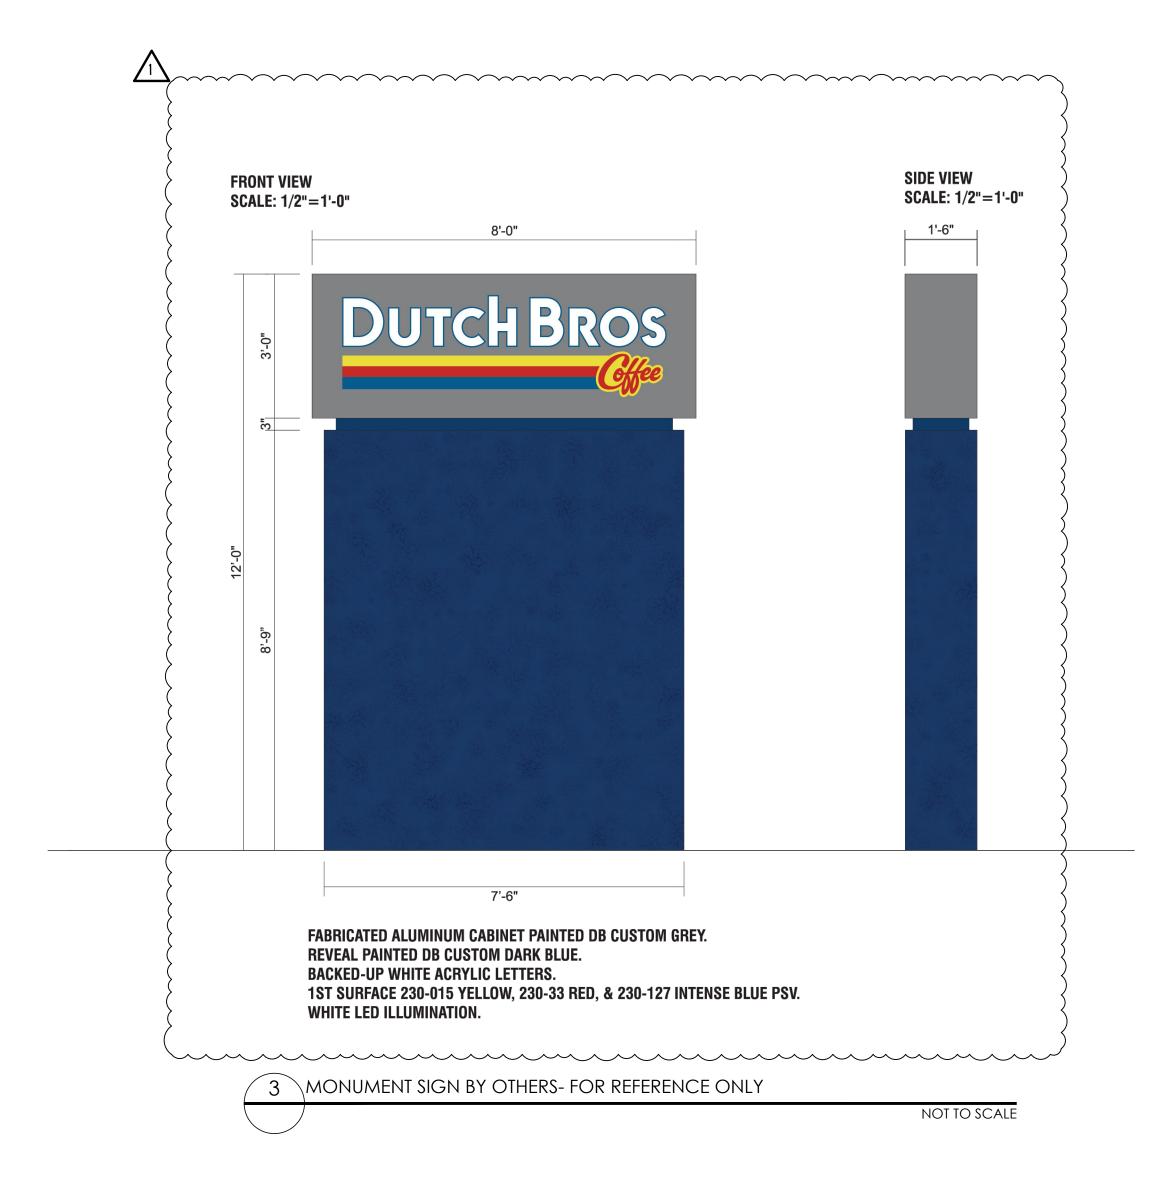

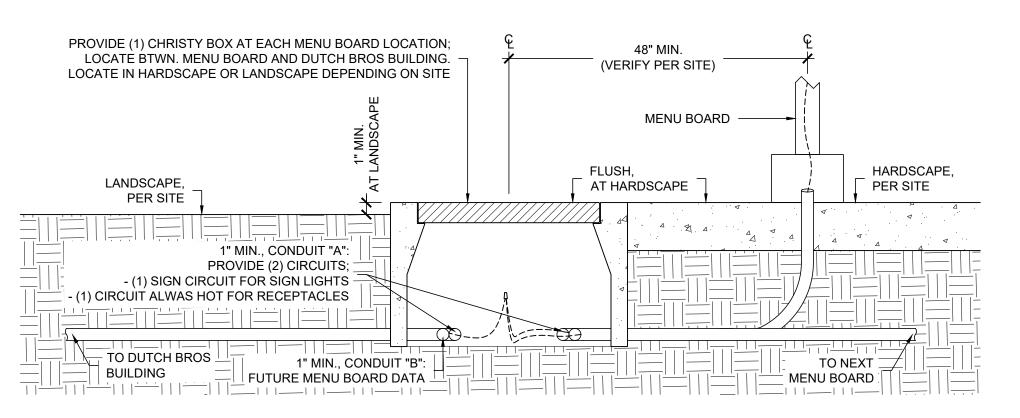







**ARCHITECT** CORALIC, LLC EDIN CORALIC 9700 MACKENZIE ROAD, STE. 222,

ST. LOUIS, MO 63123 p: 314.578.4953

e: edin@coralicarchitecture.com

STRUCTURAL ENGINEER JAMES C. KREHER JIM KREHER

208 N. MAIN STREET, COLUMBIA, IL 62236 p: 618.281.8505 jimk@kreherengineering.com

MEP ENGINEER

Case Engineering DARRELL R. CASE 796 MERUS CT., FENTON, MO 63026 T. 636.349.1600 F. 636.349.1730

dcase@caseengineeringinc.com EDIN CORALIC ARCHITECT A-2013031004 - EXP. 12-31-2021

MISSOURI CERTIFICATE OF AUTHORITY NO. 2013041393


Stor 0 00

ISSUED FOR PERMIT: 10.11.2021

REV: DATE: DESCRIPTION: 1 | 10/14/21 | CITY COMMENTS SHEET NAME:

SITE SIGNAGE DETAILS

SHEET NUMBER:

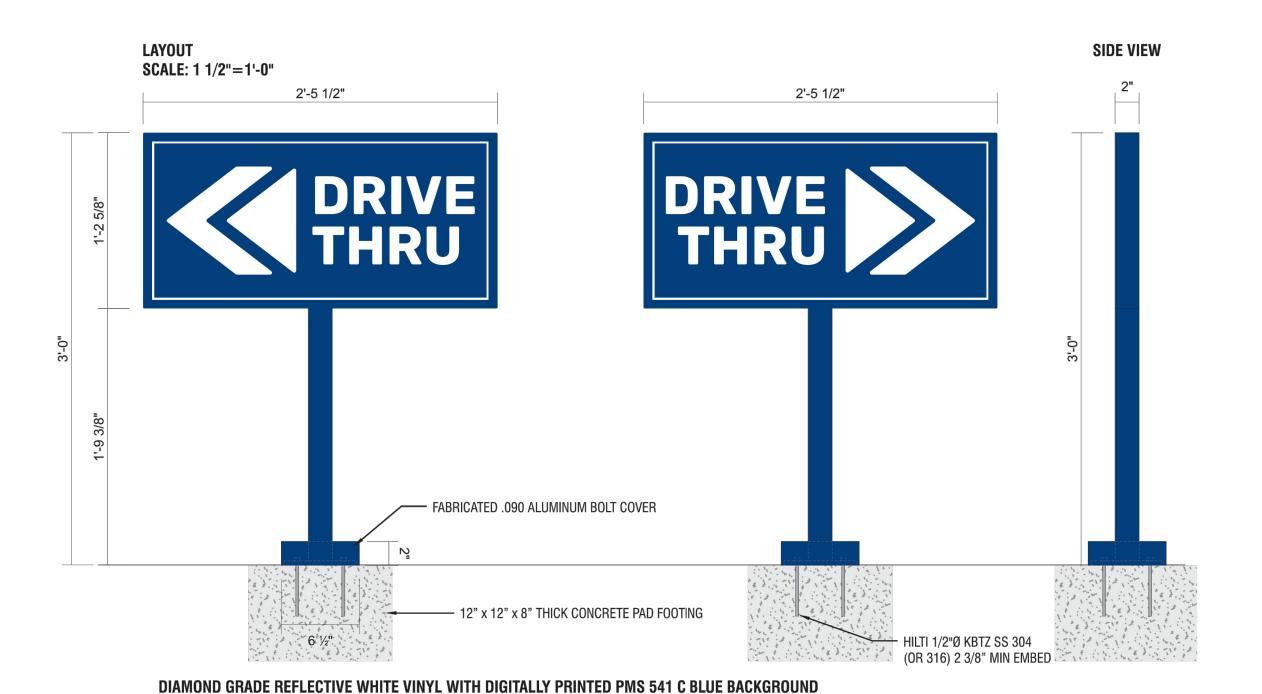

INSTALL PLATE-MOUNT SIGN WITH HILTI KWIK BOLTS PAD FOOTING INSTALLED BY GC NON-ILLUMINATED DIRECTIONAL SIGN W/ POST BY OTHERS- FOR REFERENCE ONLY

2" X 2" SQUARE TUBE ALUMINUM FRAME & POST WITH ALUMINUM FACES & 3/8" X 6" X 6" PLATE


FABRICATED .090 ALUMINUM BOLT COVER

PAINT PMS 541 C

# NOTES:

NOT TO SCALE

- 1. ALL SIGNAGE IS BY OTHERS/ SEPARATE SUBMITTAL; SHOWN HERE FOR REFERENCE ONLY.
- 2. REFER TO STRUCTURAL AND ELECTRICAL PLANS FOR ADDITIONAL INFO.

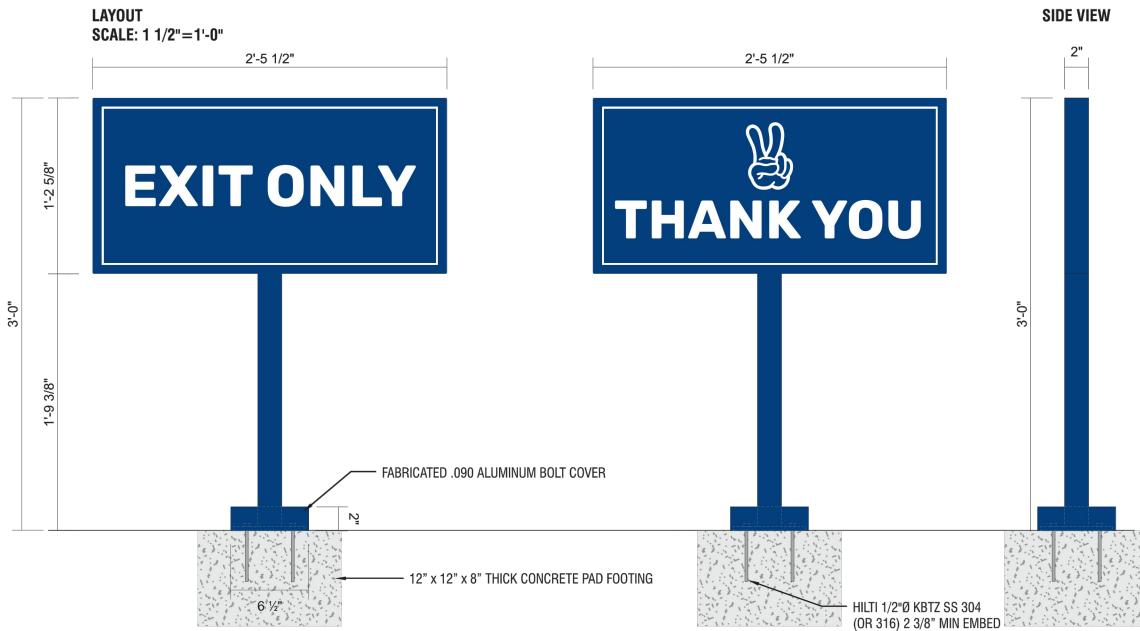



DIAMOND GRADE REFLECTIVE WHITE VINYL WITH DIGITALLY PRINTED PMS 541 C BLUE BACKGROUND 2" X 2" SQUARE TUBE ALUMINUM FRAME & POST WITH ALUMINUM FACES & 3/8" X 6" X 6" PLATE FABRICATED .090 ALUMINUM BOLT COVER PAINT PMS 541 C INSTALL PLATE-MOUNT SIGN WITH HILTI KWIK BOLTS


PAD FOOTING INSTALLED BY GC

ackslashnon-illuminated directional sign W/ Post by Others- for reference only



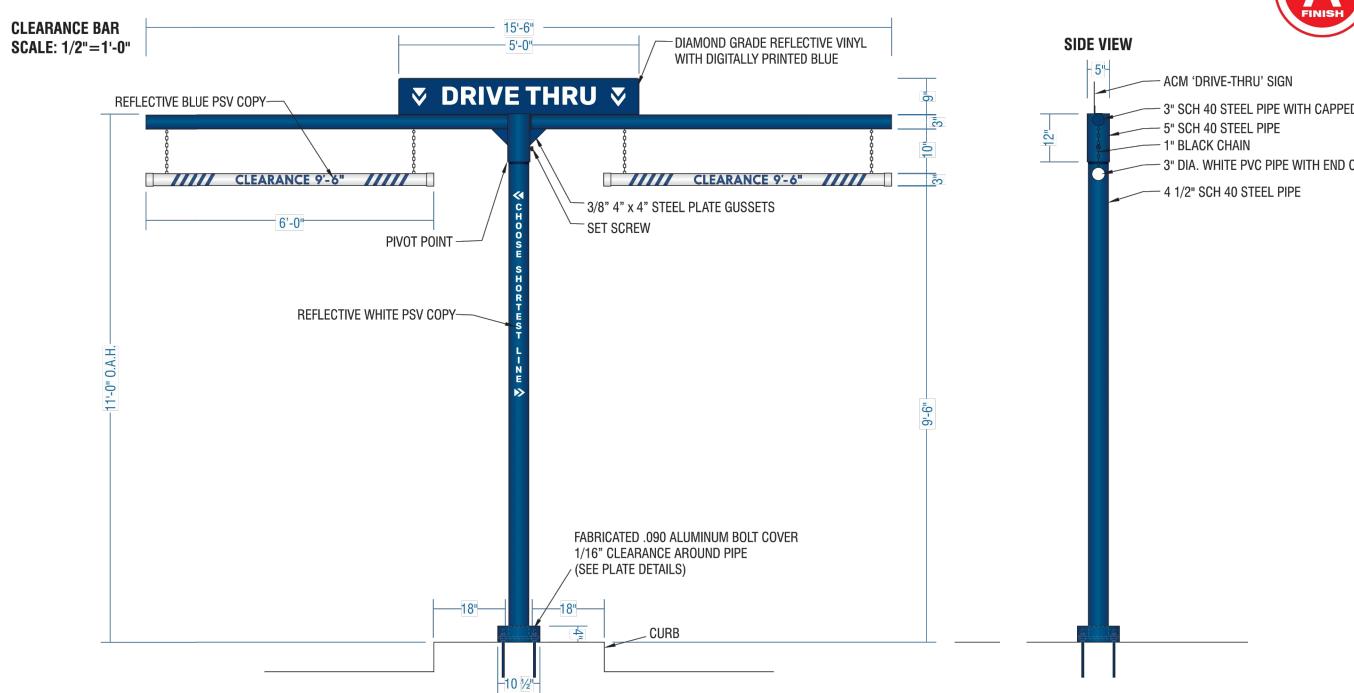

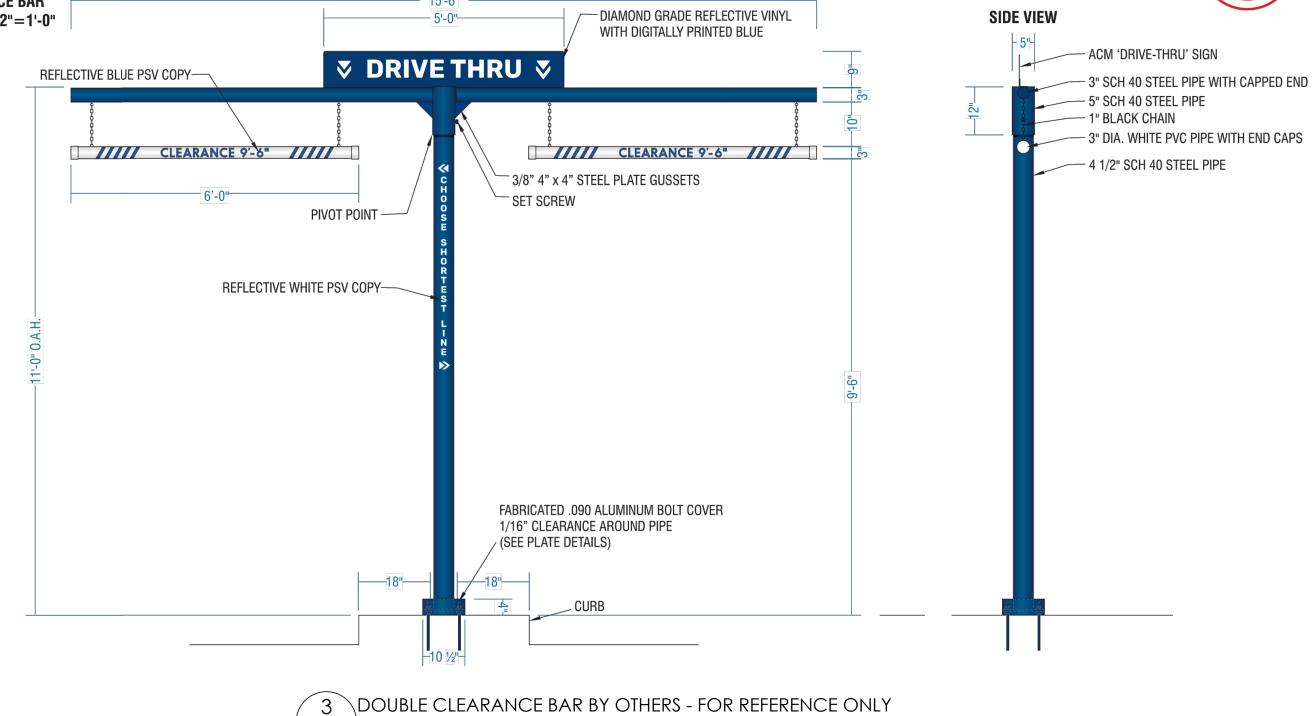

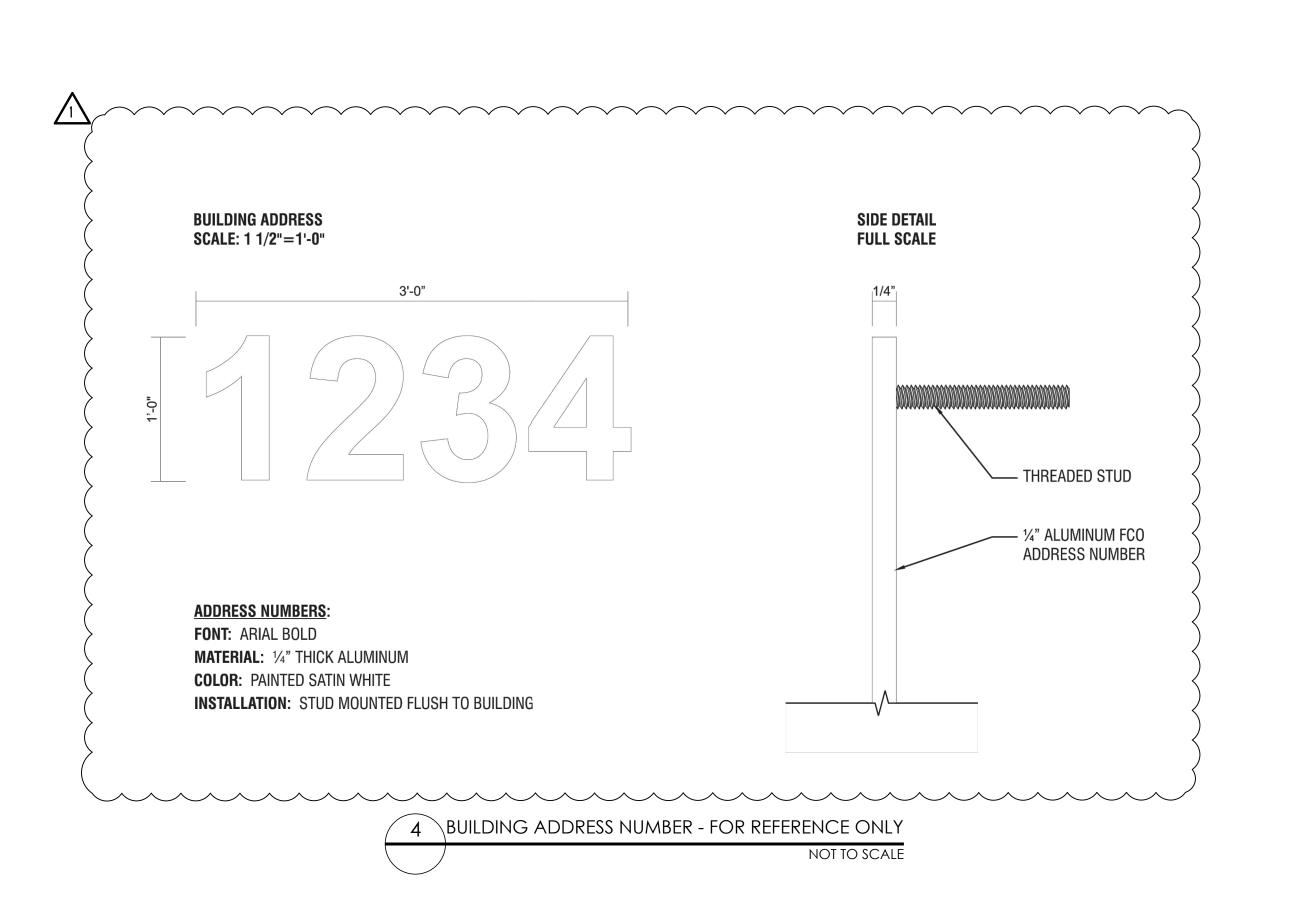



COR/LIC ARCHITECTURE

ARCHITECT CORALIC, LLC EDIN CORALIC

ST. LOUIS, MO 63123 p: 314.578.4953 e: edin@coralicarchitecture.com

9700 MACKENZIE ROAD, STE. 222,

STRUCTURAL ENGINEER JAMES C. KREHER JIM KREHER

208 N. MAIN STREET, COLUMBIA, IL 62236 p: 618.281.8505 jimk@kreherengineering.com

MEP ENGINEER Case Engineering DARRELL R. CASE 796 MERUS CT., FENTON, MO 63026 T. 636.349.1600 F. 636.349.1730

dcase@caseengineeringinc.com EDIN CORALIC ARCHITECT A-2013031004 - EXP. 12-31-2021

MISSOURI CERTIFICATE OF AUTHORITY NO. 2013041393

Stor 02 00

ISSUED FOR PERMIT: 10.11.2021

REV: DATE: DESCRIPTION: 1 10/14/21 CITY COMMENTS SHEET NAME:

SITE SIGNAGE DETAILS

SHEET NUMBER:

SP1.2

		LIGHTING F	TIXTURE	SCHED	ULE	
ID	MANUFACTURER	MODEL #	LAMPS	VOLTAGE	WATTAGE	REMARKS
L2	EIKO	SLM22-4CB-40K-U/09764 MV, 0-10V DIM	LED	120/277	30W	2x2 FLAT PANEL, LAYIN GRID CEILING, FROSTED LENS, LED 30W, 3750LM, 4000K, 0-10V DIM
L2E	EIKO	SLM22-4CB-40K-U/09764 MV, 0-10V DIM	LED	120/277	30W	2x2 FLAT PANEL, LAYIN GRID CEILING, FROSTED LENS, LED 30W, 3750LM, 4000K, 0-10V DIM, EMERGENCY BATTERY PACK
L3	NUVO	26W/LED/15/RND/FLUSH/3K/WH- 62-1191SP MV, 120V ELV DIM	LED	120/277	26W	16" DIA SURFACE J-BOX MOUNTED LED MILK-WHITE DIFFUSER, ROUND WHITE TRIM, 26W, 2000LM, 3000K ELV DIM
L4	TECH LIGHTING	700 OWVEX-9-3000K-4-H-UNV 120V NON-DIM	LED	120/277	19W	EXTERIOR LIGHT SCONCE, 5" SQUARE, 19W 600LM, 3000K, WET LOCATION, ADJUSTABLE UP/DOWN BEAM COLOR CHARCOAL
L5	LEKTRON	RIGID LED LASER/LEON LED SIMULATED NEON	LED	120/277	100W	RIGID SYSTEM BASED ON PHILIPS ADVANCED 100W, 24V OUTPUT LED DRIVER — LEDINTA0024V41FO APPROX 118FT PER STORE, 24V, 1.5W/FT, LOCATED INSIDE OF BUILDING, ACCESSIBLE LOCATION. USE USE TRANSFORMER SIZES PER RUNS/WIRING GROUPS—DEFAULT 180W. COORDINATE WITH SIGN COMPANY. SEE CONTACTS ON COVER SHEET.
L6	RAB	WPLED-26-Y/ESP MV, NON-DIM	LED	120/277	40W	EXTERIOR DECORATIVE WALLPACK, APPROX 40W, 5000LM, 3000K, W/EMERGENCY BACK UP, NO MOTION SENSOR OR PHOTOCELL
L7	SELF	CROWN-70-40K-110-S-SSP	LED	120/277	60W	6' WET LOCATION LINKABLE BATTEN STRIP, LED, HIGH— OUPUT, 60W, 6300LM, 4000K, INTEGRAL DRIVER
L8	NUVO	65-226 (CEILING MOUNT)	LED	120/277	13W	CEILING MOUNTED VAPOR PROOF FIXTURE, WITH GUARD, WILVER, LED, 13W, 850LM, 500K, WET LOCATION LISTED, FOR ELECTRICAL OR MECHANICAL ROOM.
L9	DMF LTG	DRD5S-4-R	LED	120/277	12W	4" ROUND CANOPY DOWNLIGHT
Р	IMPERIAL LTG	NV-1-T4-48L-1-40K-UNV-HSS WITH FSP-211 MOTION SENSOR & HOUSE SIDE SHEILD	LED	120/277	156W	SITE POLE HEAD, LED 156W, 9674LM, 4000K, DARK BRONZE, TYPE II DISTRIBUTION, WITH 17'POLE, VERIFY PER LOCAL REQUIREMENTS PRIOR TO ORDERING — WATTS/LUMINS, KELVIN LIGHT TEMPERATURE, TYPE DIST. MOUNTING CONFIG. SINGLE OR DOUBLE, COLOR AND HEIGHT DRILL HOLES IN POLES FOR HEADS IF REQUIRED IN FIELD VERIFY COLOR/HEIGHT BEFORE ORDERING.
Х	BEST	EZXTEU2RWEM MV,NON DIM, 4W	LED	120/277	30W	EXIT, SELF POWERED SINGLE/DOUBLE FACE, UNIVERSAL MOUNT, LED, RED ON WHITE, VERIFY COLORS
ЕМ	EM LITHONIA ELM2-LED-W		LED	120/277	1.8W	BUG EYE LED UNIT WITH WHITE FINISH.
	1	1		1	1	1

LED

120/277

--

COOLER LIGHT FIXTURE

. INSTALLATION OF LIGHT FIXTURES SHALL BE ACCORDING TO MANUFACTURER'S RECOMMENDATIONS AND APPLICABLE CODE REQUIREMENTS. B. VERIFY THE EXACT MOUNTING HEIGHT AND FINISH OF ALL LIGHTING FIXTURES WITH ARCHITECT PRIOR TO PLACING ORDER OR COMMENCING ROUGH-IN.

**ELECTRICAL LIGHTING PLAN** 

C. LIGHT FIXTURES SHALL BE PROVIDED BY THE ELECTRICAL CONTRACTOR. D. ALL MEANS OF EGRESS LIGHTING AND EXIT SIGNS SHALL HAVE A MINIMUM OF 90 MINUTES BACKUP POWER.

CL


\_\_

# PERIMETER LIGHT NOTE:

L5 - LED STRIP LIGHTING AT PERIMETER OF PARAPET 2, APPROX 118FT. RUN

### **KEYED NOTES**

- $\langle 1 \rangle$  lighting contactors and timeclock override switch. Refer to "Lighting" CONTROL DIAGRAM" ON THIS SHEET. COORDINATE LOCATION WITH OWNER'S REPRESENTATIVE PRIOR TO ROUGHIN.
- 2 POWER FOR PARAPET LIGHTING DRIVER. EC TO COORDINATE WITH LEKTRON FOR TRANSFORMER LOCATIONS.
- $\langle 3 \rangle$  LIGHTING CONTROL SWITCHBANK. LOCATION BY BACK DOOR.
- 4 PROVIDE "SENSOR SWITCH" CM ADC AUTOMATIC DAYLIGHTING PHOTOCELL AND PP-15 POWER PACK. SEE DETAIL #3 THIS SHEET.
- 5) EC TO CONNECT EMERGENCY BATTERY DRIVER, EXIT SIGNS, AND NL TO UNSWITCHED LEG OF LOCAL CIRCUIT INDICATED.
- 6 EC TO CONNECT FIXTURE LED DRIVER TO SWITCHED LEG OF CIRCUIT AND EMERGENCY BATTERY DRIVER TO UNSWITCHED LEG OF CIRCUIT. EMERGENCY BATTERY DRIVER ARE SHIPPED SEPARATELY AND ARE TO BE FIELD INSTALLED AND CONNECTED BY EC.
- 7 EC TO PROVIDE AQUITY BRANDS LOW VOLTAGE DUAL TECHNOLOGY CEILING ✓ MOUNTED OCCUPANCY SENSOR SWITCH CM-PDT9 & PP-15 POWER PACK. SENSOR SHALL ENERGIZE SWITCH FOR LOCAL CONTROL WHERE REQUIRED.
- 8 EC TO PROVIDE EXTERIOR OCCUPANCY SENSOR LISTED FOR OUTDOOR USE. COMPATIBLE WITH CANOPY LUMINARIES FOR AUTOMATIC DIMMING CONTROLS PER C130.2(c)3. SENSOR SHALL BE CAPABLE OF AUTOMATICALLY REDUCING LIGHTING BY 40% WHEN AREA IS UNOCCUPIED AND NO MORE THAN 90% WHEN OCCUPIED.
- 9 SEE KEYED NOTE #5 ON SHEET E2.01 FOR WALK-IN COOLER LIGHTING REQUIREMENTS.

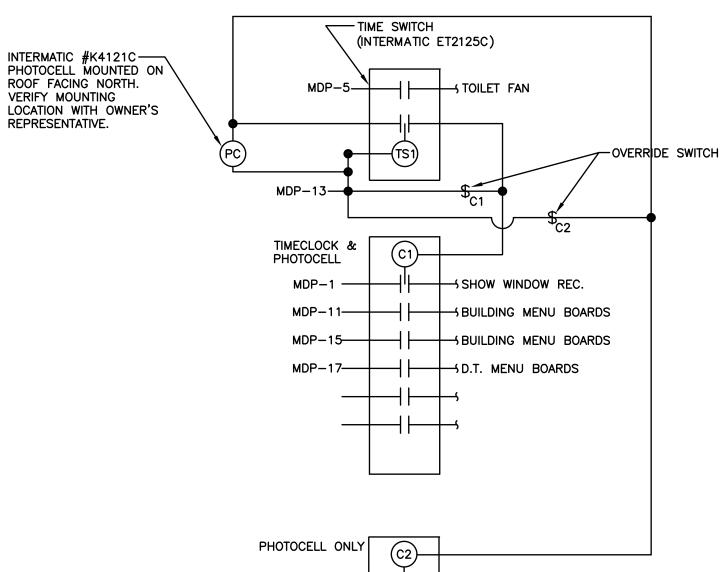

HOTOCELL ONLY	(C2)—	
MDP-3		BUILDING SIGN
MDP-4		PARKING LTG
MDP-6		PARKING LTG
MDP-9		PYLON SIGN
MDP-10		BUILDING LTG
MDP-12		PARAPET LTG
MDP-14		PARAPET LTG
MDP-16	$\vdash$	PARAPET LTG

CONTACTOR 'C1' TO BE PHOTOCELL ON AND TIMECLOCK OFF CONTACTOR 'C2' TO BE PHOTOCELL ON AND OFF

2 LIGHTING CONTROL DIAGRAM E1.01 SCALE: N.T.S.

### LIGHTING GENERAL NOTES

- A. CONNECT EXIT SIGNS, EMERGENCY AND NIGHT LIGHTS TO AN UNSWITCHED LIGHTING CIRCUIT, NOT CONTROLLED BY AN Y OCCUPANCY SENSORS, SWITCHES OR CONTACTORS.
- B. PROVIDE A DEDICATED NEUTRAL WITH ALL DIMMING SYSTEM CIRCUITS, NO COMMON NEUTRALS SHALL BE ALLOWED.
- . REFER TO ARCHITECTURAL REFLECTED CEILING PLAN AND DETAILS FOR THE EXACT LOCATION OF ALL LIGHTING FIXTURES AND ANY OTHER EQUIPMENT INSTALLED IN THE CEILING SYSTEM. VERIFY EXACT MOUNTING HEIGHTS AND FINISHES WITH ARCHITECT PRIOR TO ROUGH-IN.
- D. REFER TO THE POWER PLANS FOR LOCATIONS OF ELECTRICAL EQUIPMENT.
- E. PROVIDE (2)ADDITIONAL #12 CONDUCTORS FOR ALL 0-10V DIMMING
- 7. 15" MIN TO BOTTOM OF ALL ROUGH-IN BOXES FOR USER CONTROLLED SWITCHES, OUTLETS ETC. AND 48" MAX TO TOP OF ROUGH-IN BOX.
- G. 48" TO TOP OF ROUGH-IN BOX.

## ELECTRICAL SYMBOLS

SYMBOL

HOME RUN TO PANEL. CIRCUIT NUMBERS, PHASE, NEUTRAL AND GROUND CONDUCTORS INDICATED ALONG WITH ISOLATED GROUND CONDUCTOR IF APPLICABLE PARTIAL CIRCUIT

SINGLE POLE SWITCH, +3'-10" OR AS NOTED

DESCRIPTION

DOUBLE POLE, SINGLE THROW SWITCH, +3'-10" OR AS NOTED

THREE-WAY SWITCH, +3'-10" OR AS NOTED

DIMMER, +3'-10" OR AS NOTED

WALL MOUNTED OCCUPANCY SENSOR, +3'-10" OR AS NOTED WALL MOUNTED OCCUPANCY SENSOR, +3'-10" OR AS NOTED, CONTROLLED BY

ROOM CONTROLLER CEILING MOUNTED OCCUPANCY SENSOR

CEILING MOUNTED OCCUPANCY SENSOR, CONTROLLED BY ROOM CONTROLLER

CEILING MOUNTED INTERIOR DAYLIGHT HARVESTING PHOTOCELL SENSOR CONTROLLED BY ROOM CONTROLLER

POWER PACK, INSTALLED ABOVE ACCESSIBLE CEILING

DUPLEX RECEPTACLE, +18" OR AS NOTED

GFI DUPLEX RECEPTACLE +18" OR AS NOTED

QUADPLEX RECEPTACLE, +18" OR AS NOTED GFI QUADPLEX RECEPTACLE, +18" OR AS NOTED

GROUND FAULT INTERRUPTING RECEPTACLE, +18" OR AS NOTED

WEATHERPROOF GROUND FAULT INTERRUPTING RECEPTACLE, +18" OR AS NOTED

SPECIAL RECEPTACLE, NEMA STYLE AS NOTED, +18" OR AS NOTED

USB CHARGING DUPLEX RECEPTACLE, +18" OR AS NOTED

RECEPTACLE INSTALLED FLUSH IN CEILING

SWITCHED RECEPTACLE FOR INTERIOR SIGNAGE, +100" OR AS NOTED, LABEL RECEPTACLE ACCORDINGLY

> SWITCHED RECEPTACLE FOR PARTY LIGHTS, +100" OR AS NOTED, LABEL RECEPTACLE ACCORDINGLY

JUNCTION BOX

DISCONNECT SWITCH, TOP AT +6'-0" OR AS NOTED

DISCONNECT SWITCH PROVIDE WITH EQUIPMENT

LIGHTING CONTACTOR, INSTALLED AS NOTED

TIME CLOCK, +6'-2" OR AS NOTED

EXTERIOR PHOTOCELL, INSTALLED ON ROOF FACING NORTH ROOM CONTROLLER

PLUG LOAD CONTROLLER

ELECTRICALLY OPERATED DAMPER, PROVIDED BY MECHANICAL CONTRACTOR, WIRE BY ELECTRICAL CONTRACTOR

THERMOSTAT, TEMPERATURE SENSOR, CARBON DIOXIDE SENSOR AND HUMIDISTAT (T)(S)(C)(H)

PUSHBUTTON, TOP AT +4'-6" OR AS NOTED

DOOR BELL CHIME, +8'-0" OR AS NOTED

TELEPHONE/DATA OUTLET, +18" WITH 1" CONDUIT TO ABOVE CEILING

DATA OUTLET, +18" WITH 3/4" CONDUIT TO ABOVE CEILING MOUNTING HEIGHT ABOVE FINISHED FLOOR TO CENTERLINE OF DEVICE

**TYPICAL** 

TYP.

FIRE ALARM CONTROL PANEL, FLUSH MOUNTED, TOP AT +6'-0"

MANUAL FIRE ALARM PULL STATION, +3'-10" PER ADA

FIRE ALARM HORN/STROBE, +80" TO BOTTOM OF DEVICE PER ADA

EXTERIOR WEATHERPROOF FIRE ALARM HORN, +10'-0" AFG

STROBE ONLY, +80" TO BOTTOM OF DEVICE PER ADA

FIRE ALARM HORN/STROBE, CEILING MOUNTED

STROBE ONLY, CEILING MOUNTED

AREA TYPE PHOTOELECTRIC SMOKE DETECTOR WITH SAMPLING TUBES AND REMOTE

INDICATOR LIGHT MOUNTED FLUSH IN CEILING BELOW DETECTOR

3 DAYLIGHT ZONE WIRING DIAGRAM

E1.01 SCALE: N.T.S.



**ARCHITECT** CORALIC, LLC

EDIN CORALIC 9700 MACKENZIE ROAD, STE 222

ST. LOUIS, MO 63123 p: 314 578 4953 edin@coralicarchitecture.com

STRUCTURAL ENGINEER JAMES C. KREHER

JIM KREHER 208 N. MAIN STREET, COLUMBIA, IL 62236

p. 618.281.8505 jimk@kreherengineering.com

MEP ENGINEER Case Engineering

DARRELL R. CASE 796 MERUS CT., FENTON, MO 63026 T. 636.349.1600 F. 636.349.1730

dcase@caseengineeringinc.com

10.14.2021



0 0 nip Brc St.

**ISSUED FOR PERMIT:** 10.11.2021

REV: DATE: DESCRIPTION: 01 10.14.21 CITY COMMENTS

SHEET NAME:

PLAN

LIGHTING

SHEET NUMBER:

	PLUMBING SYMBOLS LEGEND
— G —	GAS PIPING
— CD —	CONDENSATE DRAIN PIPING
	COLD WATER PIPING
-	HOT WATER PIPING (140°)
	HOT WATER RECIRCULATING PIPING
-SAN-	SANITARY WASTE PIPING
—FW—	FILTERED WATER PIPING
—140° —	140° WATER PIPING
— GW—	GREASE WASTE PIPING
	SANITARY VENT PIPING
VTR	VENT THROUGH ROOF
<del></del>	PLUMBING TRAP
<b>-</b>	PIPE TURNING DOWN
<u> </u>	PIPE TURNING UP
<u></u>	CHECK VALVE
$\overline{}$	UNION
AFF	ABOVE FINISHED FLOOR
CO	CLEAN OUT
<u> </u>	PRESSURE REGULATING VALVE (PRV) (50 PSI)
<del></del>	BALL VALVE
Ø	BALANCE VALVE
EWF	ELECTRIC WATER FOUNTAIN
GCO	GRADE CLEAN OUT
<del>- 2</del>	CIRCUIT SETTER BALANCE VALVE
lacktriangle	POINT OF CONNECTION
<b>⟨F</b> ⟩	BELOW FLOOR
<b></b>	ABOVE CEILING
— PD —	PUMP DISCHARGE

GENERAL NOTES:

1. EXACT LOCATION OF PLUMBING FIXTURES SHALL BE DETERMINED FROM ARCHITECTURAL DRAWINGS.

- 2. BEFORE SUBMITTING BID, THE PLUMBING CONTRACTOR SHALL REVIEW THE ARCHITECTURAL DRAWINGS AND INCLUDE IN HIS BID AN AMOUNT TO FURNISH AND INSTALL ANY FIXTURES WHICH ARE SHOWN IN ADDITION TO FIXTURES SHOWN ON THE PLUMBING DRAWINGS.
- 3. CONTRACTOR SHALL VERIFY INVERT ELEVATION OF SEWERS TO WHICH NEW WASTE LINES ARE TO BE CONNECTED BEFORE MAKING UP OR INSTALLATION OF NEW WASTE SYSTEM.
- 4. CONTRACTOR SHALL VERIFY AND COORDINATE LOCATION OF ALL PLUMBING LINES WITH DUCTWORK AND ELECTRICAL
- 5. THE INSTALLATION OF ALL VALVES, UNIONS, THERMOMETERS, GAUGES, OR OTHER INDICATING OR RECORDING EQUIPMENT, OR SPECIALTIES REQUIRING FREQUENT READING, REPAIRS, ADJUSTMENT, INSPECTION, REMOVAL OR REPLACEMENT SHALL BE CONVENIENTLY AND ACCESSIBLY LOCATED WITH REFERENCE TO THE FINISHED
- 6. WHERE POSSIBLE, THE VENTS TOGETHER SO THAT A MINIMUM NUMBER TERMINATE THROUGH THE ROOF.
- 7. WATER CLOSETS IN PUBLIC TOILET ROOMS SHALL CENTER ON THE FINAL LAYOUT OF TOILET PARTITIONS.
- 8. ALL VENTS THROUGH ROOF SHALL BE AT LEAST 10' REMOVED FROM ALL AIR INTAKES, EVAP. COOLERS.
- 9. CONTRACTOR SHALL NOT CUT HOLES IN STRUCTURAL MEMBERS WITHOUT FIRST SECURING WRITTEN APPROVAL
- 10. CONTRACTOR SHALL INSTALL DIELECTRIC UNIONS AT CONNECTION OF DISSIMILAR METALS.
- 11. CONTRACTOR SHALL ROUGH-IN ALL WASTE AND SUPPLIES TO SPECIAL EQUIP. ACCORDING TO MANUFACTURERS SHOP DRAWINGS AND MAKE FINAL CONNECTIONS ALL SUPPLIES SHALL BE VALVED.

12. ASSUMED WATER PRESSURE-CONTRACTOR SHALL VERIFY

- ACTUAL WATER PRESSURES PRIOR TO CONSTRUCTION. IF PRESSURE IS LESS THAN 60 PSI, CONTRACTOR SHALL CONTACT THE ENGINEER FOR PIPE SIZING EVALUATION. IF PRESSURE EXCEEDS 80 PSI, A PRESSURE REDUCING VALVE SHALL BE PROVIDED. PIPING VELOCITY SHALL NOT EXCEED 8 FPS AND HOT WATER VELOCITY SHALL NOT EXCEED 5FPS.
- FIELD VERIFICATION NOTES: 1. THE PLUMBING CONTRACTOR SHALL VISIT THE SITE PRIOR TO BID TO FIELD VERIFY ALL EXISTING CONDITIONS WHICH MAY AFFECT HIS BID. THE FOLLOWING ITEMS SHALL BE VERIFIED. 1.A.EXACT PLACEMENT SIZE CAPACITY MANUFACTURER AND CONDITION OF ALL EXISTING PLUMBING EQUIPMENT WITHIN

WASTE, VENT AND WATER PIPING.

2. ALL REFERENCES ON THESE DRAWINGS TO EXISTING EQUIPMENT, WATER IS THE RESPONSIBILITY OF THE CONTRACTOR TO VERIFY ALL THESE ITEMS PRIOR TO BID AND INCLUDE IN HIS BID ANY AND ALL AMOUNTS REQUIRED TO ACCOMMODATE EXISTING CONDITIONS.

SCOPE OF WORK, WHETHER SPECIFICALLY SHOWN OR NOT. 1.B.SIZE AND LOCATION OF ALL EXISTING WASTE, GREASE

- 3. NO ALLOWANCES WILL BE MADE AFTER THE PROJECT HAS BEEN AWARDED FOR FAILURE TO VERIFY EXISTING CONDITIONS.
- 4. ANY DISCREPANCIES WHICH MAY AFFECT THE CONTRACTOR BID SHALL BE BROUGHT TO THE ATTENTION OF THE ENGINEER AND ARCHITECT FOR DIRECTION.
- 5. PLUMBING ROUTINGS BASED ON OWNER'S SCHEMATICS OF LOCATION OF EXISTING FIXTURES AND SHELL DRAWINGS. CONTRACTOR RESPONSIBLE FOR VERIFICATION OF ACTUAL LOCATION OF SUPPLY LINES AND MAKING APPROPRIATE ADJUSTMENTS TO ACTUAL CONDITIONS IN THE FIELD.
- 6. PRIOR TO CONSTRUCTION, VERIFY THE LOCATION OF THE HVAC/WALK-IN CONDENSATE FLOOR SINK. IF SLOPE AND DISTANCE OR IF IT IS INFEASIBLE TO DISPOSE OF WALK-IN COOLER CONDENSATE. USE A CONDENSATE PUMP.

		PLUM	BING	FIXT	JRE S	SCHE	DULE
DESIGNATION	MODEL NUMBER	MFR.	COLD	HOT WATER	WASTE	VENT SIZE	REMARKS
P-1	WATER CLOSET K-3619 ADA COMPLIANT ELONGATED BOWL	KOHLER	1/2"	-	4"	2"	18" HIGH BOWL CSEAT AND CAP BOLTS. 1.28 GAL PER FLUSH INSTALL WITH ANGLE STOP. PROVIDE "WHITE" COLOR SELECTION FOR CHINA.
P-2	LAVATORY SINK K-2030 ADA COMPLIANT	KOHLER	1/2"	<i>1</i> / <sub>2</sub> "	2"	2"	DELTA FAUCET 501LF-HGMHDF SINGLE LEVER WITH 0.5 GPM VANDAL RESISTANT AERATOR, GRID STRAINER TAILPIECE, OFFSET WHEELCHAIR TRAP LOOSE KEY STOP INSTALL HANDLE LIMIT STOP KIT WITHIN SINGLE LEVEL MIXING FAUCET TO LIMIT OUTLET HOT WATER SUPPLY TO 110°F.
P-3	WATER FILTER BY OWNER	EVERPURE	1½"	-	-	-	PLUMBING CONTRACTOR SHALL INSTALL WATER FILTER SUPPLIED BY OWNER. PROVIDE WITH BALL ISOLATION VALVE AND UNION ON BOTH ENDS OF ALL CONNECTIONS PROVIDE RPZ WITH DRAIN CUP IF REQUIRED BY CODE.
P-6	WATER HEATER - TANK DEN-52	AO SMITH	1"	1"	-	-	ELECTRIC - 10KW/3PHASE
P-7	HAND SINK 7-PS-56	ADVANCE TABCO	1/2"	1/2"	2"	2"	PROVIDED BY DBC, INSTALLED BY GC.
P-8	3 COMPARTMENT SINK BY OWNER	-	1/2"	1/2"	(3)2"	-	PLUMBING CONTRACTOR TO PROVIDE ½" CW AND ½" HW SUPPLY LINES WITH ANGLE VALVE SHUOFF AND SUPPLY STOPS TO SINK FAUCET. PLUMBING CONTRACTOR TO PROVIDE (3) 2" WASTE LINES FROM EACH BAY AND INDIRECT WASTE TO FLOOR SINK BELOW. PROVIDE FISHER 34271 FAUCET AND 24090 WASTE DRAIN WITH STRAINERS, INSTALLED BY PC.
P-9	PULL-OUT SPRAYER HANDLE MPZ-4DLN-06	T&S (T&SBRASS. COM)	-	-	-	-	TO BE INSTALLED IN DB PROVIDED STAINLESS STEEL TABLE BY PC.
P-10	MOP SINK Z1996-24	ZURN	3/4"	3/4"	3"	2"	MOP SERVICE BASIN WITH 10" HIGH WALLS 3" DRAIN , FIAT 830-AA SERVICE FAUCETS WITH VACUUM BREAKER, INTEGRAL STOPS AND HOSE WITH HOSE BRACKET.
P-11	FLOOR SINK Z1900	ZURN	-	-	4"	2"	12" X 12" X 6" DEEP CAST IRON BODY WITH WHITE PORCELAIN ENAMEL
P-12	FLOOR DRAIN EZ-5	ZURN	-	-	2"	2"	POLISHED BRASS STRAINER, AND TRAP PRIMER. LOCATE PRIMER WITH SHUT-OFF VALVE AND ACCESS PANEL IN WALL. COORDINATE WITH GENERAL CONTRACTOR.
P-13	GREASE INTERCEPTOR GB-50	SCHIER	-	-	4"	2"	SCHIER GB-50 50GPM BELOW-GRADE AT EXTERIOR VENTED THROUGH BUILDING, PROVIDE HI TRAFFIC COVER AND ACCESS. FINAL SIZE TO BE COORDINATED WITH LOCAL AUTHORITY.
P-14	ROOF DRAIN Z165	ZURN	-	-	3"	1	REFER TO ARCHITECTURAL SHEET A4.0 FOR ROOF DRAIN LOCATIONS AND DETAILS.
P-15	WALL HYDRANT HY-420-8	WATTS	1/2"	-	-	-	6" NON-FREEZE WALL HYDRANT, MOUNT AT 24"A.F.F. AT REAR ELEVATION.
P-16	YARD HYDRANT EVERBILT	WATTS	1/2"	-	-	-	FROST PROOF 2FT. BURY DEPTH
P-17	CIRCULATING PUMP 0010	TACO	-	-	-	-	115V, 3250 RPM, PROVIDE WITH AQUASTAT AND/OR TIMER AS REQUIRED.
P-18	BOOSTER PUMP AQUAVAR BAQUABII 1151AB25HM03	AQUAVAR	1-1/4"	-	-	-	1 HP VARIABLE SPEED CONTROLLER, 115V INPUT, 30 GPM @ 35 PSI BOOST. PROVIDE ALL NECESSARY VALVES AND ACCESSORIES RECOMMENDED BY MANUFACTURER FOR A COMPLETE SYSTEM.

SANITARY SIZING CALCULATION												
FIXTURE DESIGNATION DFU QUANTITY TOTAL												
WATER CLOSET	P-1	4	1	4								
LAVATORY	P-2	1	1	1								
FLOOR DRAIN	P-12	5	1	5								
3 COMP SINK	P-8	6	1	6								
FLOOR SINK	P-11	6	5	30								
HAND SINK	P-7	2	2	4								

TOTAL (DFU)

53

P-10

MOP SINK

KITCHEN FIXTURE SCHEDULE												
DESIGNATION	MFR. AND MODEL NUMBER	COLD WATER	FILTERED COLD WATER	HOT WATER	WASTE	VENT SIZE	REMARKS					
	DIPPERWELL FAUCET & SINK ASSEMBLY	1/2"	-	-	1/2"		SET INTO PRE-CUT HOLE IN COUNTER. CONNECT CW BRAIDED STAINLESS TO FAUCET AND PVC DRAIN TO WELL. PIPE DRAIN STRAIGHT BACK TO WALL, DOWN WALL, THEN FORWARD BETWEEN WHEELS OF ICE BIN BRACED TO FLOOR WITH UNISTRUT AND A 1" AIR GAP OVER FLOOR SINK					
	RAPID RINSE STATION BY OWNER	-	-	-	3/4"		PLUMBING CONTRACTOR TO PROVIDE $\frac{1}{2}$ " HW LINE WITH BALL VALVE SHUT-OFF. PROVIDE FINAL COLD WATER CONNECTION TO RAPID RINSE STATION. PROVIDE $\frac{3}{4}$ INDIRECT WASTE LINE TO FLOOR SINK BELOW. (PROVIDE RPZ IF REQUIRED BY LOCAL CODE)					
EQ-1	ESPRESSO MACHINE (3 MACHINE GROUP+1 OPTIONAL) BY OWNER	-	(4)½"	-	(3)¾"		CONTRACTOR TO PROVIDE $\frac{1}{2}$ " FW LINE WITH BRAIDED FLEX HOSE AND BALL VALVE SHUT-OFF. PROVIDE $\frac{3}{4}$ " INDIRECT WASTE LINE TO FLOOR SINK BELOW. TYPICAL OF 3 MACHINES IN GROUP.					
L( ) '3	BUNN WATER DISPENSER BY OWNER	-	(4)½"	-	-		CONTRACTOR TO PROVIDE $\frac{1}{2}$ " FW WITH BALL VALVE SHUT-OFF. SUPPLIED WITH ASSE 1022 INLINE CARTRIDGE BACKFLOW.					
<b>⊢</b> ( )_/I	GLASS FILLER BY OWNER	-	(4)½"	-	-	-	½" FILTER WATER SUPPLY - NO DRAIN REQUIRED					
⊢( )_X	ICE MACHINE BY OWNER	1/2"	-	-	3⁄4"		PROVIDE FINAL COLD WATER CONNECTION TO ICE MACHINE FILTER EQ-8B. PROVIDE (I) INDIRECT WASTE LINE TO FLOOR SINK BELOW. BACKFLOW ON FILTER ASSEMBLY IF REQUIRED. NOTE: PC AND EC TO PROVIDE ADDITIONAL OUTLET AND WATERLINE STOP FOR FUTURE 2ND ICE MACHINE.					
EQ-8B	ICE MACHINE WATER FILTER PENTAIR EVERPURE EV9293-22	1/2"	-	-	-	-	PROVIDE 1/2" COLD WATER TO ICE MACHINE FILTER.					
	ICE STORAGE BIN BY OWNER	-	-	-	3⁄4"	-	PROVIDE $\frac{3}{4}$ " INDIRECT WASTE LINE TO FLOOR SINK BELOW.					

- 1. PLUMBING CONTRACTOR SHALL STRAP UP ALL SUPPLY LINES TIGHT TO STAINLESS TABLES WITH ZIPTIES SO THAT UNDER COUNTER EQUIPMENT CAN BE REMOVED
- WITHOUT GETTING CAUGHT IN THE BRAIDED STAINLESS SUPPLY LINES. 2. PLUMBING CONTRACTOR SHALL RUN DRAINS OFF OF STAINLESS TABLES AND DRINK EQUIPMENT IN RIGID COPPER PIPE. DRAINS ARE TO BE RUN TOWARD THE CENTER OF THE FLOOR SINK BENEATH EACH TABLE. DRAINS WILL FIT BETWEEN THE WHEELS OF THE ROLLING ICE BINS. PC TO STRAP DRAINS TO FLOOR WITH

3. ALL EXPOSED WATER LINES ARE TO BE RIGID COPPER.

PRESSURE DROP THRU METER

METER TO BACKFLOW

PRESSURE DROP THRU FRICTION LOSS FROM

PRESSURE DROP DUE TO ELEVATION TO PUMP

PRESSURE DROP THRU BACKFLOW AND STRAINER

4. ALL SHUT OFF VALVES ARE TO BE COLORED BALL VALVES (DOMESTIC-BLUE, HOT-RED, FILTERED-WHITE) AND LABELED FOR EACH PIECE OF EQUIPMENT THAT IT SUPPLIES. NO ANGLE STOPS.

WATER PRESSURE CA	ALCULATION
STATIC PRESSURE	60
PRESSURE DROP THRU FRICTION LOSS FROM MAIN TO METER (12" WATER LINE)	C

PRESSURE AVAILABLE @ P	22.5					
PRESSURE AVAILABLE AFT	57.5					
PRESSURE NEEDED AT FIX	TURES		35.0			
PRESSURE DROP DUE TO E	ELEVATION		4.0			
REMAINING PRESSURE			26.5			
SYSTEM LENGTH			150			
EQUIVALENT PIPE LENGTH		187.50	FT			
ALLOWABLE LOSS PER 100	FT OF PIPE:	26.5PSI X 100FT 187.50 FT	14.1			
FIX	TURE UNITS DOMESTIC WA	TER				
FIXTURES	FIXTURES QUANTITY					
HAND SINK	2	2	2			
LAVATORY	1	1	1			
WATER CLOSET	1	3	0			
3-COMP	1	3	3			
MOP SINK	1	3	3			
WATER DISPENSER	4	4	0			
ESPRESSO MACHINE (3 MACHINE GROUP)	4	12	0			
ICE MAKER	1	1	0			
RAPID RINSE	5	5 0				
TO	TAL	34	9			
GF	20	9				

# FORMULA FOR SIZING GREASE INTERCEPTORS

INTERIOR/EXTERIOR IN-FLOOR GREASE INTERCEPTORS Length X Width X Depth/231= Gallons X .75 Fill Factor X Number of Compartments= Size of Grease Interceptor (GPM) Discharge from 3-Compartment Sink

Compartment Deminsions: 16" X 14" X 14" / 231 = 20 X .75 Fill Factor X 3 Compartments = 31 Gal

Total GPM / Retention Time GREASE WASTE SIZE: 4" 31 Gal / 1 Min = 31 GPM

FIXTURE	Y	JMBER OF	- X	FIXTURE VALUE UNIT	ΤΟΤ	AL FIXTURI UNITS	ES <sub>/</sub>	2 DFU PER GPM	= FLO	W RATING GPM
* FLOOR FIXTURES	x	6	х	3	=	18	/	2	=	9
HAND SINKS	х	2	Х	2	=	4	1	2	=	2.0
SERVICE BASIN	х	1	Х	3	=	3	1	2	=	1.5
			TOTAL	REQUIRED F	LOW	RATING GI	⊃M	= .	43.5	

\*FLOOR SINKS RECEIVING DISCHARGE FROM COMPARTMENT SINK(S), NOT COUNTED. REFER TO VOLUME CALCULATION FOR SINKS IN



ARCHITECT CORALIC, LLC EDIN CORALIC 9700 MACKENZIE ROAD, STE 222 ST. LOUIS, MO 63123

p: 314.578.4953

edin@coralicarchitecture.com STRUCTURAL ENGINEER JAMES C. KREHER JIM KREHER 208 N. MAIN STREET, COLUMBIA, IL 62236

p: 618.281.8505 jimk@kreherengineering.com MEP ENGINEER Case Engineering

DARRELL R. CASE 796 MERUS CT., FENTON, MO 63026 T. 636.349.1600 F. 636.349.1730 dcase@caseengineeringinc.com

10.14.2021



St  $\bigcirc$ 


ISSUED FOR PERMIT: 10.11.2021

REV:	DATE:	description:
01	10.14.21	CITY COMMENTS

PLUMBING SPECIFICATIONS & **SCHEDULES** 

SHEET NUMBER:

SHEET NAME:

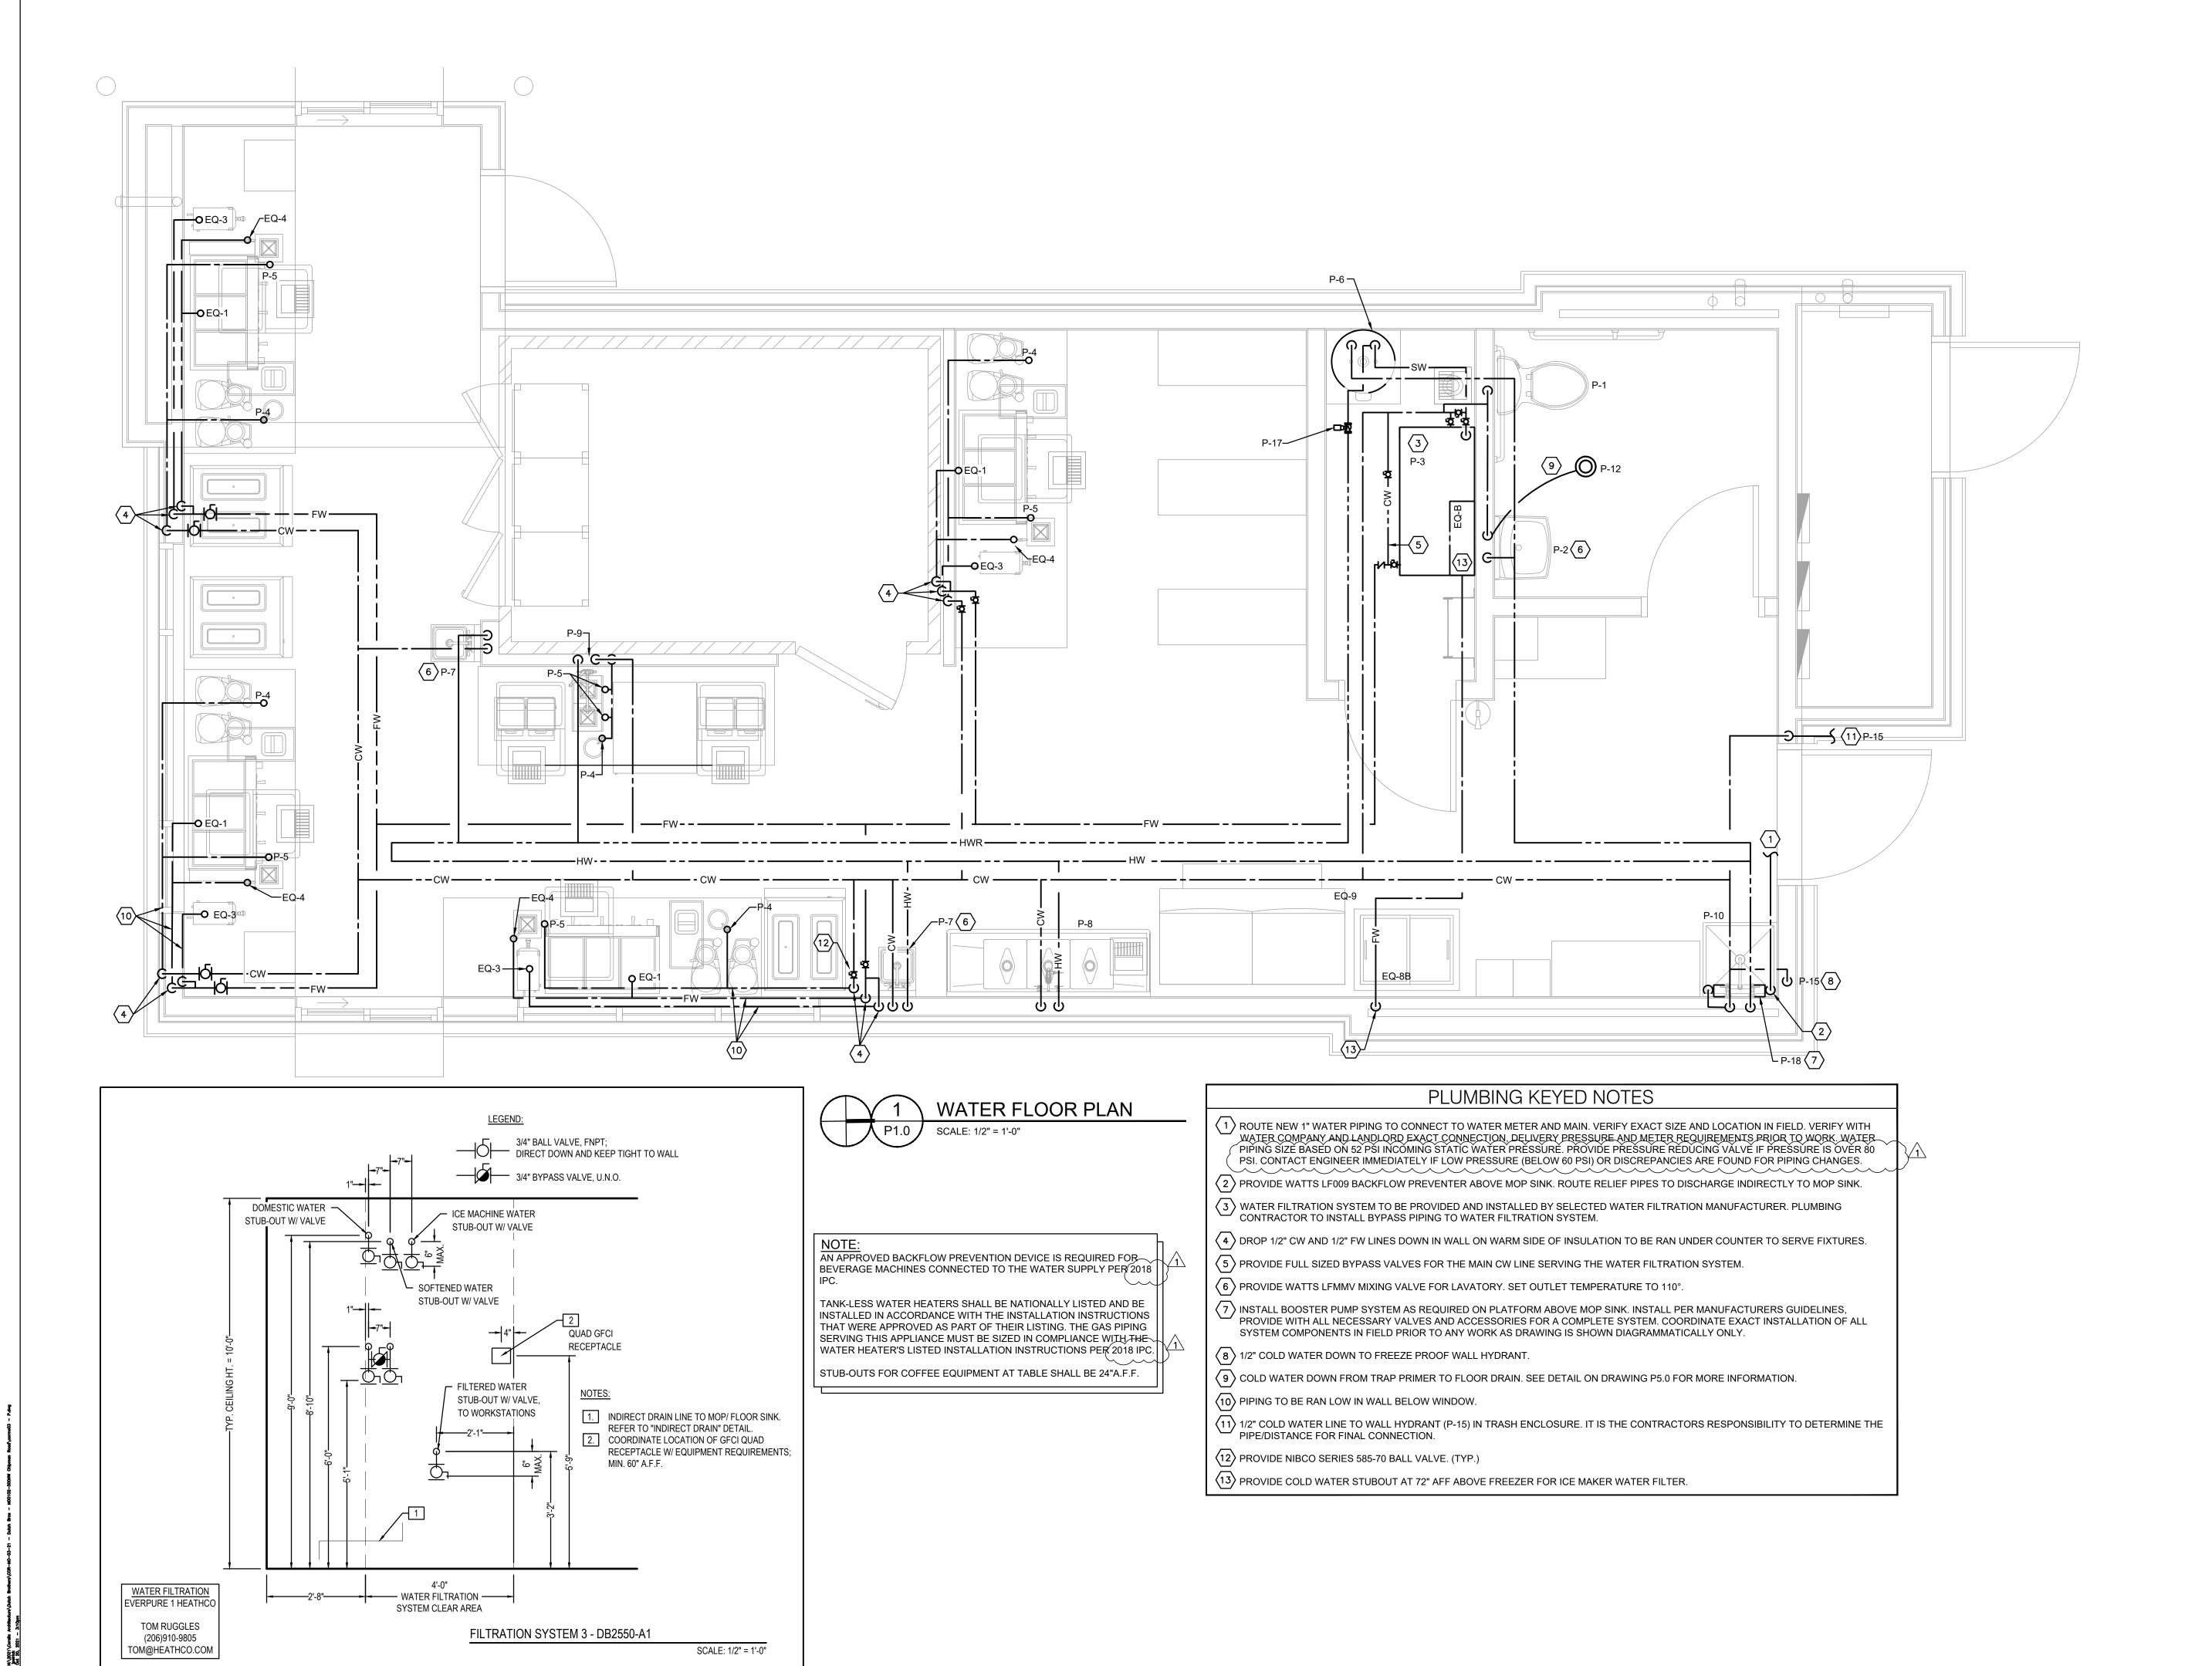





ARCHITECT
CORALIC, LLC

EDIN CORALIC 9700 MACKENZIE ROAD, STE 222 ST. LOUIS, MO 63123

p: 314.578.4953 edin@coralicarchitecture.com STRUCTURAL ENGINEER

STRUCTURAL ENGI JAMES C. KREHER JIM KREHER 208 N. MAIN STREET,

COLUMBIA, IL 62236 p: 618.281.8505 jimk@kreherengineering.com

MEP ENGINEER
Case Engineering
DARRELL R. CASE
796 MERUS CT.,

FENTON, MO 63026 T. 636.349.1600 F. 636.349.1730 dcase@caseengineeringinc.com

10.14.2021



**O:** MO0102 e - New Freestanding Store

0 NW Chipman Road. Le : Dutch Bros Coffee

ISSUED FOR PERMIT: 10.11.2021

REV: DATE: DESCRIPTION:
01 10.14.21 CITY COMMENTS

SHEET NAME:

PLUMBING SUPPLY FLOOR PLAN AND DETAILS

SHEET NUMBER:

P3.0

- 1. DRAWINGS AND GENERAL PROVISIONS OF THE CONTRACT, INCLUDING GENERAL AND SUPPLEMENTARY CONDITIONS AND ALL OTHER SPECIFICATION SECTIONS, APPLY TO ALL SECTIONS OF DIVISION 15000. 2. THE CONTRACTOR FOR THIS DIVISION OF WORK IS REQUIRED TO READ THE SPECIFICATIONS AND REVIEW THE DRAWINGS FOR ALL DIVISIONS OF WORK PRIOR TO BEGINNING WORK AND IS RESPONSIBLE FOR THE COORDINATION OF HIS/HER WORK AND THE WORK OF HIS/HER SUBCONTRACTORS WITH ALL DIVISIONS OF WORK TO AVOID INTERFERENCE AND CONFLICTS. IT IS THIS CONTRACTOR'S
- RESPONSIBILITY TO PROVIDE HIS/HER SUBCONTRACTORS WITH COMPLETE SETS OF BID DOCUMENTS. 3. THIS CONTRACTOR IS RESPONSIBLE FOR SCHEDULING THE COMPLETION AND INSPECTION OF HIS/HER WORK AND THE WORK OF HIS/HER SUBCONTRACTORS TO COMPLY WITH THE SCHEDULE.
- 4. THIS CONTRACTOR SHALL VISIT THE SITE PRIOR TO SUBMITTAL OF BID TO DETERMINE CONDITIONS AFFECTING THE WORK. ANY ITEMS WHICH ARE NOT COVERED IN THE BID DOCUMENTS OR ANY PROPOSED SUBSTITUTIONS SHALL BE LISTED SEPARATELY AND QUALIFIED IN THE CONTRACTORS BID. SUBMITTAL OF A BID SHALL SERVE AS EVIDENCE OF KNOWLEDGE OF EXISTING CONDITIONS AND ANY MODIFICATIONS WHICH ARE REQUIRED TO MEET THE INTENT OF THE DRAWINGS AND SPECIFICATIONS SHALL BE INCLUDED. FAILURE TO VISIT THE SITE DOES NOT RELIEVE THE CONTRACTOR OF HIS/HER RESPONSIBILITY IN PERFORMANCE OF WORK

- THIS CONTRACTOR SHALL PROVIDE ALL LABOR, MATERIALS, EQUIPMENT, SERVICES, TOOLS, TRANSPORTATION, AND FACILITIES NECESSARY TO PROVIDE A COMPLETE HVAC, PLUMBING, FIRE PROTECTION SYSTEM AS SHOWN ON THE DRAWINGS, CALLED FOR IN THE SPECIFICATIONS AND AS REQUIRED BY JOB CONDITIONS. ALL WORK NECESSARY AND NOT SPECIFICALLY NOTED TO BE PROVIDED BY OTHERS SHALL BE PROVIDED BY THIS CONTRACTOR.
- 2. ALL WORK SHALL BE PERFORMED IN A NEAT, PROFESSIONAL MANNER USING GOOD CONSTRUCTION
- 3. UNLESS SPECIFICALLY NOTED OTHERWISE, MATERIALS, PRODUCTS AND EQUIPMENT, INCLUDING ALL COMPONENTS THEREOF, SHALL BE NEW, TESTED, LISTED AND SIZED IN CONFORMITY WITH REQUIREMENTS OF STATE AND LOCAL CODES, WHICHEVER IS MORE STRINGENT.
- 4. ALL WORK SHALL BE INSTALLED SO AS TO BE READILY ACCESSIBLE FOR OPERATING, SERVICING, MAINTAINING AND REPAIRING. THIS CONTRACTOR IS RESPONSIBLE FOR PROVIDING SUFFICIENT SERVICE ACCESS TO ALL EQUIPMENT.
- 5. FIELD MEASURE AND VERIFY REQUIREMENTS FOR EXACT DIMENSION'S. OFFSETS AND ADDITIONAL ELBOWS REQUIRED TO SUIT SITE CONDITIONS ARE CONSIDERED PART OF THE SCOPE.

1. ALL WORK SHALL COMPLY WITH 2018 INTERNATIONAL PLUMBING CODE ORDINANCES AND OTHER STATE, COUNTY, CITY AND LOCAL CODES AND ORDINANCES, SAFETY AND HEALTH CODES, NFPA CODES, ENERGY CODES AND ALL OTHER APPLICABLE CODES AND REQUIREMENTS. THIS CONTRACTOR SHALL INQUIRE INTO AND COMPLY WITH ALL APPLICABLE CODES, ORDINANCES, AND REGULATIONS. THIS CONTRACTOR SHALL INCLUDE IN THE BID ANY CHANGES REQUIRED BY CODES AND IF THESE CHANGES ARE NOT INCLUDED IN THE BID, THEY MUST BE QUALIFIED AS A SEPARATE LINE ITEM IN THE BID. AFTER CONTRACT IS ISSUED, NO ADDITIONAL COST DUE TO CODE ISSUES SHALL BE REIMBURSED TO THE CONTRACTOR.

- . THIS CONTRACTOR SHALL OBTAIN AND PAY FOR ALL LICENSES, PERMITS, INSPECTIONS AND FEES REQUIRED OR RELATED TO DIVISION 15000 WORK.
- 2. FURNISH TO THE (OWNER) ALL CERTIFICATES OF INSPECTION AND FINAL INSPECTION APPROVAL AT COMPLETION OF PROJECT.

- THIS CONTRACTOR SHALL GUARANTEE ALL MATERIALS AND WORK PROVIDED UNDER HIS/HER CONTRACT AND SHALL MAKE GOOD, REPAIR OR REPLACE AT HIS/HER OWN EXPENSE, ANY DEFECTIVE WORK, MATERIAL OR EQUIPMENT DISCOVERED WITHIN A PERIOD OF 12 MONTHS FROM THE DATE OF ACCEPTANCE (IN WRITING) OF THE INSTALLATION. EXTENDED WARRANTIES ARE AS SPECIFIED WITH INDIVIDUAL EQUIPMENT.
- 2. THE HOT WATER HEATERS SHALL BE FURNISHED WITH A 5 YEAR HEAT EXCHANGER WARRANTY.

### PHASING REQUIREMENTS (IF APPLICABLE)

- 1. THIS CONTRACTOR SHALL INCLUDE IN THE BID ALL NECESSARY SERVICE REQUIRED TO KEEP THE OPERATING PORTION OF THE BUILDING'S (HVAC, PLUMBING AND SPRINKLER) SERVICES IN OPERATION. CONTRACTOR MUST SCHEDULE IN WRITING ONE WEEK PRIOR TO ANY SHUT DOWN OF (THE HVAC, PLUMBING OR FIRE PROTECTION) SYSTEMS
- 2. THIS CONTRACTOR SHALL BE RESPONSIBLE FOR THE COORDINATION OF THE DEMOLITION OF EXISTING WORK AND THE RENOVATION WORK. COORDINATE WITH THE OTHER CONTRACTORS ANY EXISTING EQUIPMENT REQUIRED TO BE LEFT INTACT. THIS CONTRACTOR SHALL INCLUDE AND WILL BE HELD RESPONSIBLE FOR, THE REMOVAL OF ALL EXISTING (FIRE PROTECTION SYSTEMS, PLUMBING FIXTURES, PIPING SYSTEMS, HVAC UNITS, REFRIGERANT RECAPTURE, EXHAUST FANS). AND ASSOCIATED ROOF CURBS OR RAILS NOT TO BE REUSED ON THIS PROJECT, UNLESS SPECIFICALLY NOTED OTHERWISE CONTRACTOR SHALL VERIFY ALL PRESUMED ABANDONED (EQUIPMENT, PIPES, DUCTWORK AND EQUIPMENT) PRIOR TO REMOVAL. ROOF CURBS SHALL BE REMOVED AND THE ROOF PATCHED. ALL EXTRANEOUS ITEMS IN THE SPACE, ASSOCIATED WITH THE SPACE, OR ON THE ROOF NOT APPLICABLE TO THE NEW WORK MUST BE REMOVED AND ROOF/WALL/FLOOR PATCHED/REPAIRED TO MATCH EXISTING SURROUNDINGS. EXISTING ABANDONED (PIPES, DUCTS OR EQUIPMENT) IN THE FLOOR, EMBEDDED IN CONCRETE, OR OTHERWISE INACCESSIBLE ARE TO BE CUT OFF AND SEALED BELOW OR WITHIN THE FLOOR OR WALL WHEN THEY ARE NOT TO BE REUSED IN THIS PROJECT. IF REQUIRED BY CODES, ABANDONED (PIPING AND/OR DUCTWORK) MUST BE REMOVED TO POINT OF ORIGIN. CONFIRM THE EXTENT OF DEMOLITION PRIOR TO BID AND INCLUDE IN BID PROPOSAL.

- THIS CONTRACTOR SHALL PROVIDE SLEEVES TO PROTECT EQUIPMENT OR FACILITIES IN THE INSTALLATION. EACH SLEEVE SHALL EXTEND THROUGH ITS RESPECTIVE FLOOR, WALL OR PARTITION AND SHALL BE CUT FLUSH WITH EACH SURFACE EXCEPT SLEEVES THAT PENETRATE THE FLOOR, WHICH SHALL EXTEND 2" ABOVE THE FLOOR.
- 2. CONTRACTOR SHALL COORDINATE ANY CORE DRILLING OR CUTTING OF OPENINGS IN MASONRY FLOORS OR WALLS.
- 3. ALL SLEEVES AND OPENINGS THROUGH FIRE-RATED WALLS AND/OR FLOORS SHALL BE FIRE SEALED WITH CALCIUM SILICATE, SILICONE "RTV" FOAM, "3M" FIRE RATED SEALANTS OR EQUAL, SO AS TO RETAIN THEIR FIRE RATING.SLEEVES IN BEARING AND MASONRY WALLS, FLOORS, AND PARTITIONS SHALL BE STANDARD WEIGHT STEEL PIPE FINISHED WITH SMOOTH EDGES. FOR OTHER THAN MASONRY PARTITIONS, THROUGH SUSPENDED CEILINGS, OR FOR CONCEALED VERTICAL PIPING, SLEEVES SHALL BE NO. 22 U.S.G. GALVANIZED STEEL MINIMUM.

- 1. PROVIDE HANGERS AND SUPPORTS FOR ALL PIPING, DUCTWORK, AND EQUIPMENT IN ACCORDANCE WITH SMACNA, MSS, ASME, AND ASHRAE STANDARDS.
- 2. HANGERS SHALL INCLUDE ALL MISCELLANEOUS STEEL SUCH AS ANGLE IRON, BANDS, C-CLAMPS WITH RETAINING CLIPS, CHANNELS, HANGER RODS, ETC., NECESSARY FOR THE INSTALLATION OF WORK.

- 3. HANGERS SHALL BE FASTENED TO BUILDING STEEL, CONCRETE OR MASONRY. HANGING FROM METAL DECK IS NOT PERMITTED. HANGERS MUST BE ATTACHED TO UPPER CHORDS OF BAR JOISTS. WHERE INTERFERENCES OCCUR, AND IN ORDER TO SUPPORT (DUCTWORK OR PIPING) THE CONTRACTOR SHALL INSTALL TRAPEZE TYPE HANGERS OR SUPPORTS WHICH SHALL BE LOCATED WHERE THEY DO NOT INTERFERE WITH ACCESS TO FIRE DAMPERS, VALVES, AND OTHER EQUIPMENT.
- 4. HANGERS FOR ALL INSULATED PIPING SHALL BE SIZED AND INSTALLED FOR THE OUTER DIAMETER OF INSULATION. INSTALL 6" LONG SPLIT CIRCLE GALVANIZED SADDLE BETWEEN THE HANGER AND THE PIPE INSULATION. PROVIDE HIGH DENSITY INSULATION INSERT BETWEEN THE SADDLE AND THE PIPE.
- 5. HANGERS AND PIPING OF DISSIMILAR METALS SHALL BE DI-ELECTRICALLY SEPARATED.

1. SCREEN OFF ALL AREAS WHERE CONSTRUCTION IS TO TAKE PLACE FROM THE AREAS TO REMAIN INHABITED. INHABITED AREAS SHALL REMAIN DUST AND DEBRIS FREE DURING CONSTRUCTION. 2. CLEAN ANY AREAS OUTSIDE DESIGNATED CONSTRUCTION AREA WHICH MAY HAVE BECOME SOILED DUE

- 1. REFER TO PLANS FOR SCHEDULES OF EQUIPMENT AND FIXTURES. AMERICAN STANDARD, KOHLER AND CRANE ARE CONSIDERED ACCEPTABLE AS EQUALS.
- 2. MAINTAIN A MINIMUM CLEARANCE OF 6" BETWEEN PLUMBING PIPING AND EQUIPMENT AND ALL FIRE/SMOKE RATED WALLS.
- 3. INSTALL EQUIPMENT IN ACCORDANCE WITH MANUFACTURER'S WRITTEN INSTRUCTIONS. INSTALL UNITS LEVEL AND PLUMB, FIRMLY ANCHORED IN LOCATIONS INDICATED.
- 4. POTABLE WATER PIPING SHALL BE AS FOLLOWS: a. BELOW GRADE: TYPE 'K', ANNEALED TYPE TEMPERED COPPER TUBE FOR PIPE SIZES 2 INCHES AND
- SMALLER. BRAZE ALL JOINTS. b. ALL OTHER: TYPE 'L' DRAWN COPPER TUBE WITH WROUGHT COPPER FITTINGS AND 95-5

### TIN-ANTIMONY SOLDER. 5. PIPING OF DISSIMILAR METALS SHALL BE DI-ELECTRICALLY SEPARATED.

- 6. FIELD VERIFY EXACT CONNECTION POINTS PRIOR TO SUBMITTING BID AND NOTIFY ENGINEER IF CONDITIONS ARE NOT AS SHOWN ON THE PLANS OR AS STATED IN THE SPECIFICATIONS. CONTRACTOR SHALL VERIFY THE OPERABILITY OF ENTIRE SYSTEM PRIOR TO TIE-IN AS FOLLOWS:
- c. SNAKE SANITARY FOR A DISTANCE OF 100 FEET AND REPORT ANY BLOCKAGE. d. TEST WATER PRESSURE TO INSURE MINIMUM PSI MATCHES MOST DEMANDING EQUIPMENT
- SUPPLIED. 7. INSULATE ALL HOT AND COLD WATER PIPING WITH 1" THICK (K=0.23 @ 75°F) FIBERGLASS PIPE INSULATION WITH AN ALL SERVICE JACKET TO MEET LOCAL CODES AND UL FLAME SPREAD AND SMOKE DEVELOPED RATING. INSTALL PER MANUFACTURER'S RECOMMENDATIONS.
- 8. INSULATE THE TRAP, SANITARY AND SUPPLY PIPES UNDER LAVATORIES WITH TRUEBRO MODEL 102W "HANDI LAV GUARD" INSULATION KIT OR EQUAL.
- 9. INSTALL ALL NECESSARY PIPE HANGERS, SADDLES, AND CARRIERS TO PROPERLY SUPPORT ALL PIPING AND FIXTURES. HANGERS SHALL SUIT TYPE OF PIPING PROVIDED AND BE SPACED AT A MAXIMUM SPAN
- 10.FLUSH STERILIZE WATER SYSTEM IN ACCORDANCE WITH LOCAL CODES.
- 11. TEST ENTIRE PLUMBING SYSTEM IN ACCORDANCE WITH <u>2018 INTERNATIONAL PLUMBING CODE</u>. 12. PROVIDE WATER METER AND REMOTE READER PER LOCAL UTILITIES REQUIREMENT, IF APPLICABLE.
- 13. CONDENSATE DRAIN: PROVIDE POLYVINYL CHLORINE (PVC) SCHEDULE 40 PLASTIC PIPE (TYPE (DWV) IN
- CONFORMANCE WITH STANDARD ASTM D2665.
- 14. VALVES: PROVIDE BALL VALVE NIBCO SERIES 585-70 FOR SHUT-OFF
- 15.PROVIDE ACCESS PANELS WHERE REQUIRED FOR OPERATION, MAINTENANCE AND BALANCING OR PLUMBING EQUIPMENT.
- 16.PROVIDE WATER HAMMER ARRESTORS AT EACH BRANCH LINE.

- 1. FURNISH AND INSTALL A COMPLETE GAS PIPING SYSTEM.
- 2. GAS LINES SHALL BE BLACK STEEL, SCHEDULE 40, ASTM A-53, WITH MALLEABLE THREADED FITTINGS FOR 2" AND SMALLER, AND WITH WELDED JOINTS FOR 2-1/2" AND LARGER.
- 3. FURNISH AND INSTALL A GAS COCK, DIRT LEG, AND UNION CONNECTION AT EACH PIECE OF EQUIPMENT. 4. PITCH PIPING AT A UNIFORM GRADE OF 1/4" IN 15 FEET UPWARD IN DIRECTION OF FLOW. SUPPORT PIPING EVERY 5 FEET, AS DETAILED ON DRAWINGS, OR BY STANDARD INDUSTRY PRACTICE, WHICHEVER
- IS MORE STRINGENT. 5. GAS PIPING EXPOSED ON ROOF SHALL BE PAINTED WITH RUST-INHIBITING PAINT.
- 6. GAS PIPING INSTALLED IN RETURN AIR PLENUMS SHALL BE SLEEVED AND VENTED OR WELDED IN
- ACCORDANCE WITH THE LOCAL GAS COMPANY, LOCAL CODE AND APPLICABLE NFPA 54 CODES. 7. TESTING AND PURGING OF GAS PIPING SHALL BE DONE PER THE REQUIREMENTS OF THE LOCAL GAS COMPANY, LOCAL CODES AND APPLICABLE NFPA CODES.
- 8. CONTACT AND COORDINATE GAS SERVICE, METER AND REGULATOR REQUIREMENTS WITH THE LOCAL GAS COMPANY PRIOR TO BID. INCLUDE INSTALLATION COST OF GAS METER AND REGULATOR IN BID.

### LABELS/PIPE MARKERS

- 1. FURNISH AND INSTALL PIPE IDENTIFICATION MARKERS EVERY 5 FEET ON ALL PIPES INSTALLED UNDER THIS CONTRACT. MARKERS SHALL BE A MINIMUM OF 1-1/2" X 8" AND IDENTIFIED IN ACCORDANCE WITH THE BACKGROUND AND LETTER COLORS ISSUED BY THE AMERICAN NATIONAL STANDARDS INSTITUTE (ANSI). MARKERS SHALL BE MANUFACTURED BY CHAMPION AMERICA INC., BRADY, SETON, OR EQUAL.
- 2. PIPING SHALL BE IDENTIFIED AS FOLLOWS: CONDENSATE, REFRIGERANT LIQUID, REFRIGERANT SUCTION, AND DIRECTIONAL ARROWS. ALL IDENTIFICATIONS MUST BE VISIBLE AT EQUIPMENT.
- 3. VALVES SHALL BE TAGGED IN ACCORDANCE TO VALVE OPERATION SCHEMATIC. 4. LABEL ALL FILTERED SUPPLY STOPS.

1. PROVIDE ALL NECESSARY STEEL FRAMING REQUIRED TO INSTALL ALL HVAC EQUIPMENT AS DESCRIBED OR IMPLIED ON THE DRAWINGS. ALL PENETRATIONS OF EXISTING STRUCTURE SHALL BE DONE AT THIS CONTRACTOR'S EXPENSE

1. THIS CONTRACTOR SHALL INCLUDE AS A BASE, 2-HOURS OF START-UP TIME PLUS AN ADDITIONAL 2-HOURS OF START-UP TIME PER HVAC UNIT SHOWN ON DRAWINGS.

1. ASIDE FROM NORMAL INTERIM INSPECTIONS OF WORK IN PLACE, THE ENGINEER SHALL BE NOTIFIED (IN WRITING) TO INSPECT THE FINISHED INSTALLATION UPON COMPLETION FOR COMPLIANCE WITH THE PLANS, SPECIFICATIONS AND CODES. THE INSTALLING CONTRACTOR SHALL BE RESPONSIBLE TO BRING ALL ITEMS REPORTED BY THE ENGINEER INTO COMPLIANCE. ~~~~

```
1. WASTE PIPING: PVC SCH. 40 (
```



ARCHITECT CORALIC, LLC EDIN CORALIC 9700 MACKENZIE ROAD, STE 222 ST. LOUIS, MO 63123

p: 314.578.4953 edin@coralicarchitecture.com STRUCTURAL ENGINEER JAMES C. KREHER JIM KREHER 208 N. MAIN STREET,

COLUMBIA, IL 62236 p: 618.281.8505 jimk@kreherengineering.com

796 MERUS CT.,

MEP ENGINEER Case Engineering DARRELL R. CASE

FENTON, MO 63026 T. 636.349.1600 F. 636.349.1730 dcase@caseengineeringinc.com

10.14.2021



St  $\bigcirc$ 

0

0

 $\sum$ 

Φ Ä

ISSUED FOR PERMIT: 10.11.2021

REV: DATE: DESCRIPTION: 01 10.14.21 CITY COMMENTS

SHEET NAME:

PLUMBING SPECIFICATIONS

SHEET NUMBER: