



RIGHT ELEVATION |/8" = |'0"





SQUARE FOOTAGE LIVING AREA FIRST FLOOR = 996 SECOND FLOOR = 1495 COVERED PATIO = 144

UNFINISHED AREA STORAGE BASEMENT = 835 GARAGE = 724 UNDER STOOP = 80

REAR ELEVATION

|*18*" = |'0"

THE "MAGNOLIA 4-A"


LOT 159 NAPA VALLEY

LEES SUMMIT MO

1825 SW SAGE CANYON





SHEET NO.		-	APPROX. SQ.FT.		
PLAN NO.	KU 2102 4 V	1-7 0-20-11	FILE NAME:		
DATE DRAWN:		DATE REVISED:		DESIGNER:	
PHONE:		PHONE:		LOT NO.	
HOME BUYER:		BUILPER:		SUB-DIVISION:	
BUILPER&CONTRACTOR IS RESPONSIBLE TO CHECK ALL PIMENSIONS FOR ACCURACY BETWEEN FLOORS, FOUNDATION, AND ELEVATIONS. ALSO VERIFY ALL BEAM, HEADERS,	PAD LOCATIONS, AND COLUMN SIZES, BUILDER&CONTRACTOR TO CHECK FOR	ACCEPTS ALL RESPONSIBLITY FOR LOT PLACEMENT, SET-BACKS, AND FLOOP PLANS.	BUILDER&CONTRACTOR AND HOME OWNER ACCEPTS RESPONSIBLITY FOR ANY AND ALL COPYRIGHT INFRINGMENTS OR RESEMBLANCES TO OTHER COPYRIGHTEP FLANS.	BUILDER&CONTRACTOR ACCEPTS RESPONSIBLITY FOR ANY AN ON SITE CHANGES MADE	TO STRUCTURE

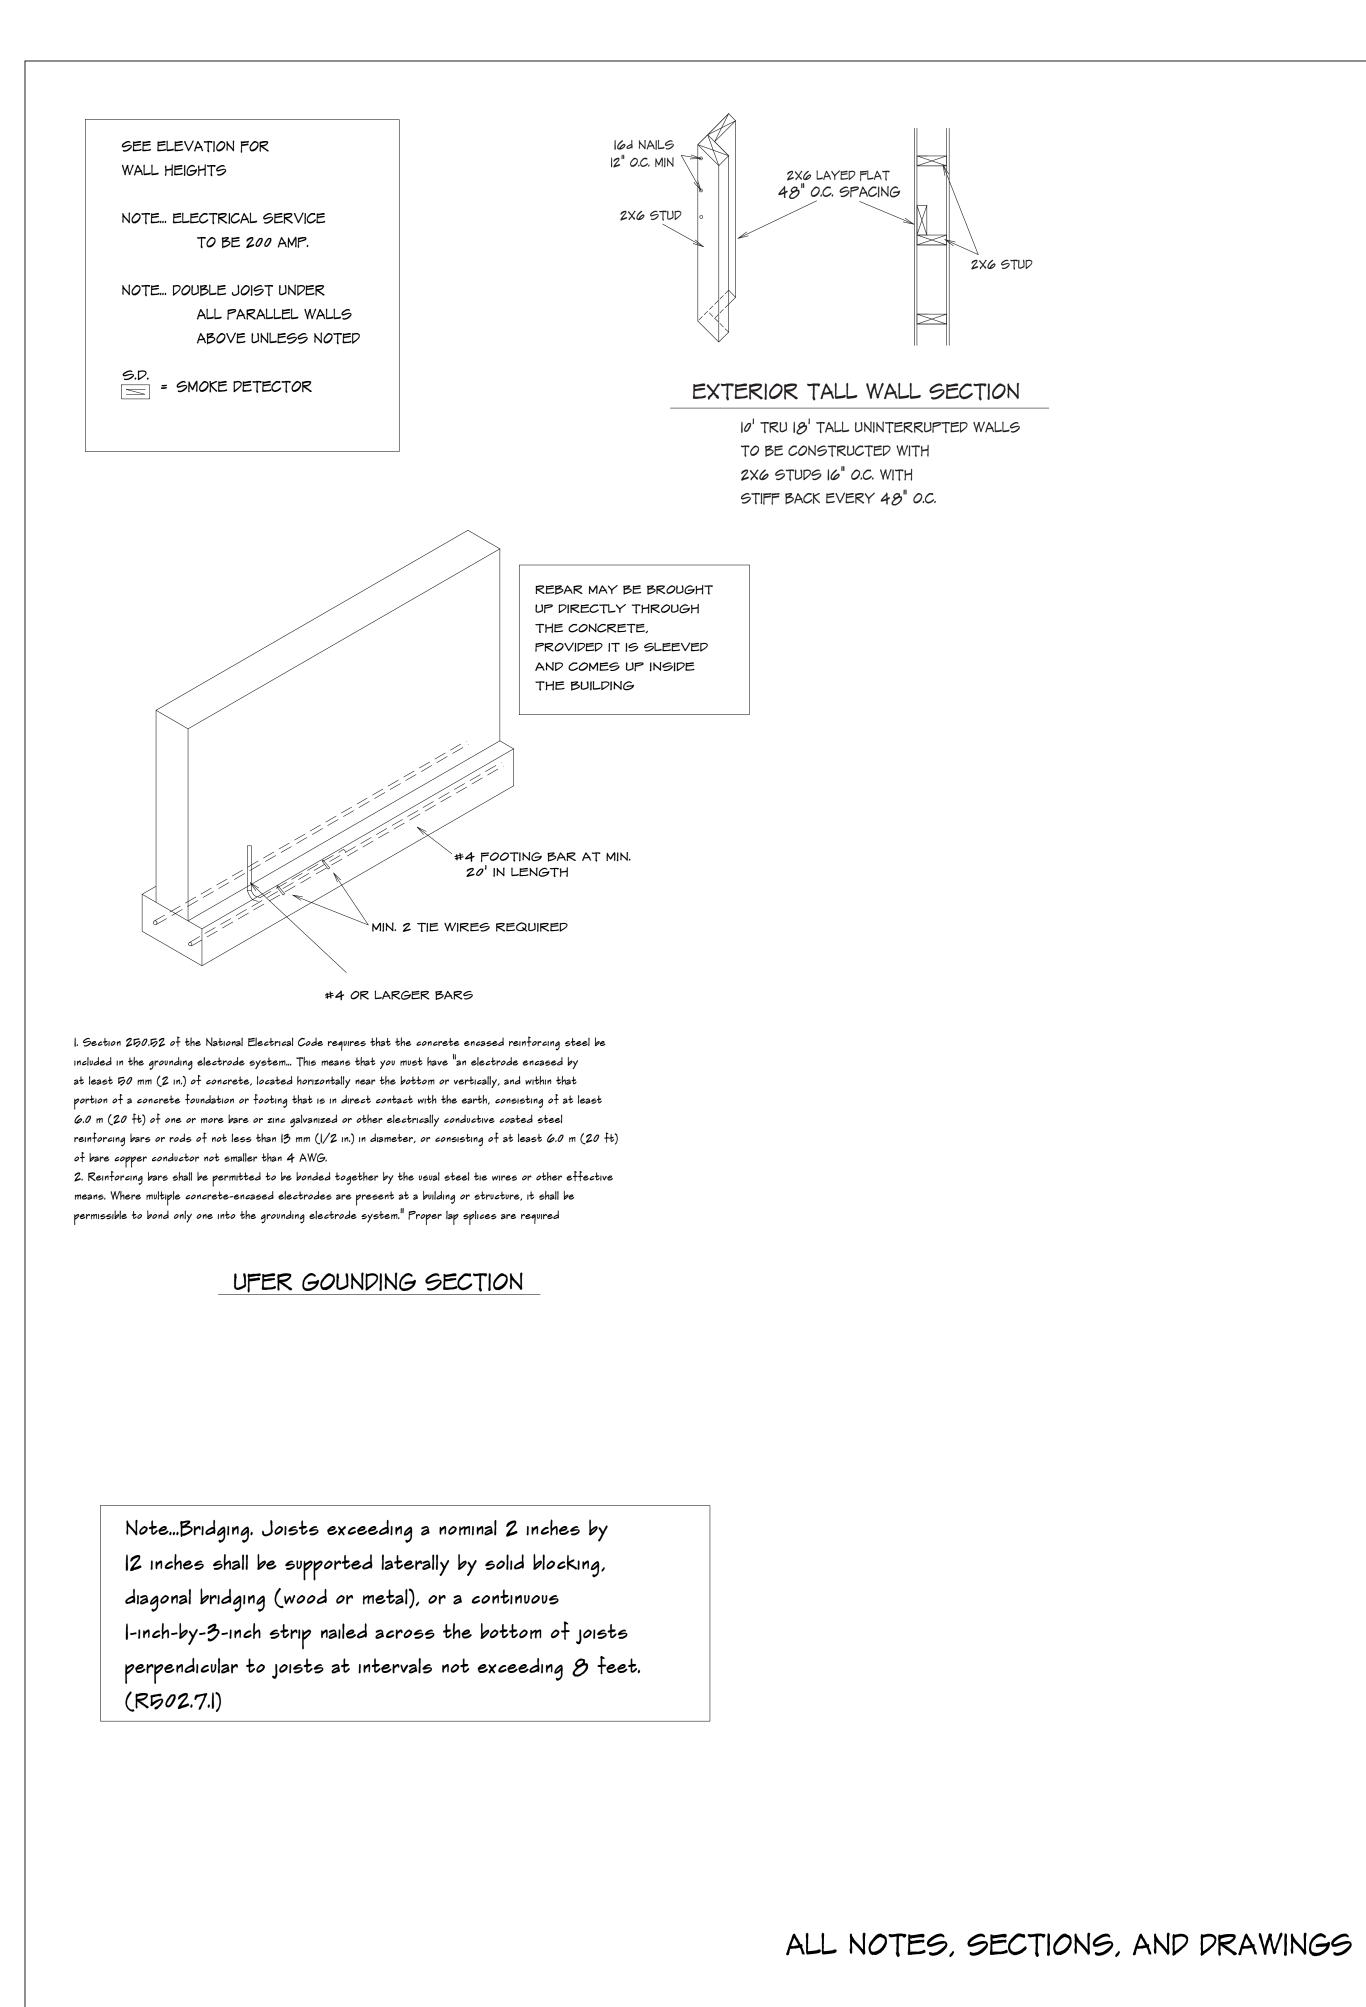

ARE IN ACCORDANCE WITH THE 2018 IRC

BASEMENT PLAN 1/4" = 1'0"

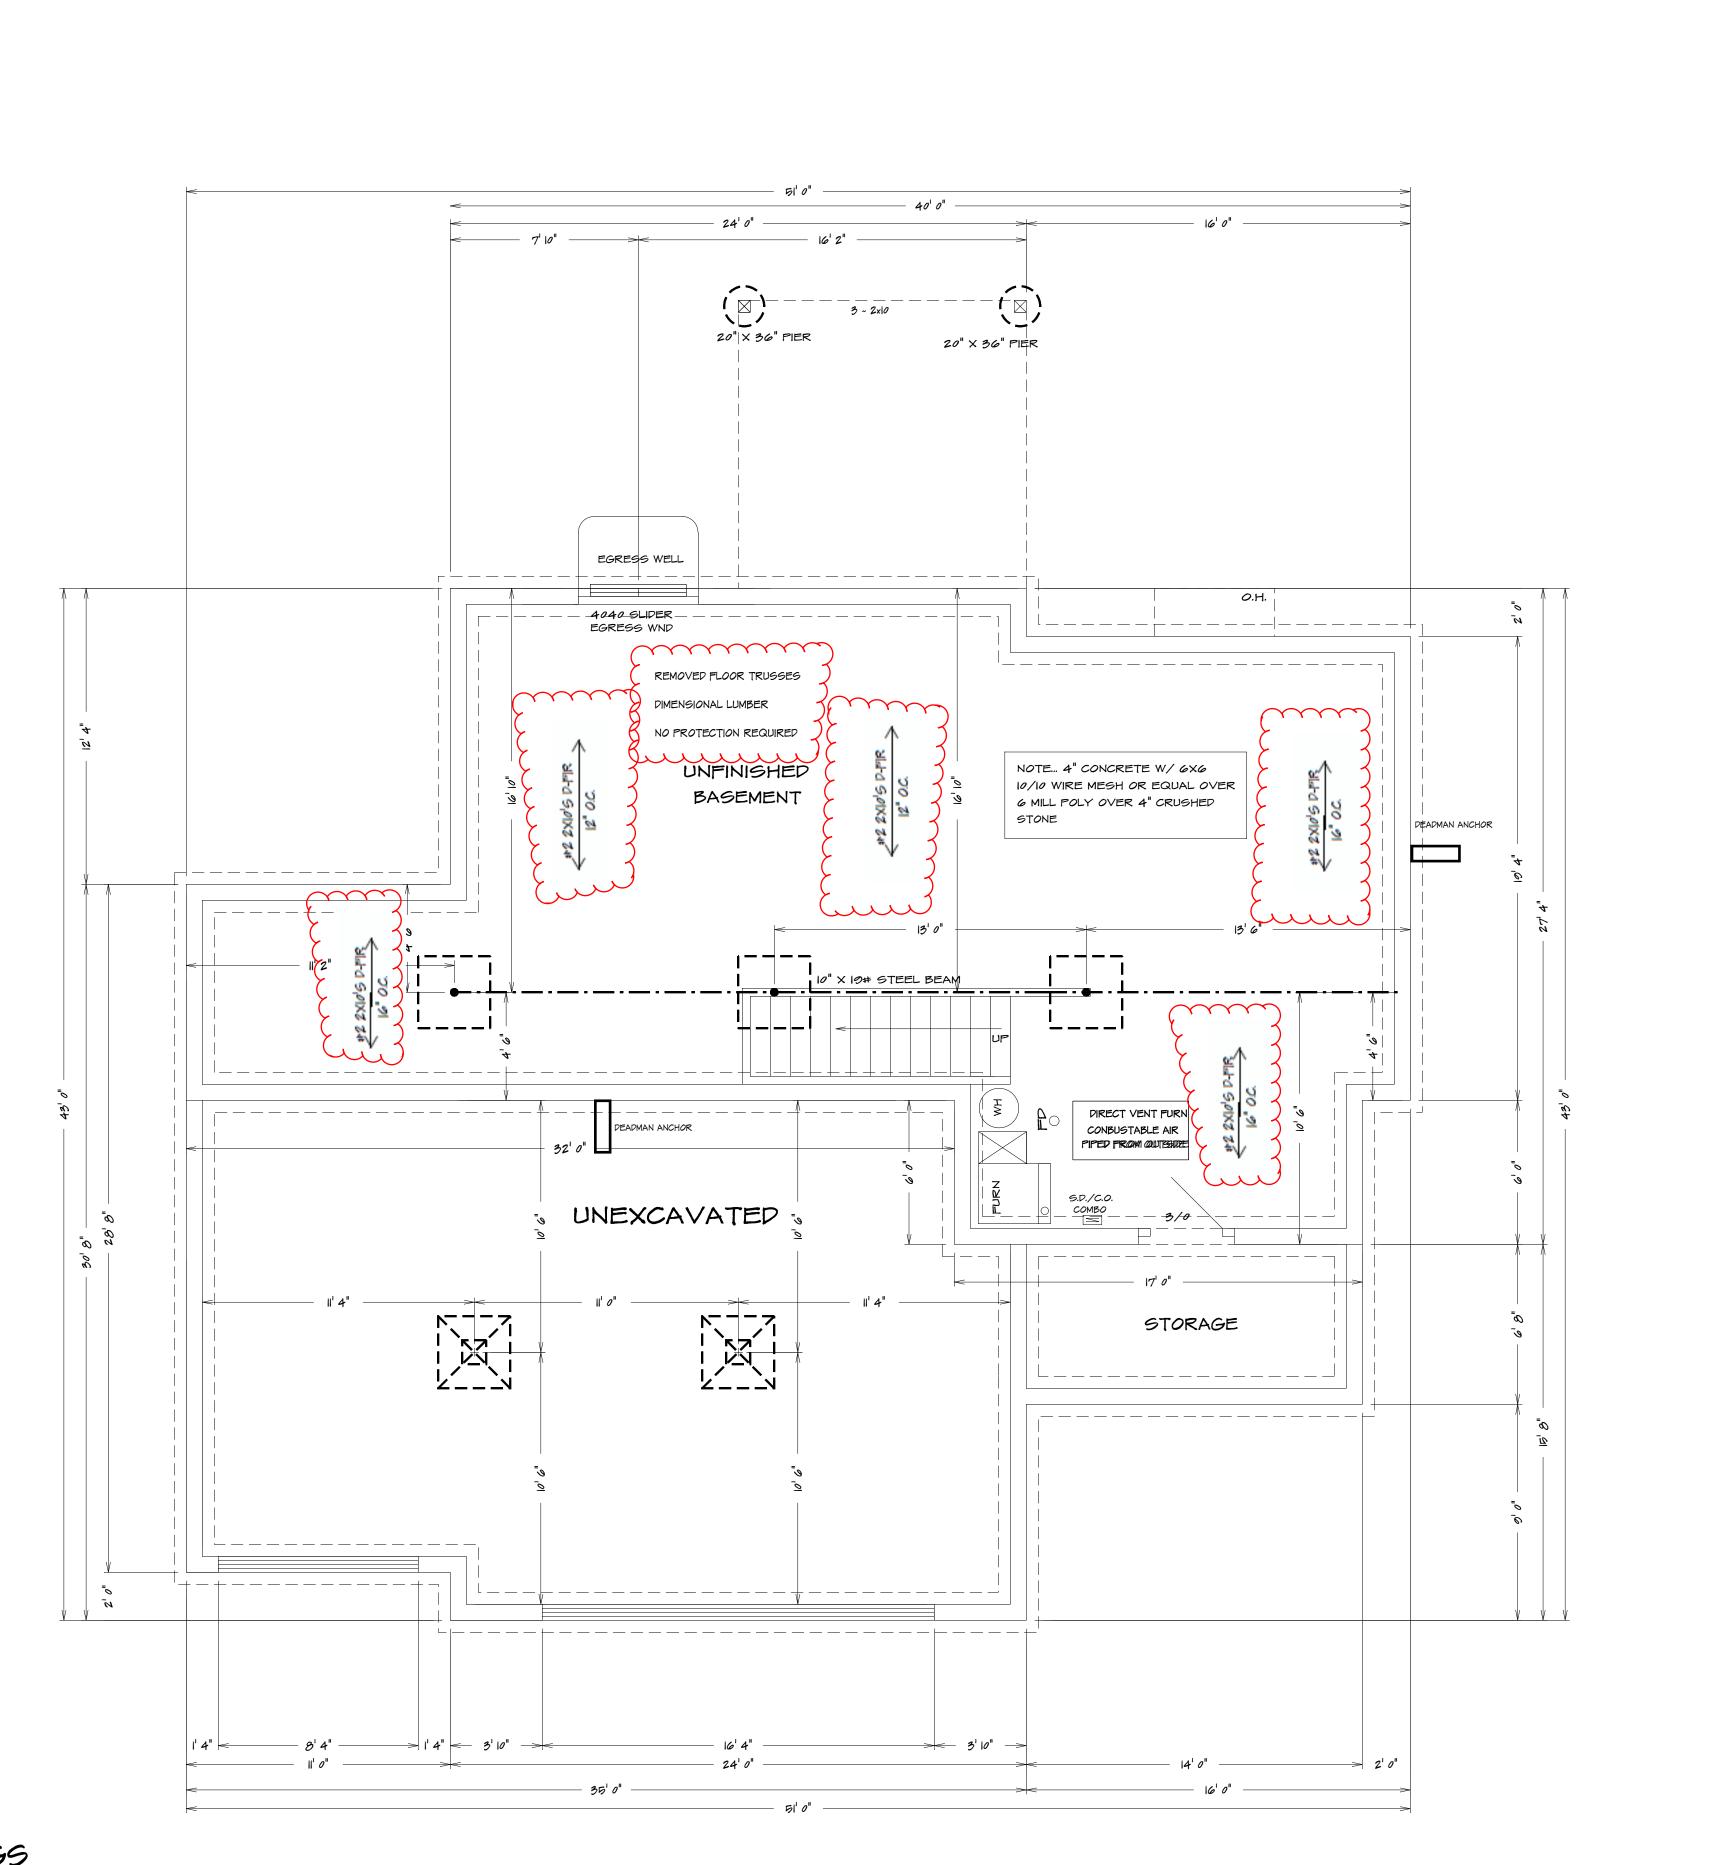

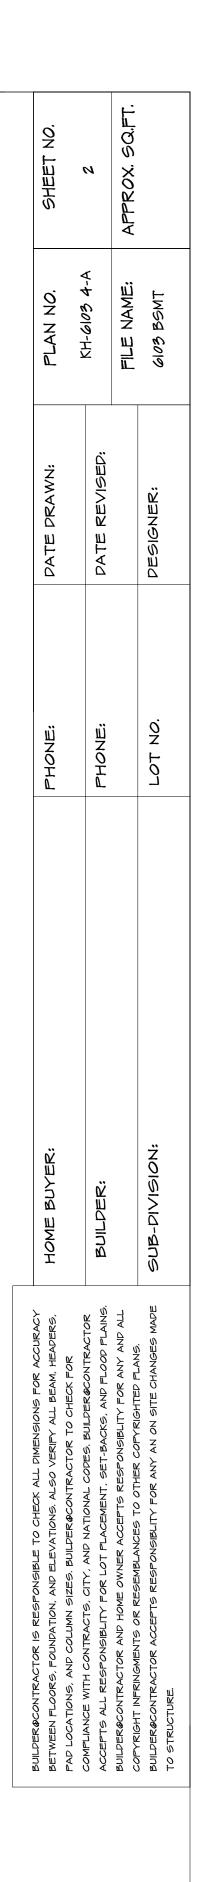



RELEASE FO CONSTRUCTION AS NOTED ON PLANS REVIEW DEVELOPMENT SERVICES LEE'S SUMMIT, MISSOURI

SEE ELEVATION FOR WALL HEIGHTS

NOTE ... ELECTRICAL SERVICE TO BE 200 AMP.

NOTE ... DOUBLE JOIST UNDER ALL PARALLEL WALLS ABOVE UNLESS NOTED

S.P. = SMOKE DETECTOR

GENERAL HEADER SPECIFICATIONS:

REQUIRED AREAS NEEDING HEADERS: WINDOWS/DOORS UP TO 38" R.O. WINDOWS/DOORS 38" UP TO 72" R.O.

8'0" GARAGE DOORS W/SECOND FLOOR

9'0" GARAGE DOORS W/SECOND FLOOR

16'0" GARAGE DOORS W/SECOND FLOOR

16'0" GARAGE DOOR W/NO SECOND FLOOR

WINDOWS/DOORS 72" UP TO 96" R.O. 8'0" GARAGE DOORS W/CEILING & ROOF LOAD 9'0" GARAGE DOORS W/CEILING & ROOF LOAD

HEADER DESCRIPTIONS: (2) #2 D-FIR 2X10'S (2) #2 D-FIR 2X10'S W/1/2" GLUE PLY (2) 9 1/2" L.V.L. (2) 9 1/2" L.V.L. (2) 9 1/2" L.V.L. (2) 9 1/2" L.V.L. (2) 11 7/8" L.V.L. (2) 11 7/8" L.V.L. (2) 14" L.V.L.

USE HEADERS FOR OPENINGS ABOVE UNLESS SPECIFIED OTHERWISE.

Window sills.

In dwelling units, where the opening of an operable window is located more than 72 inches (1829 mm) above the finished grade or surface below, the lowest part of the clear opening of the window shall be a minimum of 24 inches (610 mm) above the fininshed floor of the room in which the window is located. Operable sections of windows shall not permit openings that allow passage of a 4-inch-diameter (102 mm) sphere where such openings are located within 24 inches (610 mm) of the finished floor.

Exceptions:

- I. Windows whose openings will not allow a 4-inch-diameter (102 mm) sphere to pass through the opening when the opening is in its largest opened position.
- 2. Openings that are provided with window fall prevention devices that comply with ASTM F 2090.
- 3. Windows that are provided with window opening control devices that comply with 2018 IRC

Window opening control devices.


Window opening control devices shall comply with ASTM F 2090. The window opening control device, after operation to release the control device allowing the window to fully open, shall not reduce the minimum net clear opening area of the window unit to less than the area required by 2018 IRC

Bathrooms, water closet compartments and other similar rooms shall be provided with aggregate glazing area in windows of not less than 3 square feet, one-half of which must be openable. Exception:

The glazed areas shall not be required where artificial light and a local exhaust system are provided.

The minimum local exhaust rates shall be determined in accordance with 2018 IRC

Exhaust air from the space shall be exhausted directly to the outdoors.

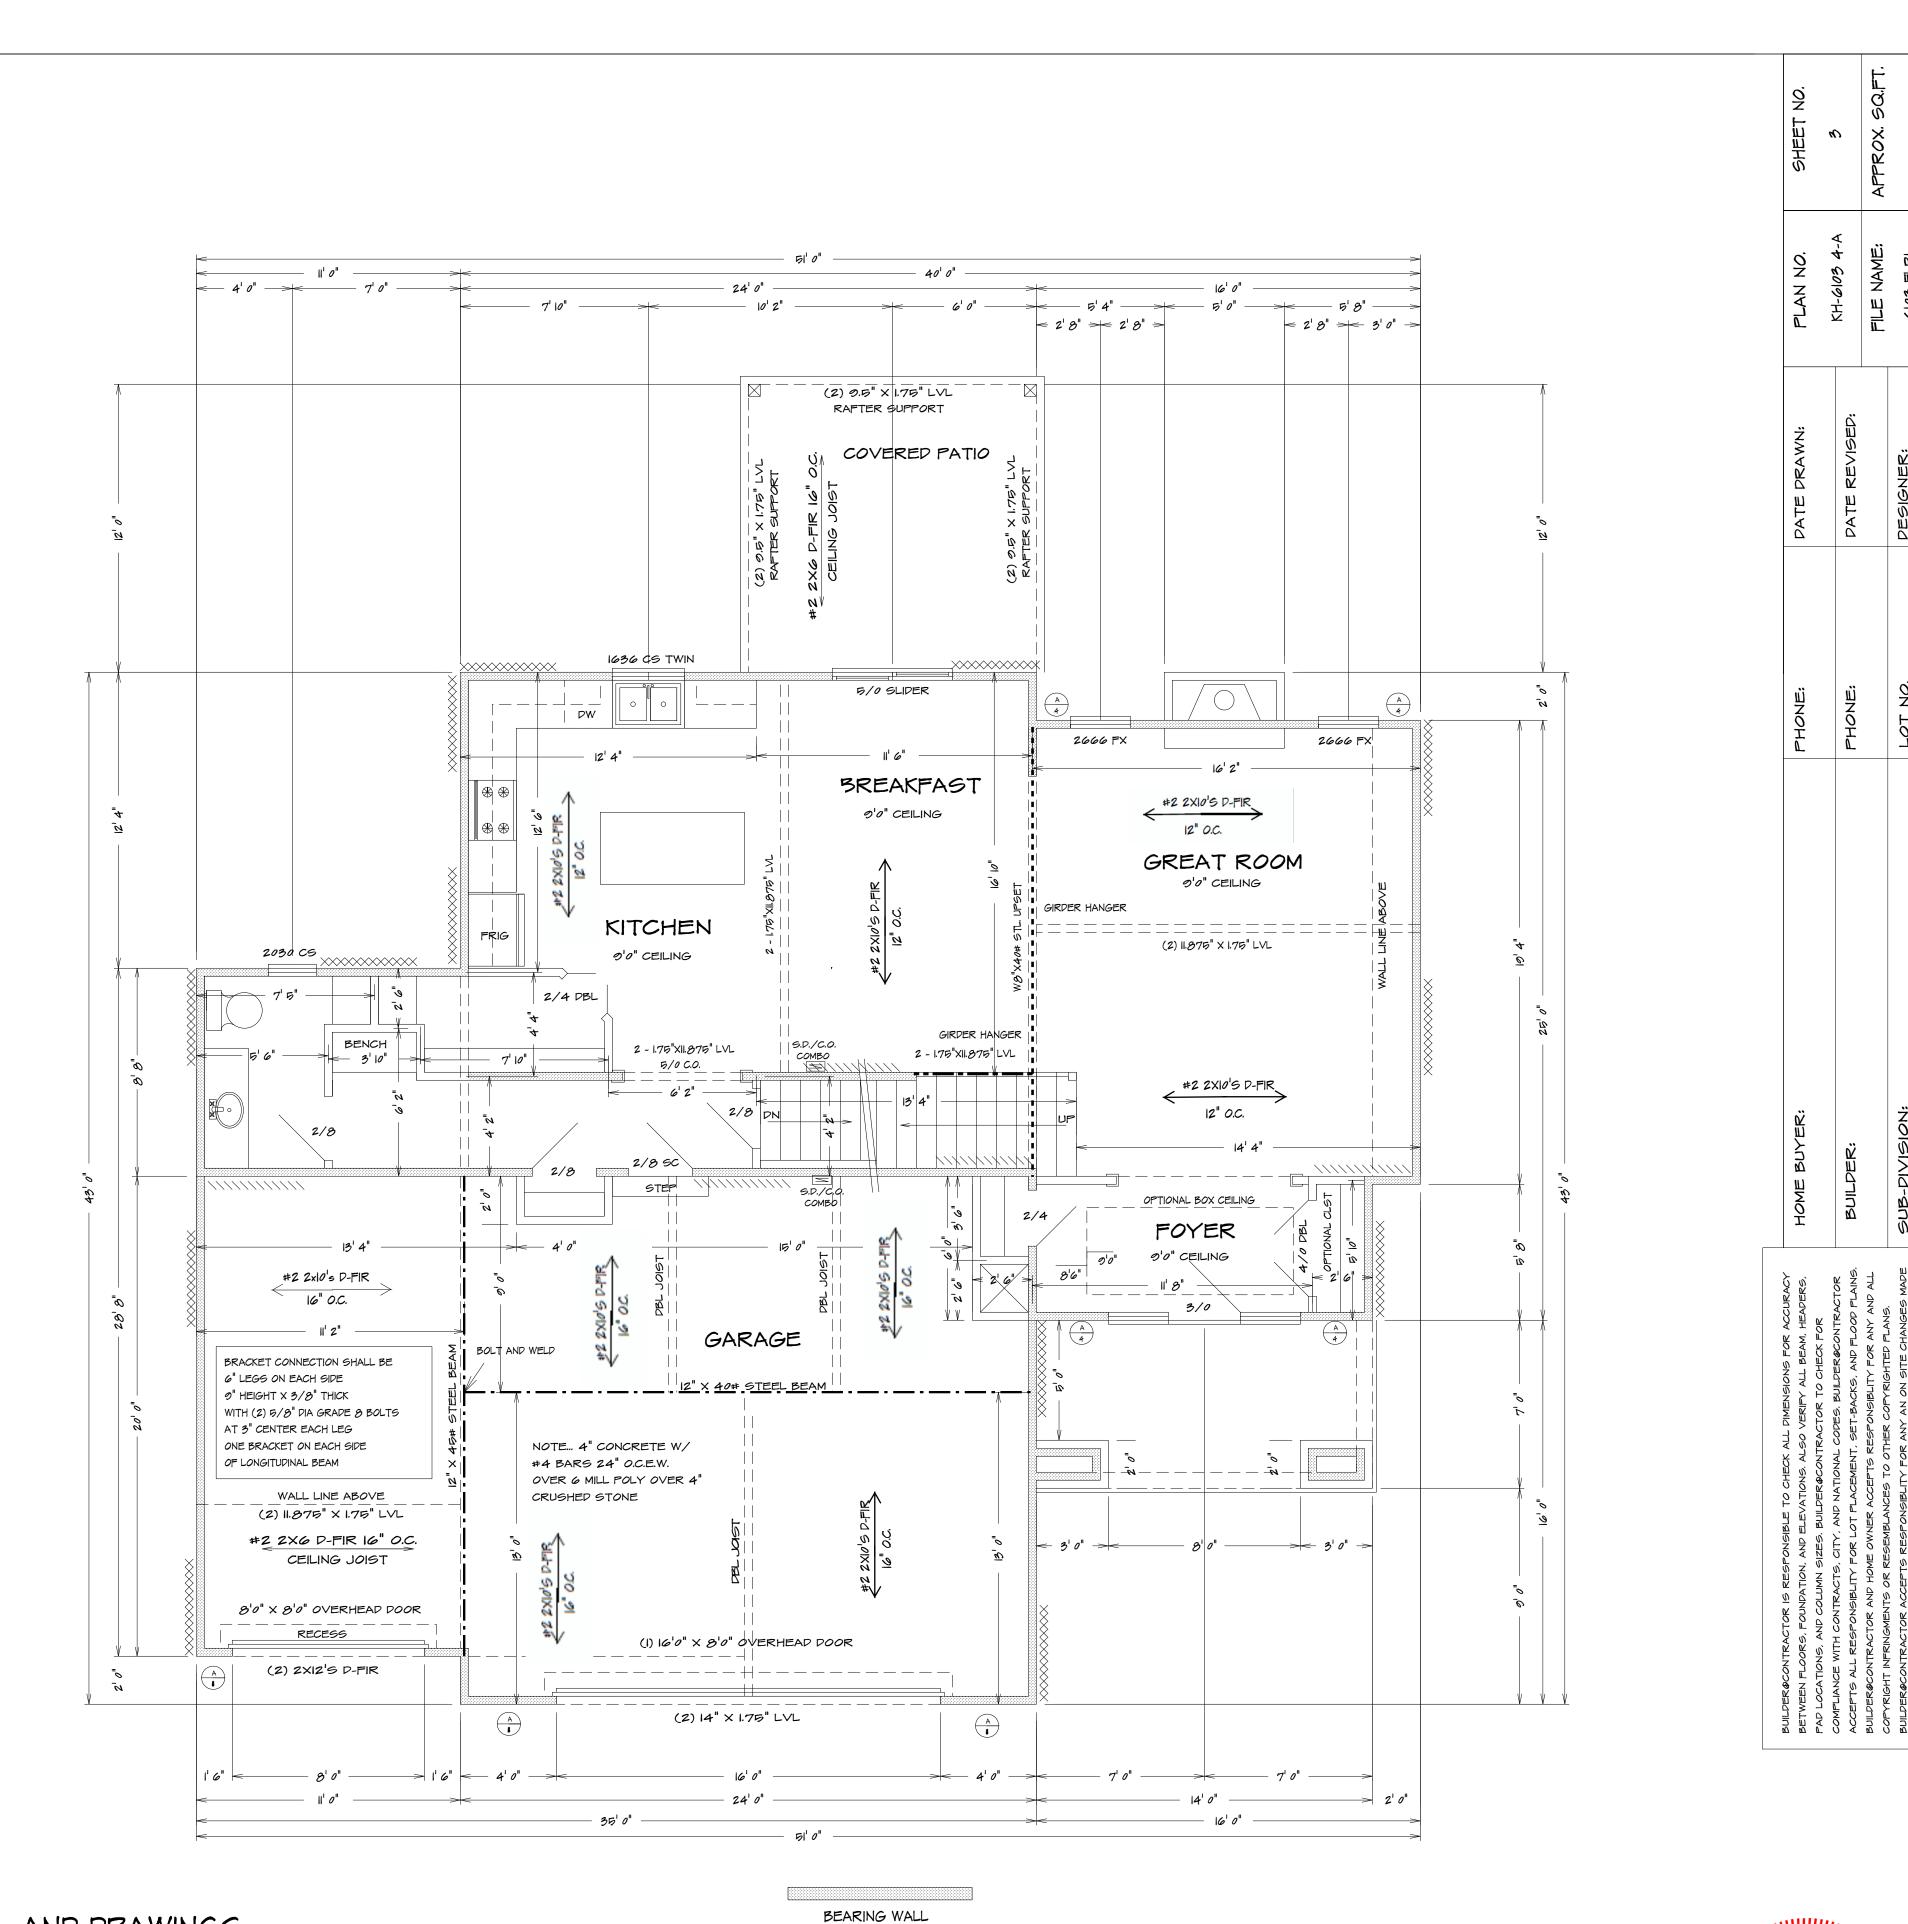

ALL NOTES, SECTIONS, AND DRAWINGS

ARE IN ACCORDANCE WITH THE 2018 IRC

FIRST FLOOR PLAN 1/4" = 1'0"

RELEASE FOI **CONSTRUCTION** AS NOTED ON PLANS REVIEW DEVELOPMENT SERVICES LEE'S SUMMIT, MISSOURI

SEE ELEVATION FOR WALL HEIGHTS

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NOTE ... DOUBLE JOIST UNDER ALL PARALLEL WALLS ABOVE UNLESS NOTED

S.P. = SMOKE DETECTOR

GENERAL HEADER SPECIFICATIONS:

(2) #2 D-FIR 2X10'S

(2) 9 1/2" L.V.L.

(2) 9 1/2" L.V.L.

(2) 11 7/8" L.V.L.

(2) 11 7/8" L.V.L.

(2) 14" L.V.L.

(2) #2 D-FIR 2X10'S W/1/2" GLUE PLY

REQUIRED AREAS NEEDING HEADERS: HEADER DESCRIPTIONS: WINDOWS/DOORS UP TO 38" R.O. WINDOWS/DOORS 38" UP TO 72" R.O.

WINDOWS/DOORS 72" UP TO 96" R.O. 8'0" GARAGE DOORS W/CEILING & ROOF LOAD

9'0" GARAGE DOORS W/CEILING & ROOF LOAD (2) 9 1/2" L.V.L. 8'0" GARAGE DOORS W/SECOND FLOOR (2) 9 1/2" L.V.L.

9'0" GARAGE DOORS W/SECOND FLOOR 16'0" GARAGE DOOR W/NO SECOND FLOOR

16'0" GARAGE DOORS W/SECOND FLOOR

USE HEADERS FOR OPENINGS ABOVE UNLESS SPECIFIED OTHERWISE.

Window sills.

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- 2. Openings that are provided with window fall prevention devices that comply with ASTM F 2090.
- 3. Windows that are provided with window opening control devices that comply with 2018 IRC

Window opening control devices.

Window opening control devices shall comply with ASTM F 2000. The window opening control device, after operation to release the control device allowing the window to fully open, shall not reduce the minimum net clear opening area of the window unit to less than the area required by 2018 IRC .

Bathrooms, water closet compartments and other similar rooms shall be provided with aggregate glazing area in windows of not less than 3 square feet, one-half of which must be openable. Exception:


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ALL NOTES, SECTIONS, AND DRAWINGS

ARE IN ACCORDANCE WITH THE 2018 IRC



BEARING WALL


SECOND FLOOR PLAN 1/4" = 1'0"

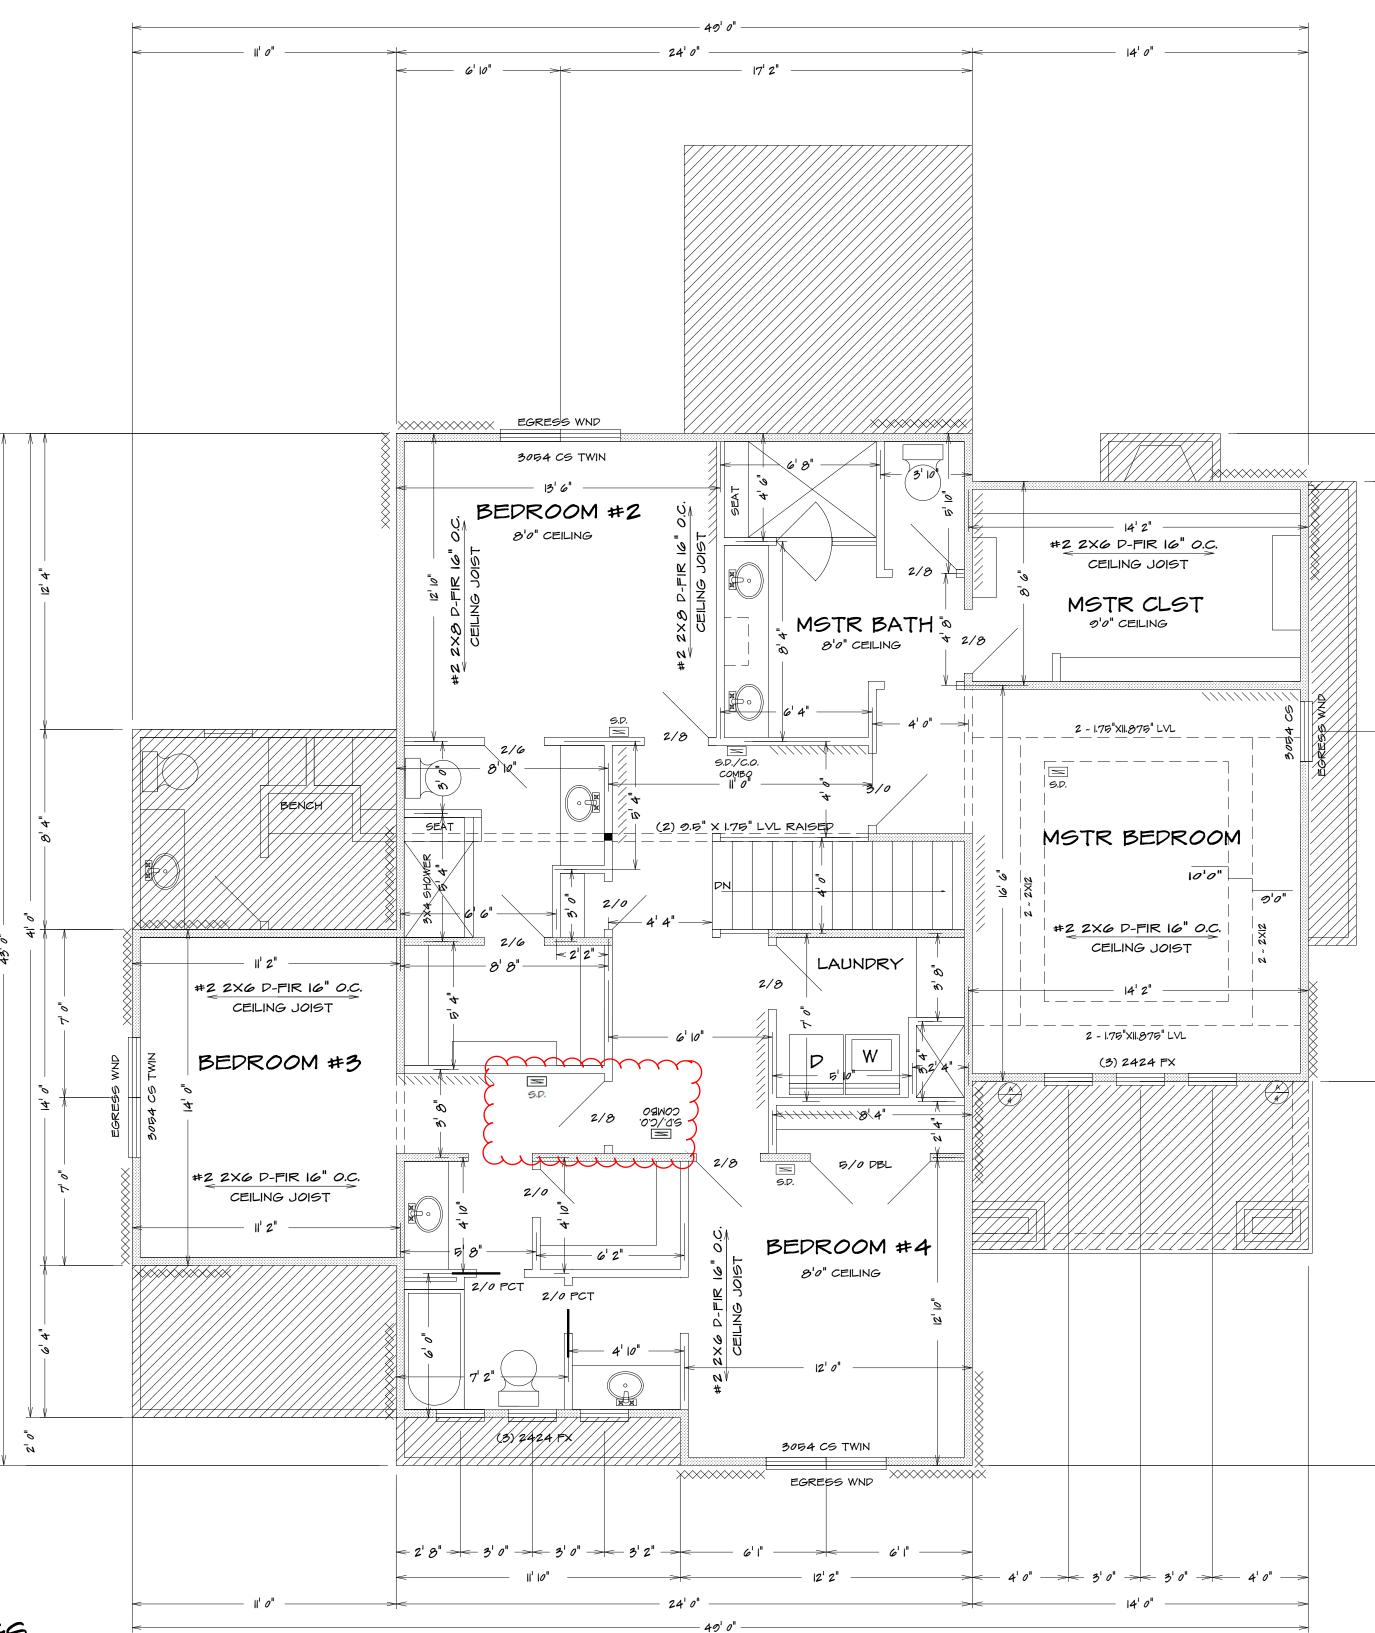


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	DATE DRAWN:			DATE REVISED:			DESIGNER:
	PHONE:			PHONE:			I DT NO
	HOME BUYER:			BUILDER:			SUB-DIVISION:
BUILDER@CONTRACTOR IS RESPONSIBLE TO CHECK ALL DIMENSIONS FOR ACCURACY	BETWEEN FLOORS, FOUNDATION, AND ELEVATIONS. ALSO VERIFY ALL BEAM, HEADERS,	PAP LOCATIONS, ANP COLUMN SIZES. BUILPER&CONTRACTOR TO CHECK FOR	COMPLIANCE WITH CONTRACTS, CITY, AND NATIONAL CODES. BUILDER&CONTRACTOR	ACCEPTS ALL RESPONSIBLITY FOR LOT PLACEMENT, SET-BACKS, AND FLOOD PLAINS.	BUILDER&CONTRACTOR AND HOME OWNER ACCEPTS RESPONSIBLITY FOR ANY AND ALL	COPYRIGHT INFRINGMENTS OR RESEMBLANCES TO OTHER COPYRIGHTED FLANS.	BUILDER@CONTRACTOR ACCEPTS RESPONSIBLITY FOR ANY AN ON SITE CHANGES MADE

RELEASE FOI

CONSTRUCTION AS NOTED ON PLANS REVIEW DEVELOPMENT SERVICES LEE'S SUMMIT, MISSOURI

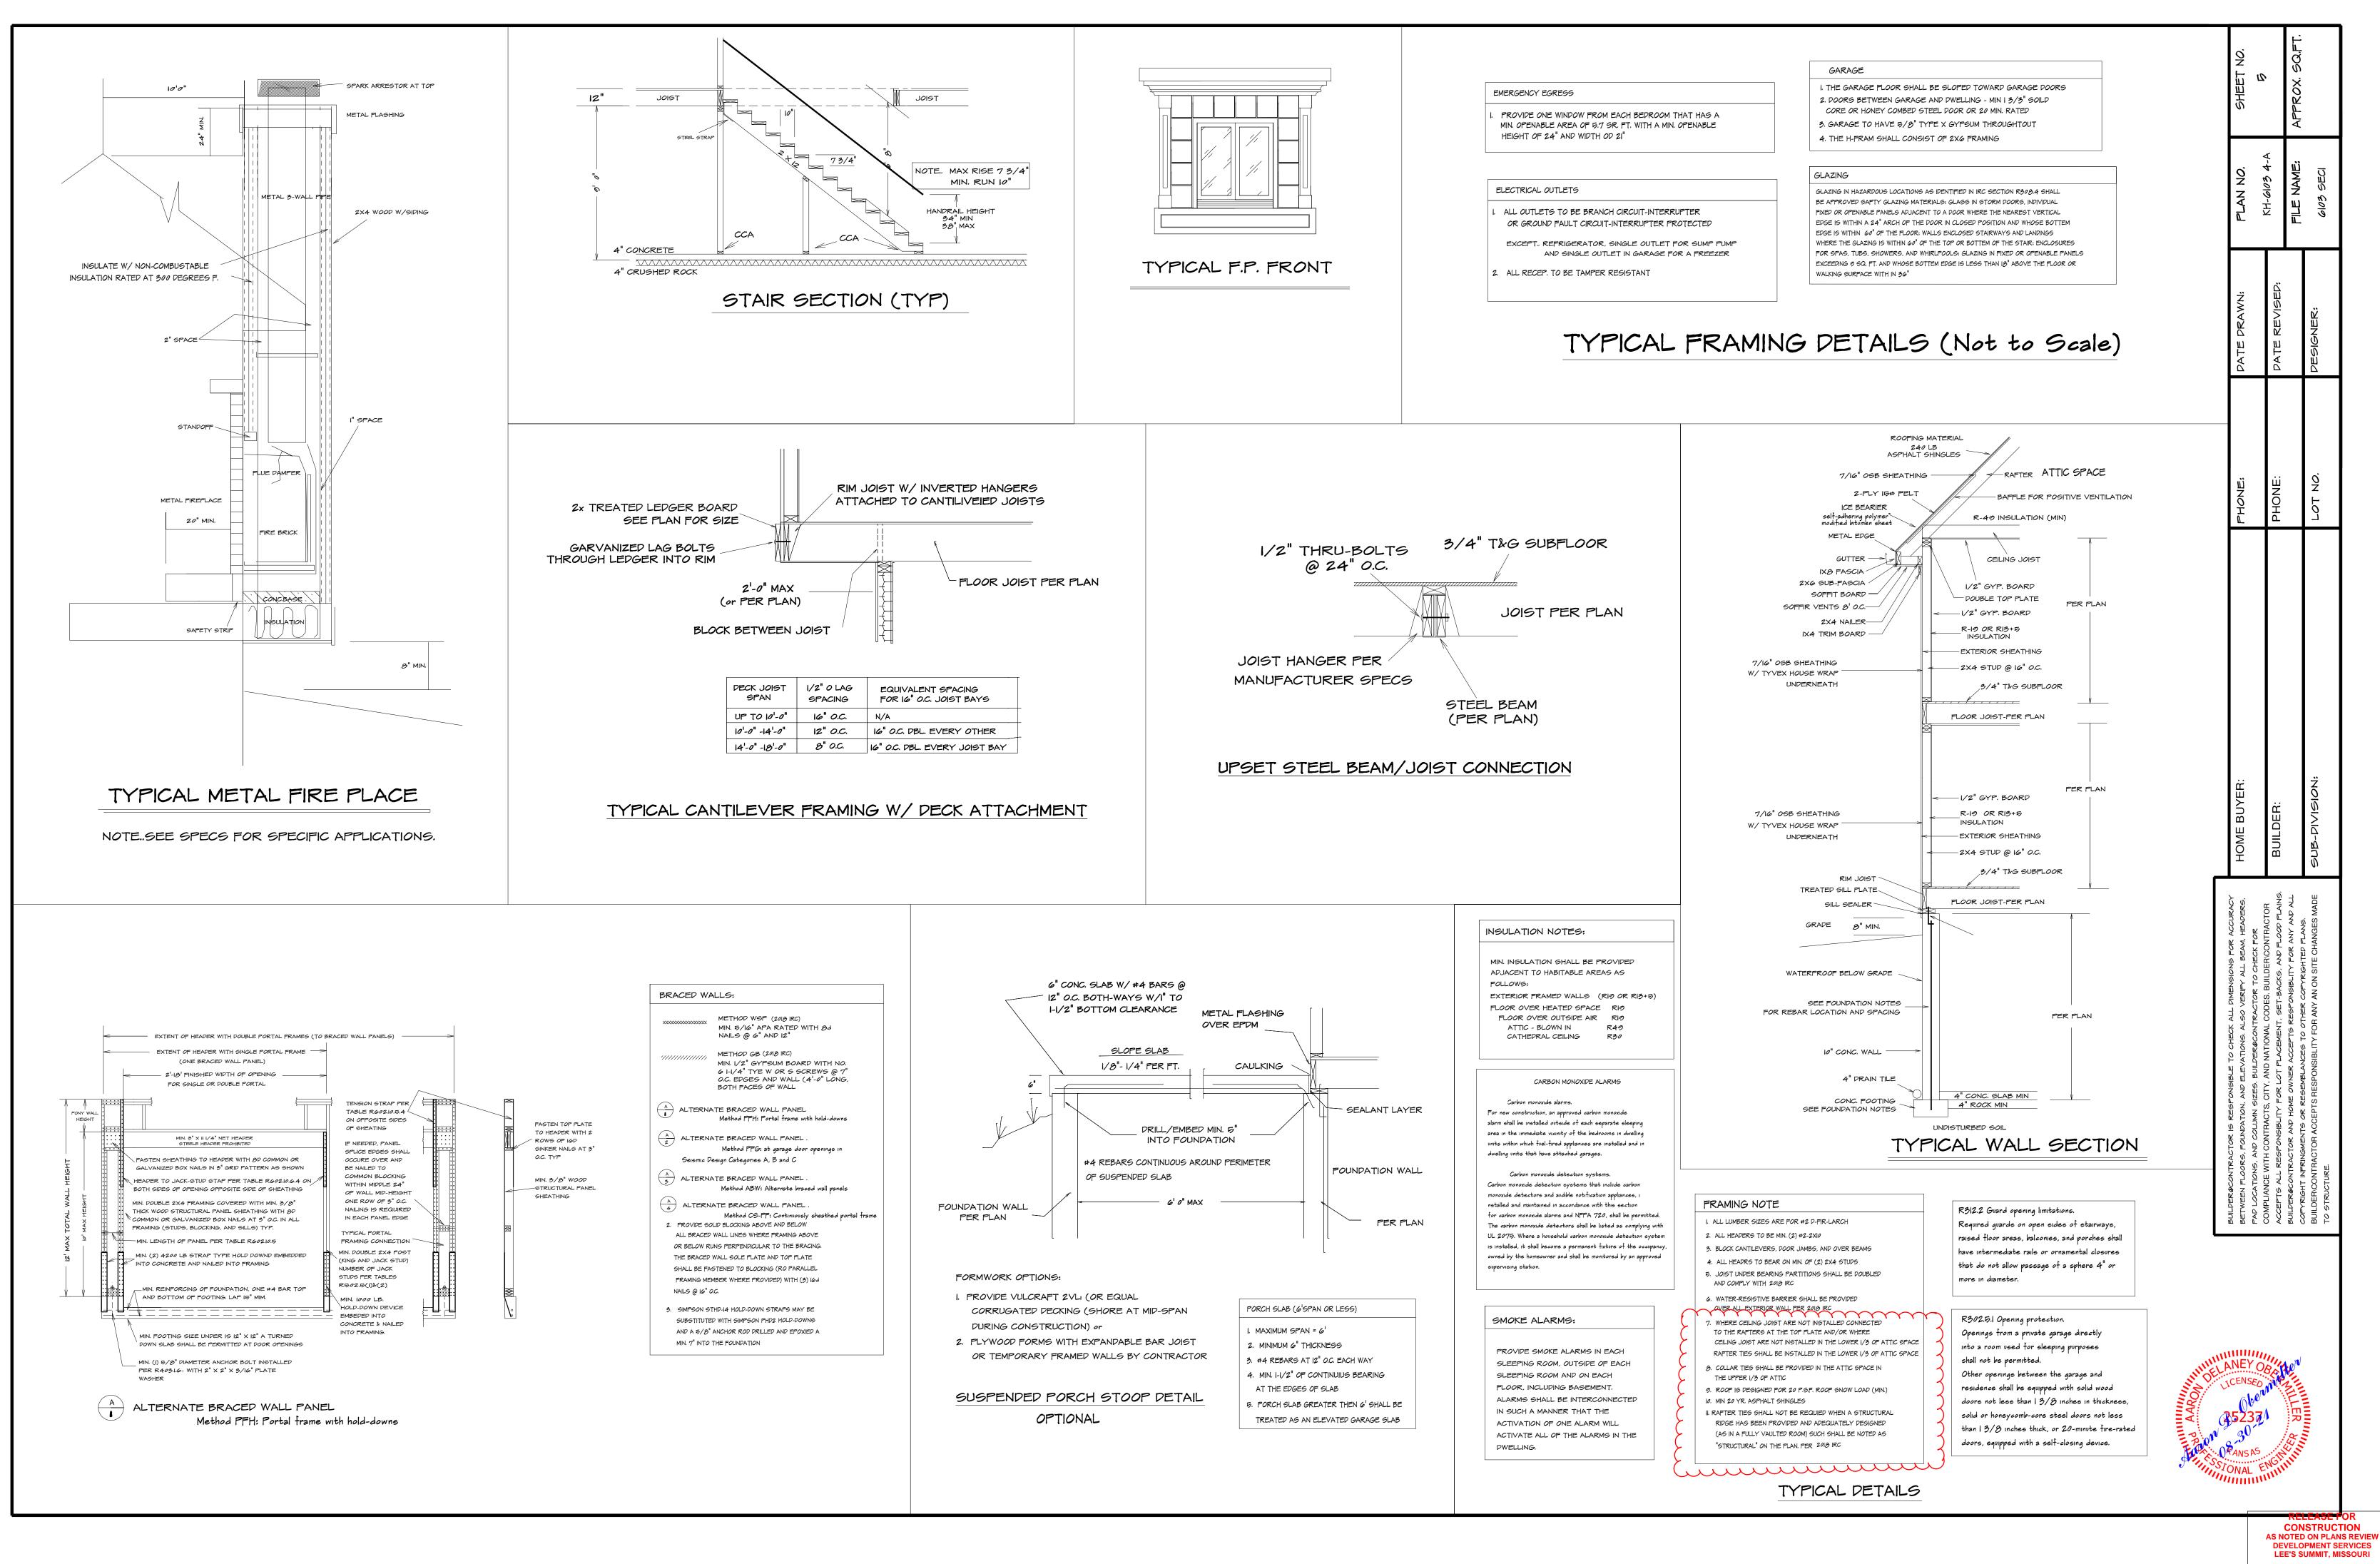

^{09/09/2021}

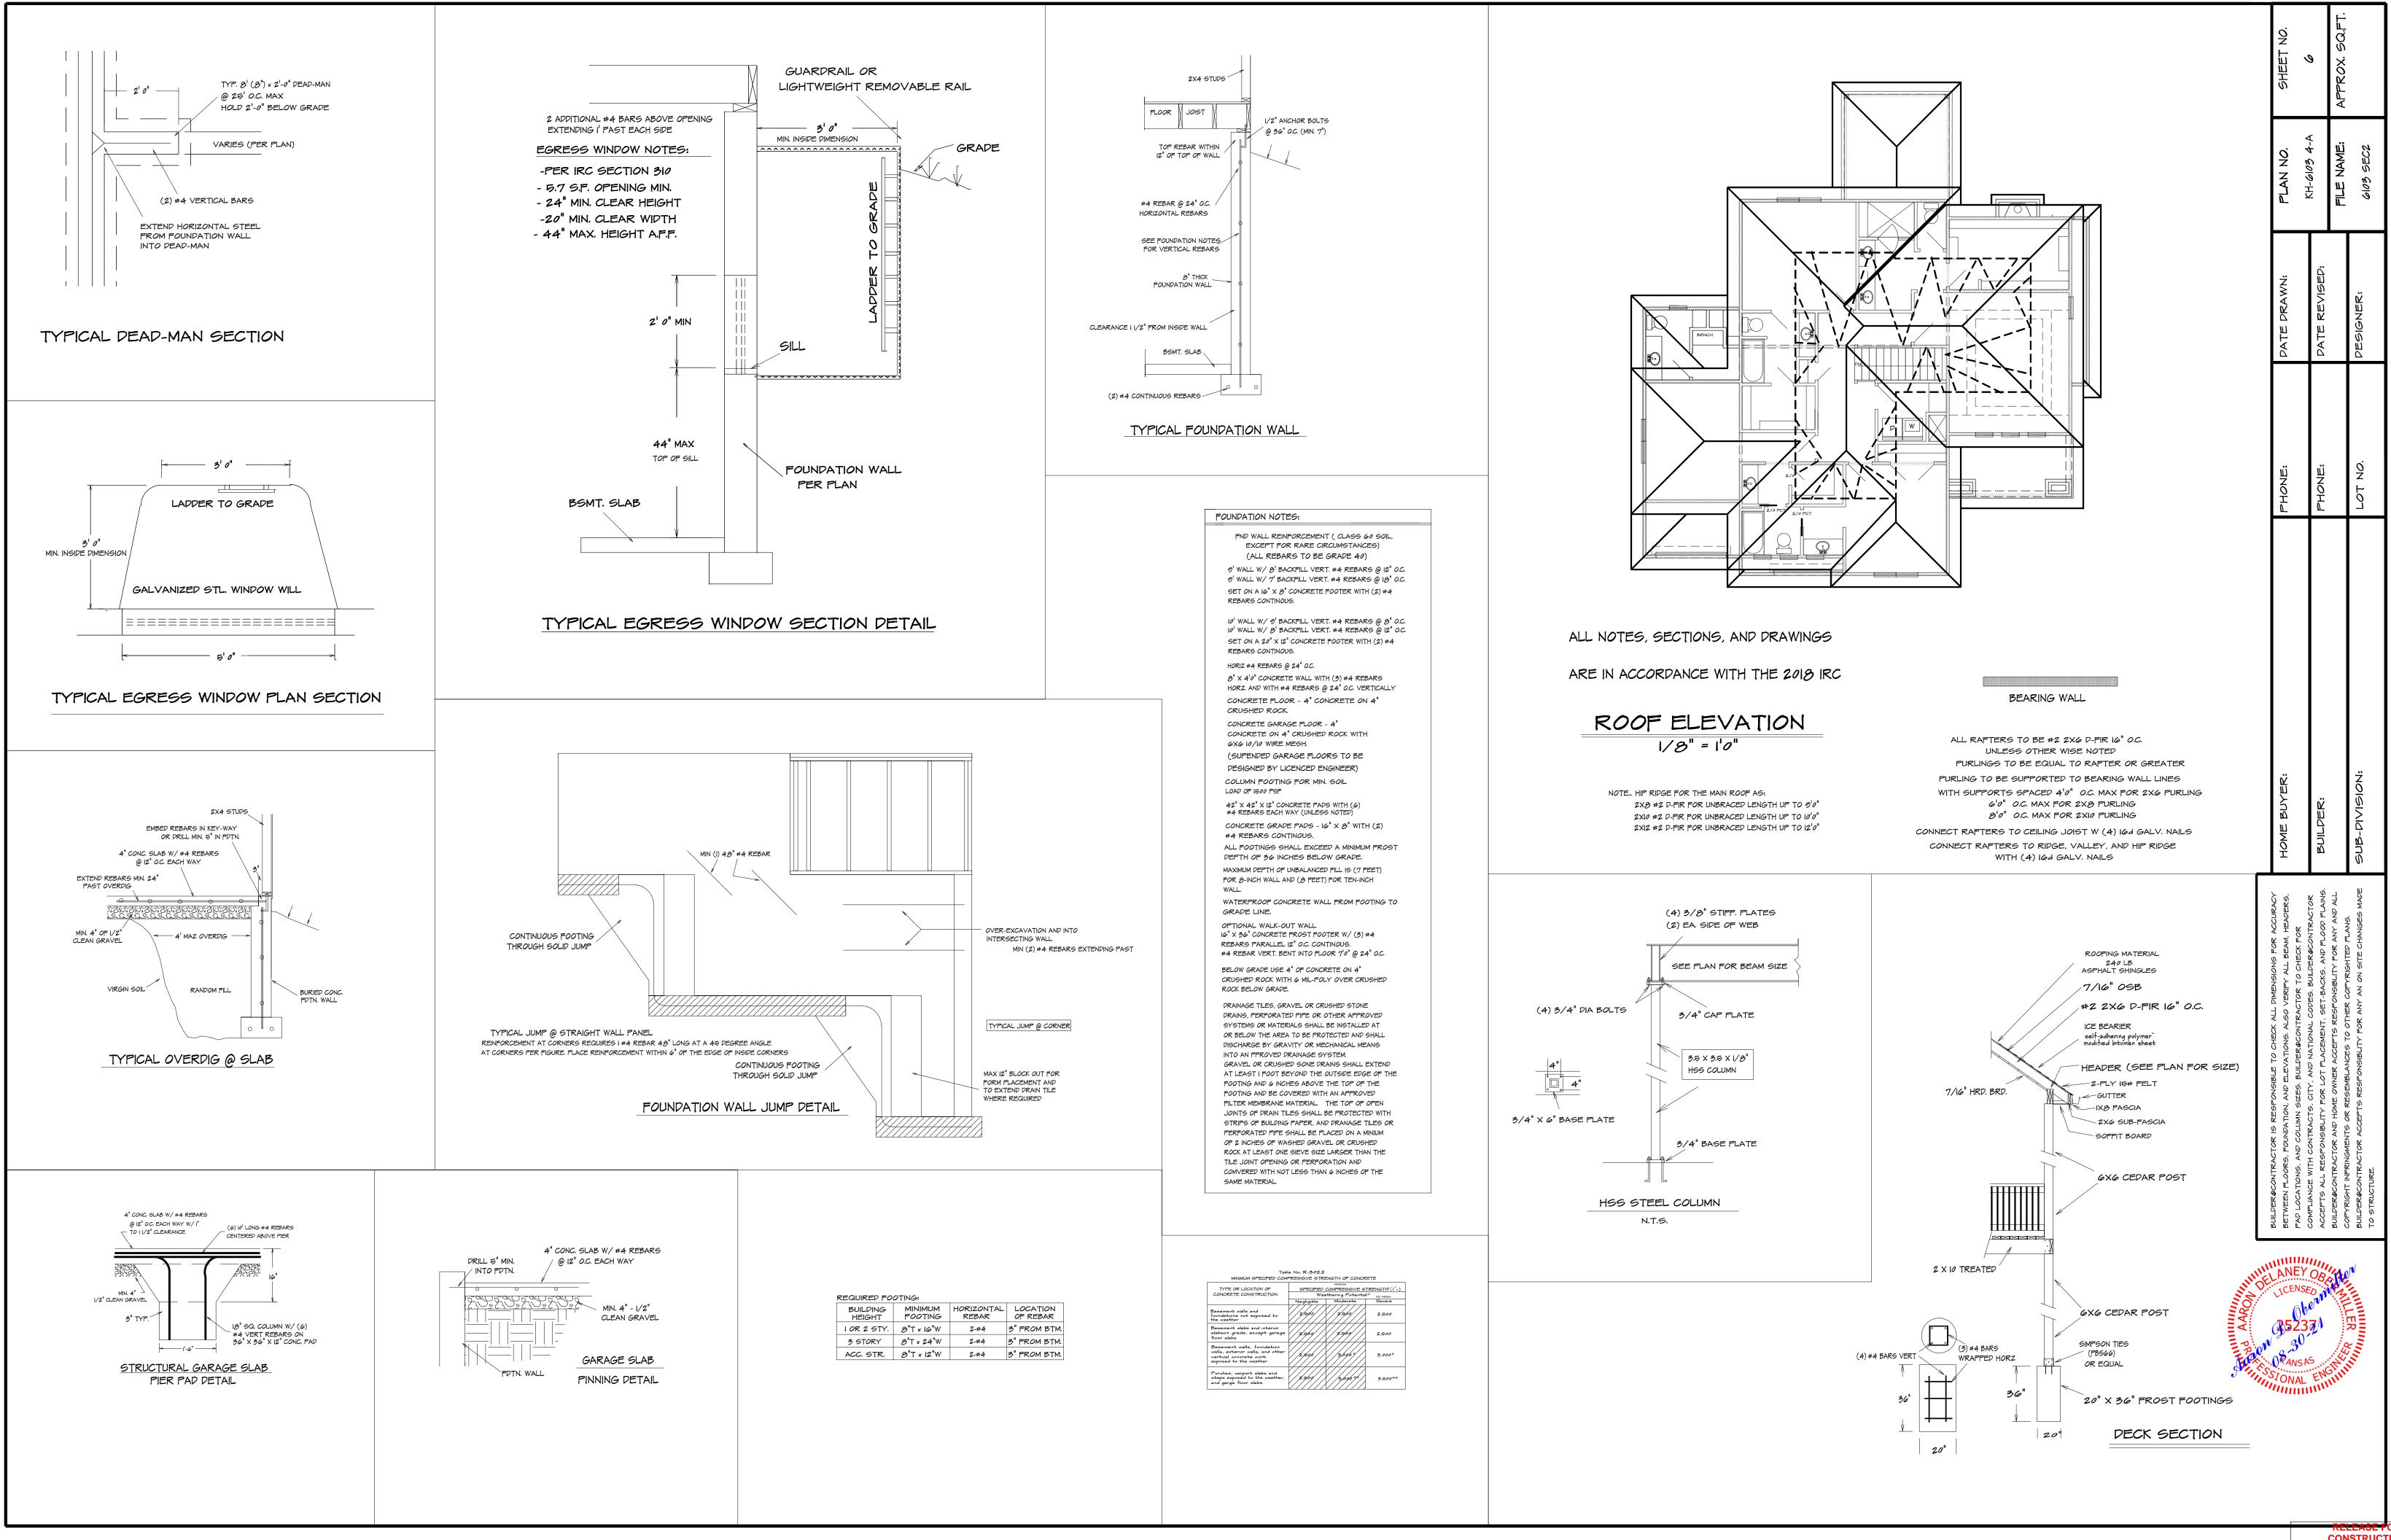

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