

LUMINAIRE SCHEDULE


TAG	MANUFACTURER & MODEL NO.	LAMP	CCT	VA SYSTEMS WATTS	GENERAL DESCRIPTION	NOTES
LTF-1	LITHONIA LIGHTING EPANEL-24-40L-35K OR APPROVED EQUAL	LED	3500	39	2'X4' LAY-IN TROFFER (WHITE COLOR TRIM) W/ INTEGRAL 90-MIN EMERGENCY BATTERY BACK-UP	INTERIOR
LRC-1	AMERLUX HOUSING: CLX-R6-NC-A17-25-120-D10V TRIM: CLX-RD6-A17-SDW-FL-3500K-83 OR APPROVED EQUAL	LED	3500	25	6" RECESSED LENSED LED DOWNLIGHT (MATTE WHITE TRIM)	INTERIOR
LEB-1	JUNO HOUSING: IC22 SERIES TRIM: 28W-WH EYEBALL OR APPROVED EQUAL	LED	3500	14	2e	INTERIOR
DLB-1	KUZCO LIGHTING PD1712-BK OR APPROVED EQUAL	LED	2700	12	11-3/4" DIA CHROMA PENDANT	INTERIOR
LTB-6	WAC LIGHTING MO-2020-935-BK OR APPROVED EQUAL	LED	3500	20	SILO X20 MOMOPOINT	INTERIOR
LE-2	LITHONIA LIGHTING LX-W-G	LED	---	2.5	EXIT LIGHT, GREEN LETTERS AC ONLY	INTERIOR

LIGHTING PLAN GENERAL NOTES

- REFER TO ARCHITECTURAL PLANS FOR EXACT LOCATION & ELVATION OF ALL LIGHTING FIXTURES AND ALL DEVICES. ALL WALL-MOUNTED DEVICE HEIGHTS SHALL BE VERIFIED WITH THE ARCHITECT PRIOR TO ROUGH-IN.
- VERIFY EXACT CEILING CONSTRUCTION WITH ARCHITECTURAL REFLECTED CEILING PLAN AND PROVIDE LIGHTING FIXTURES WITH ALL NECESSARY MOUNTING HARDWARE.
- ALL RECESSED FIXTURES SHALL BE PROVIDED WITH ALL REQUIRED STRUCTURAL SUPPORTS AS REQUIRED BY THE CURRENTLY ADOPTED ISSUE OF THE IBC, OR CBC WHERE ADOPTED, IN ADDITION TO ANY LOCAL CODES.
- ALL DIMMING BRANCH CIRCUITS SHALL BE PROVIDED WITH A DEDICATED NEUTRAL CONDUCTOR FOR EACH ZONE/CHANNEL..
- ALL EMERGENCY BATTERY PACK FIXTURES SHALL BE PROVIDED WITH A CONSTANT HOT CONNECTION TO THE CHARGING LEAD.
- REFER TO ARCHITECTURAL REFLECTED CEILING PLANS FOR EXIT SIGN CHEVRONS AND NUMBER OF FACES PER EXIT SIGN. ANY DISCREPANCIES BETWEEN EXIT SIGNS SHOWN ON THE ELECTRICAL AND ARCHITECTURAL PLANS SHALL BE BROUGHT TO THE ATTENTION OF THE ARCHITECT PRIOR TO ORDERING EXIT SIGNS.
- PROVIDE ADDITIONAL J-BOX NEAR PANEL FOR MULTIPLE HOMERUN CIRCUITRY.

KEY NOTES

- LOCATION OF SWITCH BANK
- RUN LIGHTING CIRCUIT VIA SWITCH, PROVIDE ADDITIONAL HOT WIRE FOR EXIT SIGN AND EMERGENCY LIGHTS.
- PROVIDE OCCUPANCY SENSOR FOR FULLY SHUT OFF. PROVIDE ADEQUATE SENSOR DEVICES SENSING ENTIRE ENCLOSED SPACE WHERE THE SYMBOL LOCATED.
- LIGHTING INSIDE THE COOLER/FREEZER SHALL BE PROVIDED BY THE COOLER/FREEZER MANUFACTURER. FINAL CONNECTION BY E.C. SEE POWER PLAN FOR BRANCH CIRCUIT
- PROVIDE AN EYS FITTING FOR CONDUITS THAT ENTER AND EXIT FREEZERS AND COOLER. OBTAIN APPROVAL FROM INSPECTOR PRIOR TO INSTALLING SEALANT.

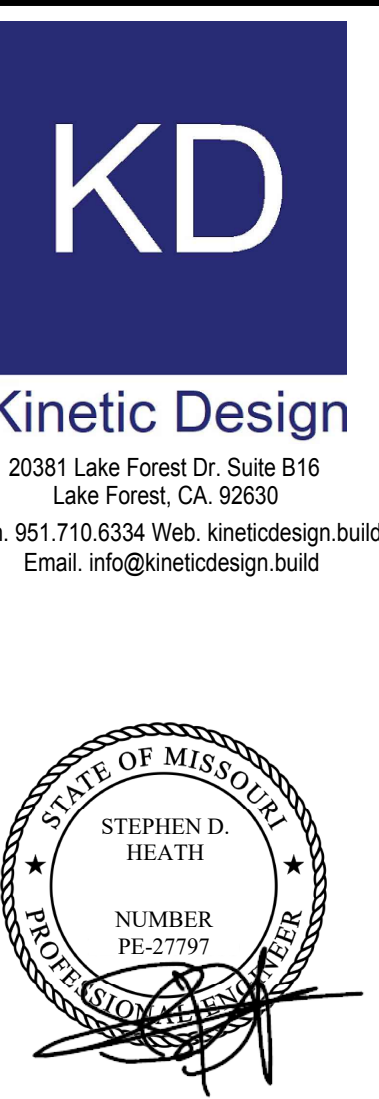

NOT FOR CONSTRUCTION

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REVISIONS

No.	DATE	DESCRIPTION

CLIENT INFORMATION




PROJECT NAME
NEKTER - LEE'S SUMMIT, MO
940 NW PRYOR ROAD, RETAIL SPACE 5,
LEE'S SUMMIT, MISSOURI 64081

SHEET NAME
LIGHTING PLAN

DRAWN	CHECKED
DATE	07/30/21
SCALE	AS NOTED
PROJECT NUMBER	
SHEET	

E201

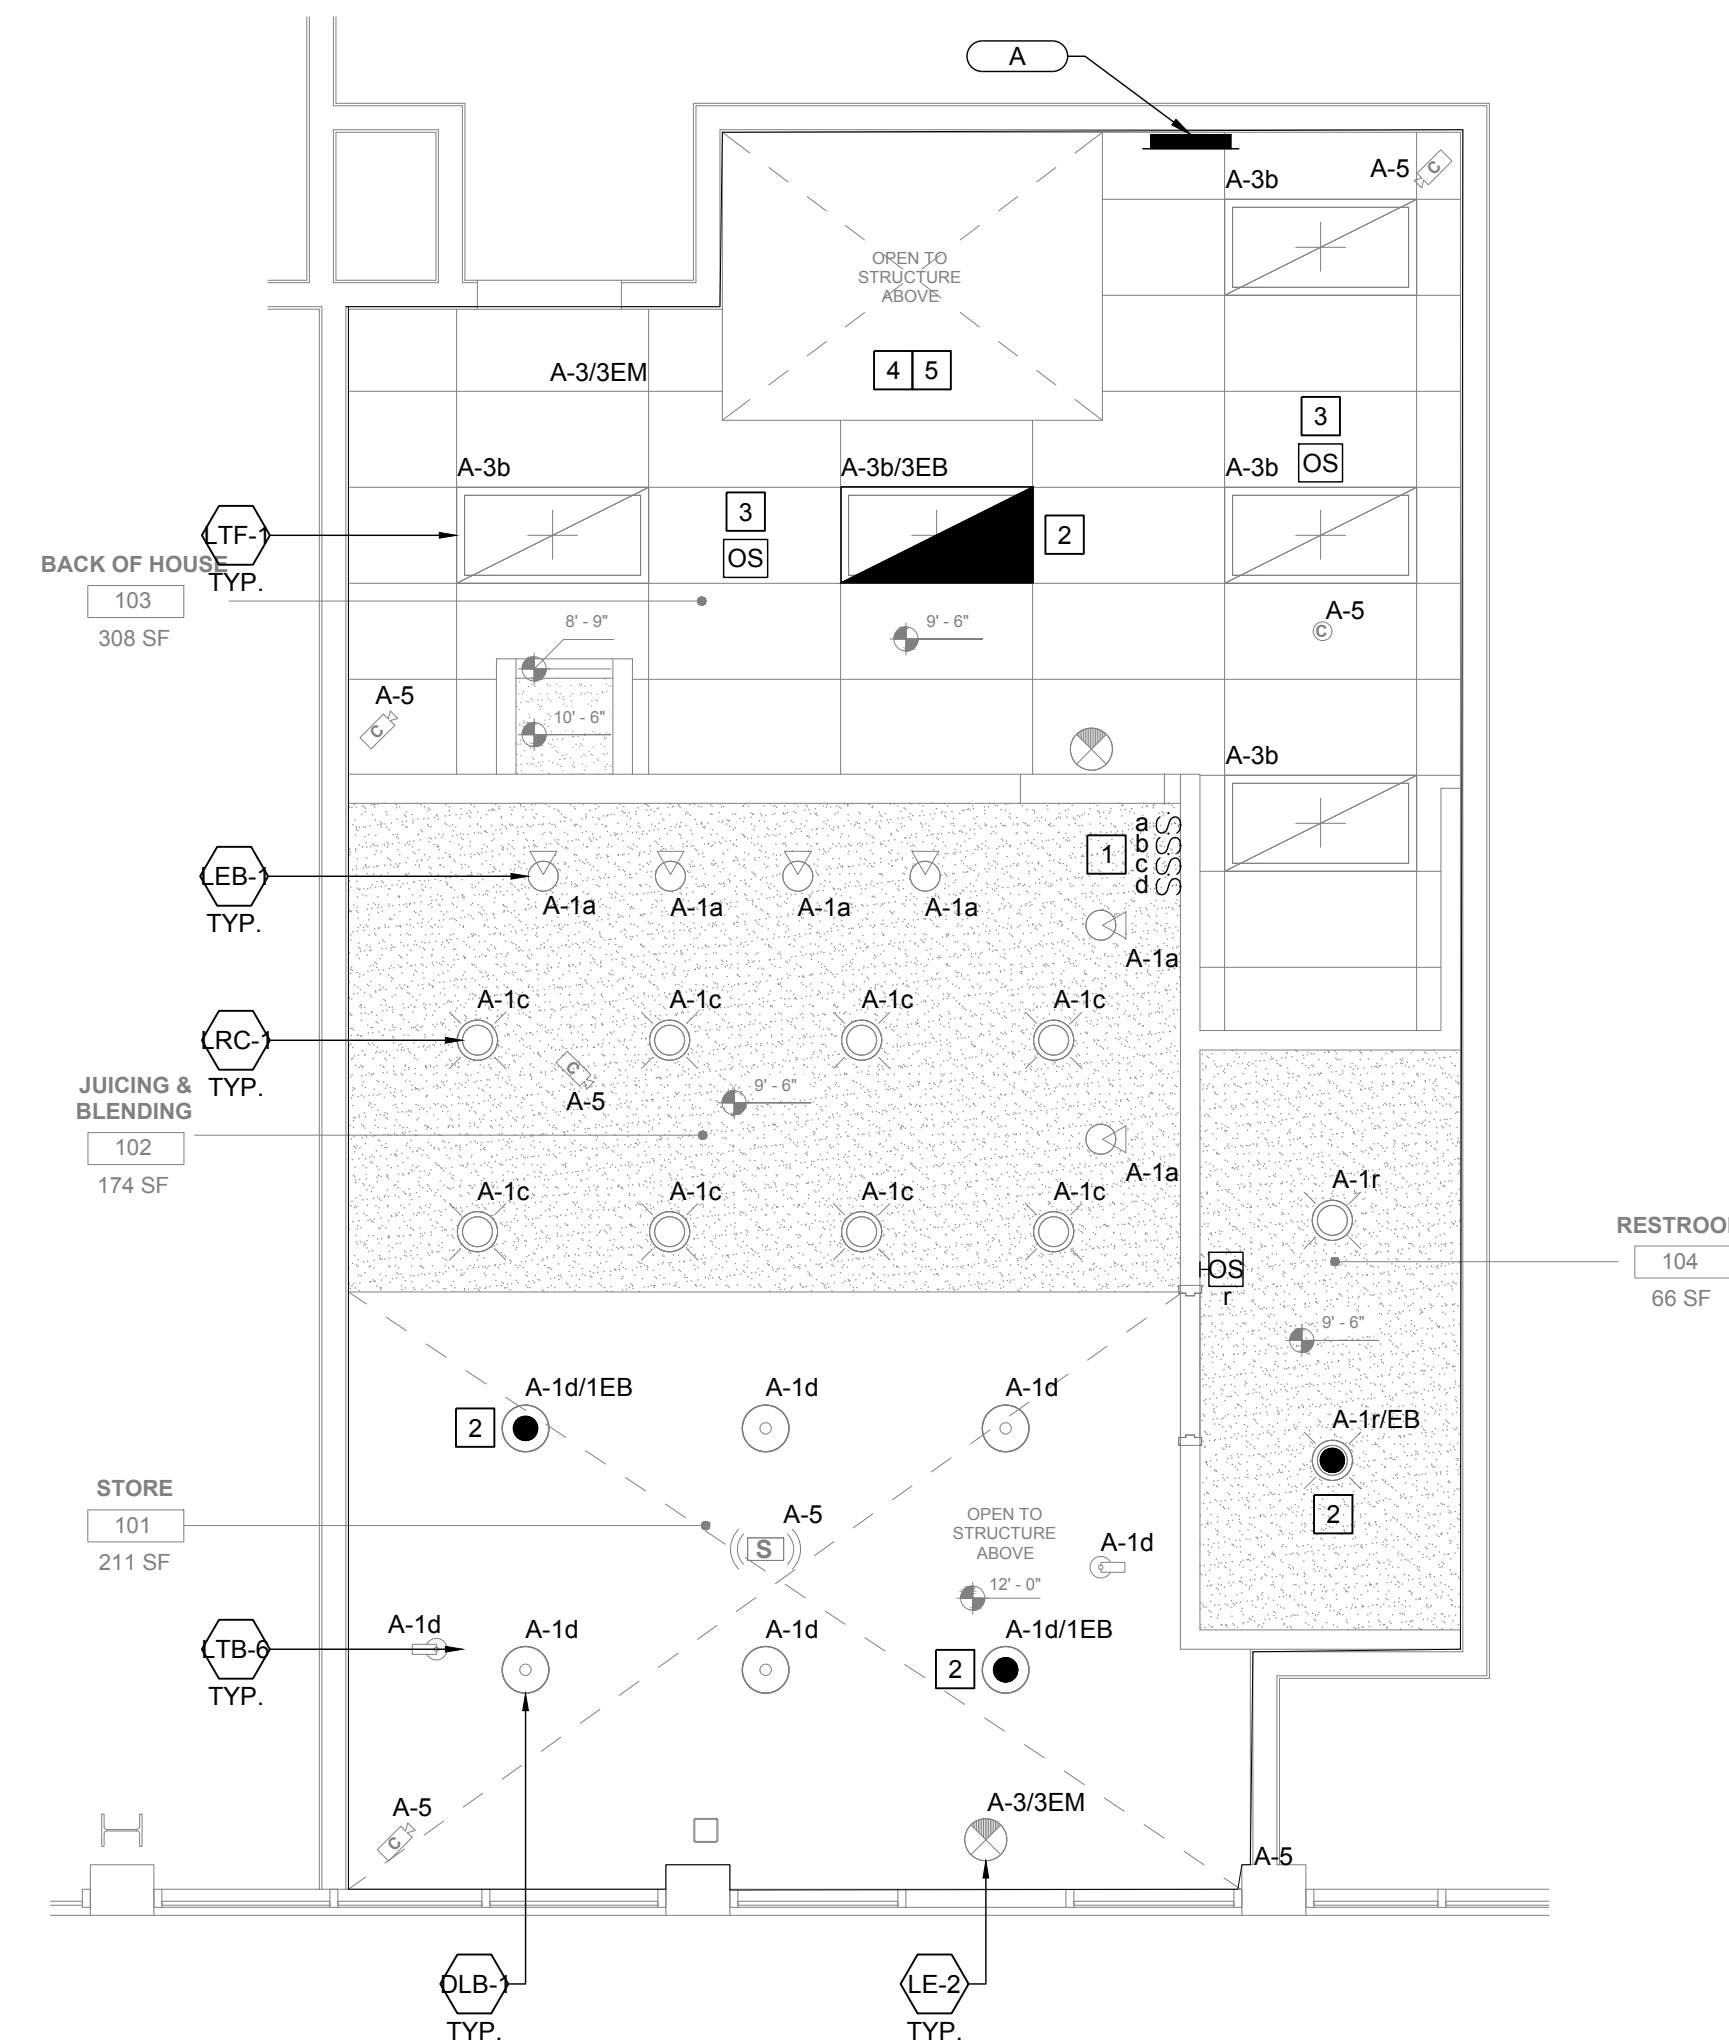

LIGHTING PLAN

Scale: 1/4" = 1'-0" 1


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POWER PLAN GENERAL NOTES

- ALL RECEPTACLES ON COMMON WALLS SHALL BE SEPARATE BOXES AND OFFSET 24" MINIMUM.
- MULTI-WIRED (SHARED NEUTRAL) BRANCH CIRCUITS SHALL NOT BE INSTALLED. ALL 120 & 277 VOLT BRANCH CIRCUITS SHALL HAVE A DEDICATED INDIVIDUAL NEUTRAL CONDUCTOR.
- PROVIDE G.F.C.I. TYPE RECEPTACLE(S) OR RECEPTACLE(S) PROTECTED BY GFCI CIRCUIT BREAKER(S) WHEN LOCATED WITHIN 6 FEET OF ANY SINK OR THERAPEUTIC TUB, SERVING ANY DRINKING FOUNTAIN OR VENDING MACHINE, WITHIN ANY KITCHEN SPACE AND/OR LOCATED OUTDOORS. WHERE RECEPTACLES ARE NOT READILY ACCESSIBLE, PROVIDE GFCI CIRCUIT BREAKER(S) TO PROTECT THE RESPECTIVE BRANCH CIRCUIT AND PROVIDE ADDITIONAL NEUTRAL CONDUCTORS IN THE BRANCH CIRCUITING AS REQUIRED TO ENSURE PROPER GFCI FUNCTION.
- ALL 15- AND 20- AMPERE, 125- AND 250-VOLT NONLOCKING TYPE RECEPTACLES THROUGHOUT BUILDING SHALL BE LISTED TAMPER-RESISTANT RECEPTACLES, NO EXCEPTIONS.
- ALL RECEPTACLES IDENTIFIED AS WEATHERPROOF ON THE DRAWINGS SHALL BE WEATHER-RESISTANT, TAMPER-RESISTANT, GFCI TYPE AND EQUIPPED WITH ENCLOSURE THAT IS WEATHERPROOF (WP) WHETHER OR NOT THE ATTACHMENT PLUG CAP IS INSERTED (WHILE "IN-USE"), AN OUTLET BOX HOOD SHALL BE LISTED AND SHALL BE IDENTIFIED AS "EXTRA DUTY".

POWER PLAN KEYNOTES

- PROVIDE RECEPTACLES MOUNTED WITHIN MILLWORK FOR EQUIPMENT. COORDINATE EXACT LOCATION AND MOUNTING HEIGHT WITH GC PRIOR TO BID AND ROUGH-IN.
- RECEPTACLE FOR SHOW WINDOW AS REQUIRED BY CODE. VERIFY WITH LOCAL AGENCY. CONNECT TO CIRCUIT NOTED.
- PROVIDE 120V POWER FOR WALK-IN COOLER LIGHTS AND DOOR HEATER. CONTRACTOR SHALL INSTALL, WIRE AND PROVIDE LAMPS FOR WALK-IN COOLER LIGHTS.
- MAKE PENETRATIONS IN WALK-IN COOLER W/ CONDUIT SEALING FITTINGS & NIPPLE TO CAST FIXTURE J-BOX. CIRCULATION OF AIR FROM WARMER TO COLDER SECTIONS OF INTERIOR RACEWAY SYSTEM EXPOSED TO WIDELY DIFFERENT TEMPERATURES SHALL HAVE JOINTS FOR CONDUIT AS REQUIRED TO COMPENSATE FOR THERMAL EXPANSION AND CONTRACTION. PROVIDE SEALING COMPOUND AFTER WIRING IS FINISHED.
- REQUIREMENTS FOR WALK-IN COOLER:
 - A. PROVIDE WIRING TO EVAPORATOR
 - B. PROVIDE CONTROL WIRING BETWEEN CONDENSER & EVAPORATOR IF REQUIRED BY INSTALLATION INSTRUCTION
 - C. INSTALL FREEZER & COOLER LIGHT FIXTURES THAT ARE SHIPPED LOOSE.
 - D. PROVIDE POWER AND CONTROL WIRING FOR FREEZER CONDENSER AND HEAT TAPE DIRECTLY FROM FREEZER CONDENSER.
 - E. VAPOR SEAL ALL CONDUIT PENETRATIONS. PENETRATIONS MUST BE PROPERLY SEALED AGAINST COLD LOST AND INFILTRATION TO PREVENT CONDENSATION AND ICE FORMATION. SILICONE CAULKING IS THE RECOMMENDED SEALANT AROUND PENETRATED ITEMS.
- PROVIDE ASTRONOMICAL TIMECLOCKS, MOUNTED AT 44" AFF, COORDINATE LOCATION WITH LANDLORD.
- PROVIDE 24"x24"x3/4" FIRE RATED PLYWOOD BACKBOARD WITH QUAD RECEPTACLE ELECTRICAL CONTRACTOR TO PROVIDE TELEPHONE CONDUIT FROM LANDLORD'S DEMARK, CONTRACTOR TO VERIFY DEMARK LOCATION PRIOR TO BID. PROVIDE FIRE RATED LABEL AND DO NOT PAINT BACKBOARD.
- PROVIDE WEATHERPROOF J-BOX AND MANUAL DISCONNECT SWITCH FOR CONNECTION TO BUILDING EXTERIOR SIGN(S), SIGN CONTROLLED BY ASTRONOMICAL PROGRAMMABLE TIME CLOCK. COORDINATE WITH LANDLORD REQUIREMENTS AND SIGNAGE VENDOR.
- PROVIDE A 60AS/50AF/3P DISCONNECT SWITCH ON WALL FOR WALK-IN COOLER CONDENSING UNIT.
- PROVIDE DUPLEX/USB OUTLETS IN MILLWORK 22" AFF AS SHOWN. COORDINATE INSTALLATION WITH MILLWORK DRAWINGS.
- PROVIDE DUPLEX/USB OUTLETS IN MILLWORK 44" AFF AS SHOWN. COORDINATE INSTALLATION WITH MILLWORK DRAWINGS.
- SNUG UNDER COUNTERTOP SEE MILLWORK ELEVATIONS
- POWER @+18" AFF
- POWER @+30" AFF
- POWER @+42" AFF
- DATA/POWER @+65" AFF

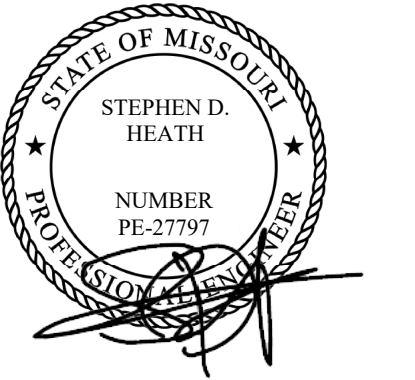

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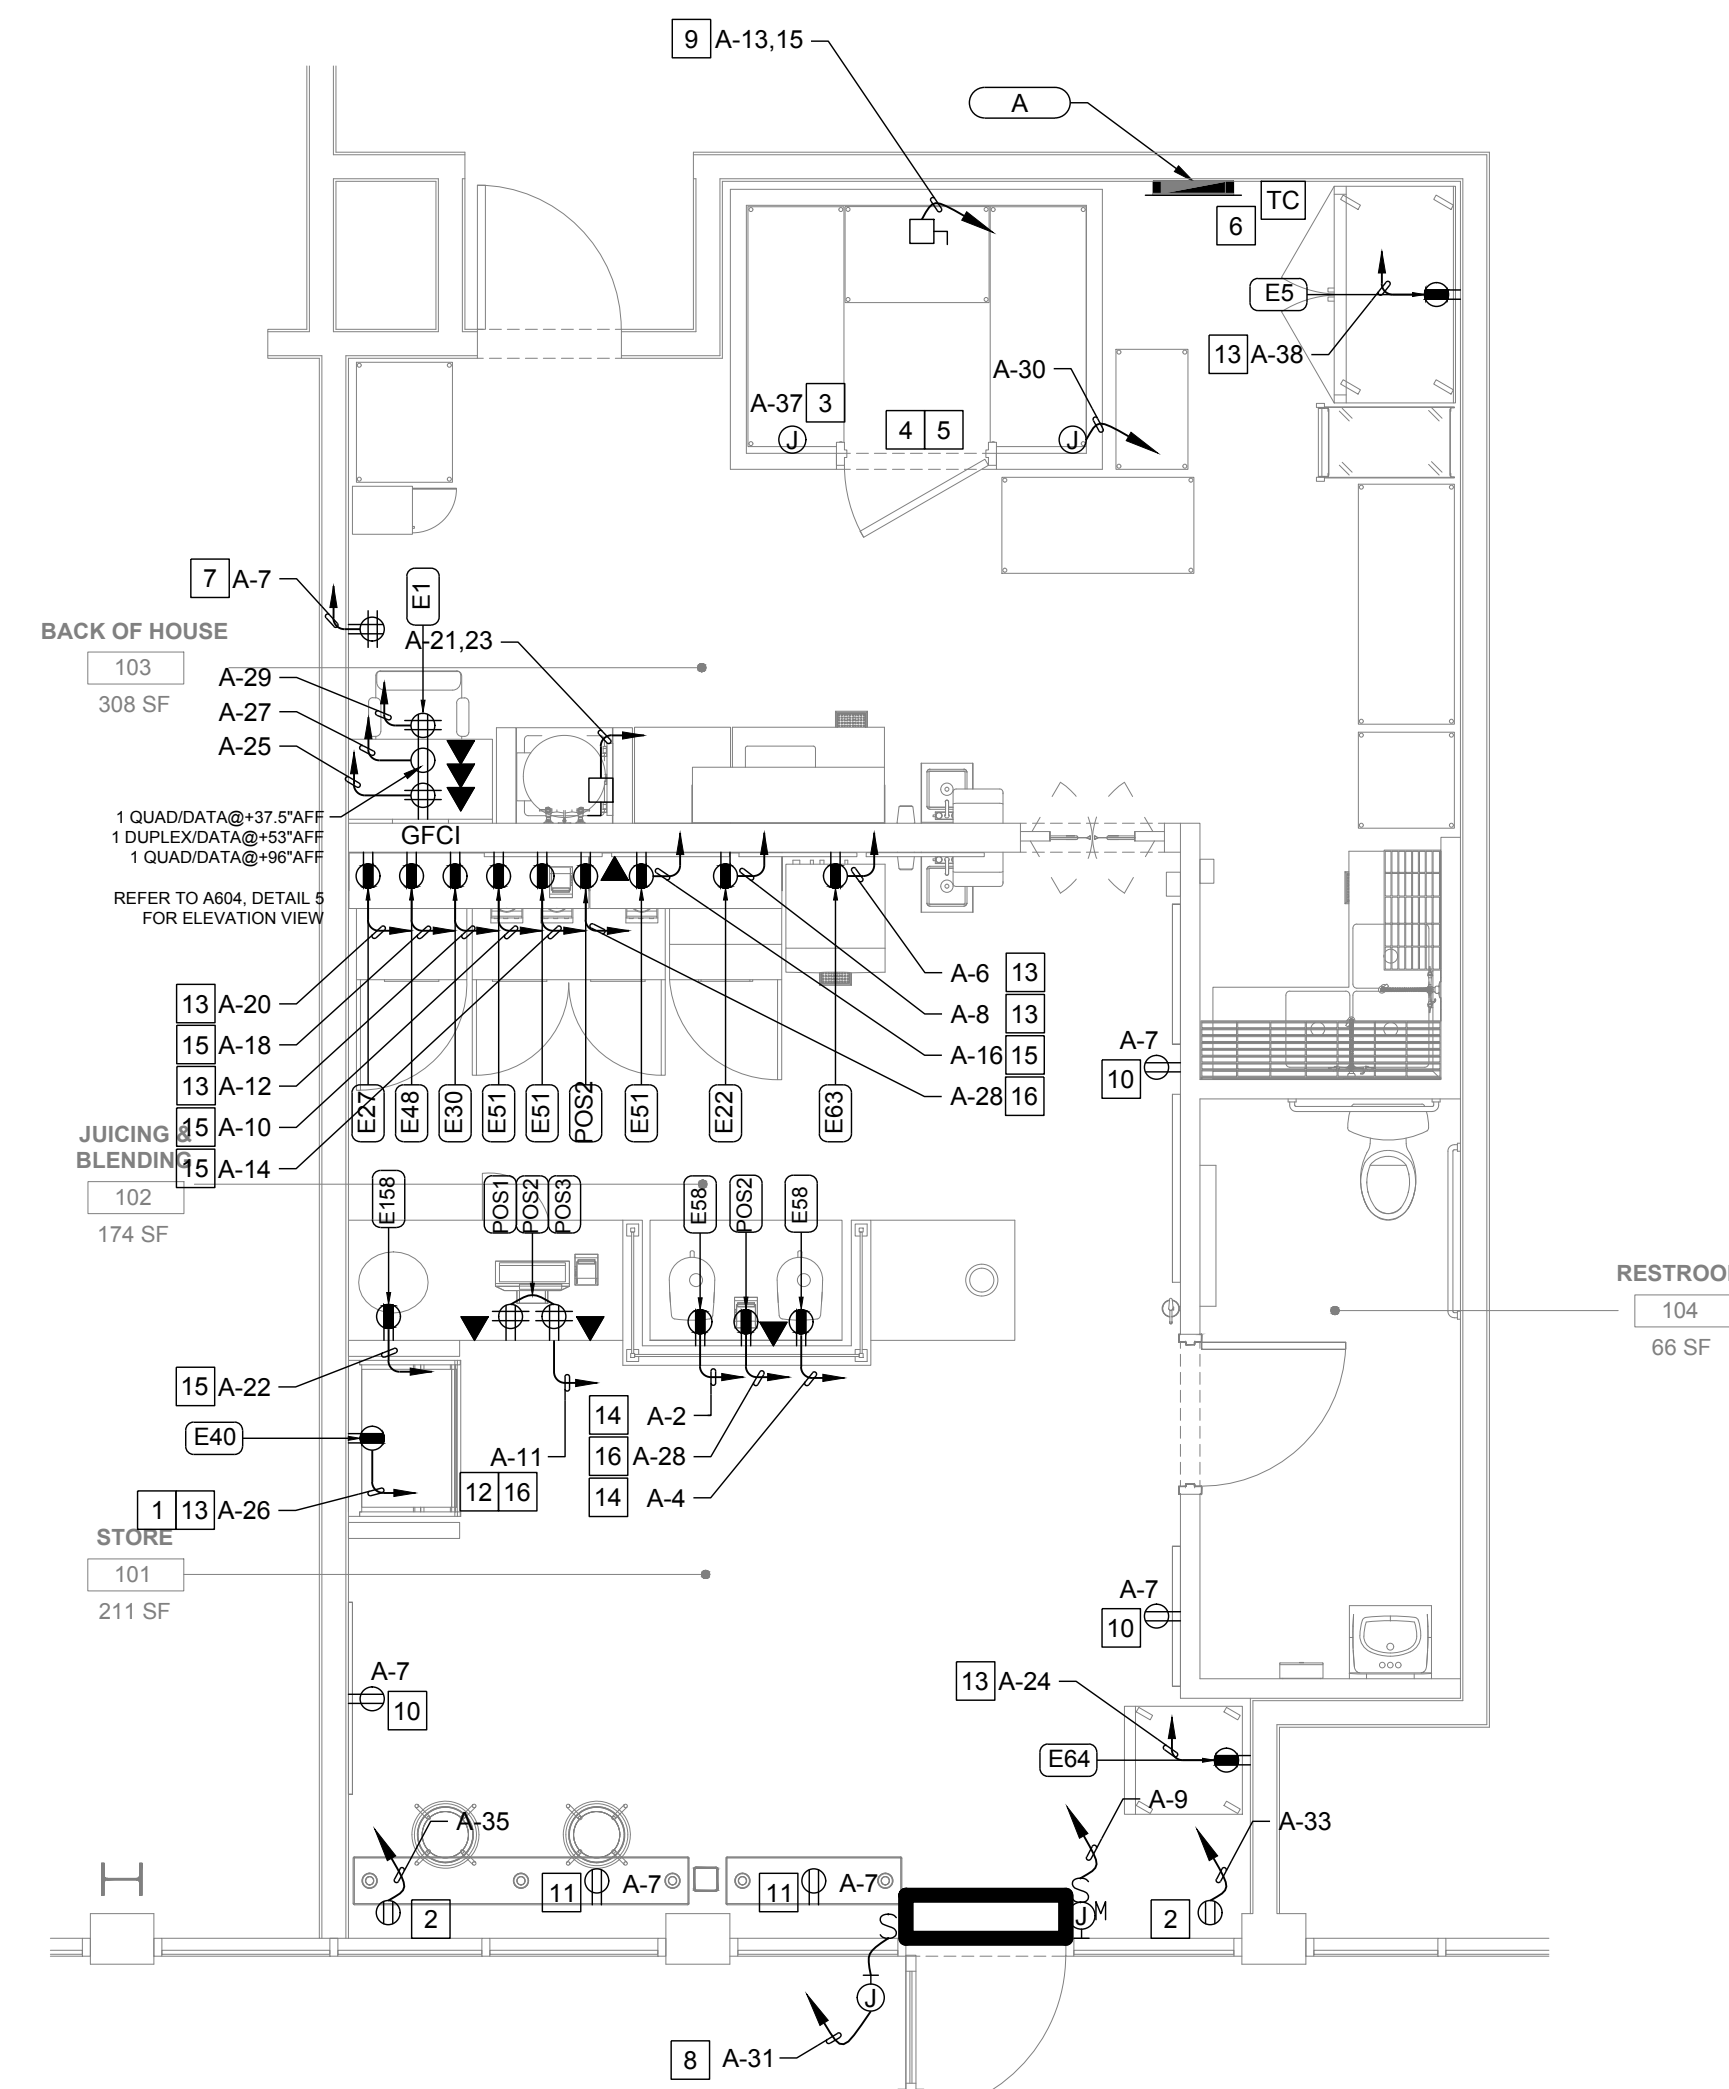


NEKTER - LEE'S SUMMIT, MO
 940 NW PRYOR ROAD, RETAIL SPACE 5,
 LEE'S SUMMIT, MISSOURI 64081

PROJECT NAME
 SHEET NAME
POWER PLAN

DRAWN	CHECKED	WR
DATE		07/30/21
SCALE		AS NOTED
PROJECT NUMBER		
SHEET		

E301



POWER PLAN

Scale: 1/4" = 1'-0" 1

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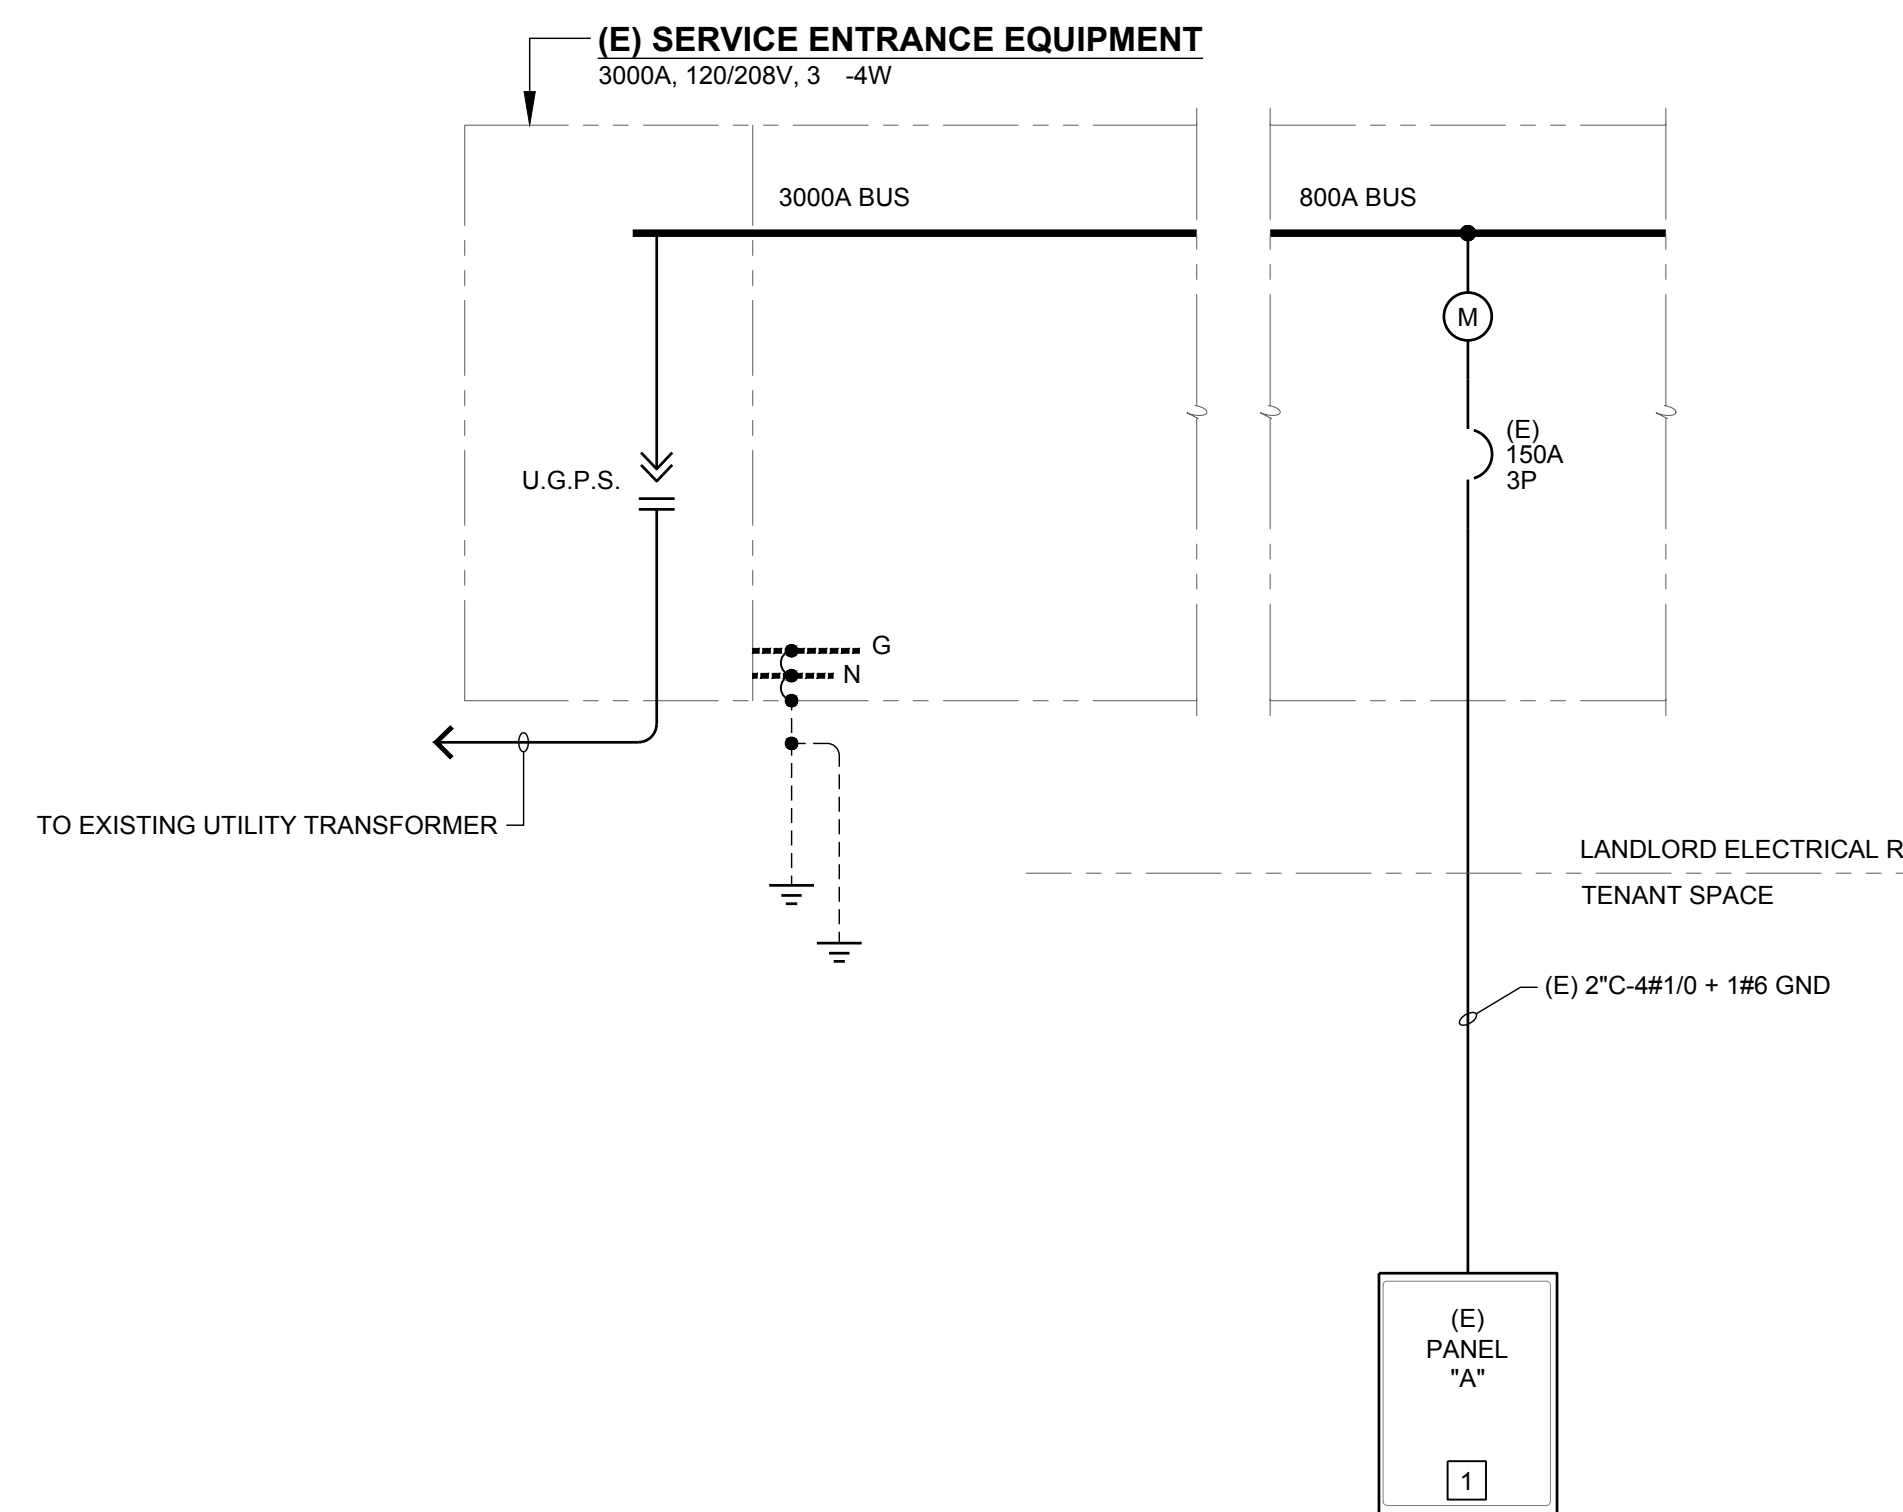
CLIENT INFORMATION



NEKTER - LEE'S SUMMIT, MO
940 NW PRYOR ROAD, RETAIL SPACE 5,
LEE'S SUMMIT, MISSOURI 64081

PROJECT NAME
SHEET NAME

DRAWN:
DATE: 07/30/21
SCALE: AS NOTED
PROJECT NUMBER
SHEET



REFERENCE NOTES

1. EXISTING PANEL WITH REVISED LOADS. REFER TO PANEL SCHEDULE THIS SHEET. ALL NEW CIRCUIT BREAKERS INSTALLED WITHIN PANELBOARD SHALL MATCH THE HIGHEST EXISTING AIC RATED BREAKERS WITHIN PANELBOARD. INSPECTOR TO VERIFY AT SITE.

1 PARTIAL SINGLE LINE DIAGRAM
SCALE: NONE

MFR:		PANEL: "A"									*PANEL IS EXISTING											
MOUNTING: <u>RECESSED</u>		DOUBLE LUG: <u>NO</u>		VOLTS: <u>208Y/120V</u>		PROVISIONS FOR SUB-METER: <u>YES</u>		MAIN: <u>MLO</u>														
NEMA 3R: <u>NO</u>		200%: <u>NO</u>		PHASES: <u>3</u>		DISAGGREGATION TYPE: <u>NO</u>		BUS: <u>225A</u>														
FEED THRU: <u>NO</u>		I/G BUS: <u>NO</u>		WIRE: <u>4</u>				A.I.C.: <u>18,000</u>														
LOADS	CLASSIFICATION	DESCRIPTION	TRIP AMPS	POLES	A	B	C	A	B	C	POLES	TRIP AMPS	DESCRIPTION	CLASSIFICATION	NOTES							
L 1		BOHSTORE LTG	20A	1	485			1300			1	20A	E58 MULTI JUICER	2	K							
L 3		FOH HALLWAY /RR	20A	1		507			1300		1	20A	E58 MULTI JUICER	4	K							
R 5		LOW VOLTAGE EQUIPMENT	20A	1			500			1309	1	20A	E63 ICE MAKER	6	K							
R 7		CONVENIENCE REC.	20A	1	500			564			1	20A	E22 FOOD REFRIGERATED PREP TABLE	8	K 3							
M 9		E136 AIR CURTAIN	20A	1		276			1560		1	20A	E51 BLENDER #1	10	K							
R 11		POS 1/POS2/POS3	20A	1			600			368	1	20A	E30 WORKTOP FREEZER	12	K 3							
K 13		E79 WALK-IN COOLER	20A	2	345			1560			1	20A	E51 BLENDER #2	14	K							
K 15		----	--	--		345			1560		1	20A	E51 BLENDER #3	16	K							
17		SPARE	20A	1						400	1	20A	E48 DIPPER WELL SQUARE	18	K							
19		SPARE	20A	1				230			1	20A	E27 FOOD REFRIGERATED	20	K 3							
N 21		WH-1	30A	2		1498			1300		1	20A	E158 OATMEAL WARMER	22	K							
N 23		----	--	--			1498			1265	1	20A	E64 REACH-IN REFRIGERATOR	24	K 3							
R 25		WORKSTATION (COMPUTER MONITOR)	20A	1	360			1725			1	20A	E40 REFRIDGE SELF SERVICE	26	K 3							
R 27		WORKSTATION (SECURITY MONITOR)	20A	1		360		300			1	20A	POS 2 (PRINTER)	28	K							
R 29		WORKSTATION (POS & COMPUTER)	20A	1			600			1020	1	20A	HEAT TRACE COOLER	30	R							
L 31		SIGNAGE	20A	1	1200						1	20A	SPARE	32								
R 33		WINDOW REC.	20A	1		500					1	20A	SPARE	34								
R 35		WINDOW REC.	20A	1		500					1	20A	SPARE	36								
L 37		WALK-IN COOLER LTG	20A	1	300			1104			1	20A	E5 REACH-IN SOLID SWING DOOR FREEZER	38	K							
39		SPACE											SPACE	40								
41		SPACE											SPACE	42								
					TOTAL LOAD DEMAND:			89% PERCENT BALANCE														
					7779			øA		øB			øC									
					85 A			7474		82 A			6890									
								57 A														
		LOAD CLASSIFICATION	CONNECTED LOAD	DEMAND FACTOR	ESTIMATED DEMAND		PANEL LOADS															
		CONTINUOUS LOAD = C	0	125%	0		TOTAL CONN. LOAD (VA):				27239											
		KITCHEN EQUIPMENT LOAD = K	16535	65%	10748		TOTAL EST. DEMAND (VA):				22144											
		LIGHTING LOAD = L	2492	125%	3115		TOTAL CONN. (AMPS):				76											
		MOTOR LOAD = M	276	100%	345		TOTAL EST. DEMAND (AMPS):				61											
		NON-CONTINUOUS LOAD = N	2996	100%	2996																	
		PANEL LOAD = P	0	100%	0																	
		RECEPTACLE LOAD = R	4940	100%	4940																	
		PANEL SCHEDULE NOTES:																				
		1) PROVIDE LOCK-ON DEVICE.				5) PROVIDE "HACR" TYPE CIRCUIT BREAKER FOR HVAC EQUIPMENT.																
		2) PROVIDE LOCK-OFF DEVICE.																				
		3) PROVIDE GFCI TYPE DEVICE.																				
		4) PROVIDE A NEW BREAKER AT SAME TYPE AND AIC RATING IN PANEL.																				

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COMcheck Software Version 4.1.5.1
Interior Lighting Compliance Certificate

Project Information
 Energy Code: 2015 IECC
 Project Title: Tekter
 Project Type: New Construction

Construction Site: 940 NW Pryor Road, Retail Space 5, Lees Summit, MO 64081
 Owner/Agent:
 Designer/Contractor: Kinetic Design, 1260 Corona Point Court, Corona, CA 92879, (951) 710-6334, info@kineticdesign.build

Unspecified

Allowed Interior Lighting Power

A Area Category	B Floor Area (ft ²)	C Allowed Watts / ft ²	D Allowed Watts (B X C)
1-Nekter (Common Space Types:Sales Area)	800	1.59	1272
Total Allowed Watts =			1272

Proposed Interior Lighting Power

A Fixture ID : Description / Lamp / Wattage Per Lamp / Ballast	B Lamps/ Fixture	C # of Fixtures	D Fixture Watt. (C X D)	E
1-Nekter (Common Space Types:Sales Area)				
LED 1: LTF-1: 2'X4' TROFFER: Other:	1	5	39	195
LED 2: LRC-1: DOWN LIGHT: Other:	1	10	25	250
LED 3: LEB-1: DOWNLIGHT ADJUSTABLE: Other:	1	6	14	84
LED 4: DLB-1: Pendant: Other:	1	6	12	72
LED 5: LTB-6: Monopoint: Other:	1	2	20	40
Total Proposed Watts =				641

Interior Lighting PASSES: Design 50% better than code

Interior Lighting Compliance Statement
 Compliance Statement: The proposed interior lighting design represented in this document is consistent with the building plans, specifications, and other calculations submitted with this permit application. The proposed interior lighting systems have been designed to meet the 2015 IECC requirements in COMcheck Version 4.1.5.1 and to comply with any applicable mandatory requirements listed in the Inspection Checklist.

Wenceslao Raymundo
 Name - Title
 Signature
 Date: 07-30-2021

Project Title: Tekter
 Data filename: \\10.6.0.15\KineticDesign\Nekter\Nekter Juice Bar - Lee's Summit, MO\02_Drawings\03_Electrical\Comcheck\Nekter.cck
 Report date: 07/30/21
 Page 1 of 5

Section # & Req.ID	Rough-In Electrical Inspection	Complies?	Comments/Assumptions
C405.2.1 [EL15] ¹	Lighting controls installed to uniformly reduce the lighting load by at least 50%.	<input type="checkbox"/> Complies <input type="checkbox"/> Does Not <input type="checkbox"/> Not Observable <input type="checkbox"/> Not Applicable	
C405.2.1 [EL18] ¹	Occupancy sensors installed in required spaces.	<input type="checkbox"/> Complies <input type="checkbox"/> Does Not <input type="checkbox"/> Not Observable <input type="checkbox"/> Not Applicable	
C405.2.1, C405.2.2, C405.2.2.3 [EL23] ¹	Independent lighting controls installed per approved lighting plans and all manual controls readily accessible and visible to occupants.	<input type="checkbox"/> Complies <input type="checkbox"/> Does Not <input type="checkbox"/> Not Observable <input type="checkbox"/> Not Applicable	
C405.2.2.1 [EL22] ¹	Automatic controls to shut off all building lighting installed in all buildings.	<input type="checkbox"/> Complies <input type="checkbox"/> Does Not <input type="checkbox"/> Not Observable <input type="checkbox"/> Not Applicable	
C405.2.3 [EL16] ¹	Daylight zones provided with individual controls that control the lights independent of general area lighting.	<input type="checkbox"/> Complies <input type="checkbox"/> Does Not <input type="checkbox"/> Not Observable <input type="checkbox"/> Not Applicable	
C405.2.3.1, C405.2.3.2 [EL20] ¹	Primary sidelighted areas are equipped with required lighting controls.	<input type="checkbox"/> Complies <input type="checkbox"/> Does Not <input type="checkbox"/> Not Observable <input type="checkbox"/> Not Applicable	
C405.2.3.1, C405.2.3.3 [EL21] ¹	Enclosed spaces with daylight area under skylights and rooftop monitors are equipped with required lighting controls.	<input type="checkbox"/> Complies <input type="checkbox"/> Does Not <input type="checkbox"/> Not Observable <input type="checkbox"/> Not Applicable	
C405.2.4 [EL4] ¹	Separate lighting control devices for specific uses installed per approved lighting plans.	<input type="checkbox"/> Complies <input type="checkbox"/> Does Not <input type="checkbox"/> Not Observable <input type="checkbox"/> Not Applicable	
C405.2.4 [EL8] ¹	Additional interior lighting power allowed for special functions per the approved lighting plans and is automatically controlled and separated from general lighting.	<input type="checkbox"/> Complies <input type="checkbox"/> Does Not <input type="checkbox"/> Not Observable <input type="checkbox"/> Not Applicable	
C405.3 [EL6] ¹	Exit signs do not exceed 5 watts per face.	<input type="checkbox"/> Complies <input type="checkbox"/> Does Not <input type="checkbox"/> Not Observable <input type="checkbox"/> Not Applicable	

Additional Comments/Assumptions:

1 High Impact (Tier 1) 2 Medium Impact (Tier 2) 3 Low Impact (Tier 3)

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 Report date: 07/30/21
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COMcheck Software Version 4.1.5.1
Inspection Checklist
 Energy Code: 2015 IECC

Requirements: 0.0% were addressed directly in the COMcheck software
 Text in the "Comments/Assumptions" column is provided by the user in the COMcheck Requirements screen. For each requirement, the user certifies that a code requirement will be met and how that is documented, or that an exception is being claimed. Where compliance is itemized in a separate table, a reference to that table is provided.

Section # & Req.ID	Plan Review	Complies?	Comments/Assumptions
C103.2 [PR4] ¹	Plans, specifications, and/or calculations provide all information with which compliance can be determined for the interior lighting and electrical systems and equipment and document where exceptions to the standard are claimed. Information provided should include interior lighting power calculations, wattage of bulbs and ballasts, transformers and control devices.	<input type="checkbox"/> Complies <input type="checkbox"/> Does Not <input type="checkbox"/> Not Observable <input type="checkbox"/> Not Applicable	

Additional Comments/Assumptions:

1 High Impact (Tier 1) 2 Medium Impact (Tier 2) 3 Low Impact (Tier 3)


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 Report date: 07/30/21
 Page 2 of 5

Section # & Req.ID	Final Inspection	Complies?	Comments/Assumptions
C303.3, C408.2.5.2 [F17] ³	Furnished O&M instructions for systems and equipment to the building owner or designated representative.	<input type="checkbox"/> Complies <input type="checkbox"/> Does Not <input type="checkbox"/> Not Observable <input type="checkbox"/> Not Applicable	
C405.4.1 [F18] ¹	Interior installed lamp and fixture lighting power is consistent with what is shown on the approved lighting plans, demonstrating proposed watts are less than or equal to allowed watts.	<input type="checkbox"/> Complies <input type="checkbox"/> Does Not <input type="checkbox"/> Not Observable <input type="checkbox"/> Not Applicable	See the Interior Lighting fixture schedule for values.
C408.2.5.1 [F16] ¹	Furnished as-built drawings for electric power systems within 90 days of system acceptance.	<input type="checkbox"/> Complies <input type="checkbox"/> Does Not <input type="checkbox"/> Not Observable <input type="checkbox"/> Not Applicable	
C408.3 [F13] ¹	Lighting systems have been tested to ensure proper calibration, adjustment, programming, and operation.	<input type="checkbox"/> Complies <input type="checkbox"/> Does Not <input type="checkbox"/> Not Observable <input type="checkbox"/> Not Applicable	

Additional Comments/Assumptions:

1 High Impact (Tier 1) 2 Medium Impact (Tier 2) 3 Low Impact (Tier 3)

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REVISIONS

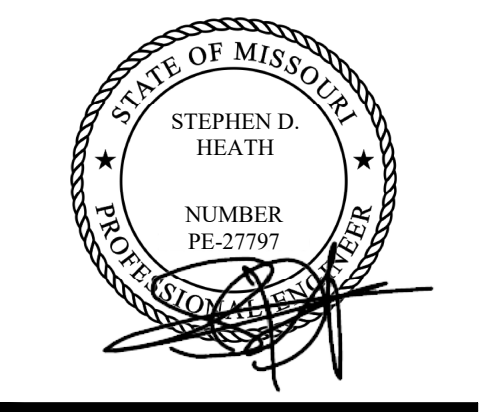No.	DATE	DESCRIPTION

CLIENT INFORMATION



PROJECT NAME
NEKTER - LEE'S SUMMIT, MO
 940 NW PRYOR ROAD, RETAIL SPACE 5,
 LEE'S SUMMIT, MISSOURI 64081

SHEET NAME
INTERIOR LIGHTING COMPLIANCE CERTIFICATE

DRAWN	CHECKED
JB	WR
DATE	07/30/21
SCALE	AS NOTED
PROJECT NUMBER	
SHEET	

E501

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