

C:\Users\JReed-Shultz\Documents\Paragon Star HUB [2]. Central\_inreedshultz@finklewilliams.com.vrt  
RENDERING FOR CONCEPTUAL REFERENCE ONLY; IMAGE MAY NOT REFLECT LATEST DESIGN. REFERENCE ELEVATIONS AND SCHEDULES FOR FINISHES.



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PROJECT TEAM

ARCHITECT

FINKLE + WILLIAMS ARCHITECTURE  
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MECHANICAL

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PLUMBING

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FINKLE + WILLIAMS  
ARCHITECTURE

PROJECT ADDRESS  
2151 NW PARAGON  
PKWY  
LEES SUMMIT, MO 64081

PROJECT NUMBER  
19050.02

RELEASE DATE  
08/06/2021

ISSUED FOR  
PERMIT SET

LOT 20 - HUB BUILDING







[illegible]

## REGISTRAR



## PROJECT TE.

ARCHITECT	FINKLE+WILLIAMS ARCHITECTURE
CIVIL	GBA
LANDSCAPE	HOERR SCHAUDT / LAND3
FOUNDATIONS	BSE STRUCTURAL ENGINEERS
STRUCTURAL	BSE STRUCTURAL ENGINEERS
PLUMBING	HENDERSON ENGINEERS
MECHANICAL	HENDERSON ENGINEERS
ELECTRICAL	HENDERSON ENGINEERS
FIRE PROTECTION	HENDERSON ENGINEERS
CONTRACTOR	FOGEL ANDERSON

FINKLE + WILLIAMS  
ARCHITECTURE


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## SHEET TITL

## WALL TYPES


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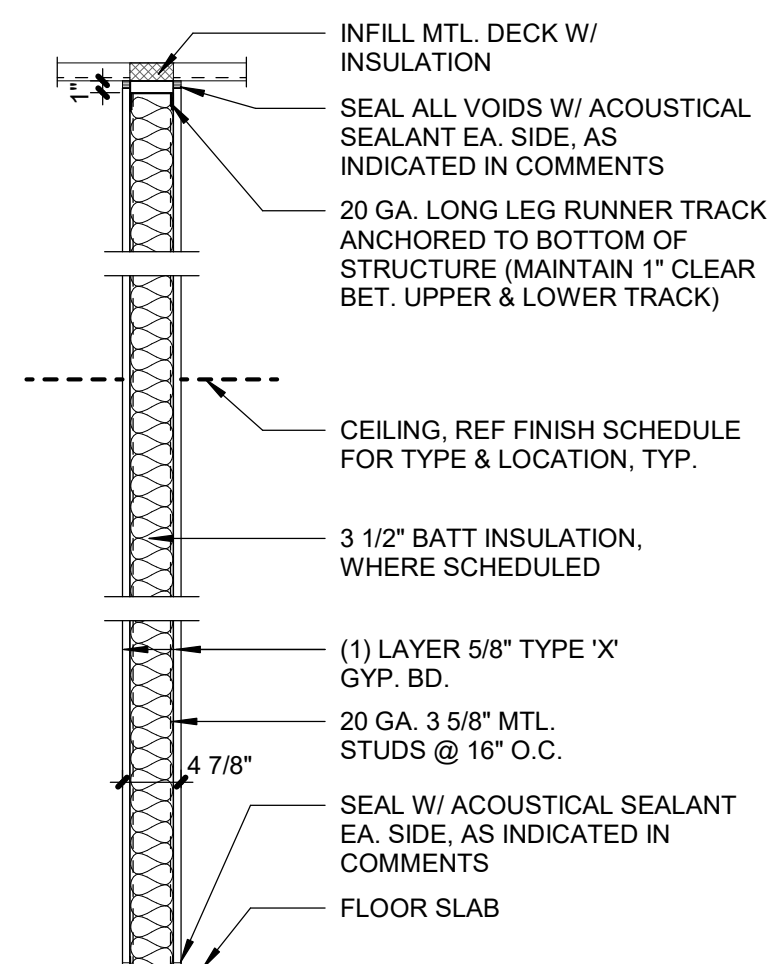
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Type	Batt Insulation	Mold & Water Resist GWB	Fire Rating	Comments
11c	Yes	Yes		Seal w/ acoustical sealant, top and bottom



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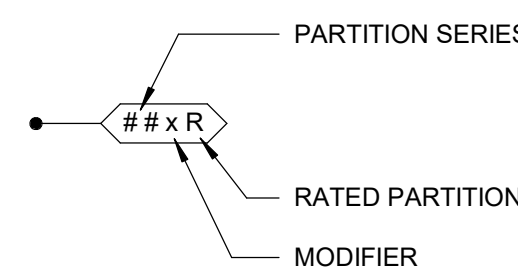
Type	Batt Insulation	Mold & Water Resist GWB	Fire Rating	Comments
04	No	No		
04b	No	Yes		

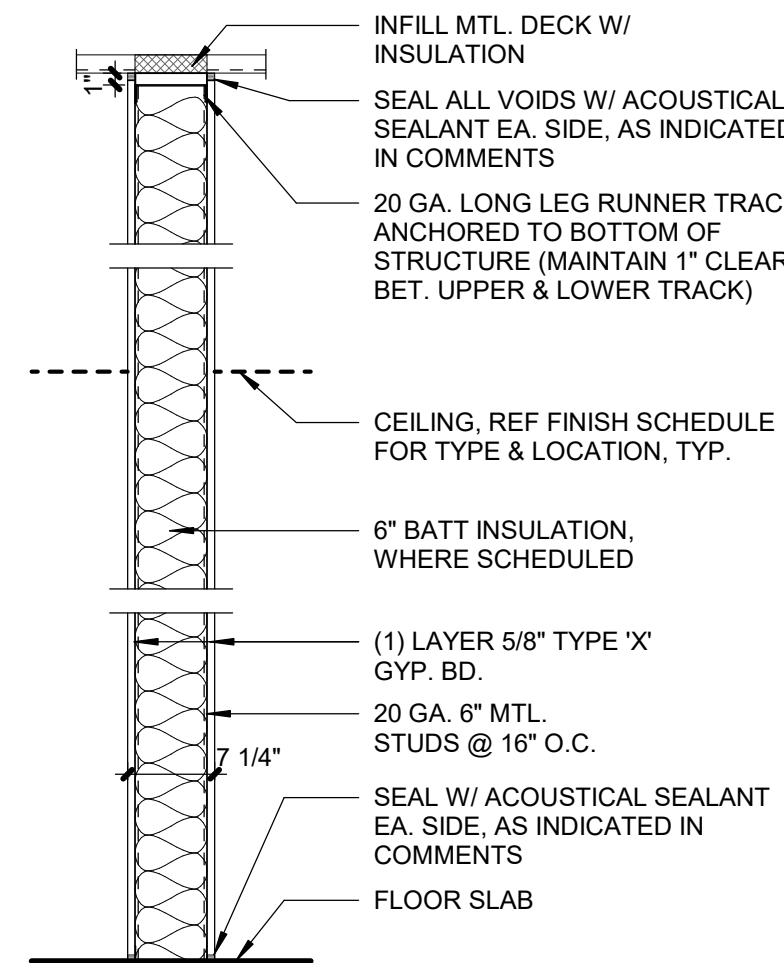

0

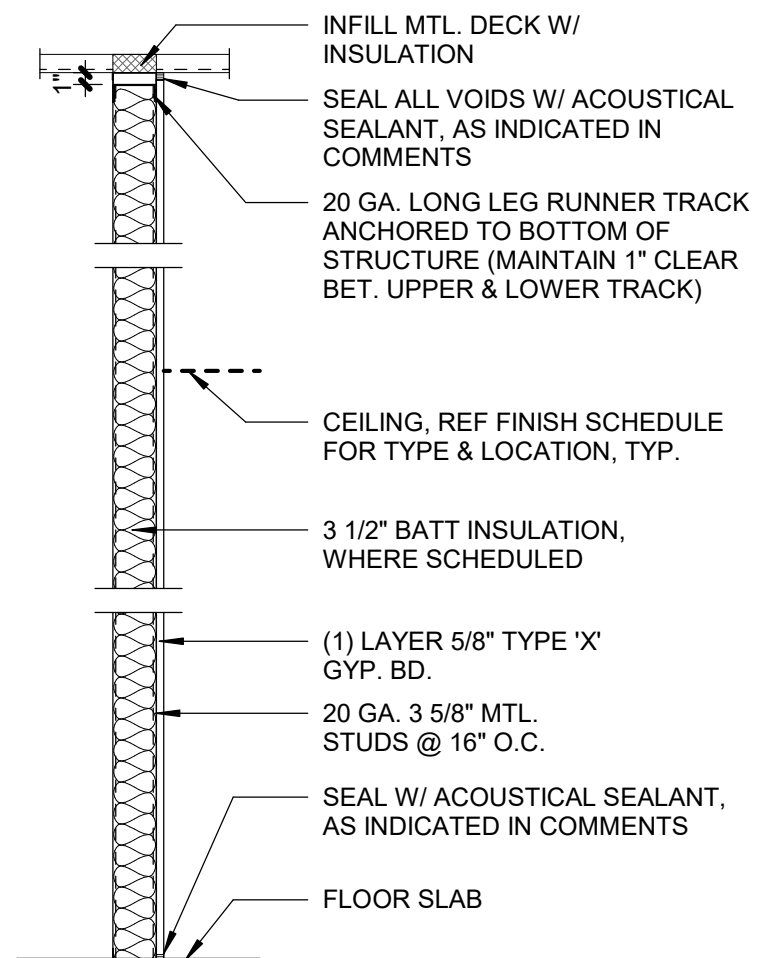Type	Batt Insulation	Mold & Water Resist GWB	Fire Rating	Comments
01	No	No		
01b	No	Yes		
01c	Yes	Yes		Seal w/ acoustical sealant, top and bottom

### PARTITION LEGEND



PARTITION SERIES	
01 - 39	METAL STUD WALLS
40 - 79	MASONRY WALLS
80 - 99	WOOD STUD WALLS

MODIFIER	
a	SOUND BATT INSULATION FULL DEPTH OF STUD
b	MOLD & WATER RESISTANT GYP. BD.
c	INSULATION AND MOLD & WATER RESISTANT GYP. BD.
d-z	VARIES. SEE PARTITION SCHEDULE COMMENTS

<b>RATING</b>	
R	FIRE RATED, SEE SCHEDULE FOR ADDITIONAL INFO.





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LEE'S SUMMIT, MO 64081

Project No.: 19050.02

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REGISTRATION



## PROJECT TEAM

ARCHITECT FINKLE+WILLIAMS  
ARCHITECTURE

CIVIL	GBA
-------	-----

LANDSCAPE HOERR SCHAUDT  
LAMES

FOUNDATIONS      BSE STRUCTURAL

STRUCTURAL BSE STRUCTURAL  
ENGINEERS ENGINEERS

PLUMBING                      HENDERSON  
ENGINEERS

MECHANICAL HENDERSON  
ENGINEERSELECTRICAL HENDERSON  
ENGINEERS

FIRE PROTECTION HENDERSON  
ENGINEERS

CONTRACTOR      FOGEL ANDERSON

---

FINKLE + WILLIAM  
ARCHITECTS


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SHEET TITLE

# ARCHITECTURAL SITE PLAN & DETAILS

SHEET NUMBER

# A0.10



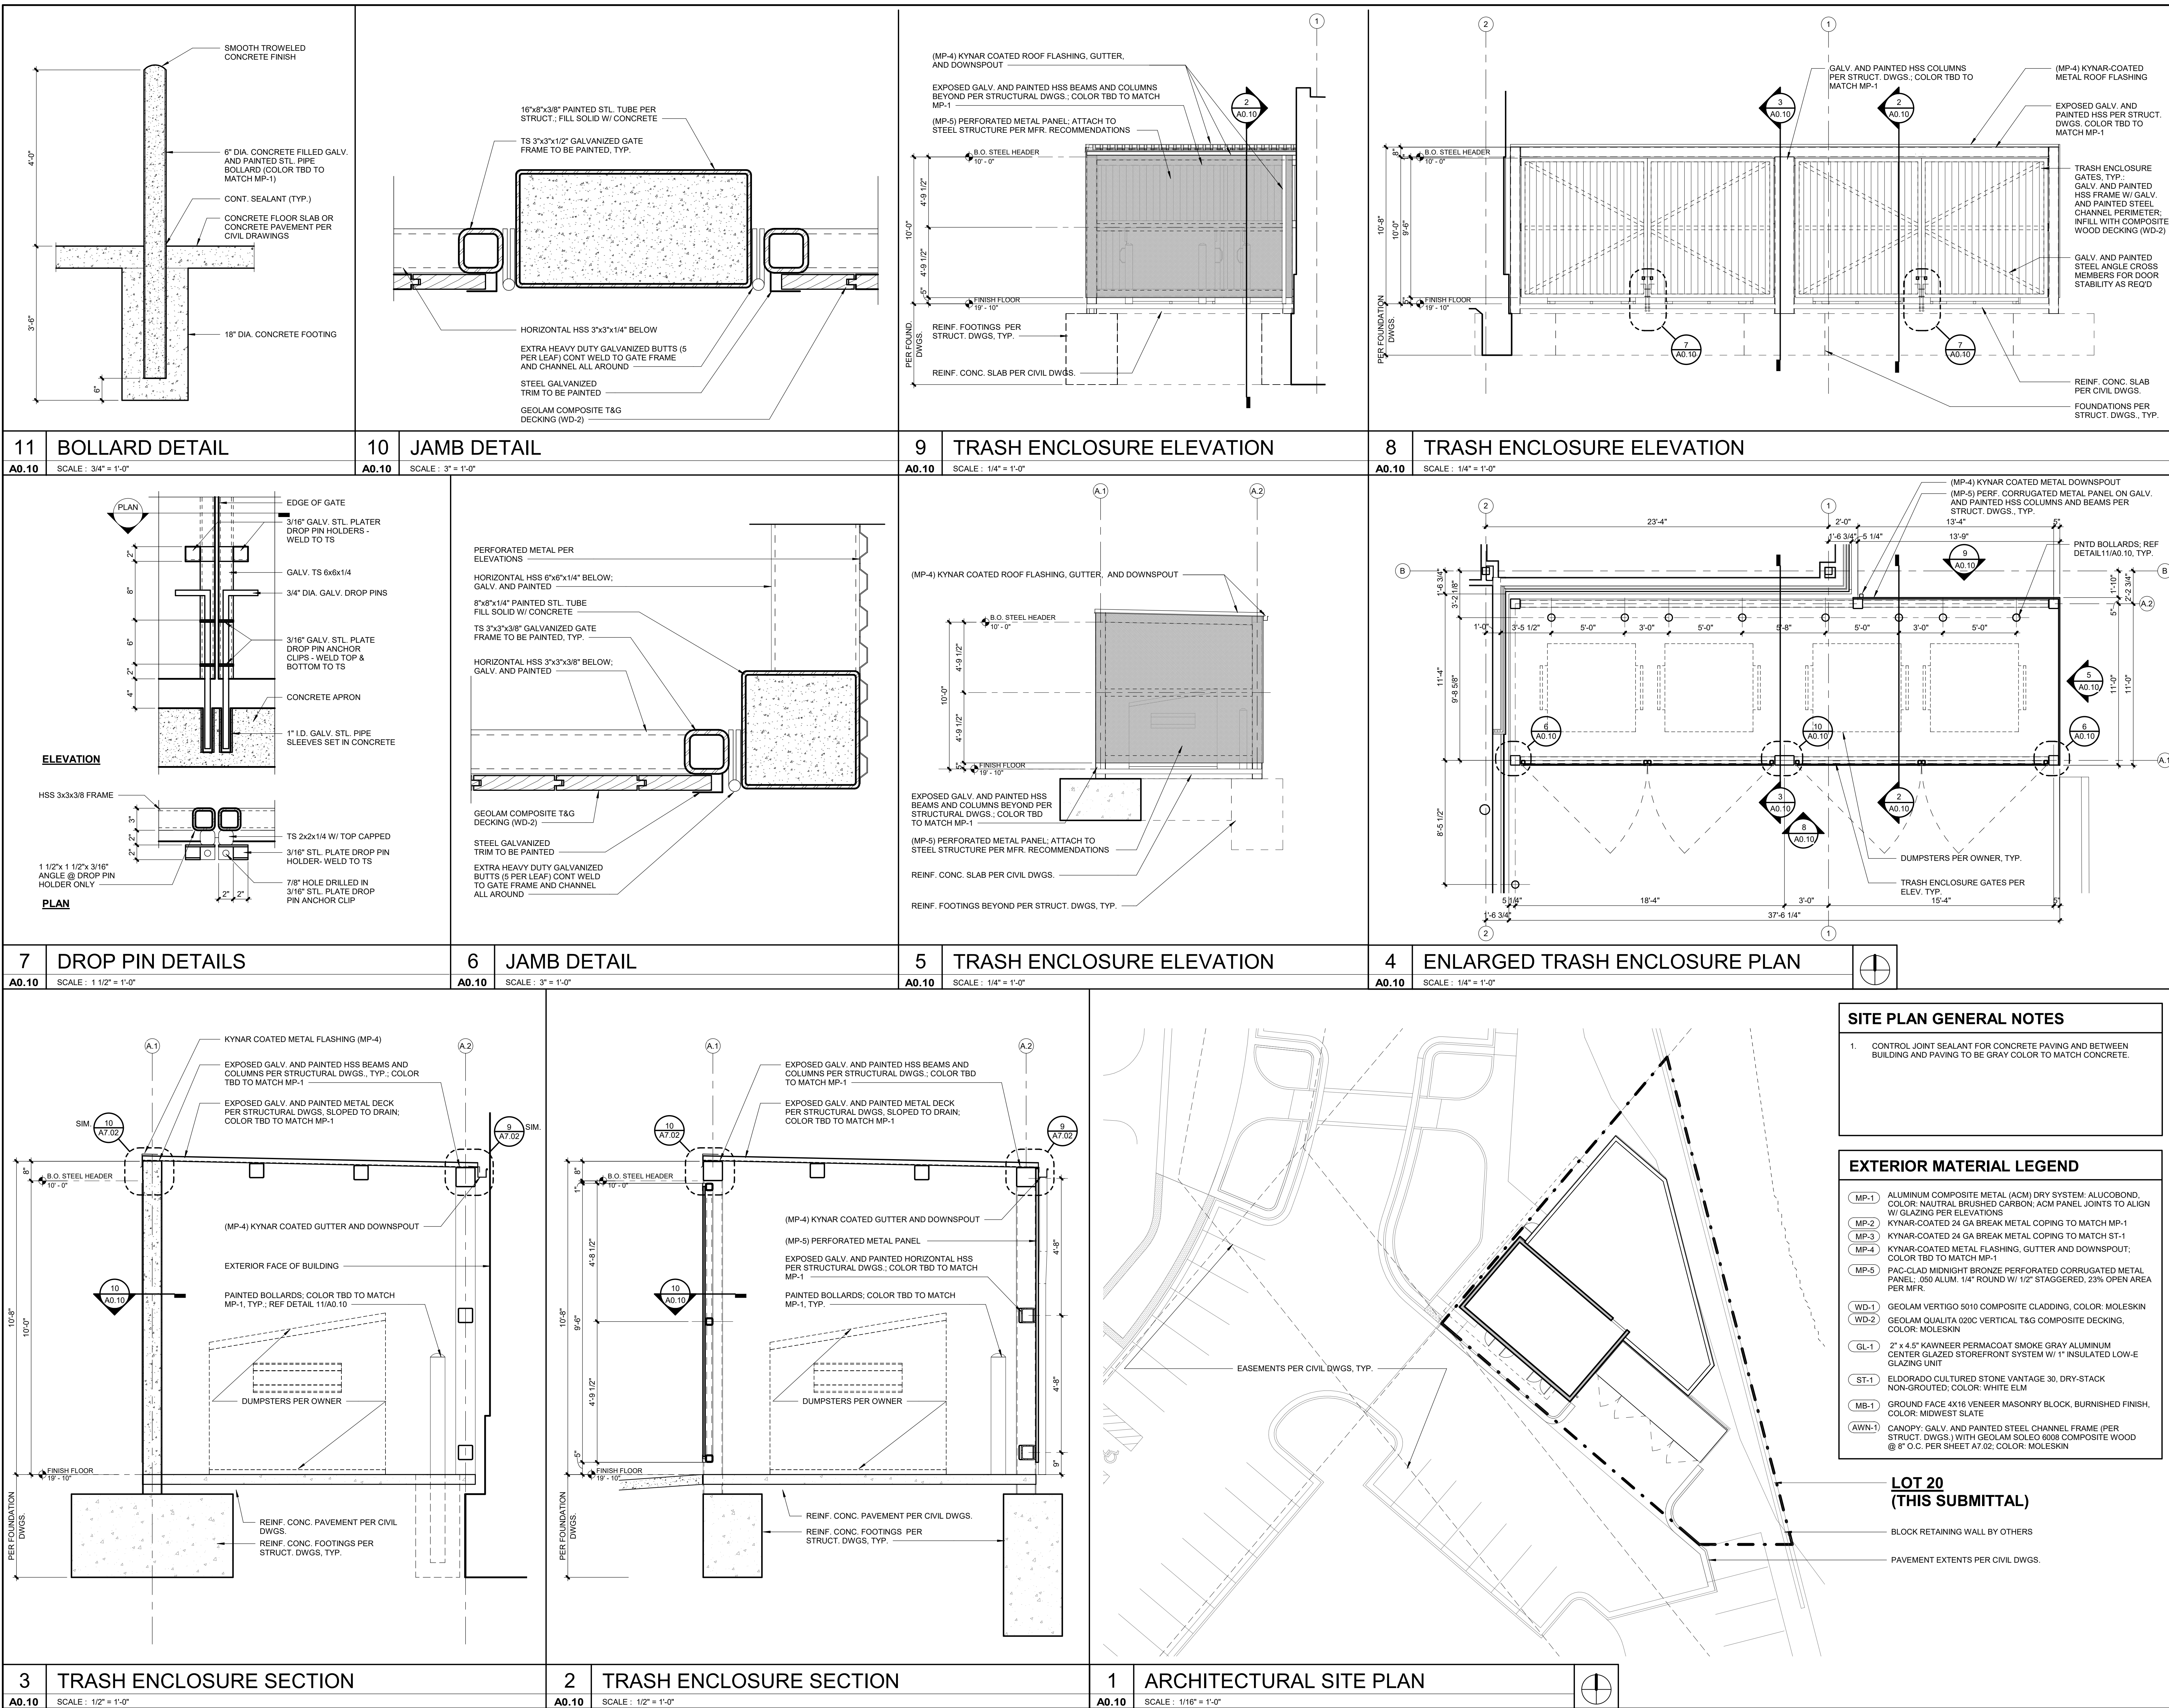

1. PROVIDE TERMITE CONTROL UNDER NEW FLOOR SLABS.
2. ALL STRUCTURAL STEEL TO BE FACTORY PRIMED GRAY.
3. ALL CMU CORNERS ARE TO BE CONSTRUCTED OF BULLNOSE BLOCK.
4. ALL SWITCHES, RECEPTACLES, PHONE/DATA, AND CONTROLS ARE TO BE GRAY COLOR WITH STAINLESS STEEL COVER PLATES.



51 NW PARAGON PKWY  
EE'S SUMMIT, MO 64081

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## REGISTRATION



## PROJECT TEAM

ARCHITECT FINKLE+WILLIAMS  
ARCHITECTURE

CIVIL GBA

LANDSCAPE HOERR SCHAUDT /  
LAND3FOUNDATIONS BSE STRUCTURAL  
ENGINEERS

STRUCTURAL BSE STRUCTURAL  
ENGINEERS

LUMBING                      HENDERSON  
ENGINEERS

MECHANICAL HENDERSON  
ENGINEERS

ELECTRICAL HENDERSON  
ENGINEERS

FIRE PROTECTION HENDERSON  
ENGINEERS

CONTRIBUTOR: P. J. J. VAN DIJK

FINKLE + WILLIAMS  
ARCHITECTURE


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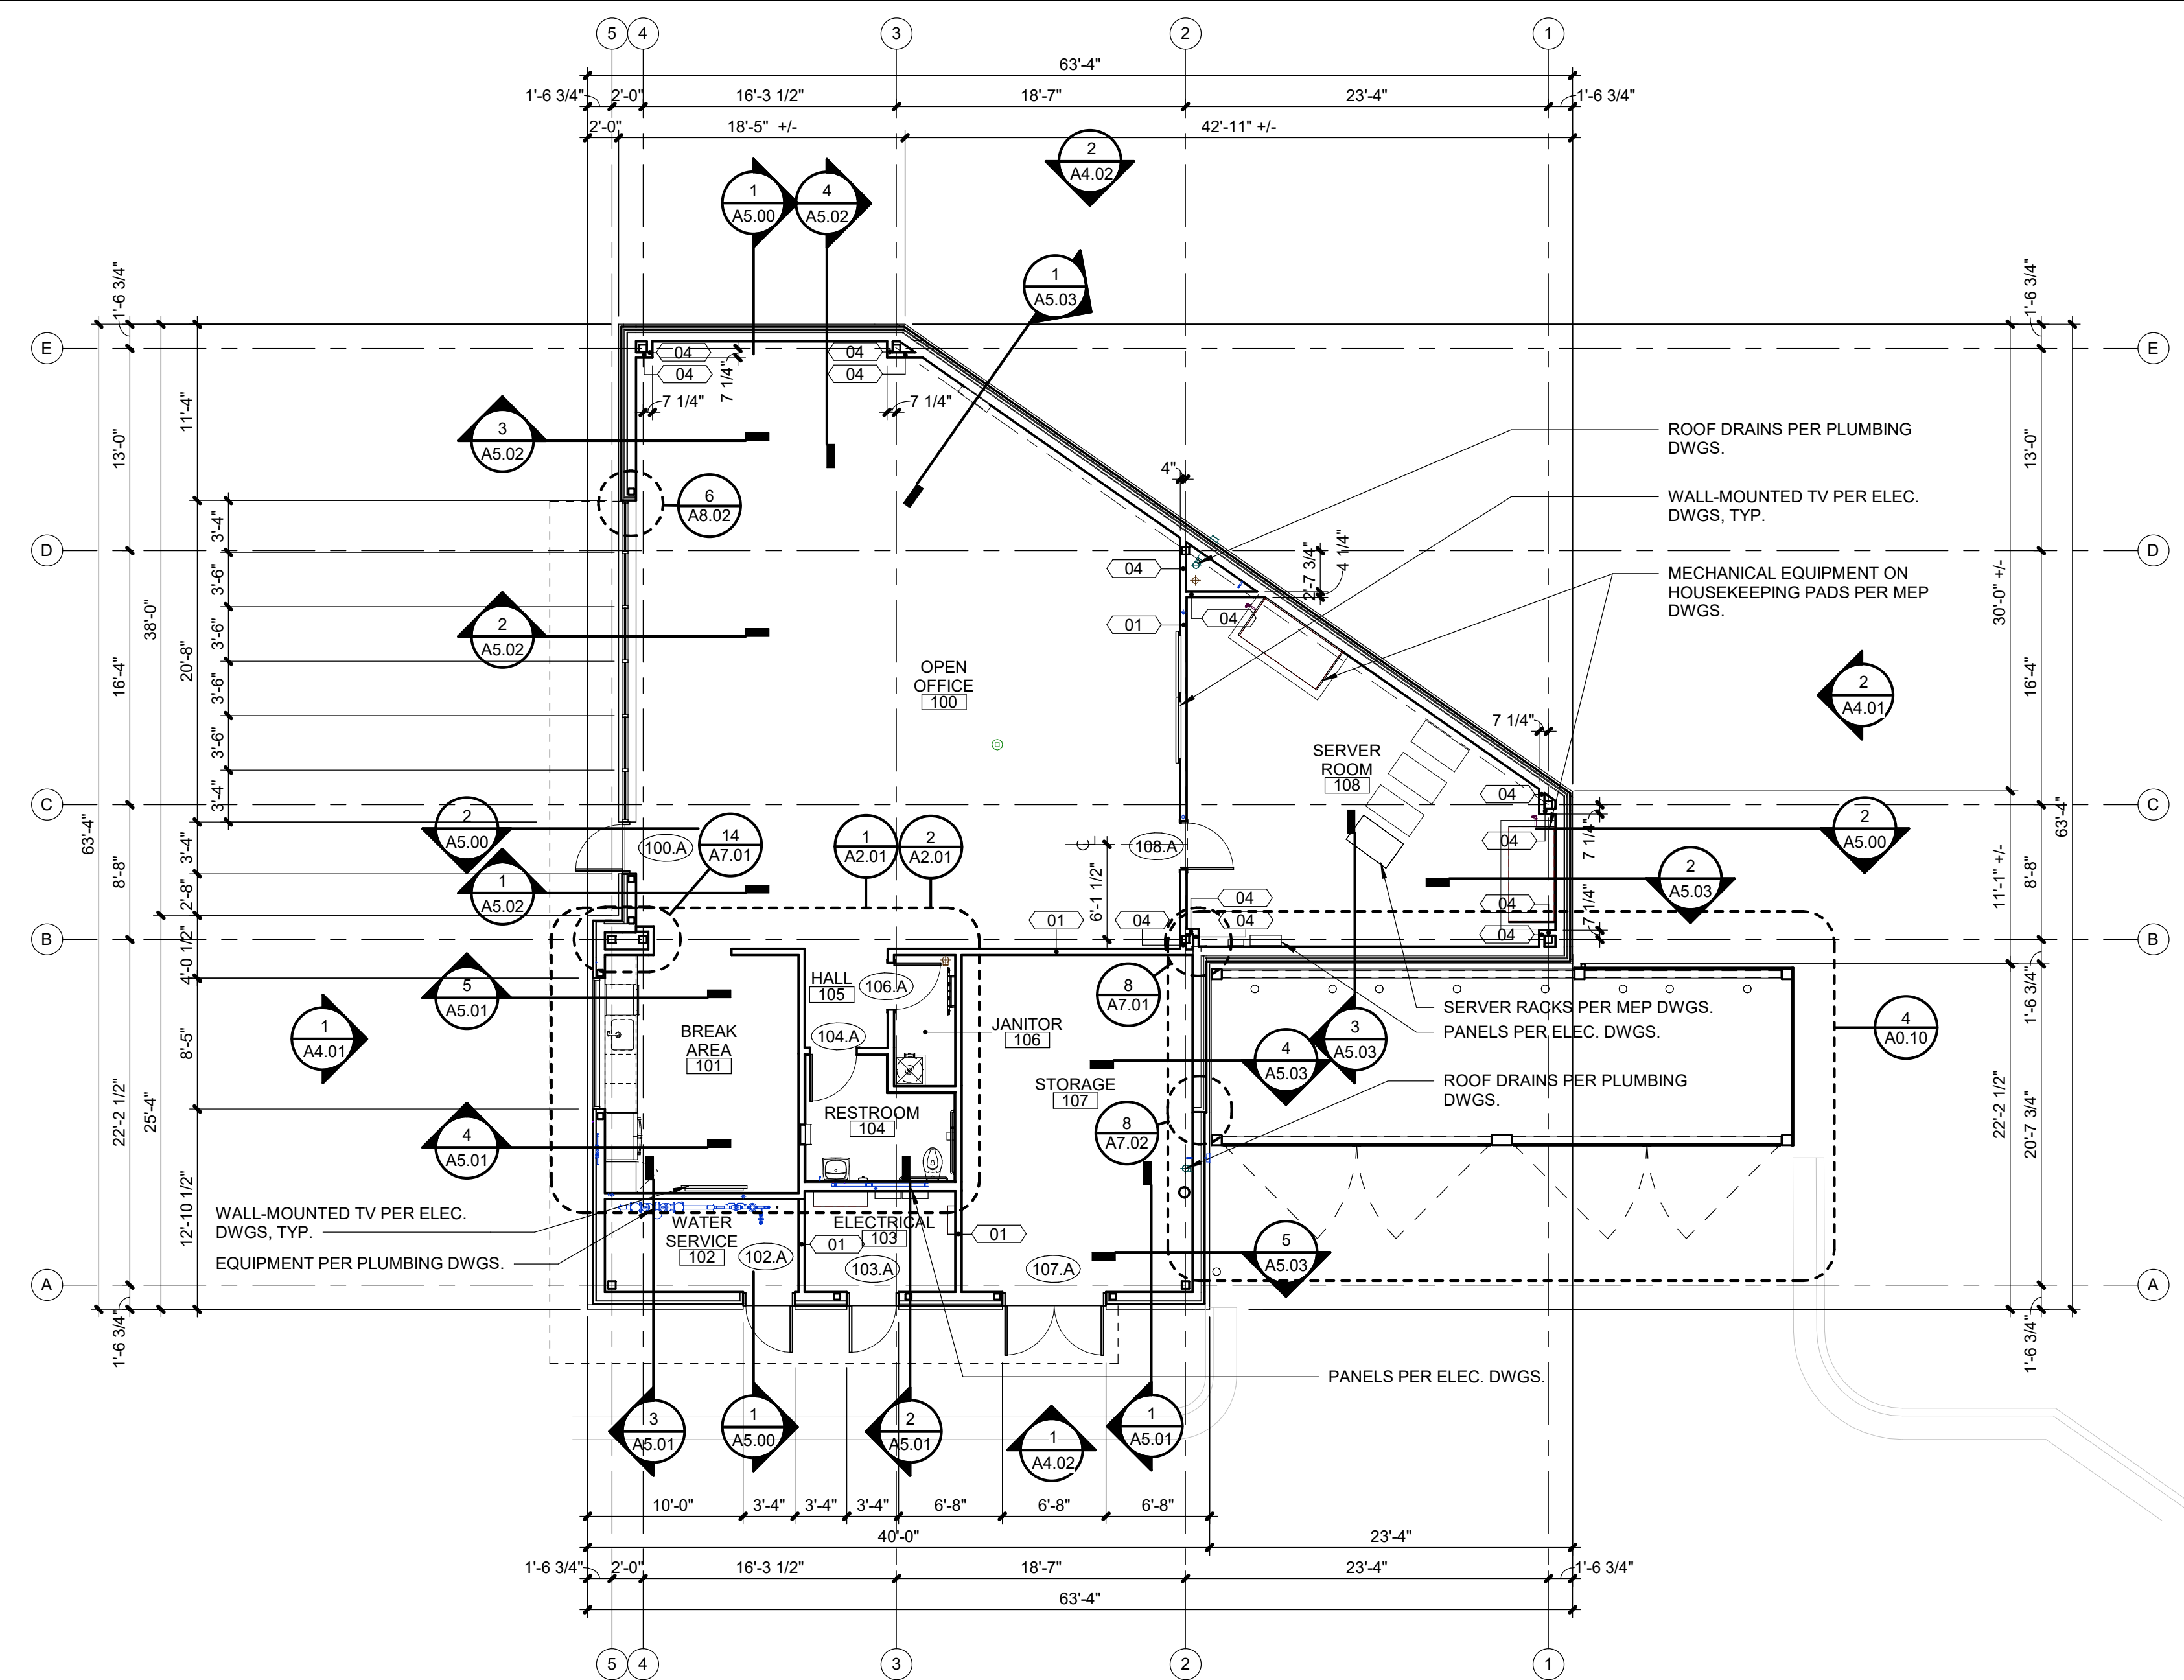
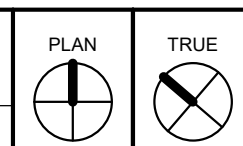
FIRST FLOOR  
PLAN

## SHEET NUMBER


## A1.01



2	EDGE OF SLAB PLAN - 1ST FLOOR
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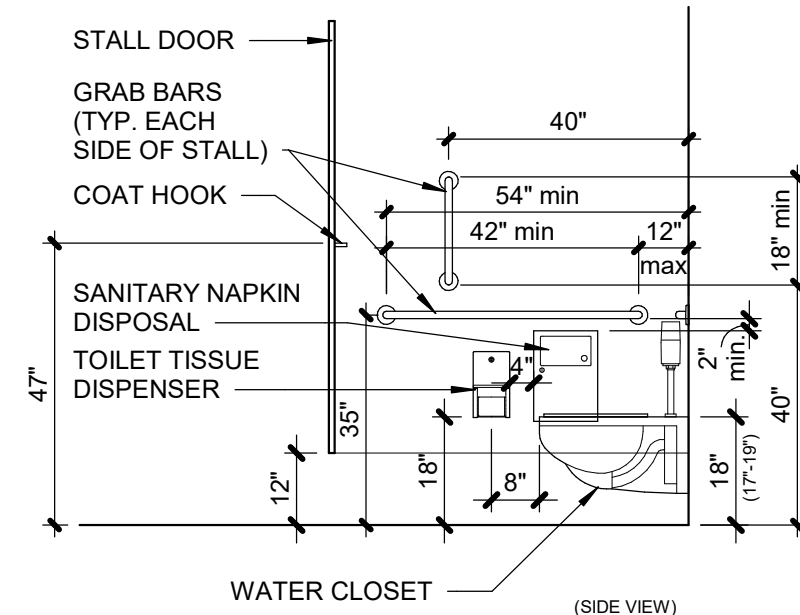
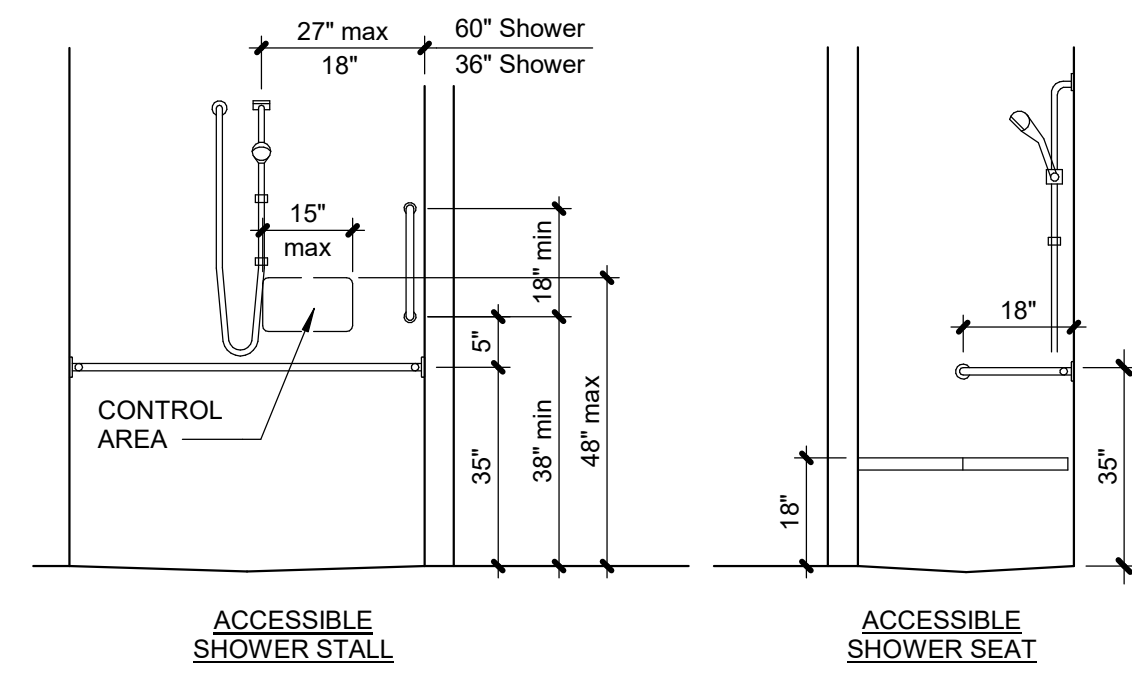
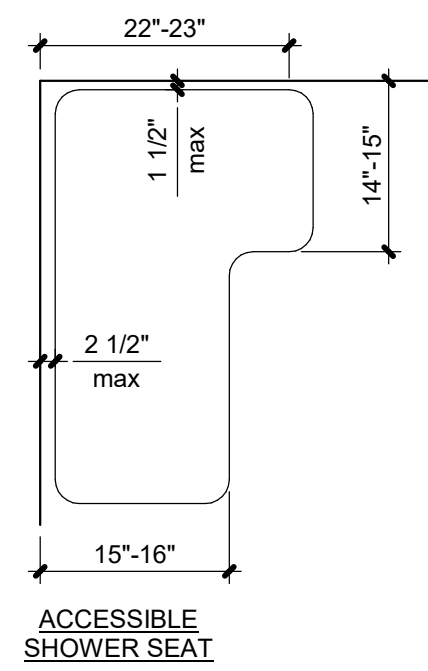
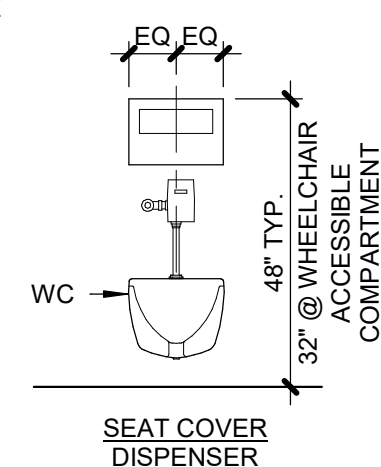
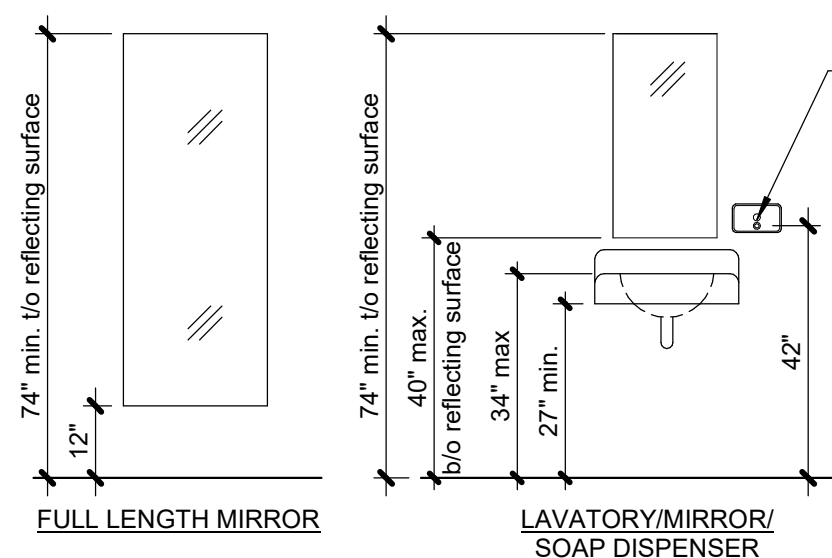
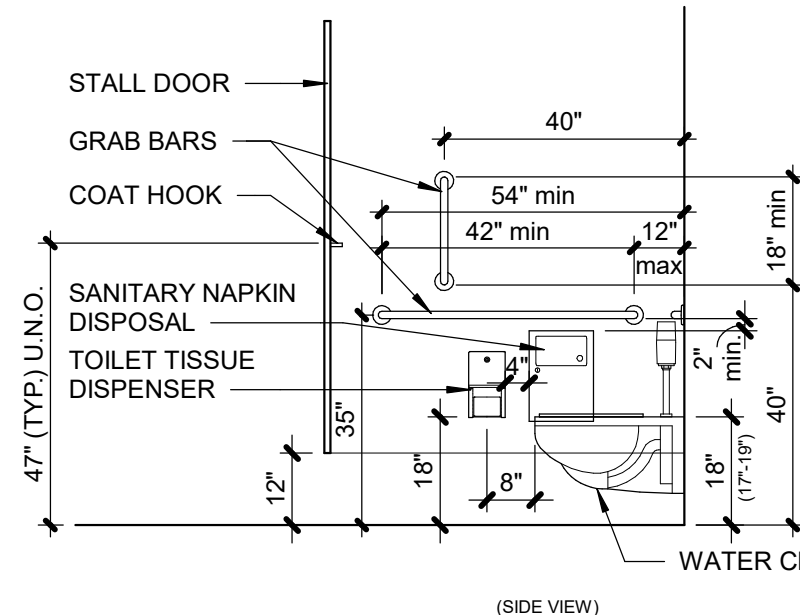


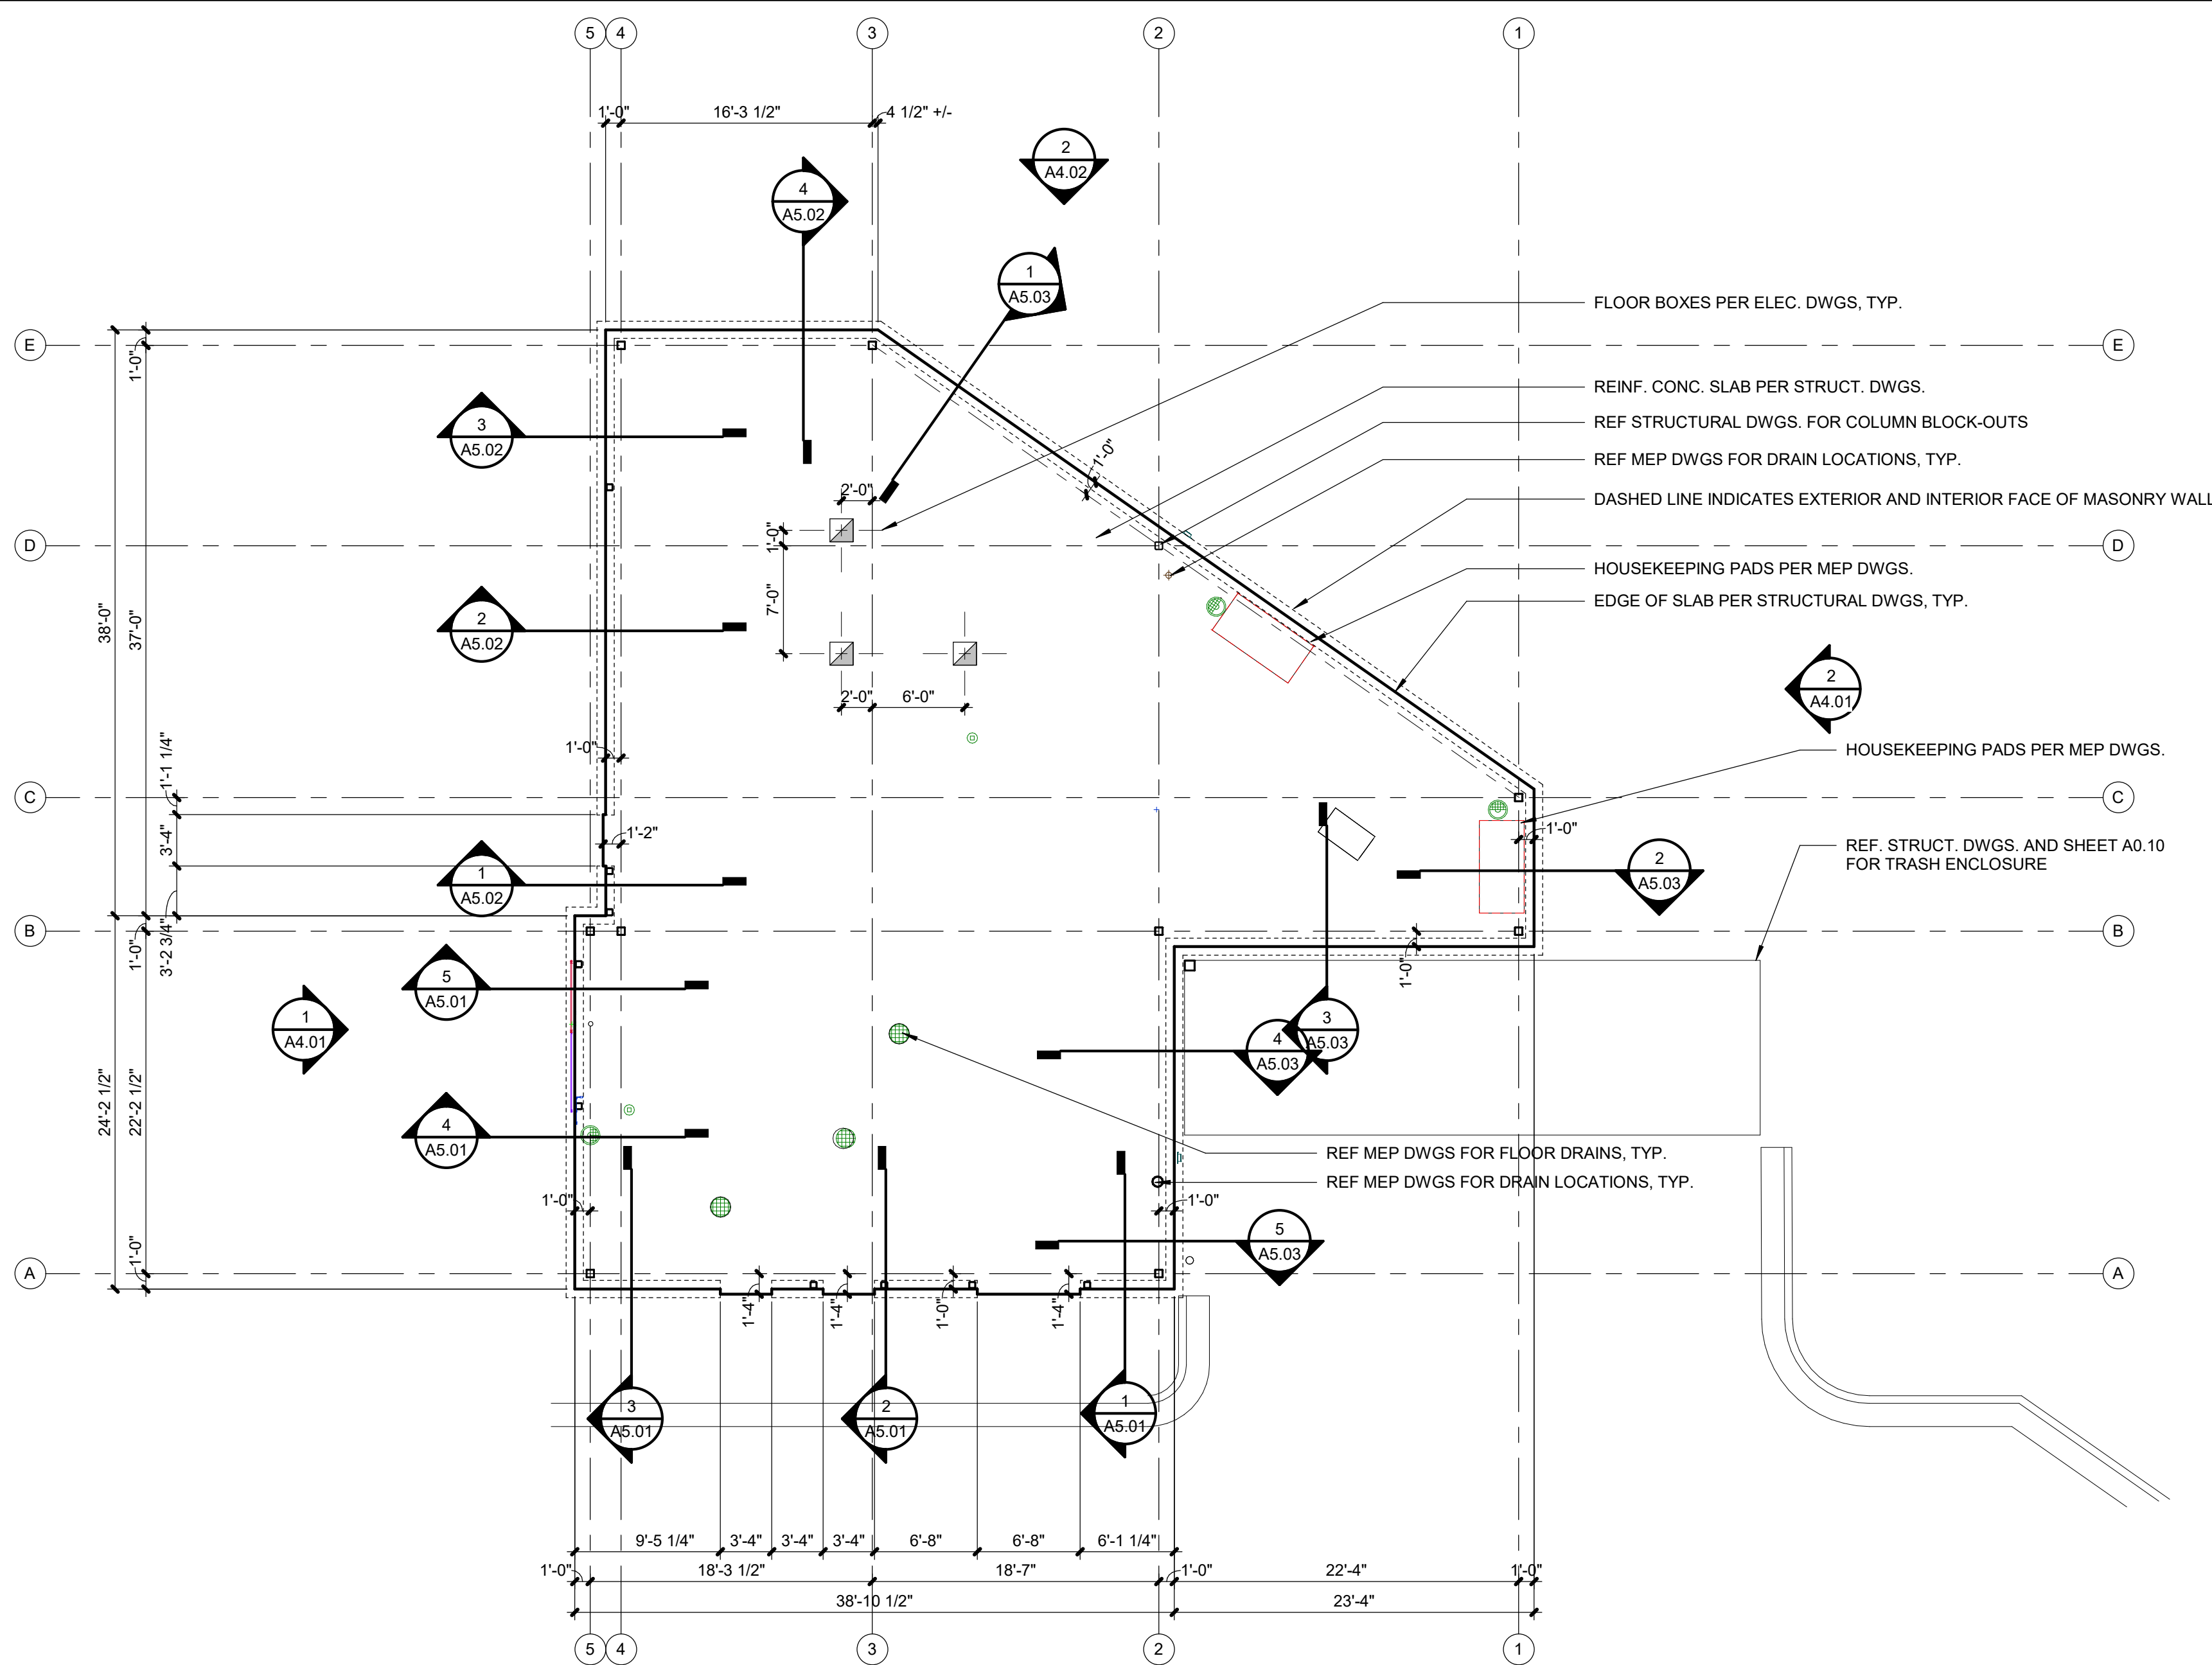1	1ST FLOOR PLAN
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## APPLIANCE LEGEND

OWNER PROVIDED, CONTRACTOR-INSTALLED APPLIANCES AS NOTED BELOW.

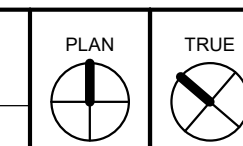- (A) REFRIGERATOR - PER OWNER
- (B) ADA DISHWASHER - PER OWNER

- ALL ACCESSORIES SHALL BE STAINLESS STEEL UNLESS NOTED OTHERWISE.  
ALL ACCESSORIES SHALL BE DESIGNED TO MEET ADA STANDARDS.
- (1) COMBINATION PAPER TOWEL DISPENSER/WASTE RECEPTACLE, RECESSED (BOBRICK B-3944)
- (2) AUTOMATIC WALL MOUNTED SOAP DISPENSER (BOBRICK B-2012)
- (3) FRAMED MIRROR (BOBRICK B-165) 30" W X 48" H
- (4) MULTI-ROLL TOILET TISSUE DISPENSER W/NO KEYED LOCK (BOBRICK B-2888)
- (5) GRAB BARS AS SHOWN ON PLANS AND ELEVATIONS (BOBRICK B-6806 SERIES)
- (6A) GRAB BAR (BOBRICK B6806 X 42)  
LOCATE AS SHOWN IN ACCESSORY MOUNTING HEIGHTS
- (6B) GRAB BAR (BOBRICK B6806 X 36)  
LOCATE AS SHOWN IN ACCESSORY MOUNTING HEIGHTS
- (6C) GRAB BAR (BOBRICK B6806 X 18)  
LOCATE AS SHOWN IN ACCESSORY MOUNTING HEIGHTS
- (6) SANITARY NAPKIN DISPOSAL, RECESSED WALL MOUNT (BOBRICK B-353)
- (7) U-LINE WALL-MOUNT UTILITY HOOKS
- (11) COAT AND HAT HOOK (BOBRICK B-6827)
- (12) A.D.A. RESTROOM SIGNAGE, SEE SHEET A0.01



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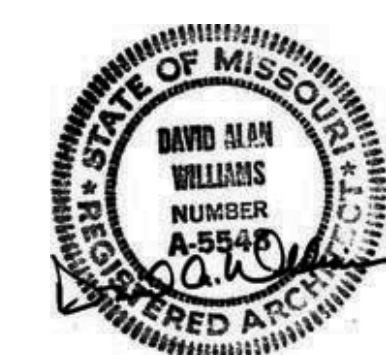
Project No.: 19050.02

Date: 08/06/2021

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## REGISTRATION



## PROJECT TEAM

ARCHITECT FINKLE+WILLIAMS  
ARCHITECTURE

CIVIL	GBA
-------	-----

LANDSCAPE HOERR SCHAUDT  
LANDSCAPE

FOUNDATIONS      BSE STRUCTURAL  
ENGINEERS

STRUCTURAL BSE STRUCTURAL  
ENGINEERS

PLUMBING      HENDERSON  
ENGINEERS

MECHANICAL HENDERSON  
ENGINEERSELECTRICAL HENDERSON  
ENGINEERS

FIRE PROTECTION HENDERSON  
ENGINEERS

CONTRACTOR      FOGEL ANDERSON

FINKLE + WILLIAMS  
ARCHITECTURE



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

## ENLARGED TOILET PLANS AND DETAILS

## SHEET NUMBER



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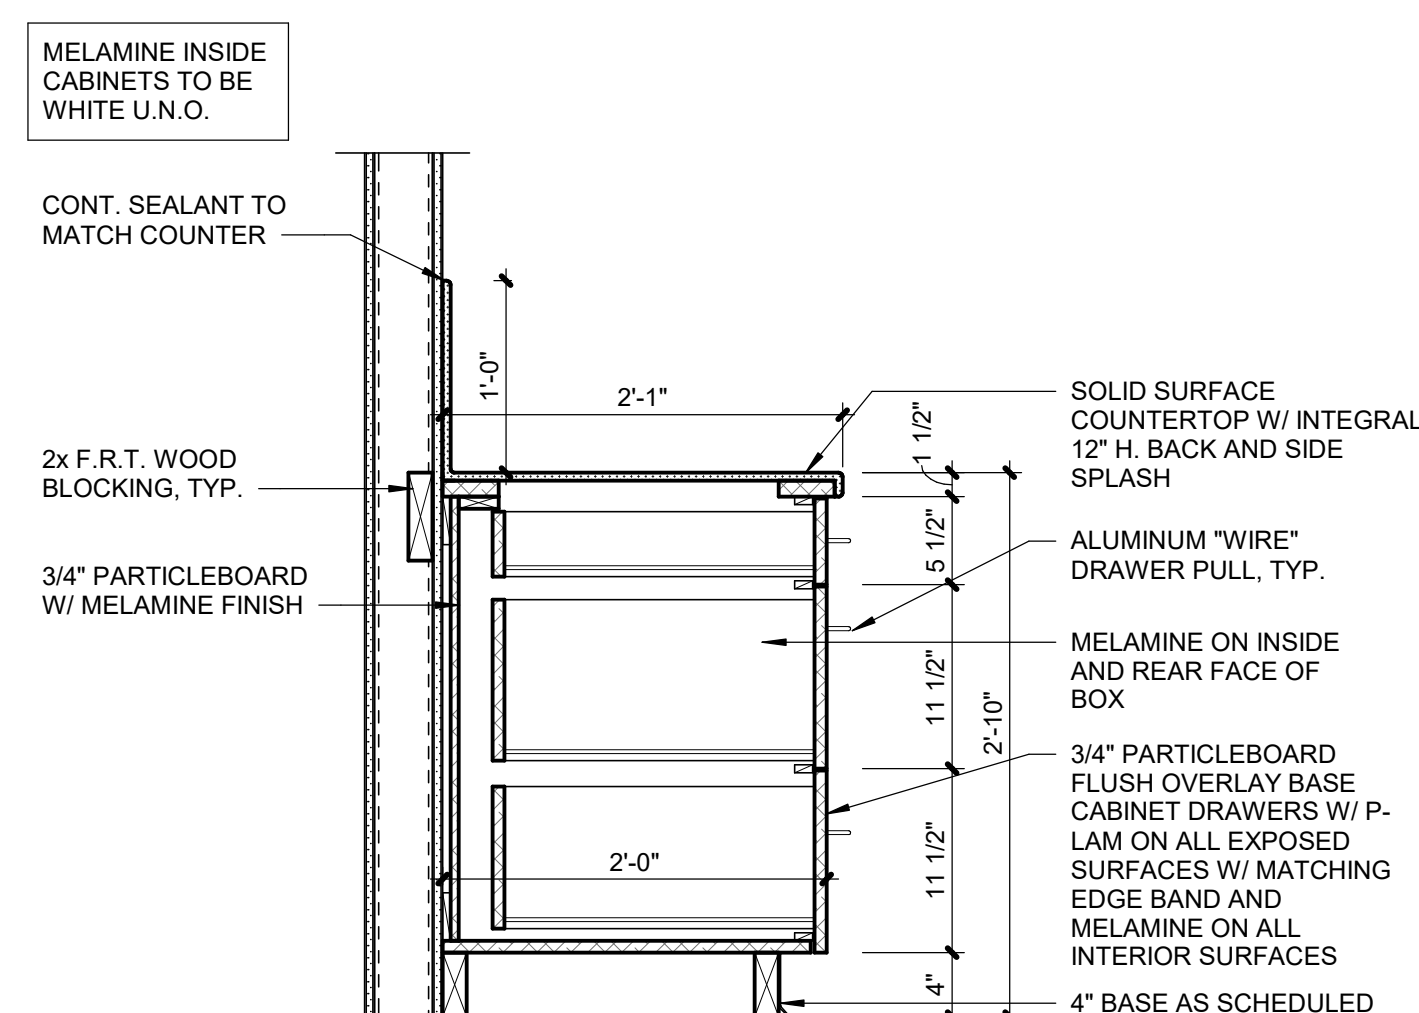
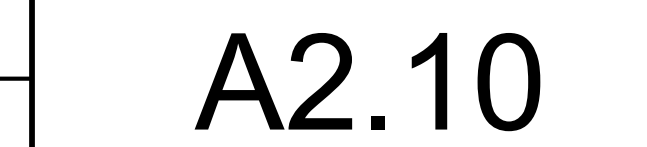
## 2 ENLARGED PLAN - ACCESSORIES

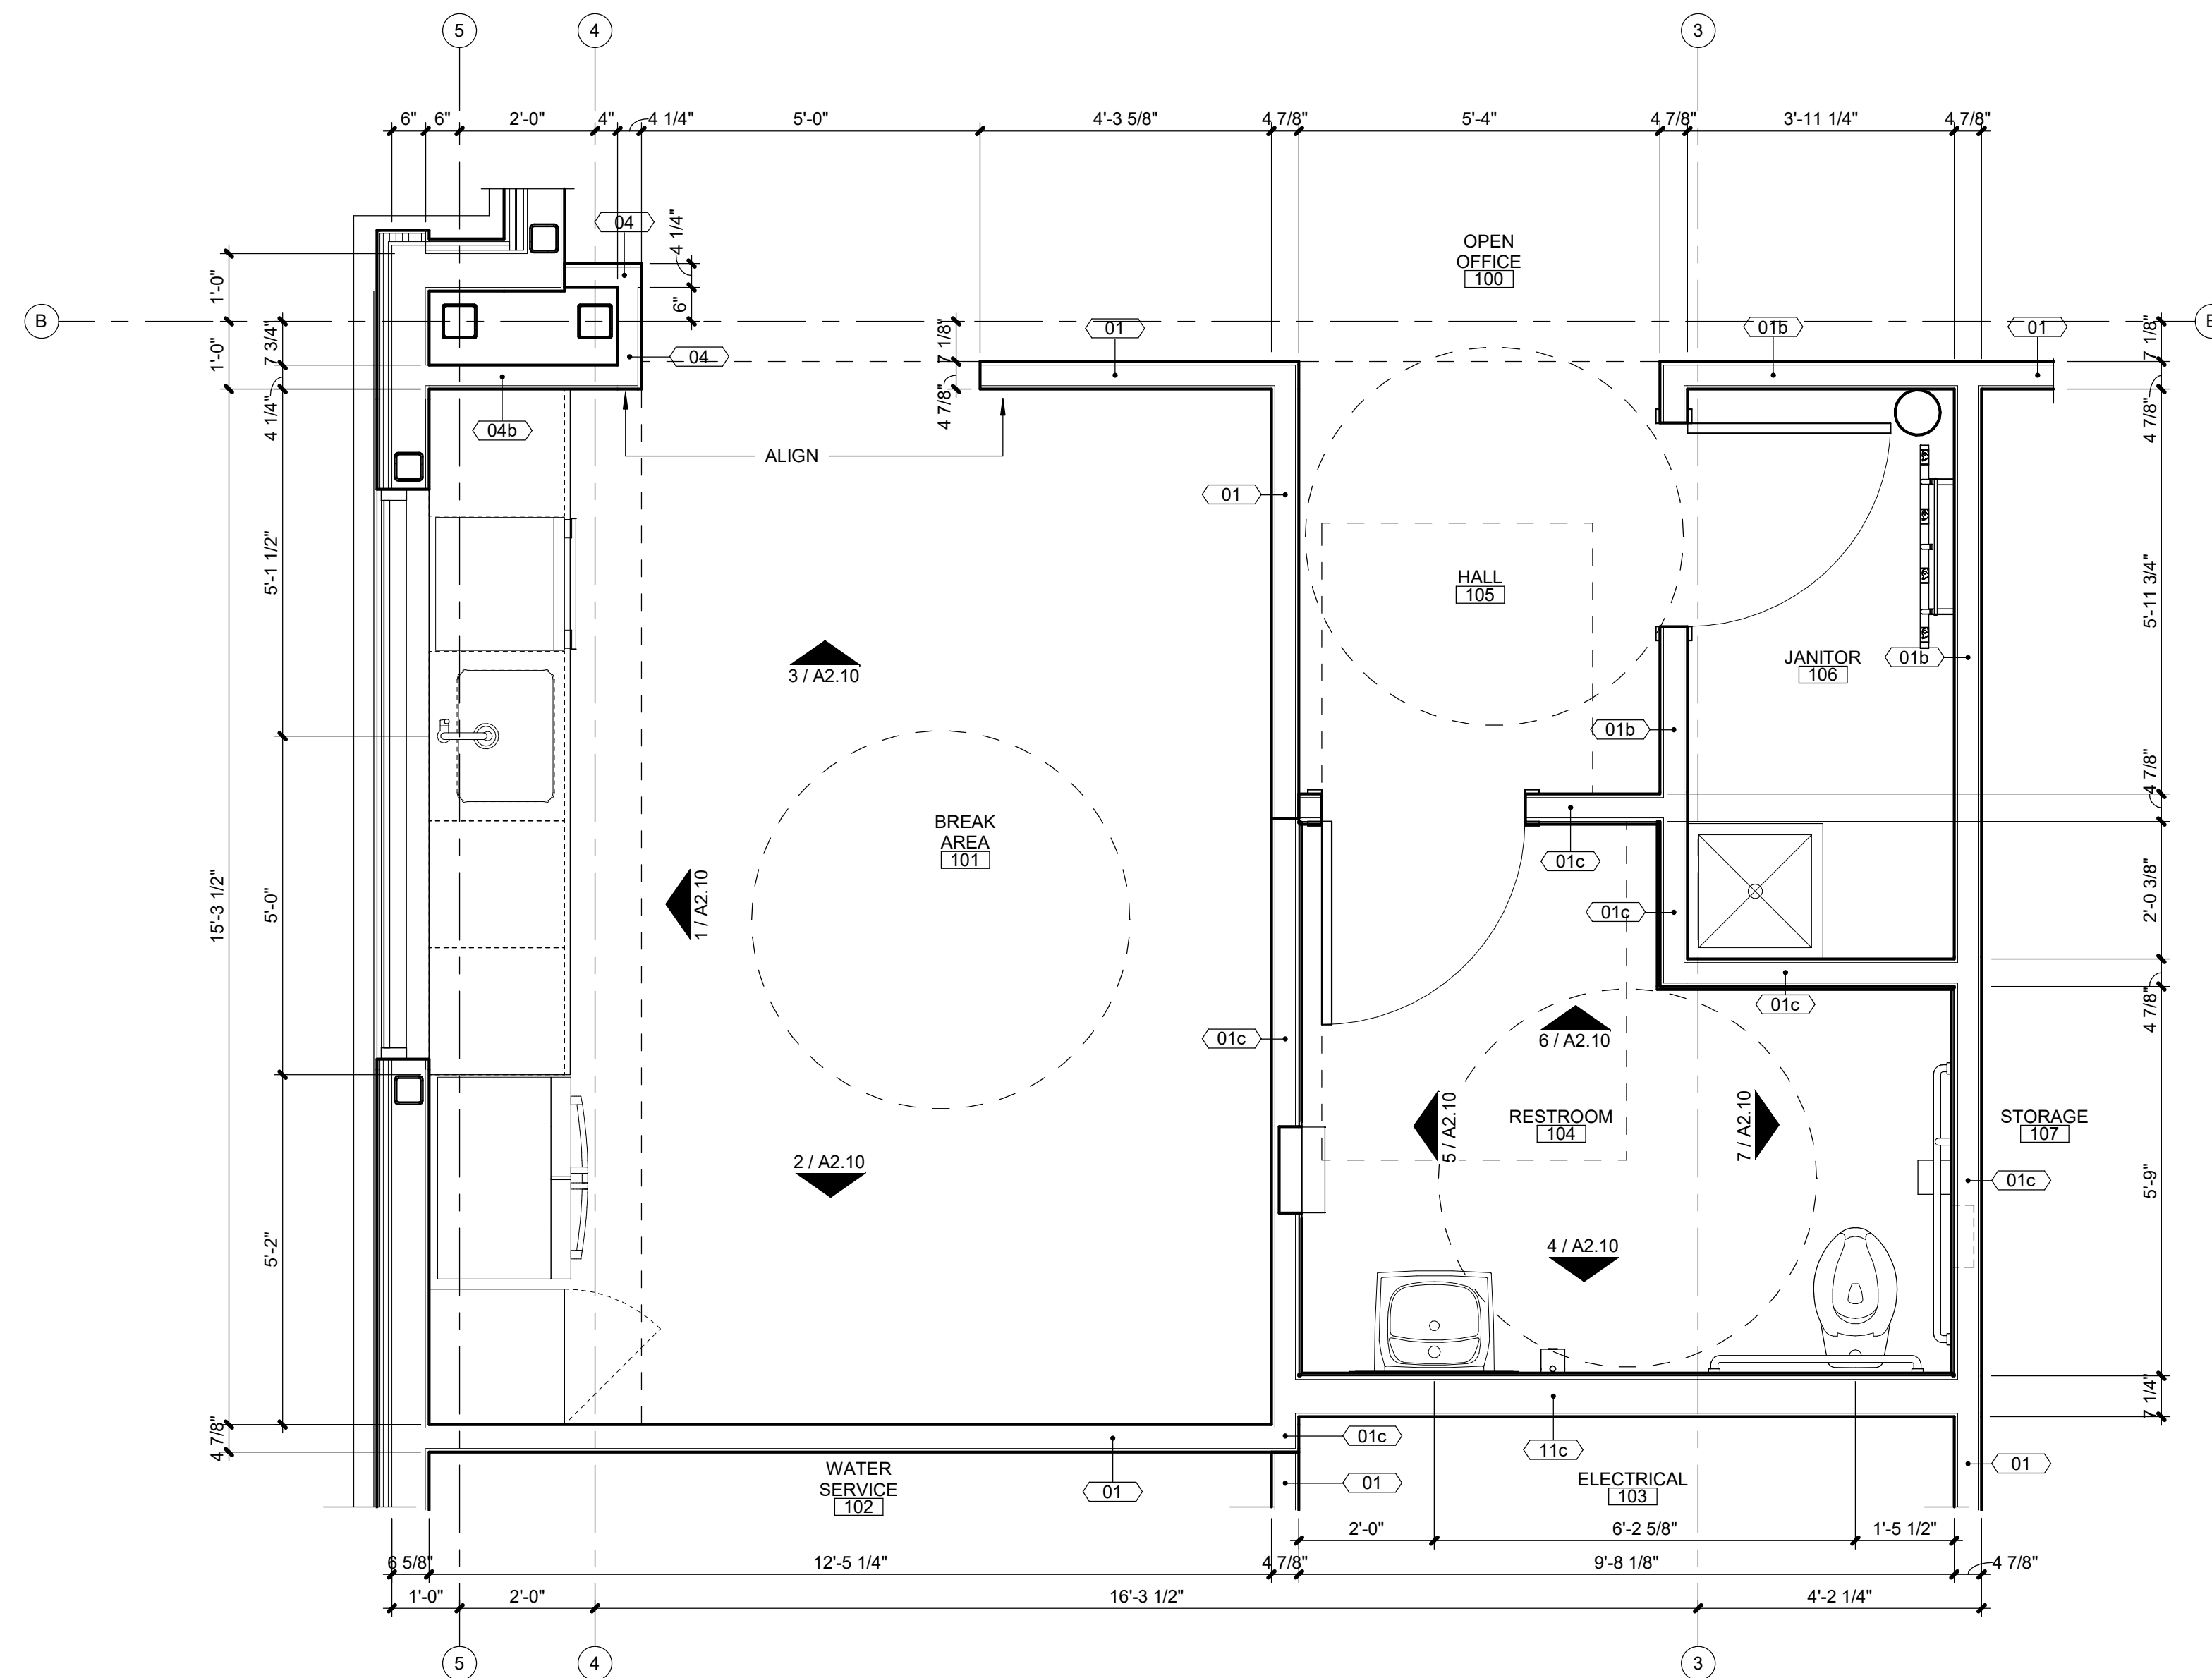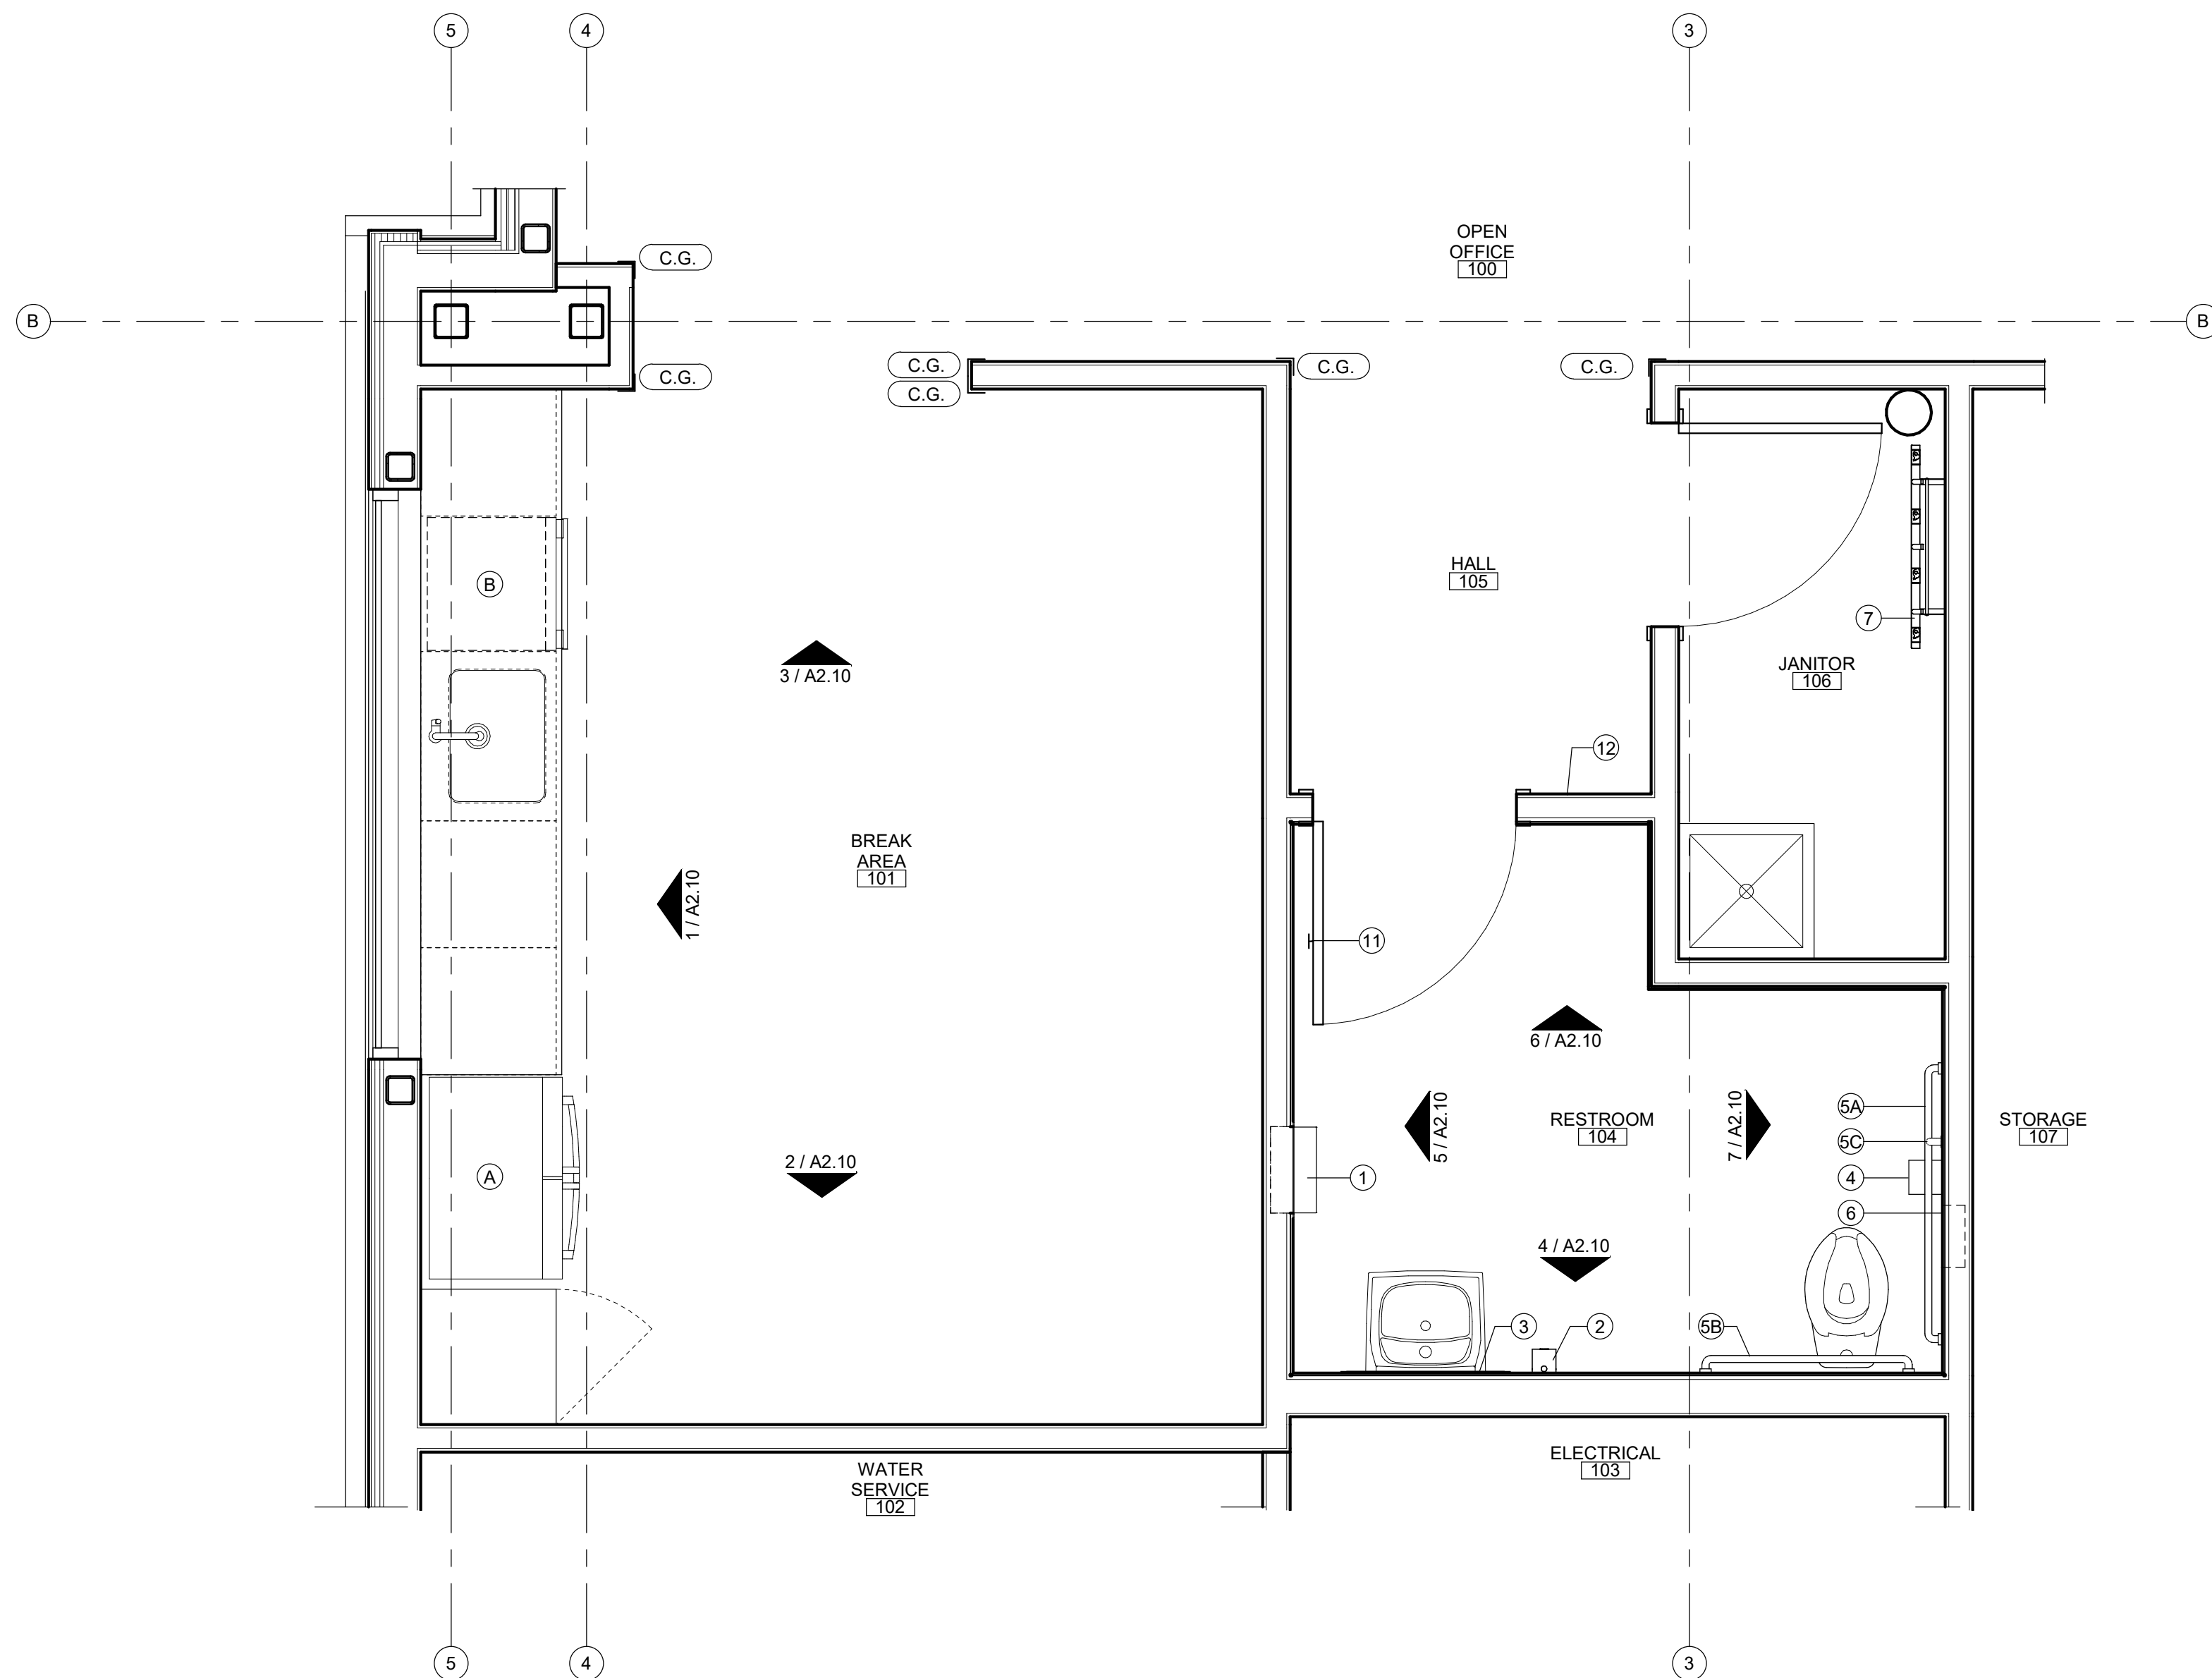PLAN	TRUE
	


1	ENLARGED PLAN
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	PLAN	TRU
		






8	CASEWORK DETAIL
A2.10	SCALE : 1" = 1'-0"

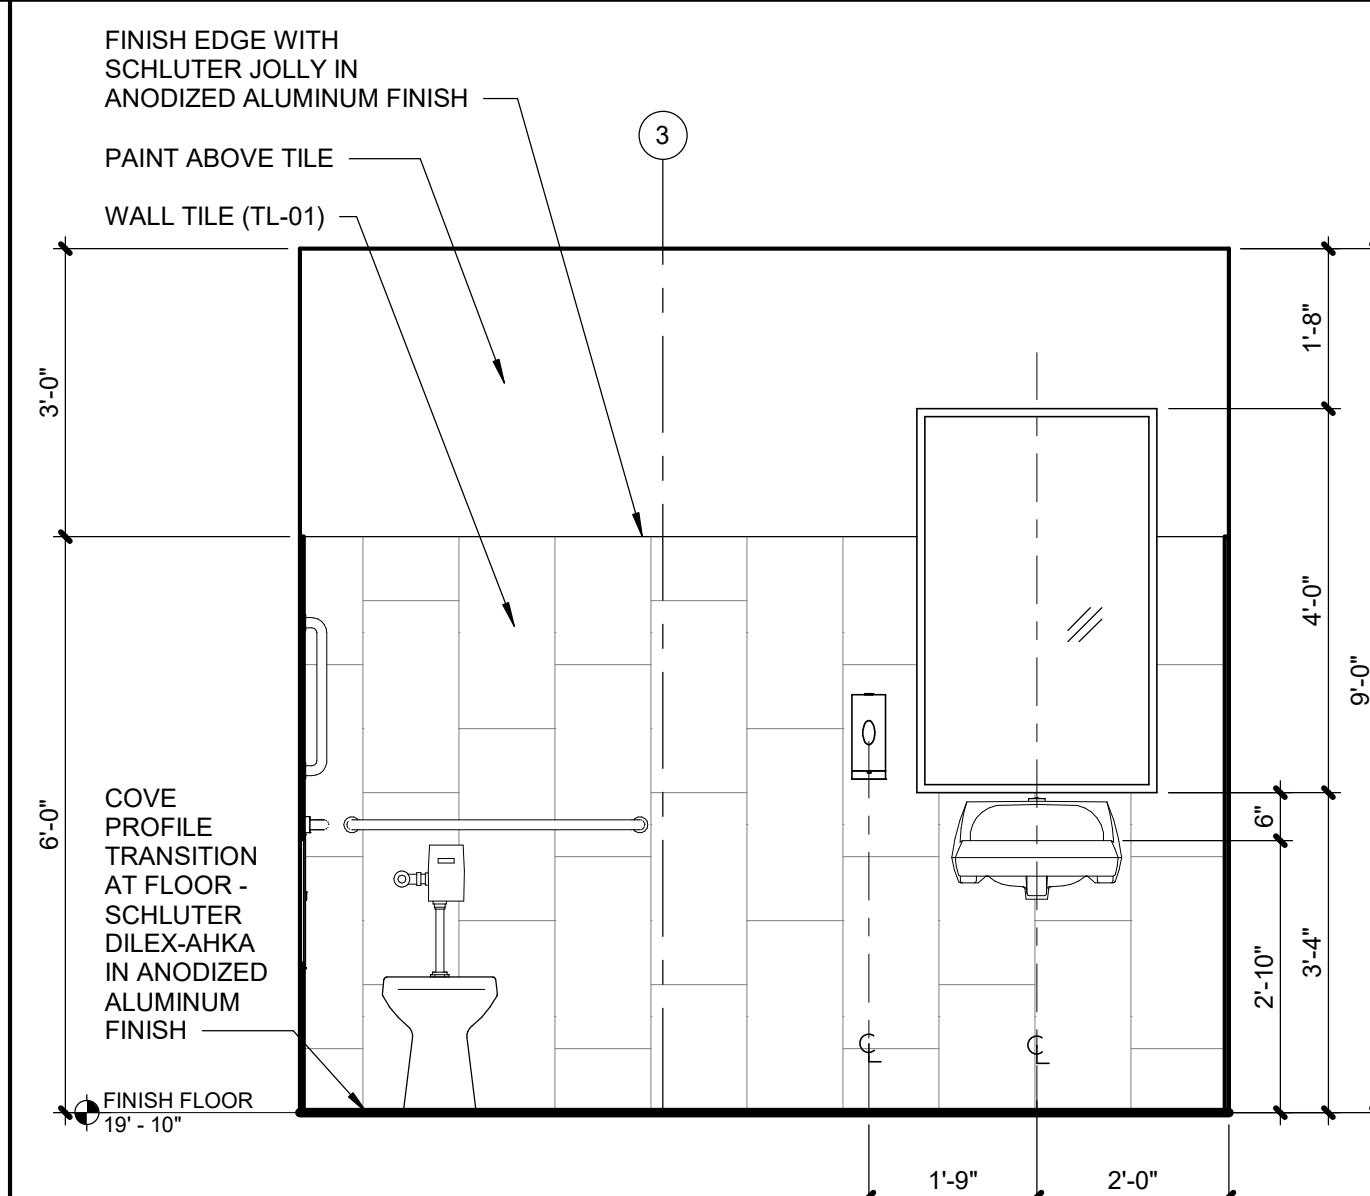

4	INTERIOR ELEV. - RESTROOM
A2.10	SCALE : 1/2" = 1'-0"

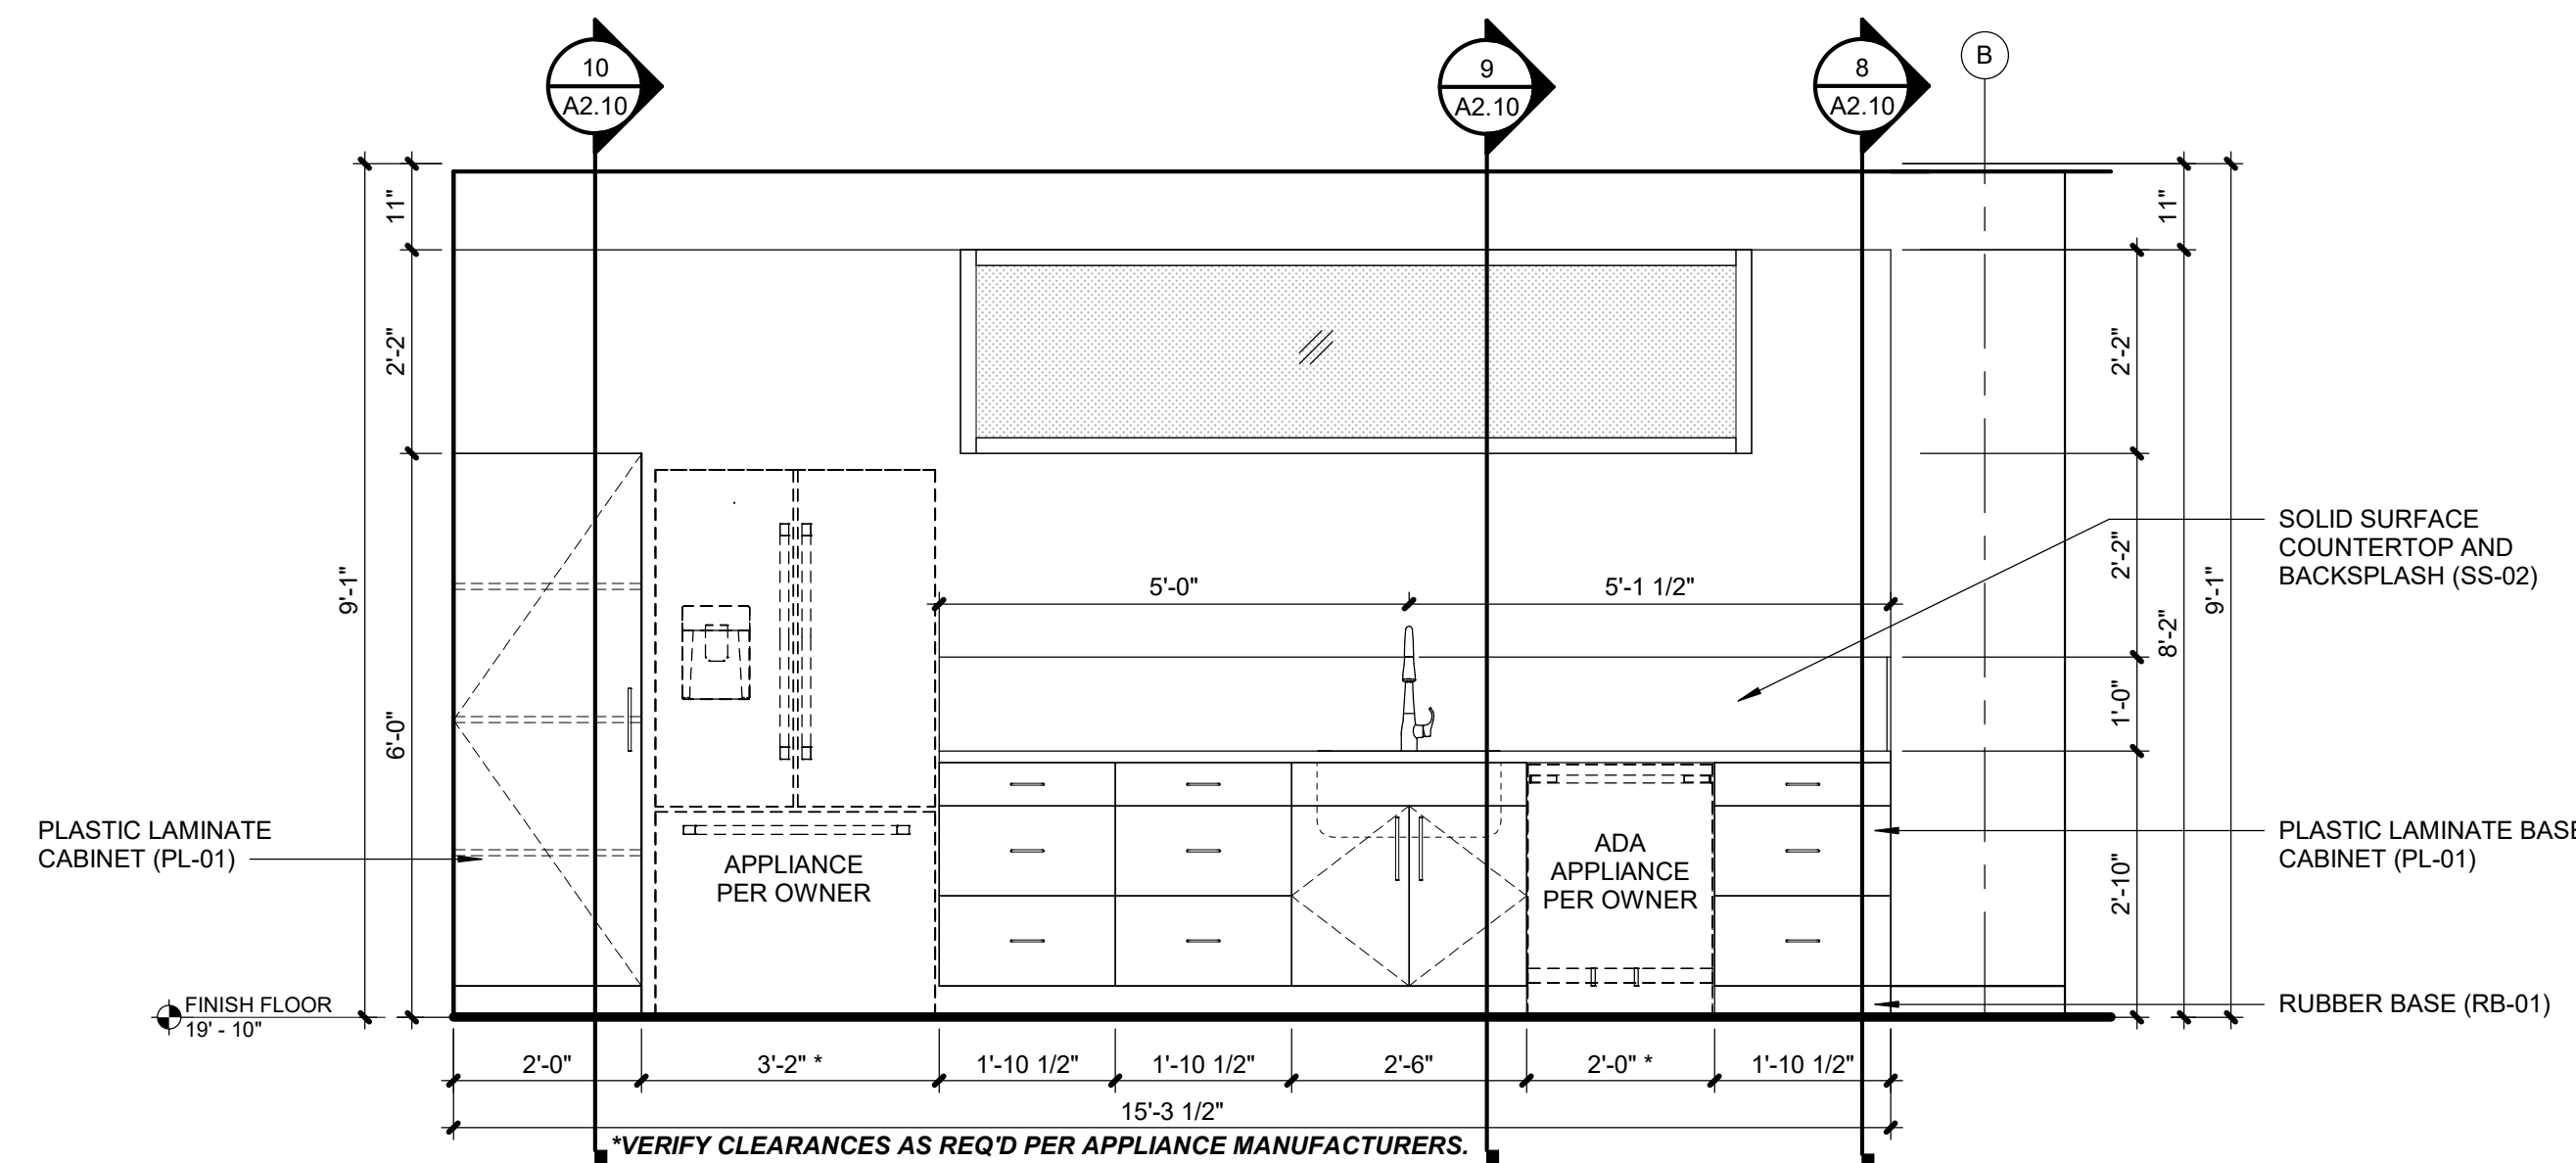

1	INTERIOR ELEV. - BREAKROOM
A2.10	SCALE : 1/2" = 1'-0"



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ROOF PLAN GENERAL NOTES

1. THE SINGLE PLY ROOF SHALL BE TPO, 60 MIL, WHITE MEMBRANE, FULLY ADHERED, W/A 20 YEAR NO DOLLAR LIMIT MANUFACTURER'S WARRANTY.
2. ROOF DRAINS ARE TO BE COLLECTED UNDERGROUND AND CONTINUED PER CIVIL ENGINEERING PLANS.
3. SEE SHEET A7.01 FOR ROOF PARAPET DETAILS
4. SEE PLUMBING AND MECHANICAL PLANS FOR ROOF TOP EQUIPMENT AND PENETRATION LOCATIONS.



LOT 20 - HUB BUILDING

2151 NW PARAGON PKWY  
LEE'S SUMMIT, MO 64081

Project No.: 19050.02  
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REVISIONS		
No.	Date	Description

REGISTRATION



PROJECT TEAM

ARCHITECT	FINKLE+WILLIAMS ARCHITECTURE
CIVIL	GBA
LANDSCAPE	HOERR SCHAUDT / LANDS
FOUNDATIONS	BSE STRUCTURAL ENGINEERS
STRUCTURAL	BSE STRUCTURAL ENGINEERS
PLUMBING	HENDERSON ENGINEERS
MECHANICAL	HENDERSON ENGINEERS
ELECTRICAL	HENDERSON ENGINEERS
FIRE PROTECTION	HENDERSON ENGINEERS
CONTRACTOR	FOGEL ANDERSON



FINKLE + WILLIAMS  
ARCHITECTURE


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SHEET TITLE

ROOF PLAN

SHEET NUMBER

A3.01

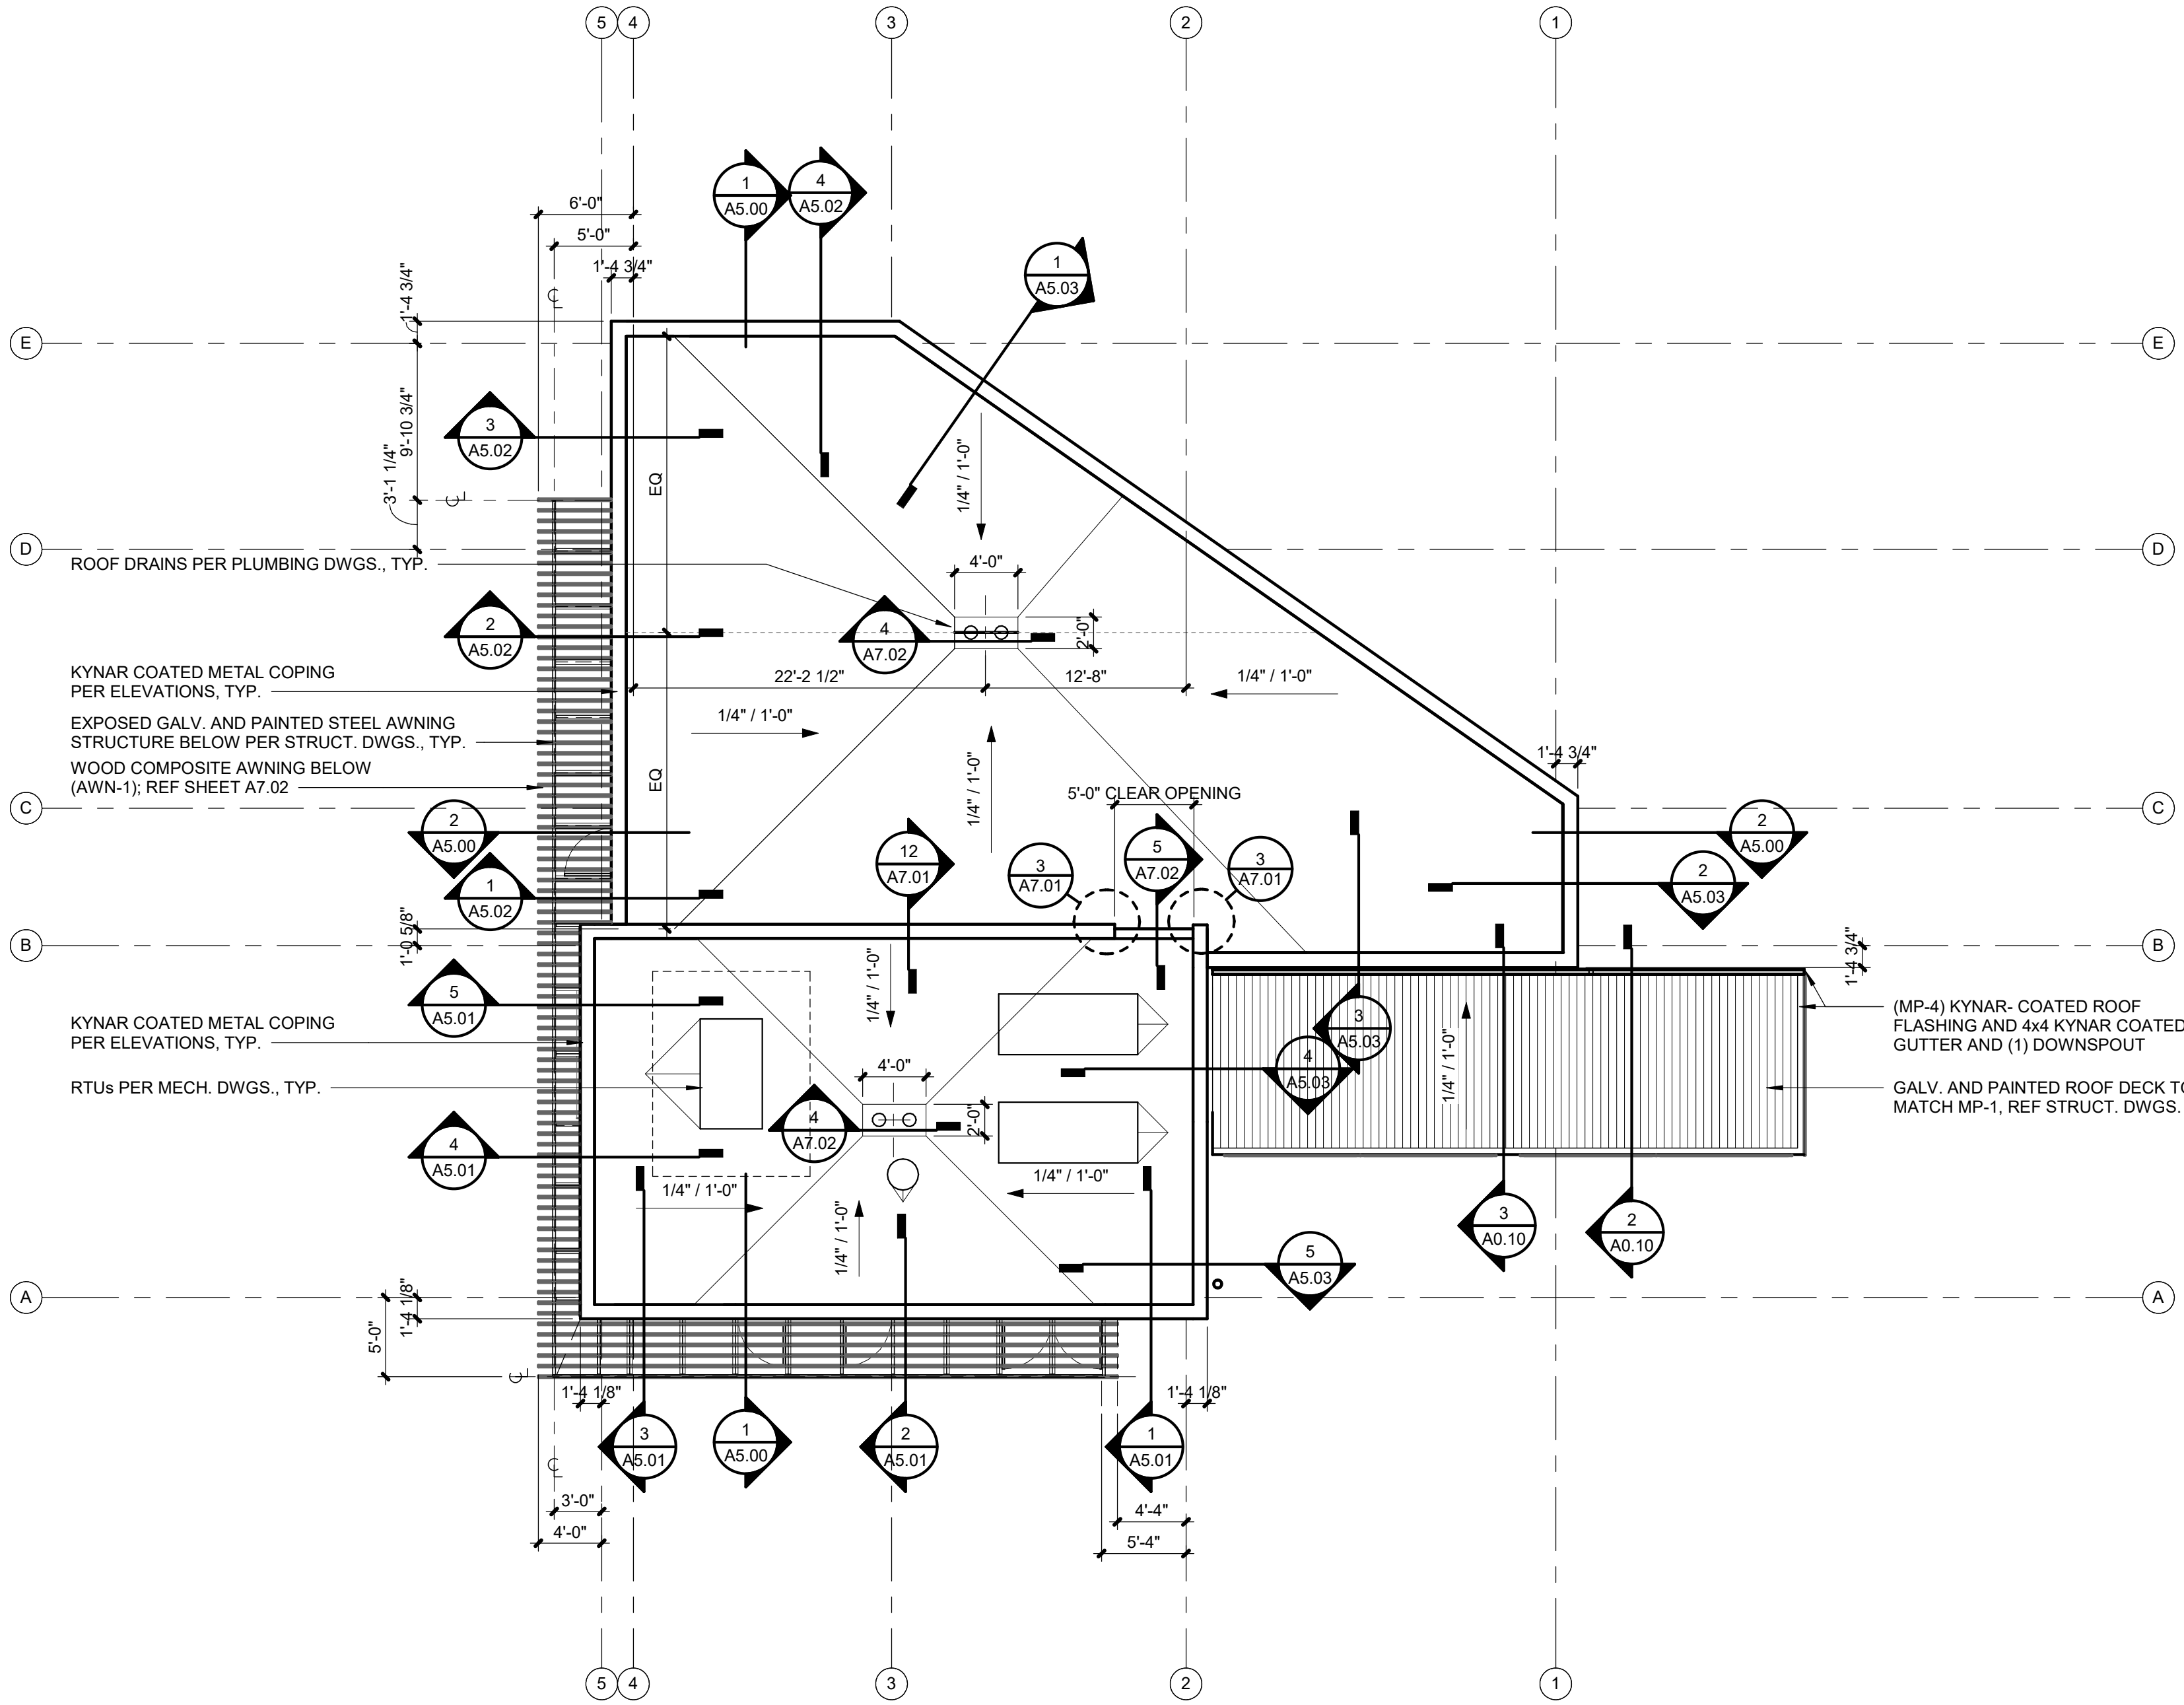

1

ROOF PLAN

A3.01

SCALE : 1/8" = 1'-0"





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LEE'S SUMMIT, MO 64081


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REGISTRATION



## PROJECT TEAM

ARCHITECT	FINKLE+WILLIAMS ARCHITECTURE
CIVIL	GBA
LANDSCAPE	HOERR SCHAUDT / LANDS
FOUNDATIONS	BSE STRUCTURAL ENGINEERS
STRUCTURAL	BSE STRUCTURAL ENGINEERS
PLUMBING	HENDERSON ENGINEERS
MECHANICAL	HENDERSON ENGINEERS
ELECTRICAL	HENDERSON ENGINEERS
FIRE PROTECTION	HENDERSON ENGINEERS
CONTRACTOR	FOGEL ANDERSON

FINKLE + WILLIAMS  
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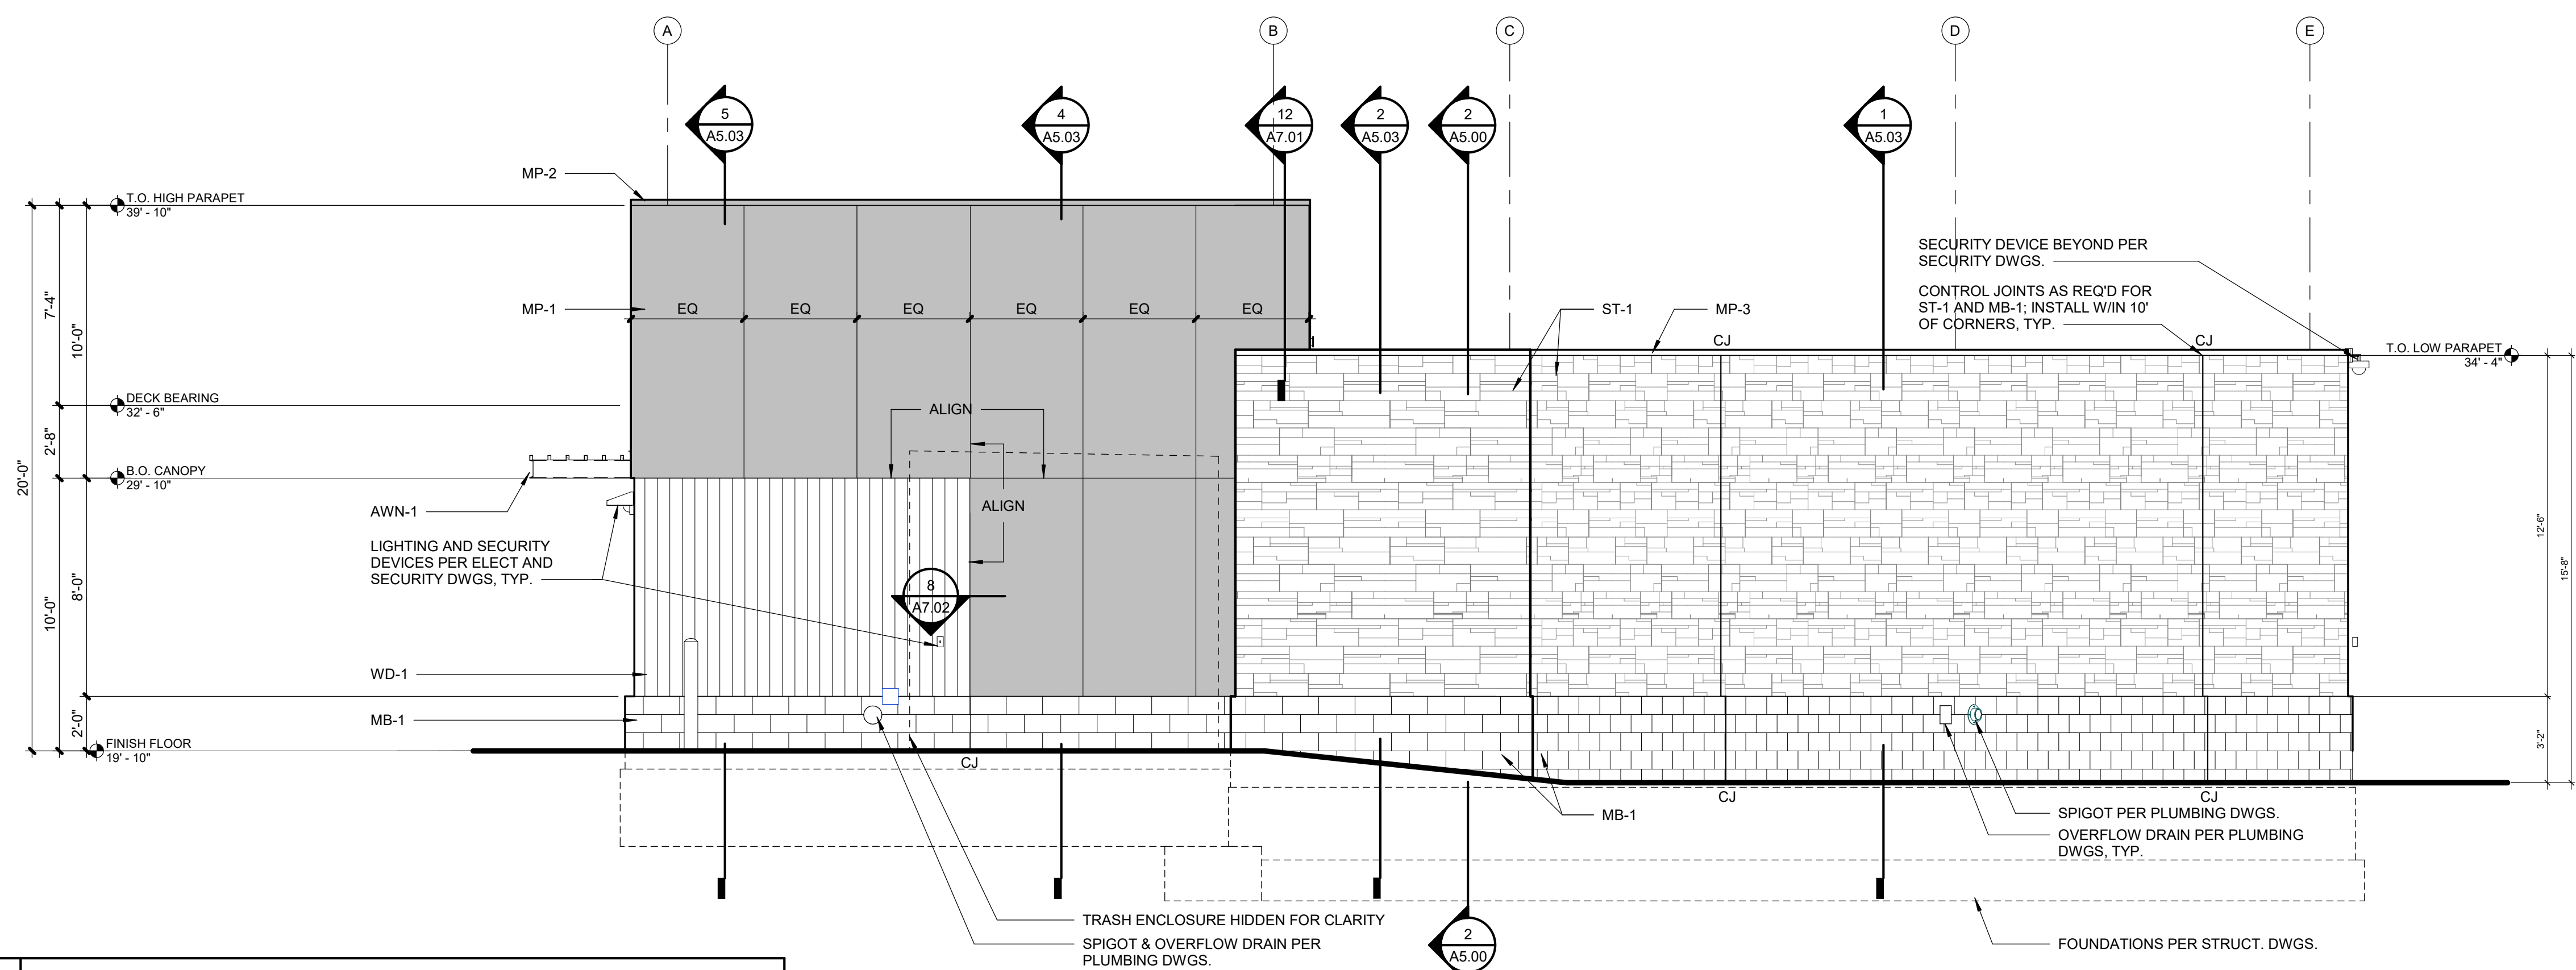
## EXTERIOR ELEVATIONS

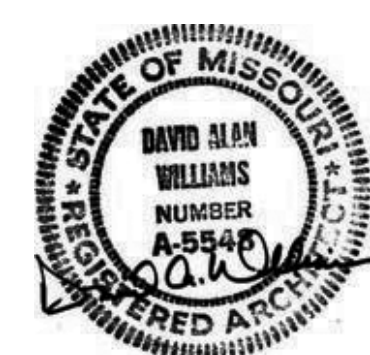SHEET NUMBER

## A4.01


## EXTERIOR MATERIAL LEGEND

- |       |   |
|-------|---|
| MP-1  | ALUMINUM COMPOSITE METAL (ACM) DRY SYSTEM; ALUOCBOND; COLOR: NAUTRAL BURNISHED CARBON; ACM PANEL JOINTS TO ALIGN WITH JOINTS PER ELEVATIONS                   |
| MP-2  | KYNAR-COATED 24 GA BREAK METAL COPING TO MATCH MP-1   |
| MP-3  | KYNAR-COATED 24 GA BREAK METAL COPING TO MATCH ST-1   |
| MP-4  | KYNAR-COATED METAL FLASHING, GUTTER AND DOWNSPOUT; COLOR TBD TO MATCH MP-1  |
| MP-5  | PAC-LACD MIDNIGHT BROWN PERFORATED CORRUGATED METAL PANEL, .050 ALUM. 1/4" ROUND W/ 1/2" STAGGERED, 23% OPEN AREA PER MFR.                                    |
| WD-1  | GEOLAM VERTIGO 5010 COMPOSITE CLADDING, COLOR: MOLESKIN   |
| WD-2  | GEOLAM GLASS 020C VERTICAL SLAB TGMOSITE DECKING, COLOR: MOLESKIN   |
| GL-1  | 2" x 4.5" KAWNEER PERMACOAT SMOKE GRAY ALUMINUM CENTER GLAZED STORERONT SYSTEM W/ 1" INSULATED LOW-E GLAZING UNIT   |
| ST-1  | ELDORADO CULTURED STONE VANTAGE 30, DRY-STACK NON-GROUTED, COLOR: WHITE ELM   |
| MB-1  | GROUND FACE 4X16 VENEER SMOLENO BLOCK, BURNISHED FINISH, COLOR: MIDWEST SLATE   |
| AWN-1 | CANOPY: GALV. AND PAINTED STEEL COLEMAN FRAME (PER PERMANENT DRAINAGE) 12' X 12' ALUMINUM SOLENO R999 COMPOSITE WOOD @ 8" O.C. PER SHEET #47, COLOR: MOLESKIN |



2	EAST ELEVATION
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<b>A4.01</b>	SCALE : 1/4" = 1'-0"
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1	WEST ELEVATION
---	----------------

**A4.01** SCALE : 1/4" = 1'-0"

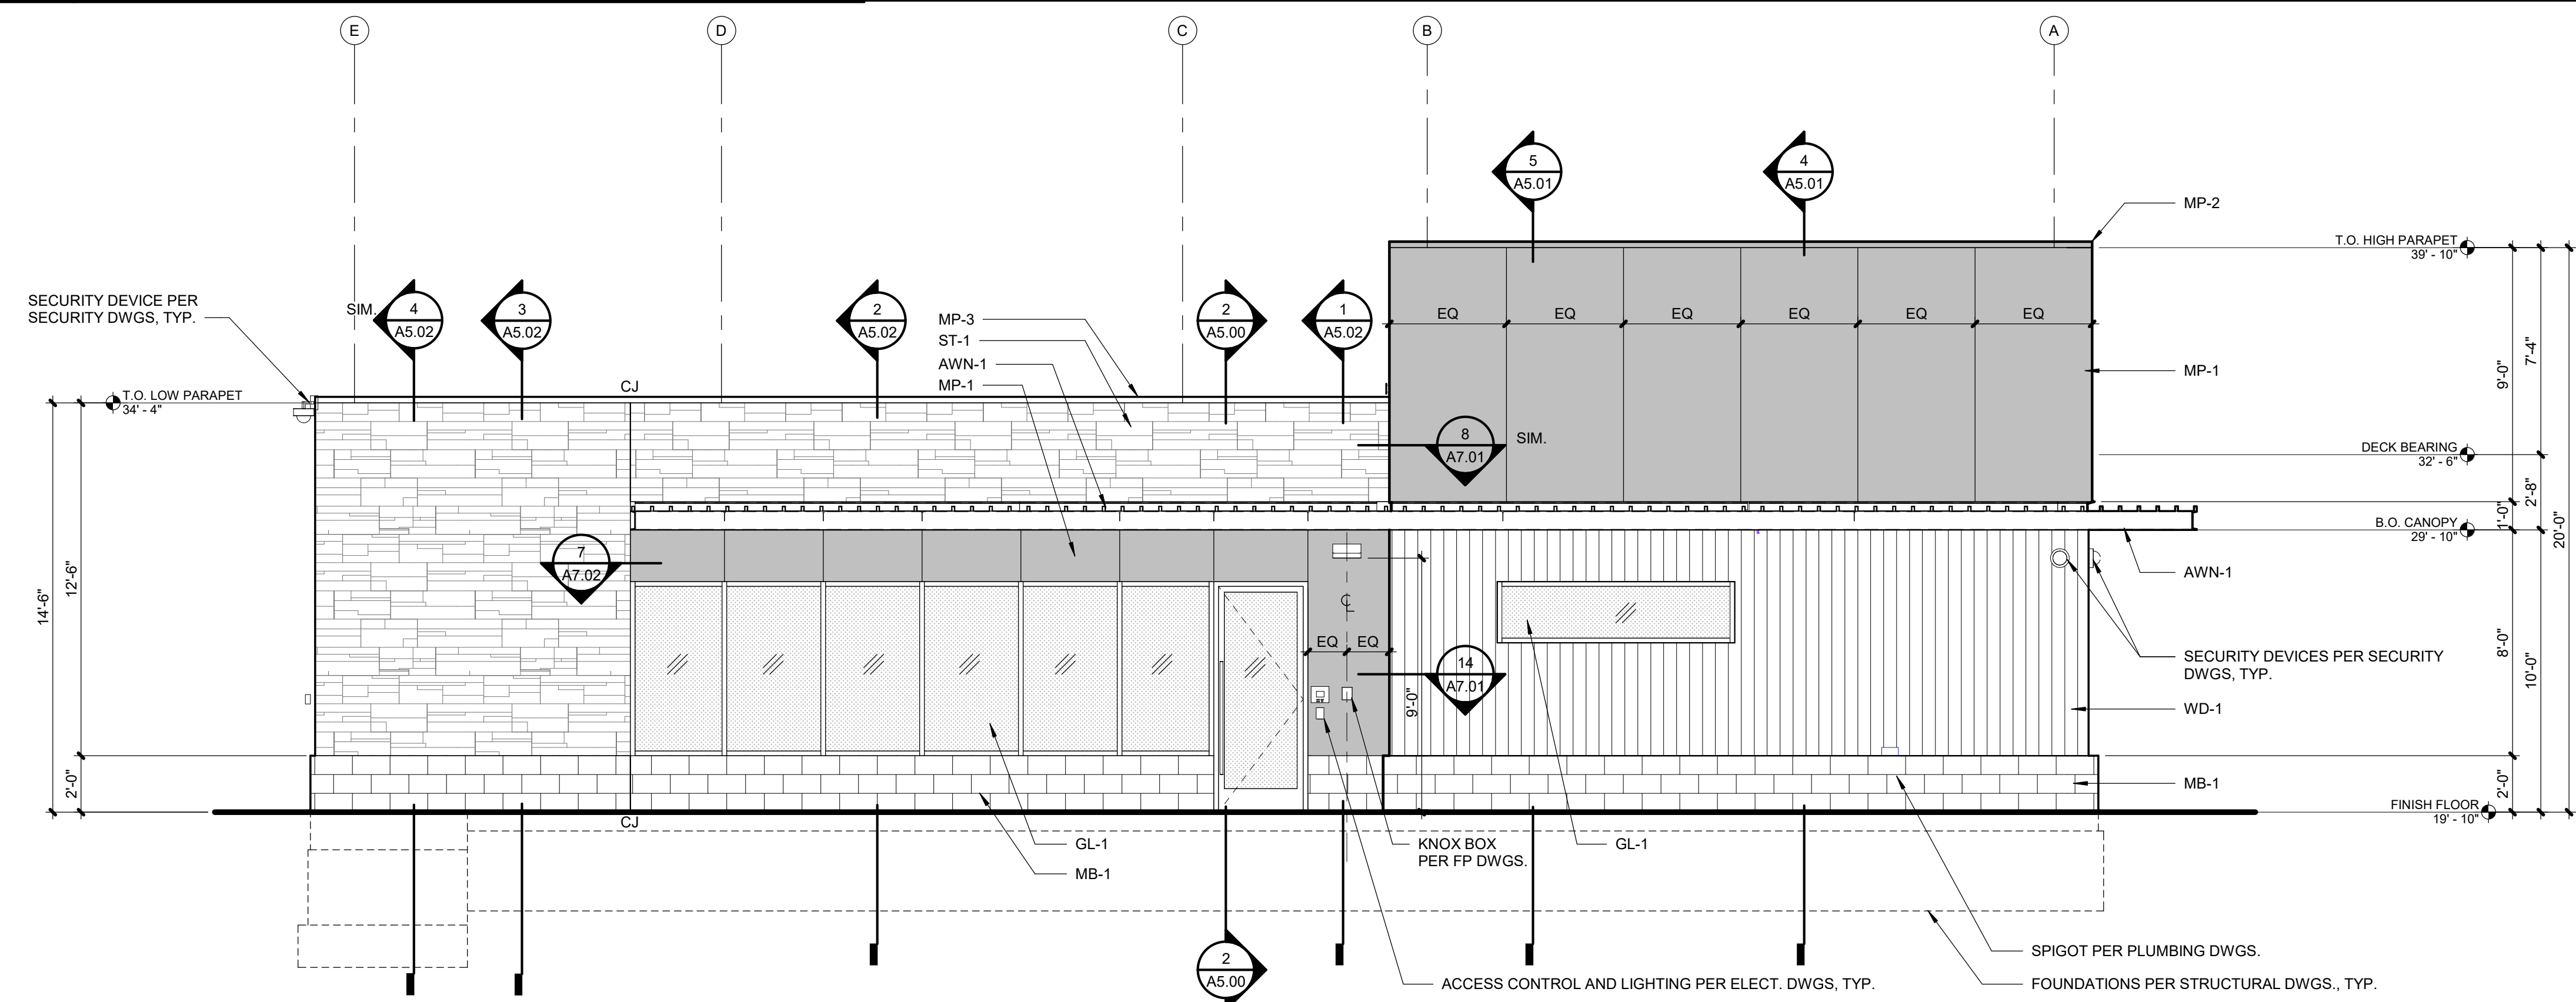



2151 NW PARAGON PKWY  
LEE'S SUMMIT, MO 64081


Project No.: 19050.02

Date: 08/06/2021

Issued For: PERMIT SET

[illegible]

## REGISTRATION

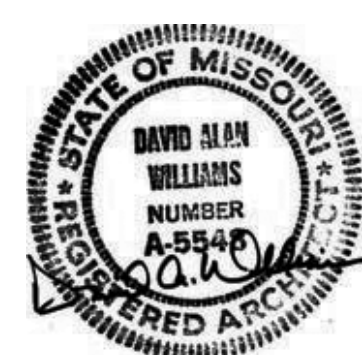

## PROJECT TEAM

ARCHITECT FINKLE+WILLIAMS  
ARCHITECTURE

CIVIL                      GBA

LANDSCAPE      HOERR SCHAUDT

FOUNDATIONS BSE STRUCTURAL  
ENGINEERSSTRUCTURAL BSE STRUCTURAL  
ENGINEERS

PLUMBING      HENDERSON  
ENGINEERS

MECHANICAL HENDERSON  
ENGINEERSELECTRICAL HENDERSON  
ENGINEERS

FIRE PROTECTION HENDERSON  
ENGINEERS

CONTRACTOR FOGEL ANDERSON

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LENEXA, KANSAS 66219  
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SHEET TITLE


## EXTERIOR ELEVATIONS

SHEET NUMBER

## A4.02


## EXTERIOR MATERIAL LEGEND

- |       |  |
|-------|--|
| MP-1  | ALUMINUM COMPOSITE METAL (ACM) DRY SYSTEM; ALUOCBOND; COLOR: NAUTRAL BURNISHED CARBON; ACM PANEL JOINTS TO ALIGN WITH JOINTS PER ELEVATIONS            |
| MP-2  | KYNAR-COATED 24 GA BREAK METAL COPING TO MATCH MP-1  |
| MP-3  | KYNAR-COATED 24 GA BREAK METAL COPING TO MATCH ST-1  |
| MP-4  | KYNAR-COATED METAL FLASHING, GUTTER AND DOWNSPOUT; COLOR TBD TO MATCH MP-1   |
| MP-5  | PAC-LACD MIDNIGHT BROWN PERFORATED CORRUGATED METAL PANEL, .050 ALUM. 1/4" ROUND W/ 1/2" STAGGERED, 23% OPEN AREA PER MFR.                             |
| WD-1  | GEOLAM VERTIGO 5010 COMPOSITE CLADDING, COLOR: MOLEKIN   |
| WD-2  | GEOLAM GLASS 020C VERTICAL SLAB TGMPOSITE DECKING, COLOR: MOLEKIN  |
| GL-1  | 2" x 4.5" KAWNEER PERMACOAT SMOKE GRAY ALUMINUM CENTER GLAZED STORERONT SYSTEM W/ 1" INSULATED LOW-E GLAZING UNIT                                      |
| ST-1  | ELDORADO CULTURED STONE VANTAGE 30, DRY-STACK NON-GROUTED, COLOR: WHITE ELM  |
| MB-1  | GROUND FACE 4X16 VENEER SMOLEY BLOCK, BURNISHED FINISH, COLOR: MIDWEST SLATE   |
| AWN-1 | CANOPY: GALV. AND PAINTED STEEL COLEMAN FRAME (PER PERMIT) BRUNT DESIGN; ALUMINUM SOLENO R90R COMPOSITE WOOD @ 8" O.C. PER SHEET #7 42, COLOR: MOLEKIN |

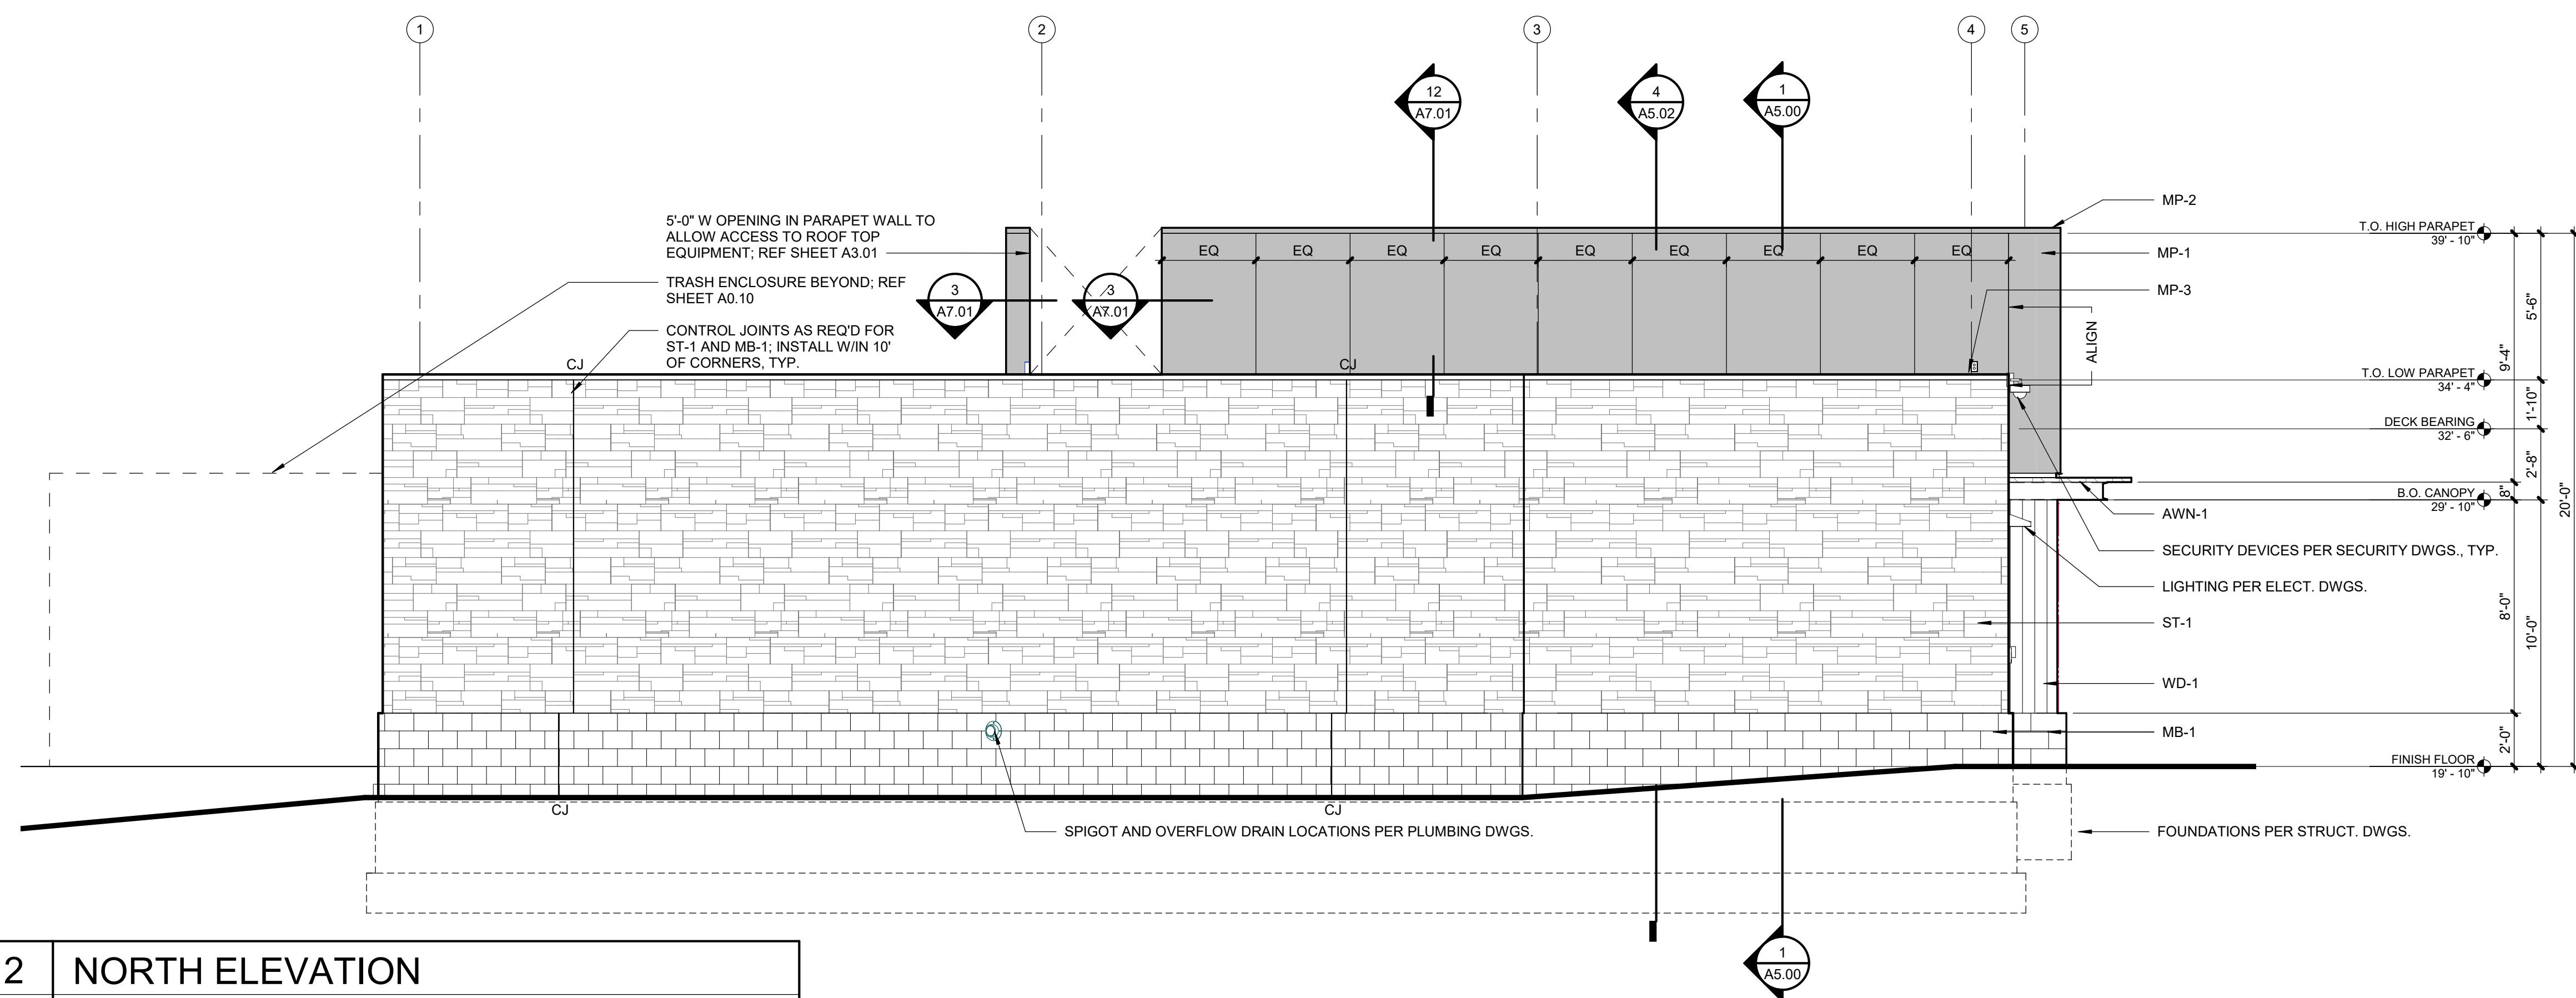

2	NORTH ELEVATION
---	-----------------


<b>A4.02</b>	SCALE : 1/4" = 1'-0"
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1	SOUTH ELEVATION
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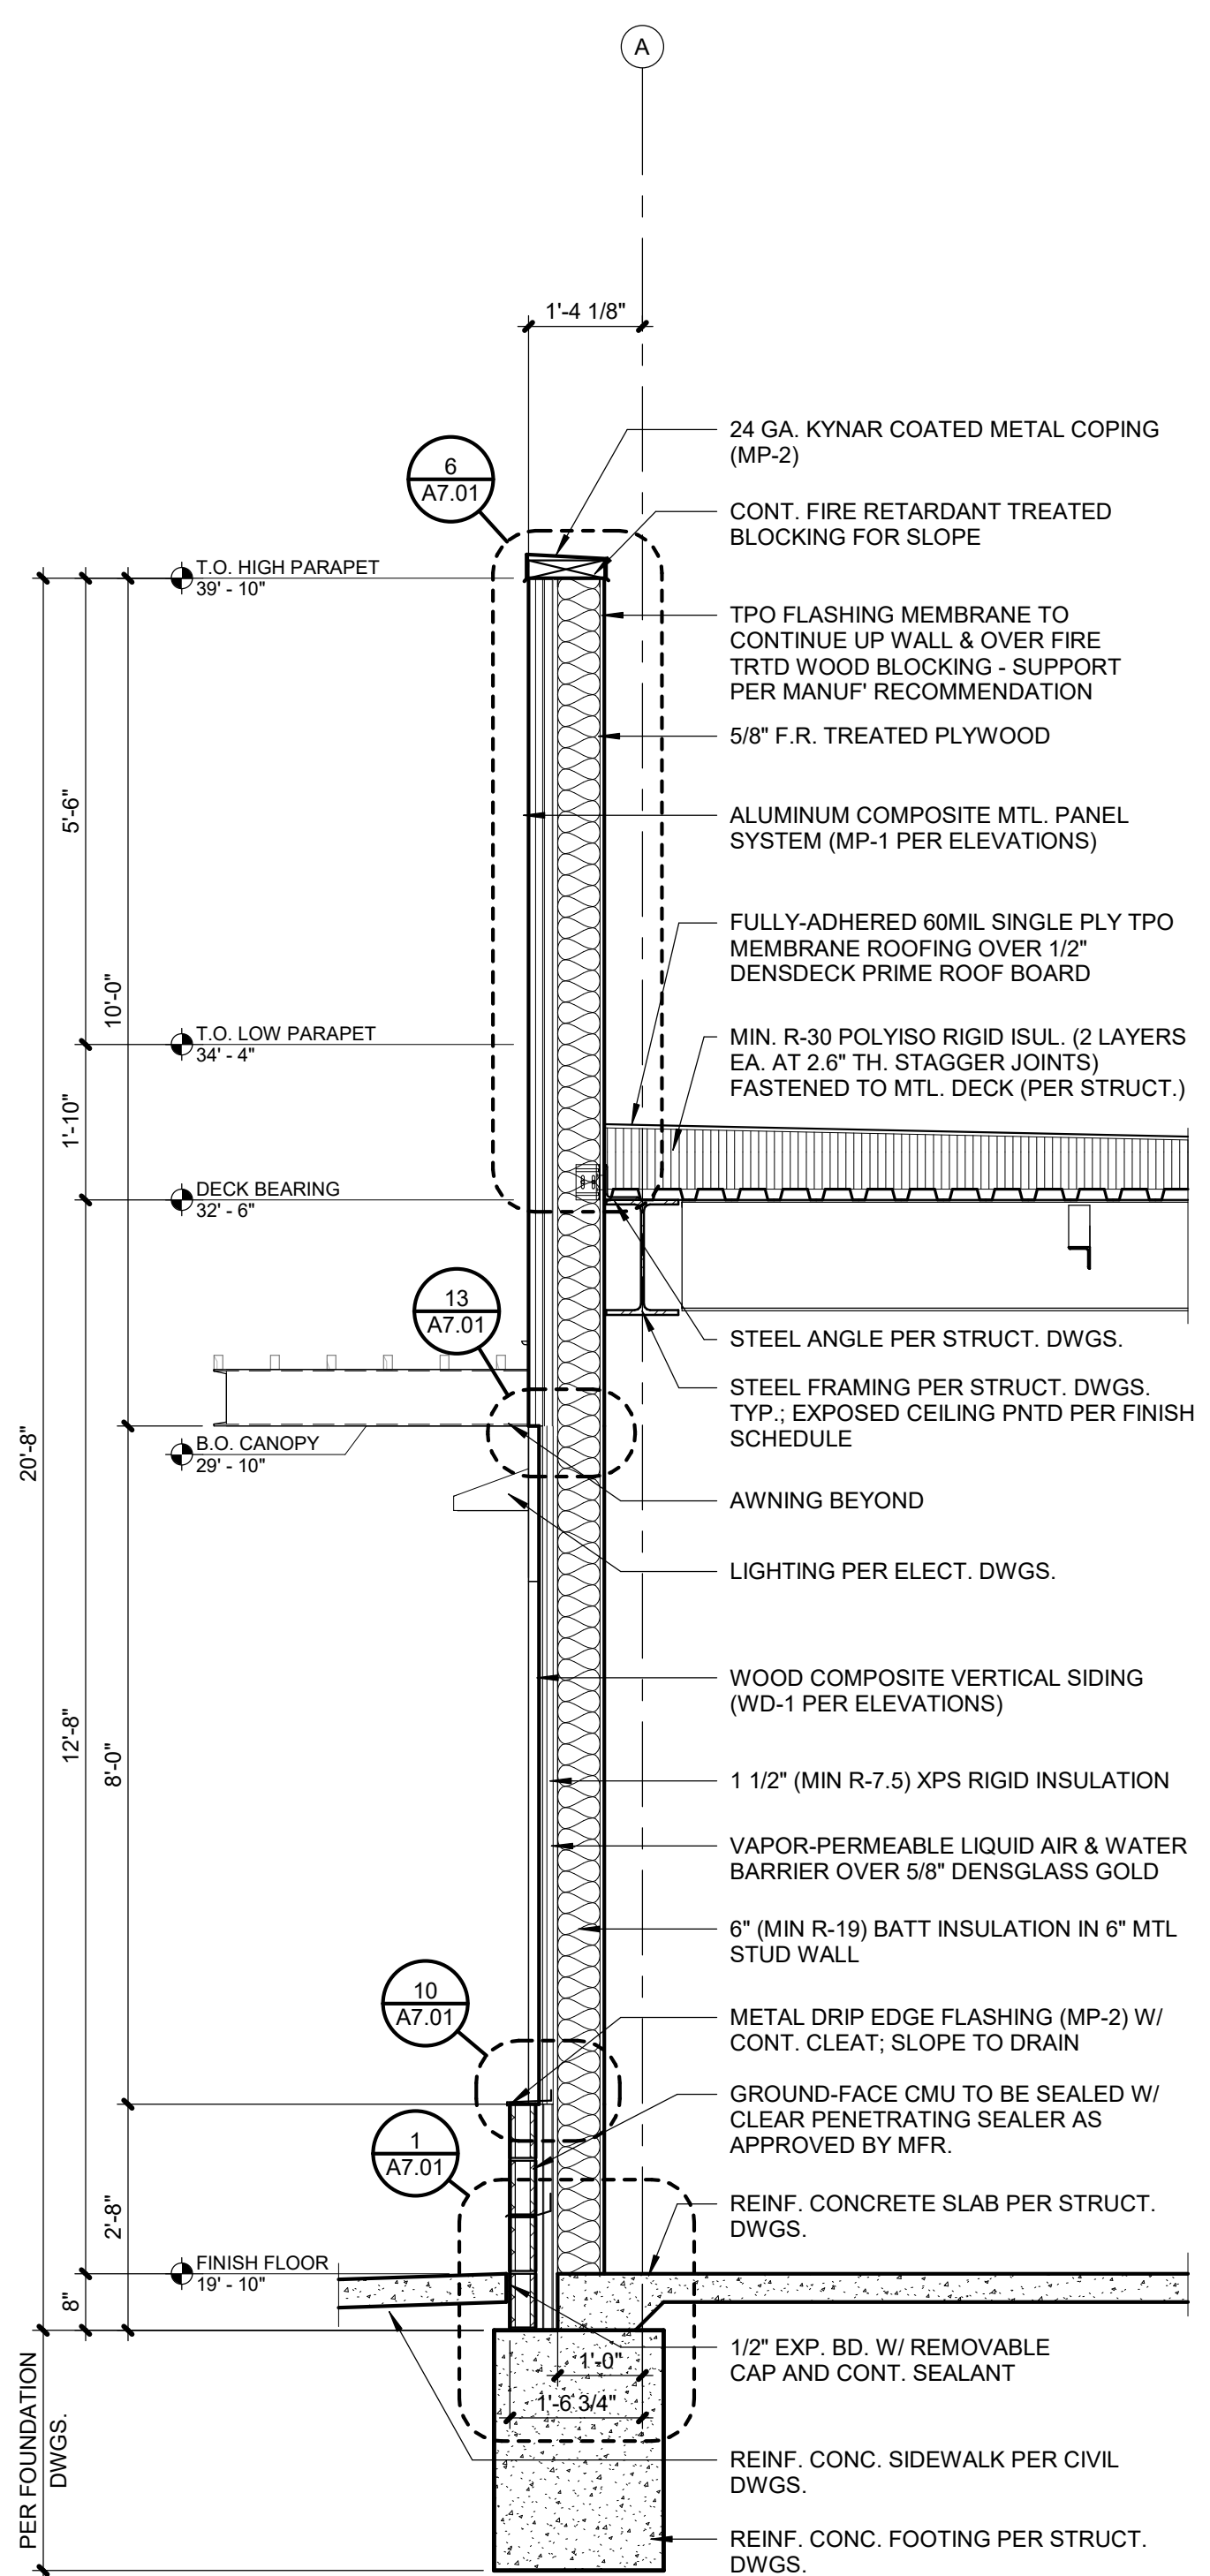
**A4.02** SCALE : 1/4" = 1'-0"

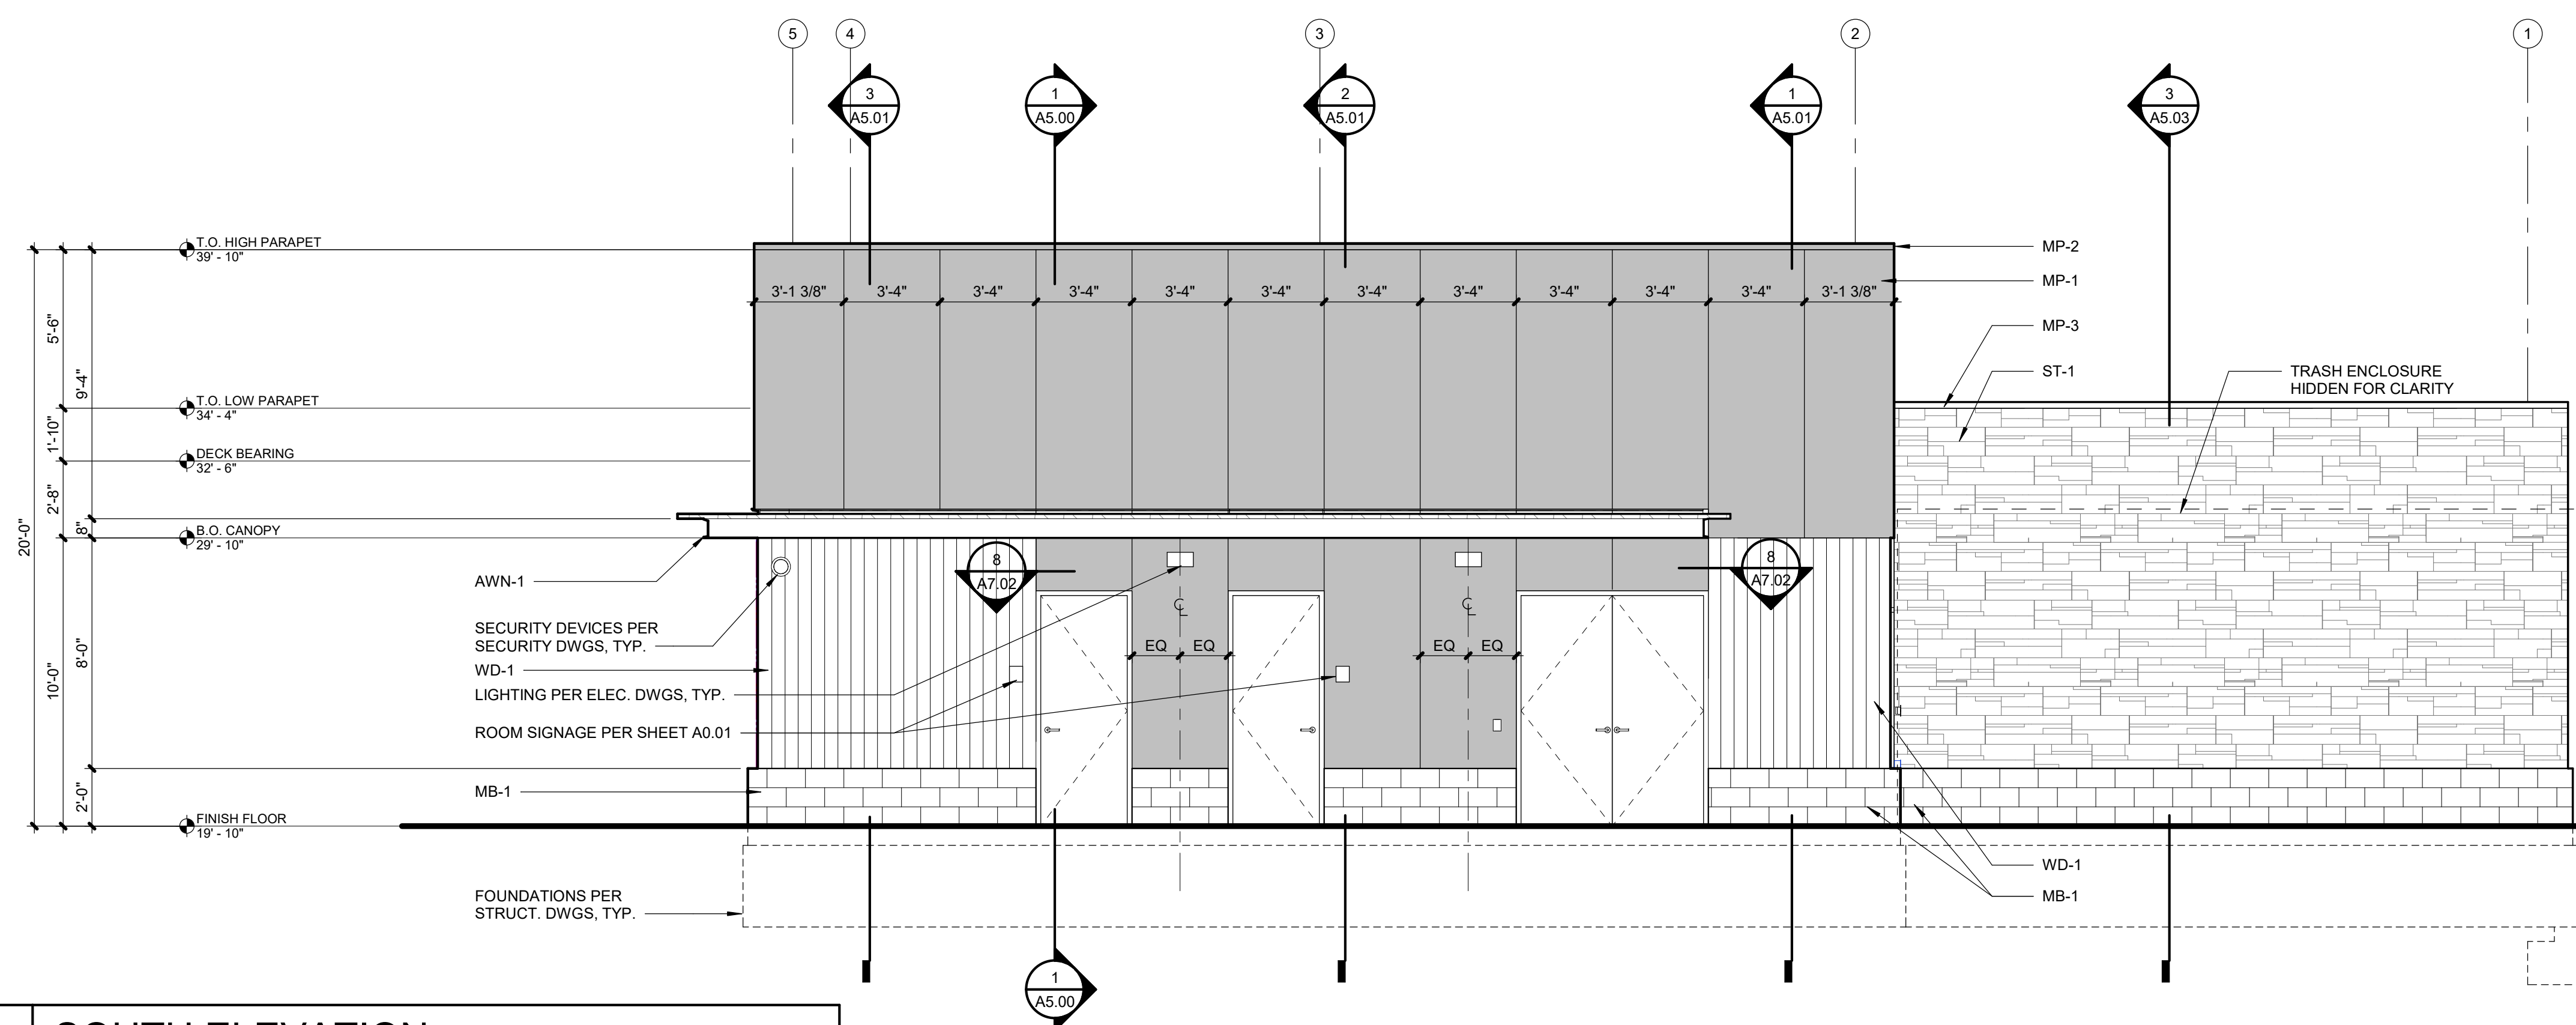



**A5.00** SCALE : 1/4" = 1'-0"




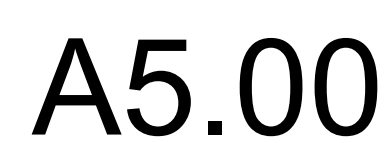

1	WALL SECTION
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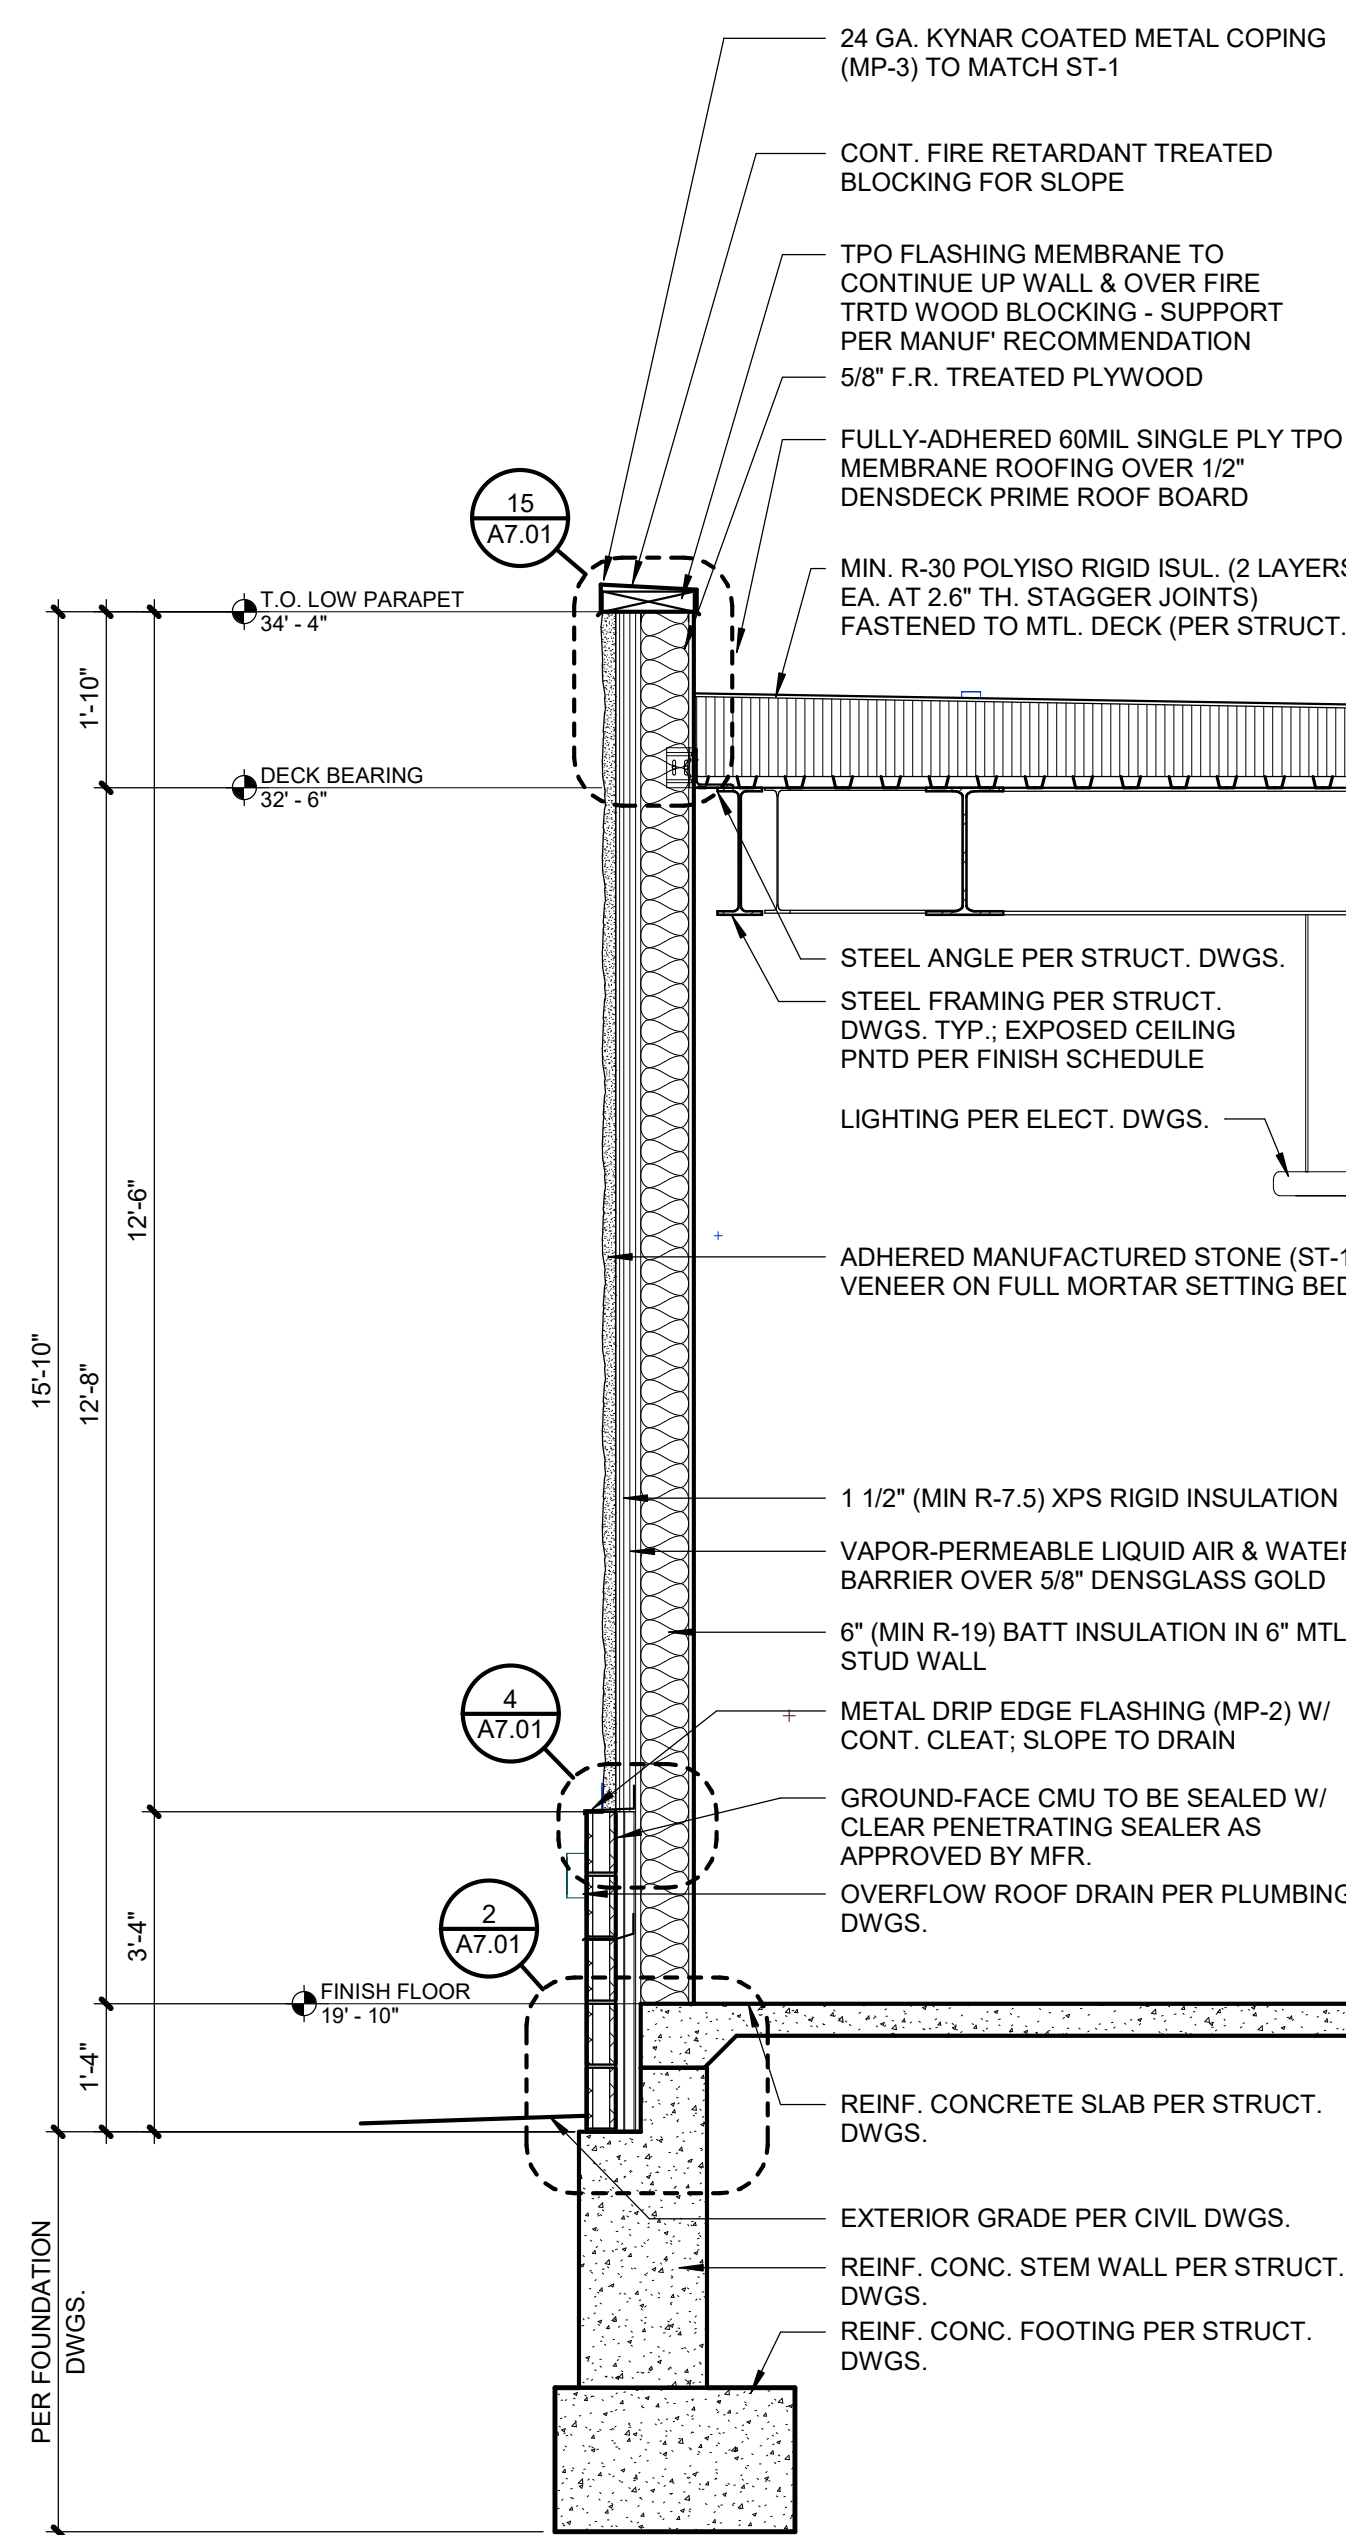
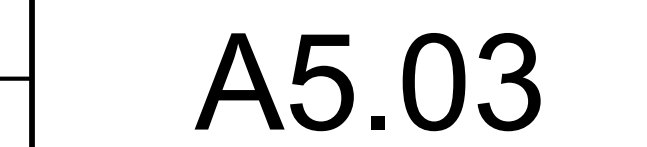
<b>A5.01</b>	SCALE : 1/2" = 1'-0"
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1	WALL SECTION
A5.02	SCALE : 1/2" = 1'-0"



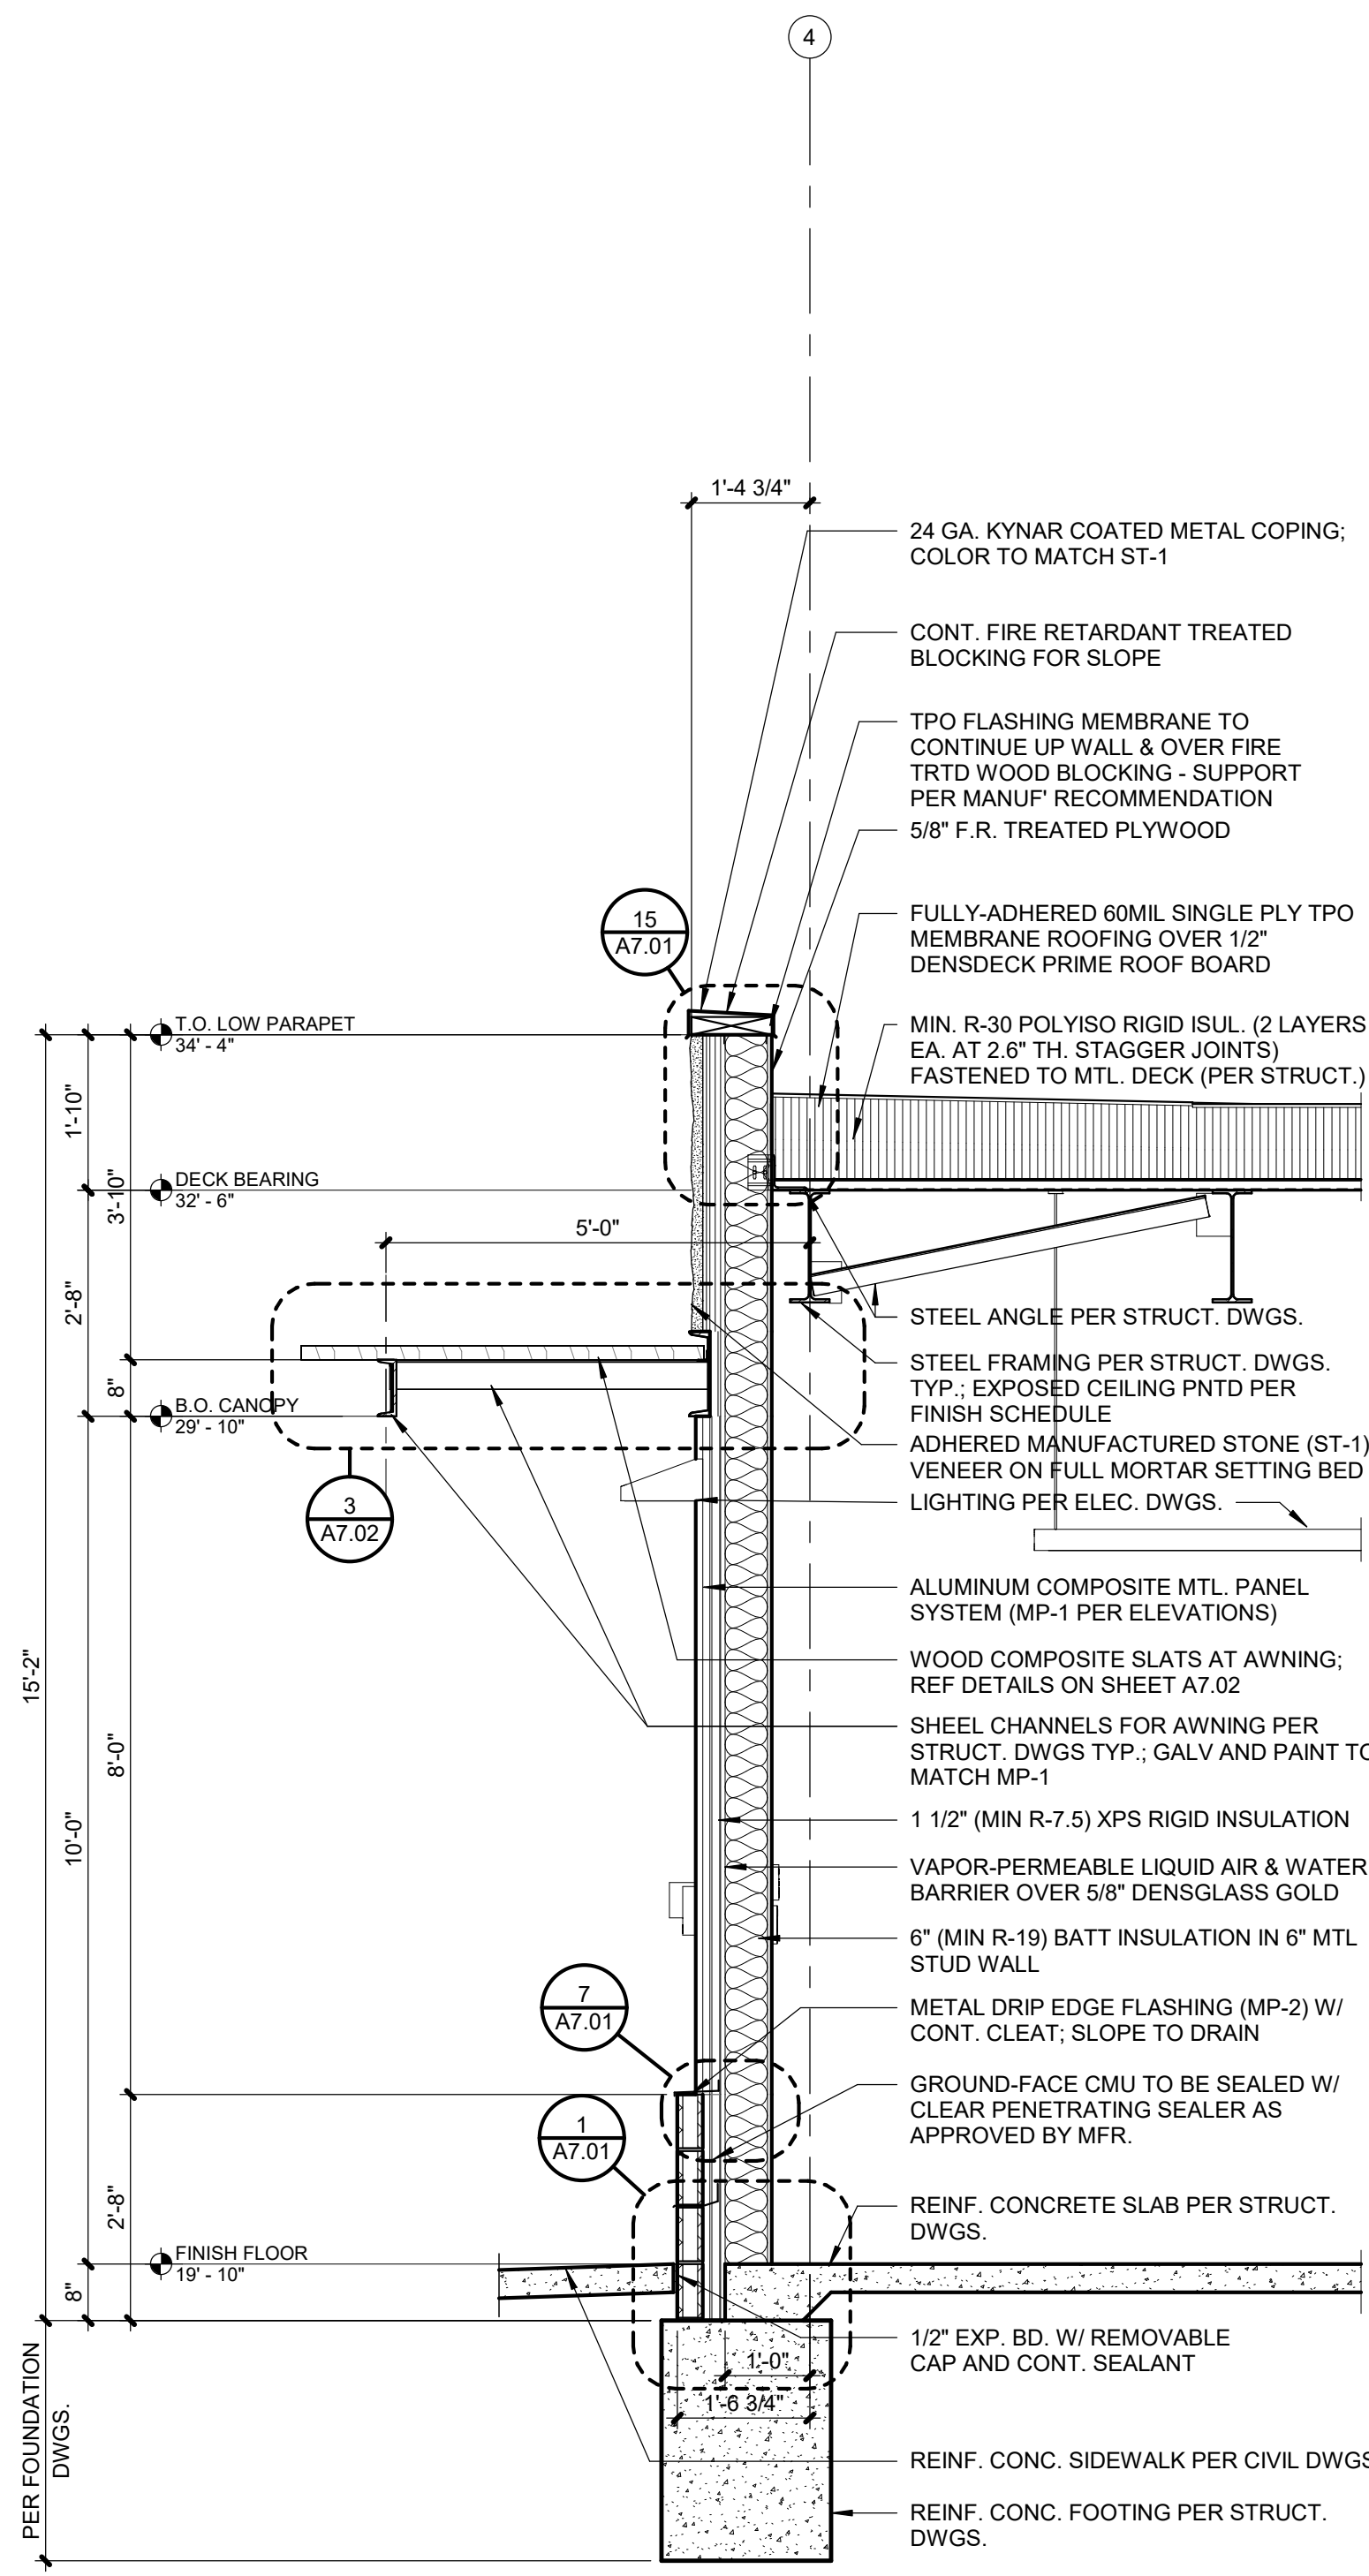

1	WALL SECTION
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<b>A5.03</b>	SCALE : 1/2" = 1'-0"
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Project No.: 19050.02


Date: 08/06/202

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REVISION

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REGISTRAR



PROJECT

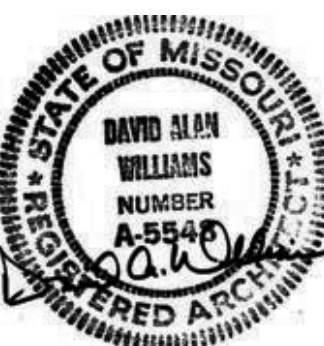ARCHITECT	FINKLE+WILLIAMS ARCHITECTURE
CIVIL	GBA
LANDSCAPE	HOERR SCHAUDT LAND
FOUNDATIONS	BSE STRUCTURAL ENGINEERS
STRUCTURAL	BSE STRUCTURAL ENGINEERS
PLUMBING	HENDERSON ENGINEERS
MECHANICAL	HENDERSON ENGINEERS
ELECTRICAL	HENDERSON ENGINEERS
FIRE PROTECTION	HENDERSON ENGINEERS
CONTRACTOR	FOGEL ANDERSON

FINKLE + WILLIAMS  
ARCHITECTURE



8787 RENNER BLVD., SUITE 100  
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SHEET T

ETA



SHEET NUMBER

## A7.02

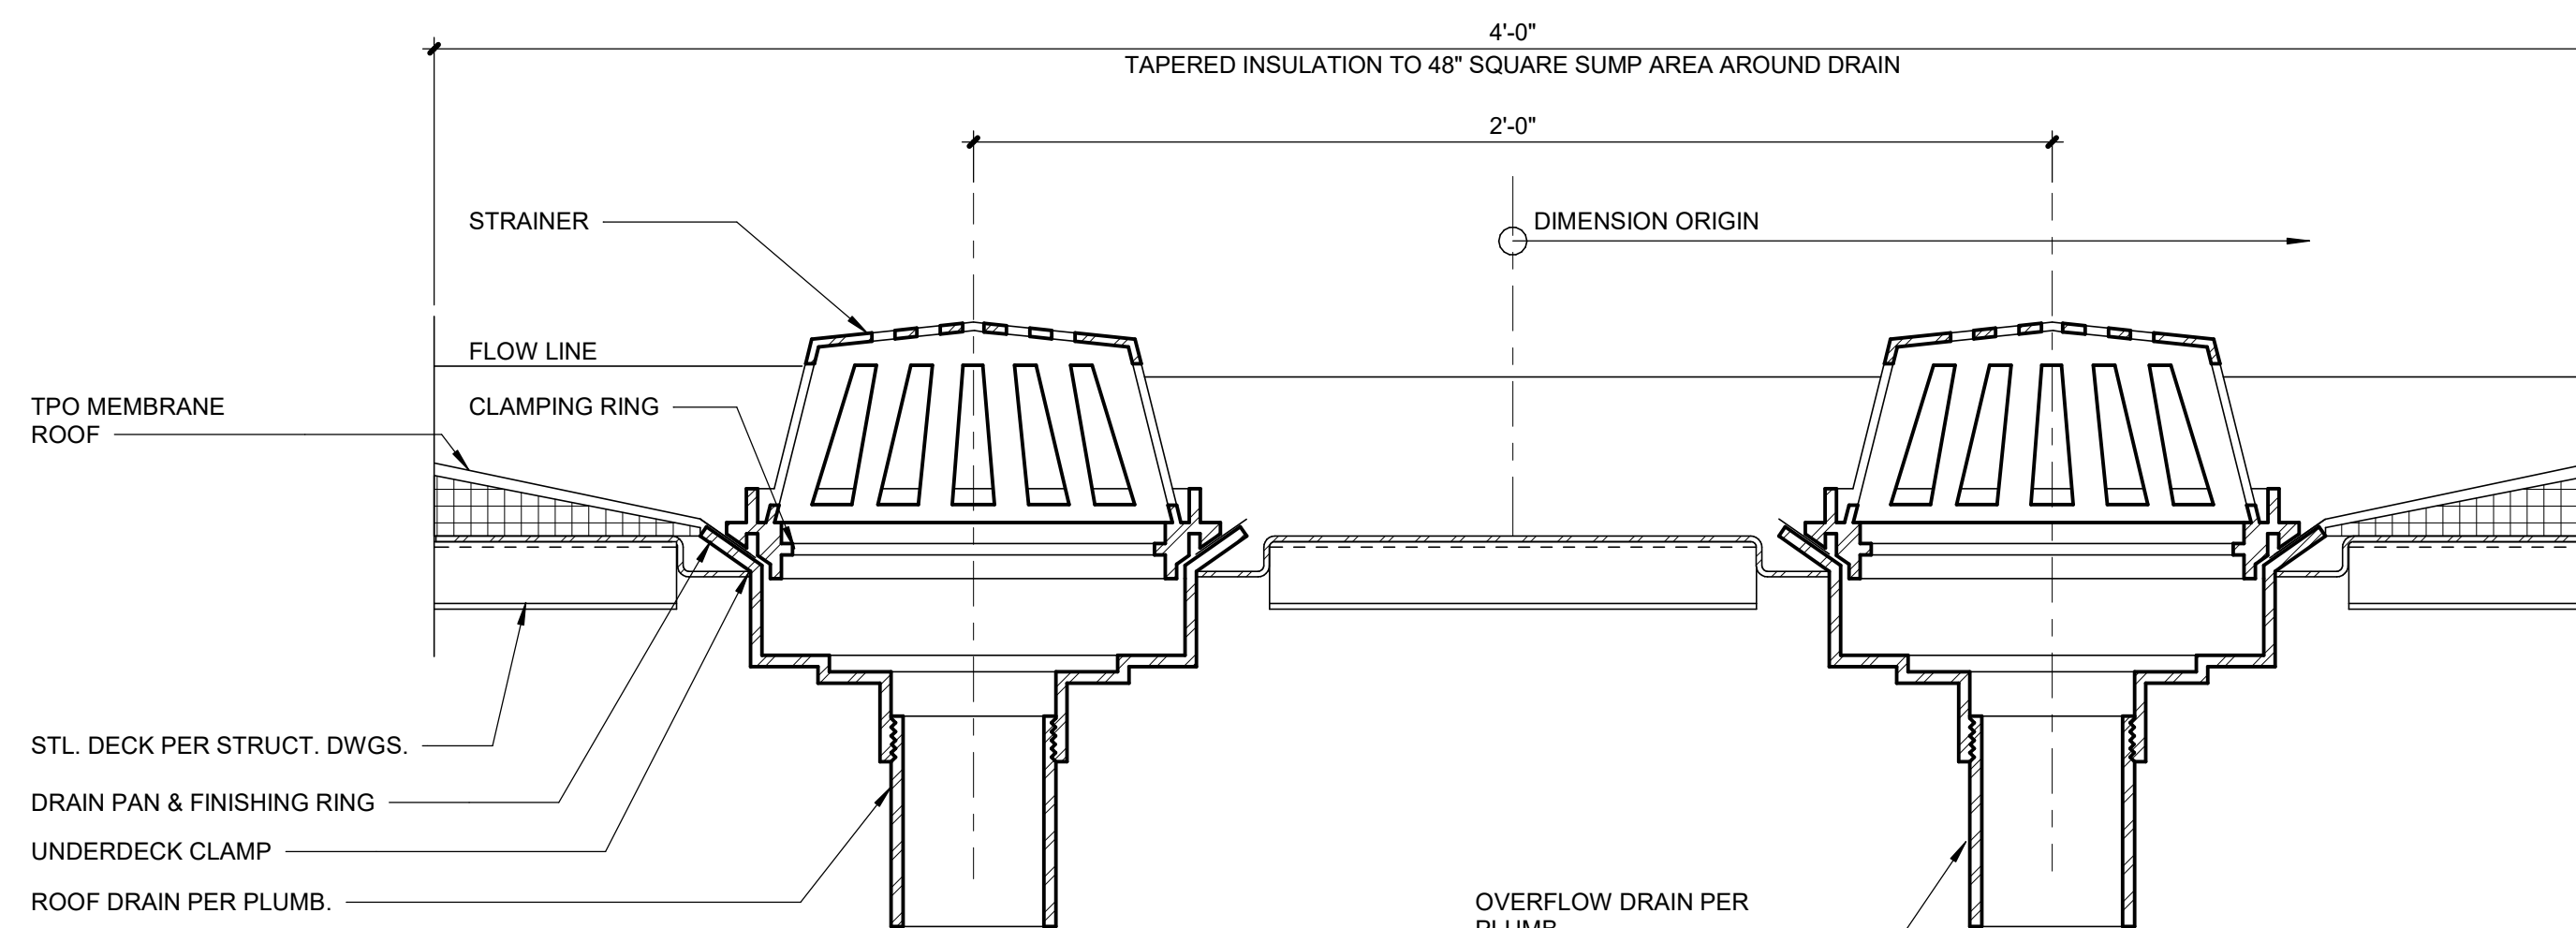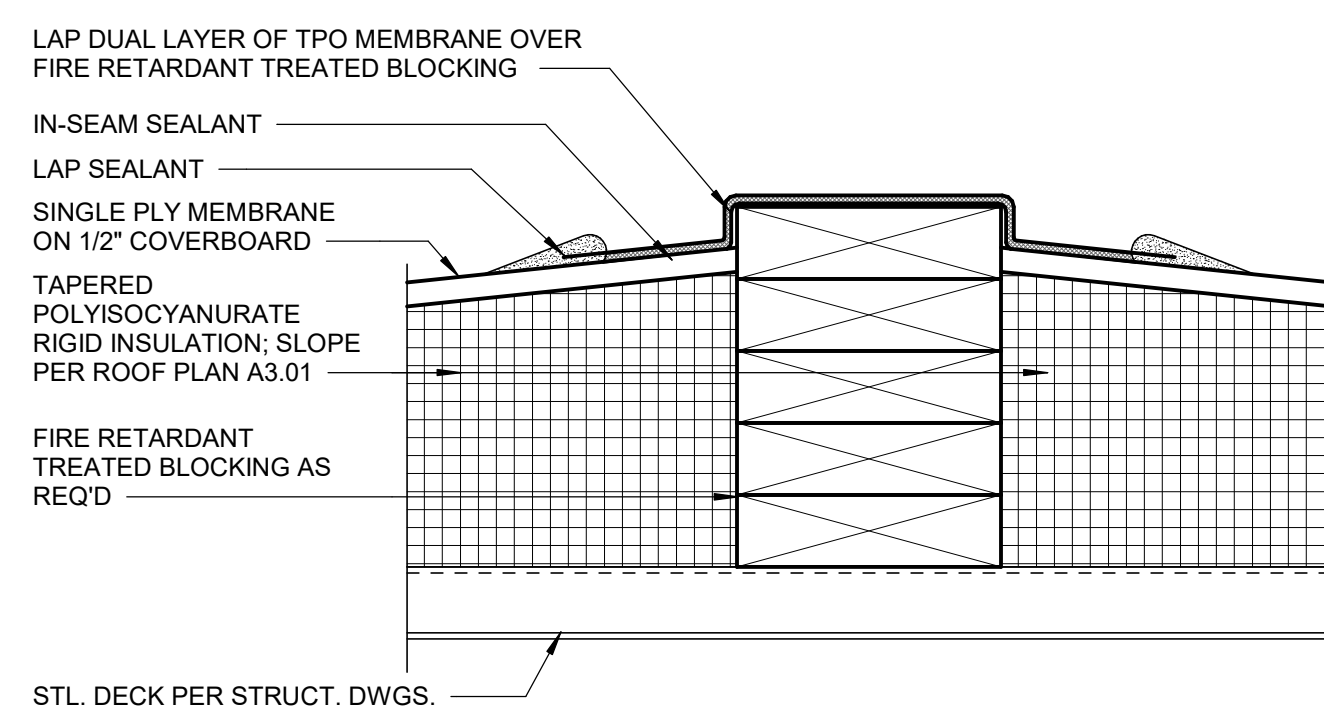


5	ROOF DETAIL
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<b>A7.02</b>	SCALE : 3" = 1'-0"
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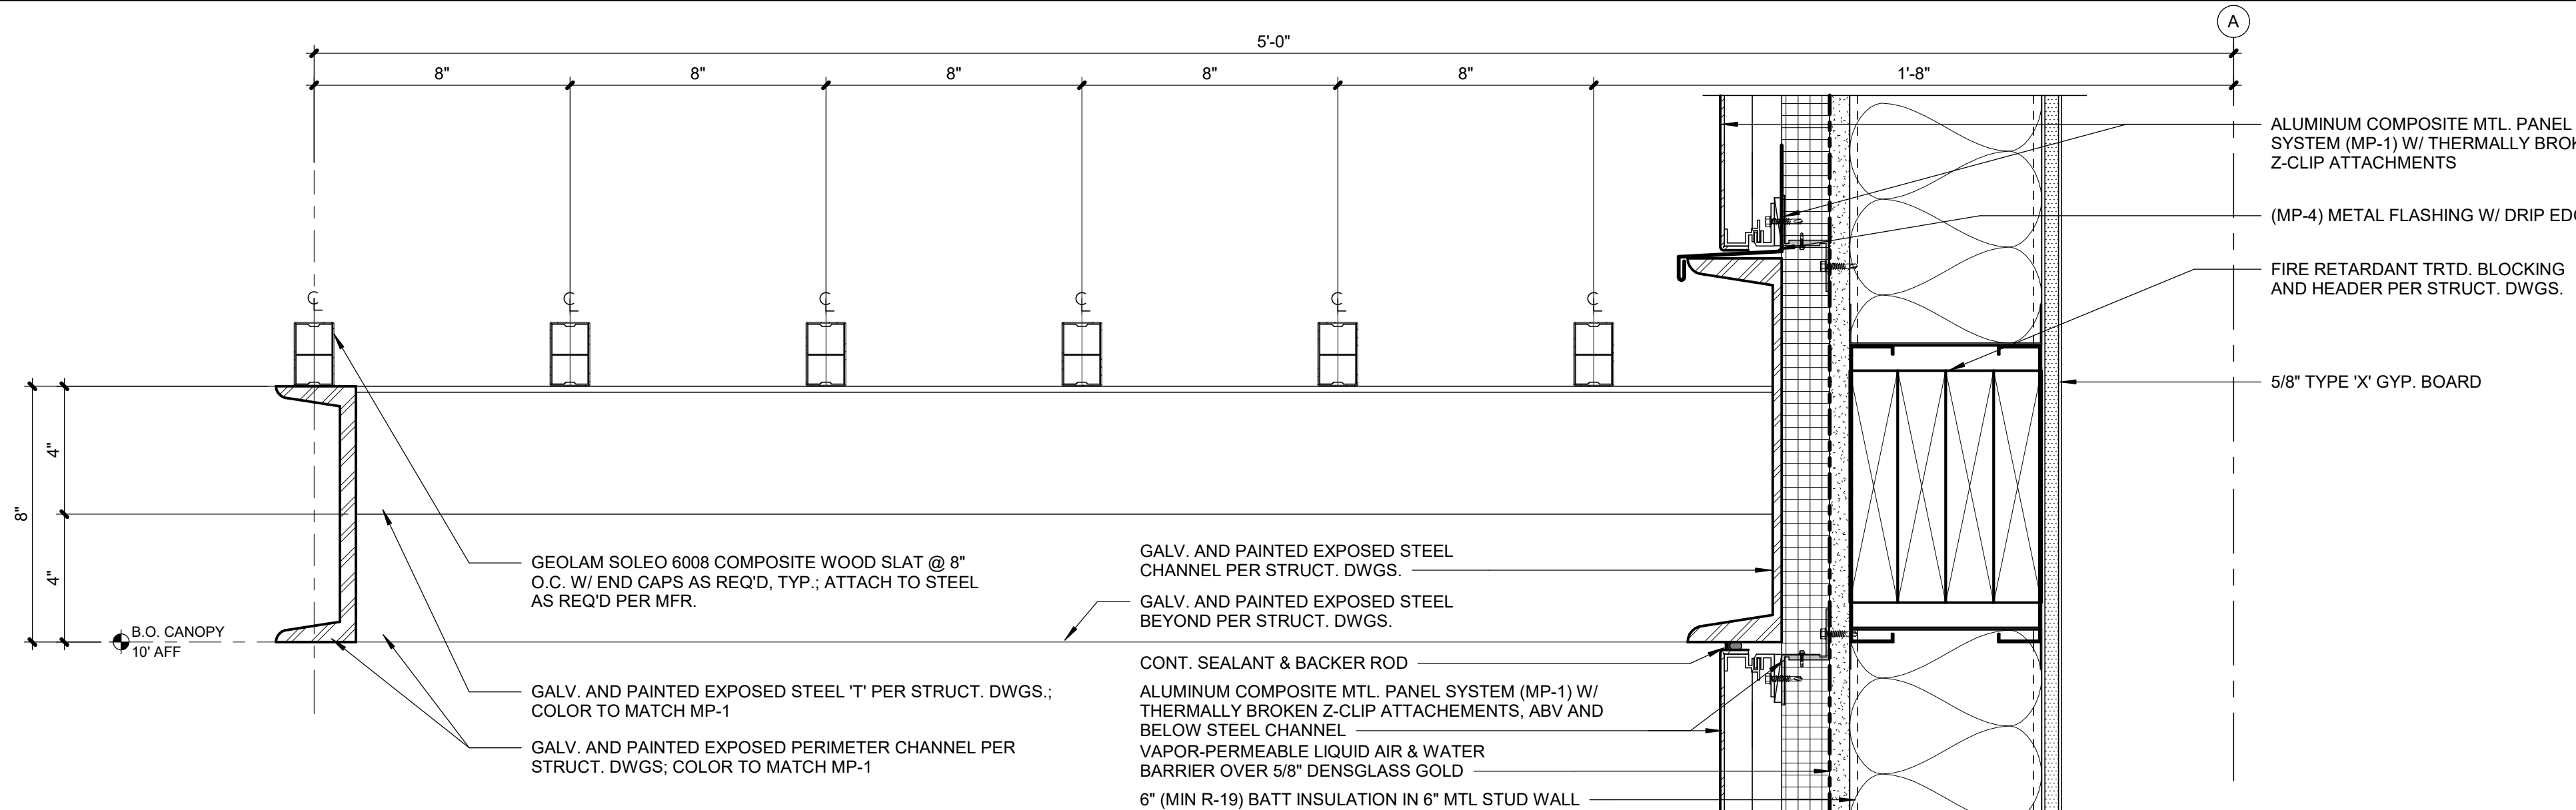
4	ROOF DRAIN DETAIL
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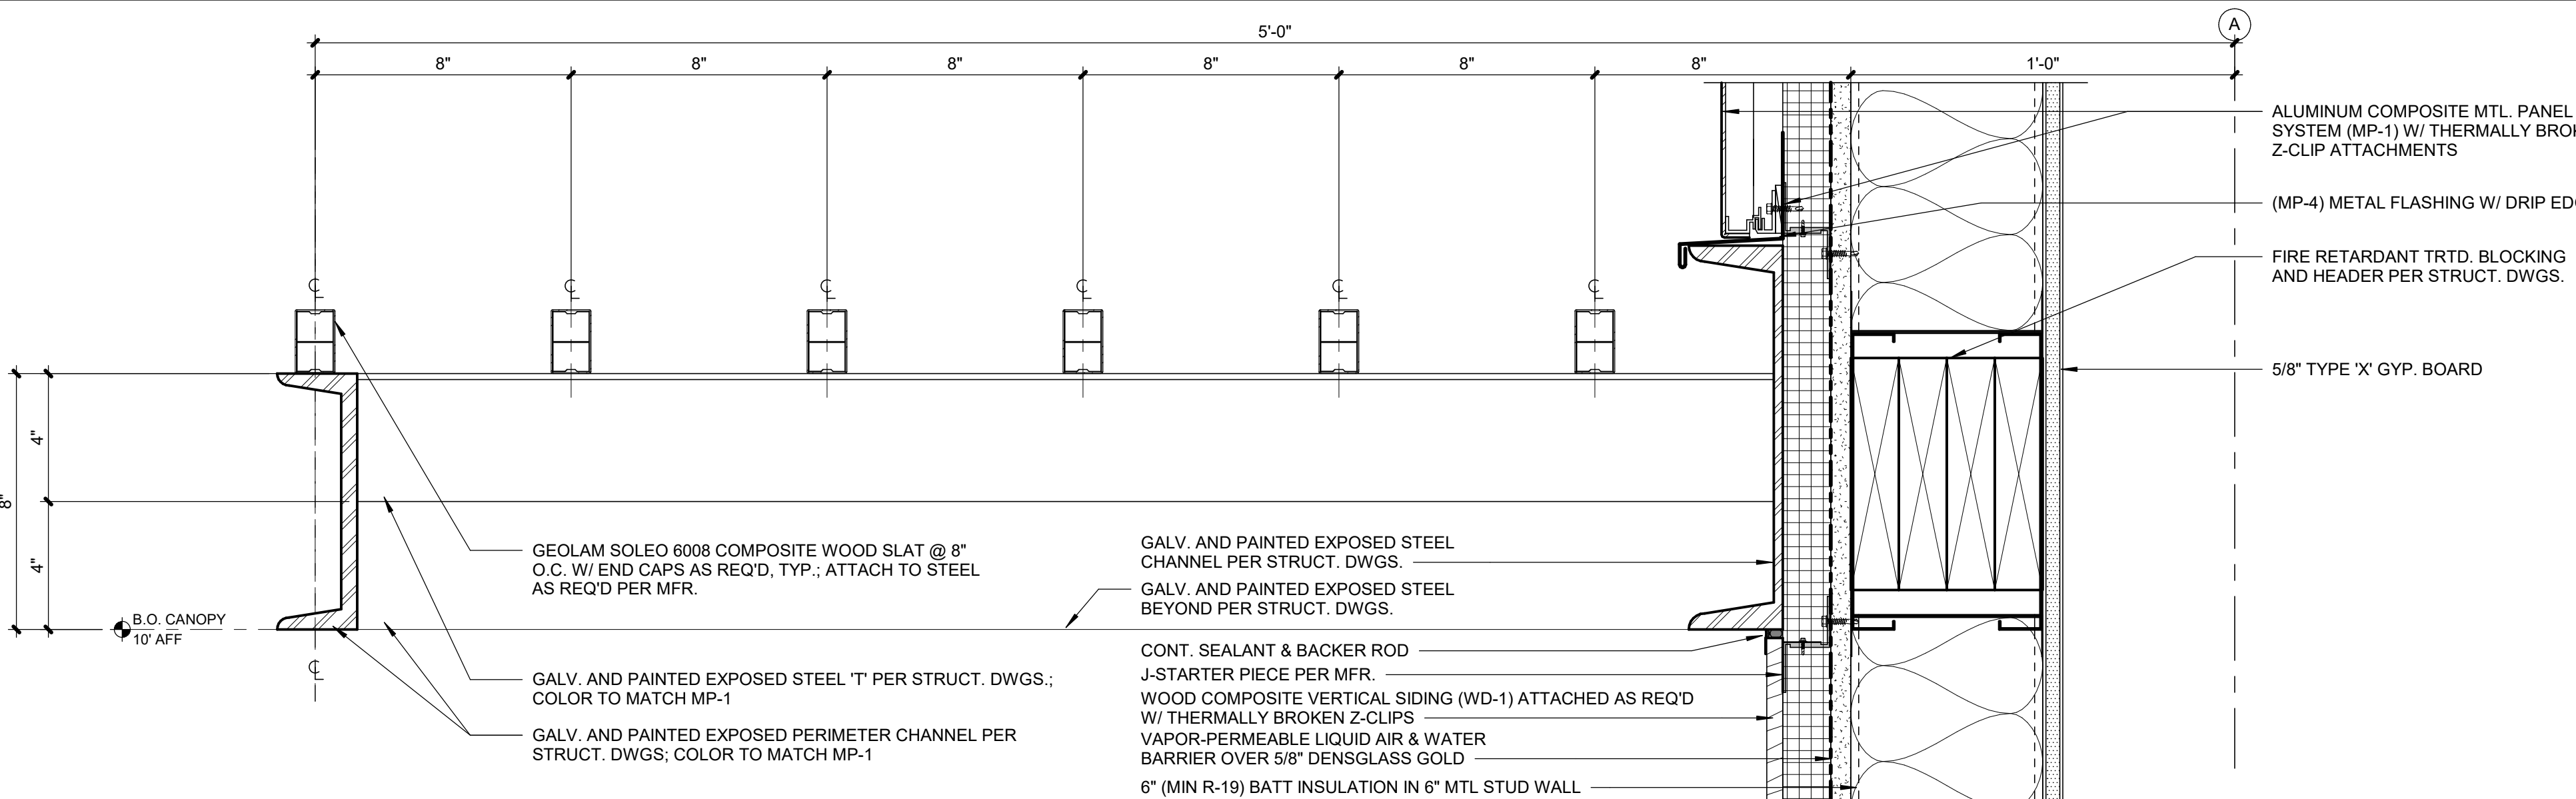
3	SHADE DETAIL
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<b>A7.02</b>	SCALE : 3" = 1'-0"
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2	SHADE DETAIL
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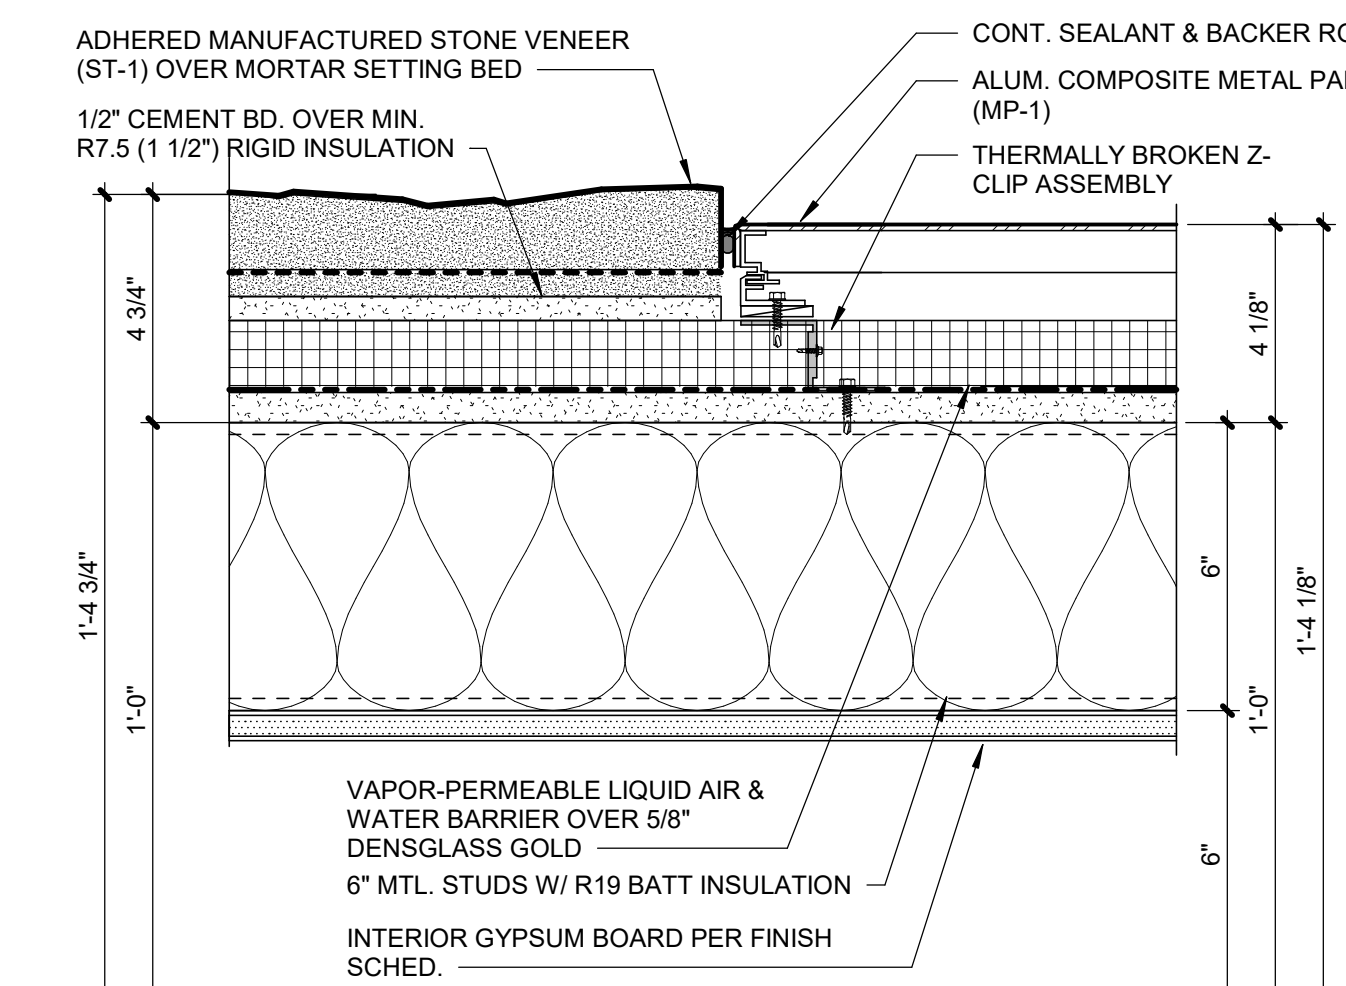


1	SHADE DETAIL
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<b>A7.02</b>	SCALE : 3" = 1'-0"
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9	ROOF DETAIL
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<b>A7.02</b>	SCALE : 3" = 1'-0"
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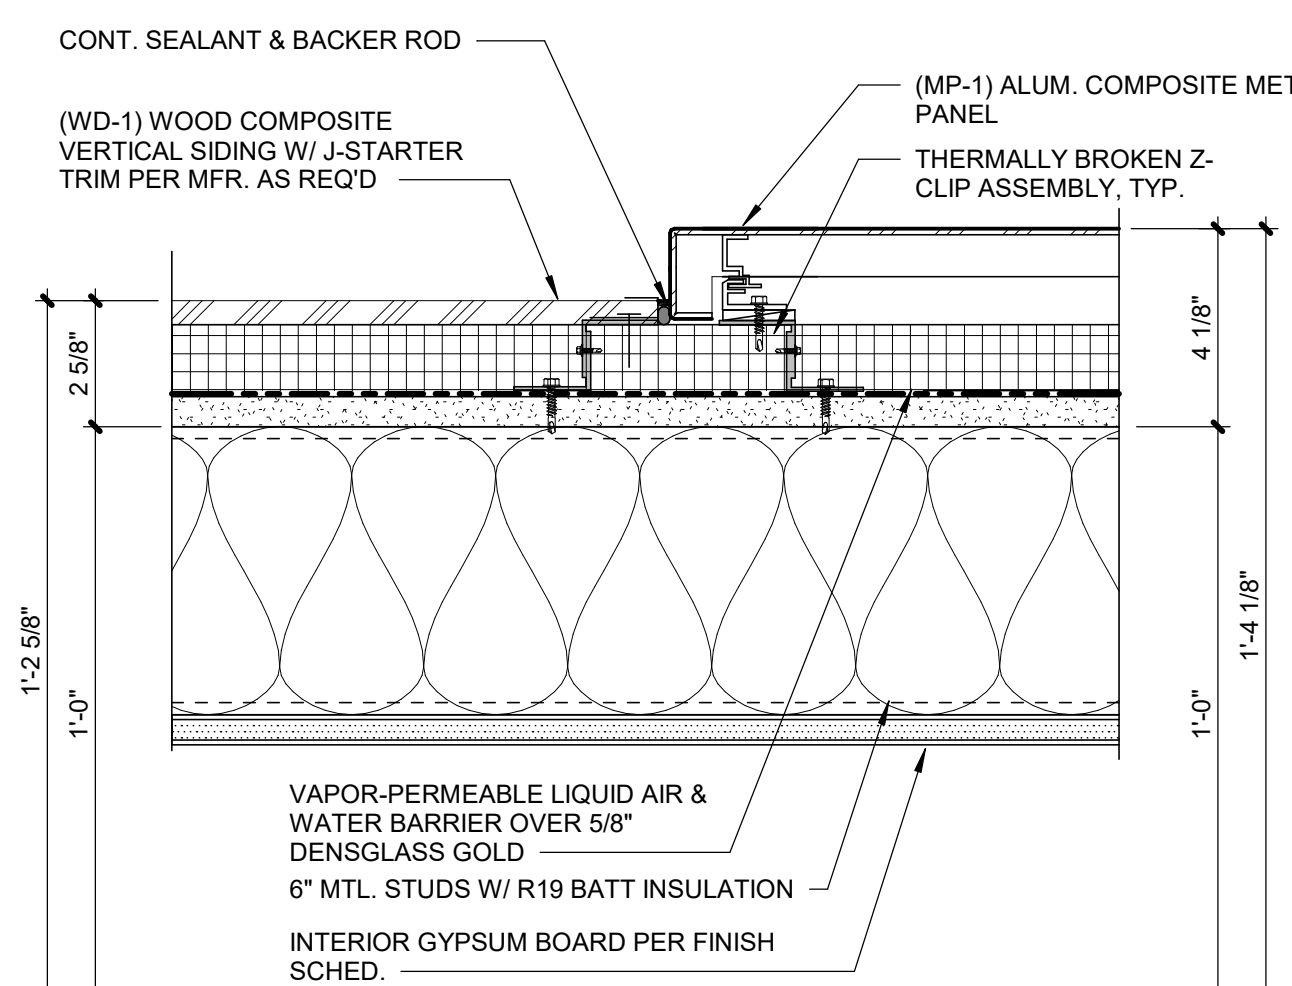


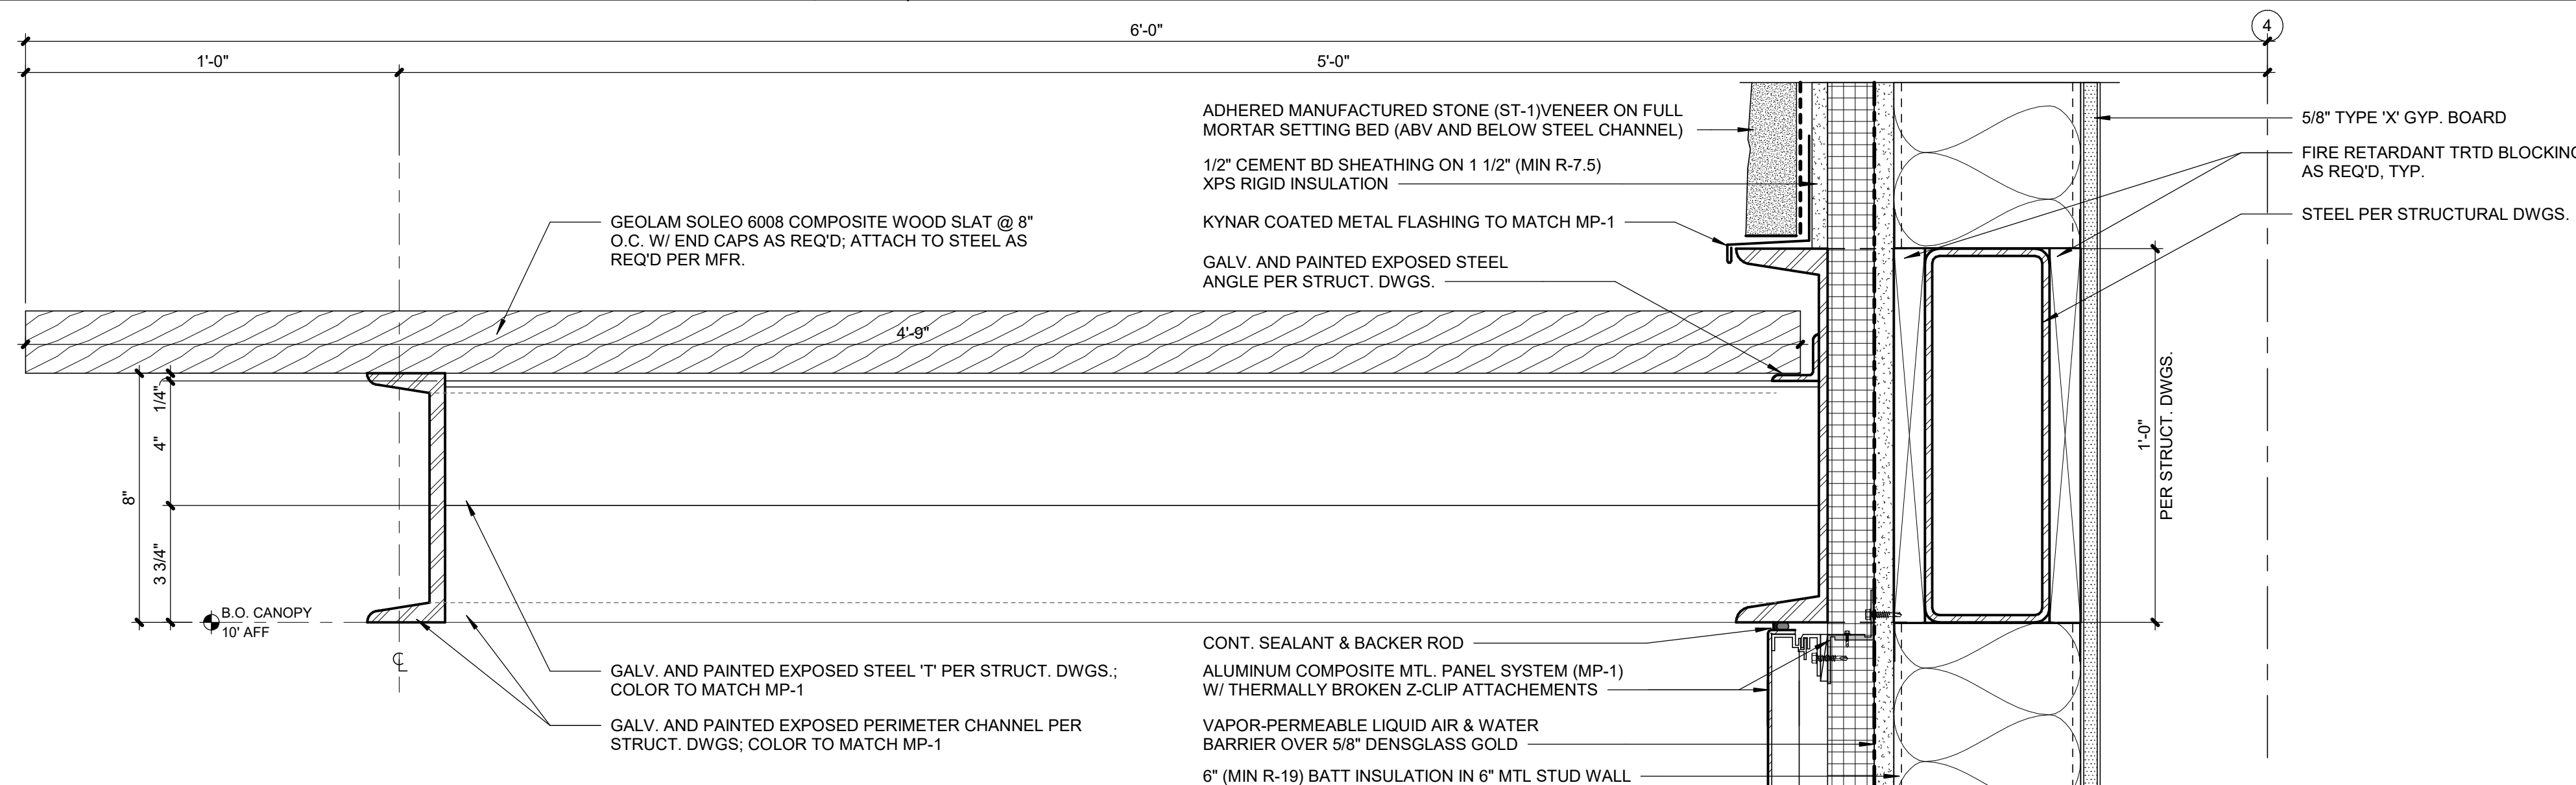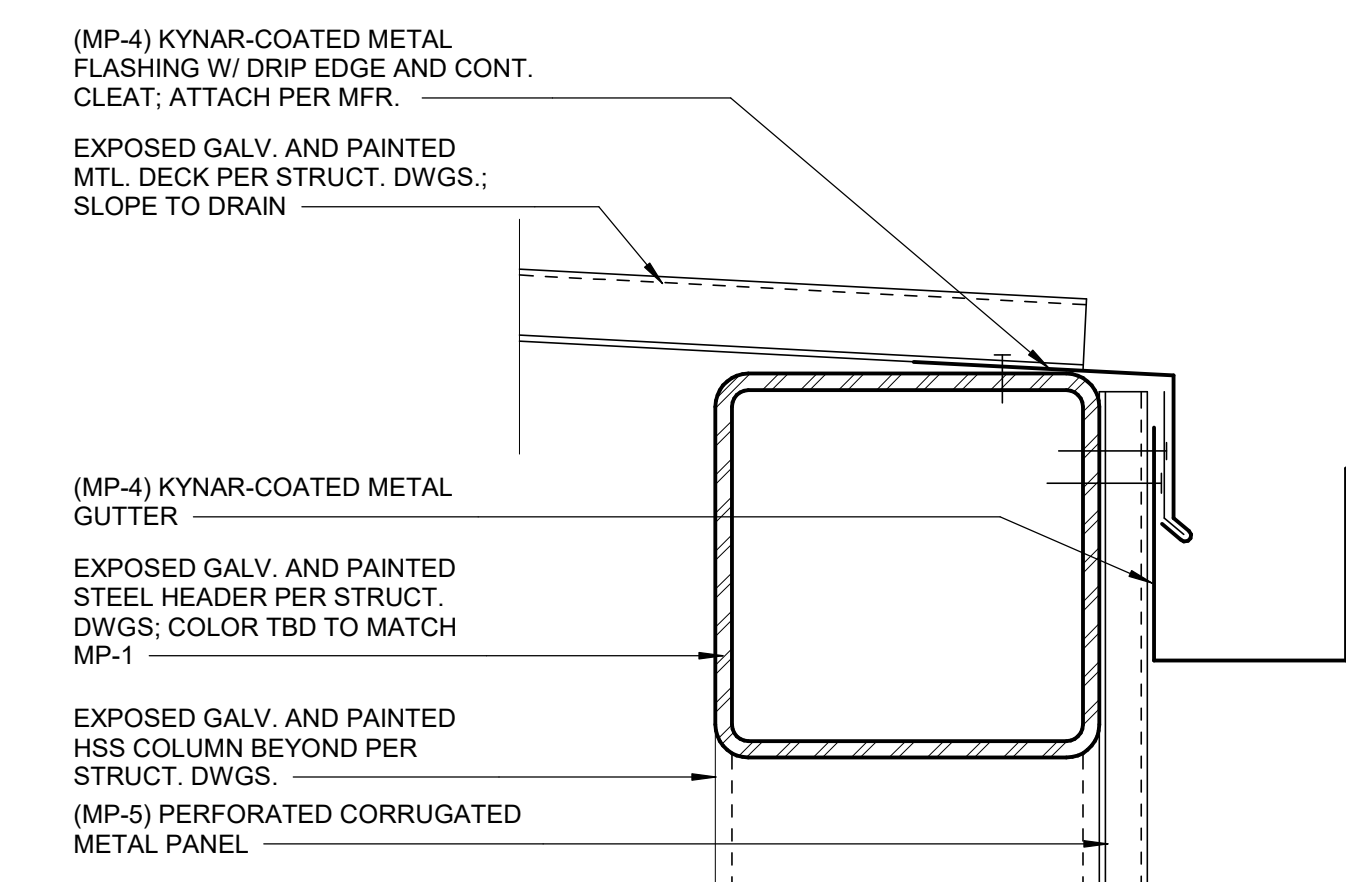1	SHADE DETAIL
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<b>A7.02</b>	SCALE : 3" = 1'-0"
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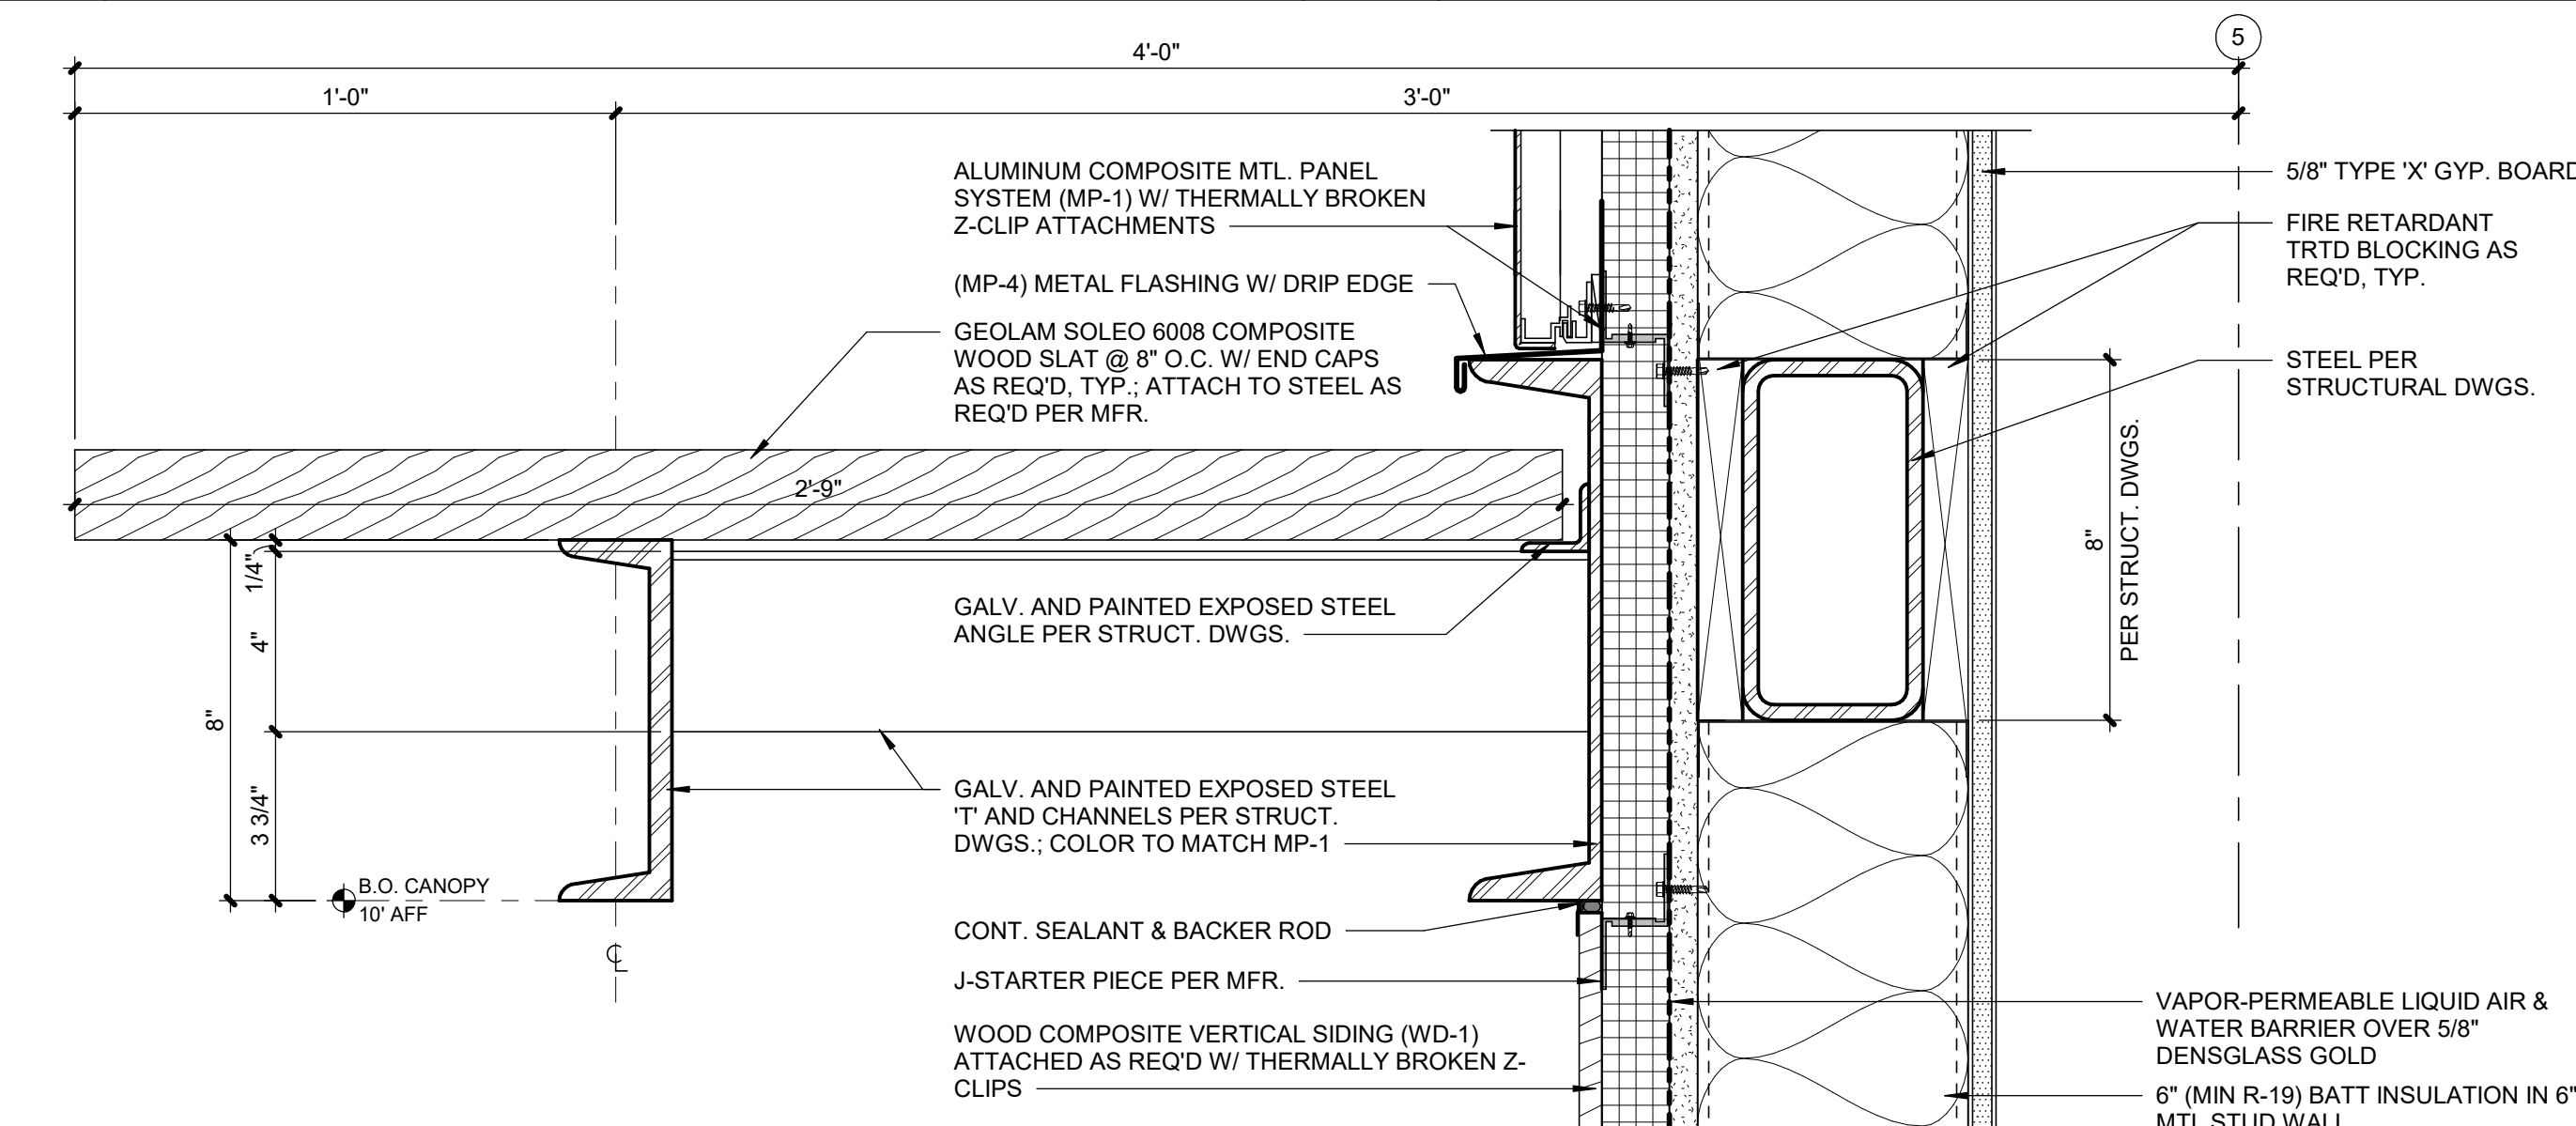
10	ROOF DETAIL
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<b>A7.02</b>	SCALE : 3" = 1'-0"
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8	TRANSITION DETAIL
---	-------------------

<b>A7.02</b>	SCALE : 3" = 1'-0"
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6	SHADE DETAIL
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<b>A7.02</b>	SCALE : 3" = 1'-0"
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## HARDWARE SETS

SEE SPECIFICATIONS FOR DETAILED HARDWARE INFORMATION.

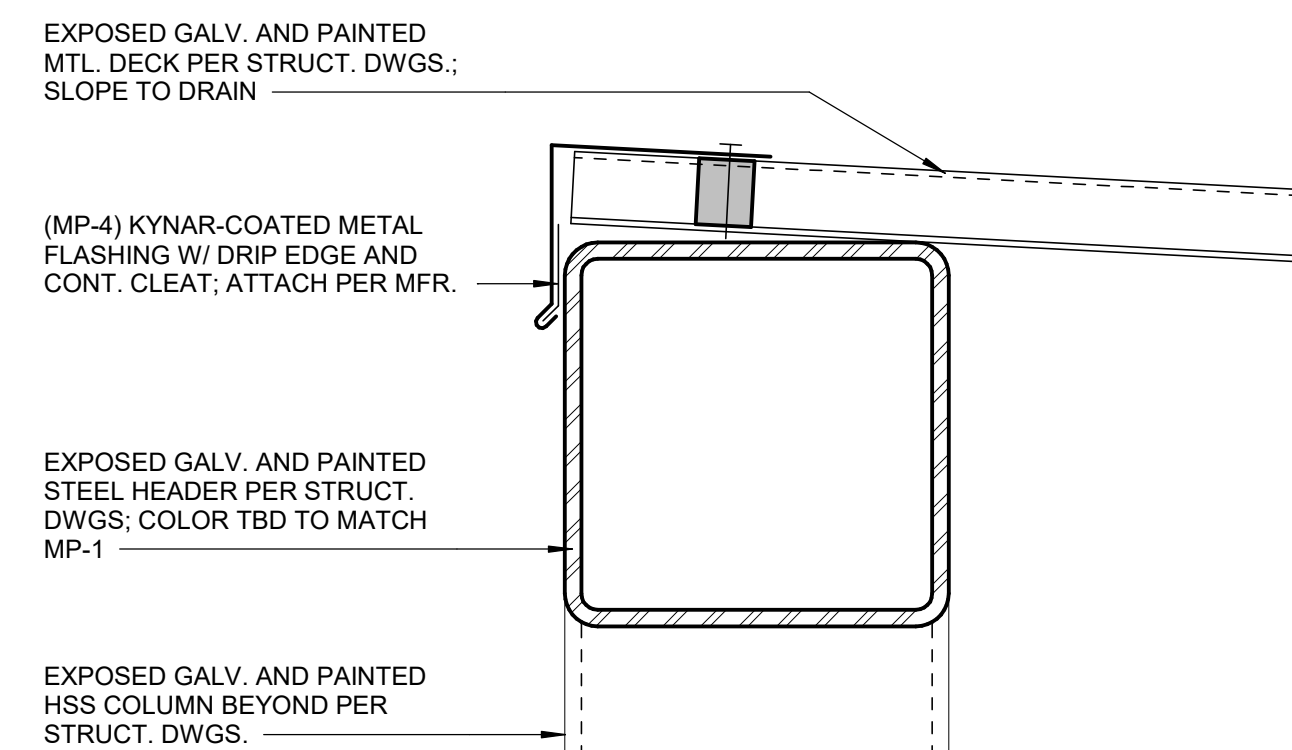**GENERAL NOTES:**

1. ALL HARDWARE SHALL COMPLY WITH APPLICABLE REQUIREMENTS OF THE AMERICANS WITH DISABILITIES ACT (ADA).
2. ALL DOOR HARDWARE SHALL BE FINISH US260 OR EQUIVALENT.
3. ALL LATCHSETS AND LOCKSETS SHALL BE EQUIPPED WITH LEVER TYPE OPERATING TRIM W/ THE "CLUTCH" FEATURE.
4. ALL CLOSERS SHALL BE LOCATED ON ROOM SIDES OF DOORS.
5. CONTRACTOR'S HARDWARE CONSULTANT SHALL BE RESPONSIBLE FOR DETERMINING APPROPRIATE HARDWARE FUNCTION AND OPTIONS.
6. CONTRACTOR SHALL COORDINATE FINAL KEYING WITH OWNER.

**(LK) INTERIOR LOCKSETS**

- SET # LK.1** (INTERIOR SINGLE W/ LOCK)
- HINGES
  - LOCKSET
  - WALL STOP
  - SILENCERS
- SET # LK.2** (INTERIOR SINGLE W/ LOCK & CLOSER)
- HINGES
  - LOCKSET
  - CLOSER
  - WALL STOP
  - SILENCERS

**(EL) EXTERIOR LOCKSETS**

- ```

SET #E L 1 (EXTERIOR SINGLE W/ LOCK)
* HINGES
* LOCKSET
* CLOSER
* THRESHOLD
* WEATHERSTRIP
* BOTTOM SWEEP
* DRIP CAP
* LATCH GUARD
* STORM CHAIN

SET #E L 3 (EXTERIOR PAIR W/ LOCK, CLOSERS, & AUTO FLUSHBITS)
* HINGES
* LOCKSET
* FLUSHBOLTS
* ASTRAGAL
* CLOSERS
* COORDINATOR
* THRESHOLD
* WEATHERSTRIP
* BOTTOM SWEEP
* DRIP CAP
* LATCH GUARD
* STORM CHAIN




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(AL) ALUMINUM DOORS

- SET # AL1** (EXTERIOR SINGLE ALUMINUM)
- HINGES (CONT. HEAVY DUTY)
  - CLOSER
  - PULL
  - EXIT DEVICE
  - THRESHOLD
  - WEATHERSTRIP
  - BOTTOM SWEEP
  -



## DOOR TYPES

ALL HOLLOW METAL DOORS TO BE FACTORY PRIMED. PAINT TO BE SPRAYED

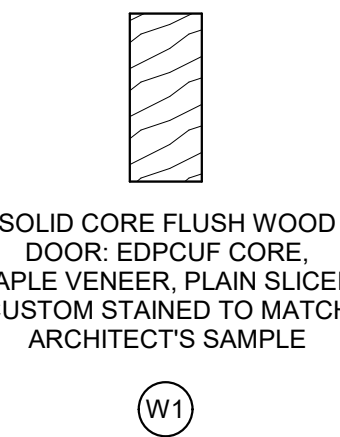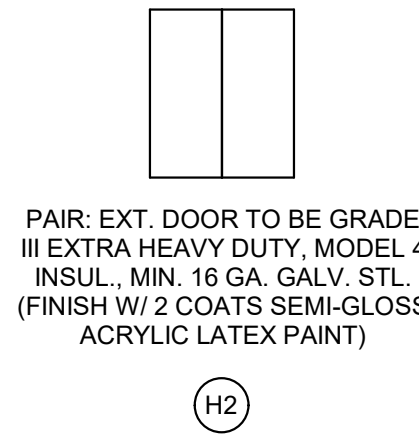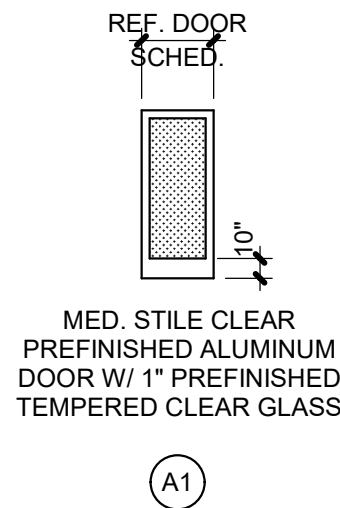

## FRAME TYPES

ALL HOLLOW METAL FRAMES TO BE FACTORY PRIMED. PAINT TO BE SPRAYED

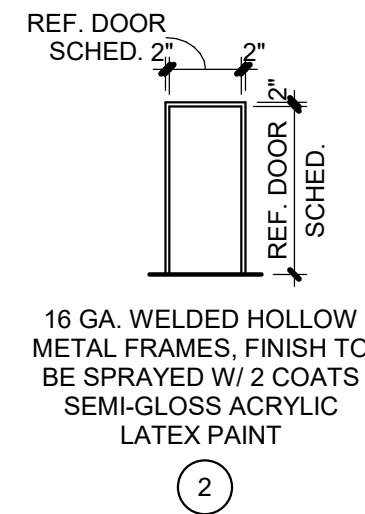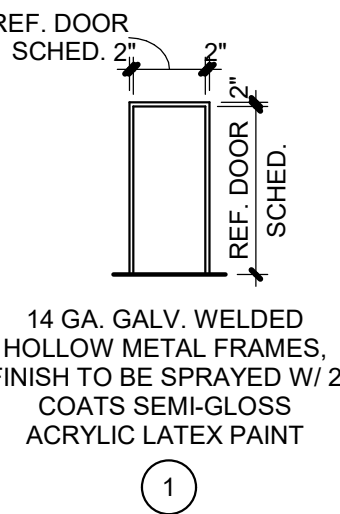


**DOOR AND FRAME SCHEDULE**

| NO.  | DOOR  |       |        |      | FRAME |      | RATING | DETAILS |                 |          | HARDWARE | REMARKS |      |
|------|-------|-------|--------|------|-------|------|--------|---------|-----------------|----------|----------|---------|------|
|      | SIZE  |       |        | TYPE | MAT.  | TYPE |        | MAT.    | JAMB            | HEAD     |          |         | SILL |
|      | W.    | H.    | Th     |      |       |      |        |         |                 |          |          |         |      |
| 100A | 3'-0" | 8'-0" | 1 3/4" | A1   | AL    | -    | AL     | -       | 9 & 10/A8.02    | 11/A8.02 | 17/A8.02 | AL.1    | (1)  |
| 102A | 3'-0" | 8'-0" | 1 3/4" | H1   | HM    | 1    | HM     | -       | 13.14, 15/A8.02 | 16/A8.02 | 17/A8.02 | EL.1    |      |
| 103A | 3'-0" | 8'-0" | 1 3/4" | H1   | HM    | 1    | HM     | -       | 13 & 14/A8.02   | 16/A8.02 | 17/A8.02 | EL.1    |      |
| 104A | 3'-0" | 7'-0" | 1 3/4" | W1   | WD    | 2    | HM     | -       | 18/A8.02        | 19/A8.02 | -        | LK.2    |      |
| 106A | 3'-0" | 7'-0" | 1 3/4" | W1   | WD    | 2    | HM     | -       | 18/A8.02        | 19/A8.02 | -        | LK.1    |      |
| 107A | 6'-4" | 8'-0" | 1 3/4" | H2   | HM    | 1    | HM     | -       | 13.14, 15/A8.02 | 16/A8.02 | 17/A8.02 | EL.3    | (1)  |
| 108A | 3'-0" | 7'-0" | 1 3/4" | W1   | WD    | 2    | HM     | -       | 18/A8.02        | 19/A8.02 | -        | LK.2    |      |

## REMARKS

- (1) ACCESS CONTROL DOORS WITH PANIC HARDWARE: PROVIDE APPROVED ENTRANCE AND EGRESS ACCESS CONTROL SYSTEM, LISTED IN ACCORDANCE WITH UL 294 AND INSTALLED IN COMPLIANCE WITH CRITERIA 1 THROUGH 8 IN SECTION 1010.1.9.7 OF IBC 2018; REF SECURITY DWGS. AND SPECS.

## DOOR LOCATION PLAN

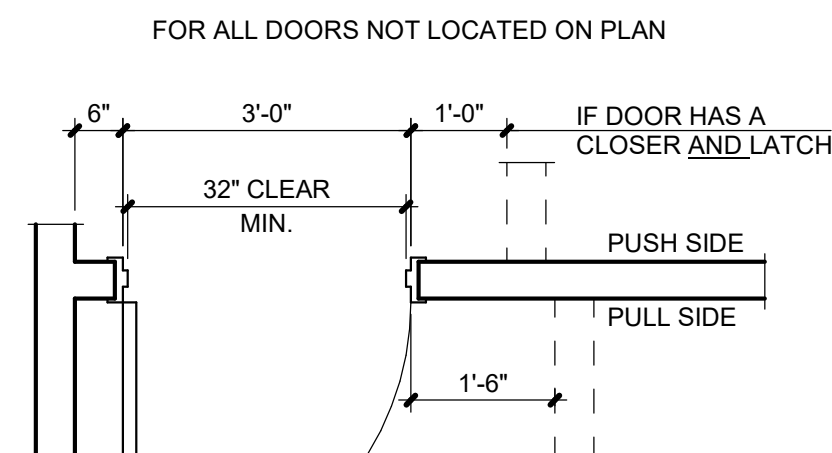

## MATERIAL LEGEND

- |      |   |                  |
|------|---|------------------|
| GL   | - | GLASS            |
| HM   | - | HOLLOW METAL     |
| WD   | - | WOOD             |
| STL  | - | STEEL            |
| AL   | - | ALUMINUM         |
| MFR  | - | PER MANUFACTURER |
| POLY | - | POLYETHYLENE     |
| P    | - | POLYCARBONATE    |

LOT 20 - HUB  
BUILDING

2151 NW PARAGON PKWY  
LEE'S SUMMIT, MO 64081

Project No.: 19050.02

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## REVISIONS

[illegible]

## REGISTRATION



## PROJECT TEAM

|                 |                                  |
|-----------------|----------------------------------|
| ARCHITECT       | FINKLE- WILLIAMS<br>ARCHITECTURE |
| CIVIL           | GBA                              |
| LANDSCAPE       | HOERR SCHAUDT<br>LAND3           |
| FOUNDATIONS     | BSE STRUCTURAL<br>ENGINEERS      |
| STRUCTURAL      | BSE STRUCTURAL<br>ENGINEERS      |
| PLUMBING        | HENDERSON<br>ENGINEERS           |
| MECHANICAL      | HENDERSON<br>ENGINEERS           |
| ELECTRICAL      | HENDERSON<br>ENGINEERS           |
| FIRE PROTECTION | HENDERSON<br>ENGINEERS           |
| CONTRACTOR      | FOGEL ANDERSON                   |

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## SHEET TITLE

## DOOR SCHEDULE AND DETAILS

## SHEET NUMBER

# A8.01
















|       |              |
|-------|--------------|
| A9.01 | 1/8" = 1'-0" |
|-------|--------------|

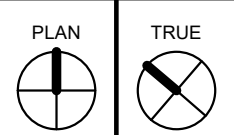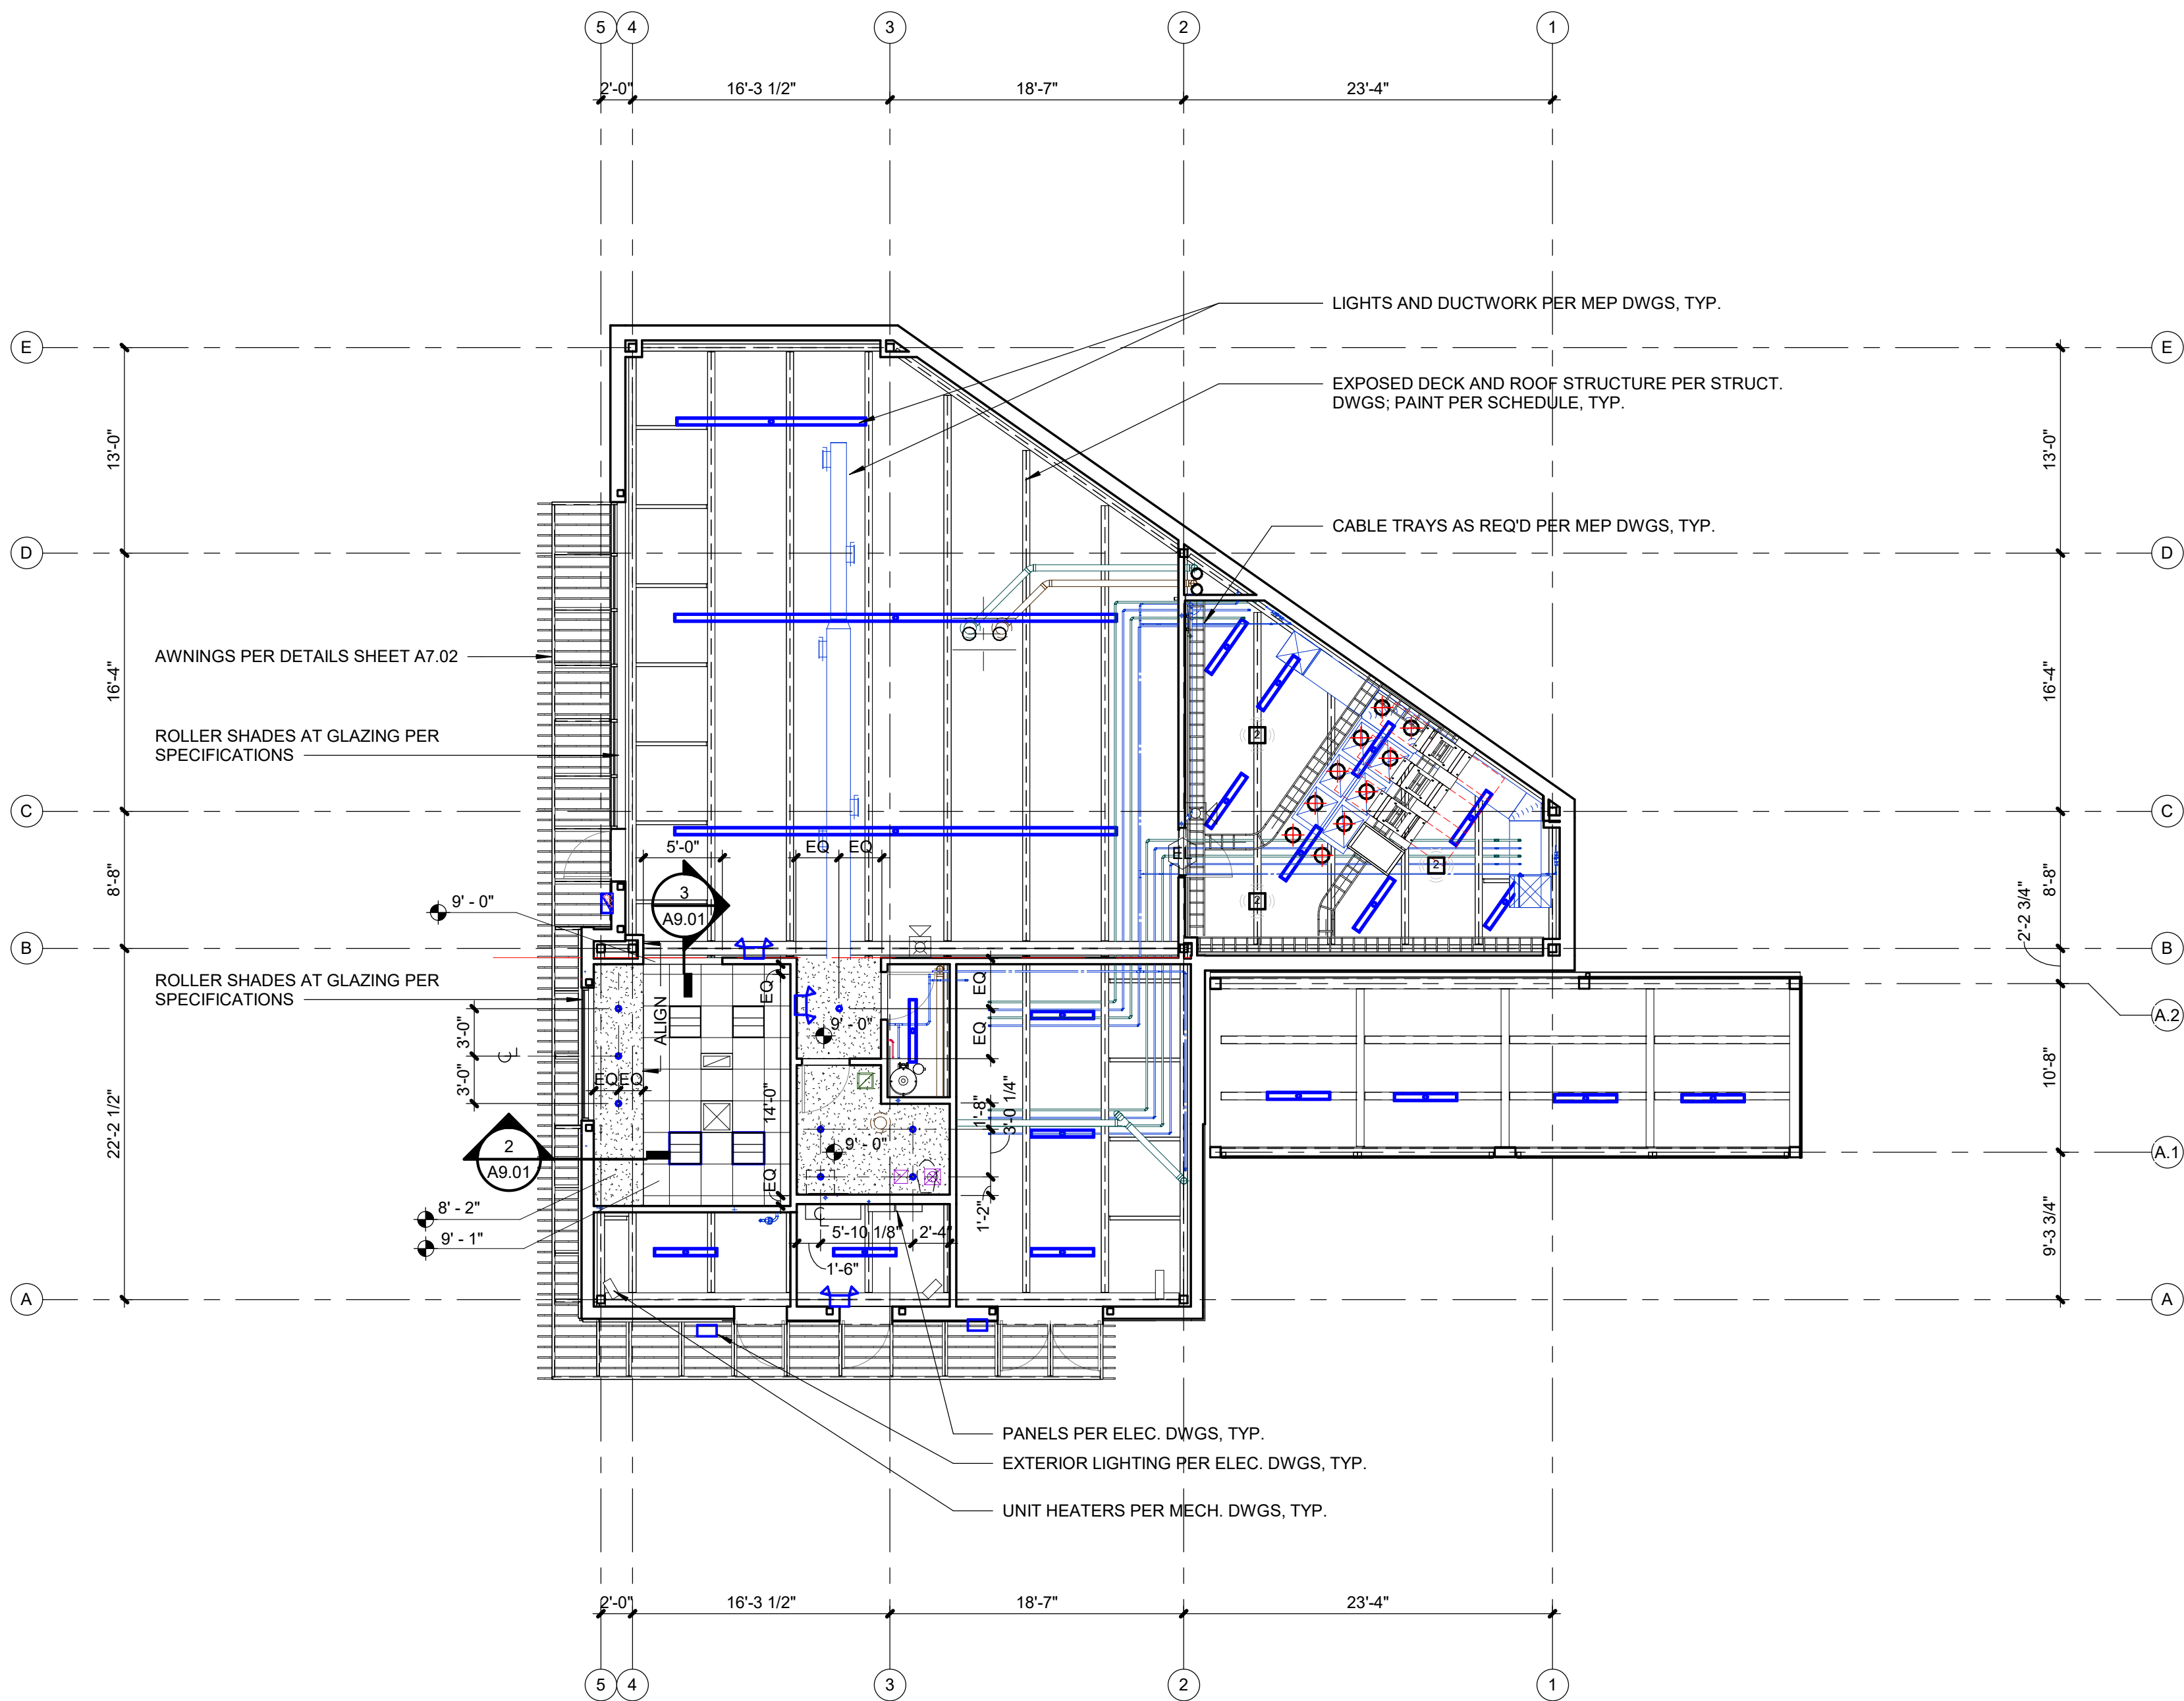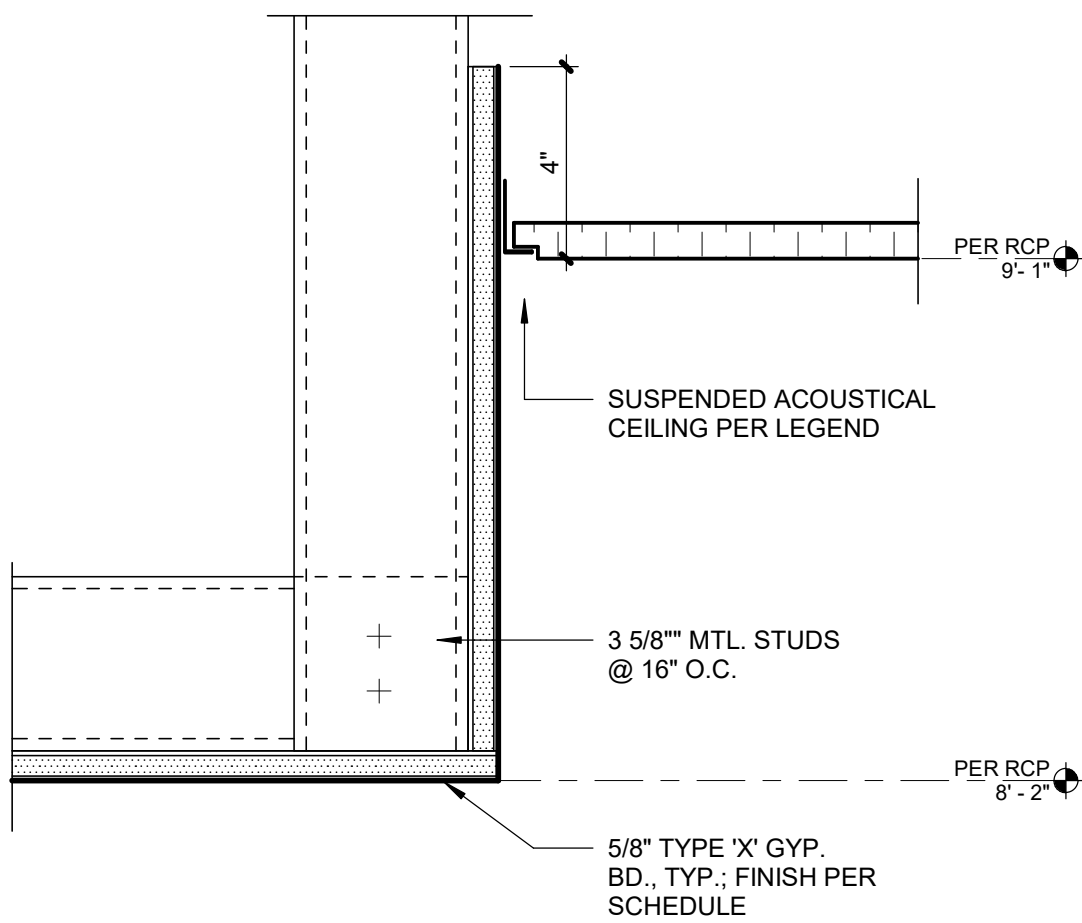



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Project No.: 19050.02

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## PROJECT TEAM

ARCHITECT FINKLE+WILLIAMS  
ARCHITECTURE

CIVIL

LANDSCAPE HOERR SCHAUDT  
LAND3

FOUNDATIONS      BSE STRUCTURAL  
ENGINEERS

ENGINEERS

ENGINEERS

ELECTRICAL HENDERSON

FIRE PROTECTION HENDERSON

CONTRACTOR      FOGEL ANDERSON

---

PINKEL + WILLIAMS  
ARCHITECTUR

LENEXA, KANSAS 66219  
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## SPECIFICATIONS

A 11 10

## APPENDIX



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