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RENDERINGS FOR CONCEPTUAL REFERENCE ONLY. IMAGE MAY NOT REFLECT LATEST DESIGN. REFERENCE ELEVATIONS AND SCHEDULES FOR FINISHES.



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PROJECT TEAM

**ARCHITECT**  
FINKLE + WILLIAMS ARCHITECTURE  
7007 College Blvd., Suite 415  
Overland Park, Kansas 66210  
PH: 913.498.1550 F: 913.498.1042

**CIVIL**  
GBA  
9801 Renner Blvd., Suite 300  
Lenexa, Kansas 66219  
PH: 913.577.8341

**LANDSCAPE**  
HOERR SCHAUJDT / LAND3  
2100 Central St., Suite 01C  
Kansas City, Missouri 64108  
PH: 312.492.6501

**FOUNDATIONS**  
BSE STRUCTURAL ENGINEERS  
11320 West 79th St.  
Lenexa, Kansas 66214  
PH: 913.492.7400

**STRUCTURAL**  
BSE STRUCTURAL ENGINEERS  
11320 West 79th St.  
Lenexa, Kansas 66214  
PH: 913.492.7400

**CONTRACTOR**  
FOGEL ANDERSON  
1212 E. 8th St.  
Kansas City, Missouri 64106  
PH: 816.842.6914

**MECHANICAL**  
HENDERSON ENGINEERS  
8345 Lenexa Dr., Suite 300  
Lenexa, Kansas 66214  
PH: 913.742.5000

**PLUMBING**  
HENDERSON ENGINEERS  
8345 Lenexa Dr., Suite 300  
Lenexa, Kansas 66214  
PH: 913.742.5000

**ELECTRICAL**  
HENDERSON ENGINEERS  
8345 Lenexa Dr., Suite 300  
Lenexa, Kansas 66214  
PH: 913.742.5000

**FIRE PROTECTION**  
HENDERSON ENGINEERS  
8345 Lenexa Dr., Suite 300  
Lenexa, Kansas 66214  
PH: 913.742.5000



FINKLE + WILLIAMS  
ARCHITECTURE

PROJECT ADDRESS  
PARAGON STAR  
FIRST PLAT, LOT 9  
LEE'S SUMMIT, MO

PROJECT NUMBER  
19050.01

RELEASE DATE  
10.25.19

ISSUED FOR  
SHELL - CD SET

PARAGON STAR - LOT 9 - BUILDING 2



Call (800) 451-1000 for more information. [www.ellonfoster.com](http://www.ellonfoster.com)














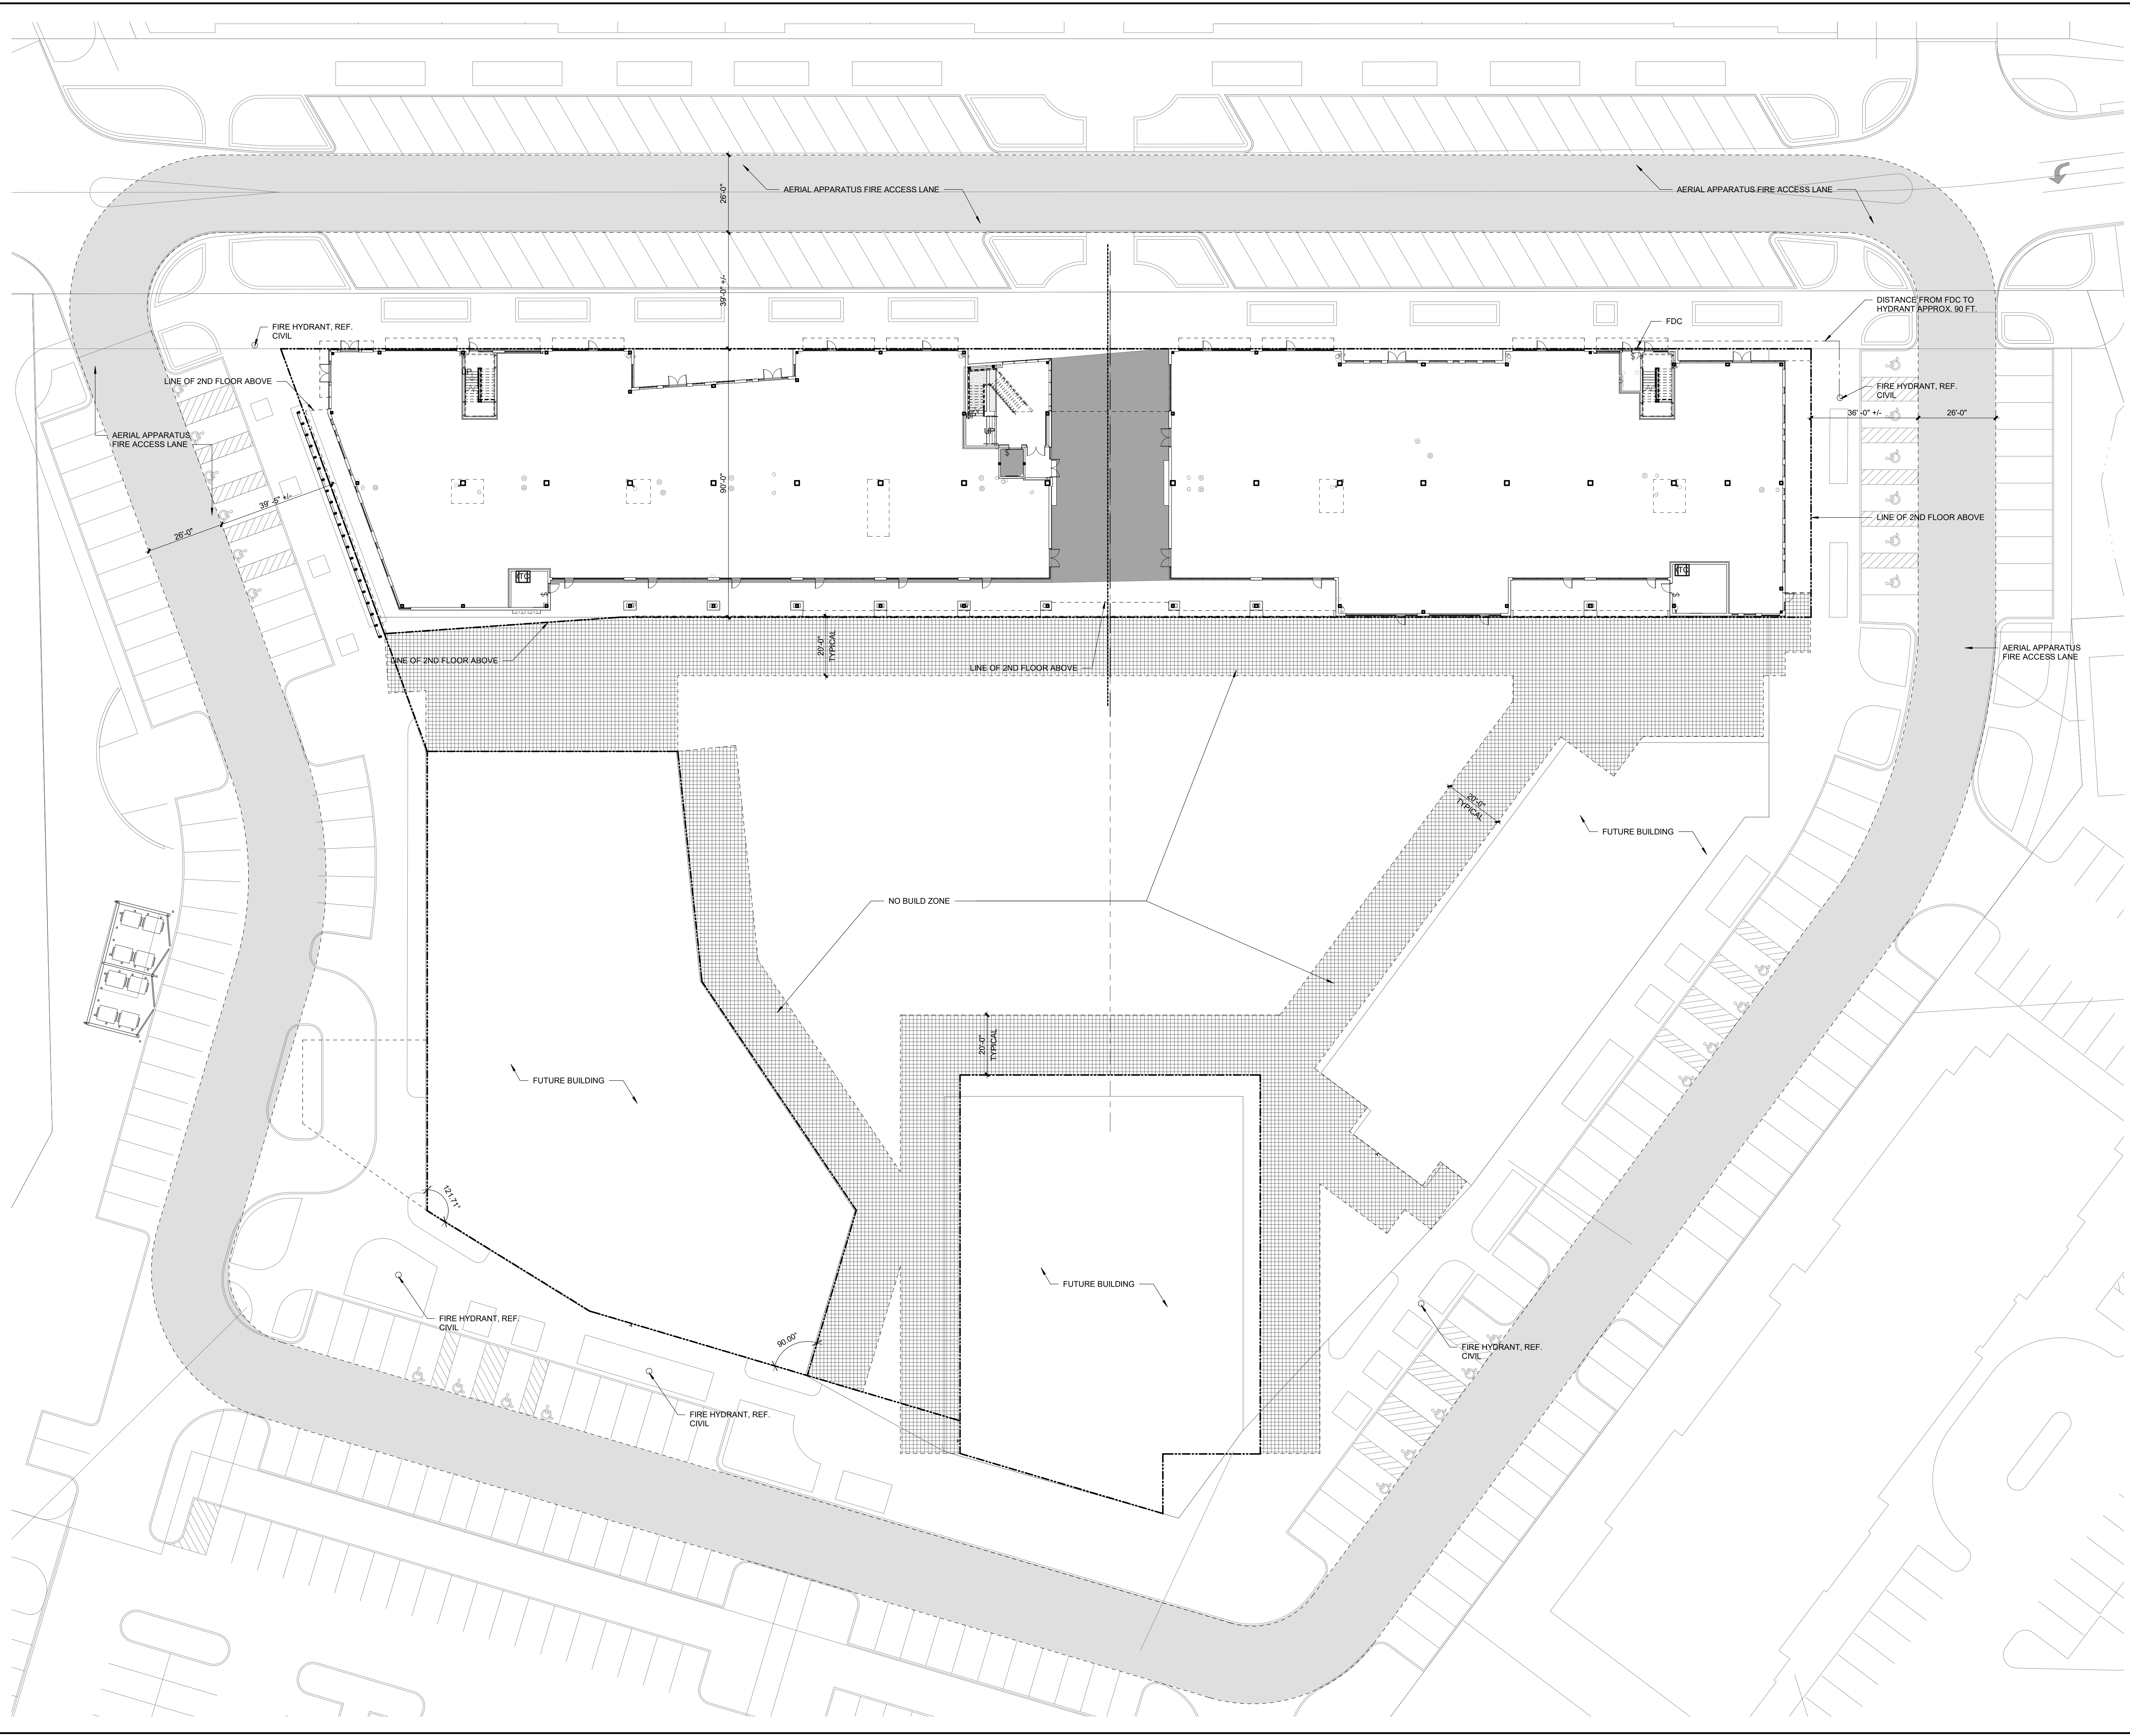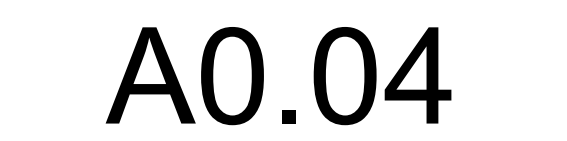







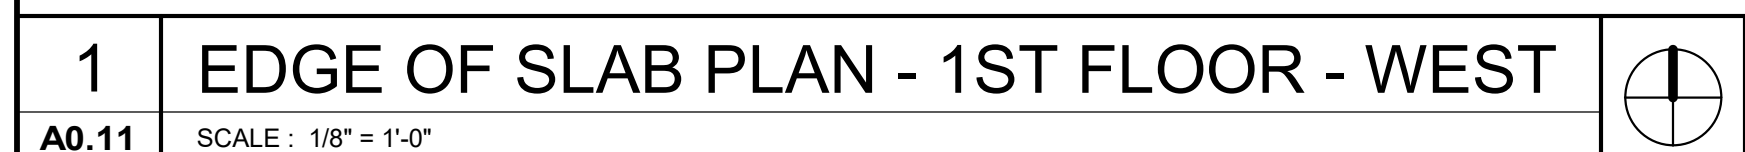



PARAGON STAR  
- LOT 9 -  
BUILDING 2

PARAGON STAR  
FIRST PLAT, LOT 9  
LEE'S SUMMIT, MO

Project No.: 19050.01  
Date: 10.25.19  
Issued For: SHELL - CD SET

| REVISIONS |      |             |
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REGISTRATION



| PROJECT TEAM    |                                 |
|-----------------|---------------------------------|
| ARCHITECT       | FINKLE+WILLIAMS<br>ARCHITECTURE |
| CIVIL           | GBA                             |
| LANDSCAPE       | HOERR SCHAUDT /<br>LANDS        |
| FOUNDATIONS     | BSE STRUCTURAL<br>ENGINEERS     |
| STRUCTURAL      | BSE STRUCTURAL<br>ENGINEERS     |
| PLUMBING        | HENDERSON<br>ENGINEERS          |
| MECHANICAL      | HENDERSON<br>ENGINEERS          |
| ELECTRICAL      | HENDERSON<br>ENGINEERS          |
| FIRE PROTECTION | HENDERSON<br>ENGINEERS          |
| CONTRACTOR      | FOGEL ANDERSON                  |




FINKLE + WILLIAMS  
ARCHITECTURE

7007 College Blvd, Suite 415  
Overland Park, Kansas 66211  
913+498-1550

SHEET TITLE  
**SLAB EDGE  
PLAN - 1ST  
FLOOR EAST**

SHEET NUMBER  
**A0.12**

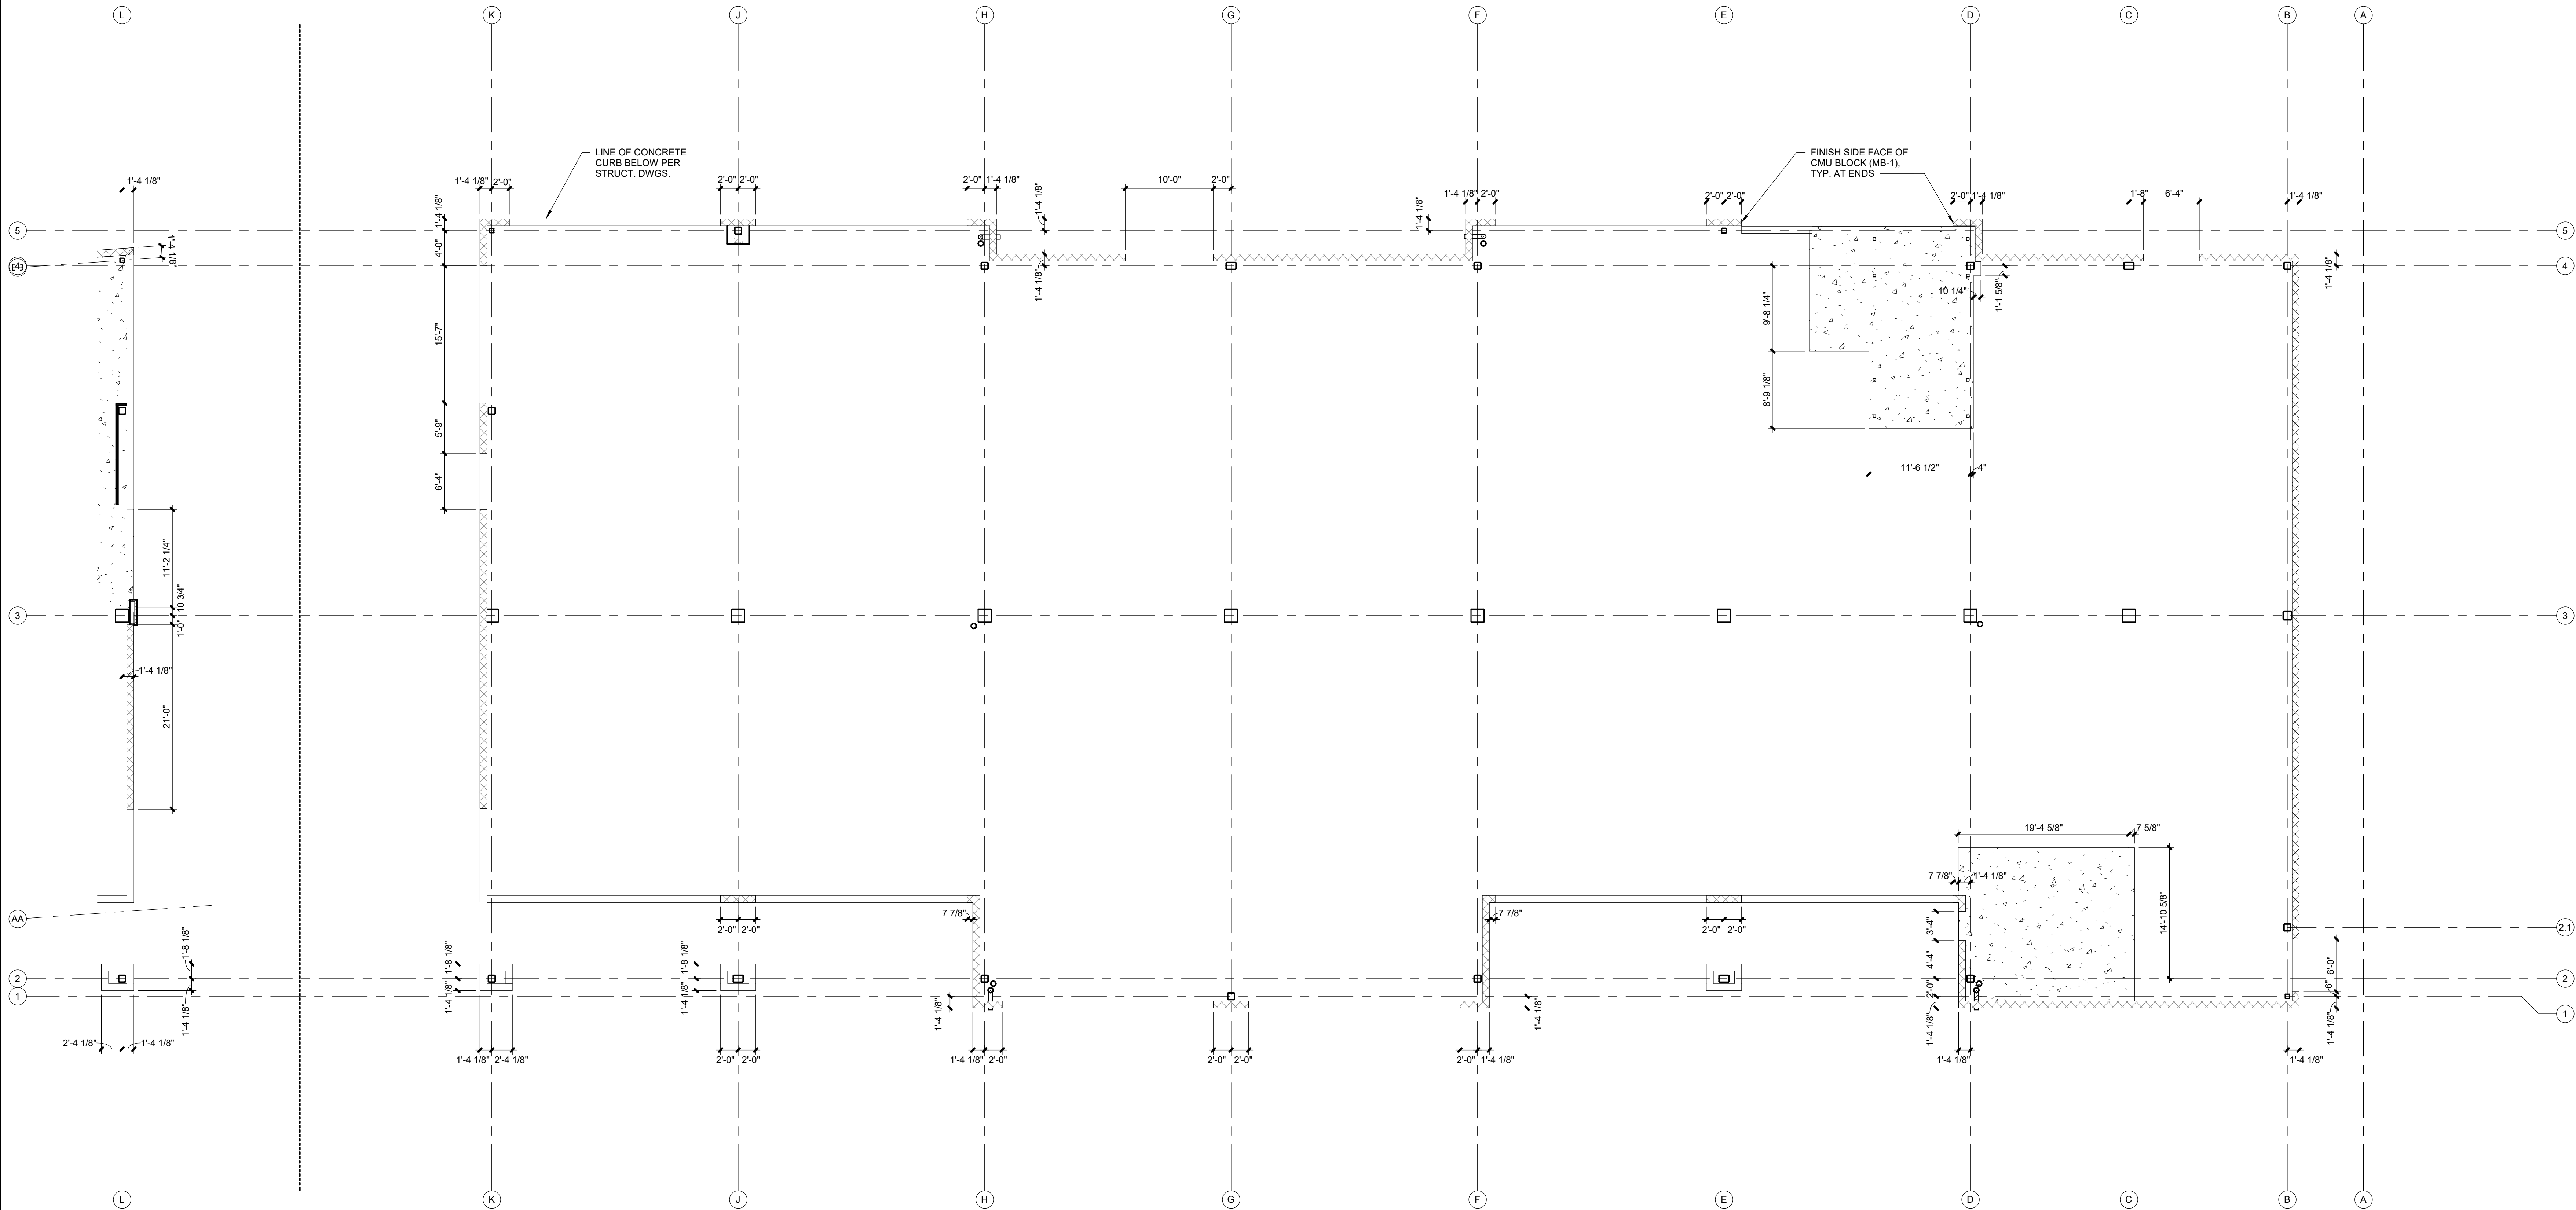






PARAGON STAR  
FIRST PLAT, LOT 9  
LEE'S SUMMIT, MO

Project No.: 19050.01  
Date: 10.25.19  
Issued For: SHELL - CD SET

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REGISTRATION

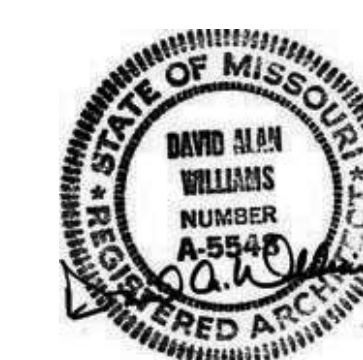

## PROJECT TEAM

|                 |                                 |
|-----------------|---------------------------------|
| ARCHITECT       | FINKLE+WILLIAMS<br>ARCHITECTURE |
| CIVIL           | G&A                             |
| LANDSCAPE       | HOERR SCHAUDT /<br>LAND3        |
| FOUNDATIONS     | BSE STRUCTURAL<br>ENGINEERS     |
| STRUCTURAL      | BSE STRUCTURAL<br>ENGINEERS     |
| PLUMBING        | HENDERSON<br>ENGINEERS          |
| MECHANICAL      | HENDERSON<br>ENGINEERS          |
| ELECTRICAL      | HENDERSON<br>ENGINEERS          |
| FIRE PROTECTION | HENDERSON<br>ENGINEERS          |
| CONTRACTOR      | FOGEL ANDERSON                  |



FINKLE + WILLIAMS  
ARCHITECTURE


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SHEET TITLE

SLAB EDGE  
PLAN - 2ND  
FLOOR WEST


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A0.13



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|   |                                      |
|---|--------------------------------------|
| 1 | EDGE OF SLAB PLAN - 2ND FLOOR - WEST |
|---|--------------------------------------|

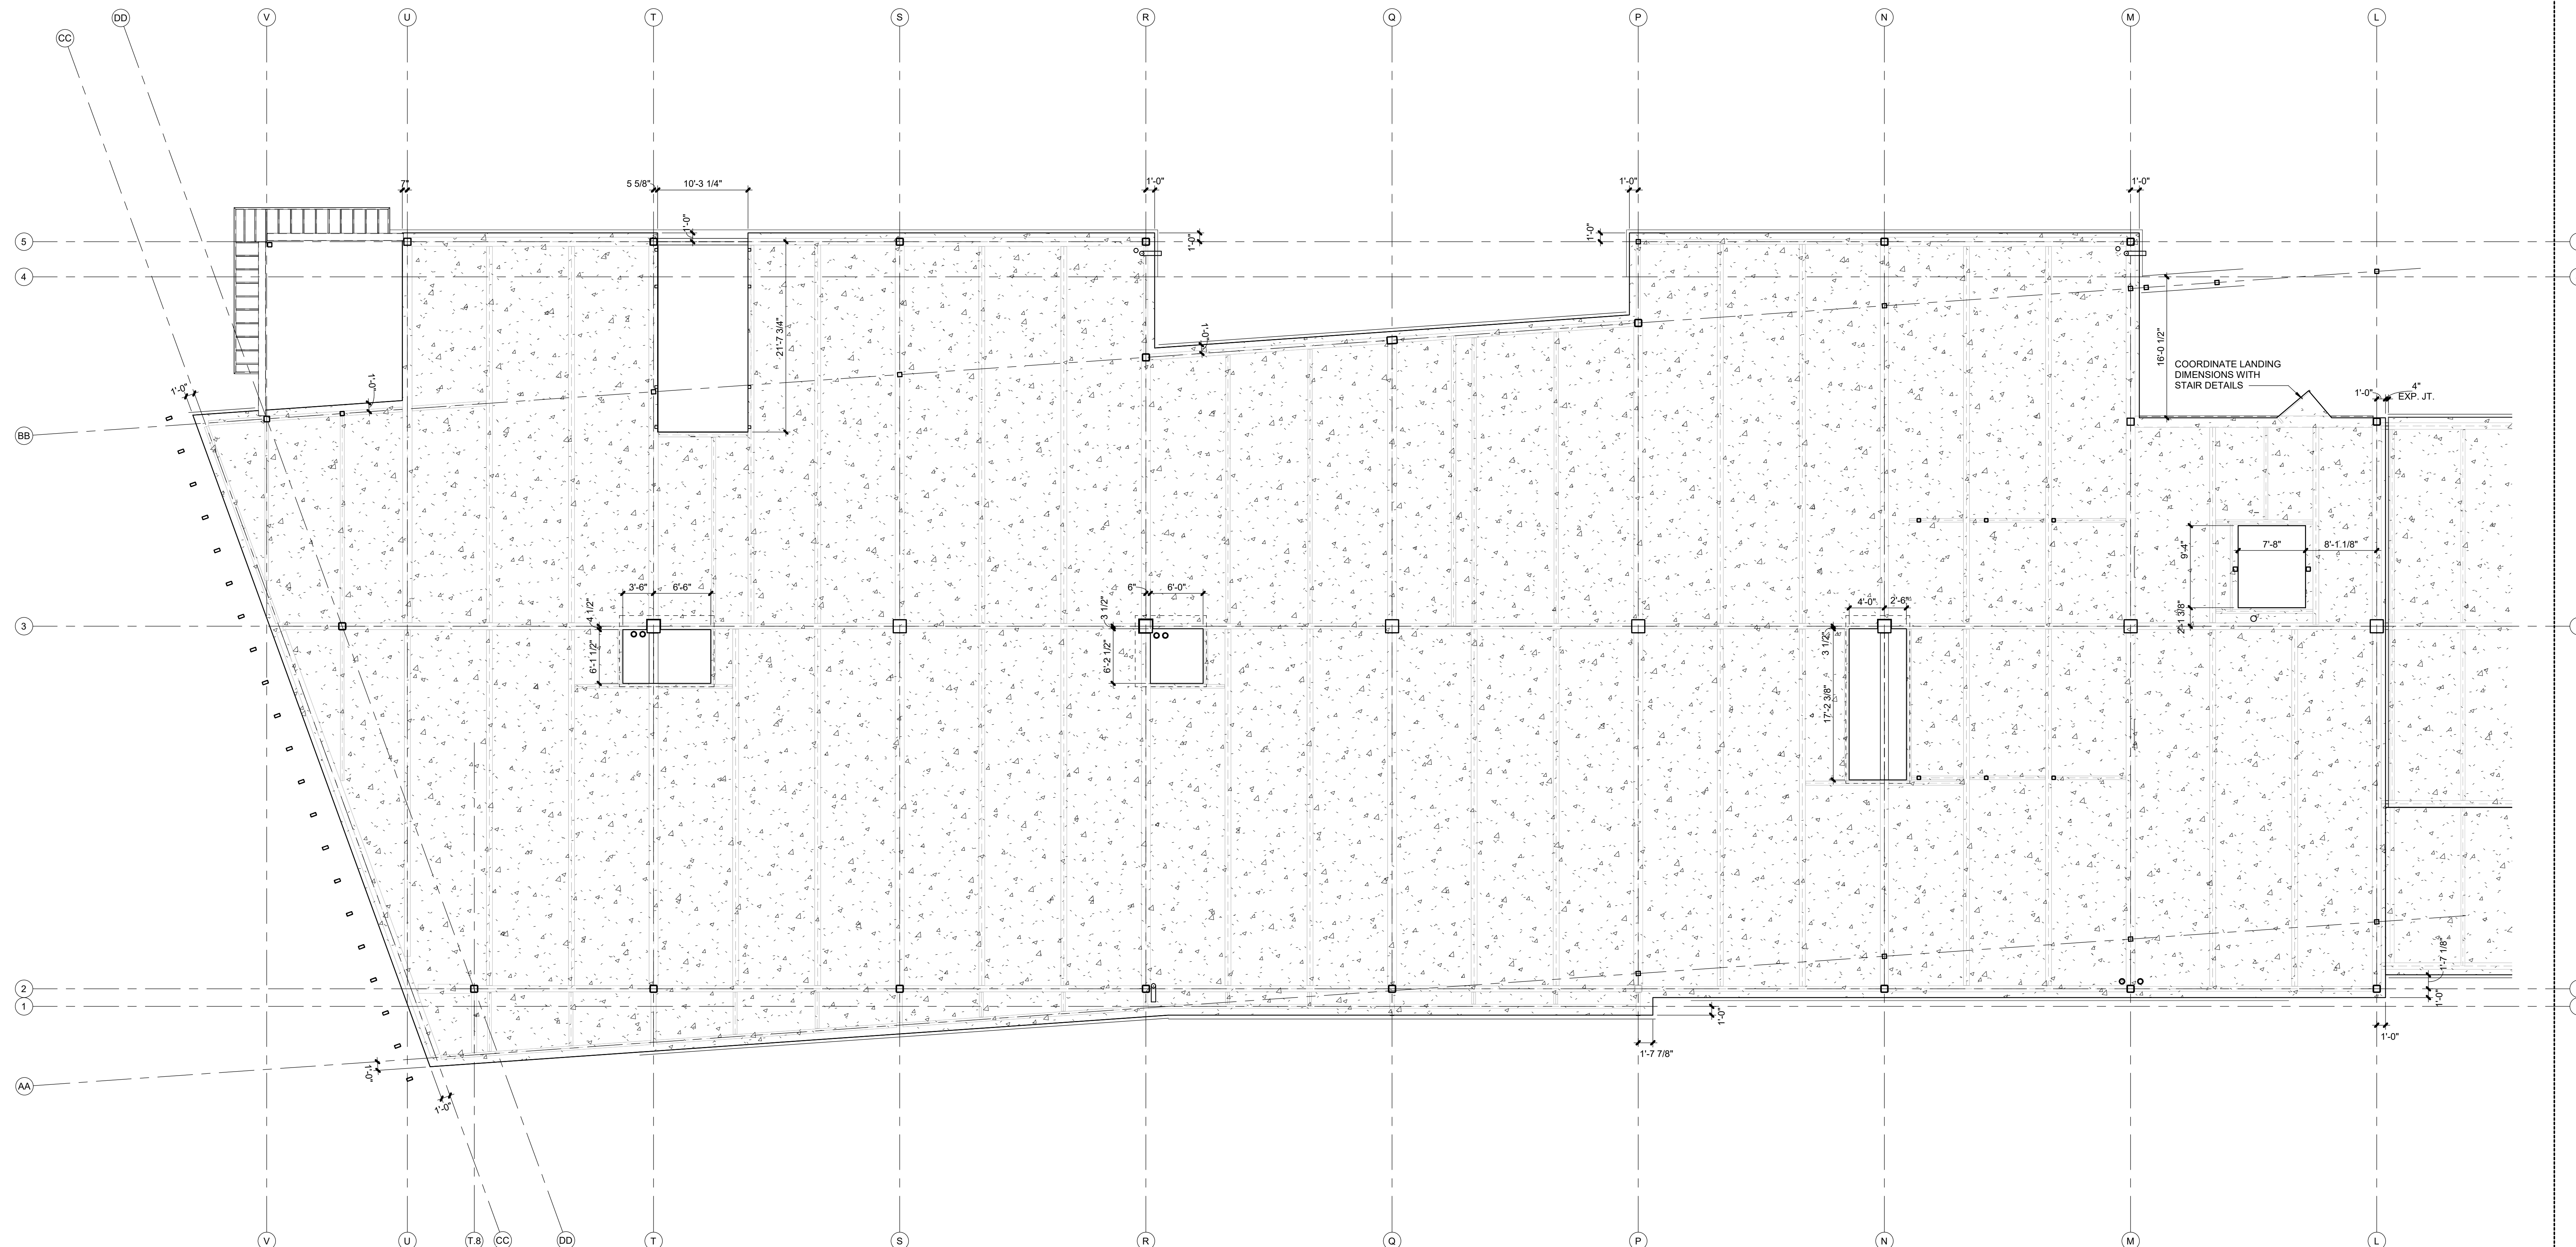

SCALE : 1/8" = 1'-0"

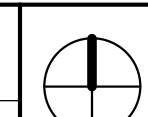


PARAGON STAR  
- LOT 9 -  
BUILDING 2

PARAGON STAR  
FIRST PLAT, LOT 9  
LEE'S SUMMIT, MO

Project No.: 19050.01  
Date: 10.25.19  
Issued For: SHELL - CD SET

| REVISIONS |      |             |
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| No.       | Date | Description |
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REGISTRATION

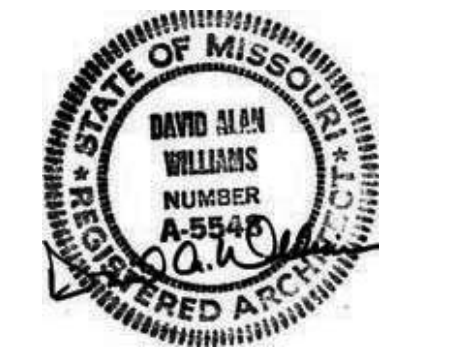

PROJECT TEAM

|                 |                                 |
|-----------------|---------------------------------|
| ARCHITECT       | FINKLE+WILLIAMS<br>ARCHITECTURE |
| CIVIL           | GBA                             |
| LANDSCAPE       | HOERR SCHAUDT /<br>LANDS        |
| FOUNDATIONS     | BSE STRUCTURAL<br>ENGINEERS     |
| STRUCTURAL      | BSE STRUCTURAL<br>ENGINEERS     |
| PLUMBING        | HENDERSON<br>ENGINEERS          |
| MECHANICAL      | HENDERSON<br>ENGINEERS          |
| ELECTRICAL      | HENDERSON<br>ENGINEERS          |
| FIRE PROTECTION | HENDERSON<br>ENGINEERS          |
| CONTRACTOR      | FOGEL ANDERSON                  |



FINKLE + WILLIAMS  
ARCHITECTURE


7007 College Blvd, Suite 415  
Overland Park, Kansas 66211  
913-498-1550

SHEET TITLE


SLAB EDGE  
PLAN - 2ND  
FLOOR EAST

SHEET NUMBER

A0.14

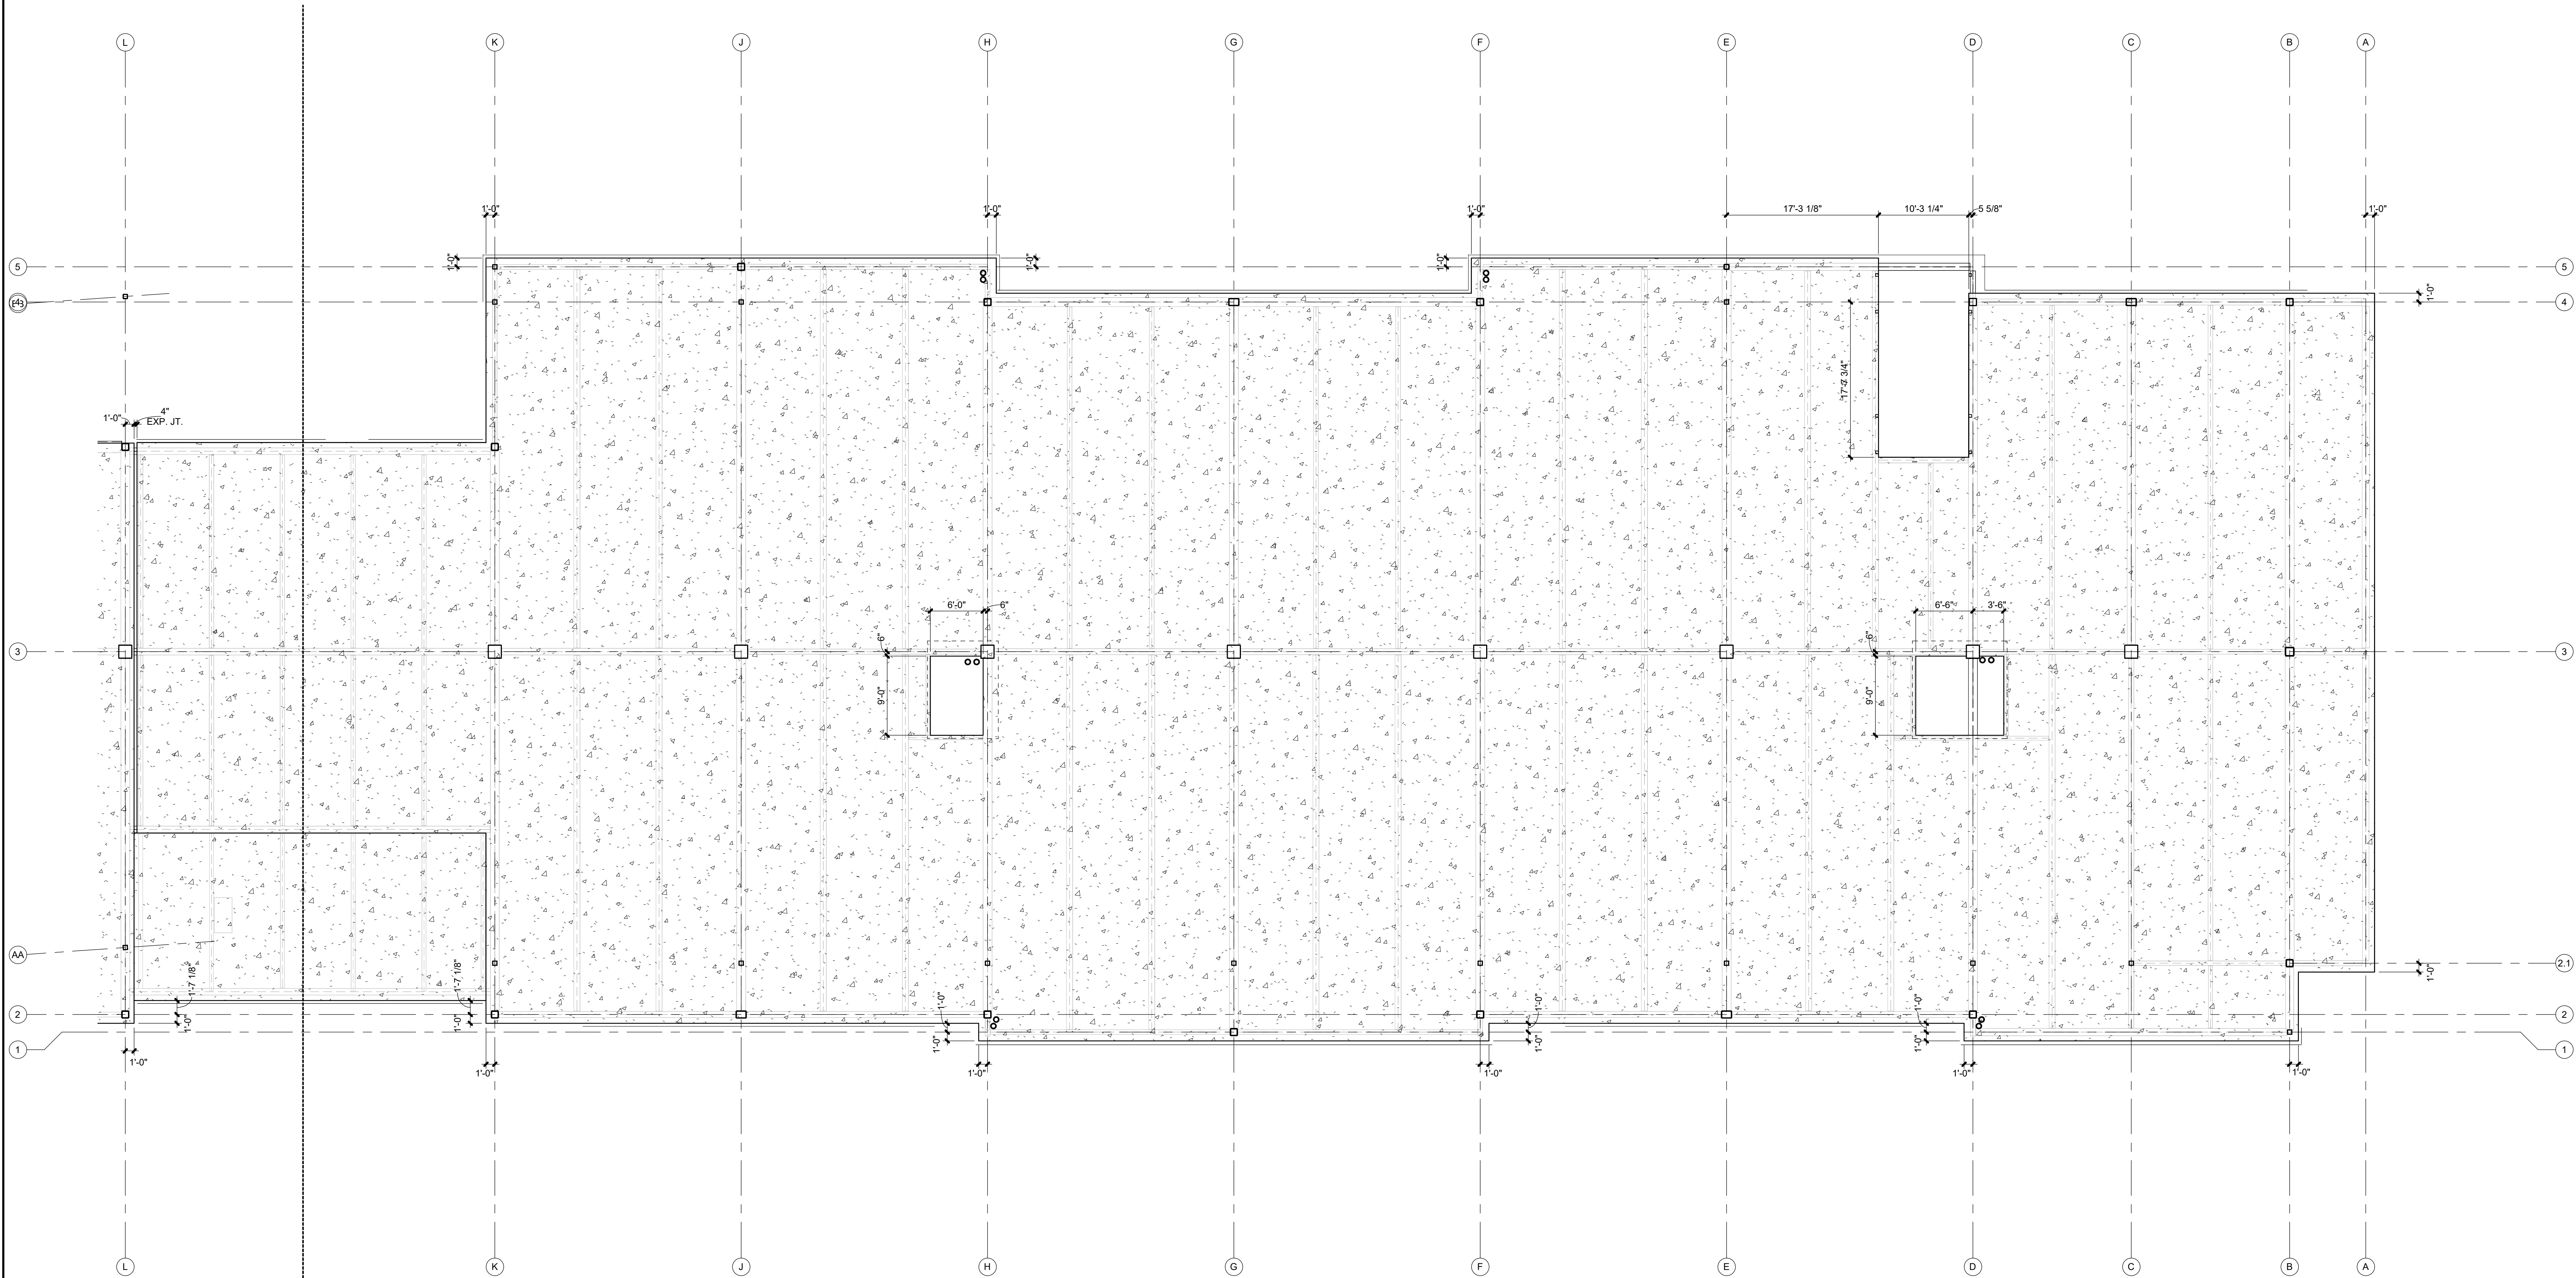



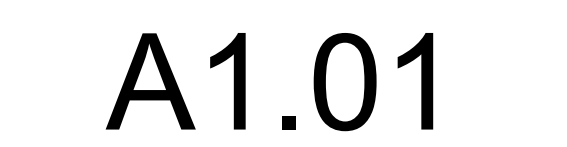

|       |                          |   |
|-------|--------------------------|---|
| 1     | OVERALL PLAN - 1ST FLOOR |  |
| A1.01 | SCALE : 1/16" = 1'-0"    |   |





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| Project No.: | 19050.01       |
| Date:        | 10.25.19       |
| Issued For:  | SHELL - CD SET |

REGISTRATION



FINKLE + WILLIAMS  
ARCHITECTURE

SHEET TITLE

SHEET NUMBER

## A1.02








PARAGON STAR  
FIRST PLAT, LOT 9  
LEE'S SUMMIT, MO

Project No.: 19050.01  
Date: 10.25.19  
Issued For: SHELL - CD SET

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REGISTRATION

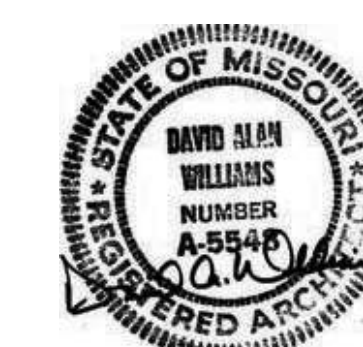

## PROJECT TEAM

|                 |                                 |
|-----------------|---------------------------------|
| ARCHITECT       | FINKLE+WILLIAMS<br>ARCHITECTURE |
| CIVIL           | GBA                             |
| LANDSCAPE       | HOERR SCHAUDT /<br>LAND3        |
| FOUNDATIONS     | BSE STRUCTURAL<br>ENGINEERS     |
| STRUCTURAL      | BSE STRUCTURAL<br>ENGINEERS     |
| PLUMBING        | HENDERSON<br>ENGINEERS          |
| MECHANICAL      | HENDERSON<br>ENGINEERS          |
| ELECTRICAL      | HENDERSON<br>ENGINEERS          |
| FIRE PROTECTION | HENDERSON<br>ENGINEERS          |
| CONTRACTOR      | FOGEL ANDERSON                  |



FINKLE + WILLIAMS  
ARCHITECTURE


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SHEET TITLE

FIRST FLOOR  
PLAN - EAST

SHEET NUMBER


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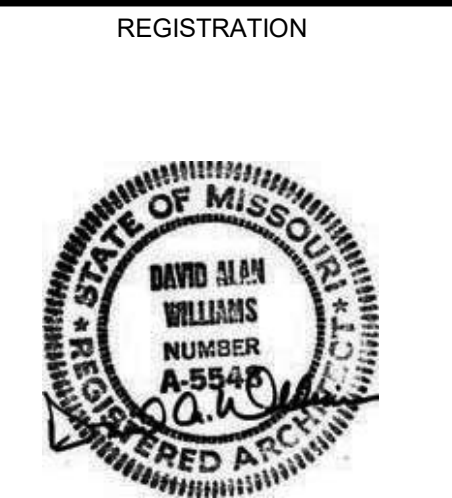
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| 1 | 1ST FLOOR PLAN - EAST |
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| <b>A1.03</b> | SCALE : 1/8" = 1'-0" |
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| REVISIONS |      |             |
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| PROJECT TEAM    |                              |
|-----------------|------------------------------|
| ARCHITECT       | FINKLE+WILLIAMS ARCHITECTURE |
| CIVIL           | GBA                          |
| LANDSCAPE       | HOERR SCHAUDT / LANDS        |
| FOUNDATIONS     | BSE STRUCTURAL ENGINEERS     |
| STRUCTURAL      | BSE STRUCTURAL ENGINEERS     |
| PLUMBING        | HENDERSON ENGINEERS          |
| MECHANICAL      | HENDERSON ENGINEERS          |
| ELECTRICAL      | HENDERSON ENGINEERS          |
| FIRE PROTECTION | HENDERSON ENGINEERS          |
| CONTRACTOR      | FOGEL ANDERSON               |

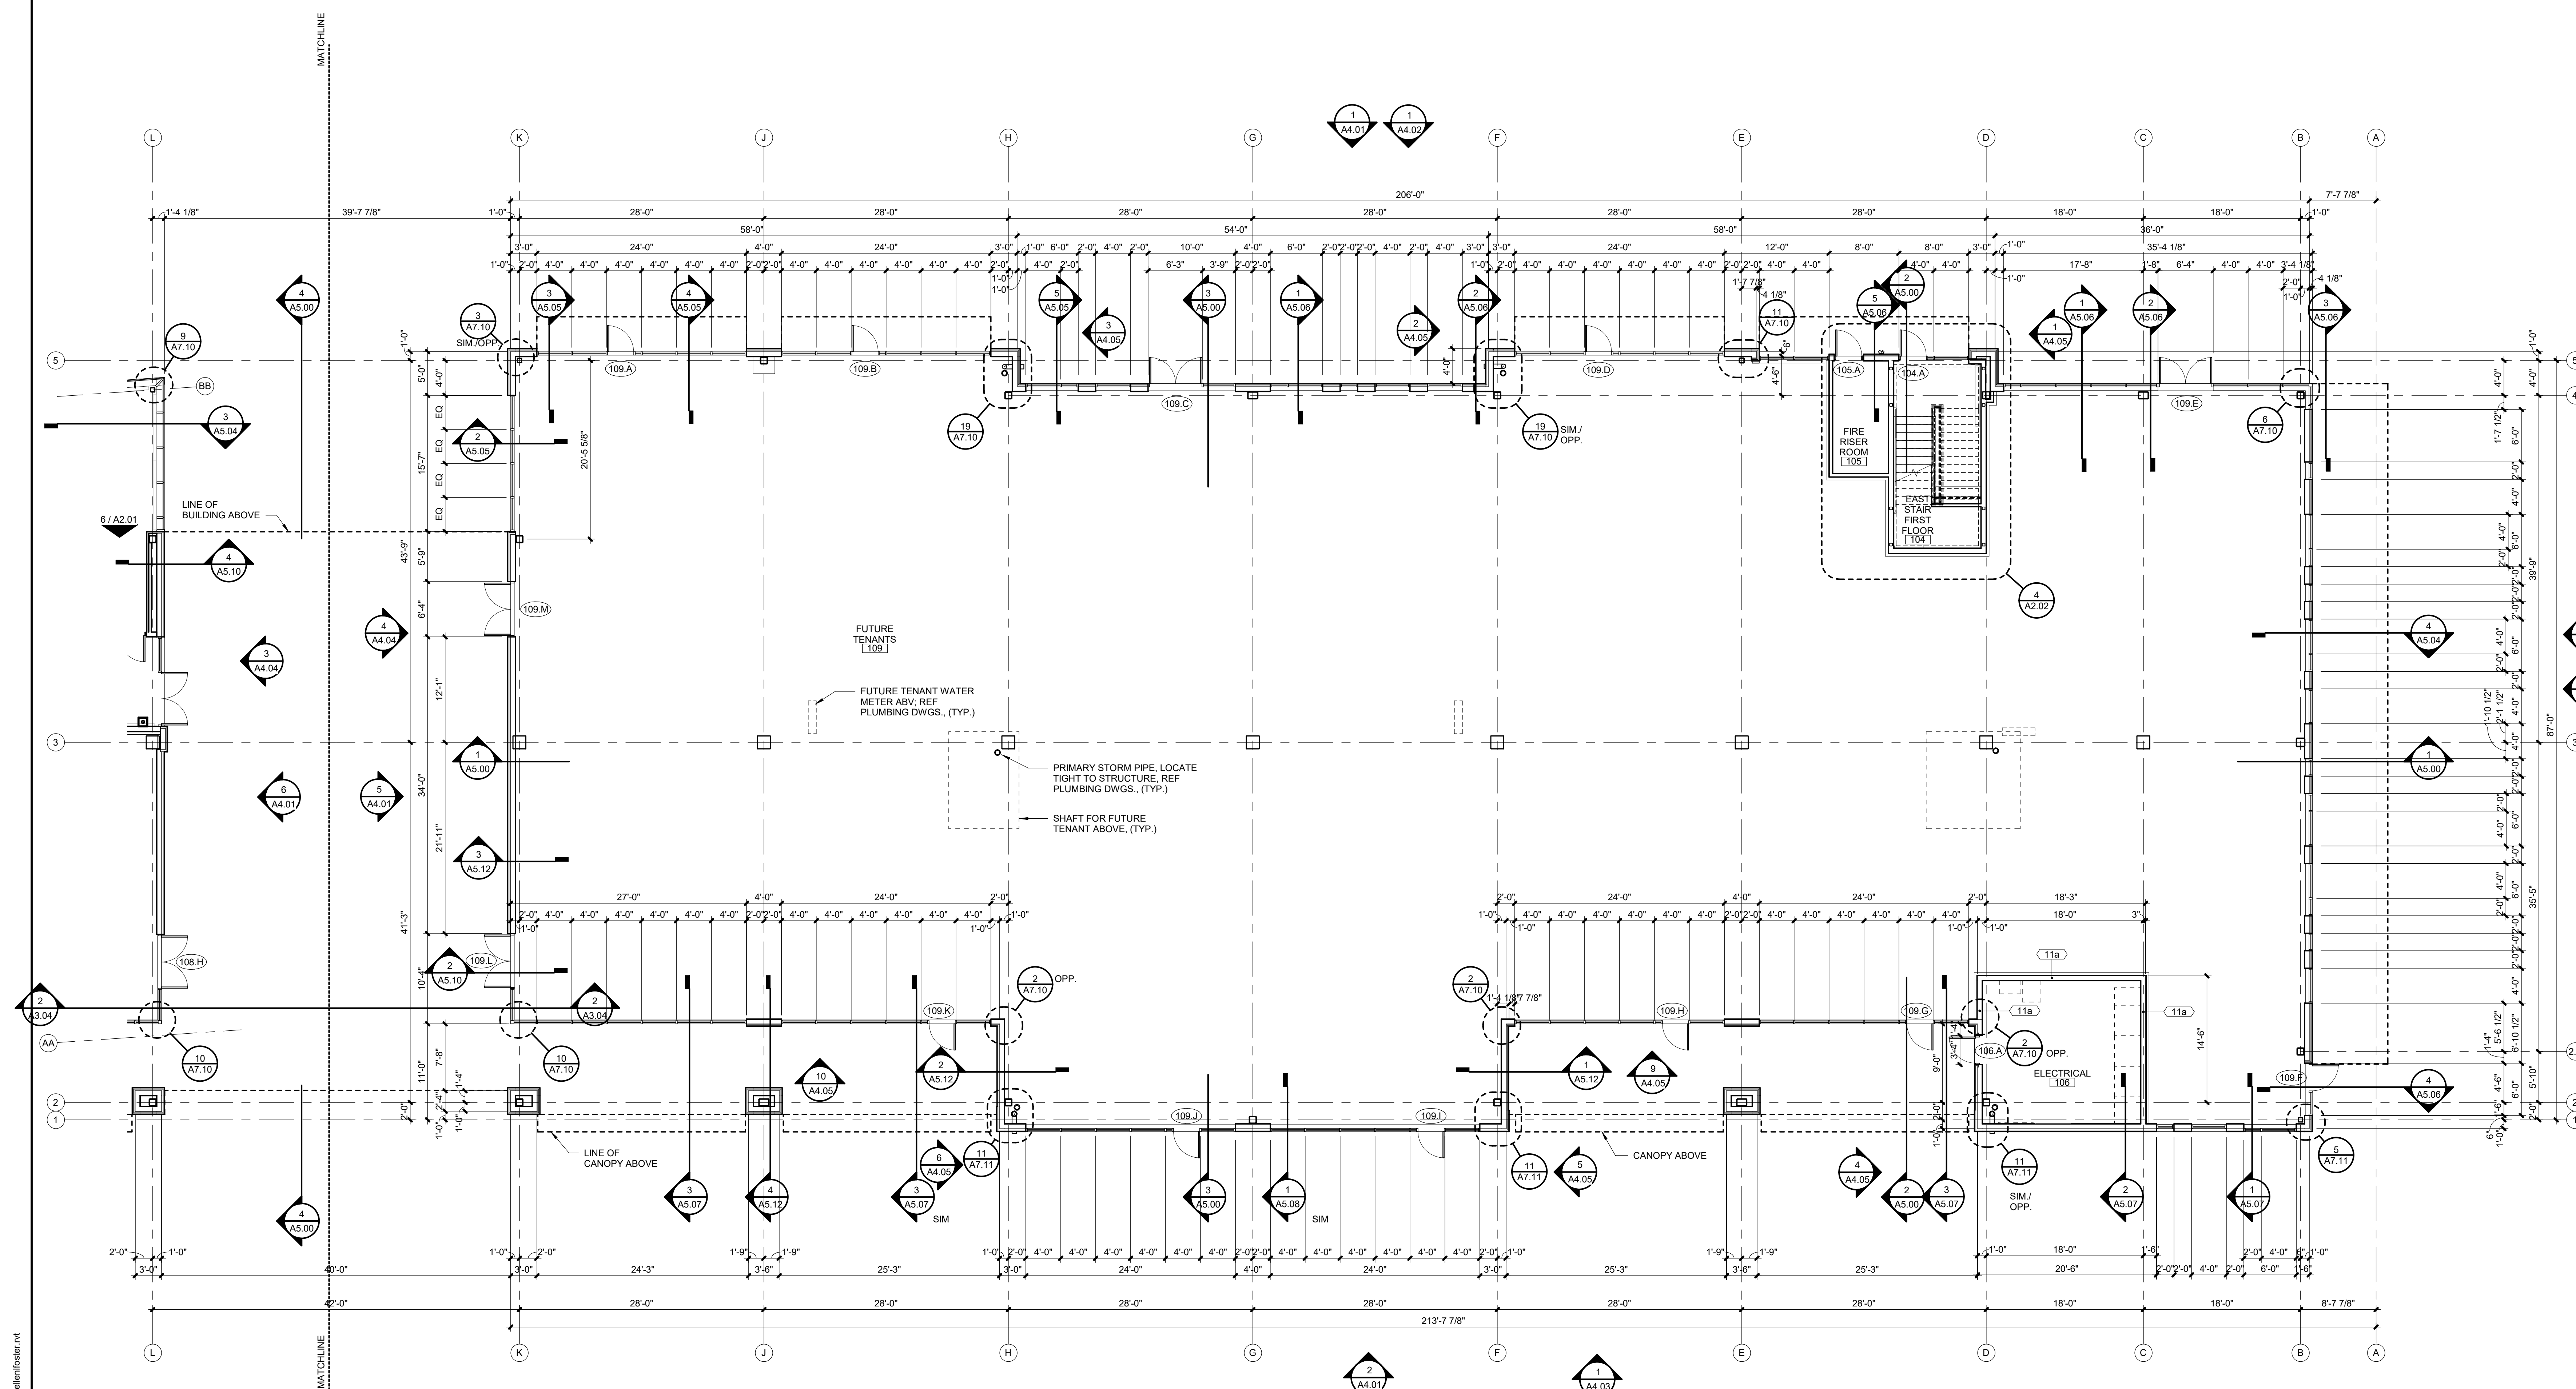

FINKLE + WILLIAMS  
ARCHITECTURE


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SHEET TITLE

SECOND FLOOR PLAN - WEST

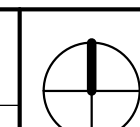SHEET NUMBER

A1.04



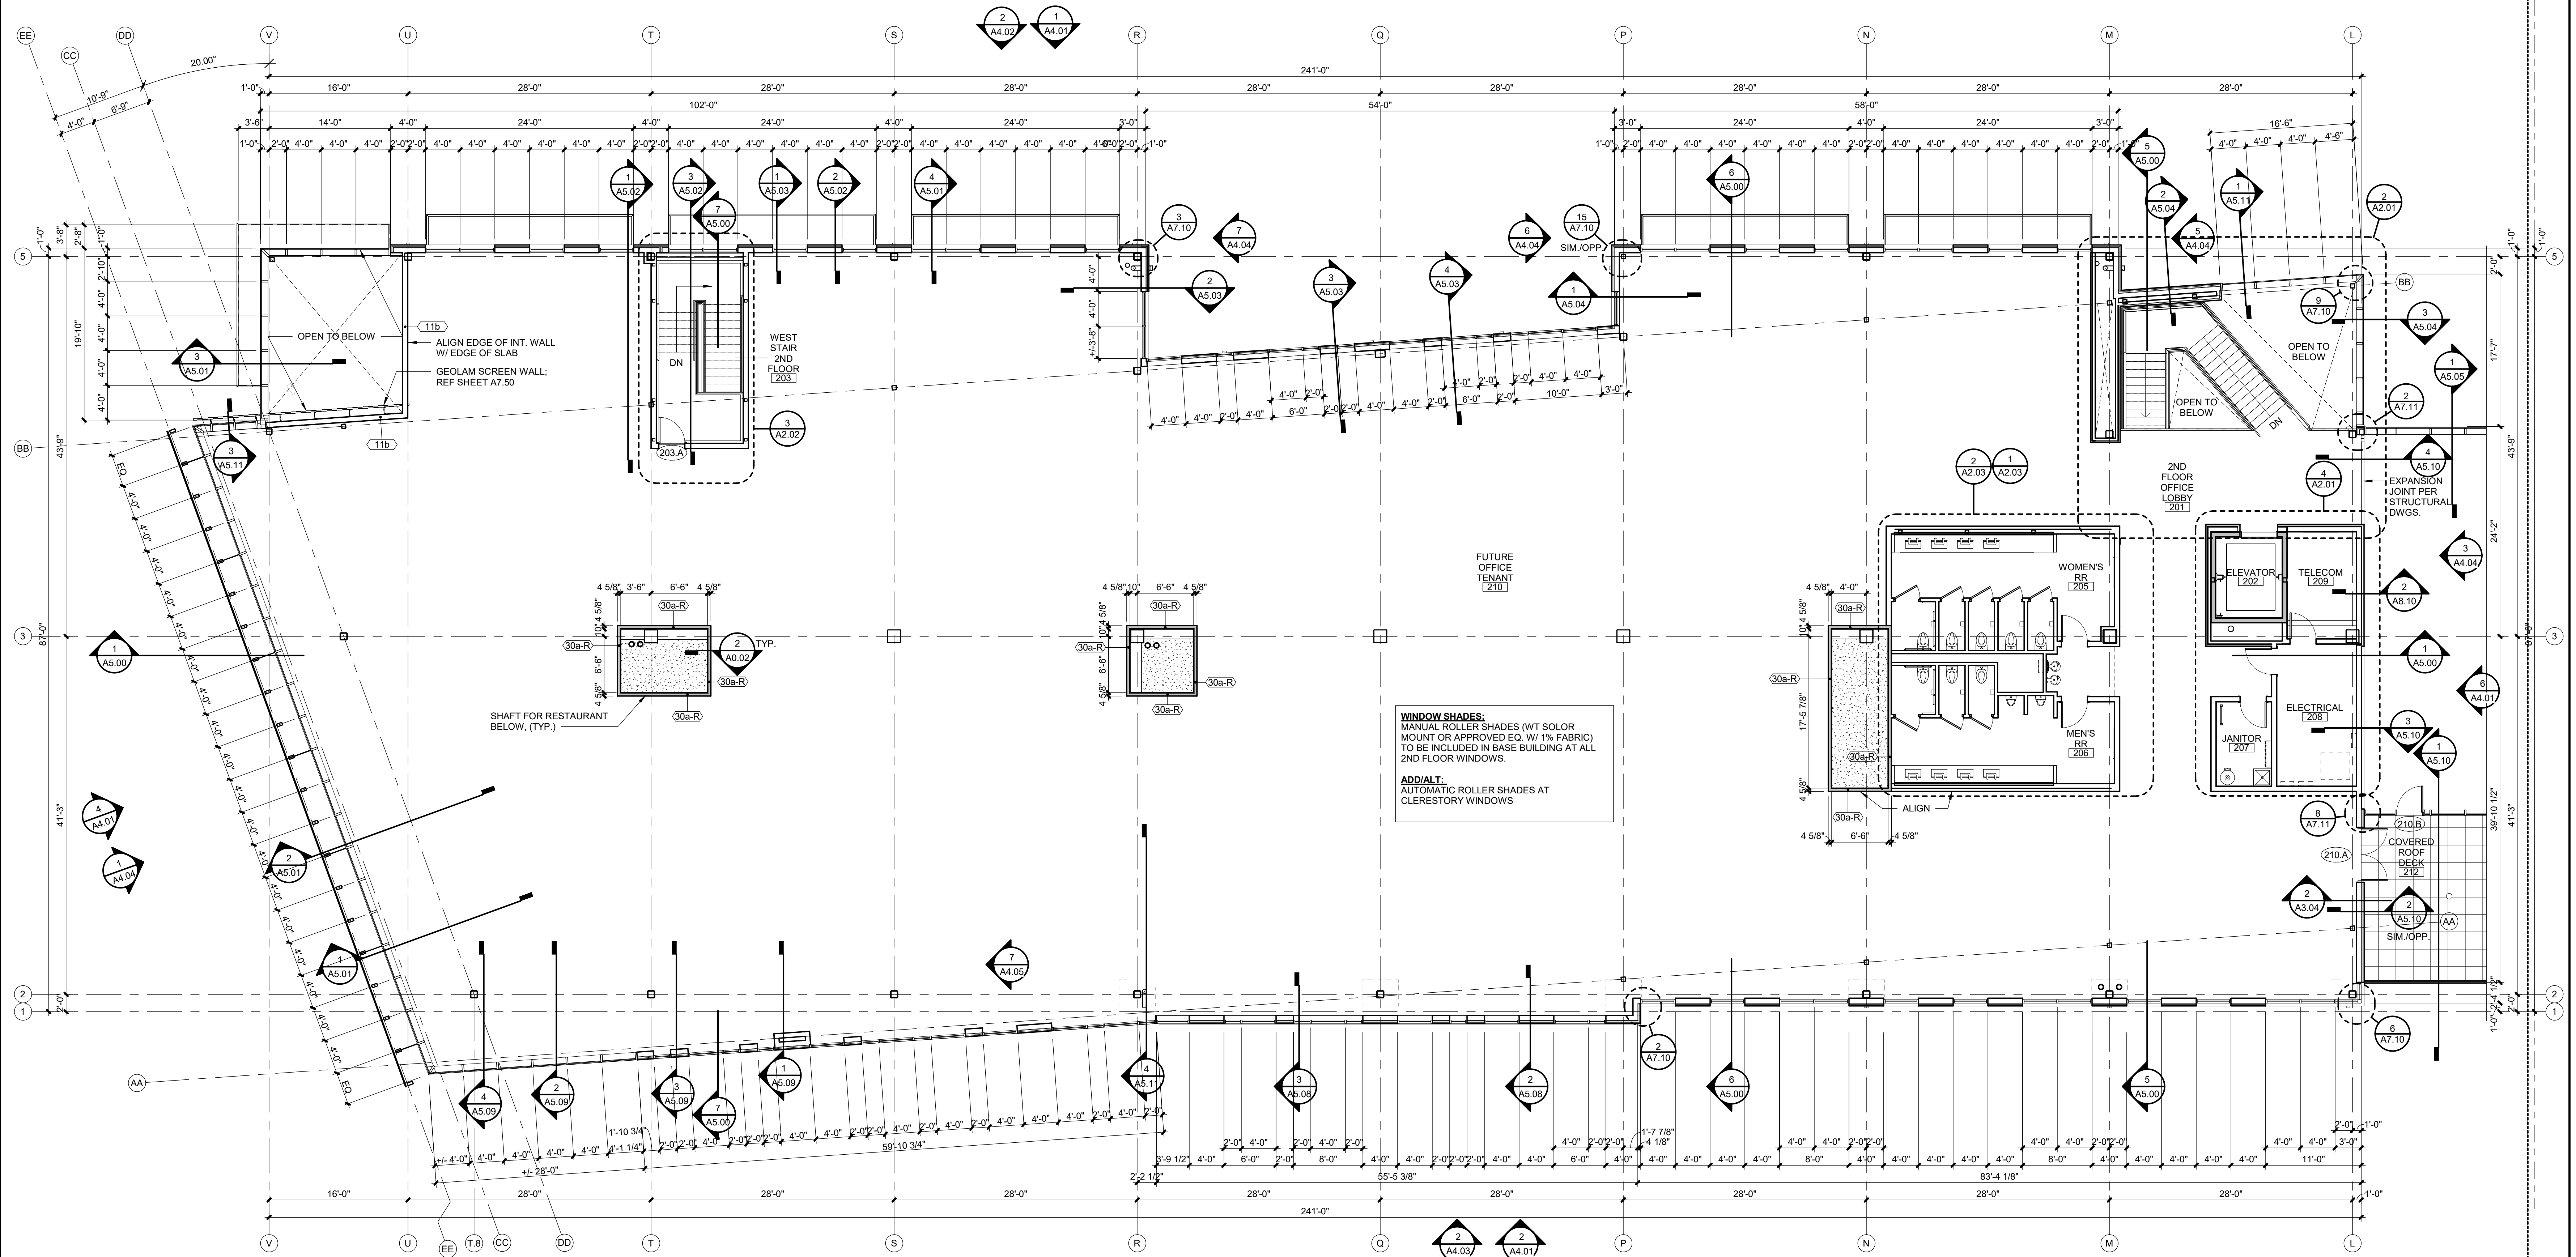











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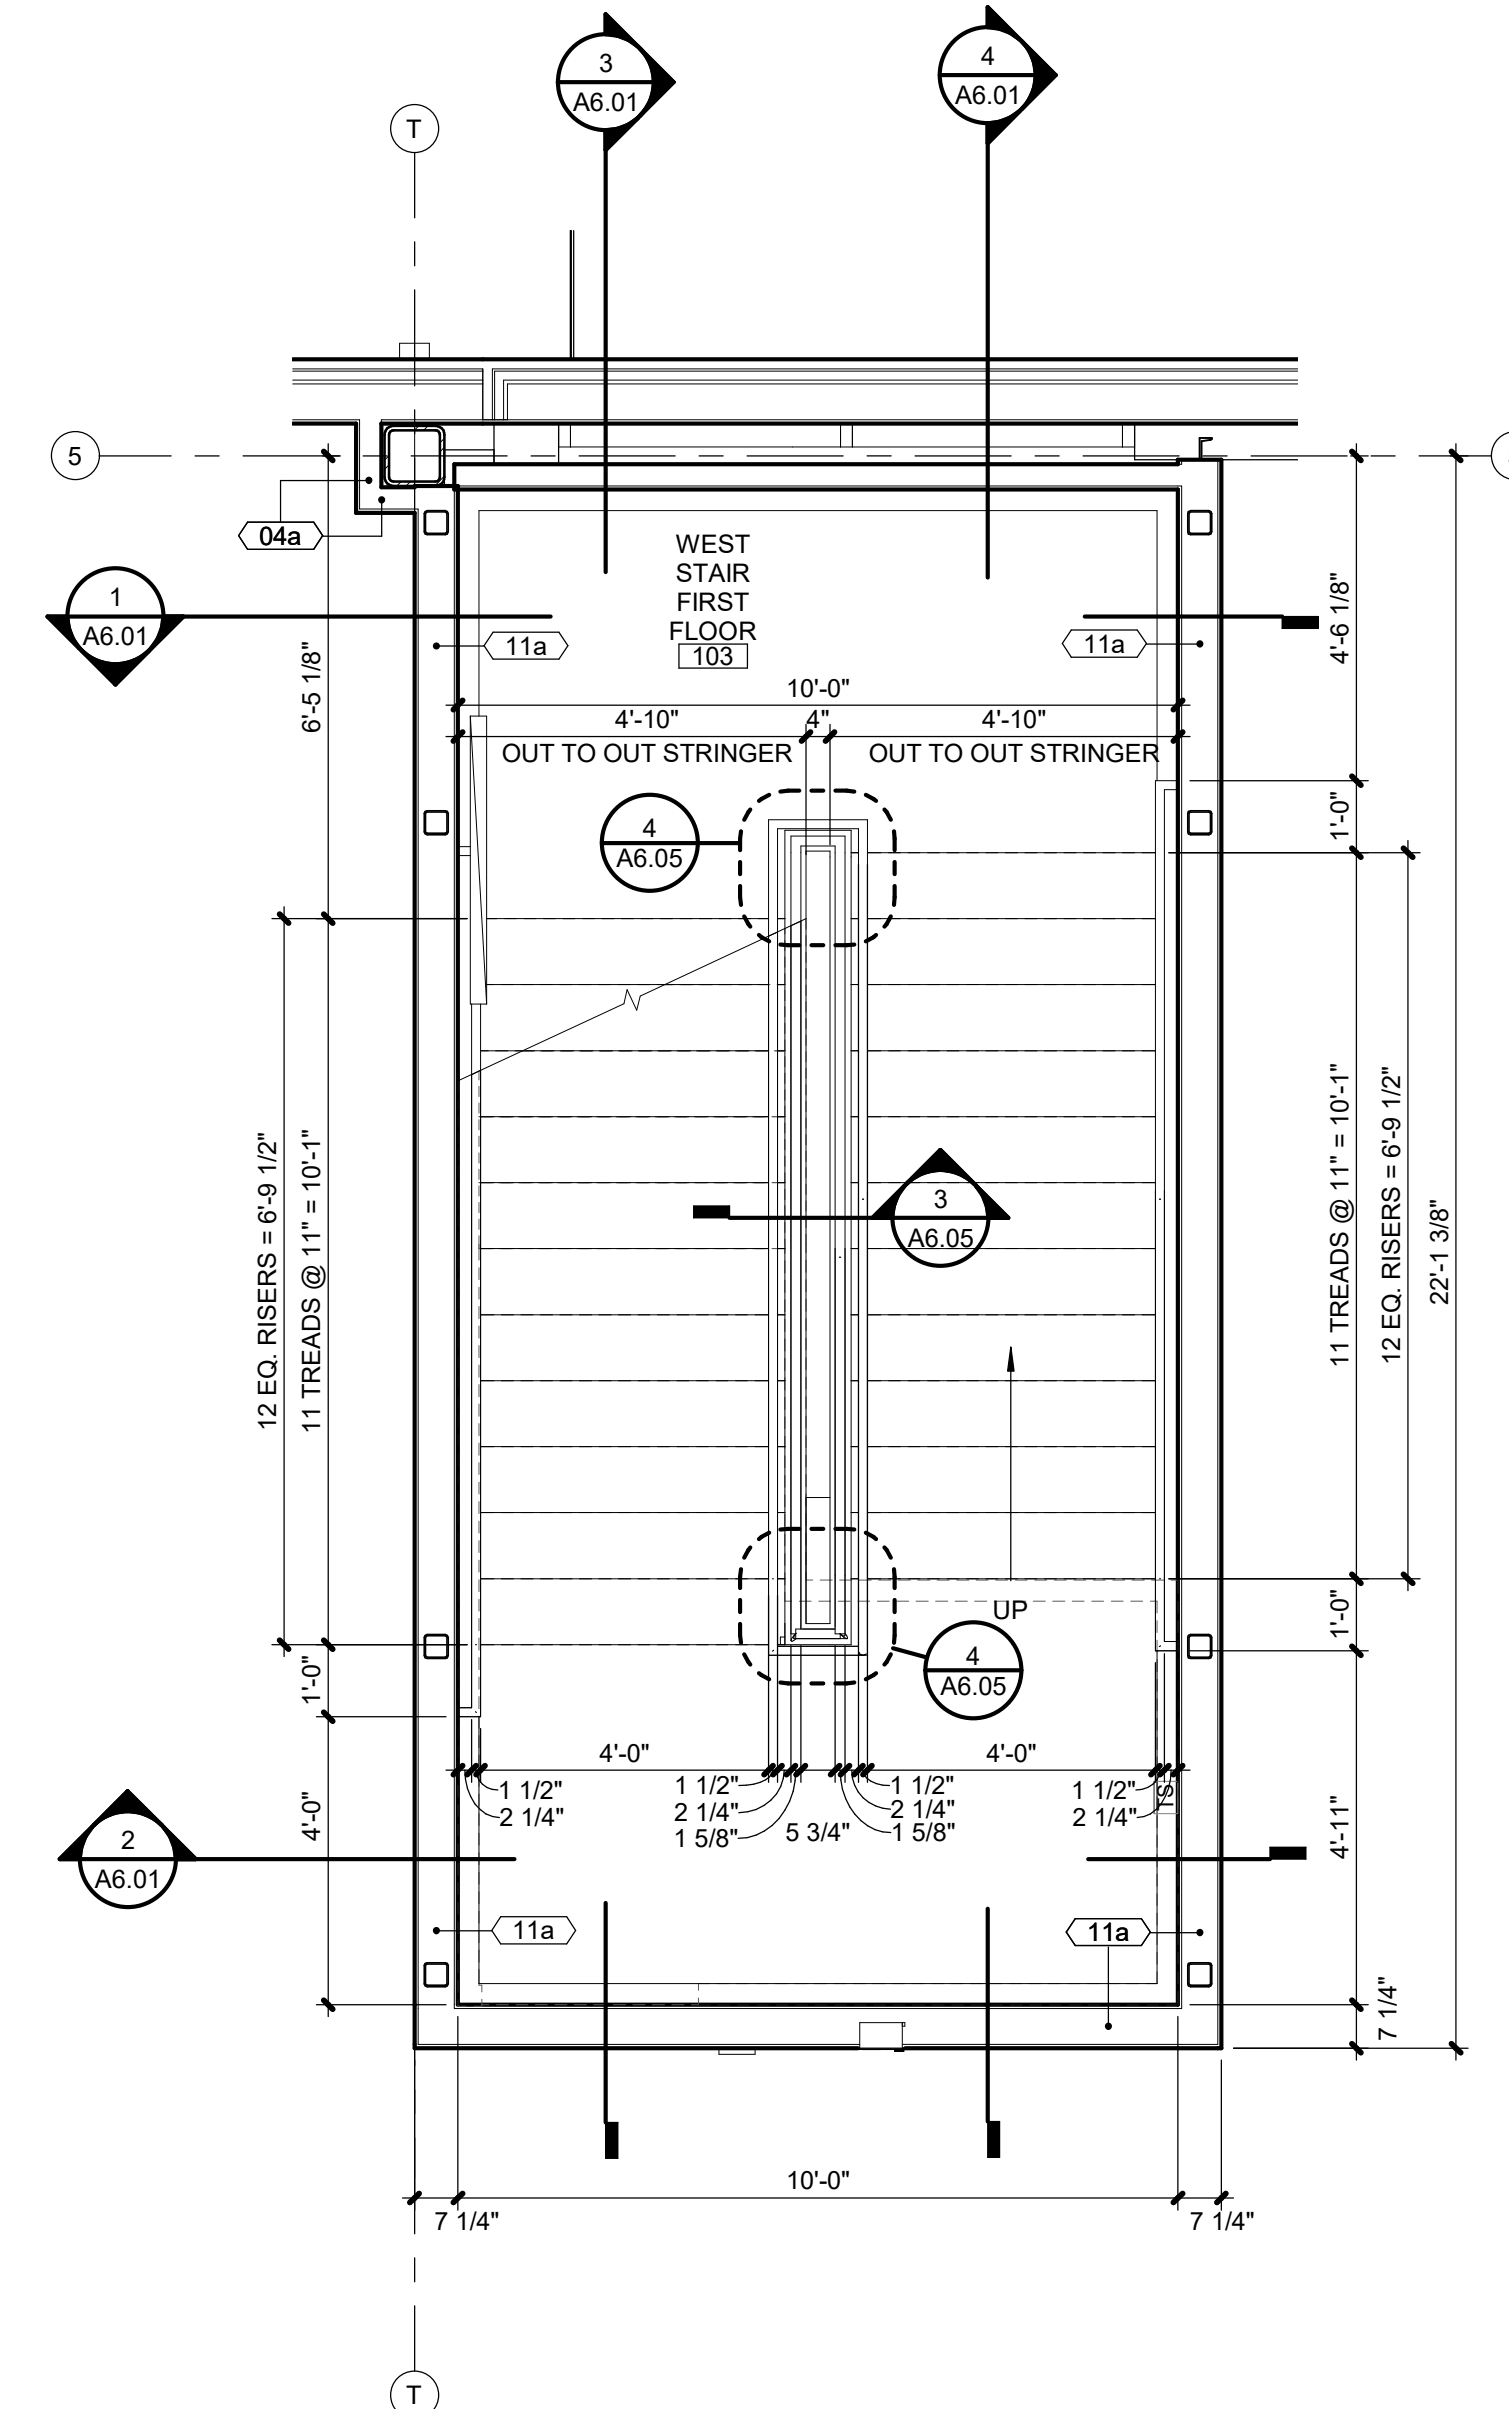
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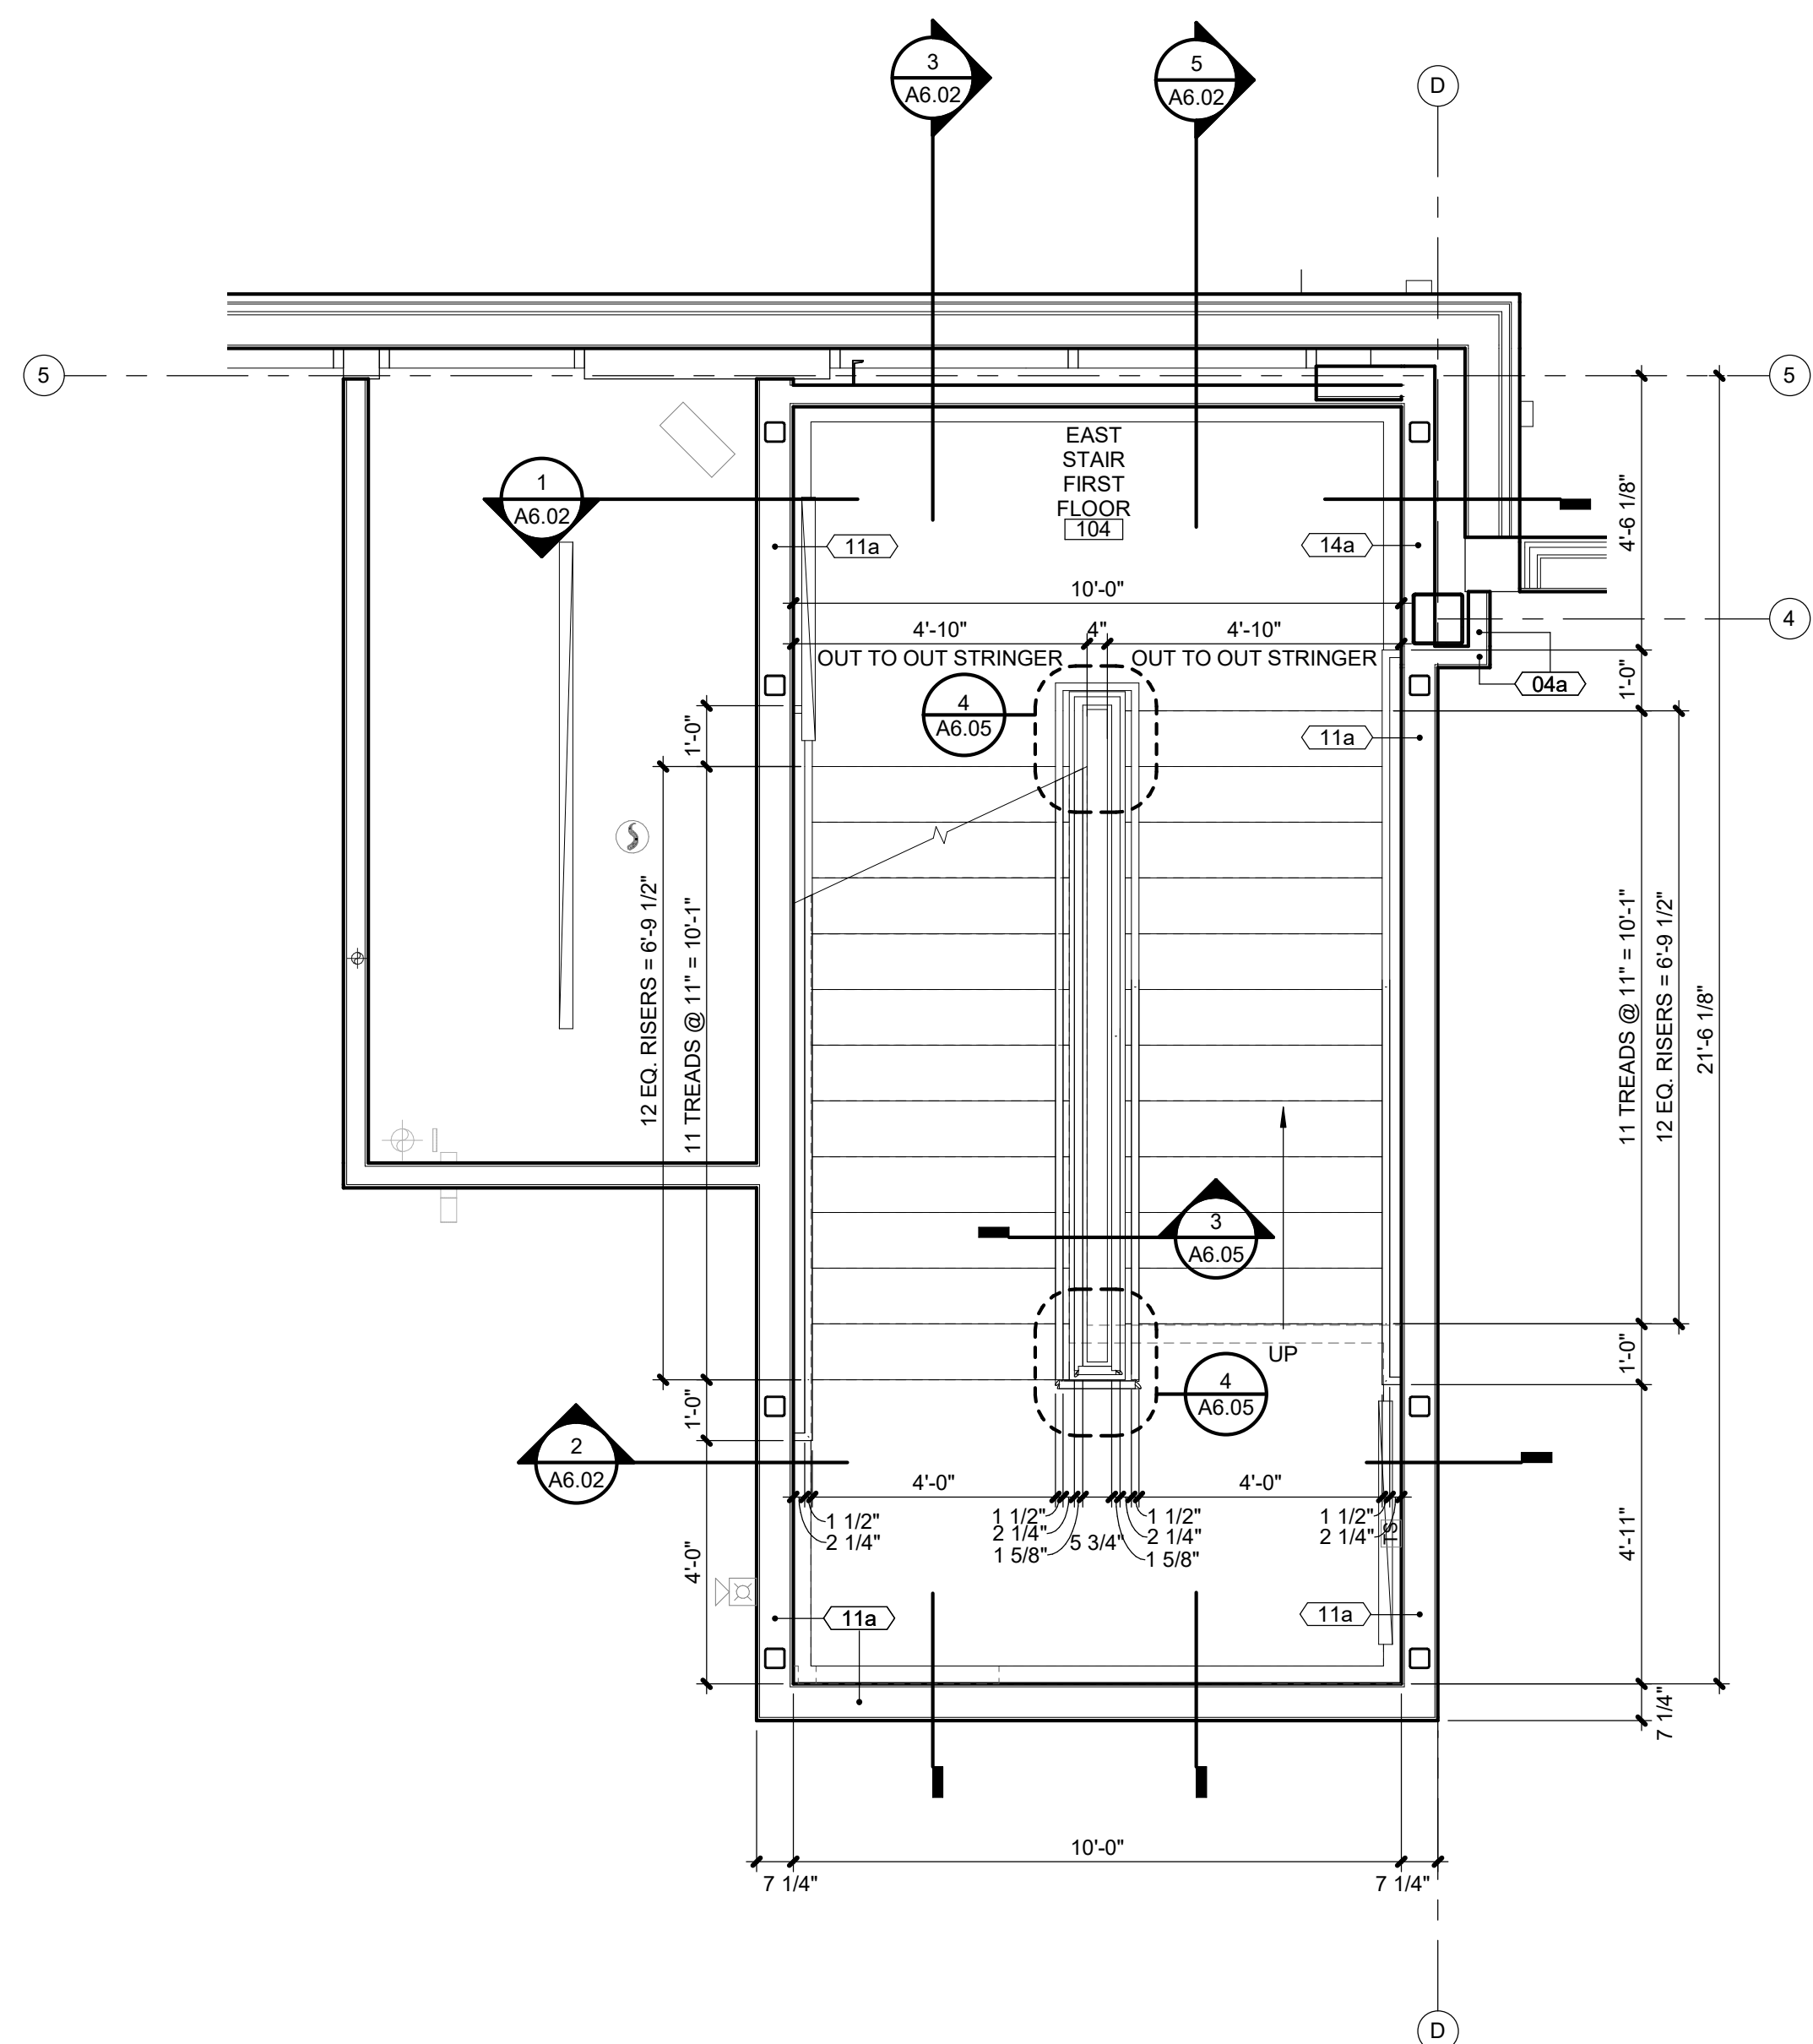
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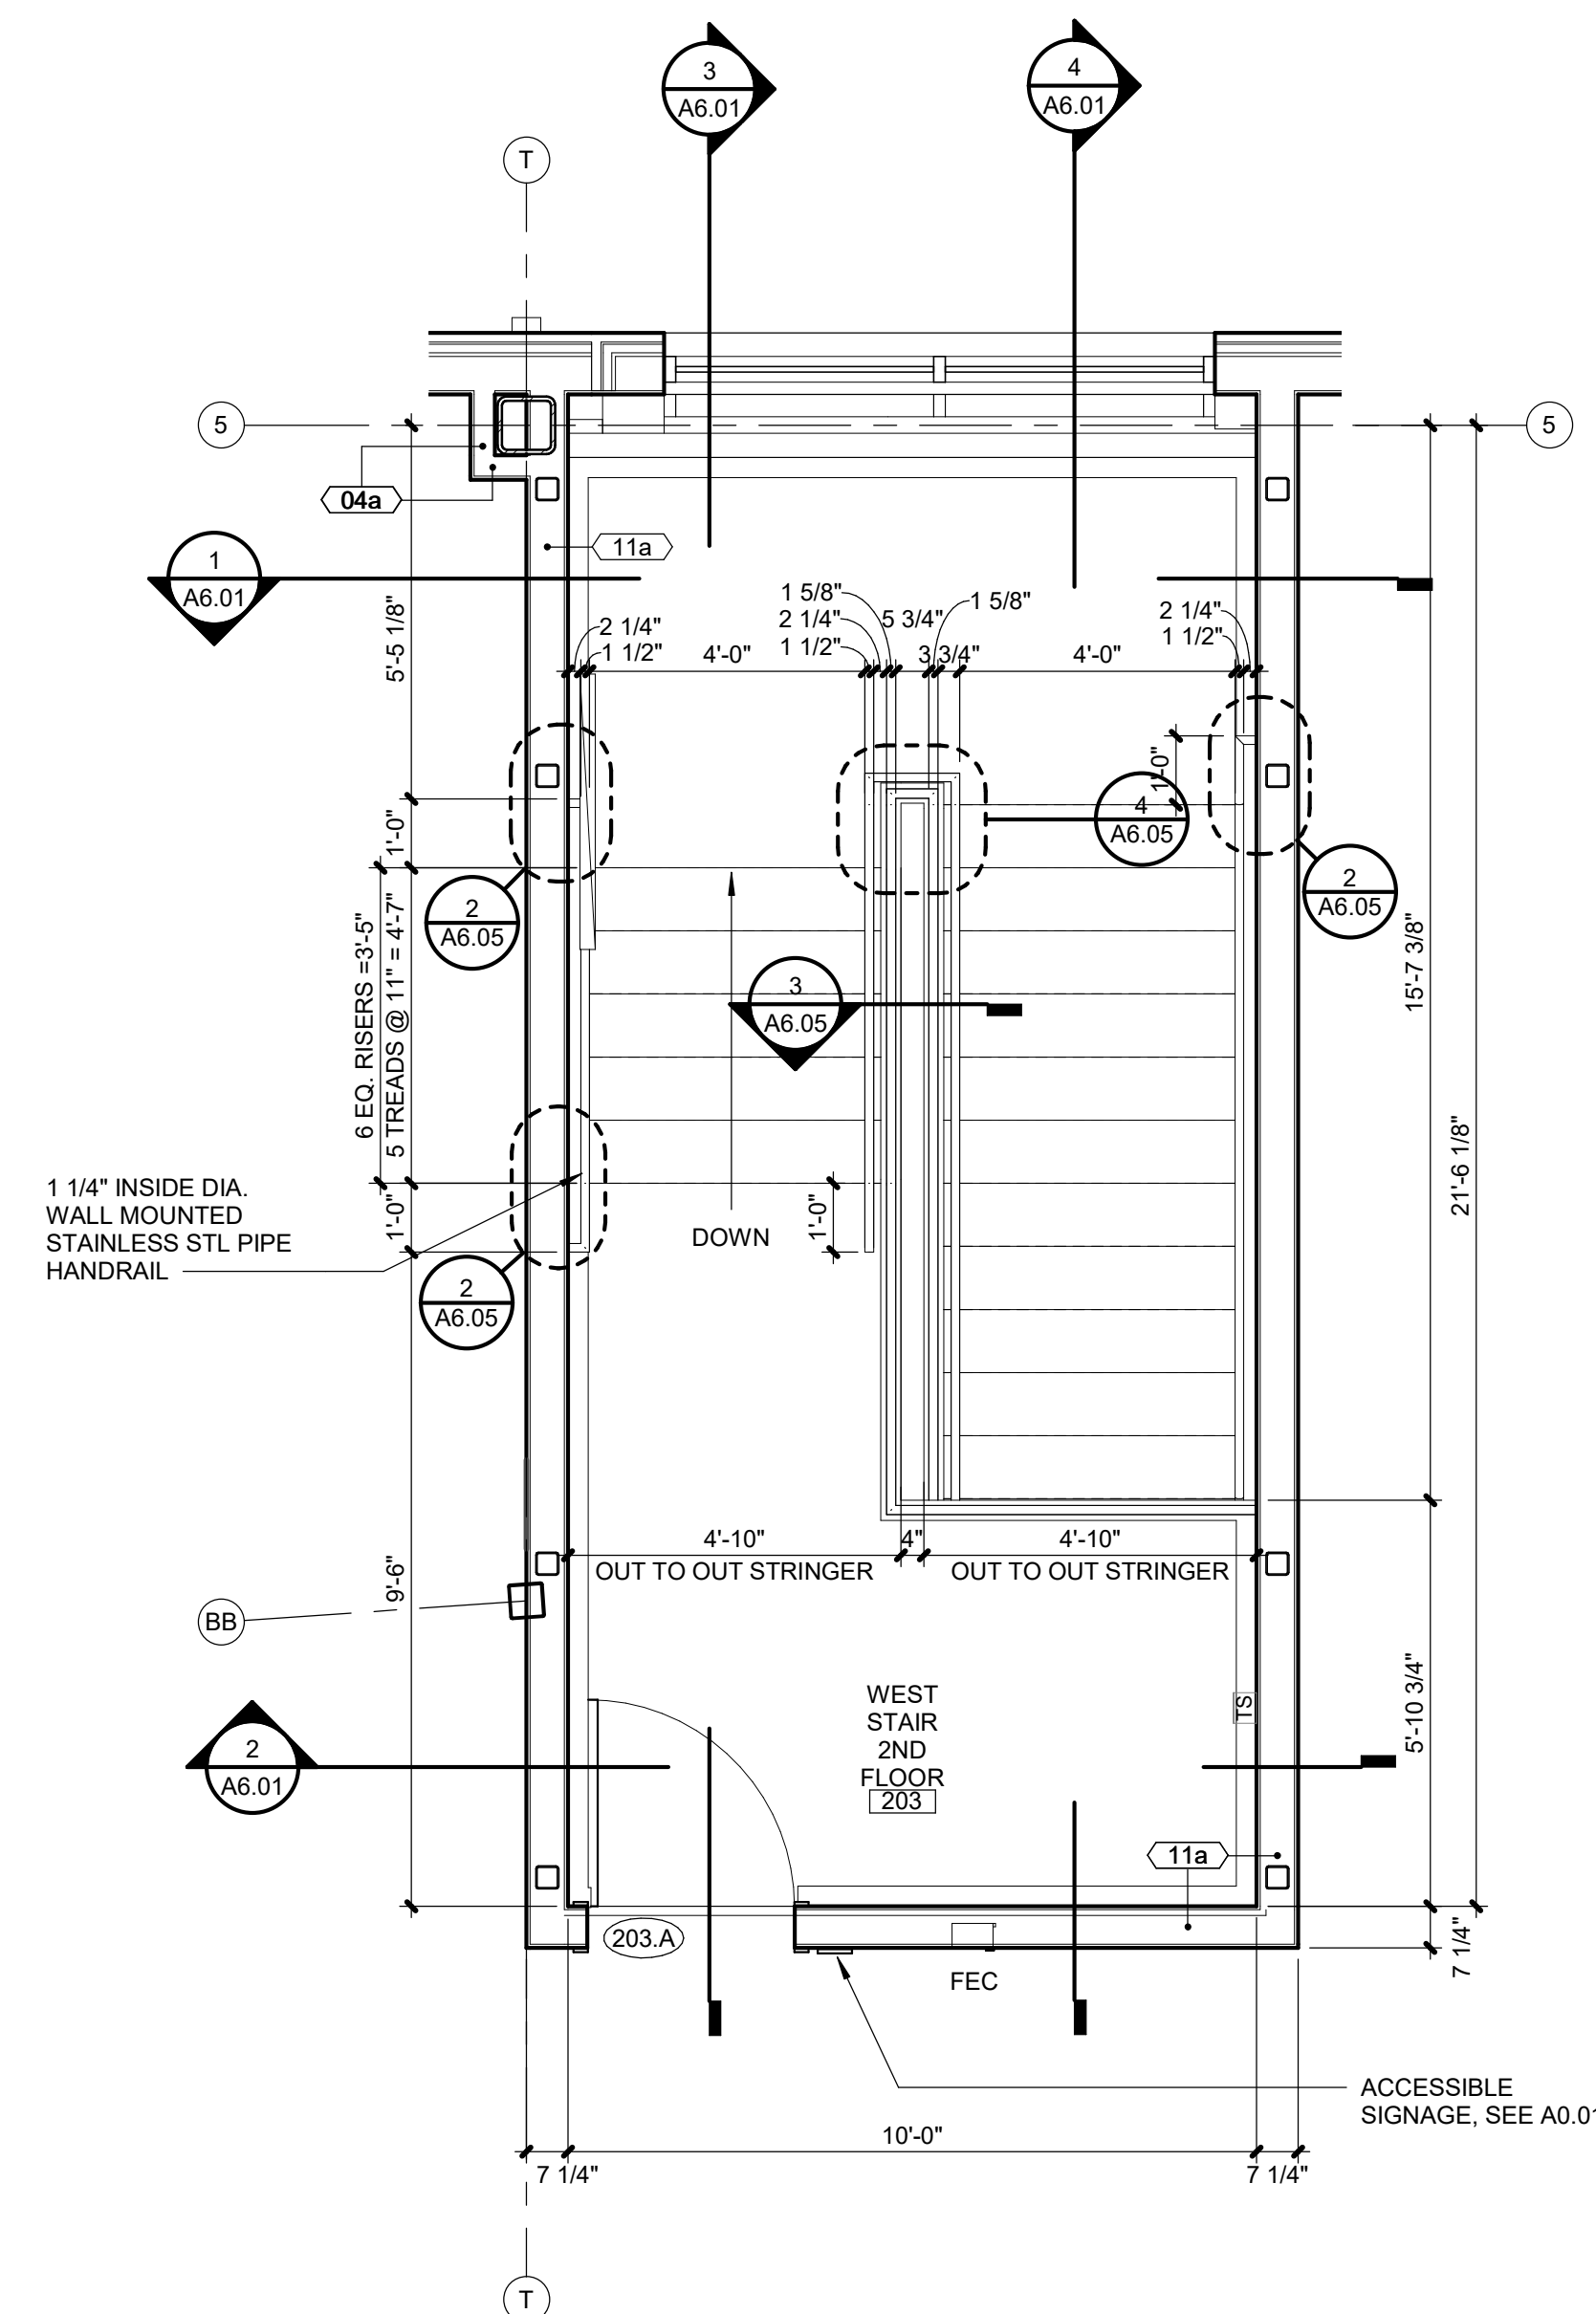
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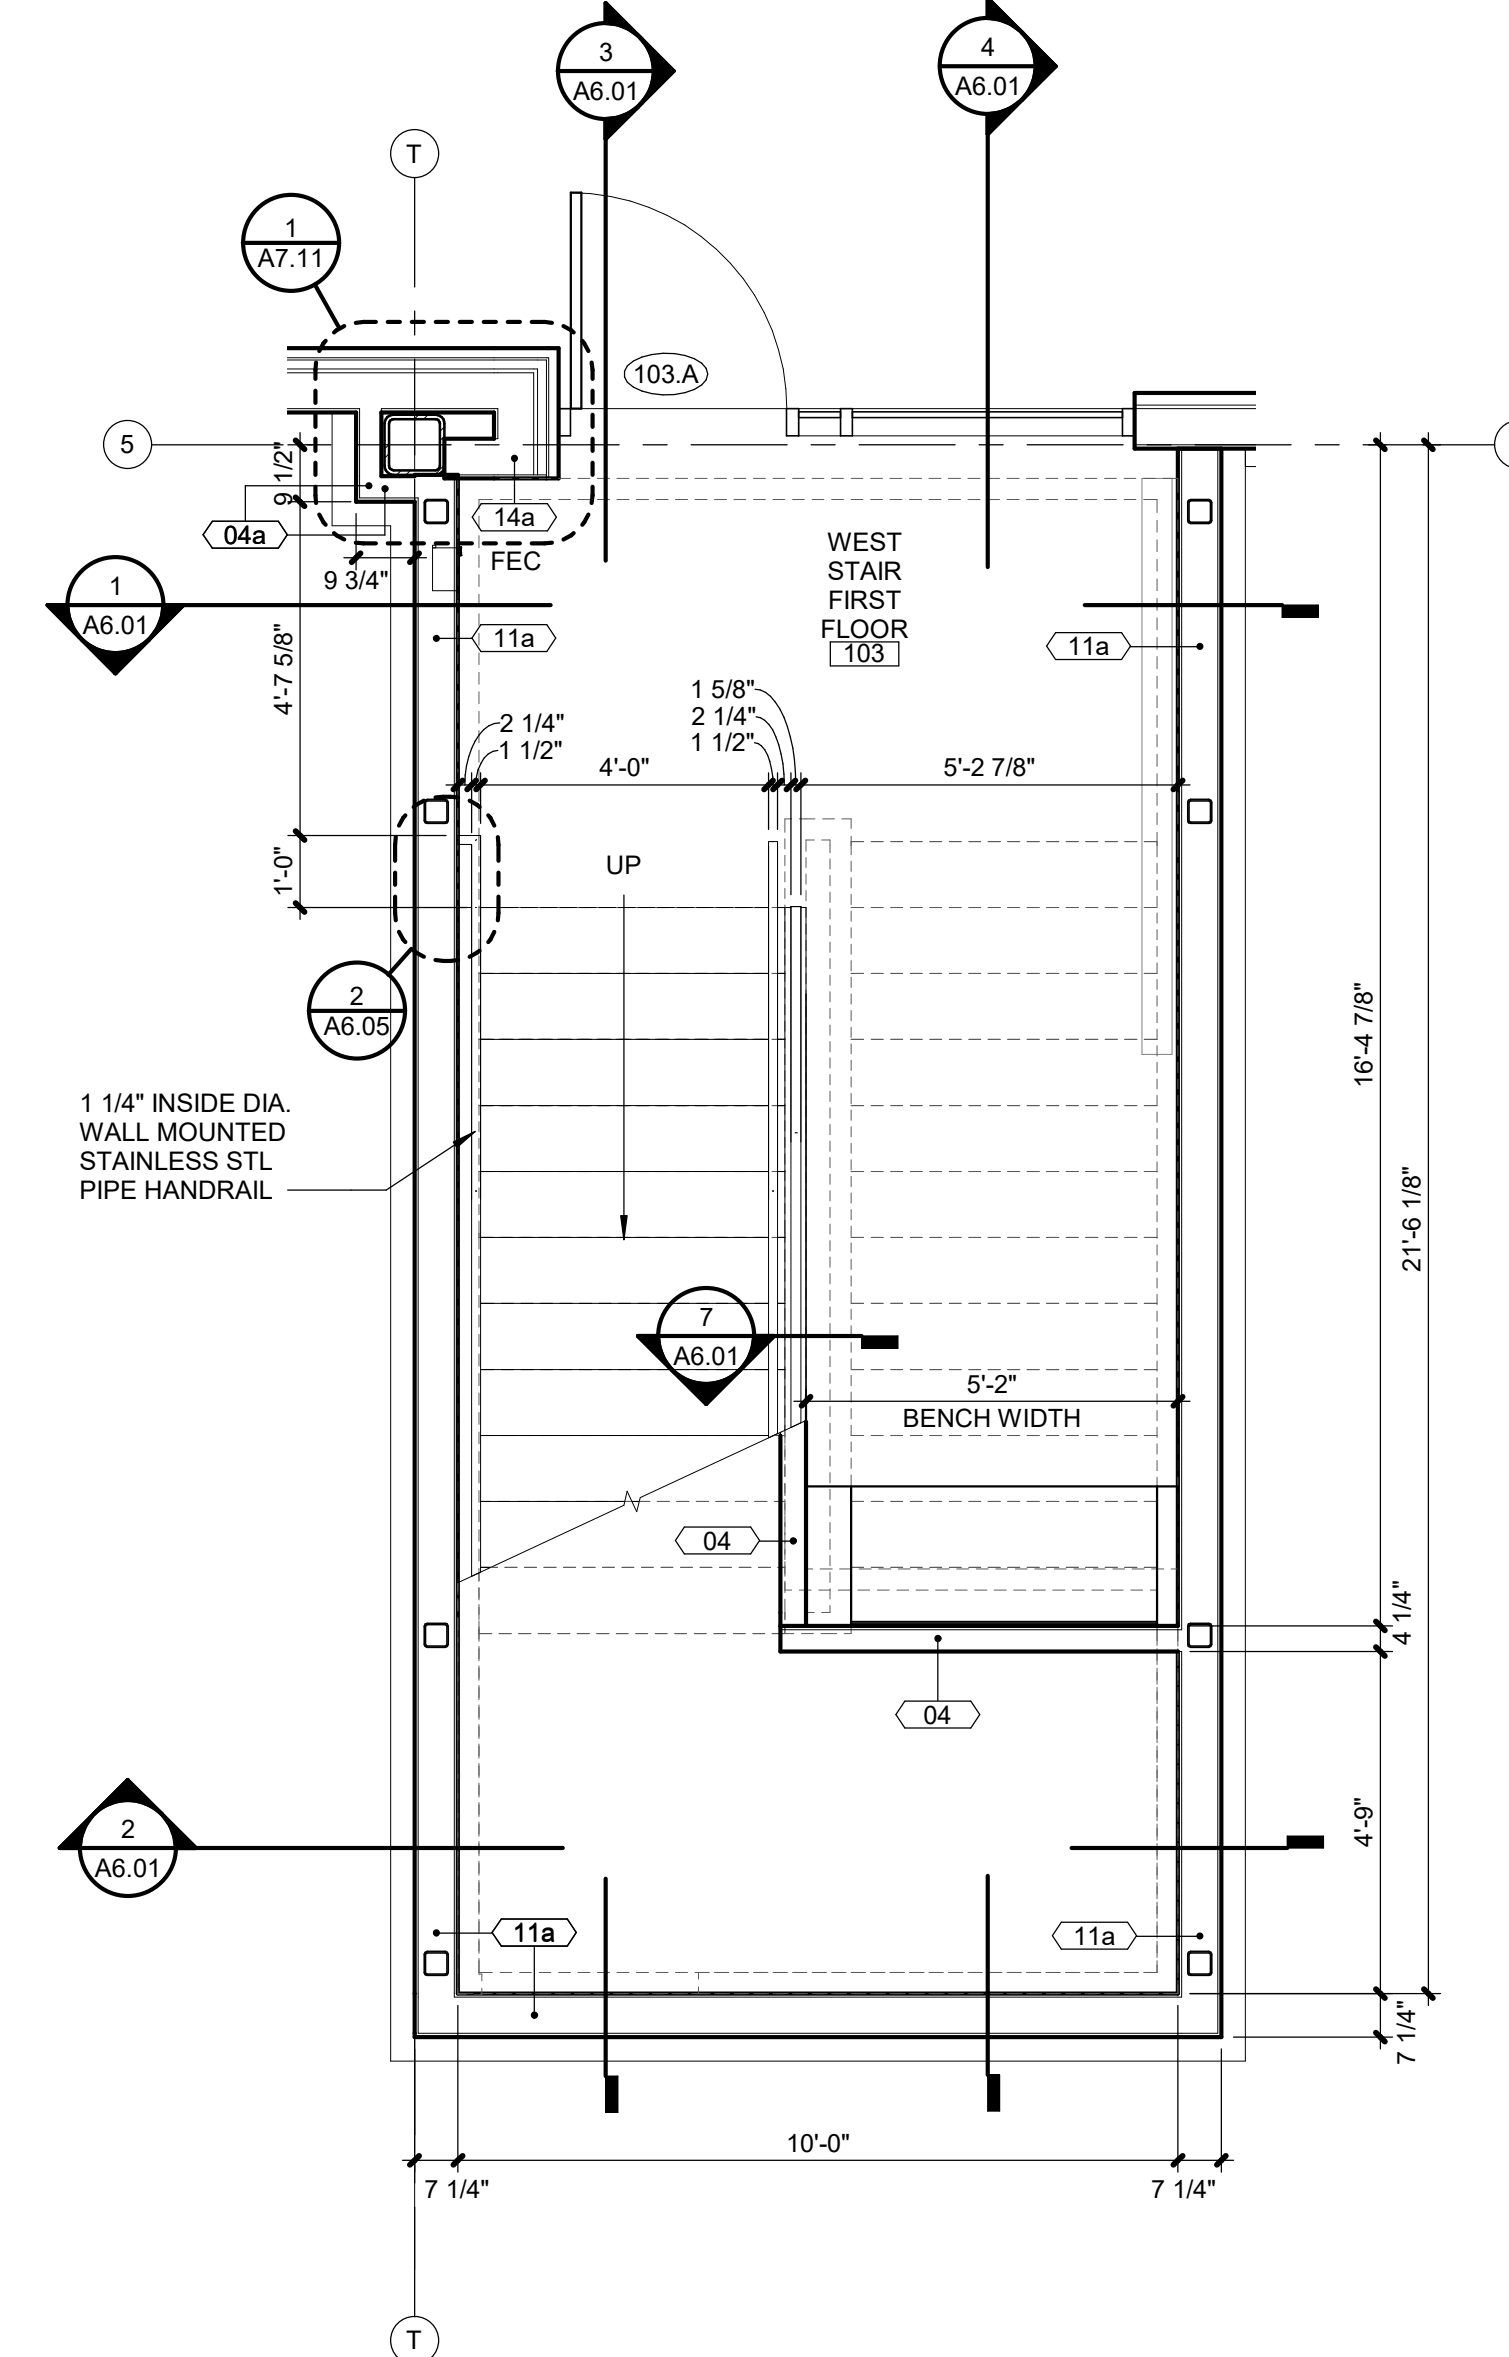
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| <b>A2.02</b> | SCALE : 3/8" = 1'-0" |
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| <b>A2.02</b> | SCALE : 3/8" = 1'-0" |
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| <b>A2.02</b> | SCALE : 3/8" = 1'-0" |
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| <b>A2.02</b> | SCALE : 3/8" = 1'-0" |
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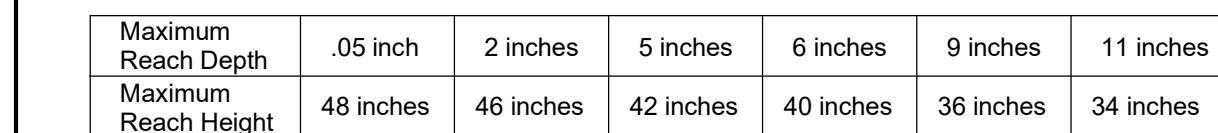
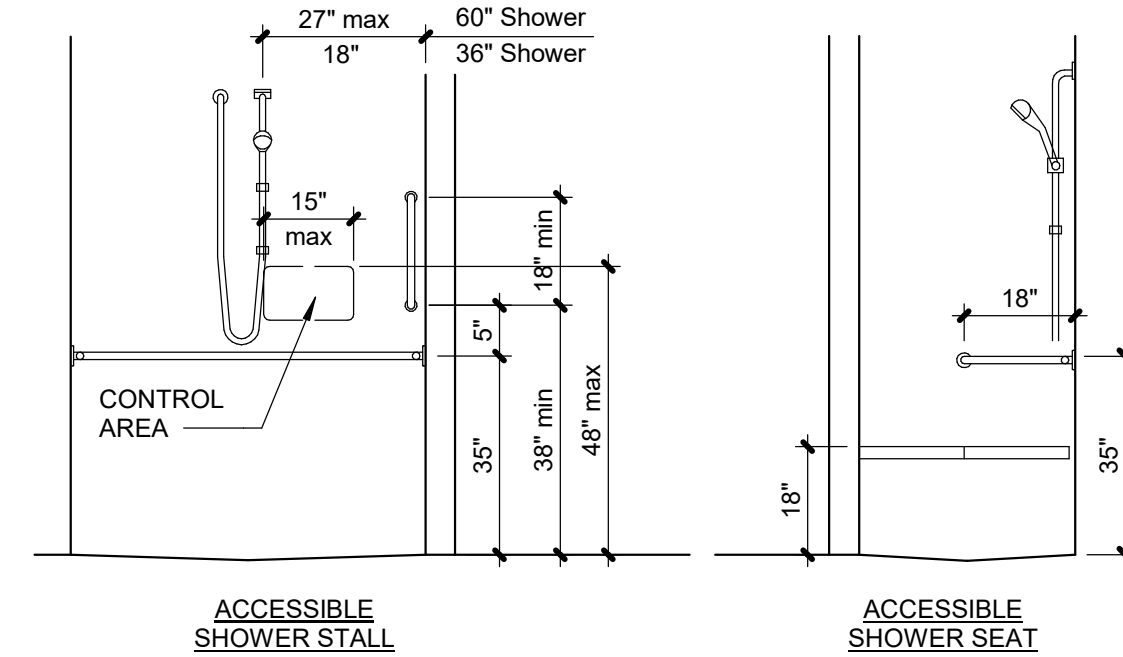
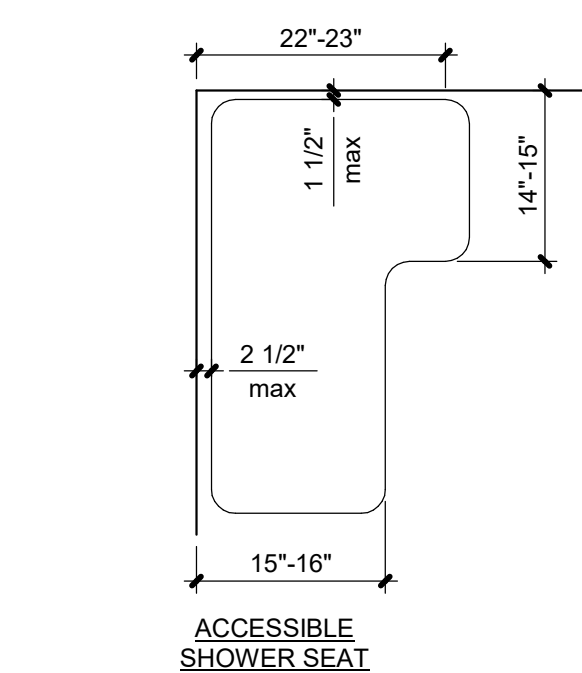
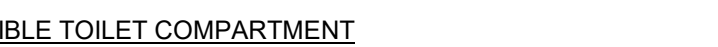
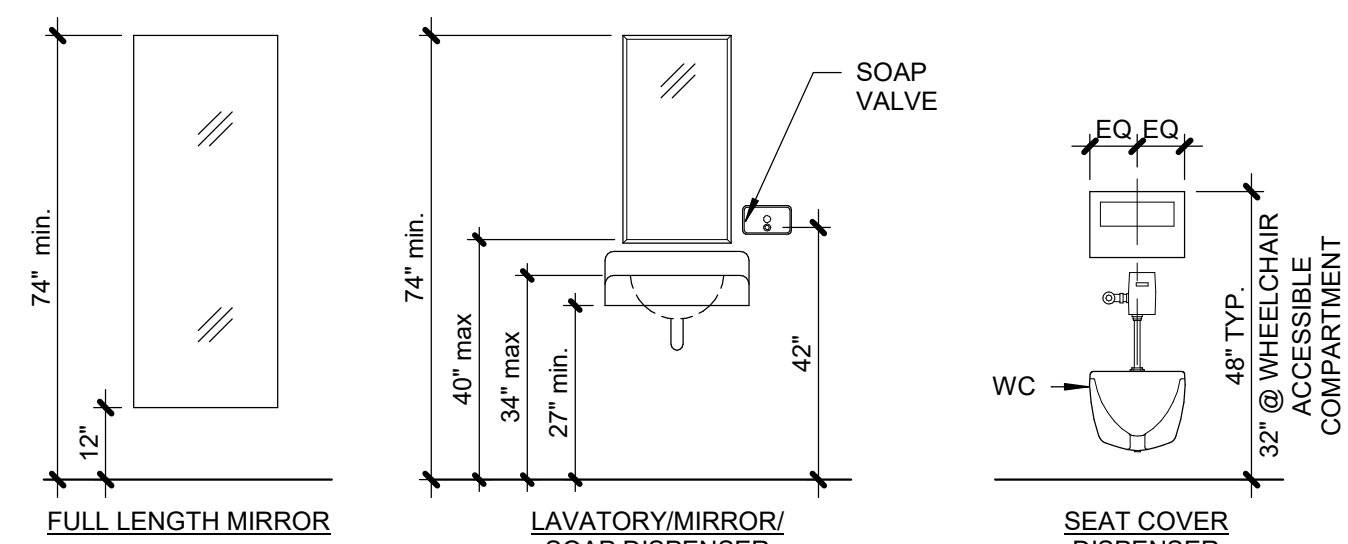


TABLE 603.6 - ANSI-117.1-2009

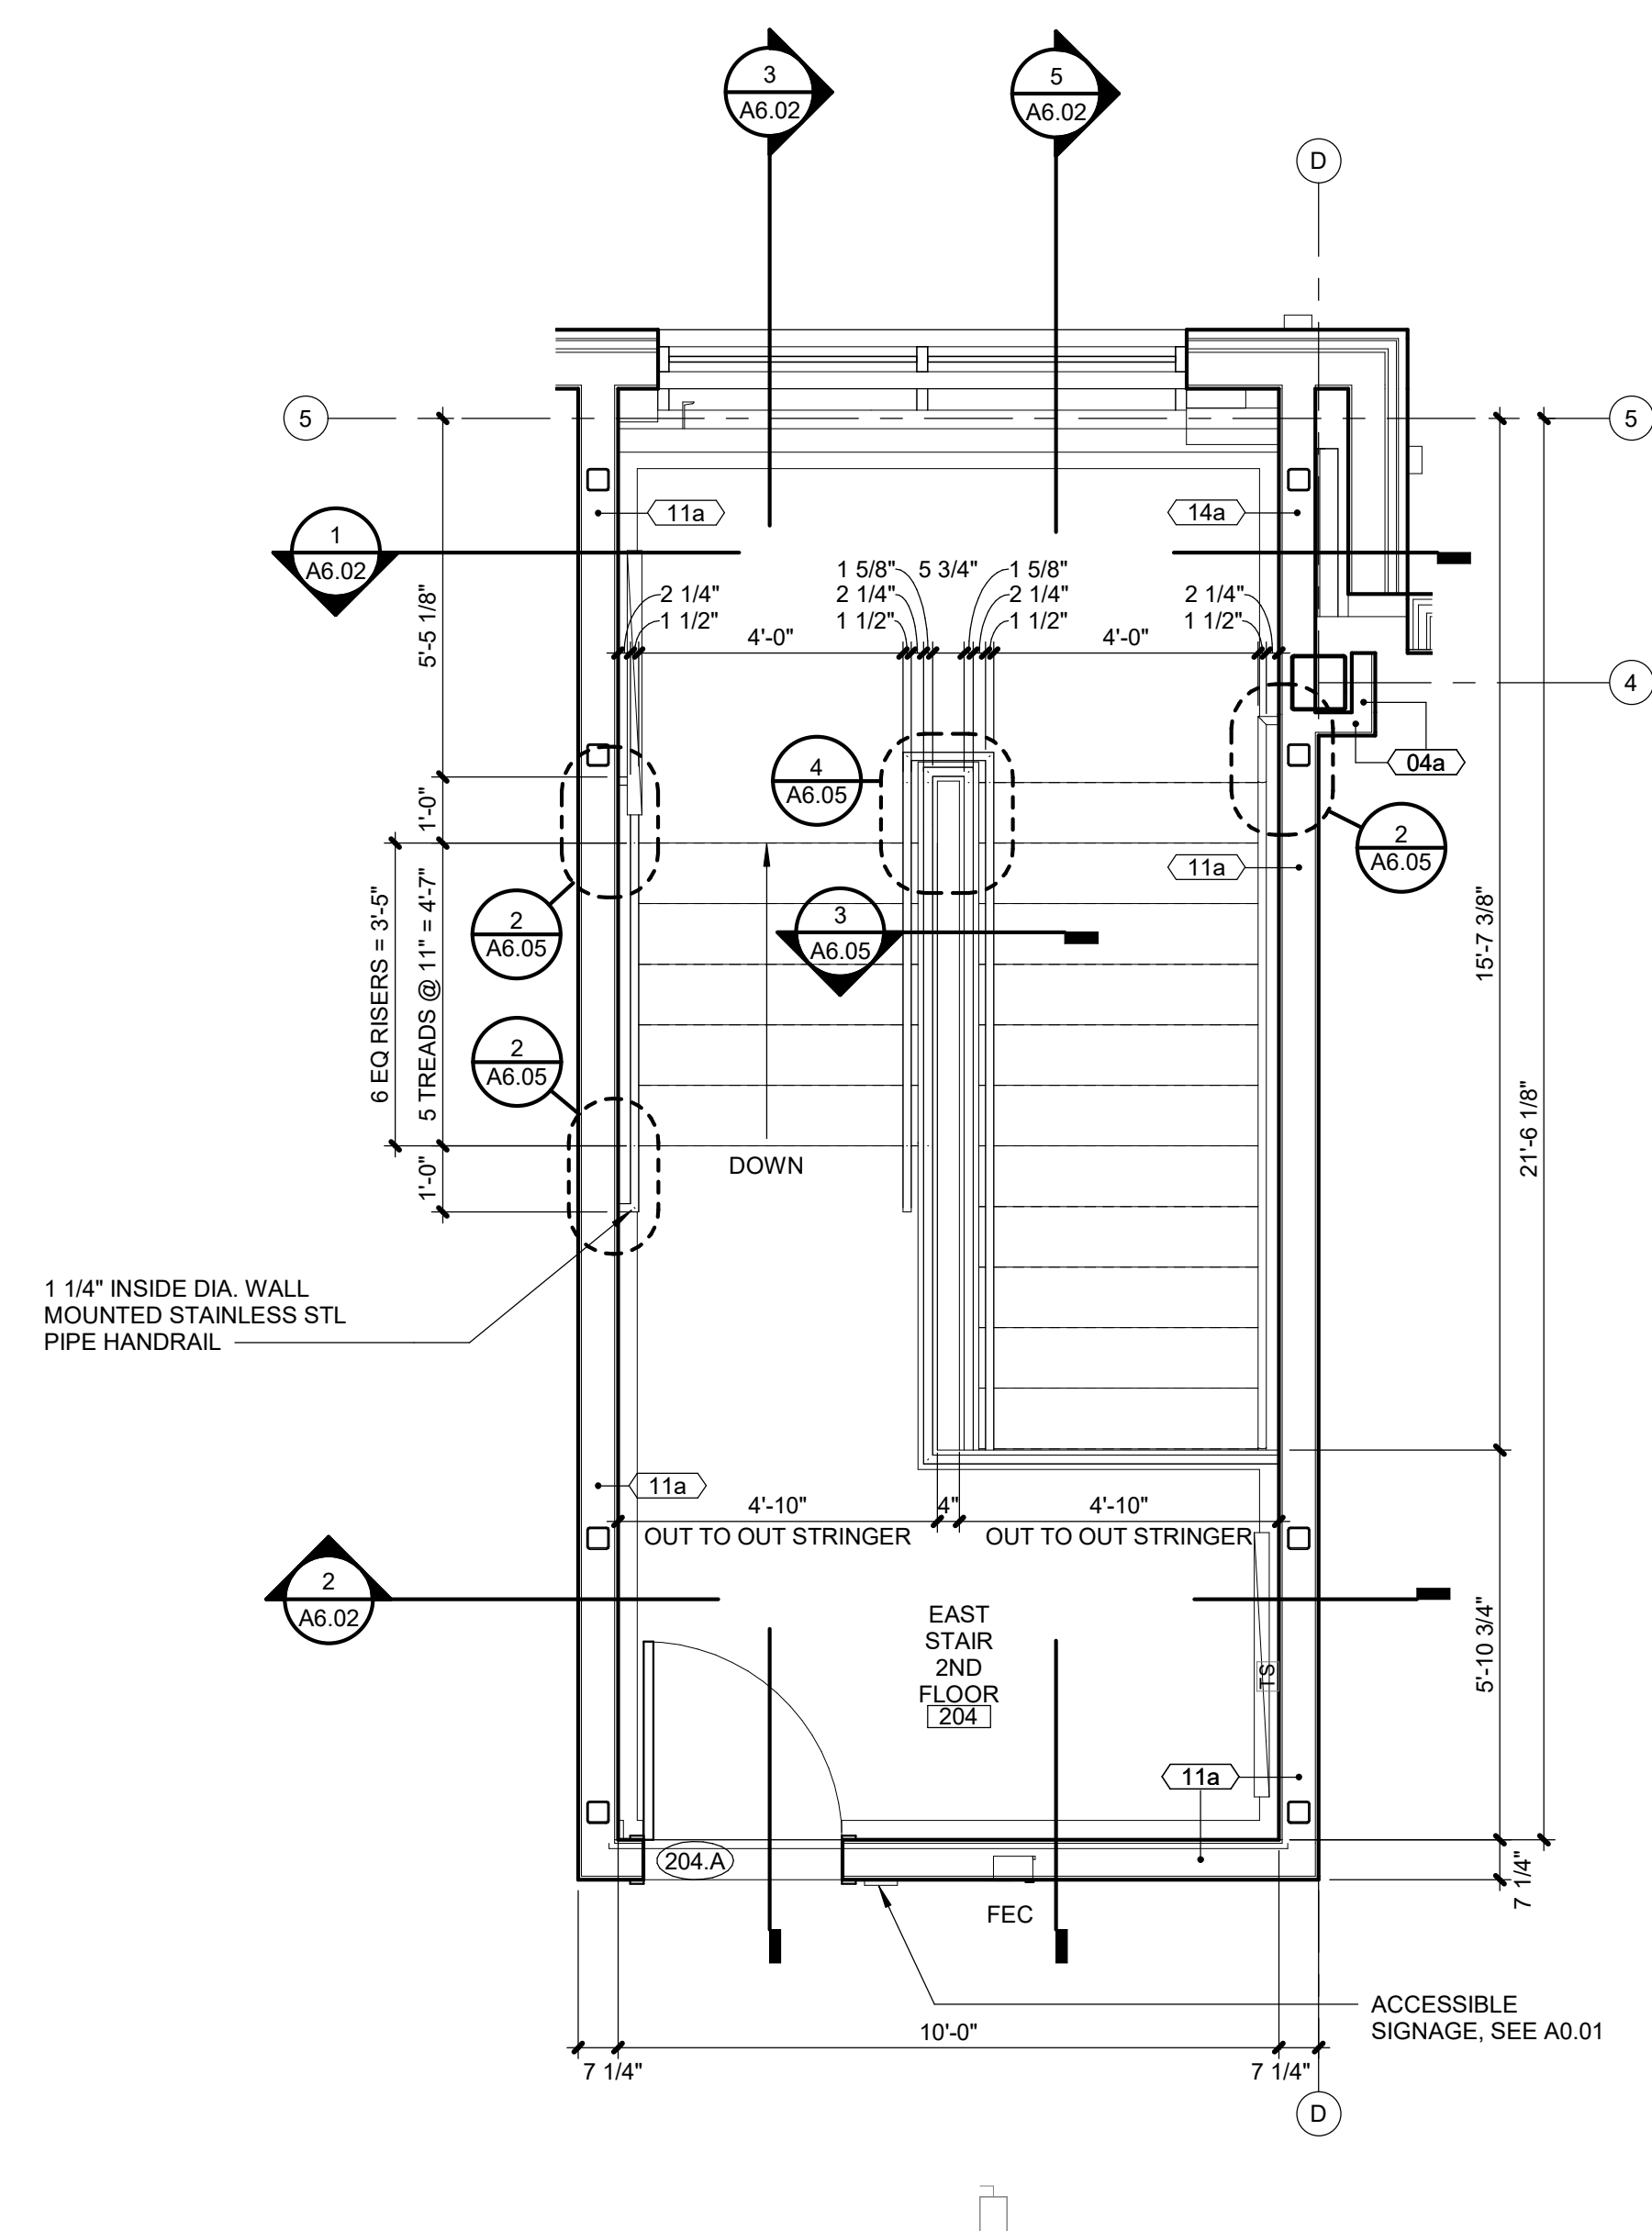

- ALL ACCESSORIES SHALL BE STAINLESS STEEL UNLESS NOTED OTHERWISE.  
ALL ACCESSORIES SHALL BE DESIGNED TO MEET ADA STANDARDS.
- ① COMBINATION PAPER TOWEL DISPENSER/WASTE RECEPTACLE, RECESSED (BOBRICK B-3944)
- ② UNDERMOUNT SINK KIT WITH WASHBAR (BRADLEY WB1-1B-ER1)
- ③ FRAMED MIRROR (42" W X 82" H) PER DIVISION 08
- ④ UNFRAMED MIRROR (30" W X 58" H) PER DIVISION 08
- ⑤ MULTI-ROLL TOWEL TISSUE DISPENSER W/NO KEYPED LOCK (BOBRICK B-2888)
- ⑥ GRAB BARS AS SHOWN ON PLANS AND ELEVATIONS (BOBRICK B-6806 SERIES)
- ⑦ GRAB BAR (BOBRICK B6806 X 42)  
LOCATE AS SHOWN IN ACCESSORY MOUNTING HEIGHTS
- ⑧ GRAB BAR (BOBRICK B6806 X 36)  
LOCATE AS SHOWN IN ACCESSORY MOUNTING HEIGHTS
- ⑨ GRAB BAR (BOBRICK B6806 X 18)  
LOCATE AS SHOWN IN ACCESSORY MOUNTING HEIGHTS
- ⑩ SANITARY NAPKIN DISPOSAL, RECESSED WALL MOUNT (BOBRICK B-353)
- ⑪ HI / LO ADA ACCESSIBLE DRINKING FOUNTAIN W/ BOTTLE FILL AND FILTER (ELKAY LZ1WS-LRPBM28K)
- ⑫ RUBBER TIPPED DOOR BUMPER (BOBRICK B-687)
- ⑬ COAT AND HAT HOOK (BOBRICK B-6827)
- ⑭ A.D.A. RESTROOM SIGNAGE, SEE SHEET A0 01
- ⑮ TOILET SEAT COVER DISPENSER (BOBRICK B-221)
- ⑯ 8" DIA. X 3" S.S. TRASH GROMMET (MOCKET TM2C OR EQ.)

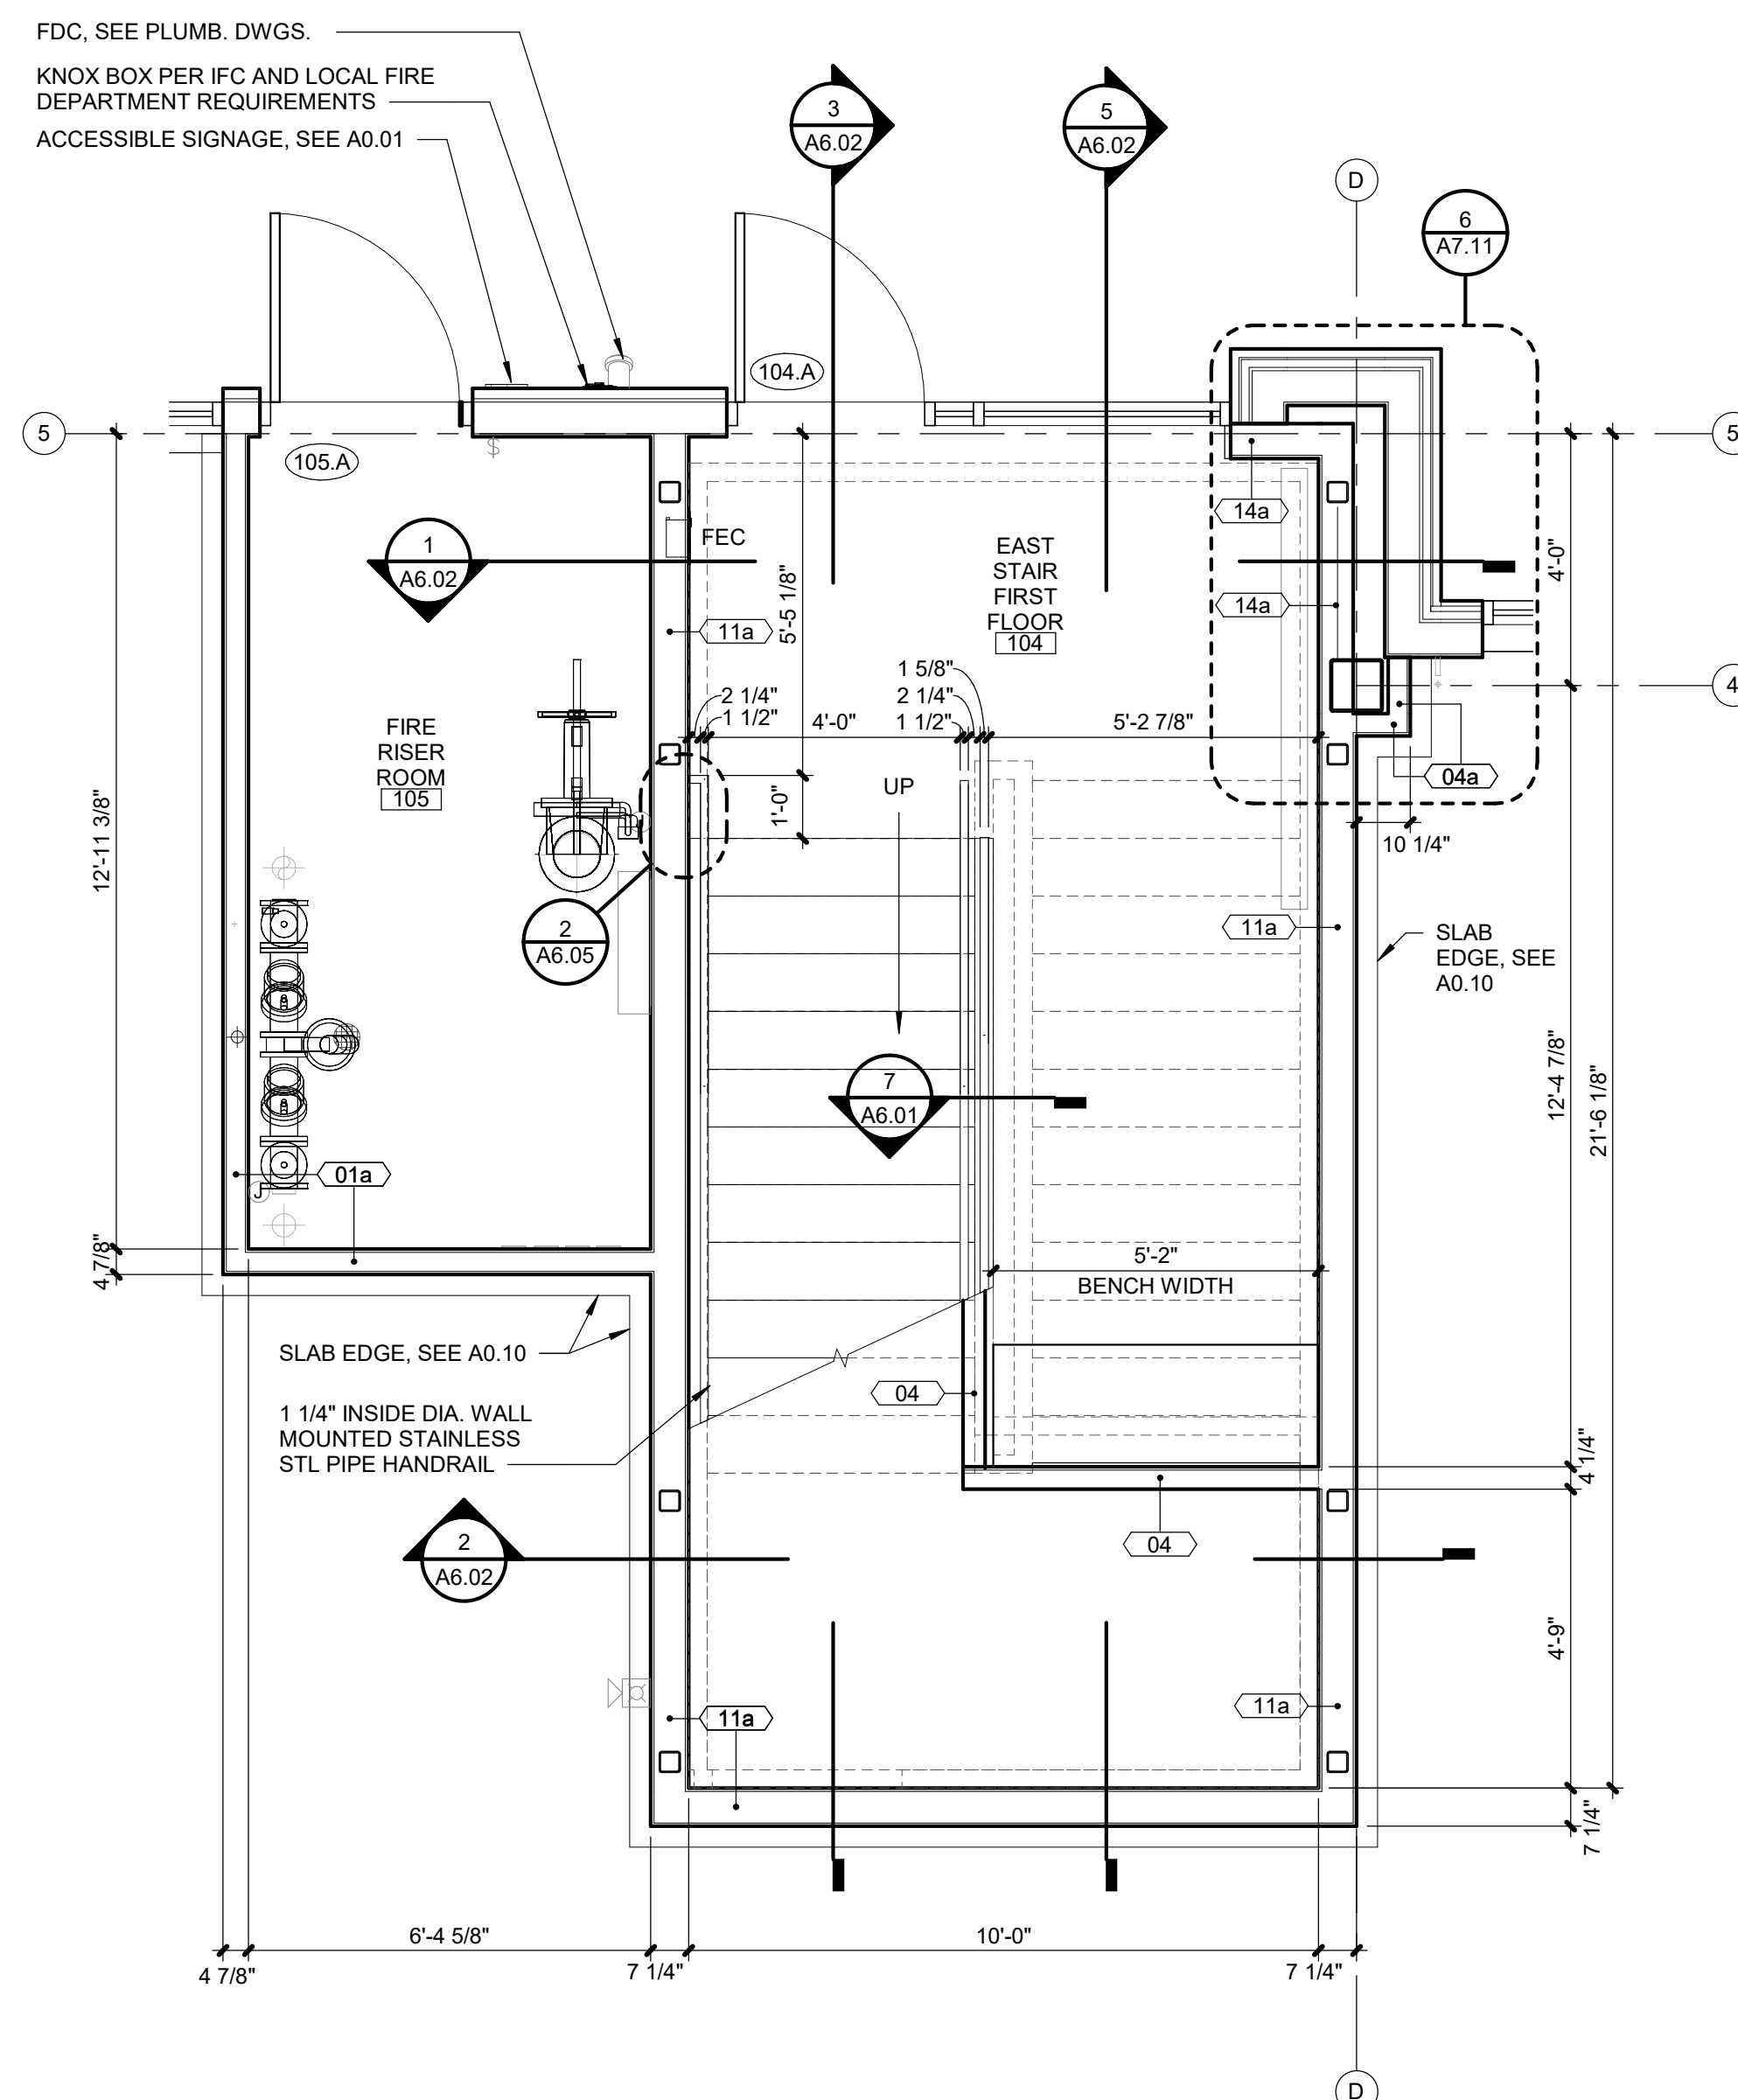

PARAGON STAR  
FIRST PLAT, LOT 9  
LEE'S SUMMIT, MO

Project No.: 19050.01

Date: 10.25.19

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[illegible]

## REGISTRATION



## PROJECT TEAM

|                 |                                 |
|-----------------|---------------------------------|
| ARCHITECT       | FINKLE+WILLIAMS<br>ARCHITECTURE |
| CIVIL           | GBA                             |
| LANDSCAPE       | HOERR SCHAUDT /<br>LAND3        |
| FOUNDATIONS     | BSE STRUCTURAL<br>ENGINEERS     |
| STRUCTURAL      | BSE STRUCTURAL<br>ENGINEERS     |
| PLUMBING        | HENDERSON<br>ENGINEERS          |
| MECHANICAL      | HENDERSON<br>ENGINEERS          |
| ELECTRICAL      | HENDERSON<br>ENGINEERS          |
| FIRE PROTECTION | HENDERSON<br>ENGINEERS          |
| CONTRACTOR      | FOGEL ANDERSON                  |



FINKLE + WILLIAMS  
ARCHITECTURE



7007 College Blvd, Suite 415  
Overland Park, Kansas 66211  
913+498-1550

## SHEET TITLE

## ENLARGED TOILET PLANS AND DETAILS

## SHEET NUMBER

## A2.03

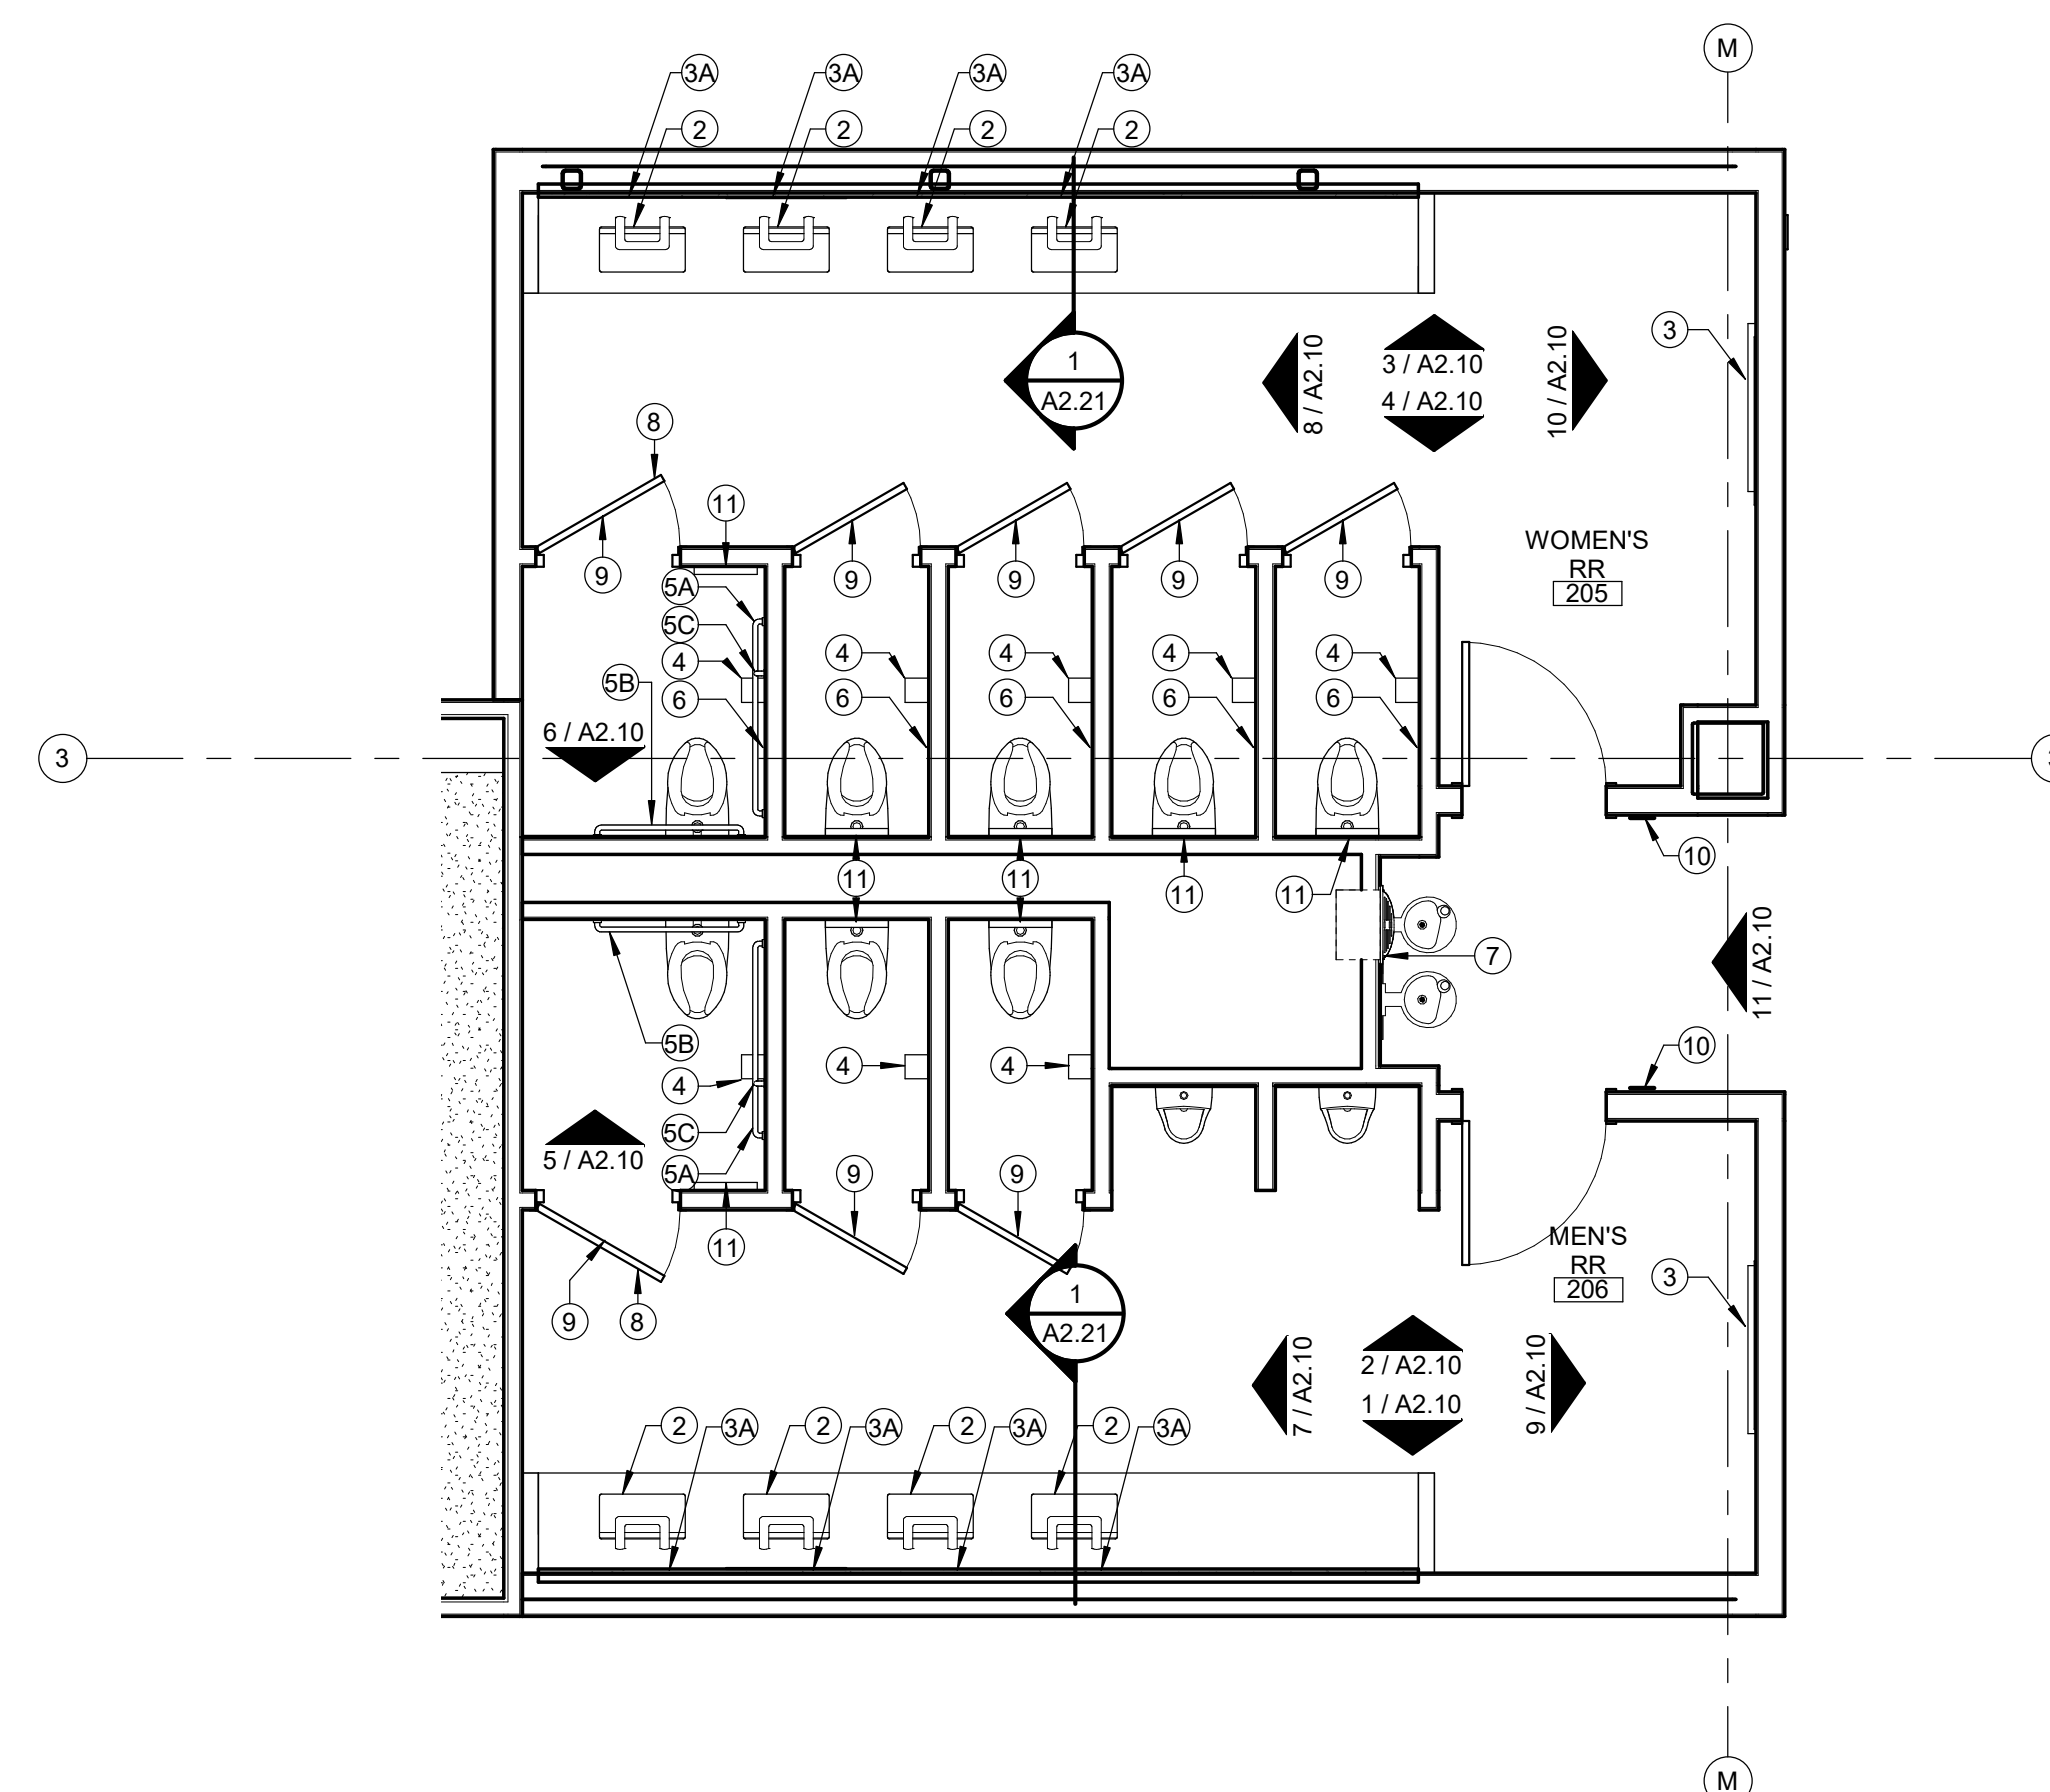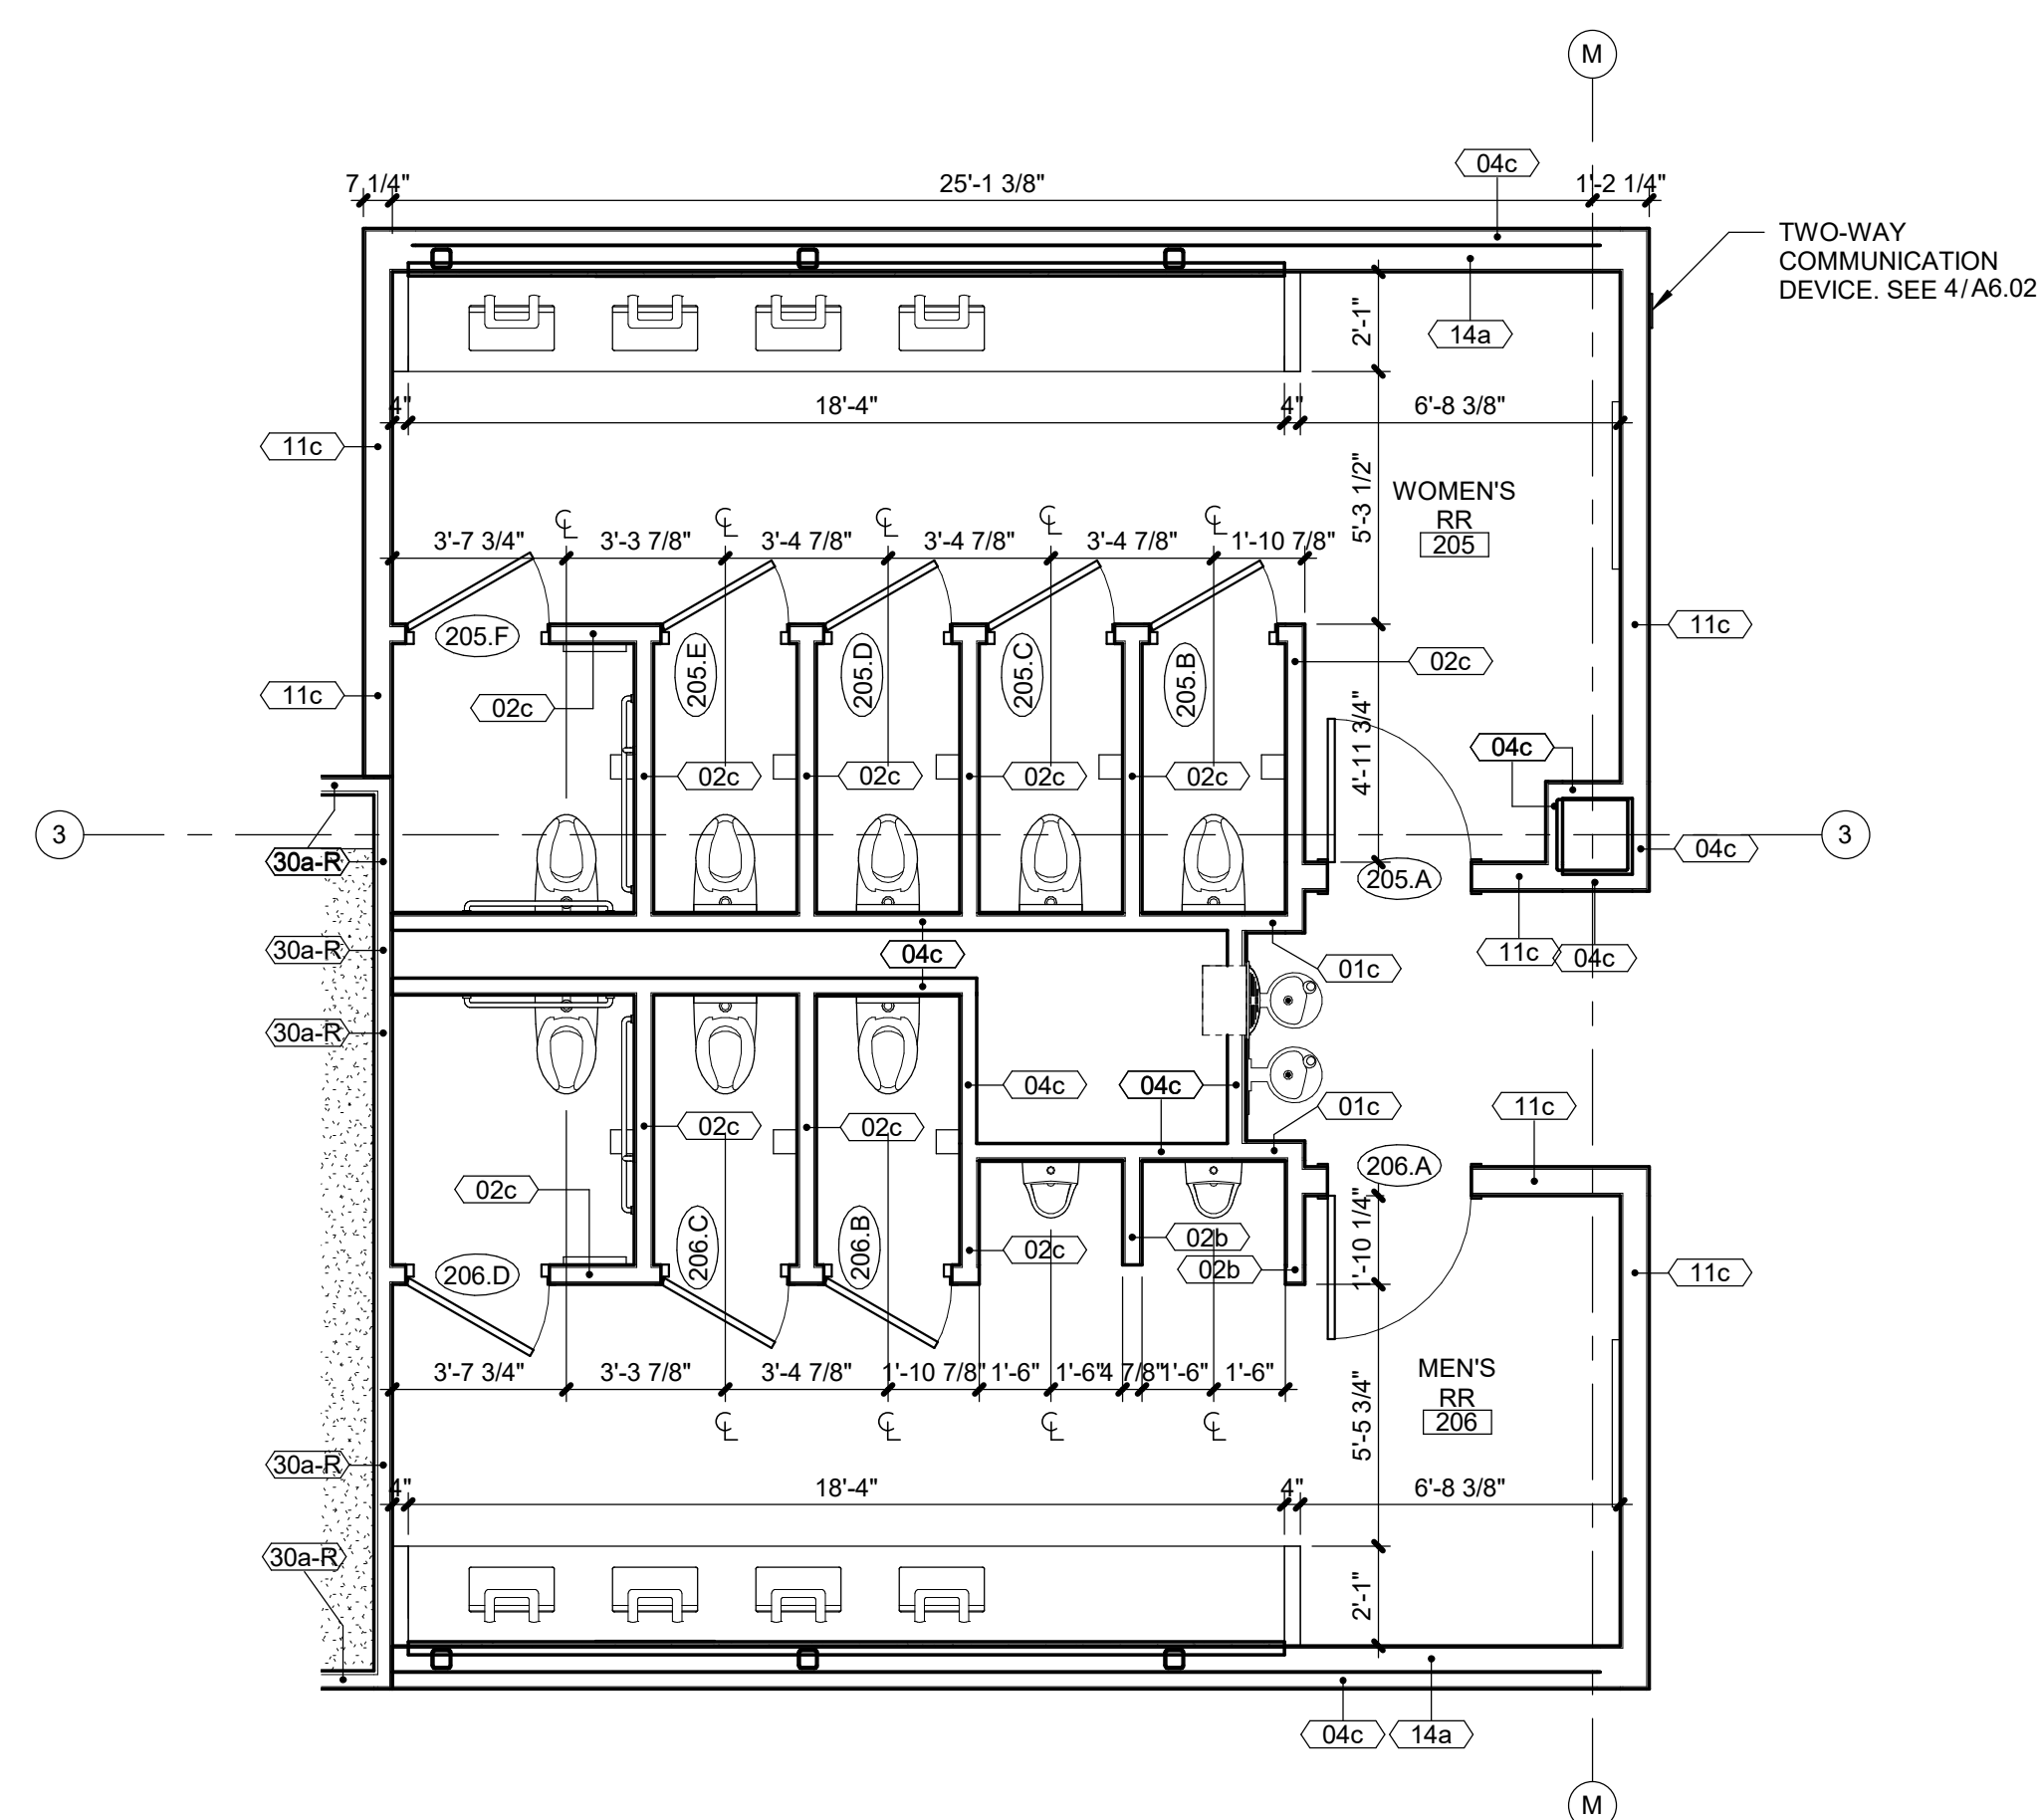



2 CORE ENLARGED FLOOR PLAN - 2ND FLOOR

|              |                      |
|--------------|----------------------|
| <b>A2.03</b> | SCALE : 1/4" = 1'-0" |
|--------------|----------------------|

1 RESTROOM ENLARGED FLOOR PLAN - 2ND FLOOR

|              |                      |
|--------------|----------------------|
| <b>A2.03</b> | SCALE : 1/4" = 1'-0" |
|--------------|----------------------|



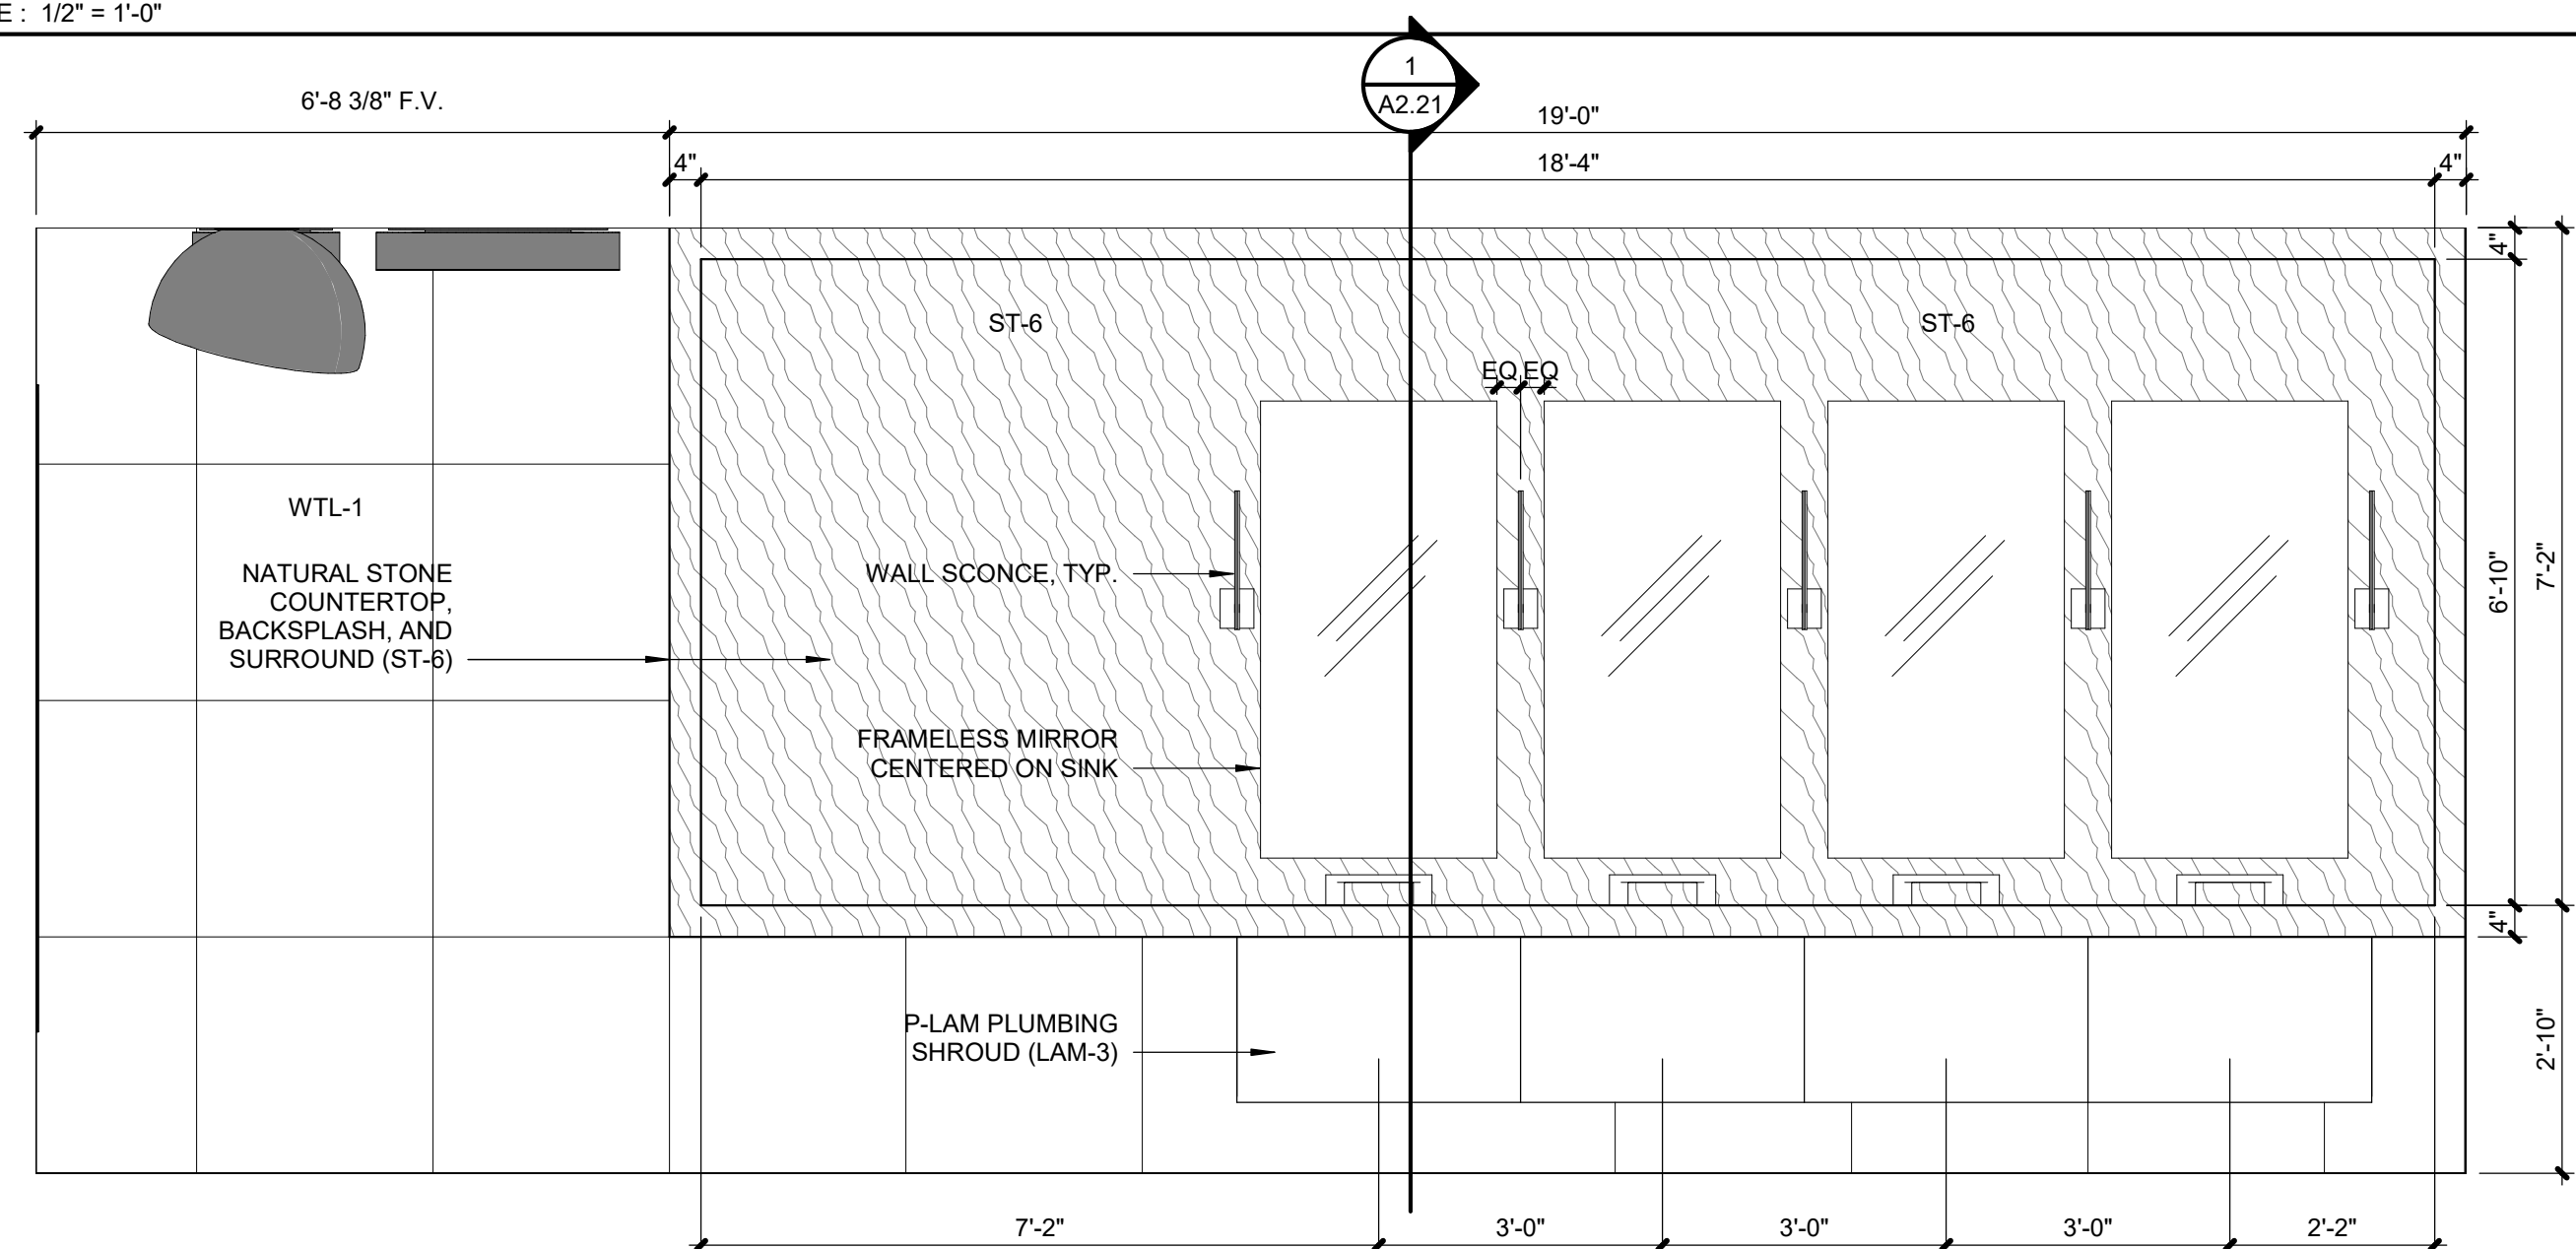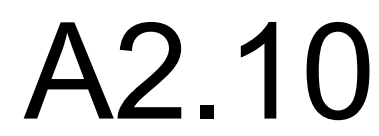

|       |                              |
|-------|------------------------------|
| 1     | MEN'S RESTROOM - ELEVATION D |
| A2.10 | SCALE : 1/2" = 1'-0"         |













Project No.: 19050.01  
Date: 10.25.19  
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REGISTRATION



## PROJECT TEAM

CONTRACTOR      FOGEL ANDERSON




7007 College Blvd, Suite 415  
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913-498-1550

SHEET TITLE


## OVERALL ROOF PLAN


SHEET NUMBER

## A3.01

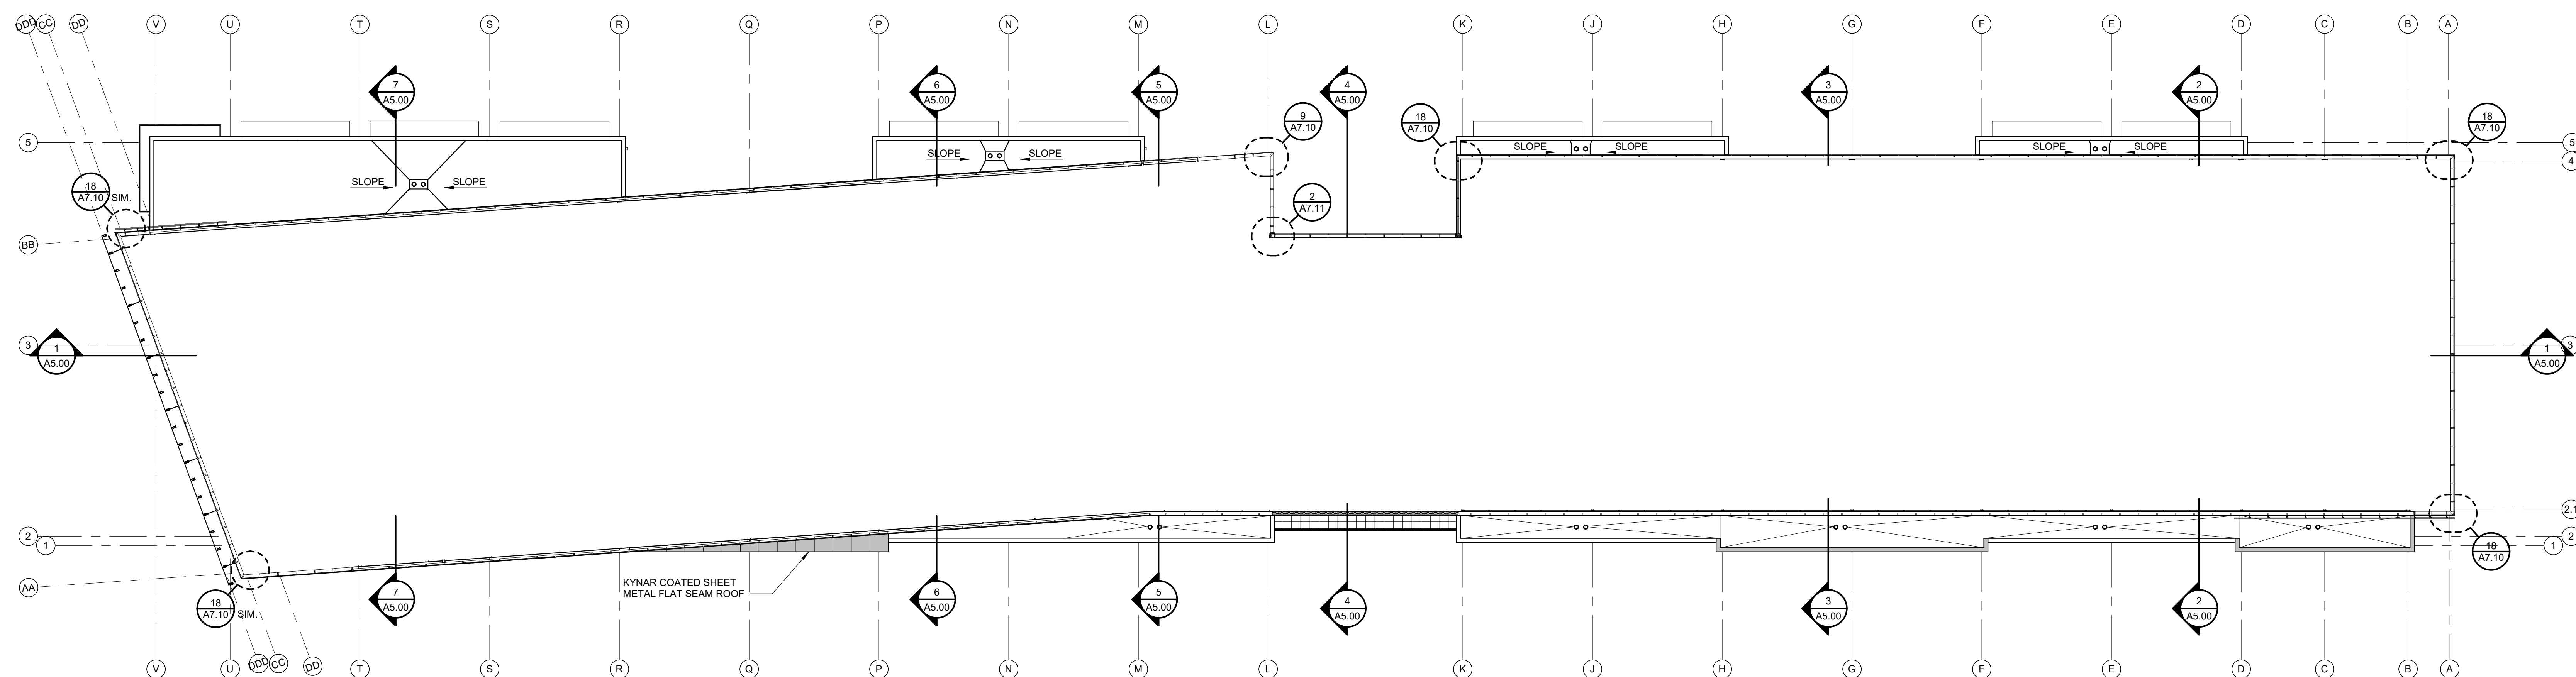

|       |                            |   |
|-------|----------------------------|---|
| 2     | LOW ROOF / CLERESTORY PLAN |  |
| A3.01 | SCALE : 1/16" = 1'-0"      |   |

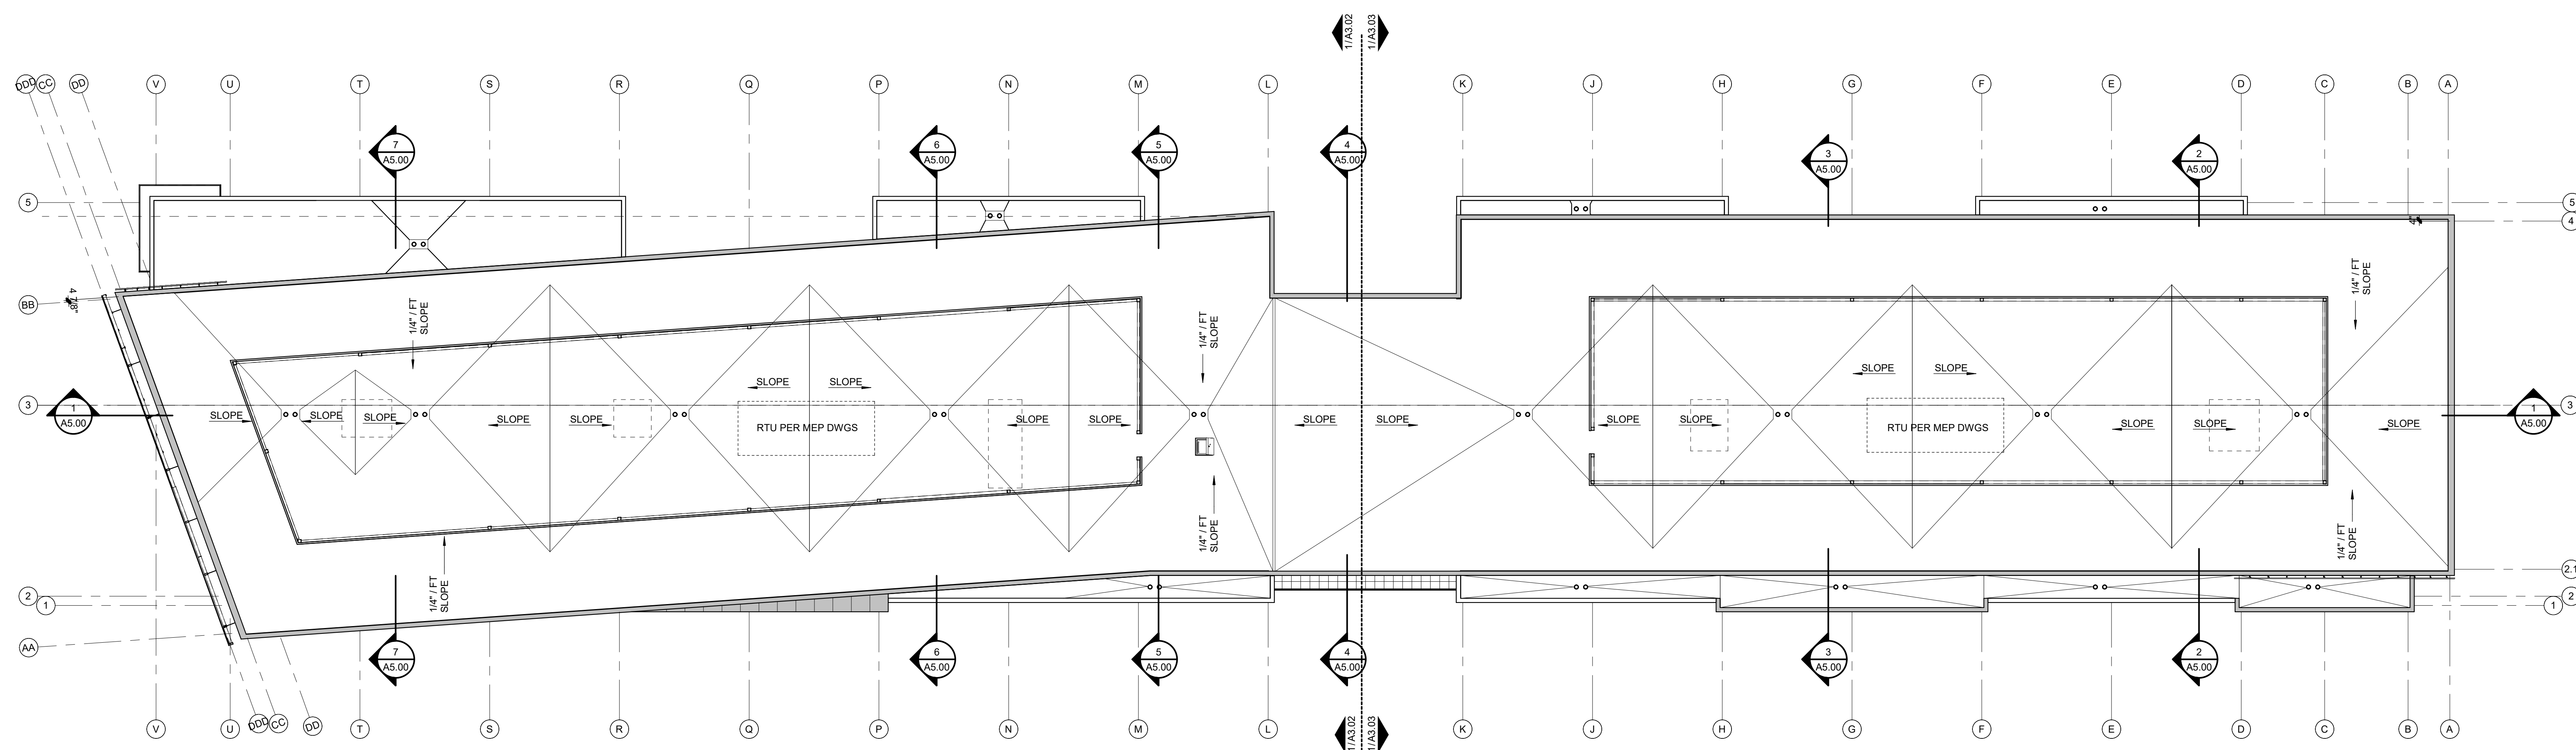

|       |                       |   |
|-------|-----------------------|---|
| 1     | ROOF PLAN             |  |
| A3.01 | SCALE : 1/16" = 1'-0" |   |

### ROOF PLAN GENERAL NOTES

1. THE SINGLE PLY ROOF SHALL BE TPO, 60 MIL, WHITE MEMBRANE, FULLY ADHERED, W/ A 20 YEAR NO DOLLAR LIMIT MANUFACTURER'S WARRANTY.
2. ROOF DRAINS ARE TO BE COLLECTED UNDERGROUND AND CONTINUED PER CIVIL ENGINEERING PLANS.
3. SEE SHEET A3.05 FOR TYPICAL ROOF DETAILS.
4. SEE PLUMBING AND MECHANICAL PLANS FOR ROOF TOP EQUIPMENT AND PENETRATION LOCATIONS.






PARAGON STAR  
FIRST PLAT, LOT 9  
LEE'S SUMMIT, MO

Project No.: 19050.01  
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REGISTRATION



## PROJECT TEAM
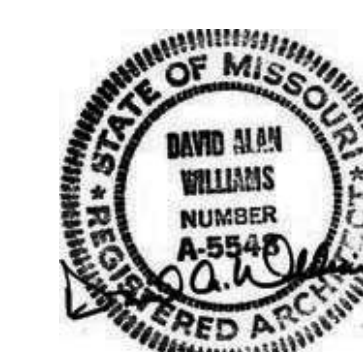
|                 |                                 |
|-----------------|---------------------------------|
| ARCHITECT       | FINKLE+WILLIAMS<br>ARCHITECTURE |
| CIVIL           | G&A                             |
| LANDSCAPE       | HOERR SCHAUDT /<br>LAND3        |
| FOUNDATIONS     | BSE STRUCTURAL<br>ENGINEERS     |
| STRUCTURAL      | BSE STRUCTURAL<br>ENGINEERS     |
| PLUMBING        | HENDERSON<br>ENGINEERS          |
| MECHANICAL      | HENDERSON<br>ENGINEERS          |
| ELECTRICAL      | HENDERSON<br>ENGINEERS          |
| FIRE PROTECTION | HENDERSON<br>ENGINEERS          |
| CONTRACTOR      | FOGEL ANDERSON                  |



FINKLE + WILLIAMS  
ARCHITECTURE


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SHEET TITLE

ROOF PLAN  
WEST

SHEET NUMBER


## A3.02

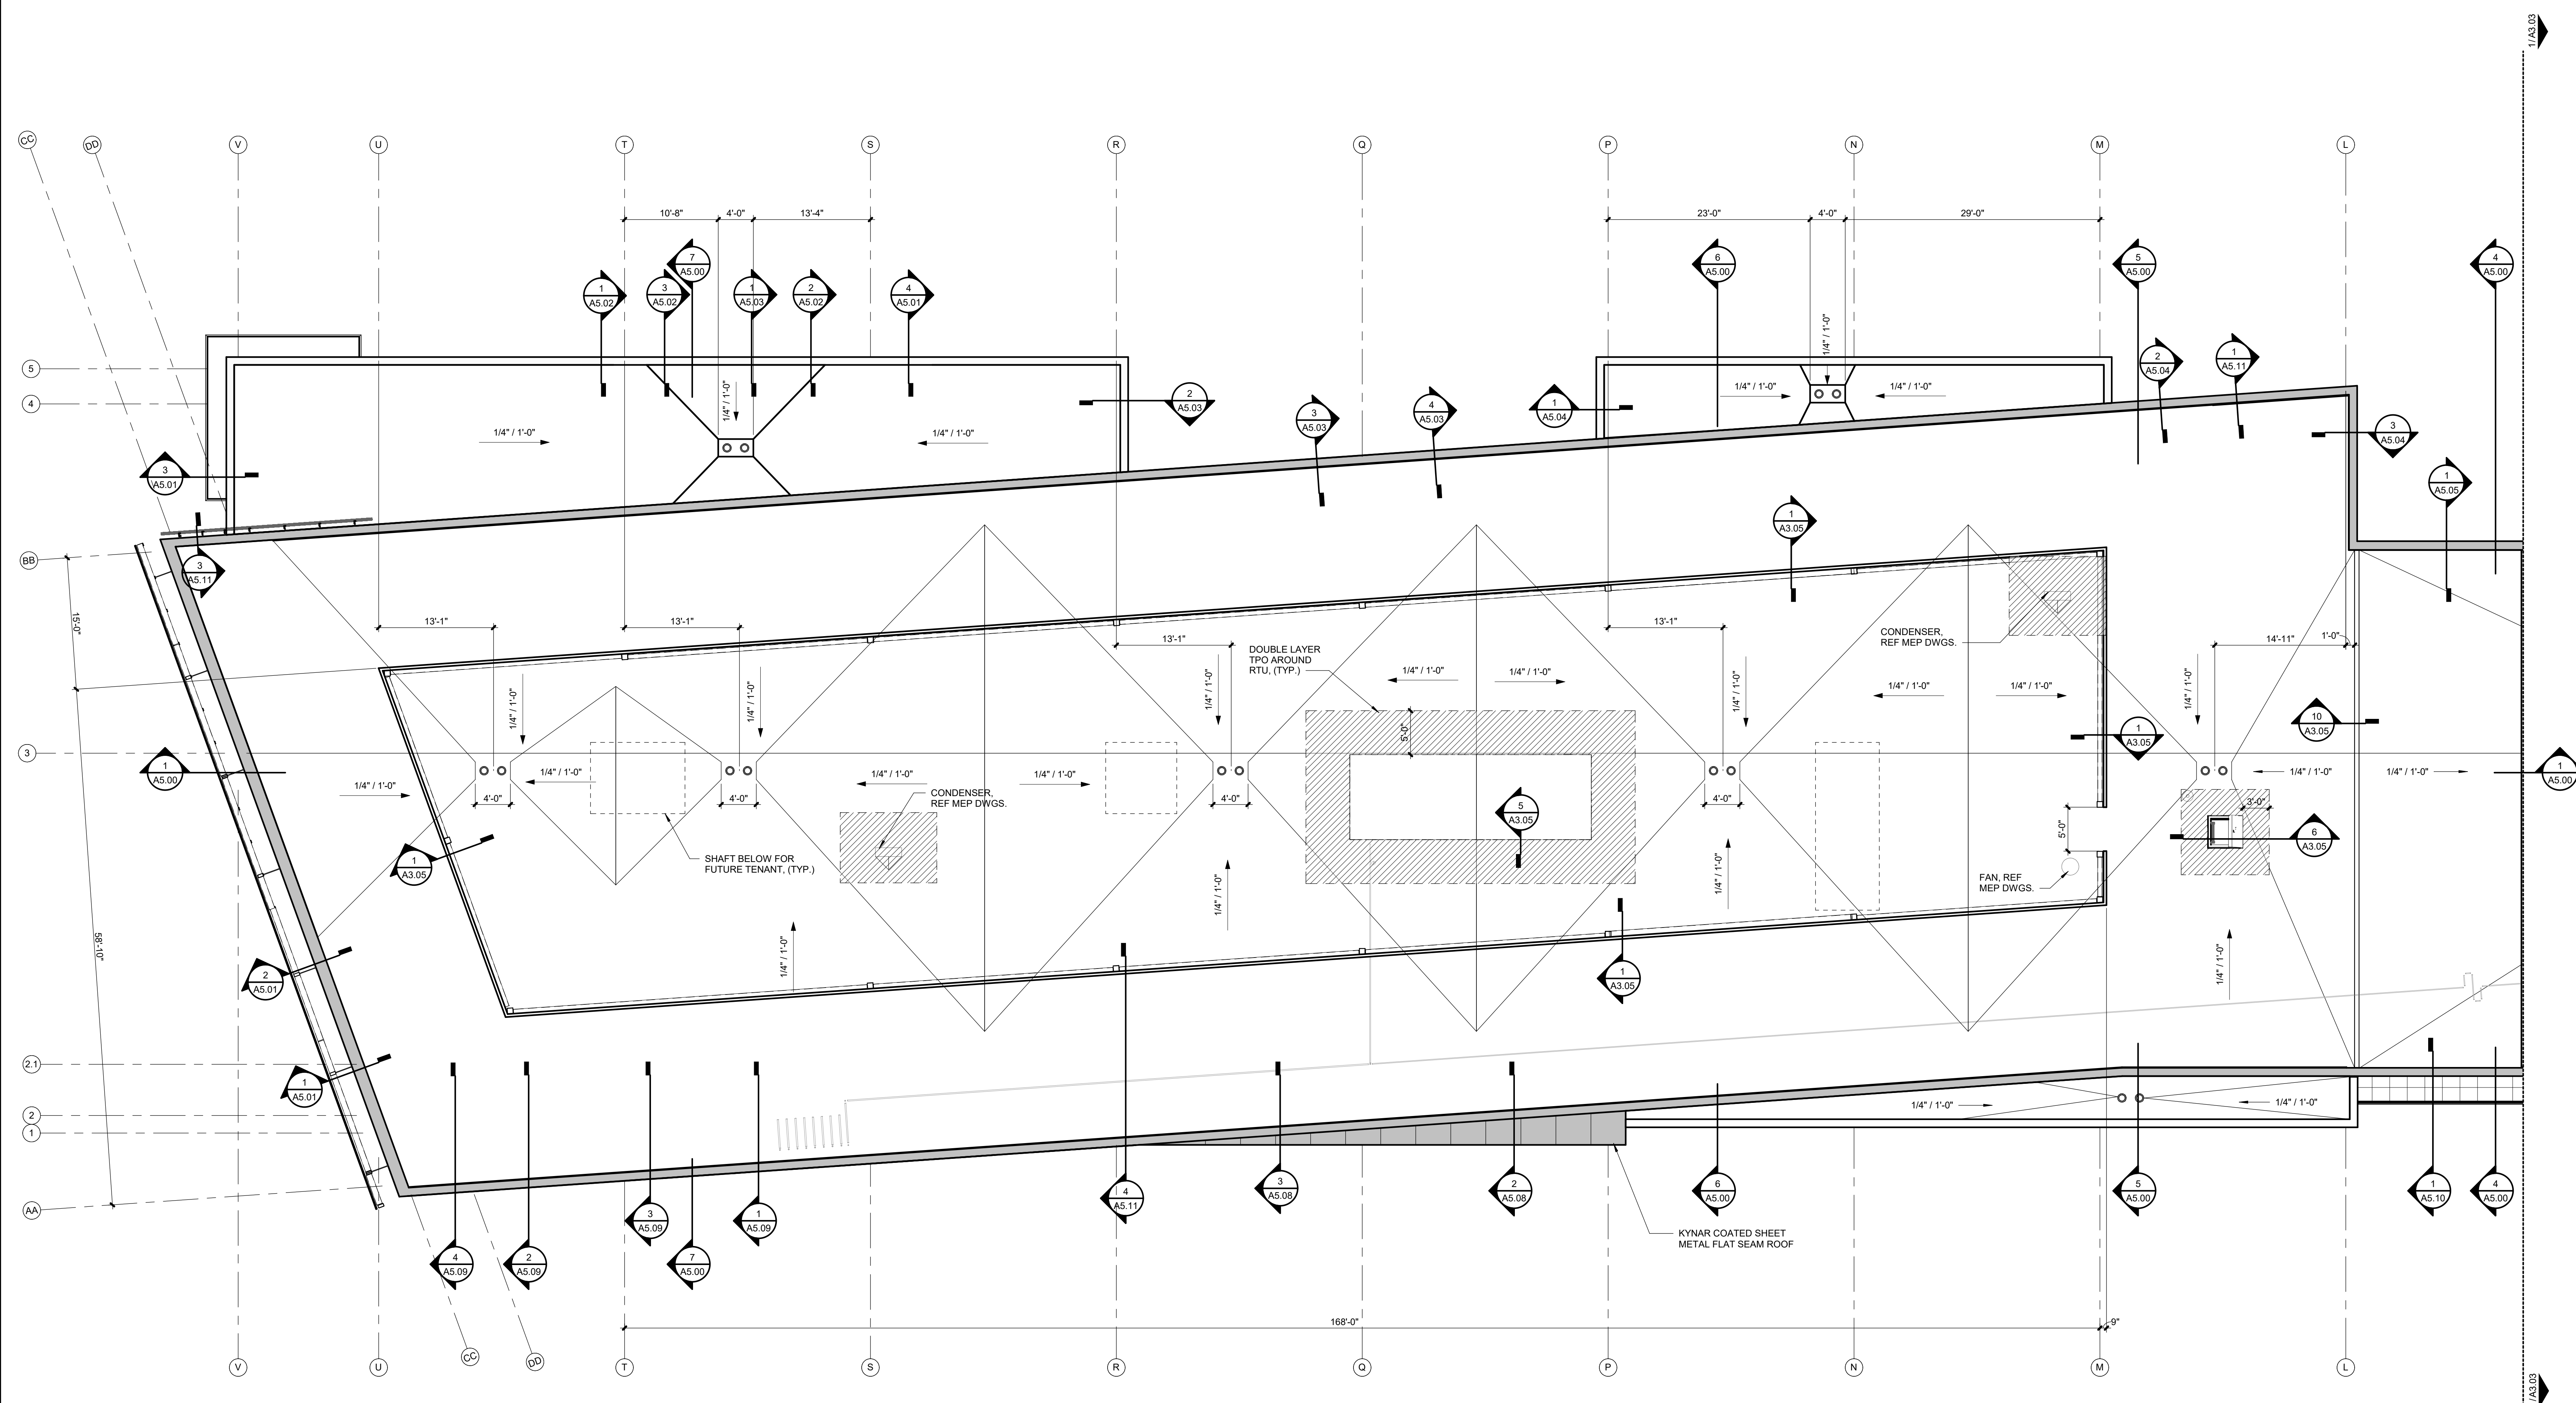

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|   |                  |
|---|------------------|
| 1 | ROOF PLAN - WEST |
|---|------------------|

|              |                      |
|--------------|----------------------|
| <b>A3.02</b> | SCALE : 1/8" = 1'-0" |
|--------------|----------------------|



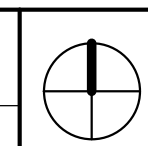



PARAGON STAR  
FIRST PLAT, LOT 9  
LEE'S SUMMIT, MO

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## REGISTRATION



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PROJECT TEAM

ARCHITECT FINKLE+WILLIAMS  
ARCHITECTURE

|   | CIVIL  | GBA  |
|---|--|--|
| 1. <i>What is the purpose of the study?</i> | 1. To determine the effect of the intervention on the outcome. | 1. To determine the effect of the intervention on the outcome. |
| 2. <i>What is the research question?</i>    | 2. To determine the effect of the intervention on the outcome. | 2. To determine the effect of the intervention on the outcome. |
| 3. <i>What is the study design?</i>         | 3. To determine the effect of the intervention on the outcome. | 3. To determine the effect of the intervention on the outcome. |
| 4. <i>What is the population?</i>           | 4. To determine the effect of the intervention on the outcome. | 4. To determine the effect of the intervention on the outcome. |
| 5. <i>What is the intervention?</i>         | 5. To determine the effect of the intervention on the outcome. | 5. To determine the effect of the intervention on the outcome. |
| 6. <i>What is the comparison?</i>           | 6. To determine the effect of the intervention on the outcome. | 6. To determine the effect of the intervention on the outcome. |
| 7. <i>What is the outcome?</i>              | 7. To determine the effect of the intervention on the outcome. | 7. To determine the effect of the intervention on the outcome. |
| 8. <i>What is the conclusion?</i>           | 8. To determine the effect of the intervention on the outcome. | 8. To determine the effect of the intervention on the outcome. |

LANDSCAPE HOERR SCHAUDT / LAUREN

FOUNDATIONS      BSE STRUCTURAL ENGINEERS

STRUCTURAL BSE STRUCTURAL  
ENGINEERS

PLUMBING HENDERSON  
ENGINEERS

MECHANICAL HENDERSON  
ENGINEERSELECTRICAL HENDERSON  
ENGINEERS

FIRE PROTECTION HENDERSON  
ENGINEERS

CONTRACTOR      FOGEL ANDERSON



FINKLE + WILLIAMS  
ARCHITECTURE


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SHEET TITLE

ROOF PLAN  
EAST

**SHEET NUMBER**


### A3.03

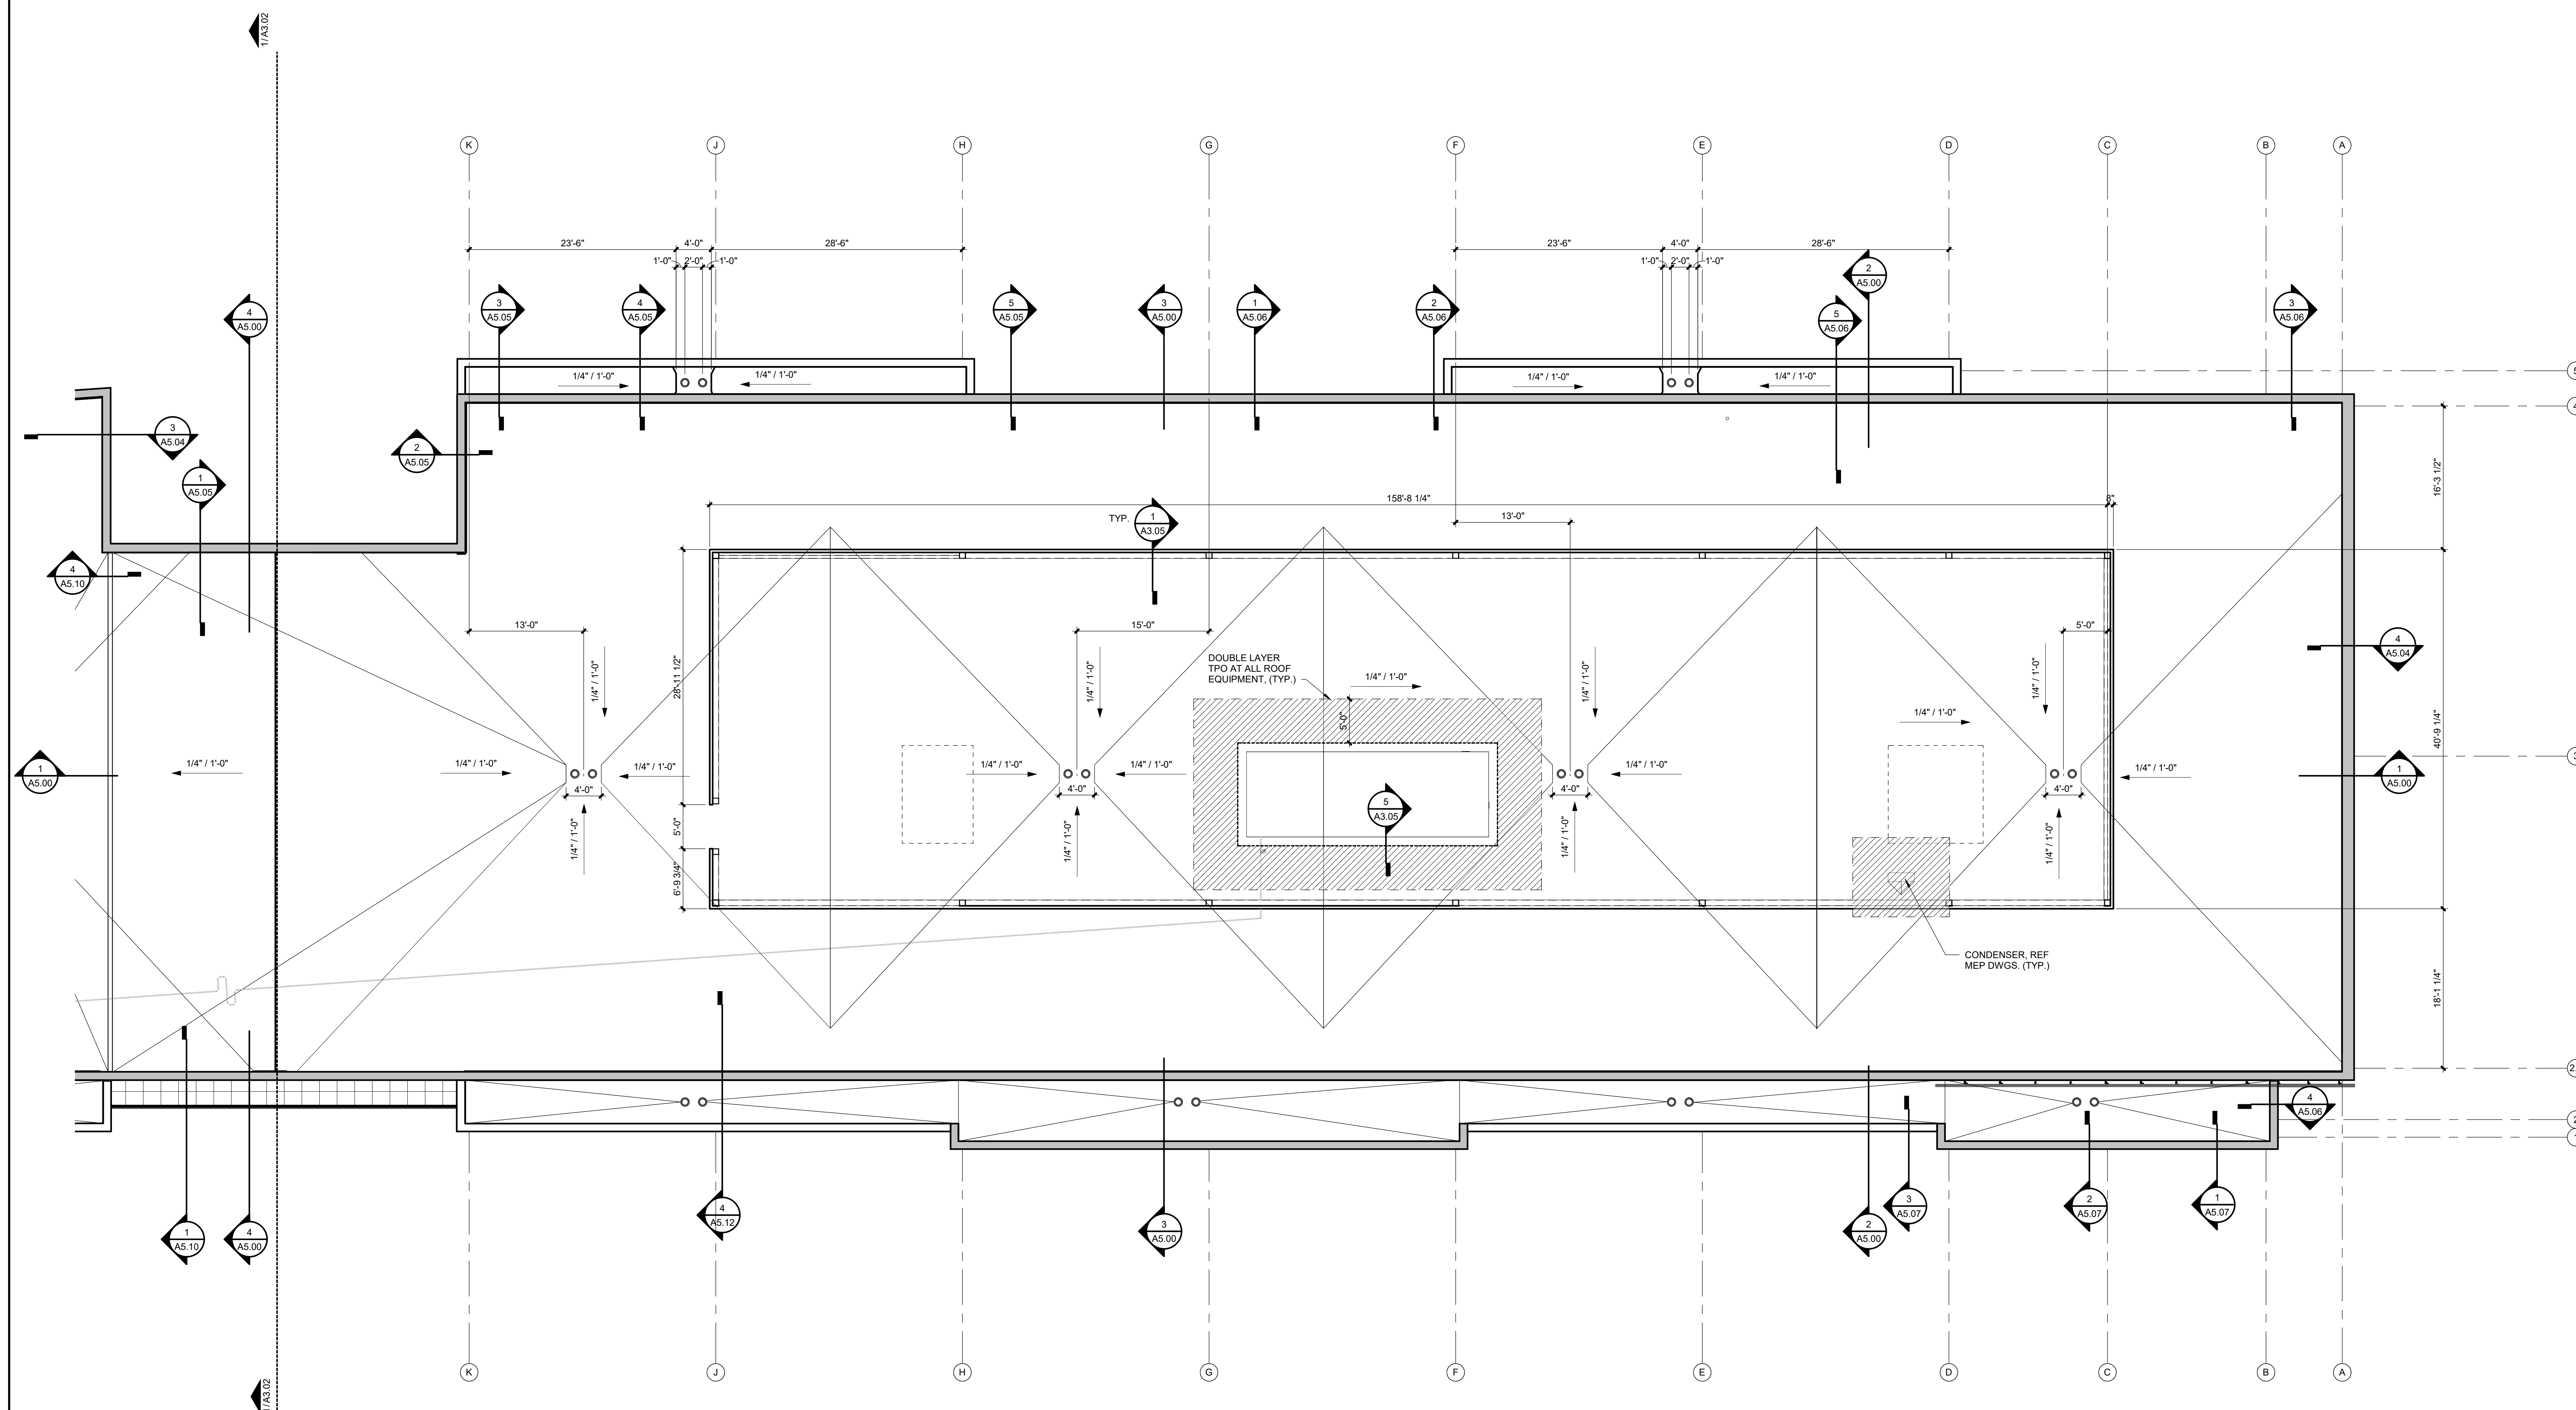


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|   |                  |
|---|------------------|
| 1 | ROOF PLAN - EAST |
|---|------------------|

|              |                      |
|--------------|----------------------|
| <b>A3.03</b> | SCALE : 1/8" = 1'-0" |
|--------------|----------------------|



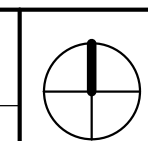

[illegible]
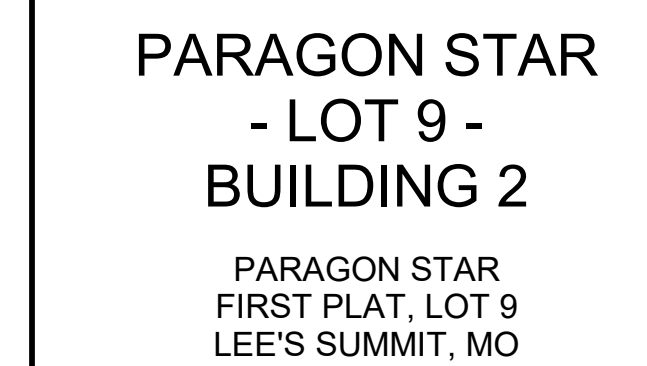
| PROJECT TEAM             |                              |
|--------------------------|------------------------------|
| ARCHITECT                | FINKLE-WILLIAMS ARCHITECTURE |
| CLIENT                   | GBA                          |
| DISCIPLINE               | HOERR SCHAUDT / LANDS        |
| FOUNDATIONS              | BSE STRUCTURAL ENGINEERS     |
| STRUCTURAL               | BSE STRUCTURAL ENGINEERS     |
| MECHANICAL               | HENDERSON ENGINEERS          |
| ELECTRICAL               | HENDERSON ENGINEERS          |
| ENVIRONMENTAL PROTECTION | HENDERSON ENGINEERS          |
| TRACTOR                  | FOGEL ANDERSON               |



## ROOF DECK DETAILS

### A3.04



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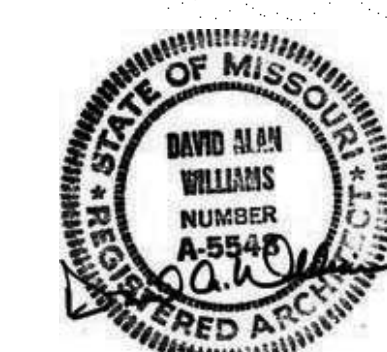


PARAGON STAR  
FIRST PLAT, LOT 9  
LEE'S SUMMIT, MO

Project No.: 19050.01  
Date: 10.25.19  
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## REGISTRATION



## PROJECT TEAM

|                 |                                  |
|-----------------|----------------------------------|
| ARCHITECT       | FINKLE- WILLIAMS<br>ARCHITECTURE |
| CIVIL           | GBA                              |
| LANDSCAPE       | HOERR SCHAUDT /<br>LAND3         |
| FOUNDATIONS     | BSE STRUCTURAL<br>ENGINEERS      |
| STRUCTURAL      | BSE STRUCTURAL<br>ENGINEERS      |
| PLUMBING        | HENDERSON<br>ENGINEERS           |
| MECHANICAL      | HENDERSON<br>ENGINEERS           |
| ELECTRICAL      | HENDERSON<br>ENGINEERS           |
| FIRE PROTECTION | HENDERSON<br>ENGINEERS           |
| CONTRACTOR      | FOGEL ANDERSON                   |



FINKLE + WILLIAMS  
ARCHITECTURE

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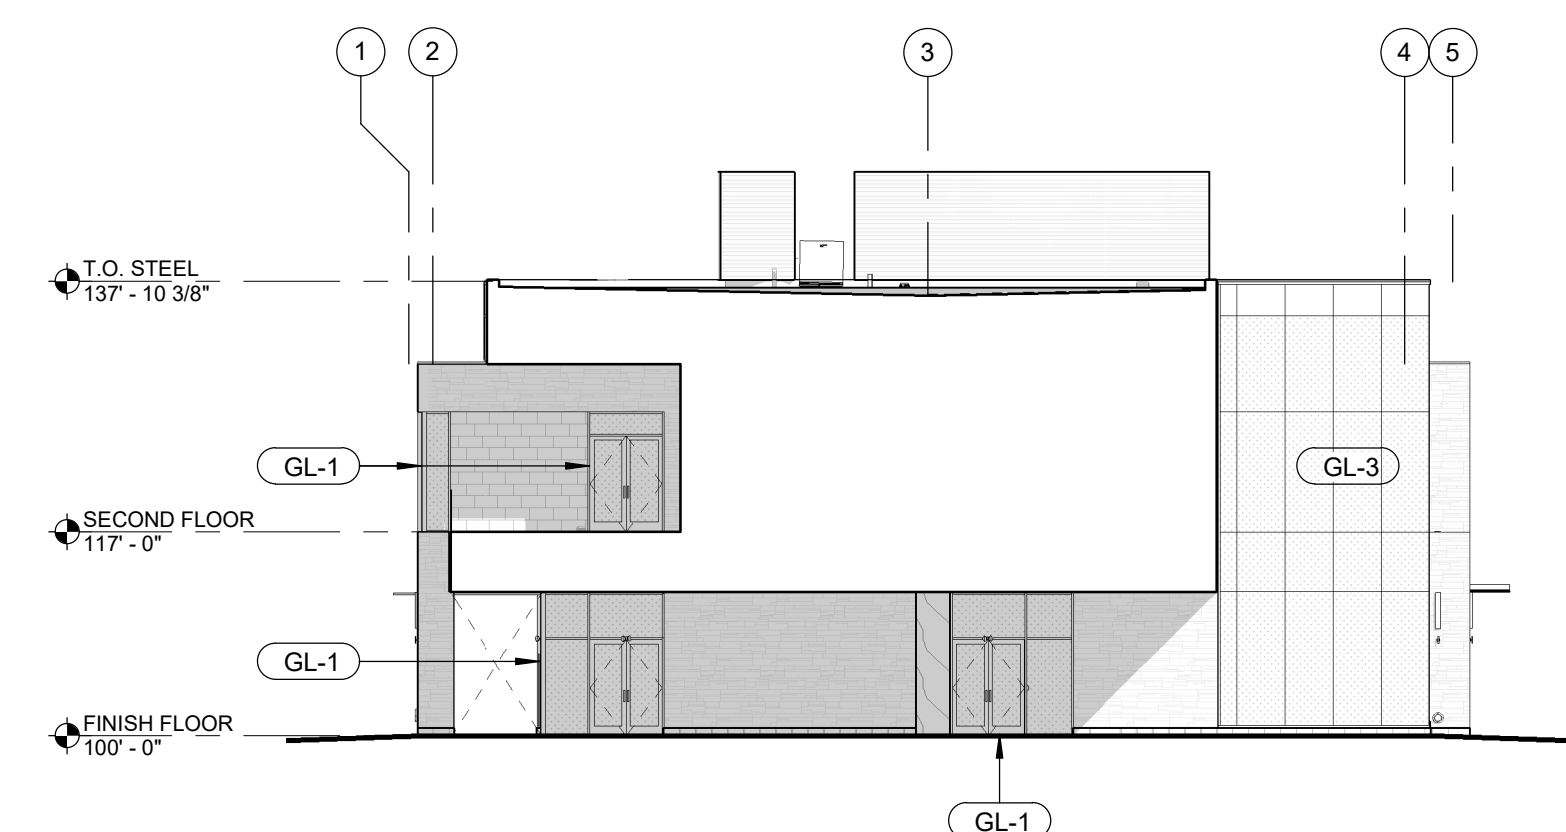
SHEET TITLE

EXTERIOR  
ELEVATIONS -  
OVERALL

SHEET NUMBER


## A4.01

|       |   |
|-------|---|
| MP-1  | ALUMINUM COMPOSITE METAL (CM) DRY SYSTEM, ALUCOBOND, COLOR: natural BRUSHED CARBON, ACM PANEL JOINTS TO ALIGN W/ GLAZING PER ELEVATIONS   |
| MP-2  | KYNAR-COATED BREAK METAL TRIM TO MATCH MP-1   |
| MP-3  | KYNAR COATED 24 GA BREAK METAL COPING TO MATCH MP-1   |
| MP-4  | KYNAR COATED 24 GA BREAK METAL COPING TO MATCH ST-1   |
| MP-5  | ALUMINUM LOUVERED RTU SCREEN, COLOR: CLEAR ANODIZED   |
| MP-6  | PERFORATED METAL PANEL ON STEEL TUBE GATE FRAME AT TRASH ENCLOSURE/SCREEN FENCE   |
| MP-7  | PERFORATED METAL PANEL SHADE STRUCTURE WITH STEEL TUBE FRAME ON WEST END (HIDDEN FOR CLARITY)   |
| MP-8  | STANDING SEAM METAL ROOF TO MATCH MP-1  |
|       |   |
| GL-1  | STOREFRONT PANEL TYPE 1: 2' x 4.5' KAWNEER PERMACOAT SMOKE GRAY ALUMINUM CENTER GLAZED STOREFRONT SYSTEM W/ 1" INSULATED LOW-E GLAZING UNIT   |
| GL-2  | CURTAINWALL TYPE 1: 2.5' x 10.5' KAWNEER PERMACOAT SMOKE GRAY CURTAINWALL W/ 1" INSULATED LOW-E GLAZING UNIT**  |
| GL-3  | CURTAINWALL TYPE 2: 2.5' x 10.5' KAWNEER PERMACOAT SMOKE GRAY SSG CURTAINWALL W/ 1" INSULATED LOW-E GLAZING UNIT*   |
| GL-4  | CURTAINWALL TYPE 3: 2.5' x 7.5' KAWNEER PERMACOAT SMOKE GRAY CURTAINWALL STOREFRONT W/ 1" INSULATED LOW-E GLAZING UNIT*   |
| GL-5  | CURTAINWALL TYPE 4: 2.5' x 4.5' KAWNEER PERMACOAT SMOKE GRAY CURTAINWALL CLEDESTORY W/ 1" INSULATED LOW-E GLAZING UNIT*   |
| GL-6  | LIVERS BRONZE GLASS FRAMELESS STRUCT-J-RAL SYSTEM, CLEAR LAMINATED TEMPERED GLASS<br>**TOP COURSE OF STOREFRONT / CURTAINWALL GLAZING AT CLEDESTORY TO BE SPANDRAL GLASS: PPG SOLARBAN 70XL SOLAR CONTROL LOW-E GLAZING UNIT W/ "SUBDUED GRAY" OPACIFIER ON 4TH SURFACE, OR APPROVED EQUAL. |
|       |   |
| WD-1  | GEOLAM VERTIGO 5010 COMPOSITE CLADDING, COLOR: MOLESKIN   |
| WD-2  | GEOLAM SOLEO 6008 COMPOSITE TRIM, COLOR: MOLESKIN   |
| WD-3  | GEOLAM SOLEO 6008 COMPOSITE TRIM, COLOR: MOLESKIN (HIDDEN FOR CLARITY)  |
|       |   |
| ST-1  | ELDORADO CULTURED STONE VANTAGE 30, COLOR: WHITE ELM*   |
| ST-2  | ELDORADO CULTURED STONE MARQUEE24, COLOR: DOVETAIL**  |
| ST-3  | 2CM COPPER QUARTZITE CLADDING; PANEL SEAMS PER ELEVATIONS<br>**PROVIDE CONTIGUOUS JOINT AT SECOND LEVEL ON ALL ST-1 AND ST-2 LOCATIONS PER MANUF. RECOMMENDATIONS   |
|       |   |
| MB-1  | GROUND FACE 8X16 MASONRY BLOCK PER STRUCTURAL DWGS, BURNISHED FINISH, COLOR: MIDWEST SLATE  |
|       |   |
| AWN-1 | CANOPY TYPE 1: STEEL CHANNEL WRAP WITH GEOLAM VERTIGO 5010 SOFFIT (COLOR: MOLESKIN)   |
| AWN-2 | CANOPY TYPE 2: CANTILEVERED GEOLAM 6008 TRIM  |
|       |   |
| WL-1  | EXTERIOR WALL LIGHT PER RCP. MOUNT W/ TOP ALIGNED AT 12'-0" AFF; CENTER ON WALL SPACE PER ELEVATIONS UNO  |
| WL-2  | EXTERIOR WALL LIGHT PER RCP. MOUNT W/ TOP ALIGNED AT 12'-0" AFF; CENTER ON WALL SPACE PER ELEVATIONS UNO  |
|       |   |
| FP-1  | LOCATION FOR FDC AND KNOX BOX PER FIRE PROTECTION DRAWINGS; CENTER FIXTURES IN WALL UNO   |
| PD-1  | RCP OVERFLOW DRAIN DOWNSPOUT COVER PER PLUMBING DRAWINGS; CENTER UNDER WL-1 ABB OR UNO WALL SPACE UNO   |




|   |                          |
|---|--------------------------|
| 6 | BREEZEWAY WEST ELEVATION |
|---|--------------------------|

**A4 01** SCALE: 1/16" = 1'-0"

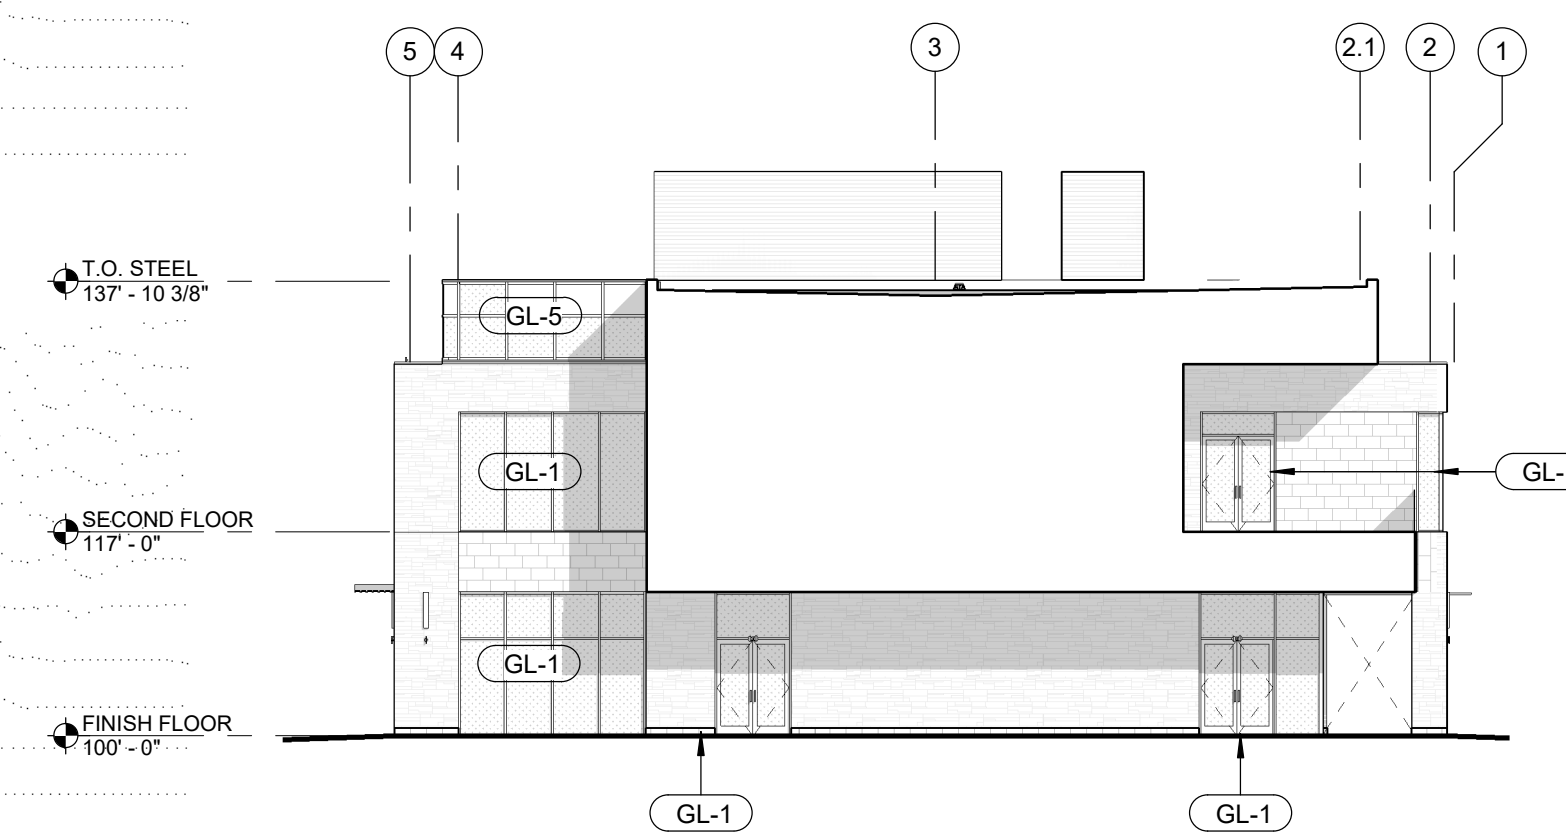


|   |                          |
|---|--------------------------|
| 5 | BREEZEWAY EAST ELEVATION |
|---|--------------------------|

|              |                      |
|--------------|----------------------|
| <b>A4 01</b> | SCALE: 1/16" = 1'-0" |
|--------------|----------------------|

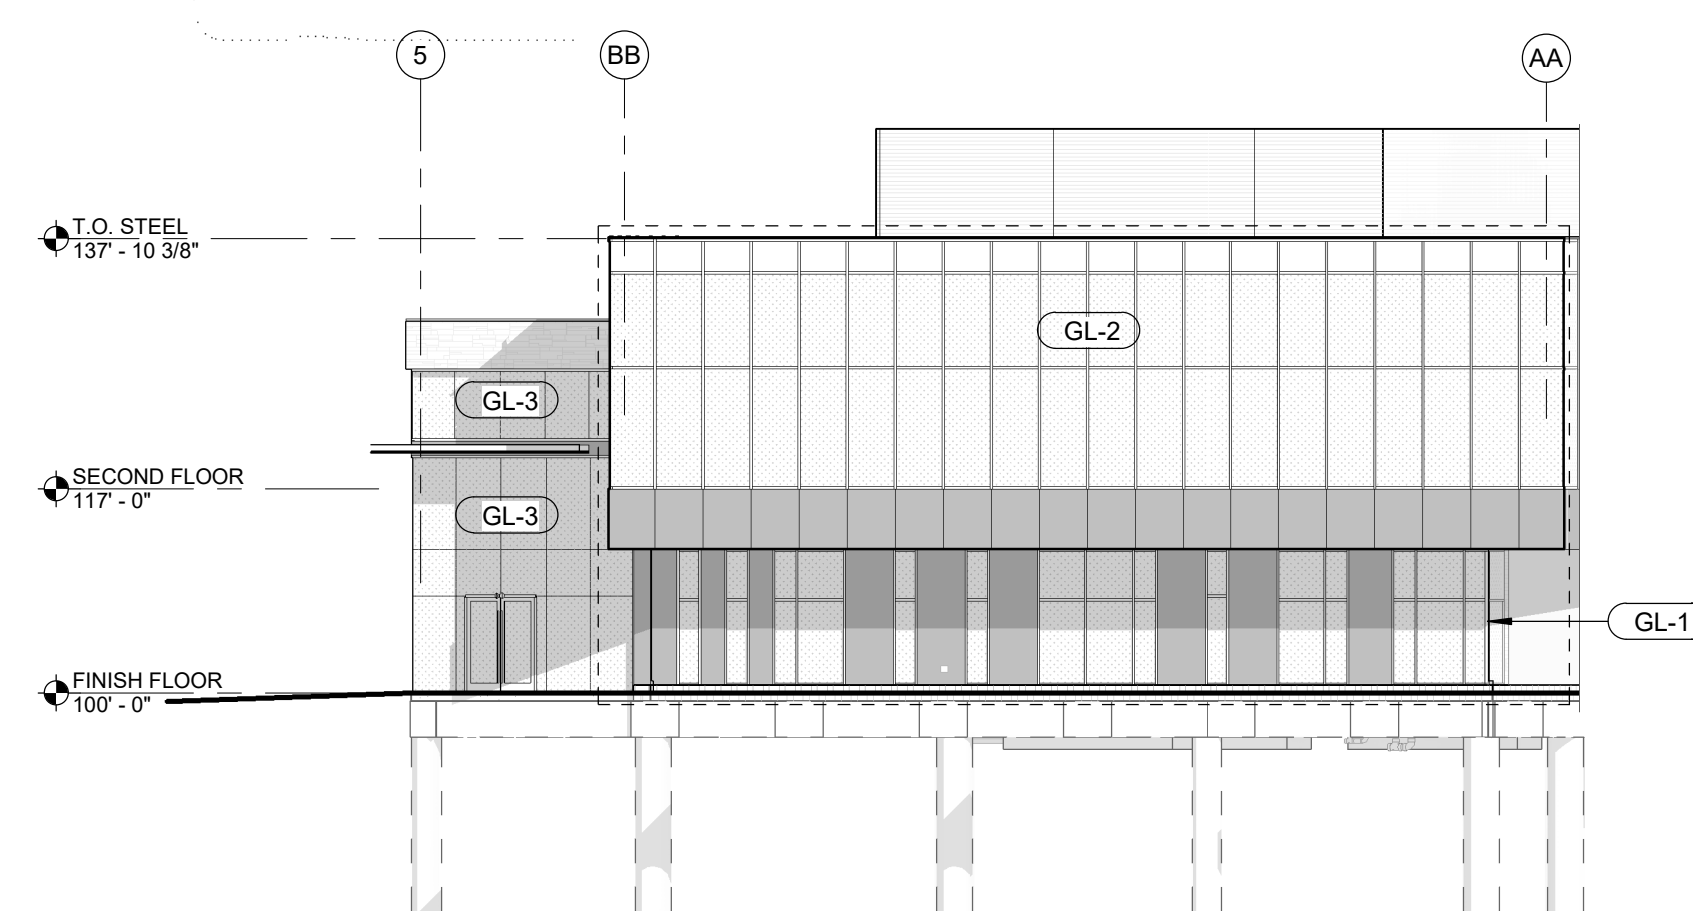


|   |                |
|---|----------------|
| 4 | WEST ELEVATION |
|---|----------------|

|              |                      |
|--------------|----------------------|
| <b>A4.01</b> | SCALE: 1/16" = 1'-0" |
|--------------|----------------------|

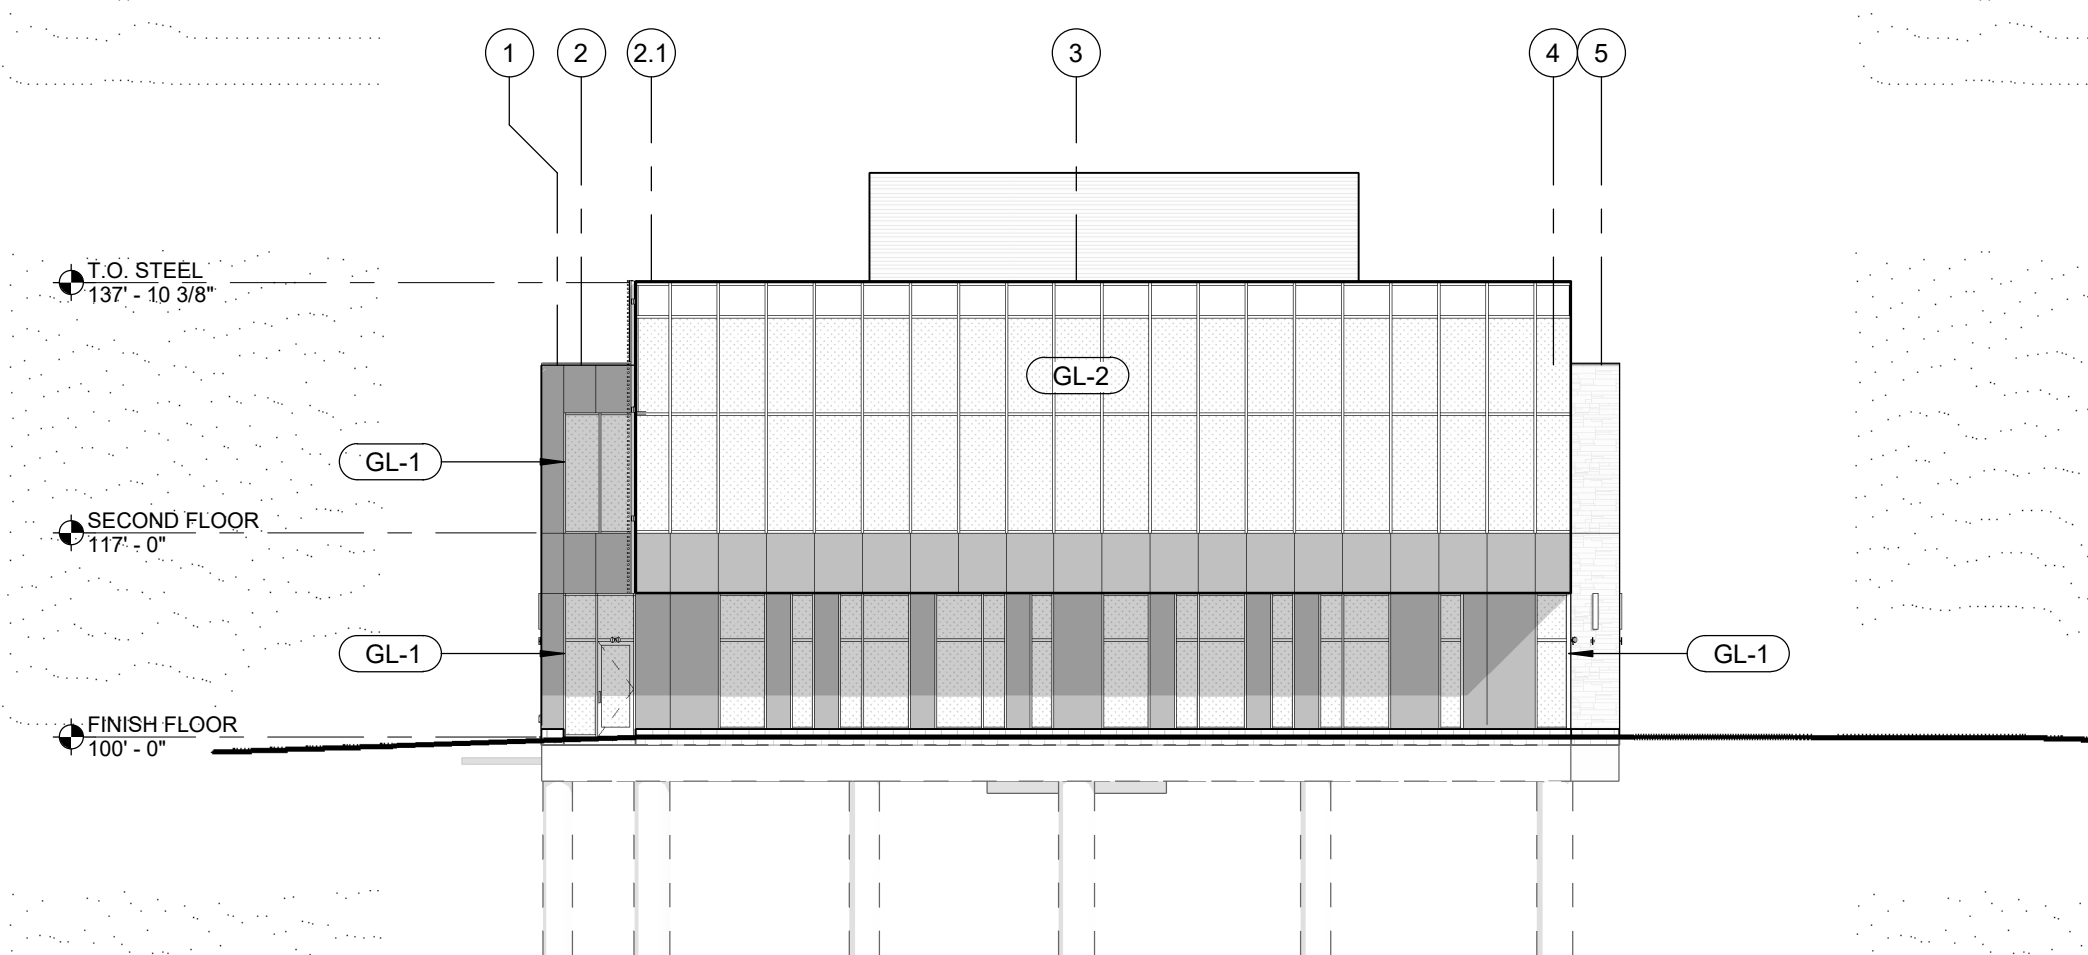


|   |                |
|---|----------------|
| 3 | EAST ELEVATION |
|---|----------------|

|              |                      |
|--------------|----------------------|
| <b>A4.01</b> | SCALE: 1/16" = 1'-0" |
|--------------|----------------------|

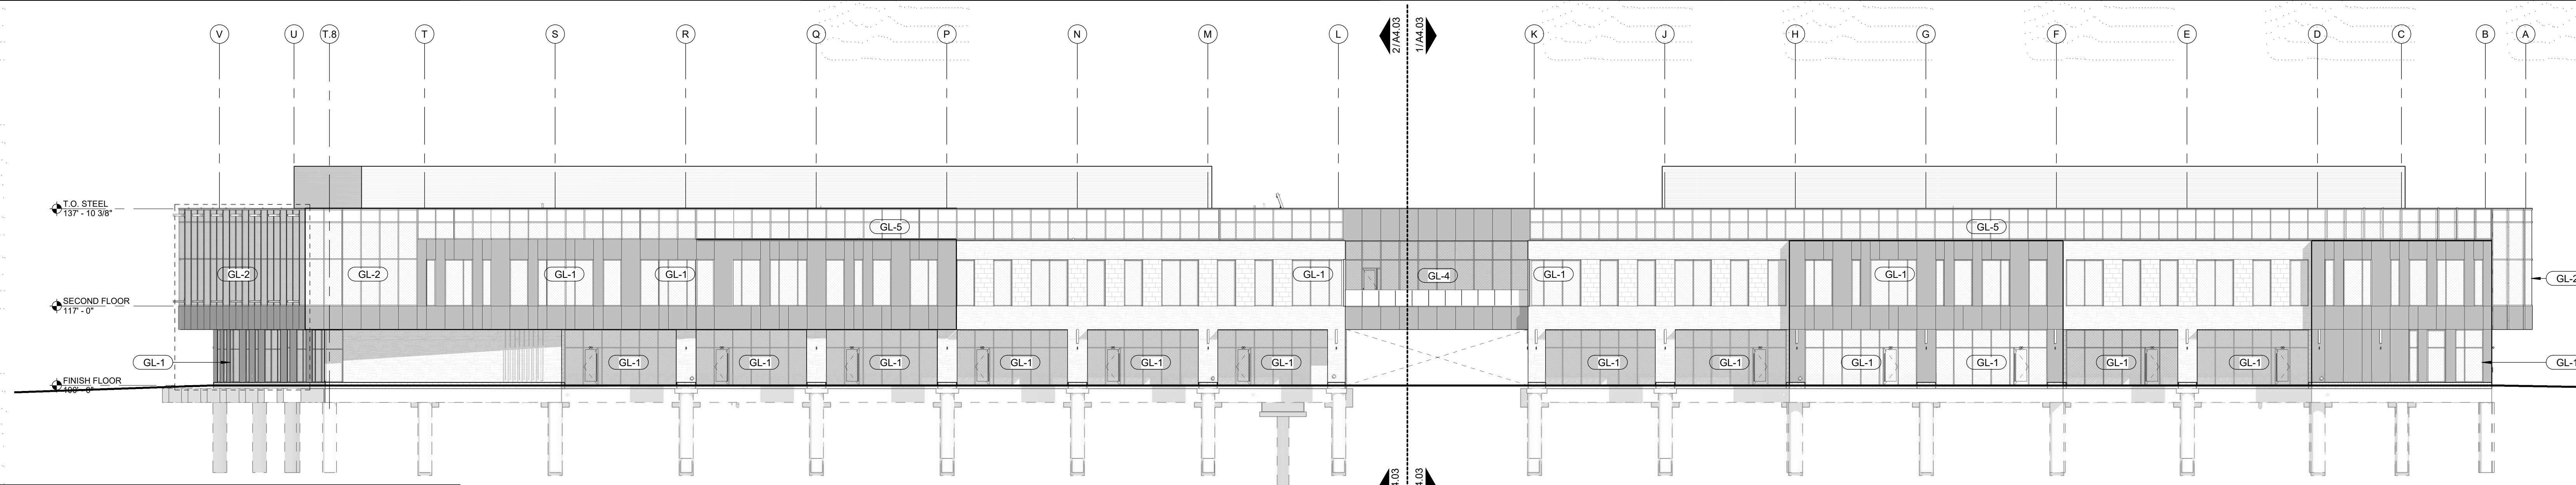

|   |                 |
|---|-----------------|
| 2 | SOUTH ELEVATION |
|---|-----------------|

|              |                       |
|--------------|-----------------------|
| <b>A4.01</b> | SCALE : 1/16" = 1'-0" |
|--------------|-----------------------|

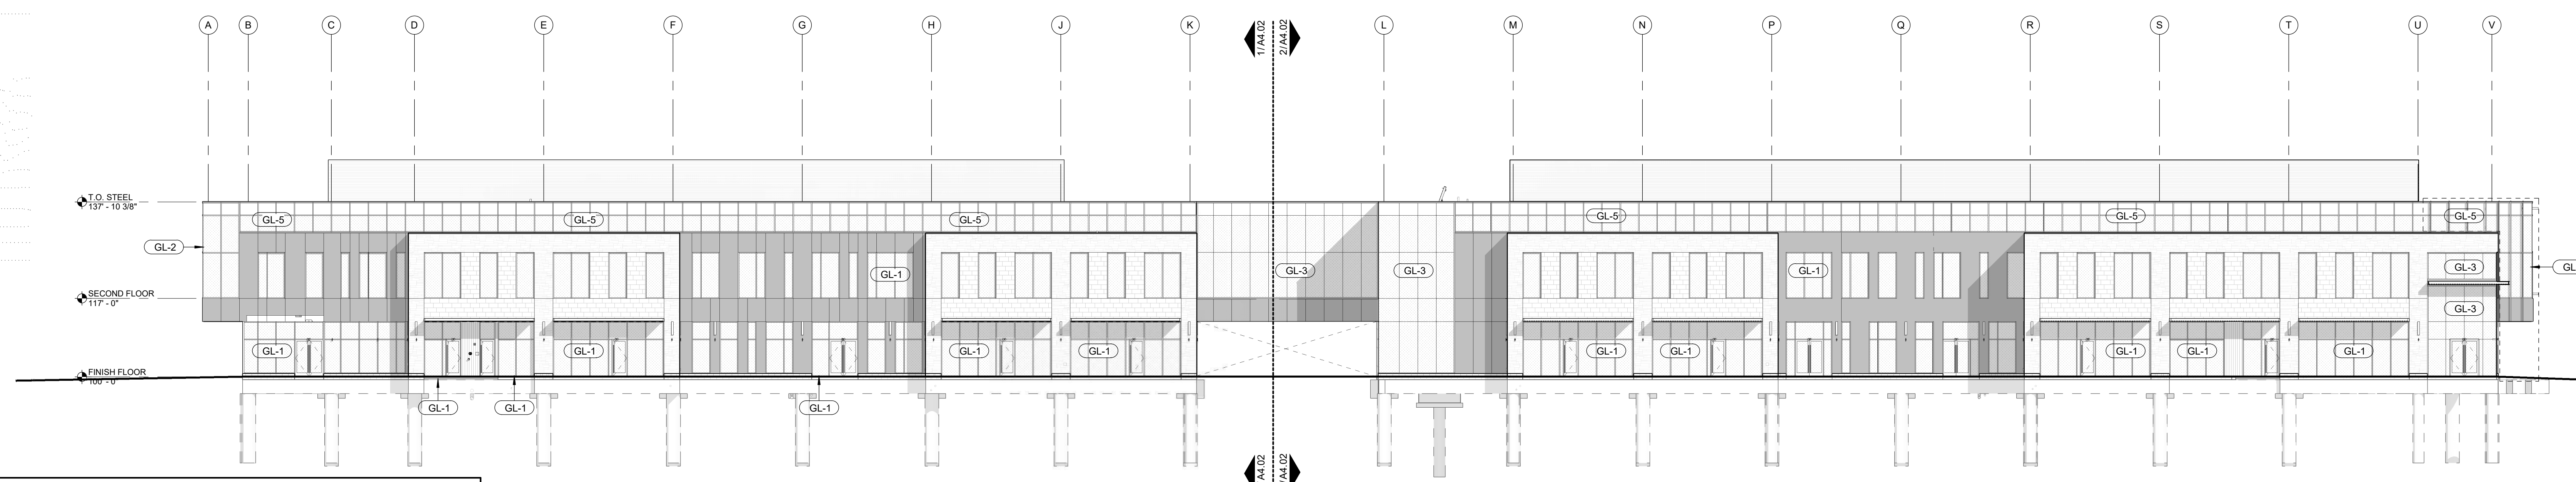

|   |                 |
|---|-----------------|
| 1 | NORTH ELEVATION |
|---|-----------------|

|              |                       |
|--------------|-----------------------|
| <b>A4.01</b> | SCALE : 1/16" = 1'-0" |
|--------------|-----------------------|



|       |   |
|-------|---|
| MP-1  | ALUMINUM COMPOSITE METAL (ACM) DRY SYSTEM: ALUCOBOND, COLOR: natural BRUSHED CARBON; ACM PANEL JOINTS TO ALIGN W/ GLAZING PER ELEVATIONS  |
| MP-2  | KYNAR-COATED BREAK METAL TRIM TO MATCH MP-1   |
| MP-3  | KYNAR COATED 24 GA BREAK METAL COPING TO MATCH MP-1   |
| MP-4  | KYNAR COATED 24 GA BREAK METAL COPING TO MATCH ST-1   |
| MP-5  | ALUMINUM LOUVERED RTU SCREEN, COLOR CLEAR ANODIZED  |
| MP-6  | PERFORATED METAL PANEL ON STEEL TUBE GATE/FRAME AT TRASH ENCLOSURE/SCREEN FENCE   |
| MP-7  | PERFORATED METAL PANEL SHADE STRUCTURE WITH STEEL TUBE FRAME ON WEST END (HIDDEN FOR CLARITY)   |
| MP-8  | STANDING SEAM METAL ROOF TO MATCH MP-1  |
|       |   |
| GL-1  | STOREFRONT TYPE 1: 2" x 4.5" KAWNEER PERMACOAT SMOKE GRAY ALUMINUM CENTER GLAZED STOREFRONT SYSTEM W/ 1" INSULATED LOW-E GLAZING UNIT   |
| GL-2  | CURTAINWALL TYPE 1: 2.5" x 10.5" KAWNEER PERMACOAT SMOKE GRAY CURTAINWALL W/ 1" INSULATED LOW-E GLAZING UNIT*   |
| GL-3  | CURTAINWALL TYPE 2: 2.5" x 10.5" KAWNEER PERMACOAT SMOKE GRAY SSG CURTAINWALL W/ 1" INSULATED LOW-E GLAZING UNIT*   |
| GL-4  | CURTAINWALL TYPE 3: 2.5" x 7.5" KAWNEER PERMACOAT SMOKE GRAY CURTAINWALL STOREFRONT W/ 1" INSULATED LOW-E GLAZING UNIT*   |
| GL-5  | CURTAINWALL TYPE 4: 2.5" x 6" KAWNEER PERMACOAT SMOKE GRAY CURTAINWALL CLERESTORY W/ 1" INSULATED LOW-E GLAZING UNIT  |
| GL-6  | LIVERS BRONZE GLASS FRAMELESS STRUCT-UL-Rail SYSTEM, CLEAR LAMINATED TEMPERED GLASS<br>*TOP COURSE OF STOREFRONT / CURTAINWALL GLAZING AT CLERESTORY TO BE SPANDRAL GLASS: PPG SOLARBAN 70XL SOLAR CONTROL LOW-E GLAZING UNIT W/ "SUBDUED GRAY" OPACIFIER ON 4TH SURFACE, OR APPROVED EQUAL |
|       |   |
| WD-1  | GEOLAM VERTIGO 5010 COMPOSITE CLADDING, COLOR: MOLESKIN   |
| WD-2  | GEOLAM SOLED 6008 COMPOSITE TRIM, COLOR: MOLESKIN   |
| WD-3  | GEOLAM SOLED 6008 COMPOSITE TRIM, COLOR: MOLESKIN (HIDDEN FOR CLARITY)  |
|       |   |
| ST-1  | ELDORADO CULTURED STONE VANTAGE 30, COLOR: WHITE ELM**  |
| ST-2  | ELDORADO CULTURED STONE MARQUEE24, COLOR: DOVETAIL**  |
| ST-3  | 2CM COPPER QUARTZITE CLADDING; PANEL SEAMS PER ELEVATIONS<br>**PROVIDE COUNTER JOINT AT SECOND LEVEL ON ALL ST-1 AND ST-2 LOCATIONS PER MANUF. REQUIREMENTS   |
|       |   |
| MB-1  | GROUND FACE 8X16 MASONRY BLOCK PER STRUCTURAL DWGS. BUSHNED FINISH, COLOR: MIDWEST SLATE  |
|       |   |
| AWN-1 | CANOPY TYPE 1: STEEL CHANNEL WRAP WITH GEOLAM VERTIGO 5010 SOFFIT (COLOR: MOLESKIN)   |
| AWN-2 | CANOPY TYPE 2: CANTILEVERED GEOLAM 6008 TRIM  |
|       |   |
| WL-1  | EXTERIOR WALL LIGHT PER RCP. MOUNT W/ TOP ALIGNED AT 12'-0" AFF; CENTER ON WALL SPACE PER ELEVATIONS UNO  |
| WL-2  | EXTERIOR WALL LIGHT PER RCP. MOUNT W/ TOP ALIGNED AT 12'-0" AFF; CENTER ON WALL SPACE PER ELEVATIONS UNO  |
|       |   |
| FP-1  | LOCATION FOR FDC AND KNOX BOX. PER FIRE PROTECTION DRAWINGS; CENTER FIXTURES IN WALL UNO  |
| PD-1  | RCP OVERFLOW DRAIN DOWNSPOT COVER PER PLUMBING DRAWINGS; CENTER UNDER WL-1 ABY OR ON WALL SPACE UNO   |



PARAGON STAR  
FIRST PLAT, LOT 9  
REE'S SUMMIT, MO

Project No.: 19050.01


ate: 10.25.19

Issued For: SHELL - CD SET

## VISIONS

[illegible]

REGISTRATION

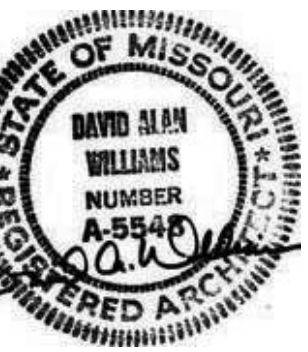

## PROJECT TEAM

|                                      |                                 |
|--------------------------------------|---------------------------------|
| ARCHITECT                            | FINKLE+WILLIAMS<br>ARCHITECTURE |
| CIVIL                                | GBA                             |
| LANDSCAPE                            | HOERR SCHAUDT /<br>LAND3        |
| FOUNDATIONS                          | BSE STRUCTURAL<br>ENGINEERS     |
| STRUCTURAL                           | BSE STRUCTURAL<br>ENGINEERS     |
| PLUMBING                             | HENDERSON<br>ENGINEERS          |
| MECHANICAL                           | HENDERSON<br>ENGINEERS          |
| ELECTRICAL                           | HENDERSON<br>ENGINEERS          |
| EROSION CONTROL<br>/ SOIL PROTECTION | HENDERSON<br>ENGINEERS          |
| CONTRACTOR                           | FOGEL ANDERSON                  |




007 College Blvd, Suite 415  
Overland Park, Kansas 66211  
13+498-1550

SHEET TITLE

EXTERIOR  
ELEVATIONS -  
NORTH


EET NUMBER

## A4.02

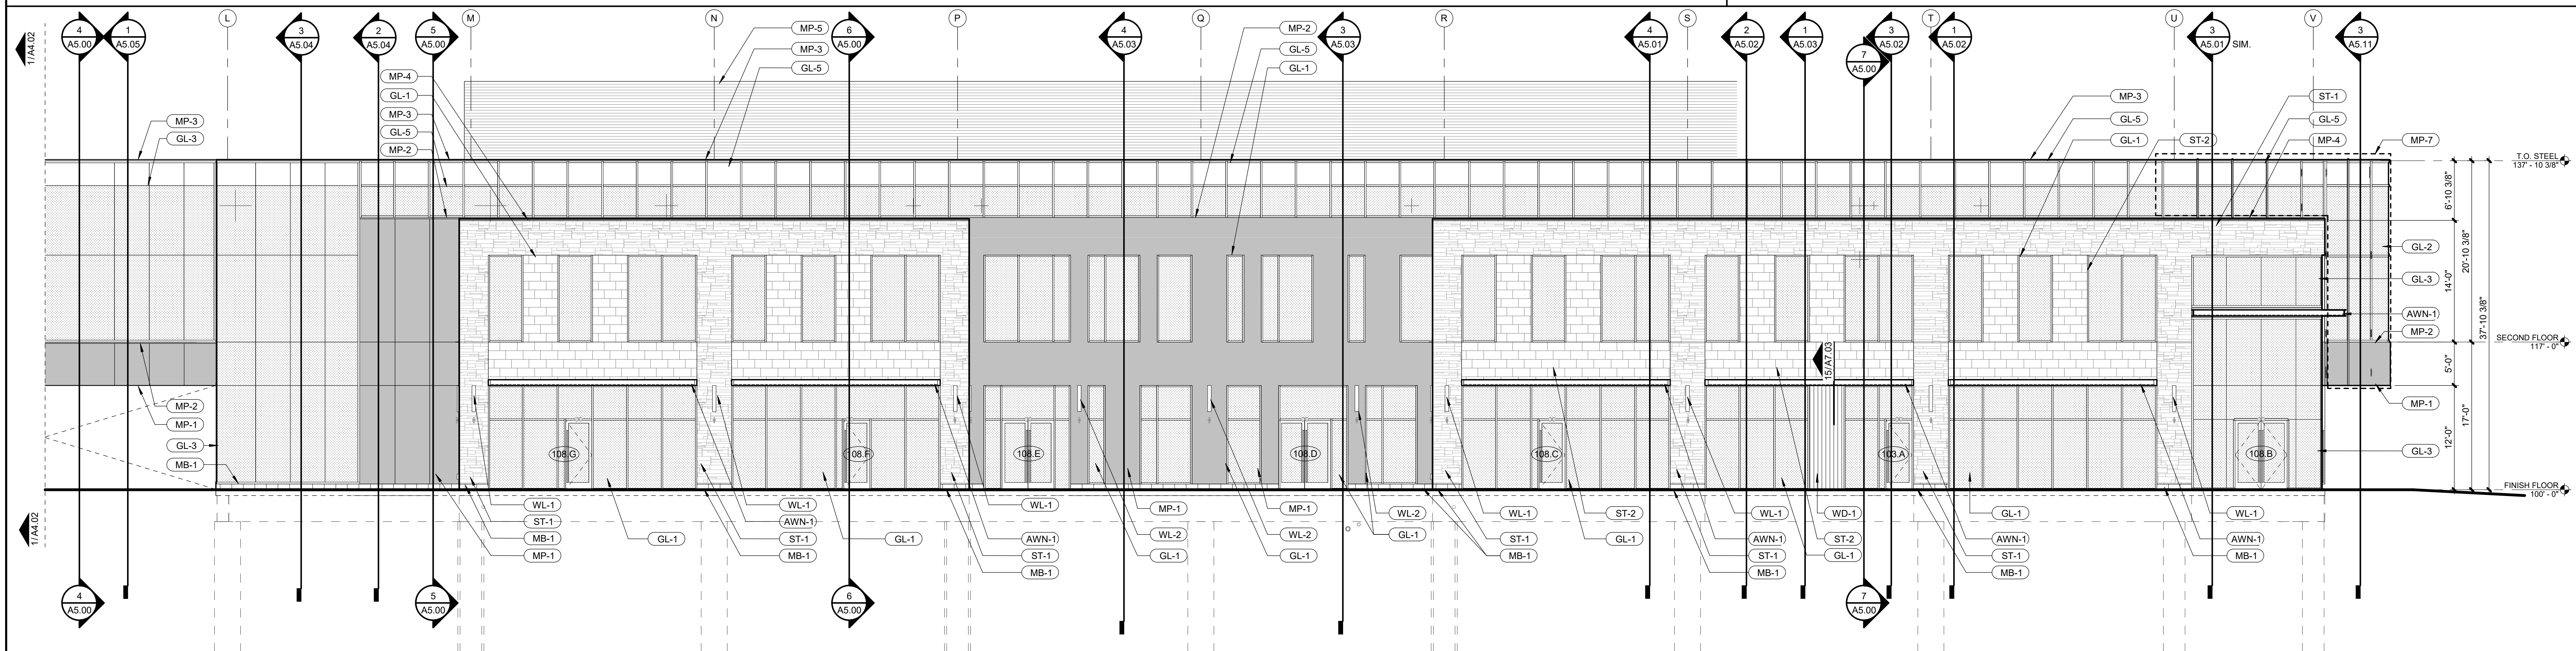

|   |                                   |
|---|-----------------------------------|
| 2 | NORTH ELEVATION - ENLARGED - WEST |
|---|-----------------------------------|

|              |                      |
|--------------|----------------------|
| <b>A4.02</b> | SCALE : 1/8" = 1'-0" |
|--------------|----------------------|

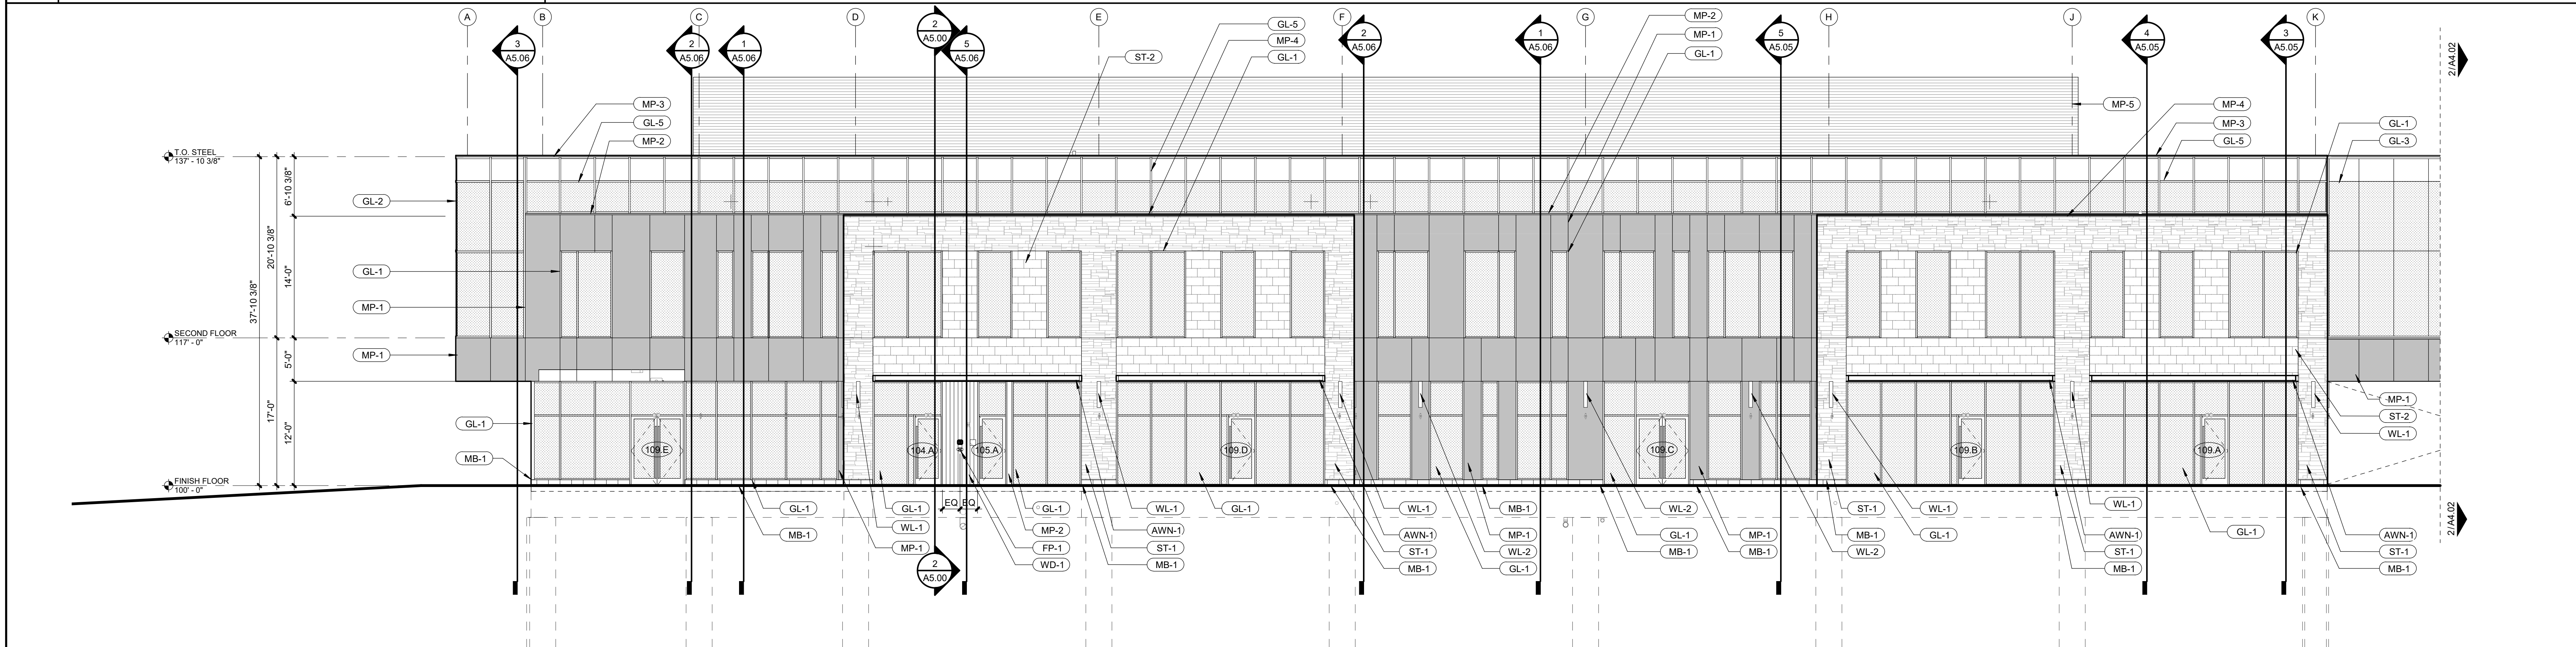

|   |                                   |
|---|-----------------------------------|
| 1 | NORTH ELEVATION - ENLARGED - EAST |
|---|-----------------------------------|

|              |                      |
|--------------|----------------------|
| <b>A4.02</b> | SCALE : 1/8" = 1'-0" |
|--------------|----------------------|



|       |  |
|-------|--|
| MP-1  | ALUMINUM COMPOSITE METAL (ACM) DRY SYSTEM. ALUCOBOND, COLOR: natural BRUSHED CARBON; ACM PANEL JOINTS TO ALIGN W/ GLAZING PER ELEVATIONS   |
| MP-2  | KYNAR-COATED BREAK METAL TRIM TO MATCH MP-1  |
| MP-3  | KYNAR COATED 24 GA BREAK METAL COPING TO MATCH MP-1  |
| MP-4  | KYNAR COATED 24 GA BREAK METAL COPING TO MATCH ST-1  |
| MP-5  | ALUMINUM LOVERED RTU SCREEN, COLOR CLEAR ANODIZED  |
| MP-6  | PERFORATED METAL PANEL ON STEEL TUBE GATE/FRAME AT TRASH ENCLOSURE/SCREEN FENCE  |
| MP-7  | PERFORATED METAL PANEL SHADE STRUCTURE WITH STEEL TUBE FRAME ON WEST END (HIDDEN FOR CLARITY)  |
| MP-8  | STANDING SEAM METAL ROOF TO MATCH MP-1   |
|       |  |
| GL-1  | STOREFRONT TYPE 1: 2' x 4.5' KAWNEER PERMACOAT SMOKE GRAY ALUMINUM CENTER GLAZED STOREFRONT SYSTEM W/ 1" INSULATED LOW-E GLAZING UNIT  |
| GL-2  | CURTAINWALL TYPE 1: 2.5' x 10.5' KAWNEER PERMACOAT SMOKE GRAY CURTAINWALL W/ 1" INSULATED LOW-E GLAZING UNIT*  |
| GL-3  | CURTAINWALL TYPE 2: 2.5' x 10.5' KAWNEER PERMACOAT SMOKE GRAY CURTAINWALL W/ 1" INSULATED LOW-E GLAZING UNIT*  |
| GL-4  | CURTAINWALL TYPE 3: 2.5' x 7.5' KAWNEER PERMACOAT SMOKE GRAY CURTAINWALL STOREFRONT W/ 1" INSULATED LOW-E GLAZING UNIT*  |
| GL-5  | CURTAINWALL TYPE 4: 2.5' x 6' KAWNEER PERMACOAT SMOKE GRAY CURTAINWALL CLERESTORY W/ 1" INSULATED LOW-E GLAZING UNIT*  |
| GL-6  | LIVERS BRONZE GLASS FRAMELESS STRUCT-U-RAIL SYSTEM; CLEAR LAMINATED TEMPERED GLASS<br>*TOP COURSE OF STOREFRONT / CURTAINWALL GLAZING AT CLERESTORY TO BE SPANDRAL GLASS: PPG SOLARBAN 70XL SOLAR CONTROL LOW-E GLAZING UNIT W/ "SUBDUED GRAY" OPACIFIER ON 4TH SURFACE, OR APPROVED EQUAL |
|       |  |
| WD-1  | GEOLAM VERTIGO 5010 COMPOSITE CLADDING, COLOR: MOLESKIN  |
| WD-2  | GEOLAM SOLEO 6008 COMPOSITE TRIM, COLOR: MOLESKIN  |
| WD-3  | GEOLAM SOLEO 6008 COMPOSITE TRIM, COLOR: MOLESKIN (HIDDEN FOR CLARITY)   |
|       |  |
| ST-1  | ELDORADO CULTURED STONE VANTAGE 30, COLOR: WHITE ELM**   |
| ST-2  | ELDORADO CULTURED STONE MARQUEE24, COLOR: DOVETAIL**   |
| ST-3  | 2CM COPPER QUARTZITE CLADDING; PANEL SEAMS PER ELEVATIONS<br>**PROVIDE CONTROL JOINT AT SECOND LEVEL ON ALL ST-1 AND ST-2 LOCATIONS PER MANUF. RECOMMENDATIONS   |
|       |  |
| MB-1  | GROUND FACE 8X16 MASONRY BLOCK PER STRUCTURAL DWGS, BURNISHED FINISH, COLOR: MIDWEST SLATE   |
|       |  |
| AWN-1 | CANOPY TYPE 1: STEEL CHANNEL WRAP WITH GEOLAM VERTIGO 5010 SOFFIT (COLOR: MOLESKIN)  |
| AWN-2 | CANOPY TYPE 2: CANTILEVERED GEOLAM 6008 TRIM   |
|       |  |
| WL-1  | EXTERIOR WALL LIGHT PER RCP. MOUNT W/ TOP ALIGNED AT 12'-0" AFF. CENTER ON WALL SPACE PER ELEVATIONS UNO   |
| WL-2  | EXTERIOR WALL LIGHT PER RCP. MOUNT W/ TOP ALIGNED AT 12'-0" AFF. CENTER ON WALL SPACE PER ELEVATIONS UNO   |
|       |  |
| FP-1  | LOCATION FOR FDC AND KNOX BOX. PER FIRE PROTECTION DRAWINGS; CENTER FIXTURES IN WALL UNO   |
| PD-1  | RCP OVERFLOW DRAIN DOWNSPOUT COVER PER PLUMBING DRAWINGS; CENTER UNDER WL-1 ABV OR ON WALL SPACE UNO   |






| EXTERIOR MATERIAL LEGEND |   |
|--------------------------|---|
| MP-1                     | ALUMINUM COMPOSITE METAL (ACM) DRY SYSTEM: ALUCOBOND, COLOR: naturAL BRUSHED CARBON; ACM PANEL JOINTS TO ALIGN W/ GLAZING PER ELEVATIONS  |
| MP-2                     | KYNAR-COATED BREAK METAL TRIM TO MATCH MP-1   |
| MP-3                     | KYNAR COATED 24 GA BREAK METAL COPING TO MATCH MP-1   |
| MP-4                     | KYNAR COATED 24 GA BREAK METAL COPING TO MATCH ST-1   |
| MP-5                     | ALUMINUM LOUVERED RTU SCREEN, COLOR CLEAR ANODIZED  |
| MP-6                     | PERFORATED METAL PANEL ON STEEL TUBE GATE/FRAME AT TRASH ENCLOSURE/SCREEN FENCE   |
| MP-7                     | PERFORATED METAL PANEL SHADE STRUCTURE WITH STEEL TUBE FRAME ON WEST END (HIDDEN FOR CLARITY)   |
| MP-8                     | STANDING SEAM METAL ROOF TO MATCH MP-1  |
|                          |   |
| GL-1                     | STOREFRONT TYPE 1: 2" x 4.5" KAWNEER PERMACOAT SMOKE GRAY ALUMINUM CENTER GLAZED STOREFRONT SYSTEM W/ 1" INSULATED LOW-E GLAZING UNIT   |
| GL-2                     | CURTAINWALL TYPE 1: 2.5" x 10.5" KAWNEER PERMACOAT SMOKE GRAY CURTAINWALL W/ 1" INSULATED LOW-E GLAZING UNIT  |
| GL-3                     | CURTAINWALL TYPE 2: 3" x 10.5" KAWNEER PERMACOAT SMOKE GRAY SSG CURTAINWALL W/ 1" INSULATED LOW-E GLAZING UNIT  |
| GL-4                     | CURTAINWALL TYPE 3: 2.5" x 7.5" KAWNEER PERMACOAT SMOKE GRAY CURTAINWALL STOREFRONT W/ 1" INSULATED LOW-E GLAZING UNIT  |
| GL-5                     | CURTAINWALL TYPE 4: 2.5" x 6" KAWNEER PERMACOAT SMOKE GRAY CURTAINWALL CLERESTORY W/ 1" INSULATED LOW-E GLAZING UNIT  |
| GL-6                     | LIVERS BRONZE GLASS FRAMELESS STRUCT-U-RAIL SYSTEM, CLEAR LAMINATED TEMPERED GLASS<br>TOP COURSE OF STOREFRONT / CURTAINWALL GLAZING AT CLERESTORY TO BE SPANDREL GLASS: PPG SOLARBAN 70XL SOLAR CONTROL LOW-E GLAZING UNIT/W/ "SUBDUED" 5010 OPAQUEIFIER ON 4TH SURFACE, OR APPROVED EQUAL |
|                          |   |
| WD-1                     | GEOLAM VERTIGO 5010 COMPOSITE CLADDING, COLOR: MOLESKIN   |
| WD-2                     | GEOLAM SOLEO 8008 COMPOSITE TRIM, COLOR: MOLESKIN   |
| WD-3                     | GEOLAM SOLEO 8008 COMPOSITE TRIM, COLOR: MOLESKIN (HIDDEN FOR CLARITY)  |
|                          |   |
| ST-1                     | ELDORADO CULTURED STONE VANTAGE 30, COLOR: WHITE ELM**  |
| ST-2                     | ELDORADO CULTURED STONE MARQUEE24, COLOR: DOVETAIL**  |
| ST-3                     | 2CM COPPER QUARTZITE CLADDING; PANEL SEAMS PER ELEVATIONS<br>**PROVIDE CONTROL JOINT AT SECOND LEVEL ON ALL ST-1 AND ST-2 LOCATIONS PER MANUF. RECOMMENDATIONS  |
|                          |   |
| MB-1                     | GROUND FACE 8X16 MASONRY BLOCK PER STRUCTURAL DWGS, BURNISHED FINISH, COLOR: MIDWEST SLATE  |
|                          |   |
| AWN-1                    | CANOPY TYPE 1: STEEL CHANNEL WRAP WITH GEOLAM VERTIGO 5010 SOFFIT (COLOR: MOLESKIN)   |
| AWN-2                    | CANOPY TYPE 2: CANTILEVERED GEOLAM 8008 TRIM  |
|                          |   |
| WL-1                     | EXTERIOR WALL LIGHT PER RCP. MOUNT W/ TOP ALIGNED AT 12'-0" AFF; CENTER ON WALL SPACE PER ELEVATIONS UNO  |
| WL-2                     | EXTERIOR WALL LIGHT PER RCP. MOUNT W/ TOP ALIGNED AT 12'-0" AFF; CENTER ON WALL SPACE PER ELEVATIONS UNO  |
|                          |   |
| FP-1                     | LOCATION FOR FDC AND KNOX BOX PER FIRE PROTECTION DRAWINGS; CENTER FIXTURES IN WALL UNO   |
| PD-1                     | ROOF OVERFLOW DRAIN DOWNSPOT COVER PER PLUMBING DRAWINGS; CENTER UNDER WL-1 ABV OR ON WALL SPACE UNO  |





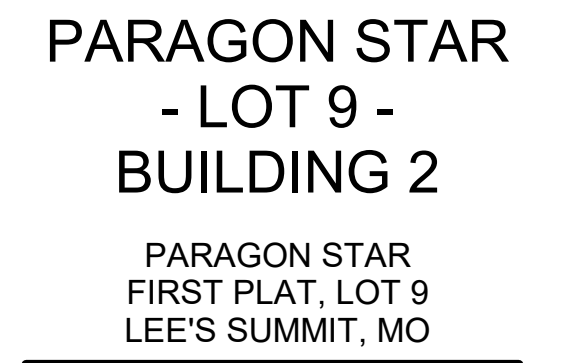


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|                 |                                 |
|-----------------|---------------------------------|
| ARCHITECT       | FINKE/ WILLIAMS<br>ARCHITECTURE |
| CIVIL           | GBA                             |
| LANDSCAPE       | HOERR SCHAUDT /<br>LANO3        |
| FOUNDATIONS     | BSE STRUCTURAL<br>ENGINEERS     |
| STRUCTURAL      | BSE STRUCTURAL<br>ENGINEERS     |
| PLUMBING        | HENDERSON<br>ENGINEERS          |
| MECHANICAL      | HENDERSON<br>ENGINEERS          |
| ELECTRICAL      | HENDERSON<br>ENGINEERS          |
| FIRE PROTECTION | HENDERSON<br>ENGINEERS          |
| CONTRACTOR      | FOGEL ANDERSON                  |




## BUILDING SECTIONS

A5.00



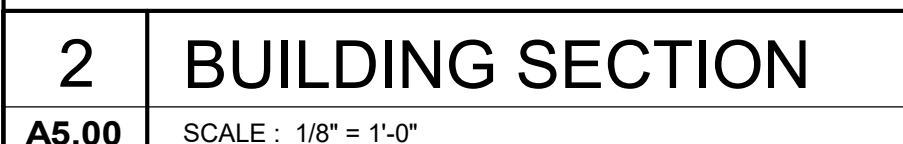

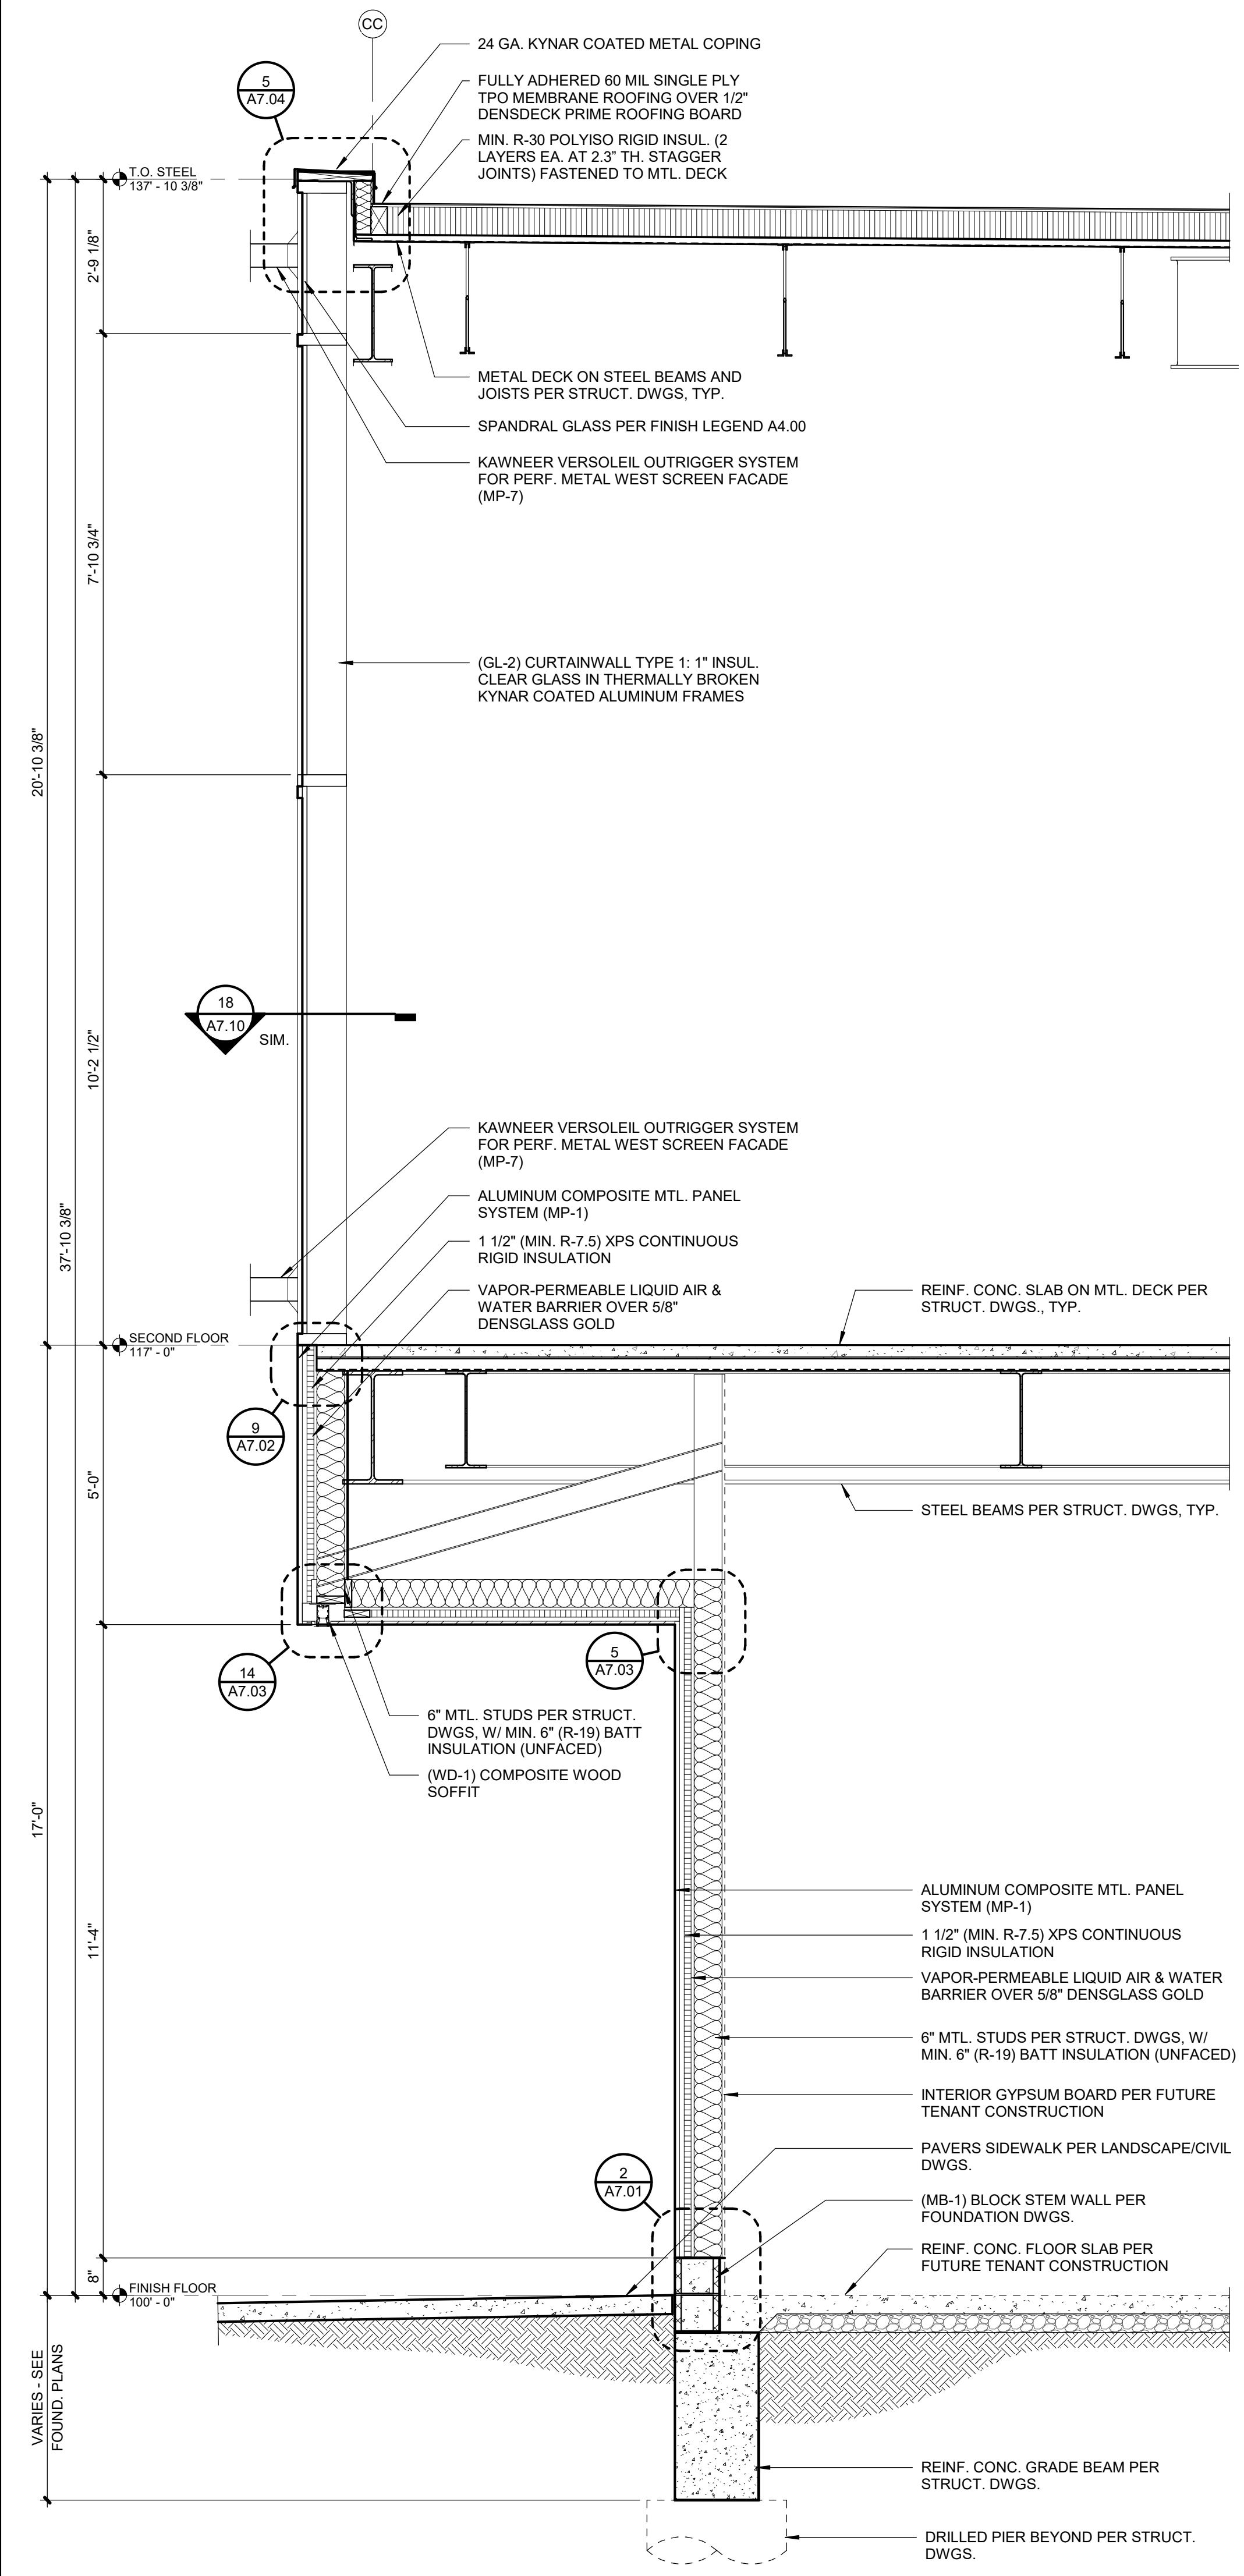





Project No.: 19050.01  
Date: 10.25.19  
Issued For: SHELL - CD SET

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REGISTRATION



## PROJECT TEAM

|                 |                                 |
|-----------------|---------------------------------|
| ARCHITECT       | FINKLE+WILLIAMS<br>ARCHITECTURE |
| CIVIL           | GBA                             |
| LANDSCAPE       | HOERR SCHAUDT /<br>LAND3        |
| FOUNDATIONS     | BSE STRUCTURAL<br>ENGINEERS     |
| STRUCTURAL      | BSE STRUCTURAL<br>ENGINEERS     |
| PLUMBING        | HENDERSON<br>ENGINEERS          |
| MECHANICAL      | HENDERSON<br>ENGINEERS          |
| ELECTRICAL      | HENDERSON<br>ENGINEERS          |
| WIRE PROTECTION | HENDERSON<br>ENGINEERS          |
| CONTRACTOR      | FOGEL ANDERSON                  |

FINKLE + WILLIAMS  
ARCHITECTURE


7007 College Blvd, Suite 415  
Overland Park, Kansas 66211  
913-498-1550

SHEET TITLE


WALL SECTIONS

SHEET NUMBER


## A5.02

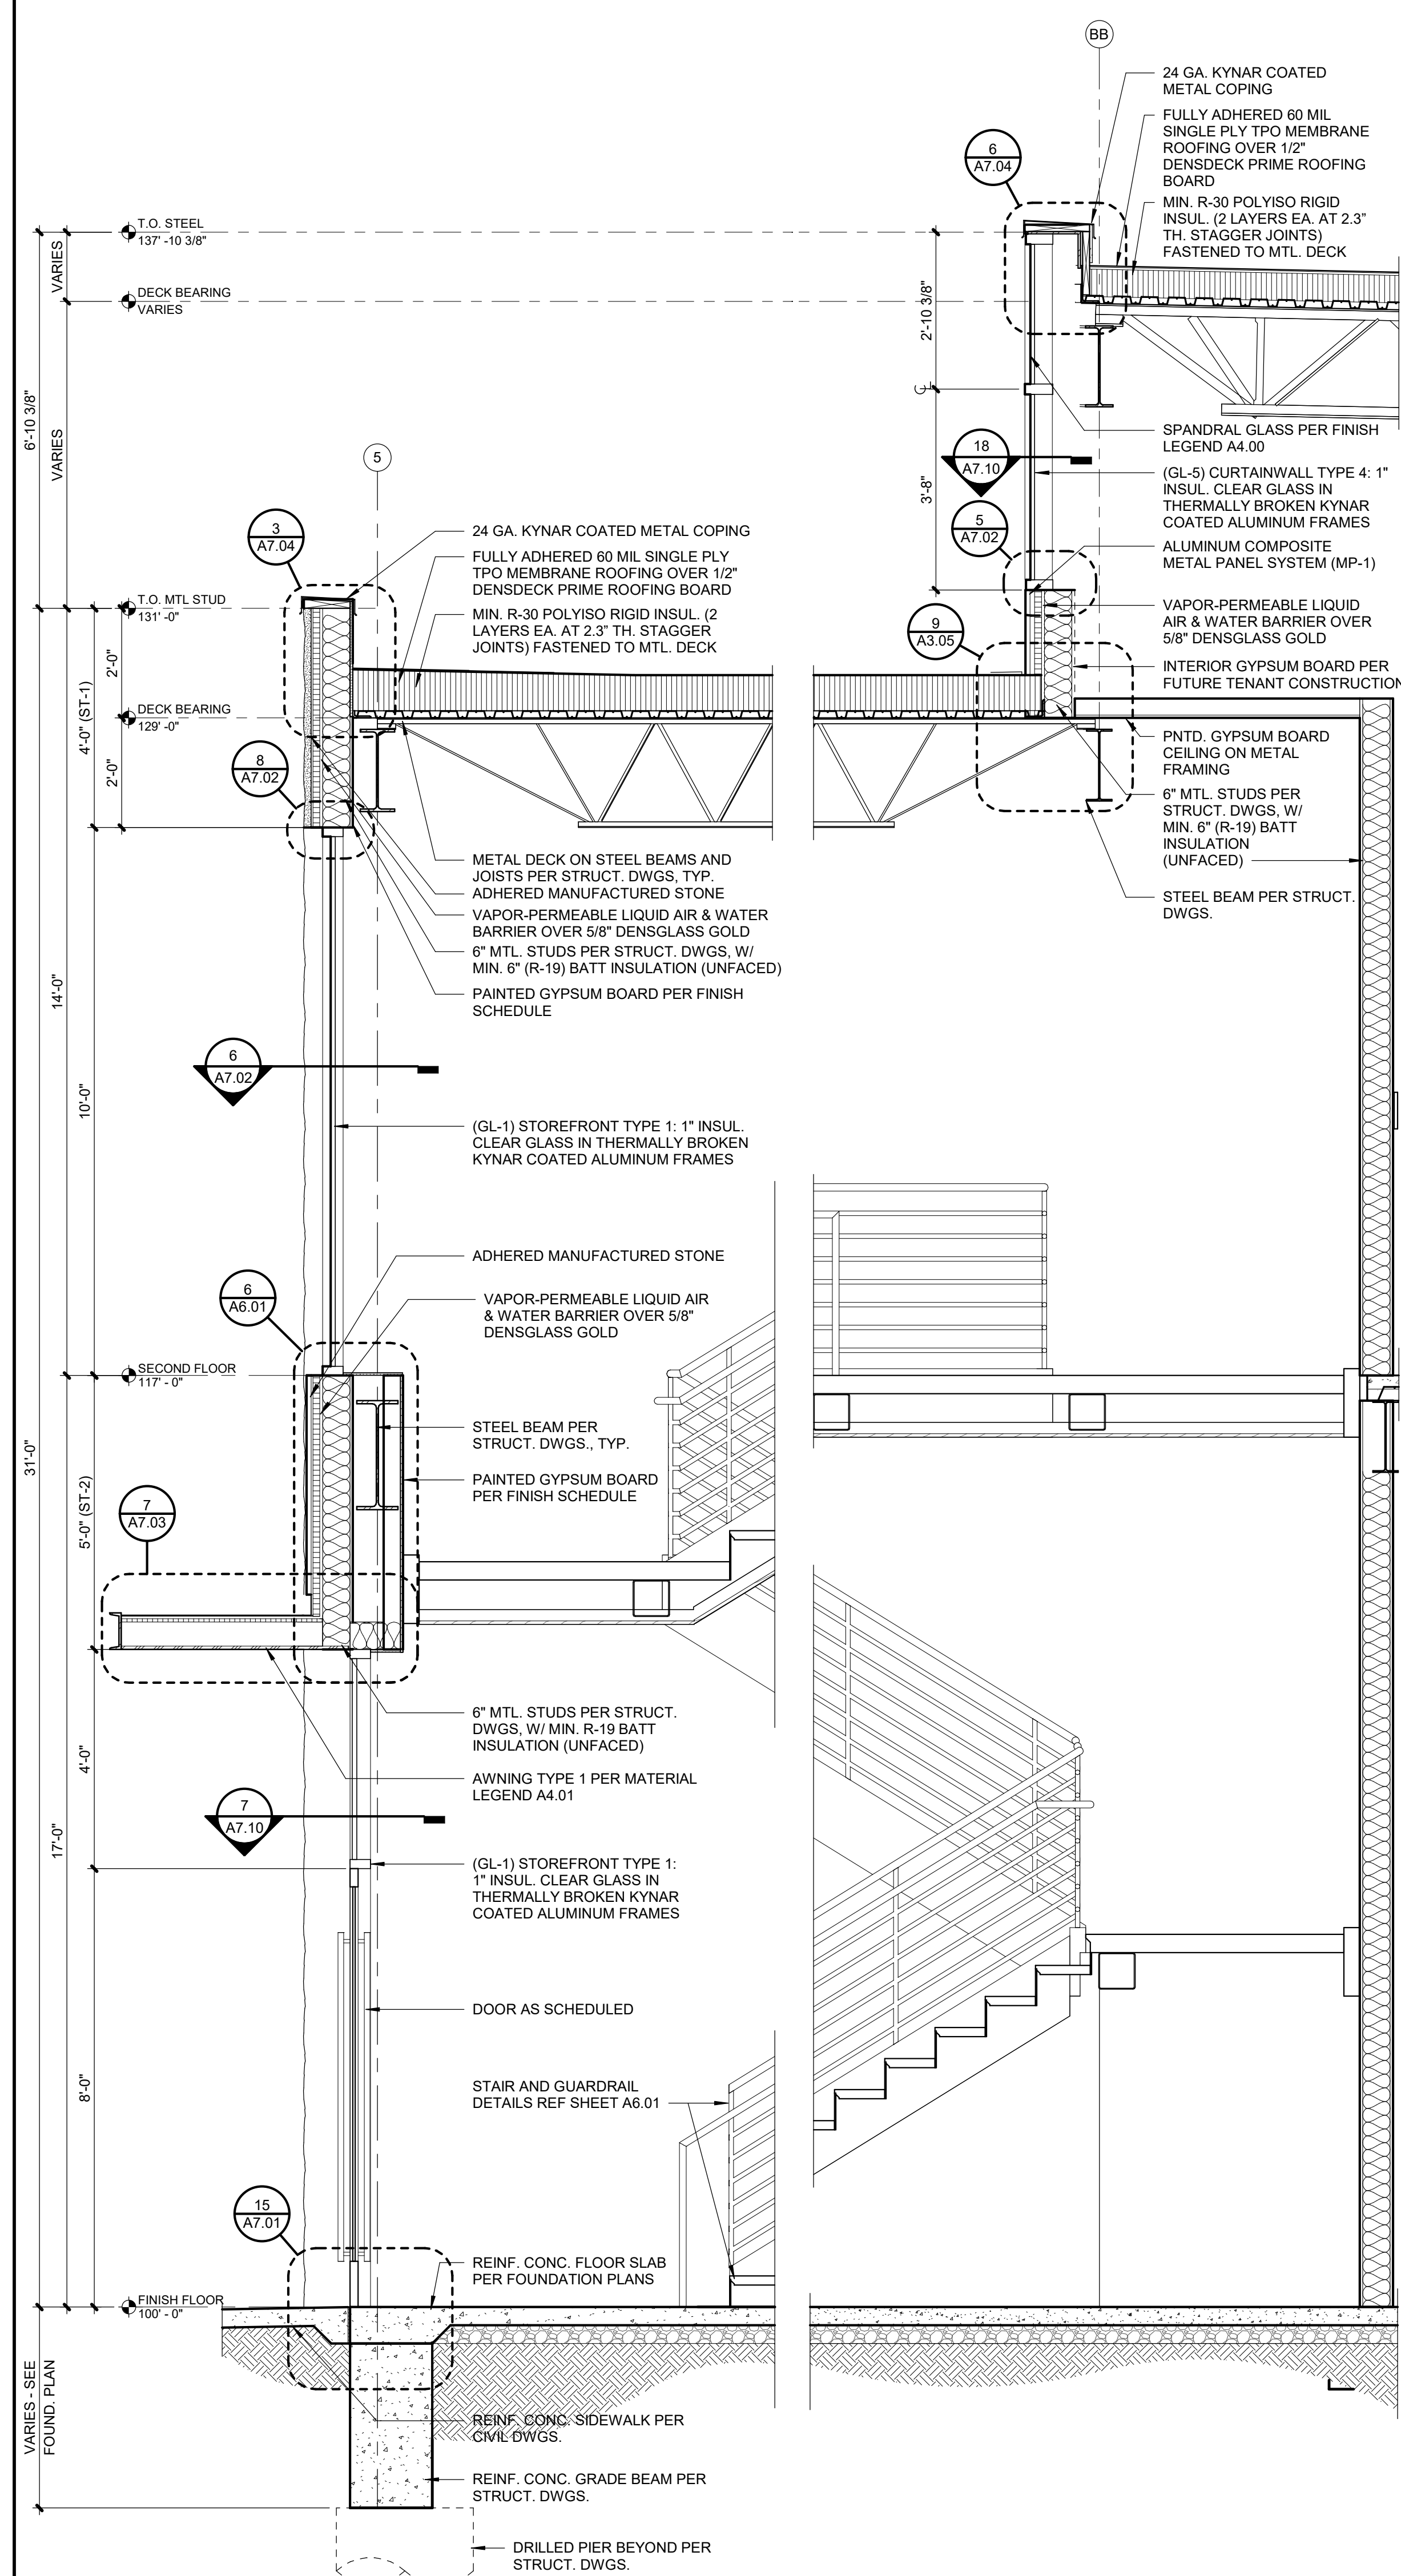

|       |                      |
|-------|----------------------|
| 3     | WALL SECTION         |
| A5.02 | SCALE : 1/2" = 1'-0" |


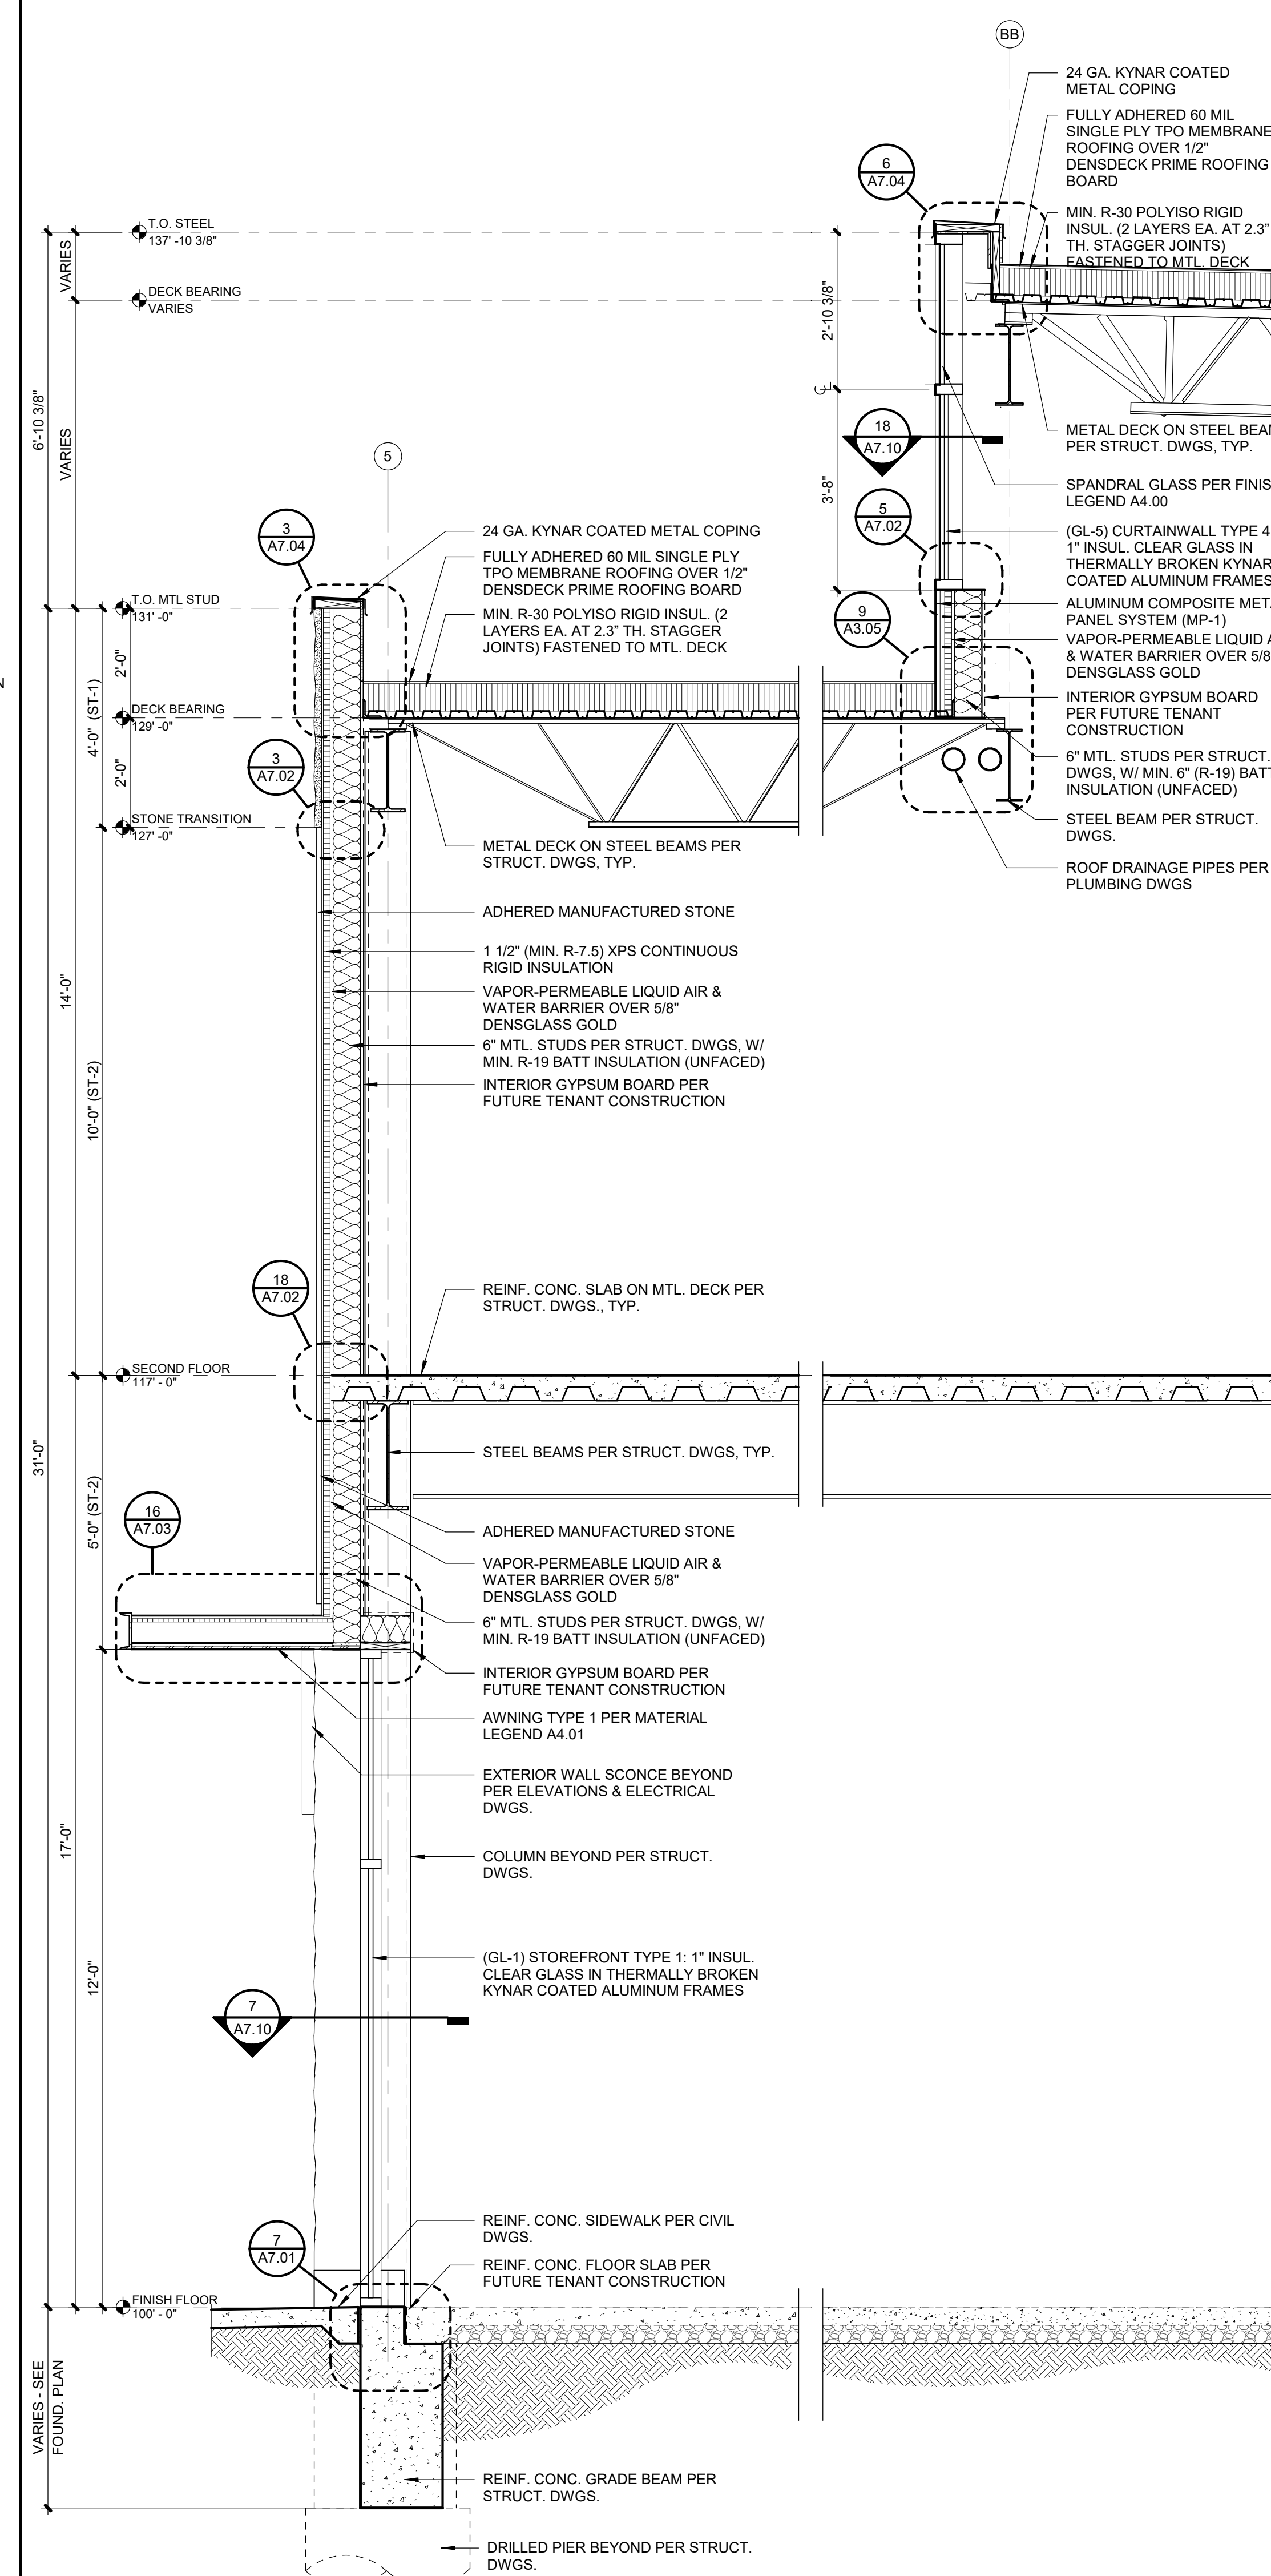


|       |                      |
|-------|----------------------|
| 2     | WALL SECTION         |
| A5.02 | SCALE : 1/2" = 1'-0" |

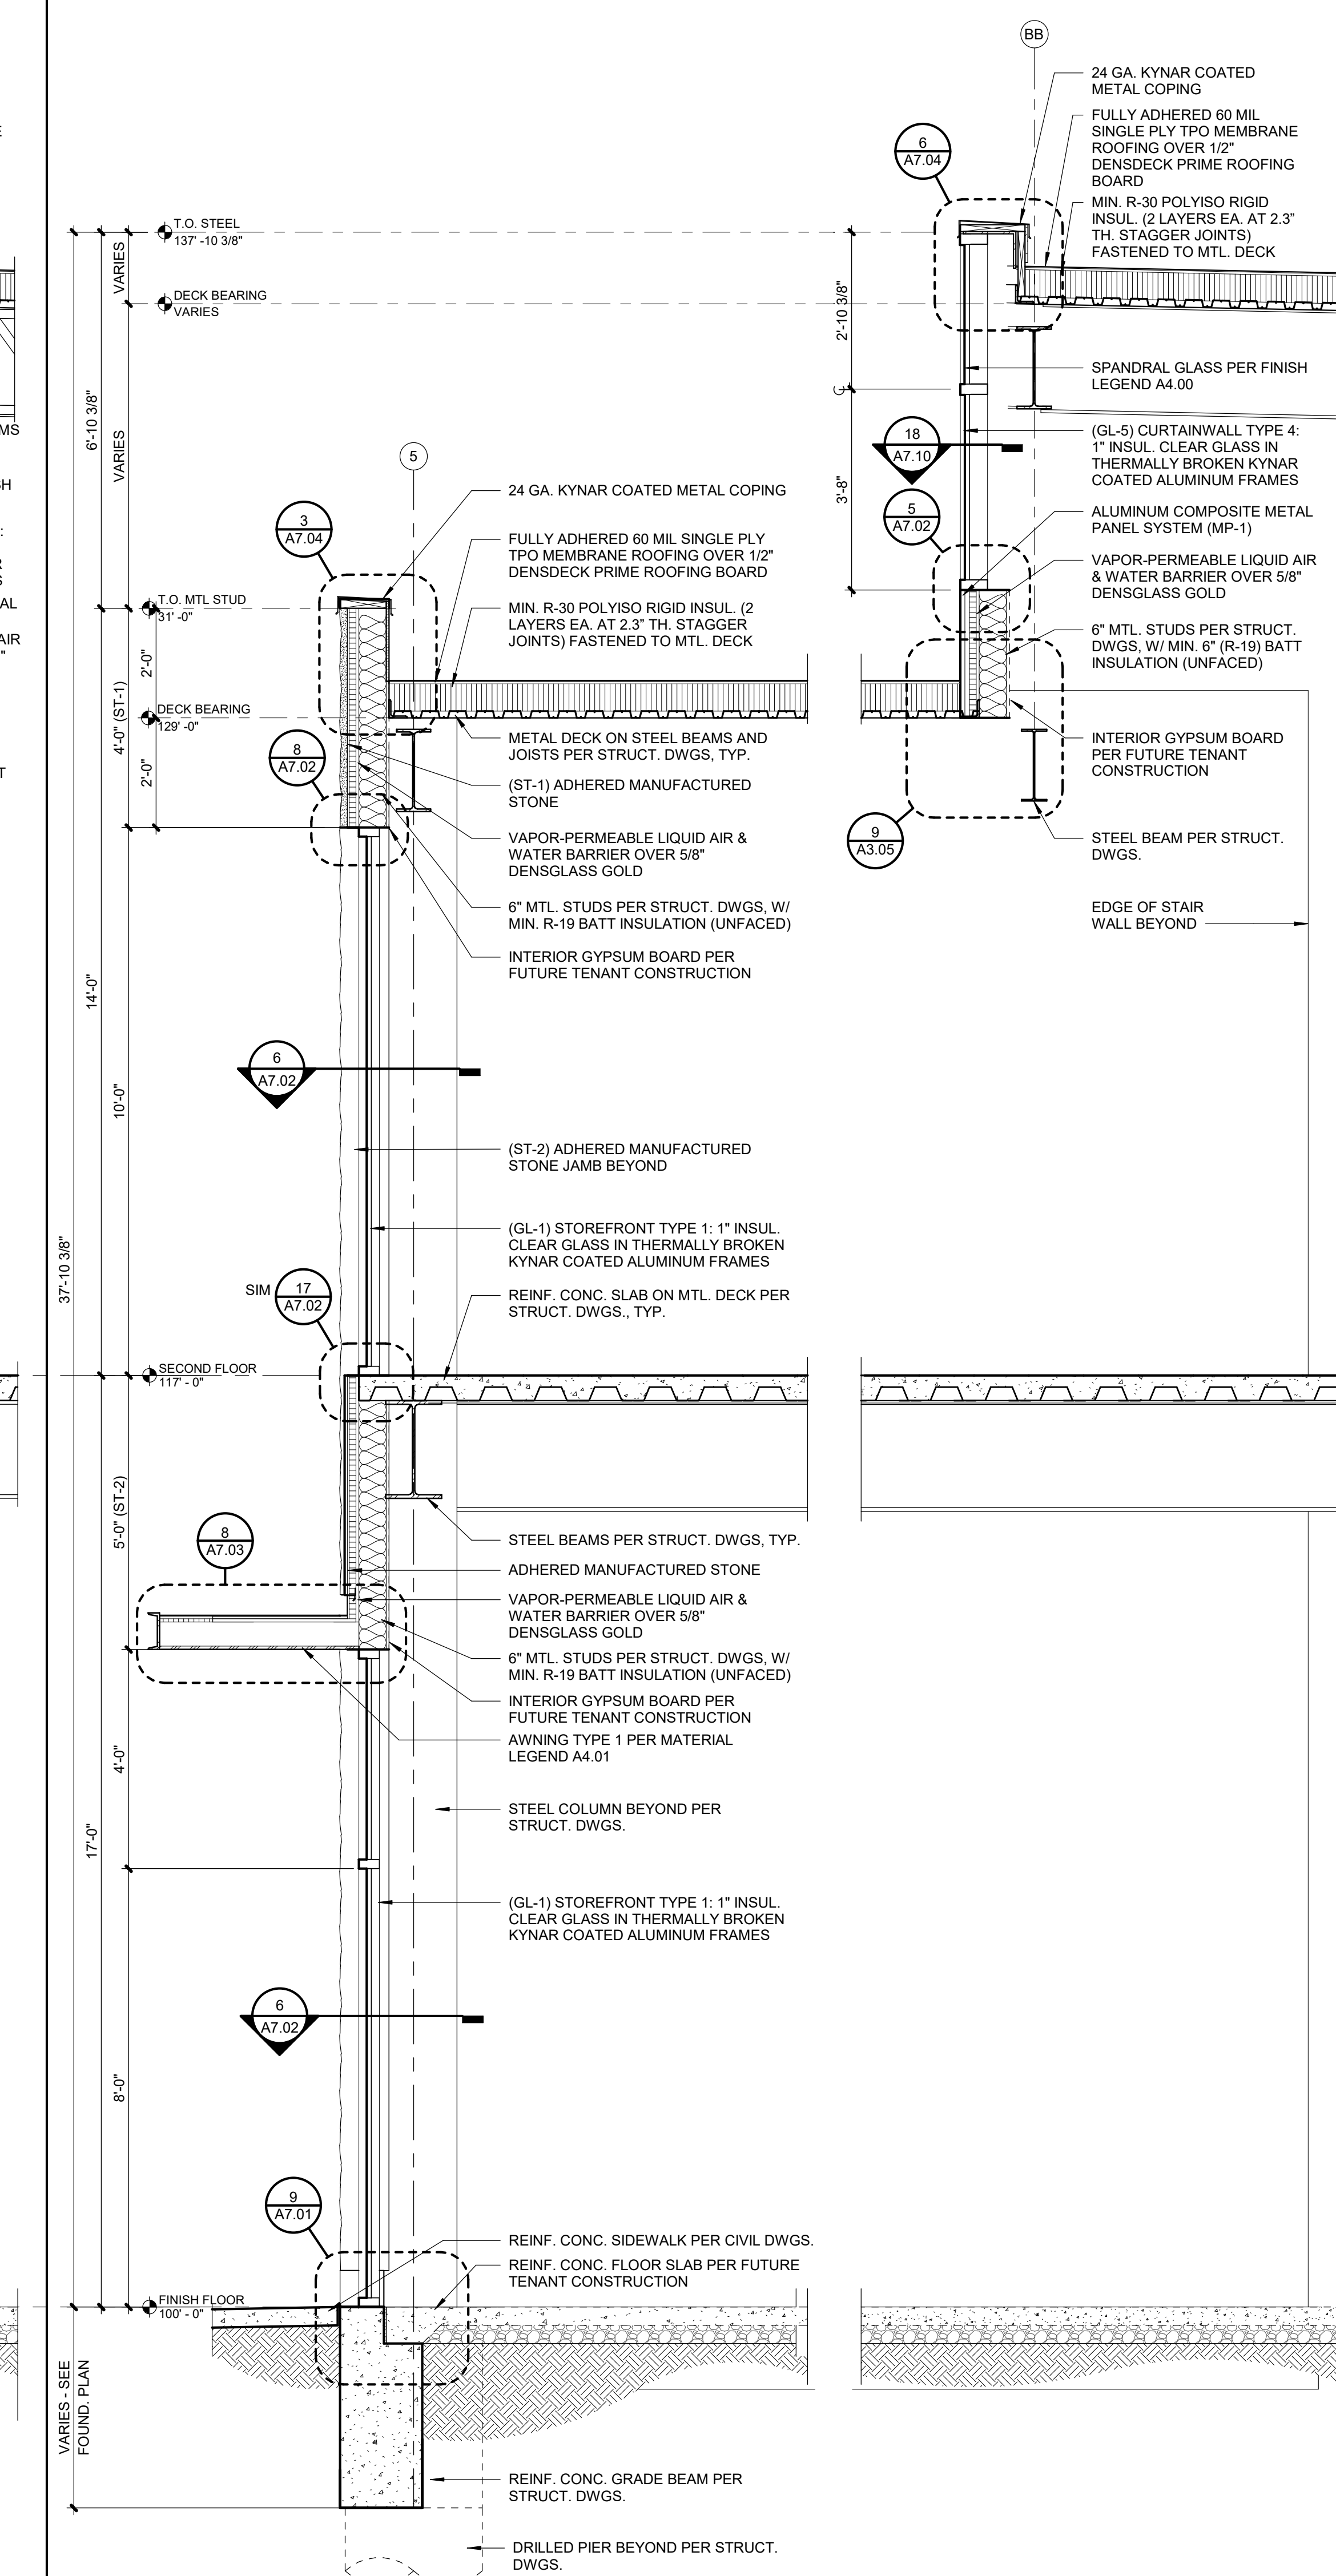

|       |                      |
|-------|----------------------|
| 1     | WALL SECTION         |
| A5.02 | SCALE : 1/2" = 1'-0" |



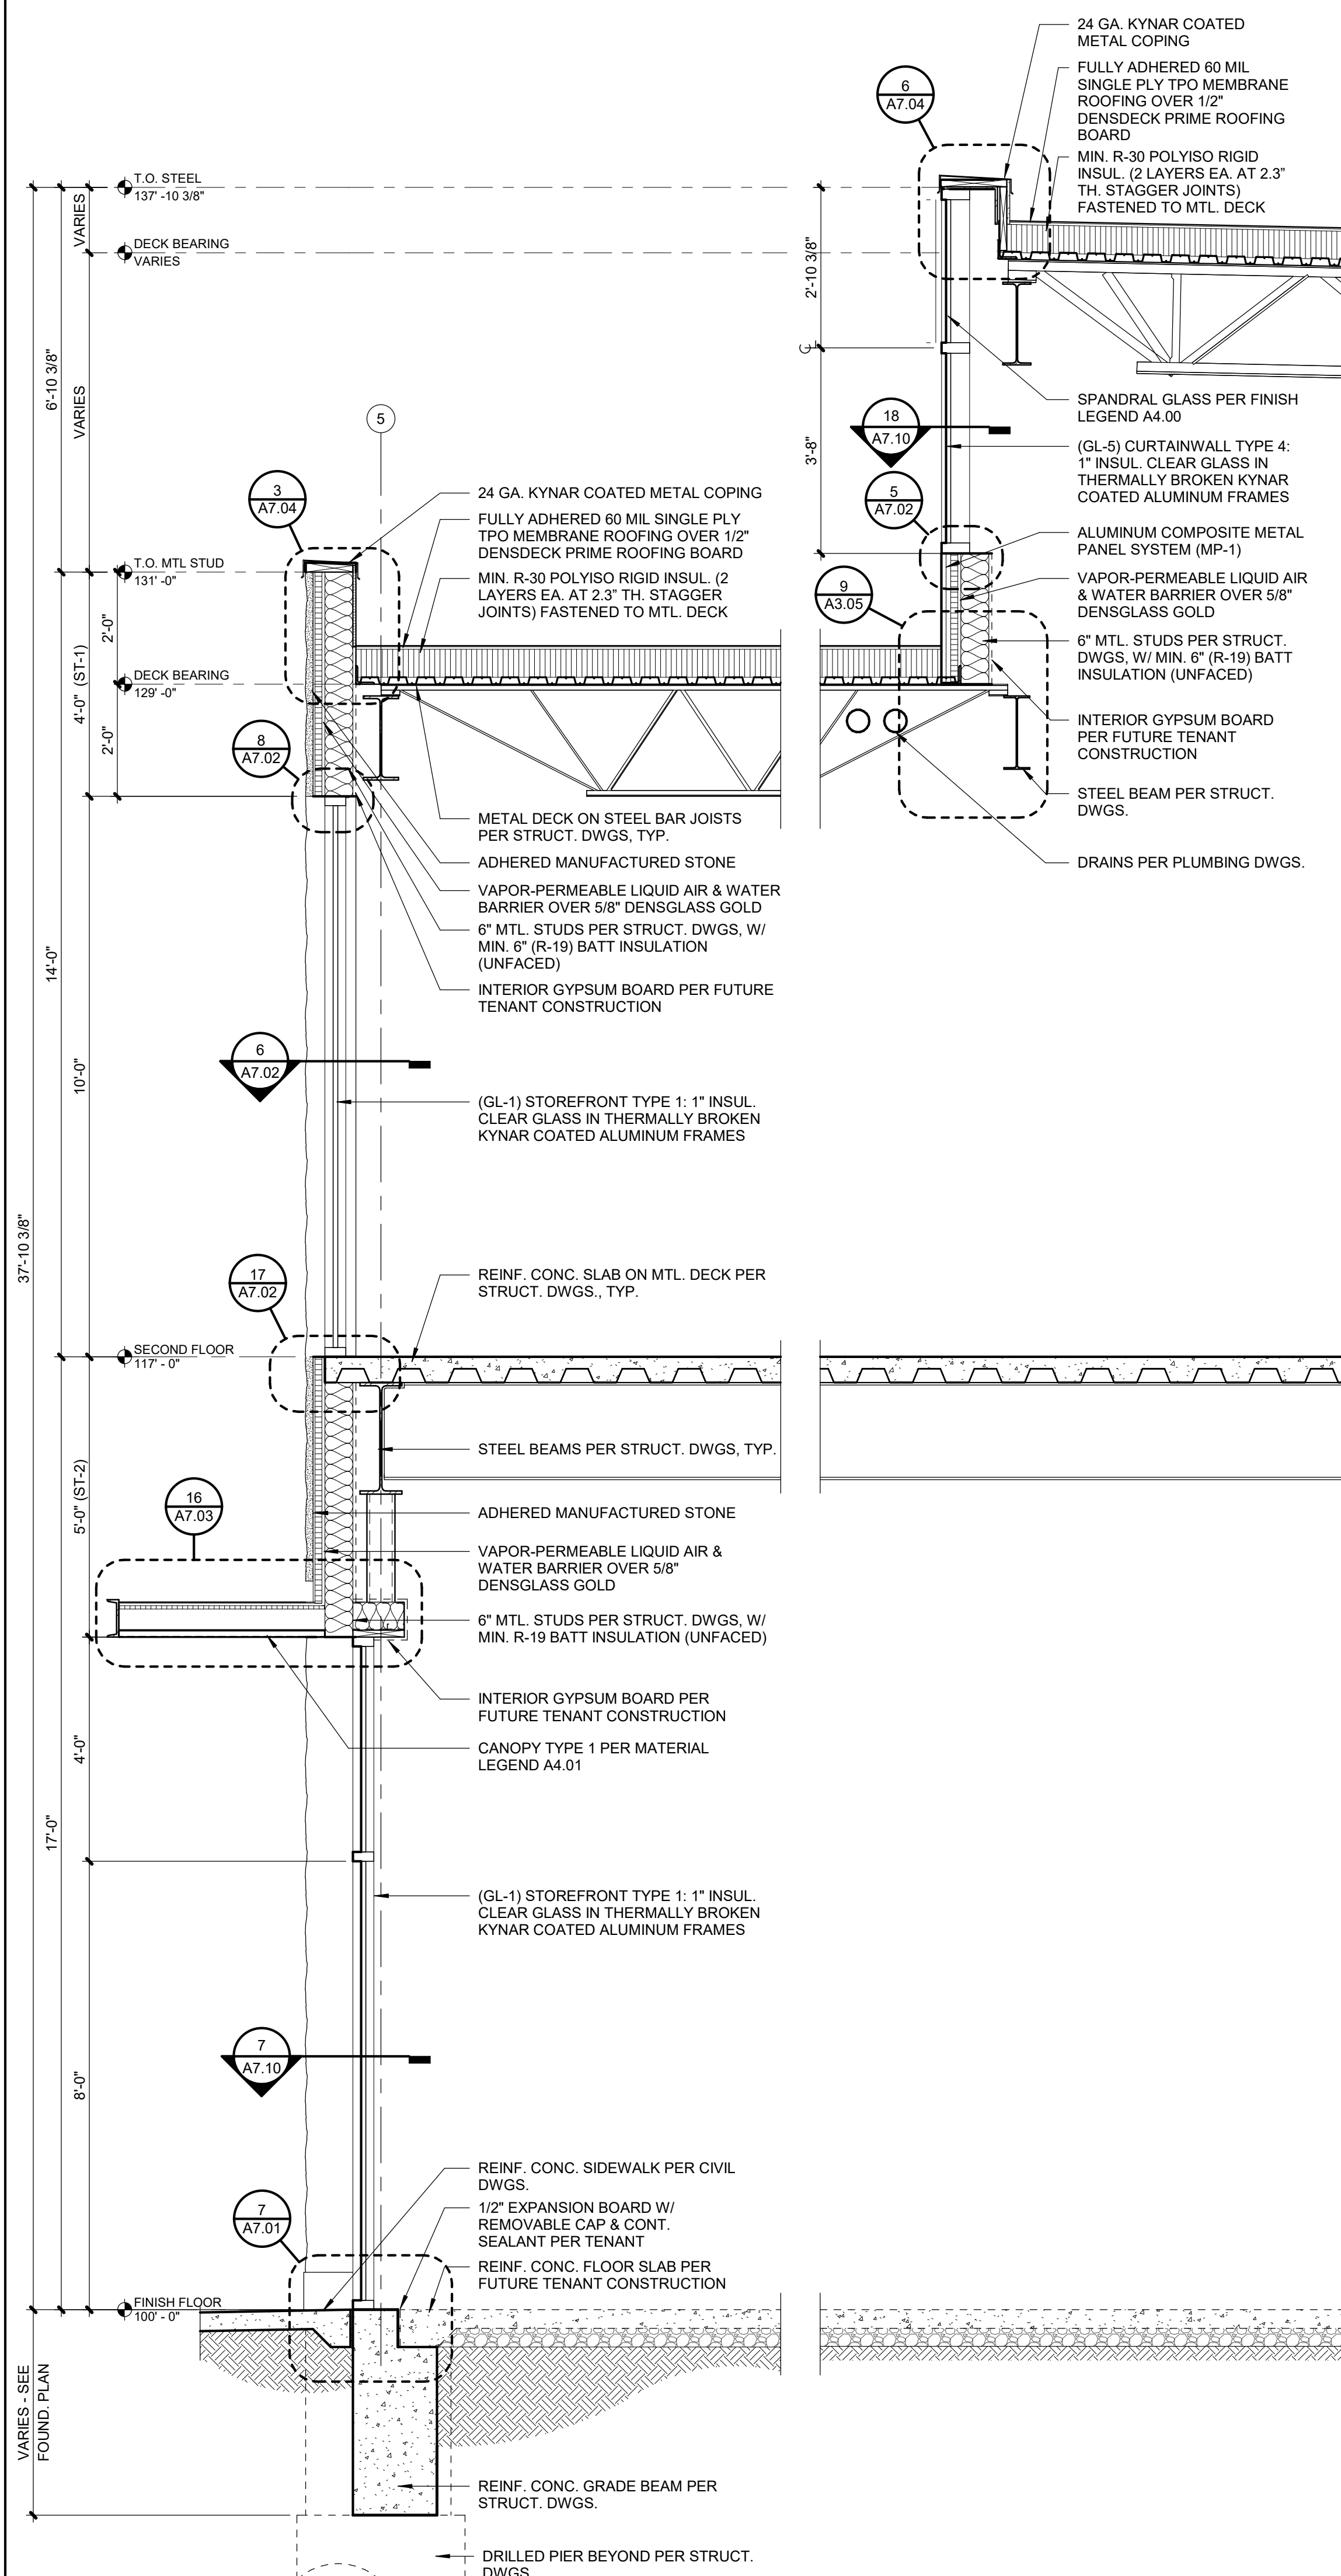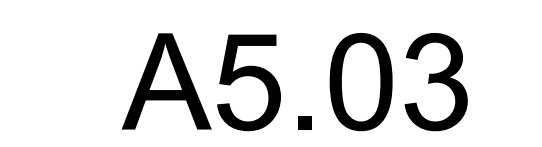

|   |              |
|---|--------------|
| 1 | WALL SECTION |
|---|--------------|







**A5.04** SCALE: 1/2" = 1'-0"




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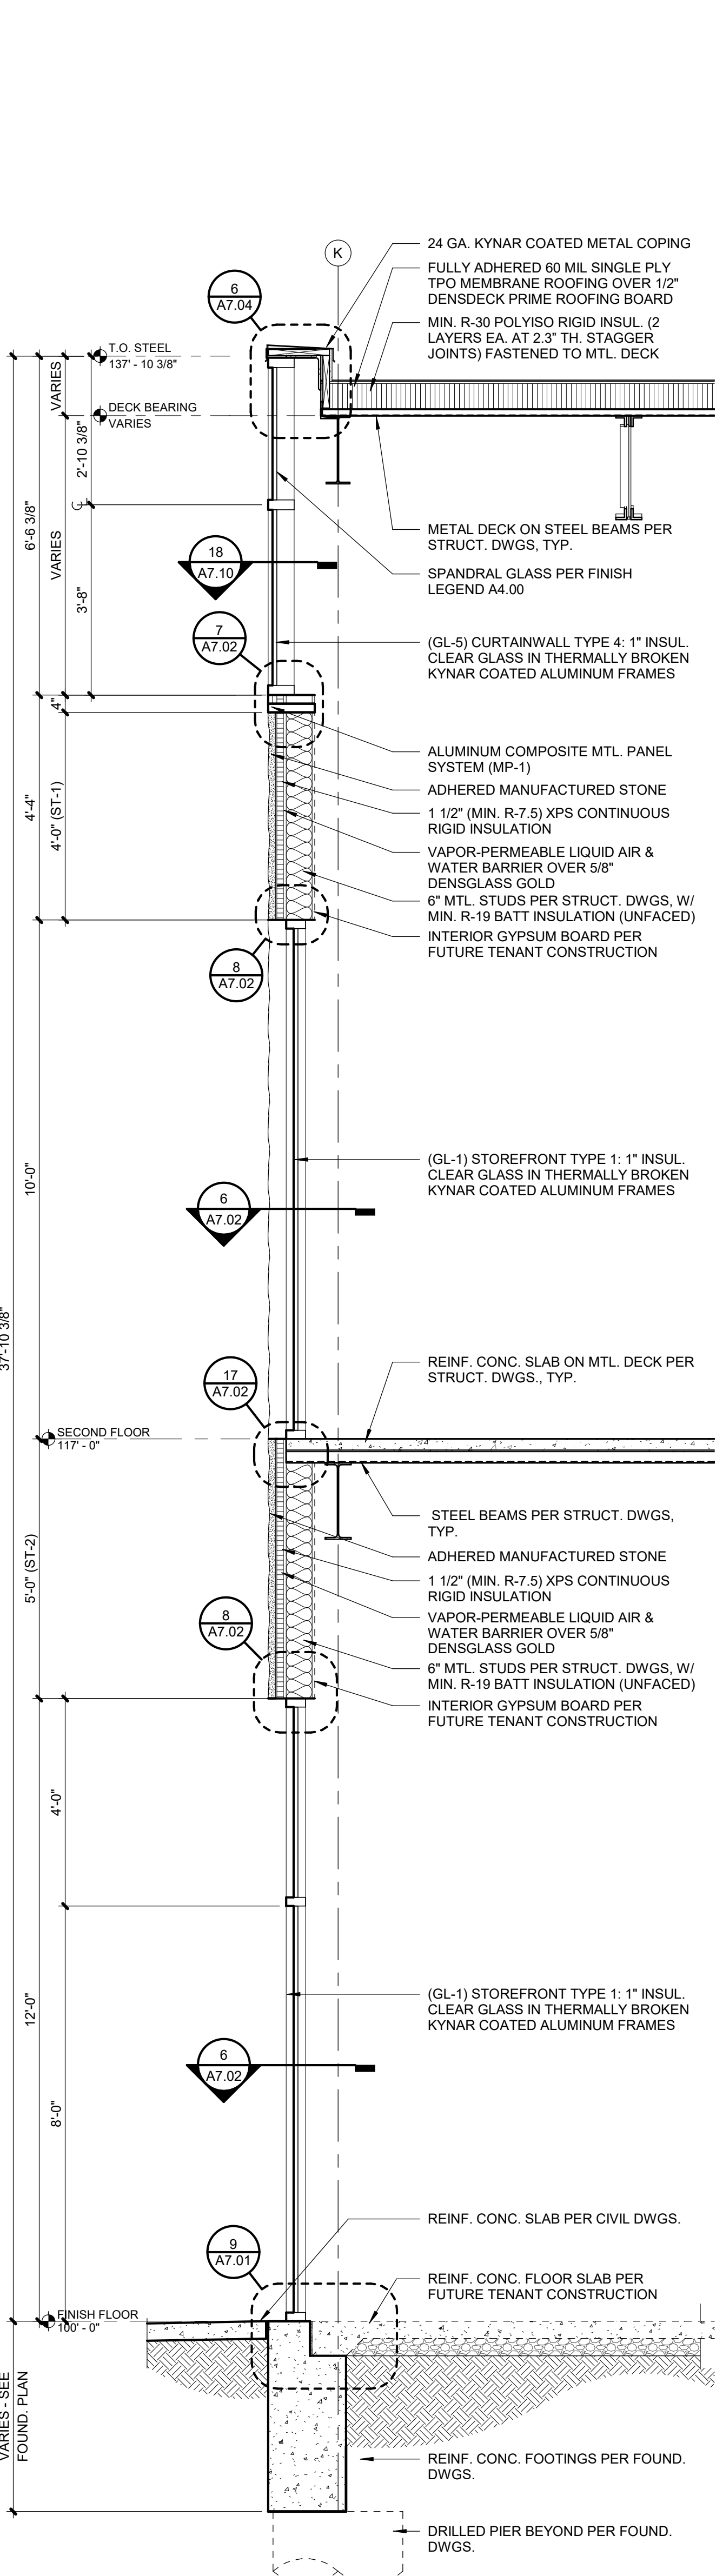
5 WALL SECTION  
A5.05 SCALE: 1/2" = 1'-0"

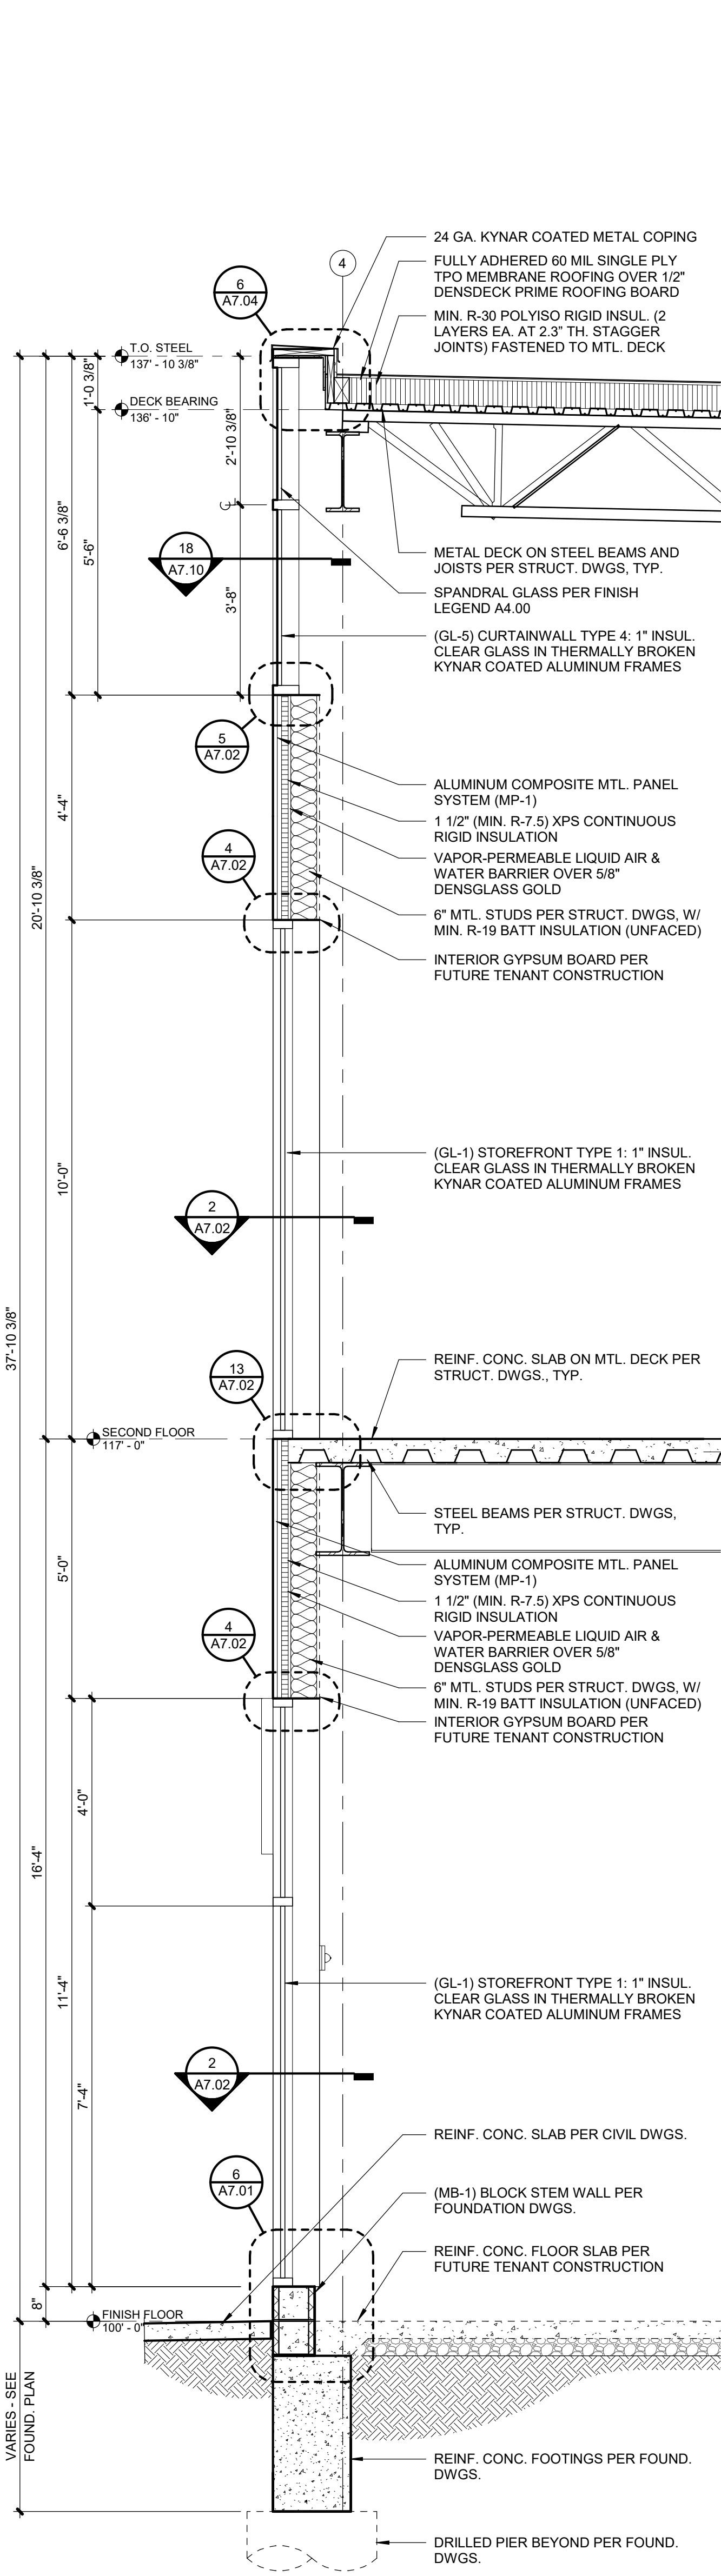


4 WALL SECTION  
A5.05 SCALE: 1/2" = 1'-0"

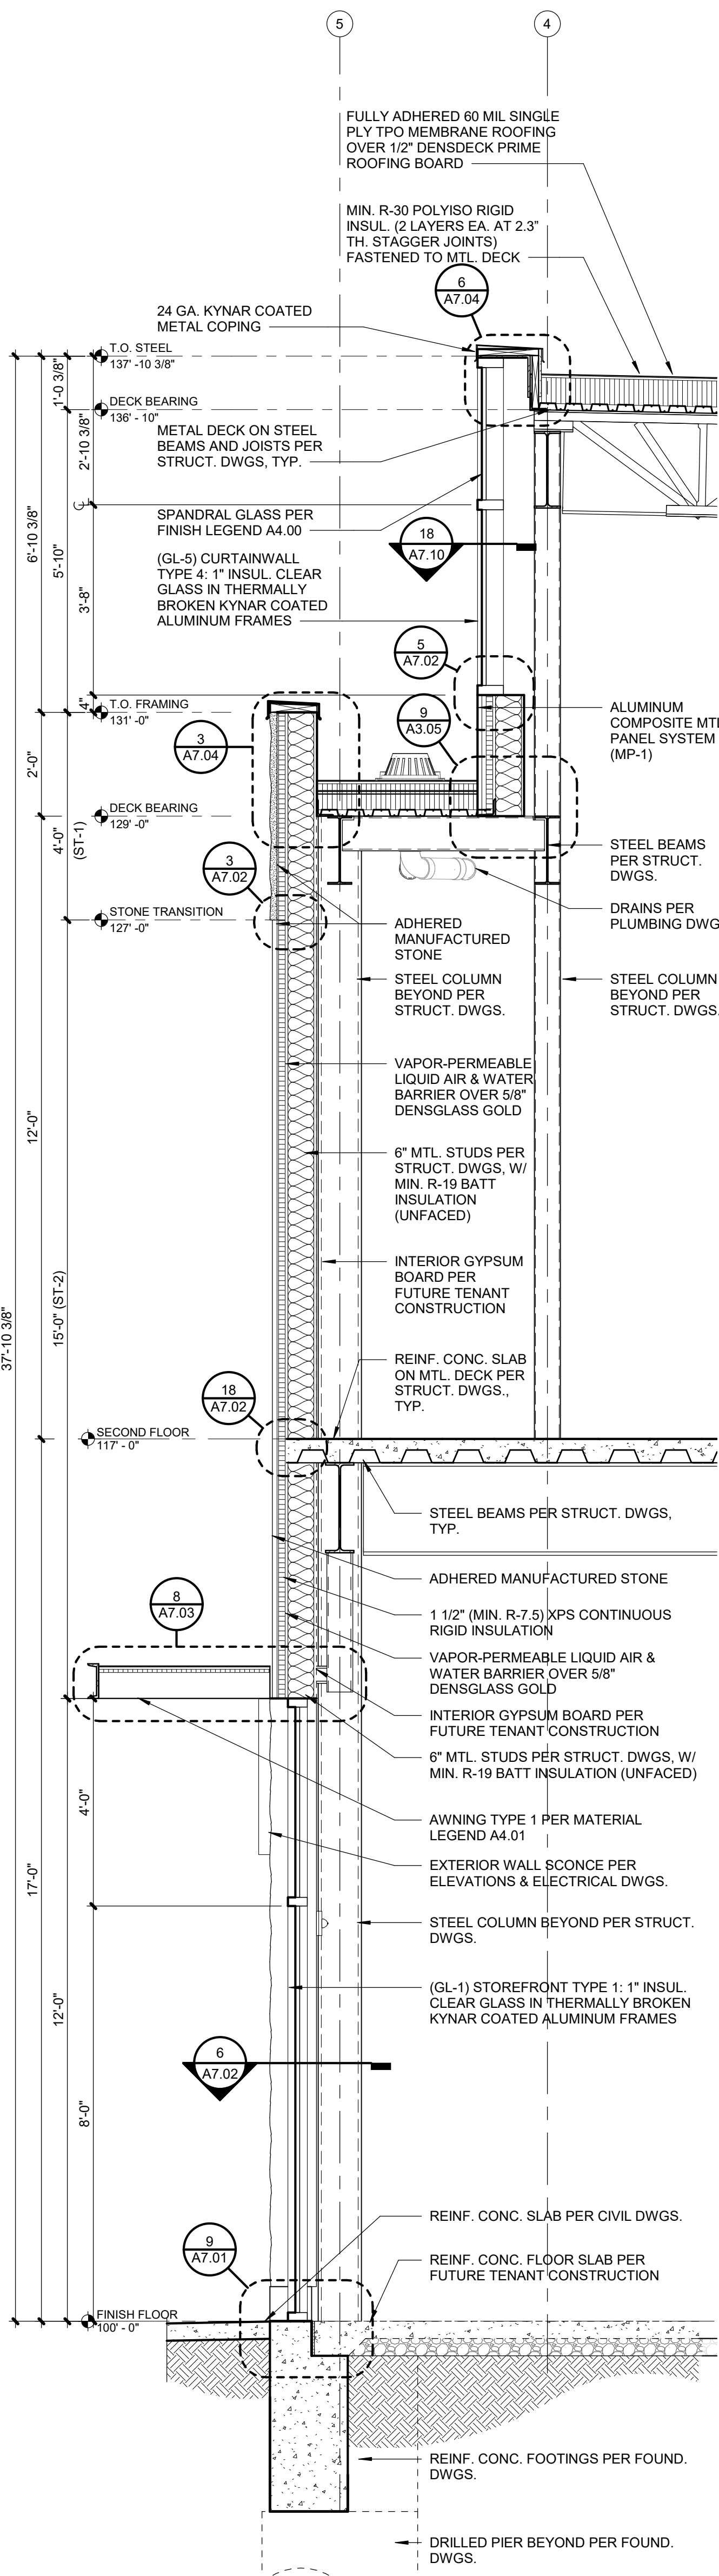

3 WALL SECTION  
A5.05 SCALE: 1/2" = 1'-0"

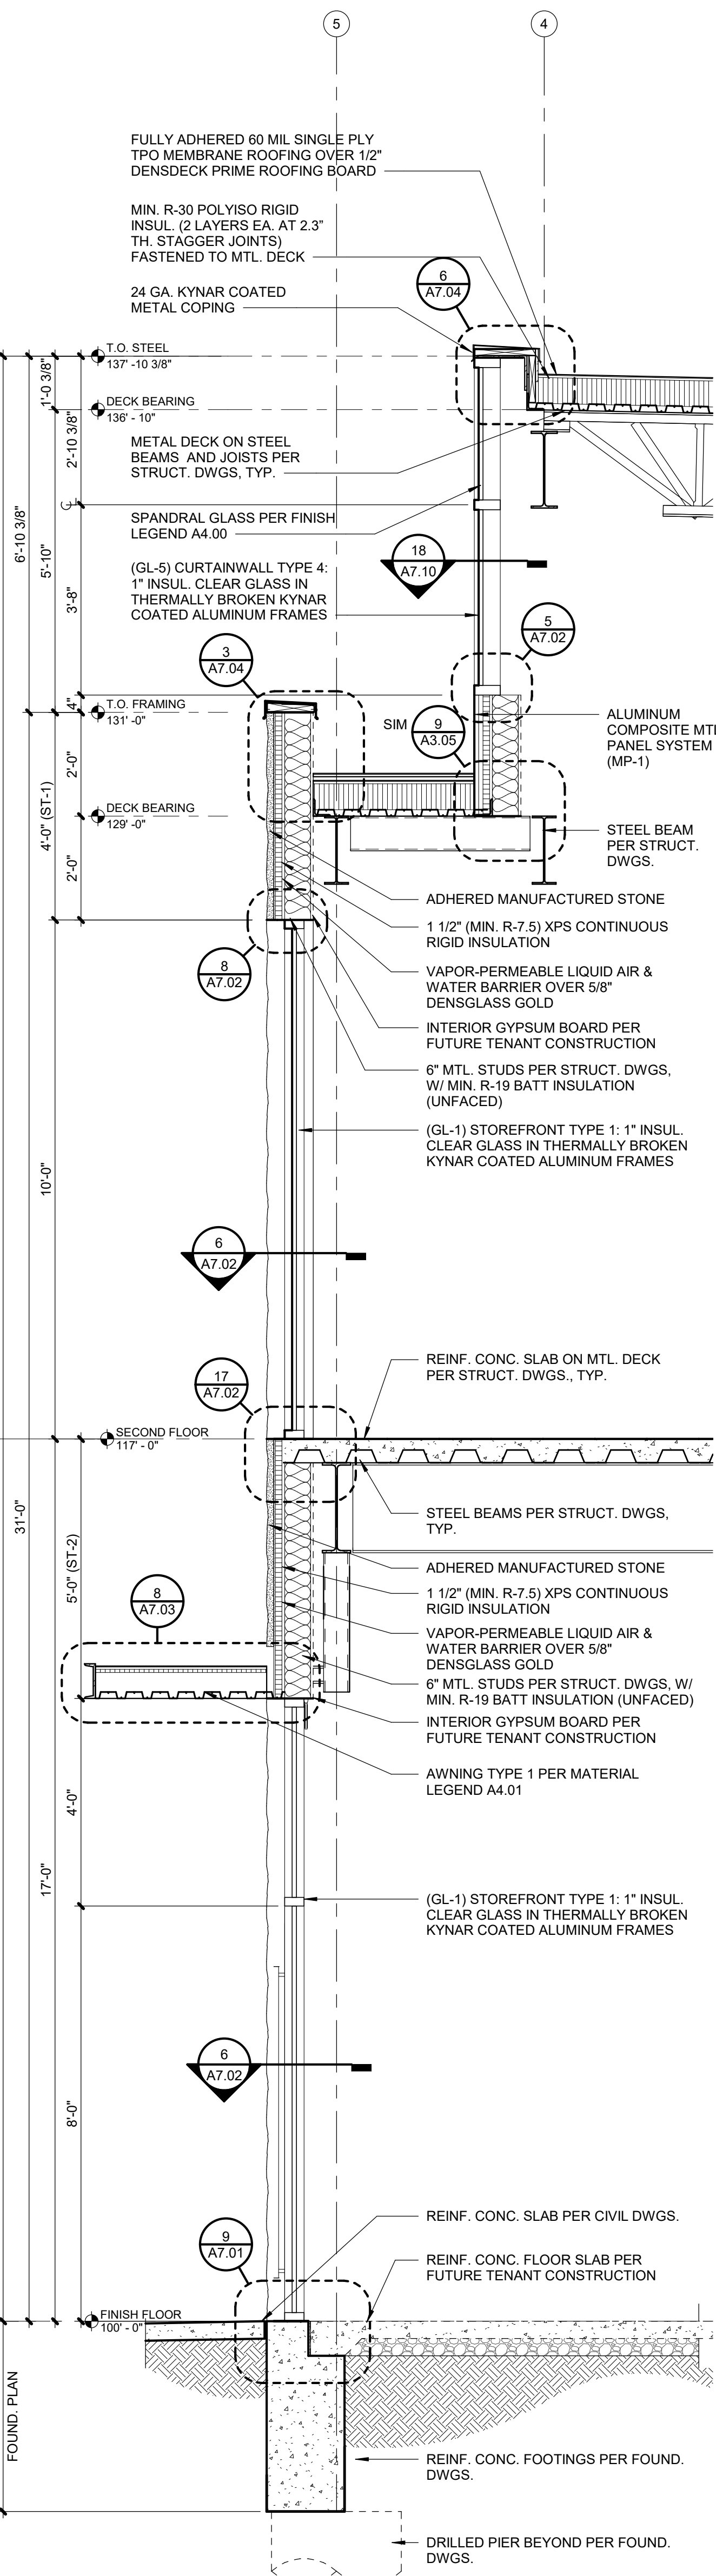

2 WALL SECTION  
A5.05 SCALE: 1/2" = 1'-0"

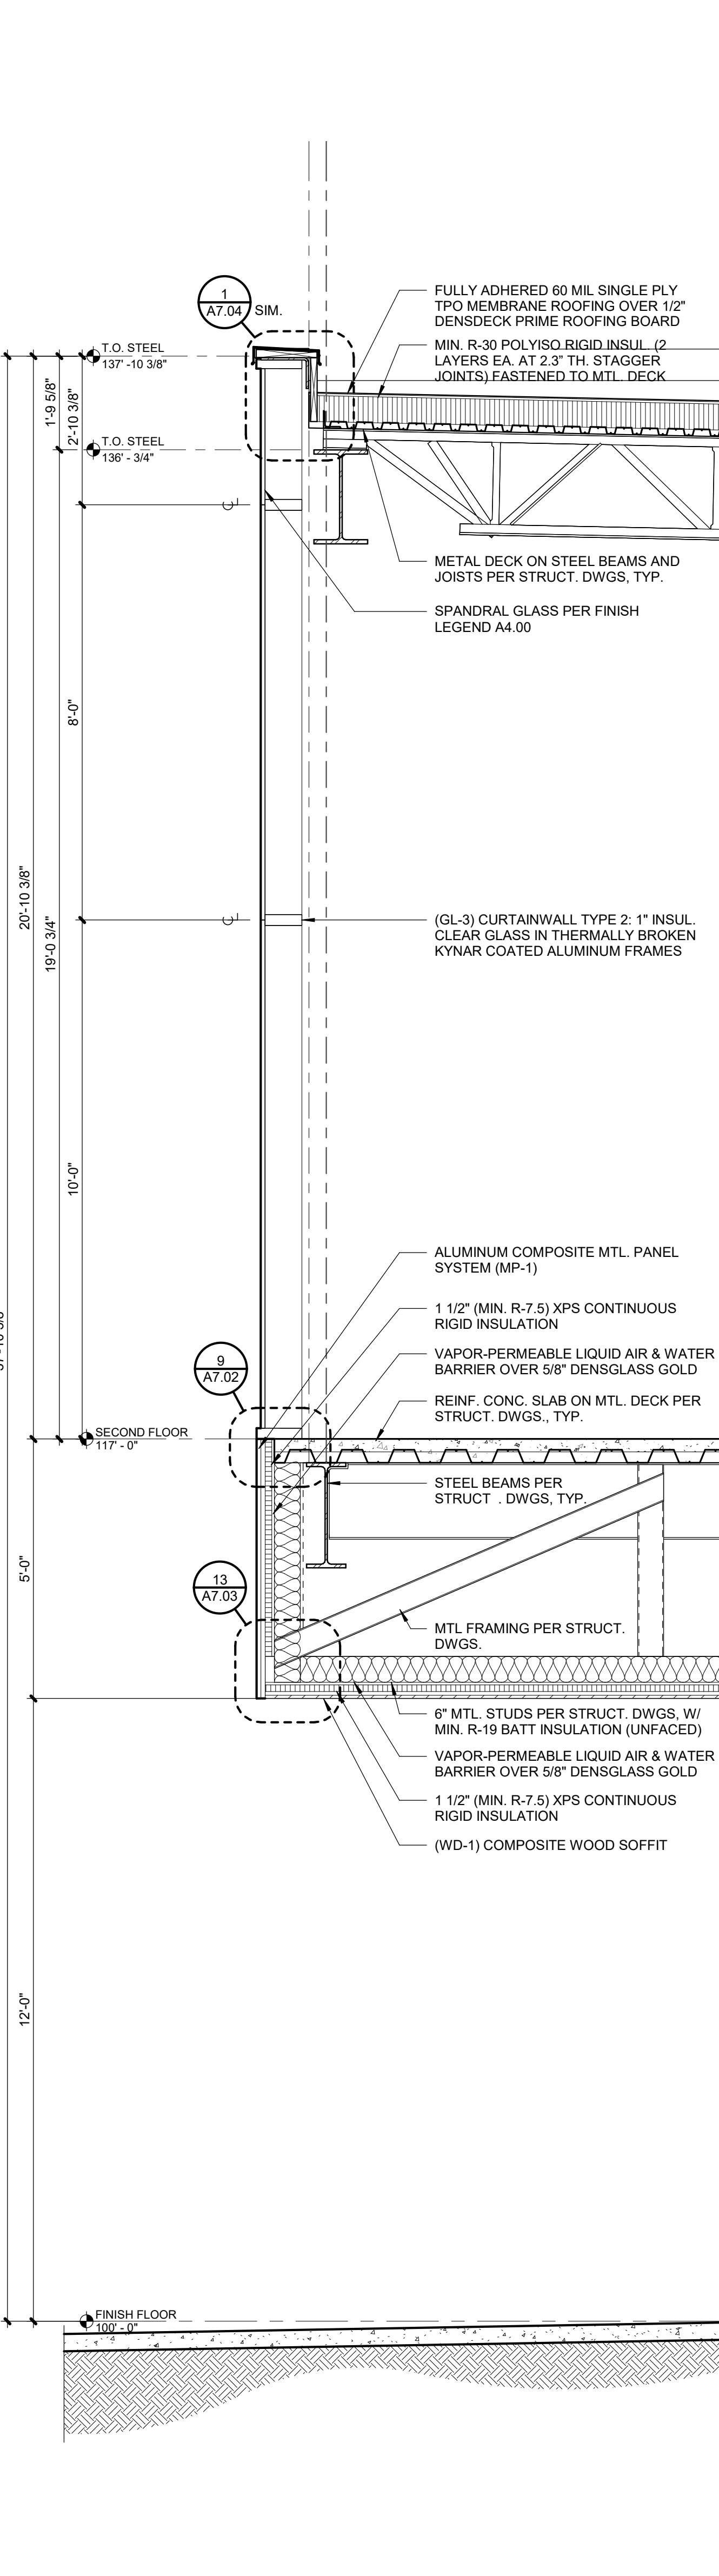

1 WALL SECTION  
A5.05 SCALE: 1/2" = 1'-0"




PARAGON STAR  
- LOT 9 -  
BUILDING 2

PARAGON STAR  
FIRST PLAT, LOT 9  
LEE'S SUMMIT, MO

Project No.: 19050.01  
Date: 10.25.19  
Issued For: SHELL - CD SET

| REVISIONS |      |             |
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| No.       | Date | Description |
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REGISTRATION

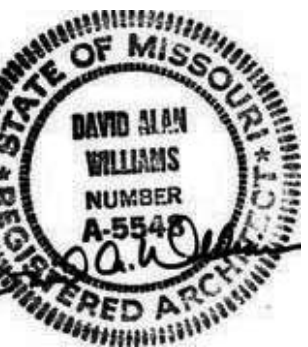

PROJECT TEAM

|                 |                                 |
|-----------------|---------------------------------|
| ARCHITECT       | FINKLE+WILLIAMS<br>ARCHITECTURE |
| CIVIL           | GBA                             |
| LANDSCAPE       | HOERR SCHAUDT /<br>LANDS        |
| FOUNDATIONS     | BSE STRUCTURAL<br>ENGINEERS     |
| STRUCTURAL      | BSE STRUCTURAL<br>ENGINEERS     |
| PLUMBING        | HENDERSON<br>ENGINEERS          |
| MECHANICAL      | HENDERSON<br>ENGINEERS          |
| ELECTRICAL      | HENDERSON<br>ENGINEERS          |
| FIRE PROTECTION | HENDERSON<br>ENGINEERS          |
| CONTRACTOR      | FOGEL ANDERSON                  |



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Overland Park, Kansas 66211  
913-498-1550

SHEET TITLE

WALL SECTIONS

SHEET NUMBER

A5.05






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| Project No.: | 19050.01       |
| Date:        | 10.25.19       |
| Issued For:  | SHELL - CD SET |

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## REGISTRATION

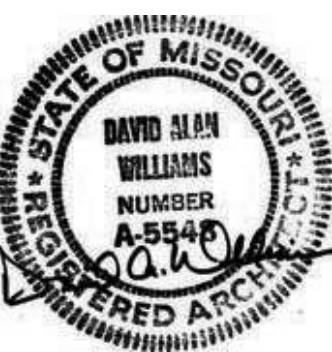

## PROJECT TEAM

|                 |                                 |
|-----------------|---------------------------------|
| ARCHITECT       | FINKLE+WILLIAMS<br>ARCHITECTURE |
| CIVIL           | GBA                             |
| LANDSCAPE       | HOERR SCHAUDT /<br>LAND3        |
| FOUNDATIONS     | BSE STRUCTURAL<br>ENGINEERS     |
| STRUCTURAL      | BSE STRUCTURAL<br>ENGINEERS     |
| PLUMBING        | HENDERSON<br>ENGINEERS          |
| MECHANICAL      | HENDERSON<br>ENGINEERS          |
| ELECTRICAL      | HENDERSON<br>ENGINEERS          |
| FIRE PROTECTION | HENDERSON<br>ENGINEERS          |
| CONTRACTOR      | FOGEL ANDERSON                  |

FINKLE + WILLIAMS  
ARCHITECTURE

7007 College Blvd, Suite 415  
Overland Park, Kansas 66211  
913+498-1550

SHEET TITLE


## WALL SECTIONS

SHEET NUMBER

## A5.06





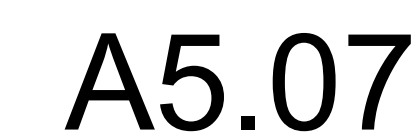



PARAGON STAR  
- LOT 9 -  
BUILDING 2

PARAGON STAR  
FIRST PLAT, LOT 9  
LEE'S SUMMIT, MO

Project No.: 19050.01  
Date: 10.25.19  
Issued For: SHELL - CD SET

| REVISIONS |      |             |
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| No.       | Date | Description |
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REGISTRATION



| PROJECT TEAM    |                              |
|-----------------|------------------------------|
| ARCHITECT       | FINKLE+WILLIAMS ARCHITECTURE |
| CIVIL           | GBA                          |
| LANDSCAPE       | HOERR SCHAUDT / LANDS        |
| FOUNDATIONS     | BSE STRUCTURAL ENGINEERS     |
| STRUCTURAL      | BSE STRUCTURAL ENGINEERS     |
| PLUMBING        | HENDERSON ENGINEERS          |
| MECHANICAL      | HENDERSON ENGINEERS          |
| ELECTRICAL      | HENDERSON ENGINEERS          |
| FIRE PROTECTION | HENDERSON ENGINEERS          |
| CONTRACTOR      | FOGEL ANDERSON               |



FINKLE + WILLIAMS  
ARCHITECTURE




7007 College Blvd, Suite 415  
Overland Park, Kansas 66211  
913+498-1550

SHEET TITLE

WALL SECTIONS

SHEET NUMBER

A5.08

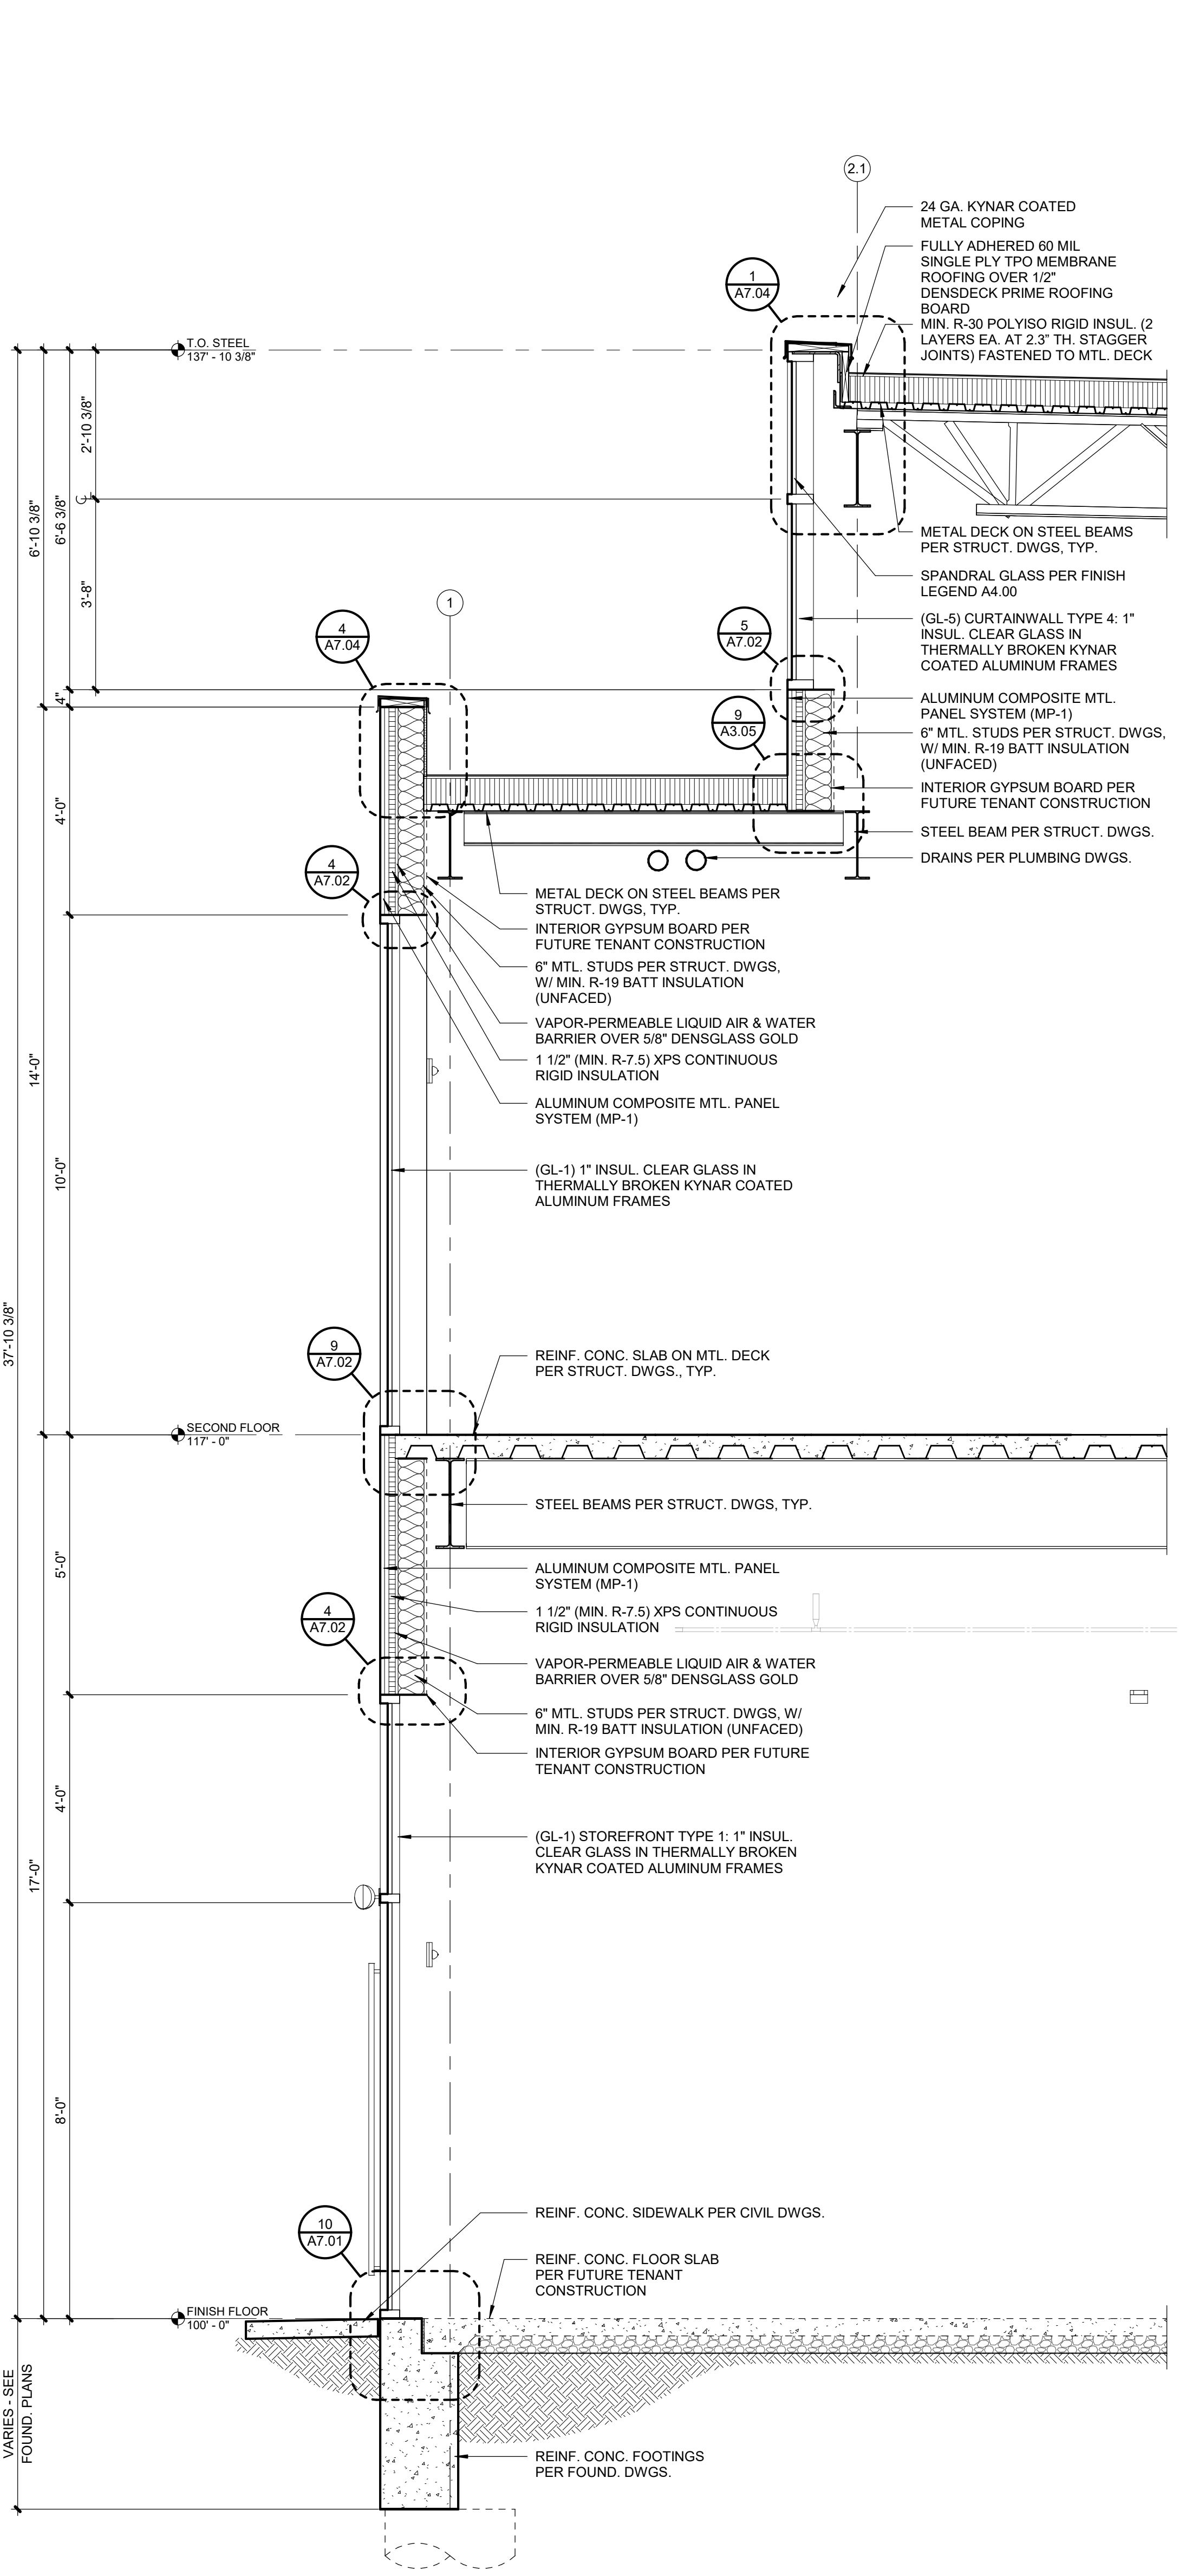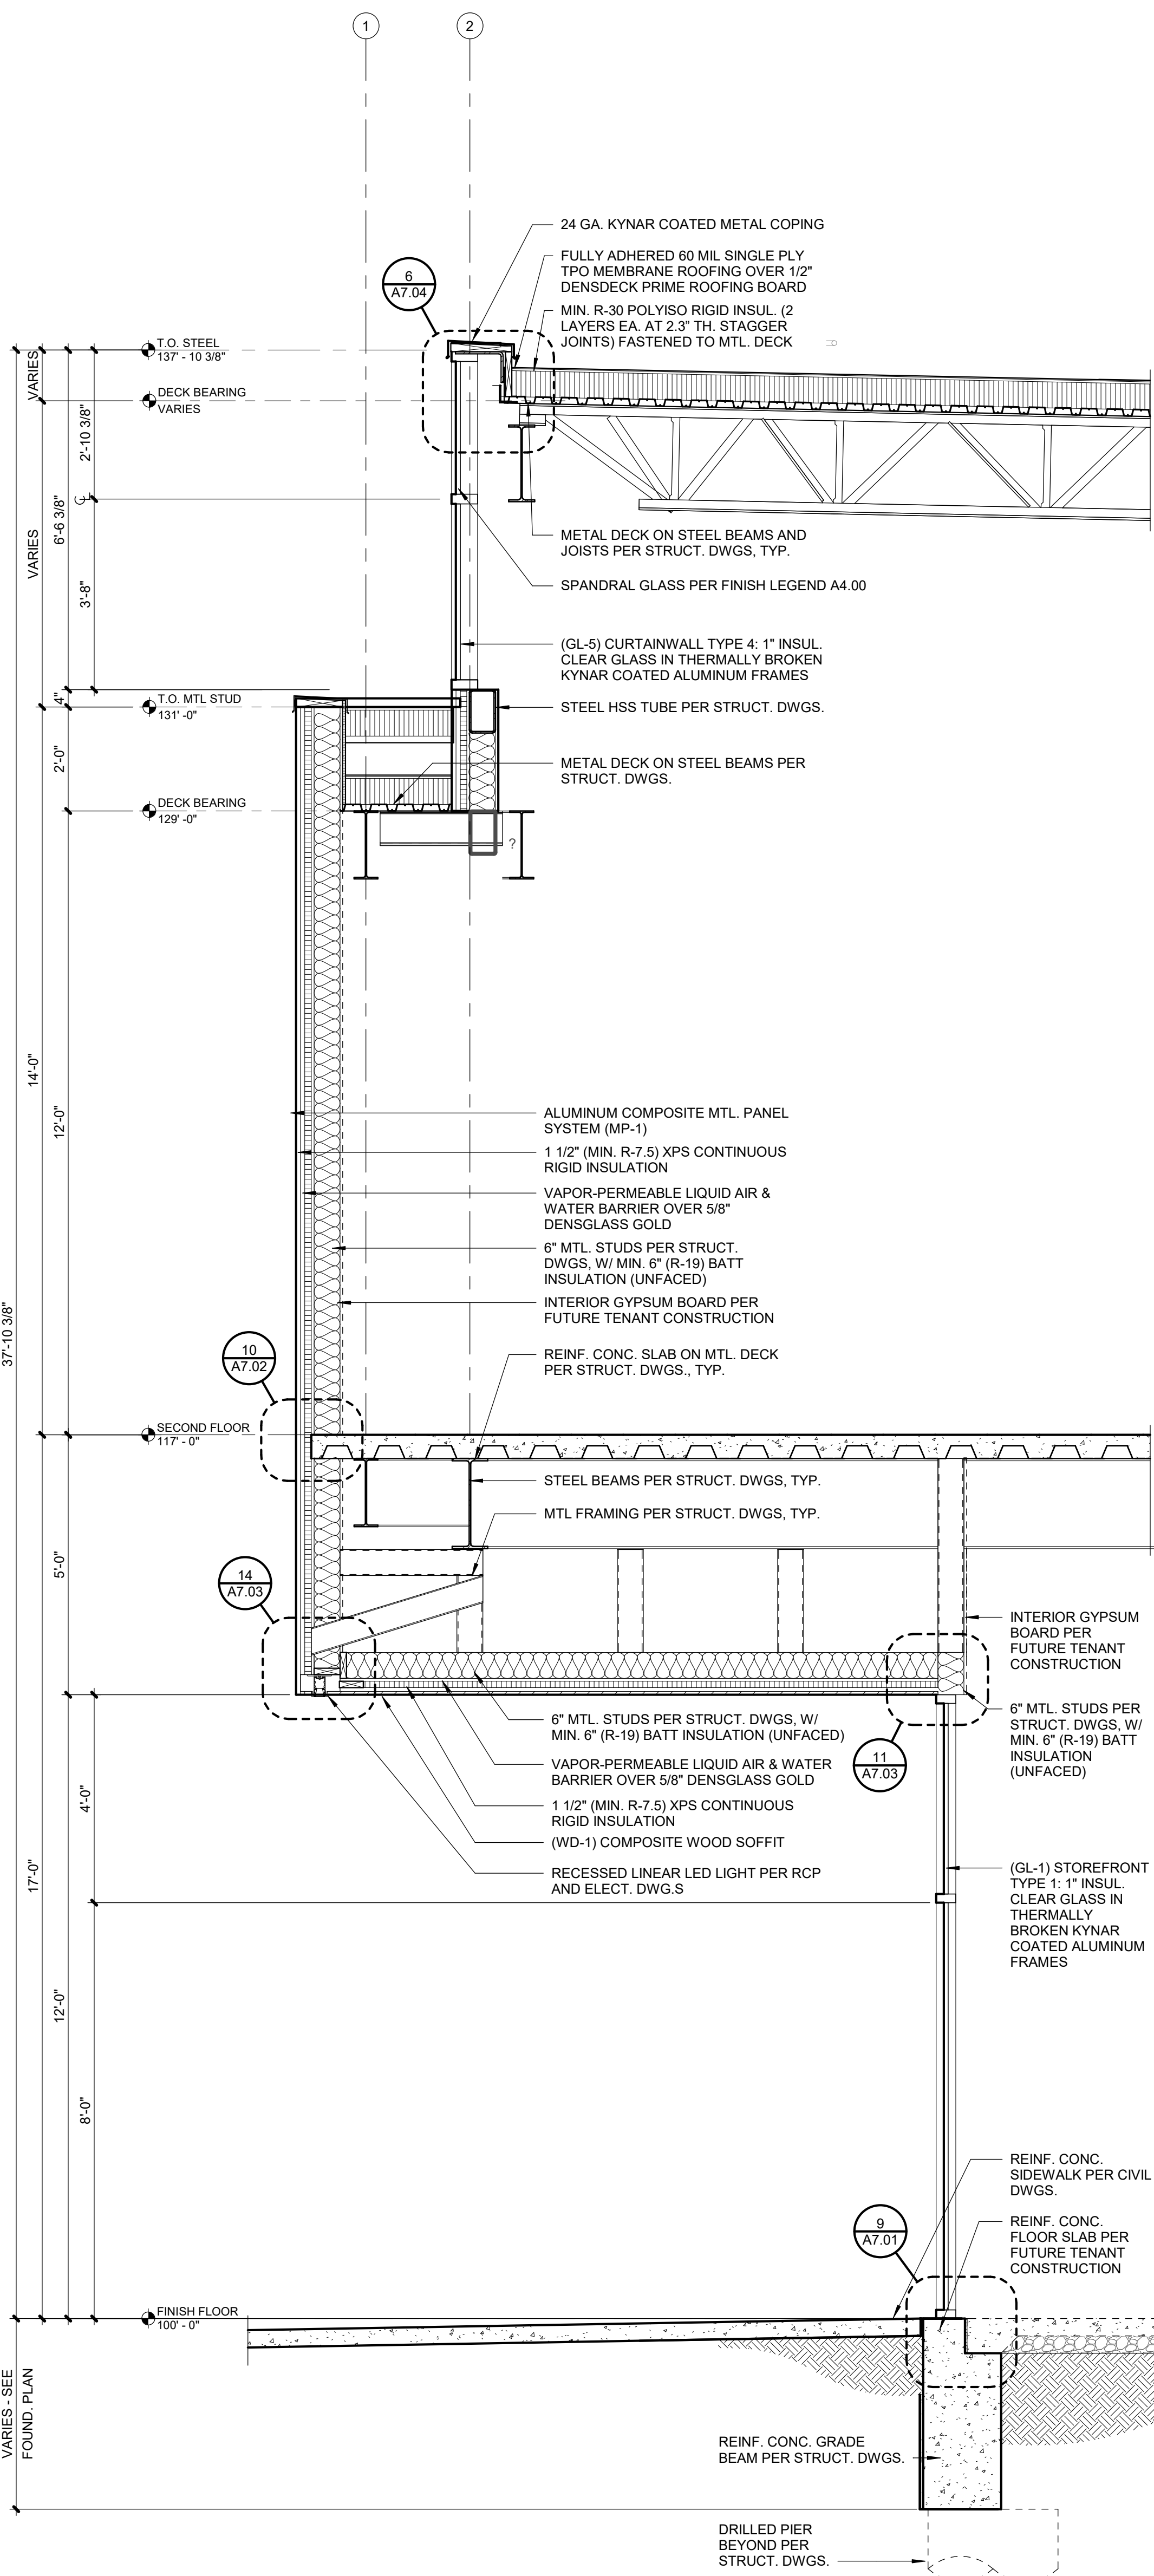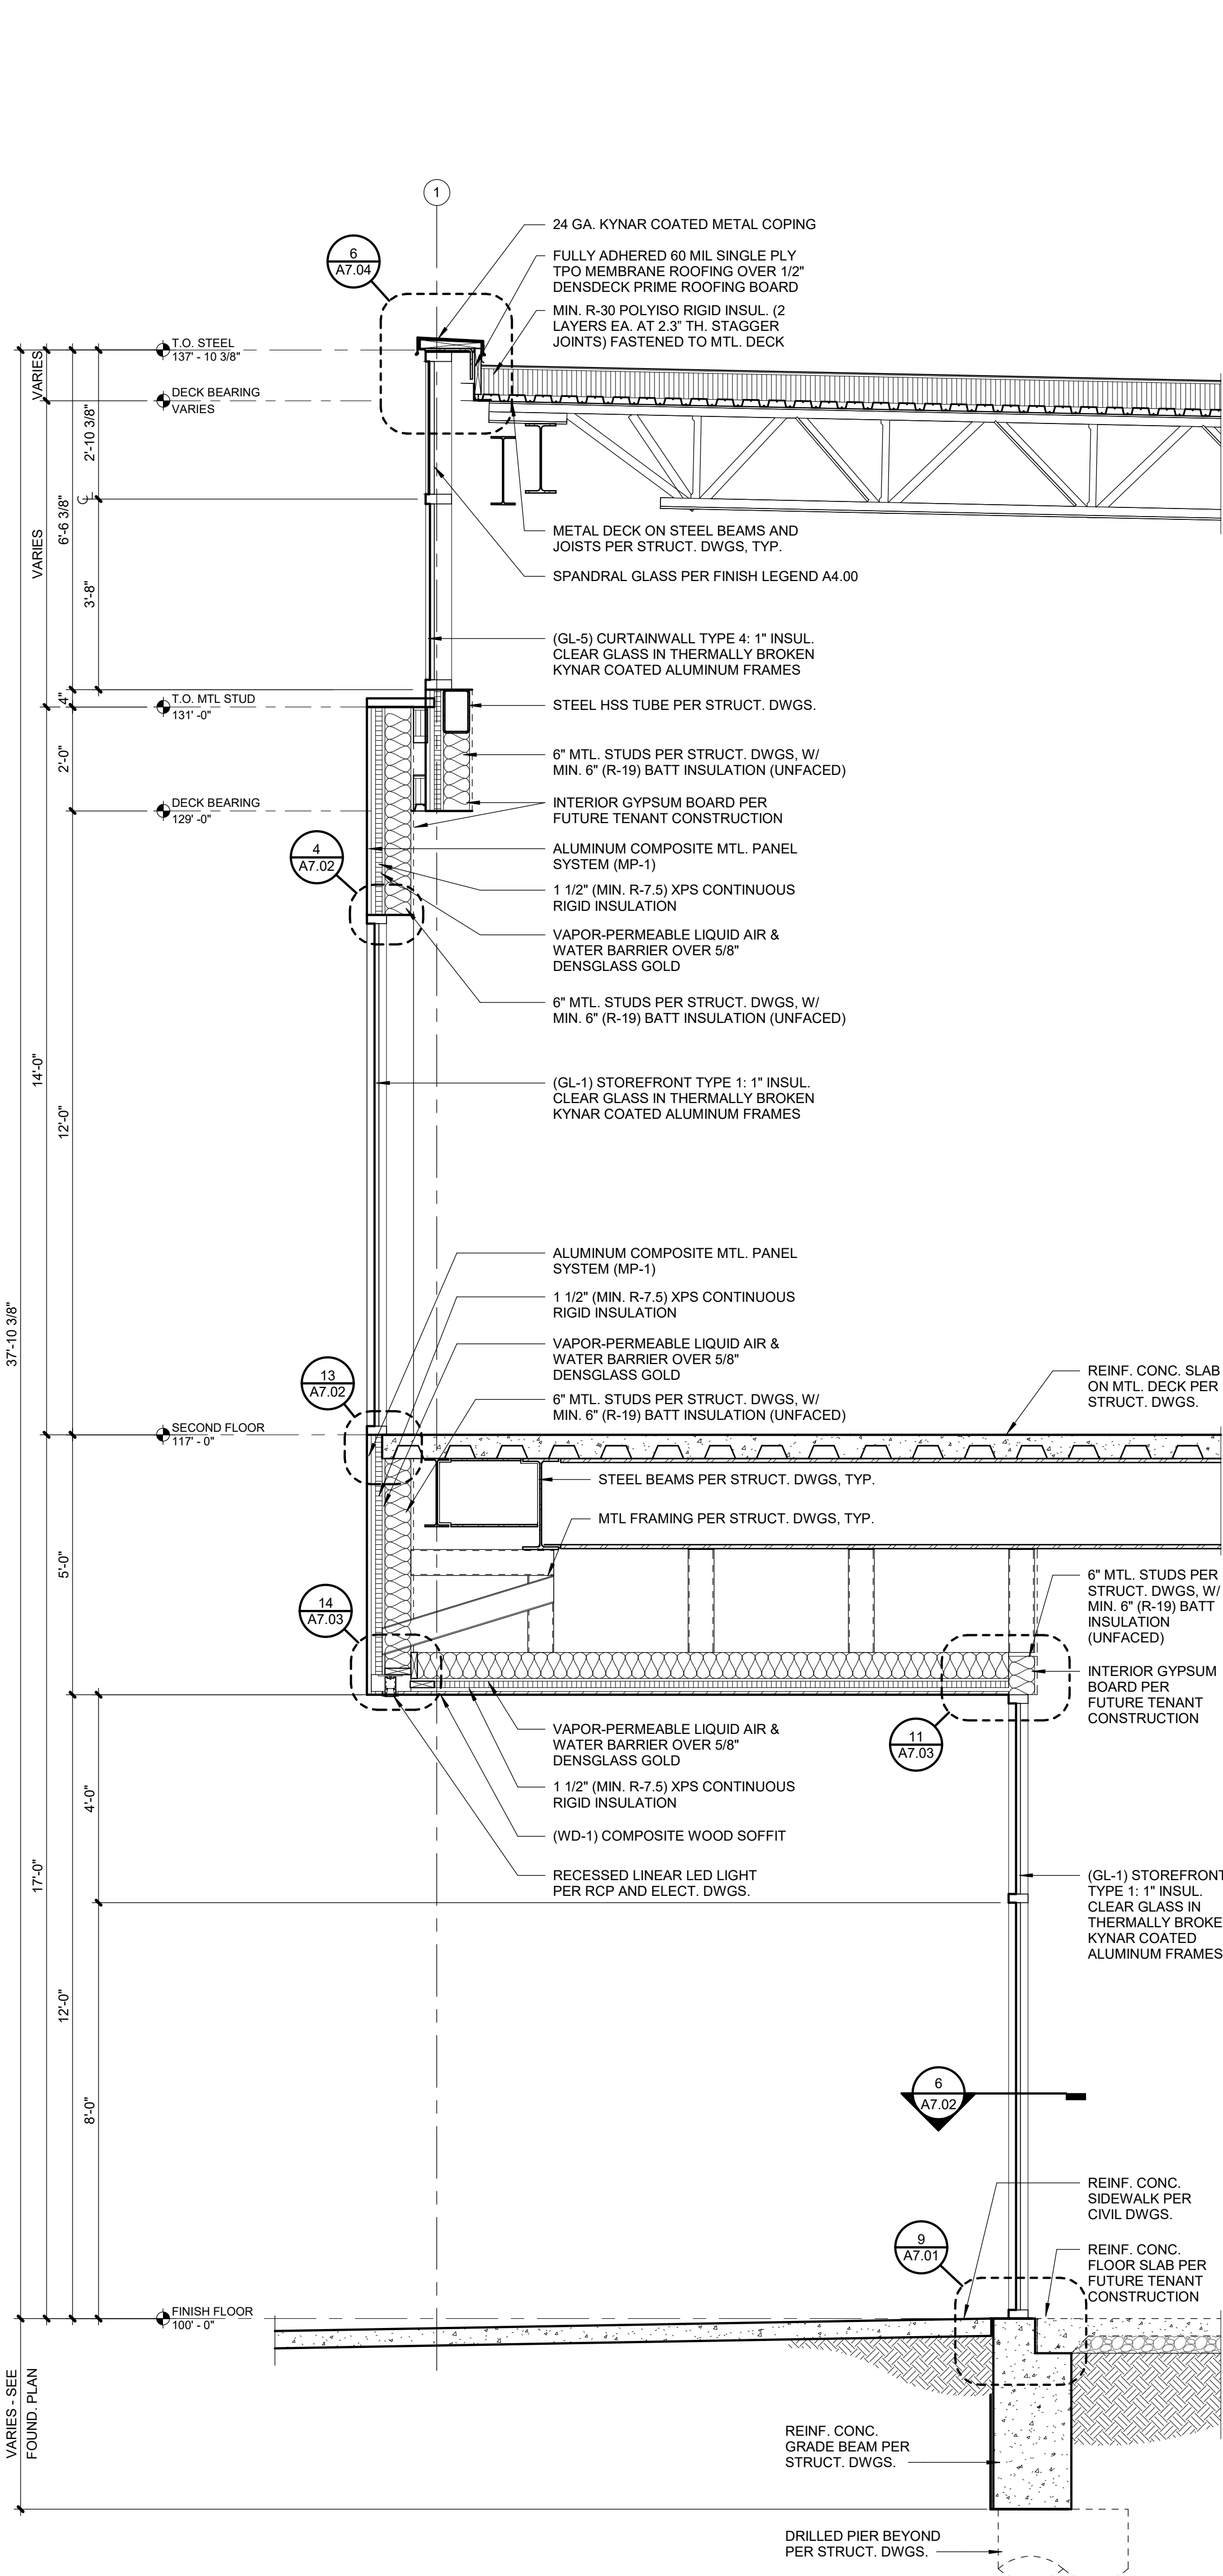



PARAGON STAR  
- LOT 9 -  
BUILDING 2

PARAGON STAR  
FIRST PLAT, LOT 9  
LEE'S SUMMIT, MO

Project No.: 19050.01  
Date: 10.25.19  
Issued For: SHELL - CD SET

| REVISIONS |      |             |
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REGISTRATION



| PROJECT TEAM    |                              |
|-----------------|------------------------------|
| ARCHITECT       | FINKLE+WILLIAMS ARCHITECTURE |
| CIVIL           | GBA                          |
| LANDSCAPE       | HOERR SCHAUDT / LANDS        |
| FOUNDATIONS     | BSE STRUCTURAL ENGINEERS     |
| STRUCTURAL      | BSE STRUCTURAL ENGINEERS     |
| PLUMBING        | HENDERSON ENGINEERS          |
| MECHANICAL      | HENDERSON ENGINEERS          |
| ELECTRICAL      | HENDERSON ENGINEERS          |
| FIRE PROTECTION | HENDERSON ENGINEERS          |
| CONTRACTOR      | FOGEL ANDERSON               |



FINKLE + WILLIAMS  
ARCHITECTURE


7007 College Blvd, Suite 415  
Overland Park, Kansas 66211  
913-498-1550

SHEET TITLE

WALL SECTIONS


SHEET NUMBER

A5.09

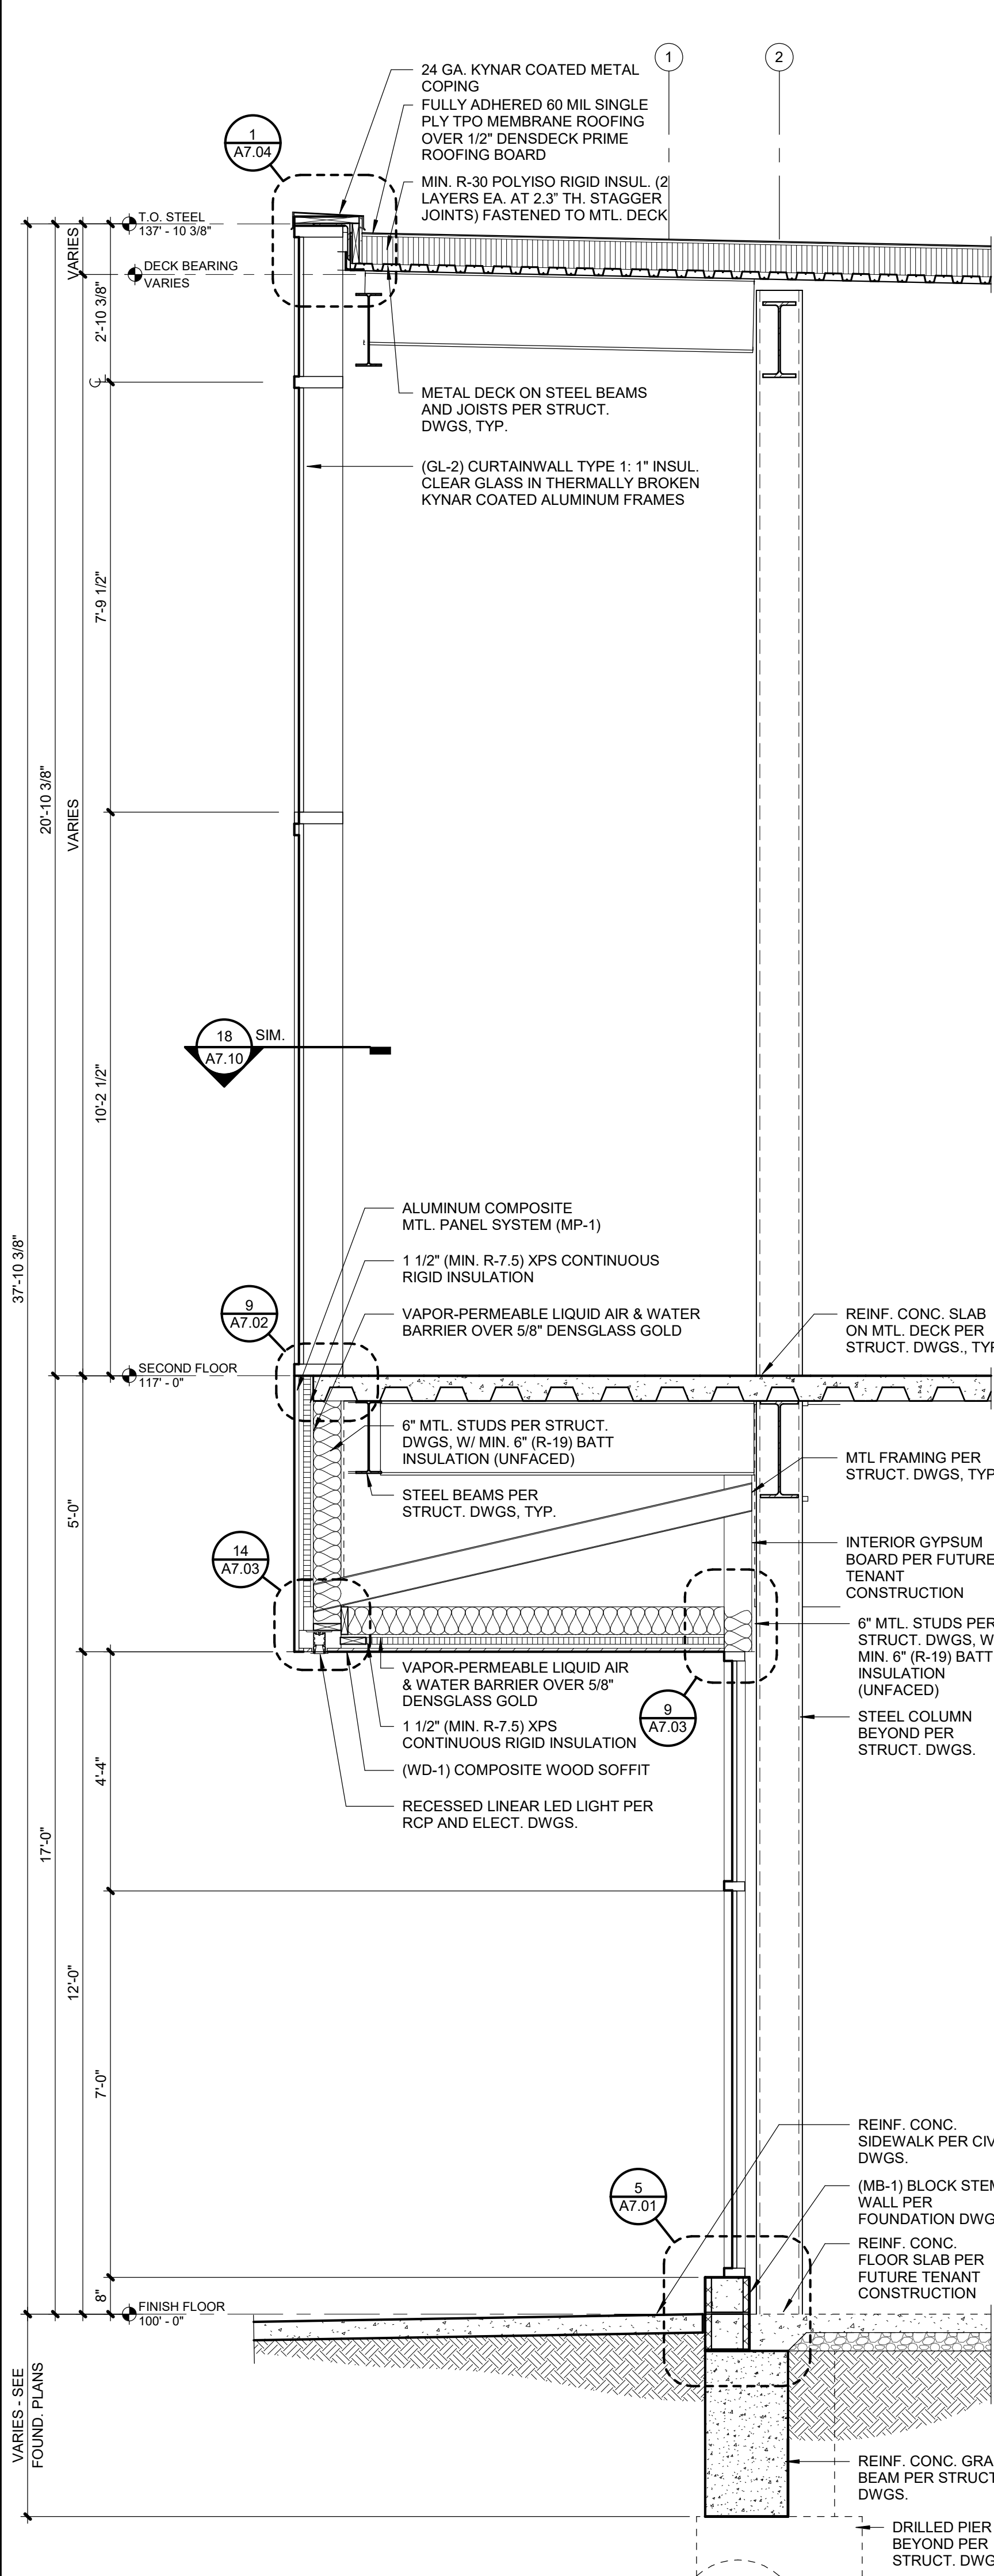


4 WALL SECTION

A5.09 SCALE: 1/2" = 1'-0"

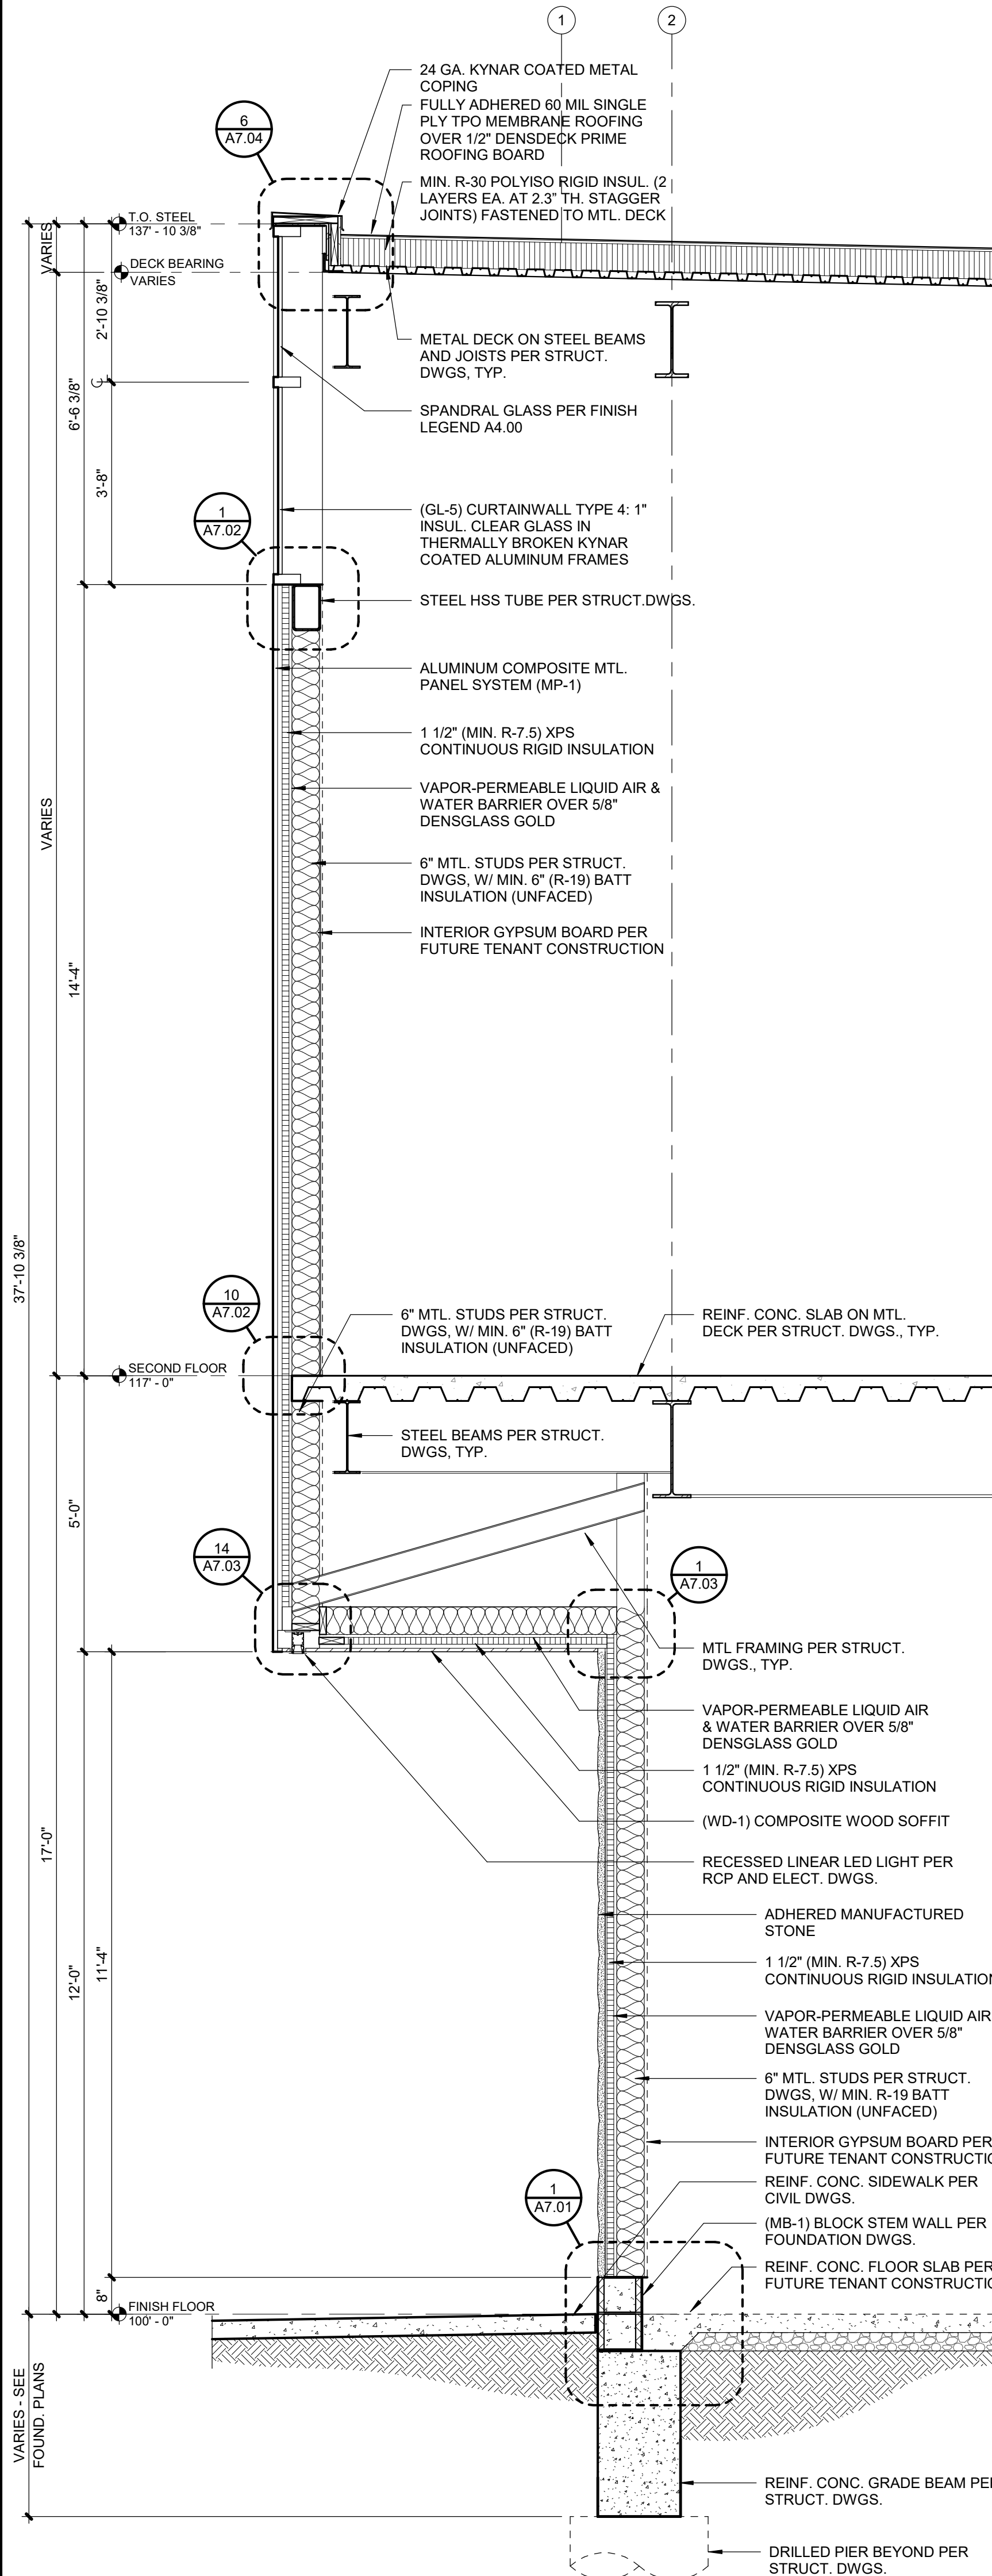


3 WALL SECTION

A5.09 SCALE: 1/2" = 1'-0"

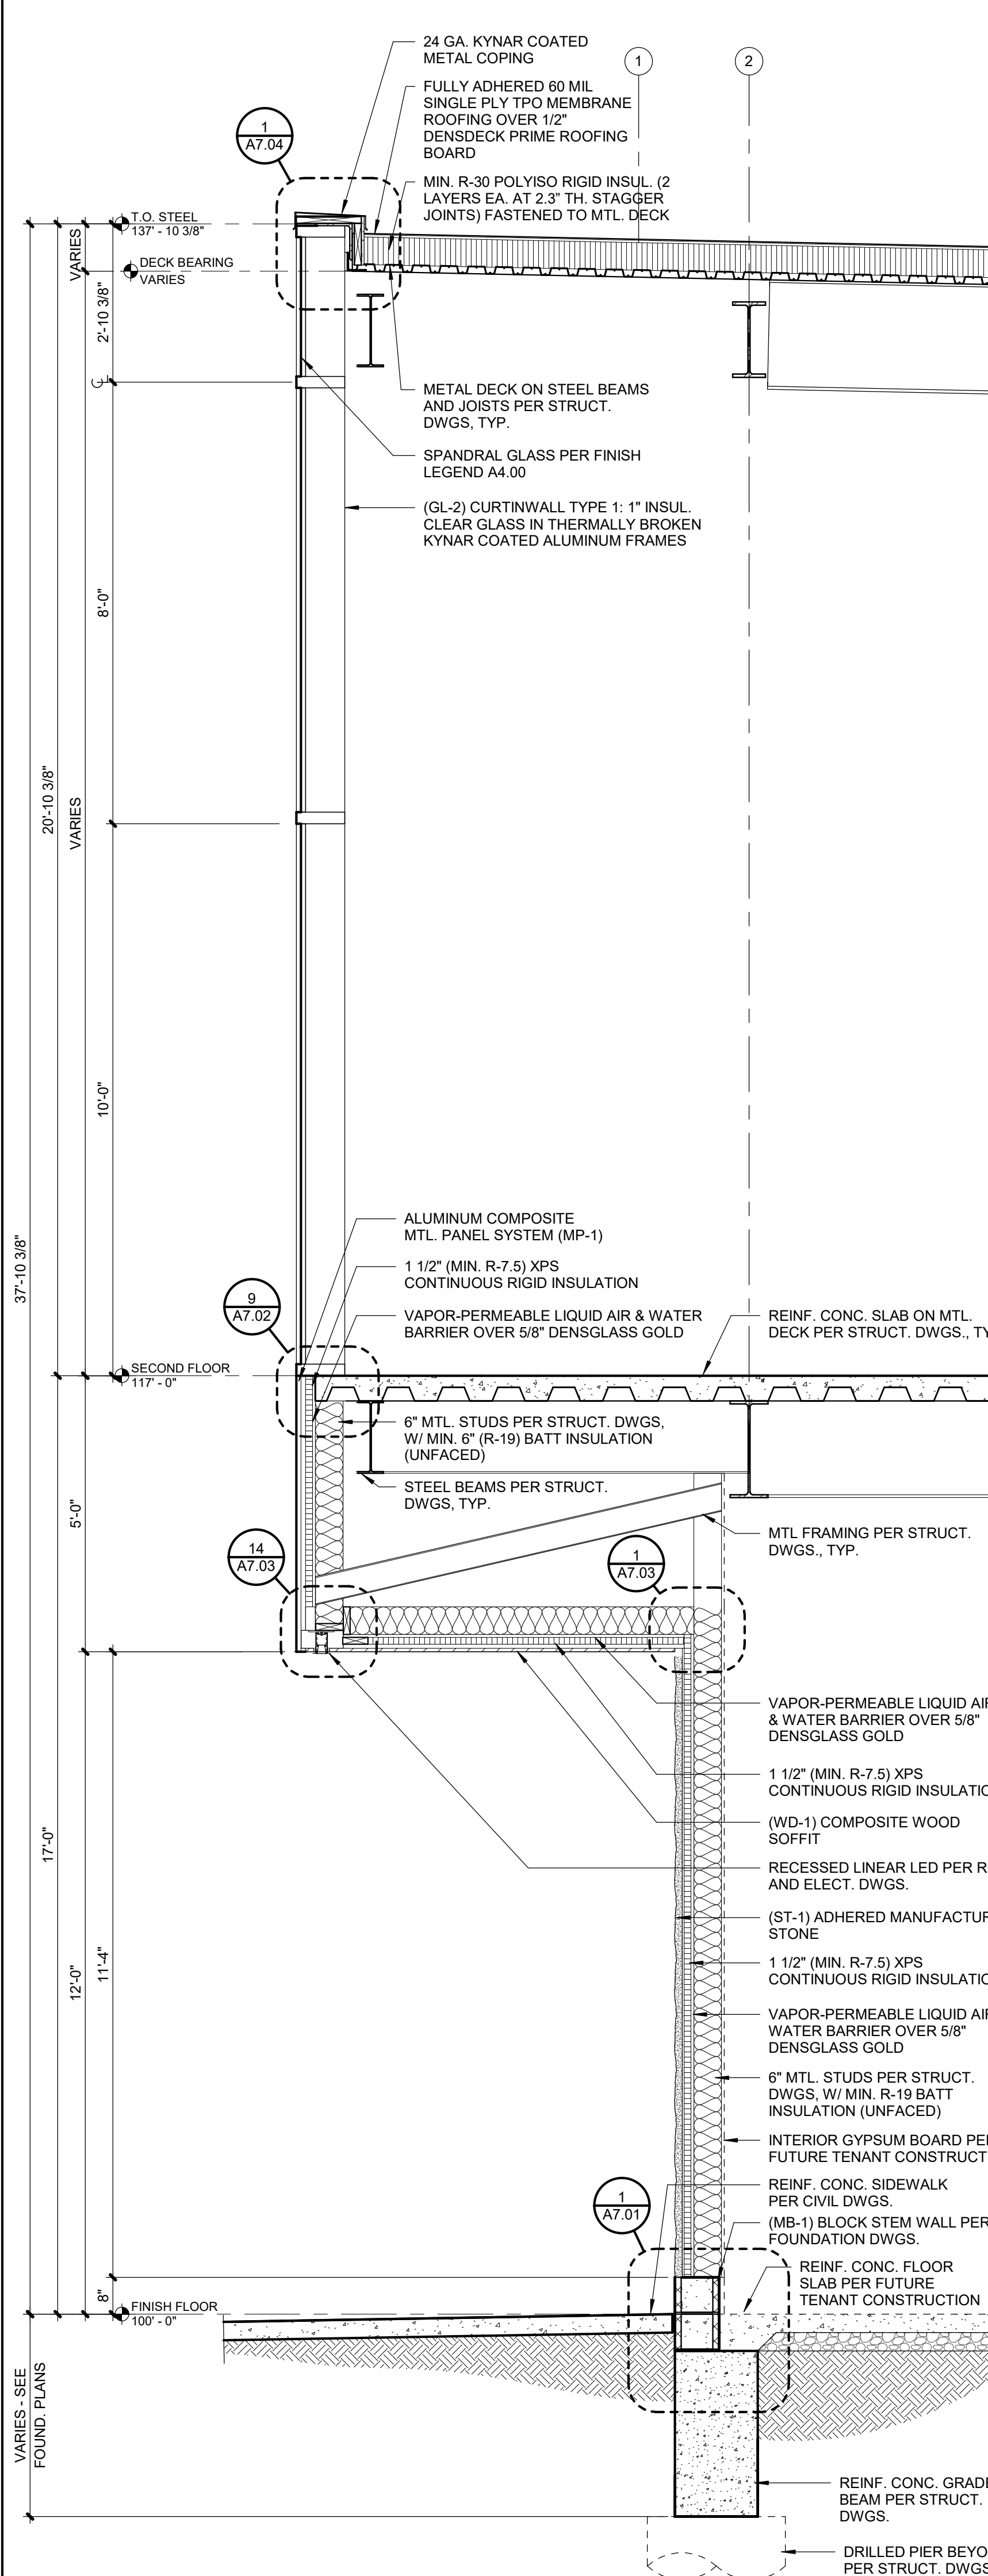

2 WALL SECTION

A5.09 SCALE: 1/2" = 1'-0"

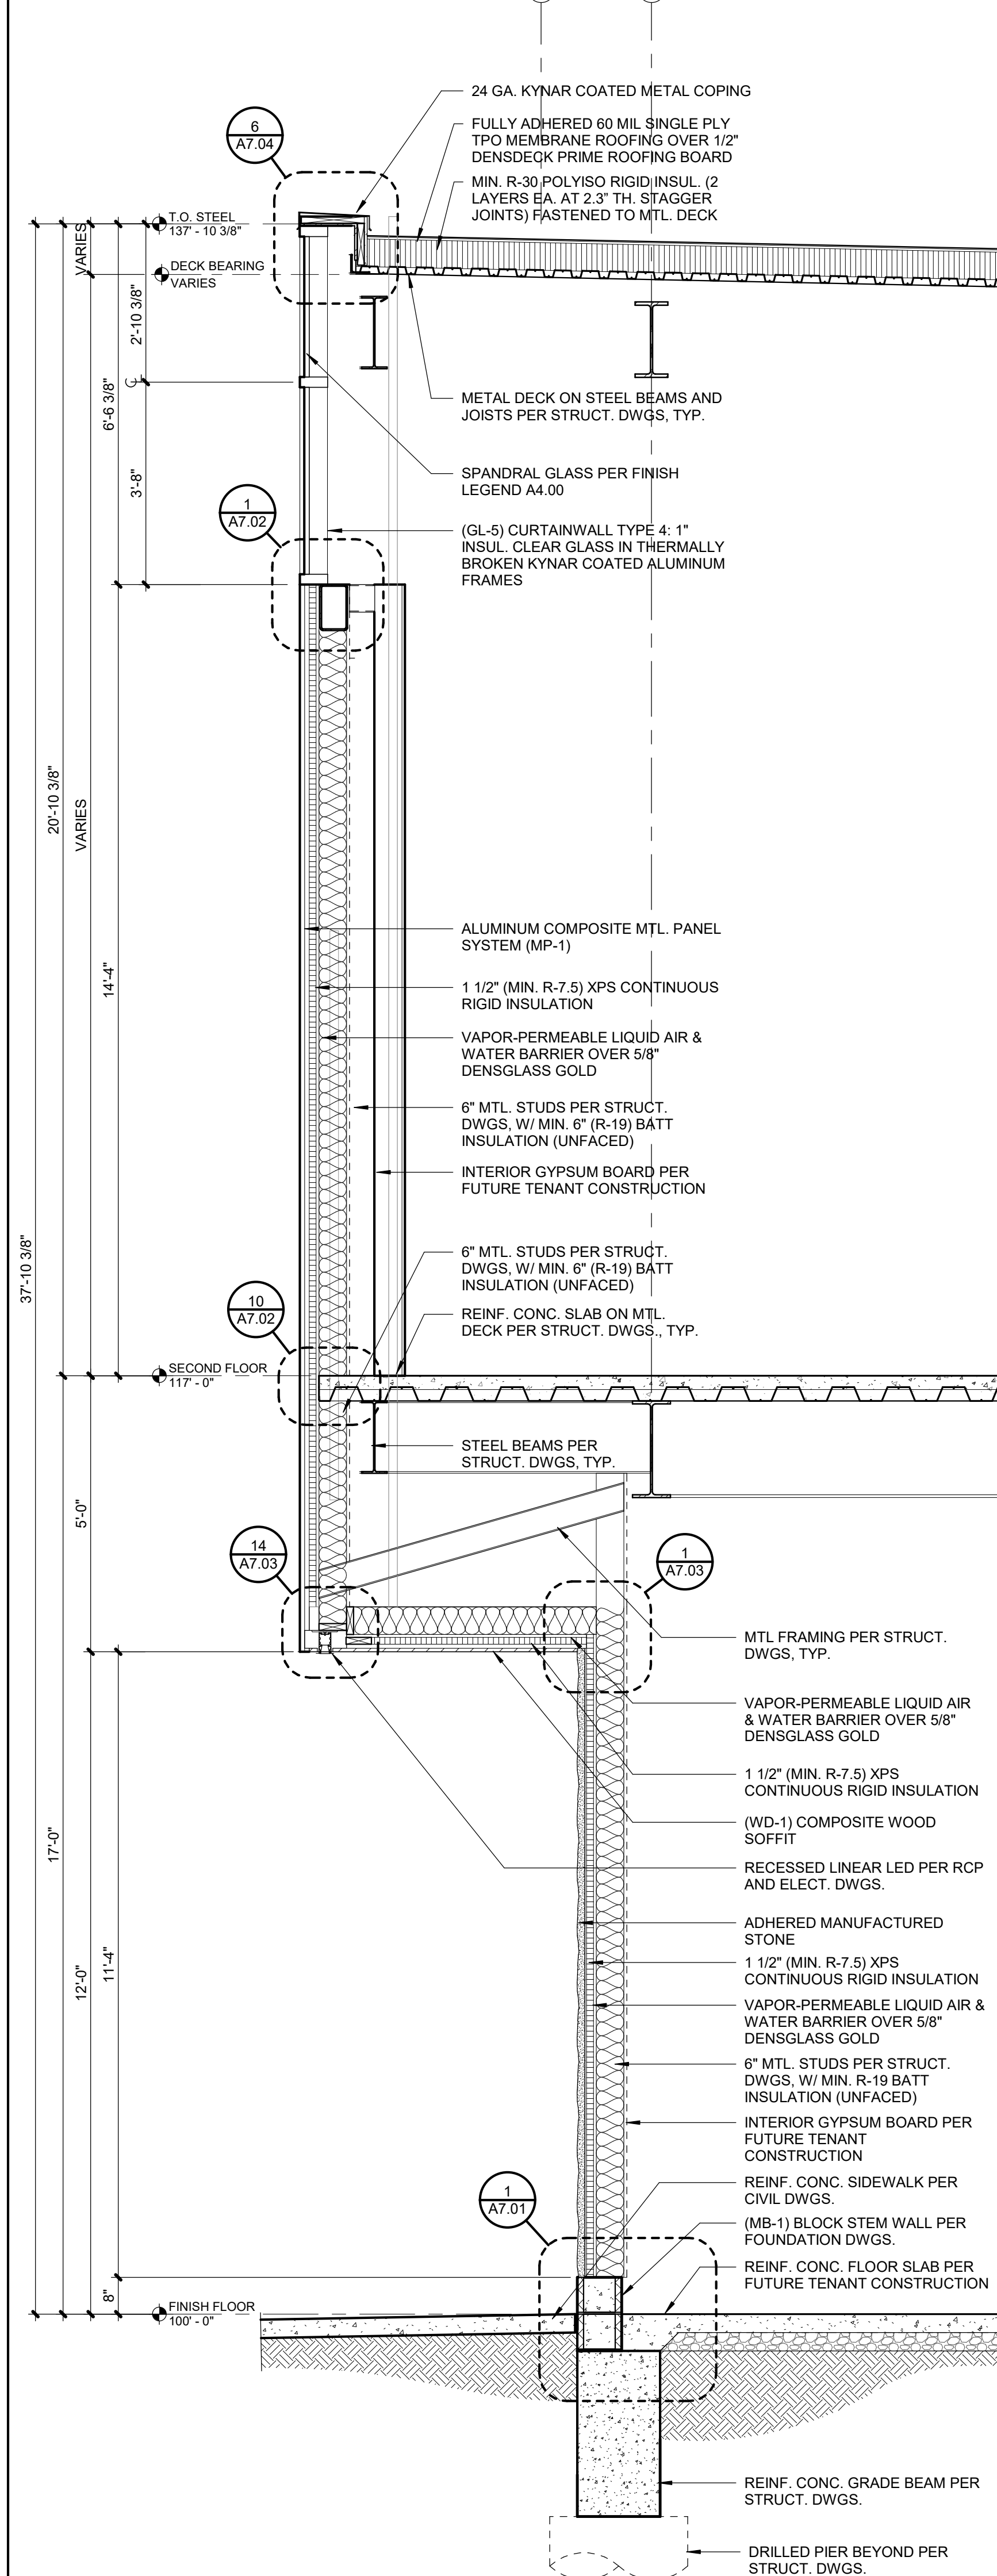

1 WALL SECTION

A5.09 SCALE: 1/2" = 1'-0"



[illegible]

REGISTRATION



PROJECT TEAM

|                 |                                 |
|-----------------|---------------------------------|
| ARCHITECT       | FINKLE+WILLIAMS<br>ARCHITECTURE |
| CIVIL           | GBA                             |
| LANDSCAPE       | HOERR SCHAUDT /<br>LAND3        |
| FOUNDATIONS     | BSE STRUCTURAL<br>ENGINEERS     |
| STRUCTURAL      | BSE STRUCTURAL<br>ENGINEERS     |
| PLUMBING        | HENDERSON<br>ENGINEERS          |
| MECHANICAL      | HENDERSON<br>ENGINEERS          |
| ELECTRICAL      | HENDERSON<br>ENGINEERS          |
| FIRE PROTECTION | HENDERSON<br>ENGINEERS          |
| CONTRACTOR      | FOGEL ANDERSON                  |

FINKLE + WILLIAMS  
ARCHITECTURE


7007 College Blvd, Suite 415  
Overland Park, Kansas 66211  
913+498-1550

SHEET TITLE


## WALL SECTIONS

SHEET NUMBER


## A5.10

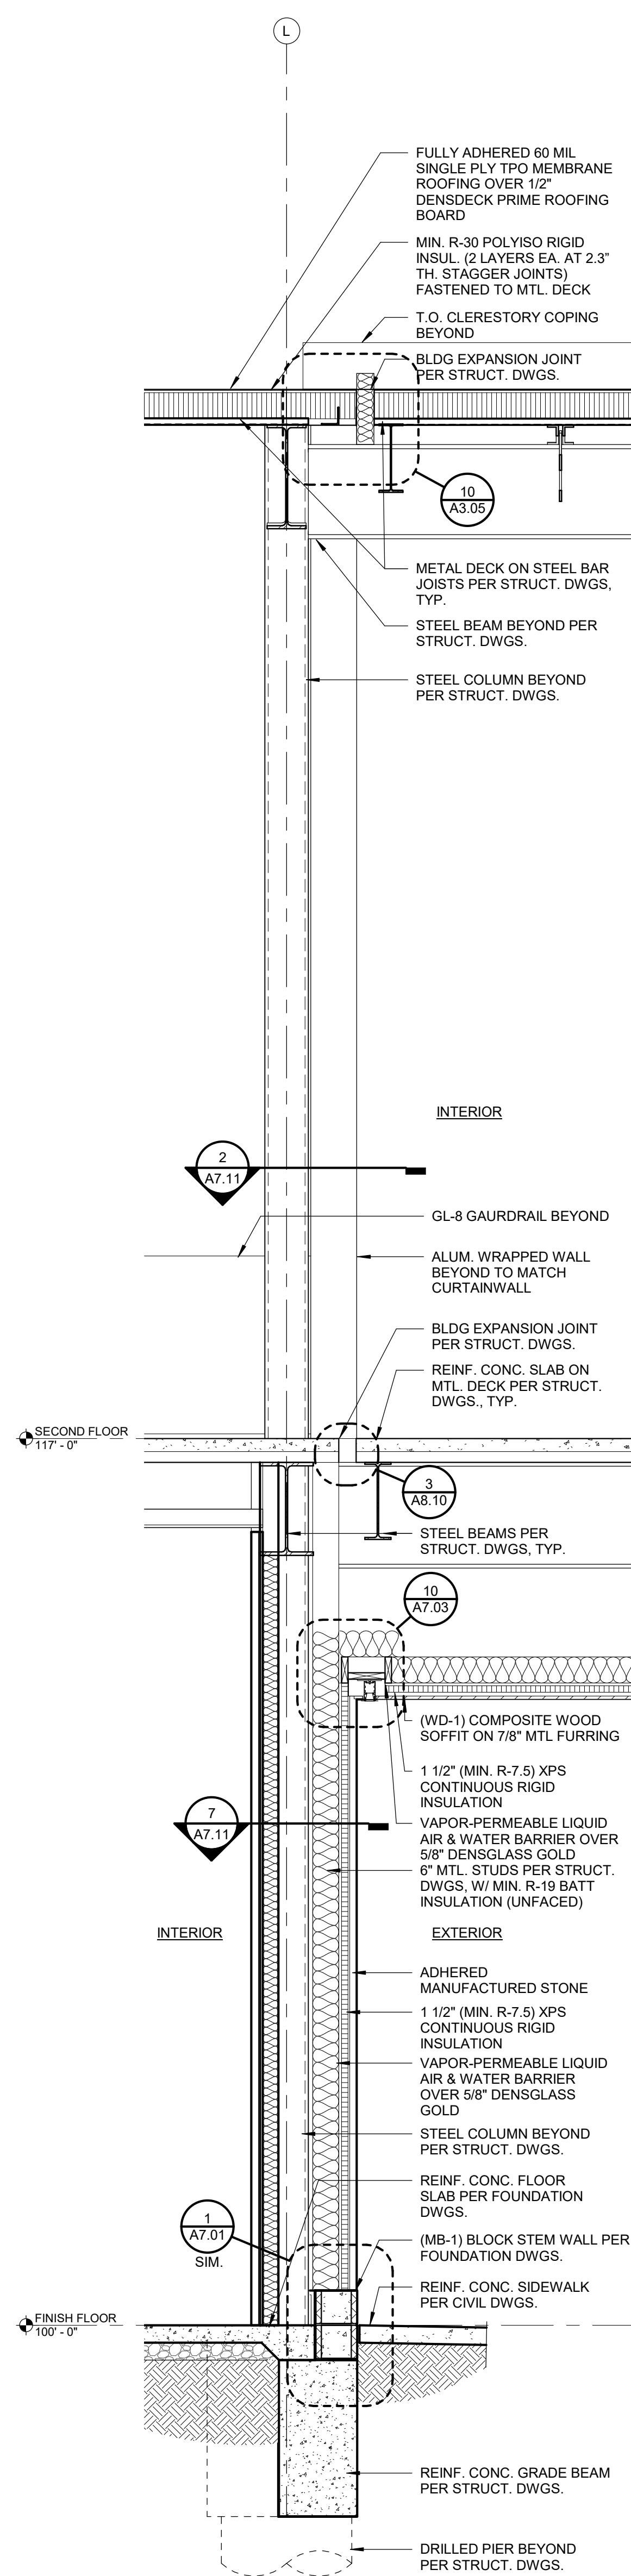


|       |                      |
|-------|----------------------|
| 4     | WALL SECTION         |
| A5.10 | SCALE : 1/2" = 1'-0" |

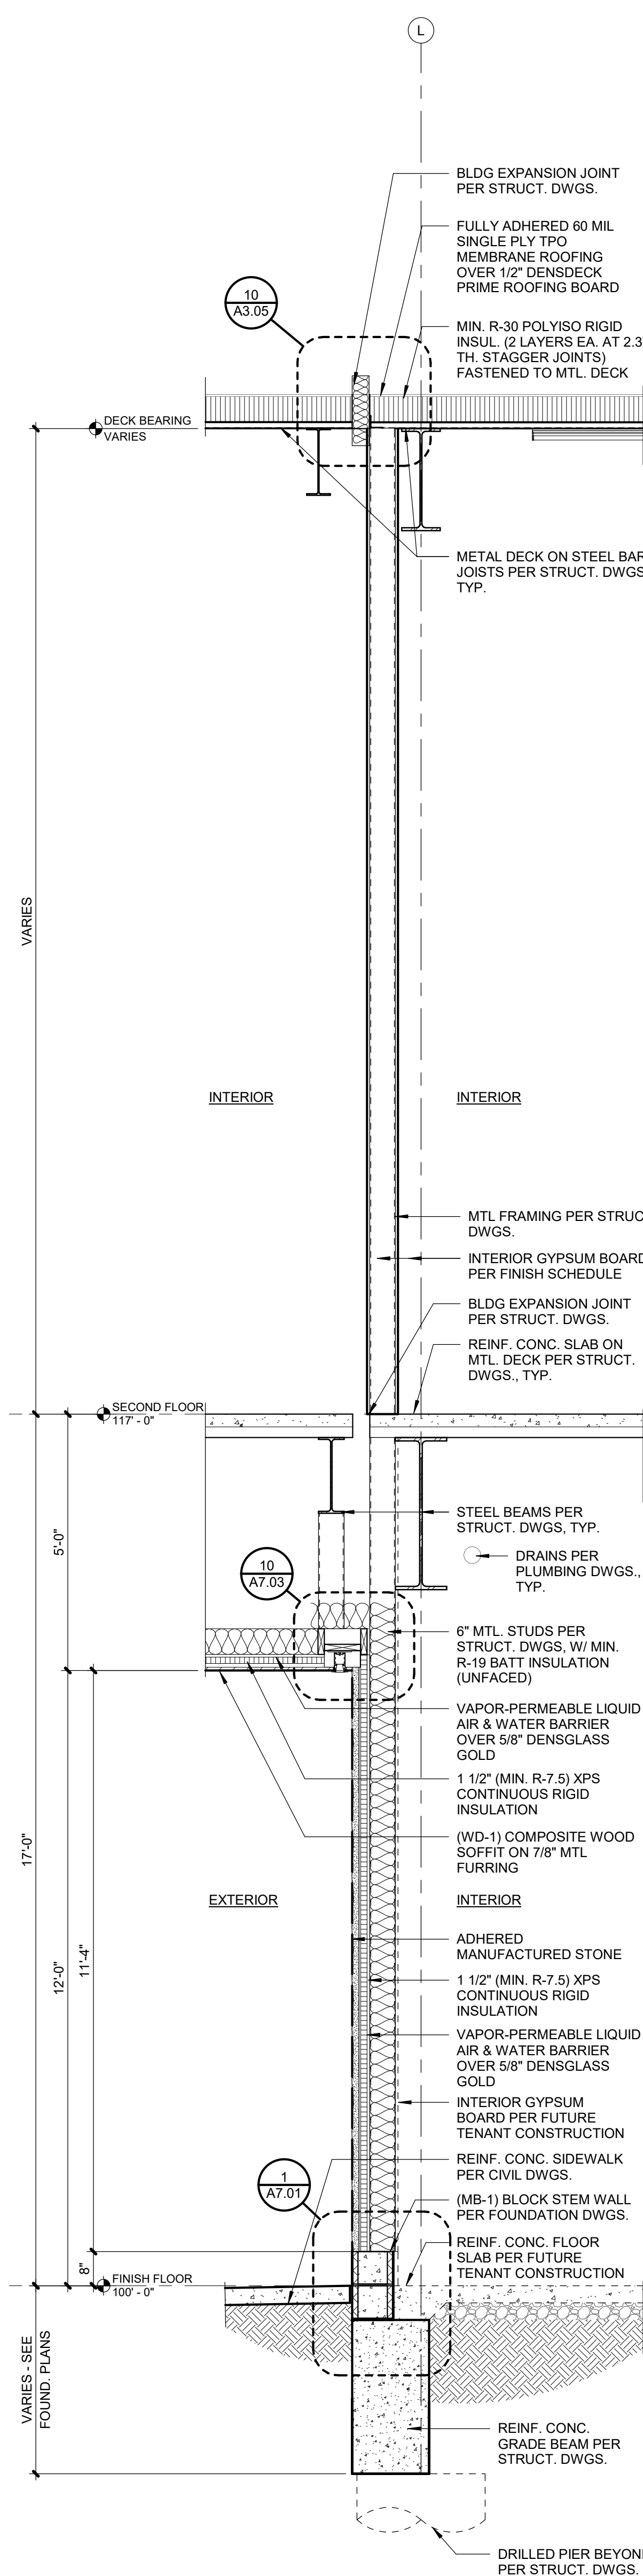

|       |                      |
|-------|----------------------|
| 3     | WALL SECTION         |
| A5.10 | SCALE : 1/2" = 1'-0" |

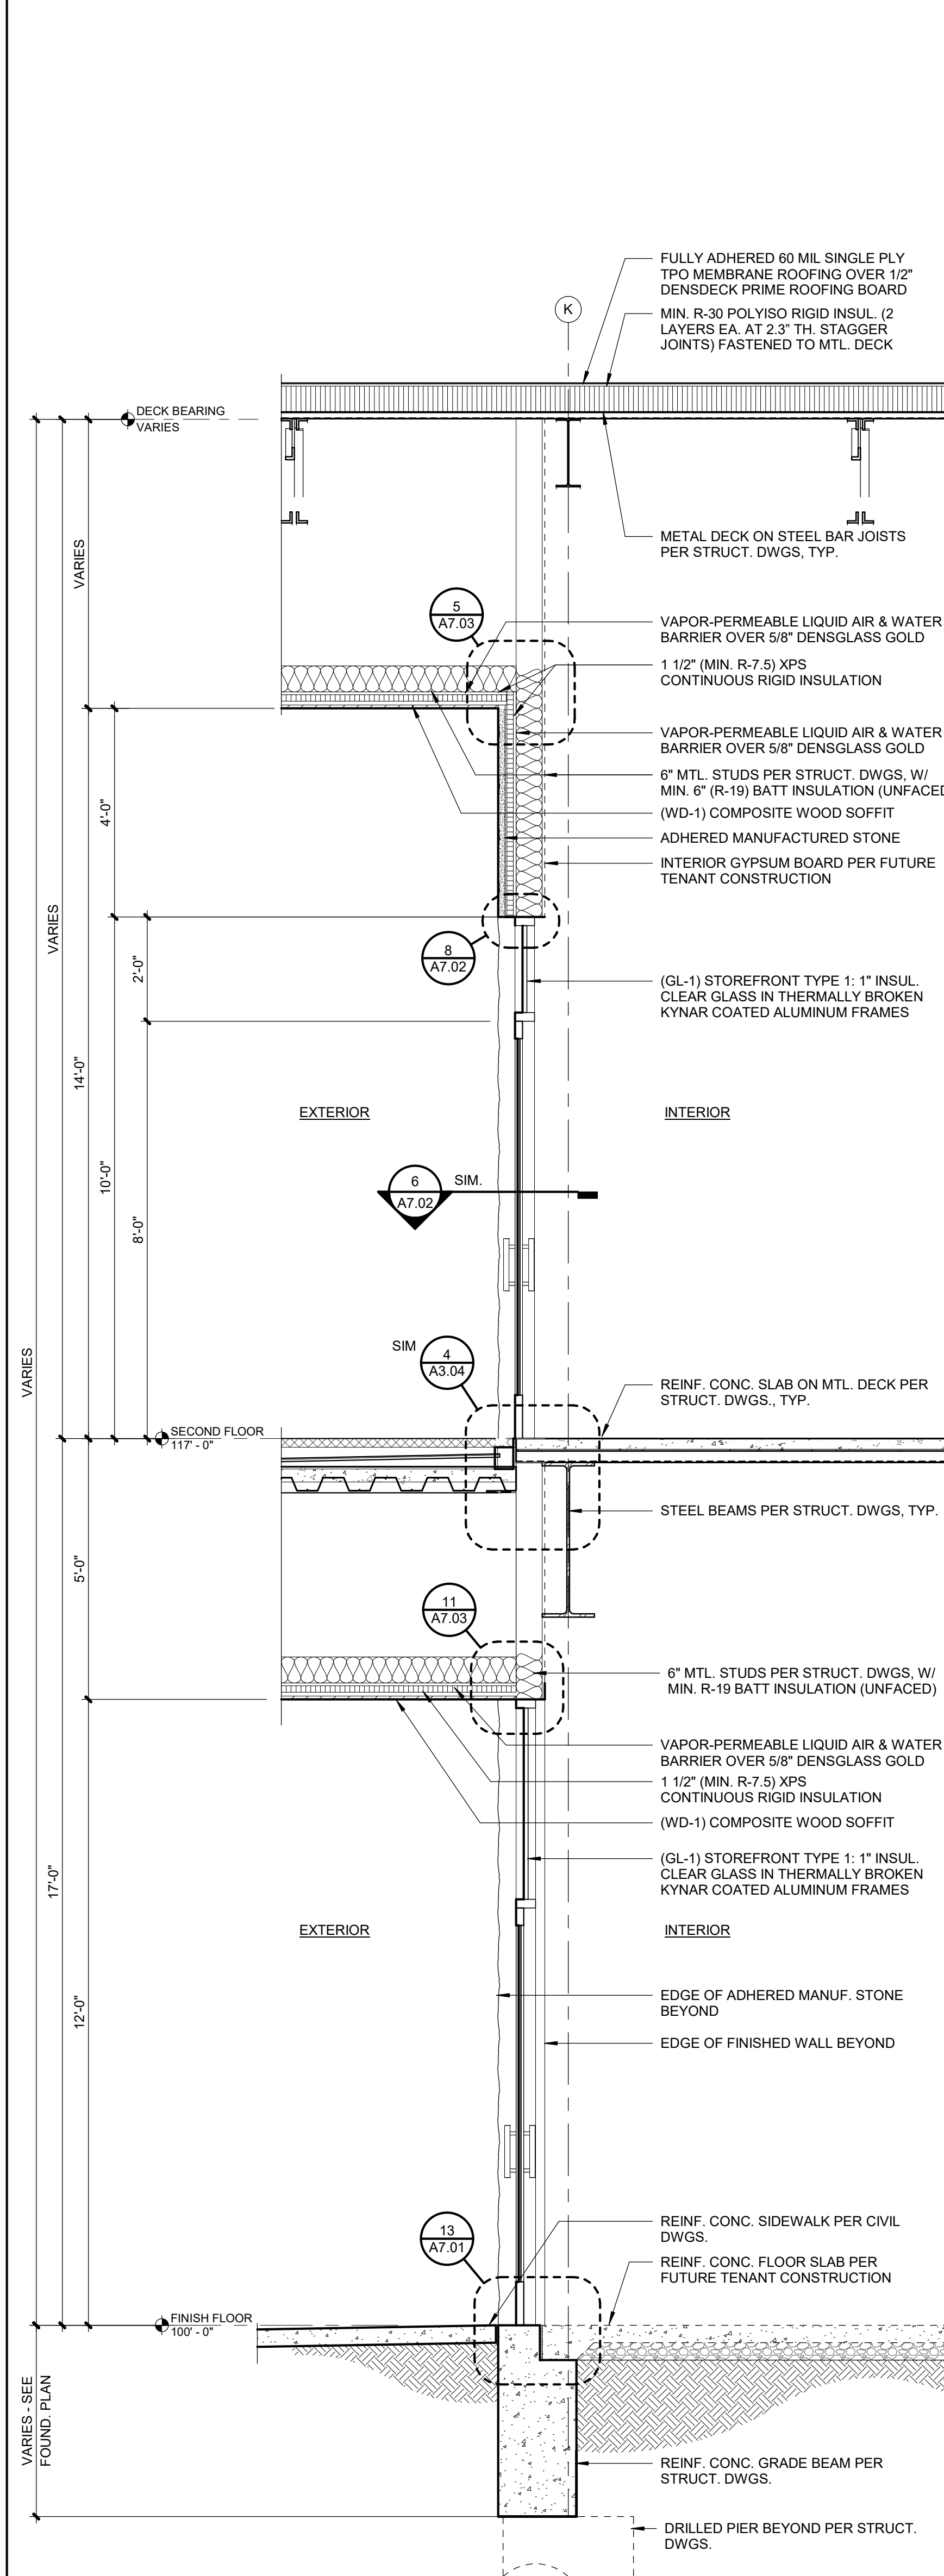

|       |                      |
|-------|----------------------|
| 2     | WALL SECTION         |
| A5.10 | SCALE : 1/2" = 1'-0" |


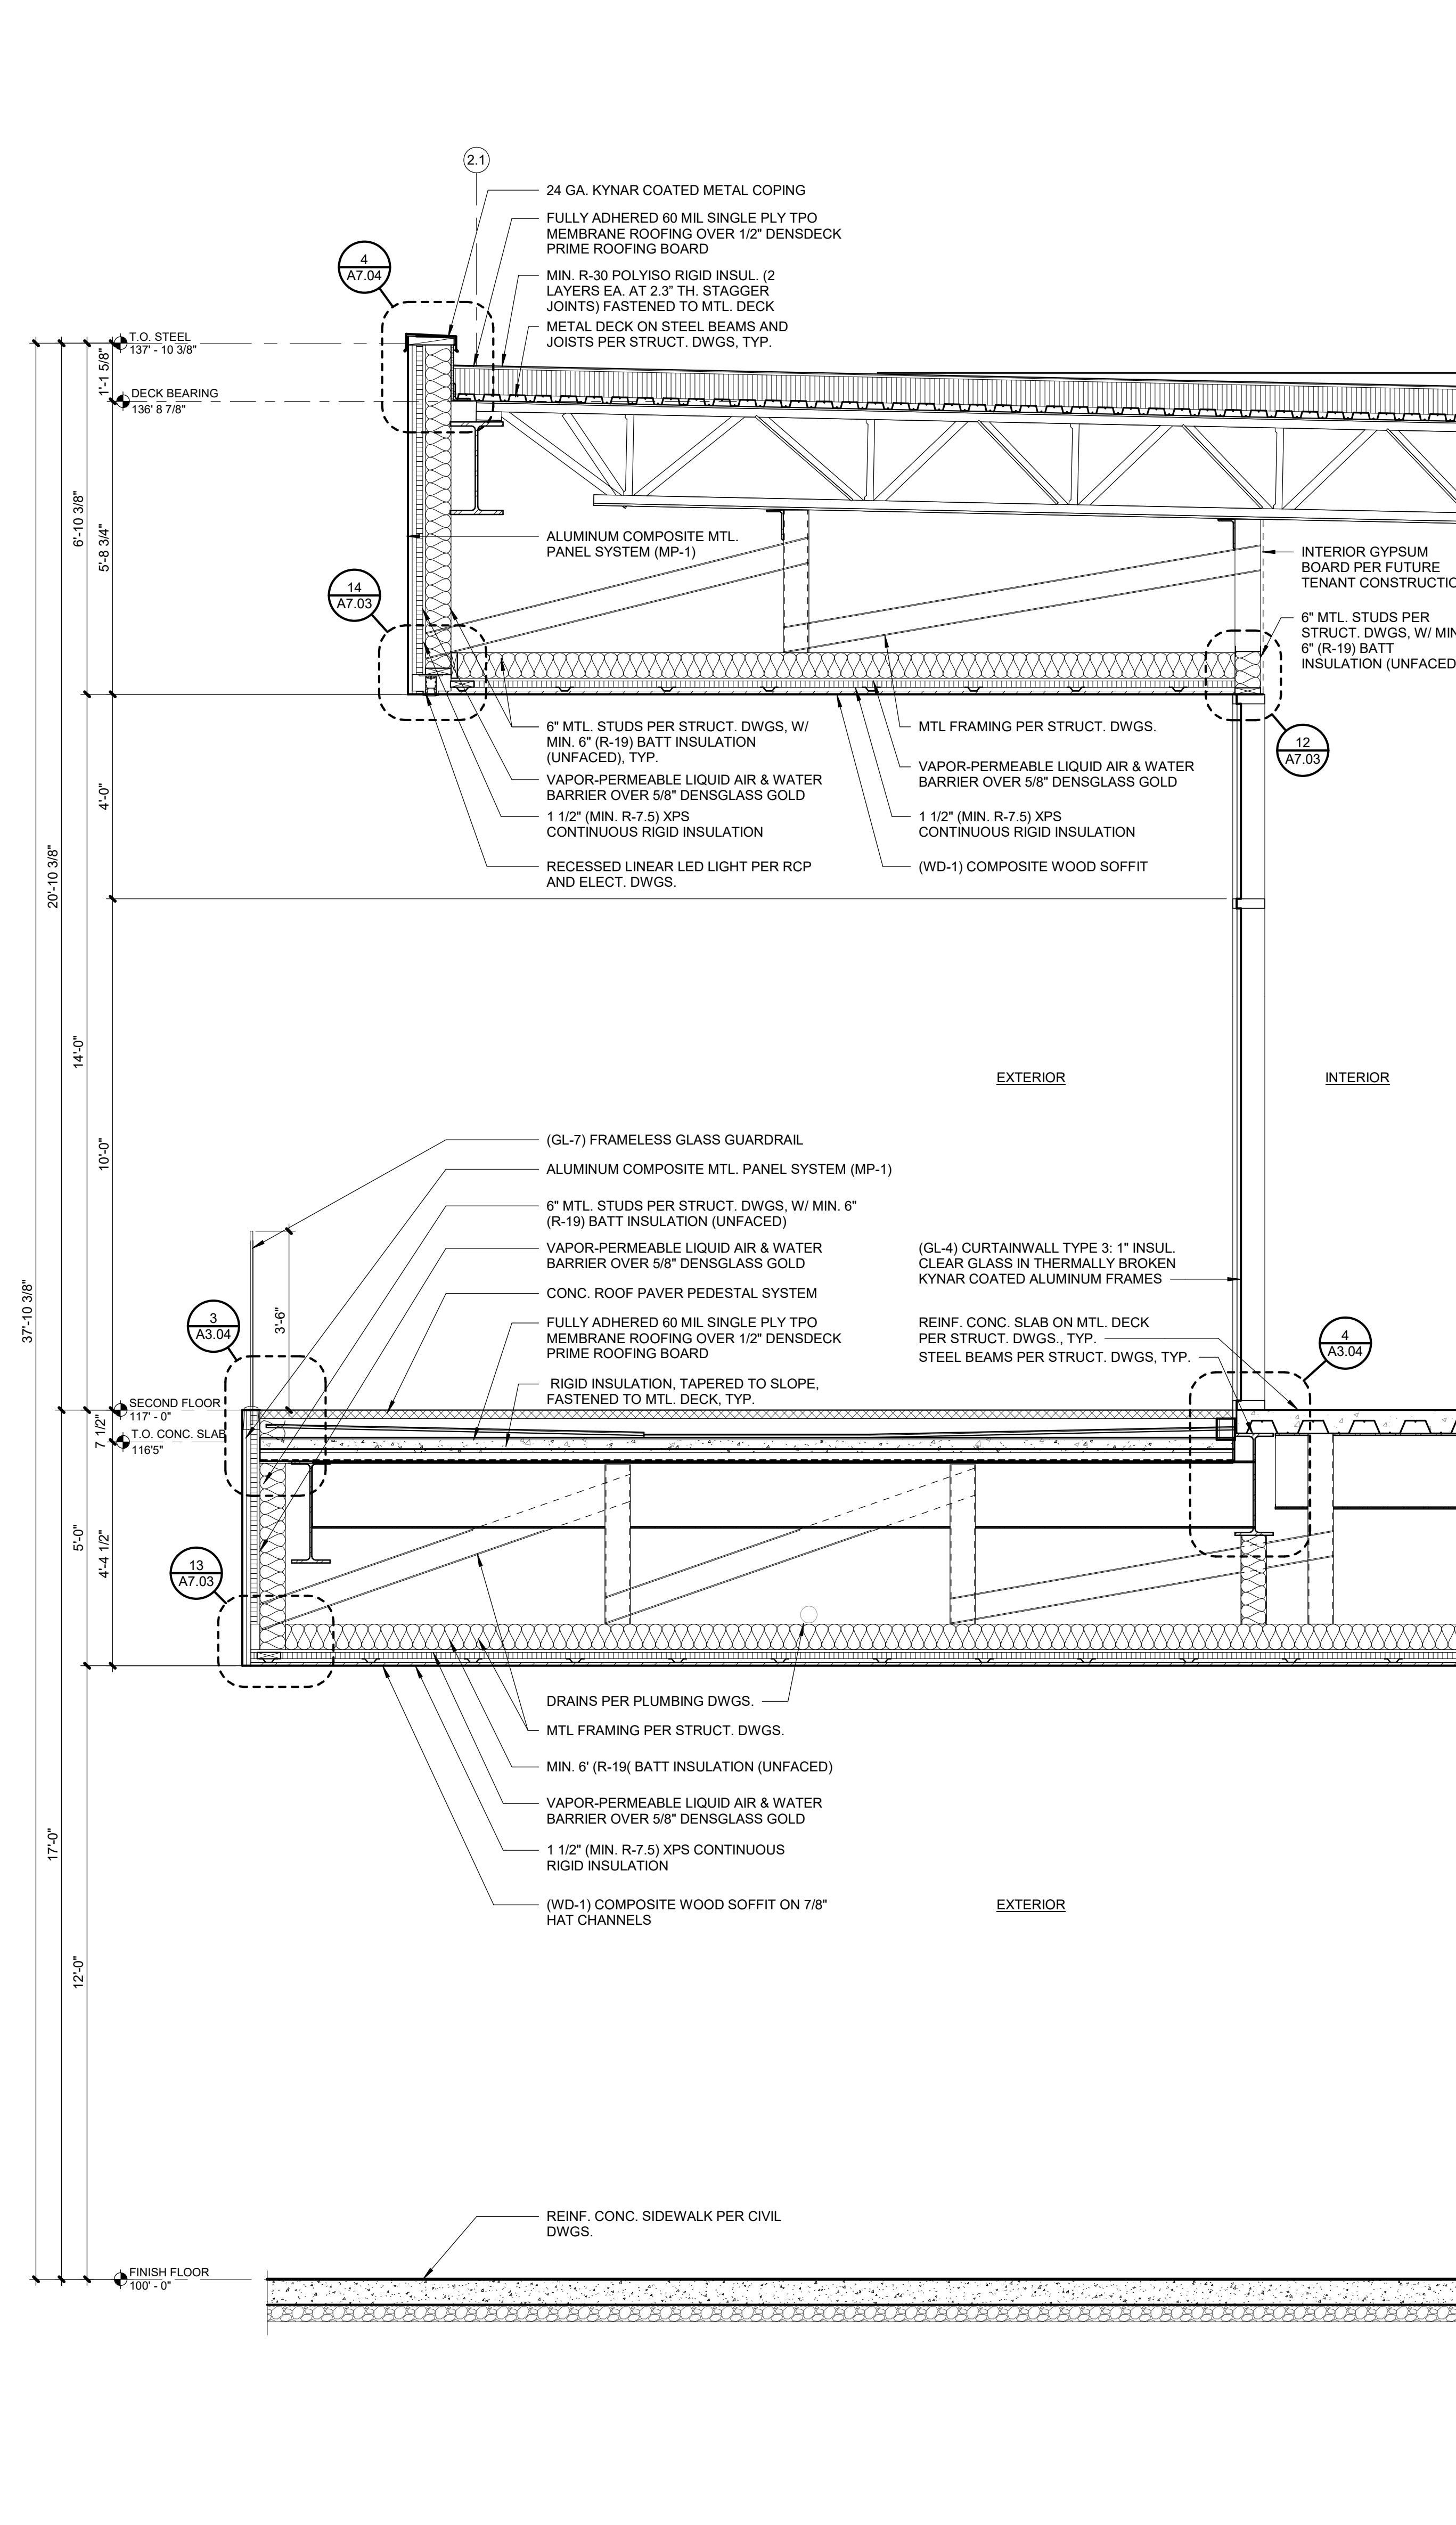


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|-------|----------------------|
| 1     | WALL SECTION         |
| A5.10 | SCALE : 1/2" = 1'-0" |












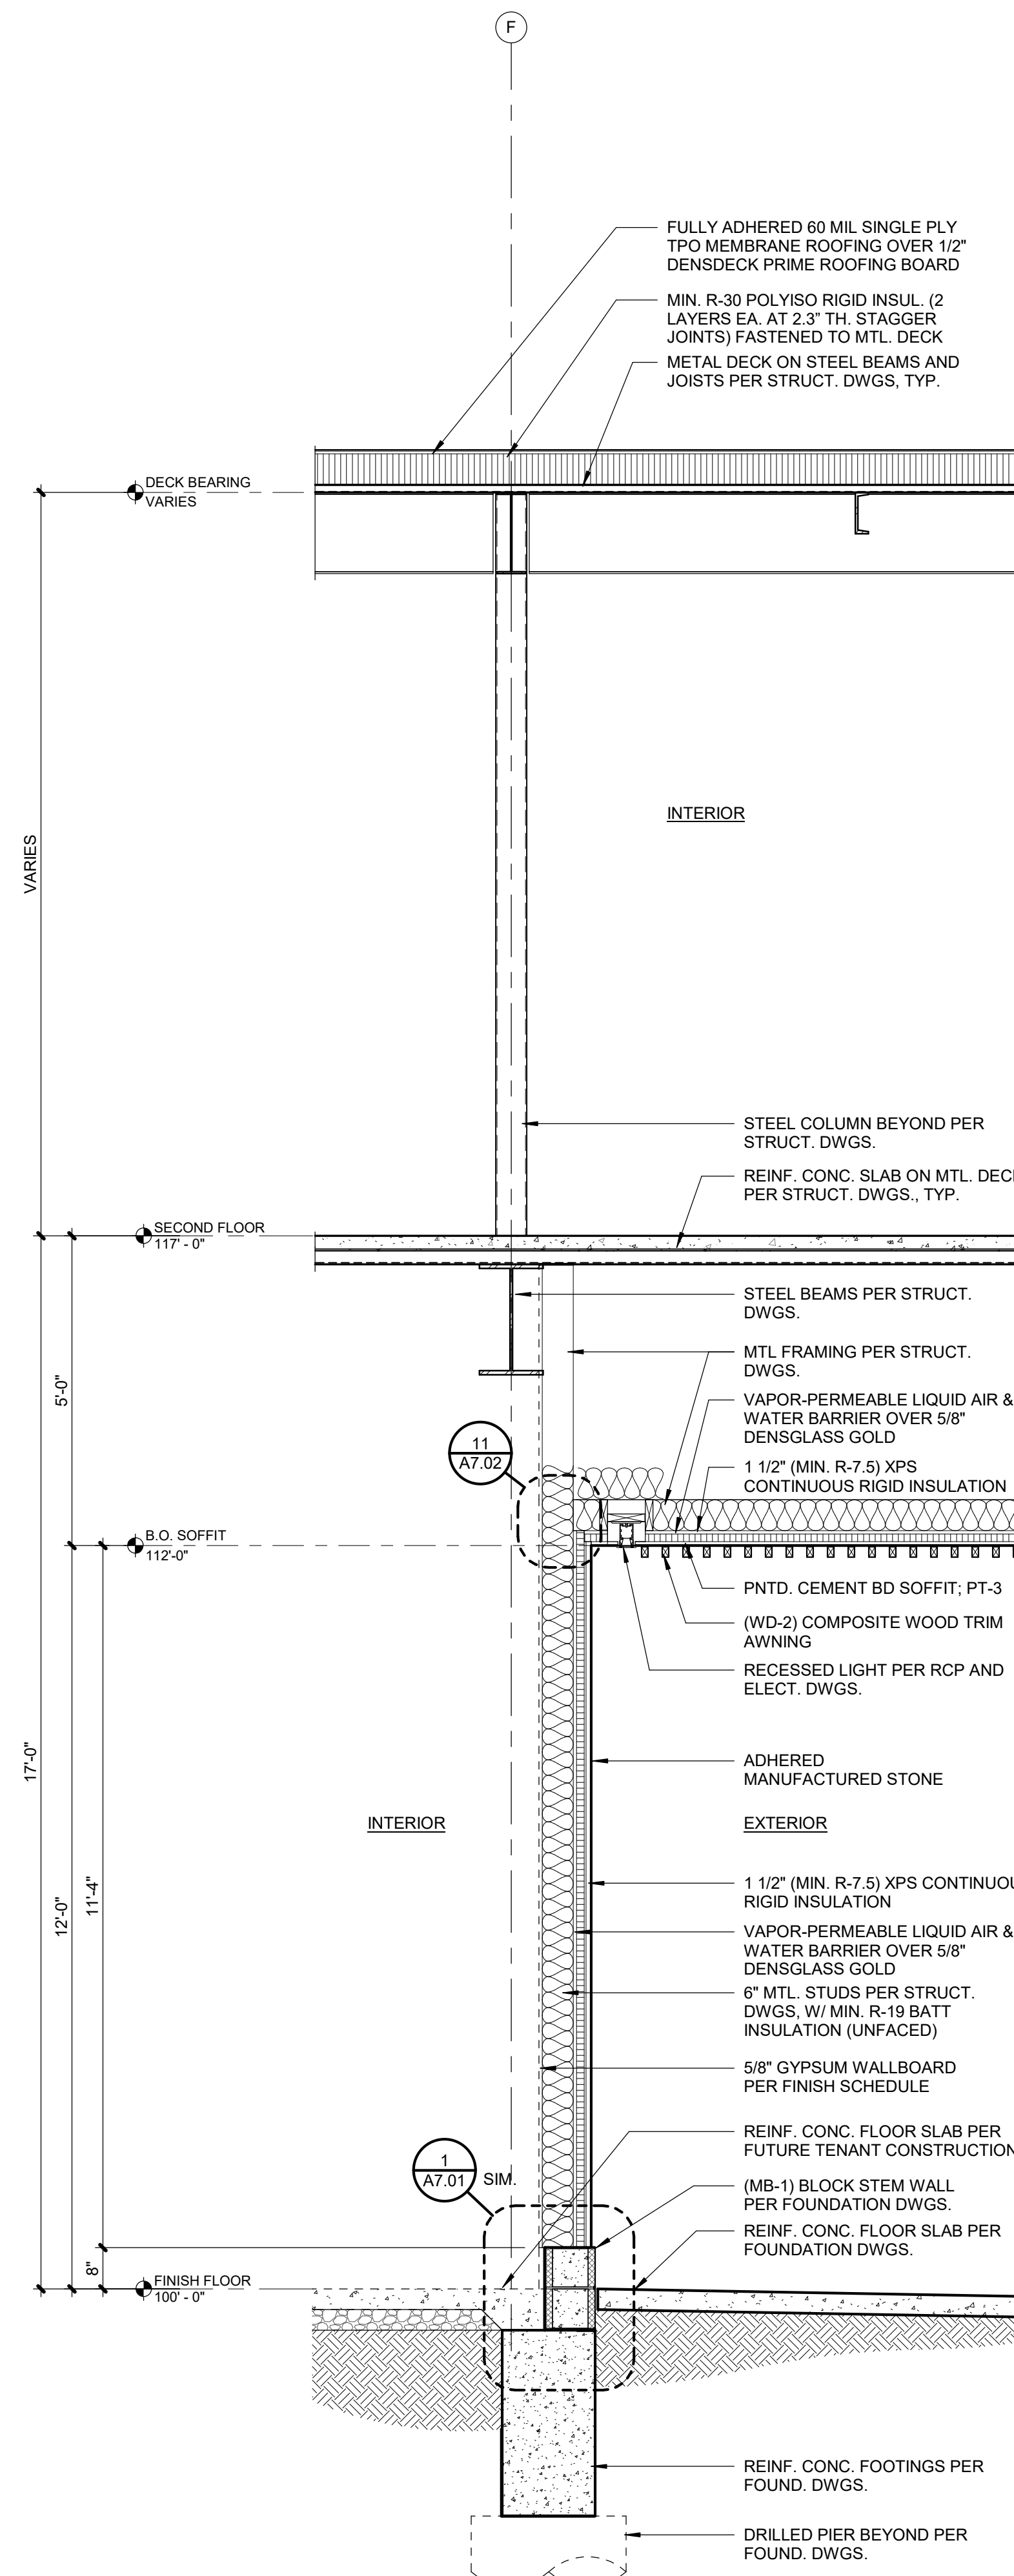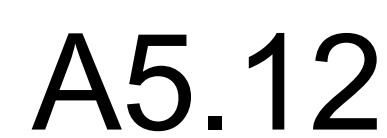



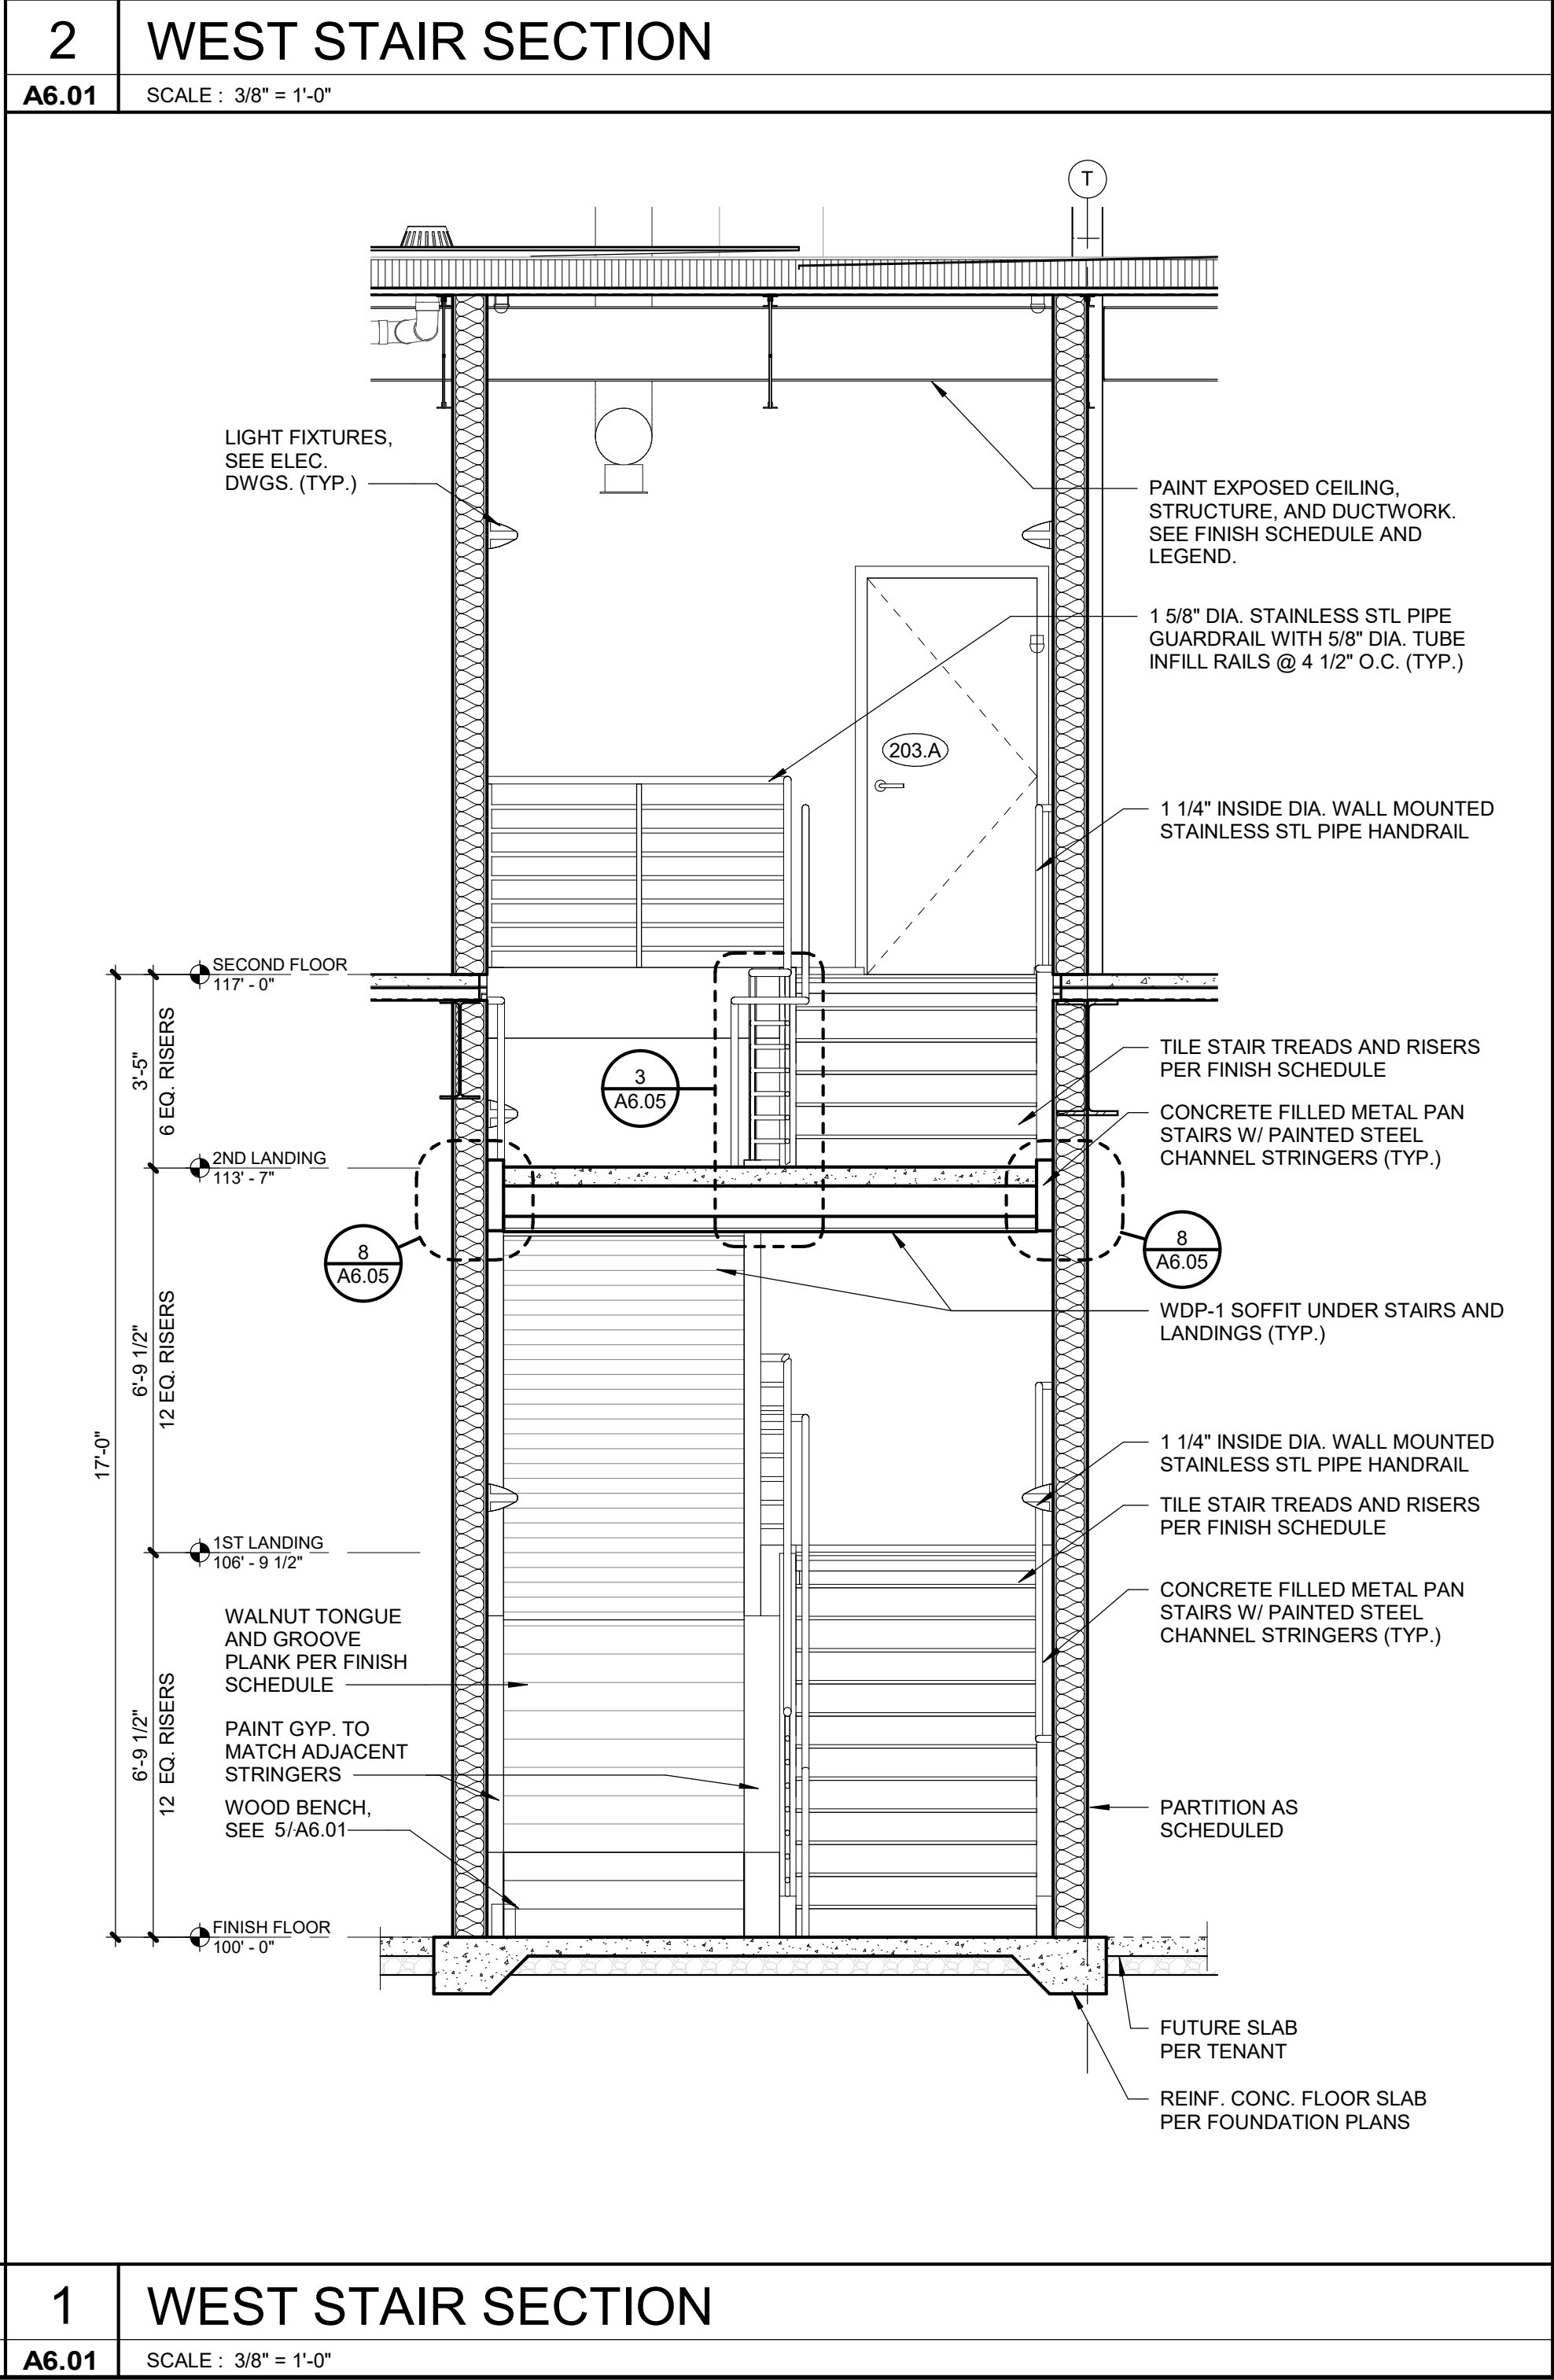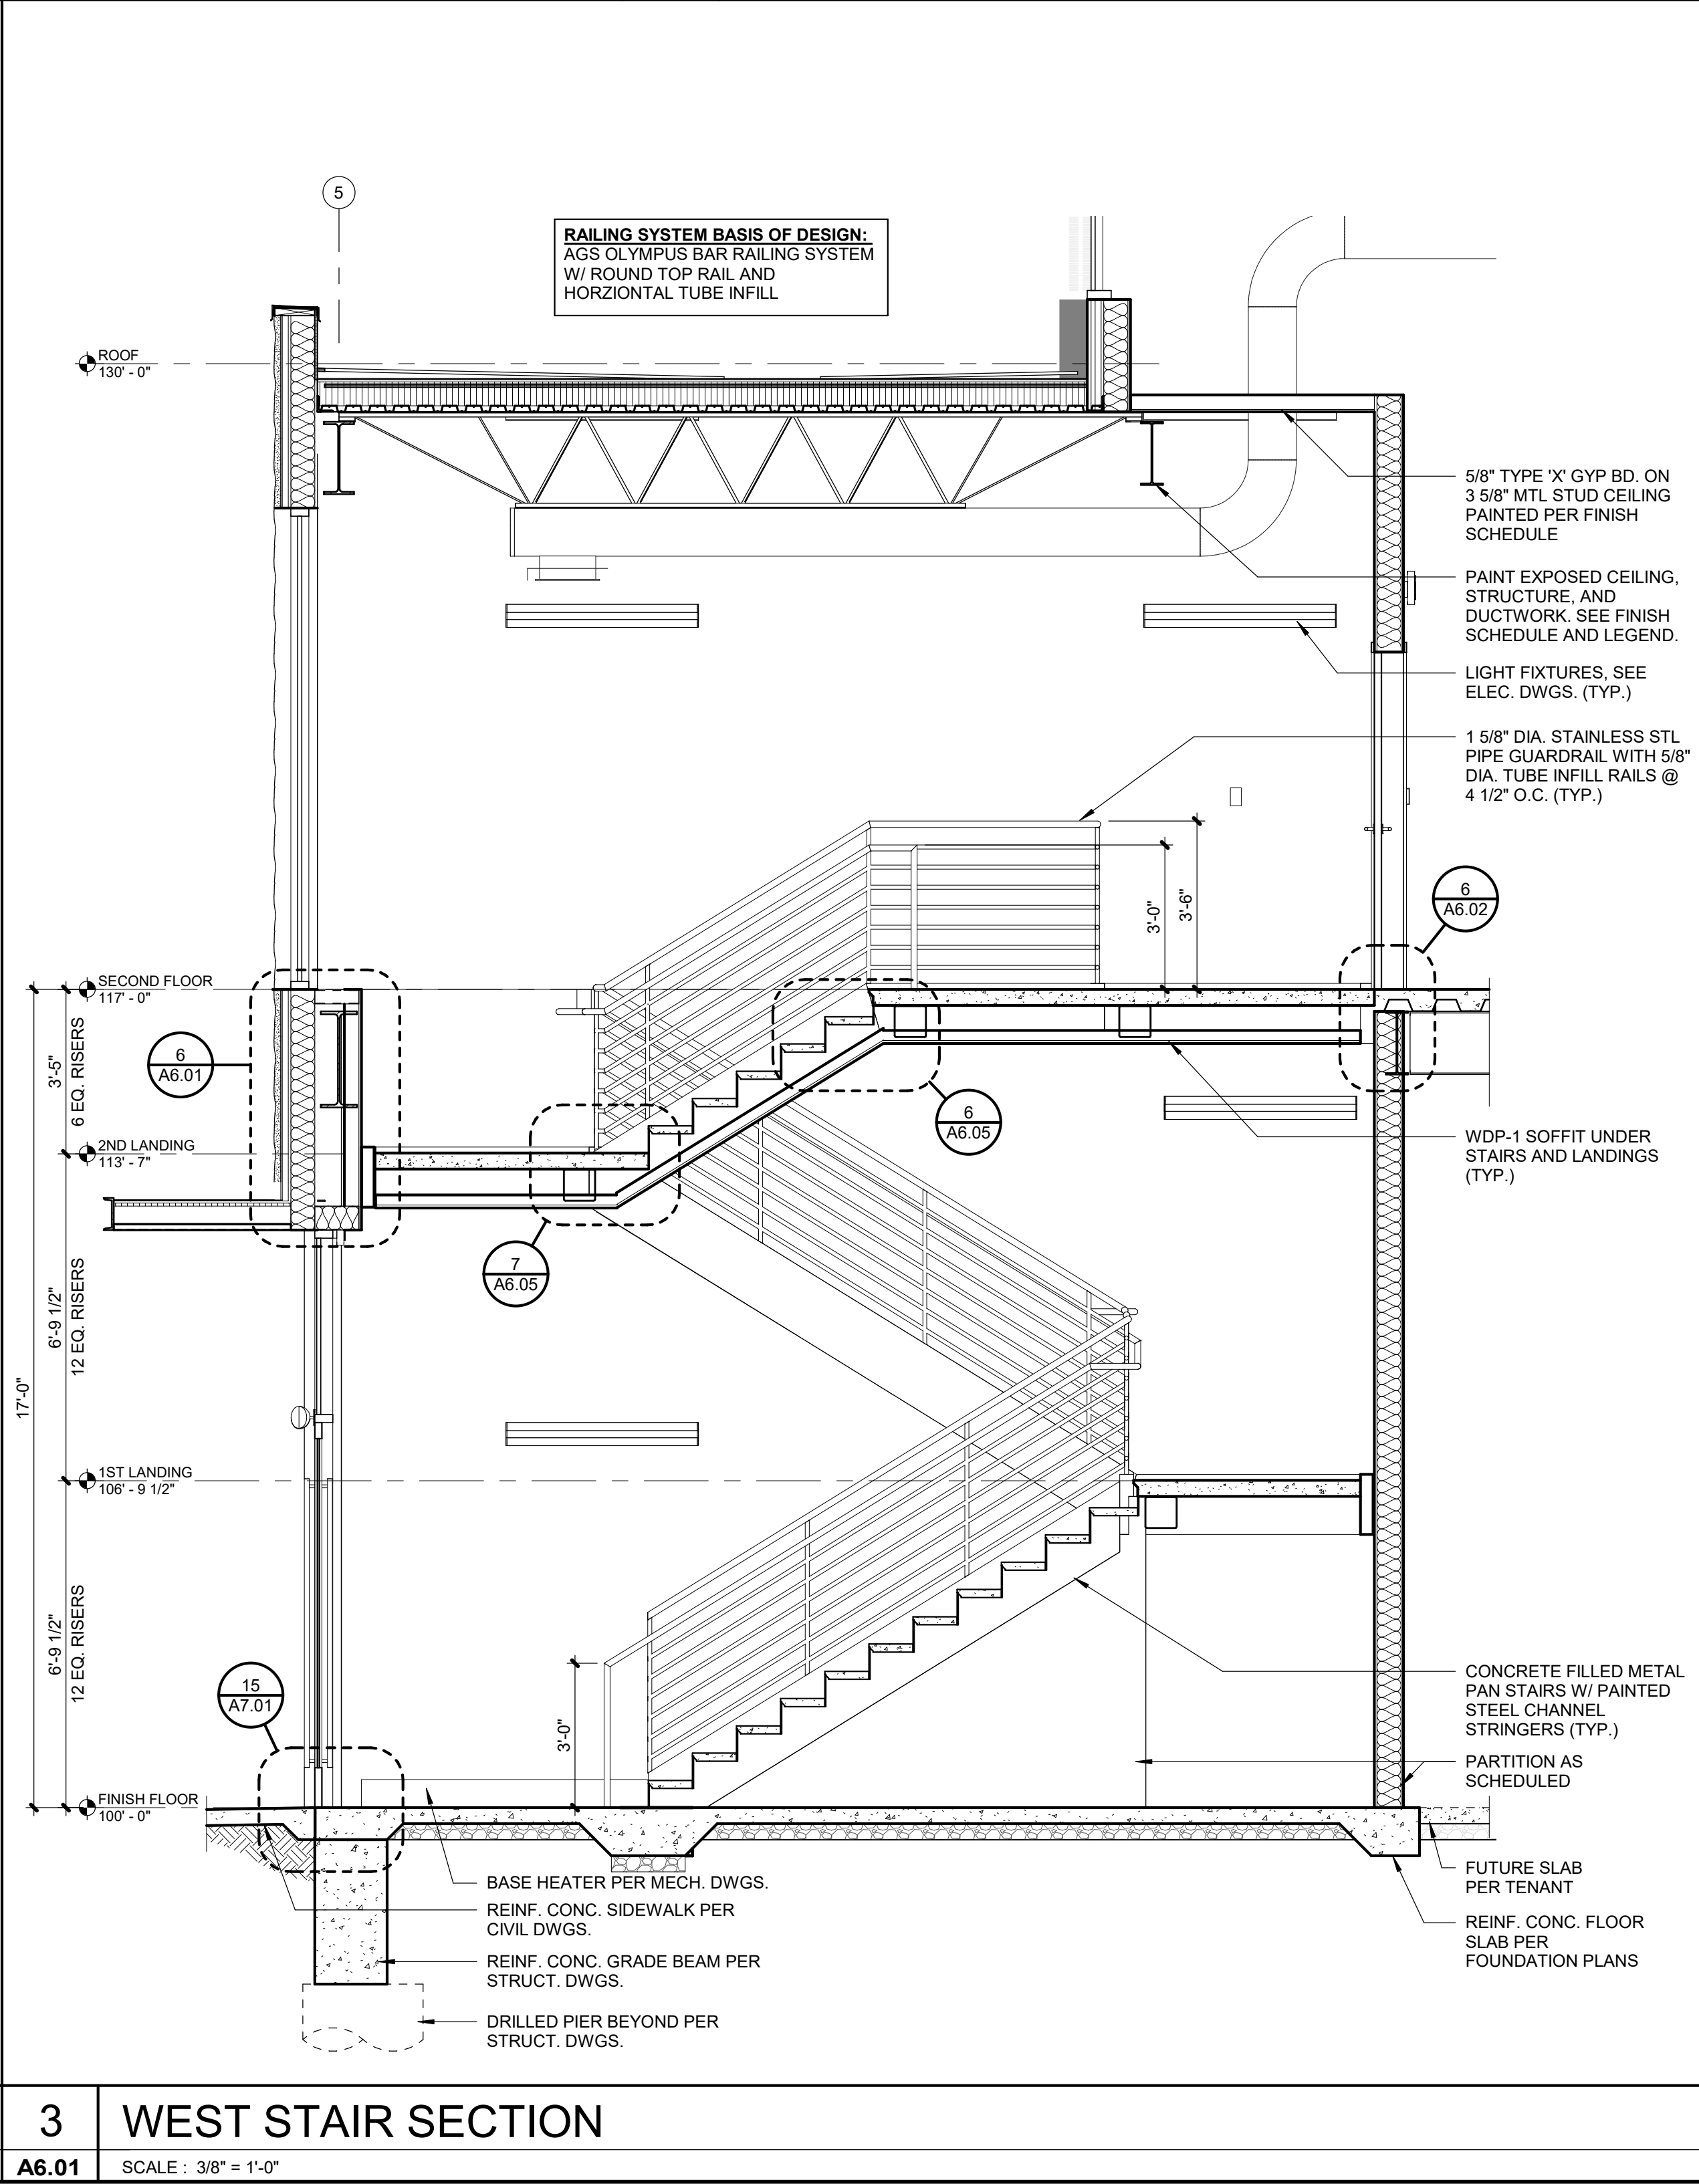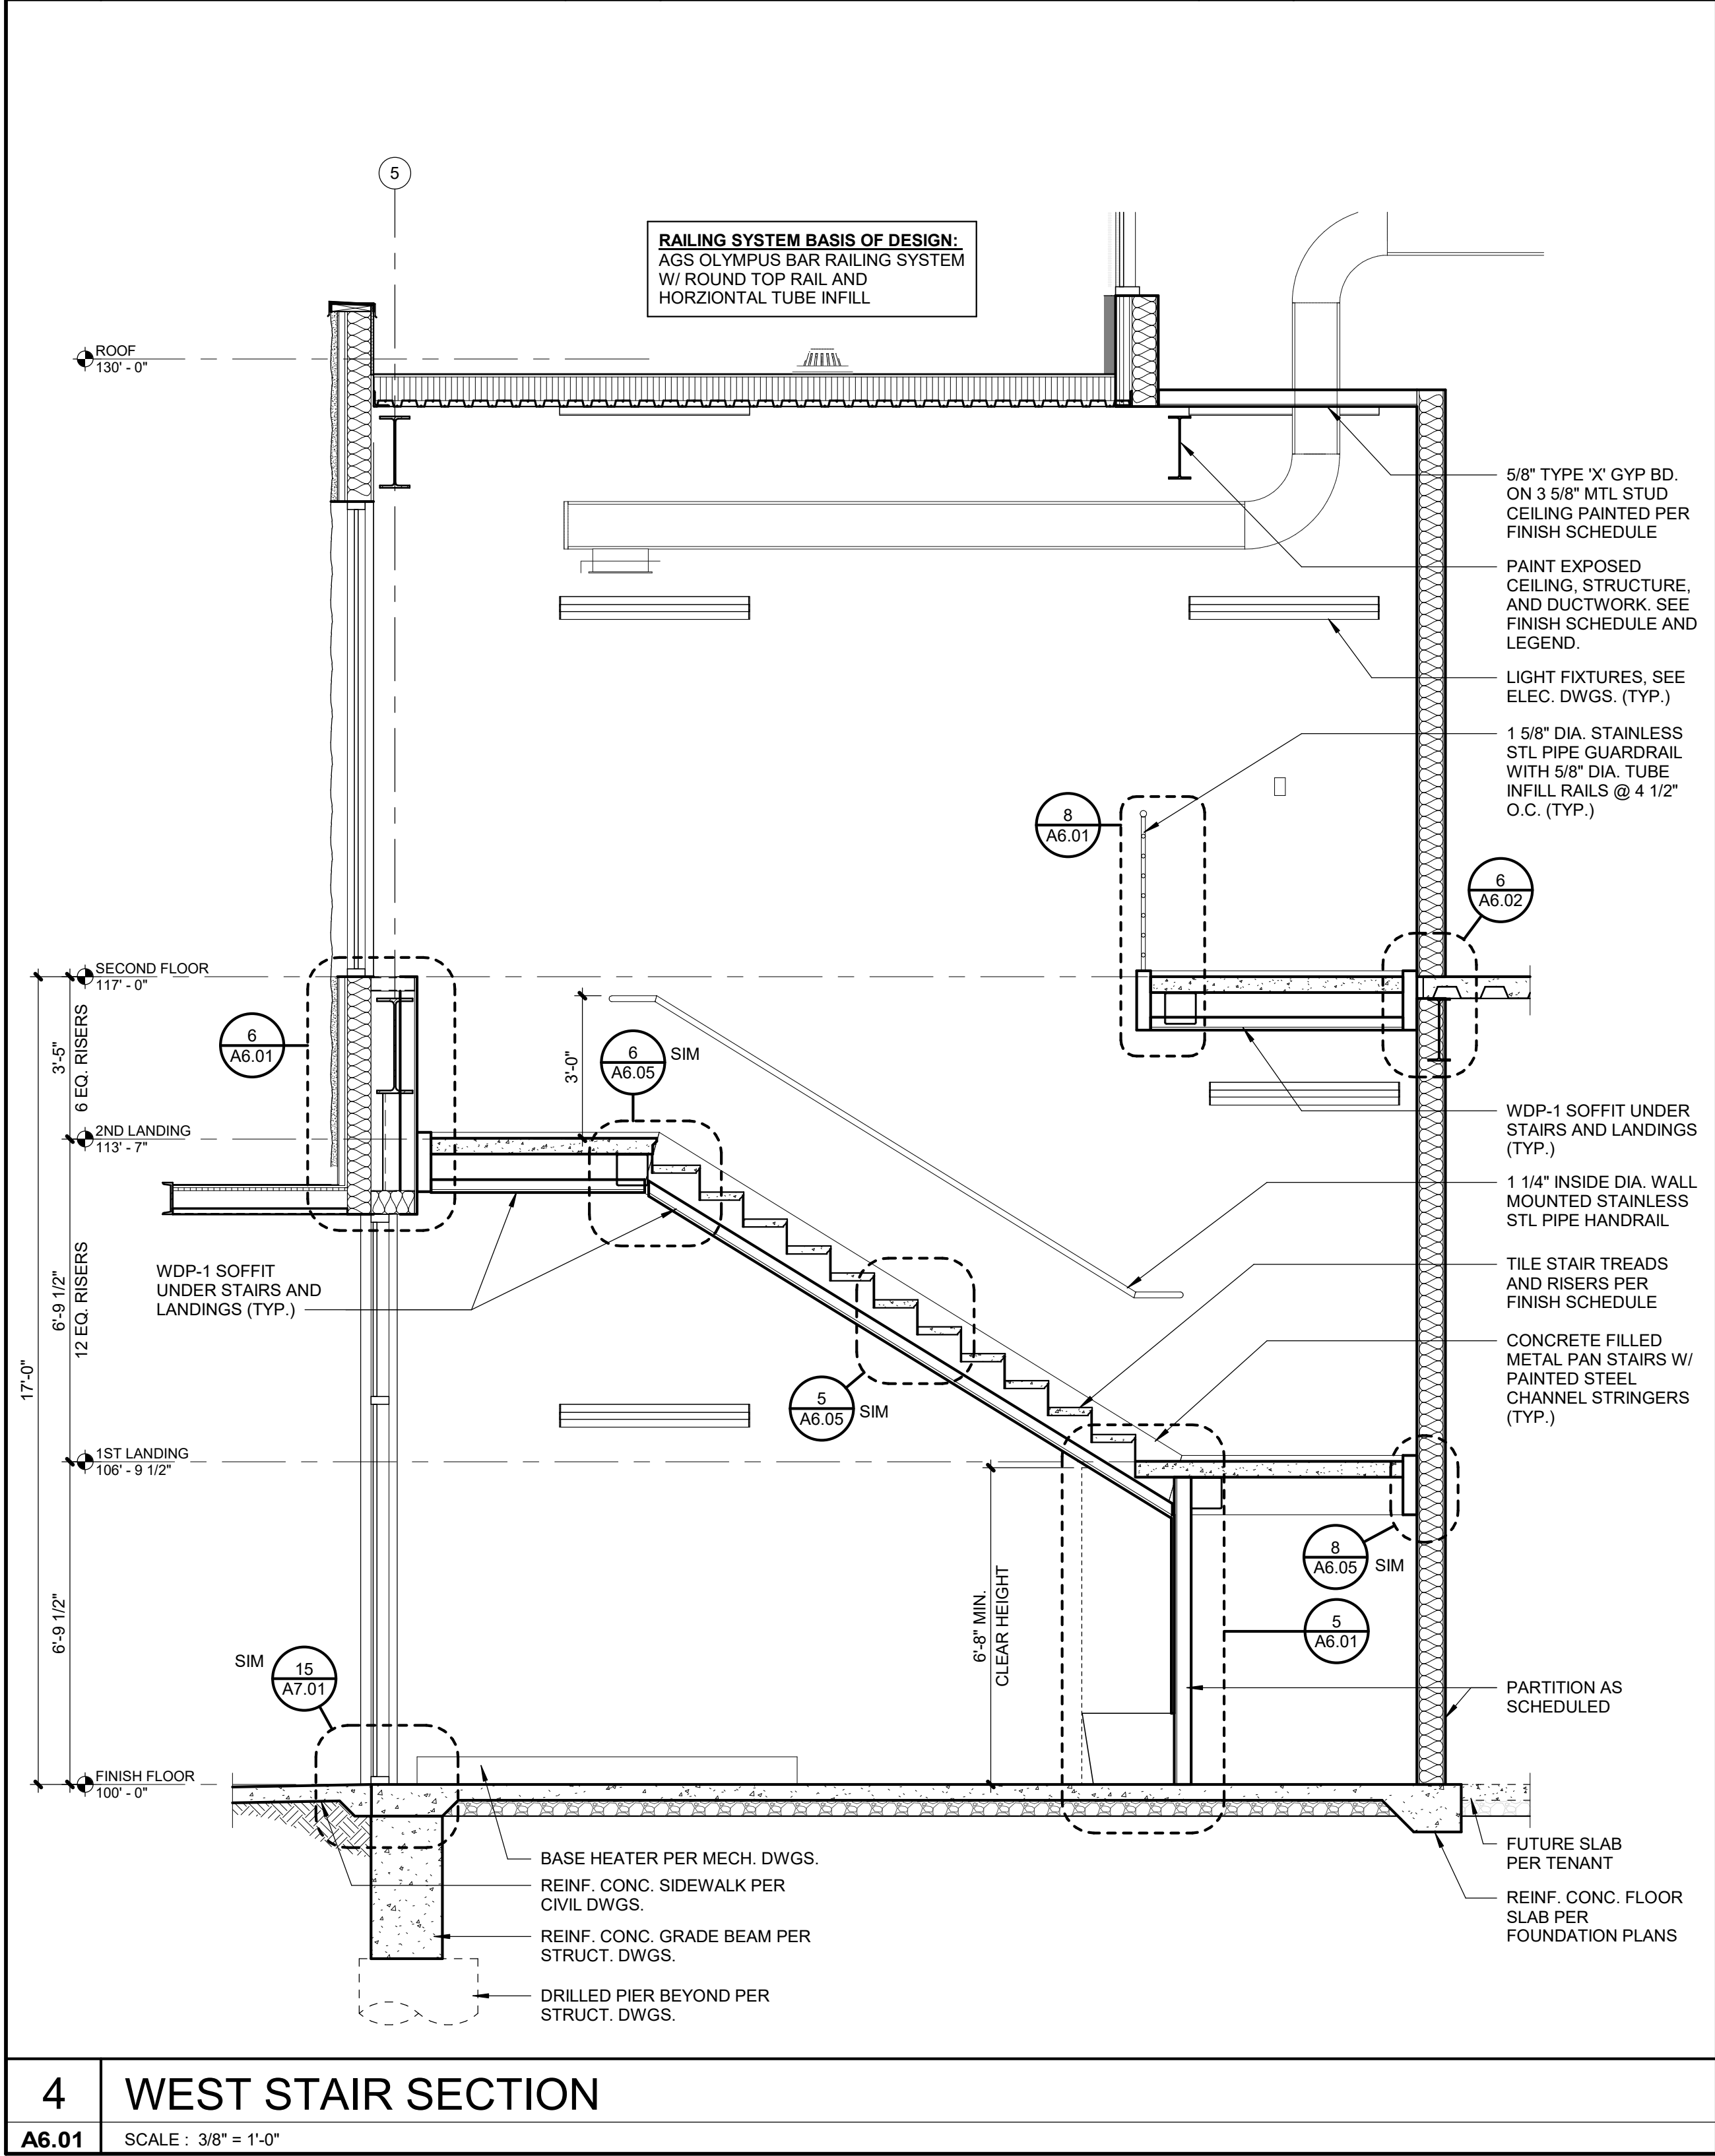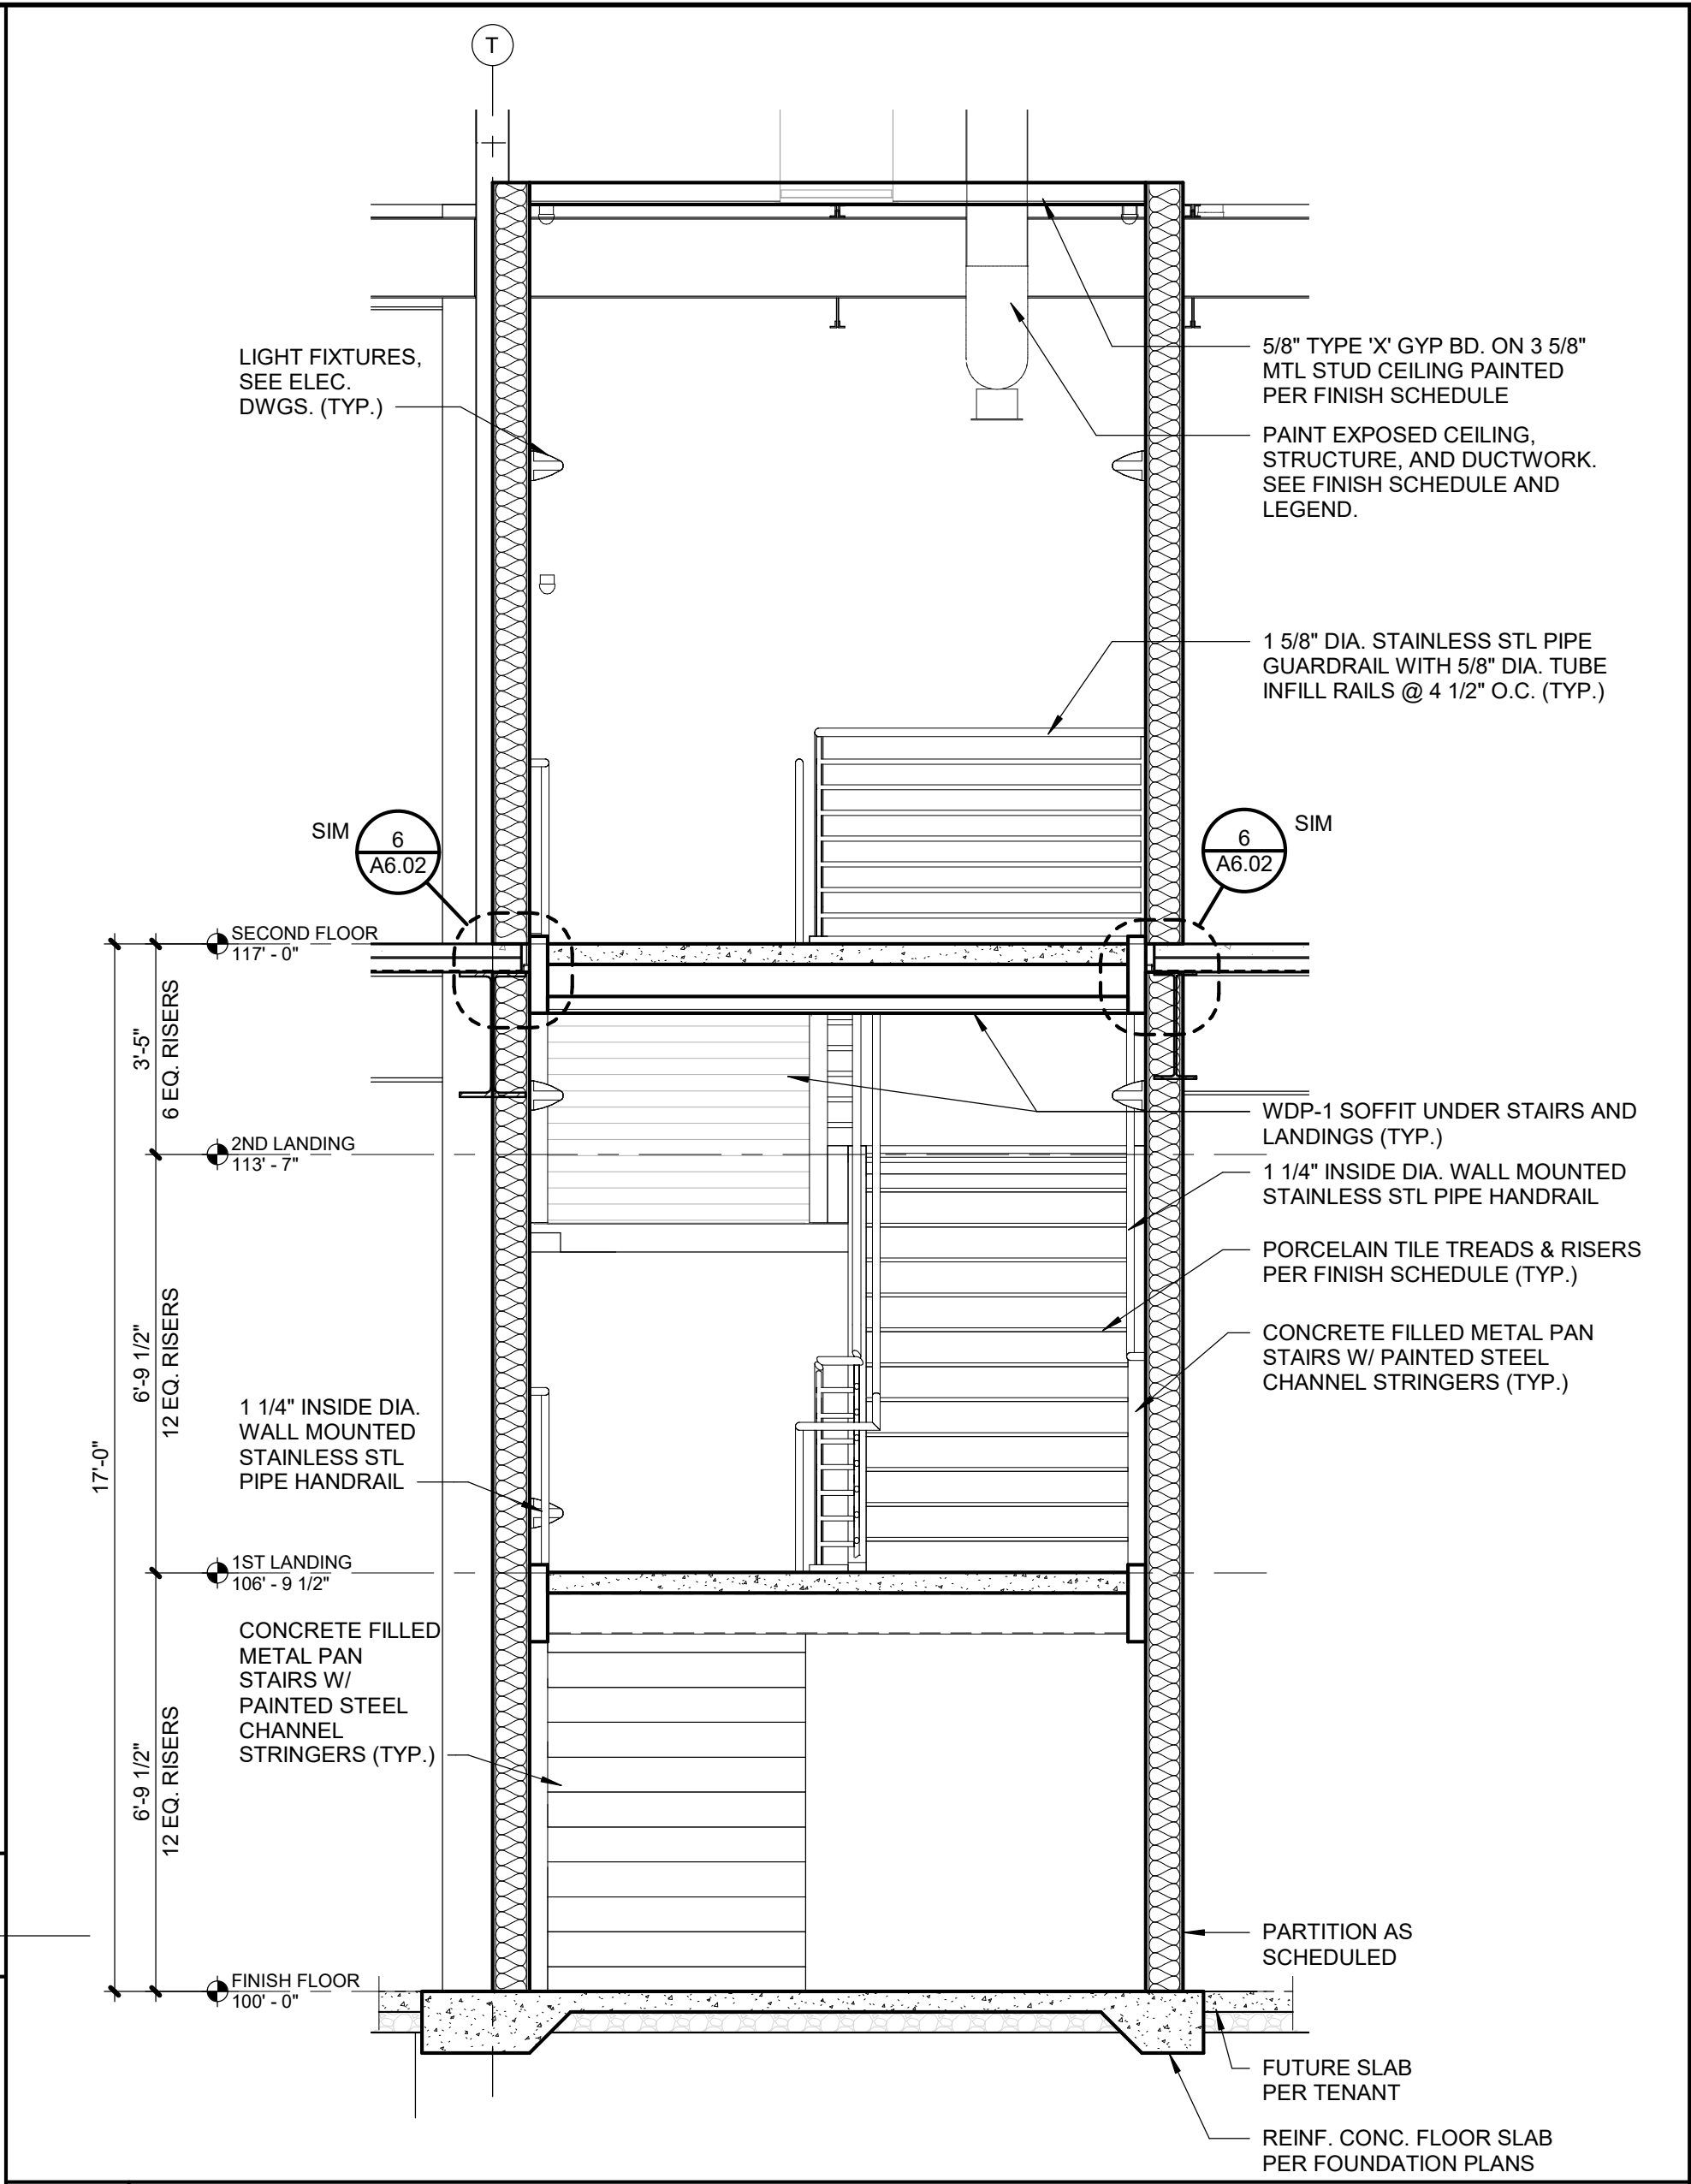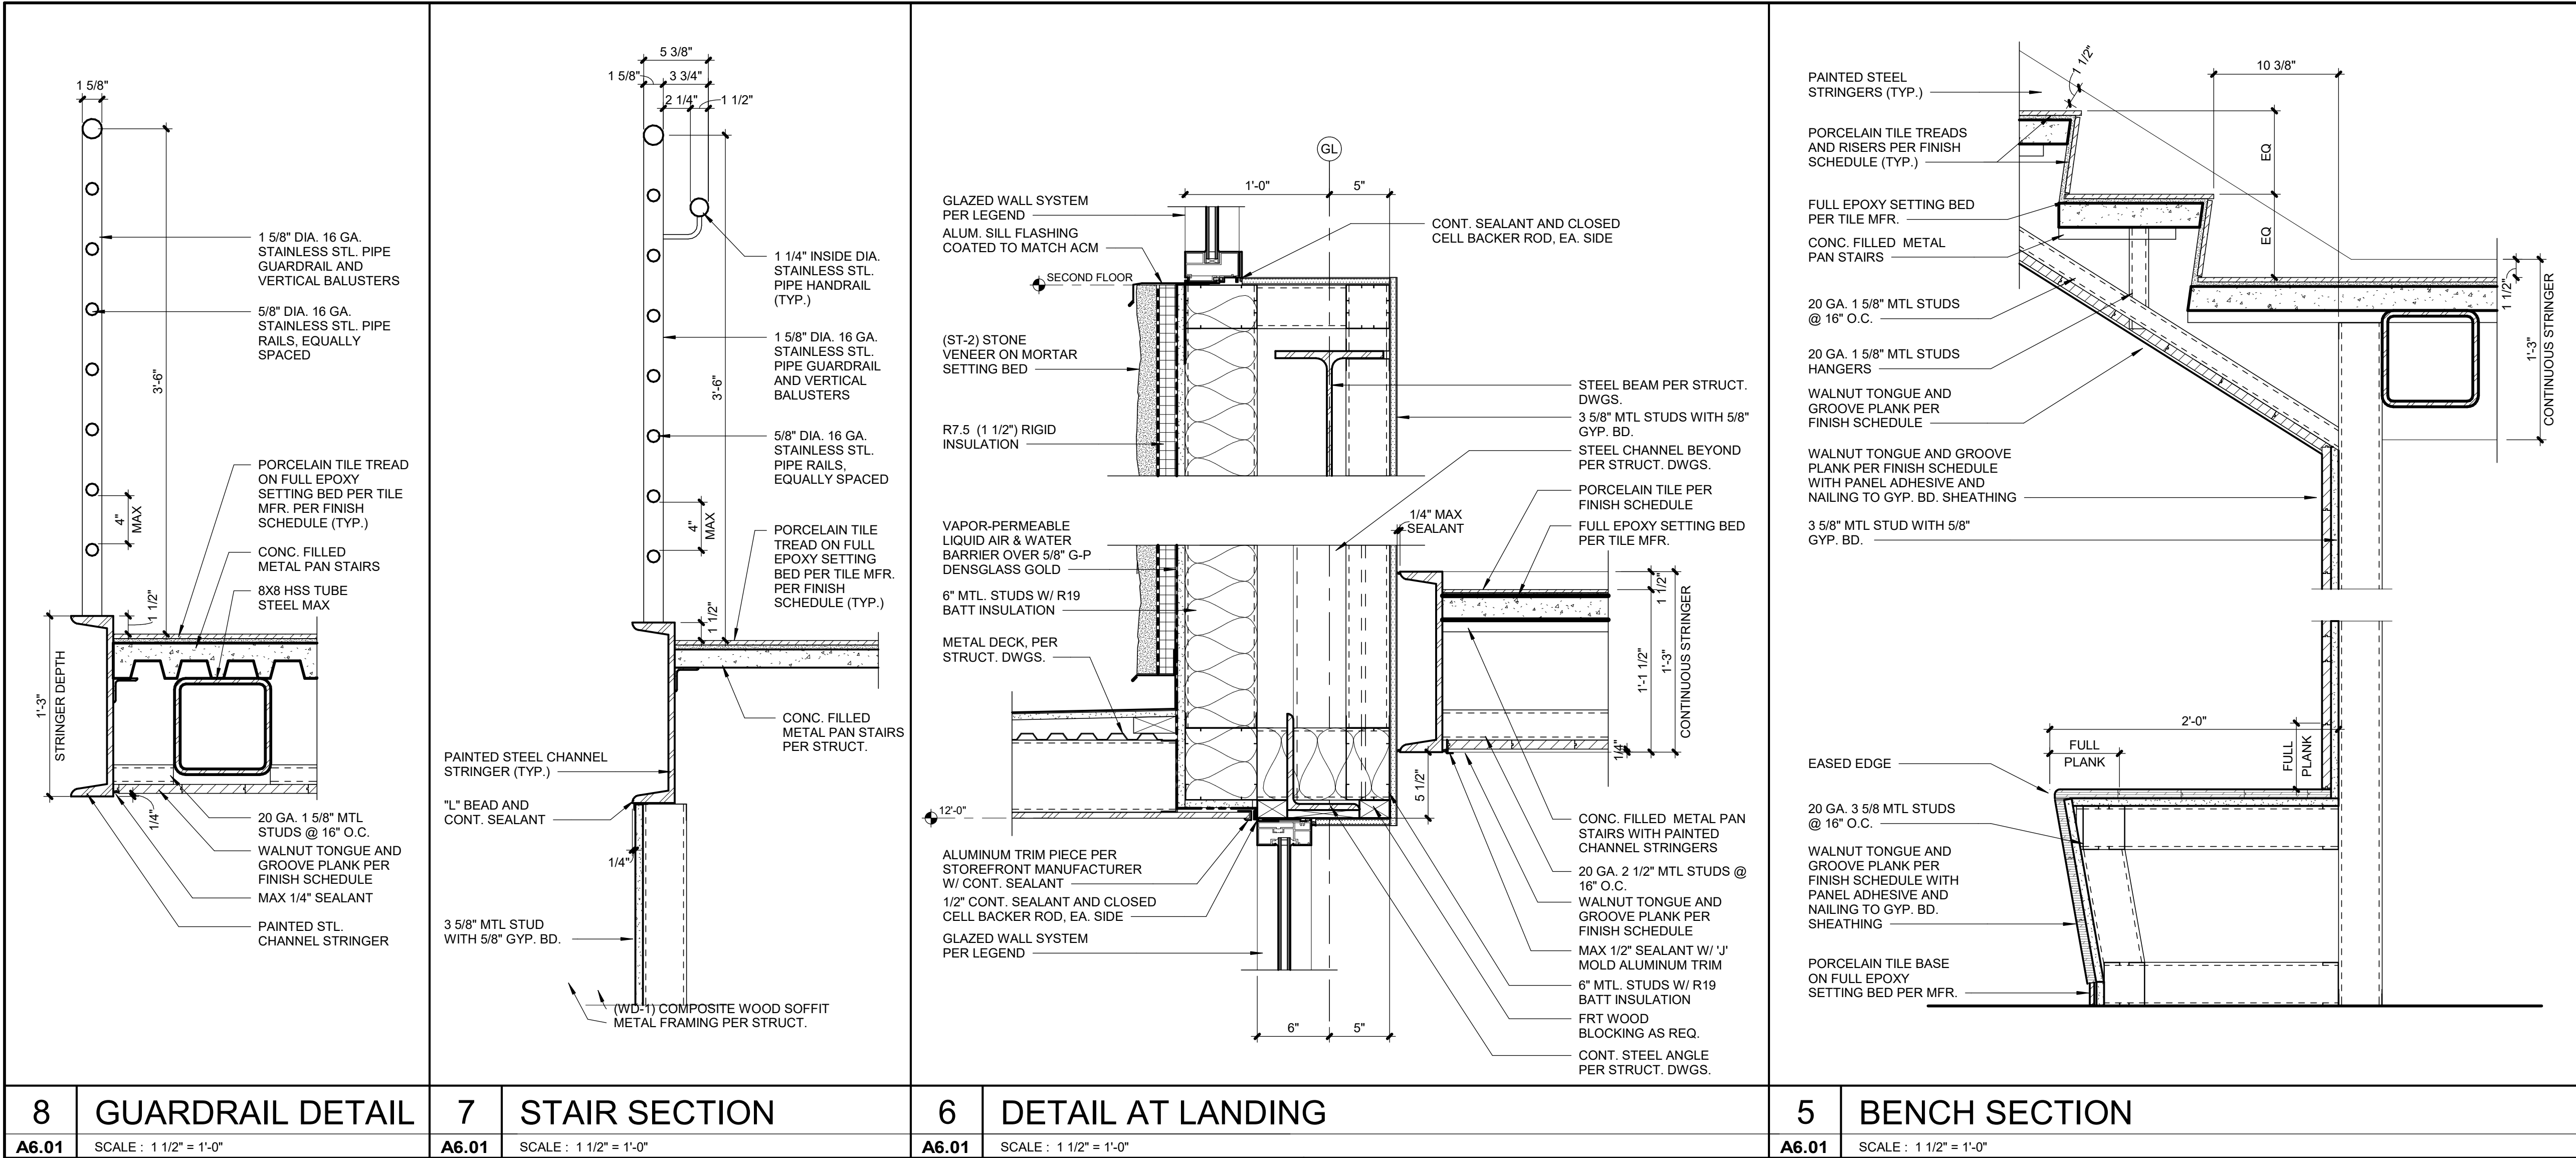





PARAGON STAR  
- LOT 9 -  
BUILDING 2  
PARAGON STAR  
FIRST PLAT, LOT 9  
LEE'S SUMMIT, MO

Project No.: 19050.01  
Date: 10.25.19  
Issued For: SHELL - CD SET


| REVISIONS |      |             |
|-----------|------|-------------|
| No.       | Date | Description |
|           |      |             |
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|           |      |             |
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|           |      |             |

REGISTRATION



PROJECT TEAM

|                 |                              |
|-----------------|------------------------------|
| ARCHITECT       | FINKLE+WILLIAMS ARCHITECTURE |
| CIVIL           | GBA                          |
| LANDSCAPE       | HOERR SCHAUDT / LANDS        |
| FOUNDATIONS     | BSE STRUCTURAL ENGINEERS     |
| STRUCTURAL      | BSE STRUCTURAL ENGINEERS     |
| PLUMBING        | HENDERSON ENGINEERS          |
| MECHANICAL      | HENDERSON ENGINEERS          |
| ELECTRICAL      | HENDERSON ENGINEERS          |
| FIRE PROTECTION | HENDERSON ENGINEERS          |
| CONTRACTOR      | FOGEL ANDERSON               |



FINKLE + WILLIAMS  
ARCHITECTURE

7007 College Blvd, Suite 415  
Overland Park, Kansas 66211  
913-498-1550

SHEET TITLE

VERTICAL CIRCULATION



SHEET NUMBER

A6.01








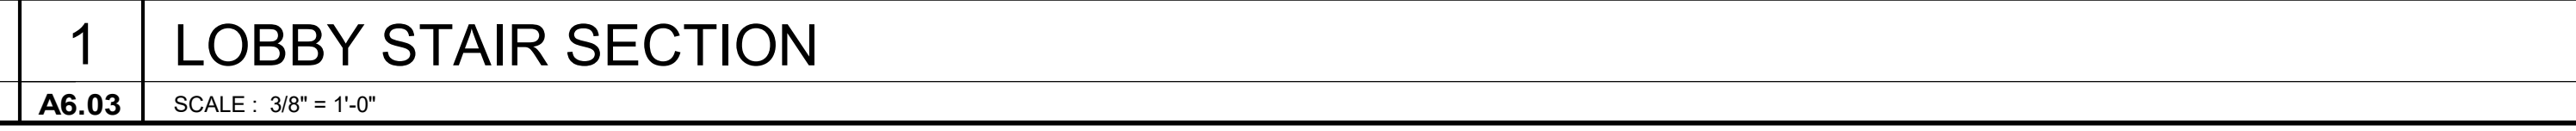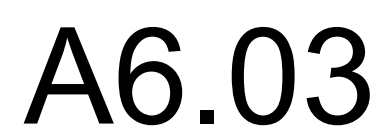




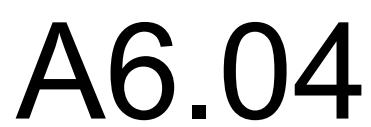


HANDRAIL: ROUND, STRAIGHT ENDS (HR61) BRUSHED STAINLESS STEEL (4SS)

SKIRTING (BRUSHED STAINLESS STEEL (4SS)

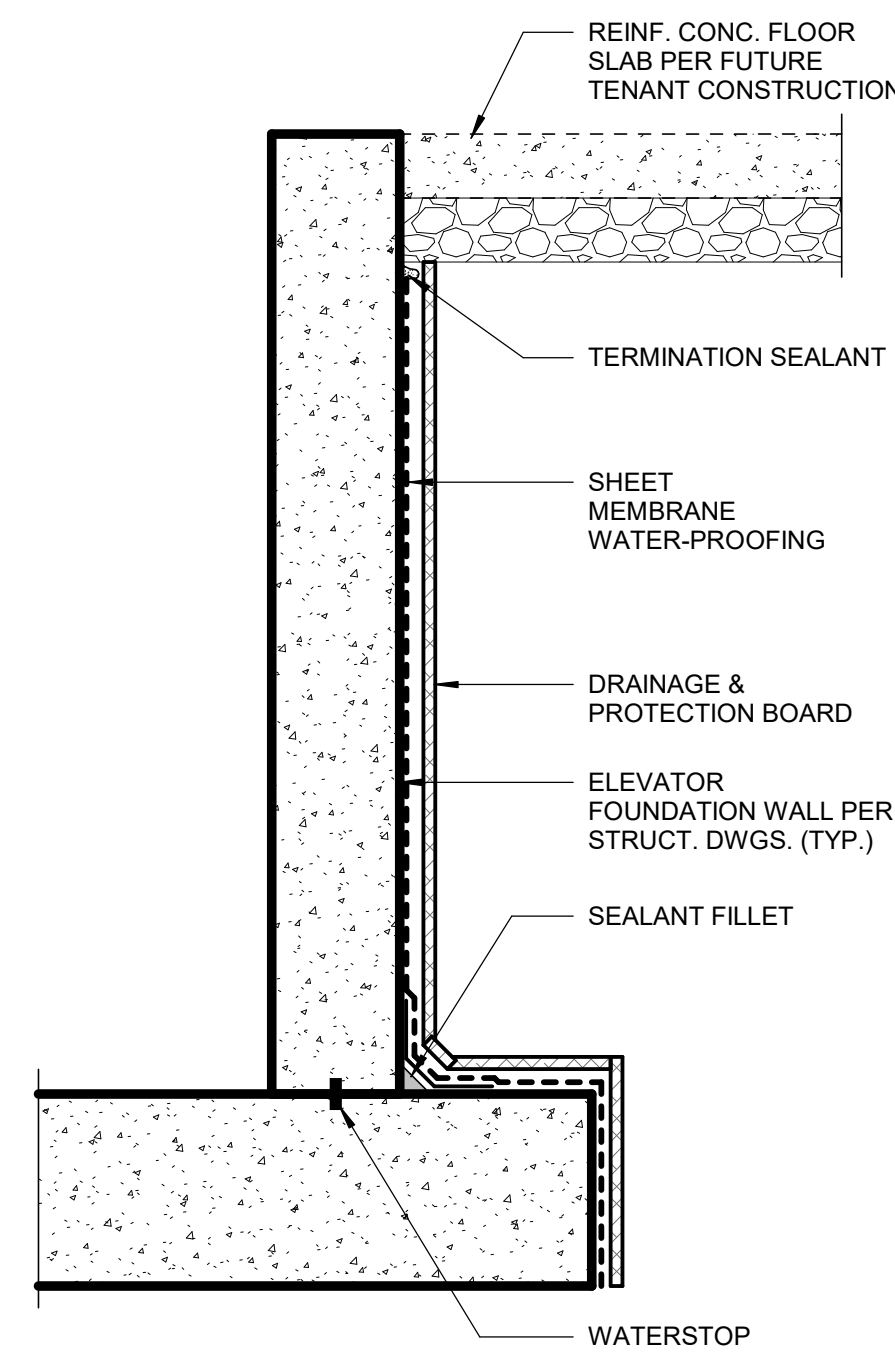


SCALE : 1" = 1'-0"


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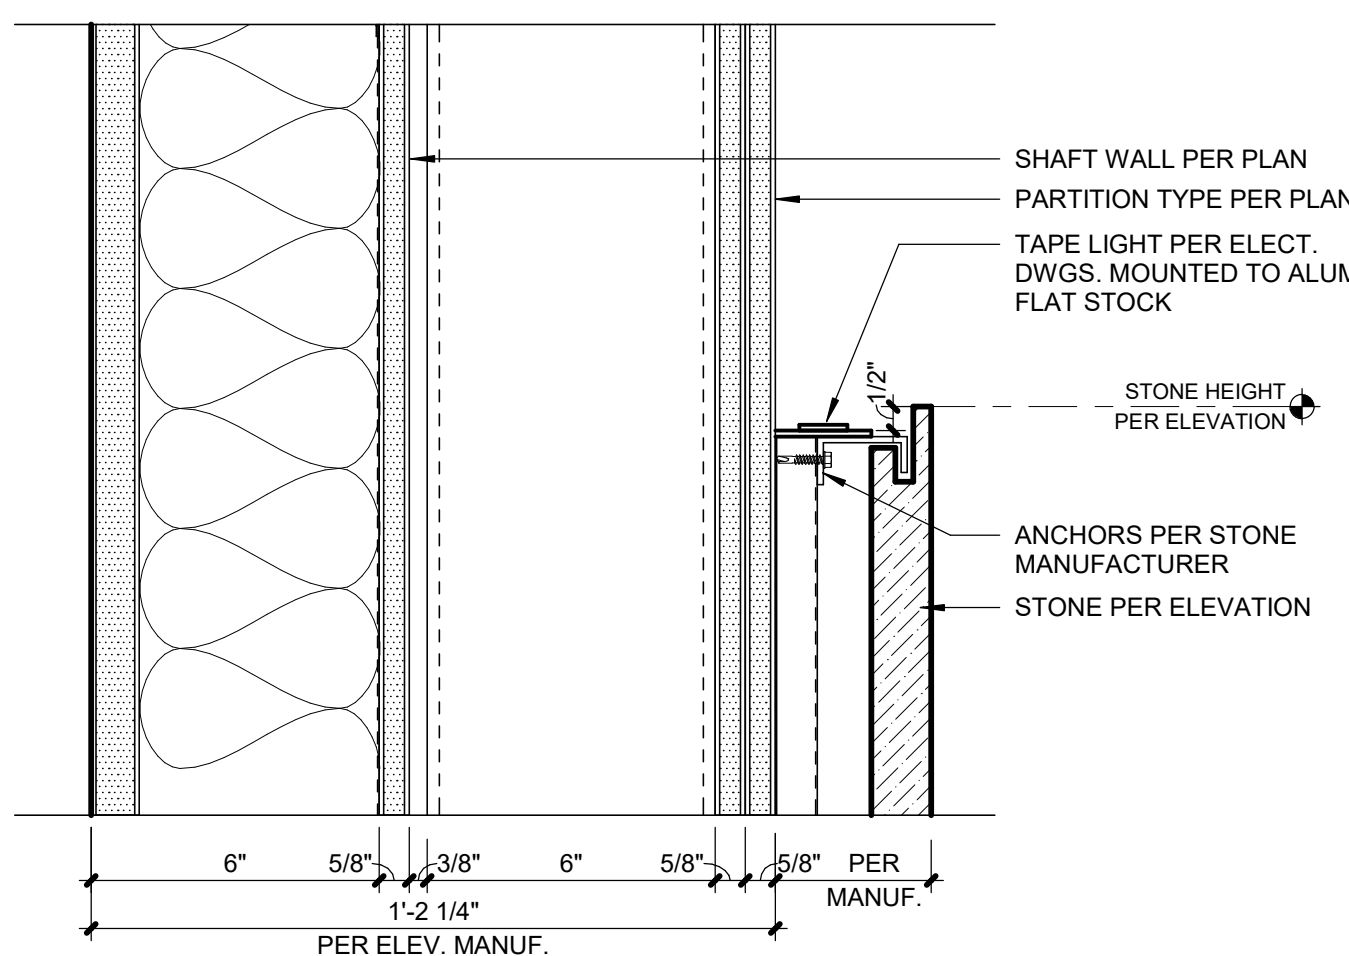
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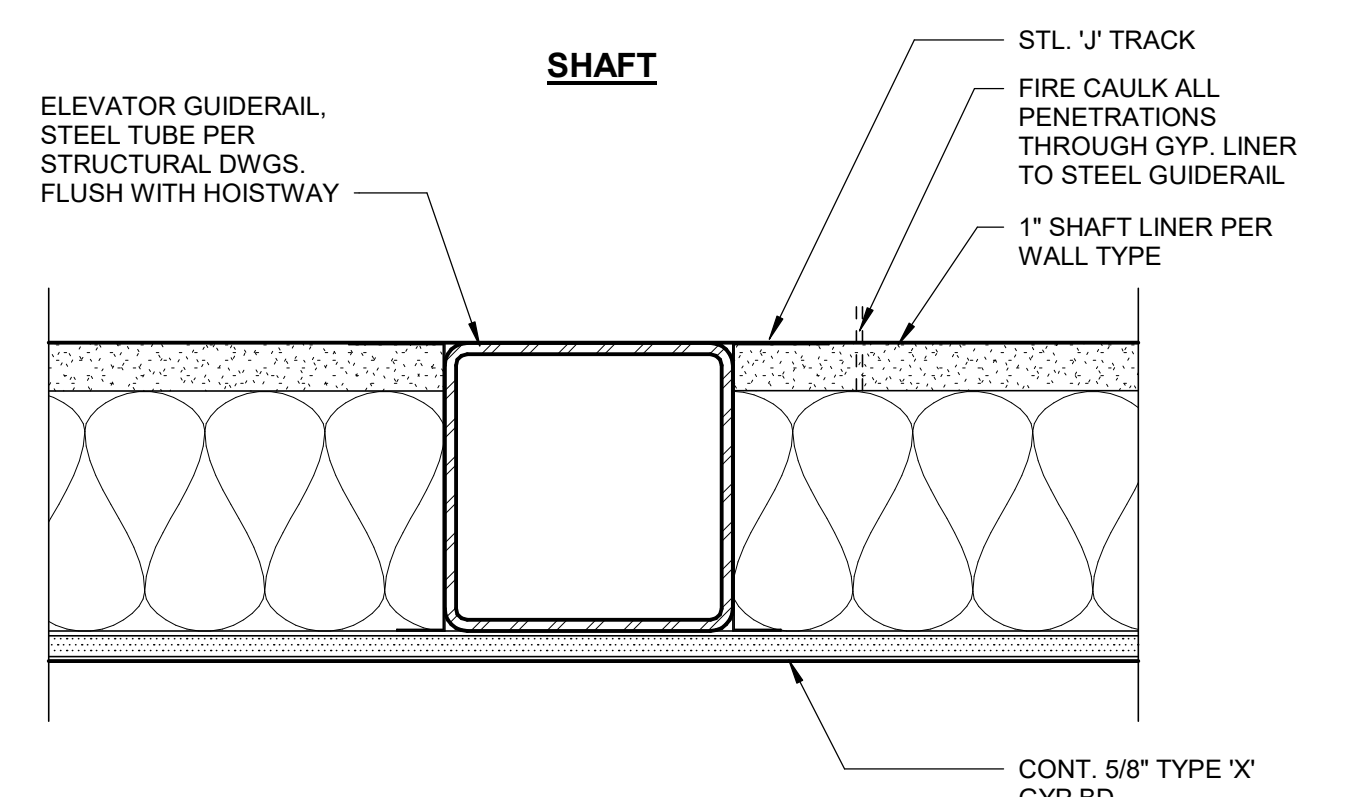
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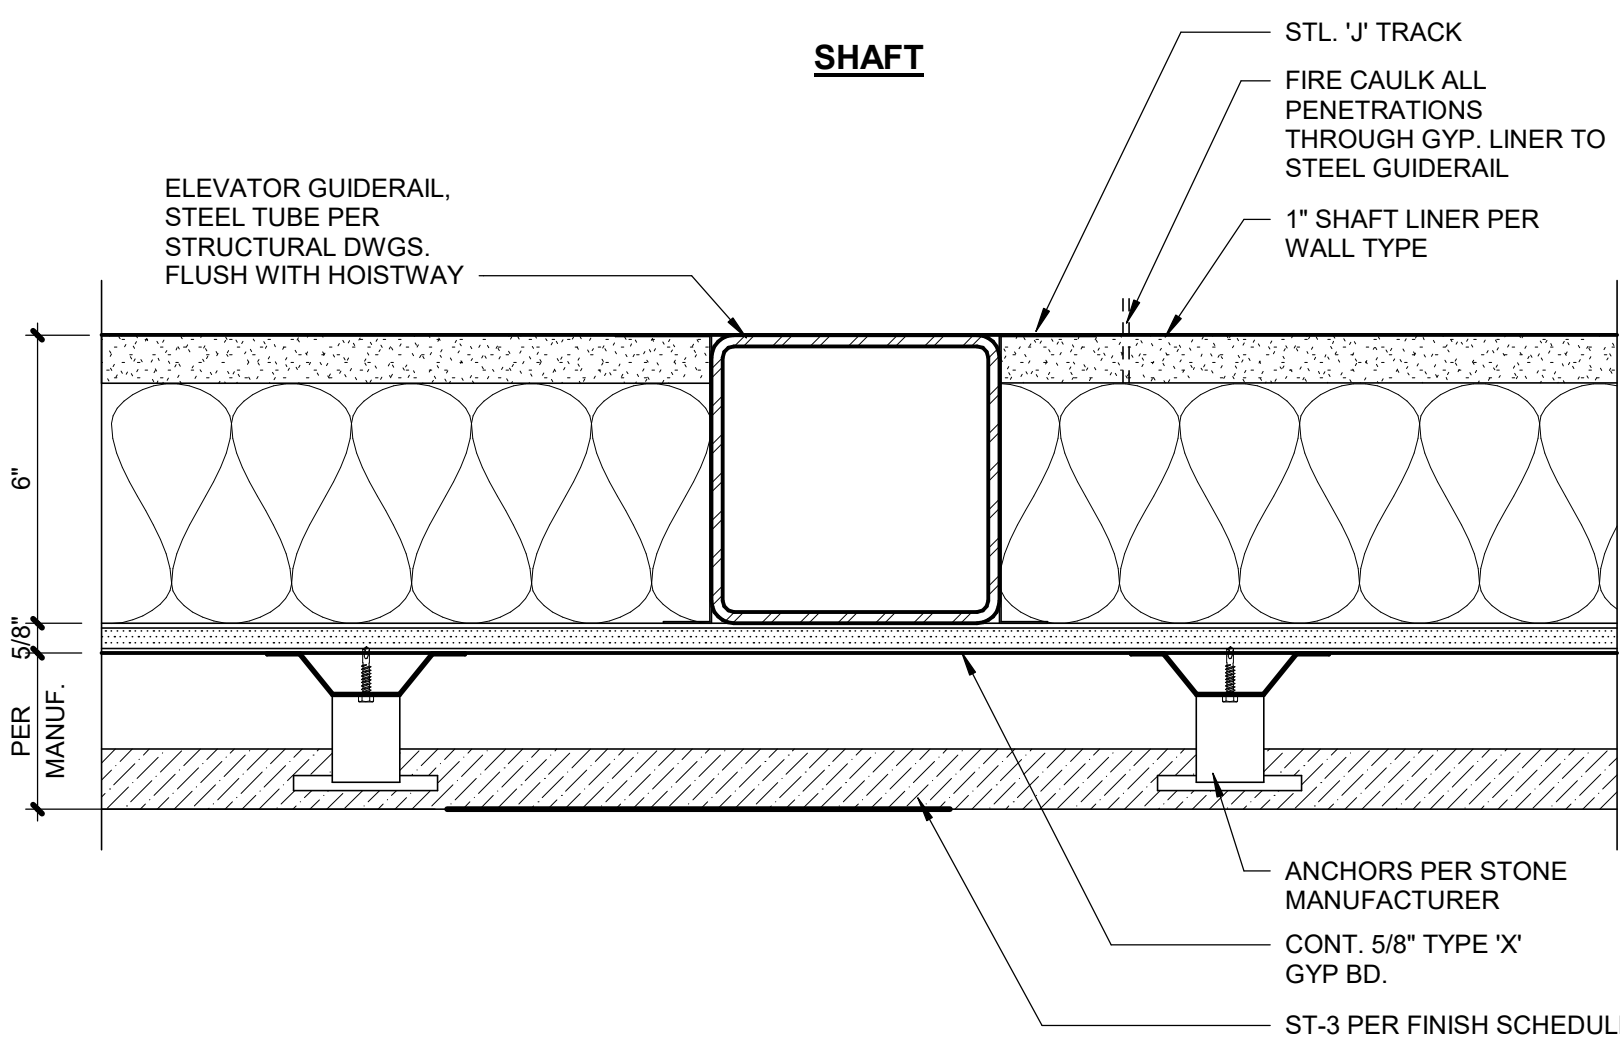
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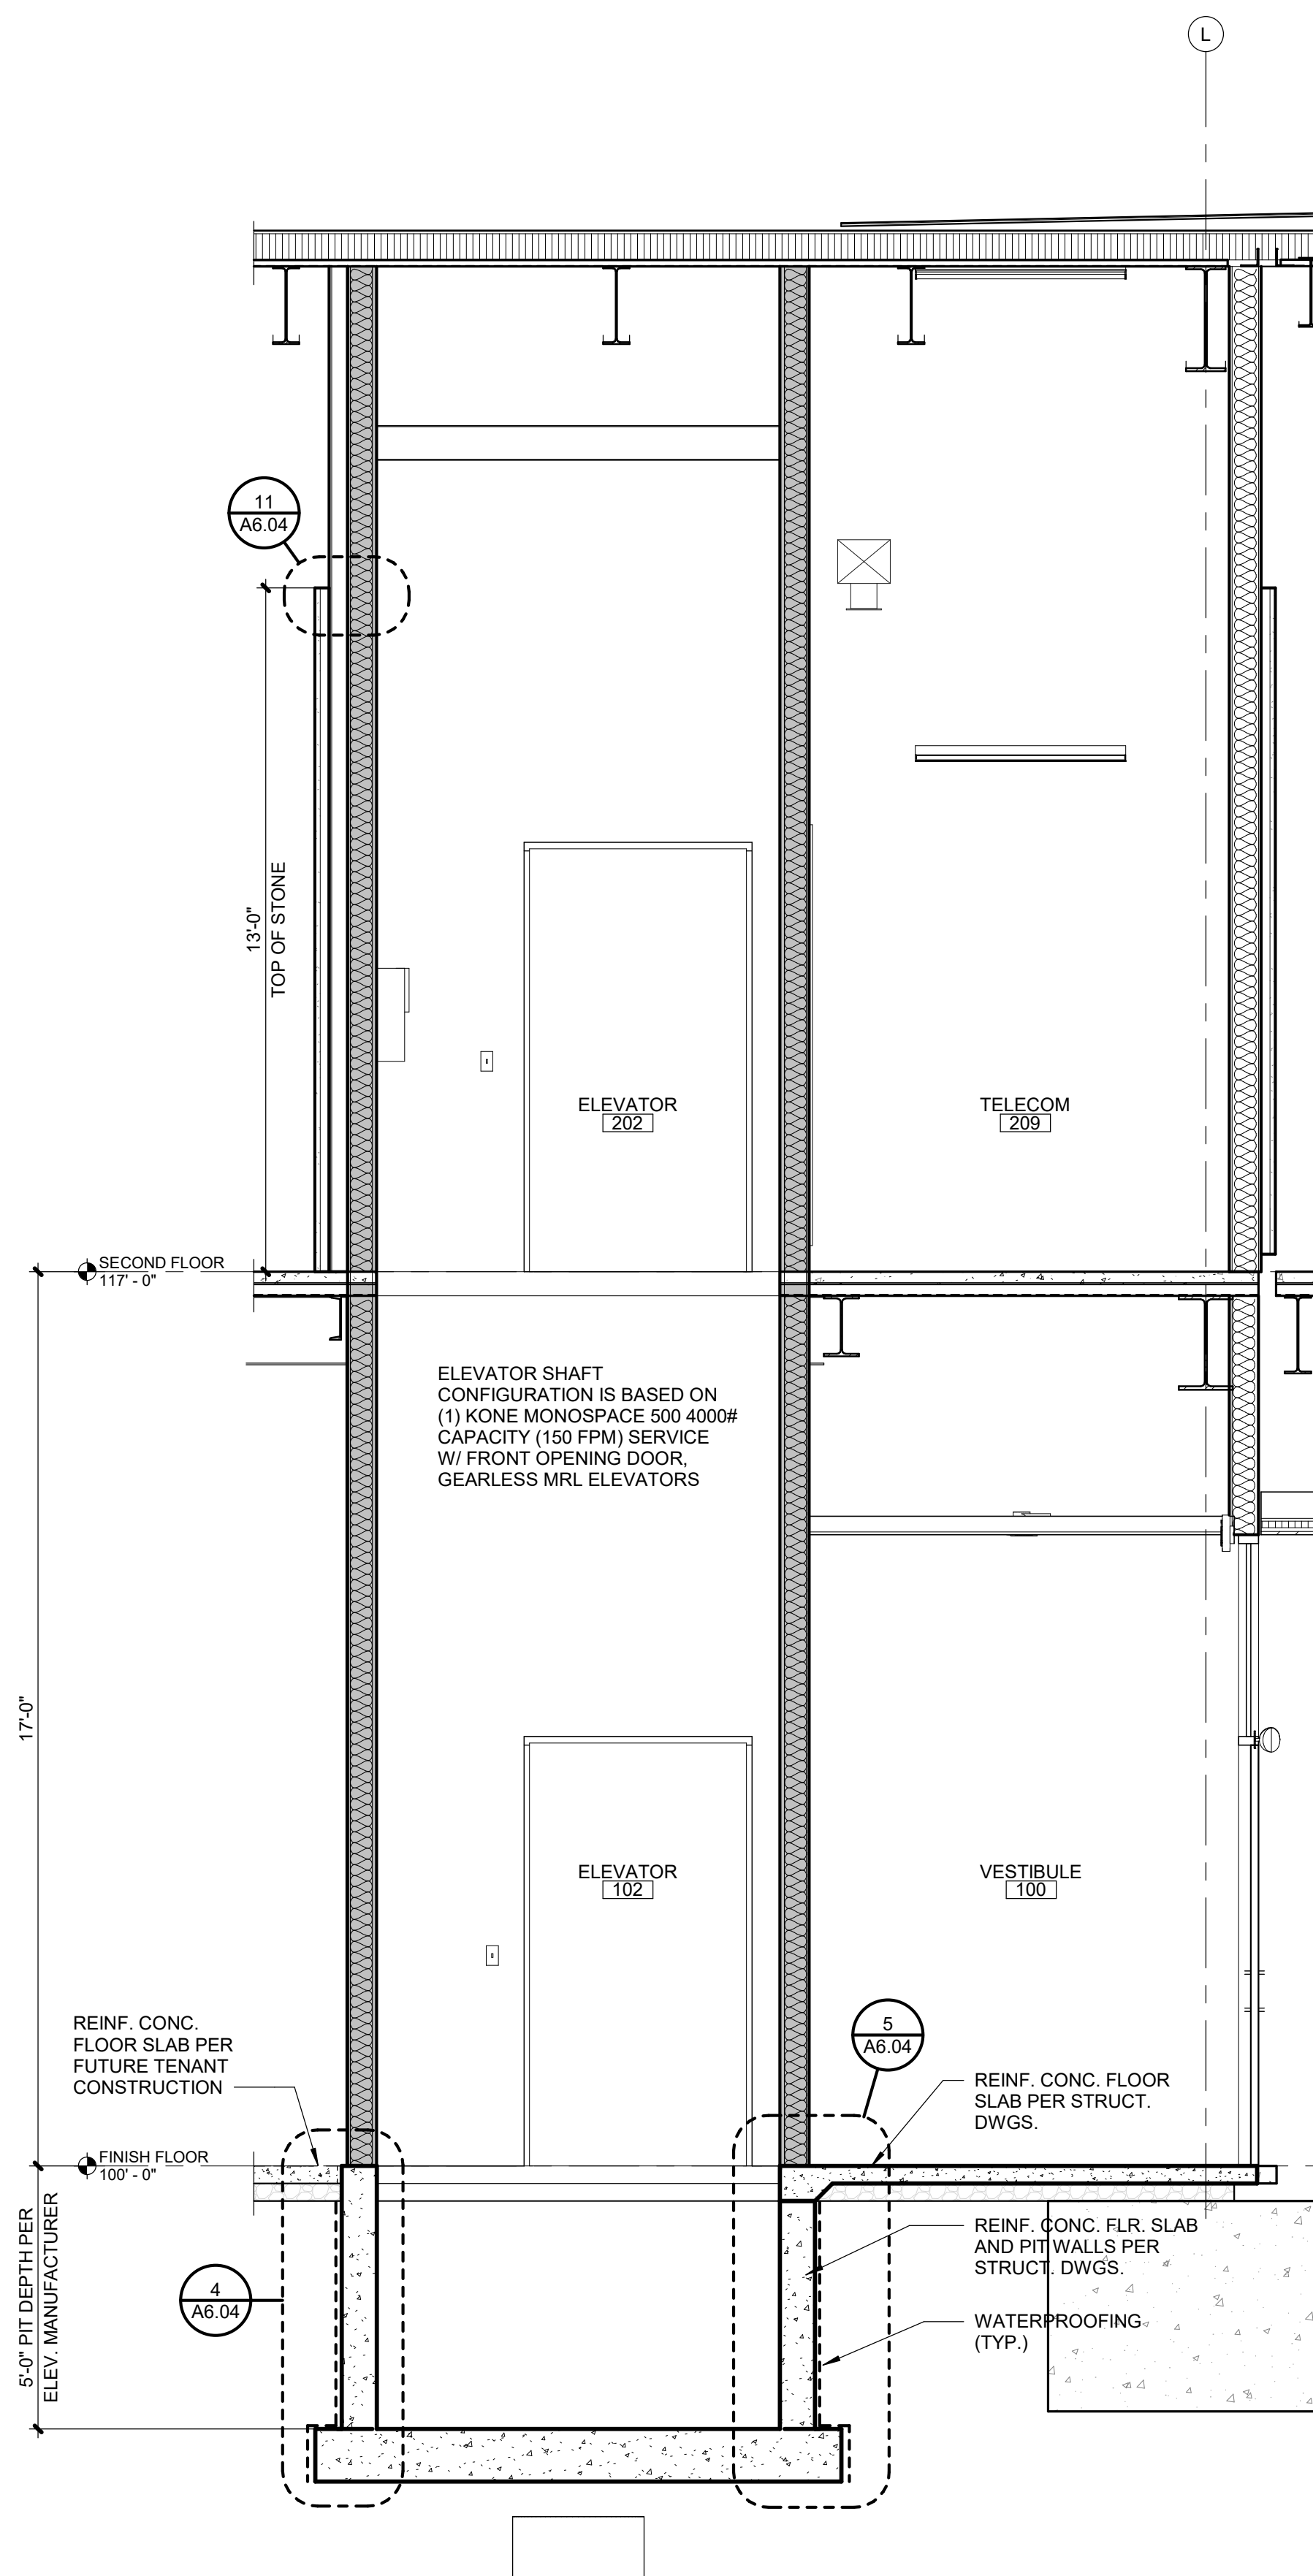
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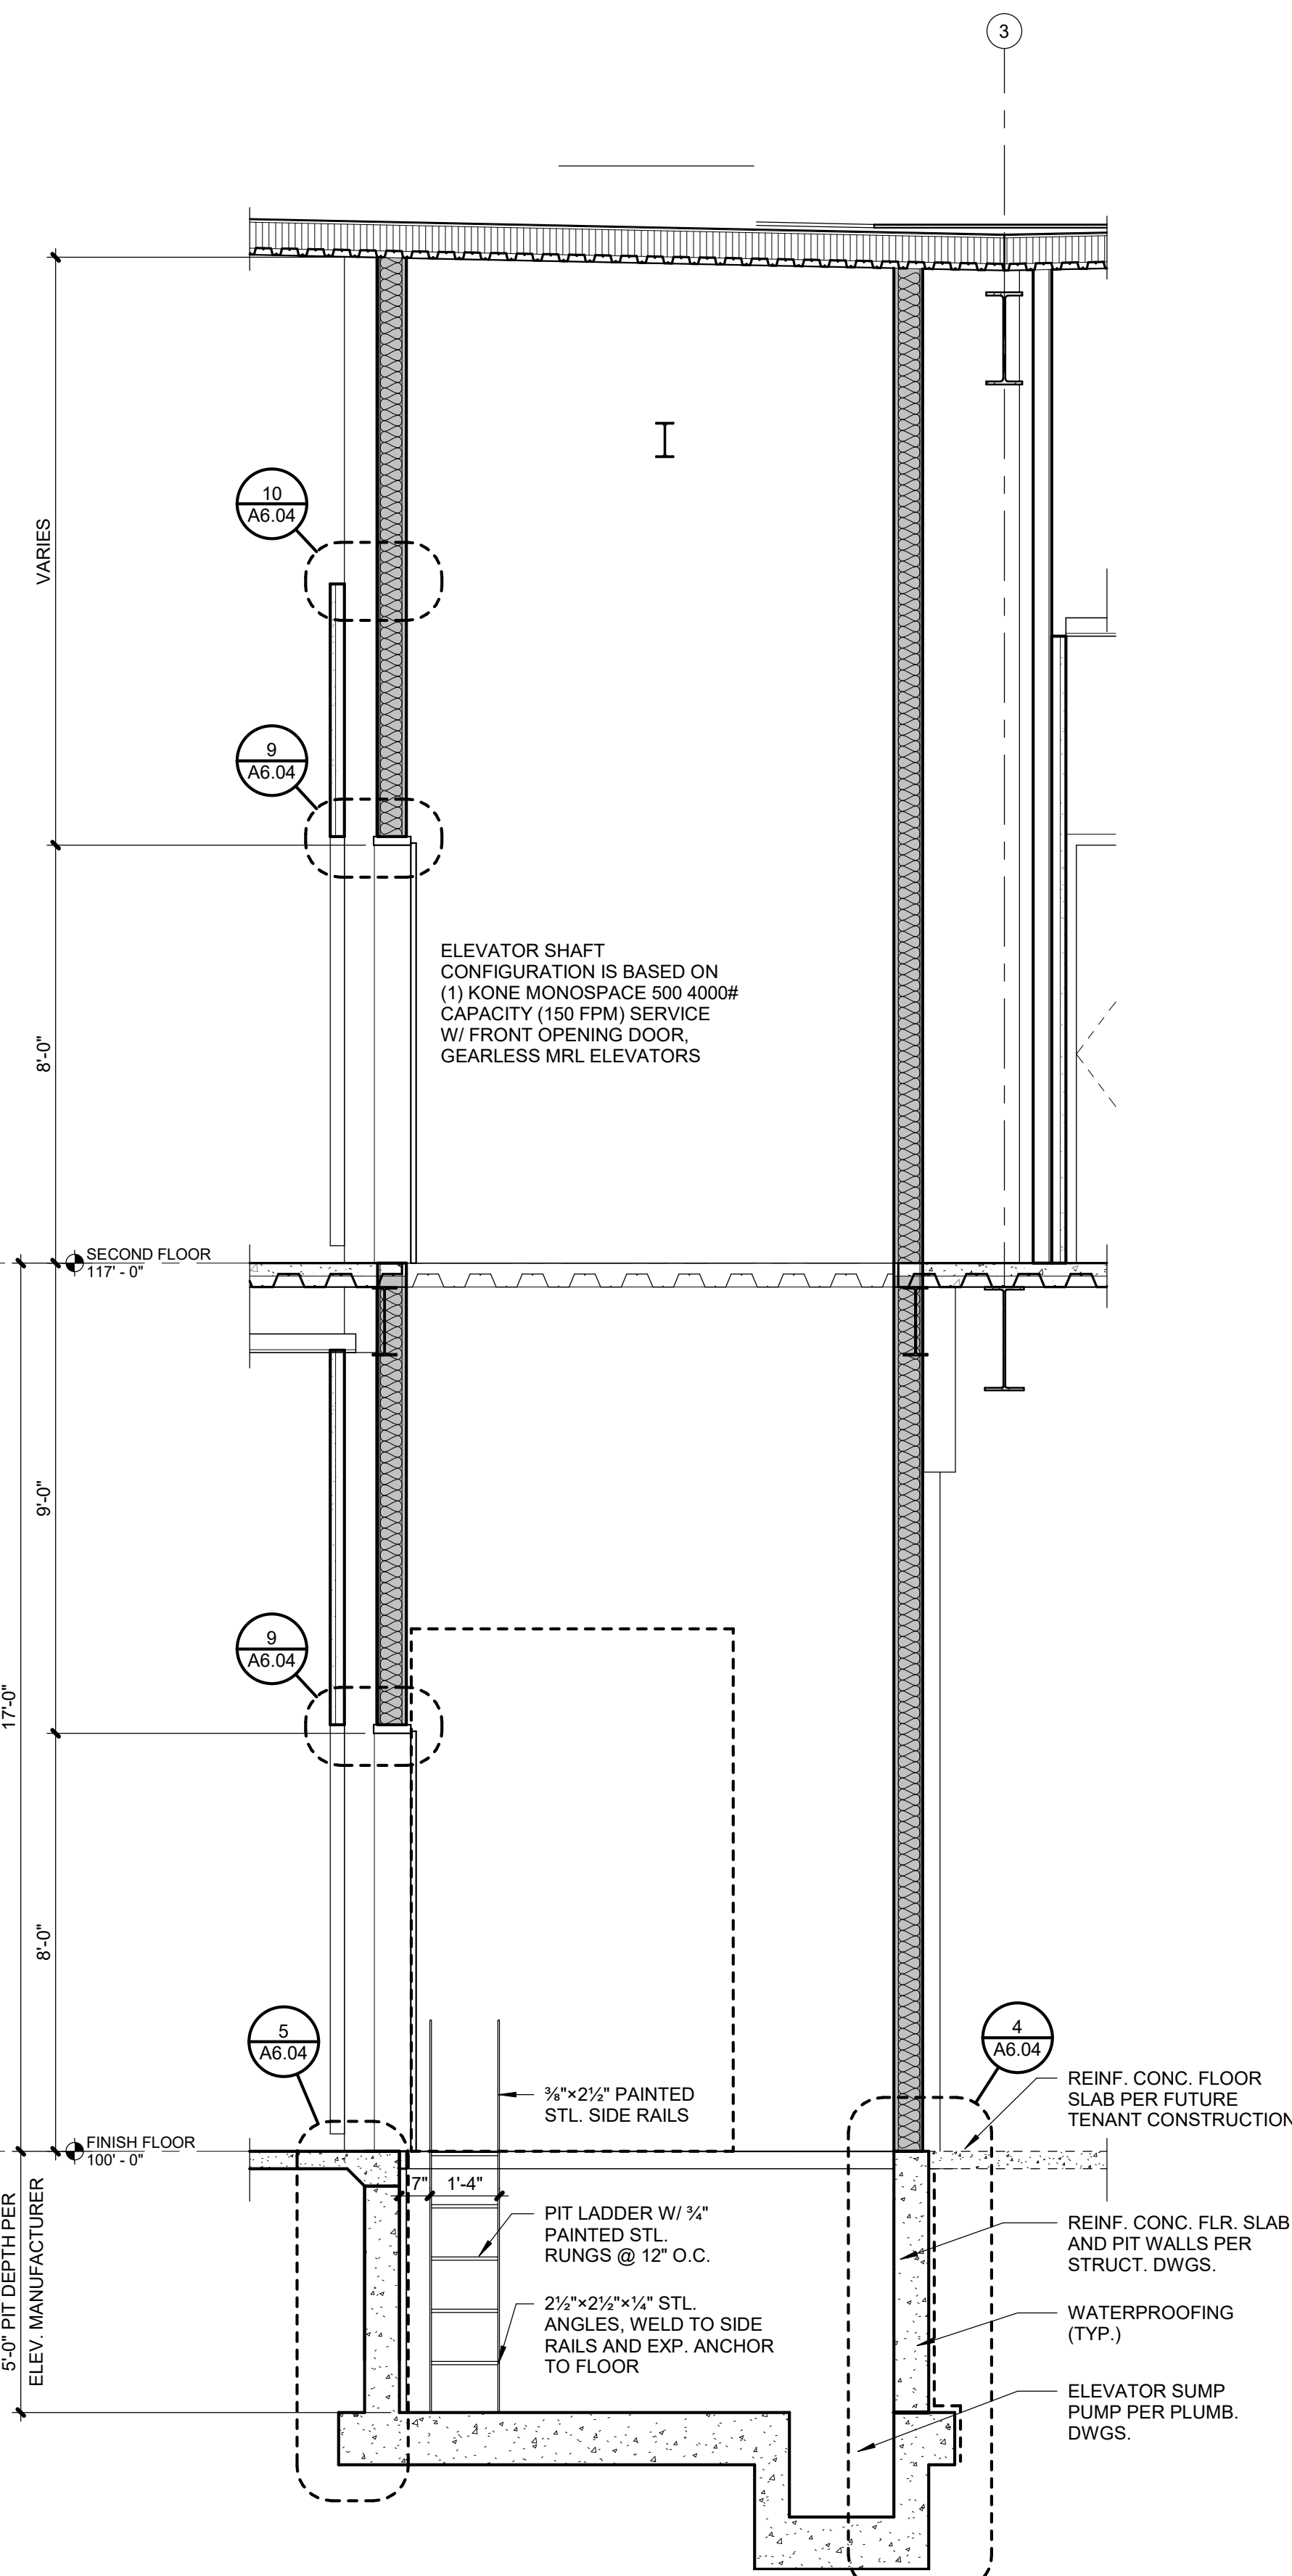
SCALE : 3" = 1'-0"

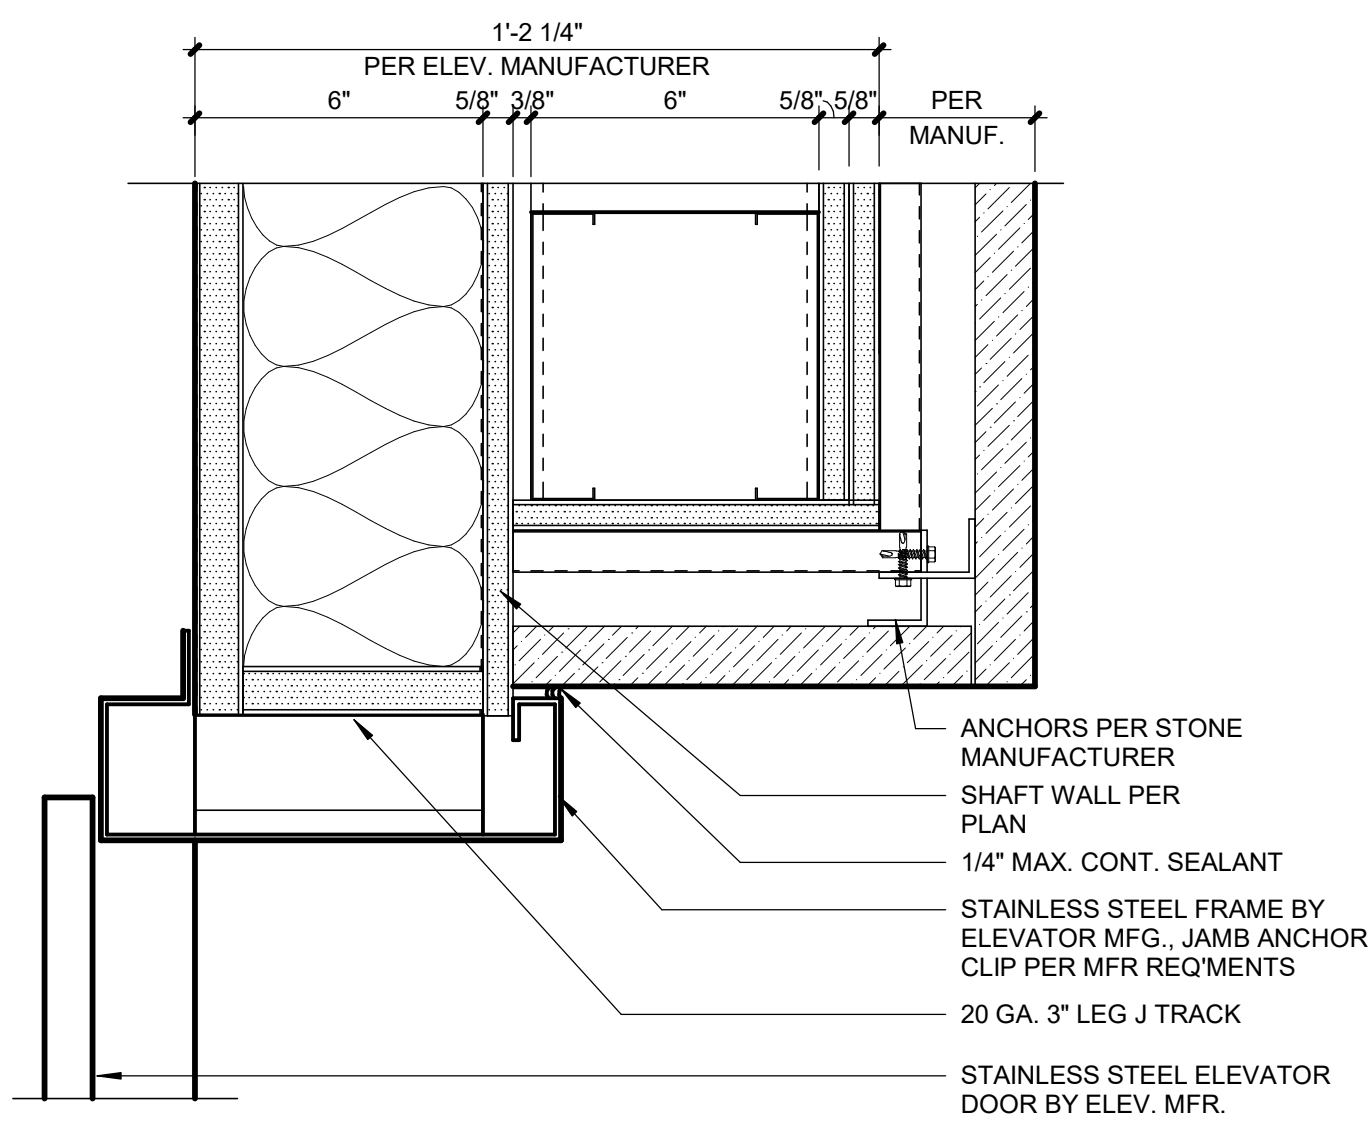

SCALE : 3" = 1'-0"




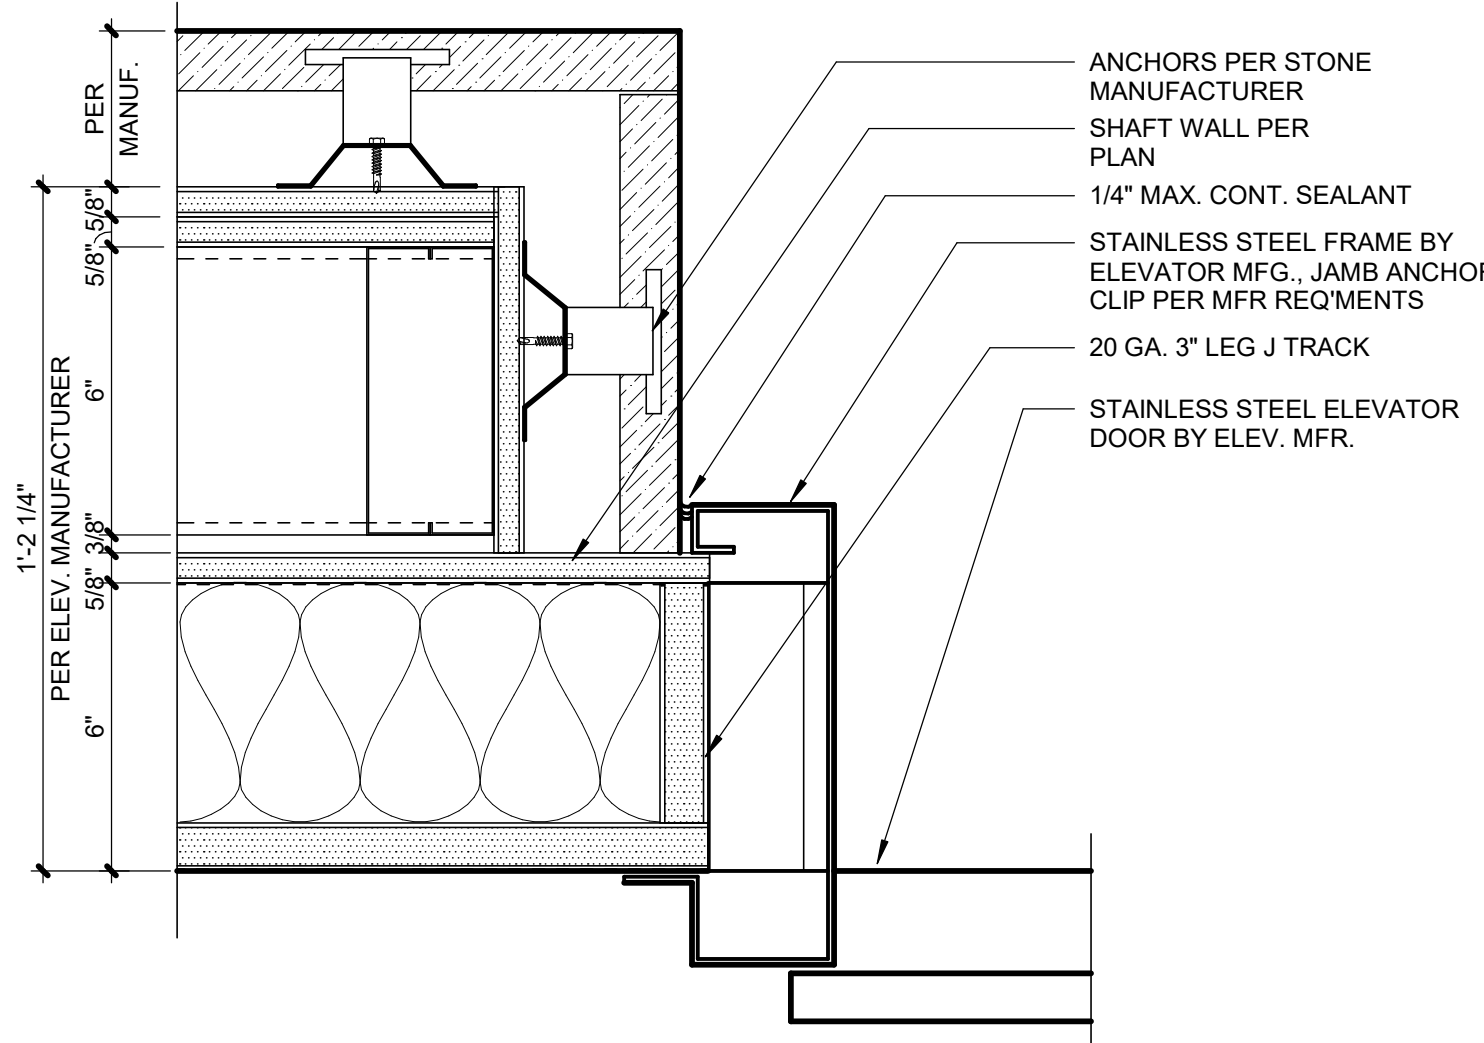


SCALE : 3/8" = 1'-0"




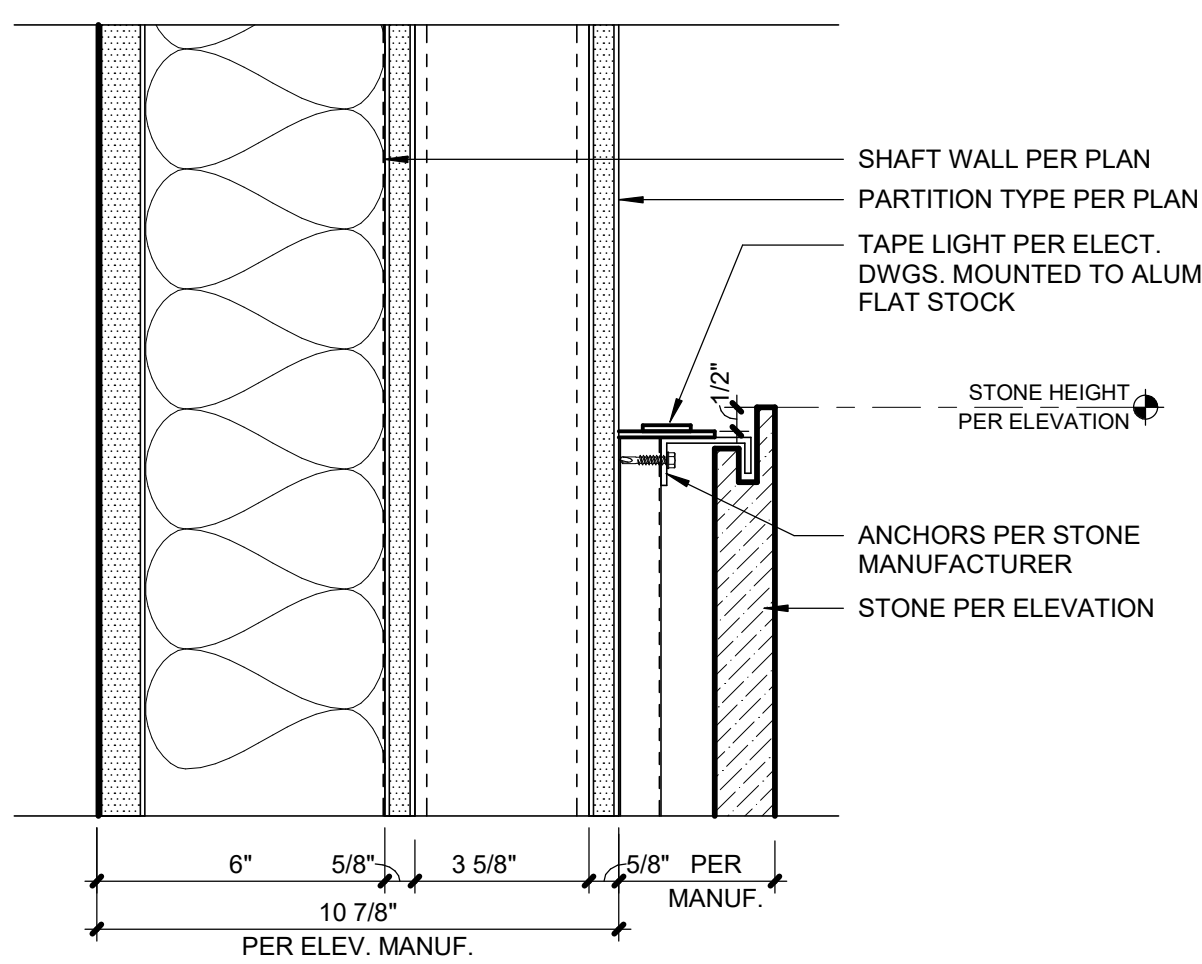


SCALE : 3/8" = 1'-







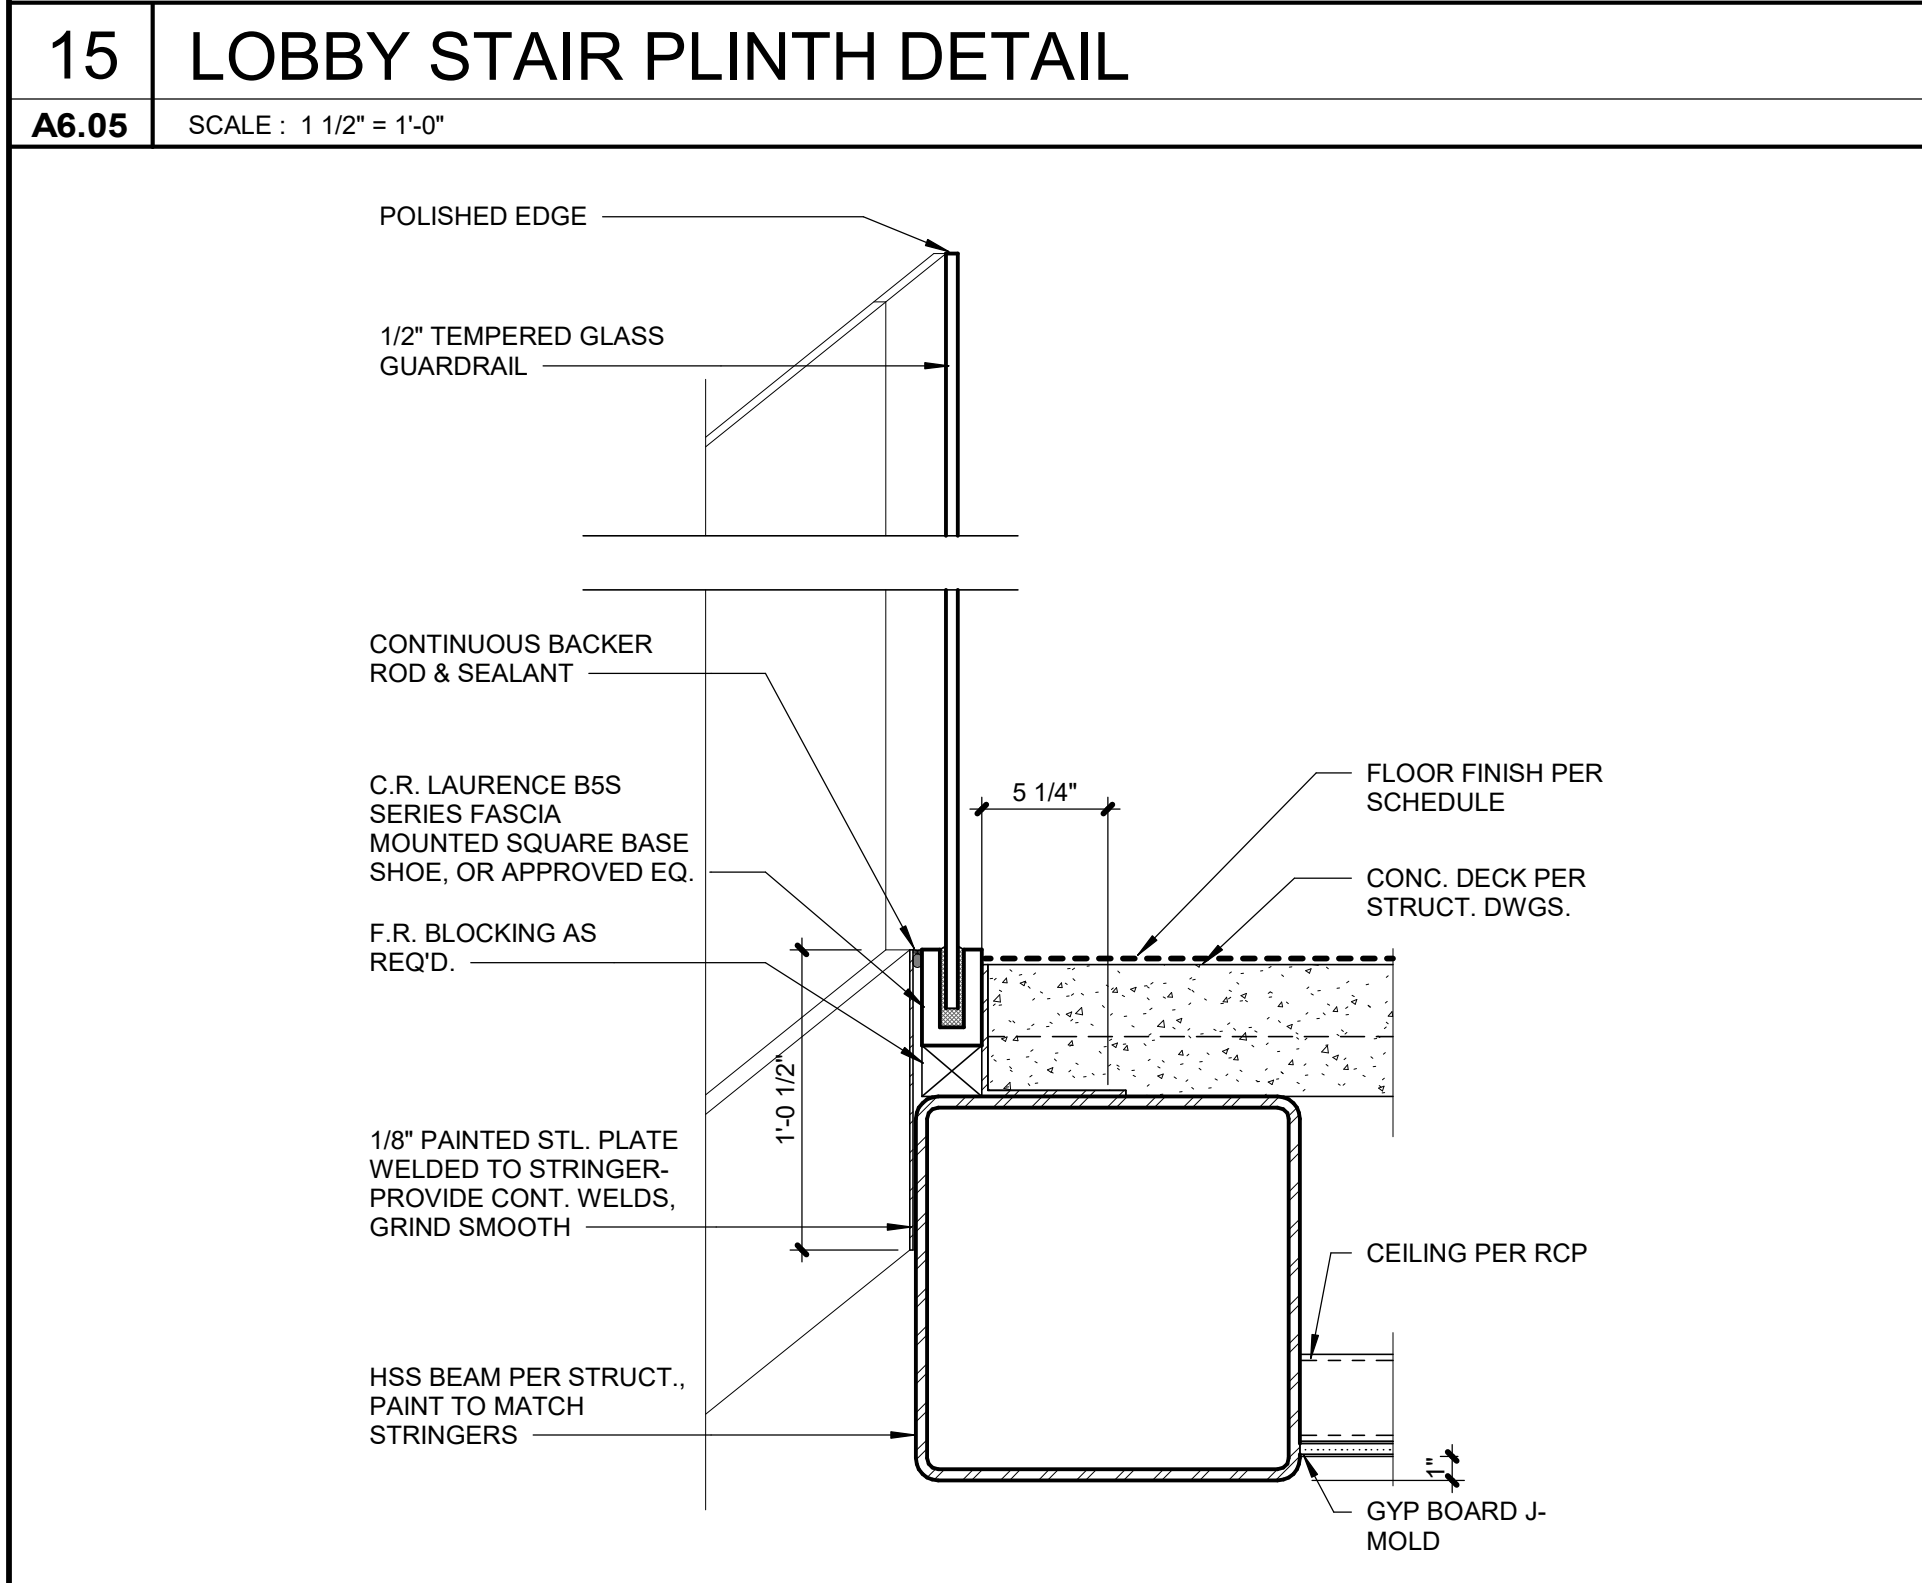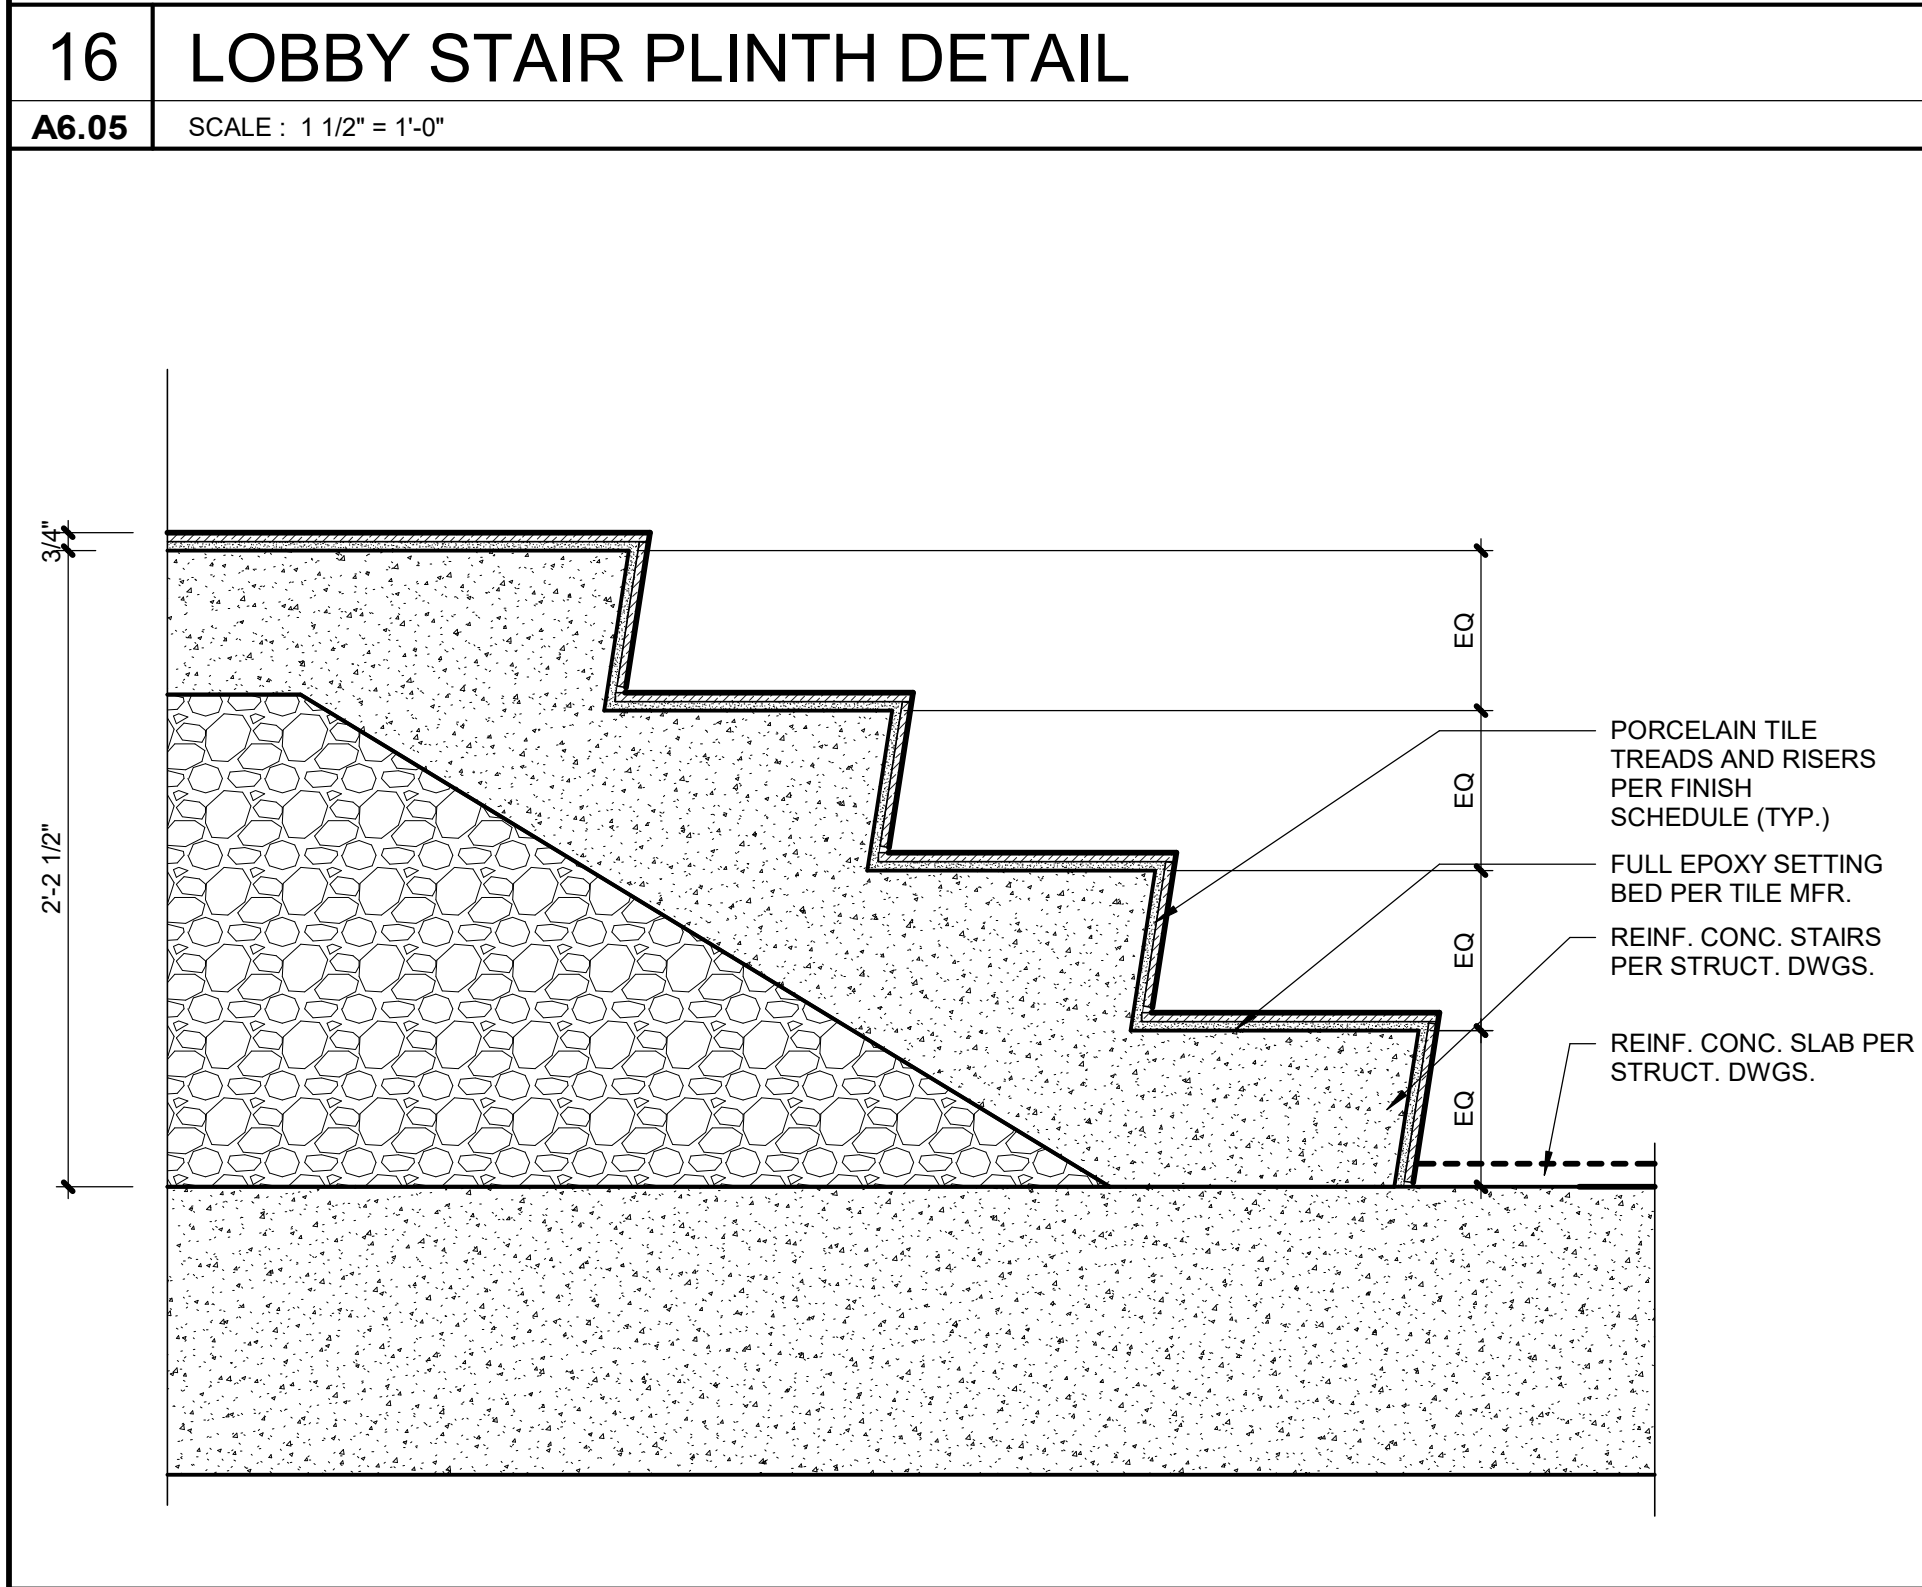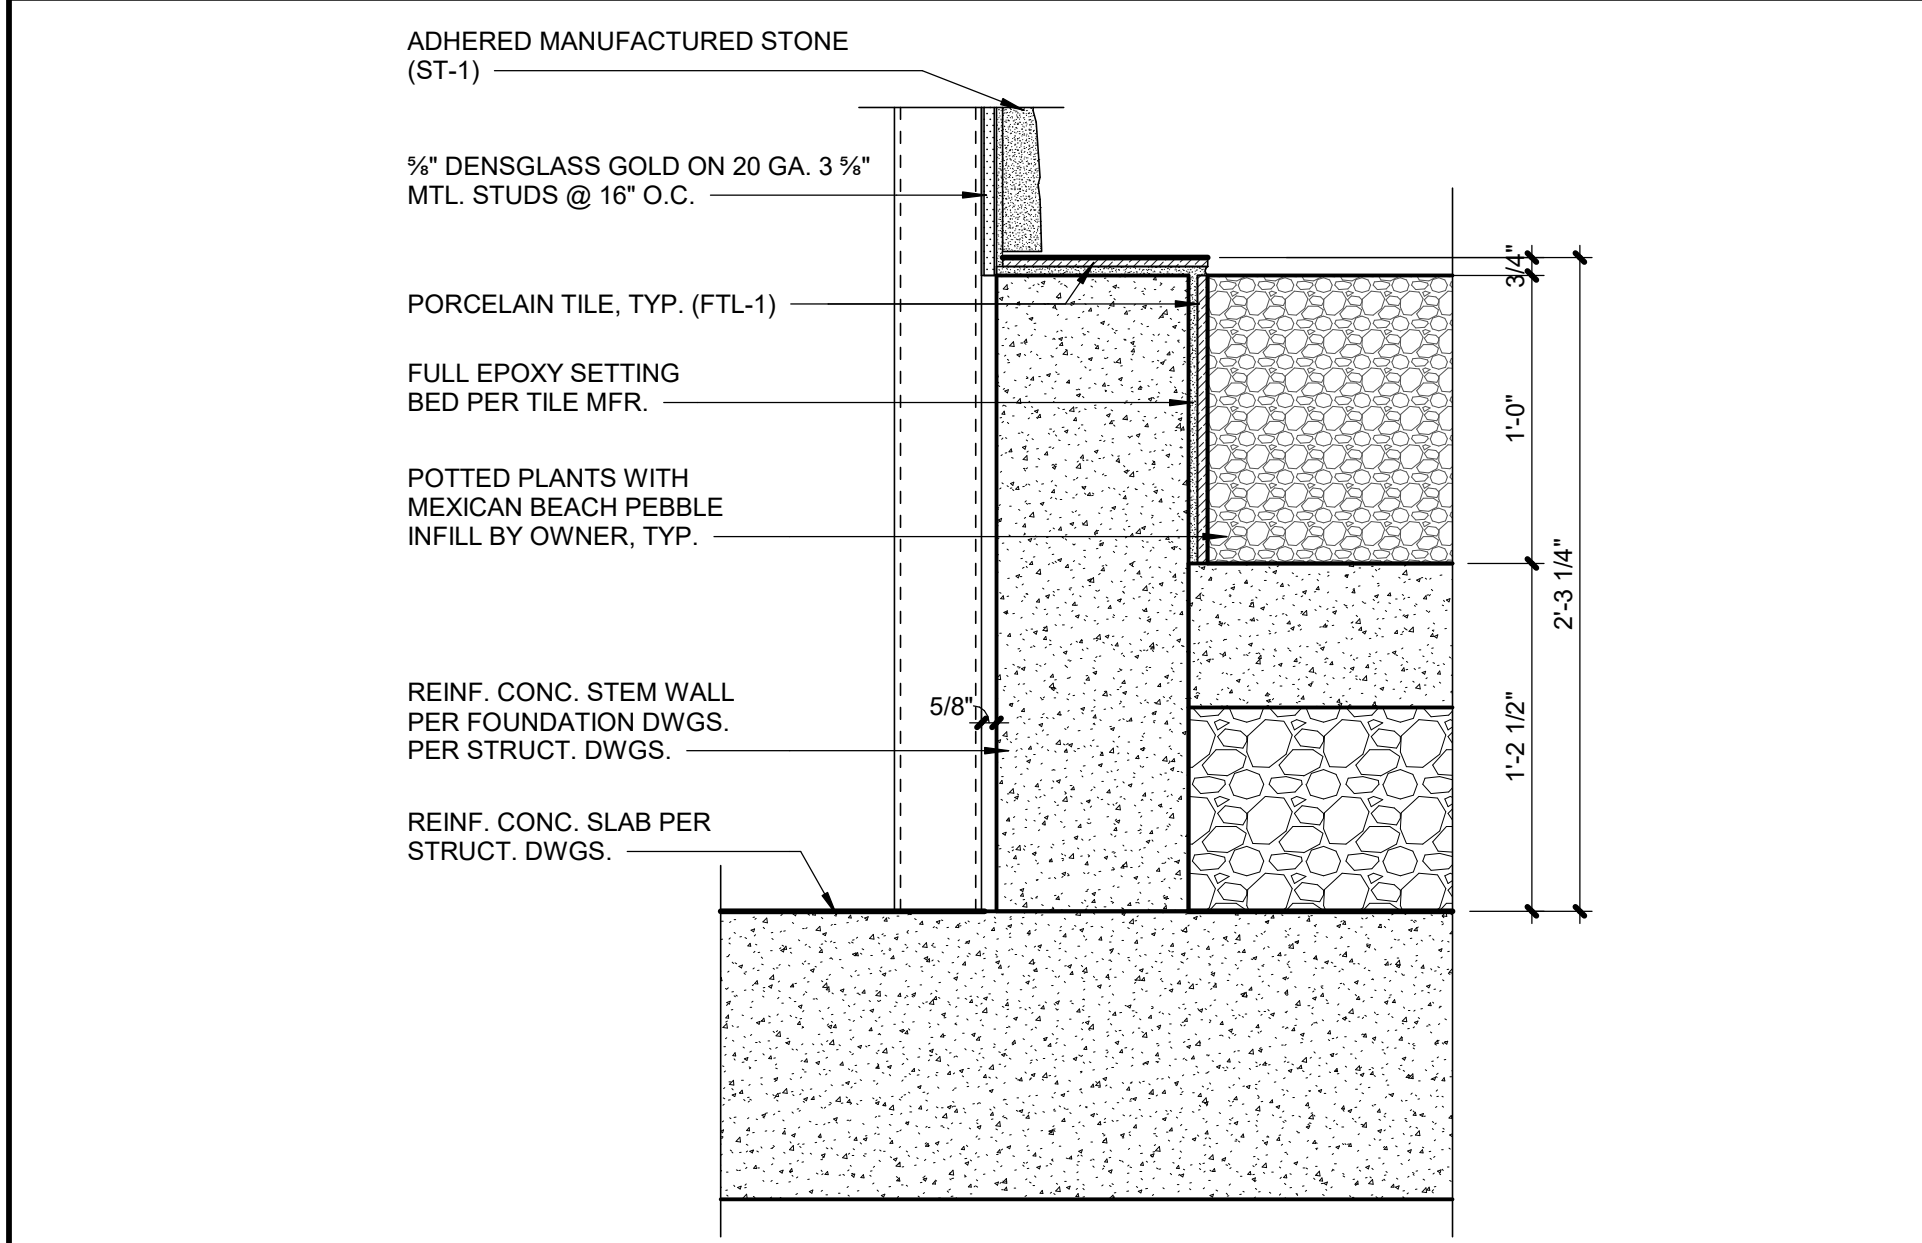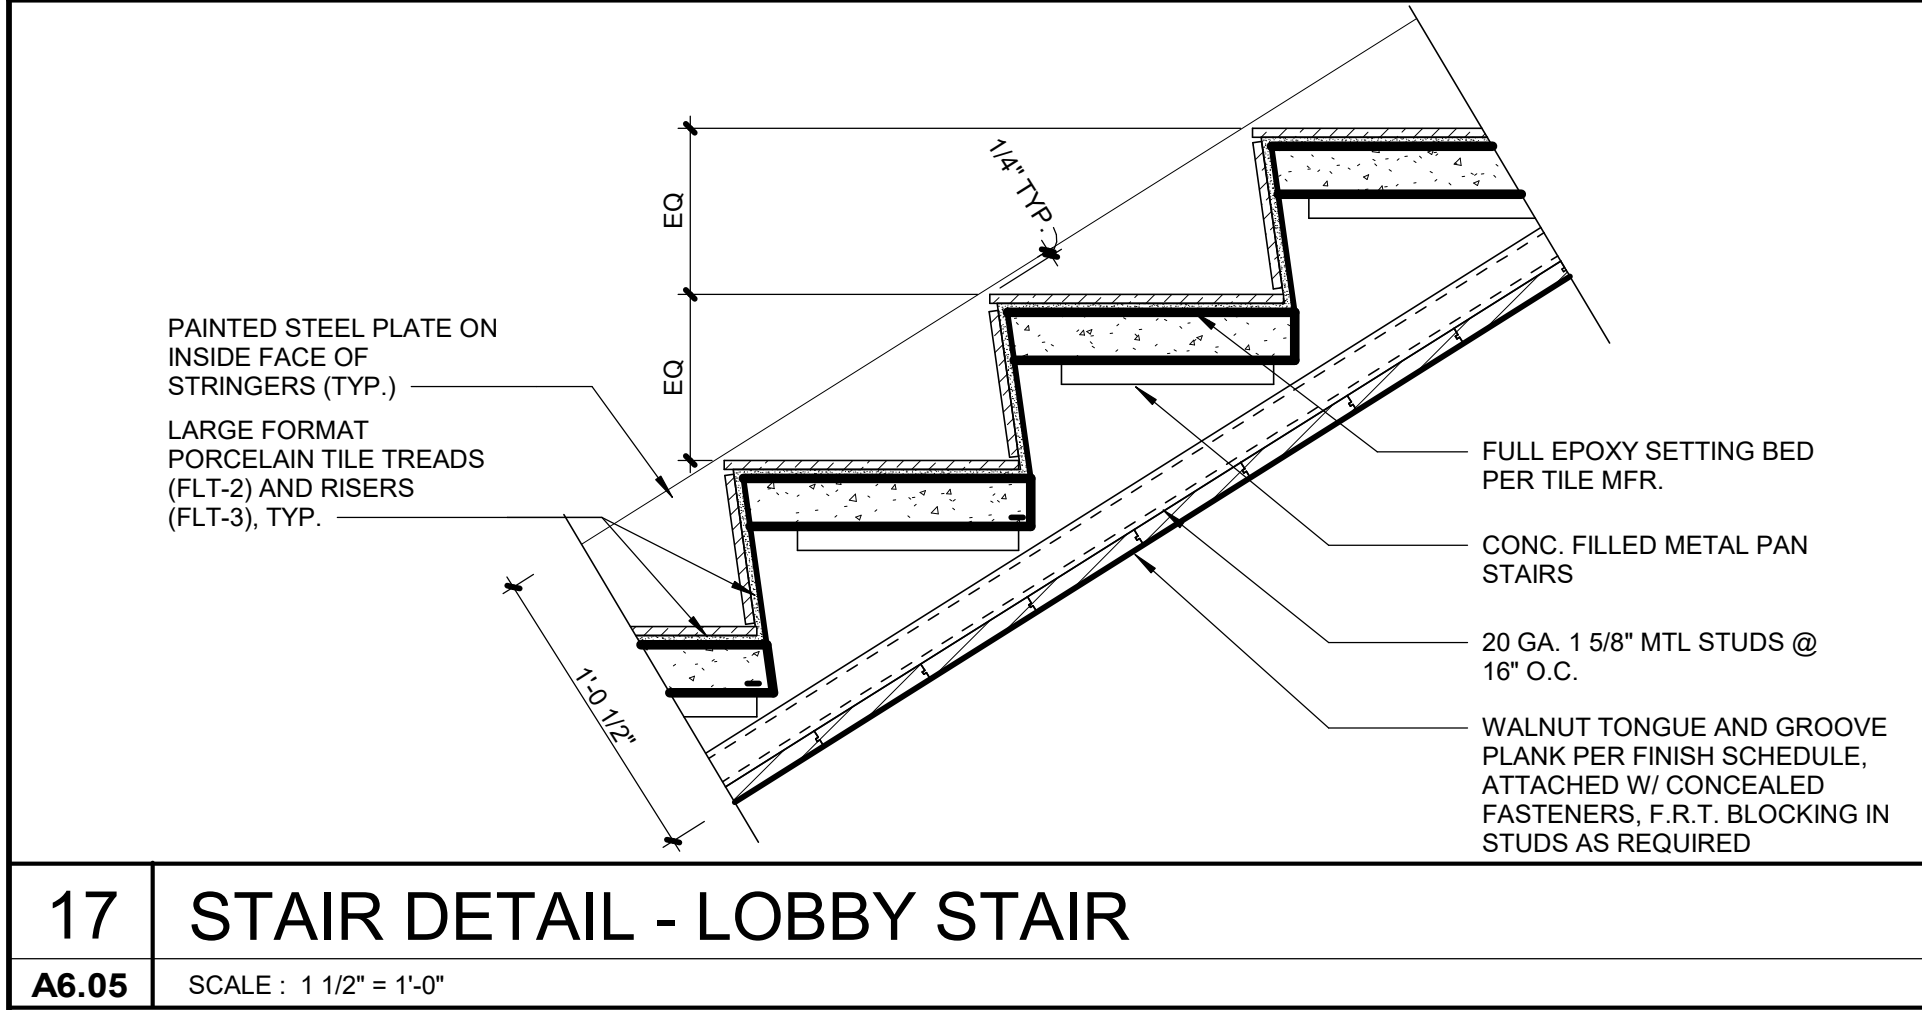





14 GUARDRAIL DETAIL - LOBBY STAIR  
A6.05 SCALE : 1 1/2" = 1'-0"

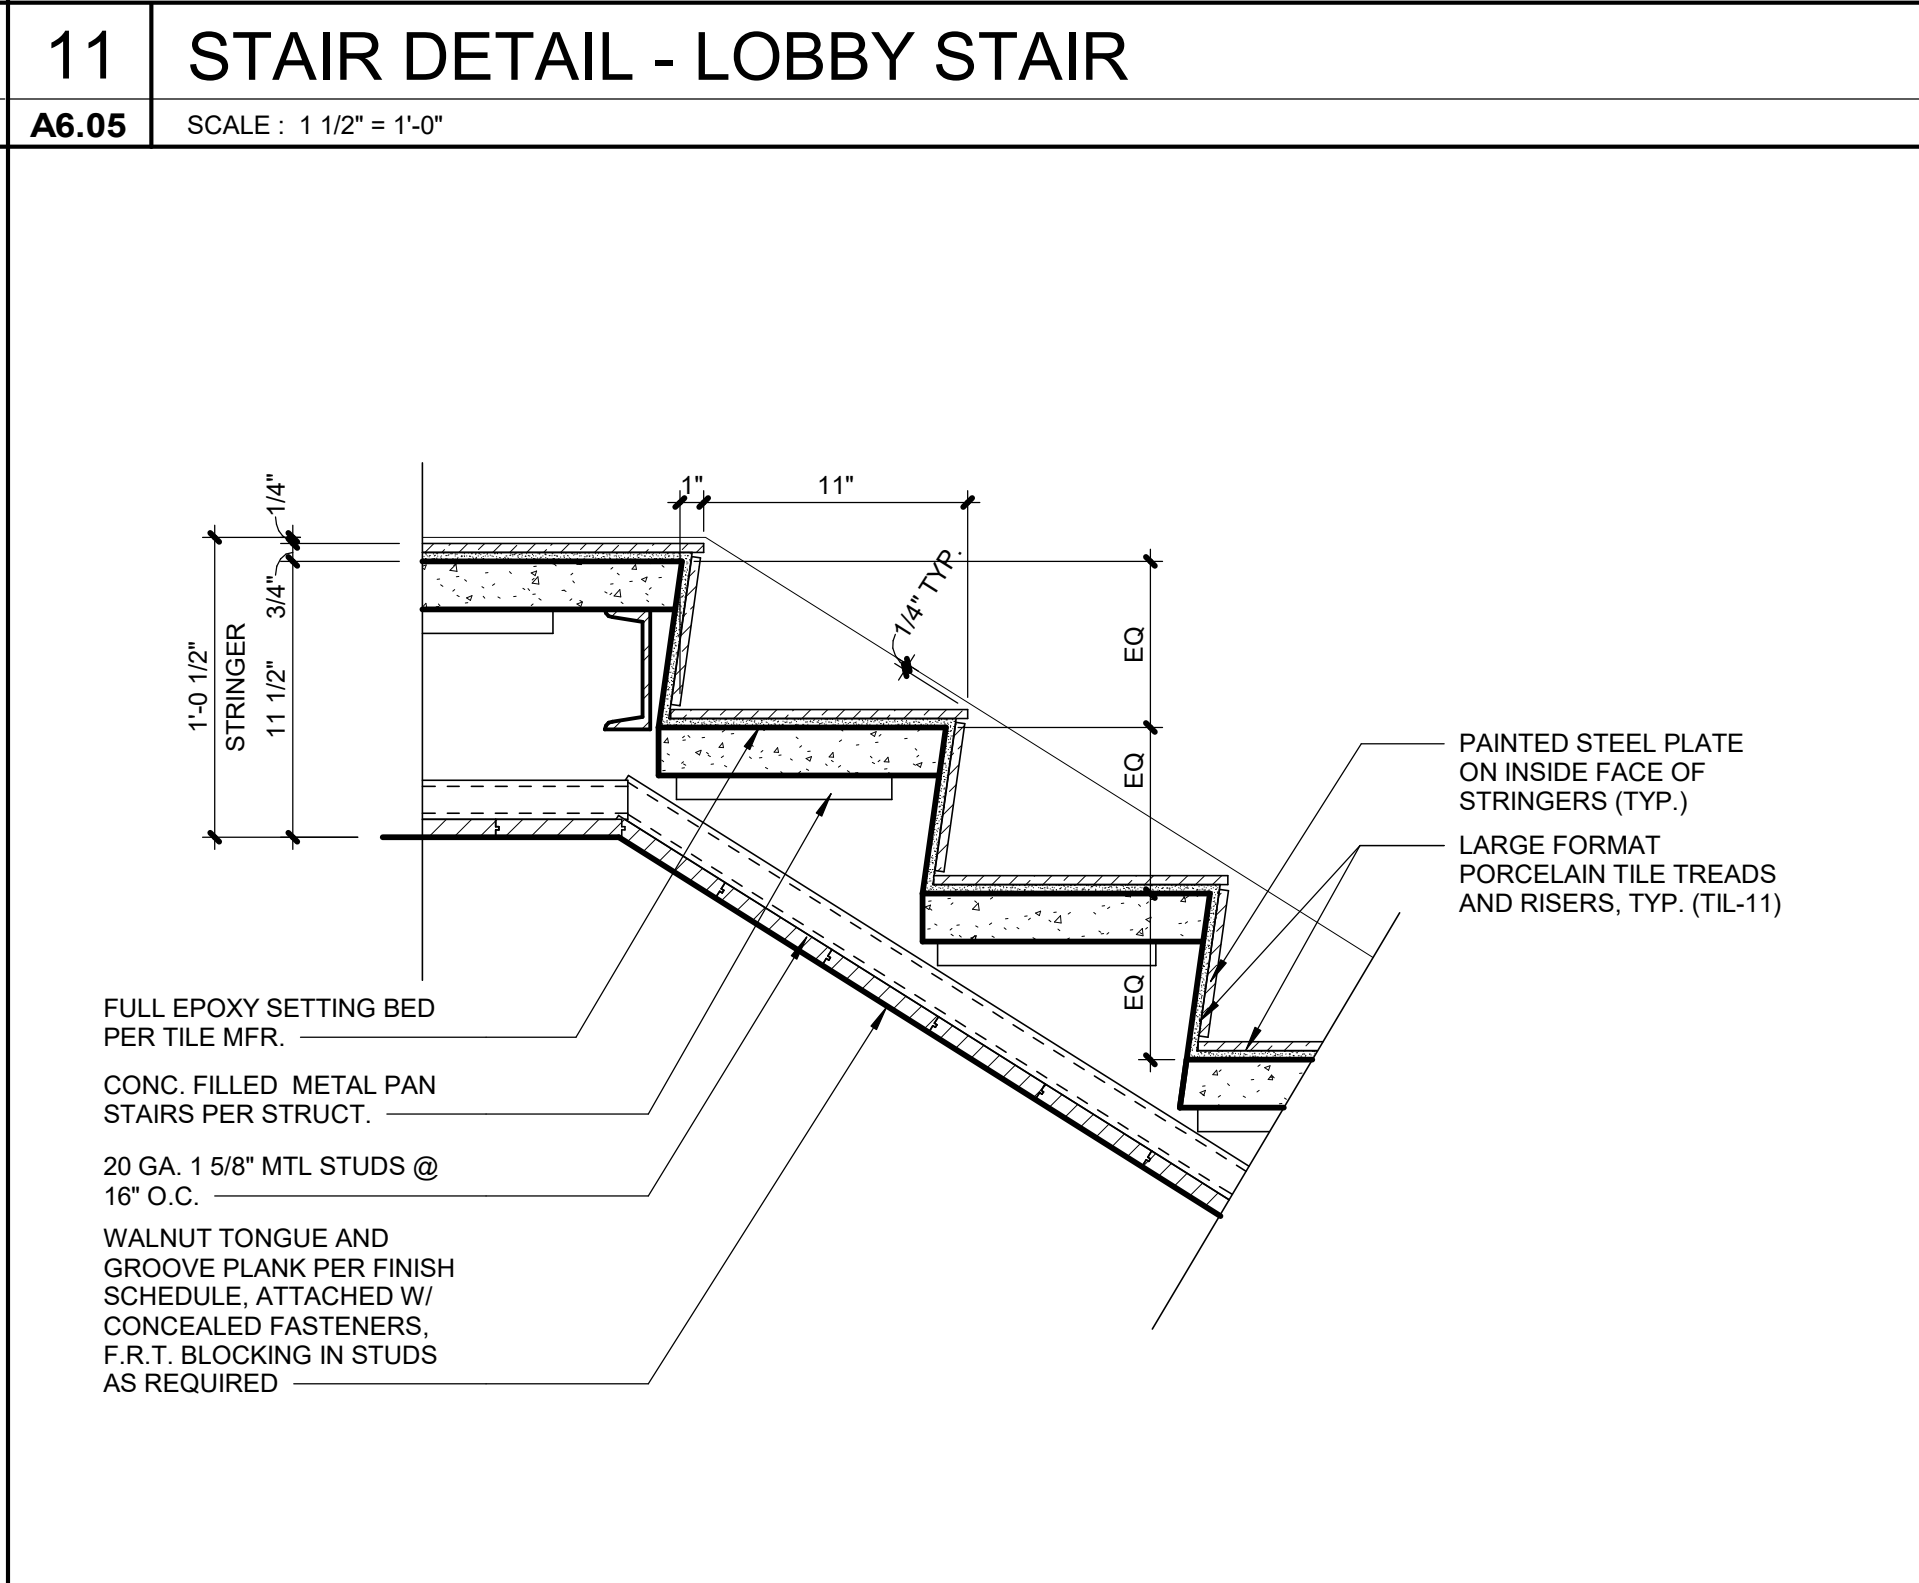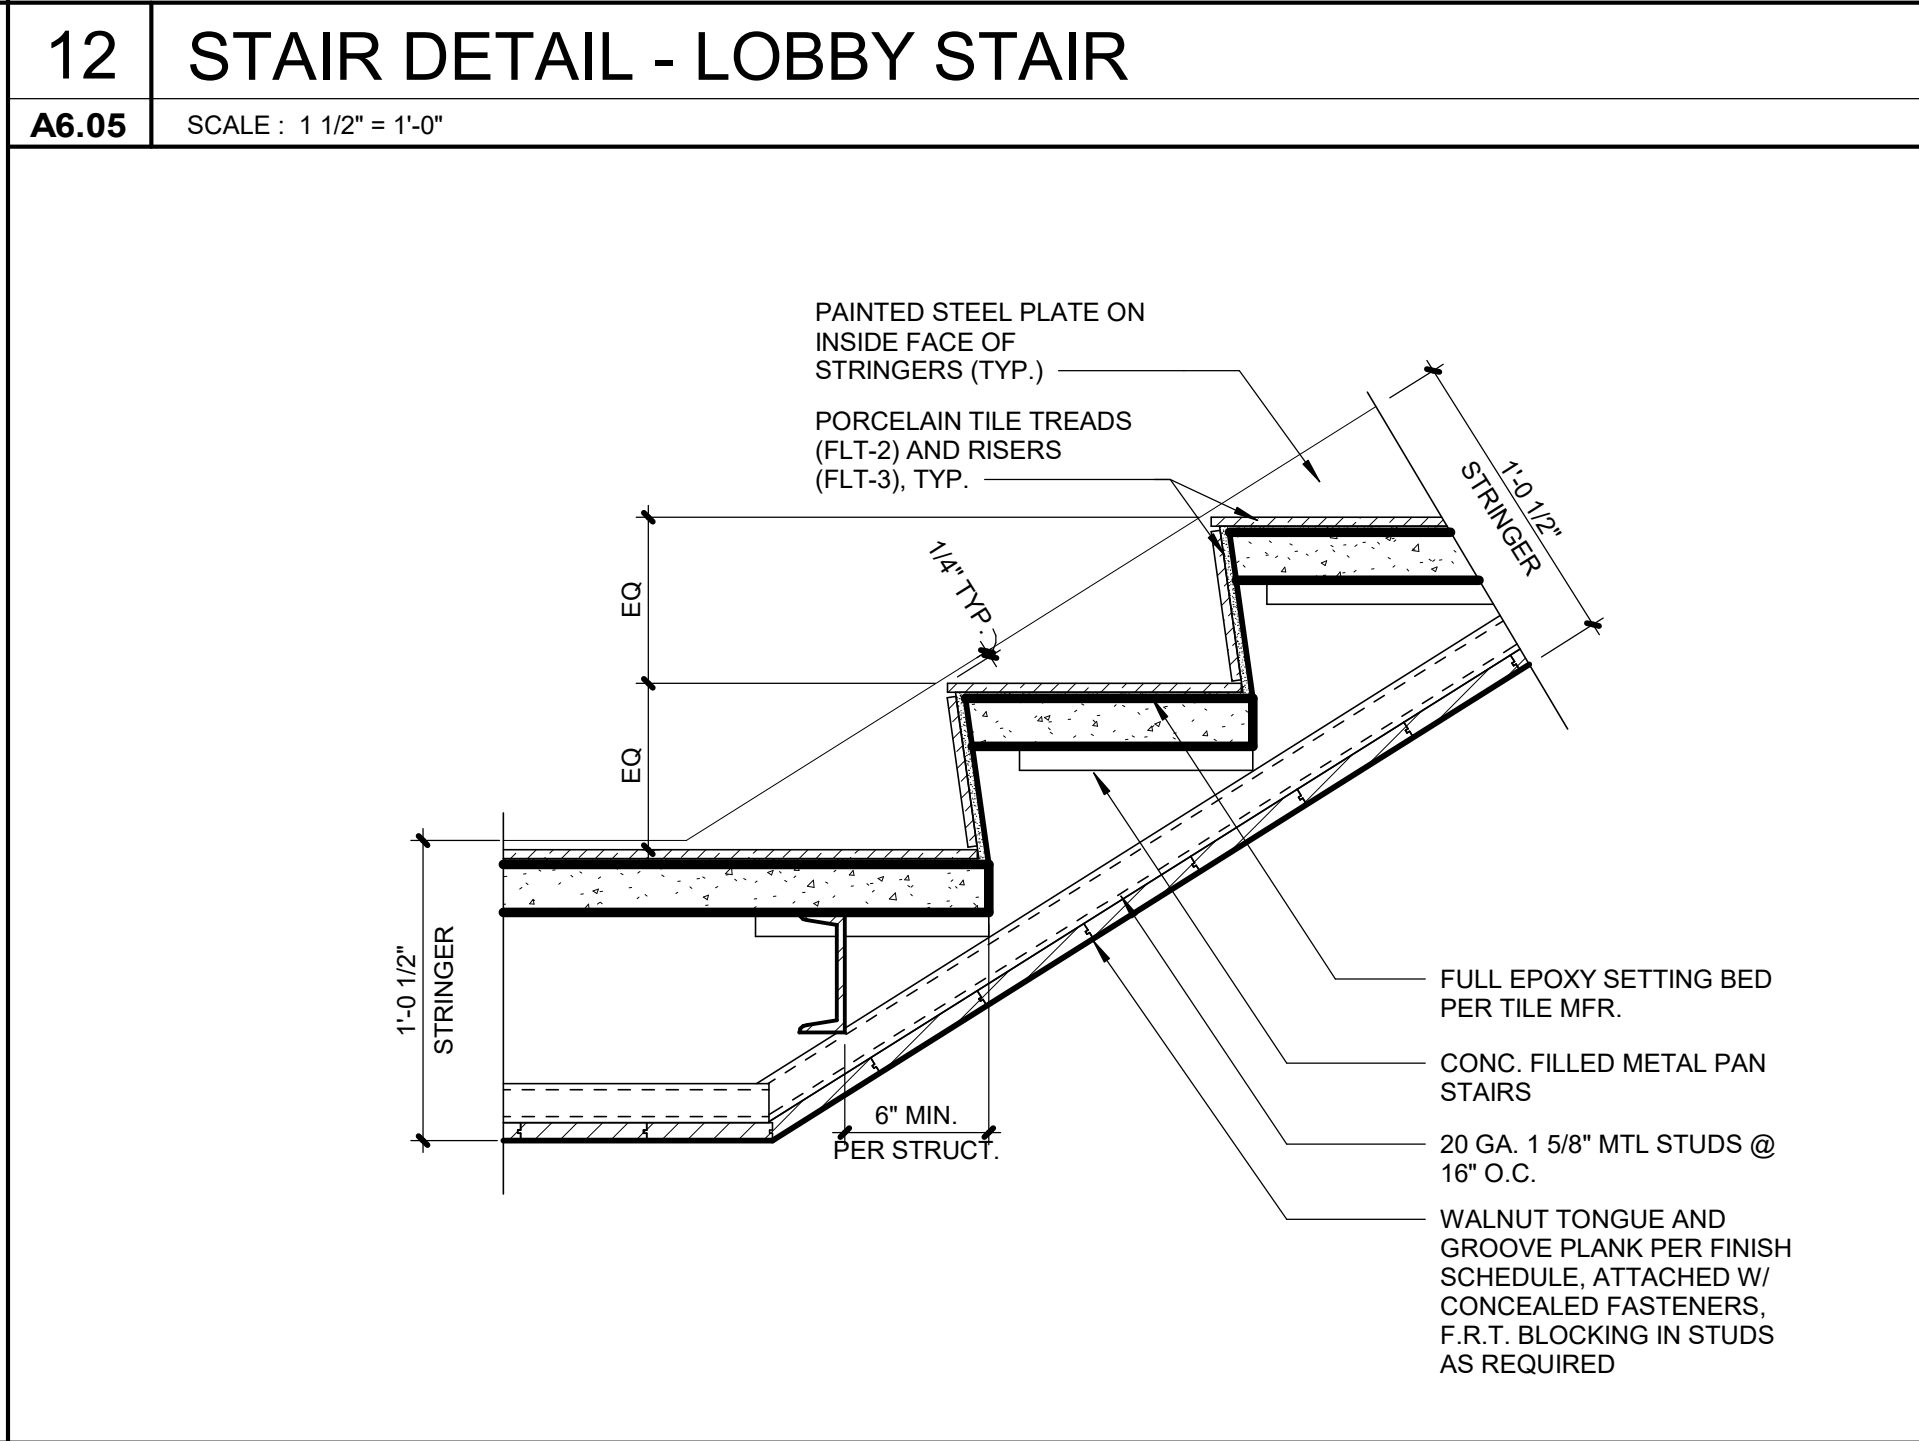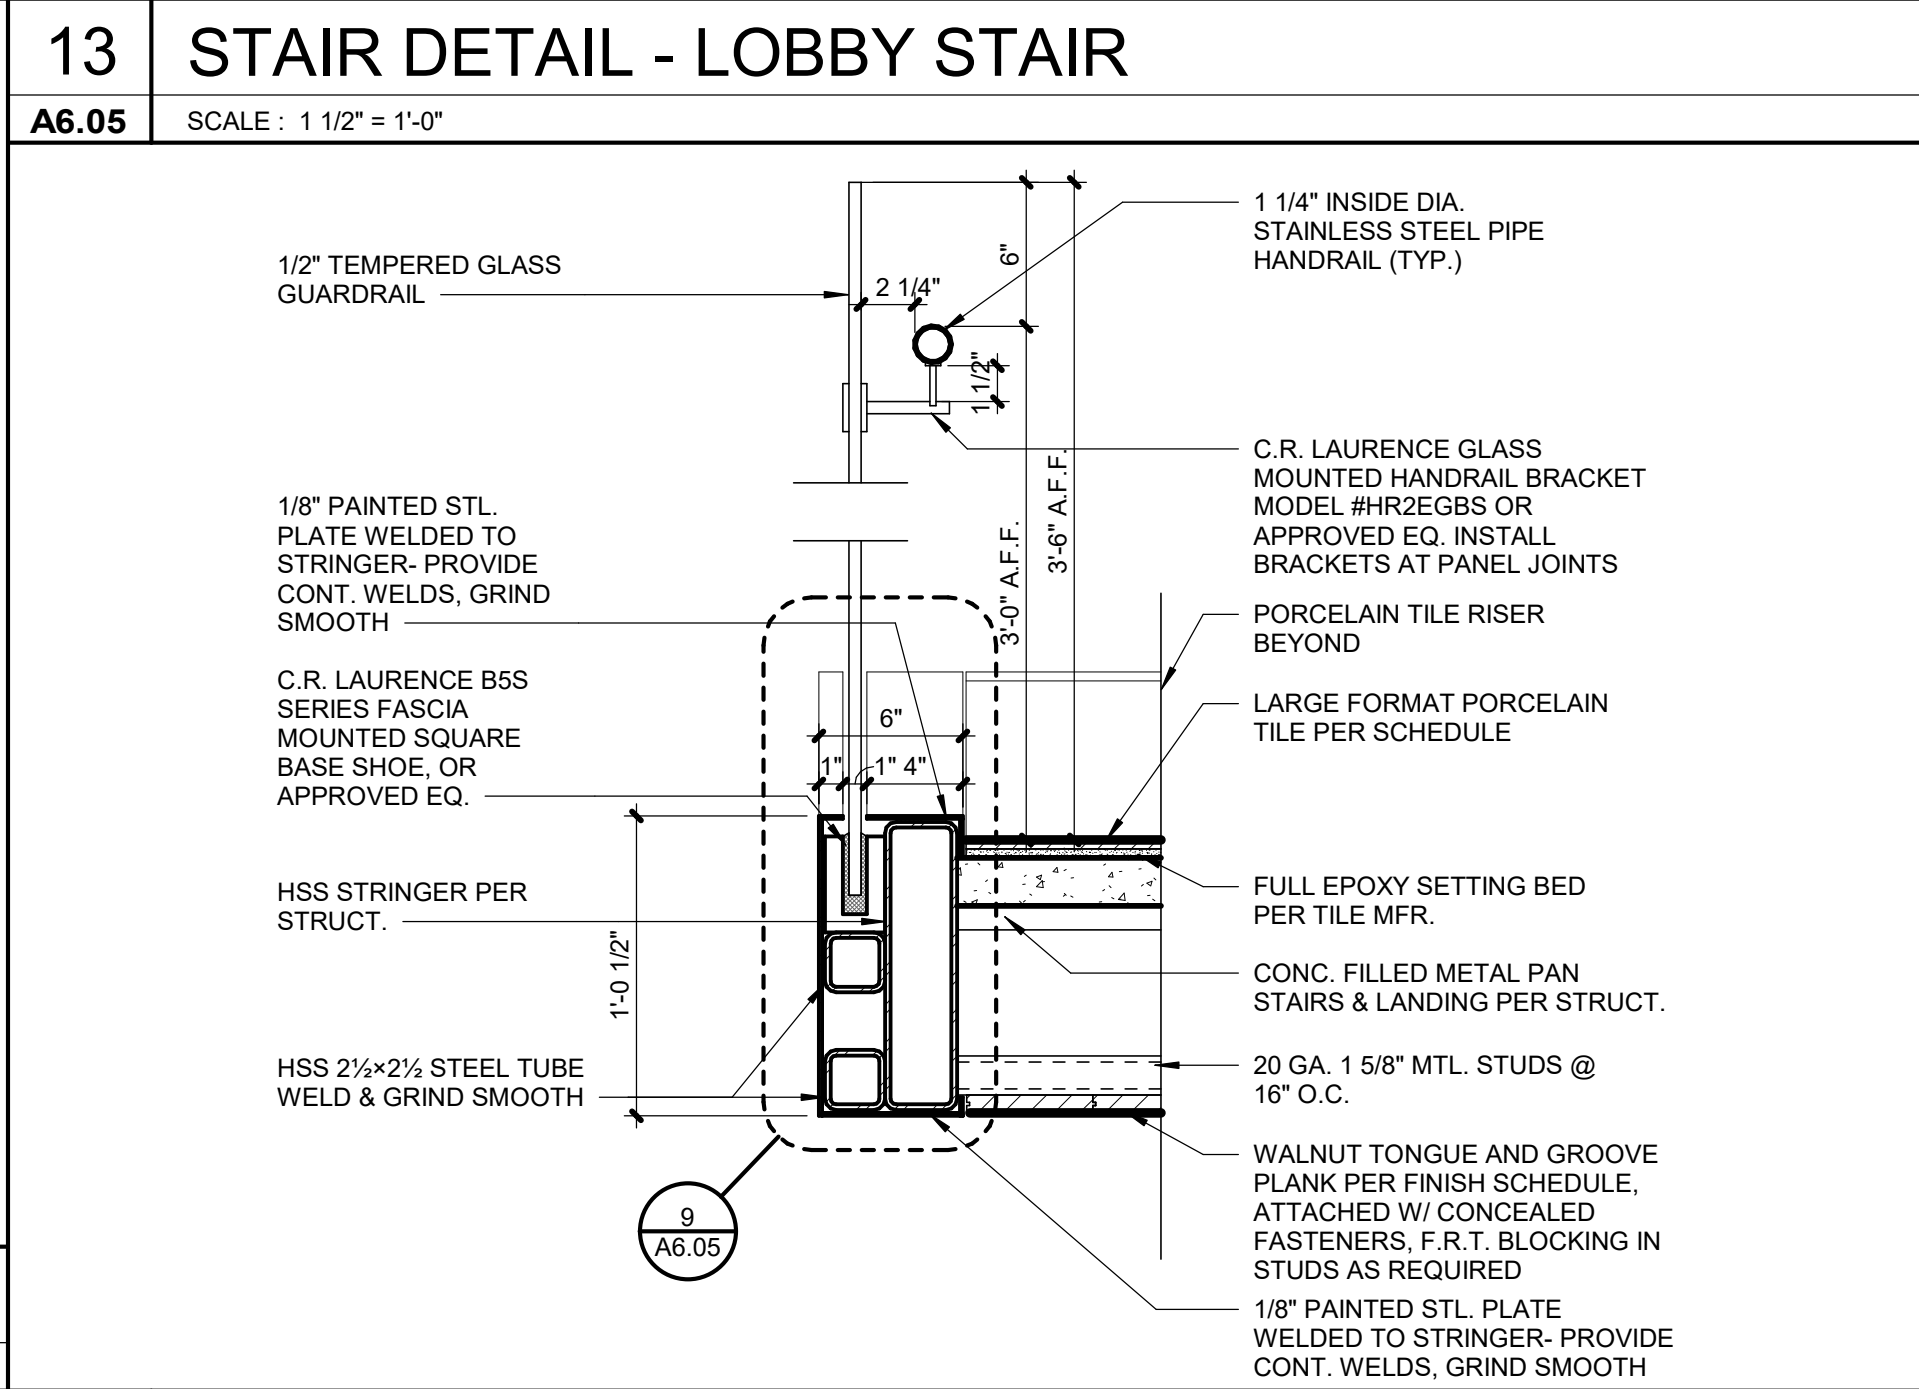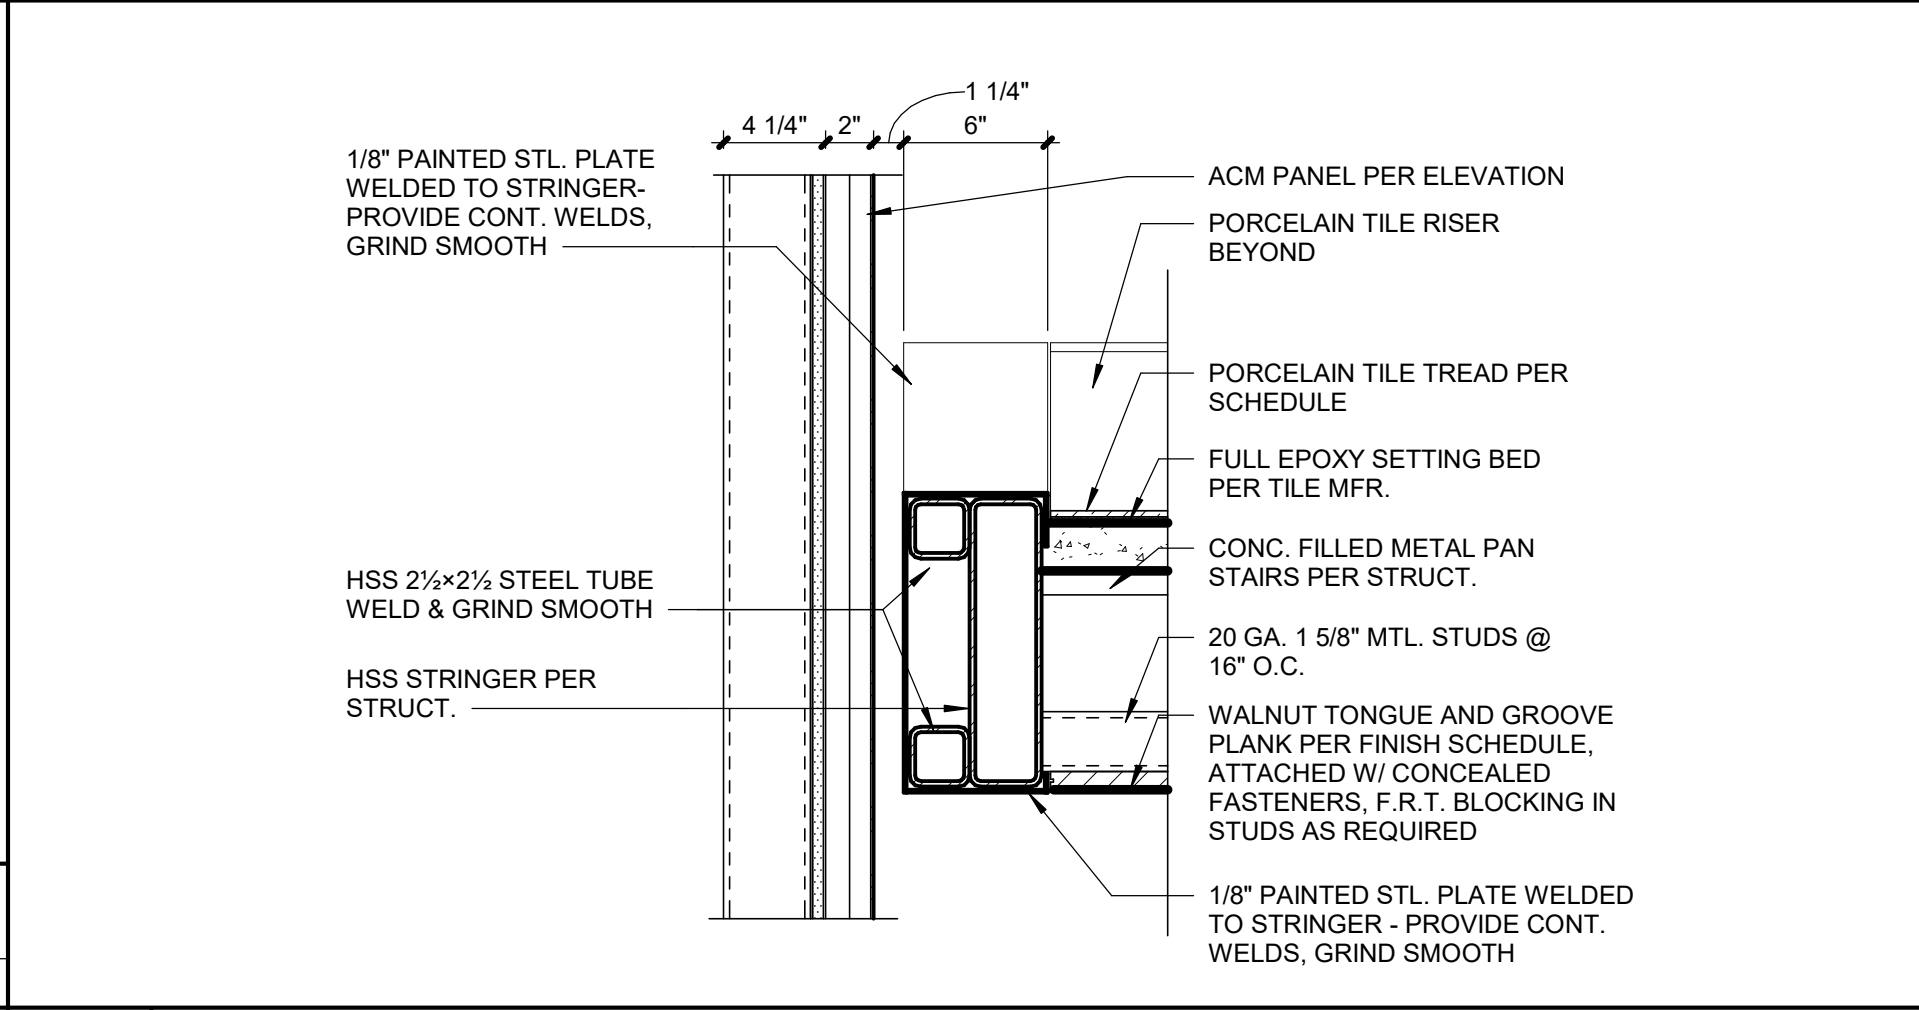

10 STAIR DETAIL - LOBBY STAIR  
A6.05 SCALE : 1 1/2" = 1'-0"

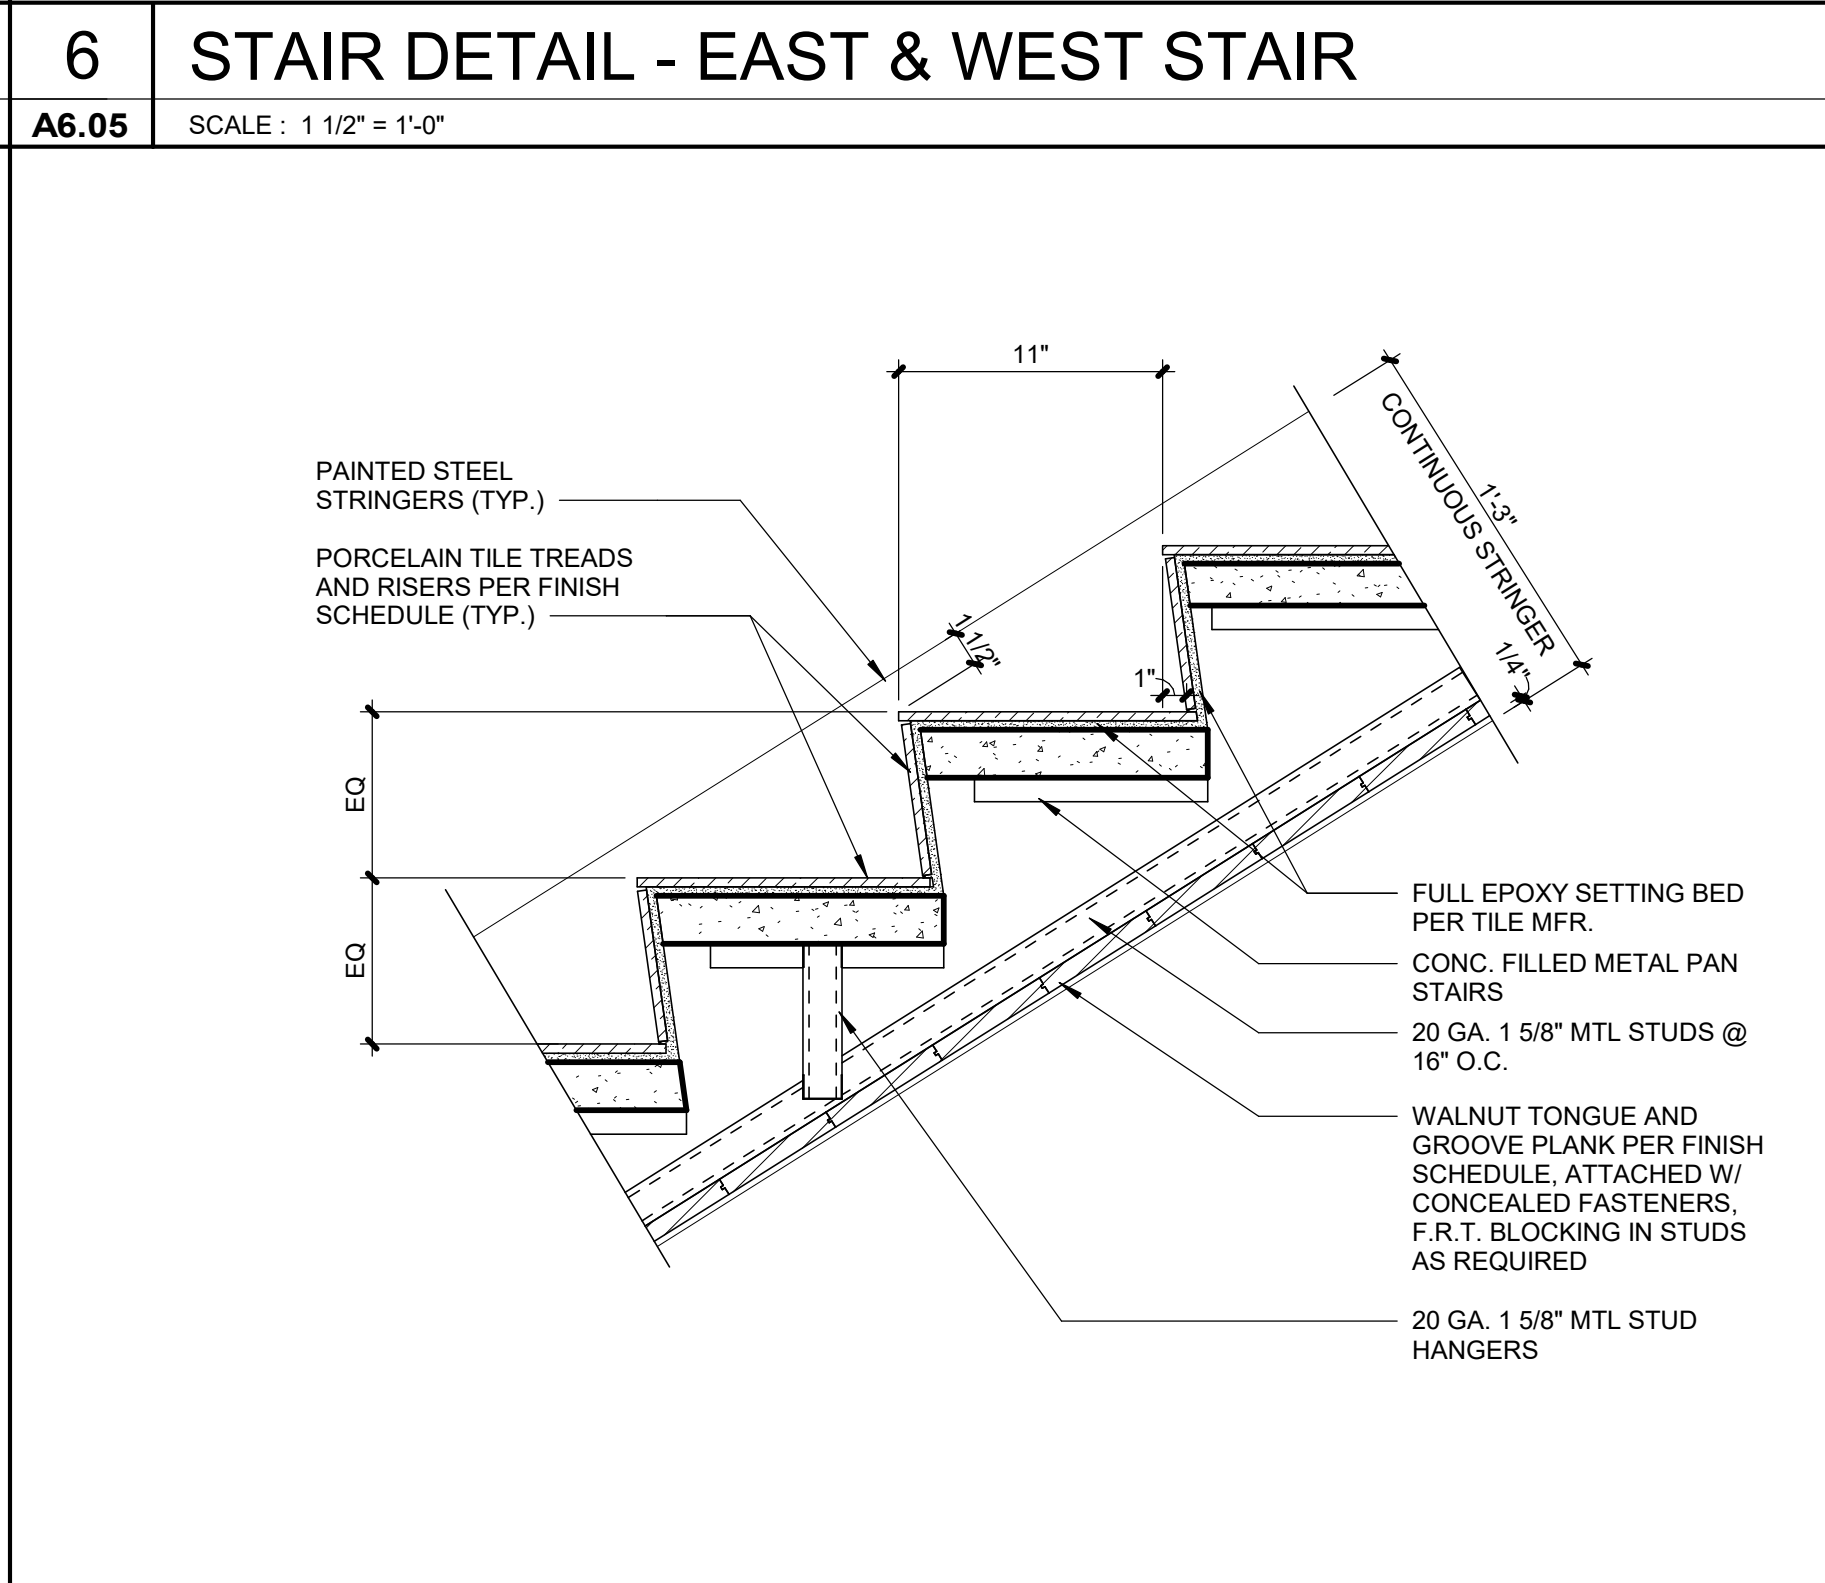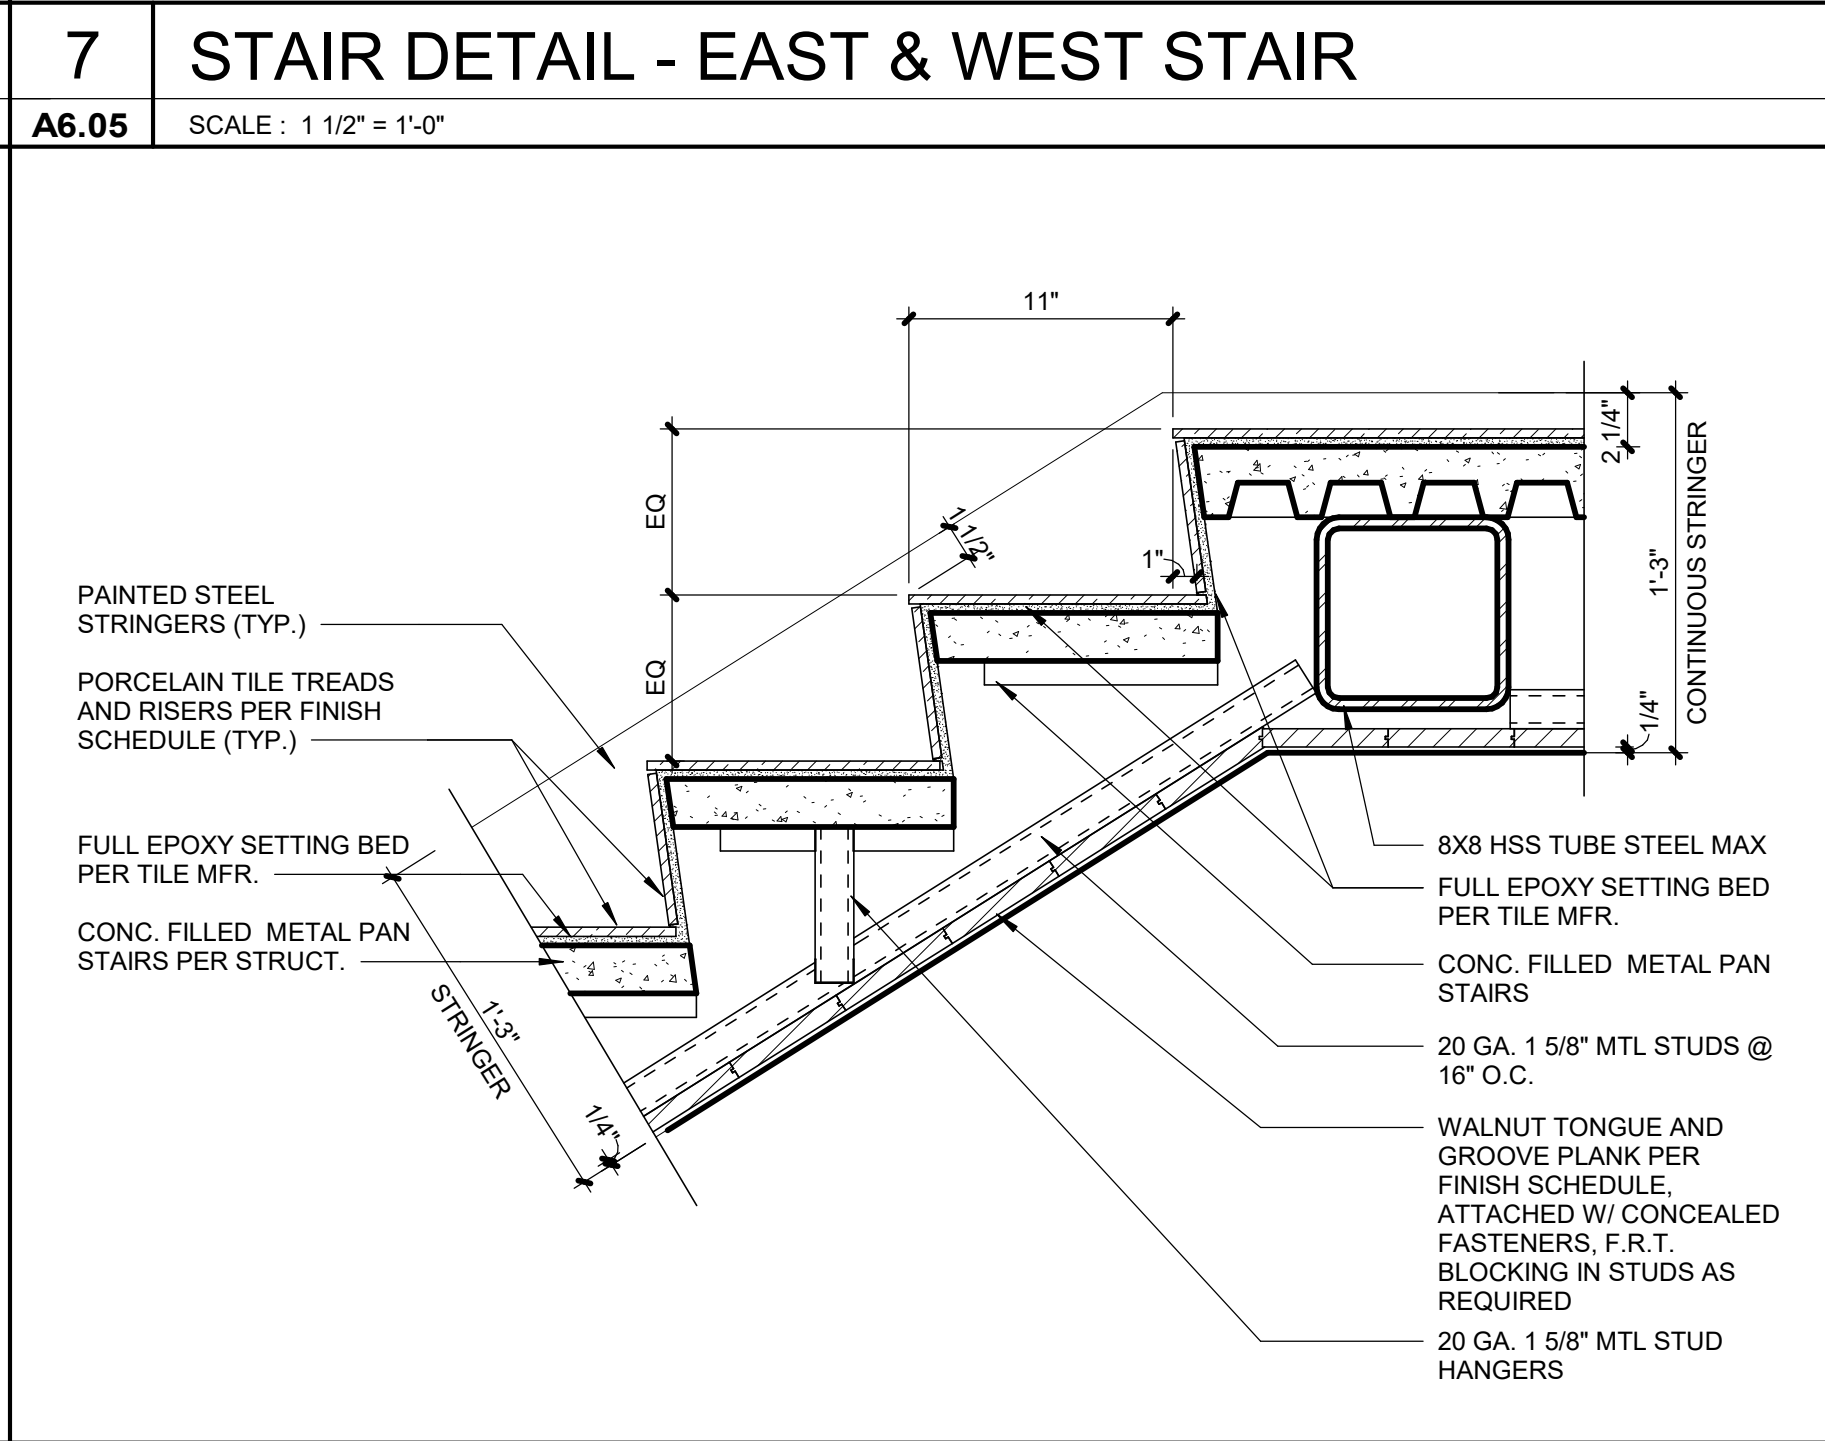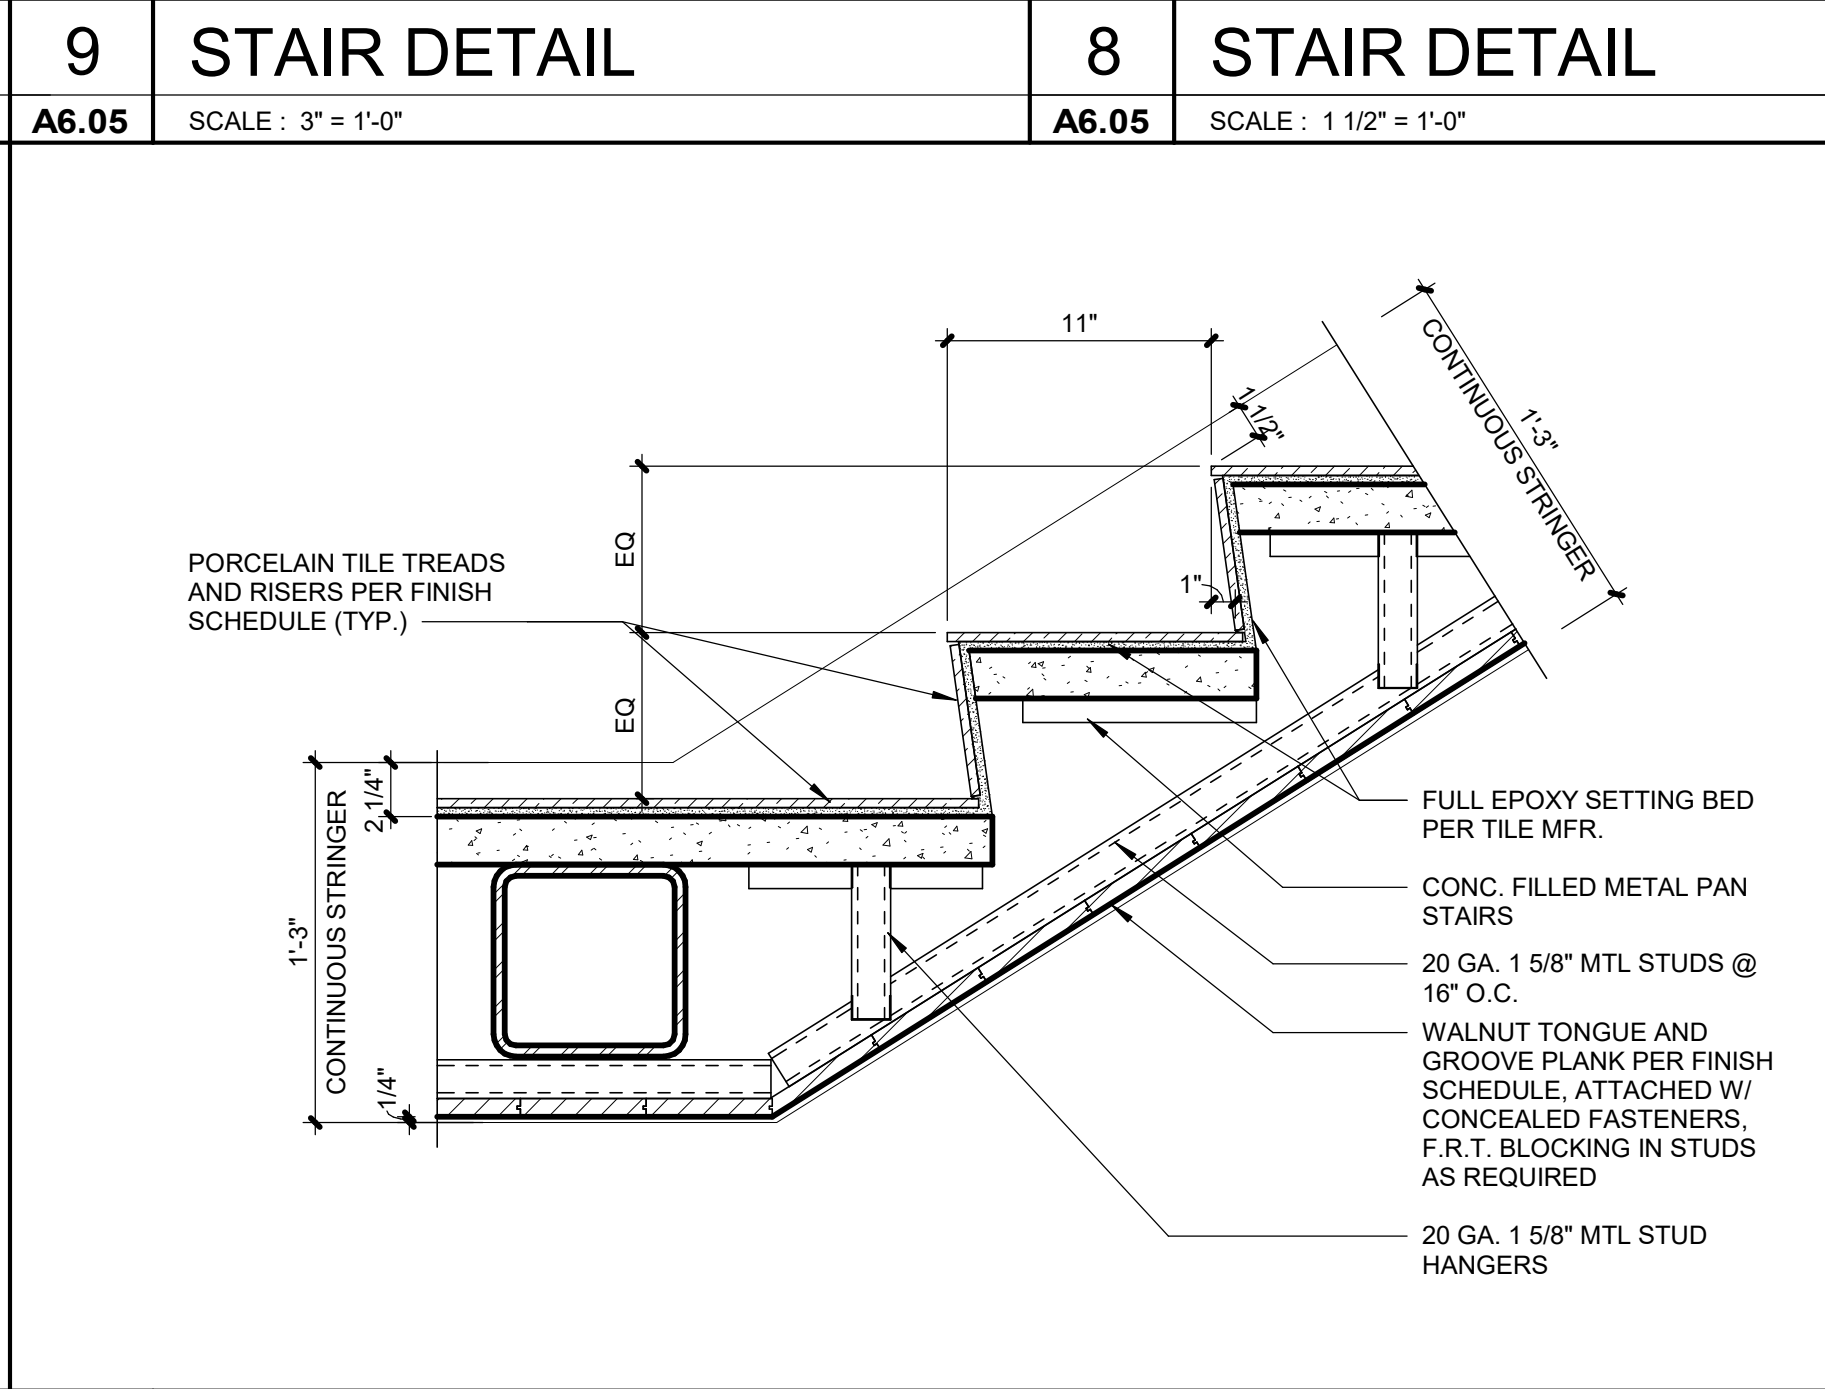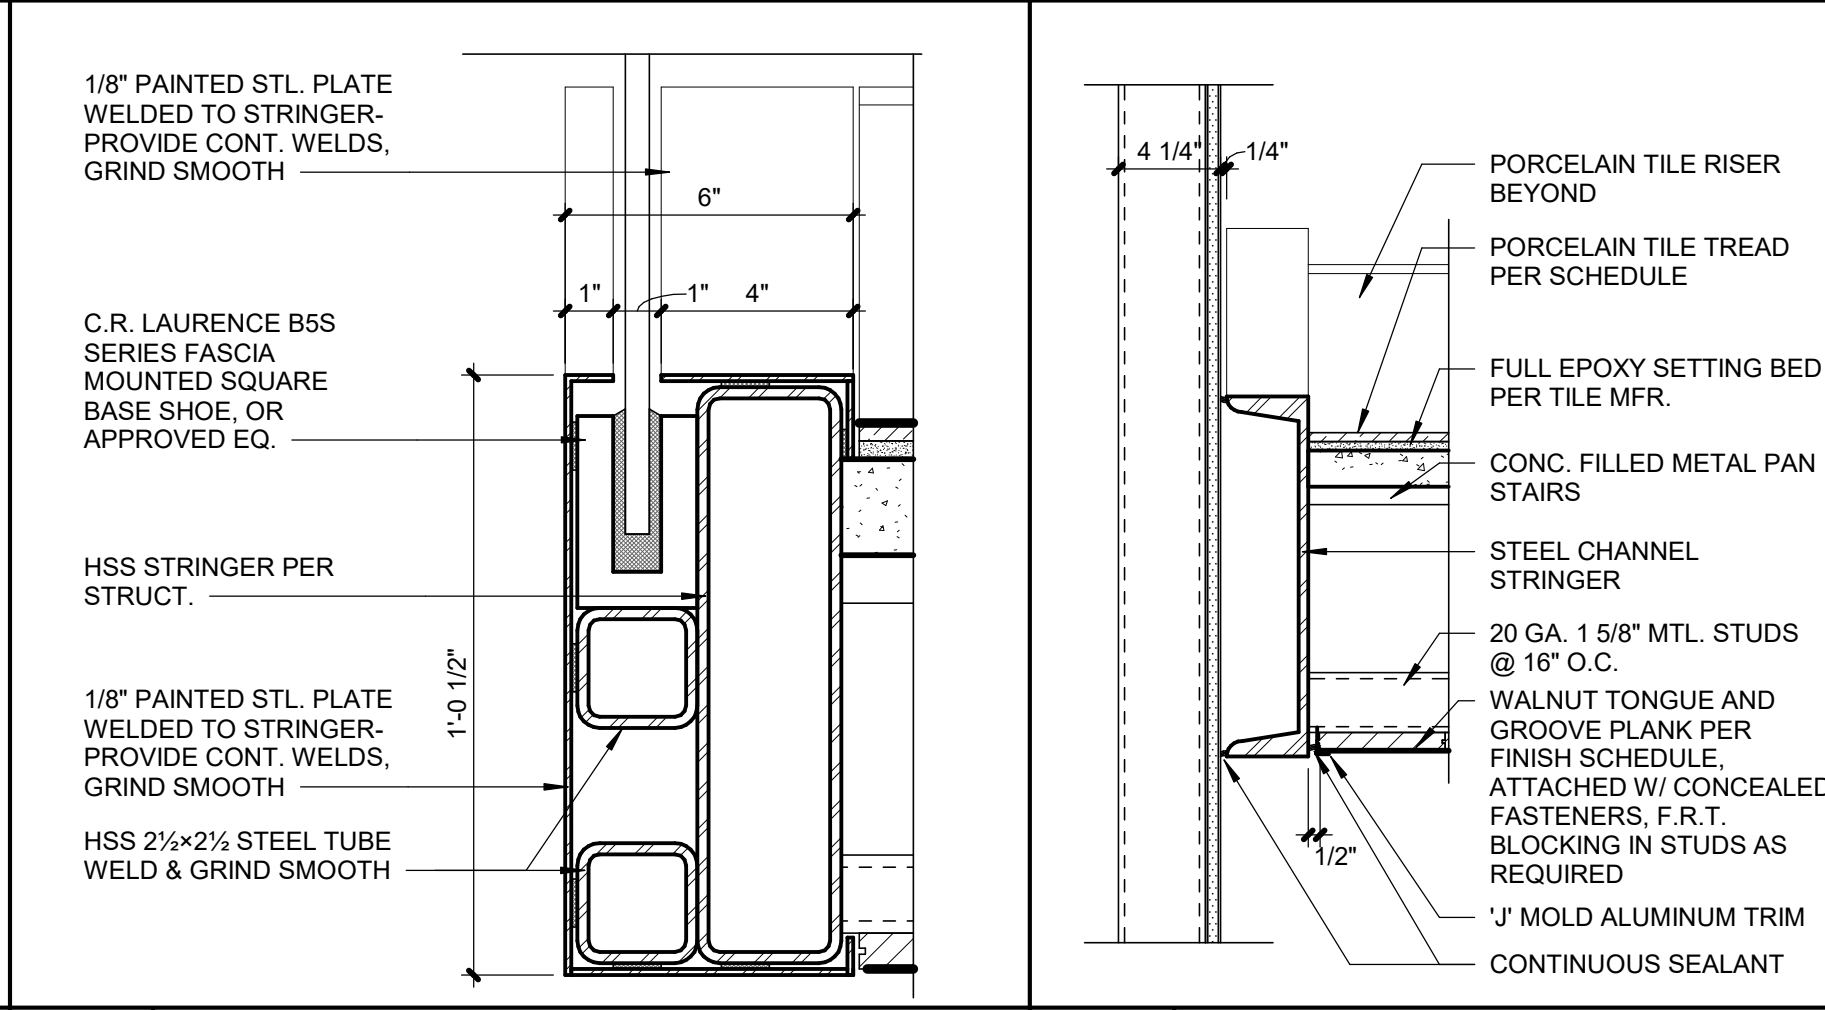

5 STAIR DETAIL - EAST & WEST STAIR  
A6.05 SCALE : 1 1/2" = 1'-0"

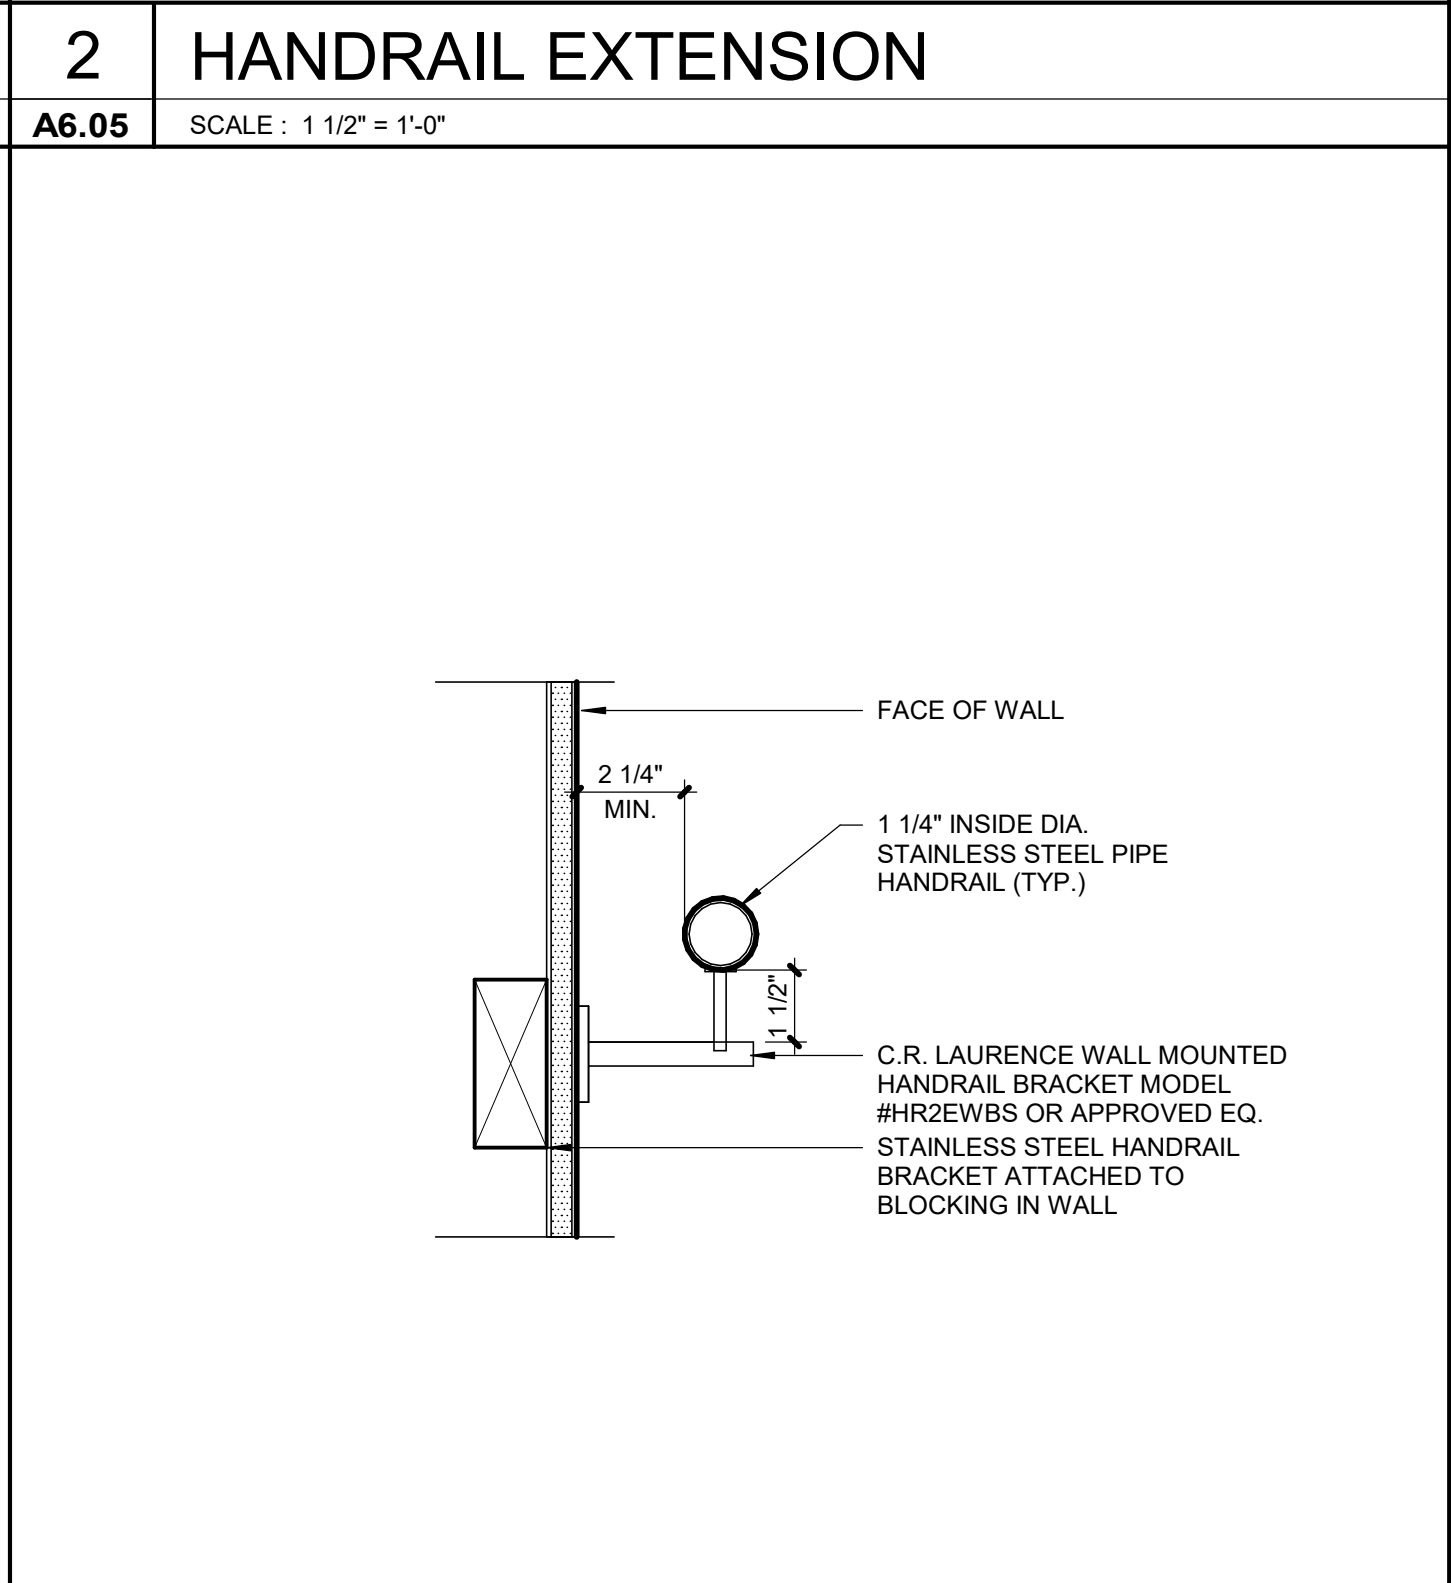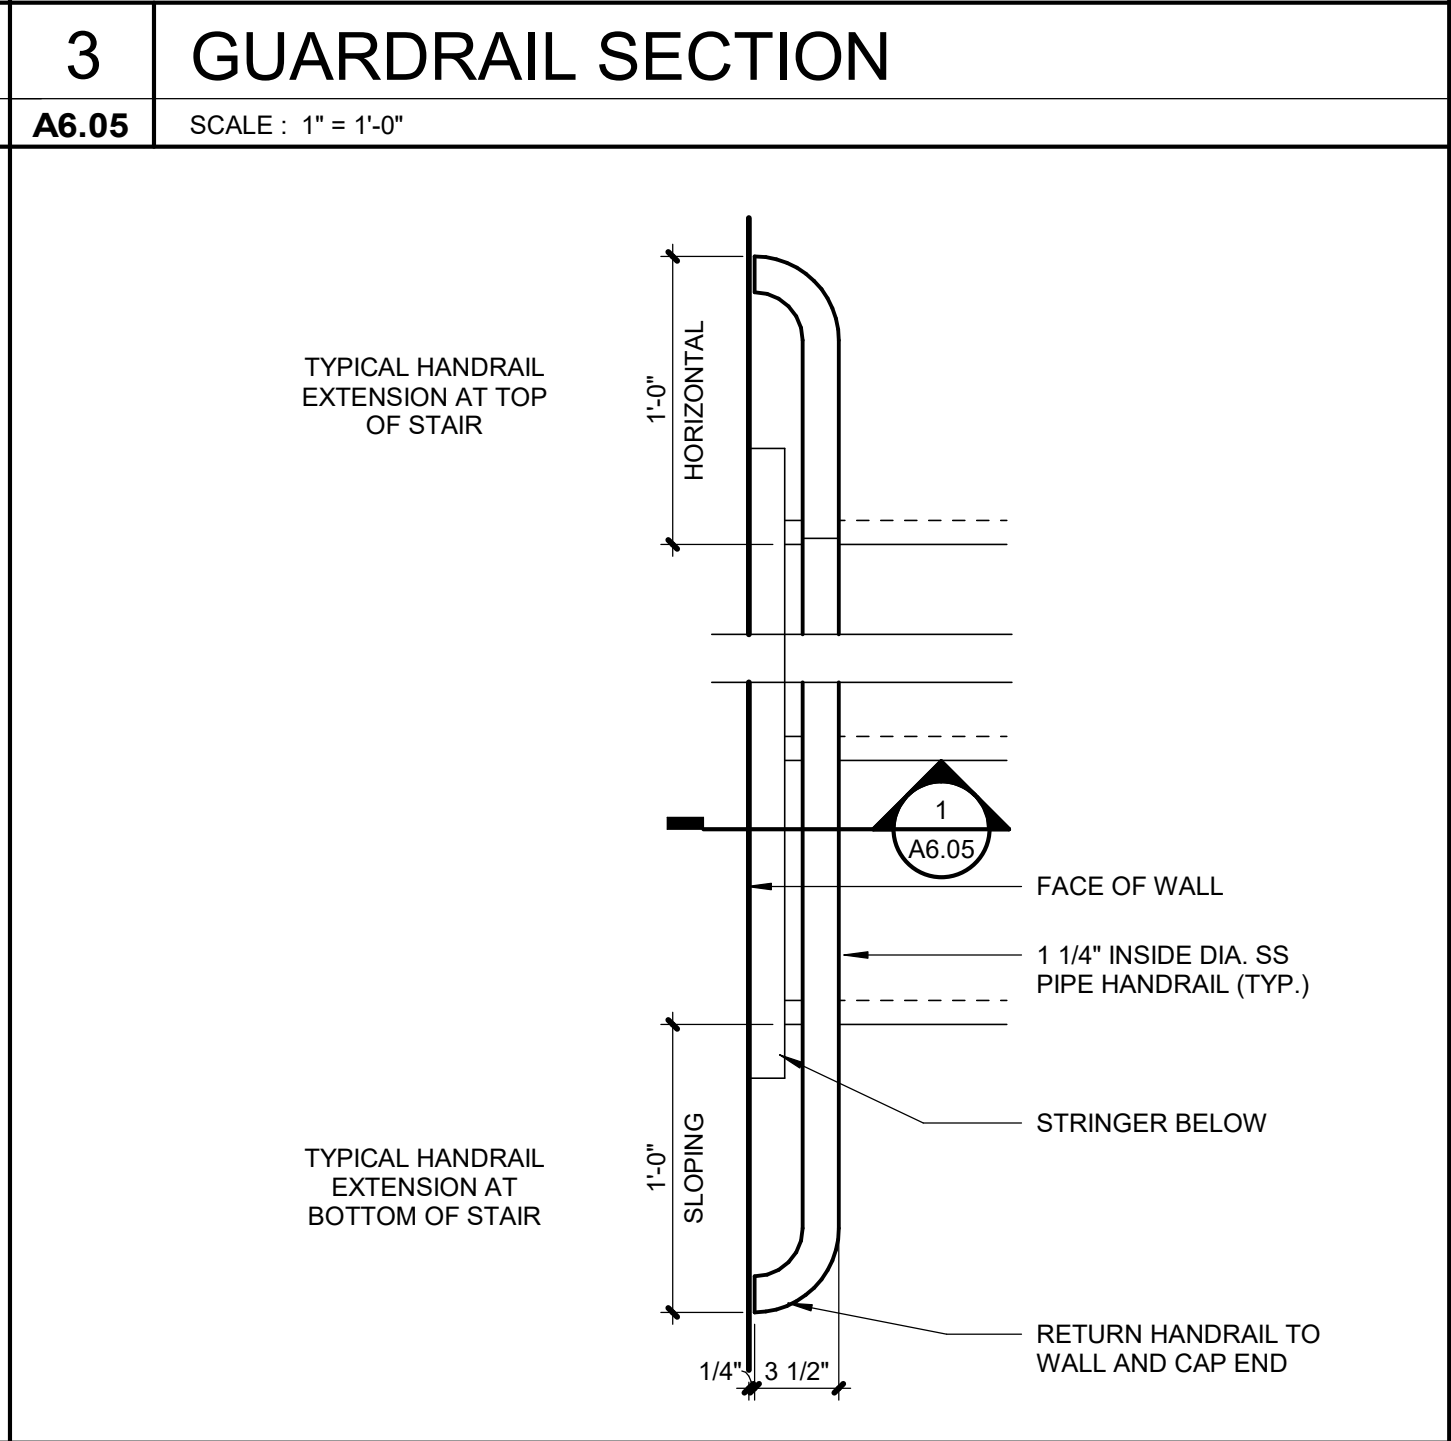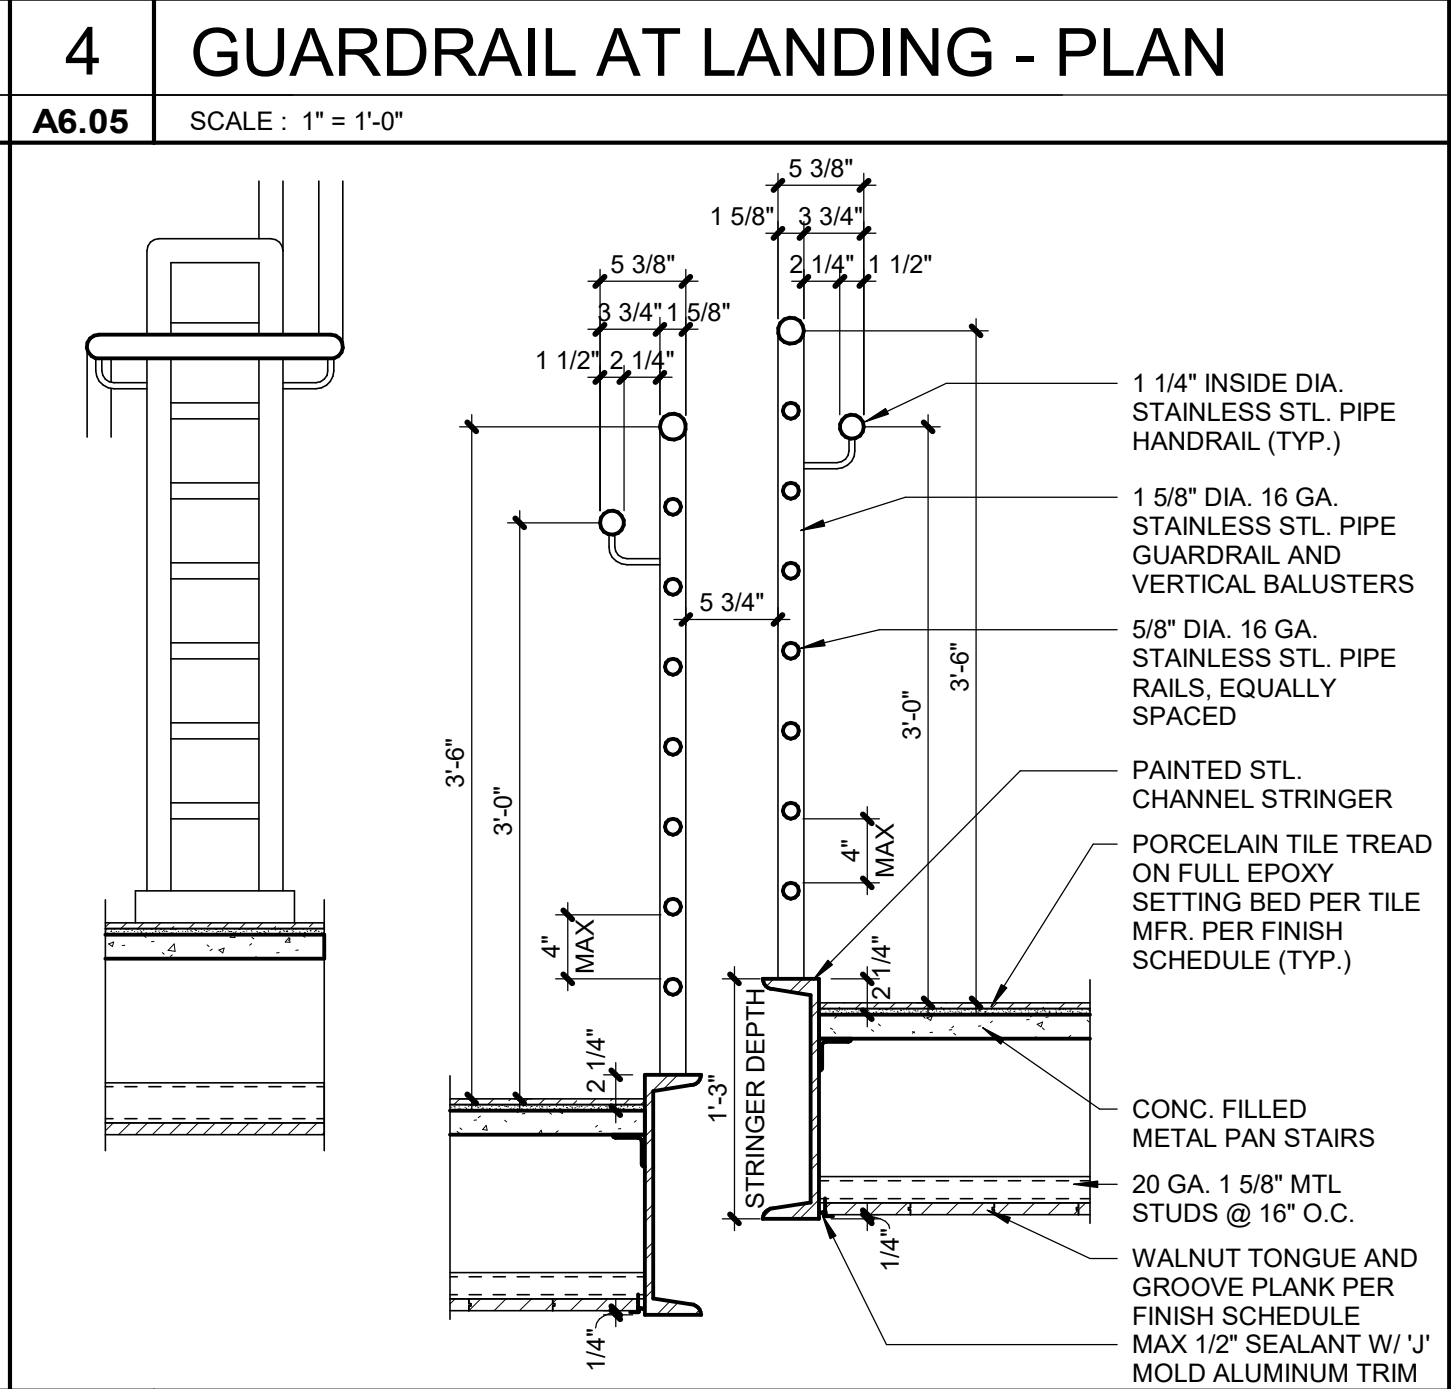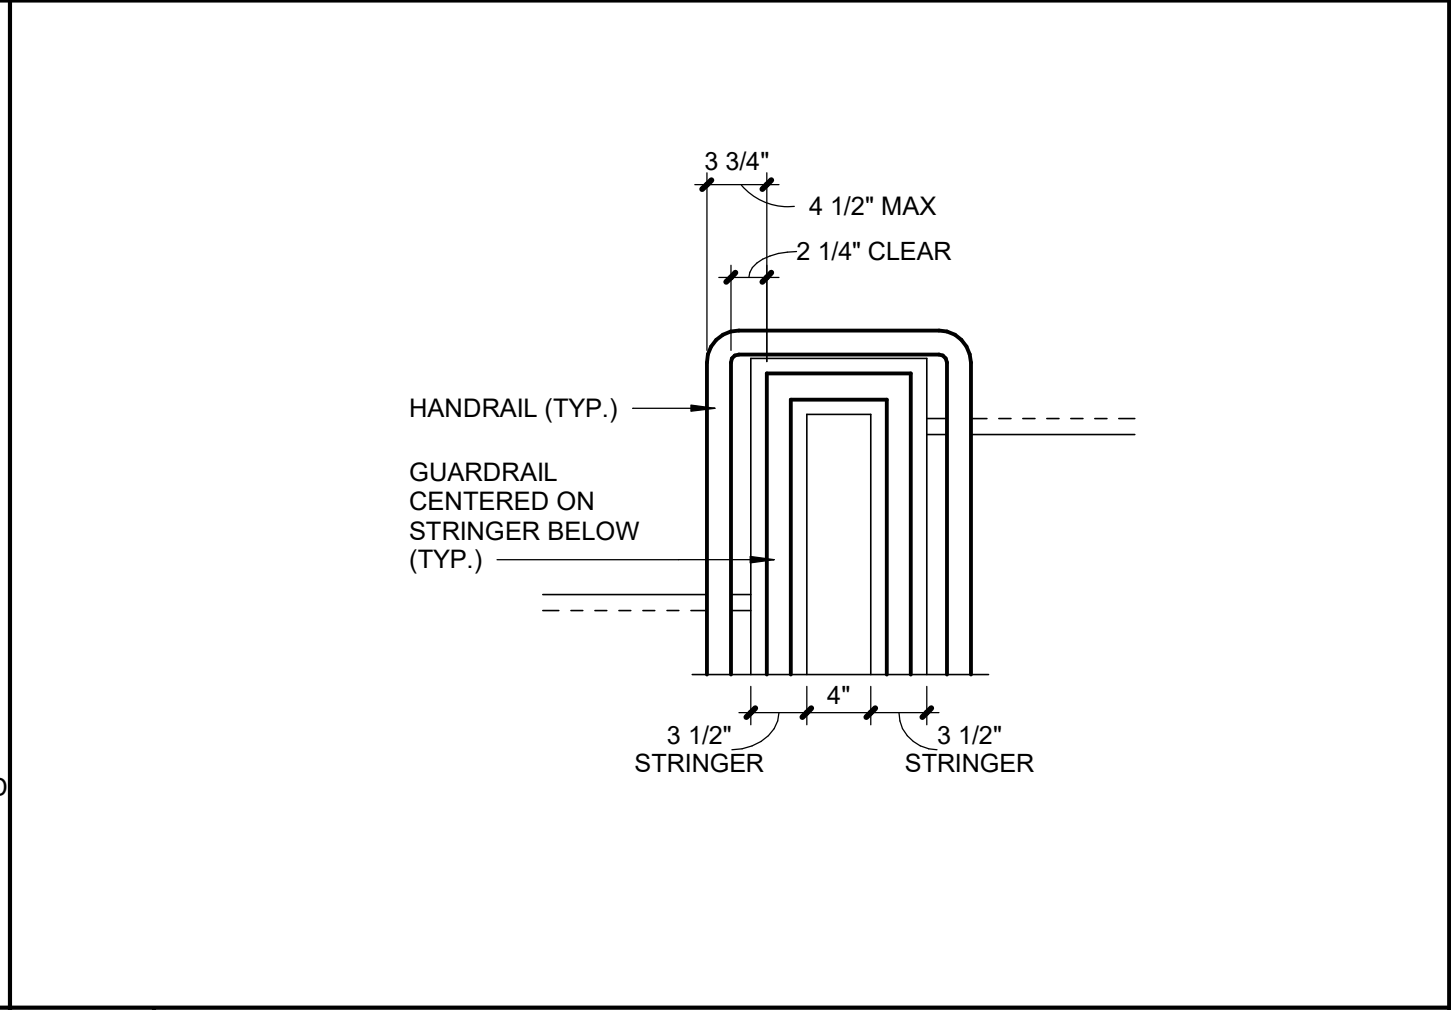

1 HANDRAIL DETAIL  
A6.05 SCALE : 3\"/>



PARAGON STAR  
- LOT 9 -  
BUILDING 2  
PARAGON STAR  
FIRST PLAT, LOT 9  
LEE'S SUMMIT, MO

Project No.: 19050.01  
Date: 10.25.19  
Issued For: SHELL - CD SET

| REVISIONS |      |             |
|-----------|------|-------------|
| No.       | Date | Description |
|           |      |             |
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|           |      |             |

REGISTRATION



| PROJECT TEAM    |                              |
|-----------------|------------------------------|
| ARCHITECT       | FINKLE+WILLIAMS ARCHITECTURE |
| CIVIL           | GBA                          |
| LANDSCAPE       | HOERR SCHAUDT / LANDS        |
| FOUNDATIONS     | BSE STRUCTURAL ENGINEERS     |
| STRUCTURAL      | BSE STRUCTURAL ENGINEERS     |
| PLUMBING        | HENDERSON ENGINEERS          |
| MECHANICAL      | HENDERSON ENGINEERS          |
| ELECTRICAL      | HENDERSON ENGINEERS          |
| FIRE PROTECTION | HENDERSON ENGINEERS          |
| CONTRACTOR      | FOGEL ANDERSON               |



FINKLE + WILLIAMS  
ARCHITECTURE  
7007 College Blvd, Suite 415  
Overland Park, Kansas 66211  
913-498-1550


SHEET TITLE  
VERTICAL  
CIRCULATION  
DETAILS


SHEET NUMBER

A6.05



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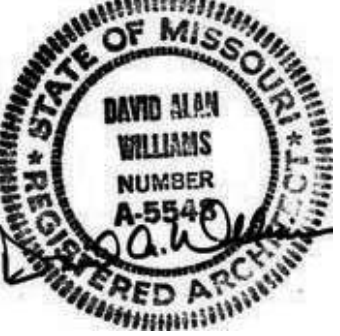


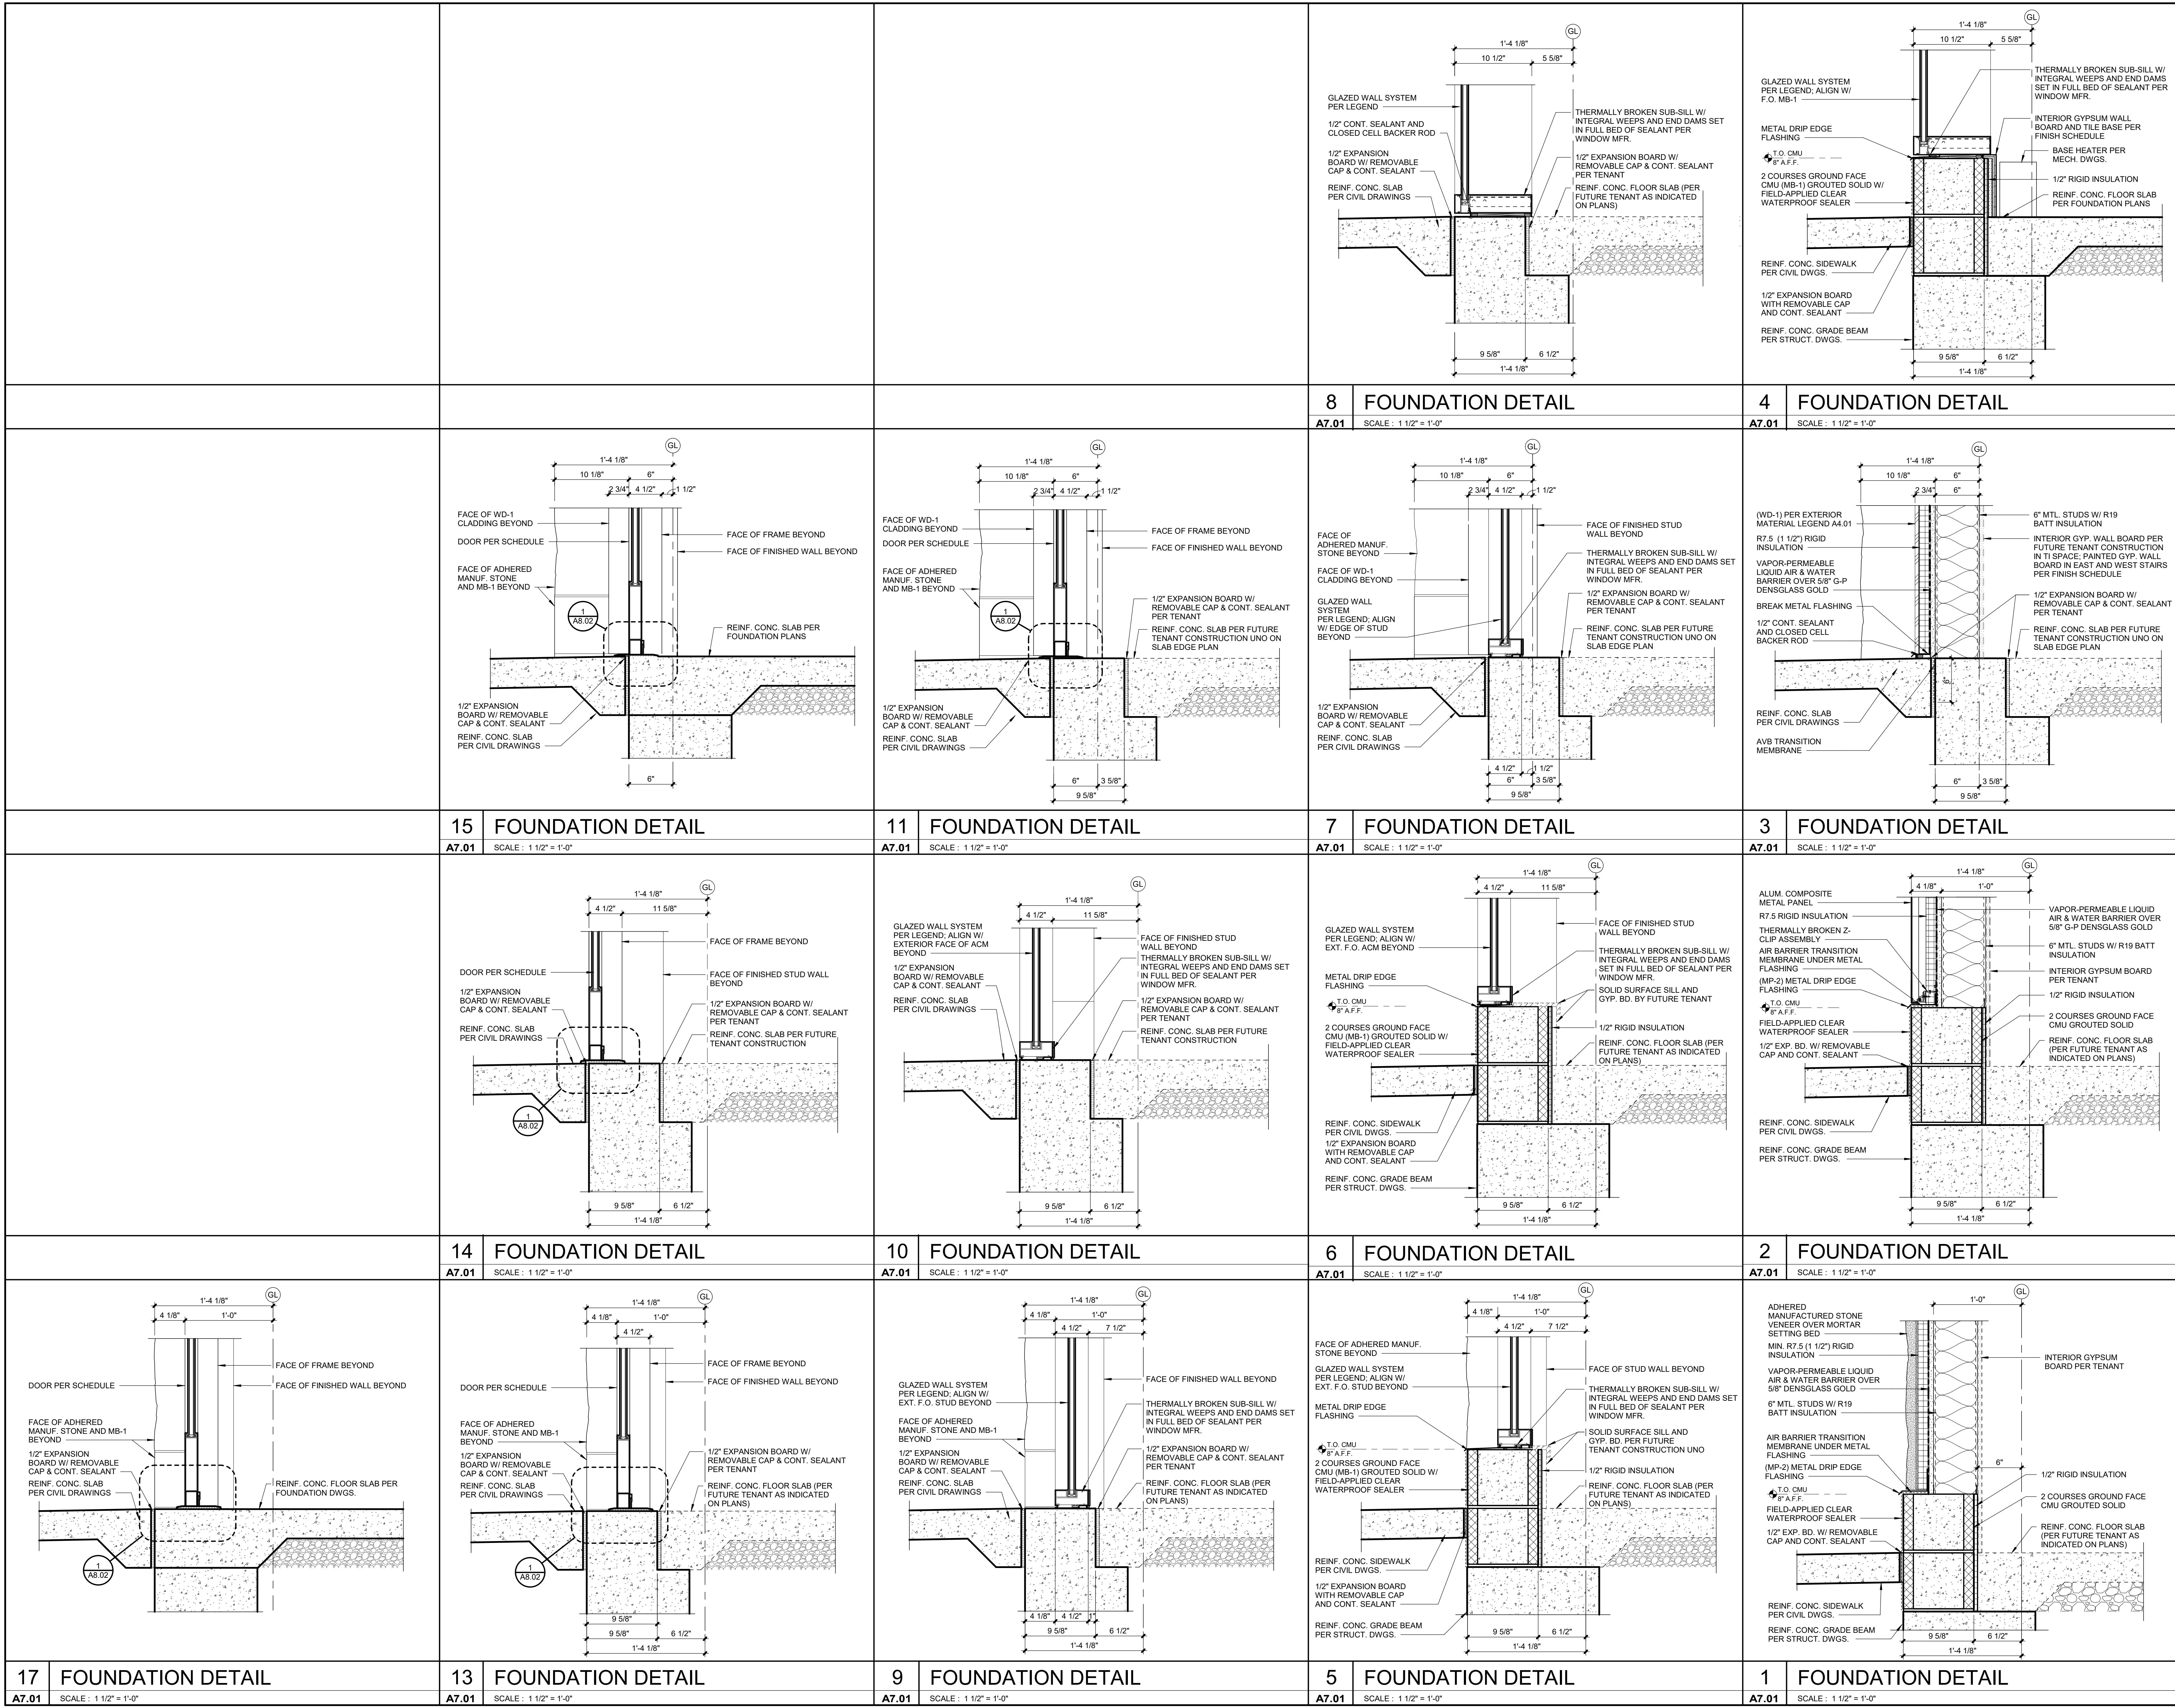


PARAGON STAR  
- LOT 9 -  
BUILDING 2  
PARAGON STAR  
FIRST PLAT, LOT 9  
LEE'S SUMMIT, MO

Project No.: 19050.01  
Date: 10.25.19  
Issued For: SHELL - CD SET

REVISIONS  
No. Date Description

REGISTRATION  


PROJECT TEAM  
ARCHITECT FINKLE+WILLIAMS ARCHITECTURE  
CIVIL GBA  
LANDSCAPE HOERR SCHAUDT / LANDS  
FOUNDATIONS BSE STRUCTURAL ENGINEERS  
STRUCTURAL BSE STRUCTURAL ENGINEERS  
PLUMBING HENDERSON ENGINEERS  
MECHANICAL HENDERSON ENGINEERS  
ELECTRICAL HENDERSON ENGINEERS  
FIRE PROTECTION HENDERSON ENGINEERS  
CONTRACTOR FOGEL ANDERSON



FINKLE + WILLIAMS  
ARCHITECTURE  
7007 College Blvd, Suite 415  
Overland Park, Kansas 66211  
913-498-1550

SHEET TITLE  
FOUNDATION  
DETAILS

SHEET NUMBER  
A7.01














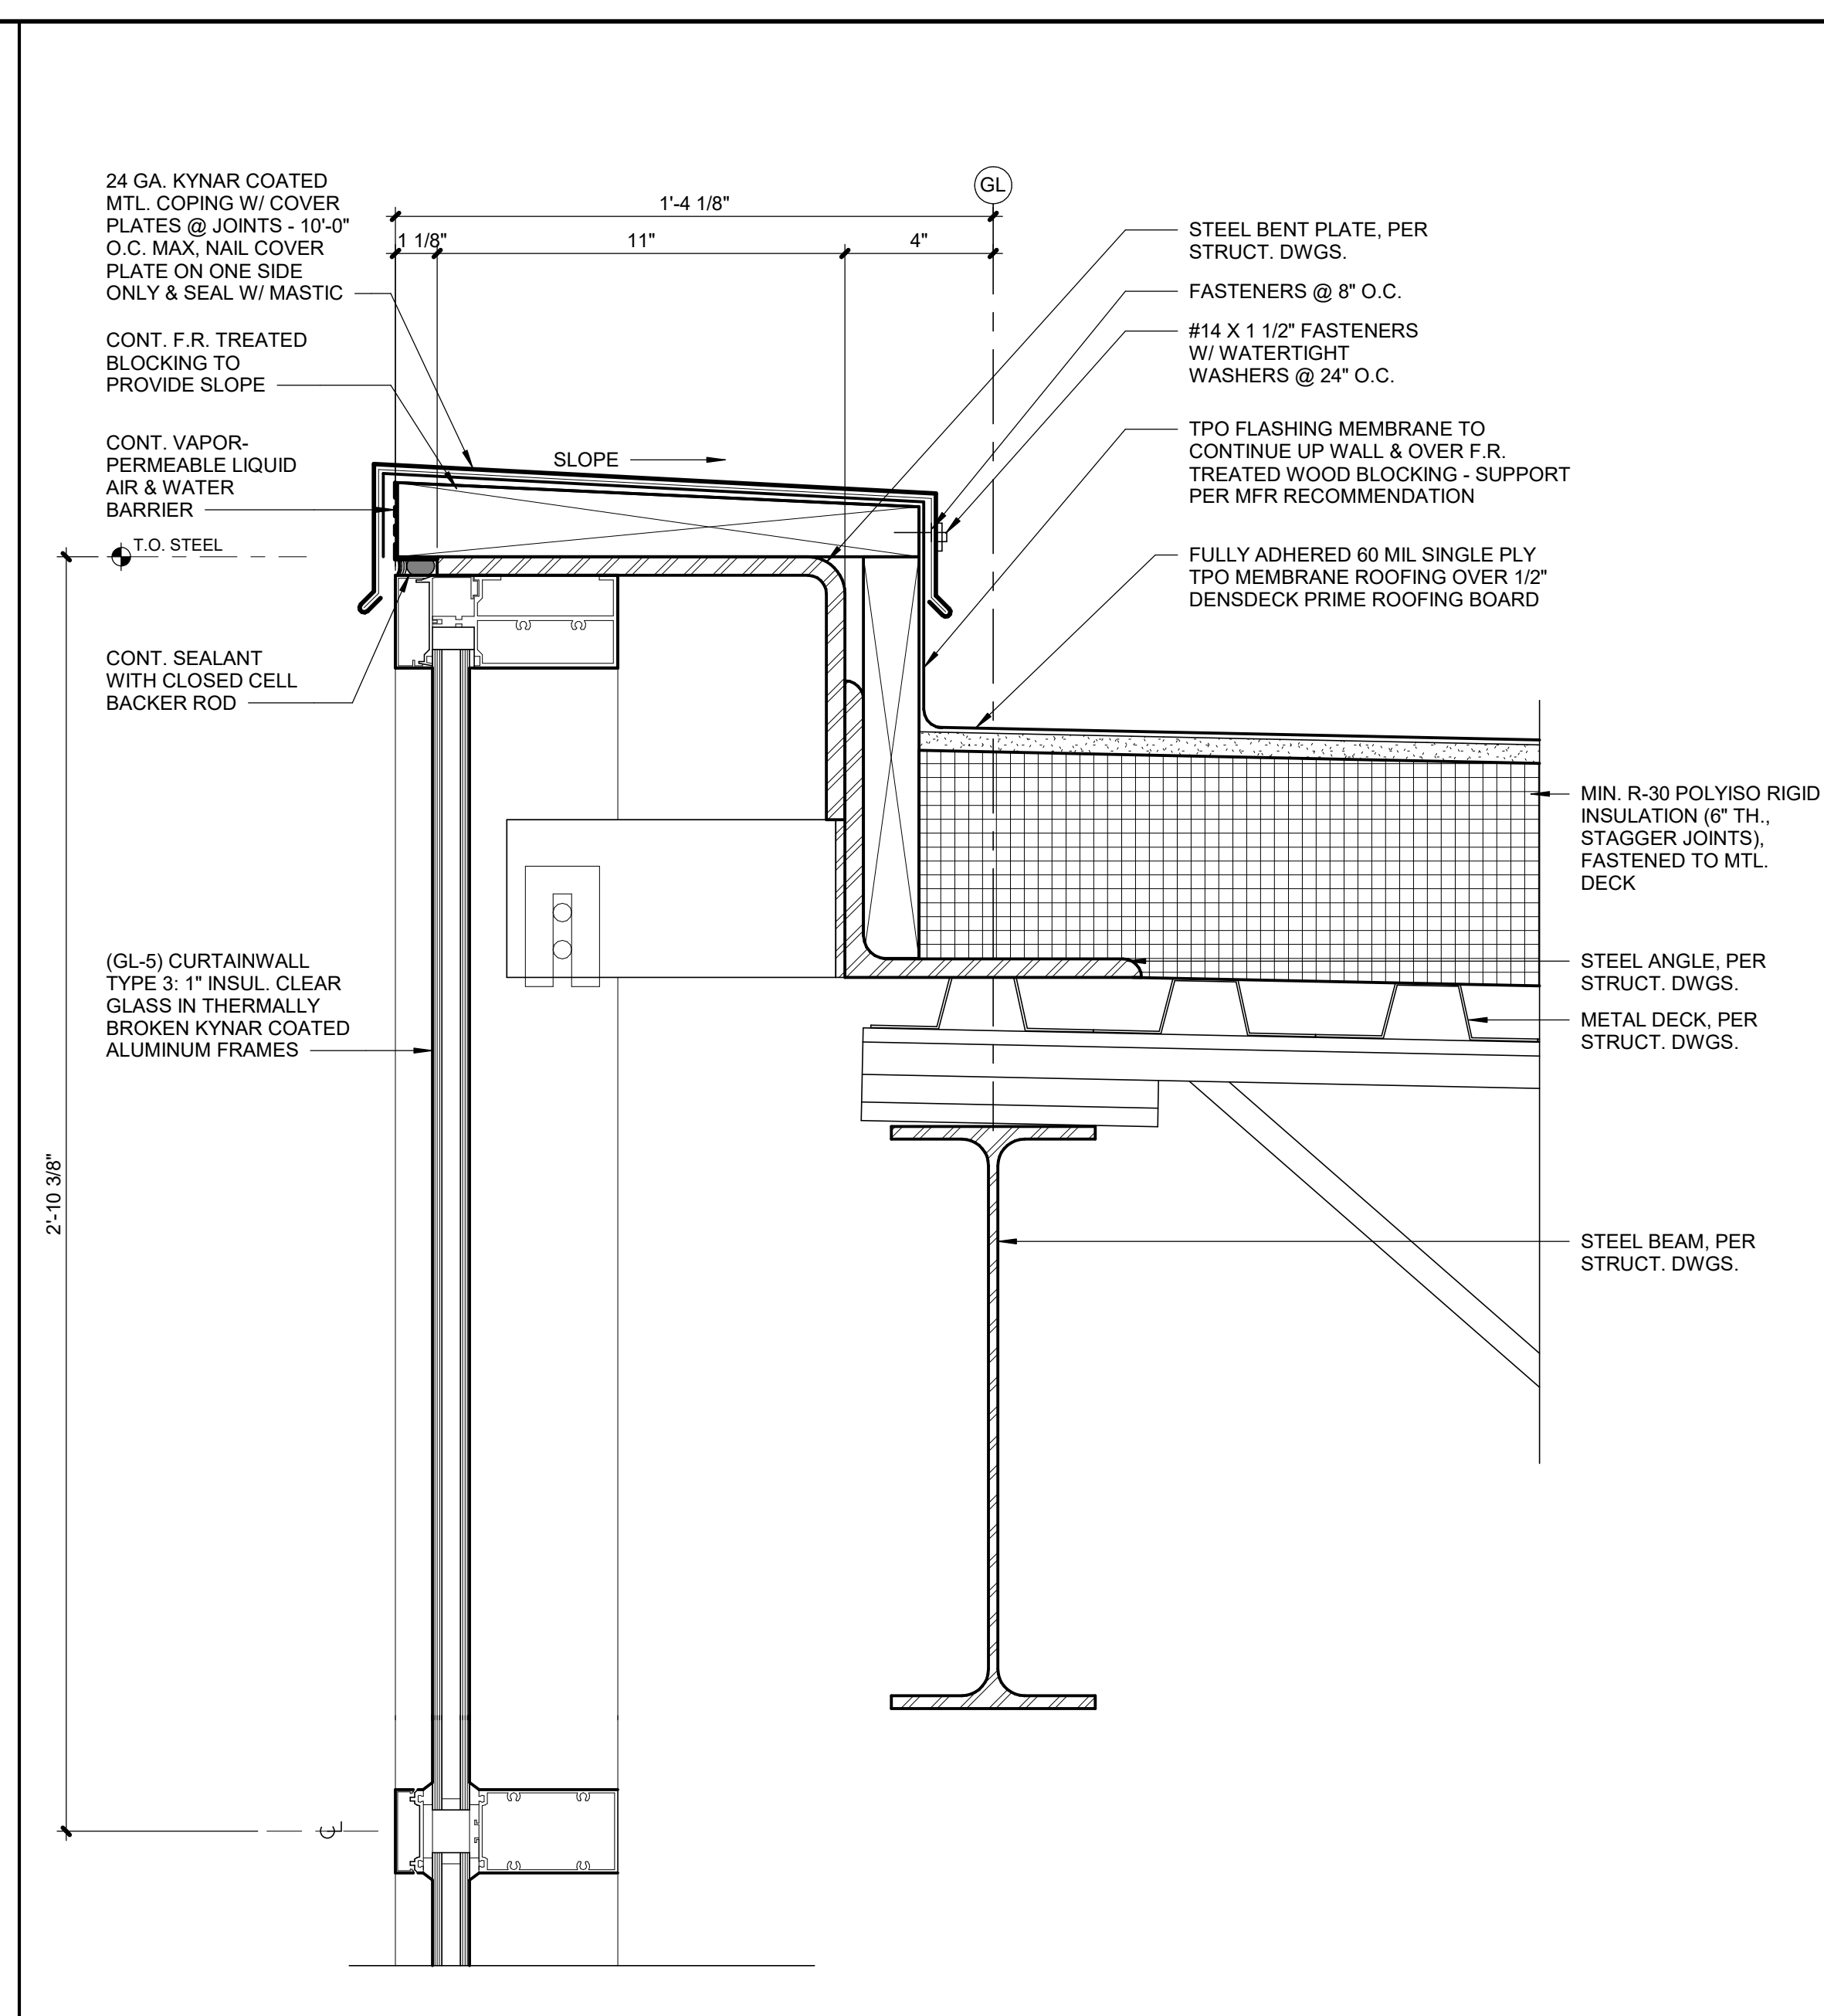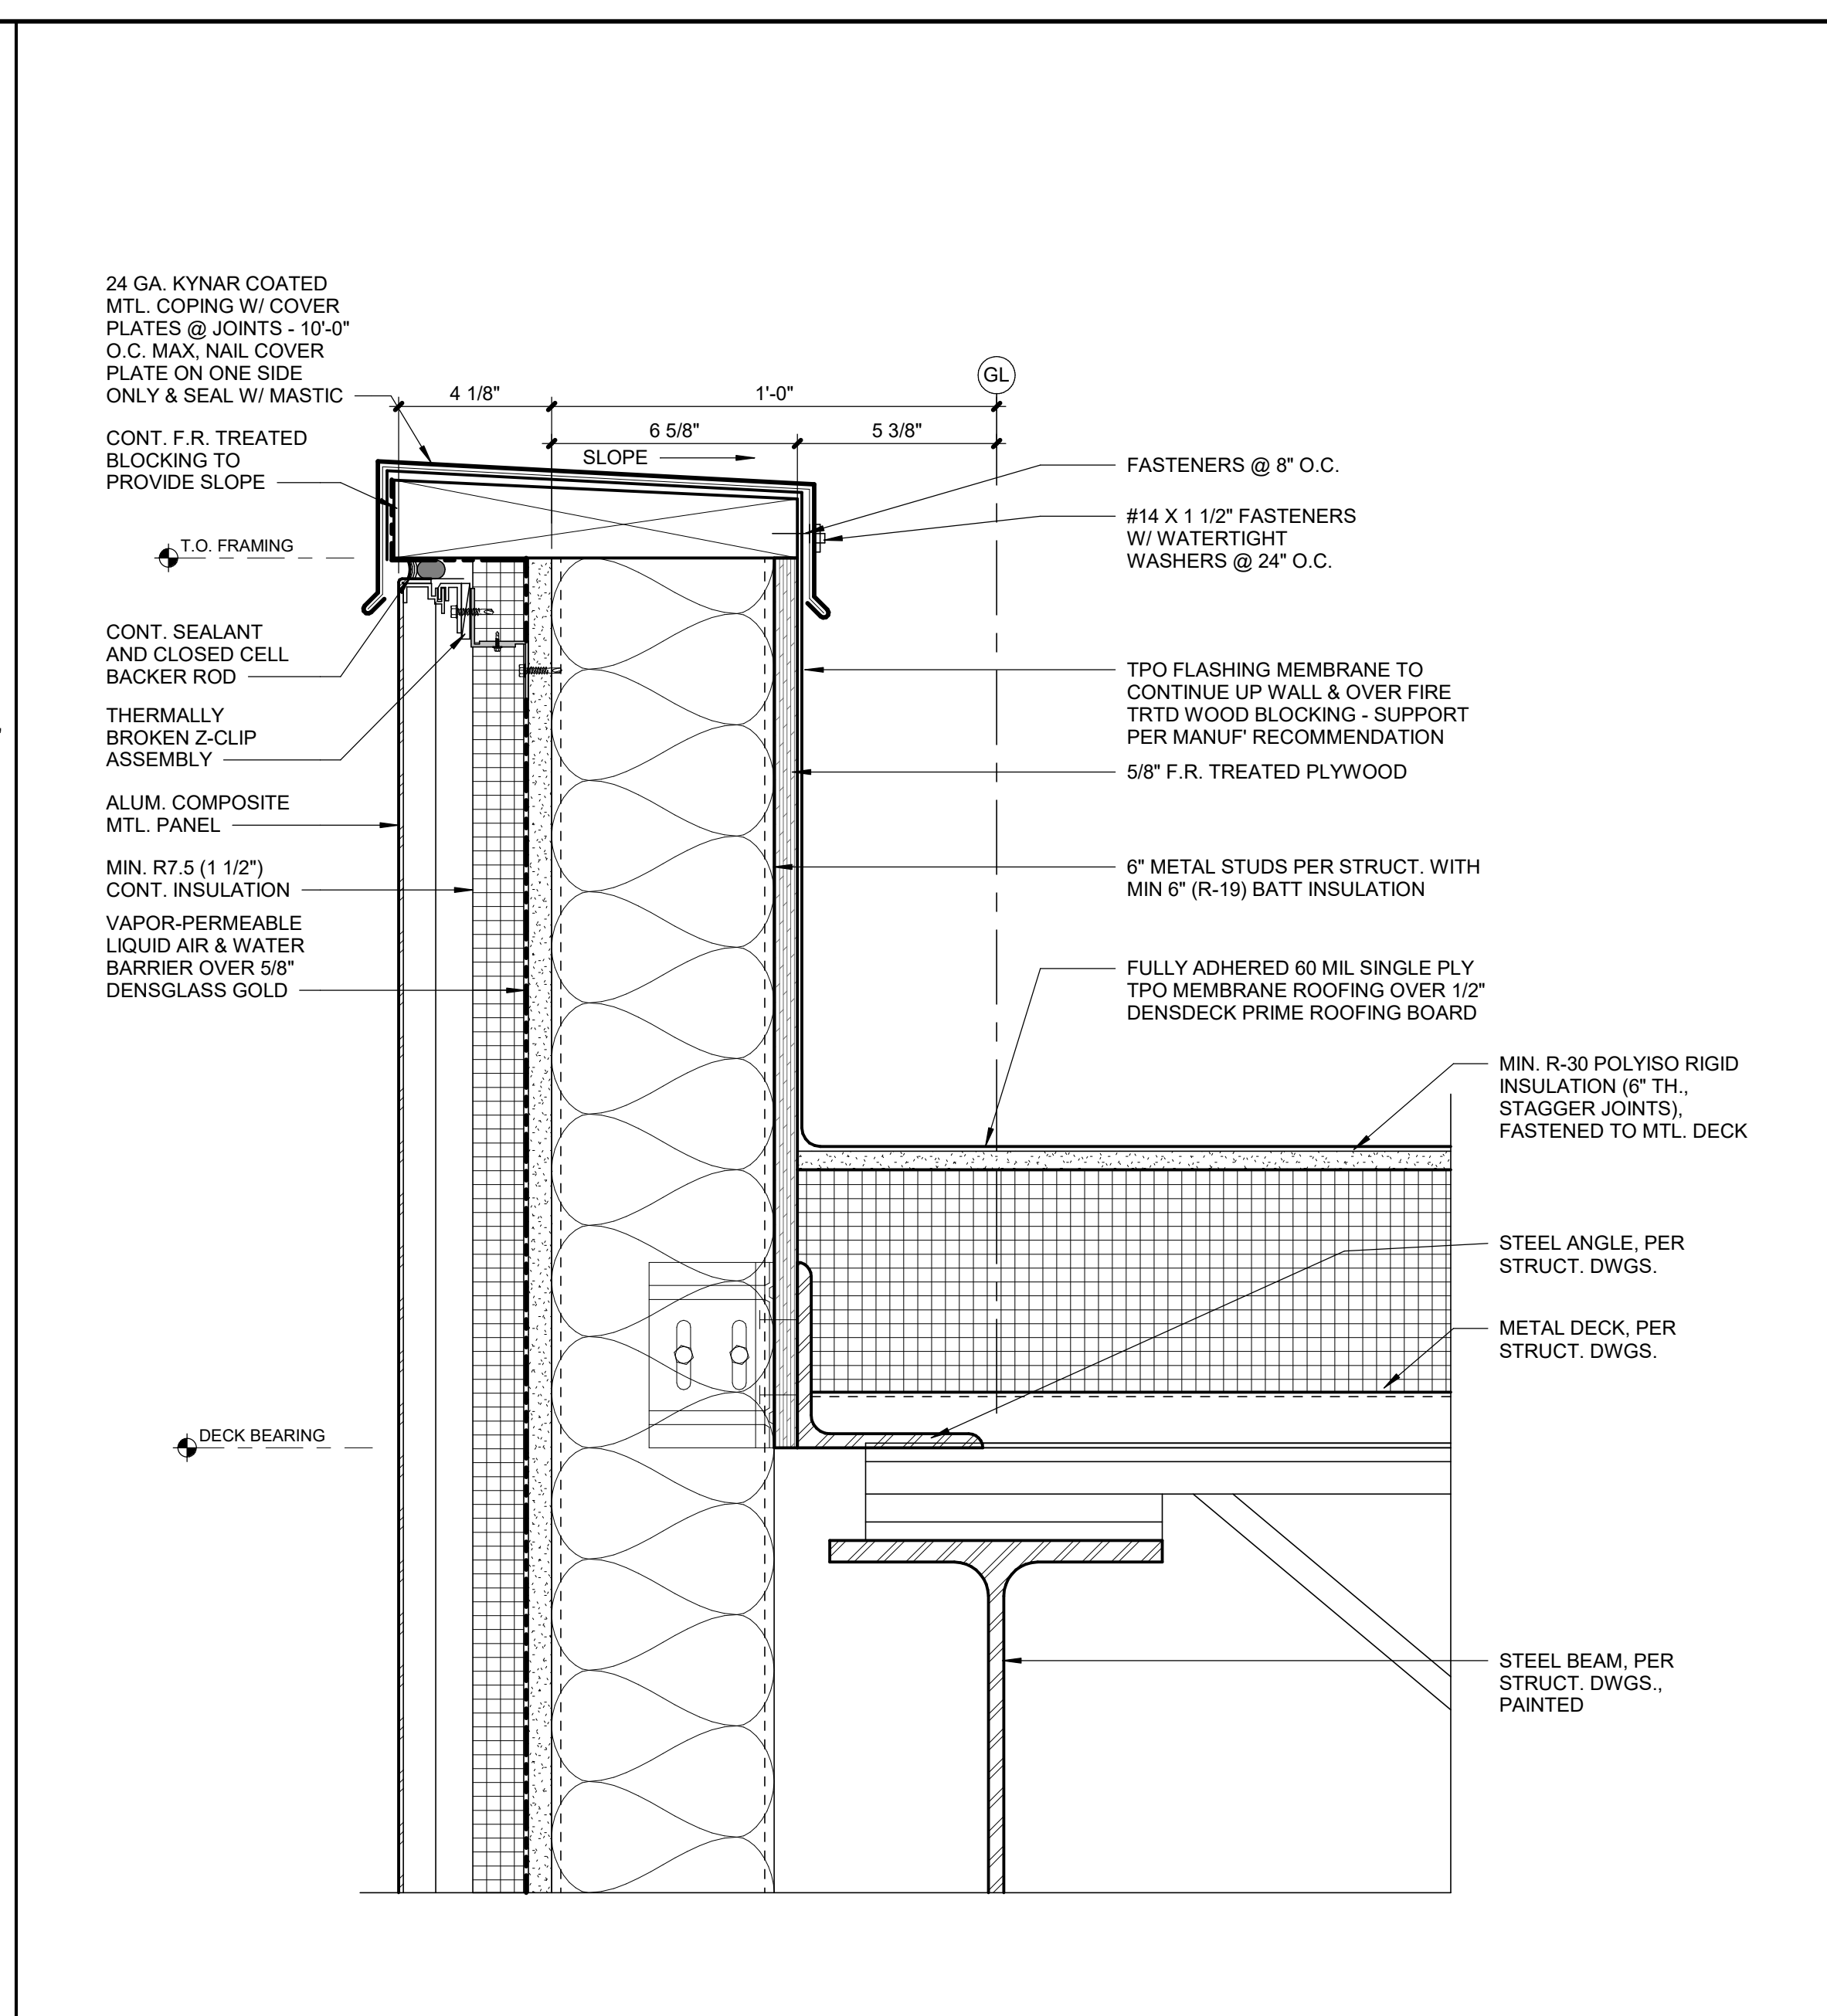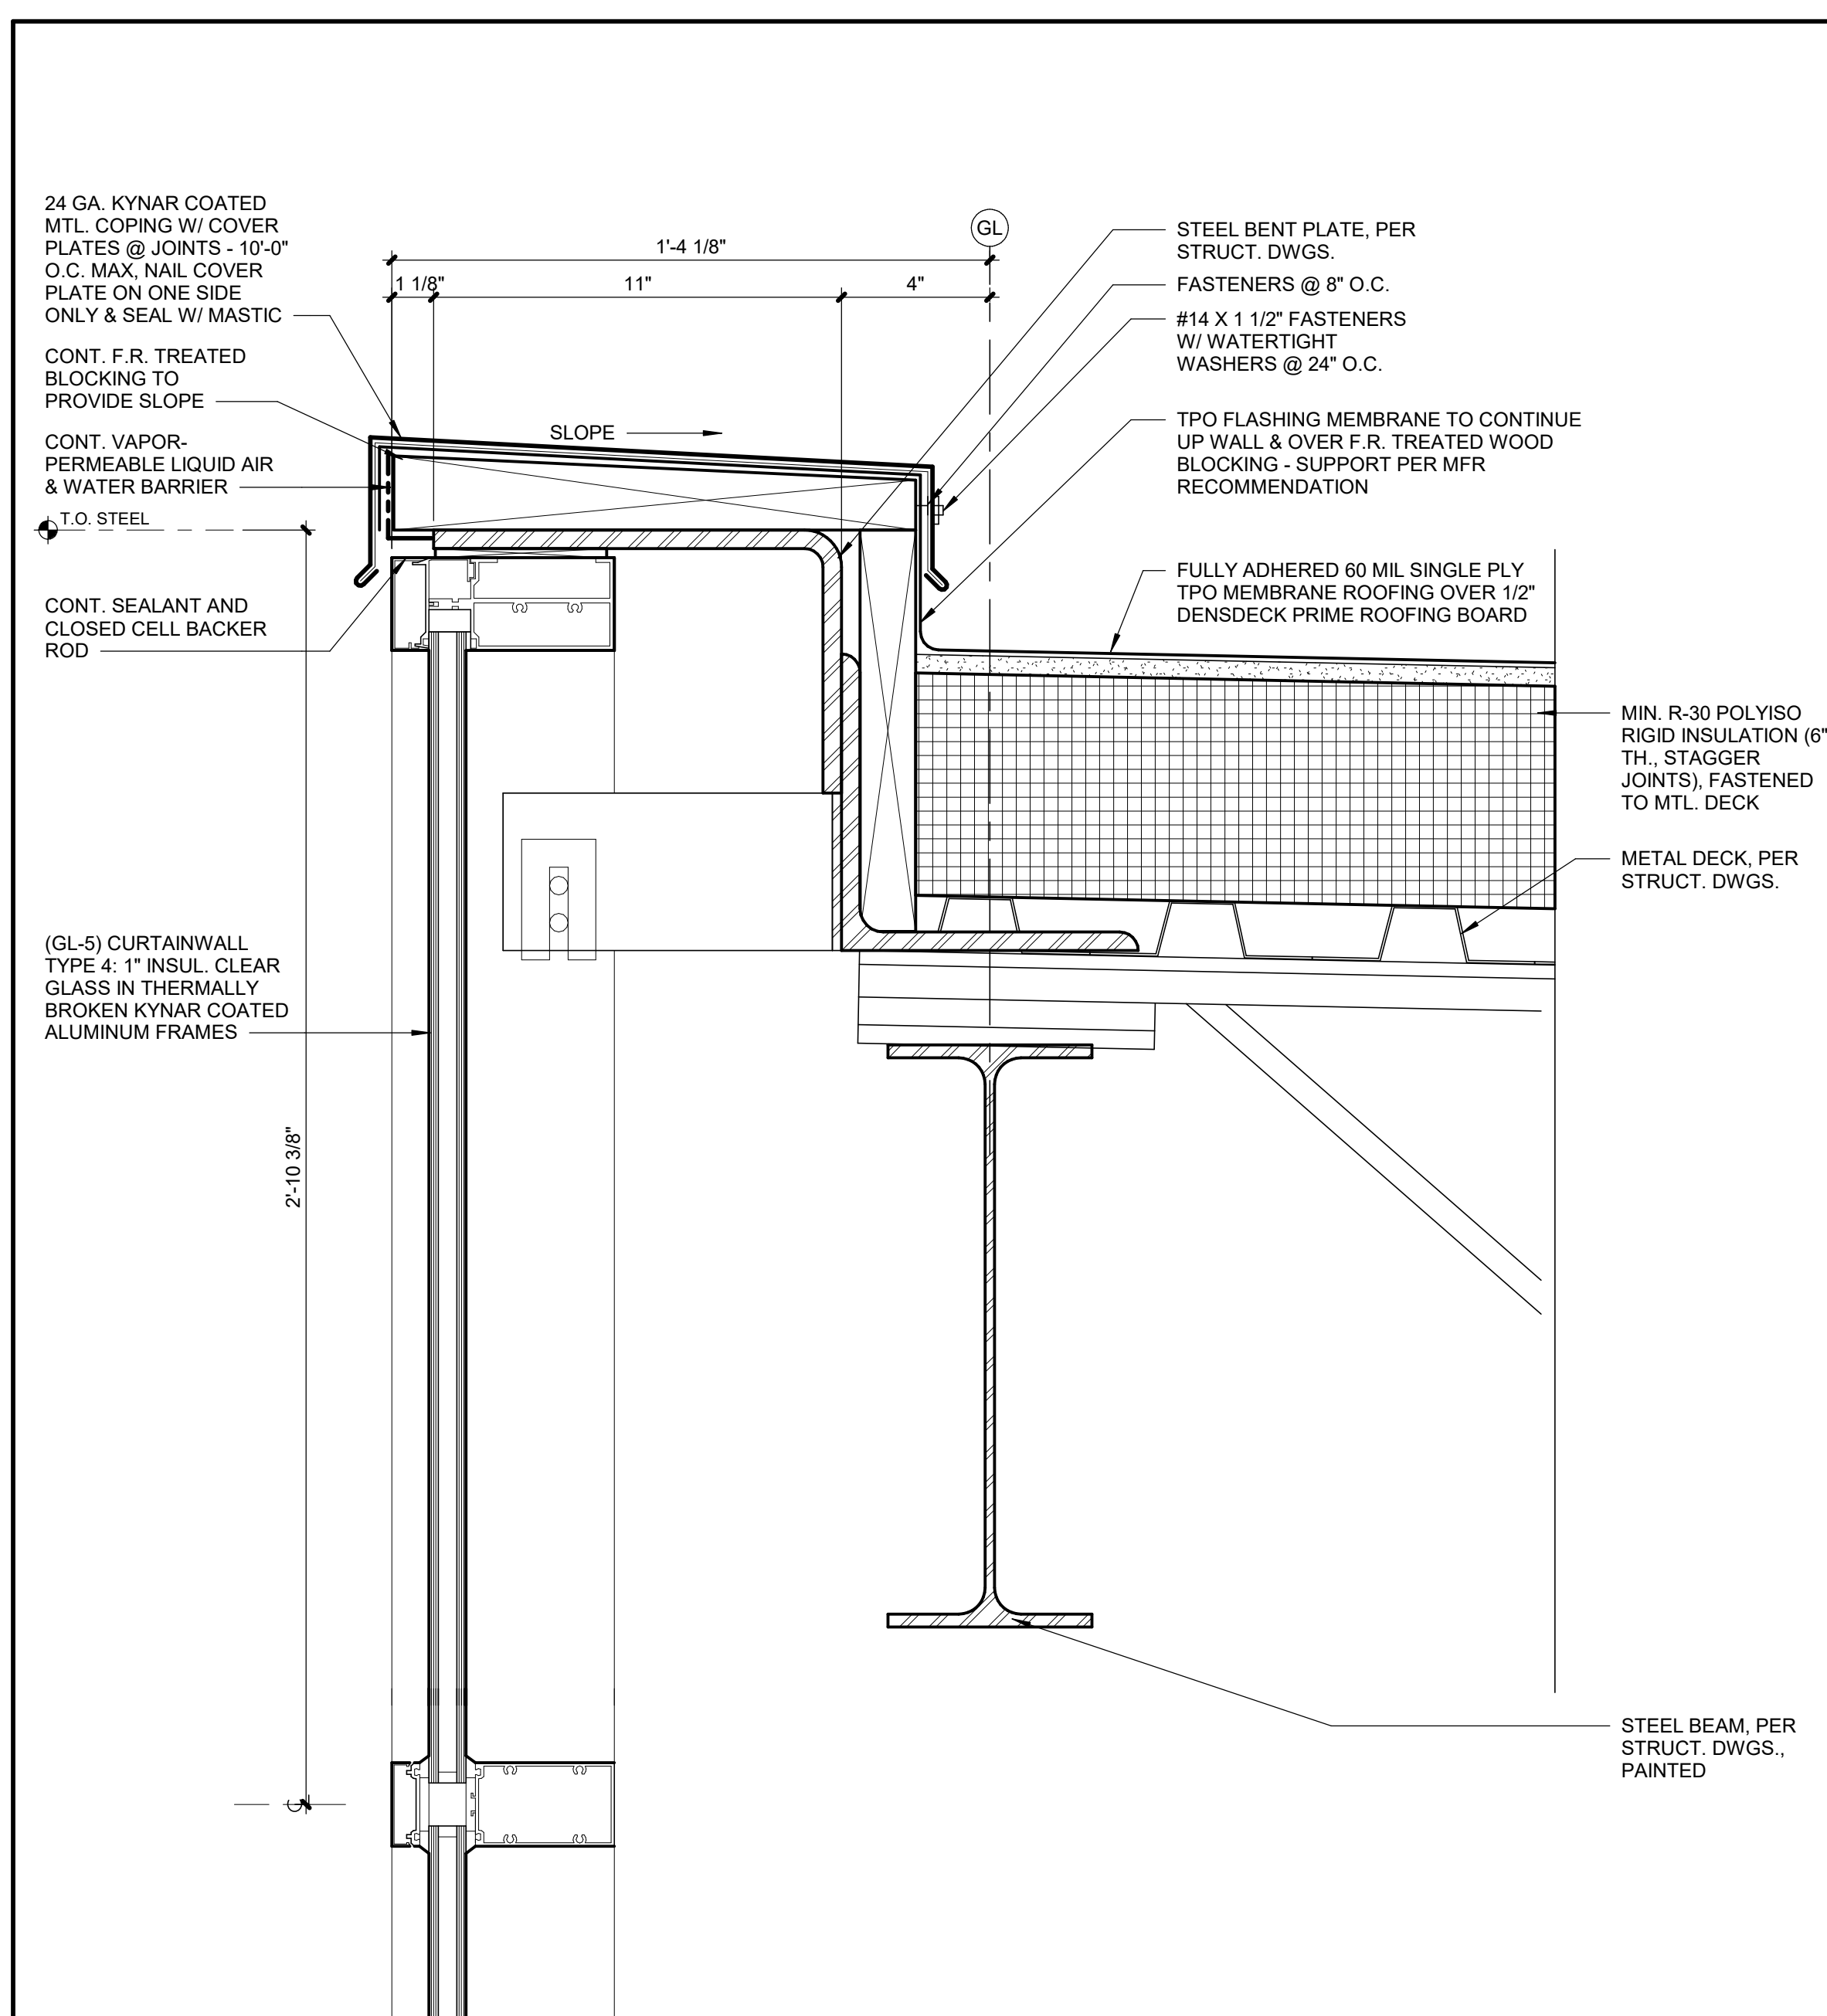

PARAGON STAR  
- LOT 9 -  
BUILDING 2

PARAGON STAR  
FIRST PLAT, LOT 9  
LEE'S SUMMIT, MO

Project No.: 19050.01

Date: 10.25.19

Issued For: SHELL - CD SET


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REGISTRATION



|   |             |
|---|-------------|
| 6 | ROOF DETAIL |
|---|-------------|

|              |                    |
|--------------|--------------------|
| <b>A7.04</b> | SCALE : 3" = 1'-0" |
|--------------|--------------------|

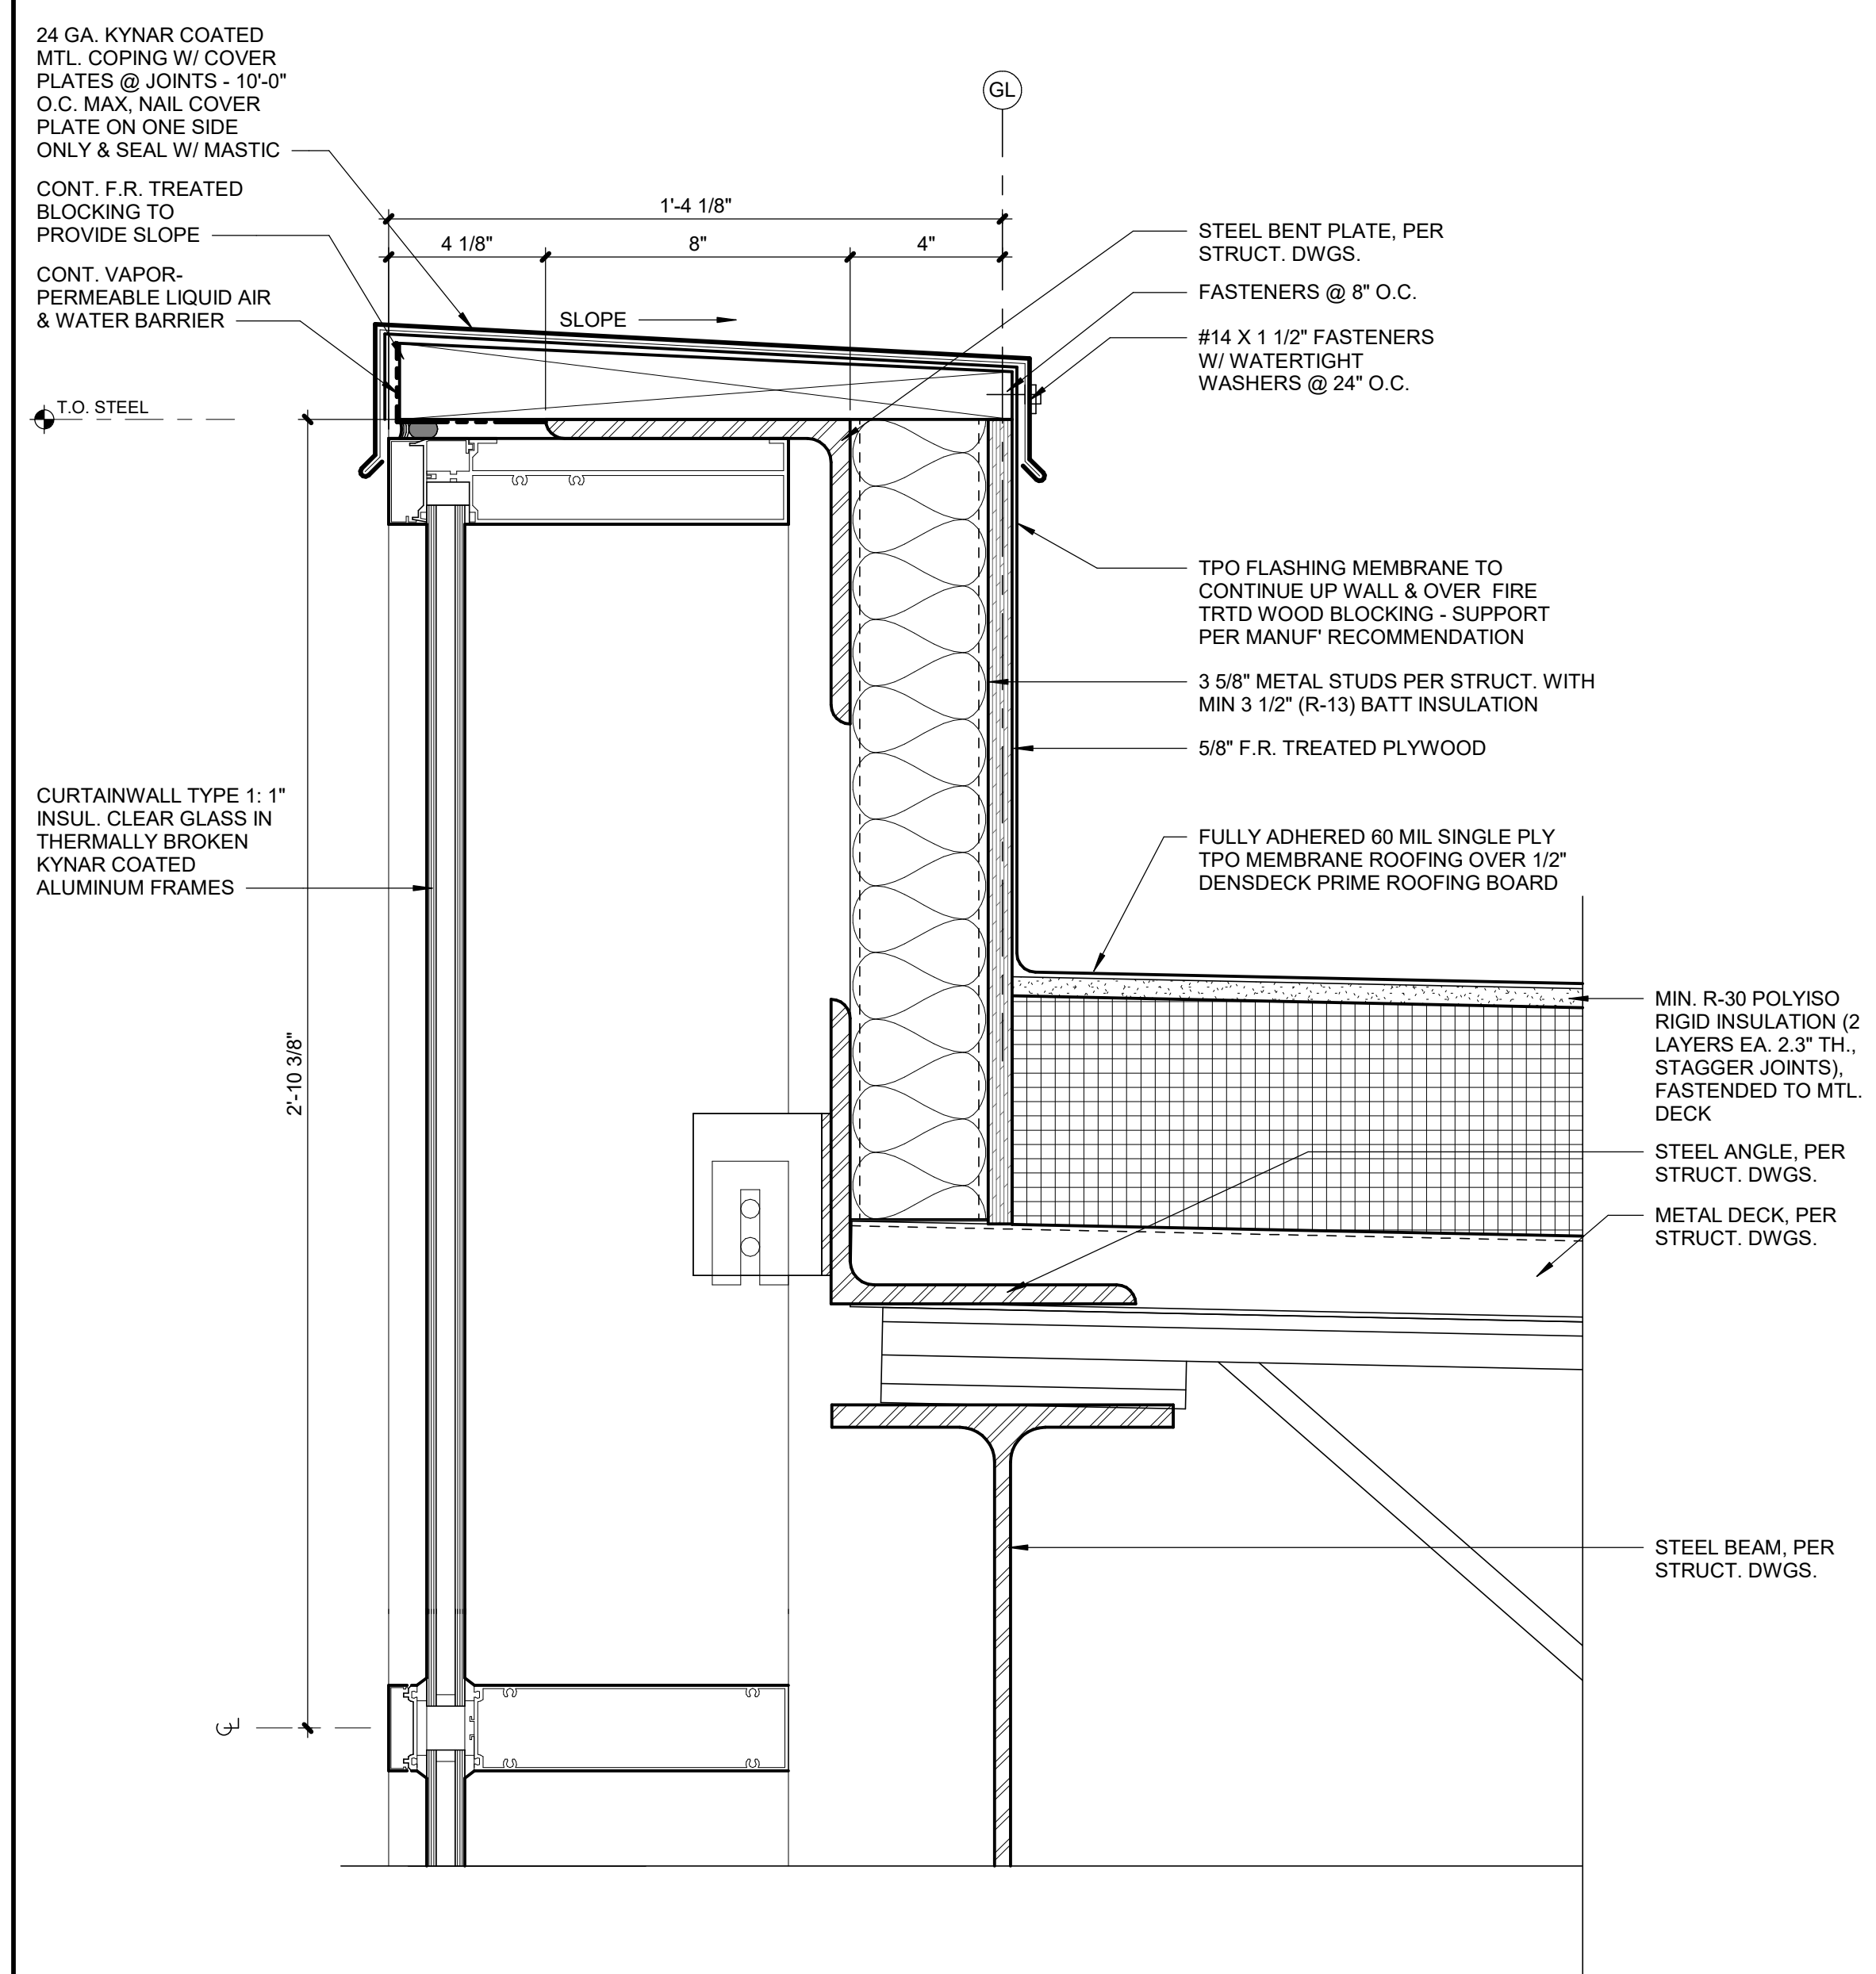


|   |                               |
|---|-------------------------------|
| 5 | ROOF EDGE DETAIL - CLERESTORY |
|---|-------------------------------|

|              |                    |
|--------------|--------------------|
| <b>A7.04</b> | SCALE : 3" = 1'-0" |
|--------------|--------------------|

|   |        |
|---|--------|
| 4 | DETAIL |
|---|--------|

|              |                    |
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| <b>A7.04</b> | SCALE : 3" = 1'-0" |
|--------------|--------------------|

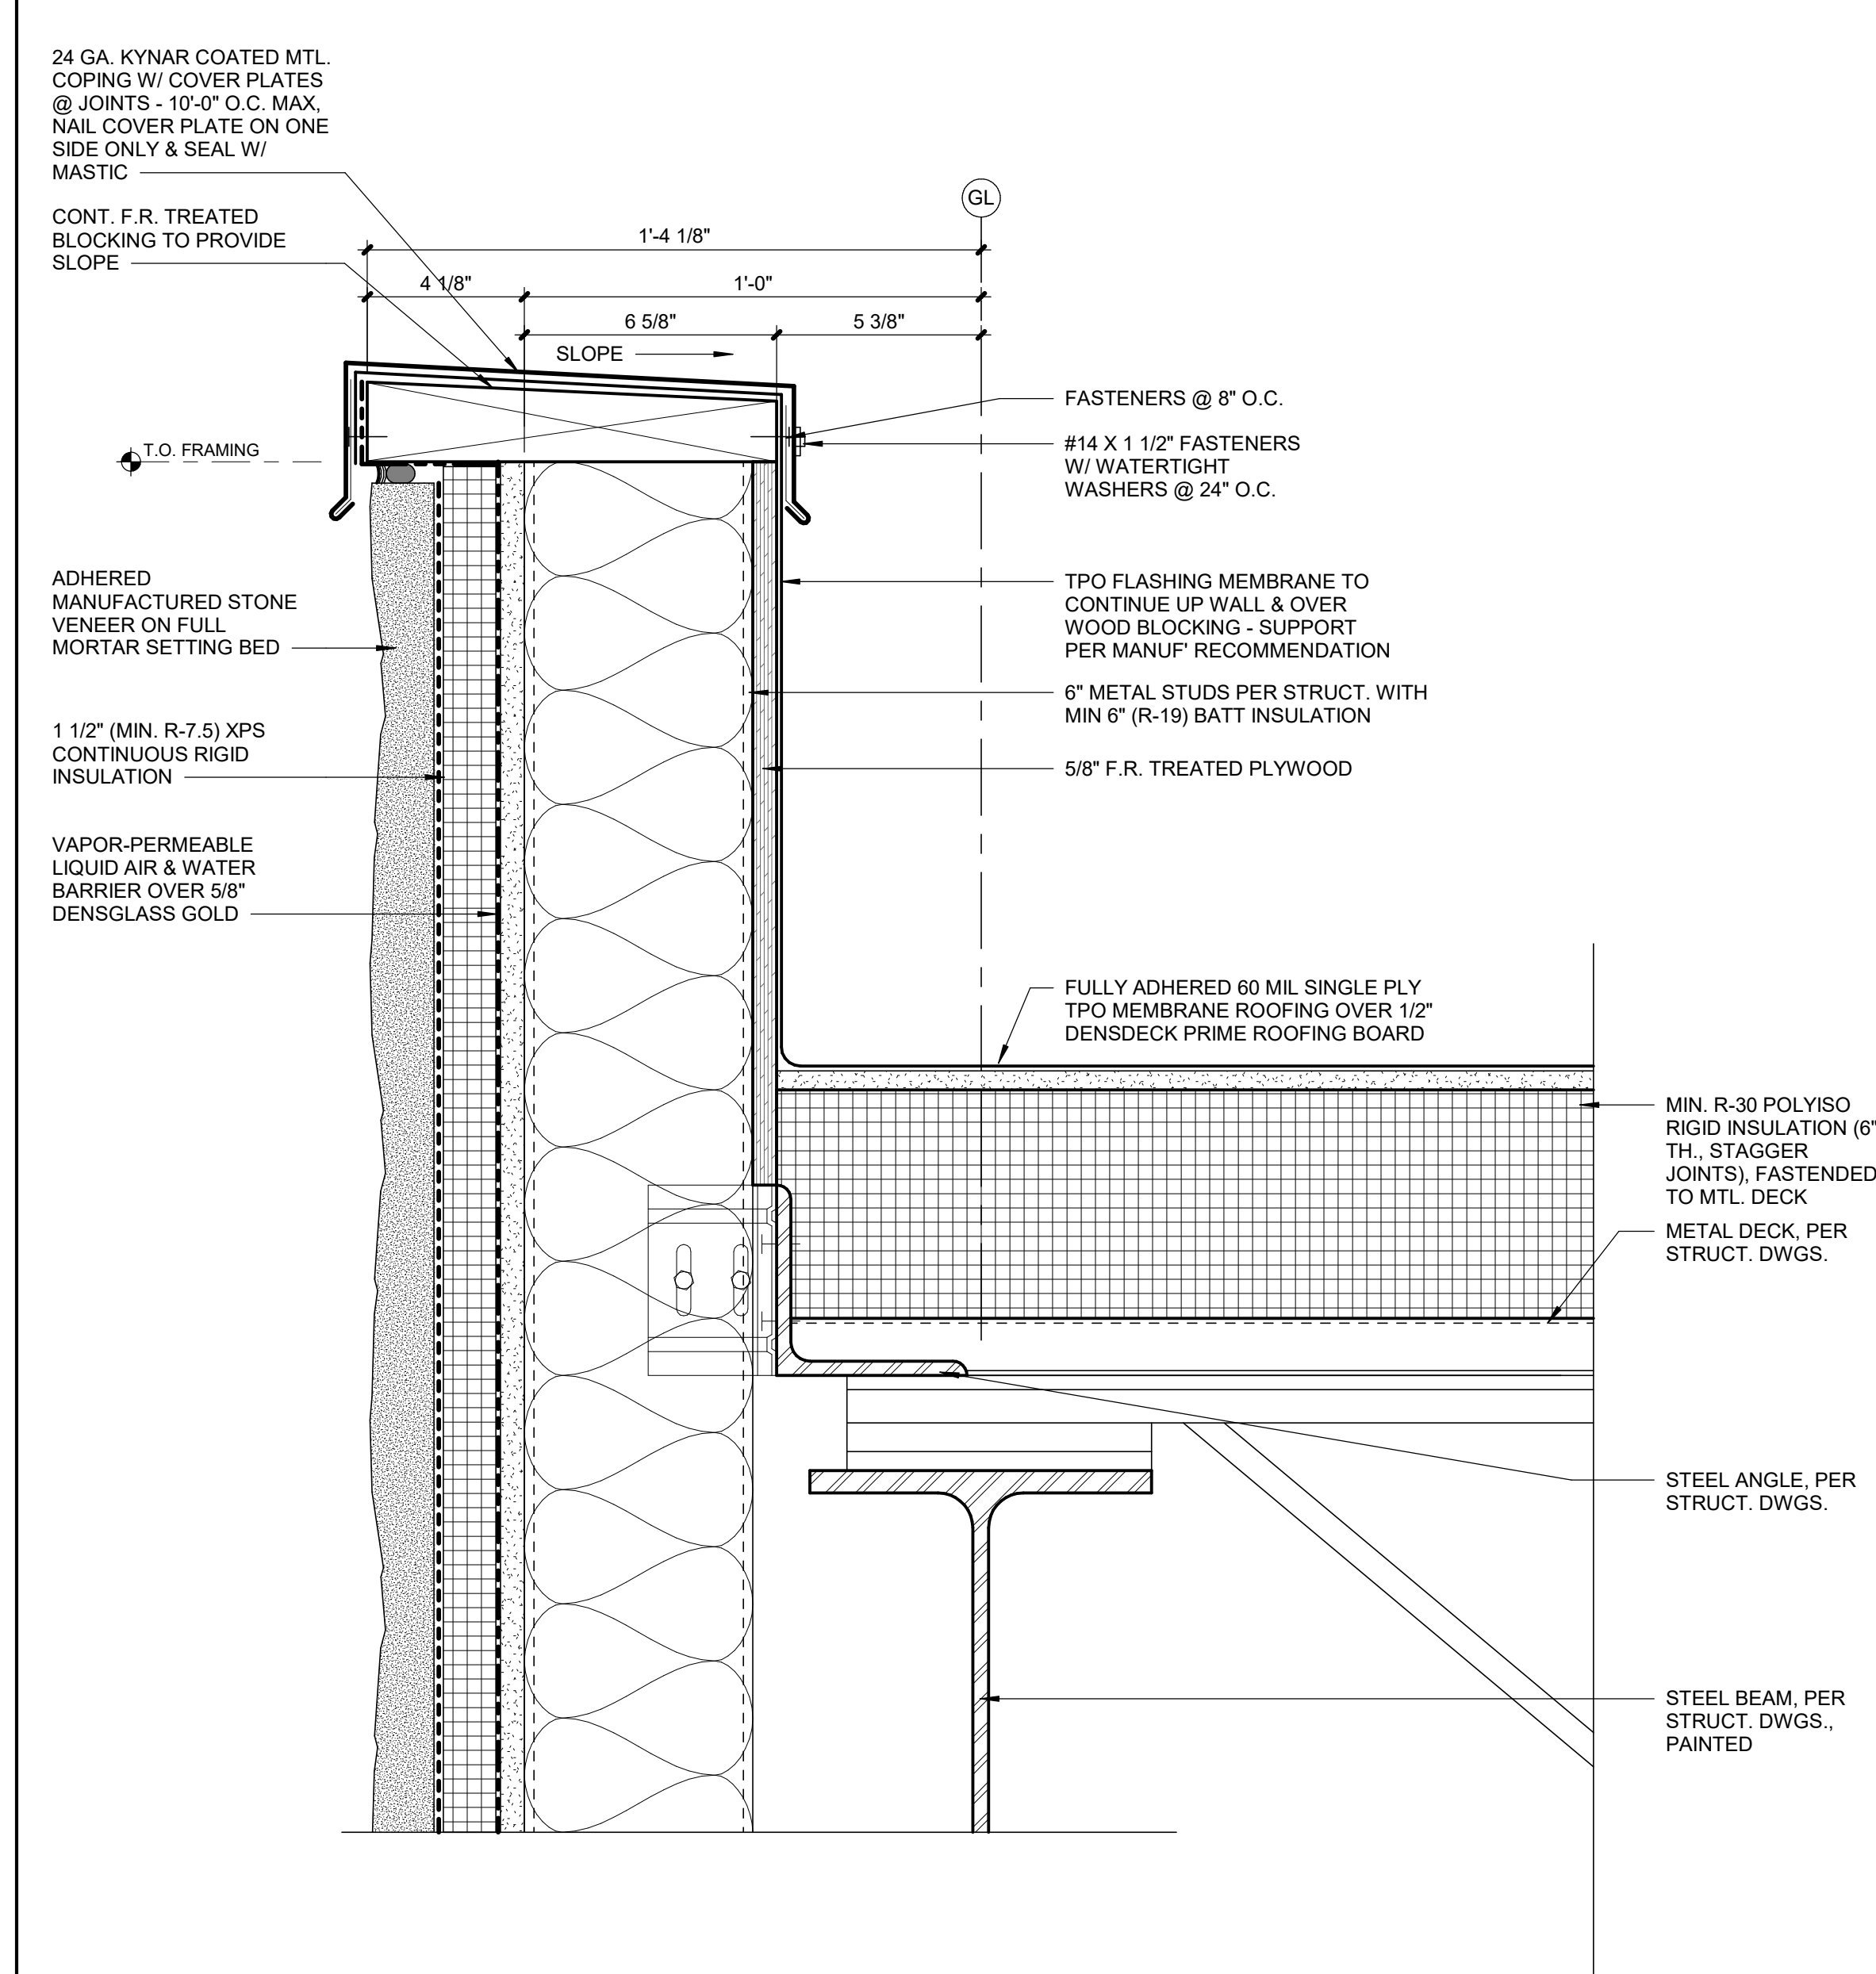


|   |             |
|---|-------------|
| 3 | ROOF DETAIL |
|---|-------------|

|              |                    |
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| <b>A7.04</b> | SCALE : 3" = 1'-0" |
|--------------|--------------------|

|   |             |
|---|-------------|
| 2 | ROOF DETAIL |
|---|-------------|

|              |                    |
|--------------|--------------------|
| <b>A7.04</b> | SCALE : 3" = 1'-0" |
|--------------|--------------------|

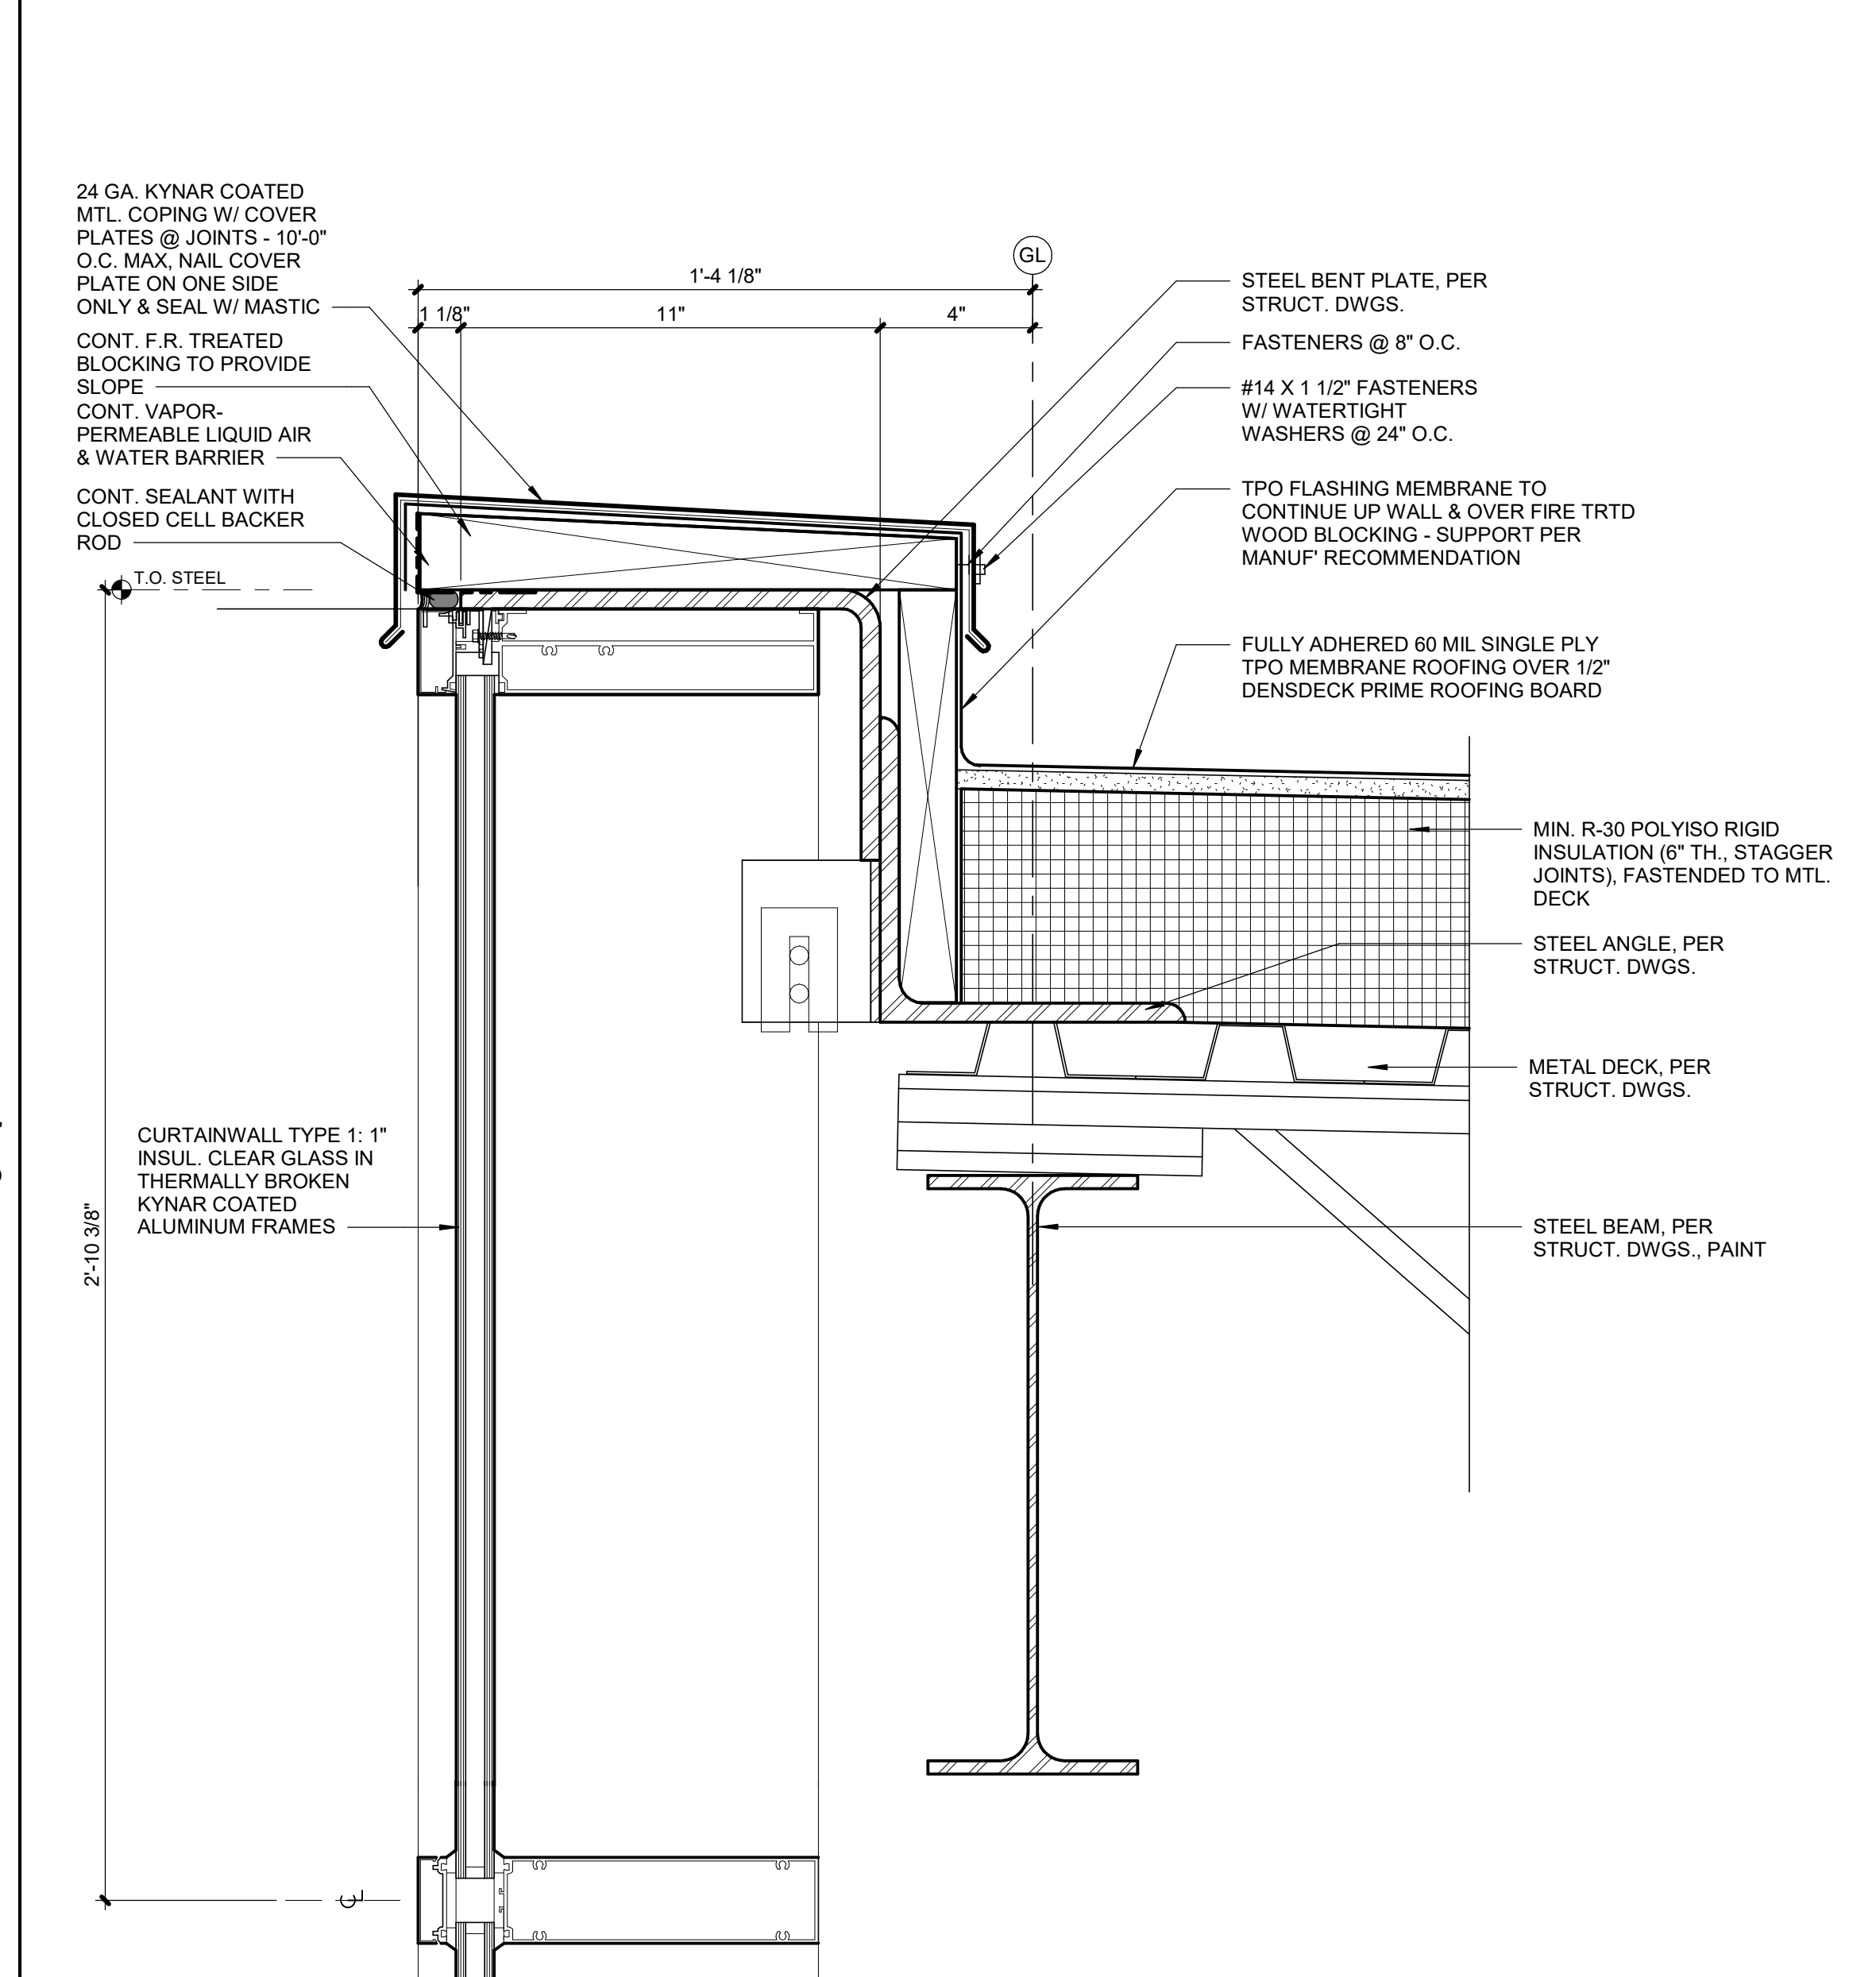

|   |             |
|---|-------------|
| 1 | ROOF DETAIL |
|---|-------------|

|              |                    |
|--------------|--------------------|
| <b>A7.04</b> | SCALE : 3" = 1'-0" |
|--------------|--------------------|

## PROJECT TEAM

|                 |                                  |
|-----------------|----------------------------------|
| ARCHITECT       | FINKLE- WILLIAMS<br>ARCHITECTURE |
| CIVIL           | G&A                              |
| LANDSCAPE       | HOERR SCHAUDT /<br>LAND3         |
| FOUNDATIONS     | BSE STRUCTURAL<br>ENGINEERS      |
| STRUCTURAL      | BSE STRUCTURAL<br>ENGINEERS      |
| PLUMBING        | HENDERSON<br>ENGINEERS           |
| MECHANICAL      | HENDERSON<br>ENGINEERS           |
| ELECTRICAL      | HENDERSON<br>ENGINEERS           |
| FIRE PROTECTION | HENDERSON<br>ENGINEERS           |
| CONTRACTOR      | FOGEL ANDERSON                   |



FINKLE + WILLIAMS  
ARCHITECTURE

7007 College Blvd, Suite 415  
Overland Park, Kansas 66211  
913+498-1550







SHEET TITLE

## DETAILS

SHEET NUMBER

## A7.04



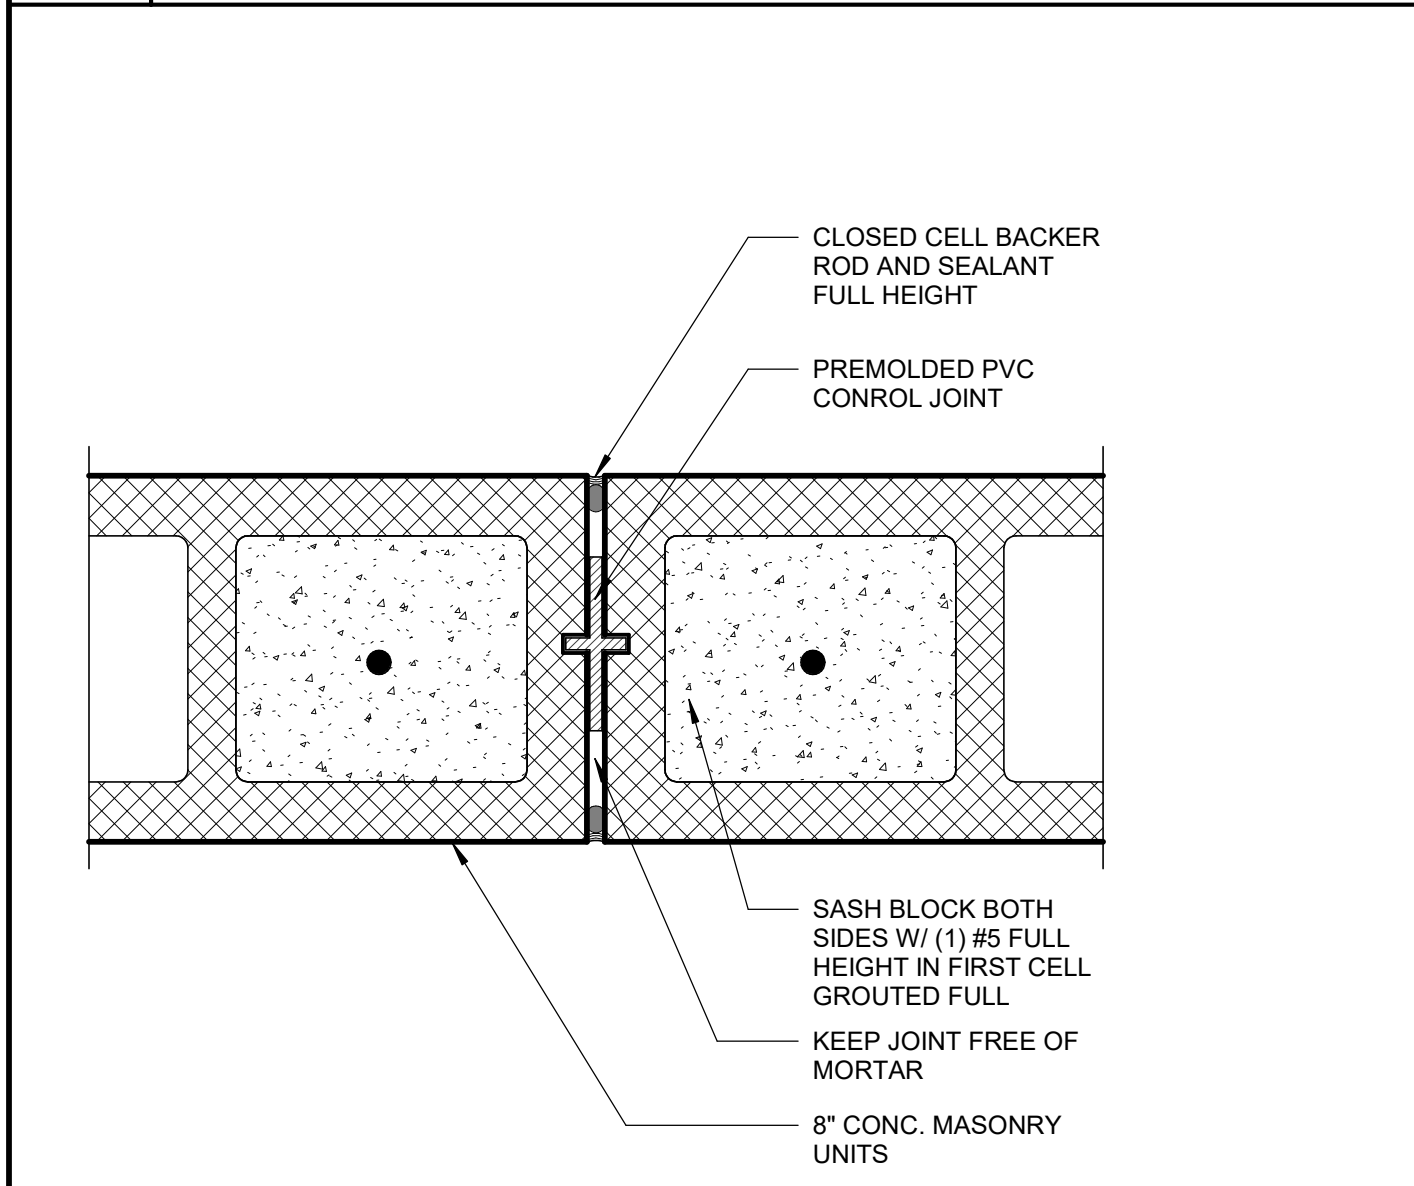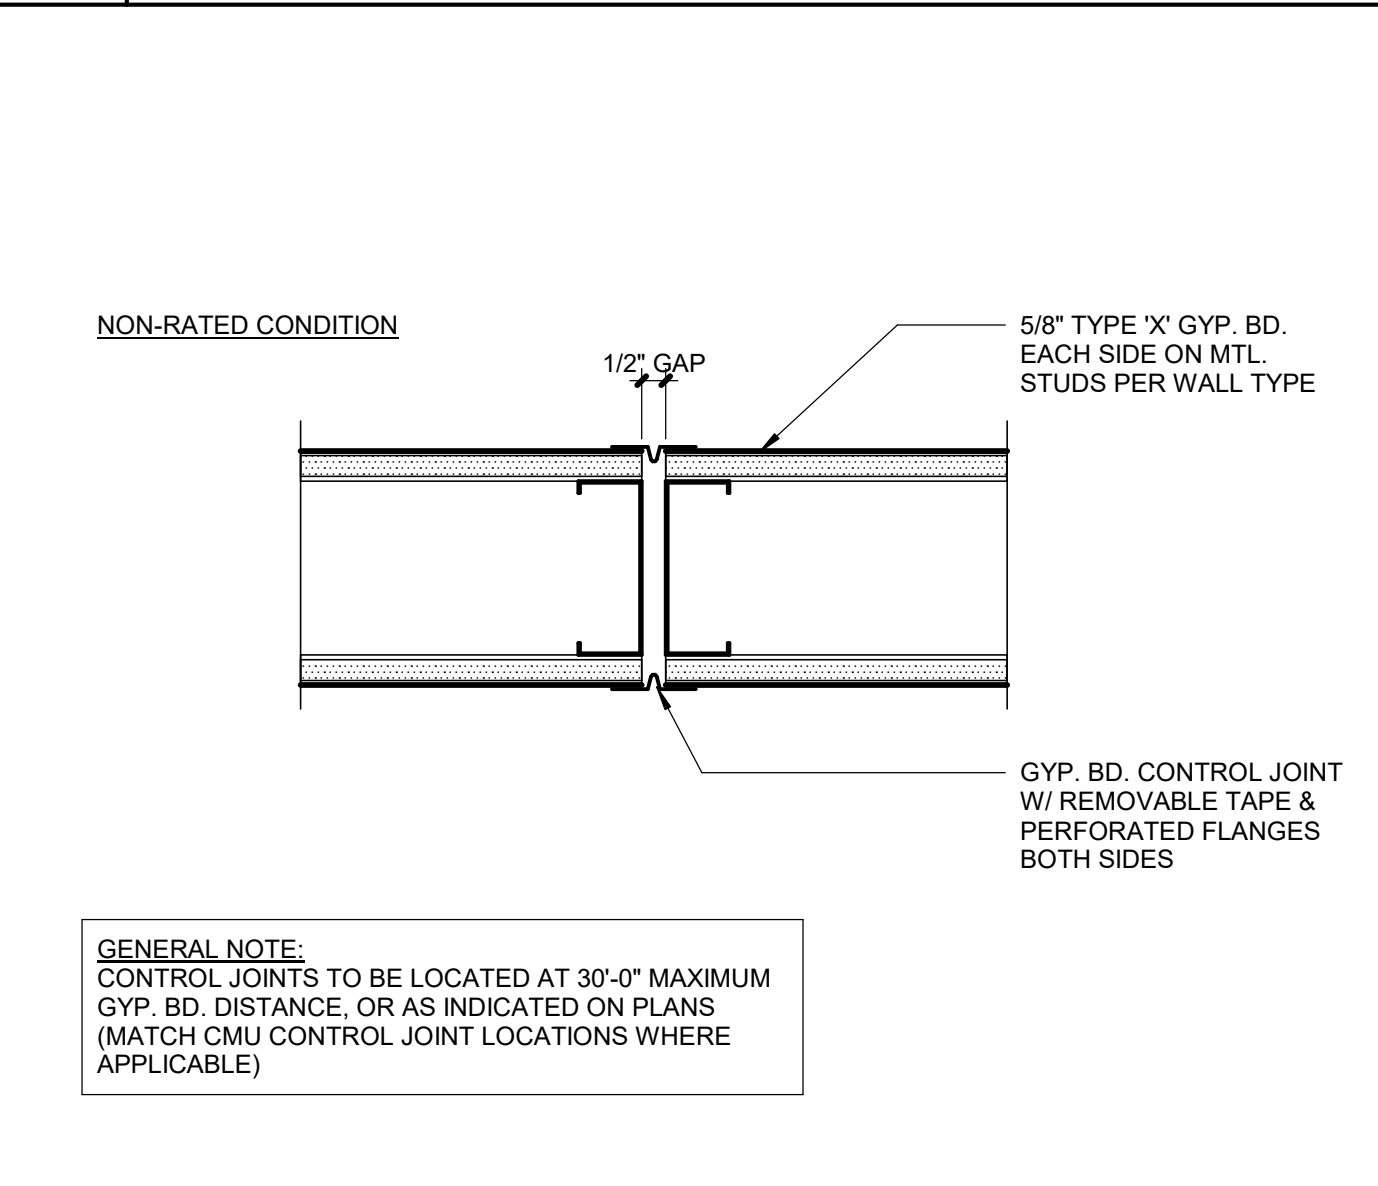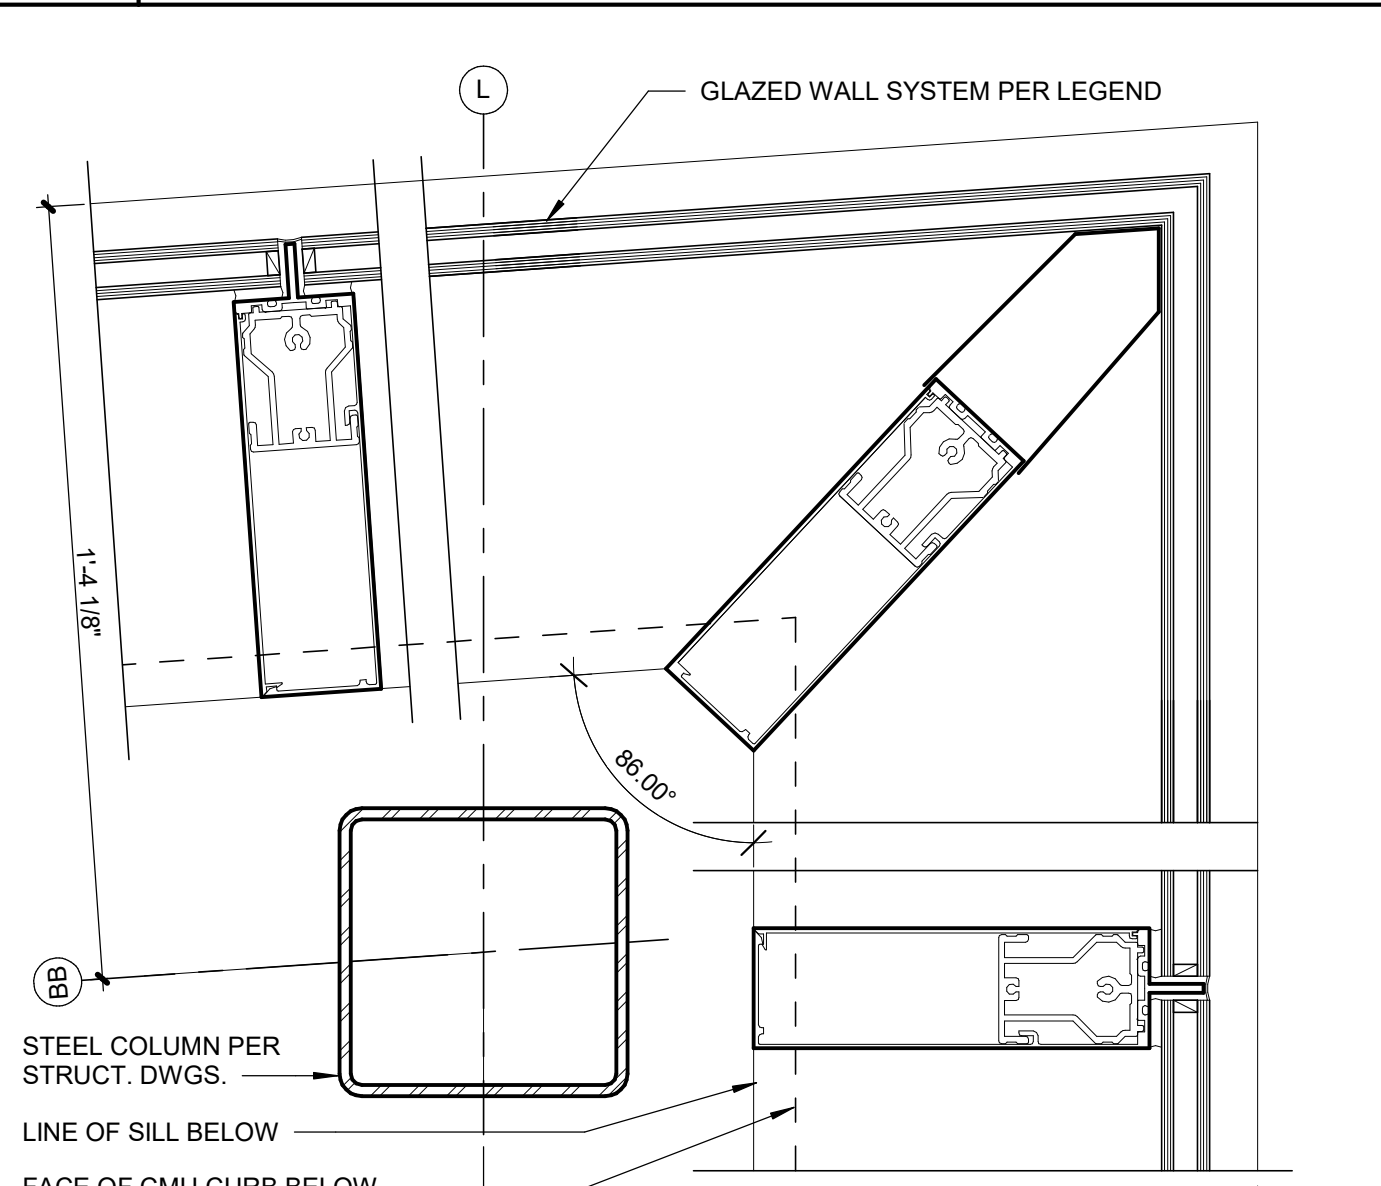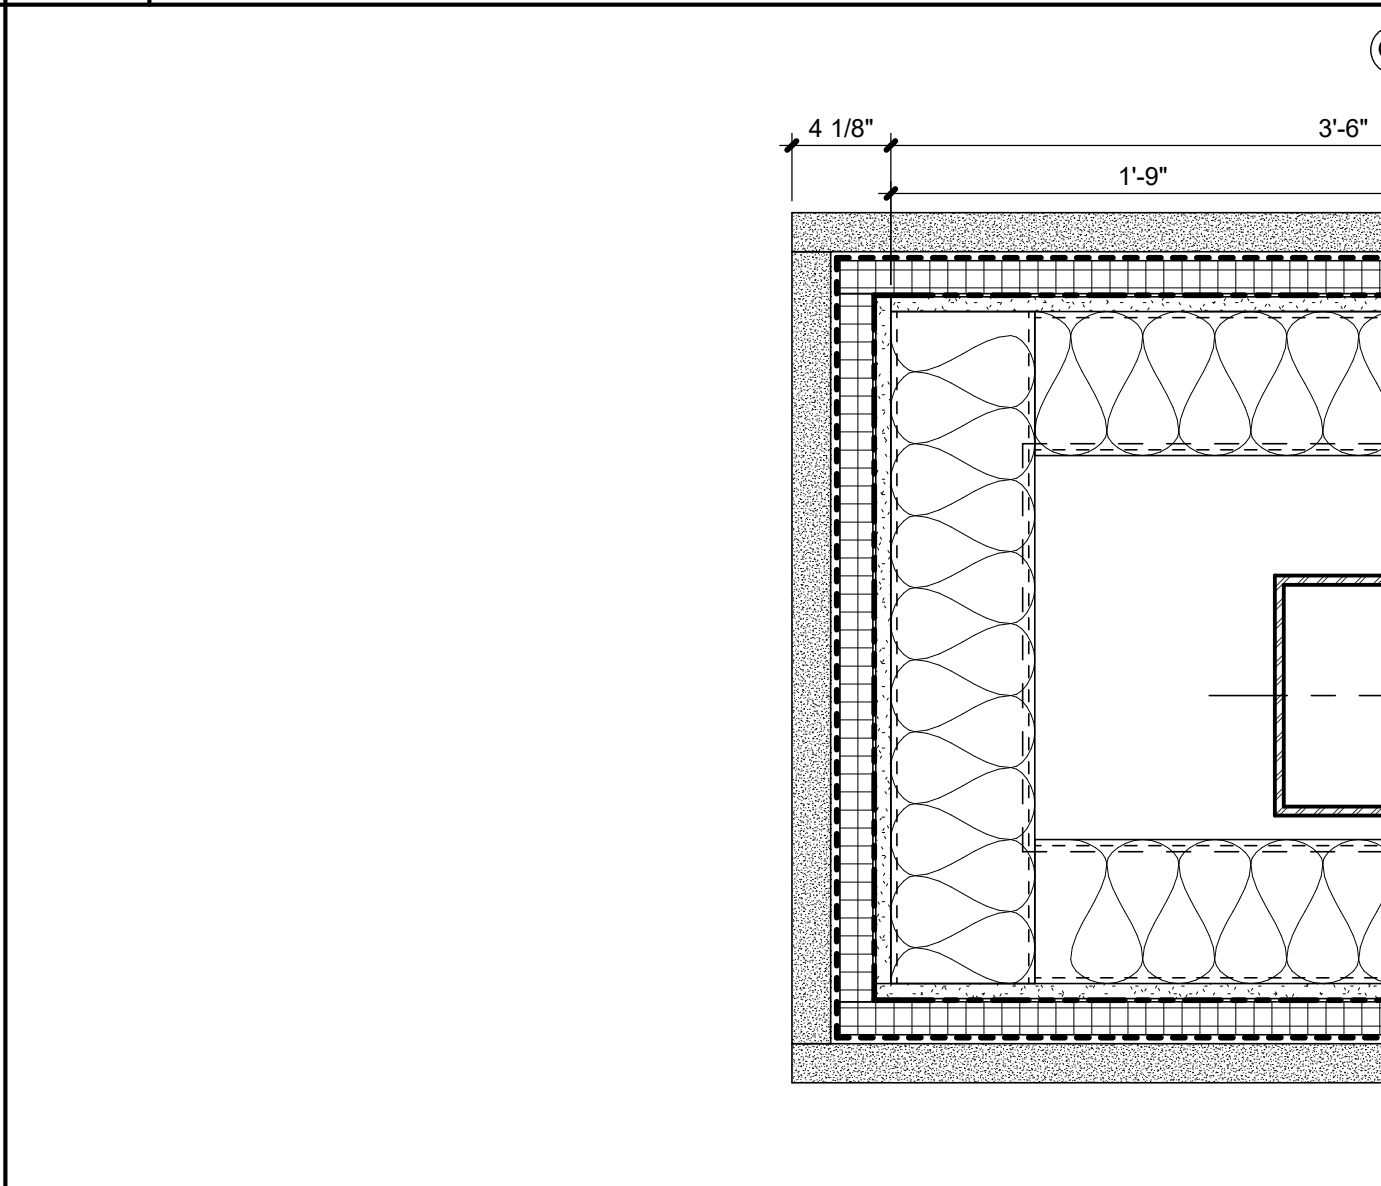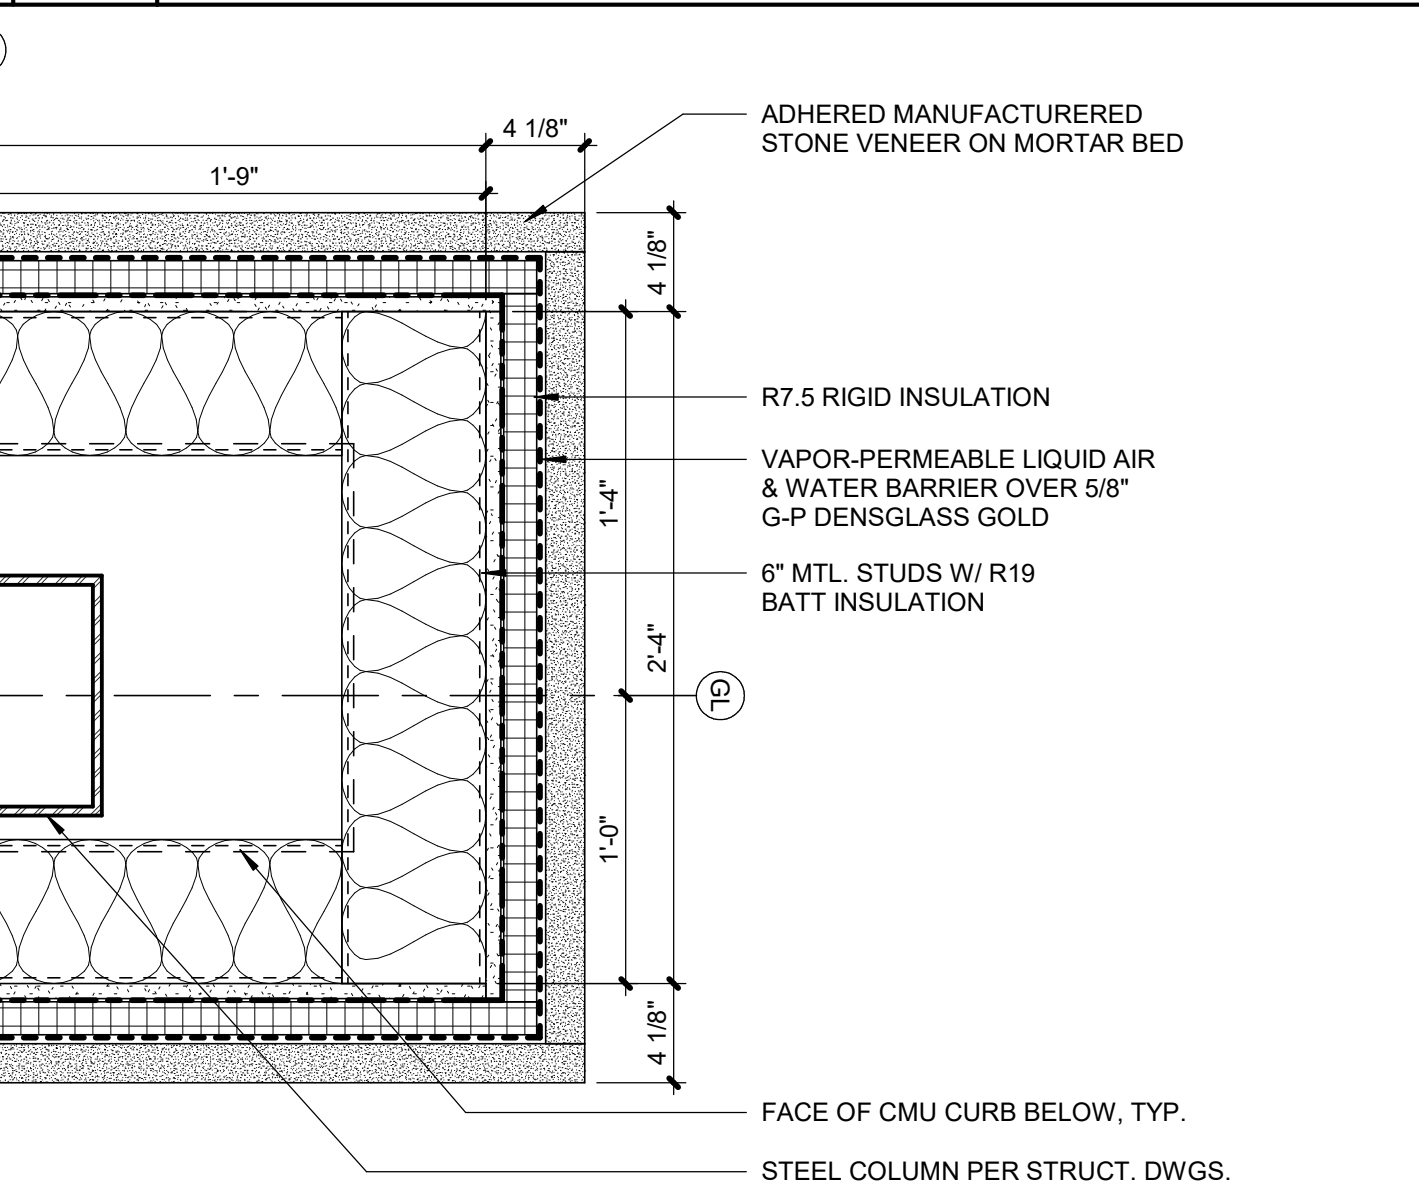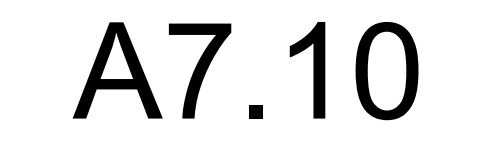





## A7.11


















PARAGON STAR  
FIRST PLAT, LOT 9  
LEE'S SUMMIT, MO

Project No.: 19050.01  
Date: 10.25.19  
Issued For: SHELL - CD SET

[illegible]

## REGISTRATION

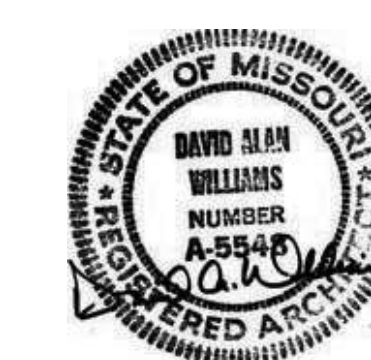

---

PROJECT TEAM

|                 |                                 |
|-----------------|---------------------------------|
| ARCHITECT       | FINKLE+WILLIAMS<br>ARCHITECTURE |
| CIVIL           | GBA                             |
| LANDSCAPE       | HOERR SCHAUDT /<br>LAND3        |
| FOUNDATIONS     | BSE STRUCTURAL<br>ENGINEERS     |
| STRUCTURAL      | BSE STRUCTURAL<br>ENGINEERS     |
| PLUMBING        | HENDERSON<br>ENGINEERS          |
| MECHANICAL      | HENDERSON<br>ENGINEERS          |
| ELECTRICAL      | HENDERSON<br>ENGINEERS          |
| FIRE PROTECTION | HENDERSON<br>ENGINEERS          |
| CONTRACTOR      | FOGEL ANDERSON                  |



FINKLE + WILLIAMS  
ARCHITECTURE



7007 College Blvd, Suite 415  
Overland Park, Kansas 66211  
913+498-1550

SHEET TITLE

ENLARGED  
FLOOR FINISH  
PLANS


SHEET NUMBER

A8.11

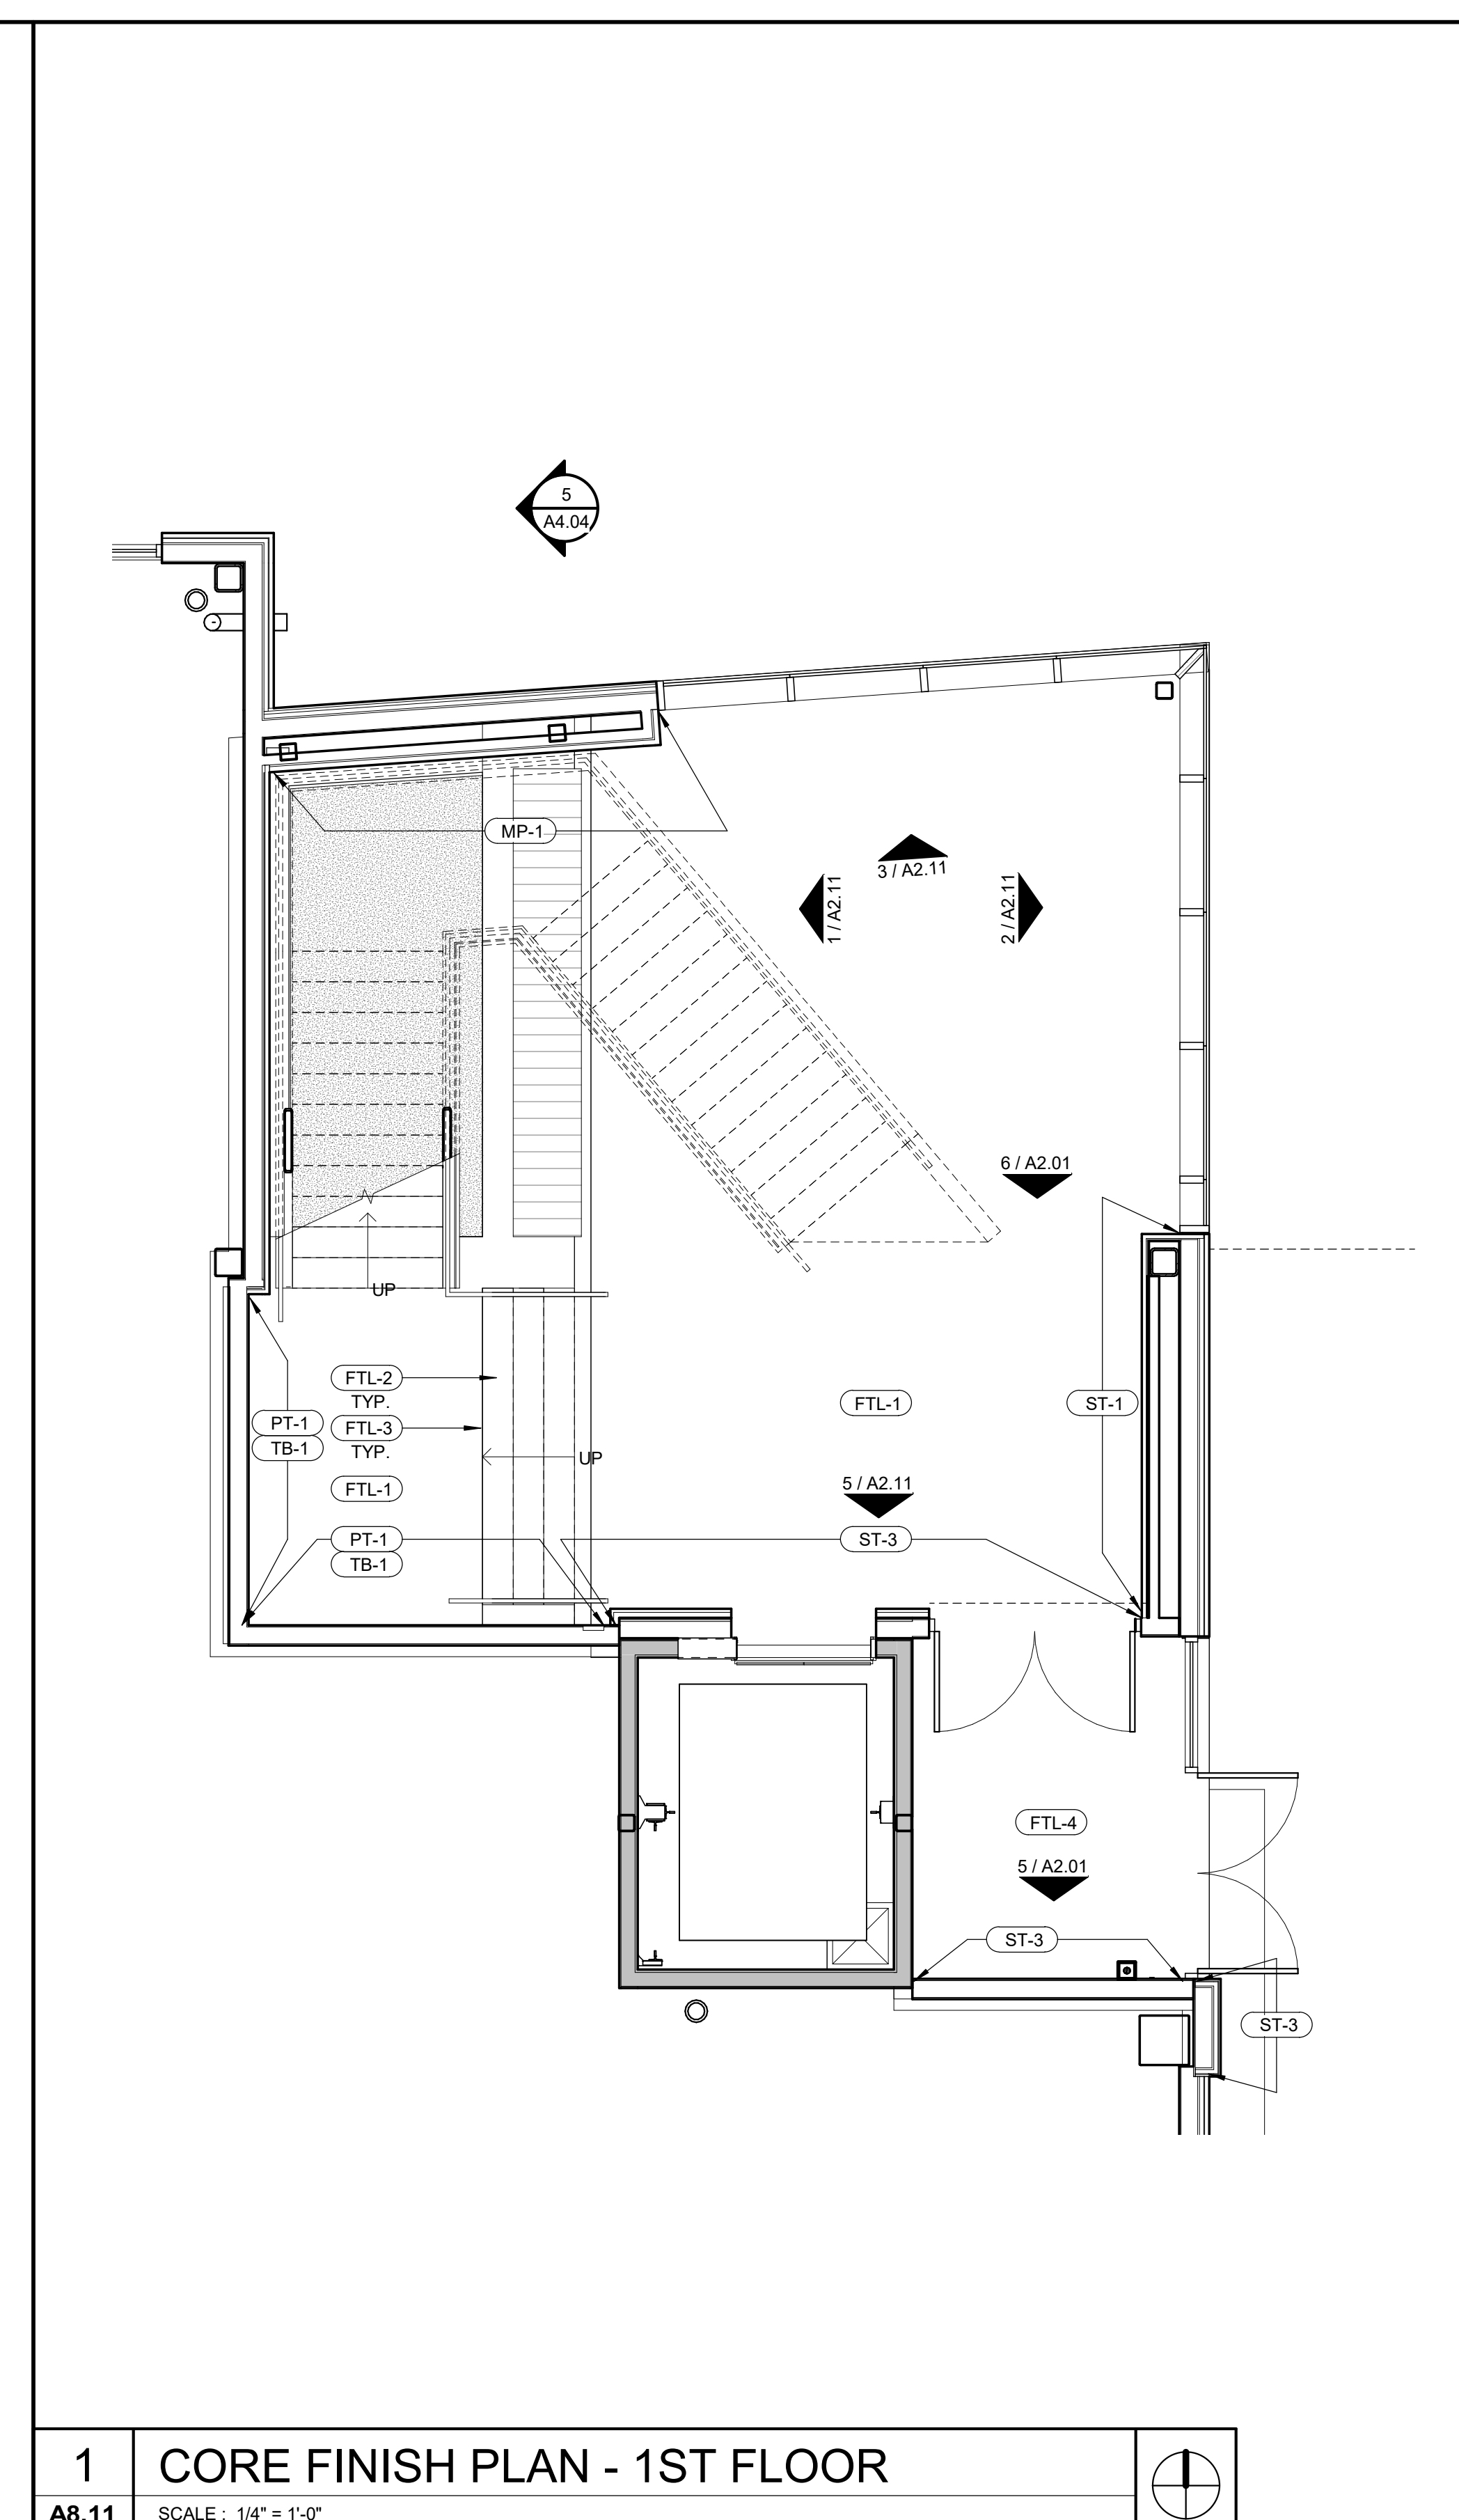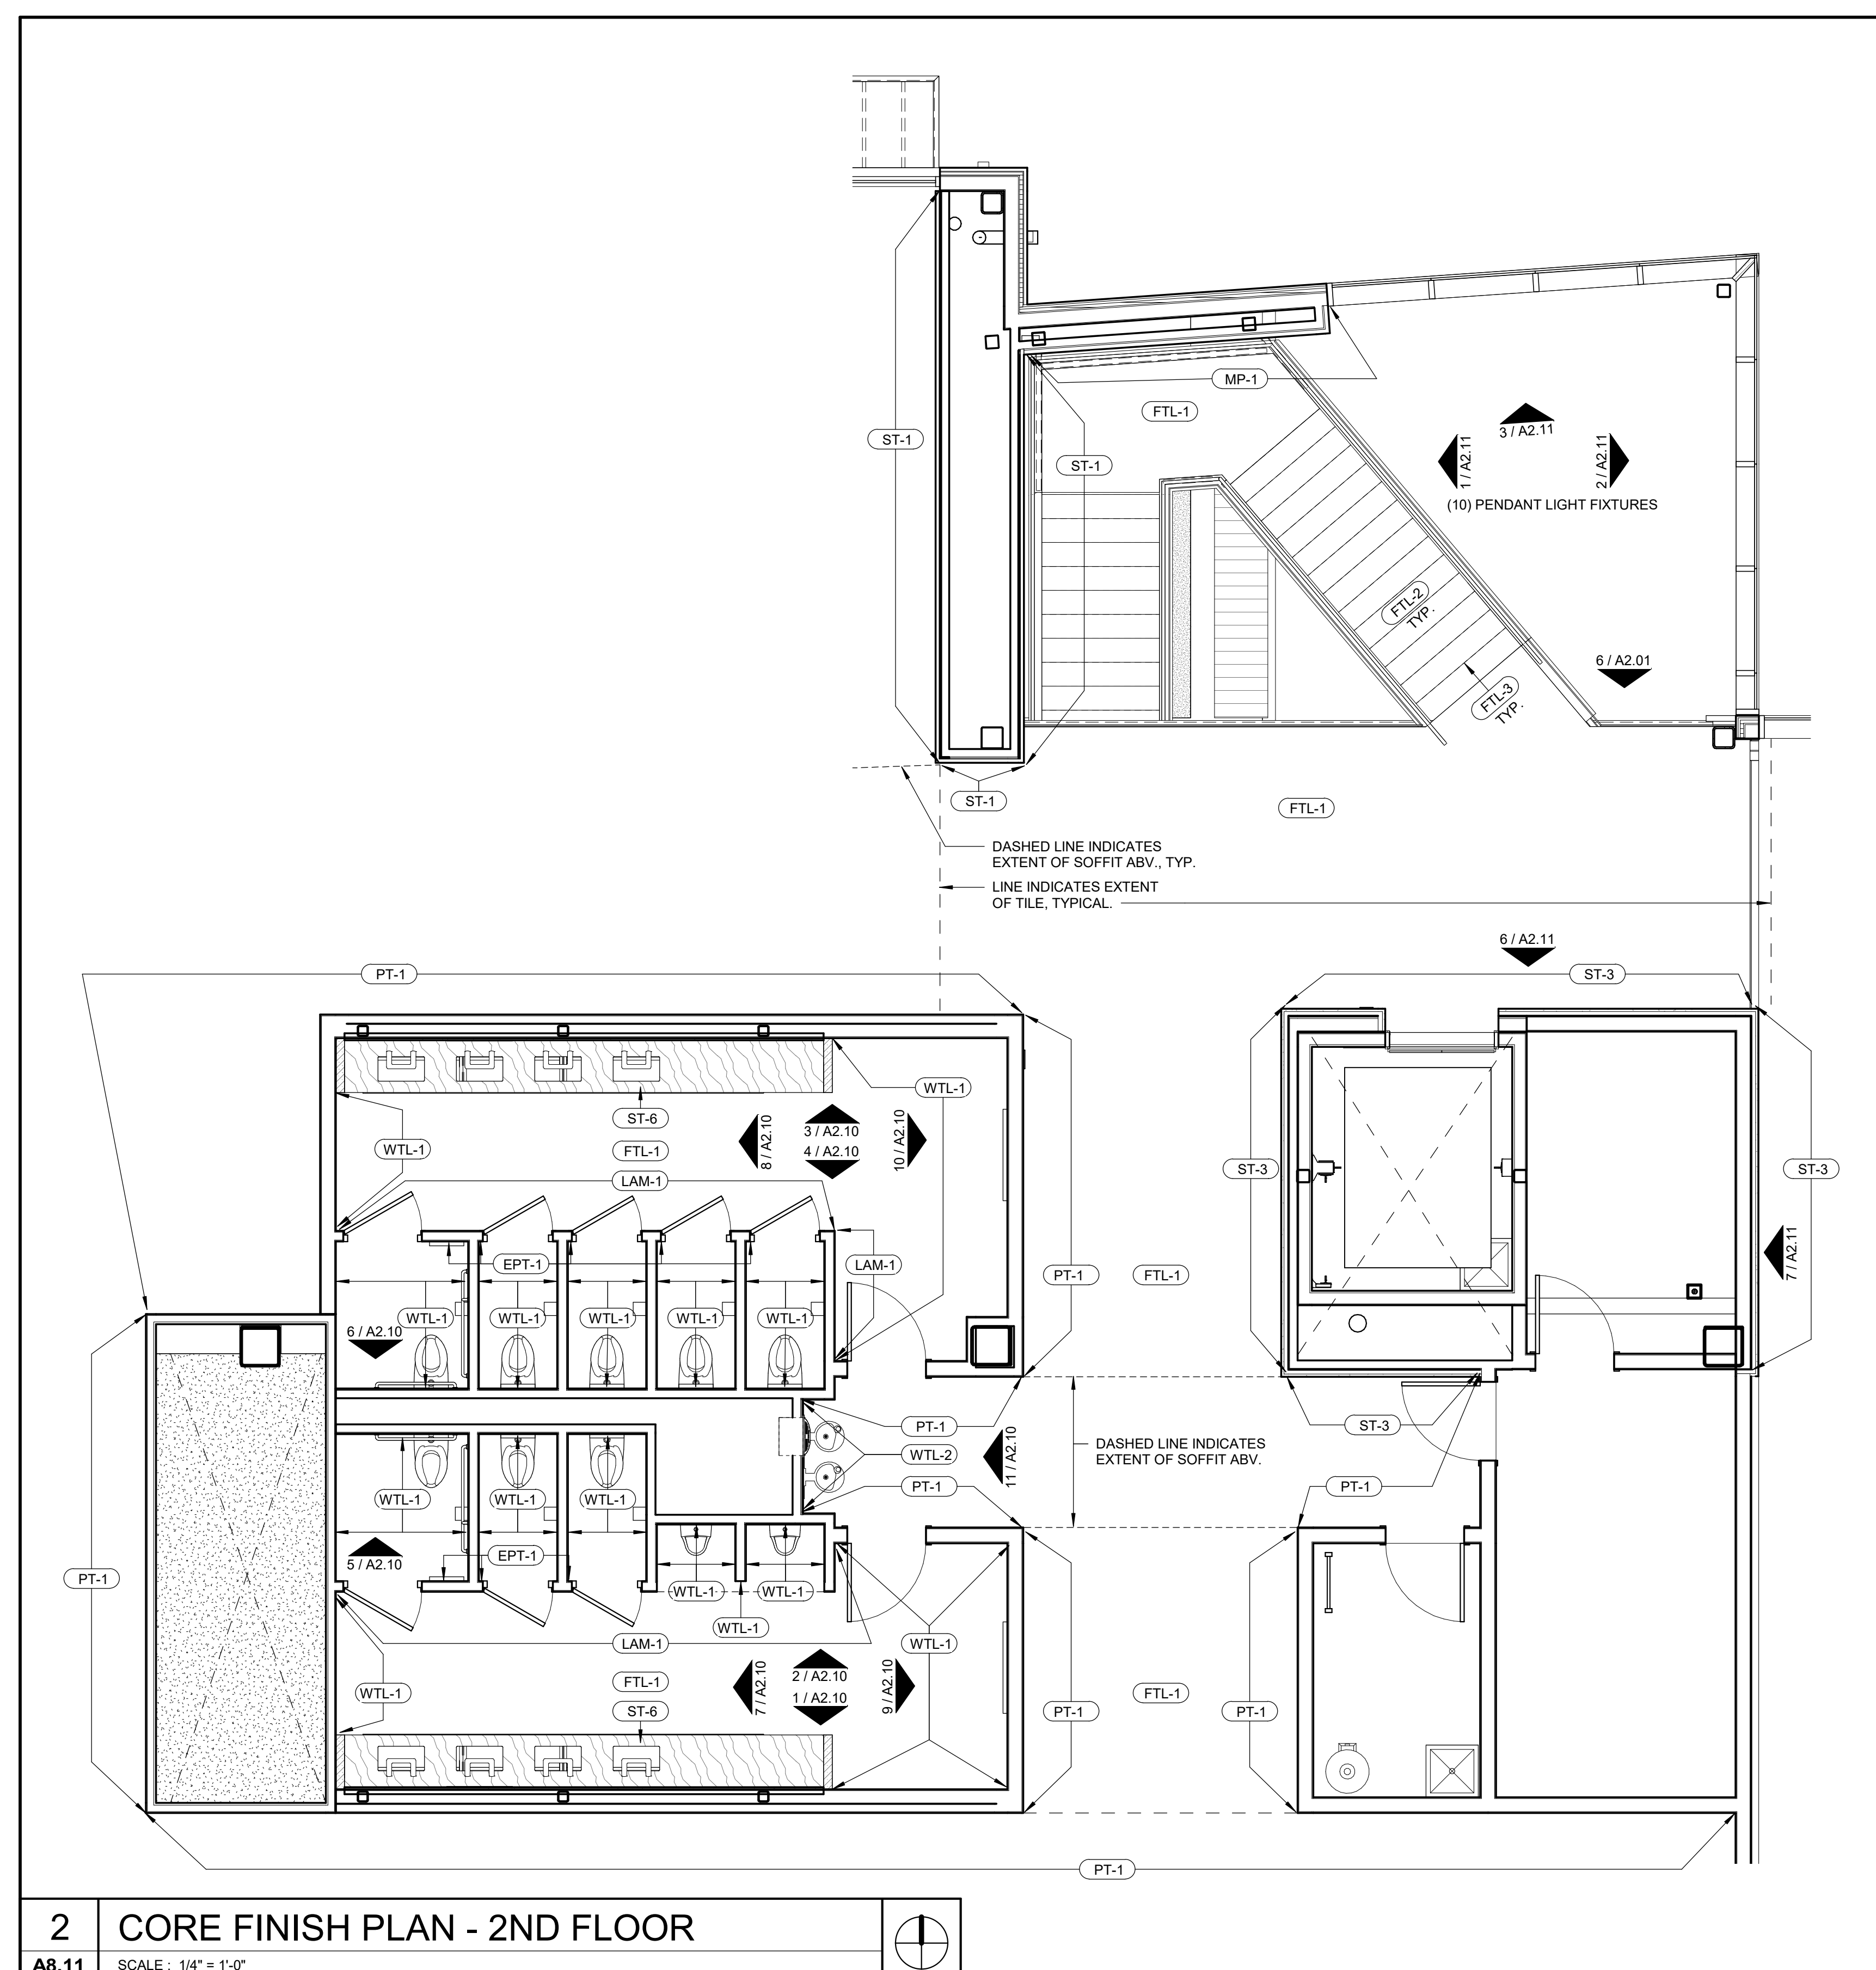



C:\Users\elidoc\Documents\Paragon Star Retail - Office Building Central\_AUDITED\_ellenfoster.rvt

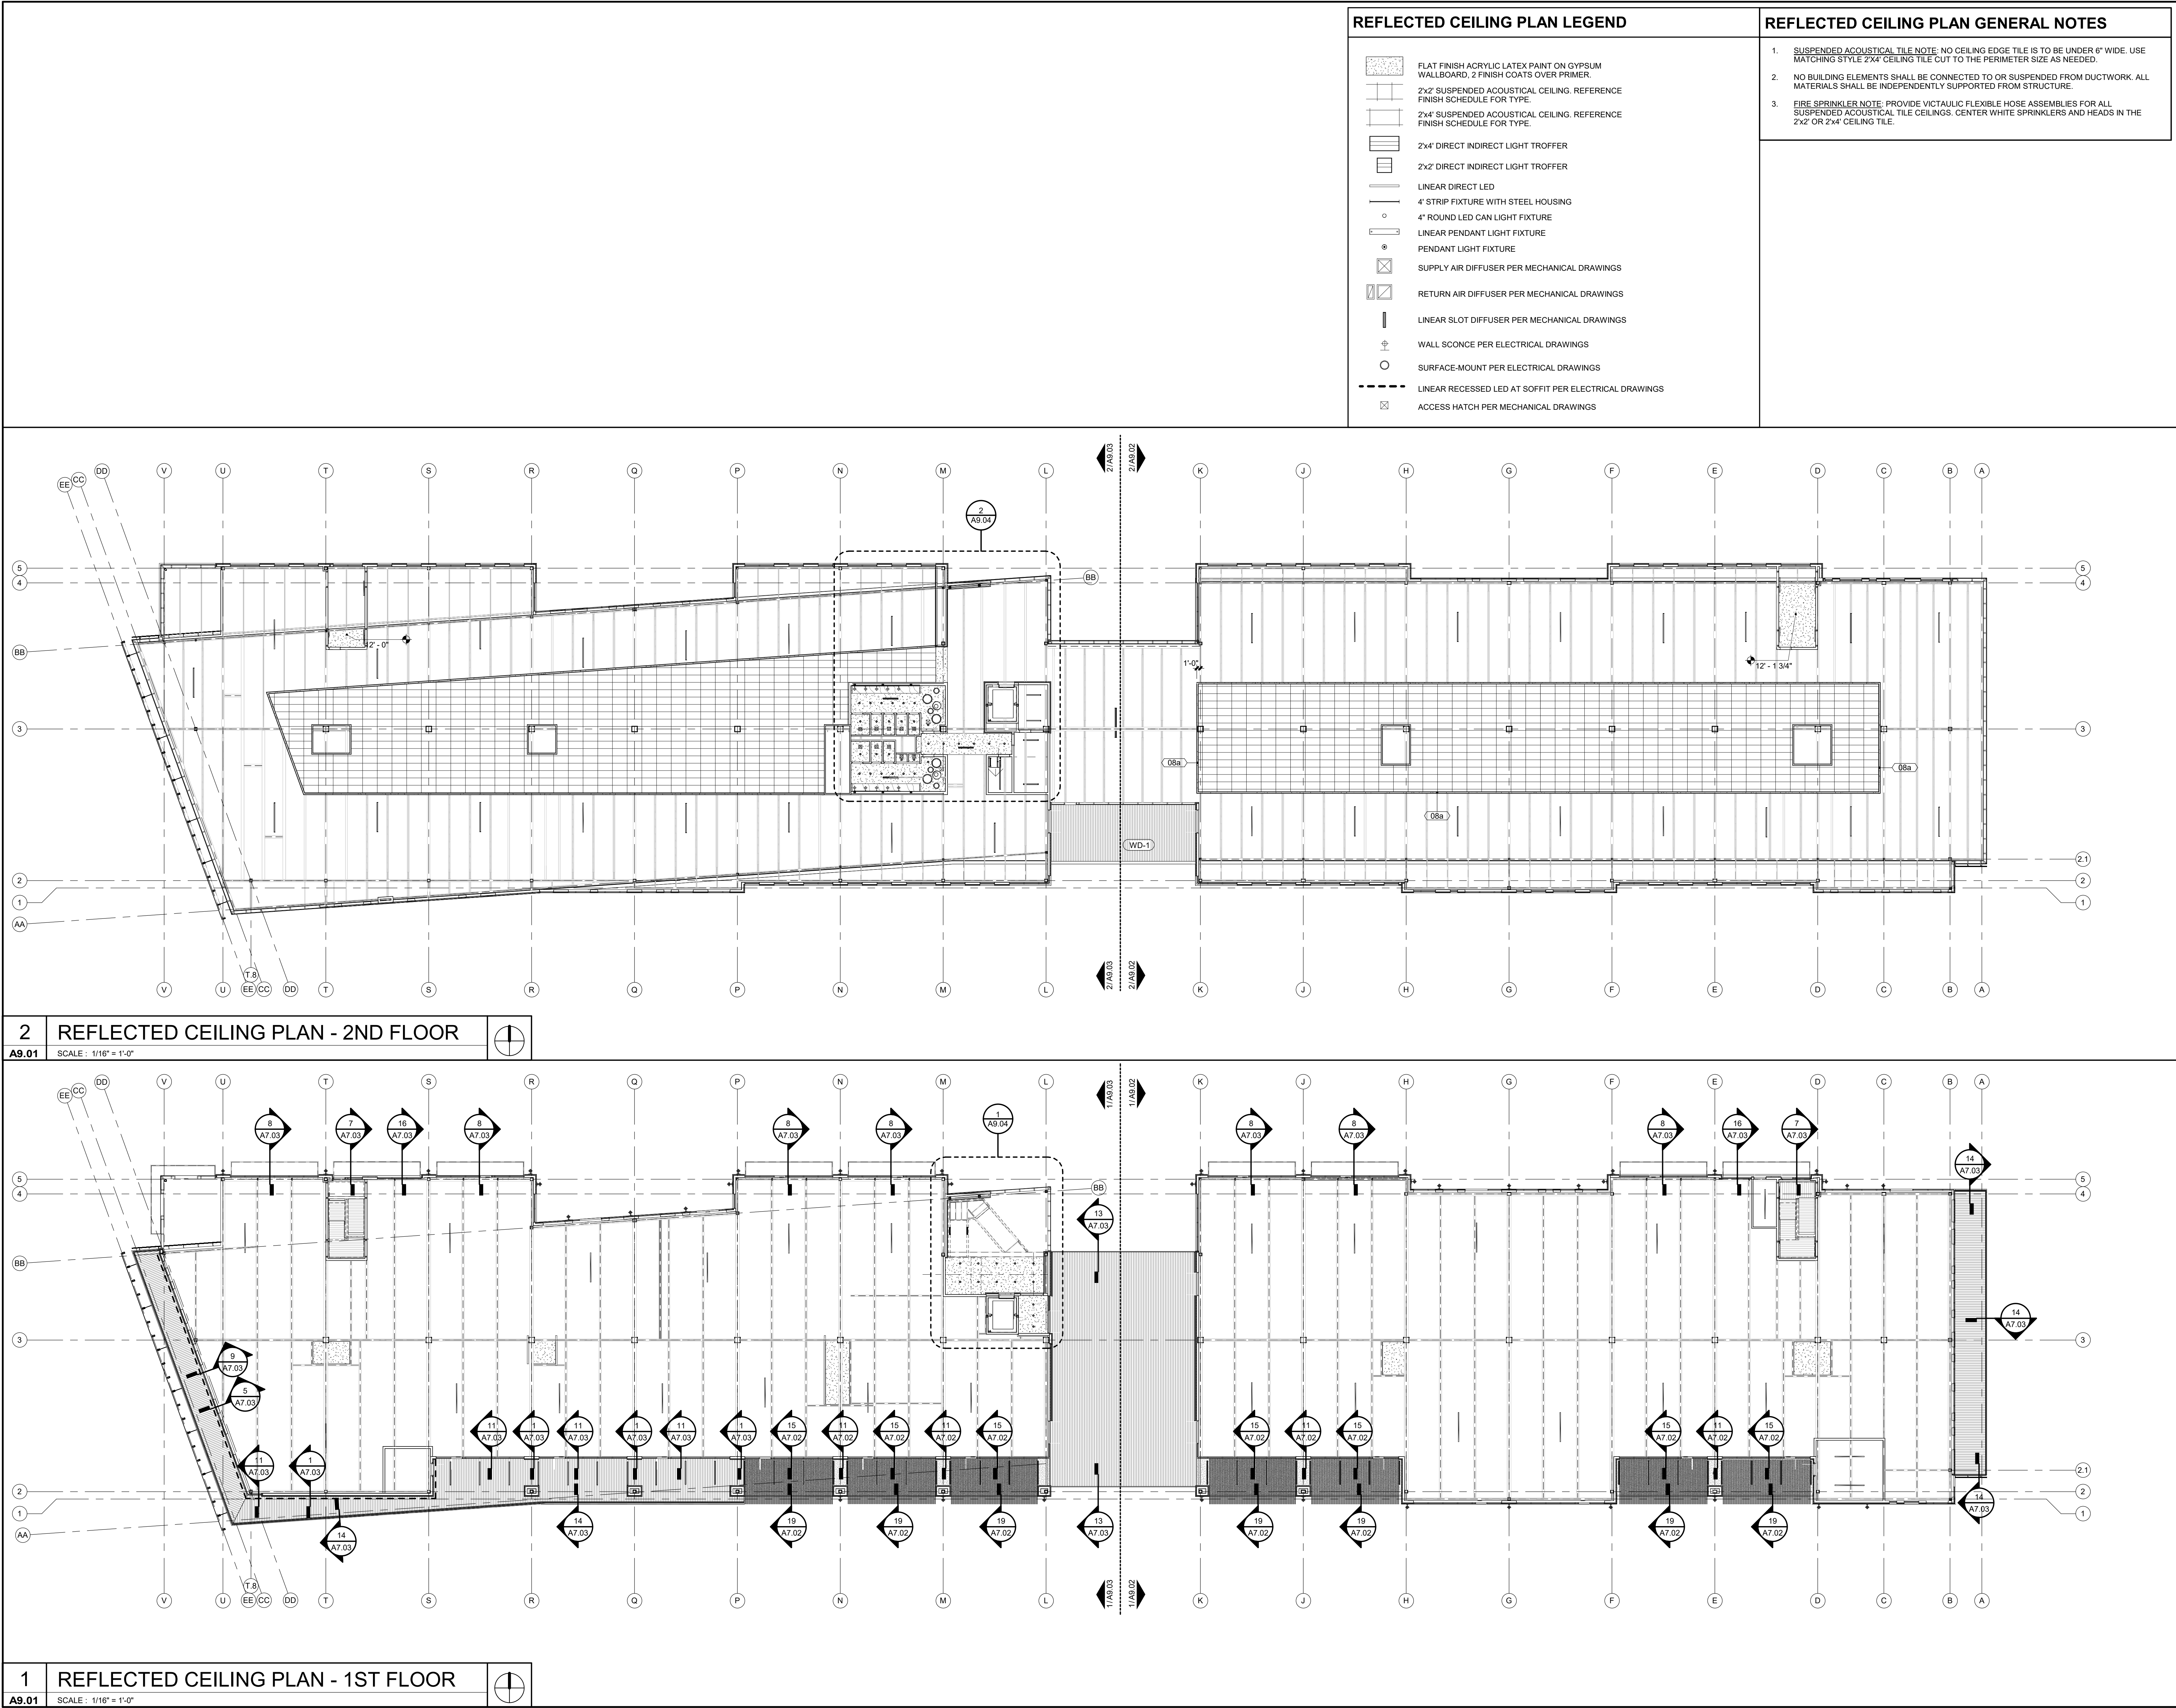





|              |                |
|--------------|----------------|
| Project No.: | 19050.01       |
| Date:        | 10.25.19       |
| Issued For:  | SHELL - CD SET |

[illegible]

## REGISTRATION



## PROJECT TEAM

|                 |                                  |
|-----------------|----------------------------------|
| ARCHITECT       | FINKLE- WILLIAMS<br>ARCHITECTURE |
| CIVIL           | GBA                              |
| LANDSCAPE       | HOERR SCHAUDT /<br>LAND3         |
| FOUNDATIONS     | BSE STRUCTURAL<br>ENGINEERS      |
| STRUCTURAL      | BSE STRUCTURAL<br>ENGINEERS      |
| PLUMBING        | HENDERSON<br>ENGINEERS           |
| MECHANICAL      | HENDERSON<br>ENGINEERS           |
| ELECTRICAL      | HENDERSON<br>ENGINEERS           |
| FIRE PROTECTION | HENDERSON<br>ENGINEERS           |
| CONTRACTOR      | FOGEL ANDERSON                   |




7007 College Blvd, Suite 415  
Overland Park, Kansas 66211  
913-498-1550

SHEET TITLE


ENLARGED  
REFLECTED  
CEILING PLANS

SHEET NUMBER

A9.02

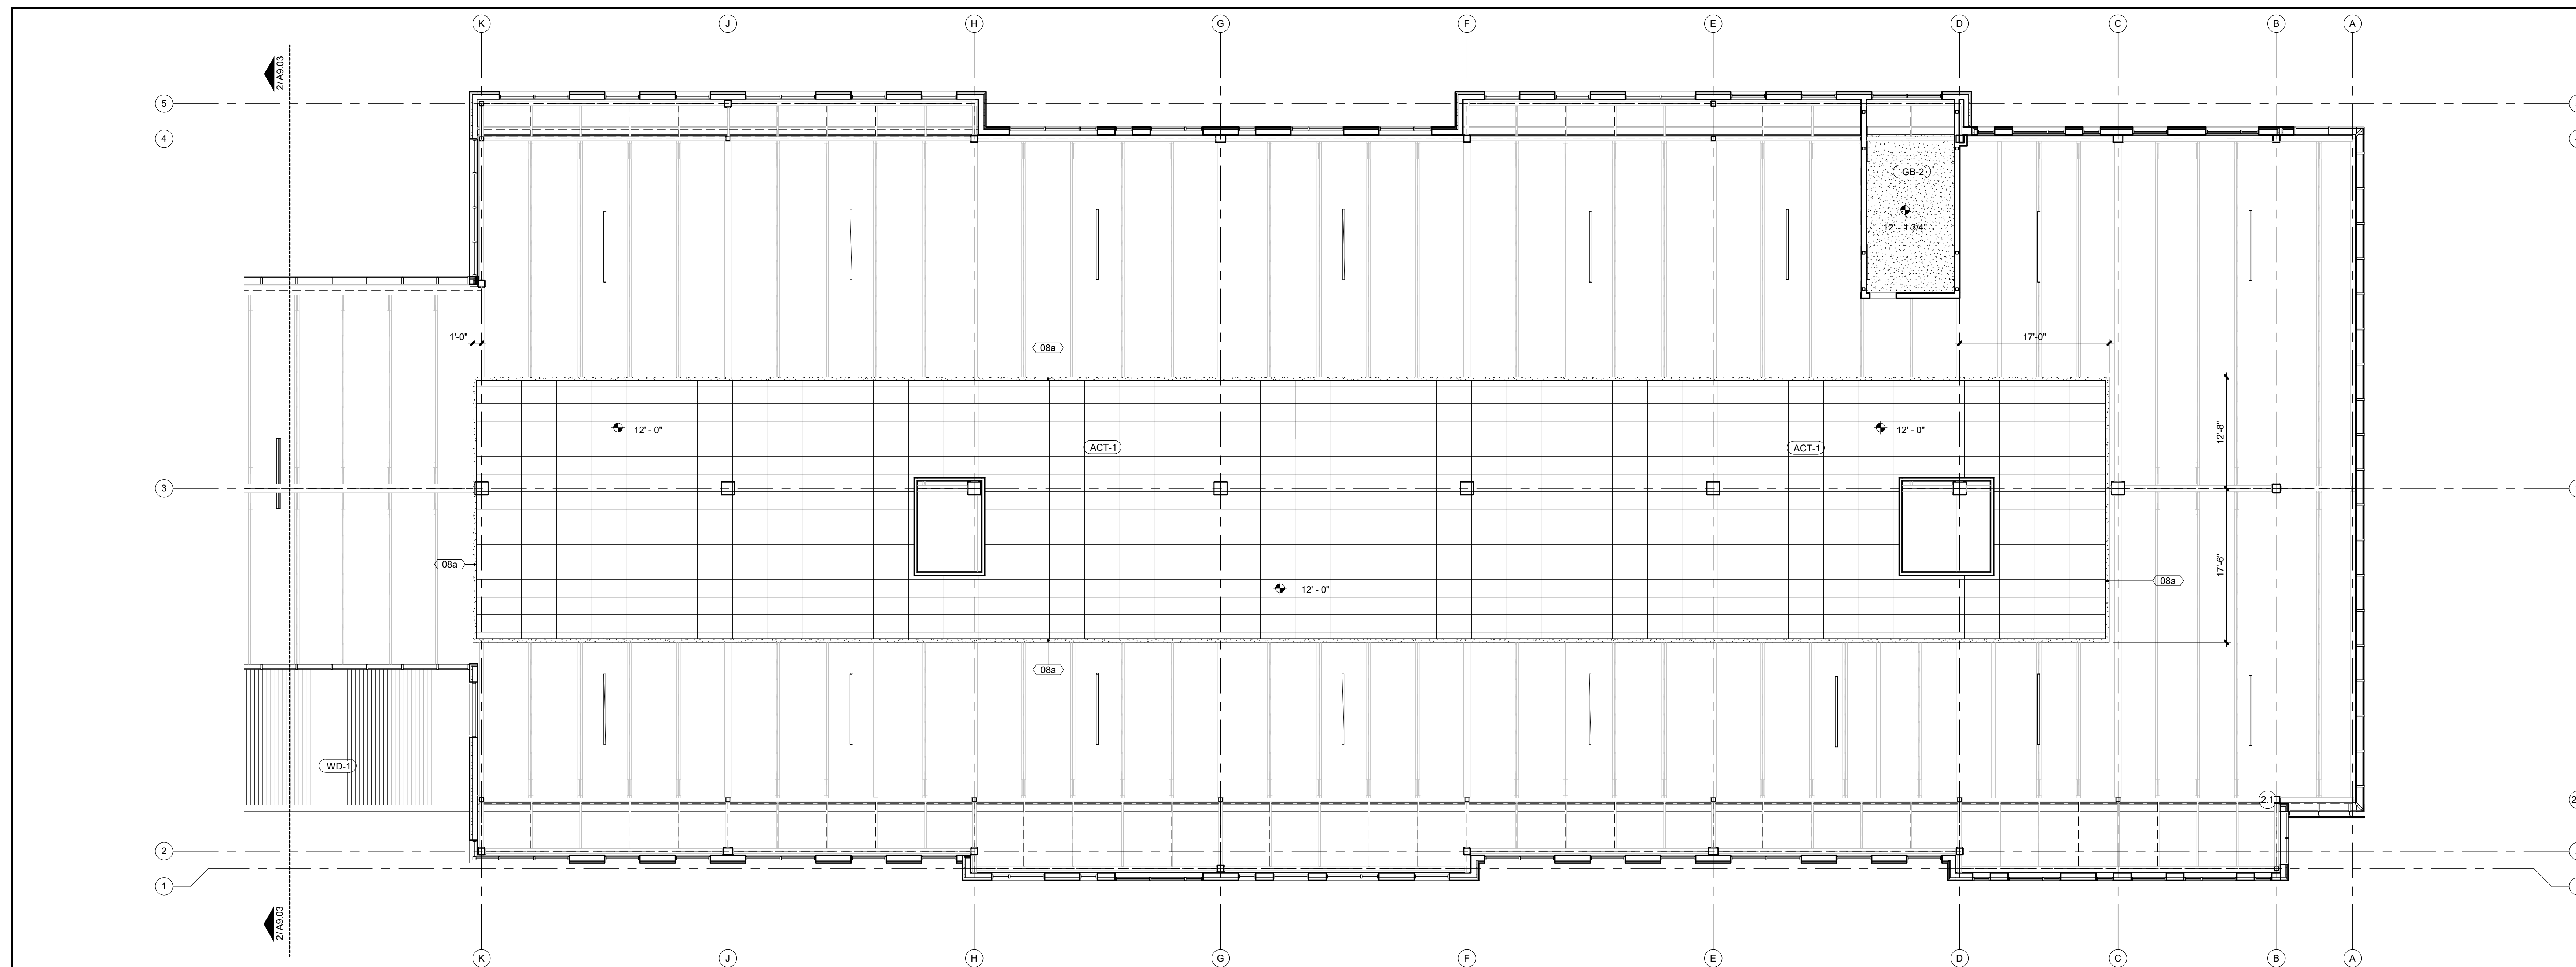

|       |                      |   |
|-------|----------------------|---|
| 2     | RCP - 2ND FLOOR EAST |  |
| A9.02 | SCALE : 1/8" = 1'-0" |   |

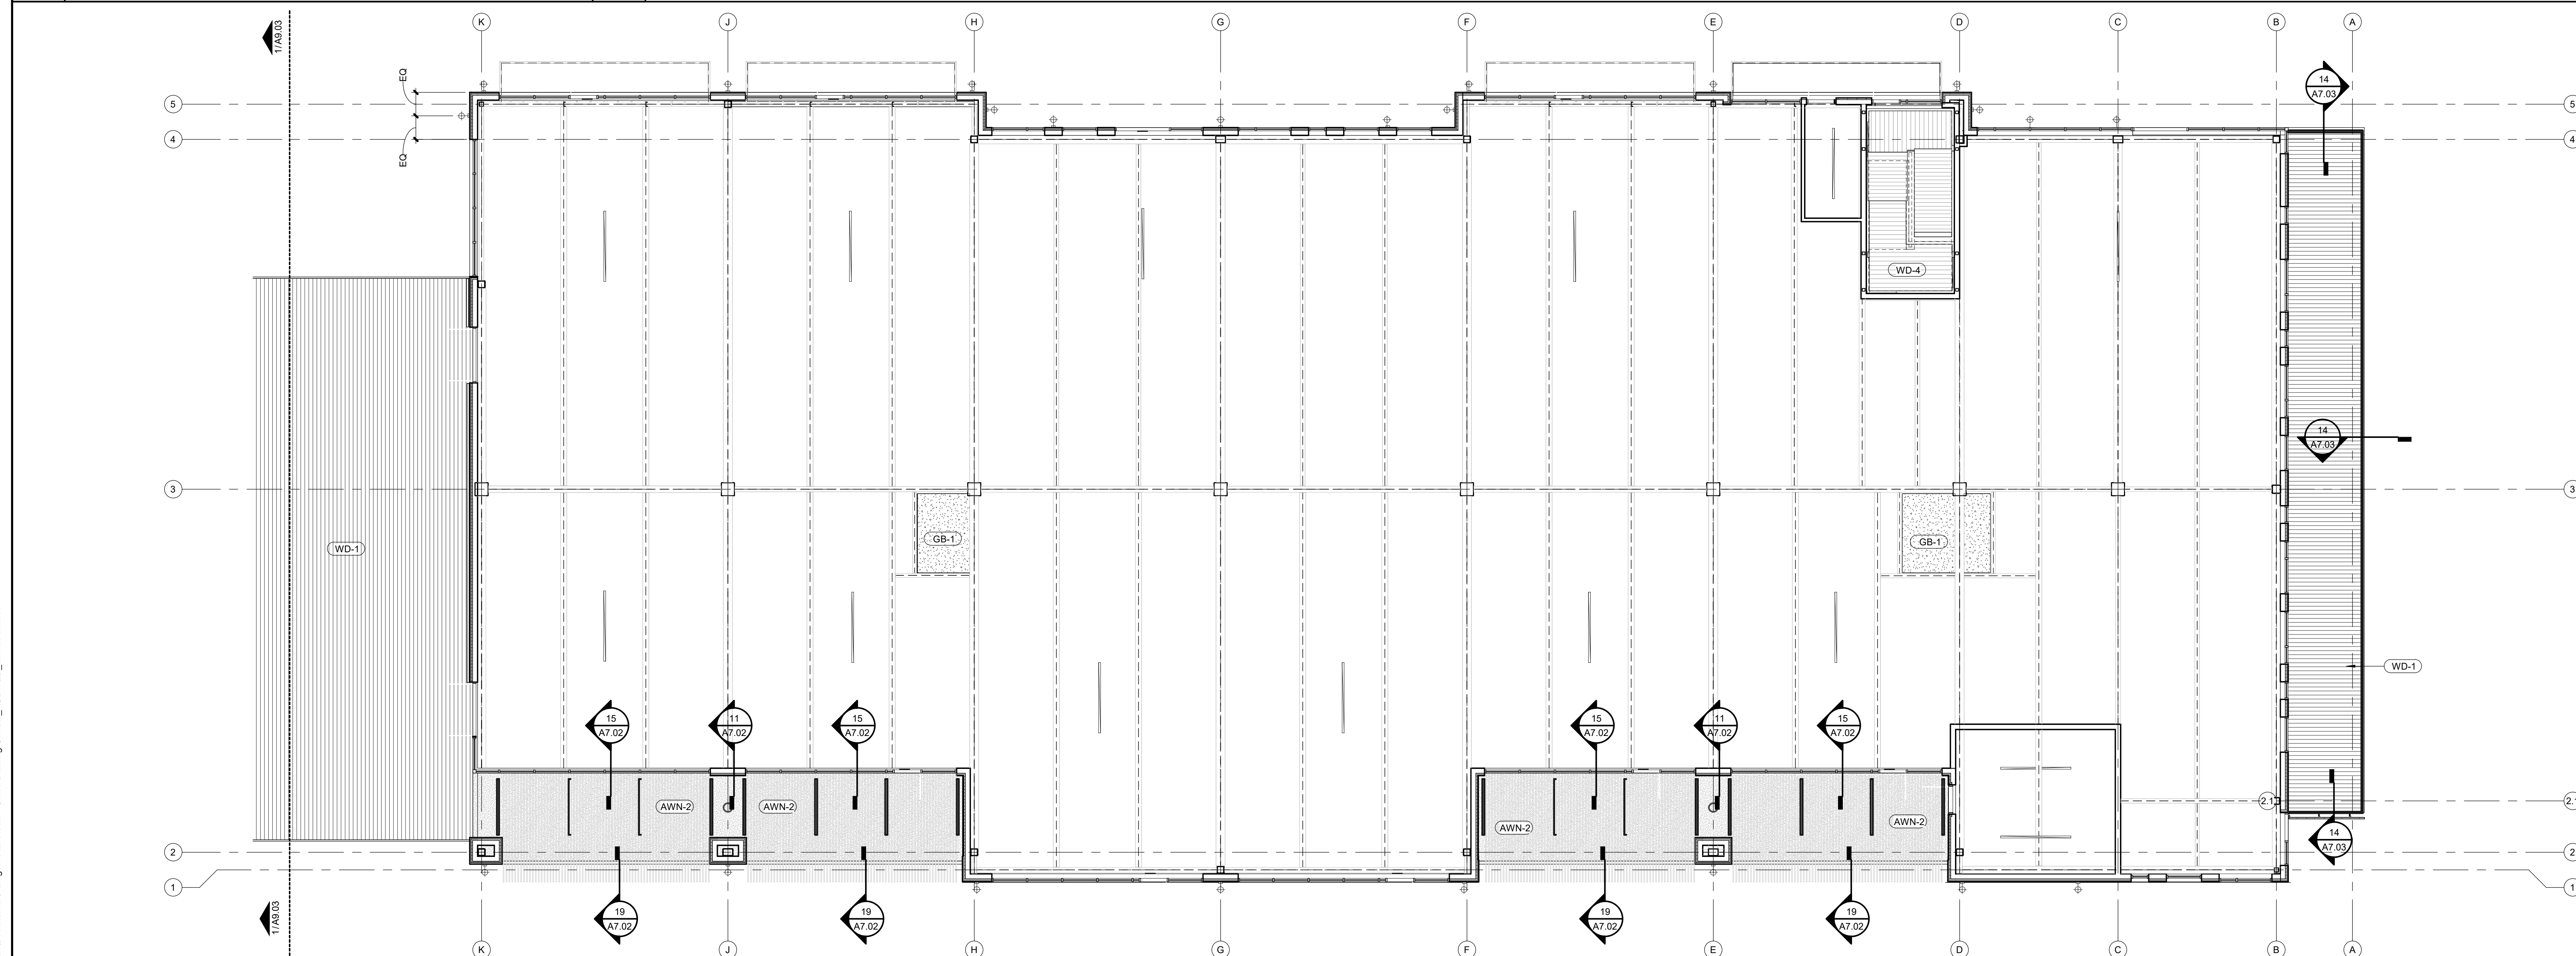


|       |                      |   |
|-------|----------------------|---|
| 1     | RCP - 1ST FLOOR EAST |  |
| A9.02 | SCALE: 1/8" = 1'-0"  |   |








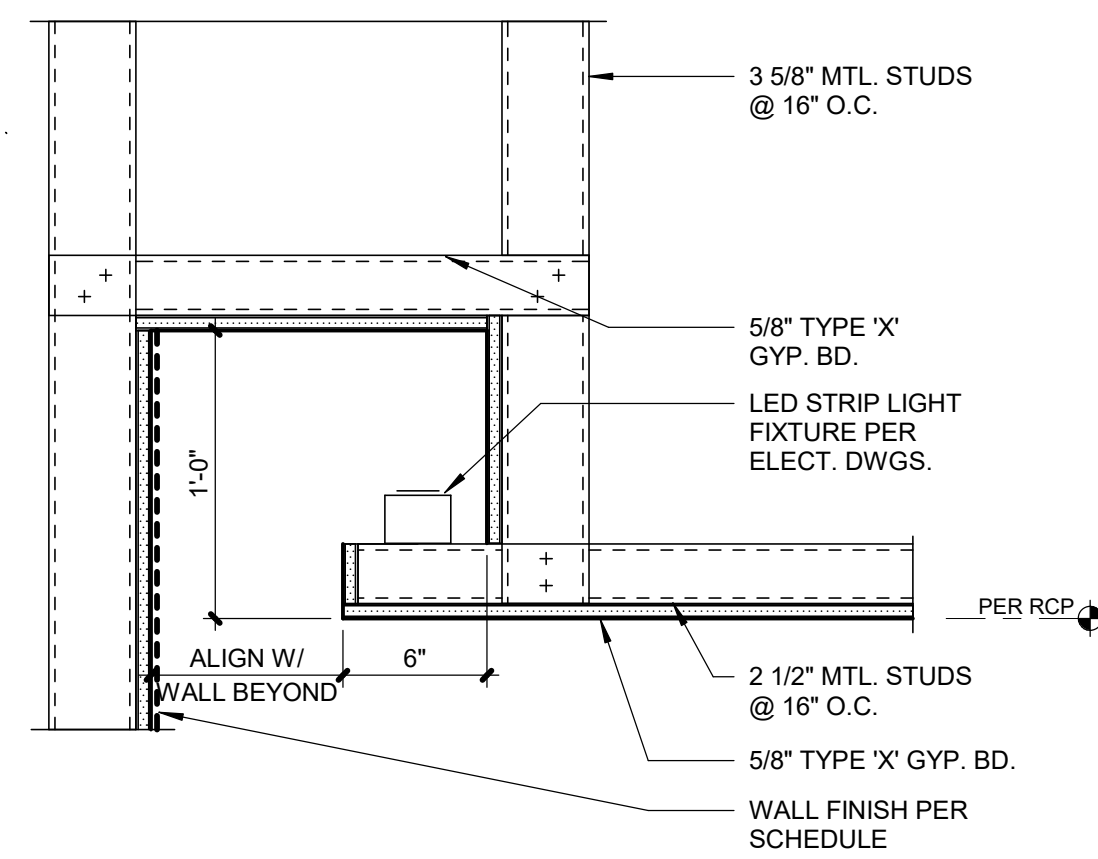



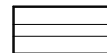




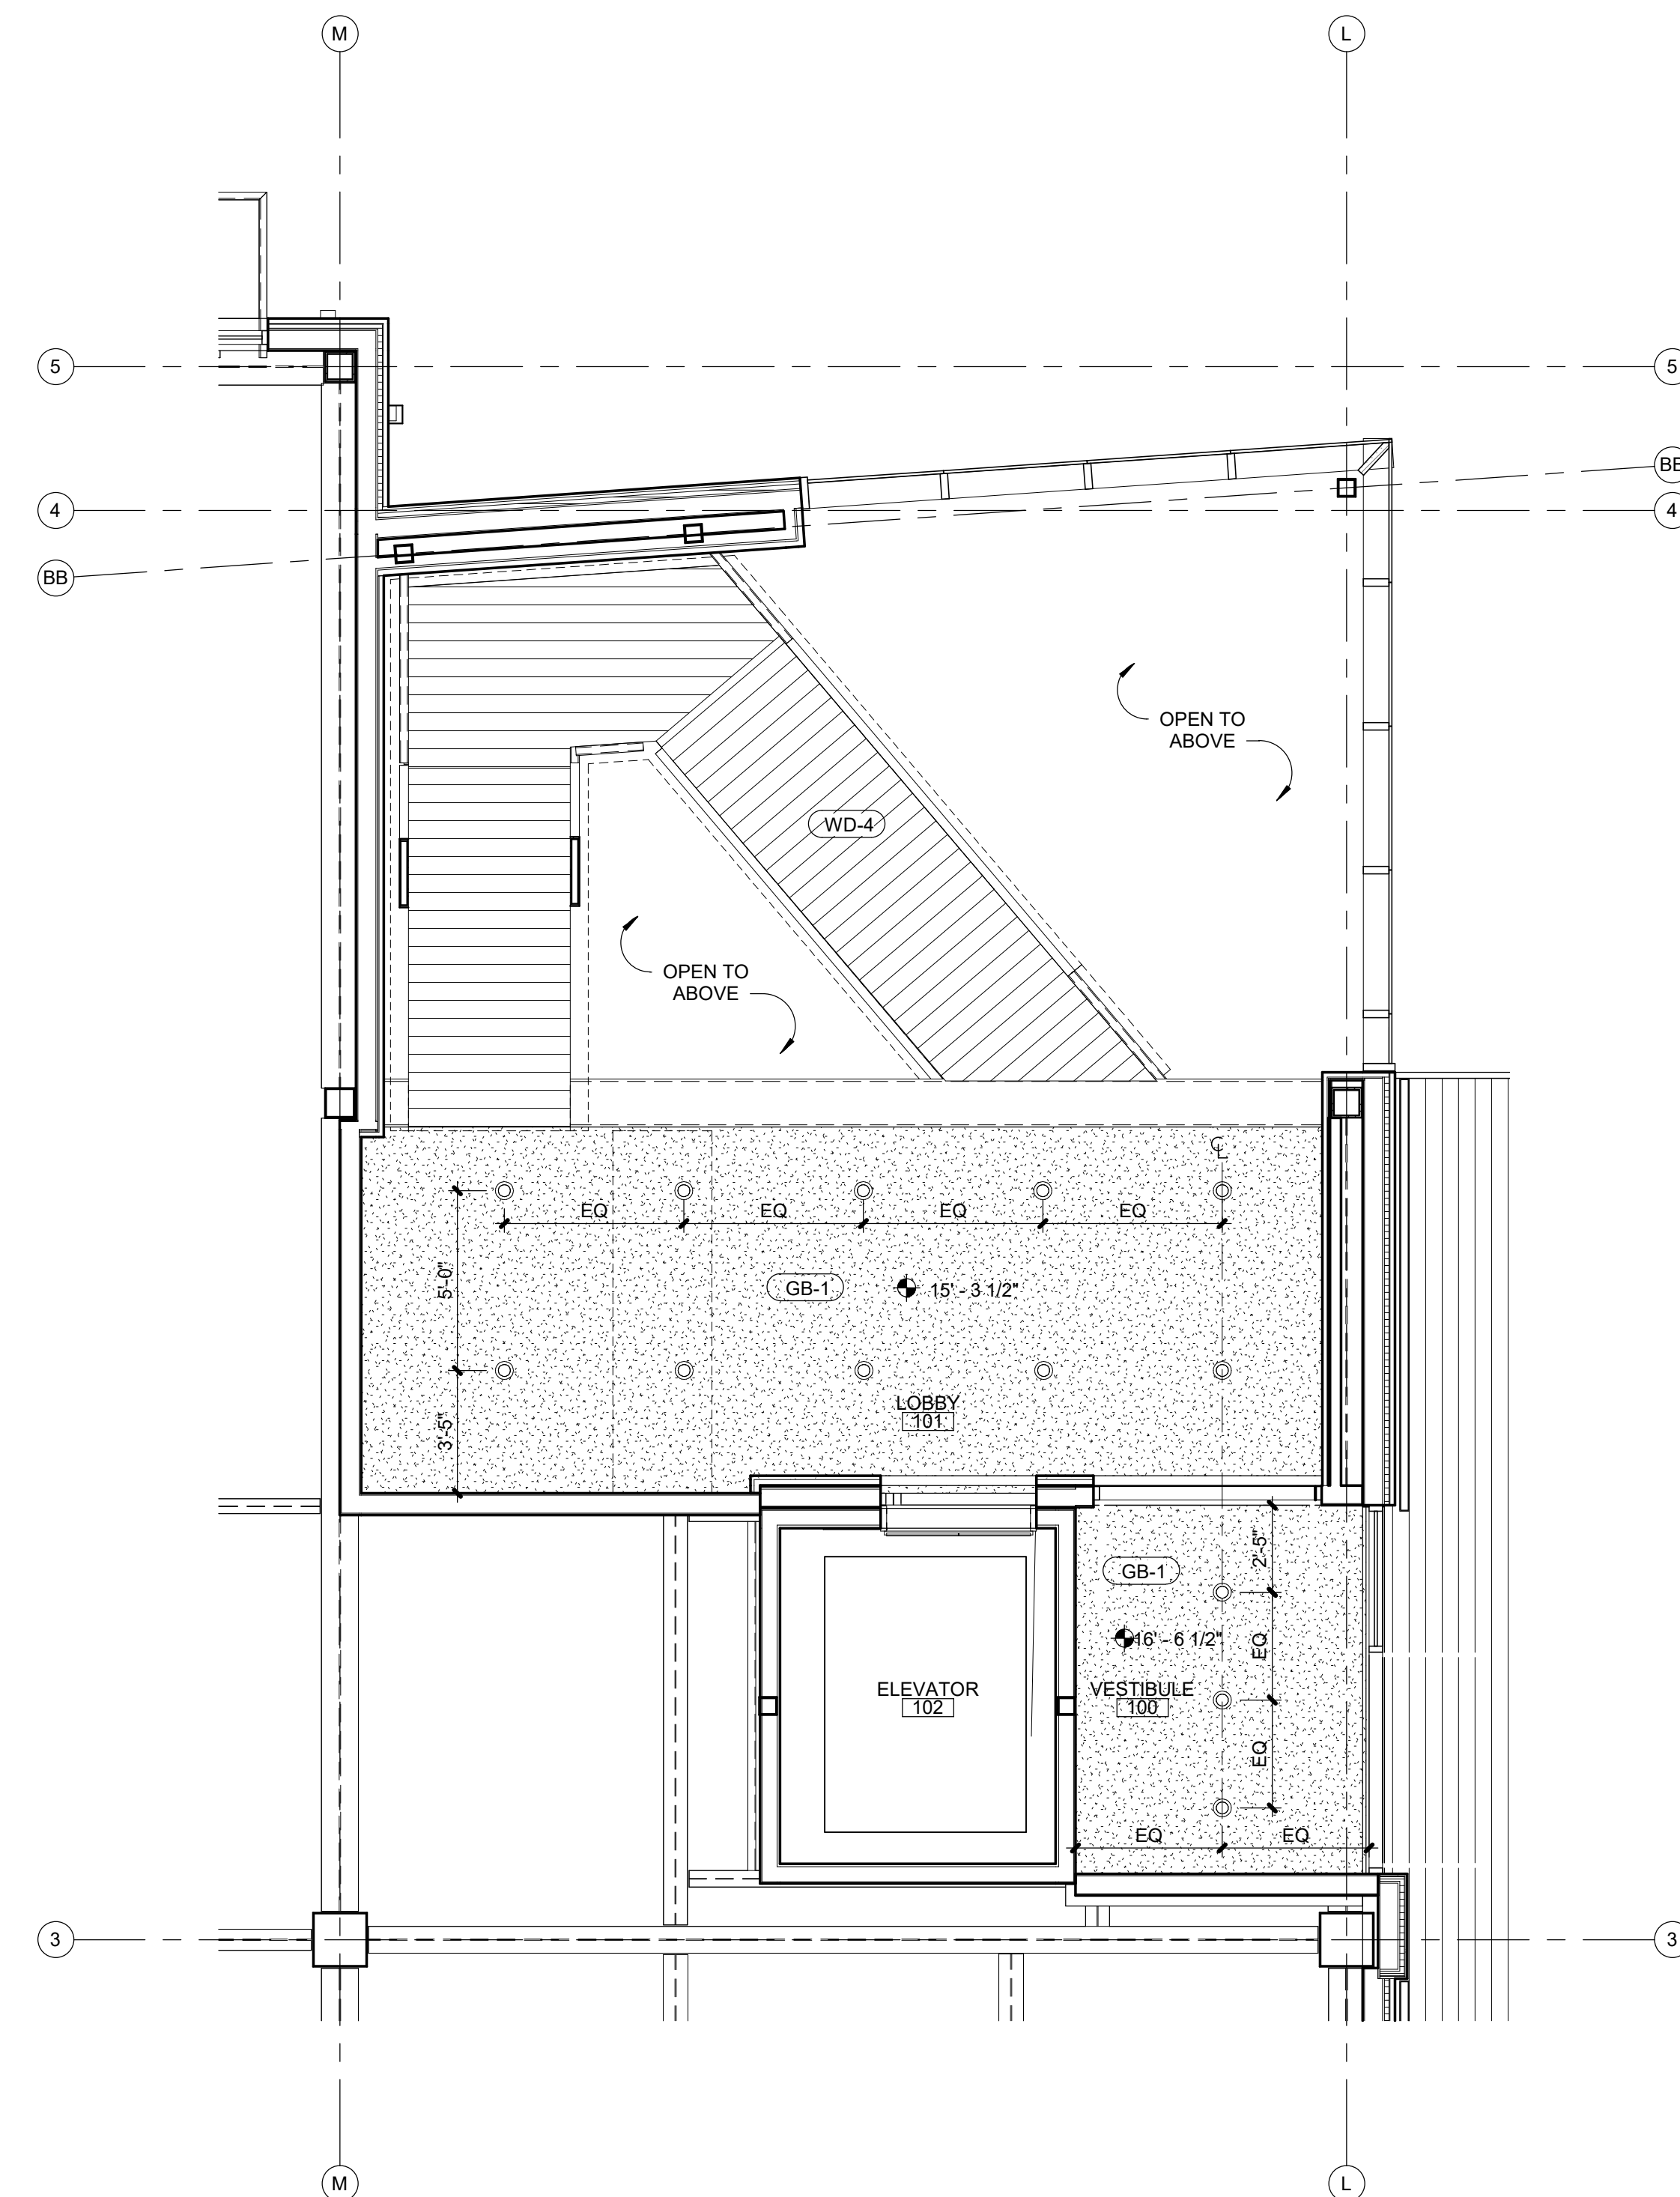



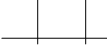


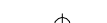


### 3 | CEILING COVE DETAIL

|              |                        |
|--------------|------------------------|
| <b>A9.04</b> | SCALE : 1 1/2" = 1'-0" |
|--------------|------------------------|



|   |                          |
|---|--------------------------|
| 1 | ENLARGED RCP - 1ST FLOOR |
|---|--------------------------|

|              |                      |
|--------------|----------------------|
| <b>A9.04</b> | SCALE : 1/4" = 1'-0" |
|--------------|----------------------|

- |   |  |
|---|--|
|  | FLAT FINISH ACRYLIC LATEX PAINT ON GYPSUM WALLBOARD. 2 FINISH COATS OVER PRIMER. |
|  | 2x2' SUSPENDED ACOUSTICAL CEILING. REFERENCE FINISH SCHEDULE FOR TYPE.           |
|  | 2x4' SUSPENDED ACOUSTICAL CEILING. REFERENCE FINISH SCHEDULE FOR TYPE.           |
|  | 2x4' DIRECT INDIRECT LIGHT TROFFER   |
|  | 2x2' DIRECT INDIRECT LIGHT TROFFER   |
|  | LINEAR DIRECT LED  |
|  | 4' STRIP FIXTURE WITH STEEL HOUSING  |
|  | 4' ROUND LED CAN LIGHT FIXTURE   |
|  | LINEAR PENDANT LIGHT FIXTURE   |
|  | PENDANT LIGHT FIXTURE  |
|  | SUPPLY AIR DIFFUSER PER MECHANICAL DRAWINGS                                      |
|  | RETURN AIR DIFFUSER PER MECHANICAL DRAWINGS                                      |
|  | LINEAR SLOT DIFFUSER PER MECHANICAL DRAWINGS                                     |
|  | WALL SCONCE PER ELECTRICAL DRAWINGS  |
|  | SURFACE-MOUNT PER ELECTRICAL DRAWINGS  |
|  | LINEAR RECESSED LED AT SOFFIT PER ELECTRICAL DRAWINGS                            |
|  | ACCESS HATCH PER MECHANICAL DRAWINGS   |

ΛΟ 04

## A9.04

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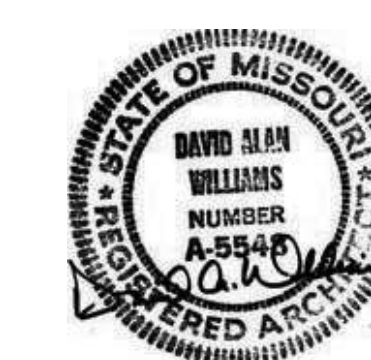


PARAGON STAR  
FIRST PLAT, LOT 9  
LEE'S SUMMIT, MO

Project No.: 19050.01  
Date: 10.25.19  
Issued For: SHELL - CD SET

[illegible]

## REGISTRATION



## PROJECT TEAM

|                 |                                 |
|-----------------|---------------------------------|
| ARCHITECT       | FINKELEWILLIAMS<br>ARCHITECTURE |
| CIVIL           | G&A                             |
| LANDSCAPE       | HOERR SCHAUDT /<br>LAND3        |
| FOUNDATIONS     | BSE STRUCTURAL<br>ENGINEERS     |
| STRUCTURAL      | BSE STRUCTURAL<br>ENGINEERS     |
| PLUMBING        | HENDERSON<br>ENGINEERS          |
| MECHANICAL      | HENDERSON<br>ENGINEERS          |
| ELECTRICAL      | HENDERSON<br>ENGINEERS          |
| FIRE PROTECTION | HENDERSON<br>ENGINEERS          |
| CONTRACTOR      | FOGEL ANDERSON                  |



FINKLE + WILLIAMS  
ARCHITECTURE


7007 College Blvd, Suite 415  
Overland Park, Kansas 66211  
913+498-1550

SHEET TITLE

## EXTERIOR VIEWS


SHEET NUMBER

## A10.02

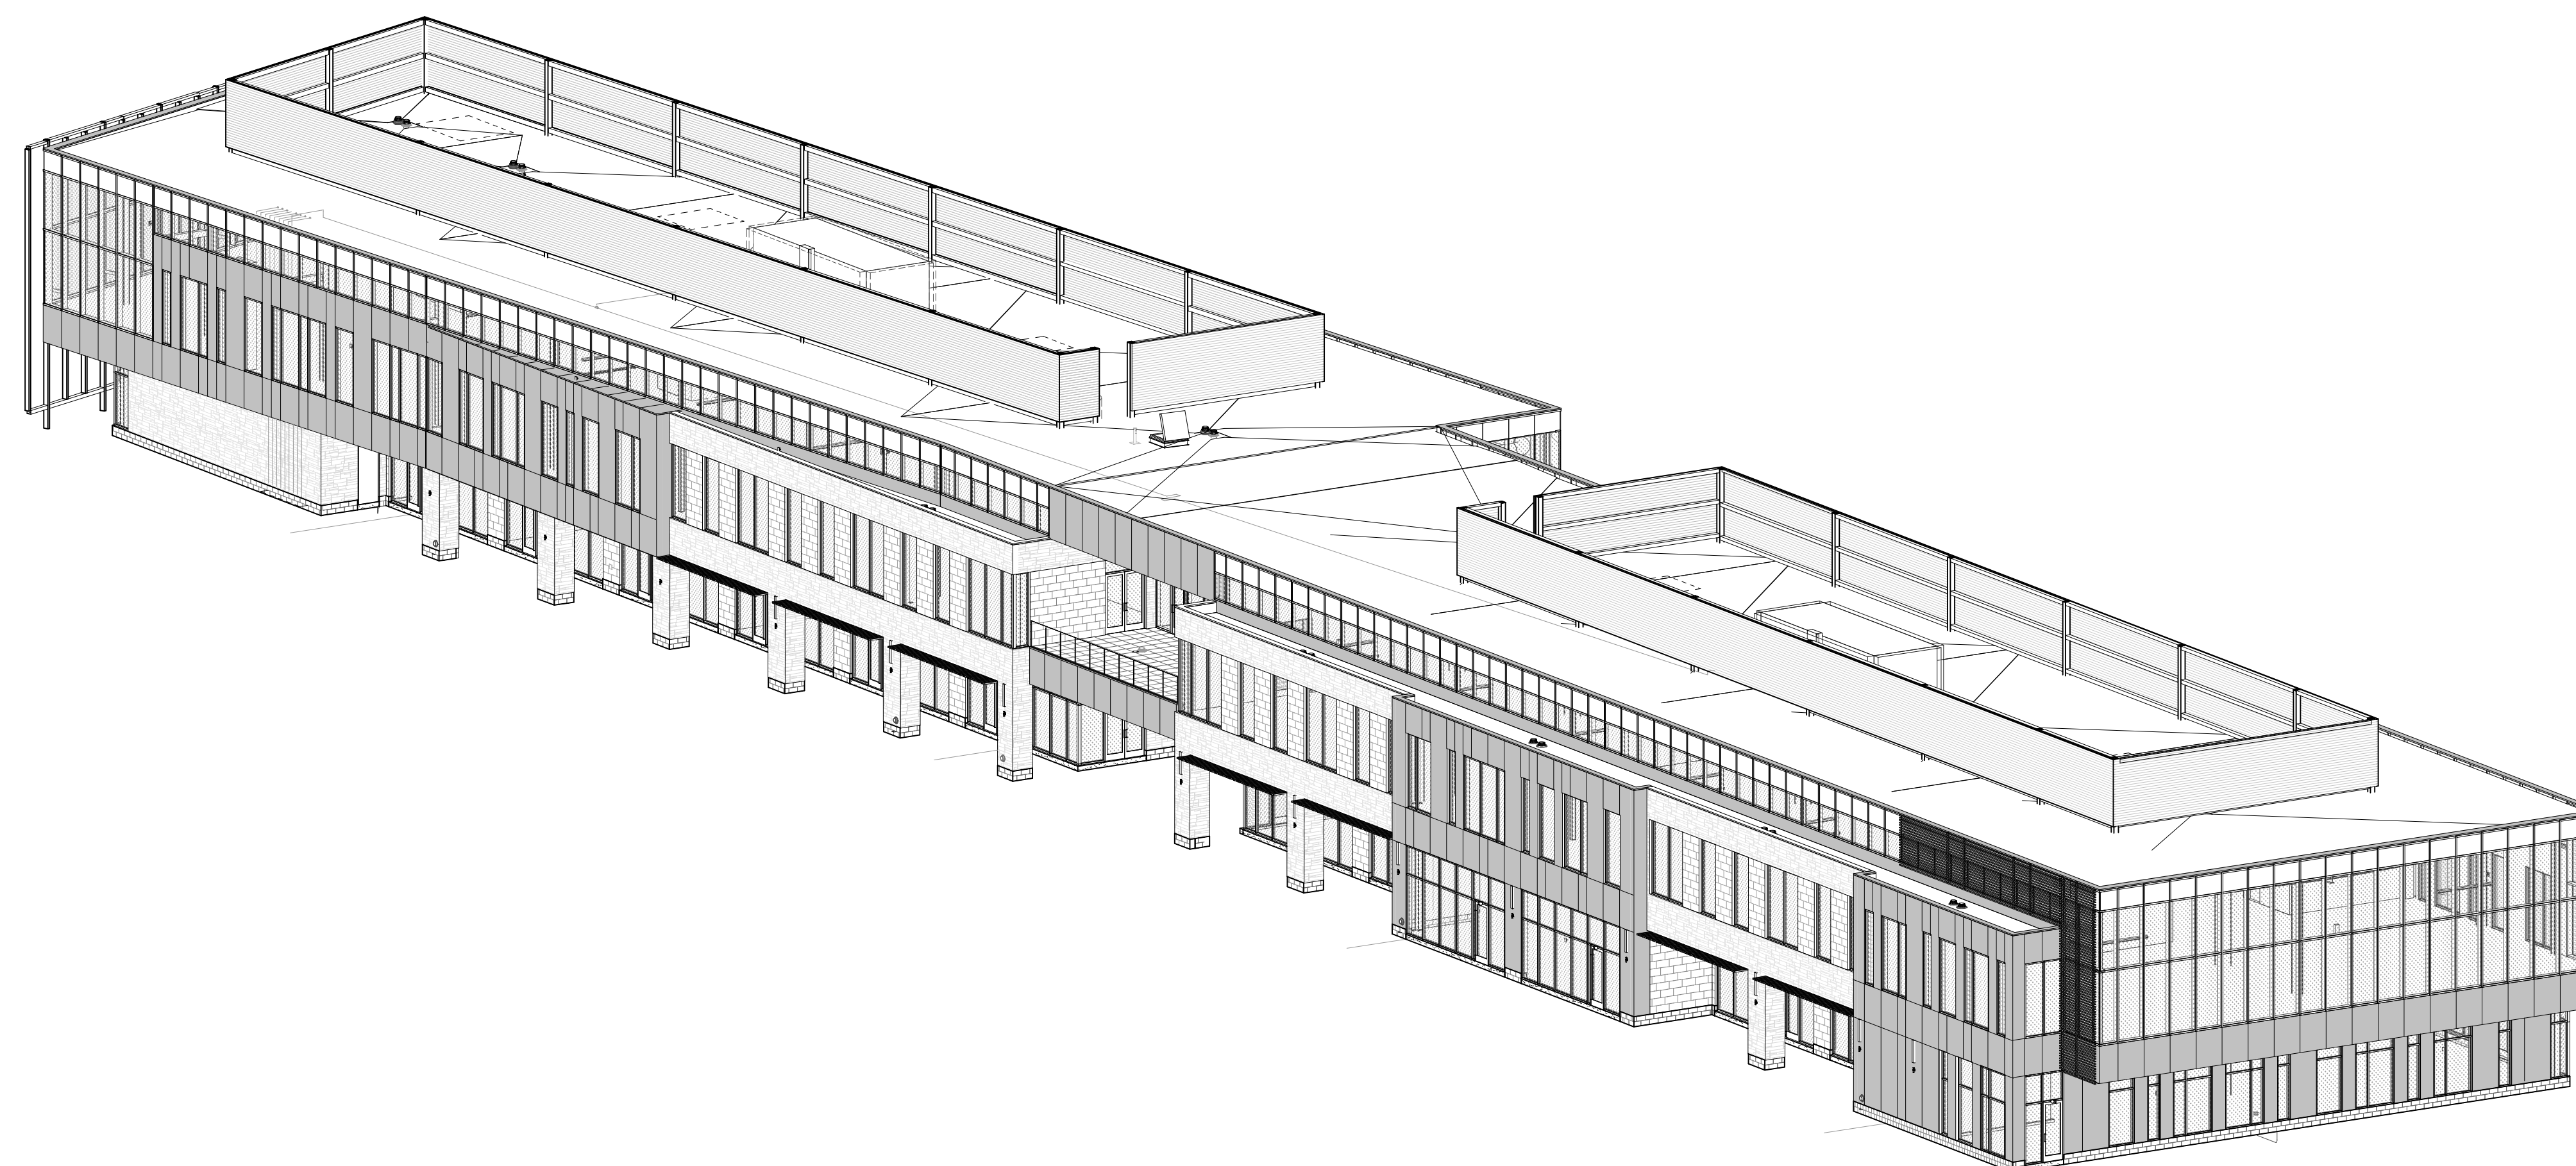

|   |                          |
|---|--------------------------|
| 2 | 3D AXON - FROM SOUTHEAST |
|---|--------------------------|

|               |         |
|---------------|---------|
| <b>A10.02</b> | SCALE : |
|---------------|---------|

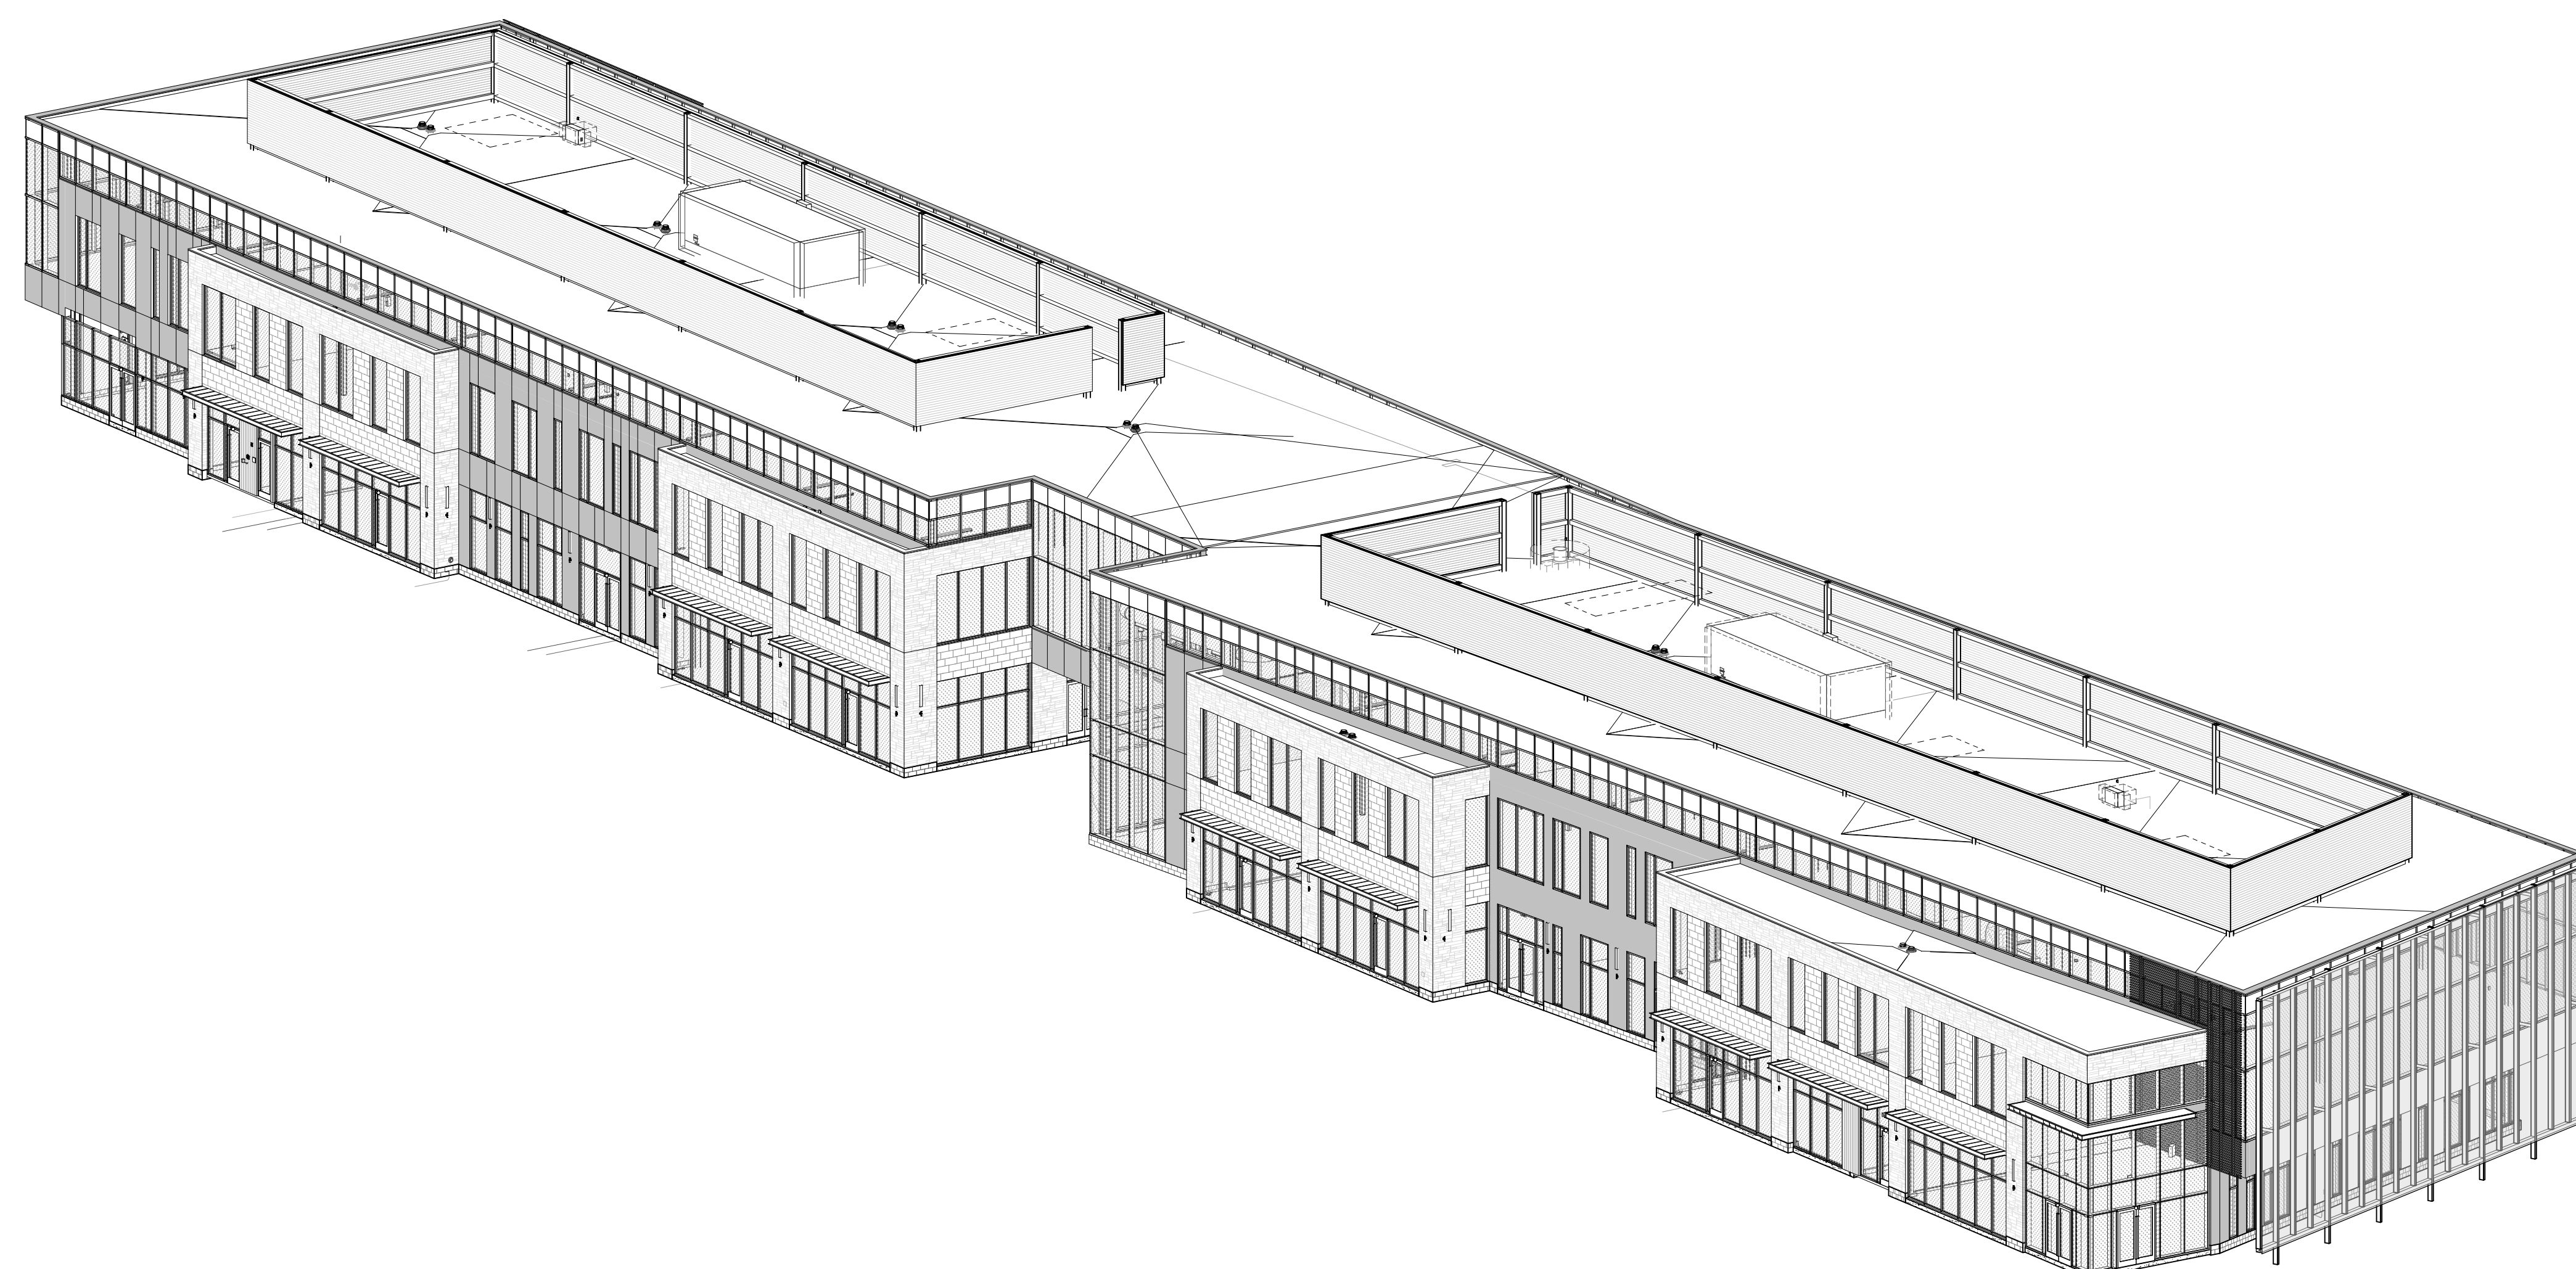

|   |                          |
|---|--------------------------|
| 1 | 3D AXON - FROM NORTHWEST |
|---|--------------------------|

|        |         |
|--------|---------|
| A10.02 | SCALE : |
|--------|---------|













PARAGON STAR  
- LOT 9 -  
BUILDING 2

PARAGON STAR  
FIRST PLAT, LOT 9  
LEE'S SUMMIT, MO

|              |                |
|--------------|----------------|
| Project No.: | 19050.01       |
| Date:        | 10.25.19       |
| Issued For:  | SHELL - CD SET |

[illegible]

## REGISTRATION



| PROJECT TEAM    |                                 |
|-----------------|---------------------------------|
| ARCHITECT       | FINKLE+WILLIAMS<br>ARCHITECTURE |
| CIVIL           | GBA                             |
| LANDSCAPE       | HOERR SCHAUDT /<br>LANDS        |
| FOUNDATIONS     | BSE STRUCTURAL<br>ENGINEERS     |
| STRUCTURAL      | BSE STRUCTURAL<br>ENGINEERS     |
| PLUMBING        | HENDERSON<br>ENGINEERS          |
| MECHANICAL      | HENDERSON<br>ENGINEERS          |
| ELECTRICAL      | HENDERSON<br>ENGINEERS          |
| FIRE PROTECTION | HENDERSON<br>ENGINEERS          |
| CONTRACTOR      | FOGEL ANDERSON                  |



FINKLE + WILLIAMS  
ARCHITECTURE

7007 College Blvd, Suite 415  
Overland Park, Kansas 66211  
913+498-1550

SHEET TITLE

# PROJECT SPECIFICATIONS


SHEET NUMBER

# A11.12







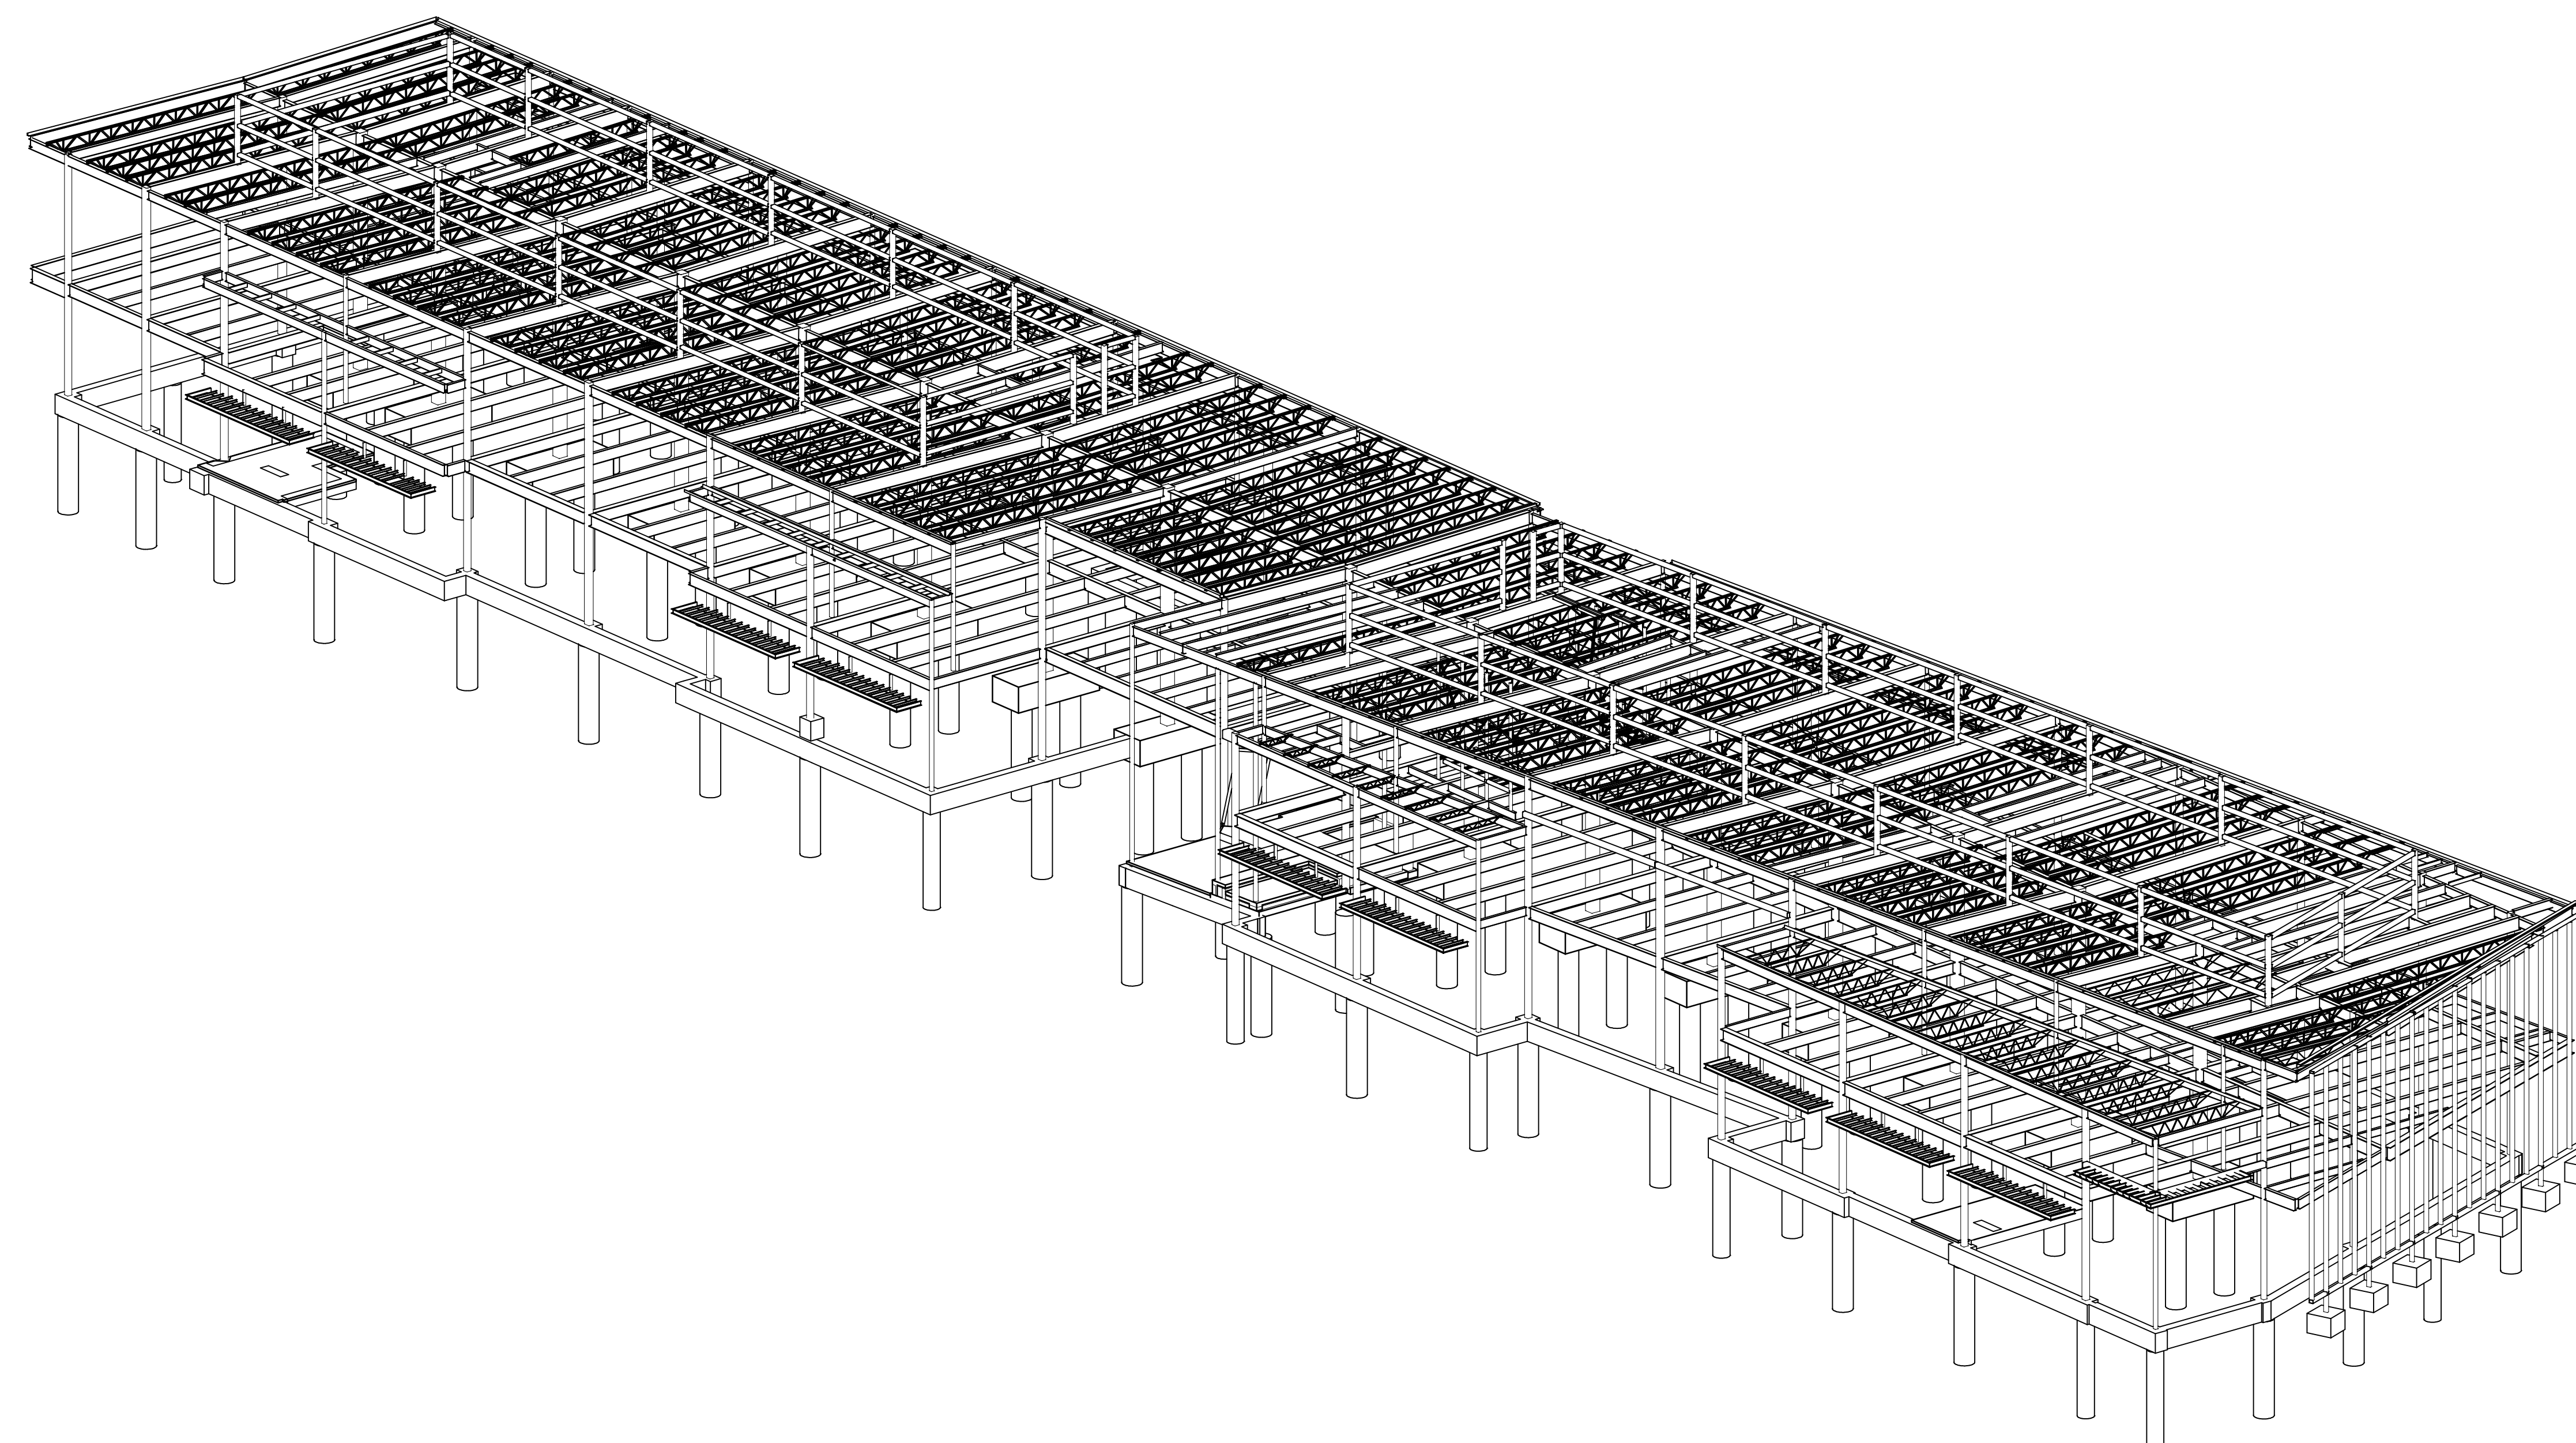


1.) ISOMETRIC VIEWS ARE SHOWN FOR SCHEMATIC PURPOSES ONLY. ACTUAL CONSTRUCTION TO MATCH CONSTRUCTION DOCUMENTS. REFERENCE ARCHITECTURAL, MECHANICAL, CIVIL, & STRUCTURAL DOCUMENTS.

1.) ISOMETRIC VIEWS ARE SHOWN FOR SCHEMATIC PURPOSES ONLY. ACTUAL CONSTRUCTION TO MATCH CONSTRUCTION DOCUMENTS. REFERENCE ARCHITECTURAL, MECHANICAL, CIVIL, & STRUCTURAL DOCUMENTS.

# S0.1




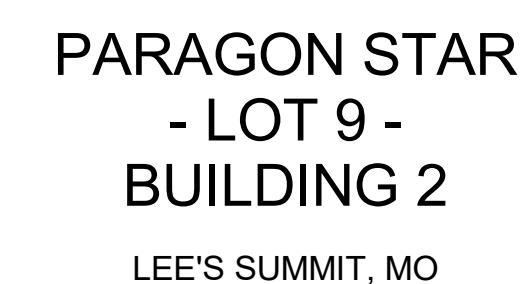

Issued For: SHELL -


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CONTRACTOR      FOGEL ANDERSON

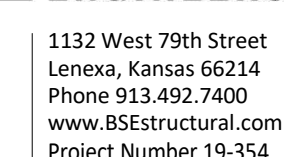


## OVERALL PLAN

## S0.2

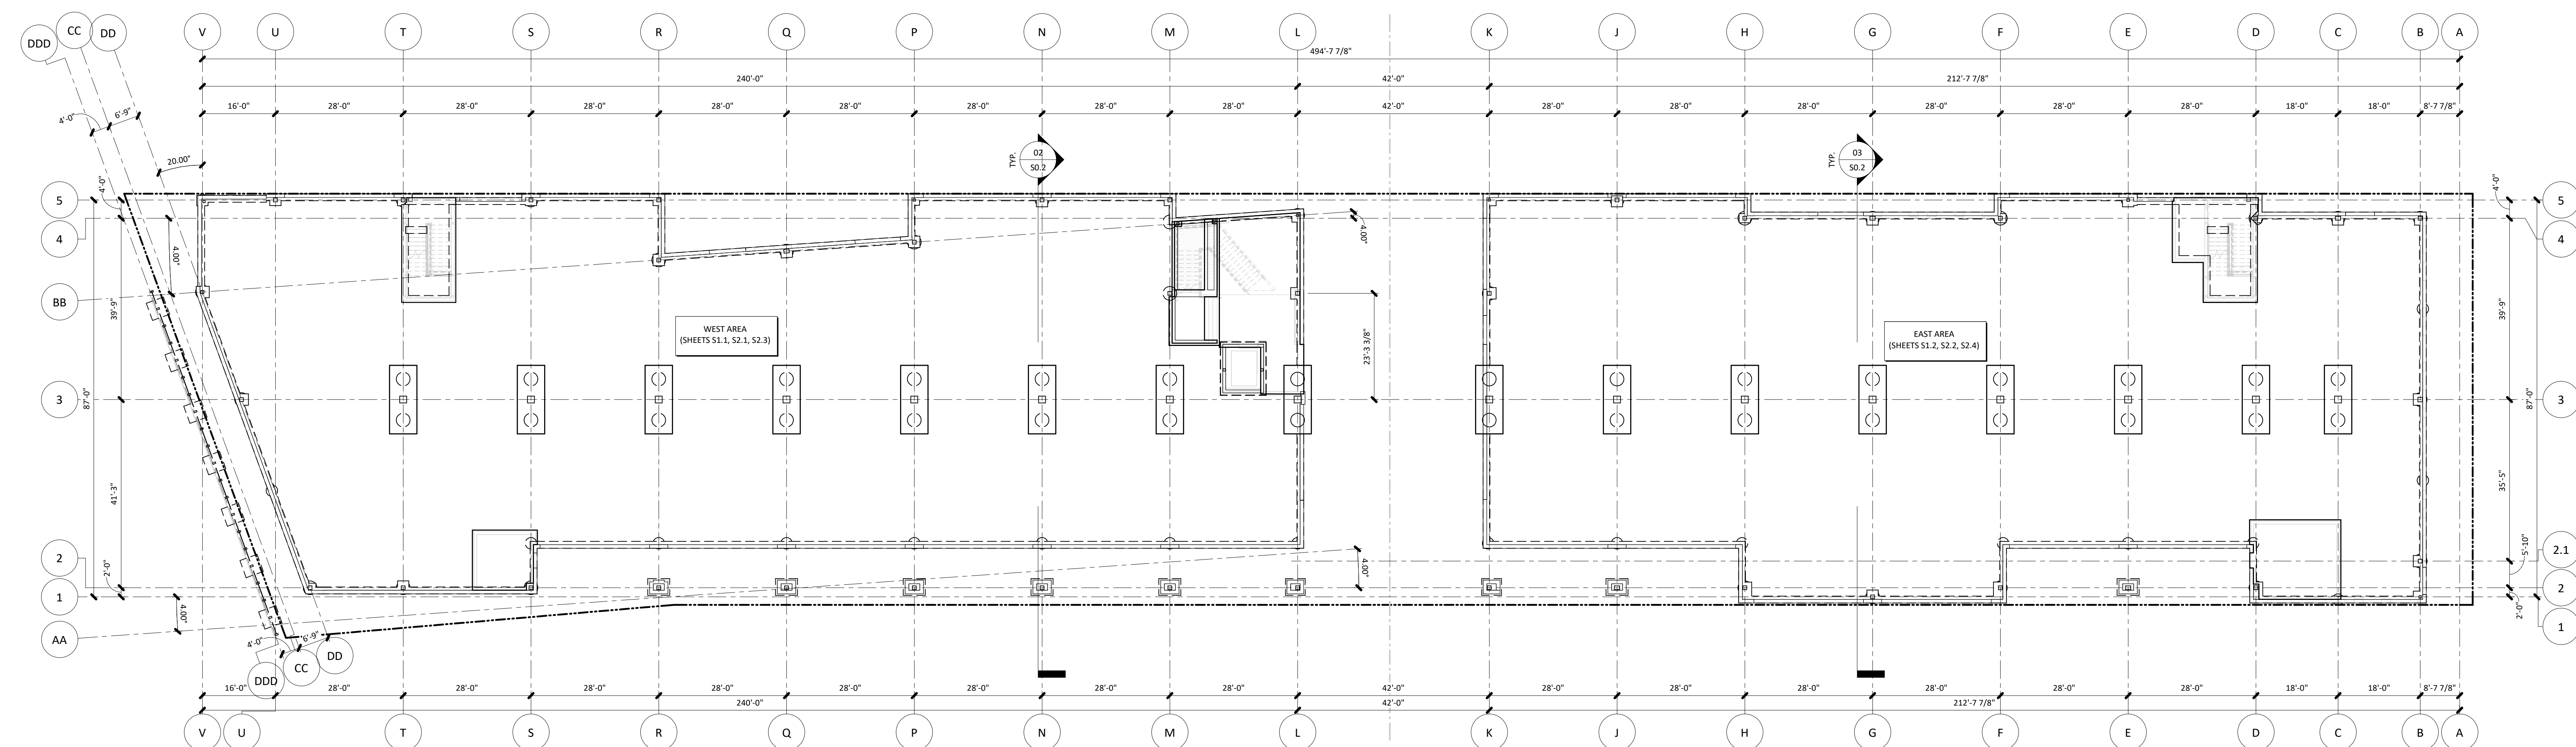


OVERALL PLAN | 01

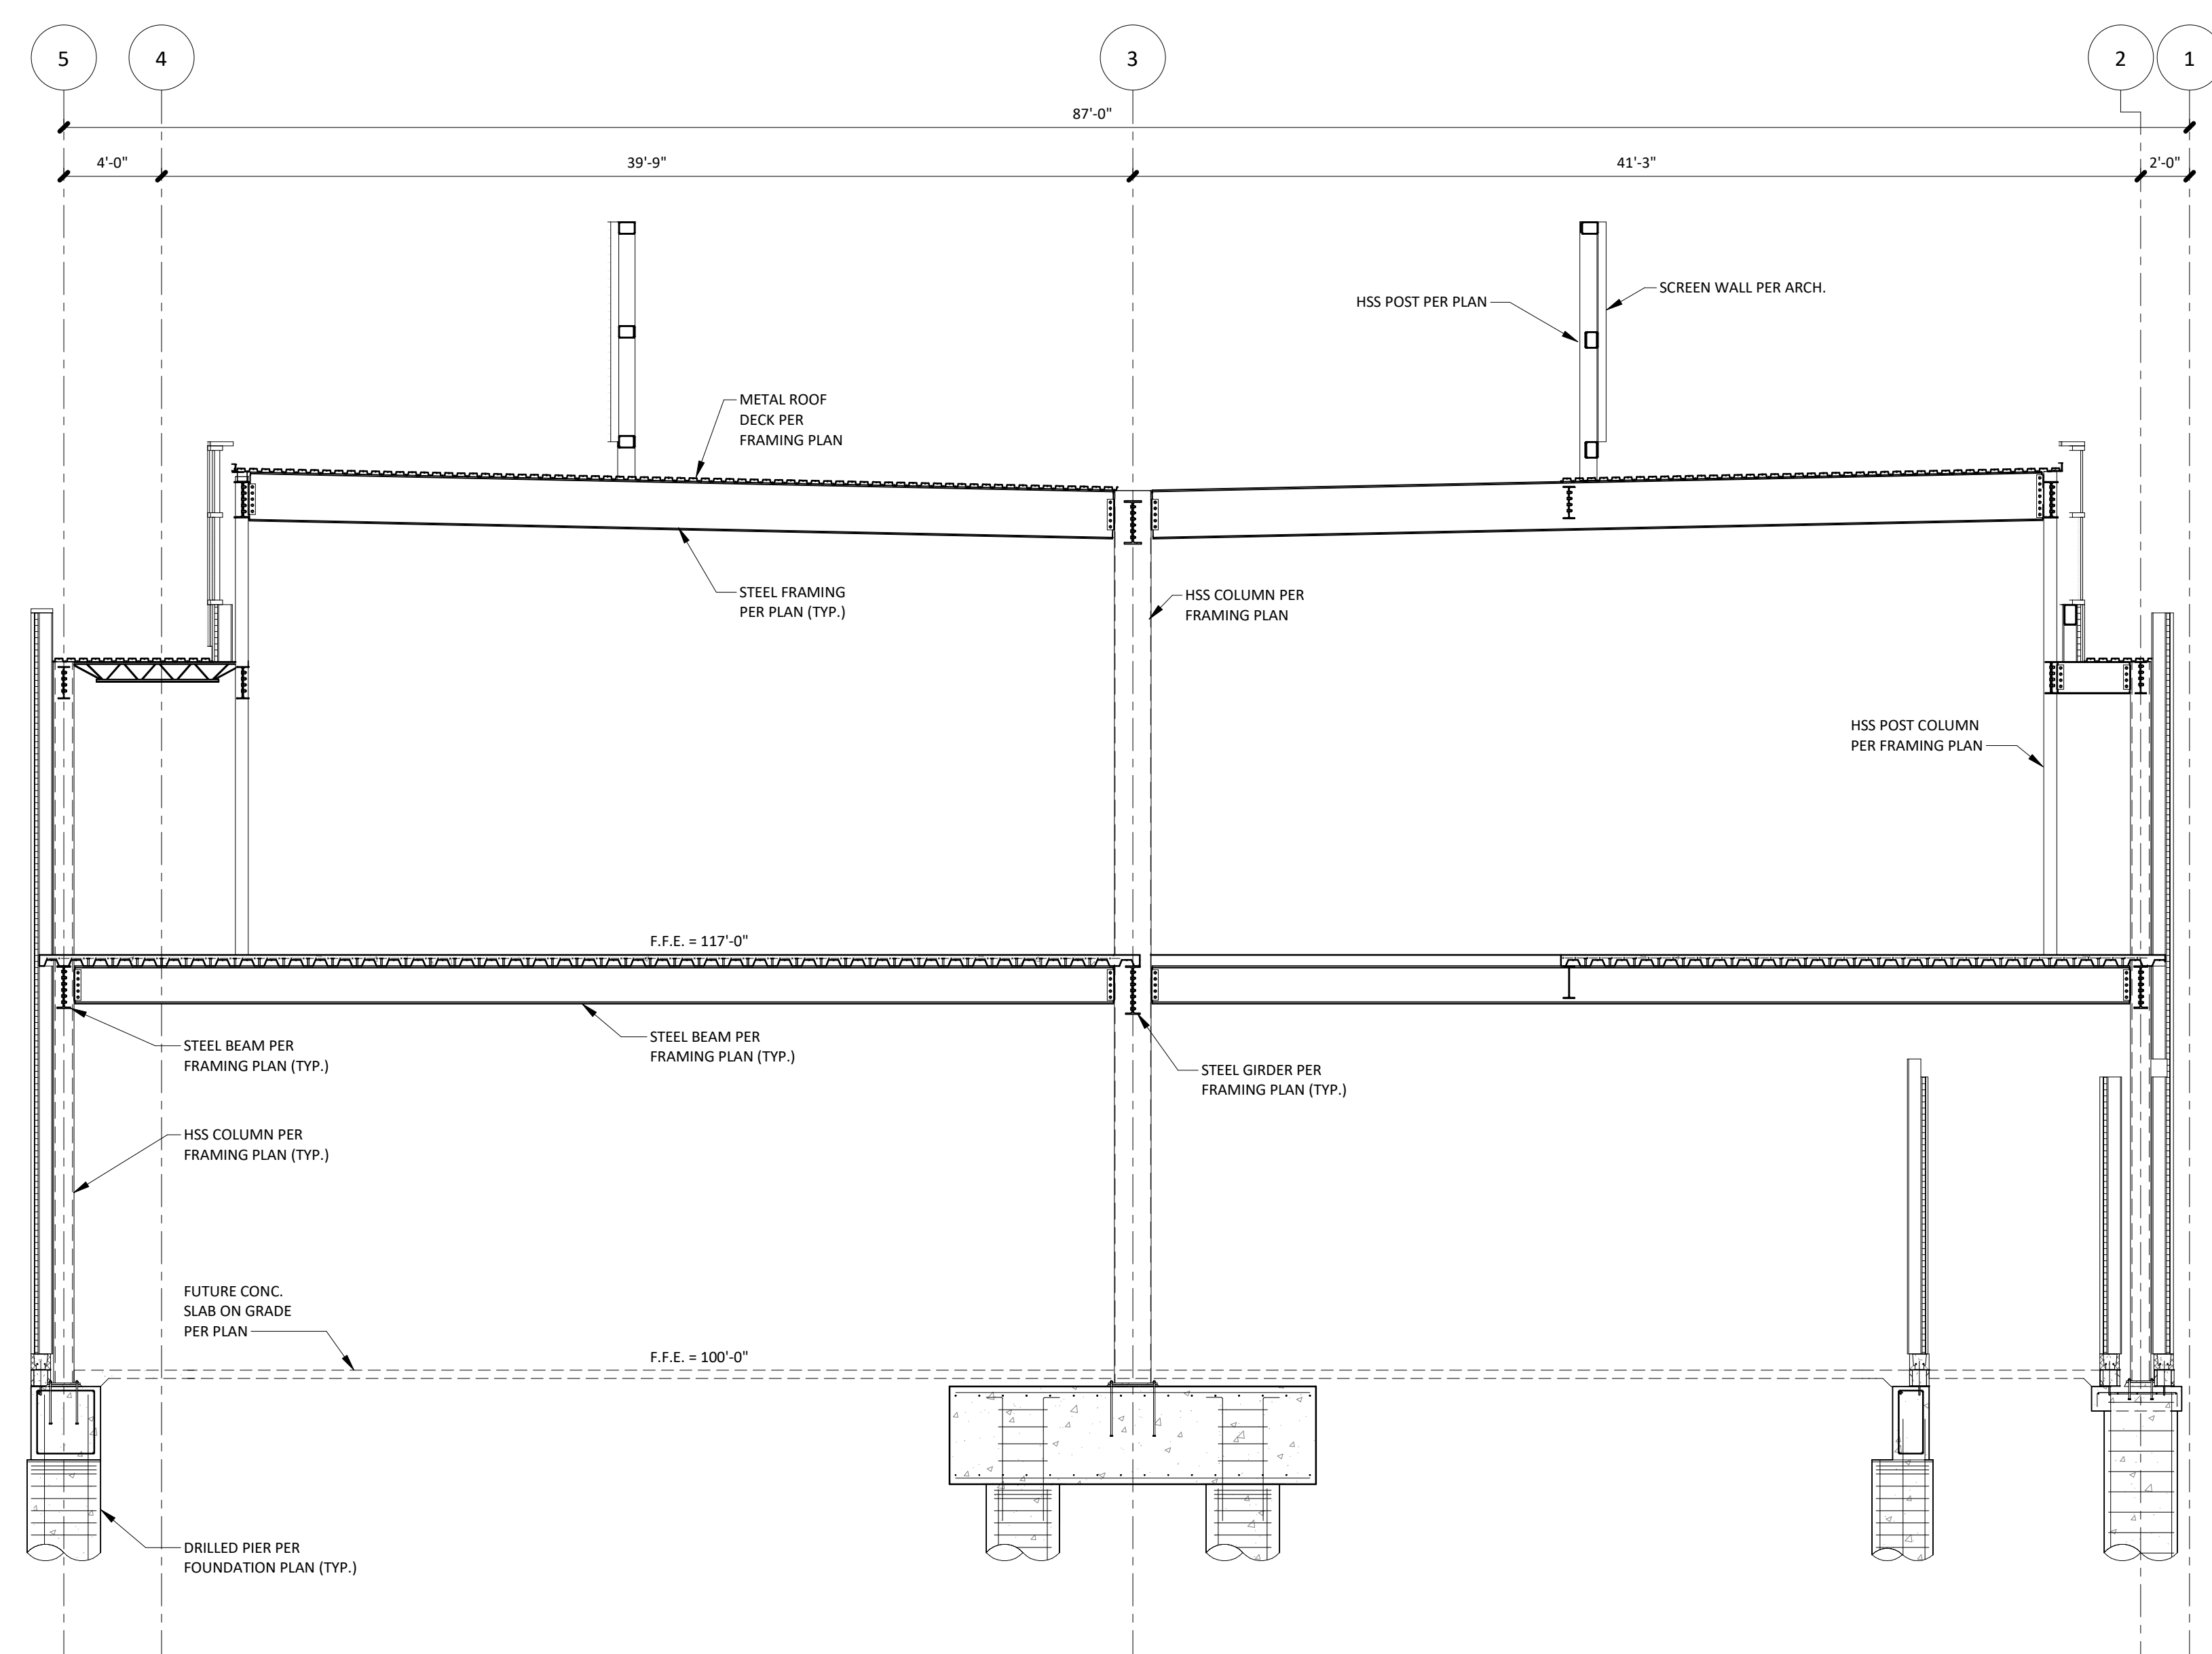

1.) BUILDING SECTIONS ARE SHOWN FOR SCHEMATIC PURPOSES ONLY. ACTUAL CONSTRUCTION TO MATCH CONSTRUCTION DOCUMENTS. REFERENCE ARCHITECTURAL, MECHANICAL, CIVIL, & STRUCTURAL DOCUMENTS.


|                  |      |
|------------------|------|
| BUILDING SECTION | 02   |
| 3/16" = 1'-0"    | S0.2 |

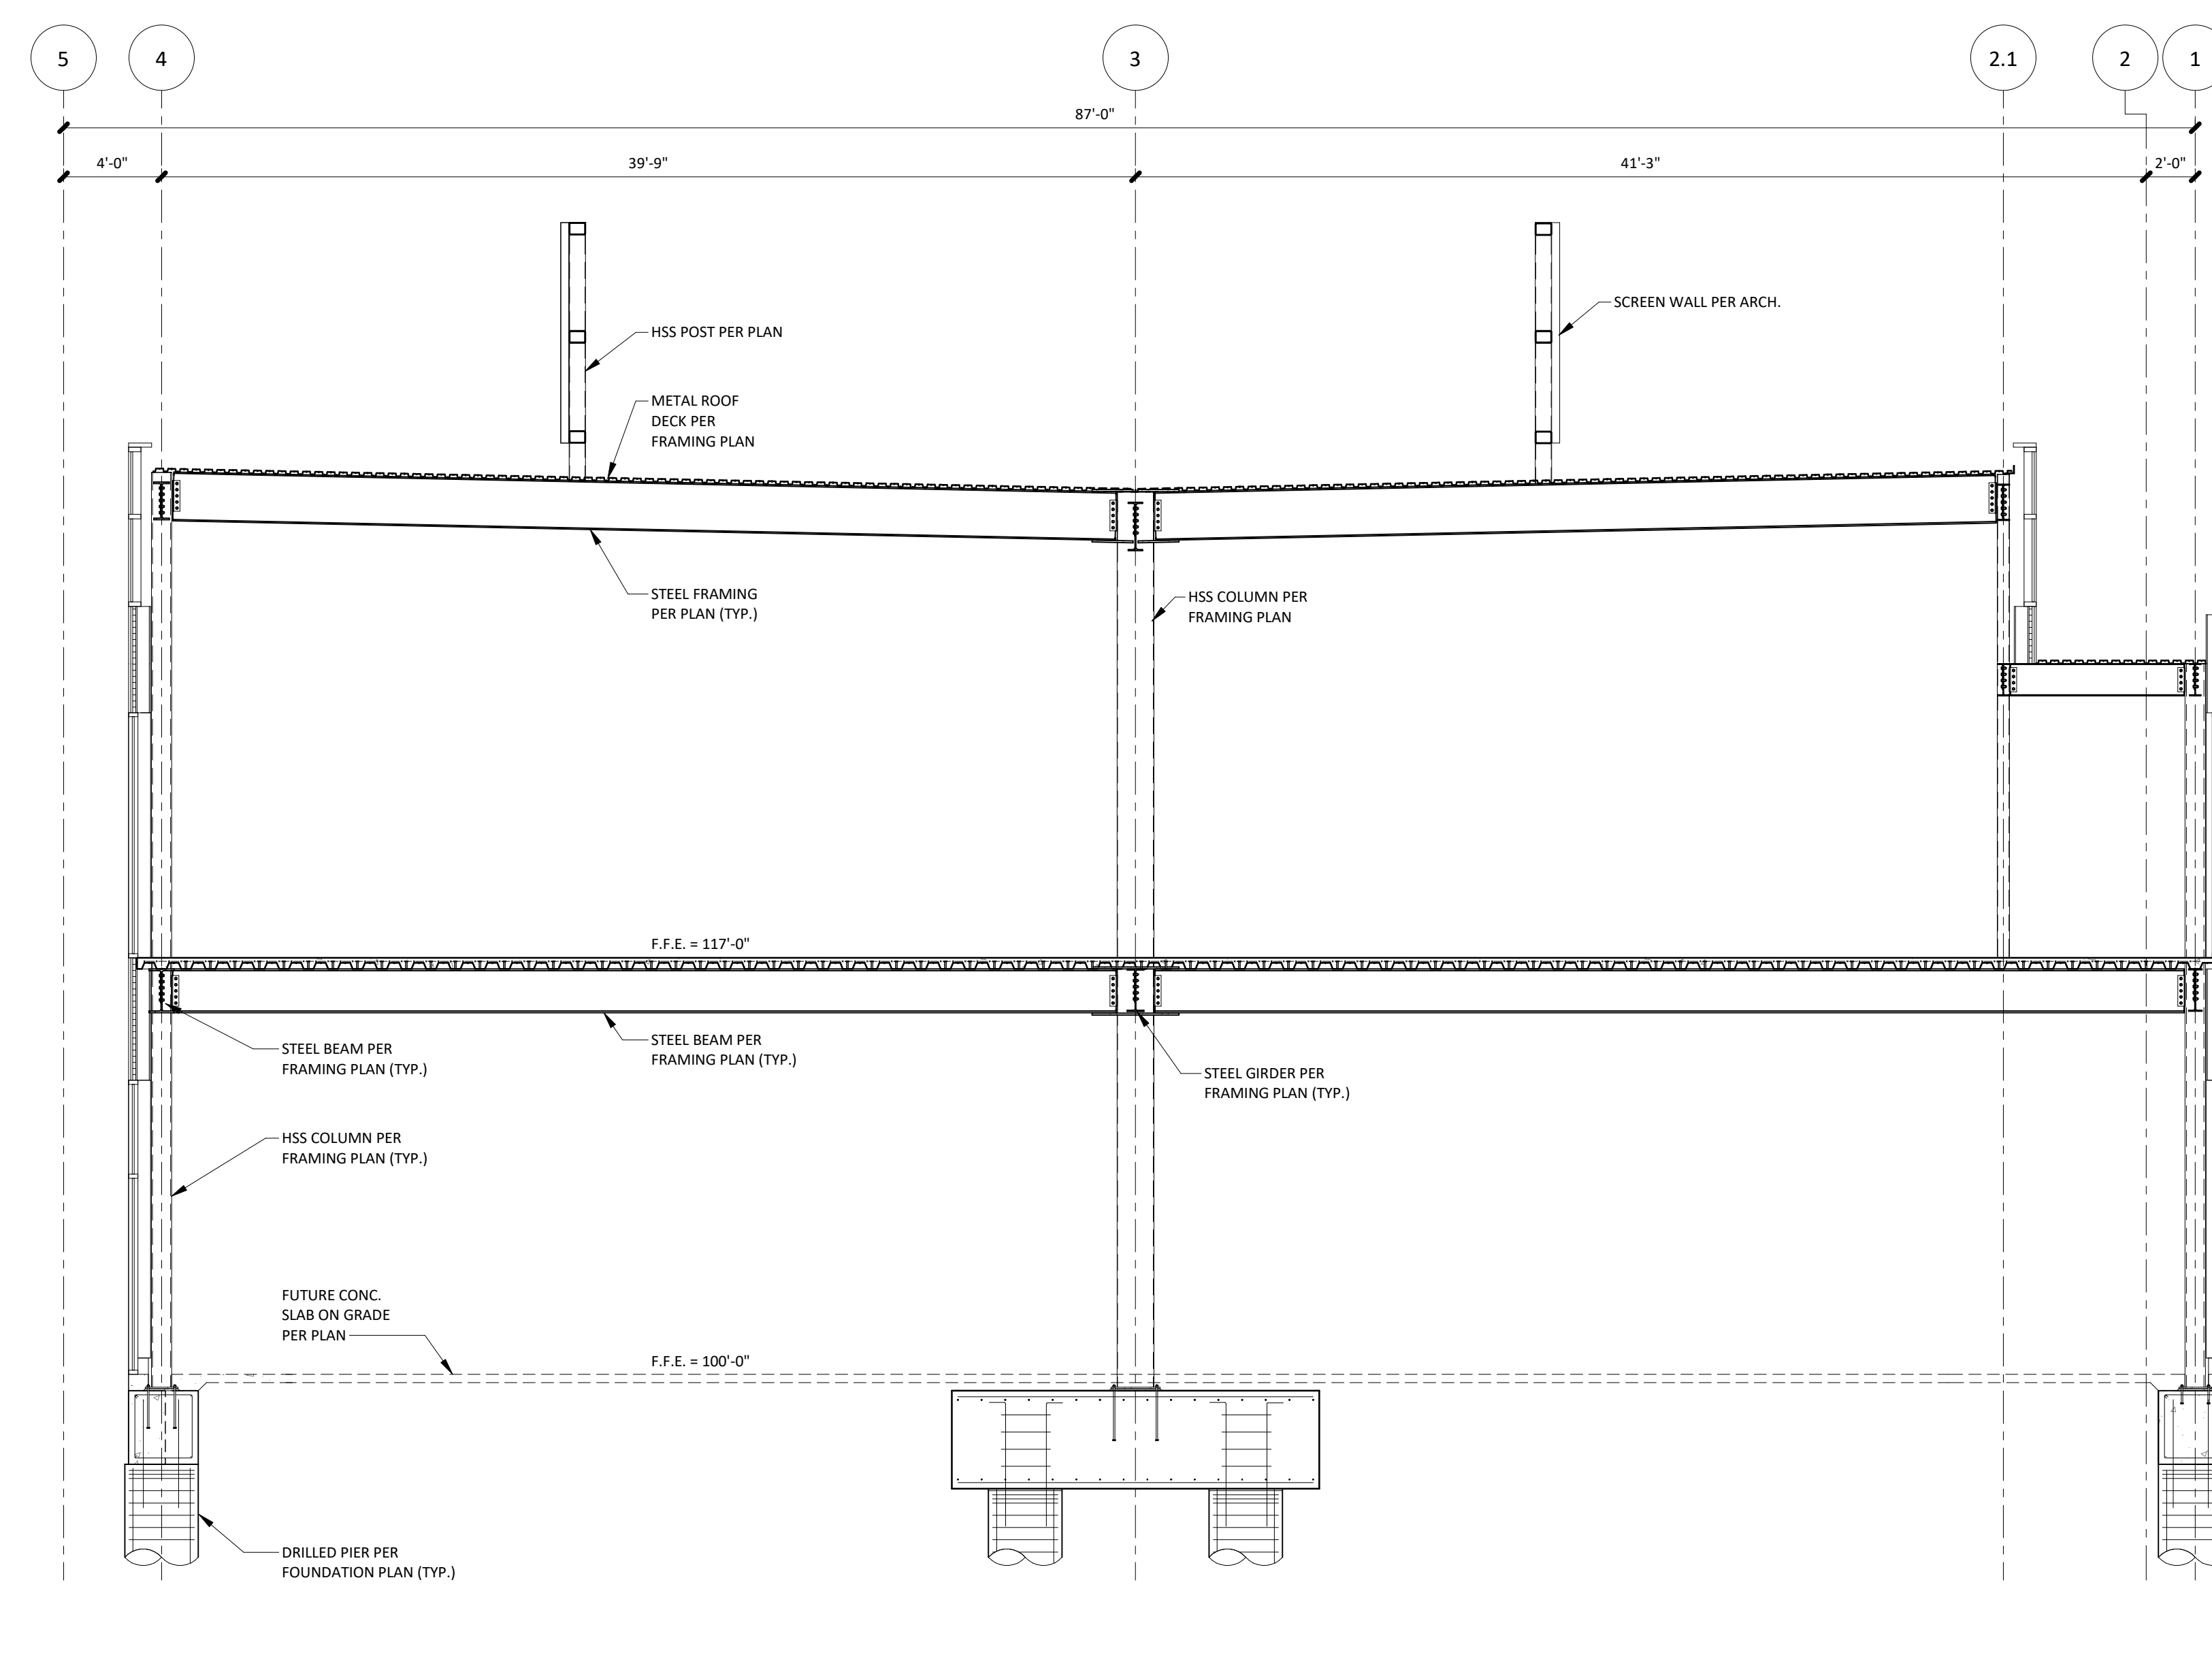

1.) BUILDING SECTIONS ARE SHOWN FOR SCHEMATIC PURPOSES ONLY. ACTUAL CONSTRUCTION TO MATCH CONSTRUCTION DOCUMENTS. REFERENCE ARCHITECTURAL, MECHANICAL, CIVIL, & STRUCTURAL DOCUMENTS.

|                  |      |
|------------------|------|
| BUILDING SECTION | 03   |
| 3/16" = 1'-0"    | S0.2 |



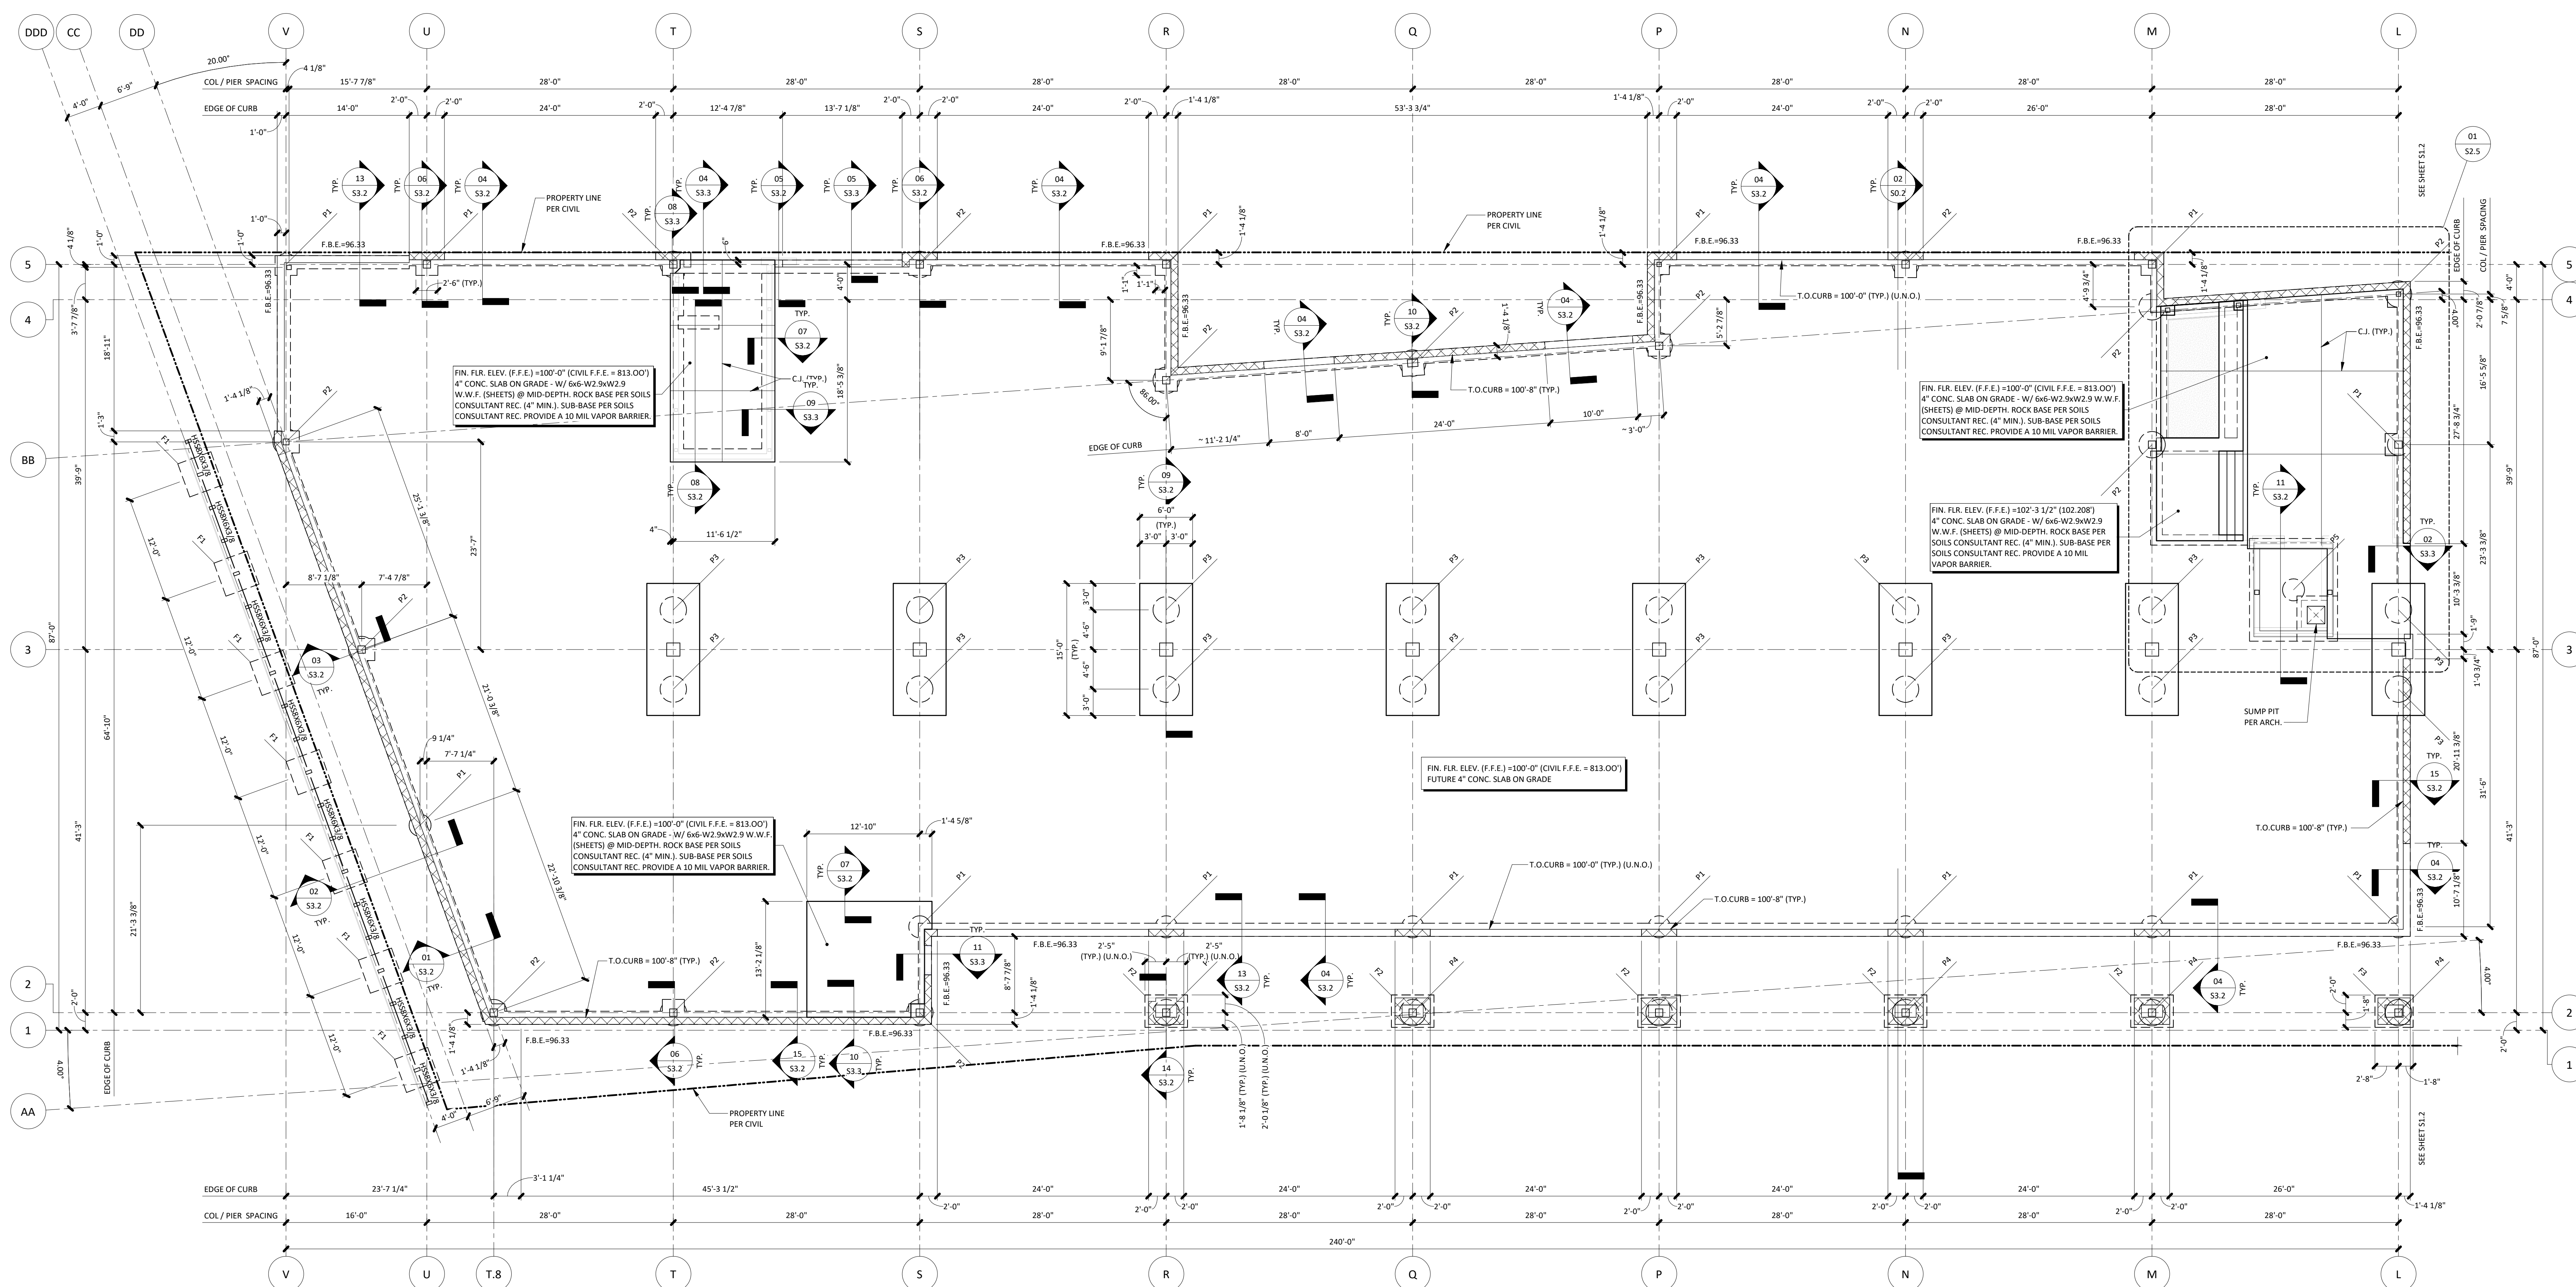

- 1.) SEE DRAWING S0.0 FOR GENERAL NOTES, SYMBOLS LEGEND, MATERIALS LEGEND, & ABBREVIATION LIST.
- 2.) REFERENCE DRAWING S3.1 FOR TYPICAL FOUNDATION DETAILS INCLUDING ANCHOR ROD DETAILS, FOOTING STEP DETAILS, CONTROL JOINT & CONSTRUCTION JOINT DETAILS, REINF. LAP LENGTH TABLE, ETC.
- 3.) SEE DRAWING S0.1 & S0.2 FOR ISOMETRIC VIEW & FULL BUILDING SECTIONS
- 4.) REINF. SHALL BE INSTALLED IN TOP 15'-0" OF PIERS
- 5.) REFER TO GEOTECHNICAL REPORT FOR SOIL REQUIREMENTS AT BASE OF PIER.
- 6.) VERIFY BEARING W/ GEOTECHNICAL ENGINEER.
- 7.) REFER TO GEOTECHNICAL REPORT FOR APPROXIMATE BOTTOM OF PIER ELEVATIONS.
- 8.) @ BOTT. OF PIER ELEVATION FOR BIDDING PURPOSES ONLY. G.C. TO FIELD VERIFY TO ENSURE ADEQUATE BEARING & EMBEDMENT PER GEOTECHNICAL REPORT IS PROVIDED.
- 9.) REFER TO GEOTECHNICAL REPORT FOR BEHIND WALL DRAINAGE RECOMMENDATIONS. COORD. W/ CIVIL & RIZZO. REFER TO ARCHITECTURAL DRAWINGS FOR FOUNDATION WATERPROOFING & INSULATION REQUIREMENT
- 10.) COAT ALL EXPOSED STEEL BELOW GRADE W/ COAL TAR EPOXY OR FULLY ENCASED IN GROUT

| DRILLED PIER SCHEDULE |               |                     |               |        |
|-----------------------|---------------|---------------------|---------------|--------|
| MARK                  | PIER DIAMETER | VERT. REINFORCEMENT | PIER TIES     | T.O.P. |
| P1                    | 30"           | (16) #6             | #3 @ 10" SPA. | 96'-4" |
| P2                    | 36"           | (24) #6             | #3 @ 10" SPA. | 96'-4" |
| P3                    | 36"           | (24) #6             | #3 @ 10" SPA. | 95'-8" |
| P4                    | 36"           | (24) #6             | #3 @ 10" SPA. | 99'-4" |
| P5                    | 36"           | (16) #6             | #3 @ 10" SPA. | 93'-4" |

**NOTE:**  
- EMBED DRILLED PIER INTO ROCK PER THE GEOTECHNICAL REPORT RECOMMENDATIONS

The diagram consists of two irregular, block-like shapes representing land areas. The left shape is shaded gray and contains the text 'WEST AREA'. The right shape is white with a black outline and contains the text 'EAST AREA'.

FOUNDATION PLAN - WEST | 01





NOTE:  
- EMBED DRILLED PIER INTO ROCK PER THE GEOTECHNICAL REPORT RECOMMENDATION



[illegible]

## REGISTRATION




## PROJECT TEAM

|                 |                                 |
|-----------------|---------------------------------|
| ARCHITECT       | FINKLE+WILLIAMS<br>ARCHITECTURE |
| CIVIL           | GBA                             |
| LANDSCAPE       | HOERR SCHAUDT /<br>LAND3        |
| FOUNDATIONS     | BSE STRUCTURAL<br>ENGINEERS     |
| STRUCTURAL      | BSE STRUCTURAL<br>ENGINEERS     |
| PLUMBING        | HENDERSON<br>ENGINEERS          |
| MECHANICAL      | HENDERSON<br>ENGINEERS          |
| ELECTRICAL      | HENDERSON<br>ENGINEERS          |
| FIRE PROTECTION | FIRE PROTECTION                 |
| CONTRACTOR      | FOGEL ANDERSON                  |




1132 West 79th Street  
Lenexa, Kansas 66214  
Phone 913.492.7400  
www.BSEstructural.com  
Project Number 19-354

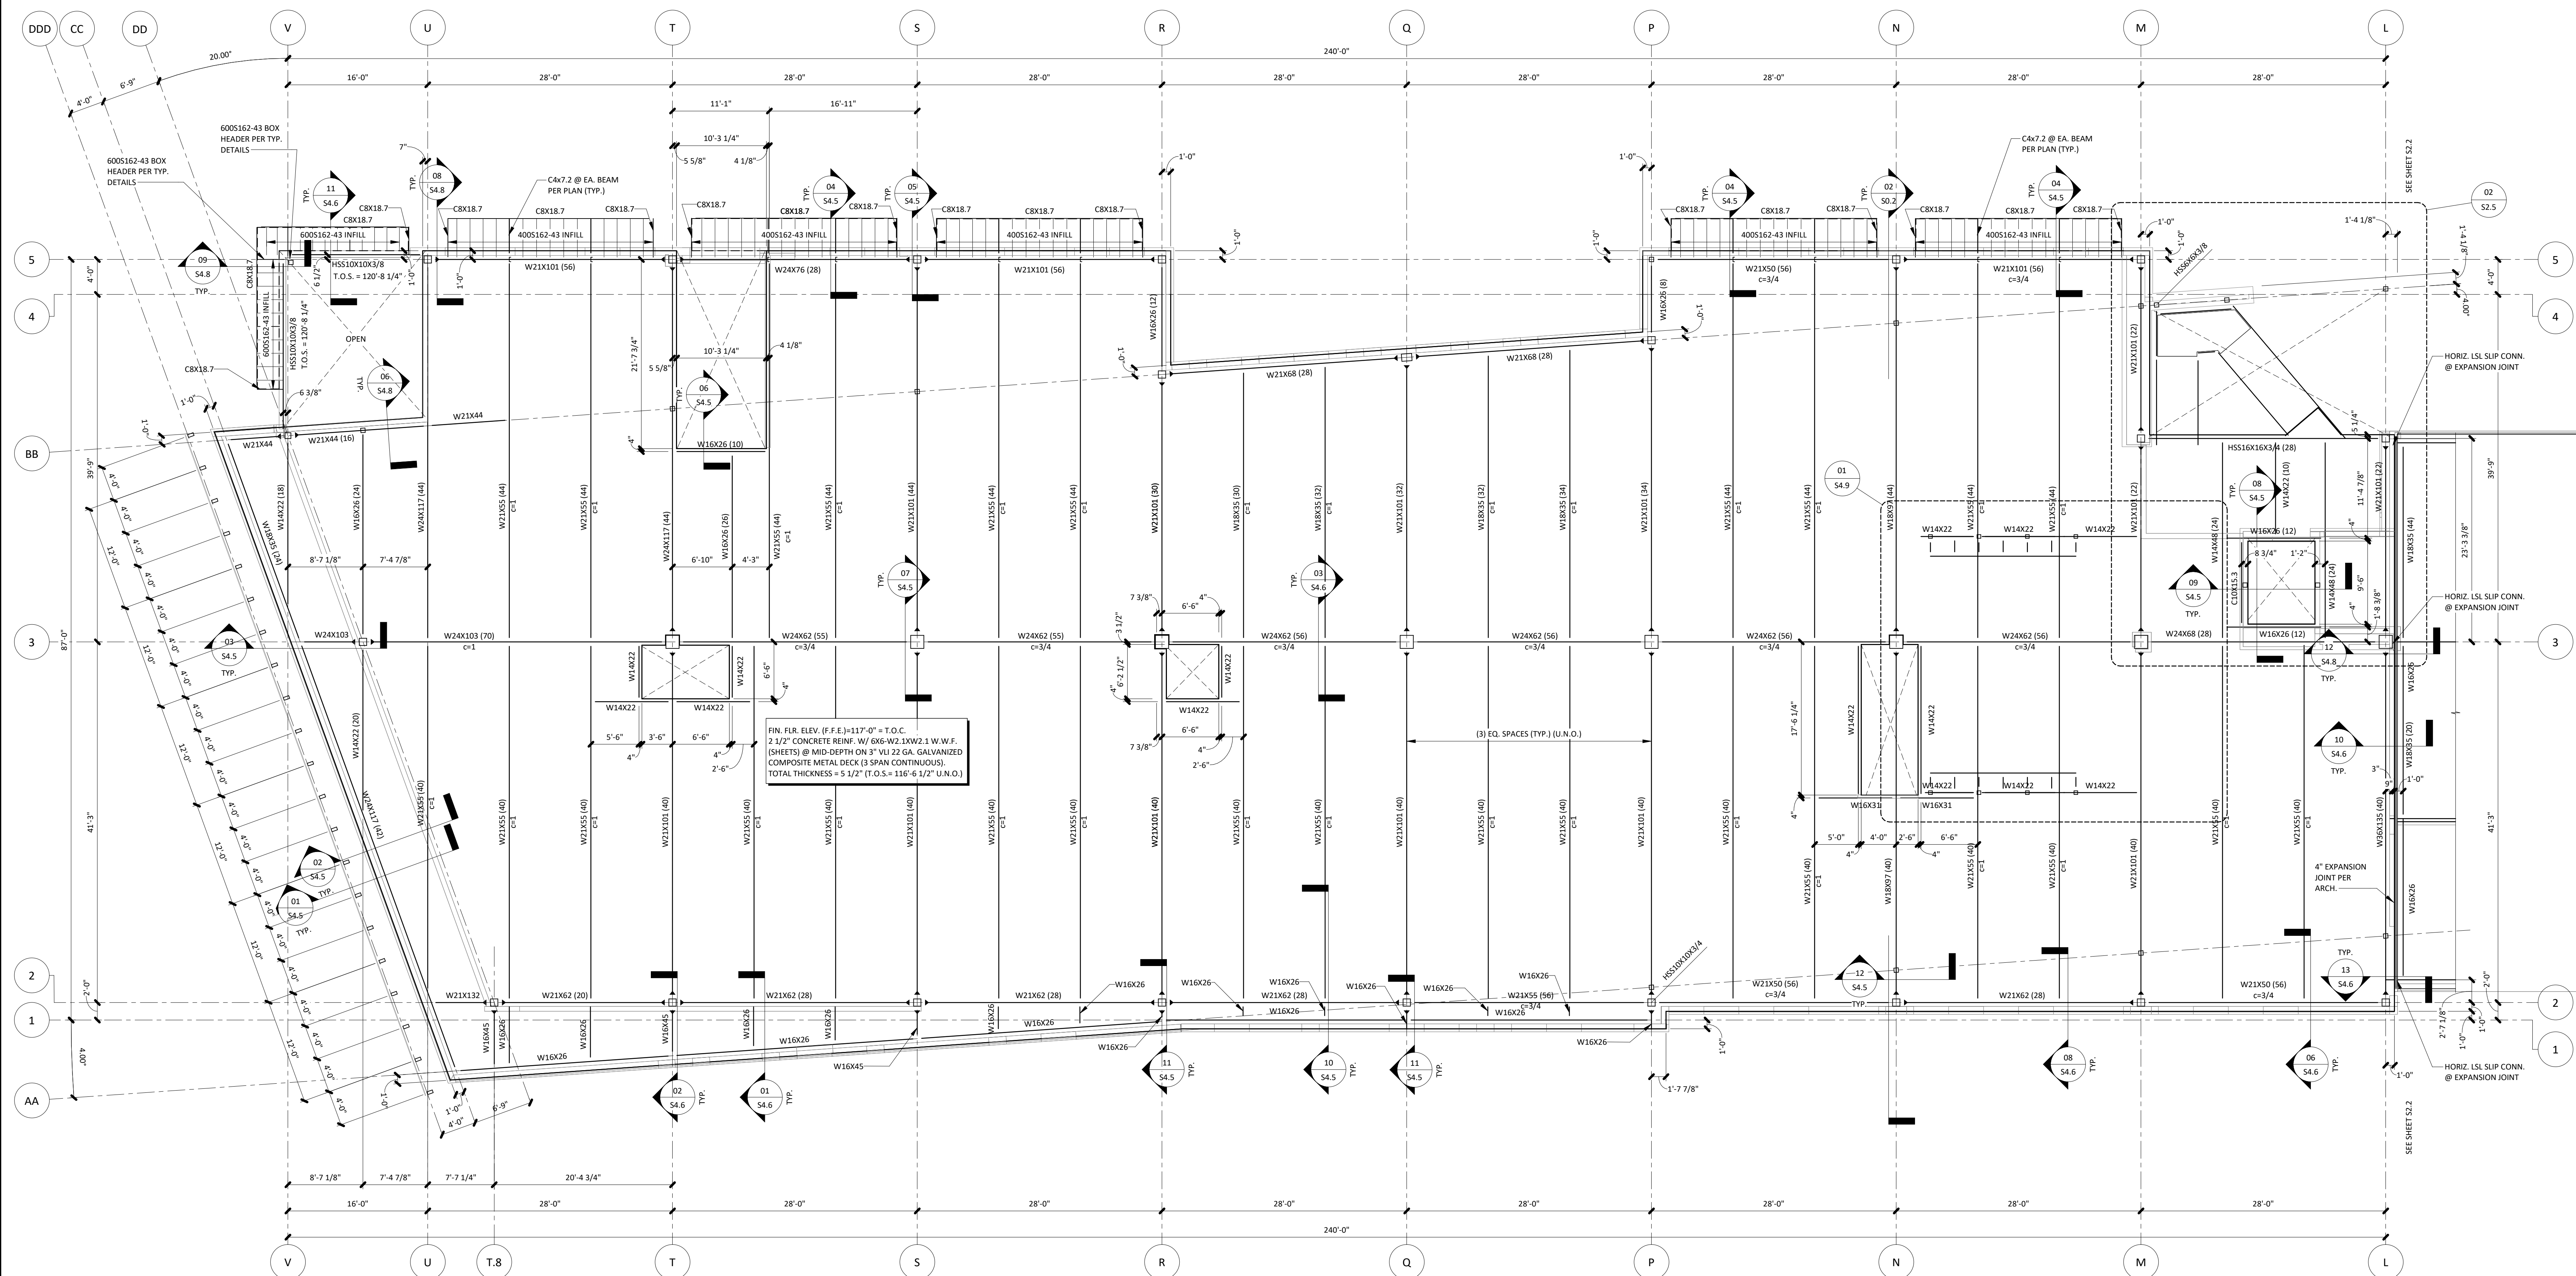

NOTES:

- 1.) SEE DRAWING SO 4 FOR GENERAL NOTES, SYMBOLS/LEGEND, MATERIALS/LEGEND, & ABBREVIATION LIST.
- 2.) REFERENCE DRAWING 54.1 FOR TYPICAL FRAMING DETAILS.
- 3.) SEE DRAWING SO 1 FOR ISOMETRIC VIEW & FULL BUILDING SECTIONS.
- 4.) REFERENCE ARCHITECTURAL DRAWINGS TO VERIFY SIZE & LOCATIONS OF ALL FLOOR & WALL OPENINGS.
- 5.) PROVIDE JOIST BRIDGING PER SJI REQUIREMENTS.
- 6.) PROVIDE 3/4" x 1/2" LONG HEADED SHEAR STUDS FOR COMPOSITE BEAMS. SEE TYPICAL FRAMING DETAIL SHEET FOR ADDITIONAL DETAILS.
- 7.) ATTACH COMPOSITE METAL DECK W/ 1/8" SPAN WELD IN A 36/4 PATTERN & (2) WELDED SIDE W/ 5/16" PER SPAN.
- 8.) G.C. TO COORDINATE CONSTRUCTION JOINT IN CONC. SLAB POUR AT THIS GRID.
- 9.) G.C. TO COORD. COMP. CONC. SLAB PIGMENT AND FINISH W/ ARCH.
- 10.) ALL EXTERIOR STEEL EXPOSED TO WEATHER SHALL BE HOT-DIPPED GALVANIZED AND/OR PAINTED PER ARCHITECT UNLESS NOTED OTHERWISE.

### KEY PLAN

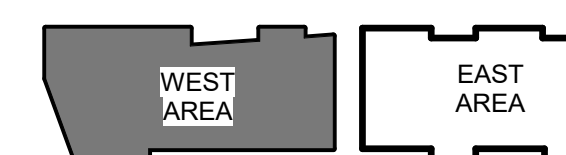

2ND FLOOR FRAMING PLAN - WEST | 01

|                |      |
|----------------|------|
| $1/8" = 1'-0"$ | S2.1 |
|----------------|------|




SHEET TITLE

2ND FLOOR  
FRAMING PLAN -  
WEST

SHEET NUMBER

## S2.1



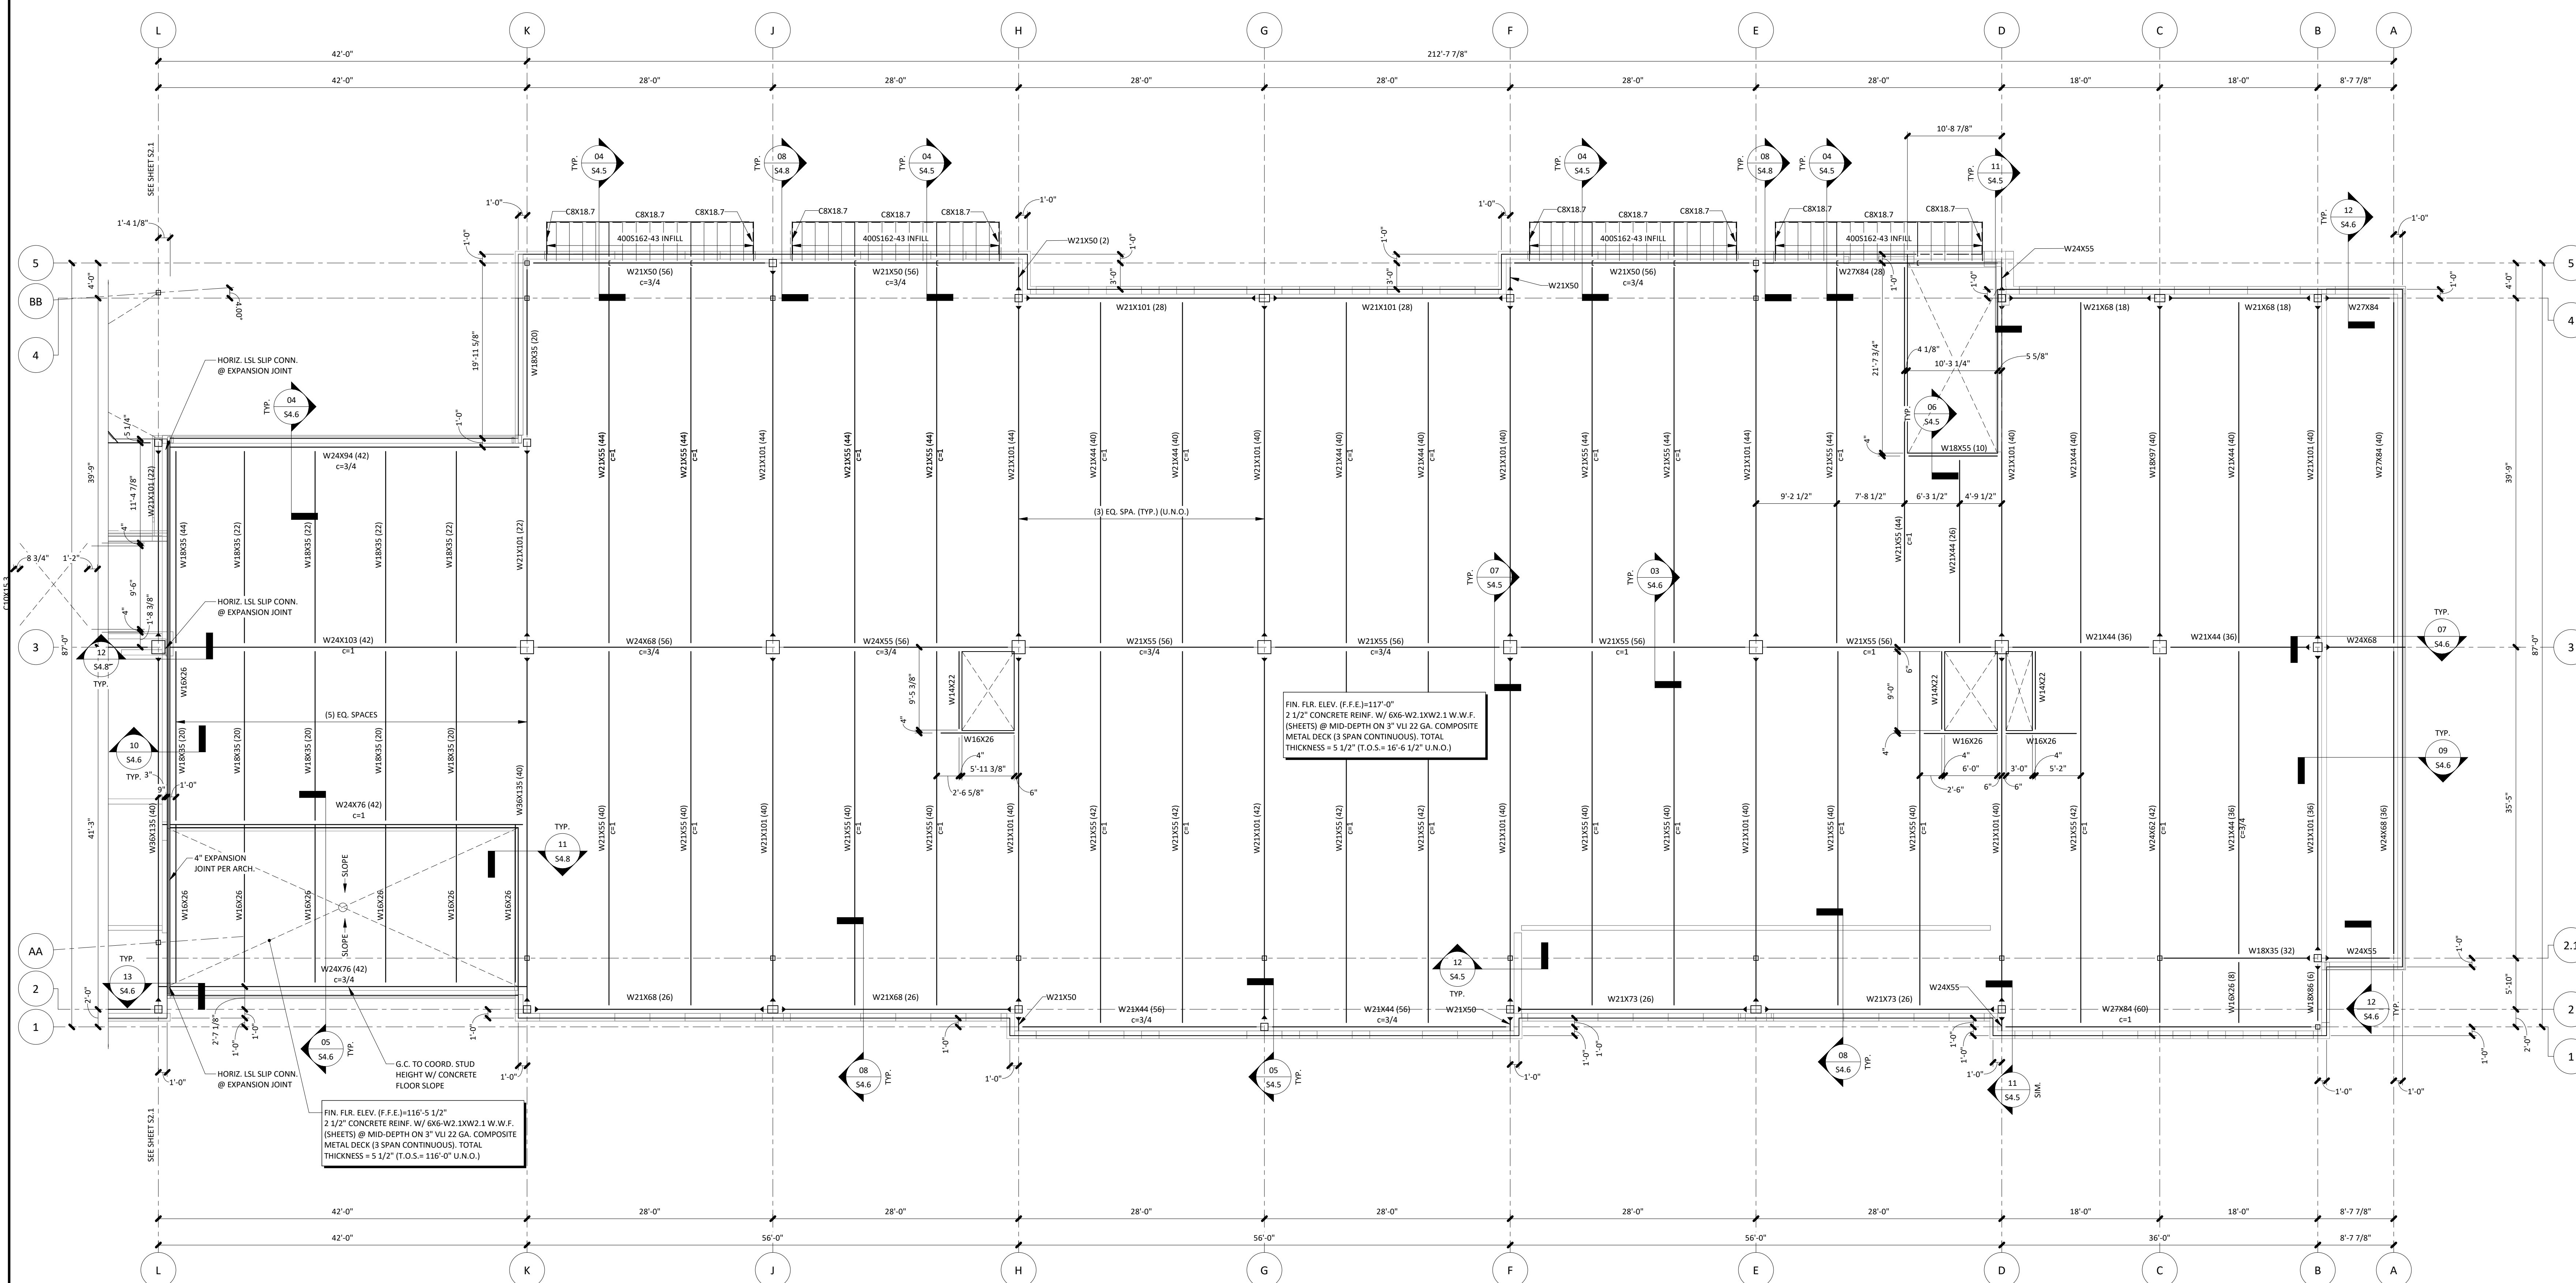

- 1.) SEE DRAWING 50.0 FOR GENERAL NOTES, SYMBOLS LEGEND, MATERIALS LEGEND, & ABREVIATION LIST.
- 2.) REFERENCE DRAWING 54.1 FOR TYPICAL FRAMING DETAILS.
- 3.) SEE DRAWING 50.1 FOR ISOMETRIC VIEW & FULL BUILDING SECTION.
- 4.) REFERENCE ARCHITECTURAL DRAWINGS TO VERIFY SIZE & LOCATION OF ALL FLOOR & WALL OPENINGS.
- 5.) PROVIDE JOIST BRIDGING PER SJI REQUIREMENTS.
- 6.) PROVIDE 3/4" x 1/2" LONG HATED SHEAR STUDS FOR COMPOSITE BEAMS. SEE TYPICAL FRAMING DETAIL SHEET FOR ADDITIONAL DETAILS.
- 7.) ATTACH COMPOSITE METAL DECK W/ 5/8" PUDDLE WELD IN A 36/4 PATTERN & 2) WELDED SIDE LAP FASTENERS PER SPAN.
- 8.) G.C. TO COORDINATE CONSTRUCTION JOINT IN CONCL. SLAB POUR AT THIS GRID.
- 9.) G.C. TO COORD. COMP. CONCL. SLAB PIGMENT AND FINISH W/ ARCH.

The diagram consists of two adjacent irregular polygons. The left polygon is white with a black outline and is labeled "WEST AREA". The right polygon is gray with a black outline and is labeled "EAST AREA".

|                |      |
|----------------|------|
| $1/8" = 1'-0"$ | S2.2 |
|----------------|------|







| REVISIONS |      |             |
|-----------|------|-------------|
| No.       | Date | Description |
|           |      |             |
|           |      |             |
REGISTRATION



PROJECT TEAM

|                 |                                  |
|-----------------|----------------------------------|
| ARCHITECT       | FINKLE- WILLIAMS<br>ARCHITECTURE |
| CIVIL           | GBA                              |
| LANDSCAPE       | HOERR SCHAUDT /<br>LAND3         |
| FOUNDATIONS     | BSE STRUCTURAL<br>ENGINEERS      |
| STRUCTURAL      | BSE STRUCTURAL<br>ENGINEERS      |
| PLUMBING        | HENDERSON<br>ENGINEERS           |
| MECHANICAL      | HENDERSON<br>ENGINEERS           |
| ELECTRICAL      | HENDERSON<br>ENGINEERS           |
| FIRE PROTECTION | FIRE PROTECTION                  |
| CONTRACTOR      | FOGEL ANDERSON                   |






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Project Number 19-354

SHEET TITLE

ROOF FRAMING  
PLAN - EAST















SHEET NUMBER

S2.4

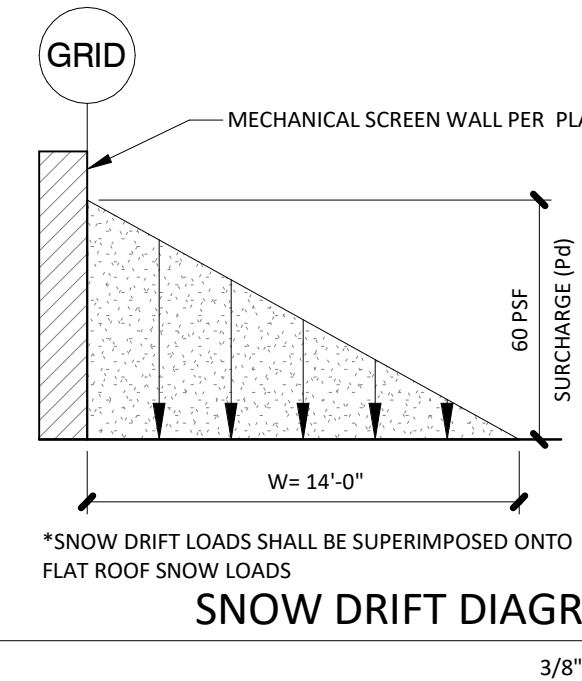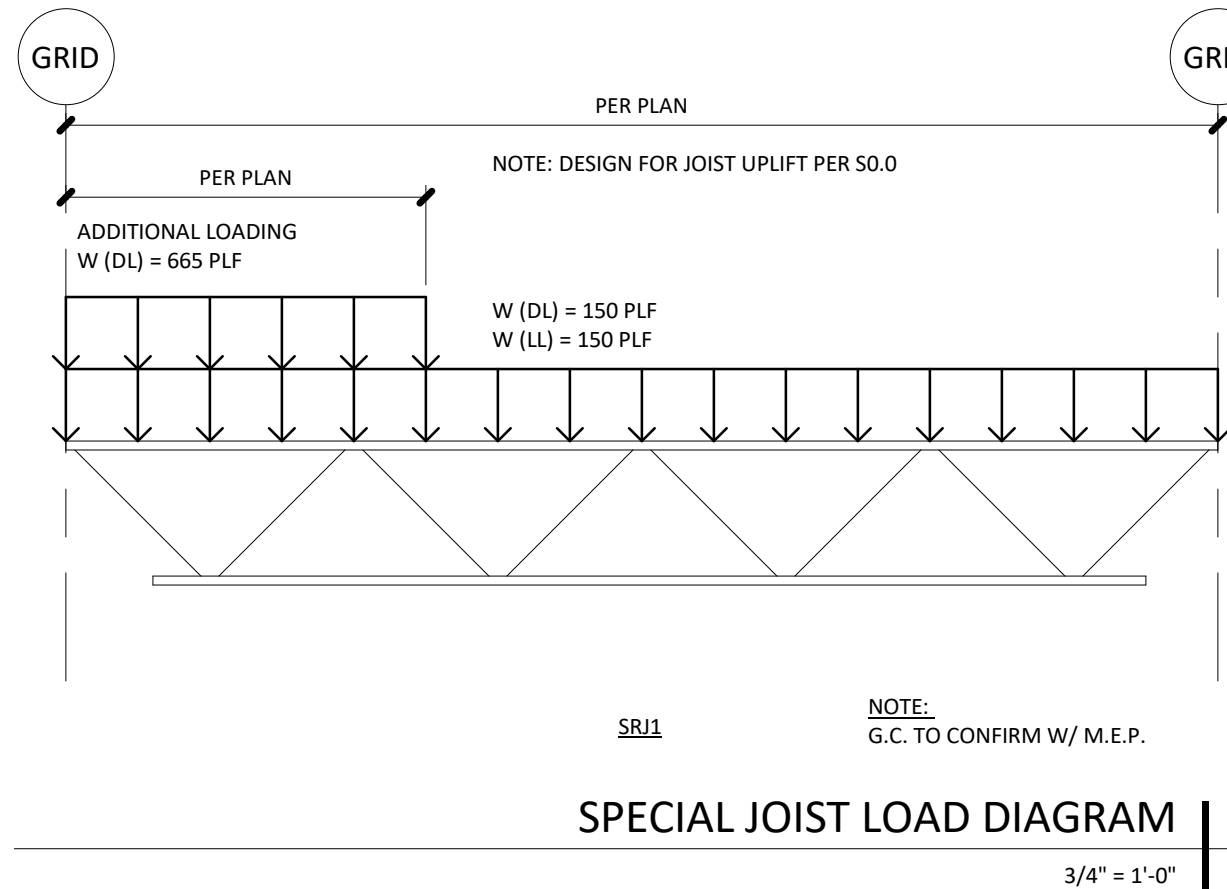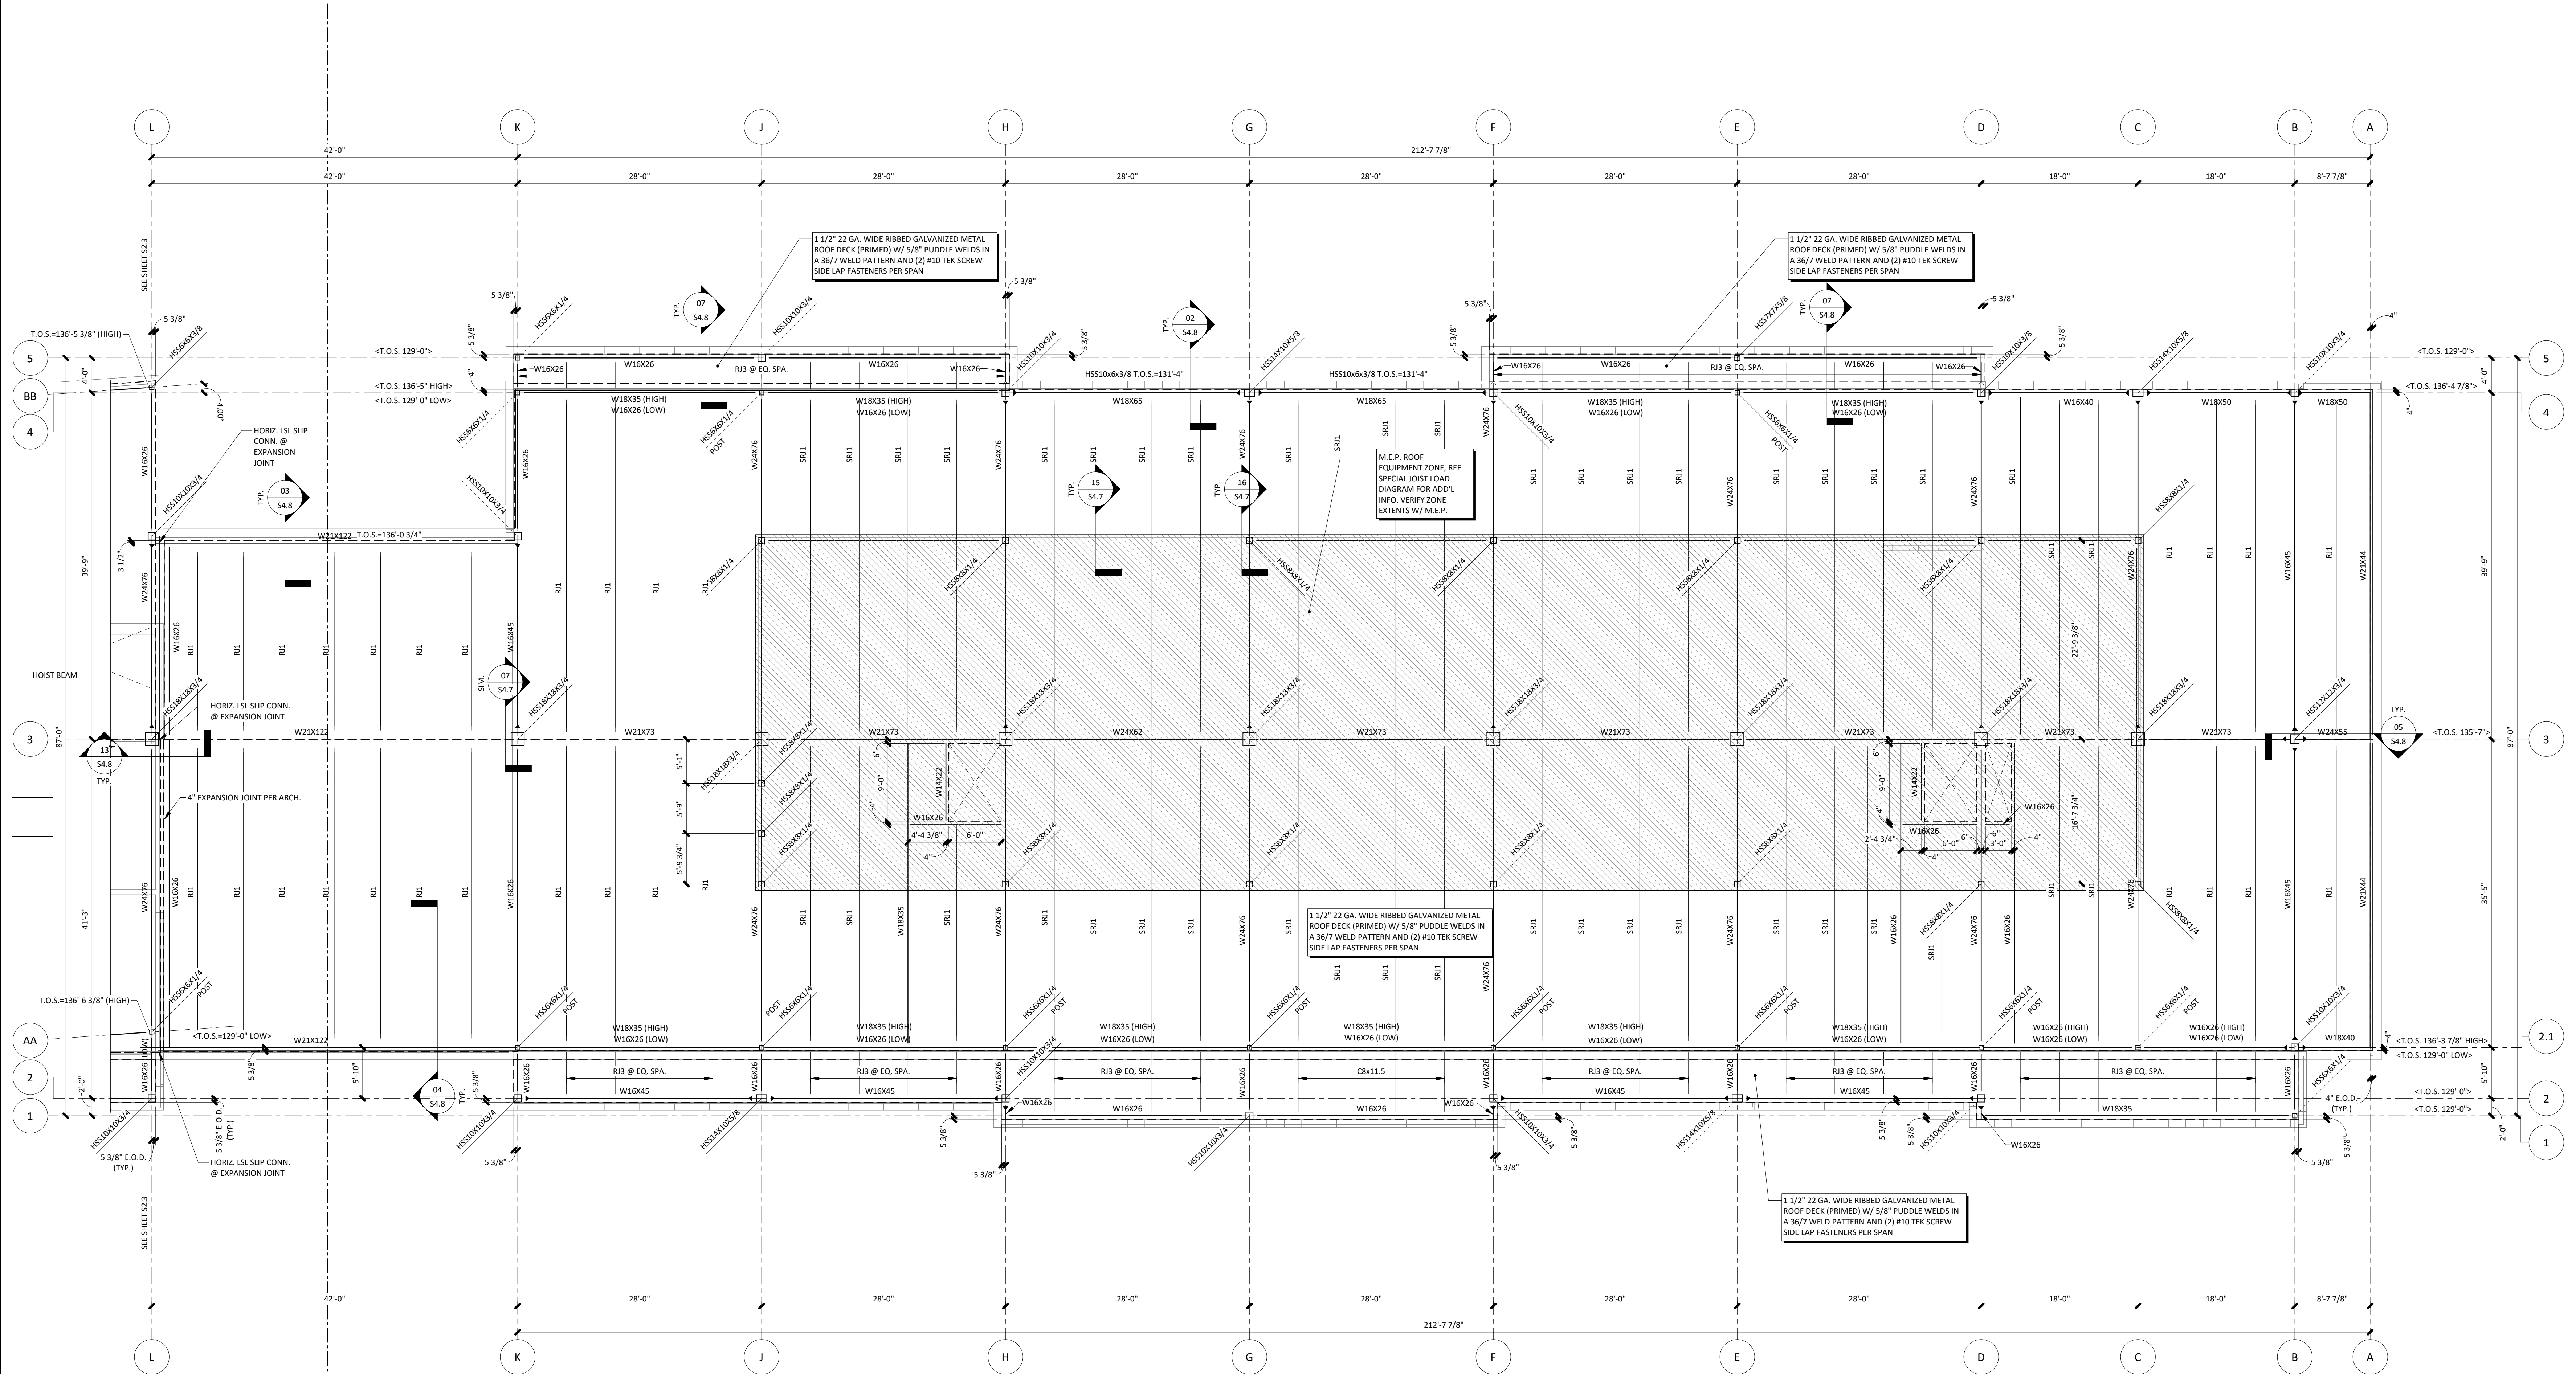

- NOTES:
- 1.) SEE DRAWING S.O.0 FOR GENERAL NOTES, SYMBOLS LEGEND, MATERIALS LEGEND, & ABBREVIATION LIST.
  - 2.) REFERENCE DRAWING S4.1 FOR TYPICAL FRAMING DETAILS.
  - 3.) SEE DRAWING S.O.1 FOR ISOMETRIC VIEW & FULL BUILDING SECTIONS.
  - 4.) REFERENCE ARCHITECTURAL DRAWINGS TO VERIFY SIZE & LOCATIONS OF ALL ROOF & WALL OPENINGS.
  - 5.) PROVIDE JOIST BRIDGING PER SUI REQUIREMENTS.
- KEY PLAN
- WEST AREA EAST AREA
- ROOF FRAMING PLAN - EAST | 01
- 1/8" = 1'-0"



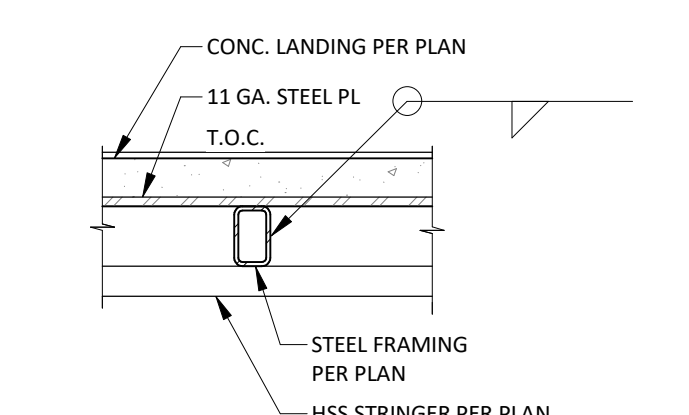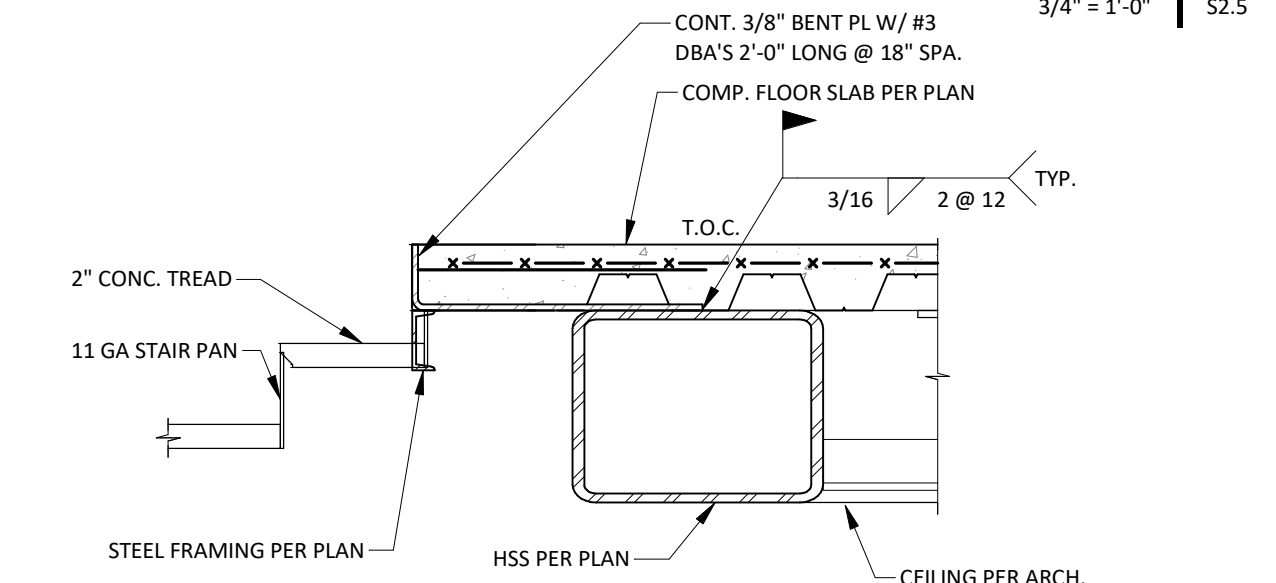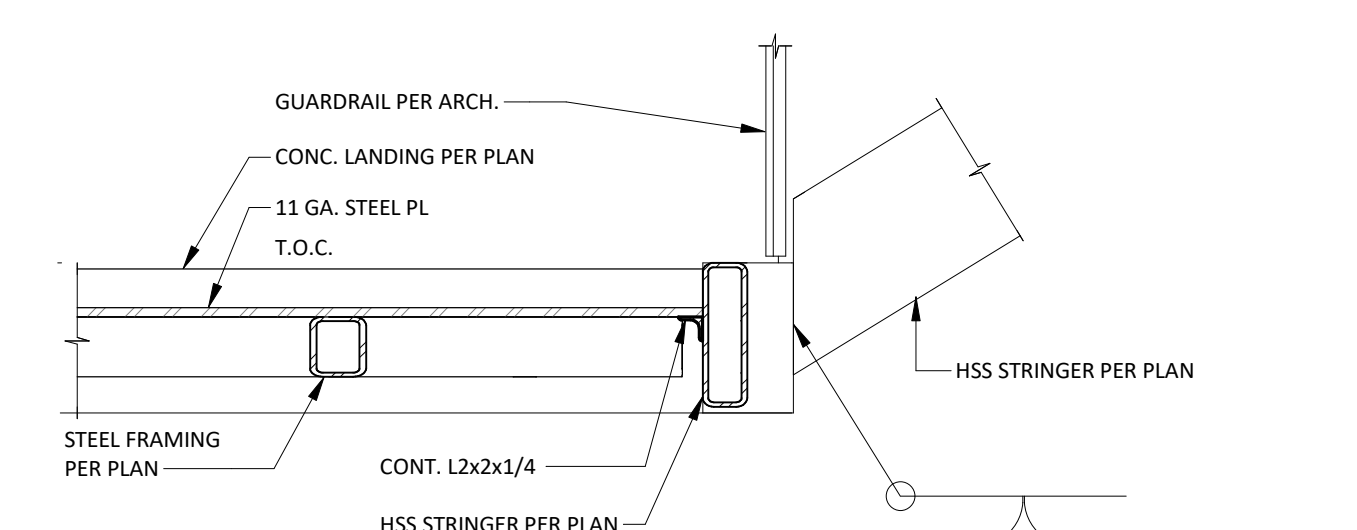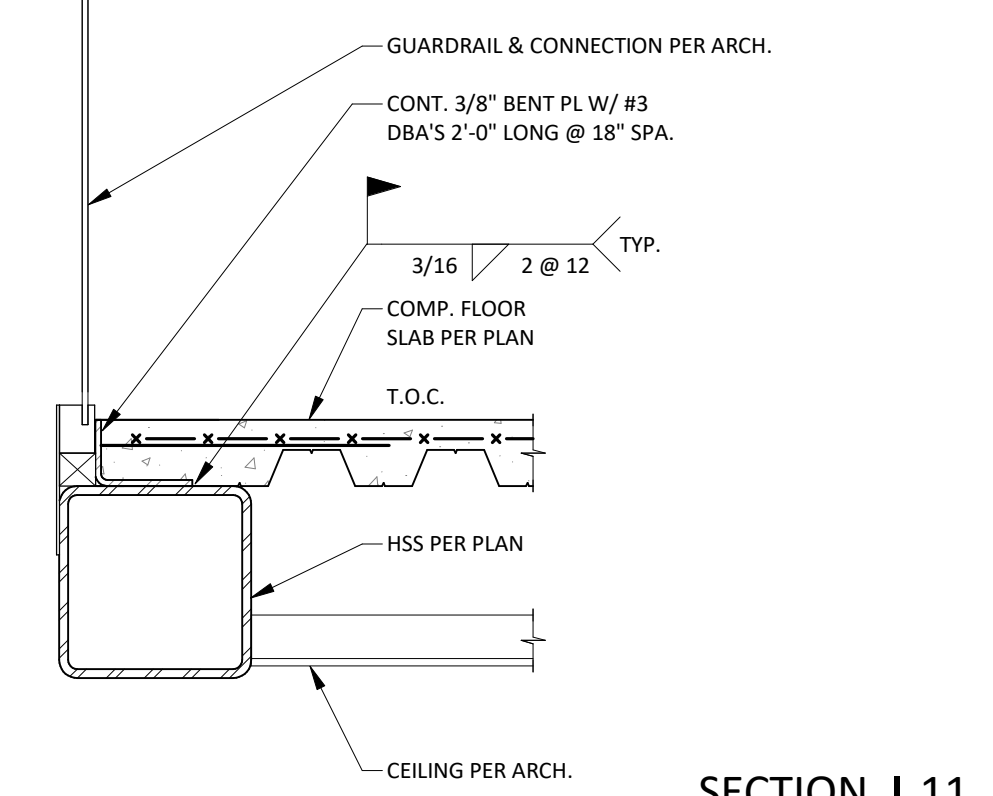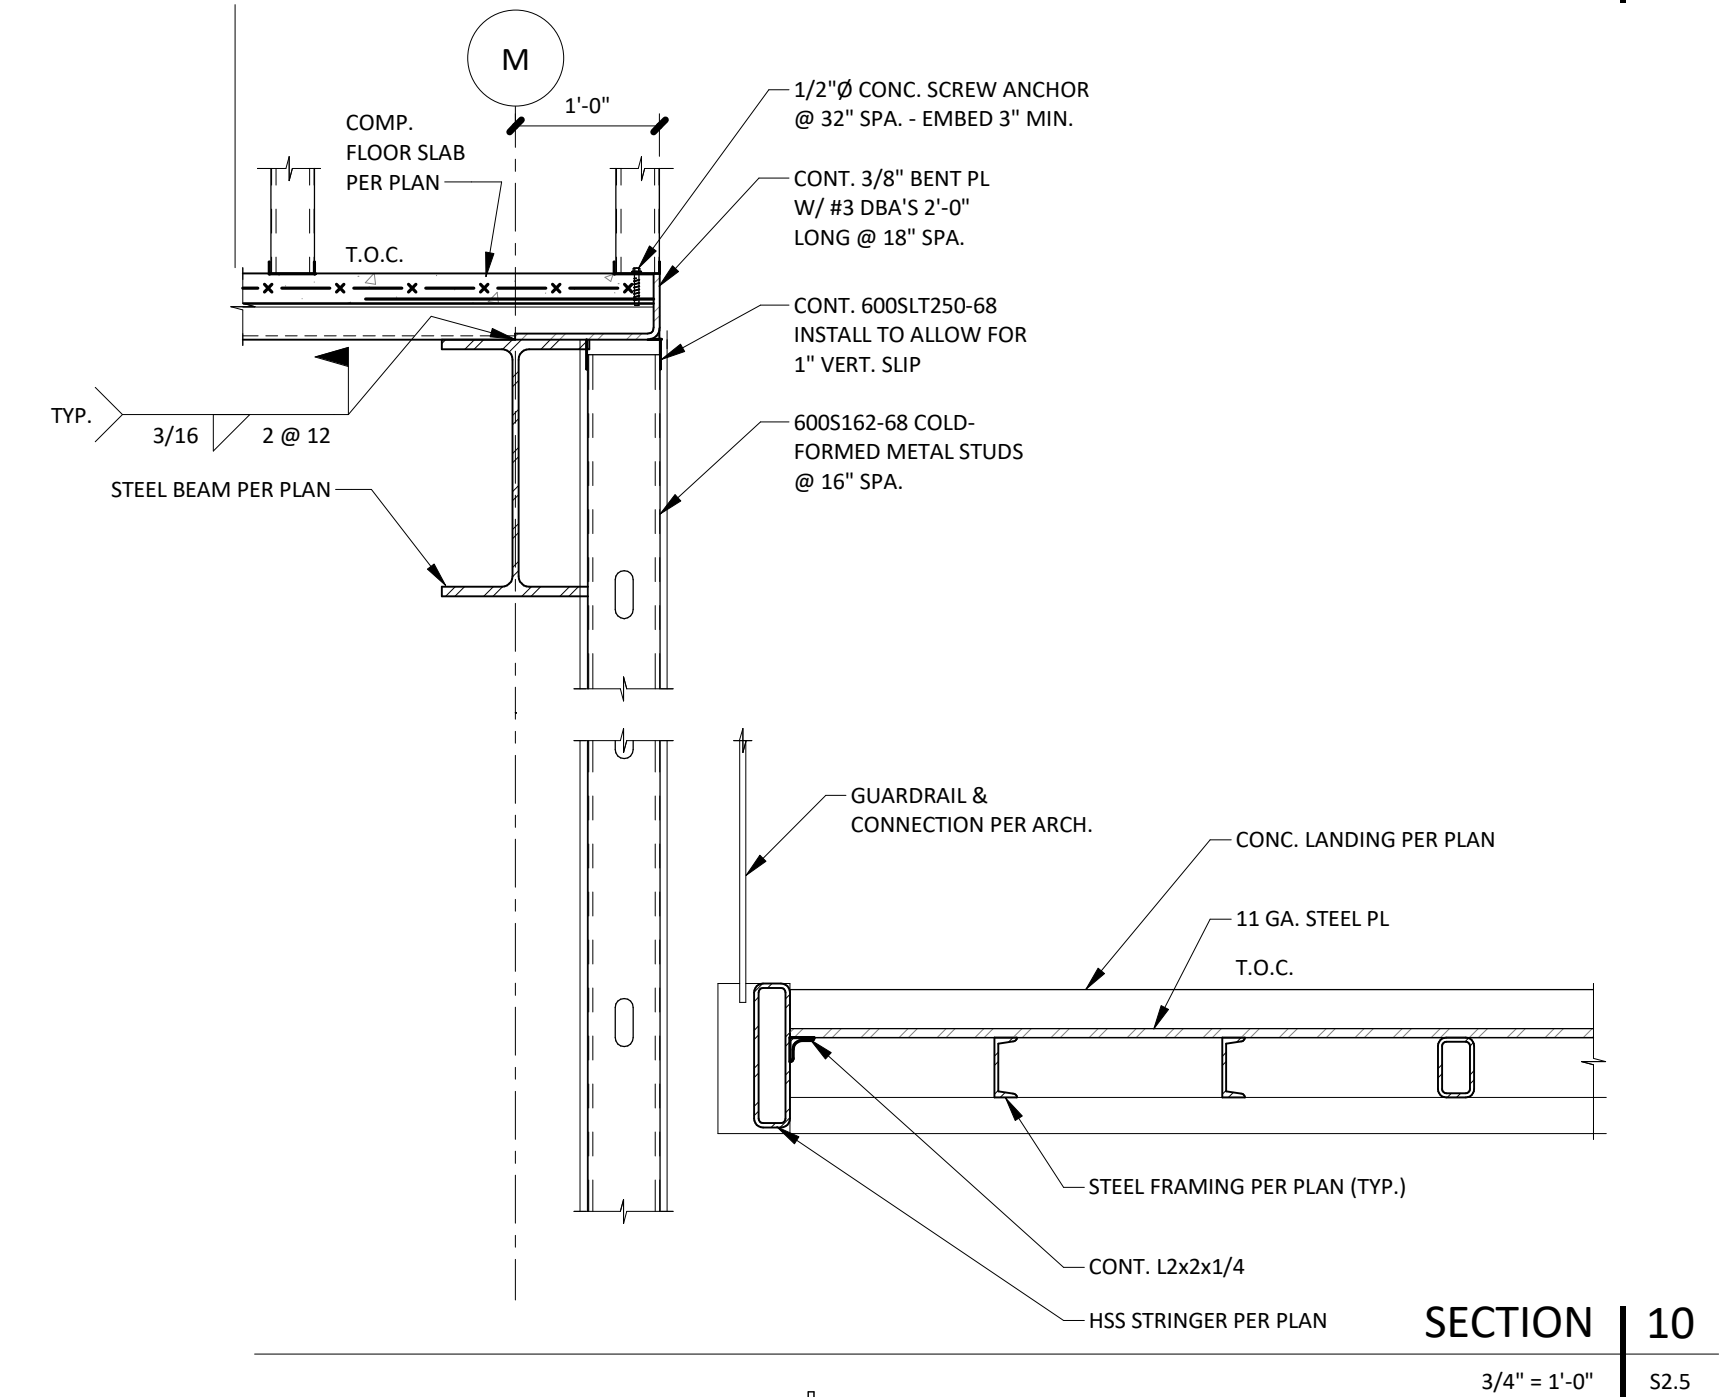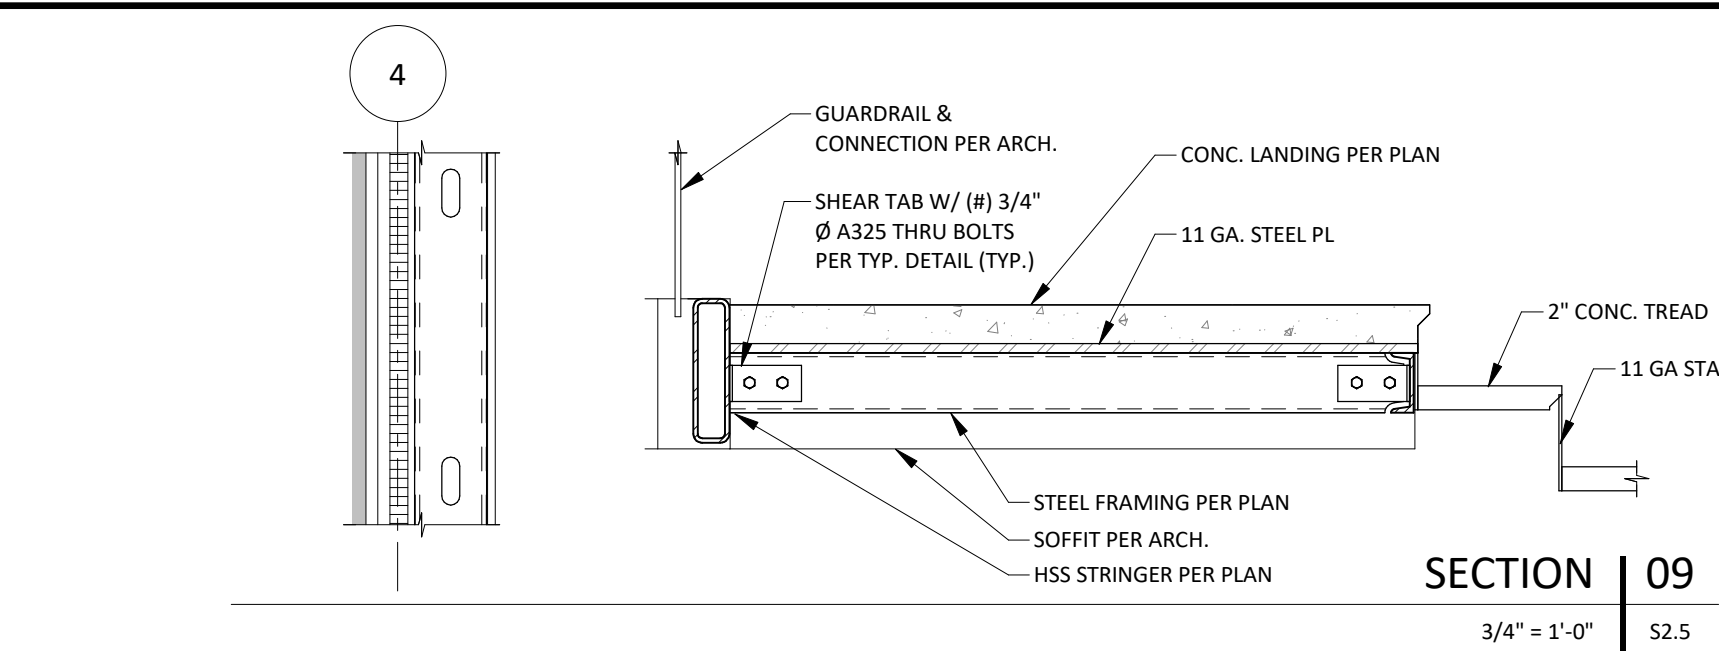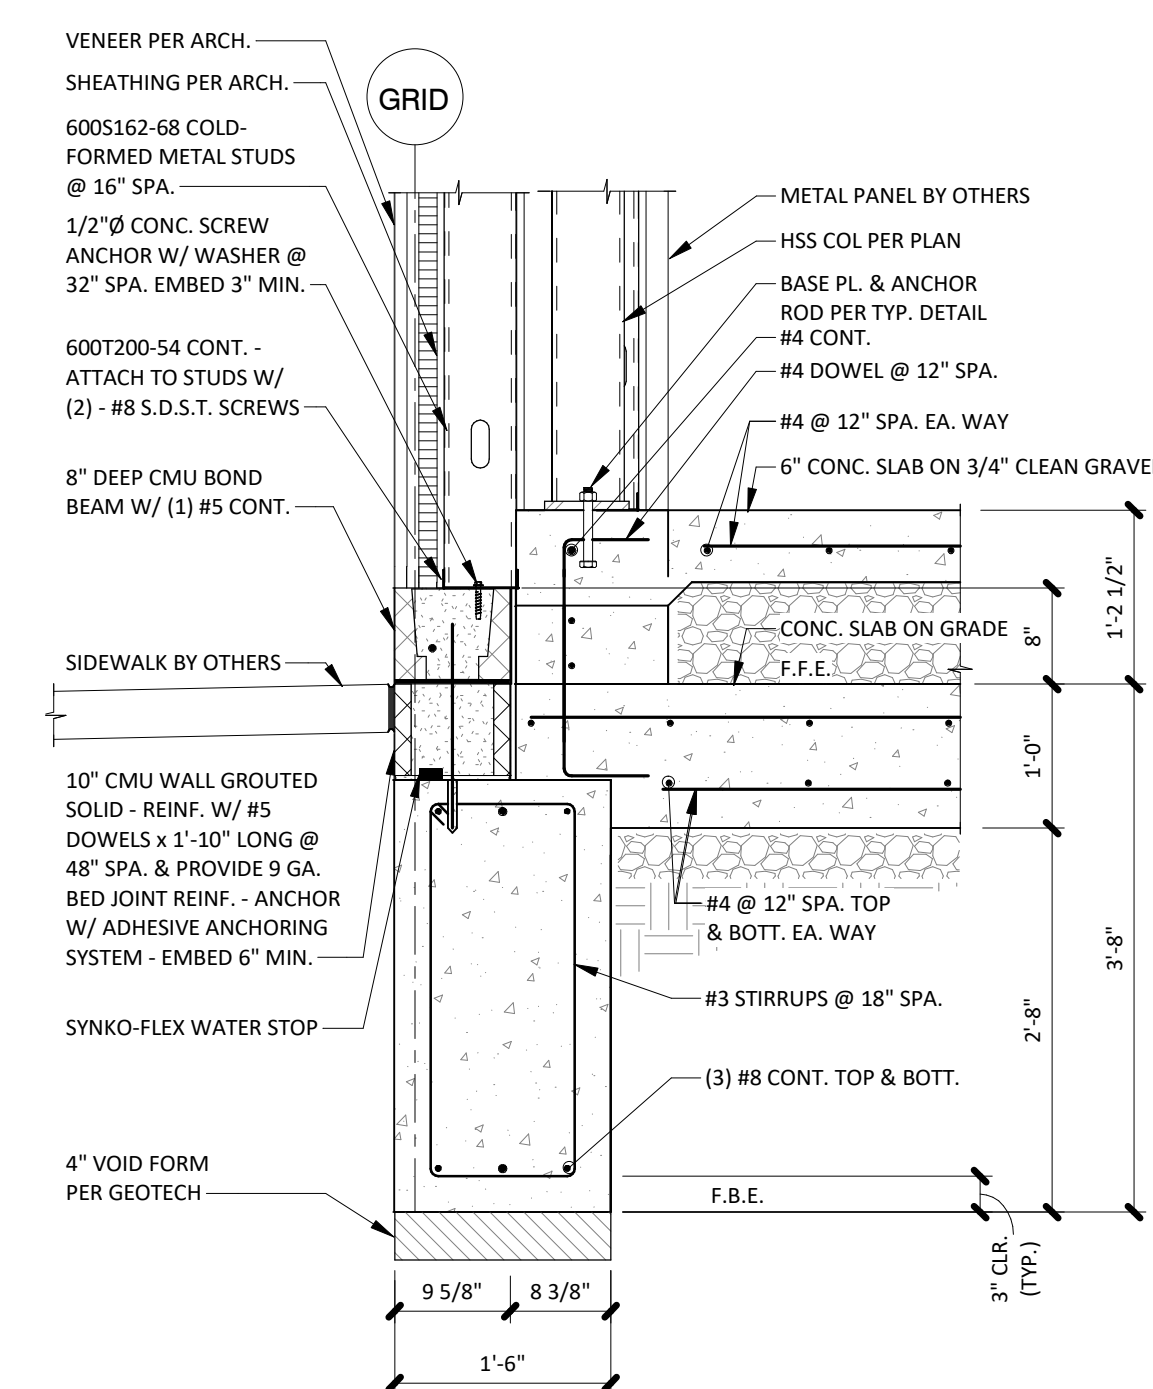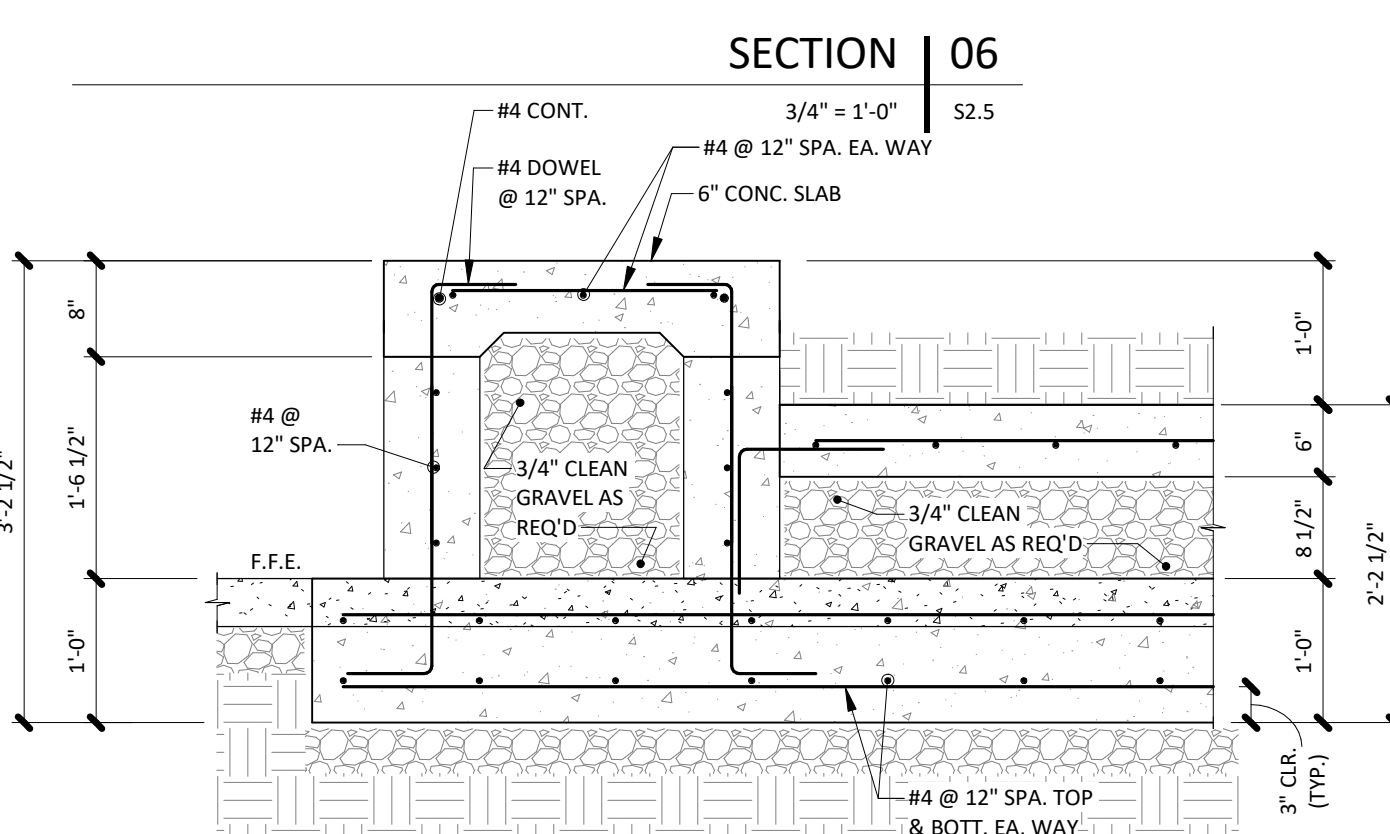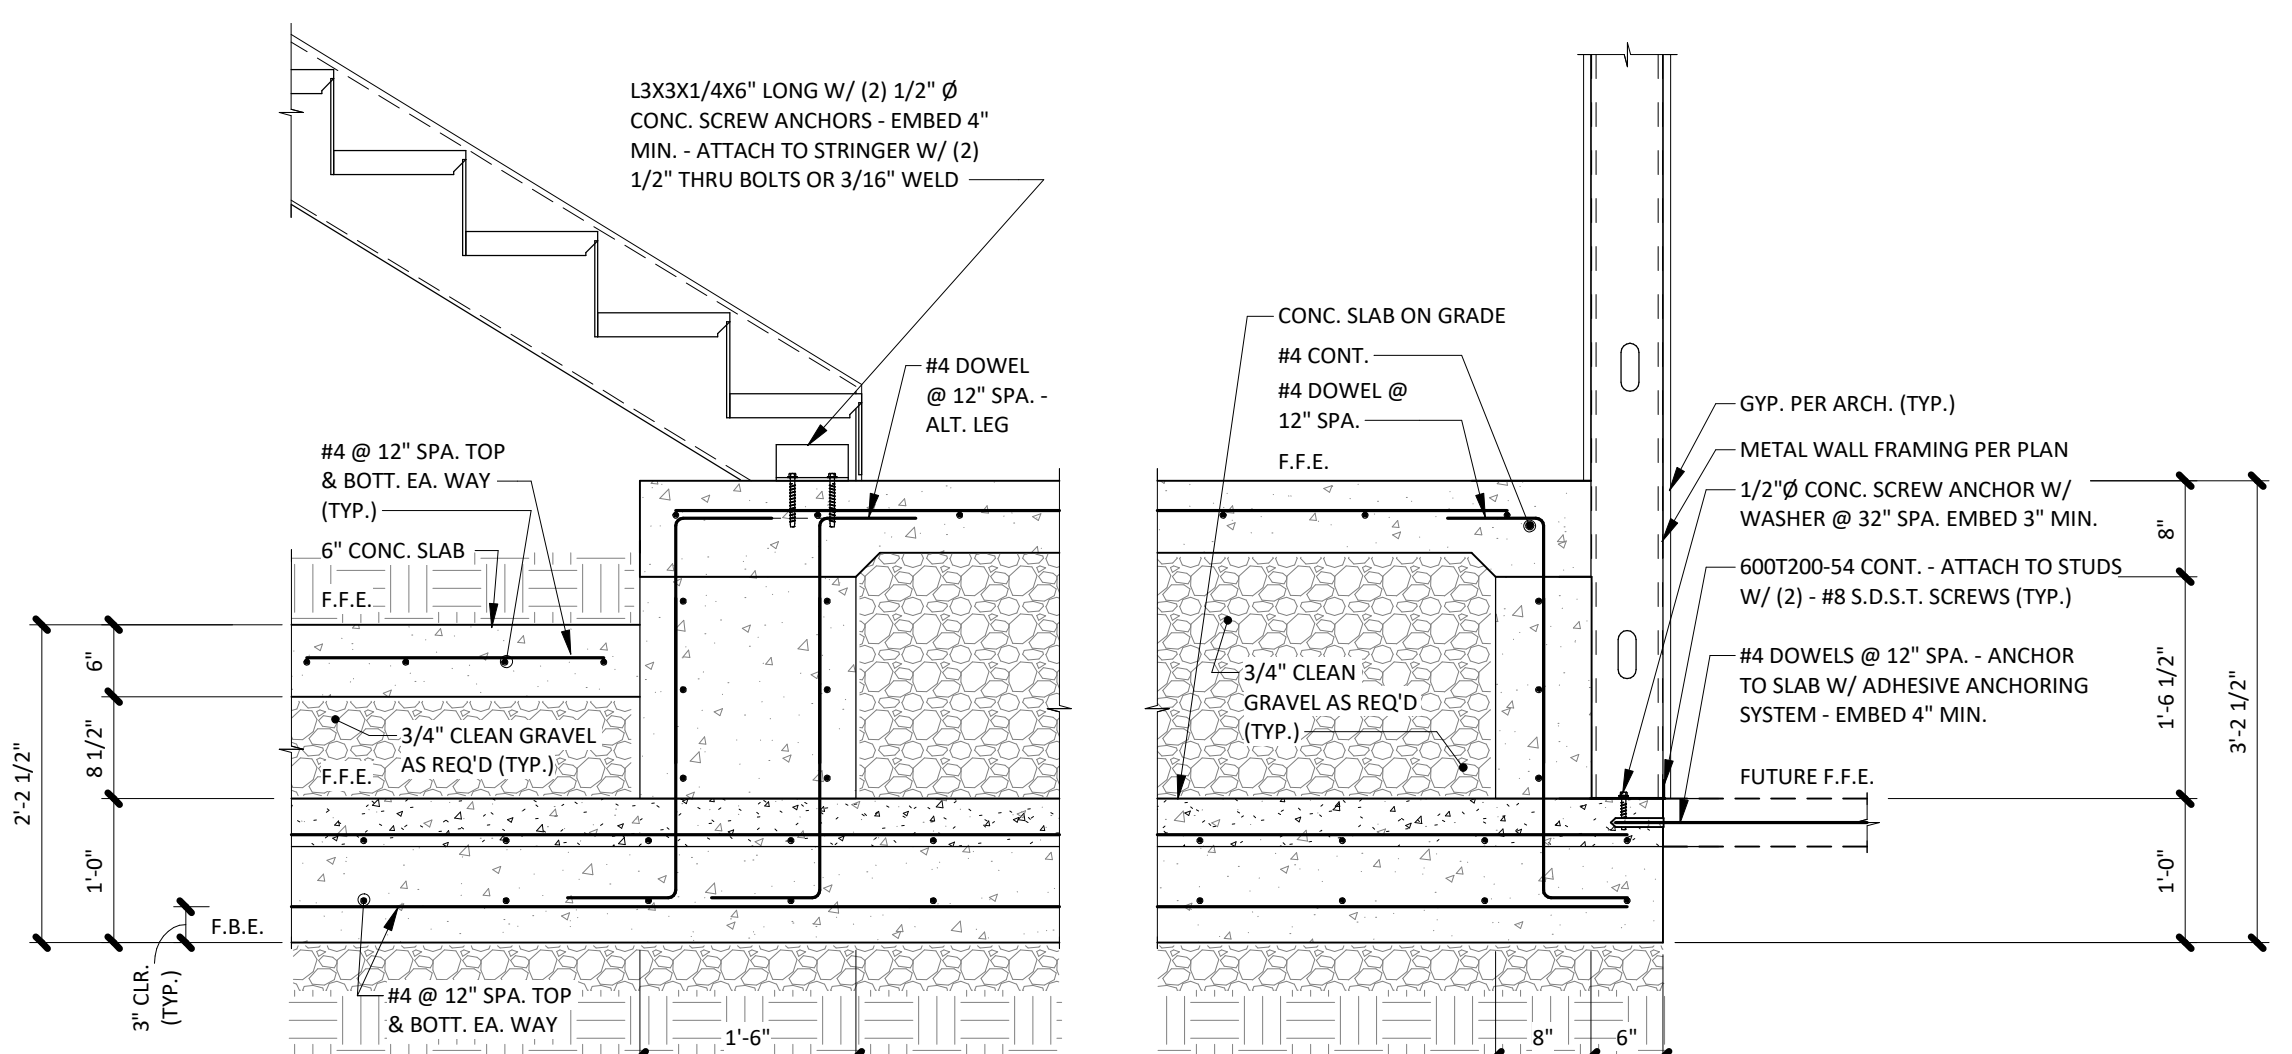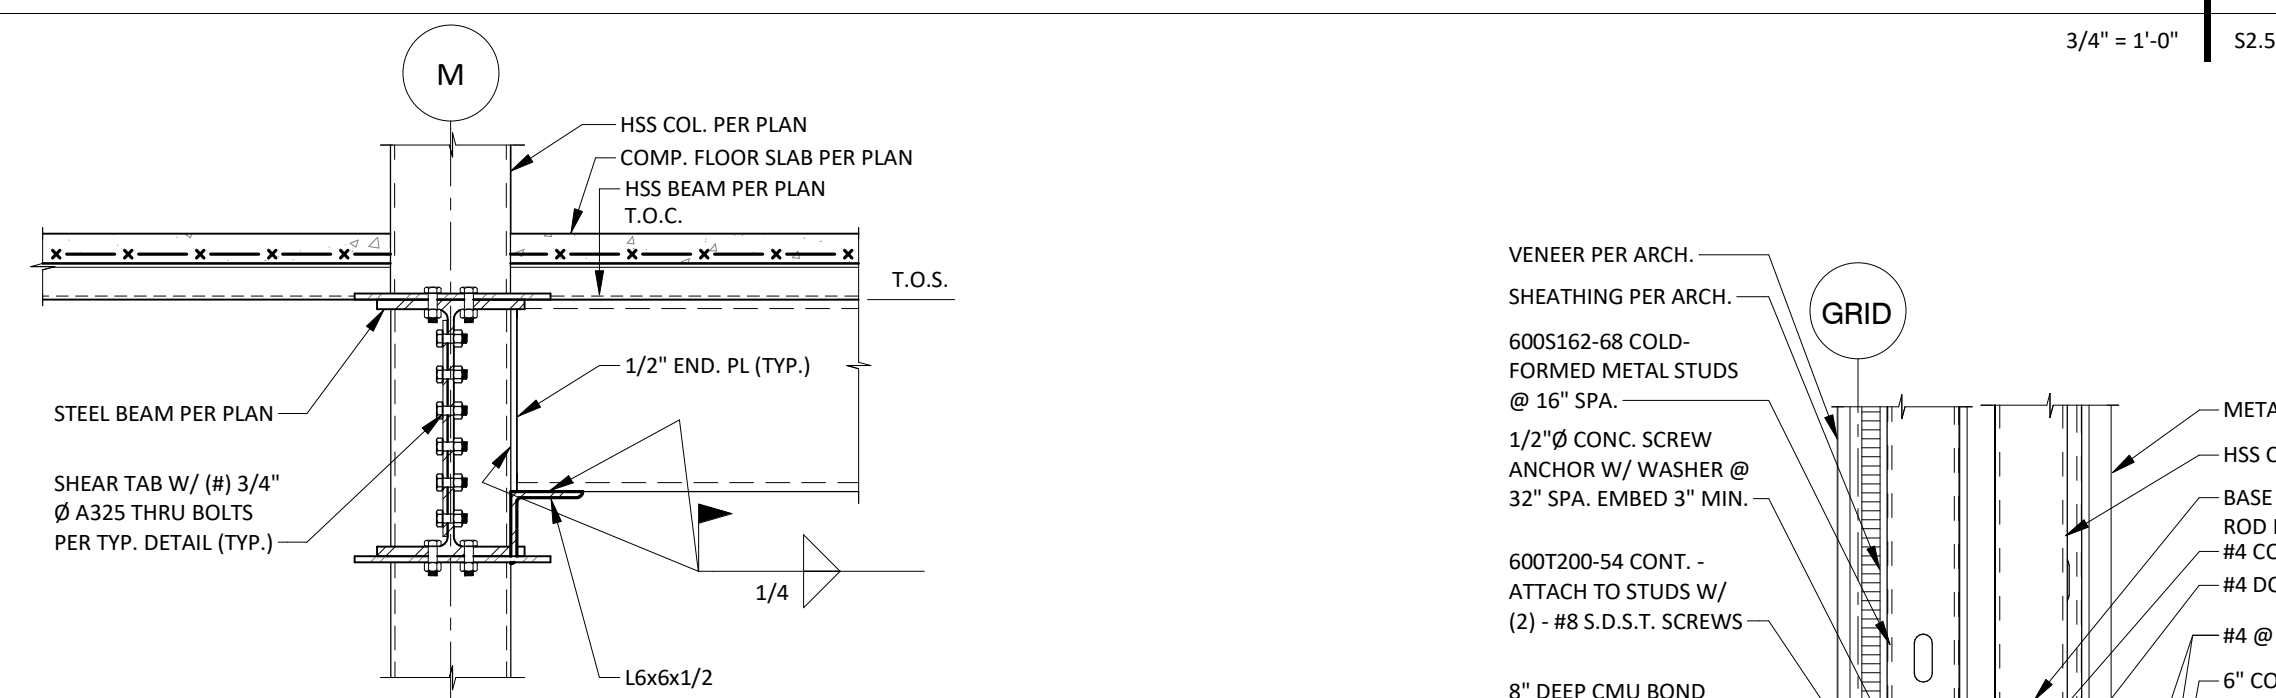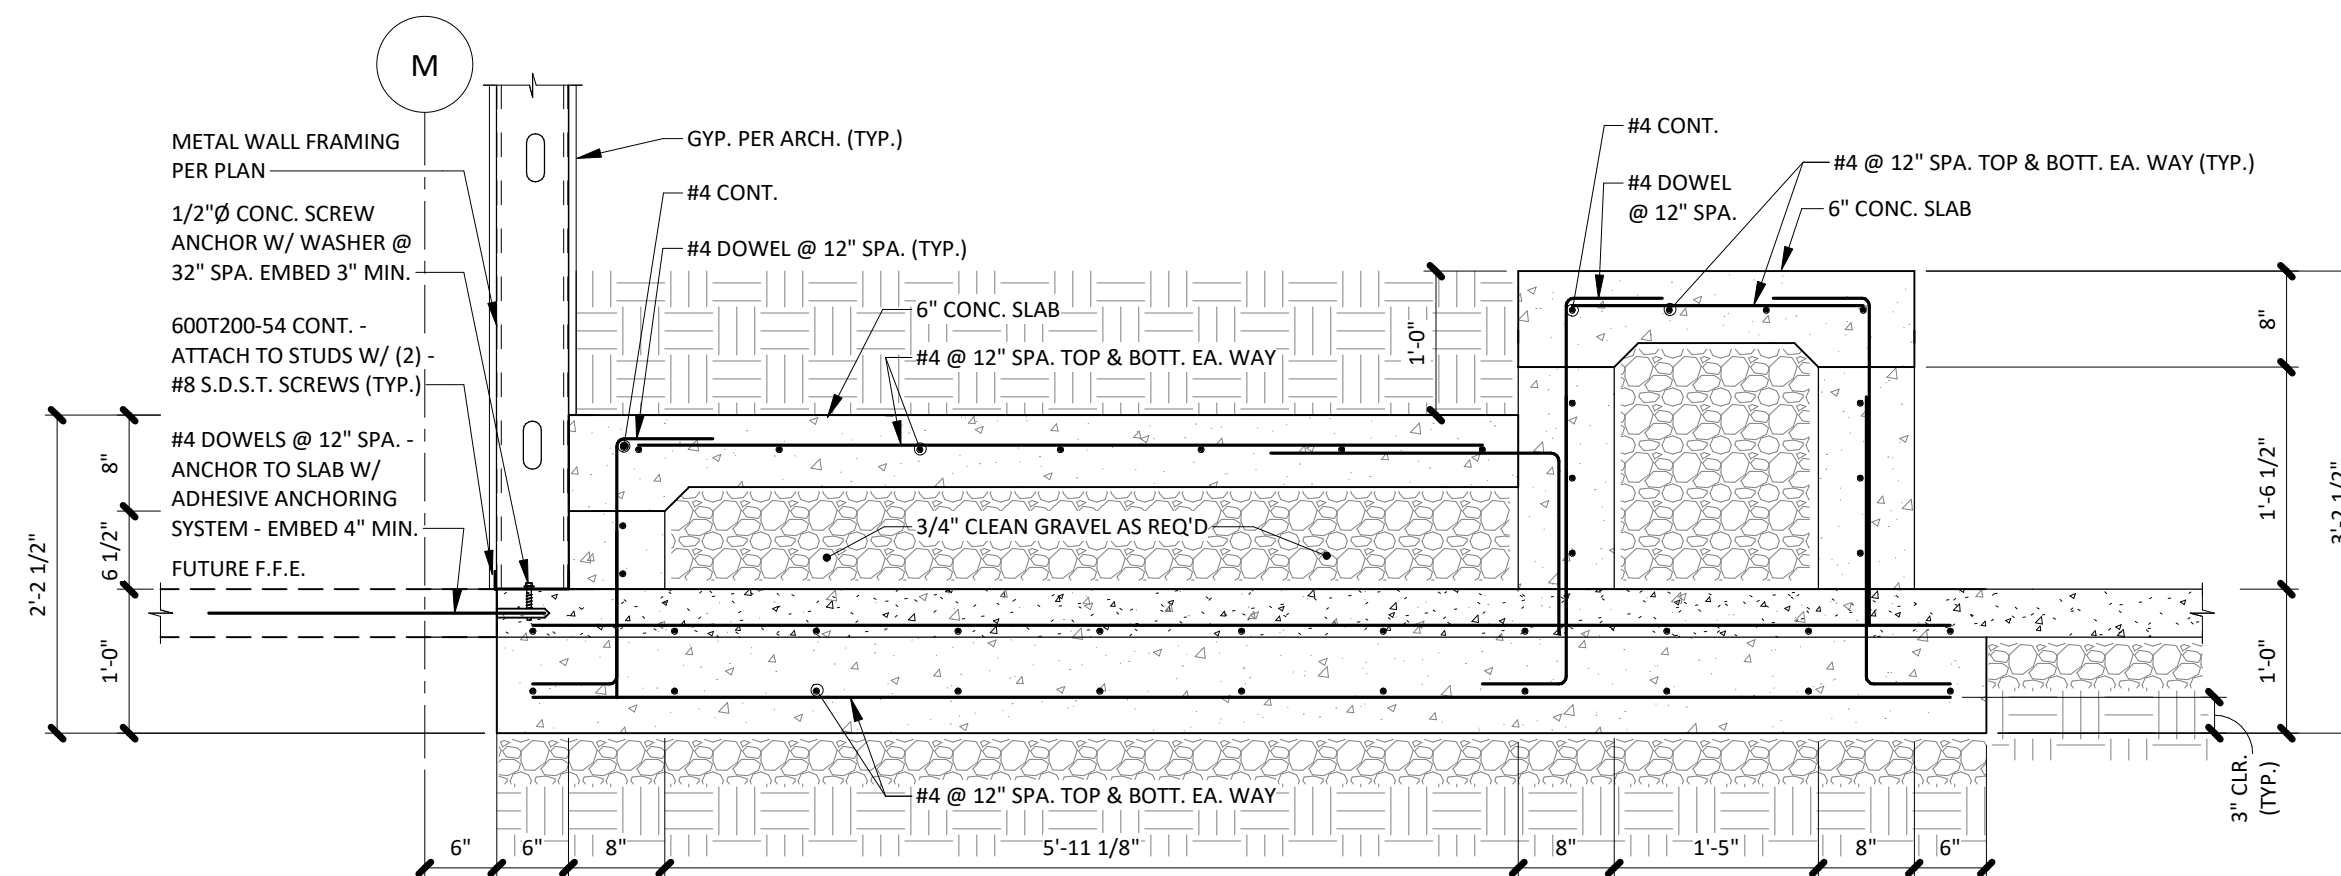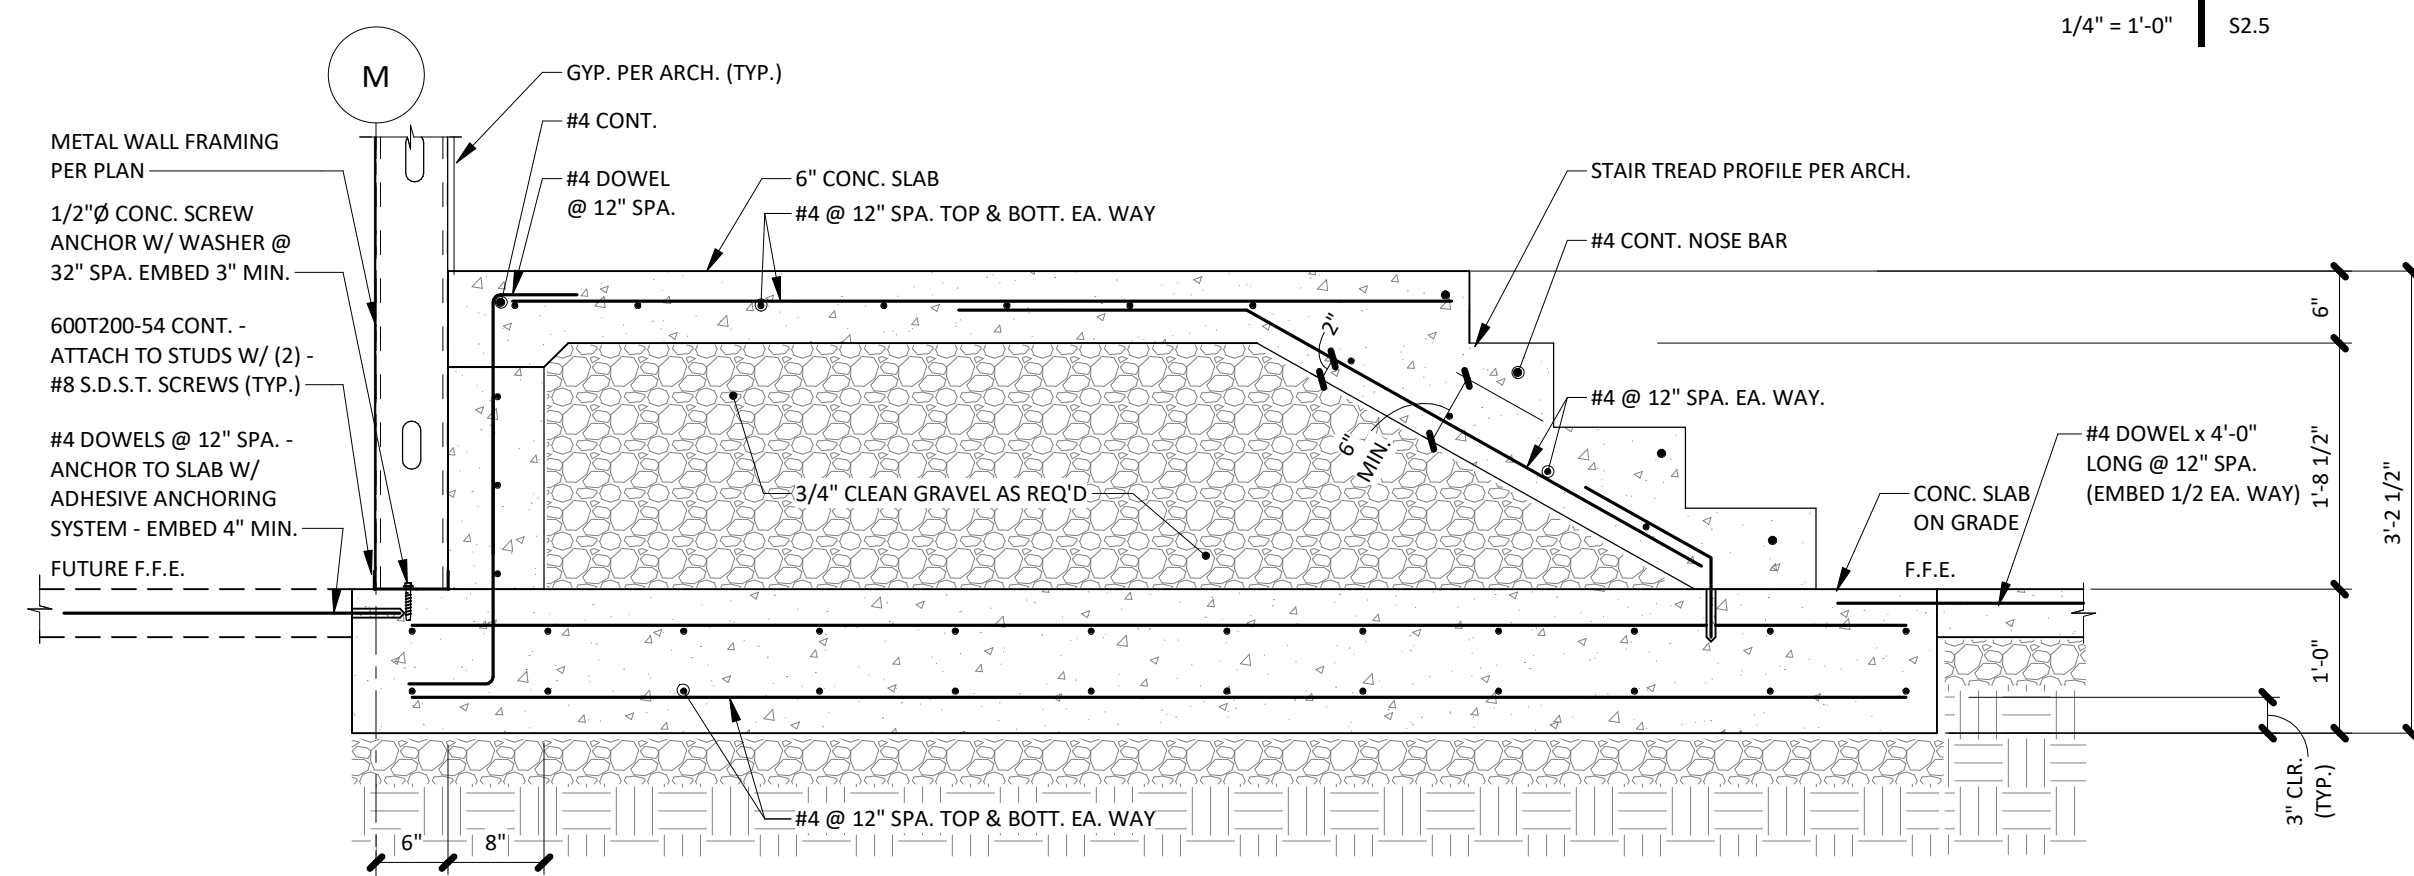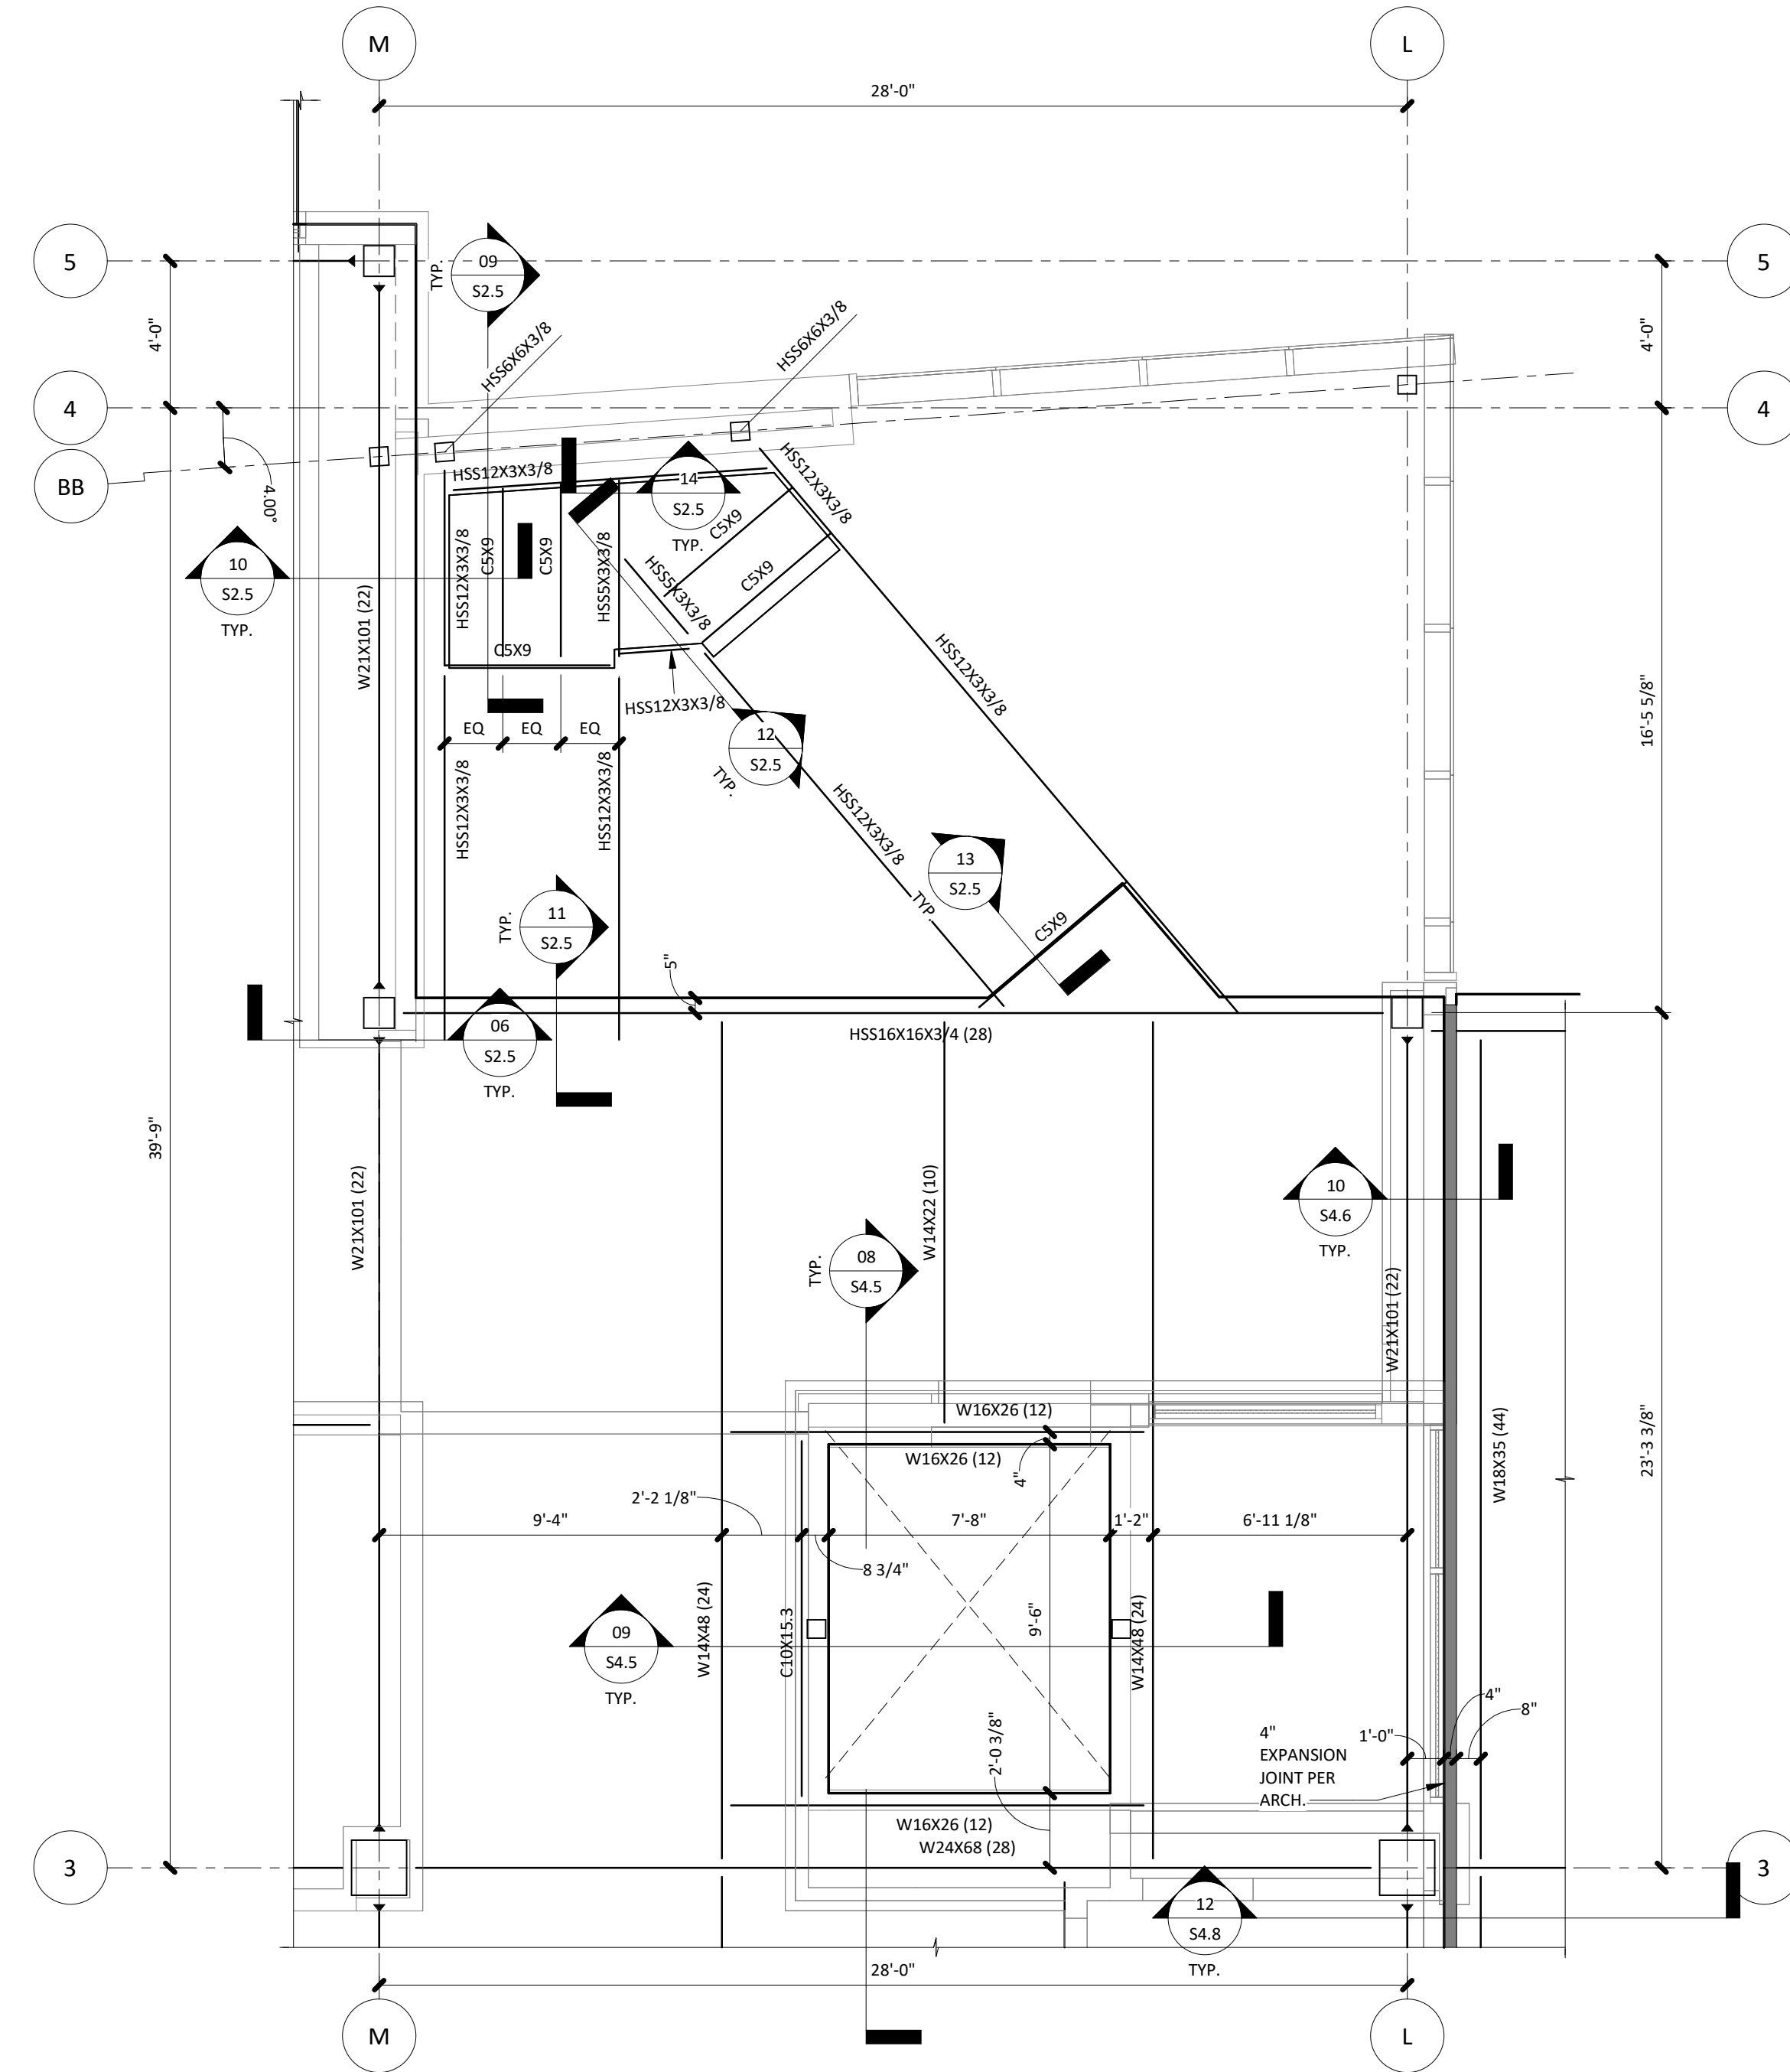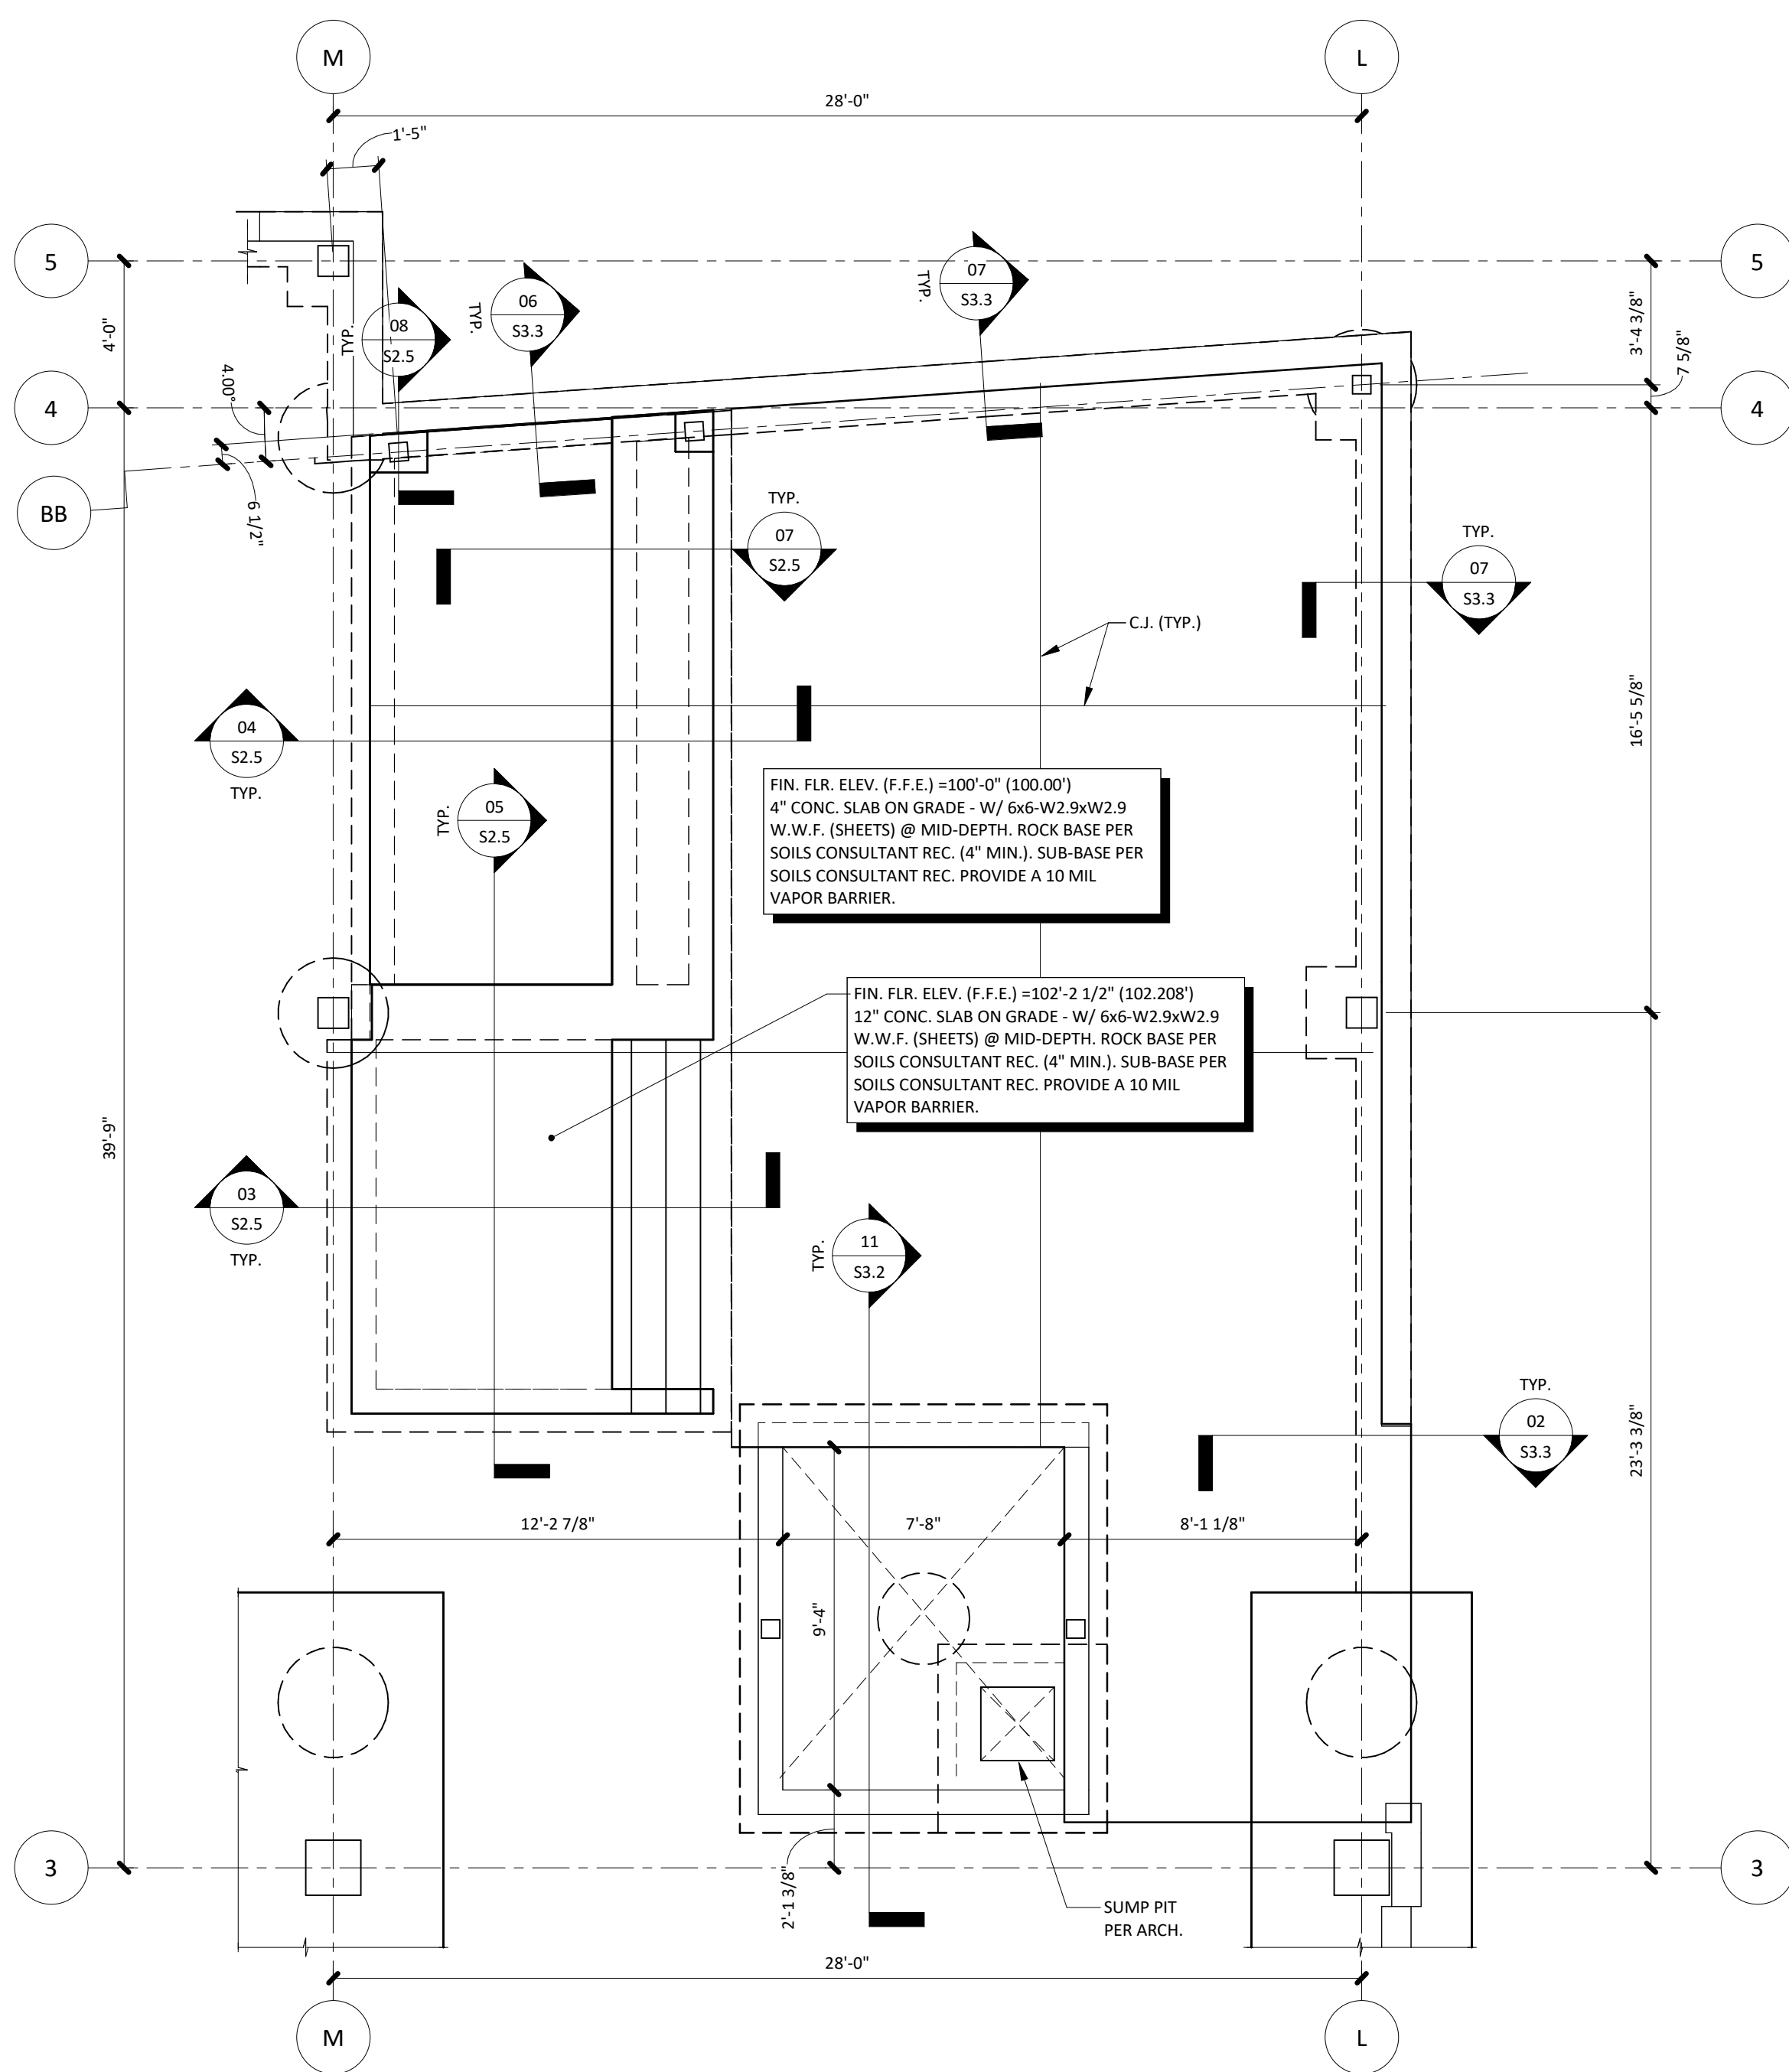

PARAGON STAR  
- LOT 9 -  
BUILDING 2  
LEE'S SUMMIT, MO

|              |                |
|--------------|----------------|
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| Date:        | 10.25.19       |
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[illegible]

| PROJECT TEAM    |                              |
|-----------------|------------------------------|
| ARCHITECT       | FRANK- WILLIAMS ARCHITECTURE |
| CIVIL           | GBA                          |
| LANDSCAPE       | HOERR SCHAUDT / LAND3        |
| FOUNDATIONS     | BSE STRUCTURAL ENGINEERS     |
| STRUCTURAL      | BSE STRUCTURAL ENGINEERS     |
| PLUMBING        | HENDERSON ENGINEERS          |
| MECHANICAL      | HENDERSON ENGINEERS          |
| ELECTRICAL      | HENDERSON ENGINEERS          |
| FIRE PROTECTION | FIRE PROTECTION              |
| CONTRACTOR      | FOGEL ANDERSON               |



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SHEET TITLE

## MAIN STAIR FRAMING

SHEET NUMBER

## S2.5

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|                                  |      |
|----------------------------------|------|
| $1\ 1/2^{\circ} = 1^{\circ}-0''$ | S3.1 |
|----------------------------------|------|

|                  |      |
|------------------|------|
| $1/2'' = 1'-0''$ | S3.1 |
|------------------|------|

|                |      |
|----------------|------|
| $3/4" = 1'-0"$ | S3.1 |
|----------------|------|

|                  |      |
|------------------|------|
| $3/4'' = 1'-0''$ | S3.1 |
|------------------|------|

$$3/4'' = 1'-0'' \quad S3.1$$

| BAR SIZE | HOOK   |
|----------|--------|
| #4       | 8 in.  |
| #5       | 10 in. |
| #6       | 12 in. |
| #7       | 14 in. |
| #8       | 16 in. |

|                                |      |
|--------------------------------|------|
| $12^{\circ} = 1^{\circ} - 0''$ | S3.1 |
|--------------------------------|------|



PARAGON STAR  
- LOT 9 -  
BUILDING 2  
LEE'S SUMMIT, MO

|              |                |
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## PROJECT TEAM

|                 |                                 |
|-----------------|---------------------------------|
| ARCHITECT       | FINKLE+WILLIAMS<br>ARCHITECTURE |
| CIVIL           | GBA                             |
| LANDSCAPE       | HOERR SCHAUDT /<br>LAND3        |
| FOUNDATIONS     | BSE STRUCTURAL<br>ENGINEERS     |
| STRUCTURAL      | BSE STRUCTURAL<br>ENGINEERS     |
| PLUMBING        | HENDERSON<br>ENGINEERS          |
| MECHANICAL      | HENDERSON<br>ENGINEERS          |
| ELECTRICAL      | HENDERSON<br>ENGINEERS          |
| FIRE PROTECTION | FIRE PROTECTION                 |
| CONTRACTOR      | FOGEL ANDERSON                  |



**RBE** STRUCTURAL  
ENGINEERS

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SHEET TITLE

## TYPICAL FOUNDATION DETAILS

SHEET NUMBER

## S3.1

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[illegible]ARCHITECT FINKLE+WILLIAMS  
ARCHITECTURE

CIVIL GBA

LANDSCAPE HOERR SCHAUDT /

FOUNDATIONS      BSE STRUCTURAL

STRUCTURAL BSE STRUCTURAL  
ENGINEERS

PLUMBING      HENDERSON  
ENGINEERS

MECHANICAL HENDERSON  
ENGINEERSELECTRICAL HENDERSON  
ENGINEERS

FIRE PROTECTION FIRE PROTECTION

CONTRACTOR      FOGEL ANDERSON








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SHEET TITLE

## FOUNDATION DETAILS

SHEET NUMBER

## S3.2

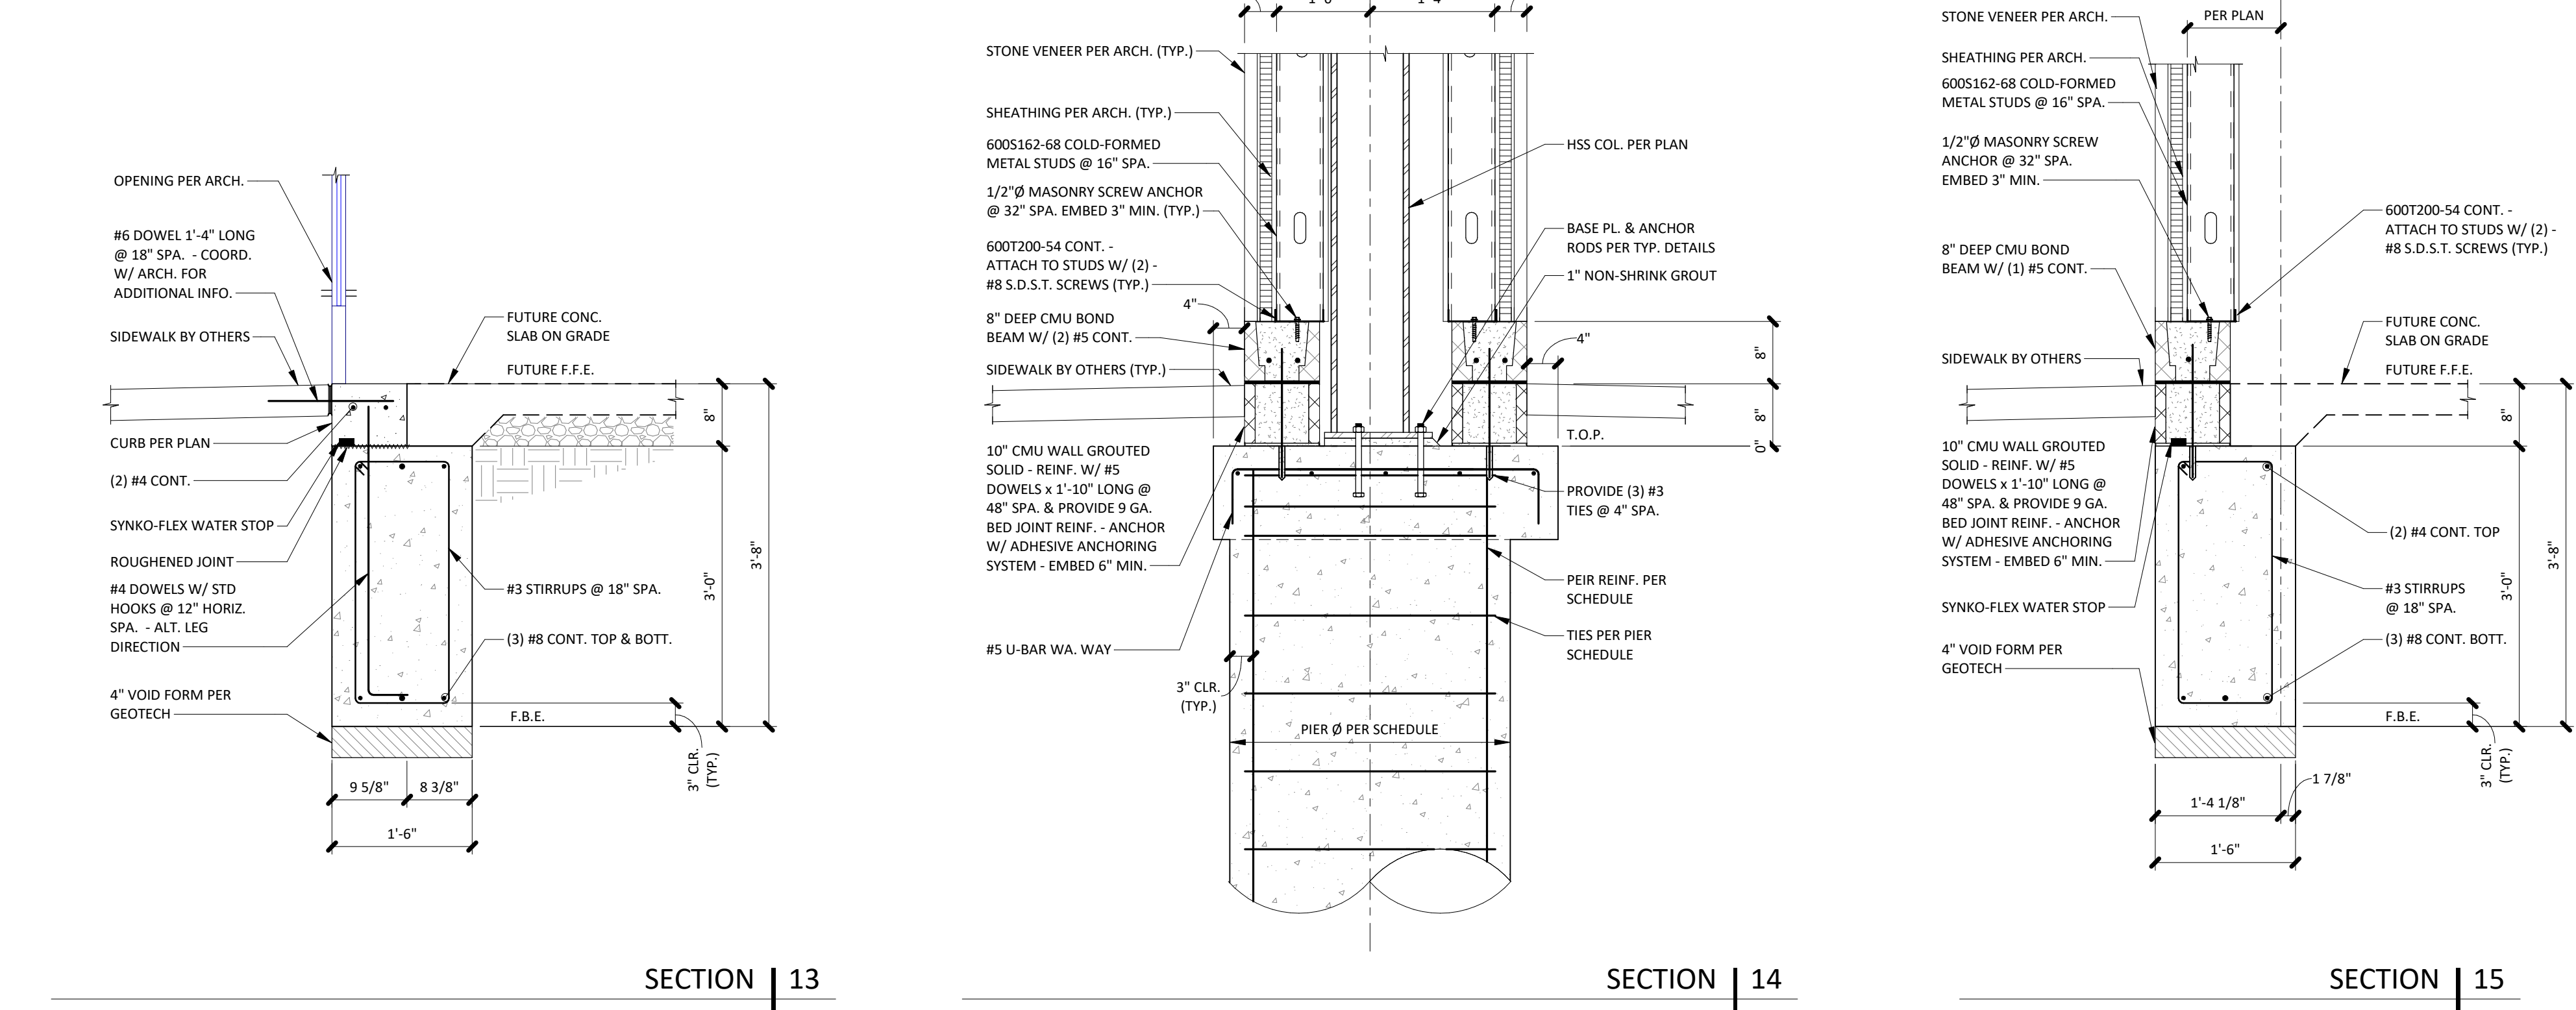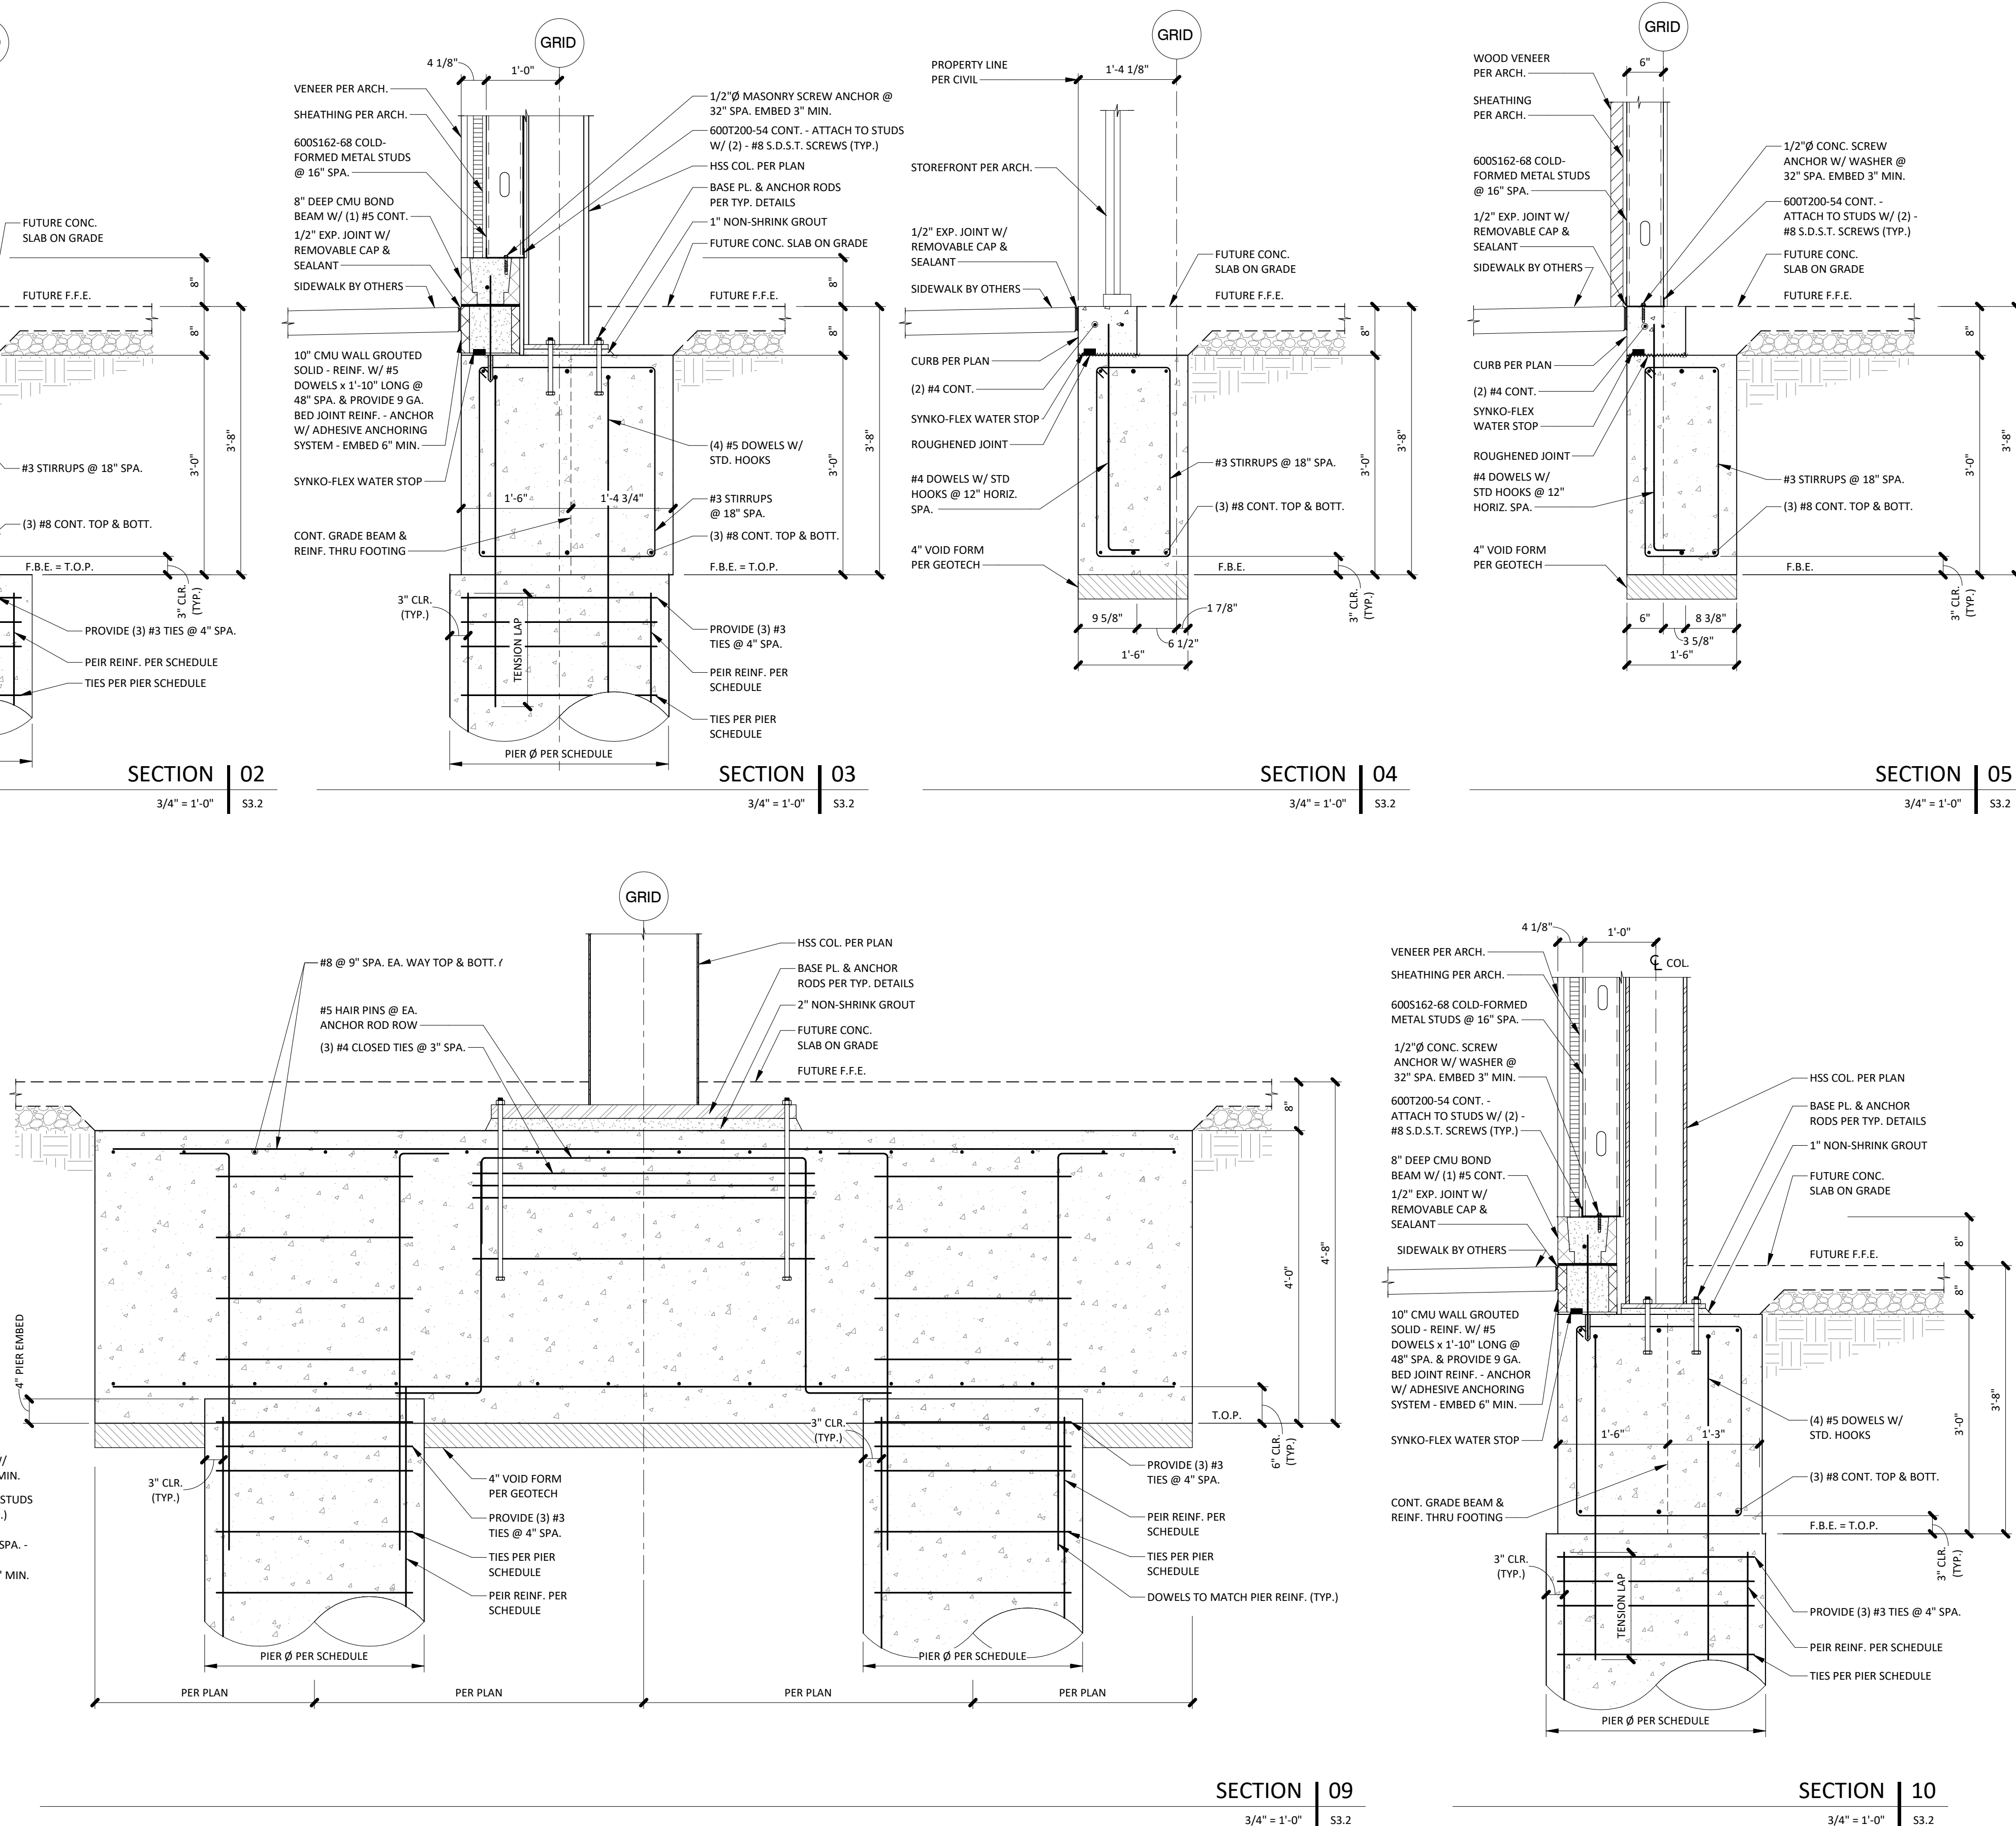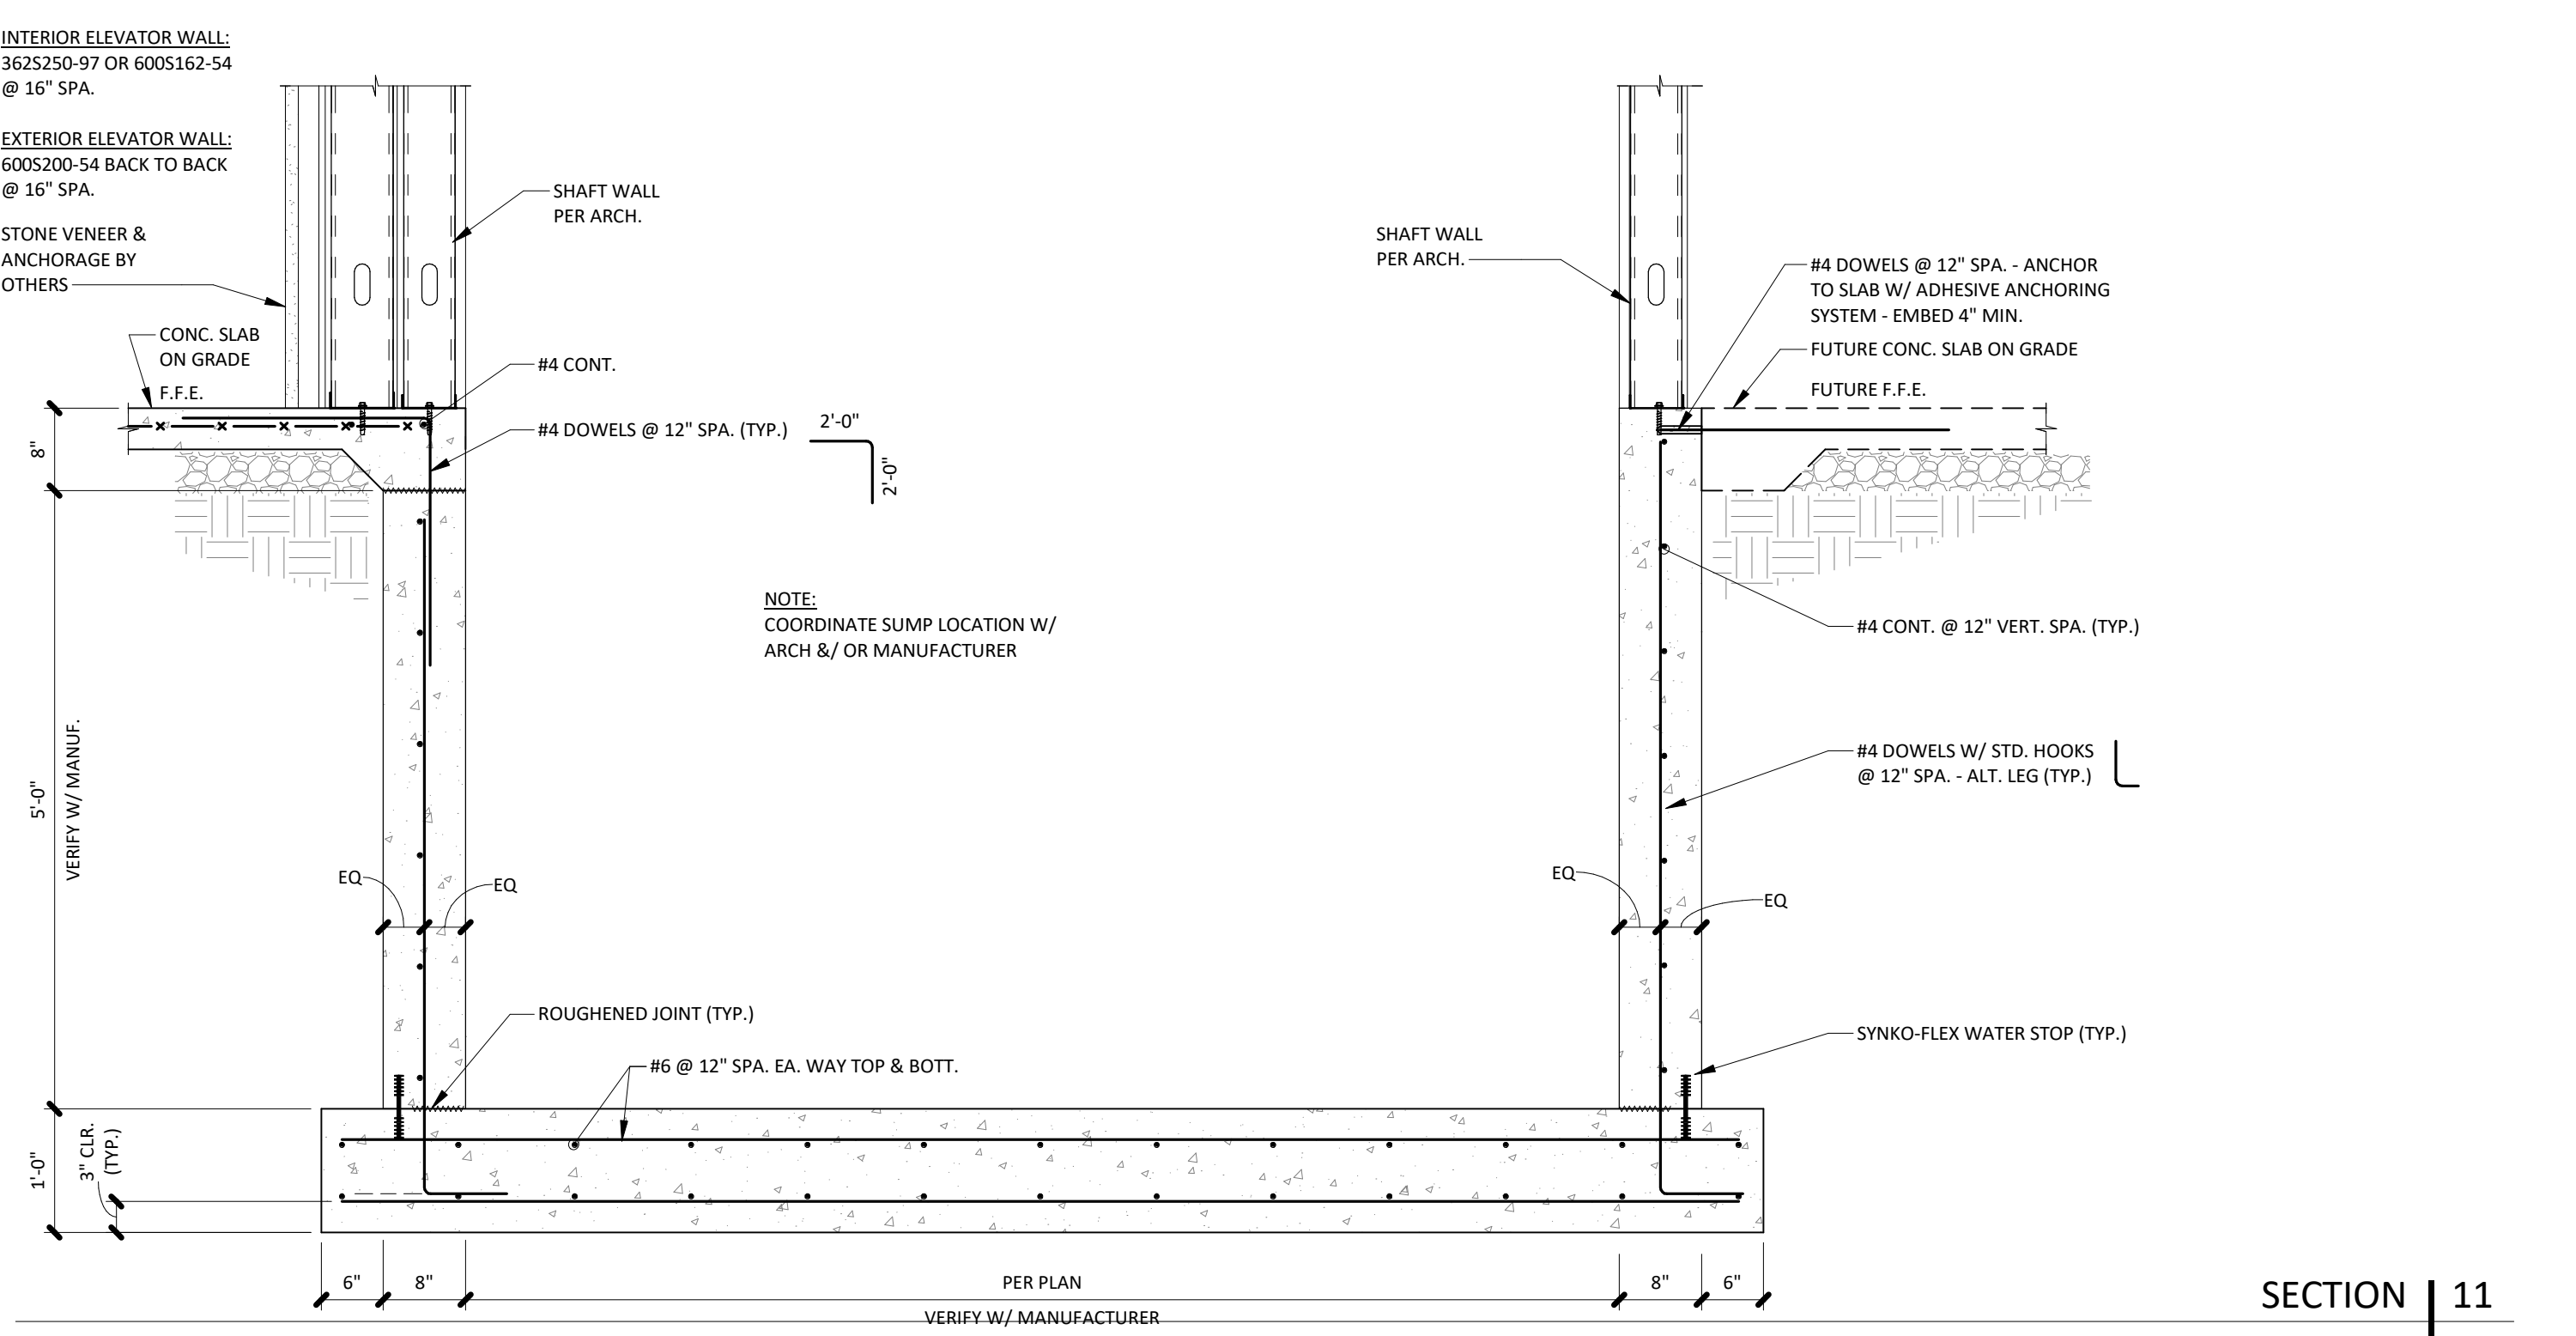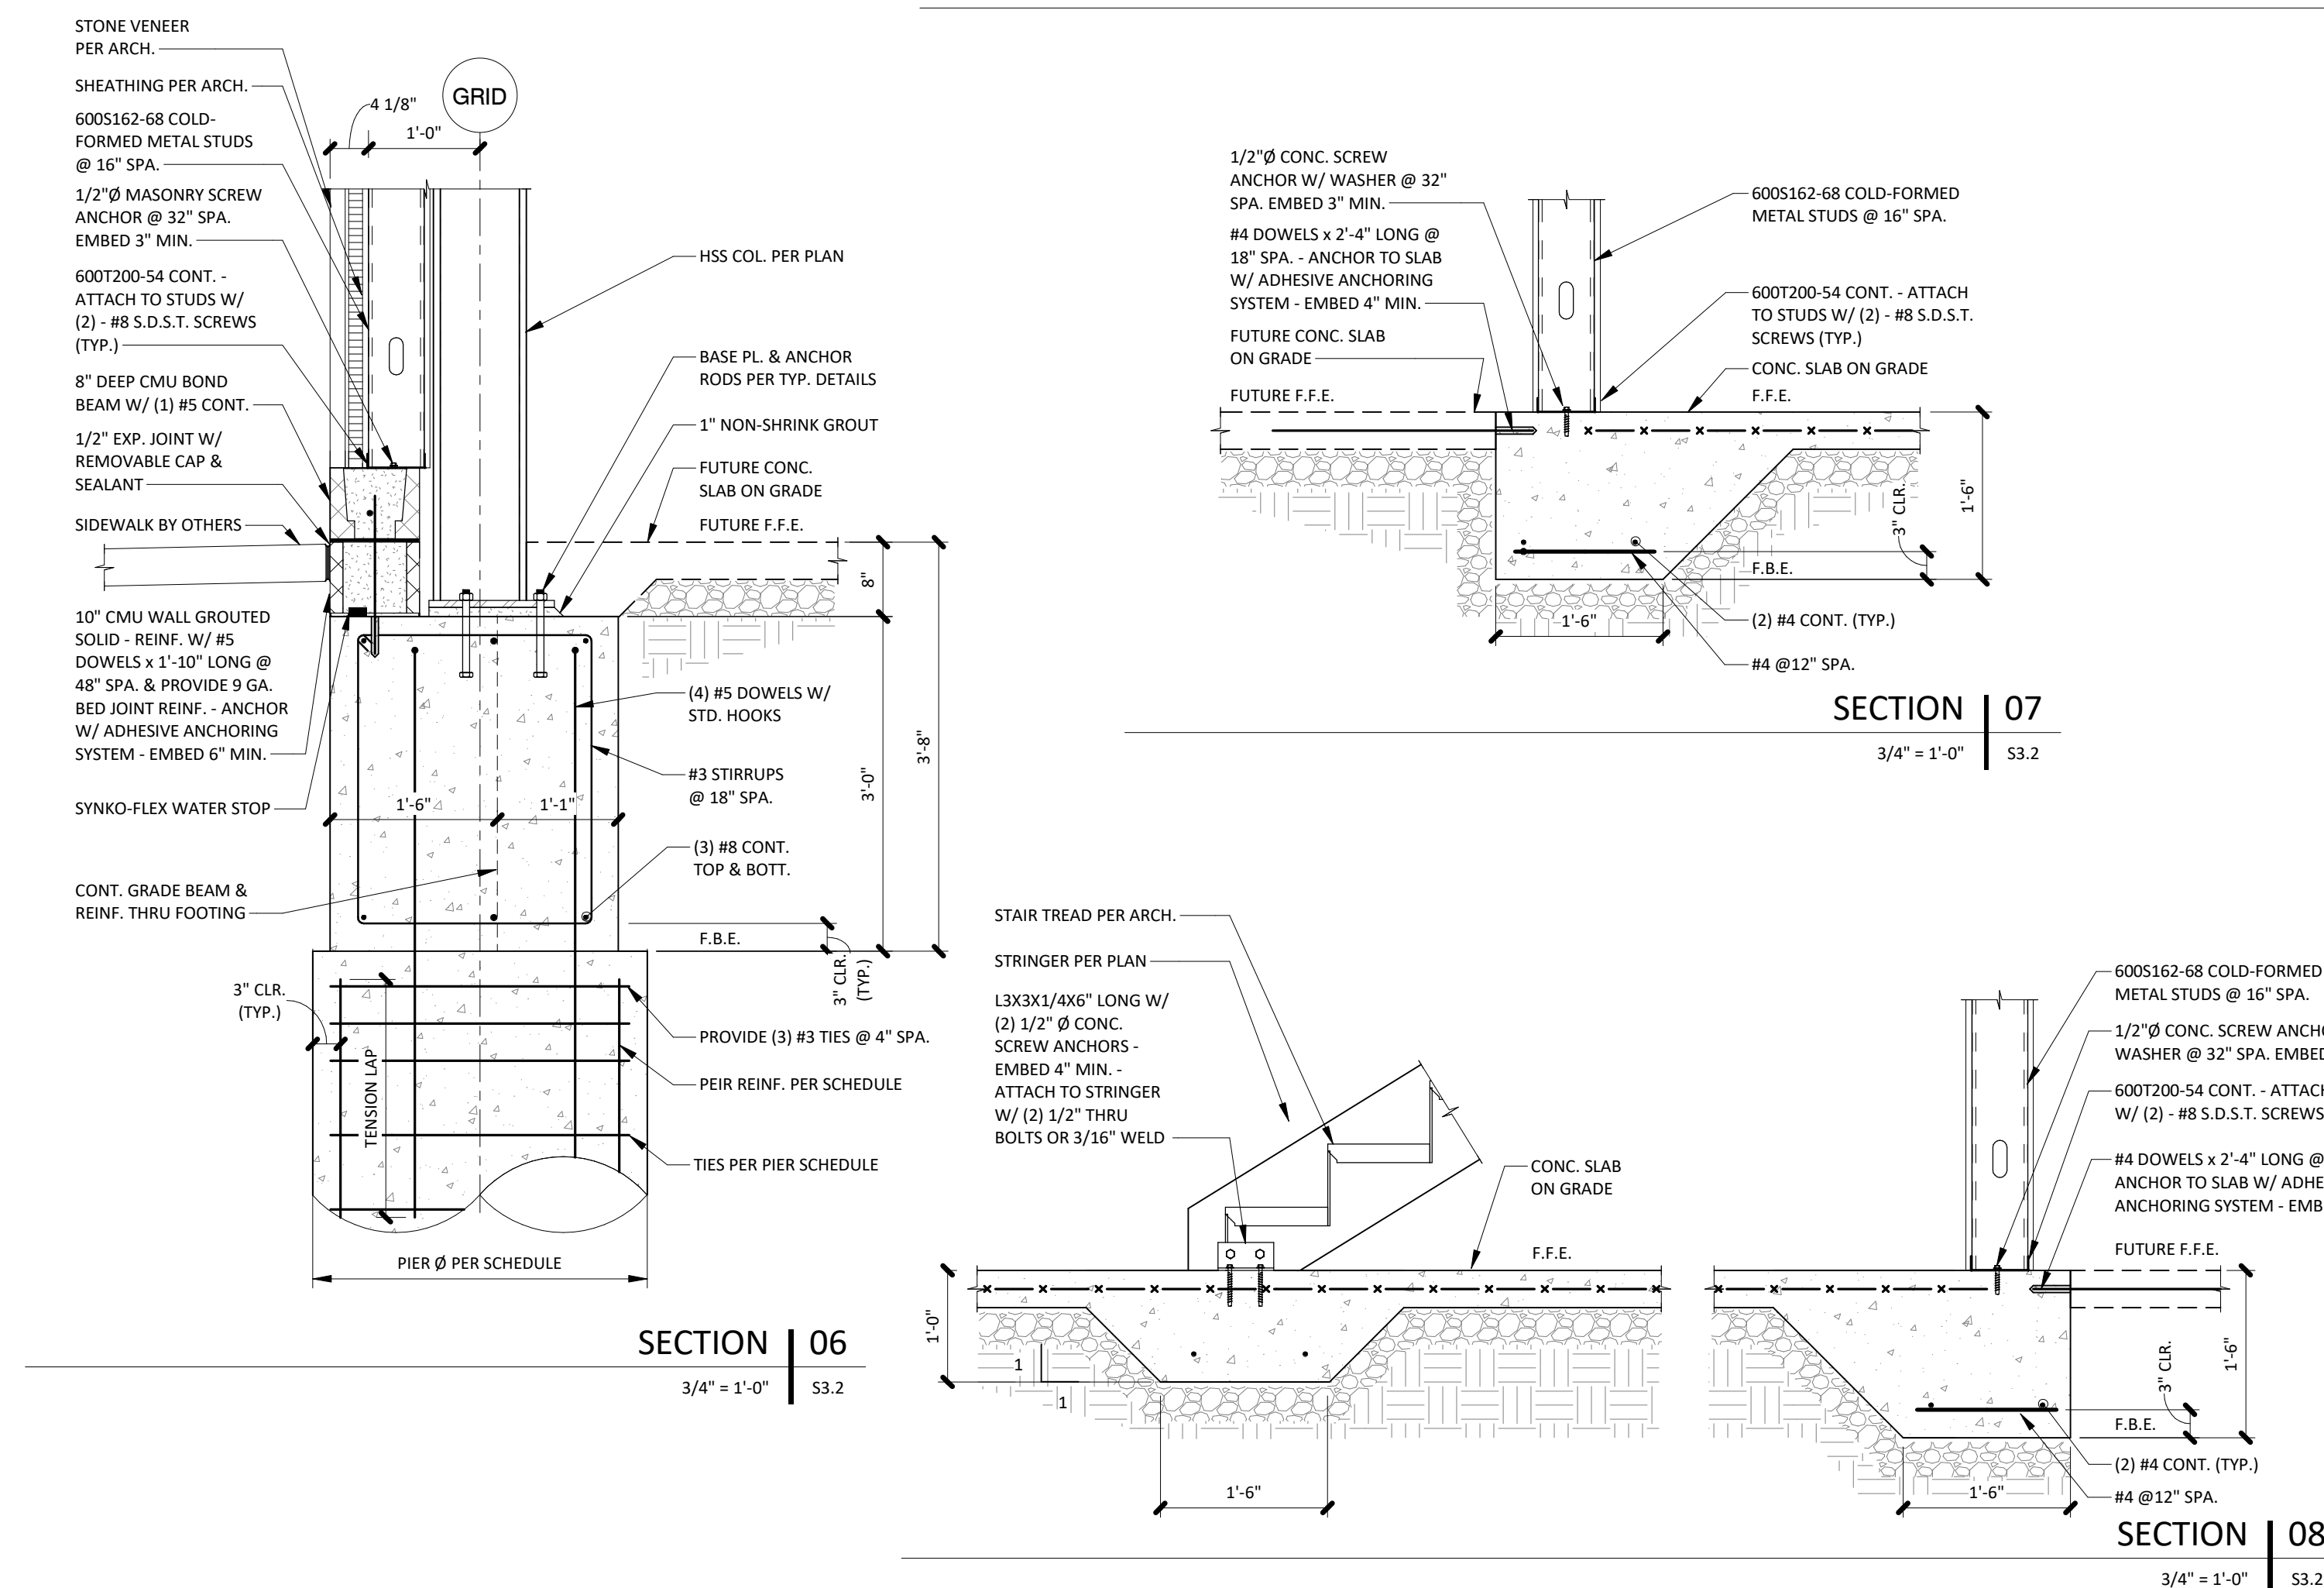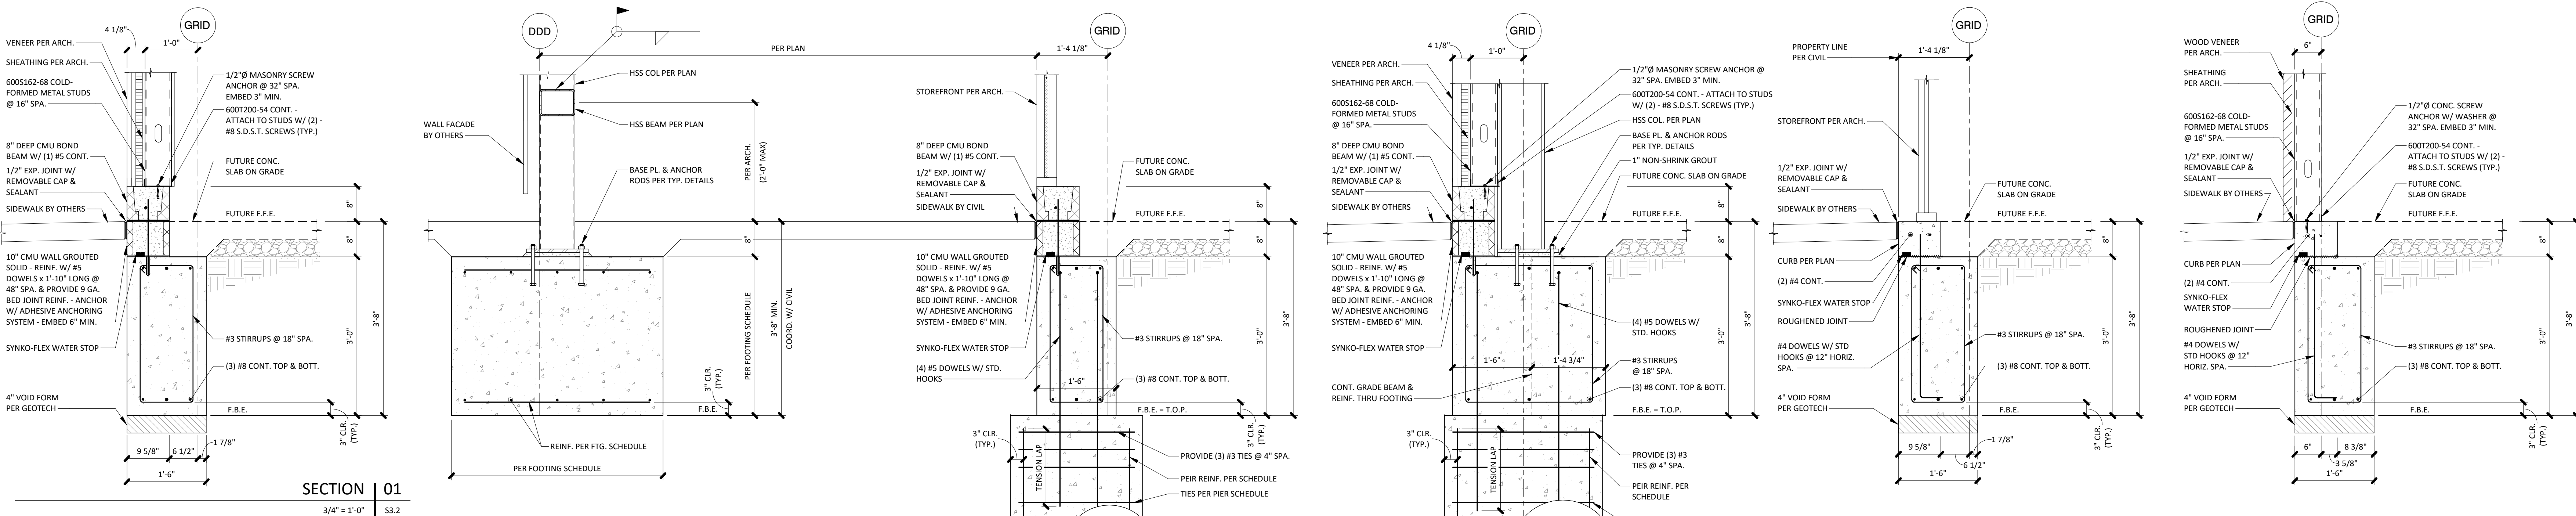

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|              |                |
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## PROJECT TEAM

|                 |                                 |
|-----------------|---------------------------------|
| ARCHITECT       | FINKLE+WILLIAMS<br>ARCHITECTURE |
| CIVIL           | GBA                             |
| LANDSCAPE       | HOERR SCHAUDT /<br>LAND3        |
| FOUNDATIONS     | BSE STRUCTURAL<br>ENGINEERS     |
| STRUCTURAL      | BSE STRUCTURAL<br>ENGINEERS     |
| PLUMBING        | HENDERSON<br>ENGINEERS          |
| MECHANICAL      | HENDERSON<br>ENGINEERS          |
| ELECTRICAL      | HENDERSON<br>ENGINEERS          |
| FIRE PROTECTION | FIRE PROTECTION                 |
| CONTRACTOR      | FOGEL ANDERSON                  |








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SHEET TITLE

## TYPICAL MASONRY DETAILS

SHEET NUMBER

## S4.4

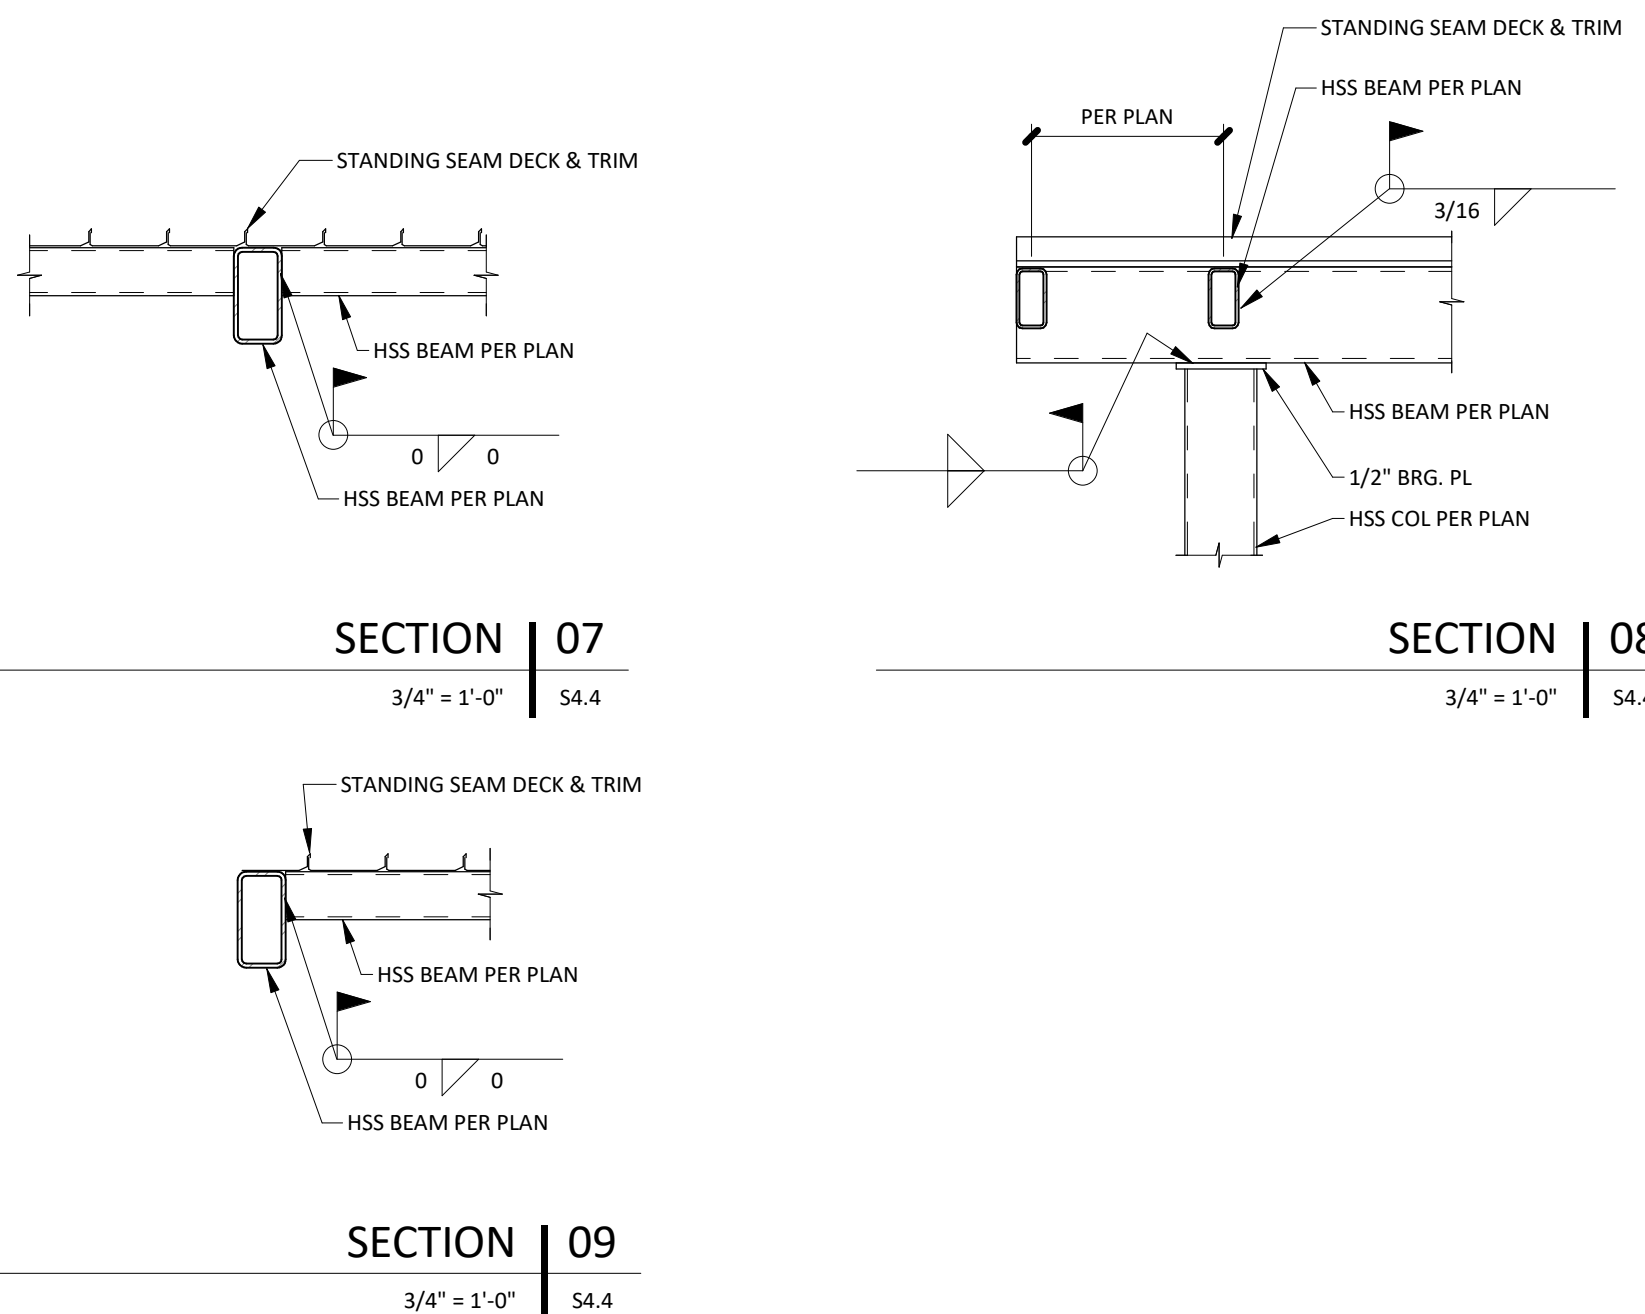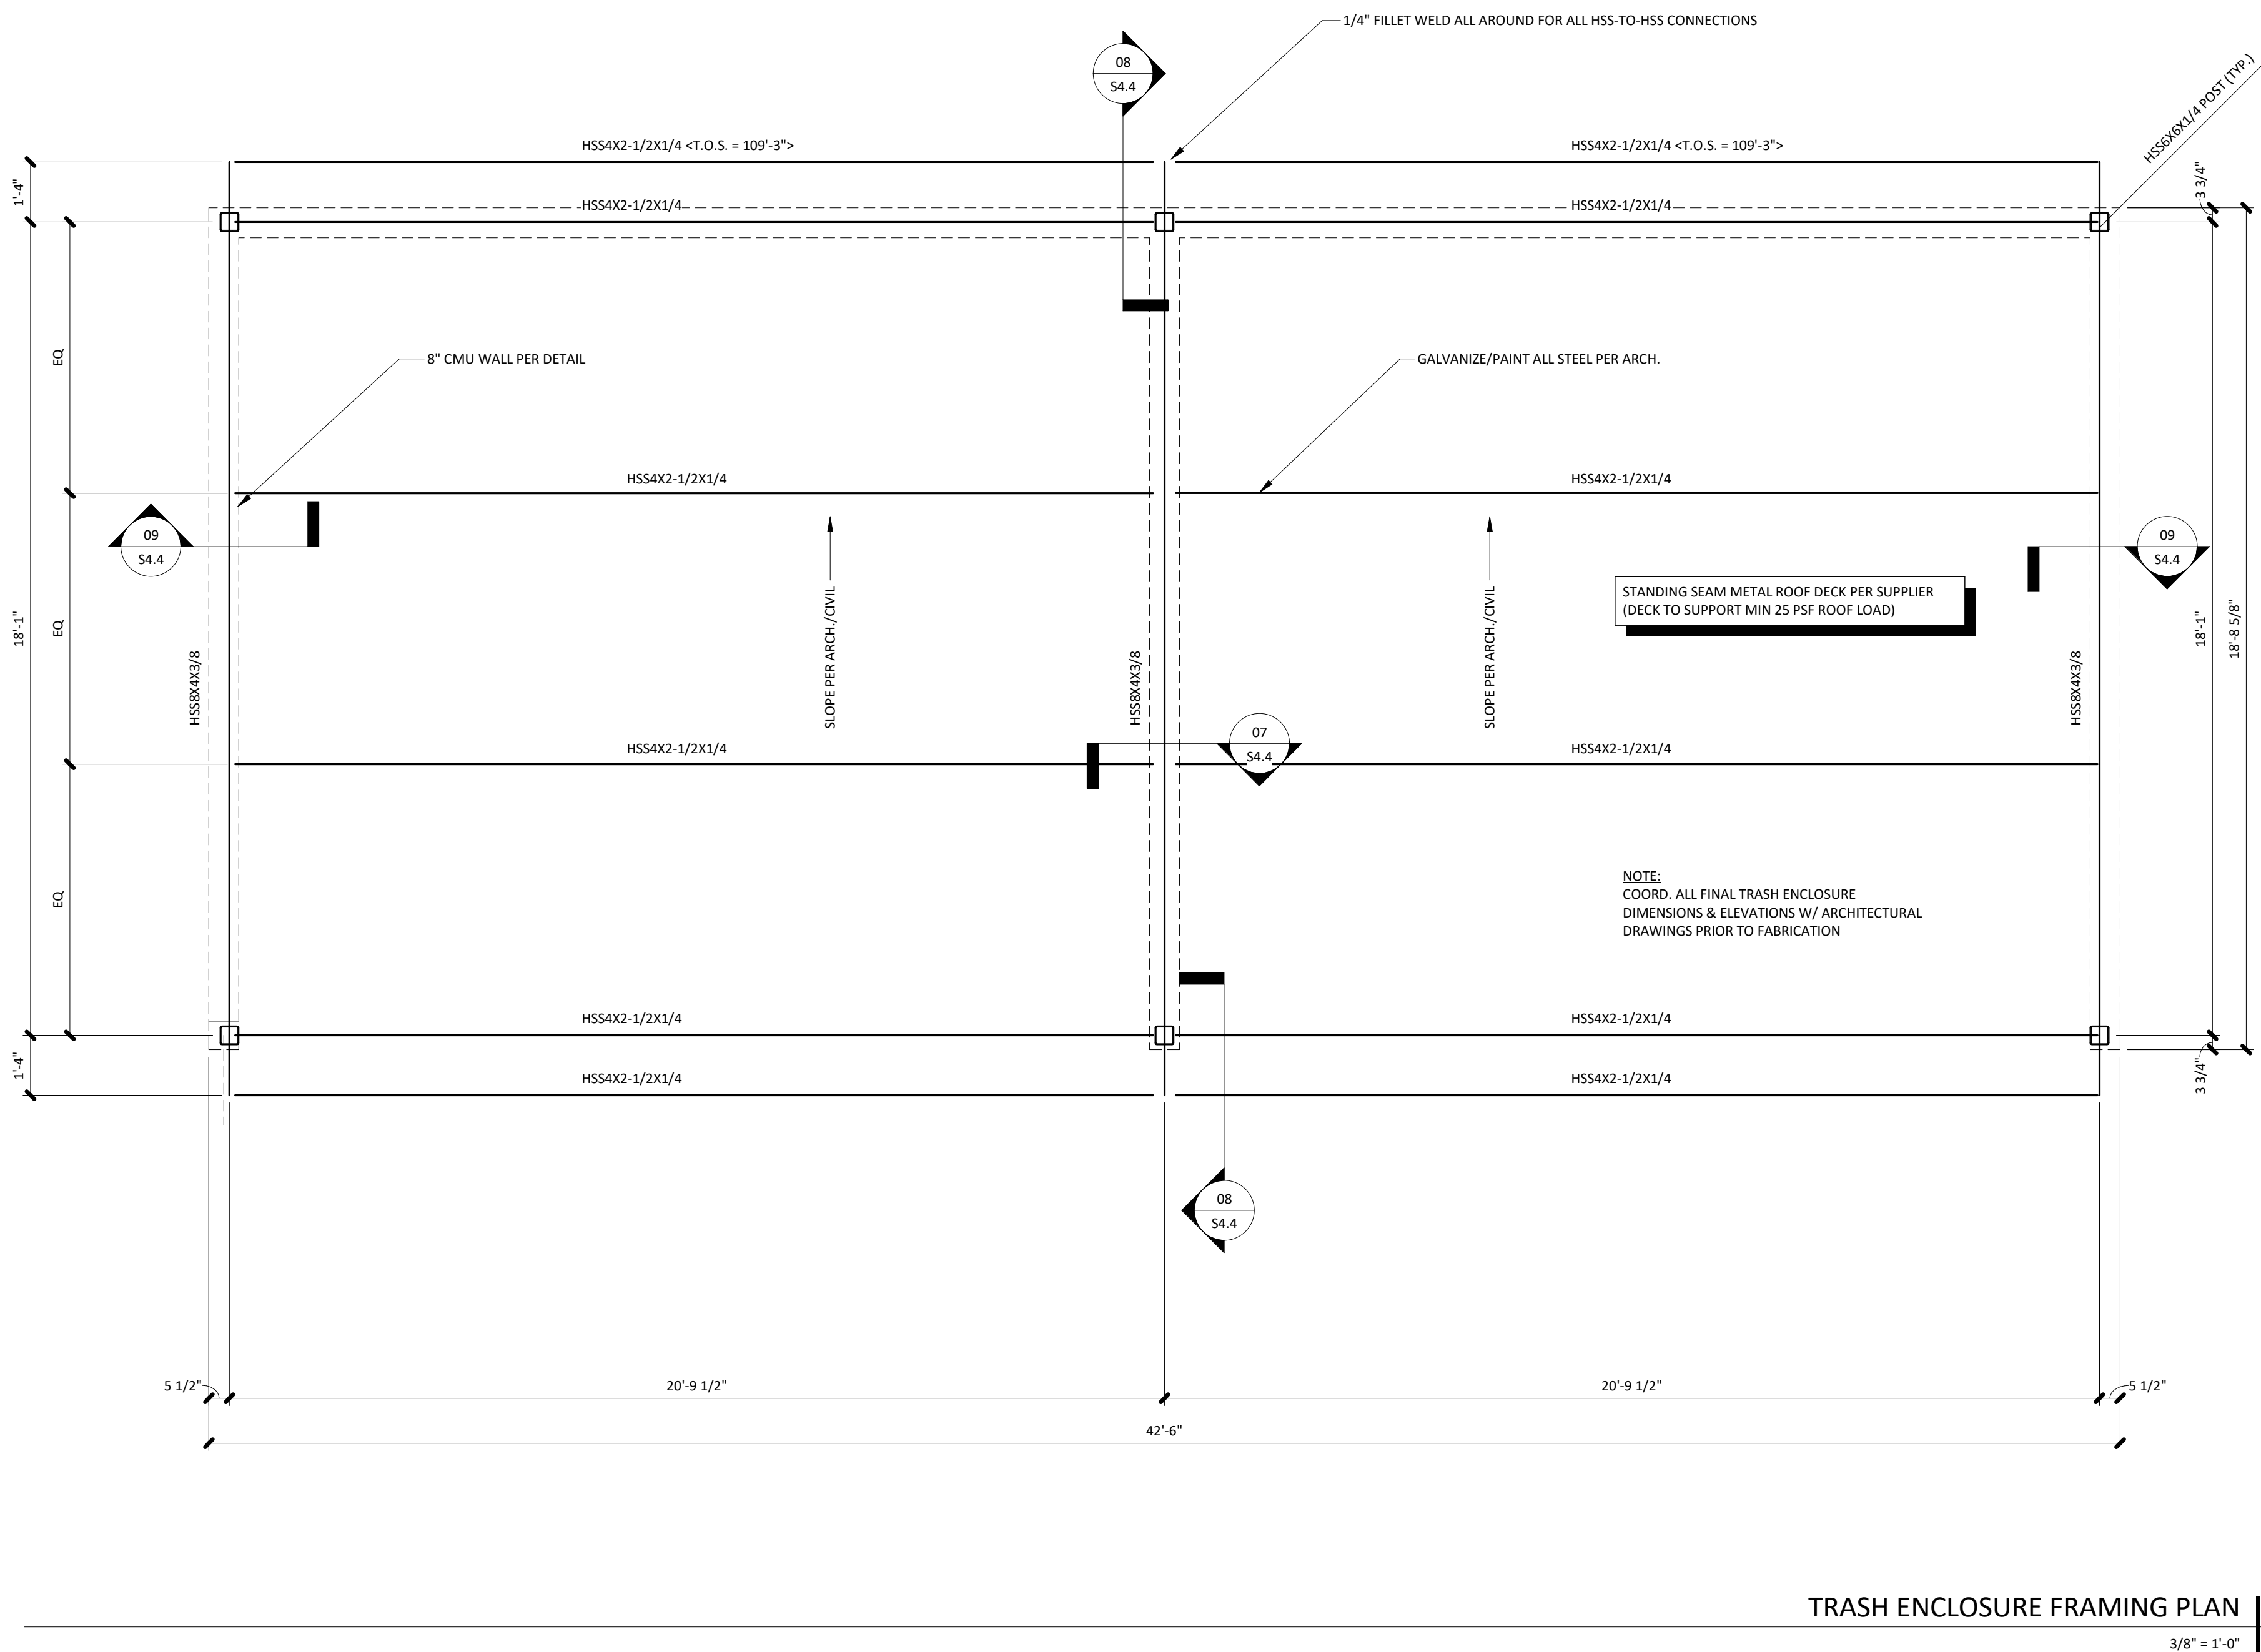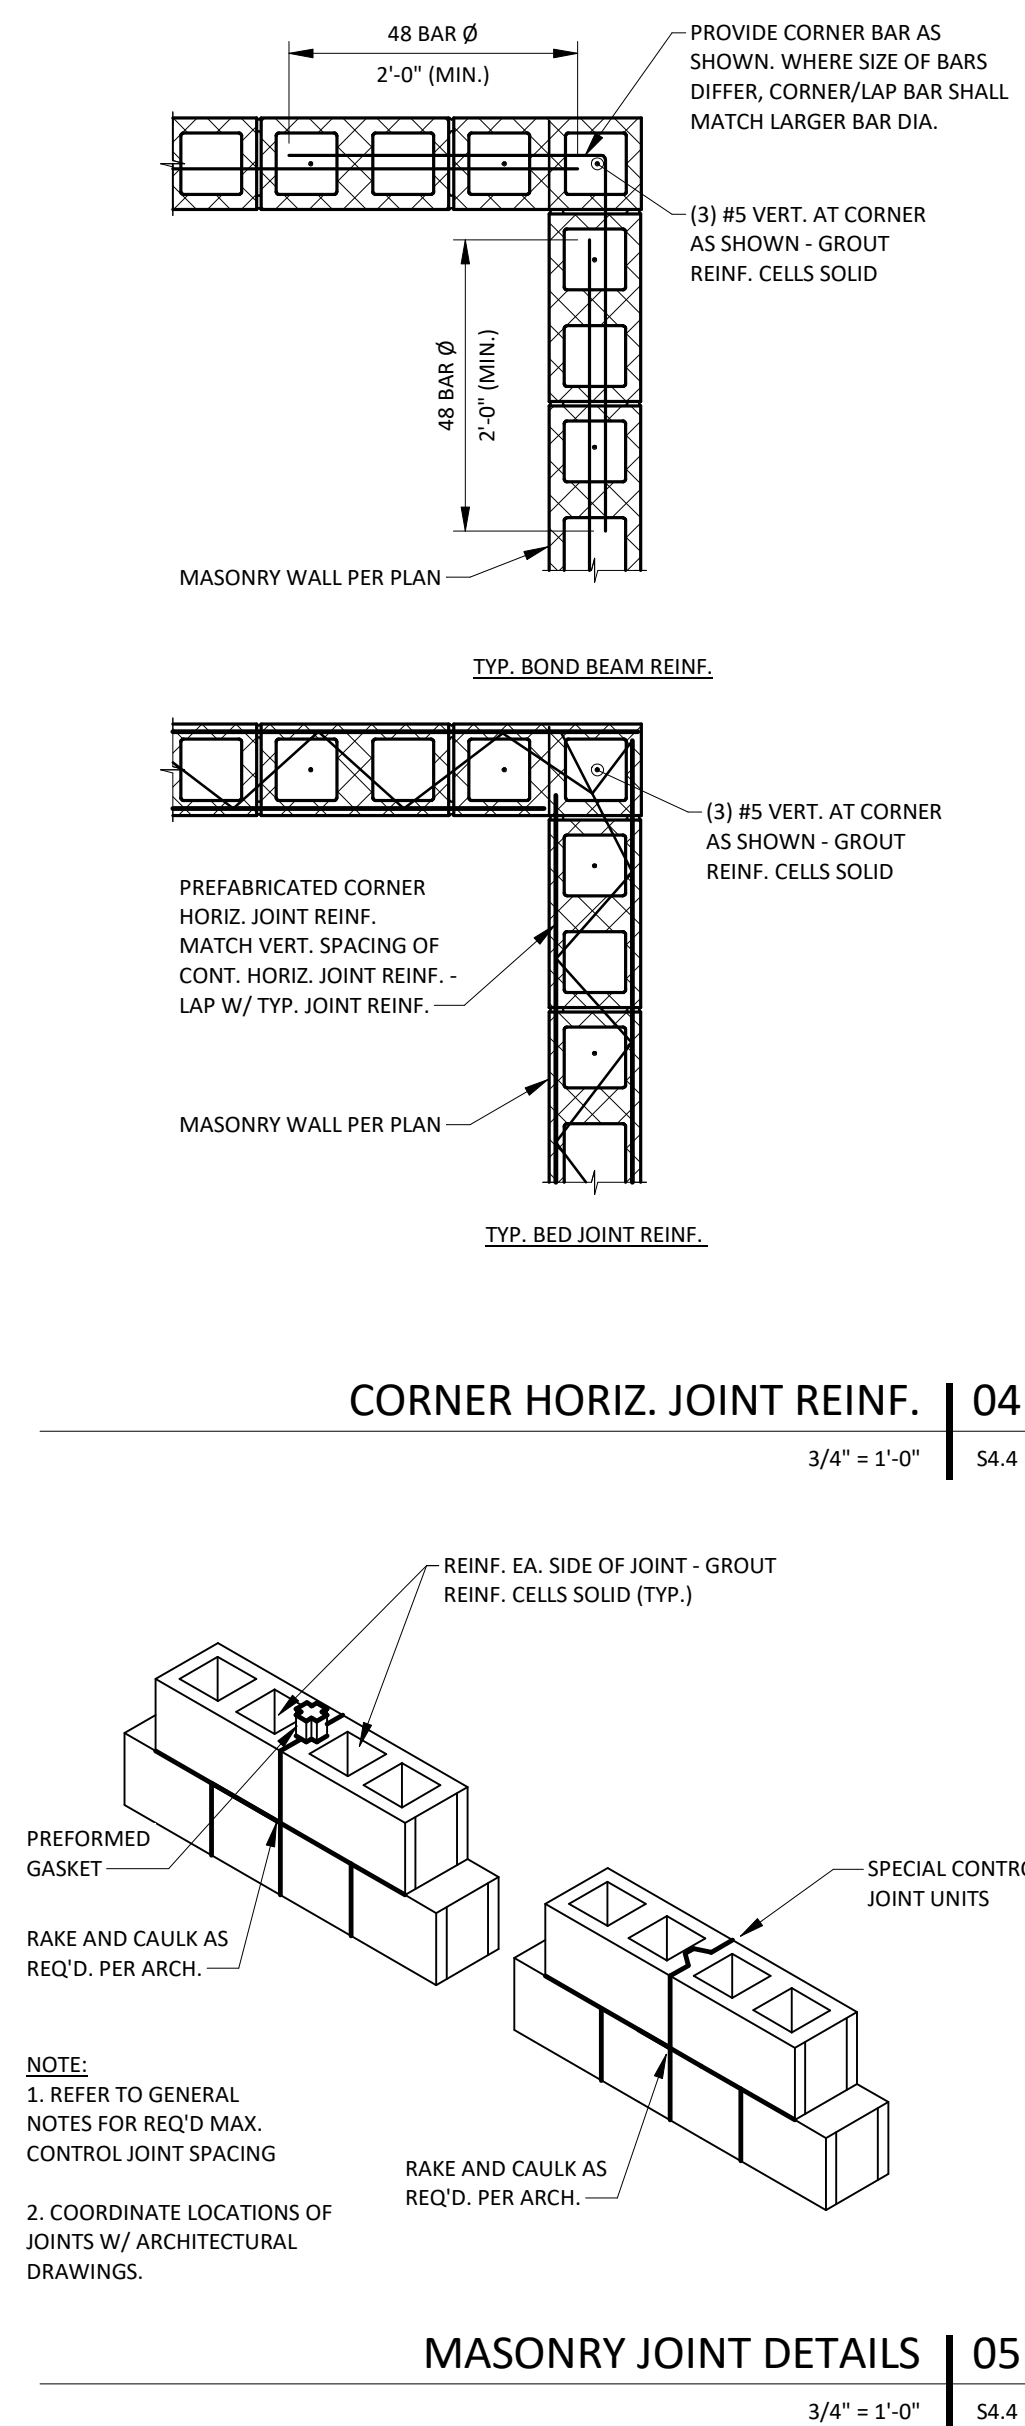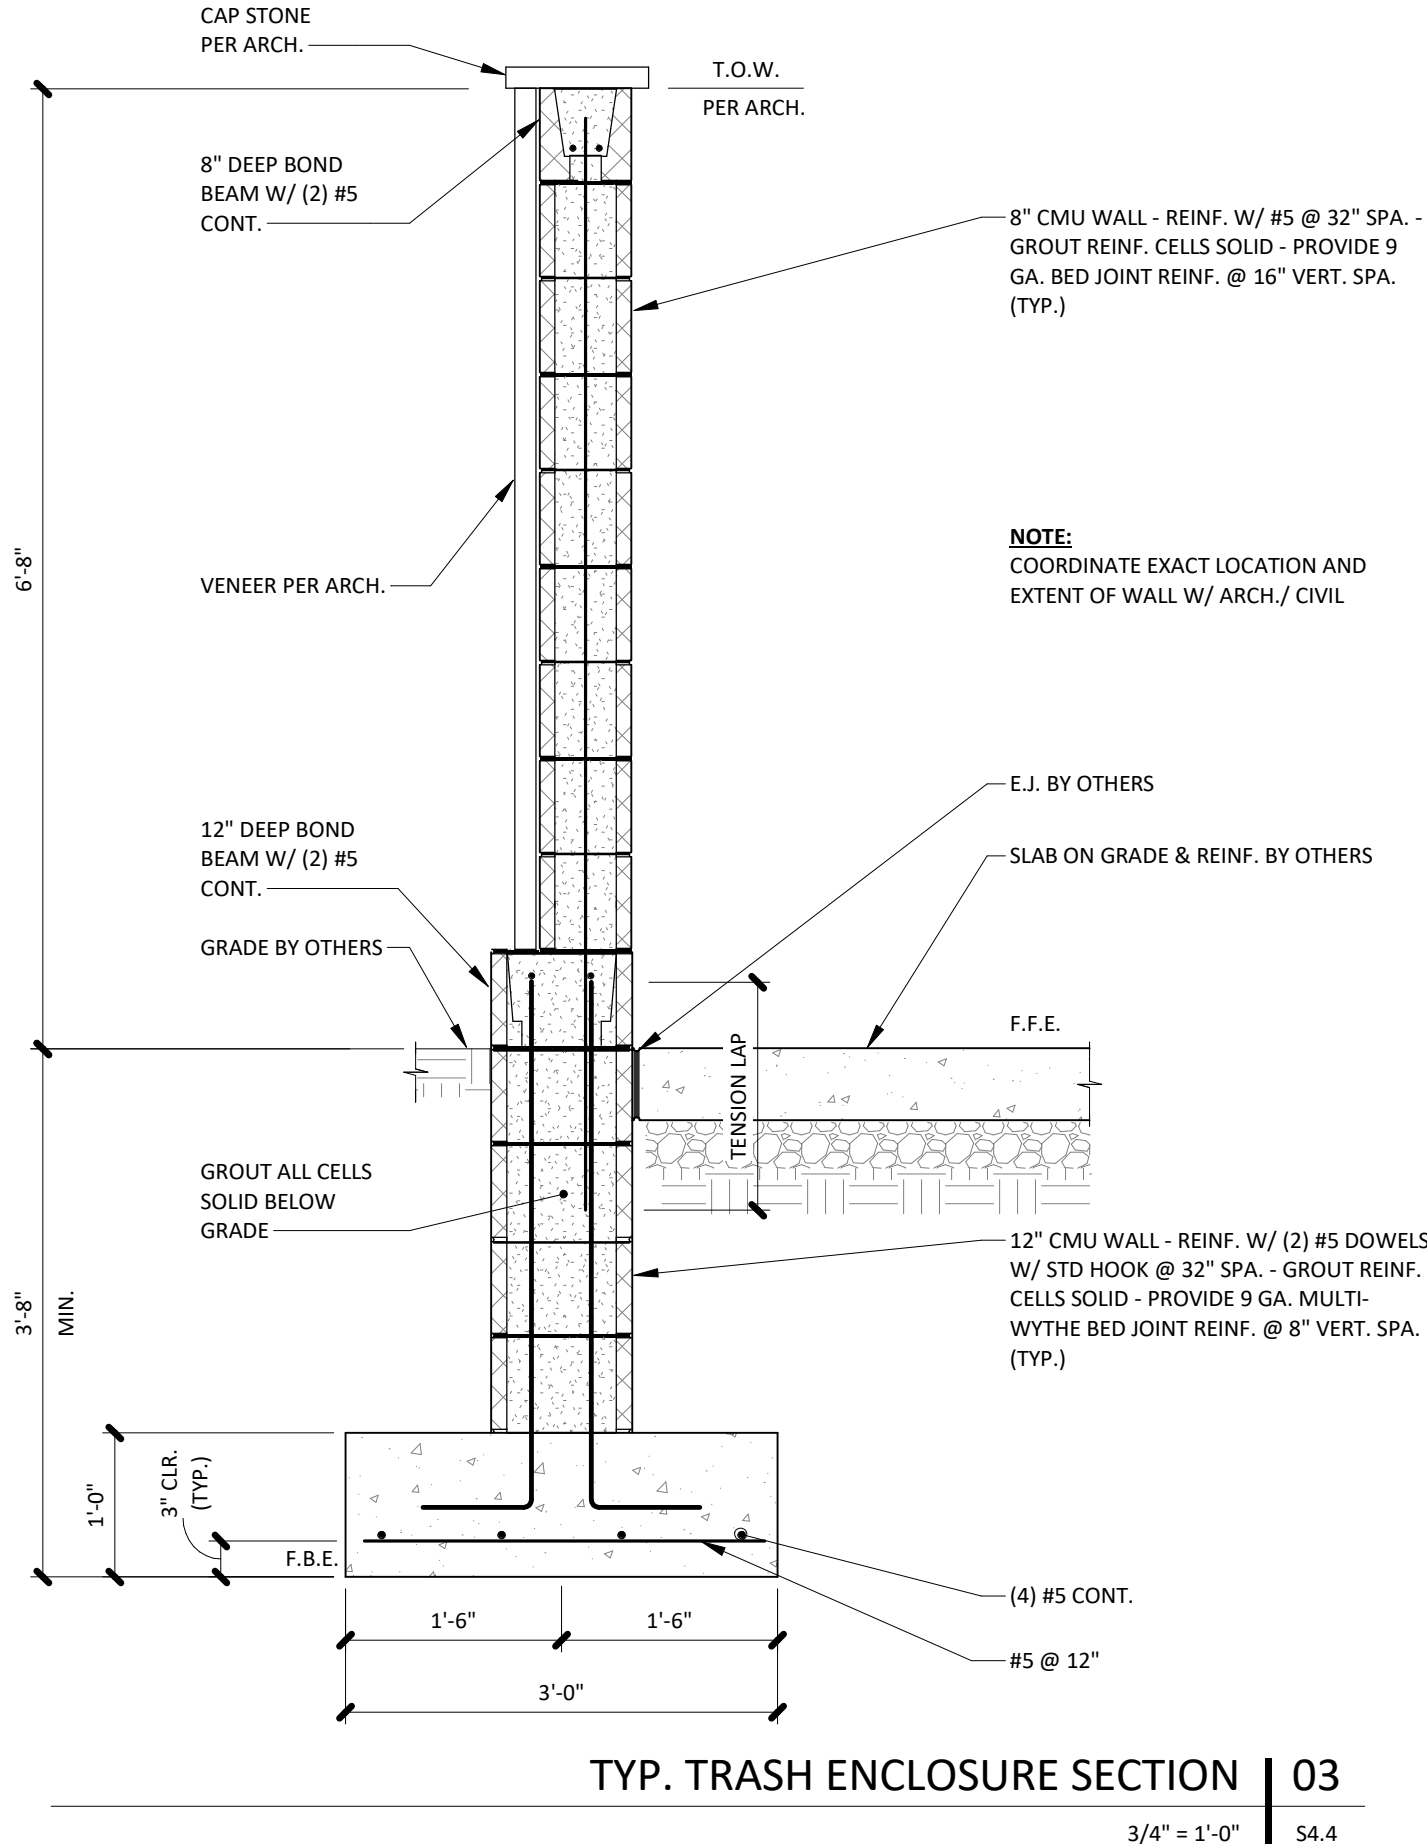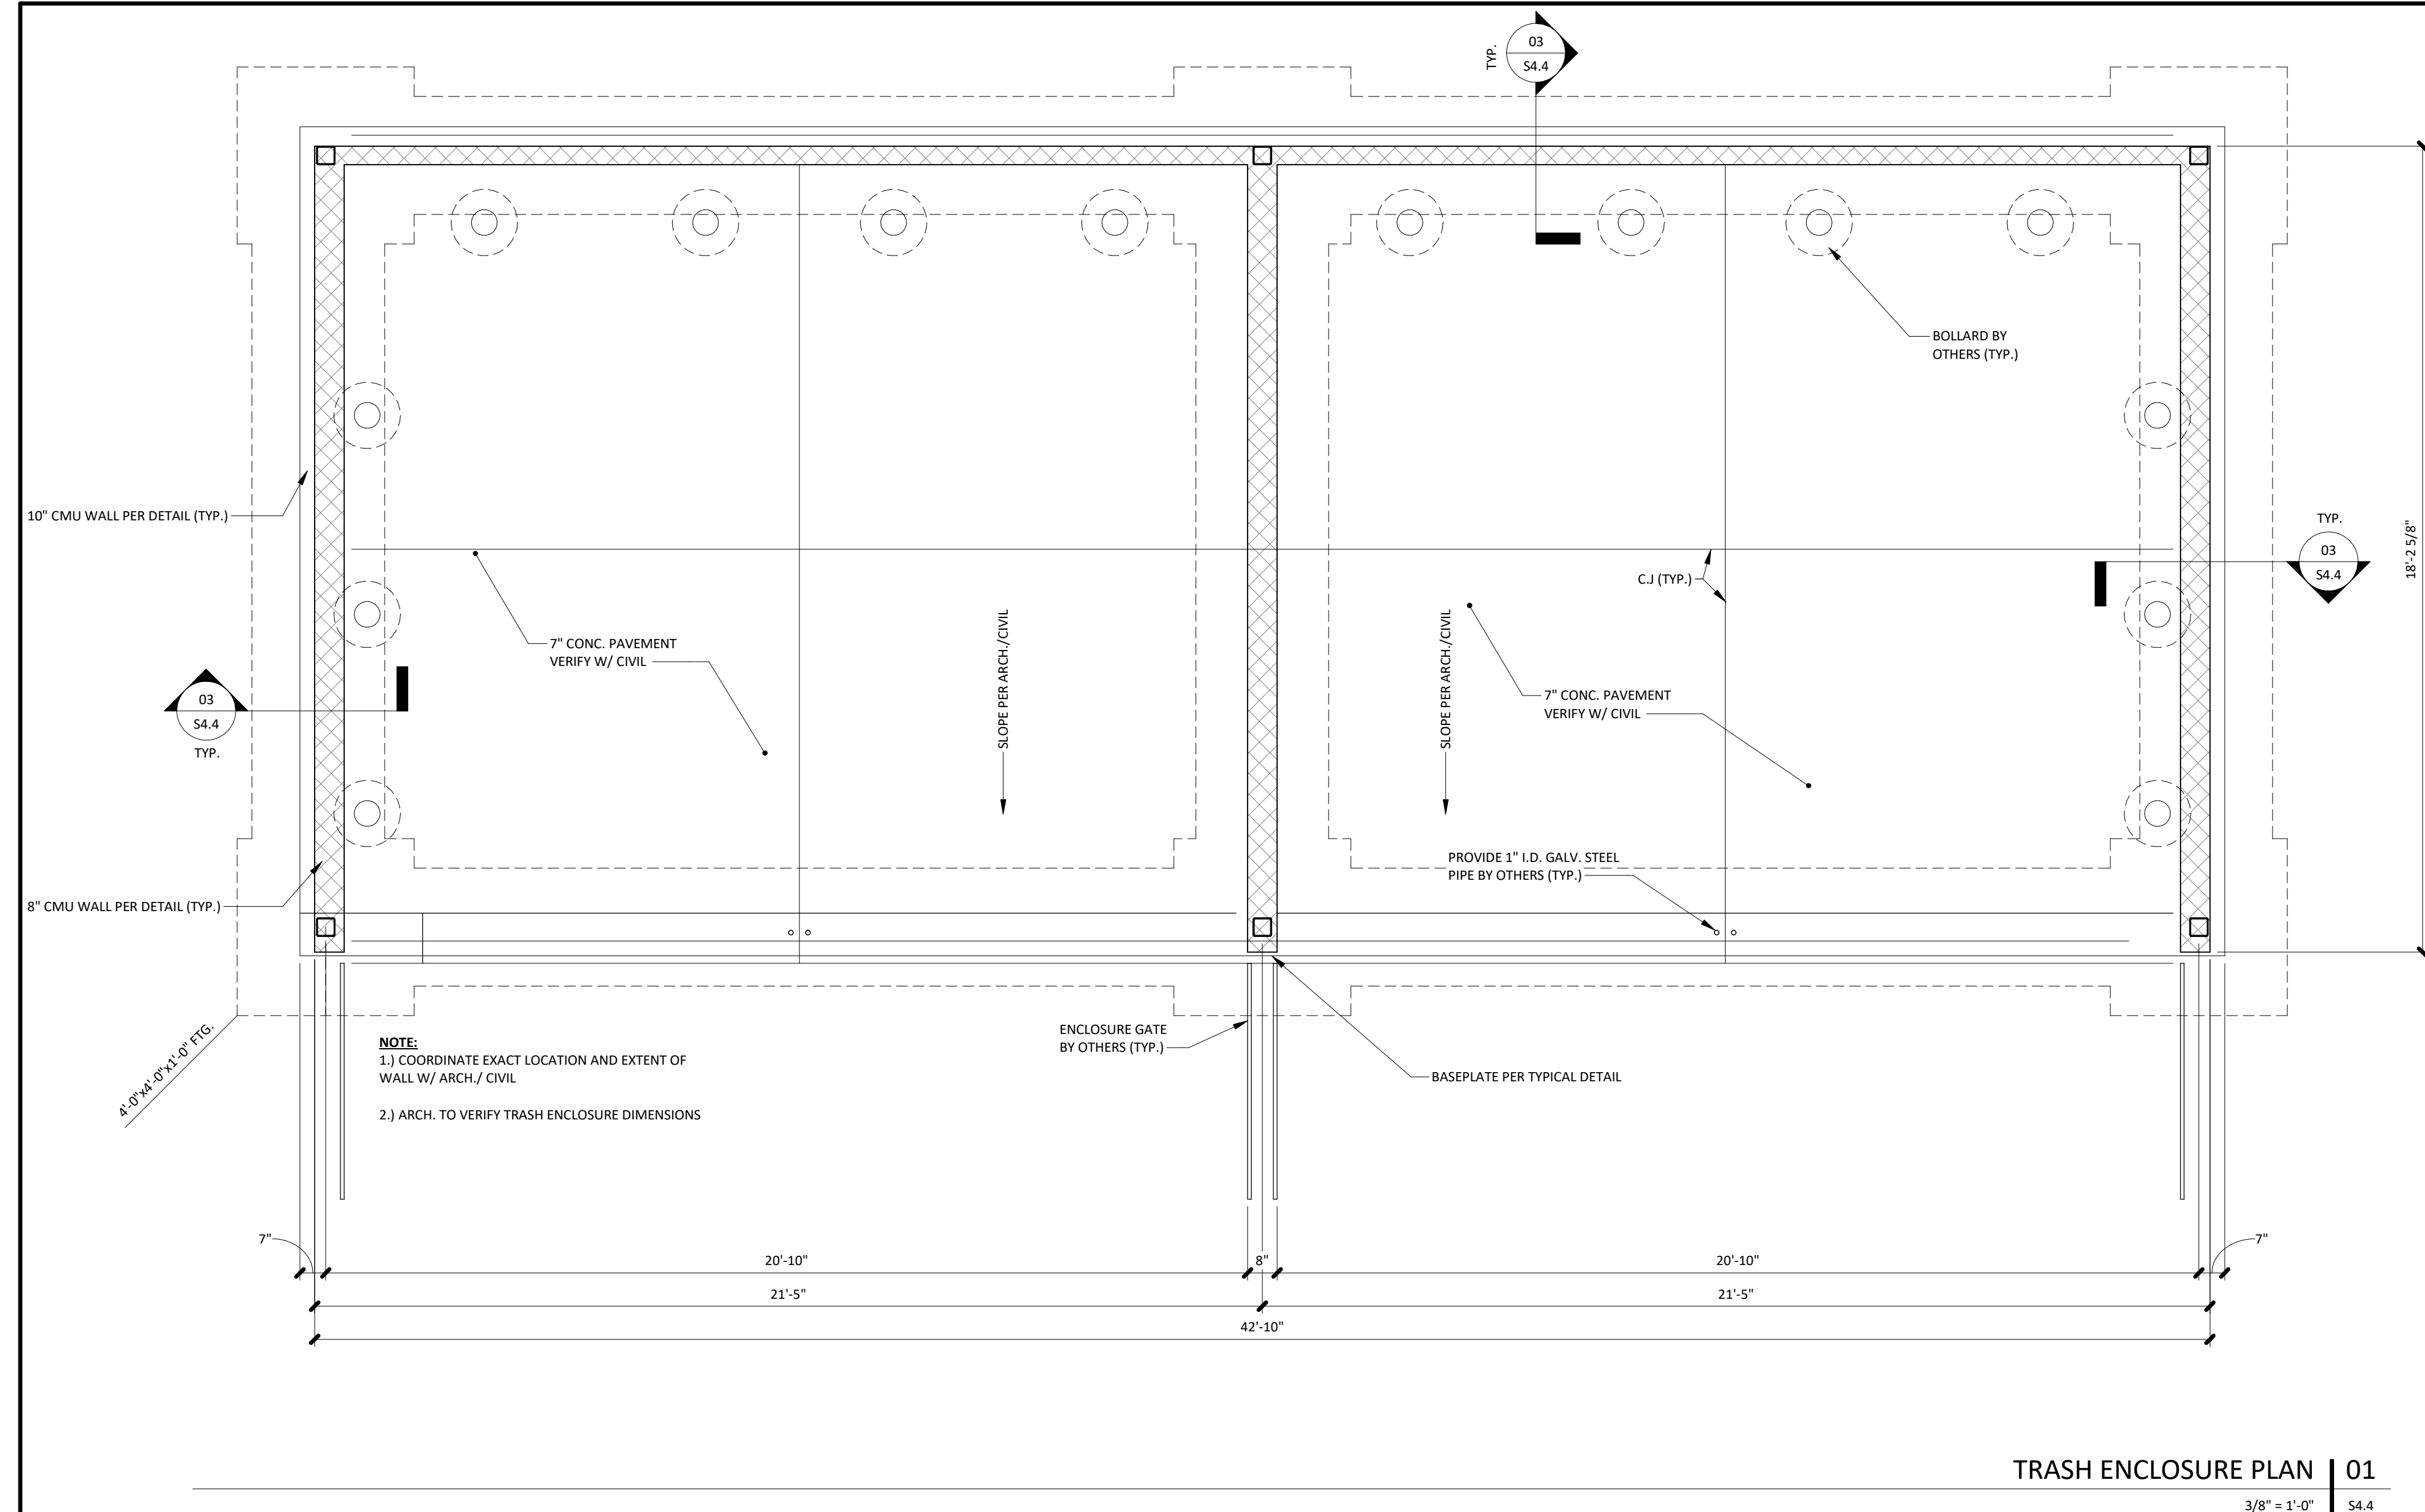


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|--|------------------------|-----|-----|-----|-----|-------------------|----|-----|-----|-----|-----|-----|-----|
| BLOCK<br>WIDTH   | CASE A - BARS CENTERED |     |     |     |     | CASE B - (2) BARS |    |     |     |     |     |     |     |
|  | VERTICAL BAR SIZE      |     |     |     |     | VERTICAL BAR SIZE |    |     |     |     |     |     |     |
|  | #3                     | #4  | #5  | #6  | #7  | #8                | #9 | #3  | #4  | #5  | #6  | #7  | #9  |
| 6" BLOCK   | 14"                    | 18" | 28" | 53" | -   | -                 | -  | -   | -   | -   | -   | -   | -   |
| 8" BLOCK   | 14"                    | 18" | 22" | 38" | 52" | 72"               | *  | 15" | 25" | 39" | 54" | 63" | -   |
| 10" BLOCK  | 14"                    | 18" | 22" | 35" | 50" | 61"               | *  | 15" | 25" | 39" | 54" | 63" | 72" |
| 12" BLOCK  | 14"                    | 18" | 22" | 35" | 40" | 61"               | *  | 14" | 22" | 35" | 54" | 63" | 72" |
|  |                        |     |     |     |     |                   |    |     |     |     |     |     | *   |

**SYMBOLS:**

- REINFORCING CONFIGURATION NOT PERMISSIBLE
- \* MECHANICAL TENSION SPLICE REQ'D

NOTES:

- 1) MECH. TENSION SPLICE CAN BE FOR ANY BAR SIZE IF NOT NOTED
- 2) FOR USE WITH  $f'_m=2,000$  psi &  $f_y = 60,000$  psi

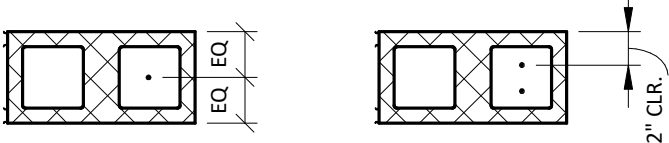

MASONRY SPLICE TABLE | 06





|              |                |
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| PROJECT TEAM    |                                 |
|-----------------|---------------------------------|
| ARCHITECT       | FINKLE+WILLIAMS<br>ARCHITECTURE |
| CIVIL           | GBA                             |
| LANDSCAPE       | HOERR SCHAUDT /<br>LAND3        |
| FOUNDATIONS     | BSE STRUCTURAL<br>ENGINEERS     |
| STRUCTURAL      | BSE STRUCTURAL<br>ENGINEERS     |
| PLUMBING        | HENDERSON<br>ENGINEERS          |
| MECHANICAL      | HENDERSON<br>ENGINEERS          |
| ELECTRICAL      | HENDERSON<br>ENGINEERS          |
| FIRE PROTECTION | FIRE PROTECTION                 |
| CONTRACTOR      | FOGEL ANDERSON                  |




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## FRAMING DETAILS

SHEET NUMBER

## S4.5






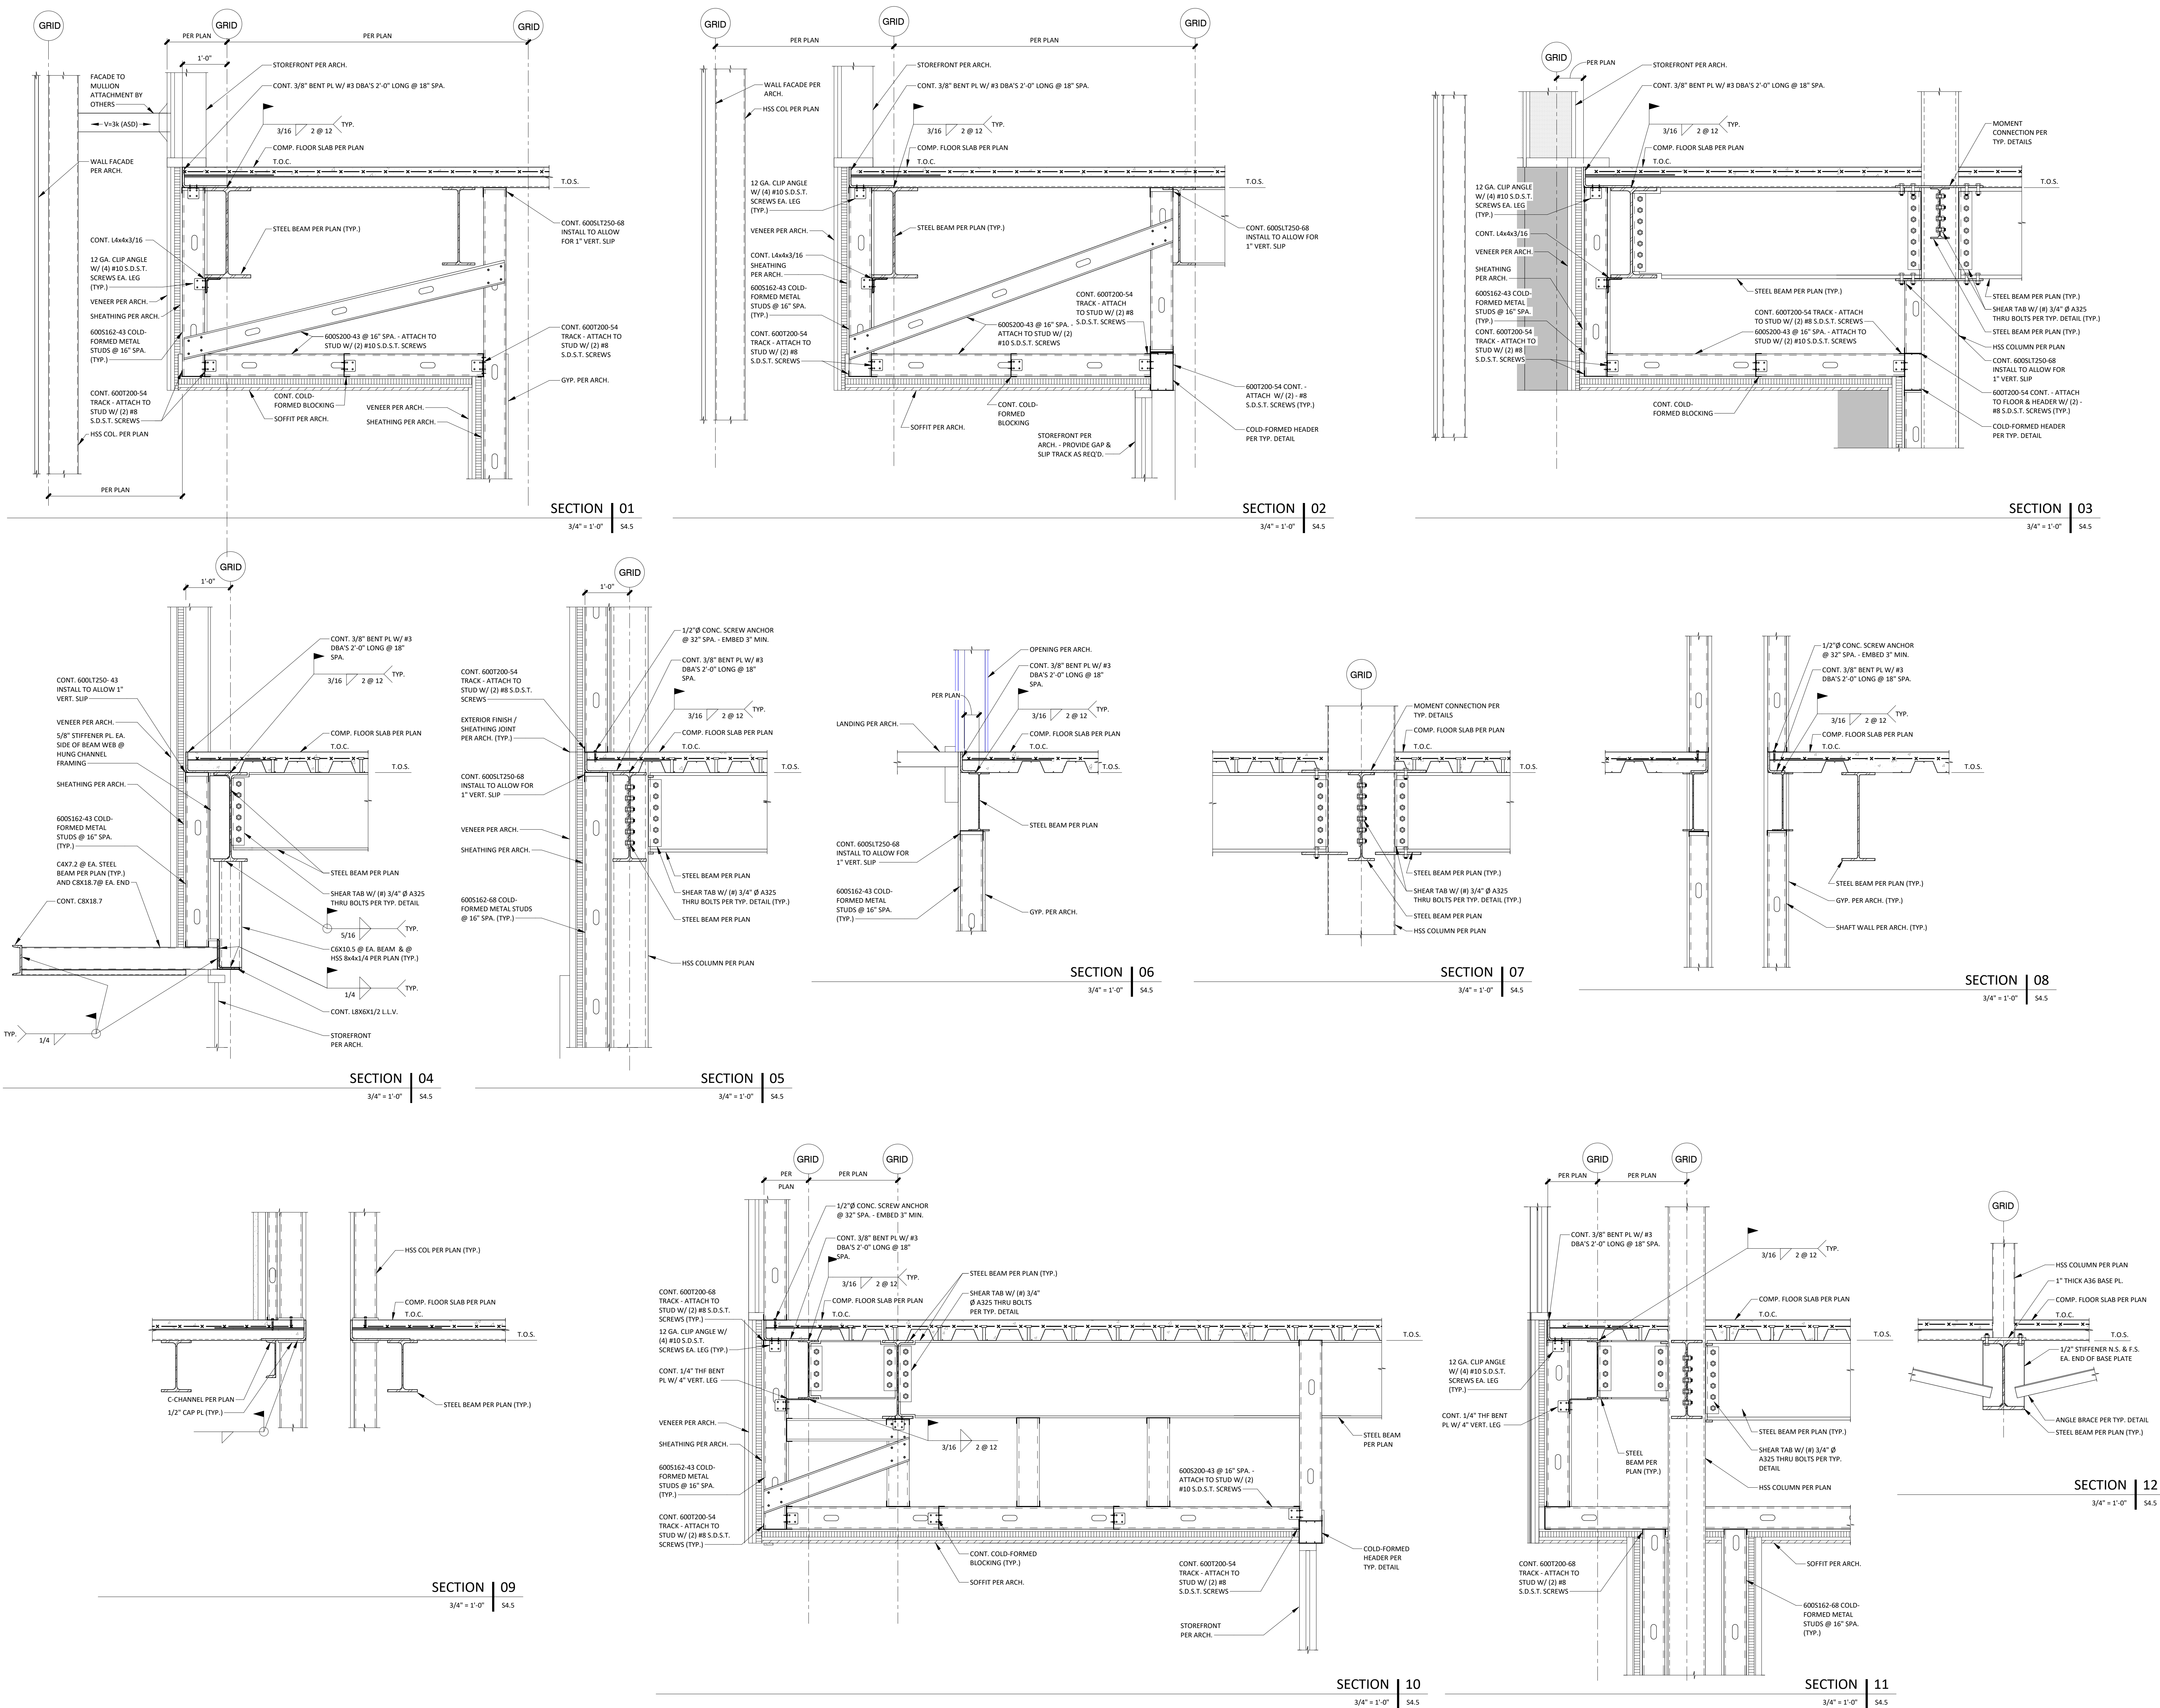

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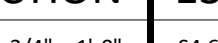
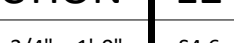
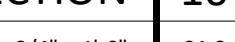
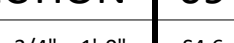
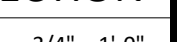
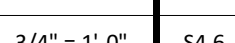
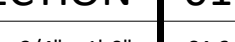
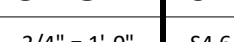
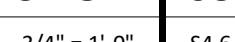
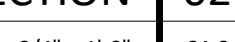
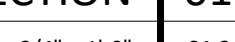
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| PROJECT TEAM    |                              |
|-----------------|------------------------------|
| ARCHITECT       | FINKLE-WILLIAMS ARCHITECTURE |
| CIVIL           | GBA                          |
| LANDSCAPE       | HOERR SCHAUDT LANDSC         |
| FOUNDATIONS     | BSE STRUCTURAL ENGINEERS     |
| STRUCTURAL      | BSE STRUCTURAL ENGINEERS     |
| PLUMBING        | HENDERSON ENGINEERS          |
| MECHANICAL      | HENDERSON ENGINEERS          |
| ELECTRICAL      | HENDERSON ENGINEERS          |
| FIRE PROTECTION | FIRE PROTECTION              |
| CONTRACTOR      | FOGEL ANDERSON               |



## FRAMING DETAILS
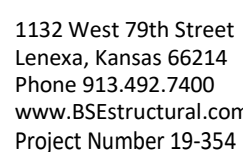
## S4.6







|              |                |
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| PROJECT TEAM    |                              |
|-----------------|------------------------------|
| ARCHITECT       | FINKLE+WILLIAMS ARCHITECTURE |
| CIVIL           | GBA                          |
| LANDSCAPE       | HOERR SCHAUDT LANDS          |
| FOUNDATIONS     | BSE STRUCTURAL ENGINEERS     |
| STRUCTURAL      | BSE STRUCTURAL ENGINEERS     |
| PLUMBING        | HENDERSON ENGINEERS          |
| MECHANICAL      | HENDERSON ENGINEERS          |
| ELECTRICAL      | HENDERSON ENGINEERS          |
| FIRE PROTECTION | FIRE PROTECTION              |
| CONTRACTOR      | FOGEL ANDERSON               |



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## FRAMING DETAILS

SHEET NUMBER

## S4.7





|              |                |
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## PROJECT TEAM

|                 |                                 |
|-----------------|---------------------------------|
| ARCHITECT       | FINKLE+WILLIAMS<br>ARCHITECTURE |
| CIVIL           | GBA                             |
| LANDSCAPE       | HOERR SCHAUDT F<br>LAND3        |
| FOUNDATIONS     | BSE STRUCTURAL<br>ENGINEERS     |
| STRUCTURAL      | BSE STRUCTURAL<br>ENGINEERS     |
| PLUMBING        | HENDERSON<br>ENGINEERS          |
| MECHANICAL      | HENDERSON<br>ENGINEERS          |
| ELECTRICAL      | HENDERSON<br>ENGINEERS          |
| FIRE PROTECTION | FIRE PROTECTION                 |
| CONTRACTOR      | FOGEL ANDERSON                  |




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## FRAMING DETAILS

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## S4.8




C:\Users\julie markham\Documents\19-354 Paragon - Lee's Summit, MO - Option 1\_markham@bsestructural.com.mt

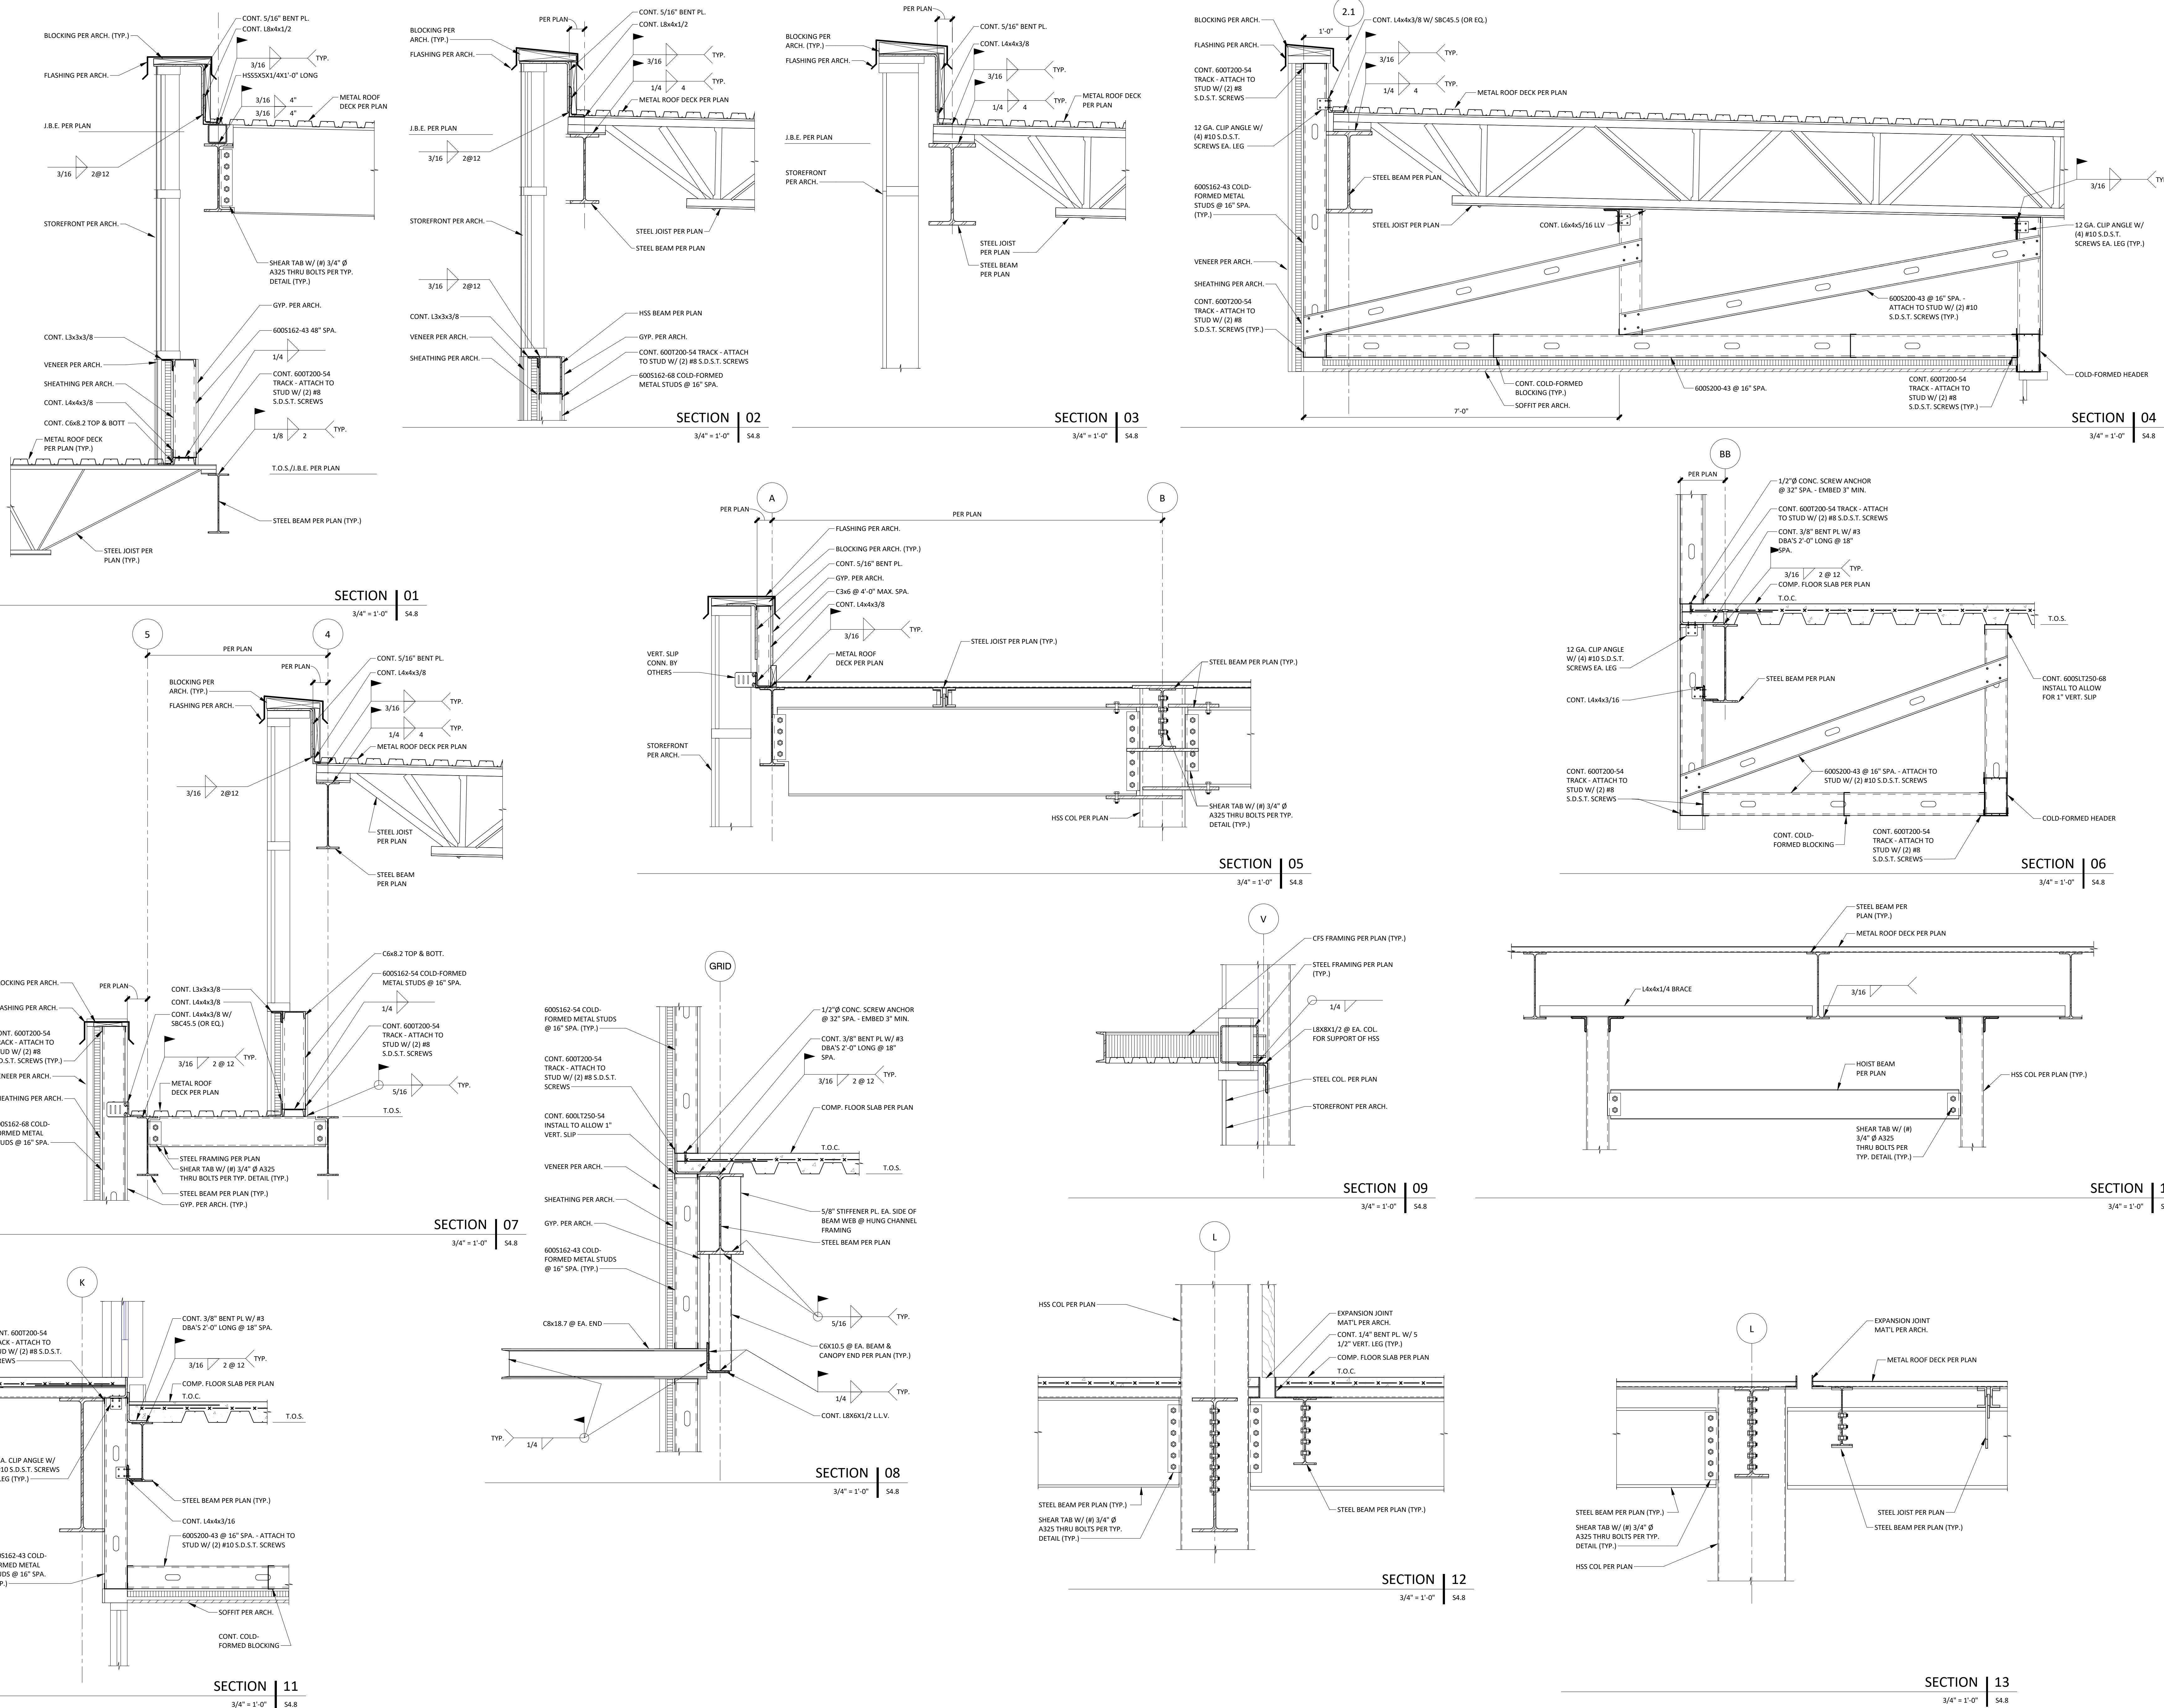

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## REGISTRATION



## PROJECT TEAM
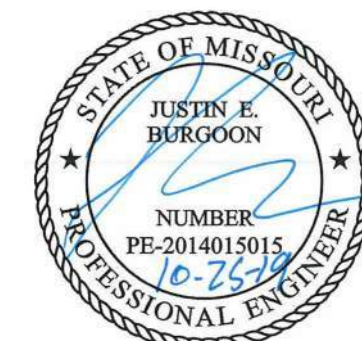
|                 |                                |
|-----------------|--------------------------------|
| ARCHITECT       | FINKE+WILLIAMS<br>ARCHITECTURE |
| CIVIL           | GBA                            |
| LANDSCAPE       | HOERR SCHAUDT /<br>LAND3       |
| FOUNDATIONS     | BSE STRUCTURAL<br>ENGINEERS    |
| STRUCTURAL      | BSE STRUCTURAL<br>ENGINEERS    |
| PLUMBING        | HENDERSON<br>ENGINEERS         |
| MECHANICAL      | HENDERSON<br>ENGINEERS         |
| ELECTRICAL      | HENDERSON<br>ENGINEERS         |
| FIRE PROTECTION | FIRE PROTECTION                |
| CONTRACTOR      | FOGEL ANDERSON                 |





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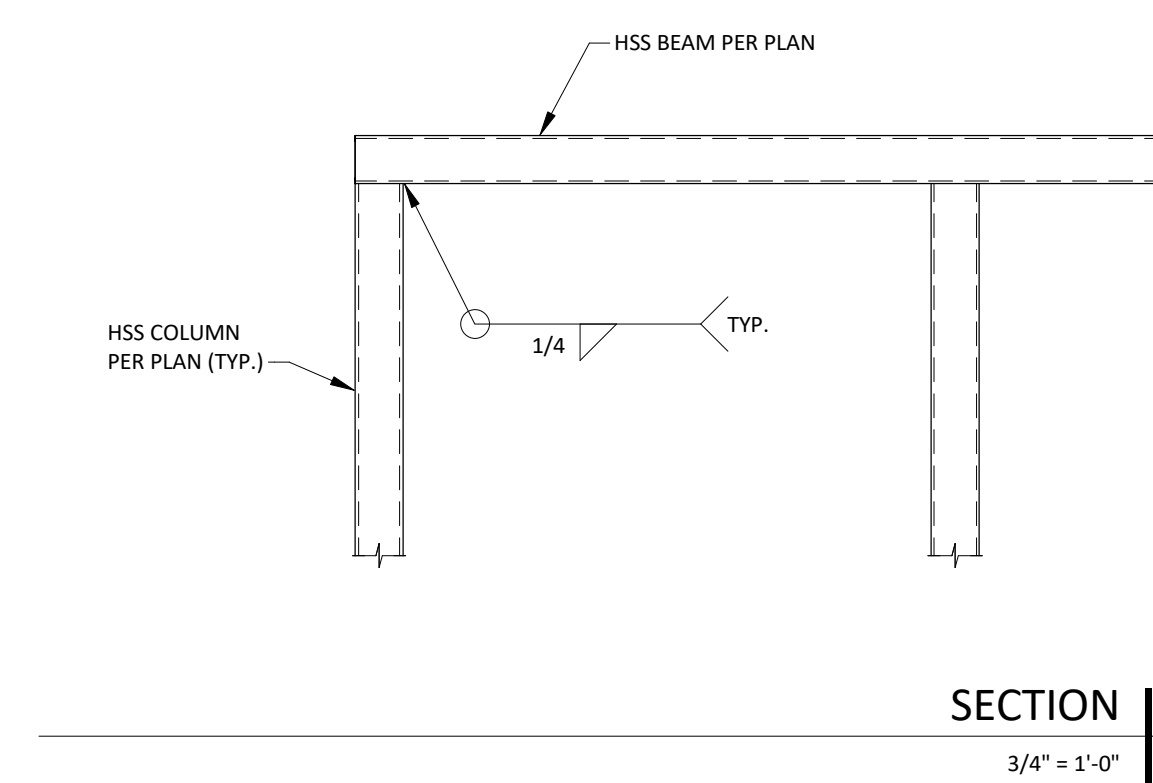
## FRAMING DETAILS

SHEET NUMBER

## S4.9

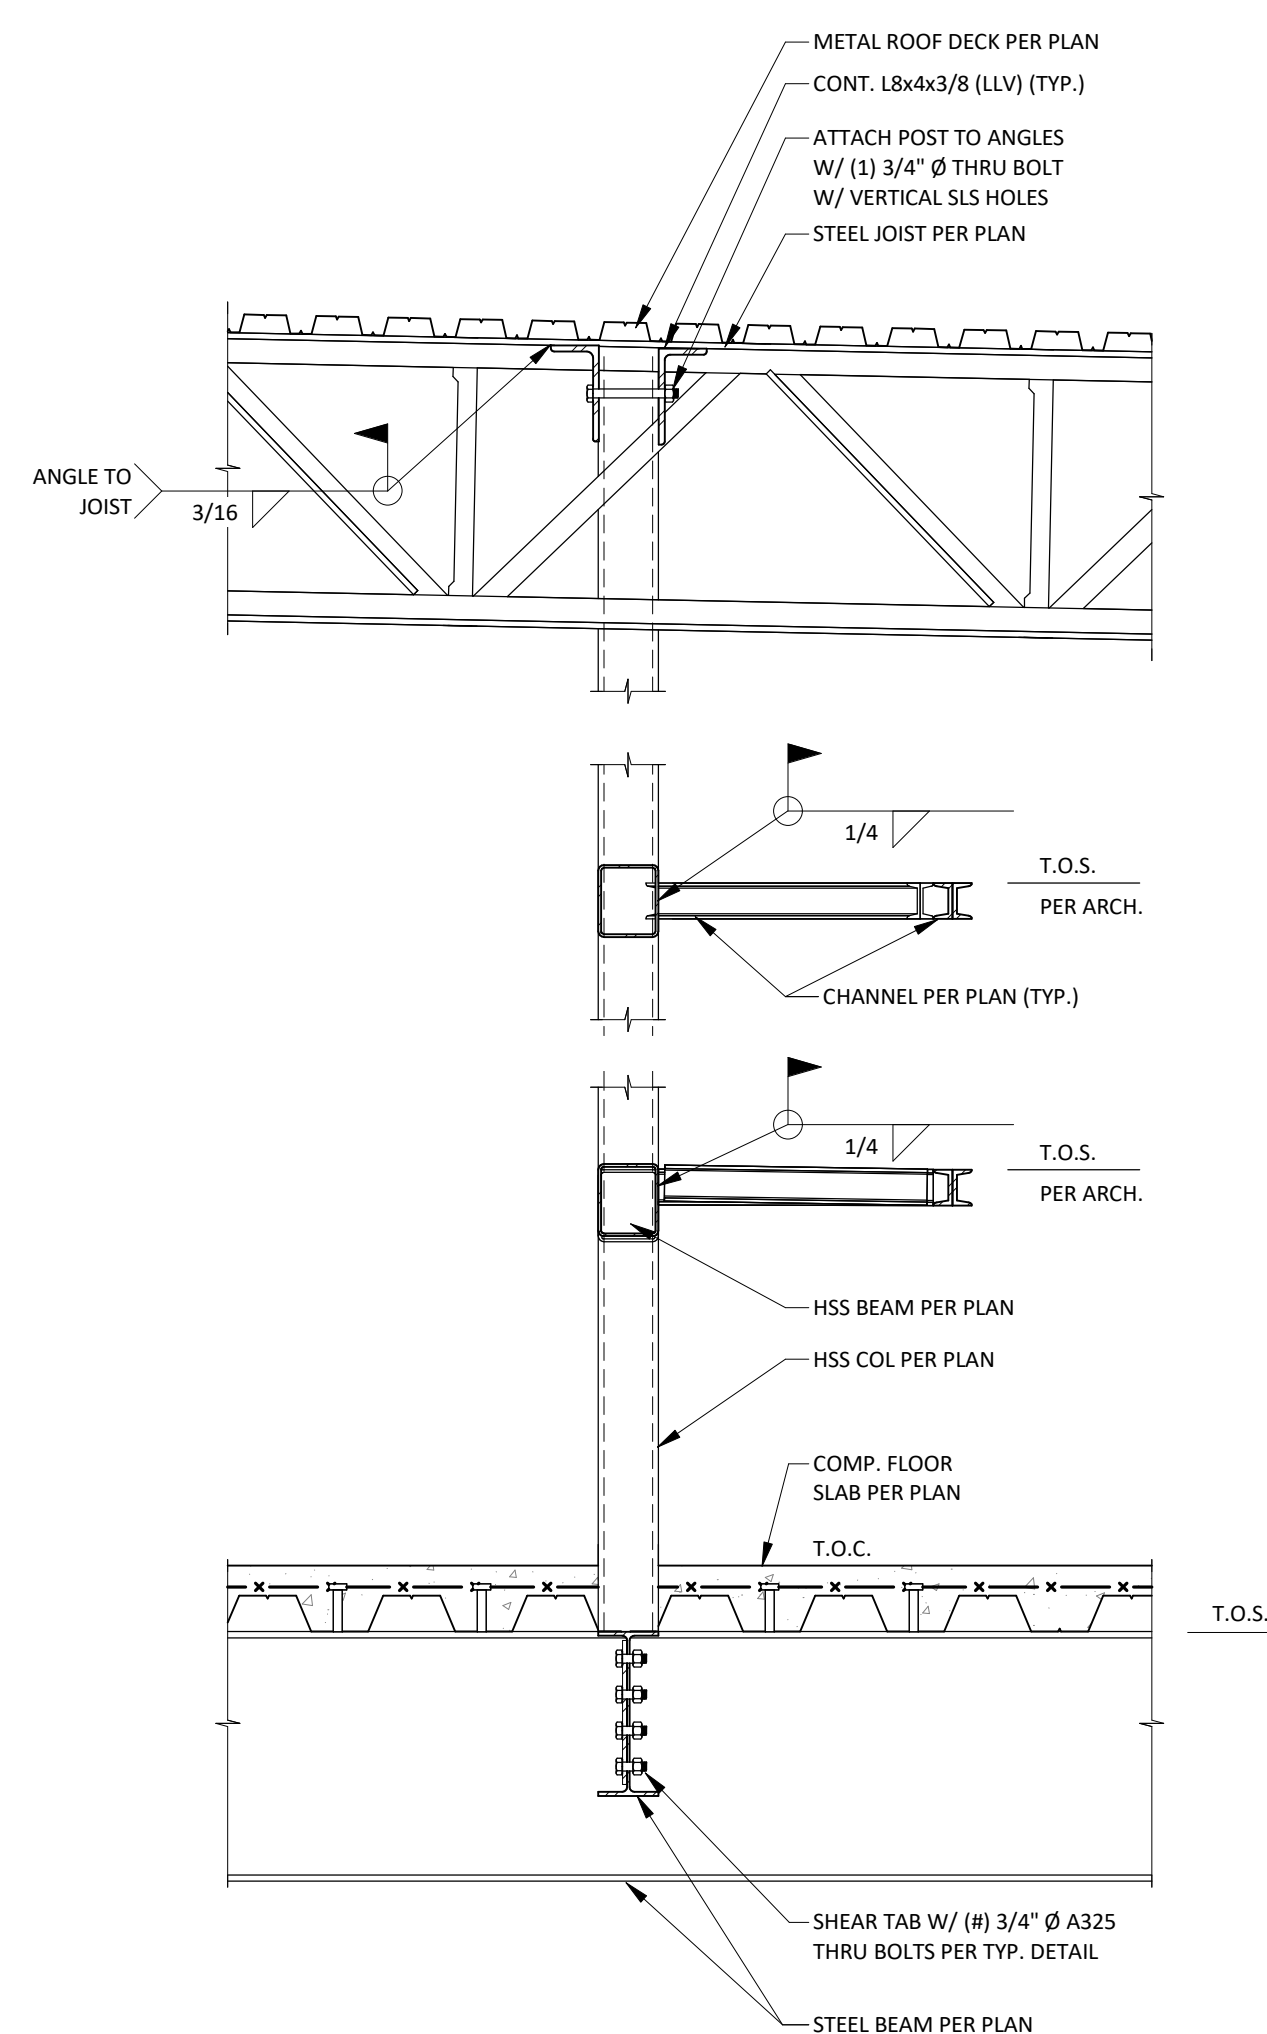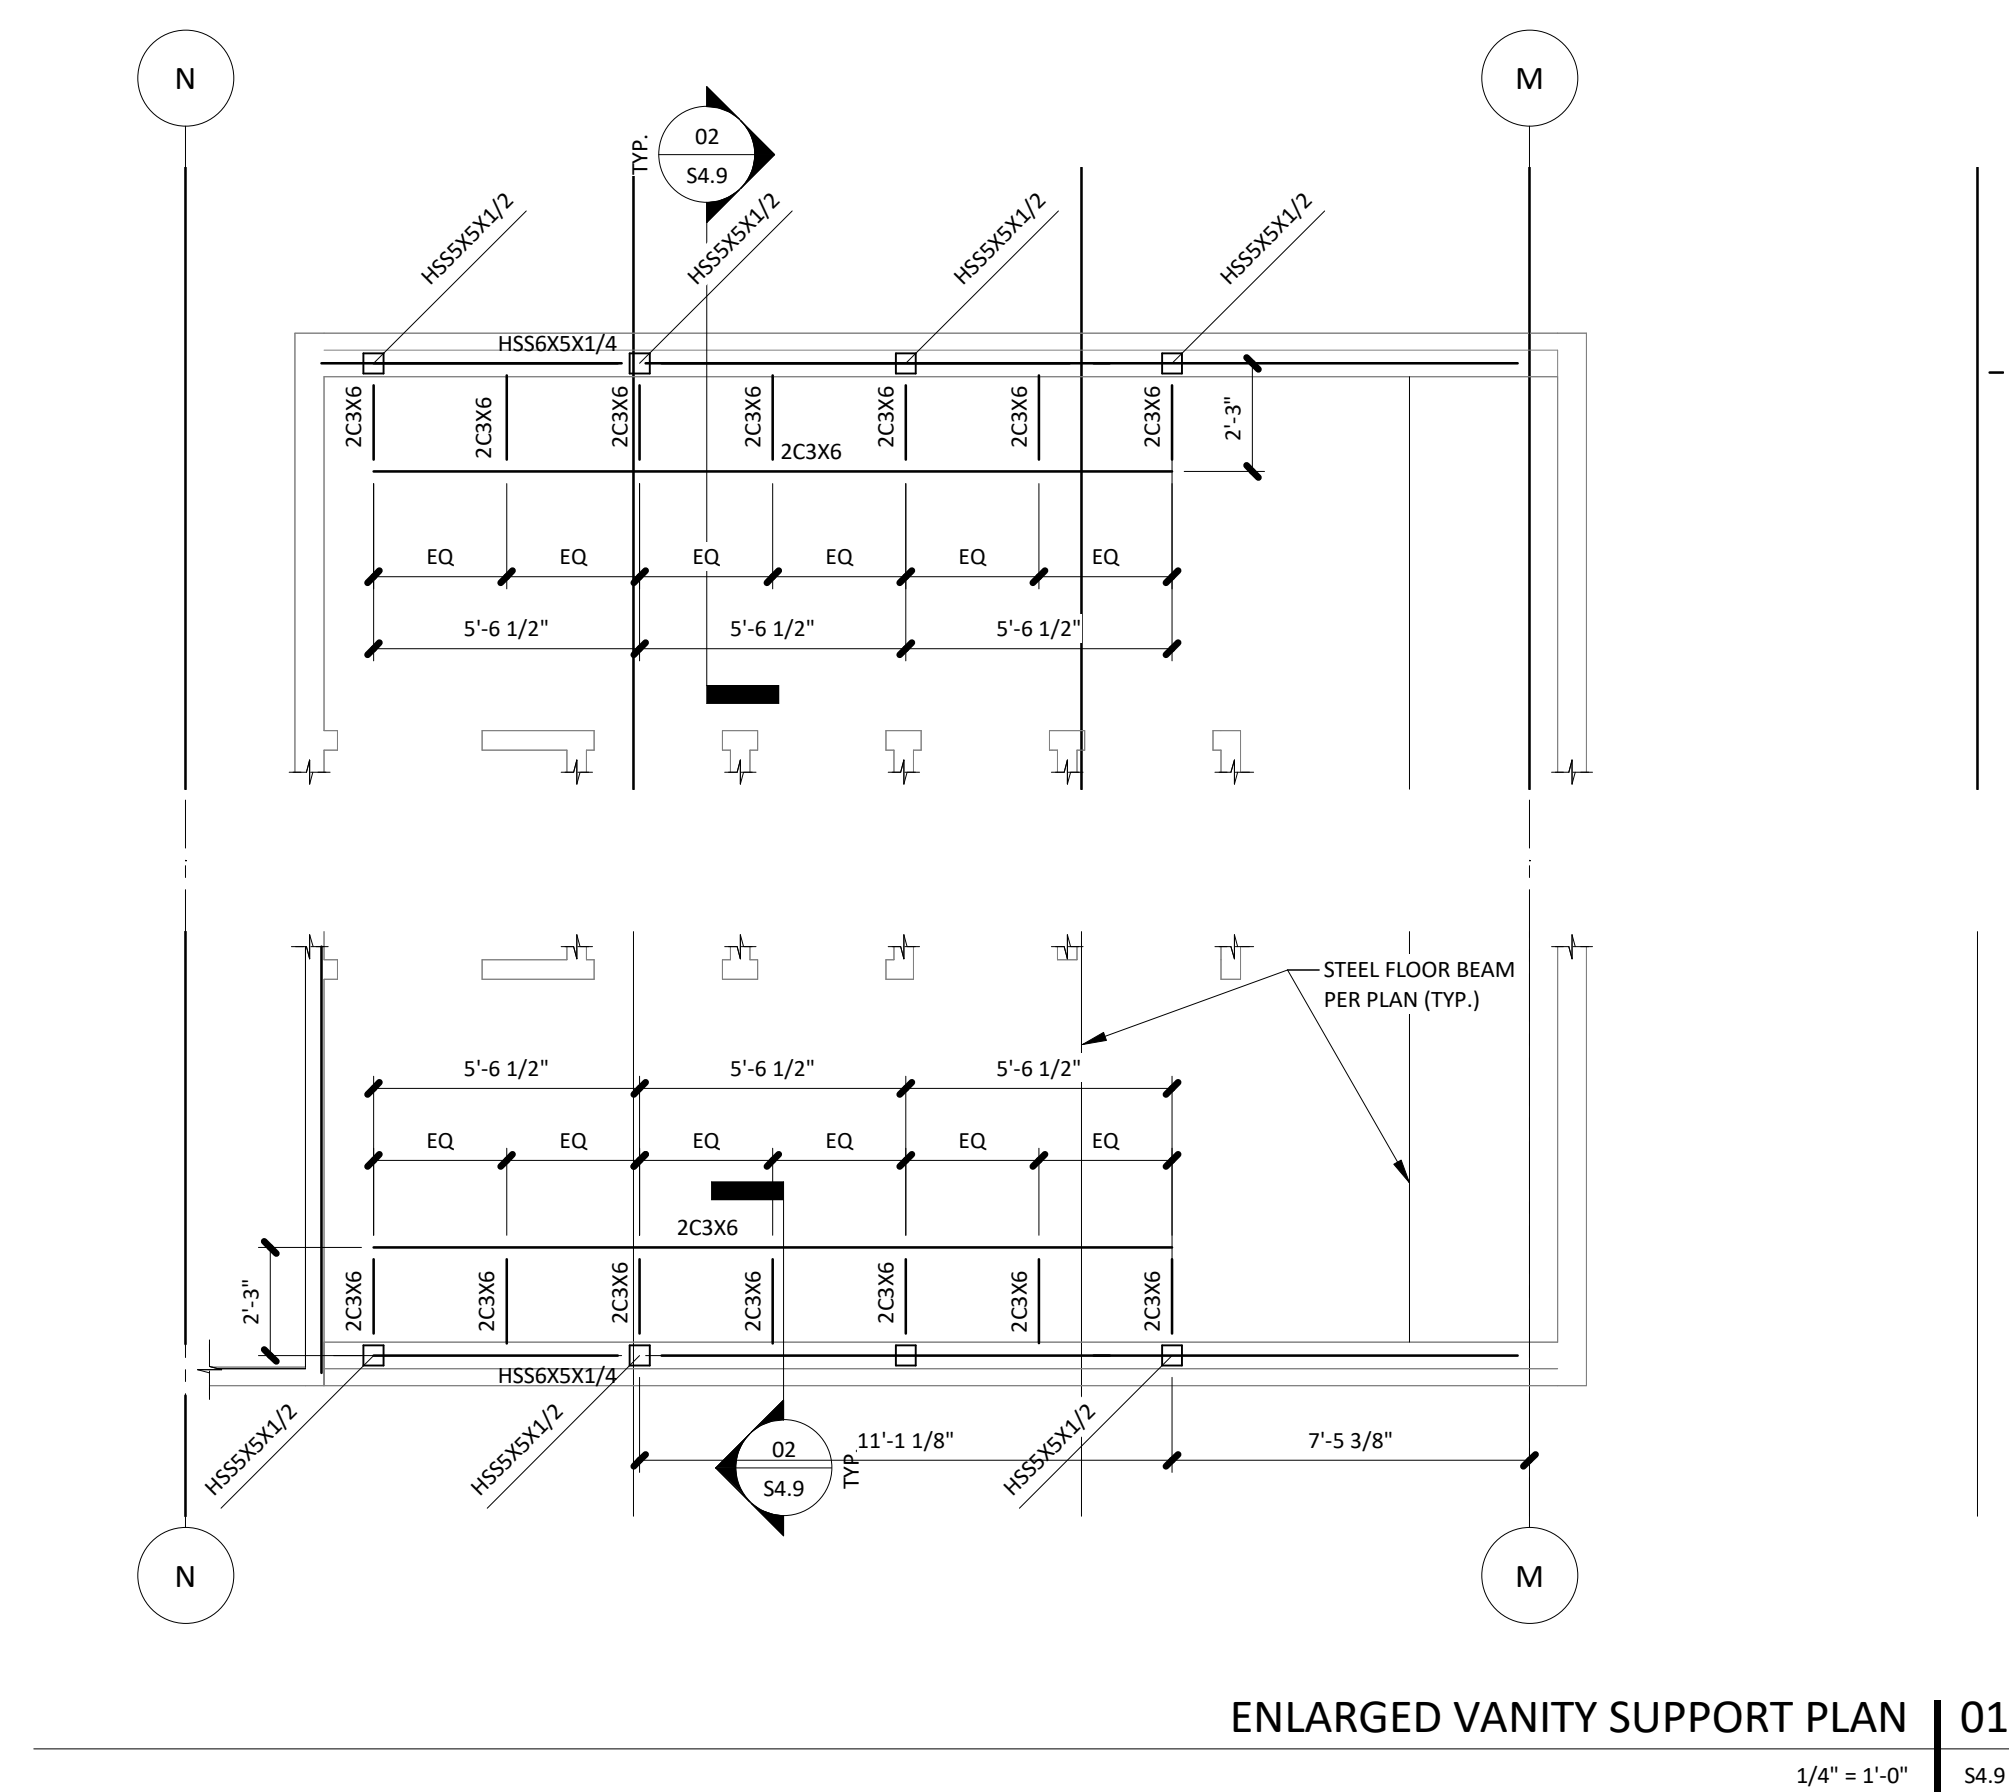

## SECTION 102



## SECTION 1.03