

HY-VEE INC.


5820 Westown Parkway West Des Moines, Iowa 50266



PROJECT LOCATION:

LEE'S SUMMIT, MO #2

310 SW WARD RD, LEE'S SUMMIT, MO 64081

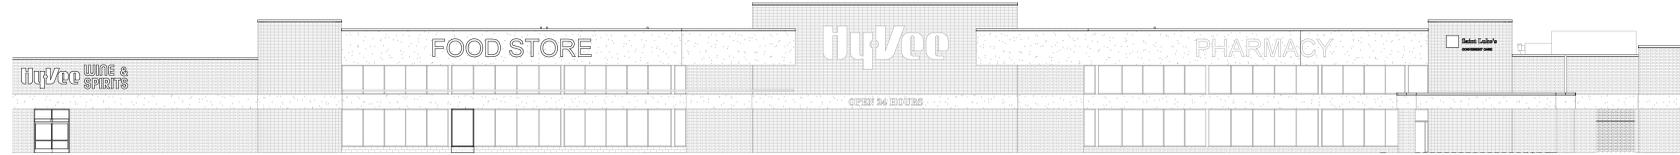

DRAWING SCHEDULE

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PD1.0A	UNDERFLOOR DEMOLITION PLUMBING PLAN - A
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E3.1	LIGHTING SCHEDULES AND DETAILS
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ED1.0B	ELECTRICAL DEMOLITION PLAN - PART B
ED2.0	ELECTRICAL DEMOLITION ROOF PLAN
PE1.1	ELECTRICAL STUB-UP PLAN
E6.1	CONTROL WIRE PULLS

1	REMOVE SHEETS XE4.0 AND XE4.0A FROM THE DRAWING SCHEDULE IN THEIR ENTIRETY.	1	ASI #1 - 11/12/20	
	E7.1	CONTROL WIRE PULLS	2	ASI #2 - 01/08/21
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7	TECHNOLOGY		6	ASI #7 - 04/16/21
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	R3.1	REFRIGERATION STRUCTURAL COORDINATION		
	R4.0	REFRIGERATION LEGEND AND LINE SIZING SCHEMATIC		
	R4.1	REFRIGERATION LEGEND AND LINE SIZING SCHEMATIC		
	R4.2	REFRIGERATION LEGEND AND LINE SIZING SCHEMATIC		
	R4.3	REFRIGERATION LEGEND AND LINE SIZING SCHEMATIC		
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	R5.1	PIPING DETAILS		

DEMOLITION REQUIREMENTS

- ALL WORK SHALL BE DONE IN A SAFE AND WORKMAN-LIKE MANNER AND IN STRICT ACCORDANCE WITH THE LOCAL AND/OR STATE BUILDING CODES, NATIONAL ELECTRIC CODE (NEC), OSHA, AND ALL APPLICABLE CODES, REGULATIONS, ORDINANCES, AND AUTHORITIES HAVING JURISDICTION.
- EACH SUBCONTRACTOR IS RESPONSIBLE FOR HAVING A THOROUGH KNOWLEDGE OF ALL DRAWINGS AND SPECIFICATIONS IN THEIR RELATED FIELD. THE FAILURE TO ACQUAINT THEMSELVES WITH THIS KNOWLEDGE DOES NOT RELIEVE THEM OF ANY RESPONSIBILITY FOR PERFORMING WORK PROPERLY. NO ADDITIONAL COMPENSATION SHALL BE ALLOWED BECAUSE OF CONDITIONS THAT OCCUR DUE TO FAILURE TO FAMILIARIZE WORKERS WITH THIS KNOWLEDGE.
- THE EXISTING BUILDING SHALL BE PROTECTED FROM MOISTURE, DUST, AND DEBRIS. INSTALL DUST PARTITIONS OR DRAPES AS REQUIRED AND/OR AS DIRECTED BY THE TENANT'S CONSTRUCTION MANAGER.
- ANY DAMAGE TO PROPERTY (ADJACENT OR EXISTING), WHICH OCCURS DURING THE PROCESS OF CONSTRUCTION SHALL BE REPAIRED/REPLACED AT NO ADDITIONAL COST TO THE TENANT.
- NO FLAMMABLE MATERIALS OR LIQUIDS MAY BE STORED IN THE EXISTING BUILDING.
- THE CONTRACTOR SHALL MAINTAIN THE INTEGRITY OF THE EXISTING BUILDING AT ALL TIMES. THIS INCLUDES KEEPING THE BUILDING SECURE FROM PERSONS, ENVIRONMENTAL ELEMENTS, OR HAZARDS. THE CONTRACTOR SHALL BE RESPONSIBLE TO MAINTAIN THE INTEGRITY OF ALL EXISTING SECURITY SYSTEMS. THE CONTRACTOR SHALL OBTAIN PERMISSION FROM STORE MANAGER PRIOR TO THE MODIFICATION OF ANY EXISTING SECURITY SYSTEM FOR THE OPENING (DEMOLITION) OF ANY EXTERIOR WALL.
- REMOVE ANY EXISTING ITEMS, SERVICES, FINISHES OR SURFACES AS REQUIRED FOR THE INSTALLATION OF NEW CONSTRUCTION. PROVIDE FURRING FOR CONDUITS AND PIPING, SHOWN OR NOT, AND FINISH OUT FURRING TO MATCH ADJACENT EXISTING FINISHES.
- REPAIR, RE-ROUTE, AND EXTEND ALL SERVICES, PIPING, CONDUIT OF EXISTING ITEMS AND EQUIPMENT AS REQUIRED DURING THE CONSTRUCTION PROCESS FOR THE COMPLETE INSTALLATION AND OPERATIONS OF NEW EQUIPMENT. THIS INCLUDES ALL ITEMS SHOWN OR NOT SHOWN ON THE DRAWINGS. RESET EXISTING EQUIPMENT OR RELATED ITEMS AS REQUIRED FOR PROPER OPERATIONS.
- WHERE EXISTING FINISHES ARE TO REMAIN, CLEAN, REPAIR, PATCH, AND/OR REPAIR AS NECESSARY TO BLEND WITH ADJACENT SURFACES OR AS LINED OUT ON DRAWINGS. COORDINATE WITH THE TENANT'S CONSTRUCTION MANAGER.
- THE CONTRACTOR SHALL RESPOND TO ALL REQUIREMENTS OF THE ENGINEER/ARCHITECT FOR VERIFICATIONS, RESPONSES AND SUBMISSIONS.
- DURING ENTIRE CONSTRUCTION PERIOD, PROVIDE ONE UL LISTED 2A-20BC DRY CHEMICAL FIRE EXTINGUISHER, OR ONE STANDARD UL LISTED 2-1/2 GALLON WATER (E-10) AND ONE UL LISTED 10BC CARBON DIOXIDE FIRE EXTINGUISHER MOUNTED TOGETHER IN EACH 3000 SQ FT OF WORK AREA OR FRACTION THEREOF MINIMUM OF TWO AVAILABLE IN ALL CONSTRUCTION AREAS AT ALL TIMES.
- NOTES INDICATING DEMOLITION WORK ARE NOT CONFINED SOLELY TO THE DEMOLITION PLANS. THE GENERAL CONTRACTOR SHALL SCHEDULE OF THIS PROJECT. IT IS THE RESPONSIBILITY OF THE CONTRACTOR TO COORDINATE DELIVERY OF MATERIALS IN A TIMELY MANNER.
- ALL DEMOLITION BUILDINGS AND TENANT SPACES SHALL REMAIN IN SERVICE DURING DEMOLITION/CONSTRUCTION.
- MUD AND DEBRIS TRACKED ONTO OWNER PAVING OR CITY STREETS TO BE CLEANED IMMEDIATELY.
- IT IS IMPERATIVE THAT THE ROOF FRAMING AND ROOFING SYSTEM BE KEPT INTACT TO ELIMINATE POTENTIAL WATER DAMAGE OR MOISTURE INFILTRATION. THE CONTRACTOR SHALL KEEP THE BUILDING WATER-TIGHT AT ALL TIMES AND MAKE REPAIRS IMMEDIATELY SHOULD ANY DAMAGE OCCUR TO THE ROOFING SYSTEM.
- BUILDING COMPONENTS AFFECTED BY THE SCOPE OF WORK AND ALLOWED TO REMAIN SHALL BE SECURED TO PREVENT FALLING, LOOSENING, OR CREATING DAMAGE OF ANY KIND IN THE FUTURE.
- WHEN UTILITIES ARE REMOVED, CAP AND SEAL A MINIMUM OF 8" BELOW FINISH FLOOR OR A MINIMUM OF 6" ABOVE FINISH CEILING.
- REFER TO MEP DRAWINGS FOR ADDITIONAL ITEMS TO BE REMOVED.
- NOTES INDICATING DEMOLITION WORK ARE NOT CONFINED SOLELY TO THE DEMOLITION PLANS. THE GENERAL CONTRACTOR SHALL REVIEW ALL CONSTRUCTION DOCUMENTS, INCLUSIVE OF SCHEDULES AND SPECIFICATIONS, TO DETERMINE FULL EXTENT OF DEMOLITION WORK.
- IT IS THE CONTRACTOR'S RESPONSIBILITY TO PROVIDE ADEQUATE SHORING, BRACING AND SUPPORT SYSTEMS FOR EXISTING STRUCTURE AND TO KEEP THE EXISTING STRUCTURE INTACT AND IN A SAFE CONDITION DURING DEMOLITION AND NEW CONSTRUCTION. THE CONTRACTOR SHALL RETAIN A REGISTERED PROFESSIONAL ENGINEER TO DESIGN THE SHORING OR BRACING AND SPECIFY DEMOLITION PROCEDURES. IT IS THE CONTRACTOR'S RESPONSIBILITY TO DETERMINE THE MEANS AND METHODS OF DEMOLITION AND NEW CONSTRUCTION.
- THE CONTRACTOR SHALL FIELD VERIFY THE EXTENT OF DEMOLITION. THE WORK INCLUDES, BUT IS NOT LIMITED TO, THE DEMOLITION AND REMOVAL OF WALLS, DOORS, FIXTURES, PLUMBING, MECHANICAL AND ELECTRICAL ITEMS INCLUDING CONDUITS AND DUCTWORK AS SHOWN ON DRAWING OR AS REQUIRED FOR THE INSTALLATION OF THE NEW WORK FOR A COMPLETE JOB.

GENERAL NOTES REGARDING MOLD AND MILDEW

- THE FOLLOWING REQUIREMENTS SHALL APPLY TO ALL NEW AND REMODEL CONSTRUCTION PROJECTS.
- IN THE EVENT THE CONTRACTOR DISCOVERS, AT ANY TIME DURING DEMOLITION, CONSTRUCTION AND/OR REMODELING OPERATIONS, EXISTING CONDITIONS THAT COULD INCLUDE THE PRESENCE OF MOLD AND/OR MILDEW, THE CONTRACTOR SHALL IMMEDIATELY NOTIFY THE TENANT'S REPRESENTATIVE AND THE PROFESSIONAL OF RECORD, IN WRITING, OF THE CONCERNS AND/OR SUSPICIONS.
- CONCURRENTLY, THE CONTRACTOR SHALL BE RESPONSIBLE TO RETAIN A MOLD AND MILDEW CERTIFIED TESTING AGENCY TO PERFORM AN INVESTIGATION AND TESTING AS REQUIRED TO EVALUATE THE NATURE AND EXTENT OF THE PROBLEM. IF THE TESTING AGENCY CONFIRMS HAZARDS, THE CONTRACTOR SHALL BE RESPONSIBLE TO OBTAIN A MINIMUM OF TWO (2) BIDS FROM COMPANIES QUALIFIED AND LICENSED TO PERFORM ALL NECESSARY REMEDIATION WORK, COMPLYING WITH ALL LOCAL, STATE AND FEDERAL ENVIRONMENTAL REGULATIONS, CODES, AND STATUTES.
- ONCE DISCOVERY OR SUSPICION OF MOLD AND/OR MILDEW IS MADE, THE CONTRACTOR SHALL TAKE ALL RESPONSIBLE MEASURES AND PRACTICE PRECAUTIONS TO PROTECT ALL CONSTRUCTION PERSONNEL AND THE PUBLIC FROM EXPOSURE TO MOLD AND/OR MILDEW, AND SUCH PRECAUTIONS SHALL REMAIN IN PLACE UNTIL SUCH A TIME AS THE OWNER OR HEALTH AUTHORITY DIRECTS OTHERWISE. CONSTRUCTION OPERATIONS SHALL NOT BE STOPPED OR CURTAILED, EXCEPT IN THE AREA OF MOLD/MILDEW CONCERN, DUE TO THESE REQUIRED PRECAUTIONS.
- THE CONTRACTOR SHALL MAKE ALL REASONABLE EFFORTS TO AVOID CONDITIONS FAVORABLE TO THE DEVELOPMENT OF MOLD AND MILDEW, ESPECIALLY IN VOIDS WHICH WILL BE CONCEALED AND NOT VENTILATED. IN ALL CASES, INTERIOR SPACES AND INTERIOR FINISHED CONSTRUCTION SHALL BE MAINTAINED IN DRY AND WELL-VENTILATED CONDITIONS.
- THE CONTRACTOR SHALL COMPLY WITH FEDERAL ENVIRONMENTAL AND OSHA REGULATIONS AND ALL LOCAL AND STATE HEALTH DEPARTMENT REQUIREMENTS AND RECOMMENDATIONS REGARDING MOLD AND MILDEW.
- ALL PENETRATIONS SHALL BE SEALED WATER-TIGHT TO PREVENT MOISTURE MIGRATION FROM ENTERING THE BUILDING OR WALL CAVITIES.
- INSURE THAT THERE ARE NO WATER LEAKS IN CONCEALED PLUMBING CHASES. ALL EXISTING SUPPLY AIR PATHS AND ALL EXISTING RETURN AIR PATHS AND PLENUMS SHALL BE KEPT DRY.
- DUCTWORK TO BE RE-USED SHALL BE CLEANED AND TREATED AS REQUIRED TO REMOVE POTENTIAL FOR MOLD AND MILDEW. ALL DAMP AREAS SHALL BE DRIED THOROUGHLY PRIOR TO ENCLOSURE.



SCOPE OF WORK

- NEW WINE AND SPIRITS DEPARTMENT IN ADJACENT STORAGE SPACE
- NEW OFFICES AND EMPLOYEE LOUNGE IN ADJACENT STORAGE SPACE
- REMOVE MARKET GRILLE RESTAURANT AND ADD CASUAL SEATING AREA
- ADD STARBUCKS KIOSK
- ADD SUSHI ISLAND
- REMODEL AT KITCHEN AND PREP AREAS
- ADD DELICATESSEN DEPARTMENT
- NEW PRODUCE PREP AND PRODUCE COOLER
- ADD CUSTOMER REACH IN DOORS TO DAIRY COOLER
- RESET CENTER STORE FIXTURES
- NEW PHARMACY AND CLINIC
- NEW FLORAL DEPARTMENT
- NEW CUSTOMER SERVICE & AISLES ONLINE GROCERY PICK UP AREA AT FRONT OF STORE

SITE VERIFICATION NOTES

- THE ARCHITECT HAS MADE A SCOPE VISIT WITH MEASUREMENTS AND PHOTOGRAPHS OF EXISTING CONDITIONS AND THE ARCHITECTURAL DRAWINGS INDICATE EXISTING CONDITIONS VERIFIED IN THE FIELD. IT, HOWEVER, REMAINS THE RESPONSIBILITY OF THE CONTRACTOR TO VERIFY ALL EXISTING CONDITIONS PRIOR TO THE SUBMISSION OF THEIR BID AND TO THE COMMENCEMENT OF ANY WORK. NO ADDITIONAL COMPENSATION WILL BE PAID DUE TO THE CONTRACTOR'S FAILURE TO ACQUAINT THEMSELVES WITH EXISTING SITE CONDITIONS WHICH INCLUDE, BUT ARE NOT LIMITED TO, GRADES, EXTENT OF PAVING, OR UTILITIES.
- THE CONTRACTOR SHALL FIELD LOCATE AND VERIFY ALL PROPERTY LINES, EASEMENTS, SETBACKS AND RESTRICTIONS. A REGISTERED SURVEYOR SHALL ESTABLISH ALL PROPERTY LINES AND SETBACKS PRIOR TO COMMENCEMENT OF CONSTRUCTION AND CLEARLY FLAG PROPERTY LINES AND SETBACKS. IT REMAINS THE RESPONSIBILITY OF THE GENERAL CONTRACTOR TO DETERMINE EXACT LOCATION OF ALL SAID BOUNDARIES.
- ALL UTILITY LOCATIONS SHOWN ARE APPROXIMATE. THE CONTRACTOR SHALL FIELD VERIFY THE EXACT LOCATION OF ALL EXISTING UTILITIES (WHETHER SHOWN OR NOT) PRIOR TO THE SUBMISSION OF THEIR BID OR THE COMMENCEMENT OF CONSTRUCTION. THE CONTRACTOR SHALL NOTIFY THE CONSTRUCTION MANAGER AND ARCHITECT OF THE DISCOVERY OF EXISTING UTILITIES NOT SHOWN OR NOTED ON DRAWINGS.
- THE CONTRACTOR SHALL VERIFY EXACT LOCATIONS AND DEPTHS OF UNDERGROUND UTILITY SERVICES PRIOR TO ANY EXCAVATION.
- THE CONTRACTOR SHALL VERIFY ALL GRADES AND PROPOSED FINAL GRADES, IF RAMPS, STOOPS, STAIRS, SIDEWALKS, FLATWORK OR PAVING ARE INSTALLED, VERIFY FINAL GRADES SURROUNDING THE NEW CONSTRUCTION AND ADJUST STAIR RISERS, RAMP LENGTHS, LIMITS OF PAVING, ETC., TO ACCOMMODATE THE REQUIRED RAMP SLOPE, RISER HEIGHTS OR PAVING AREAS. ALL RAMPS AND STAIRS SHALL MEET ADA-ADAGS (OR ADOPTED HANDICAP ACCESSIBILITY REQUIREMENTS). IF THERE IS CONFLICT IN FIELD CONDITIONS, NOTIFY THE CONSTRUCTION MANAGER AND THE ARCHITECT IMMEDIATELY TO CORRECT OR ORDERING OF MATERIALS.
- THE CONTRACTOR SHALL VERIFY THE EXISTING FINISH FLOOR ELEVATION AT ALL INTERIOR WALLS OF THE EXISTING BUILDING PRIOR TO ESTABLISHING THE FINISH FLOOR ELEVATION. TO VERIFY FLOOR ELEVATION, THE CONTRACTOR SHALL REMOVE A SMALL PORTION OF THE WALL AT THE PROPOSED OPENING BETWEEN THE INTERIOR WALLS.
- THE CONTRACTOR SHALL VERIFY EXISTING FOOTING DEPTHS AND MATCH AT NEW ADDITION TO INSURE PROPER BLOCK COURSEING. ANY DISCREPANCY SHALL BE REPORTED TO THE CONSTRUCTION MANAGER PRIOR TO CONSTRUCTION.
- FOR ANY ROOF WORK REQUIRED AS PART OF THESE DOCUMENTS, IT IS THE CONTRACTOR'S RESPONSIBILITY TO MATCH EXISTING ROOF INSULATION THICKNESS UNLESS DIRECTED OTHERWISE. REFER TO THE ROOFING SPECIFICATIONS SECTION.
- REPORT ANY DISCREPANCIES FOUND IN THE FIELD IMMEDIATELY TO THE CONSTRUCTION MANAGER AND THE ARCHITECT PRIOR TO MAKING ANY STRUCTURAL MODIFICATIONS OR ORDERING OF ANY MATERIALS.
- IF THERE IS A DISCREPANCY WITH THE EXISTING SITE CONDITIONS AND/OR THE DRAWINGS SHALL BE BROUGHT TO THE ATTENTION OF THE ARCHITECT FOR CLARIFICATION AND INSTRUCTION. THESE CONSTRUCTION DOCUMENTS HAVE BEEN DESIGNED AND DRAWN ASSUMING EXISTING BUILDING CONDITIONS MATCH THE ORIGINAL DRAWINGS. THE CONTRACTOR, IMMEDIATELY UPON ARRIVAL AT THE SITE, SHALL VERIFY ALL EXISTING STRUCTURAL COLUMN DIMENSIONS, STRUCTURAL BEARING HEIGHTS AND EXISTING DIMENSIONS. IF DISCREPANCIES ARE FOUND BETWEEN WHAT IS SHOWN ON THE DRAWINGS AND EXISTING FIELD CONDITIONS, CONTACT THE CONSTRUCTION MANAGER AND THE ARCHITECT IMMEDIATELY TO DETERMINE WHAT ACTION SHOULD BE TAKEN TO MATCH EXISTING CONDITIONS. THE BEGINNING OF CONSTRUCTION BY THE GENERAL CONTRACTOR MEANS ACCEPTANCE OF THE EXISTING CONDITIONS.

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STRUCTURAL ENGINEER
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MECHANICAL, ELECTRICAL, PLUMBING ENGINEER
HENDERSON ENGINEERS
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LENEXA, KS 66214
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FINAL CONSTRUCTION DOCUMENTS - 10/20/2020

CODE ANALYSIS

- 1) APPLICABLE CODES**
BUILDING CODE: 2018 INTERNATIONAL BUILDING CODE (IBC)
MECHANICAL CODE: 2018 INTERNATIONAL MECHANICAL CODE (IMC)
PLUMBING CODE: 2018 INTERNATIONAL PLUMBING CODE (IPC)
ELECTRIC CODE: 2017 NATIONAL ELECTRICAL CODE (NEC)
FIRE CODE: 2018 INTERNATIONAL FIRE CODE (IFC)
ACCESSIBILITY CODE: 2009 ICC A117.1
FUEL / GAS CODE: 2018 INTERNATIONAL FUEL GAS CODE

- 2) DEFERRED SUBMITTALS**
FIRE PROTECTION SYSTEM SHOP DRAWINGS
FIRE ALARM SYSTEM SHOP DRAWINGS

- 3) USE GROUP: M
 4) TYPE OF CONSTRUCTION: III-B - UNLIMITED
 5) THIS BUILDING IS EQUIPPED THROUGHOUT WITH AN AUTOMATIC SPRINKLER SYSTEM.
 6) MIXED OCCUPANTS

- A2 - BREAK ROOM AND FOOD TENANT - ACCESSORY USE
 B - OFFICE, CUSTOMER SERVICE, PHARMACY, BAR - ACCESSORY USE
 F-1 - FOOD PREP AREAS (DELI, BAKERY, MEAT, PRODUCE) - ACCESSORY USE
 M - RETAIL SALES - MIXED USE
 S1 - RECEIVING, STOCK/STORAGE ROOMS, COOLERS/FREEZERS - STORAGE AREAS (MIXED USE)



- 7) ALLOWABLE AREA:
 A) ALL ALLOWABLE TABULAR AREA - UNLIMITED
 B) ENTIRE BUILDING IS FULLY SPRINKLERED
 8) ACTUAL BUILDING AREA:
 A) EXISTING FOOTPRINT AREA (MAIN LEVEL) = 85,703 SF
 B) NO ADDED SQUARE FOOTAGE AS PART OF THIS REMODEL
 9) OCCUPANT LOAD: TABLE 1004.5

OCCUPANCY LOAD CALCULATIONS				
Name	Area	Occupancy Load	Occupants	
ASSEMBLY	3,289.16	15	218	
BUSINESS	2,318.24	150	16	
MERCANTILE	54,830.62	60	916	
PREP	6,033.35	200	31	
STORAGE	13,997.98	300	44	
Grand total	79,646.43		1,225	

- 10) EXITS REQUIREMENTS**
 A) (4) EXITS REQUIRED (SECTION 1006.3.2) - (7) PUBLIC & (1) EMPLOYEE PROVIDED
 B) 250' MAXIMUM TRAVEL (TABLE 1017.2)
 C) TOTAL OCCUPANT LOAD OF LIQUOR STORE = 202 OCCUPANTS
 D) TOTAL OCCUPANT EXIT OF LIQUOR STORE = 770 OCCUPANTS
 E) TOTAL OCCUPANT LOAD OF GROCERY PUBLIC SPACE = 916 OCCUPANTS
 F) TOTAL OCCUPANT EXIT OF GROCERY PUBLIC SPACE = 2,200 OCCUPANTS
 G) TOTAL EMPLOYEE OCCUPANT EXIT = 195 OCCUPANTS
 H) TOTAL OCCUPANT EXIT PROVIDED = 3,165 OCCUPANTS (3,165 > 1,225)
 I) TOTAL ACCESSIBLE EXITS (PER ADA): 2 REQUIRED & 5 PROVIDED

- 11) TRAVEL DISTANCE
 MAXIMUM TRAVEL DISTANCE: 250 FT

- 12) PLUMBING FIXTURE COUNTS**
PER TABLE 403.1 (IPC) AND CHAPTER 29 (IBC)
TOTAL BUILDING OCCUPANT LOAD: 1,225
LOAD DISTRIBUTION: 50% MALE, 50% FEMALE
DISTRIBUTION COUNT: 613 MALE & 613 FEMALE
LAVATORIES REQUIRED:
MALE LAVATORIES: 1 (6 PROVIDED)
FEMALE LAVATORIES: 1 (6 PROVIDED)
WATER CLOSETS REQUIRED:
MALE WATER CLOSETS: 2 (6 PROVIDED)
FEMALE WATER CLOSETS: 2 (6 PROVIDED)
UNISEX/FAMILY WATER CLOSETS: 0 (1 PROVIDED)
PER INTERNATIONAL PLUMBING CODE (IPC) TABLE 419.2
URINALS CAN BE SUBSTITUTED UP TO 50 PERCENT OF THE REQUIRED WATER CLOSETS
DRINKING FOUNTAINS:
 3 REQUIRED, 2 PROVIDED (HI-LOW) + WATER AT SEATING AREA

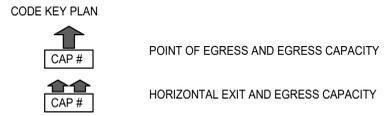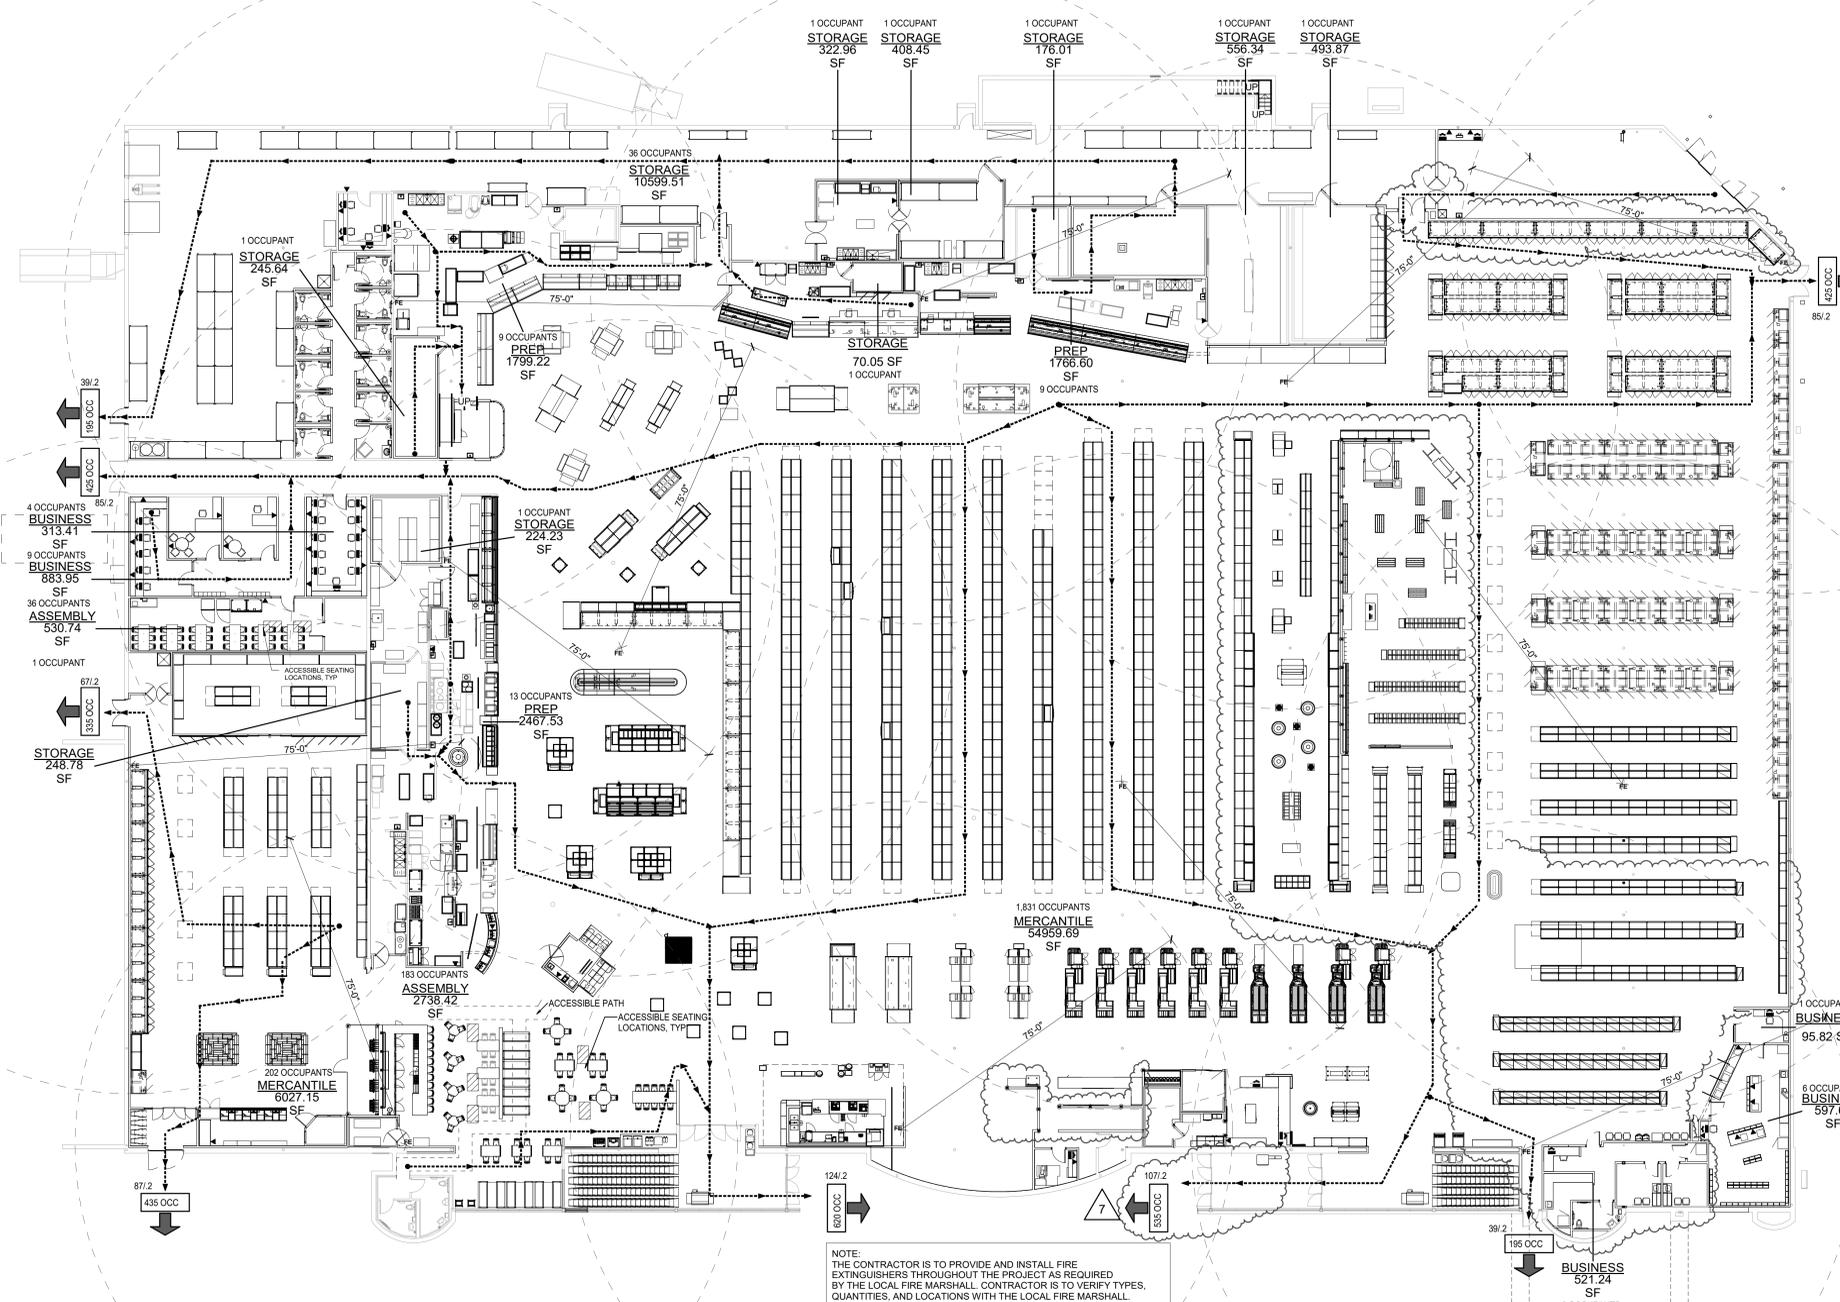

1 MAIN LEVEL CODE ANALYSIS PLAN
 SCALE: 1/16" = 1'-0"

NOTE:
 THE CONTRACTOR IS TO PROVIDE AND INSTALL FIRE EXTINGUISHERS THROUGHOUT THE PROJECT AS REQUIRED BY THE LOCAL FIRE MARSHALL. CONTRACTOR IS TO VERIFY TYPES, QUANTITIES, AND LOCATIONS WITH THE LOCAL FIRE MARSHALL.
 PROVIDE PORTABLE FIRE EXTINGUISHERS THROUGHOUT THE BUILDING AS REQUIRED BY THE APPLICABLE BUILDING AND FIRE CODES. SIZE AND LOCATE FIRE EXTINGUISHERS IN ACCORDANCE WITH NFPA 10. STANDARD FOR PORTABLE FIRE EXTINGUISHERS SHALL BE 20 LB. TYPE 2A, 10BC IN ALL AREAS EXCEPT WHERE LOCATED NEAR COMMERCIAL COOKING EQUIPMENT. FIRE EXTINGUISHERS NEAR COMMERCIAL COOKING EQUIPMENT SHALL BE TYPE K.
 LEGEND:
 FIRE EXTINGUISHER FE

REVISION		DATE BY
1	ADD	11/20/20
2	ADD	09/16/21

brr

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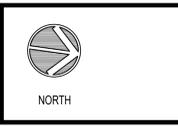
PROFESSIONAL SEAL
 RICHARD A. MAJORS, JR.
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 NUMBER 171341
 EXPIRES 12/31/2024

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HyVee
 EMPLOYEE OWNED



CODE ANALYSIS PLAN

PROJECT MANAGER	CHECKED BY
SB	JPS
DRAWN BY: AP	DATE: 3/19/2021
SCALE: As indicated	JOB NUMBER: 62930547

SHEET:
GO.0

GENERAL NOTES

- PROJECT SITE WORK SHALL BE IN ACCORDANCE WITH THE PROJECT SPECIFICATIONS, CITY OF LEE'S SUMMIT BUILDING CODE AND APPLICABLE LOCAL, STATE AND FEDERAL REQUIREMENTS.
- ALL WORK WITHIN CITY OF LEE'S SUMMIT RIGHT OF WAY SHALL BE COMPLETED IN ACCORDANCE WITH CITY OF LEE'S SUMMIT RIGHT OF WAY CONSTRUCTION MANAGEMENT REQUIREMENTS. CONTRACTOR SHALL OBTAIN RIGHT OF WAY CONSTRUCTION PERMIT AND ADHERE TO STANDARDS AND REQUIREMENTS OF PERMIT.
- CONTRACTOR IS REQUIRED TO OBTAIN NECESSARY PERMITS FOR PROPOSED SITE WORK.
- THE EXISTENCE AND LOCATION OF UNDERGROUND UTILITY PIPES AND STRUCTURES SHOWN ON THESE PLANS WERE OBTAINED BY A SEARCH OF AVAILABLE RECORDS AND VISIBLE FEATURES AT THE PROJECT SITE. UNKNOWN UTILITIES OR STRUCTURES COULD BE ENCOUNTERED AT PROJECT SITE. THE CONTRACTOR SHALL TAKE PRECAUTIONARY MEASURES TO PROTECT ANY EXISTING UTILITIES OR STRUCTURES LOCATED AT THE WORK SITE. EXISTING UTILITY LINES, EITHER OVERHEAD OR UNDERGROUND, AND PERMANENT STRUCTURE WITHIN THE PROPERTY LINES SHALL BE KEPT FREE OF DAMAGE BY CONTRACTOR'S OPERATIONS. IF SUCH UTILITY OR STRUCTURE IS DAMAGED, IT SHALL BE RESTORED AT THE CONTRACTOR'S EXPENSE.
- IN ACCORDANCE WITH STATE LAW, CONTRACTOR SHALL NOTIFY NEBRASKA ONE CALL (NE 811) IN ADVANCE OF ANY SITE EXCAVATION OPERATIONS TO ALLOW UTILITY OPERATORS TO IDENTIFY AND LOCATE UNDERGROUND FACILITIES.
- BEFORE EXCAVATING FOR THIS CONTRACT, THE CONTRACTOR SHALL FIELD VERIFY LOCATION AND ELEVATION OF UNDERGROUND UTILITIES AHEAD OF CONSTRUCTION. EXISTING UTILITY ELEVATION DISCREPANCIES SHALL BE REPORTED TO ENGINEER TO PERMIT REVISIONS TO DESIGN PLAN ELEVATIONS IF REQUIRED.
- ANY ON-SITE FUELING WILL COMPLY WITH LOCAL, STATE, AND FEDERAL REQUIREMENTS.
- THE CONTRACTOR SHALL REPAIR OR REPLACE ALL EROSION CONTROL MEASURES DAMAGED BY CONSTRUCTION ACTIVITIES.
- CONTRACTOR IS RESPONSIBLE FOR ALL TRAFFIC CONTROL & SAFETY MEASURES. WHERE REQUIRED IN CITY OF LEE'S SUMMIT RIGHT OF WAY TO FACILITATE UTILITY OR PAVEMENT INSTALLATION, TRAFFIC CONTROL SHALL BE PROVIDED IN ACCORDANCE WITH LEE'S SUMMIT TRAFFIC CONTROL GUIDELINES.
- CONTRACTOR SHALL NOTIFY THE UTILITY PROVIDER TO COORDINATE AND SCHEDULE PROPOSED UTILITY SERVICE CONNECTIONS.
- CONTRACTOR SHALL BE RESPONSIBLE FOR EROSION AND DUST CONTROL, IN ACCORDANCE WITH THE CONSTRUCTION STORMWATER DISCHARGE PERMIT (CSW) FOR THE PROJECT SITE. SEDIMENT AND VEHICLE TRACK OUT FROM FACILITY SHALL BE PROMPTLY CLEANED BY CONTRACTOR. ANY DAMAGE FROM BLOWING DUST OR EROSION AND RUNOFF FROM THE SITE SHALL BE REPAIRED BY THE CONTRACTOR AT NO ADDITIONAL COST TO THE OWNER.
- THE CONTRACTOR IS RESPONSIBLE FOR PROTECTION OF ALL SURVEYED PROPERTY CORNERS.

GENERAL GRADING NOTES

- CONTRACTOR SHALL VERIFY THAT CONSTRUCTION STORMWATER DISCHARGE PERMIT, NPDES CSW-NOI, HAS BEEN SUBMITTED AND APPROVED PRIOR TO LAND DISTURBANCE ACTIVITIES. THE CONTRACTOR IS RESPONSIBLE FOR OBTAINING ALL NECESSARY PERMITS AND INSPECTIONS PRIOR TO COMMENCING CONSTRUCTION.
- CONTRACTOR SHALL INSTALL EROSION AND SEDIMENT CONTROL MEASURES WHERE INDICATED ON EROSION AND SEDIMENT CONTROL PLANS.
- ALL HERBACEOUS VEGETATION AND TOPSOIL SHALL BE REMOVED FROM WITHIN THE LIMITS OF GRADING PRIOR TO PLACEMENT OF FILL MATERIAL. REFERENCE GEOTECHNICAL REPORT FOR ANTICIPATED DEPTH OF TOPSOIL ON THE PROJECT SITE.
- SITE EARTHWORK ACTIVITIES INCLUDING: PLACEMENT OF STRUCTURAL FILL, BUILDING PAD PREPARATION, PAVEMENT SUBGRADE PREPARATION, UTILITY EXCAVATION, COMPACTION, MOISTURE CONDITIONING, ETC. AND OTHER REMEDIAL SOIL MEASURES SHALL BE IN ACCORDANCE WITH THE PROJECT REPORT OF GEOTECHNICAL EXPLORATION (IF AVAILABLE). REFER TO GRADING PROCEDURE NOTES.
- THE PROPOSED CONTOURS AND SPOT ELEVATIONS REPRESENT TOP OF SLAB, TOP OF CURB, OR BUILDING FLOOR ELEVATIONS. IN GREENSPACE AREAS, THEY REPRESENT THE FINISHED GROUND SURFACE. THE GRADING CONTRACTOR SHALL REVIEW TYPICAL SECTIONS FOR: BUILDING FLOOR SLABS, PAVEMENTS AND LANDSCAPE AREAS TO VERIFY FINAL SUBGRADE ELEVATIONS IN THOSE AREAS.
- ALL LINES SHOWN REPRESENTING PAVEMENT ARE TO BACK OF CURB OR EDGE OF PAVEMENT, UNLESS OTHERWISE NOTED.
- CONTRACTOR WILL BE HELD RESPONSIBLE FOR SETTLEMENT DUE TO IMPROPER COMPACTION.
- THE CONTRACTOR IS RESPONSIBLE FOR PROTECTION OF ALL PROPERTY CORNERS. PROPOSED GRADING SHALL NOT EXTEND BEYOND LIMITS OF PROPERTY LINES OR PROJECT LIMITS INDICATED ON GRADING PLANS. THE CONTRACTOR SHALL NOTIFY THE SITE INSPECTOR, OWNER OR ENGINEER IMMEDIATELY IF ANY GRADING WILL TAKE PLACE BEYOND THE PROPERTY LINE.
- SUFFICIENT TOPSOIL SHOULD BE SALVAGED AND STOCKPILED BY THE CONTRACTOR FOR RE-SPREADING IN PERMANENT PLANTING AREAS, INCLUDING PARKING LOT ISLANDS AND GREEN SPACES. STOCKPILING AND RE-SPREADING OF TOPSOIL IS NOT A SEPARATE BID ITEM, BUT SHALL BE CONSIDERED SUBSIDIARY TO THE SITE GRADING.
- UNLESS OTHERWISE INDICATED, TOPSOIL SALVAGED AS PART OF THE EXCAVATION SHALL BE PLACED TO A MINIMUM DEPTH OF 6 INCHES OVER ALL PERMANENT GREENSPACE AREAS. LARGE STONES, STICKS AND LUMPS SHALL BE REMOVED OR BROKEN UP, AND THE TOPSOIL SHALL BE LEVELED AND RAKED TO MATCH ADJACENT GRADES, READY FOR SEEDING. ANY ROCK OR SAND FROM PAVING ACTIVITIES SHALL BE REMOVED PRIOR TO PLACEMENT OF TOPSOIL. ALL EXCESS SOILS, NOT RE-SPREAD WITHIN THE PROJECT LIMITS, SHALL BE REMOVED BY THE CONTRACTOR.
- IF THERE ARE TREES ON THIS SITE THAT DO NOT SHOW UP ON THE PLANS, THE CONTRACTOR SHALL COORDINATE WITH OWNER'S REPRESENTATIVE OR ENGINEER FOR REMOVAL OR RELOCATION, IF REQUIRED.
- THE CONTRACTOR SHALL FINISH GRADE SLOPES AS SHOWN NO STEEPER THAN ONE FOOT VERTICAL IN 4 FEET HORIZONTAL.
- CONTRACTOR SHALL GRADE ALL GREENSPACE AND LANDSCAPE AREAS TO PROVIDE POSITIVE DRAINAGE AWAY FROM BUILDING PADS AND SIDEWALKS AFTER LANDSCAPE MATERIALS ARE IN PLACE. TYPICAL SLOPE AWAY FROM BUILDING SHALL BE 2% UNLESS OTHERWISE INDICATED.
- AT THE COMPLETION OF GRADING, THE CONTRACTOR SHALL REMOVE ANY EXCESS EXCAVATION FROM THE SITE.
- CONTRACTOR IS RESPONSIBLE FOR ALL TRAFFIC CONTROL NECESSARY FOR PROPOSED LAND DISTURBANCE ACTIVITIES.
- ALL EXCAVATIONS AND TRENCHES SHALL BE SLOPED/SHORED/BRACED FOR PROTECTION OF PERSONNEL IN ACCORDANCE WITH FEDERAL, STATE AND LOCAL REGULATIONS. CONTRACTOR IS RESPONSIBLE FOR SITE SAFETY AND IMPLEMENTING/INSTALLING SAFETY MEASURES AS REQUIRED TO PROTECT SITE WORKERS AND THE SAFETY OF THE PUBLIC. OPEN EXCAVATIONS SHALL BE PROTECTED AND/OR FENCED AS NECESSARY.

GRADING PROCEDURE NOTES

- ALL HERBACEOUS VEGETATION AND TOPSOIL SHALL BE REMOVED FROM WITHIN THE LIMITS OF GRADING PRIOR TO PLACEMENT OF STRUCTURAL FILL MATERIAL.
- THE TOP TWELVE (12) INCHES OF THE EXISTING SUBGRADE TO BE SCARIFIED AND RECOMPACTED BEFORE THE PLACEMENT OF ANY FILL.
- STRUCTURAL FILL AND BACKFILL USED ON THIS SITE SHALL CONSIST OF APPROVED MATERIALS FREE OF INORGANIC MATTER AND DEBRIS. SOILS MUST BE LOW-PLASTICITY, COHESIVE MATERIAL WITH A LIQUID LIMIT LESS THAN 45 AND PLASTICITY INDEX LESS THAN 25.
- ALL FLOOR SLABS SHALL BEAR ON A MINIMUM OF 18 INCHES OF CONTROLLED FILL.
- PROPOSED FILL SOILS MUST BE TESTED AND APPROVED PRIOR TO PLACEMENT USING AT A MINIMUM A STANDARD PROCTOR TEST (ASTM D698) AND AN ATTEBERG LIMITS TEST FOR EACH SOIL TYPE OR SOURCE CONSIDERED.
- FILL AND BACKFILL PLACED IN AND AROUND THE BUILDING AREAS MUST BE COMPACTED TO AT LEAST 98% OF THE MATERIALS STANDARD PROCTOR. FILL PLACED BELOW THE BASE OF THE PAVEMENT SOIL SUBGRADE MUST BE COMPACTED TO AT LEAST 95% OF THE MATERIALS STANDARD PROCTOR. FILL PLACED WITHIN THE UPPER 12 INCHES OF PAVEMENT AND BUILDING SUBGRADES SHALL BE COMPACTED TO AT LEAST 98% STANDARD PROCTOR.
- UNLESS OTHERWISE INDICATED, ALL EXCESS UTILITY, PAVING AND FOUNDATION SPOIL MATERIAL SHALL BE REMOVED FROM SITE.
- ROUGH GRADING TOLERANCES: BUILDING PAD: -0.0' TO +0.1'; PAVED AREAS -0.1' TO +0.1'; ALL OTHER AREAS: -0.2' TO +0.2'. FINAL BUILDING PAD GRADING AND PAVEMENT GRADING SHALL MATCH THE PROPOSED TYPICAL SECTIONS OF BUILDING SLAB AND PAVEMENT THICKNESS.
- ANY GEOTECHNICAL/TESTING REPORTS SOLICITED BY THE CONTRACTOR SHALL BE SUBMITTED TO THE OWNER AND THE ENGINEER.
- ONCE STRIPPING AND REMOVAL OPERATIONS ARE COMPLETE, THE CONTRACTOR SHALL PROOFROLL THE AREAS TO RECEIVE STRUCTURAL FILL.

GENERAL UTILITY NOTES

- THE CONTRACTOR SHALL BE RESPONSIBLE TO MAINTAIN UTILITY CLEARANCES BETWEEN SITE UTILITIES FOR ALL PROPOSED SITE UTILITY LINES.
- ALL TRENCHES SHALL BE BACKFILLED AND COMPACTED TO A MINIMUM OF 98% (ASTM D698).
- THE CONTRACTOR SHALL RESTORE ANY DISTURBED AREAS TO ITS PREVIOUS CONDITION.
- THE CONTRACTOR SHALL VERIFY ALL VERTICAL AND HORIZONTAL CROSSINGS OF ALL PROPOSED AND EXISTING UTILITIES PRIOR TO INSTALLATION OF UTILITIES. NOTIFY THE ENGINEER IN CASE OF ANY CONFLICTS.
- ALL CONDUIT STUBS SHALL BE CAPPED AND MARKED ABOVE GROUND WITH REBAR AND A FLAG.

PRIVATE STORM SERVICE NOTES

- ALL STORM SEWER CONSTRUCTION SHALL COMPLY WITH APPLICABLE CITY OF LEE'S SUMMIT BUILDING AND PLUMBING CODES. THE CONTRACTOR IS RESPONSIBLE FOR OBTAINING ALL NECESSARY PERMITS FOR PROPOSED STORM SEWER CONSTRUCTION.
- WHERE REQUIRED TO FACILITATE UTILITY INSTALLATION, TRAFFIC CONTROL SHALL BE PROVIDED IN ACCORDANCE WITH LEE'S SUMMIT TRAFFIC CONTROL GUIDELINES.
- ALL STORM SEWER PIPING AND FITTINGS SHALL COMPLY WITH CITY OF LEE'S SUMMIT PLUMBING CODE.
- STORM SEWER PIPING MATERIALS SHALL BE IN ACCORDANCE WITH PROJECT TECHNICAL SPECIFICATIONS. IF TECHNICAL SPECIFICATIONS ARE NOT INCLUDED IN CONSTRUCTION DOCUMENTS, CONTRACTOR SHALL PROVIDE:
 - REINFORCED CONCRETE PIPE (RCP) CLASS III
 - HOPE DUAL WALL (ASTM F2645), ADVANCED DRAINAGE SYSTEM (ADS) TYPE N-12 OR APPROVED EQUAL.
- STORM SEWER STRUCTURES MATERIALS SHALL BE IN ACCORDANCE WITH PROJECT TECHNICAL SPECIFICATIONS OR CONSTRUCTION DETAILS. IF TECHNICAL SPECIFICATIONS ARE NOT INCLUDED IN CONSTRUCTION DOCUMENTS, CONTRACTOR SHALL PROVIDE:
 - DRAINAGE BASINS, CURB INLETS AND INLINE DRAINS SHALL BE (ADS), NYLOPLAST OR APPROVED EQUAL.
- FOR PURPOSES OF CLARITY, NOT ALL FITTINGS FOR STORM SEWER PIPING ARE SHOWN. CONTRACTOR SHALL PROVIDE FITTINGS AS NECESSARY TO COMPLETE CONNECTIONS AS SHOWN ON THESE DRAWINGS.
- PRIOR TO INSTALLATION, THE CONTRACTOR SHALL VERIFY THE LOCATION AND ELEVATION OF THE EXISTING STORM SEWER ELEVATION. CONTRACTOR SHALL NOTIFY ENGINEER OF ANY ELEVATION DISCREPANCIES PRIOR TO PLACEMENT OF CONCRETE PAVEMENT.
- CONTRACTOR SHALL MAINTAIN STORM SEWER SERVICE OF THE EXISTING STORM PIPING DURING CONSTRUCTION OF NEW STORM SEWER.

PRIVATE PAVING NOTES (SITE CONSTRUCTION)

- PAVEMENT SUBGRADE SHALL BE PREPARED IN ACCORDANCE WITH THE PROJECT TECHNICAL SPECIFICATIONS, OR THE CONSTRUCTION DETAILS AS SHOWN ON THESE PLANS. IN CASES WHERE THE SPECIFICATIONS OR DETAILS DIFFER, THE MORE STRINGENT REQUIREMENT SHALL APPLY.
- THE CONTRACTOR SHALL COORDINATE SUBGRADE DENSITY TESTING AND CONCRETE TESTING WITH OWNER'S TESTING AGENCY PRIOR TO INSTALLATION OF CONCRETE PAVEMENT.
- CONCRETE MIX DESIGN SHALL BE IN ACCORDANCE WITH PROJECT TECHNICAL SPECIFICATIONS. IF TECHNICAL SPECIFICATIONS ARE NOT INCLUDED IN CONSTRUCTION DOCUMENTS, CONTRACTOR SHALL PROVIDE ENGINEER APPROVED EQUAL.
- THE CONTRACTOR SHALL VERIFY THE LOCATION AND ELEVATION OF THE EXISTING PAVEMENT. CONTRACTOR SHALL NOTIFY ENGINEER OF ANY ELEVATION DISCREPANCIES PRIOR TO PLACEMENT OF CONCRETE PAVEMENT.
- CONTRACTOR SHALL OBTAIN ALL NECESSARY PERMITS AND INSPECTIONS PRIOR TO PAVEMENT CONSTRUCTION INCLUDING: CURB CUT PERMIT, SIDEWALK PERMIT OR OTHER PERMITS AS REQUIRED BY LOCAL JURISDICTION.
- CONCRETE PAVEMENT SHALL BE INSTALLED IN ACCORDANCE WITH PROJECT TECHNICAL SPECIFICATIONS. IF TECHNICAL SPECIFICATIONS ARE NOT INCLUDED IN CONSTRUCTION DOCUMENTS, CONCRETE PAVEMENT SHALL BE INSTALLED TO MEET THE INDUSTRY STANDARDS AS DESCRIBED IN ACI 330R-08. IN CASES WHERE THE CONSTRUCTION PLANS OR DETAILS DIFFER FROM ACI330R-08, THE MORE STRINGENT REQUIREMENT SHALL APPLY.
- ALL CONCRETE SHALL BE PLACED IN ACCORDANCE WITH ACI 305 & 206 'HOT WEATHER' & 'COLD WEATHER' CONCRETING. THE CONTRACTOR SHALL PROVIDE ALL NECESSARY BLANKETS, EXTERNAL HEAT, OR OTHER METHODS AS REQUIRED TO ENSURE CONCRETE PLACEMENT AND TEMPERATURE ARE MAINTAINED WITHIN SPECIFIED REQUIREMENTS. CONCRETE SHALL BE MAINTAINED AT A MINIMUM TEMPERATURE OF 50° FOR THREE DAYS AFTER THE COMPLETION OF PLACEMENT.
- PAVEMENT JOINTS SHALL BE INSTALLED IN ACCORDANCE WITH THE DETAILS SHOWN ON THESE PLANS. MAXIMUM SPACING FOR SAWED TRANSVERSE CONSTRUCTION JOINTS FOR CONCRETE PAVEMENT SHALL BE 10'. SLABS SHALL BE KEPT AS SQUARE AS POSSIBLE. TRANSVERSE JOINT SPACING SHALL NOT EXCEED 125% OF THE LONGITUDINAL JOINT SPACING. SAWED JOINTS SHALL BE A MINIMUM DEPTH OF 1/4 OF THE PAVEMENT THICKNESS.
- ALL PAVEMENT JOINTS SHALL BE SEALED WITH SELF-LEVELING POLYURETHANE SEALANT WITH COLOR MATCHING THE CONCRETE PAVEMENT.
- A 1/2" CLOSED CELL EXPANSION JOINT SHALL BE PROVIDED BETWEEN CONCRETE PAVEMENT AND FIXED STRUCTURAL OBJECTS (MANHOLES, WALLS, LIGHT POLES, ETC.), AND BETWEEN PAVEMENT CURBS AND SIDEWALKS.
- MAXIMUM JOINT SPACING ON CONCRETE SIDEWALKS SHALL BE 5', UNLESS OTHERWISE SHOWN ON PAVEMENT JOINTING PLAN.
- CONCRETE SIDEWALK SHALL BE INSTALLED IN ACCORDANCE WITH THE CONSTRUCTION DETAILS AS SHOWN ON THESE PLANS. THE MAXIMUM CROSS SLOPE ON ALL SIDEWALKS SHALL BE 2.0%. THE MAXIMUM RUNNING SLOPE ON ALL SIDEWALKS (EXCLUDING CURB RAMPS) SHALL BE 5.0%. SIDEWALK SHALL BE MINIMUM OF 4" CONCRETE, UNLESS OTHERWISE SHOWN.
- PROVIDE OPENINGS IN PAVEMENT CURB FOR ACCESSIBLE CURB RAMPS WHERE SHOWN ON THE PLANS.
- THE PAVING CONTRACTOR SHALL ADJUST ALL MANHOLES, VALVES, INLETS, AND CLEAN-OUTS TO GRADE. THE PAVING CONTRACTOR IS RESPONSIBLE FOR SETTING INLET TOPS. THE PAVING CONTRACTOR SHALL PLACE TRAFFIC RATED CAPS ON ALL CLEAN-OUTS WITHIN PAVED AREAS.
- CONTRACTOR SHALL STRIPE ALL PARKING LOTS AS SHOWN. PARKING STALL STRIPPING SHALL BE 4" WHITE MARKINGS, UNLESS OTHERWISE SHOWN.
- ALL DIMENSIONS ARE TO BACK OF CURB UNLESS OTHERWISE NOTED.
- ALL COORDINATE POINTS ARE TO BACK OF CURB UNLESS SPECIFIED OTHERWISE.
- PAVEMENT CURBS SHALL BE PROMPTLY BACKFILLED FOLLOWING PAVEMENT OPERATIONS. ALL ISLANDS SHALL BE BACKFILLED WITH TOPSOIL PRIOR TO LANDSCAPING.

REVISION	DATE BY

olsson

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 7301 W 133rd Street, Suite 200
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TEL: 913.318.1170
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LOCATION: LEE'S SUMMIT, MISSOURI 2
 AISLES ONLINE

HyVee
 EMPLOYEE OWNED

HY-VEE INC.
 5820 WESTOWN PARKWAY
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 TELEPHONE: (515) 267-2800
 FAX: (515) 267-2935

TRUE NORTH PLAN NORTH

GENERAL NOTES

DRAWN: HMO	DATE: 05/20/2021
SCALE:	JOB NUMBER: LS2020-3151

SHEET: **C0.1**

REVISION	DATE BY



olsson

Missouri Certificate of Authority #001592 TEL 913.318.1170
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LOCATION:
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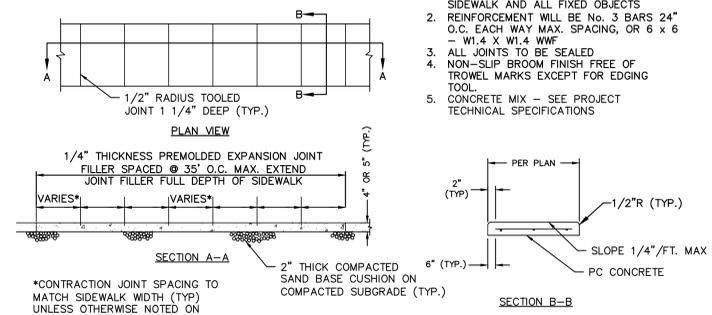


**GENERAL
DETAILS**


DRAWN: HMO	DATE: 05/20/2021
SCALE:	JOB NUMBER: LS2020-3151

C0.2

- NOTE:
1. PROVIDE 1/2" EXPANSION JOINT BETWEEN SIDEWALK AND ALL FIXED OBJECTS
 2. REINFORCEMENT WILL BE No. 3 BARS 24" O.C. EACH WAY MAX. SPACING, OR 6 x 6 - W1.4 X W1.4 WWF
 3. ALL JOINTS TO BE SEALED
 4. NON-SLIP BROOM FINISH FREE OF TROWEL MARKS EXCEPT FOR EDGING TOOL
 5. CONCRETE MIX - SEE PROJECT TECHNICAL SPECIFICATIONS




CONCRETE SIDEWALK
NOT TO SCALE

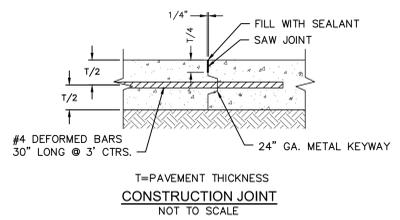


T=PAVEMENT THICKNESS
CONSTRUCTION JOINT
NOT TO SCALE

GENERAL NOTES:

1. 3/4" ISOLATION JOINTS WITH 5/8" DIA. X 2' SMOOTH DOWELS SHALL BE PLACED AT RADIUS POINTS AND AT 150' INTERVALS. THESE DOWEL BARS SHALL BE GREASED AND WRAPPED ON ONE END WITH EXPANSION TUBES.
2. 1" DEEP CONTRACTION JOINTS SHALL BE INSTALLED AT APPROXIMATELY 10' INTERVALS. THESE JOINTS SHALL PASS ACROSS THE ENTIRE CURB SECTION.
3. FIX DOWEL BARS WITH BAR SUPPORTS.
4. DEPTH OF CURB SHALL BE A MINIMUM OF 8" THROUGH HANDICAP ACCESSRAMP.

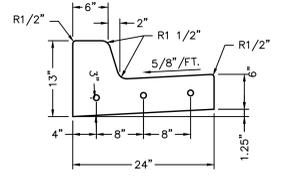

STRAIGHT BACK CURB & GUTTER
NOT TO SCALE

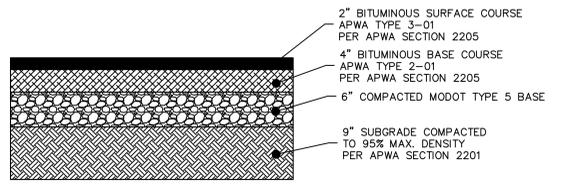


NOTE: ALL CONSTRUCTION, SITE PREPARATION, GRADING, AND EXCAVATION PROCEDURES SHALL CONFORM TO RECOMMENDATIONS AS OUTLINED IN THE GENERAL NOTES INCLUDING ADDENDUMS. CONTRACTOR SHALL CONTACT ENGINEER WITH ANY DISCREPANCIES OR CONCERNS BASED ON ACTUAL SITE CONDITIONS.

HEAVY ASPHALT PAVEMENT
NOT TO SCALE

GENERAL NOTES:

1. 3/4" ISOLATION JOINTS WITH 5/8" DIA. X 2' SMOOTH DOWELS SHALL BE PLACED AT RADIUS POINTS AND AT 150' INTERVALS. THESE DOWEL BARS SHALL BE GREASED AND WRAPPED ON ONE END WITH EXPANSION TUBES.
2. 1" DEEP CONTRACTION JOINTS SHALL BE INSTALLED AT APPROXIMATELY 10' INTERVALS. THESE JOINTS SHALL PASS ACROSS THE ENTIRE CURB SECTION.
3. FIX DOWEL BARS WITH BAR SUPPORTS.
4. DEPTH OF CURB SHALL BE A MINIMUM OF 8" THROUGH HANDICAP ACCESSIBLE RAMP.

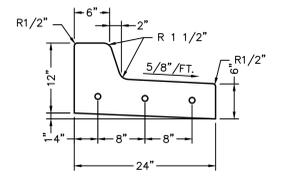

STRAIGHT BACK DRY CURB & GUTTER
NOT TO SCALE

DWC: F:\2020\3001-3500\020-3151\40-Design\AutoCAD\Preliminary Plans\Sheets\GNVC\140 Lee's Summit 2 HyVee\XC-DT101-LS20203151.dwg
DATE: May 20, 2021 2:13pm USER: hokeefe

CONTROL POINT INFORMATION:

Horizontal & Vertical Control is based on the MoDOT Continuously Operating GNSS Network, Missouri State Plane Coordinate System 1983, West Zone.

Coordinate Datum: State Plane Bearings, Ground Distances, US Survey Feet. Project Coordinates are State Plane Coordinates.

Olsson Control Point #1

Set 3/8" rebar with red Olsson control cap set in grass on West side of South entrance into HyVee gas station.

Project Coordinates

N: 999006.61

E: 2817609.29

Elevation: 990.11'

- 8.60' South to back of curb for private road.
- 13.30' East to back of curb at entrance to gas station.
- 20.40' North to South edge of light pole base.

Olsson Control Point #2

Set 3/8" rebar with red Olsson control cap set in grass island NW of HyVee building.

Project Coordinates

N: 998961.41

E: 2817622.30

Elevation: 988.80'

- 6.00' South to East most corner of curb inlet.
- 6.50' SW to West most corner of curb inlet.
- 26.80' NE to a 12" tree.

Olsson Control Point #3

Set 3/8" rebar with red Olsson control cap set in grass island on North side of HyVee building, lying between the second and third trees in the South row of trees.

Project Coordinates

N: 999002.29

E: 2817828.86

Elevation: 990.46'

- 4.90' South to back of curb on North side of parking lot on North side of HyVee building.
- 15.50' NW to a 12" tree.
- 12.80' NE to a 14" tree.

Olsson Control Point #4

Set 3/8" rebar with red Olsson control cap set in grass island of parking lot, lying East of NE corner of HyVee building and East of main drive.

Project Coordinates

N: 998952.51

E: 2817982.08

Elevation: 989.80'


- 8.90' SW to a water spigot.
- 6.30' NE to PI in curb line of island.
- 7.70' South to PI in curb line of island.

UTILITIES NOTE:

Utilities shown have been located from field survey information, together with obtained records. The Surveyor makes no guarantee that the utilities shown comprise all such utilities in the area, either in-service or abandoned. The Surveyor further does not warrant that the utilities shown are in the exact location indicated. Locates are in compliance with Subsurface Utility Engineering Quality Level "B", and were through the Missouri One-Call System, Ticket Number 210632309. Utility companies listed on said Ticket are: ATT Distribution; Evergy; Spire MO West; City of Lee's Summit Water; City of Lee's Summit Sewer; City of Lee's Summit Storm Sewer; and Spectrum. No private utilities were located.

- SET 1/2" X 24" REBAR W/ OLSSON CONTROL CAP
- FOUND REBAR (ORIGIN UNKNOWN UNLESS OTHERWISE NOTED)
- FIRE HYDRANT
- WATER VALVE
- WATER METER
- STORM SEWER MANHOLE
- ELECTRIC BOX
- WATER LINE
- UNDERGROUND POWER LINE
- STORM SEWER PIPE
- SIGN
- DECIDUOUS TREE
- CONIFEROUS TREE
- BUSH
- TREE LINE/ BRUSH LINE
- BUILDING LINE
- ASPH. ASPHALT
- AT&T AMERICAN TELEPHONE & TELEGRAPH
- BMK BENCHMARK
- CONC. CONCRETE
- CP CONTROL POINT
- CTL CONTROL
- ELEV. ELEVATION
- FL FLOW LINE
- FF FINISH FLOOR ELEVATION
- FND FOUND
- HDPE HIGH DENSITY POLYETHYLENE PIPE
- LSA LANDSCAPE AREA
- LTP LIGHT POLE
- RBCP REBAR W/ CONTROL CAP
- UG UNDERGROUND
- W/ WITH
- * DENOTES OLSSON BENCHMARK

- LEGEND**
- FOUND MONUMENT
 - BOLLARD
 - WATER VALVE/SPRINKLER
 - SIGN
 - POWER POLE
 - YARD LIGHT
 - STORM DRAIN MANHOLE
 - SPRINKLER HEAD
 - SPRINKLER VALVE
 - STORM PIPE
 - PROPERTY LINE
 - BUILDING LINE

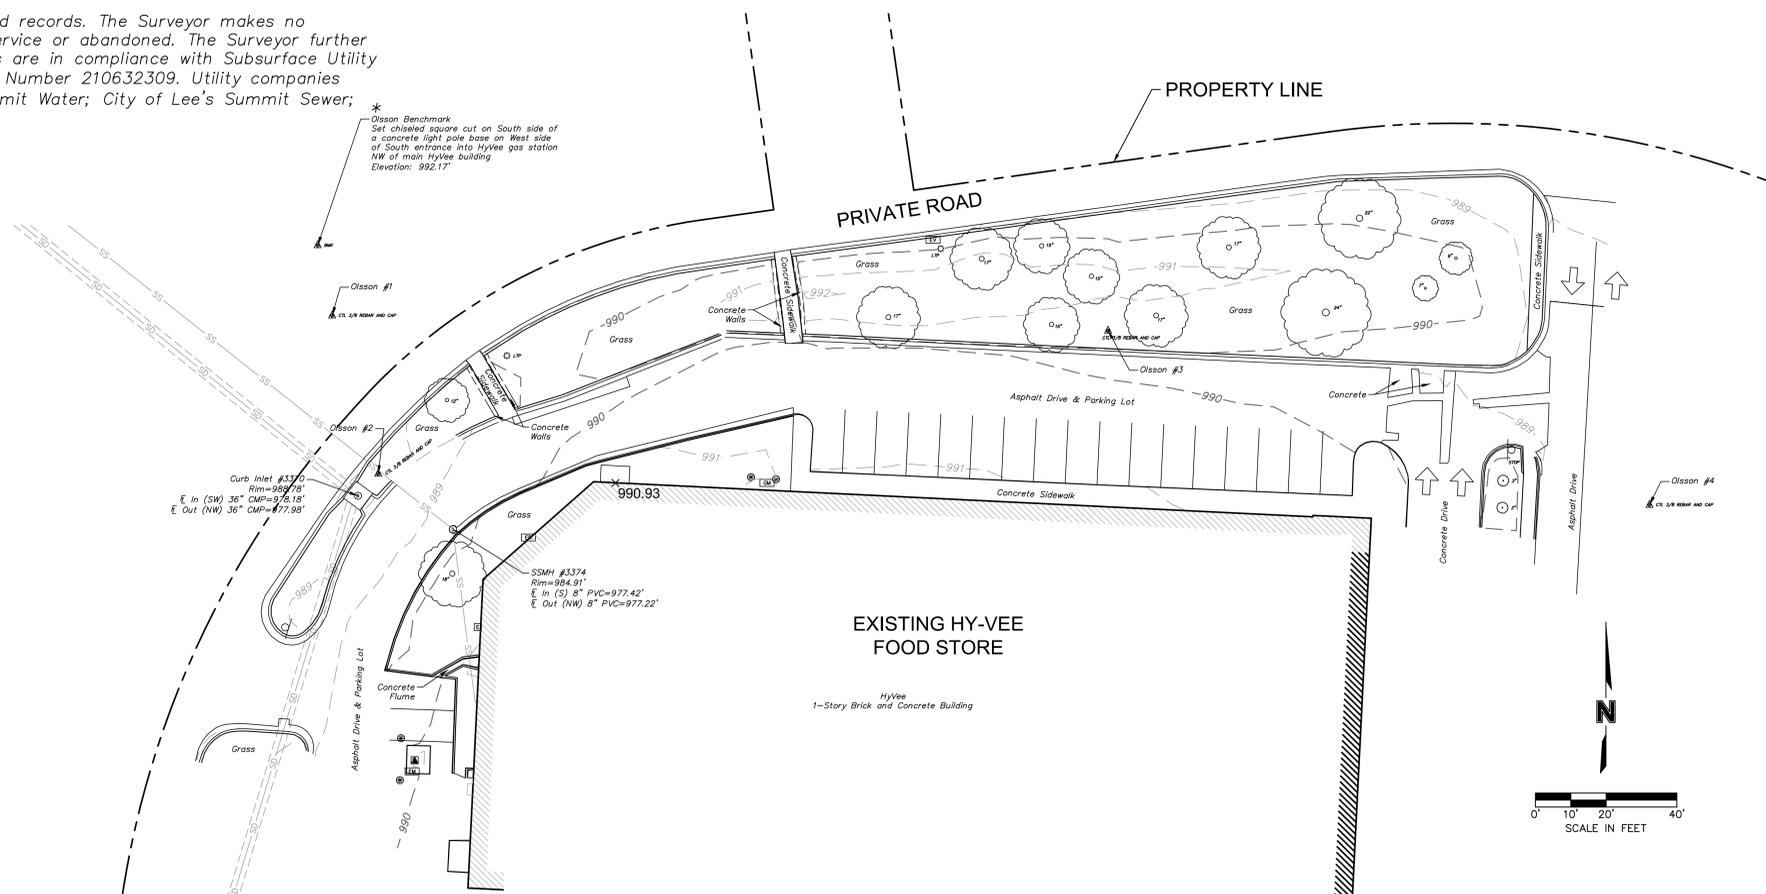

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REVISION	DATE BY



olsson

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 7301 W 133rd Street, Suite 200 www.olsson.com
 Overland Park, Kansas 66213

LOCATION: MISSOURI 2
 LEE'S SUMMIT, MISSOURI 2
 AISLES ONLINE

HY-VEE INC.
 5820 WESTOWN PARKWAY
 WEST DES MOINES, IOWA 50266
 TELEPHONE: (515) 267-2800
 FAX: (515) 267-2935

HyVee
 EMPLOYEE OWNED




EXISTING CONDITIONS

DRAWN: HMO	DATE: 05/20/2021
SCALE: 1" = 10'	SHEET: LS2020-3151

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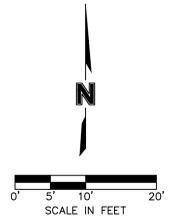


DEMOLITION NOTES

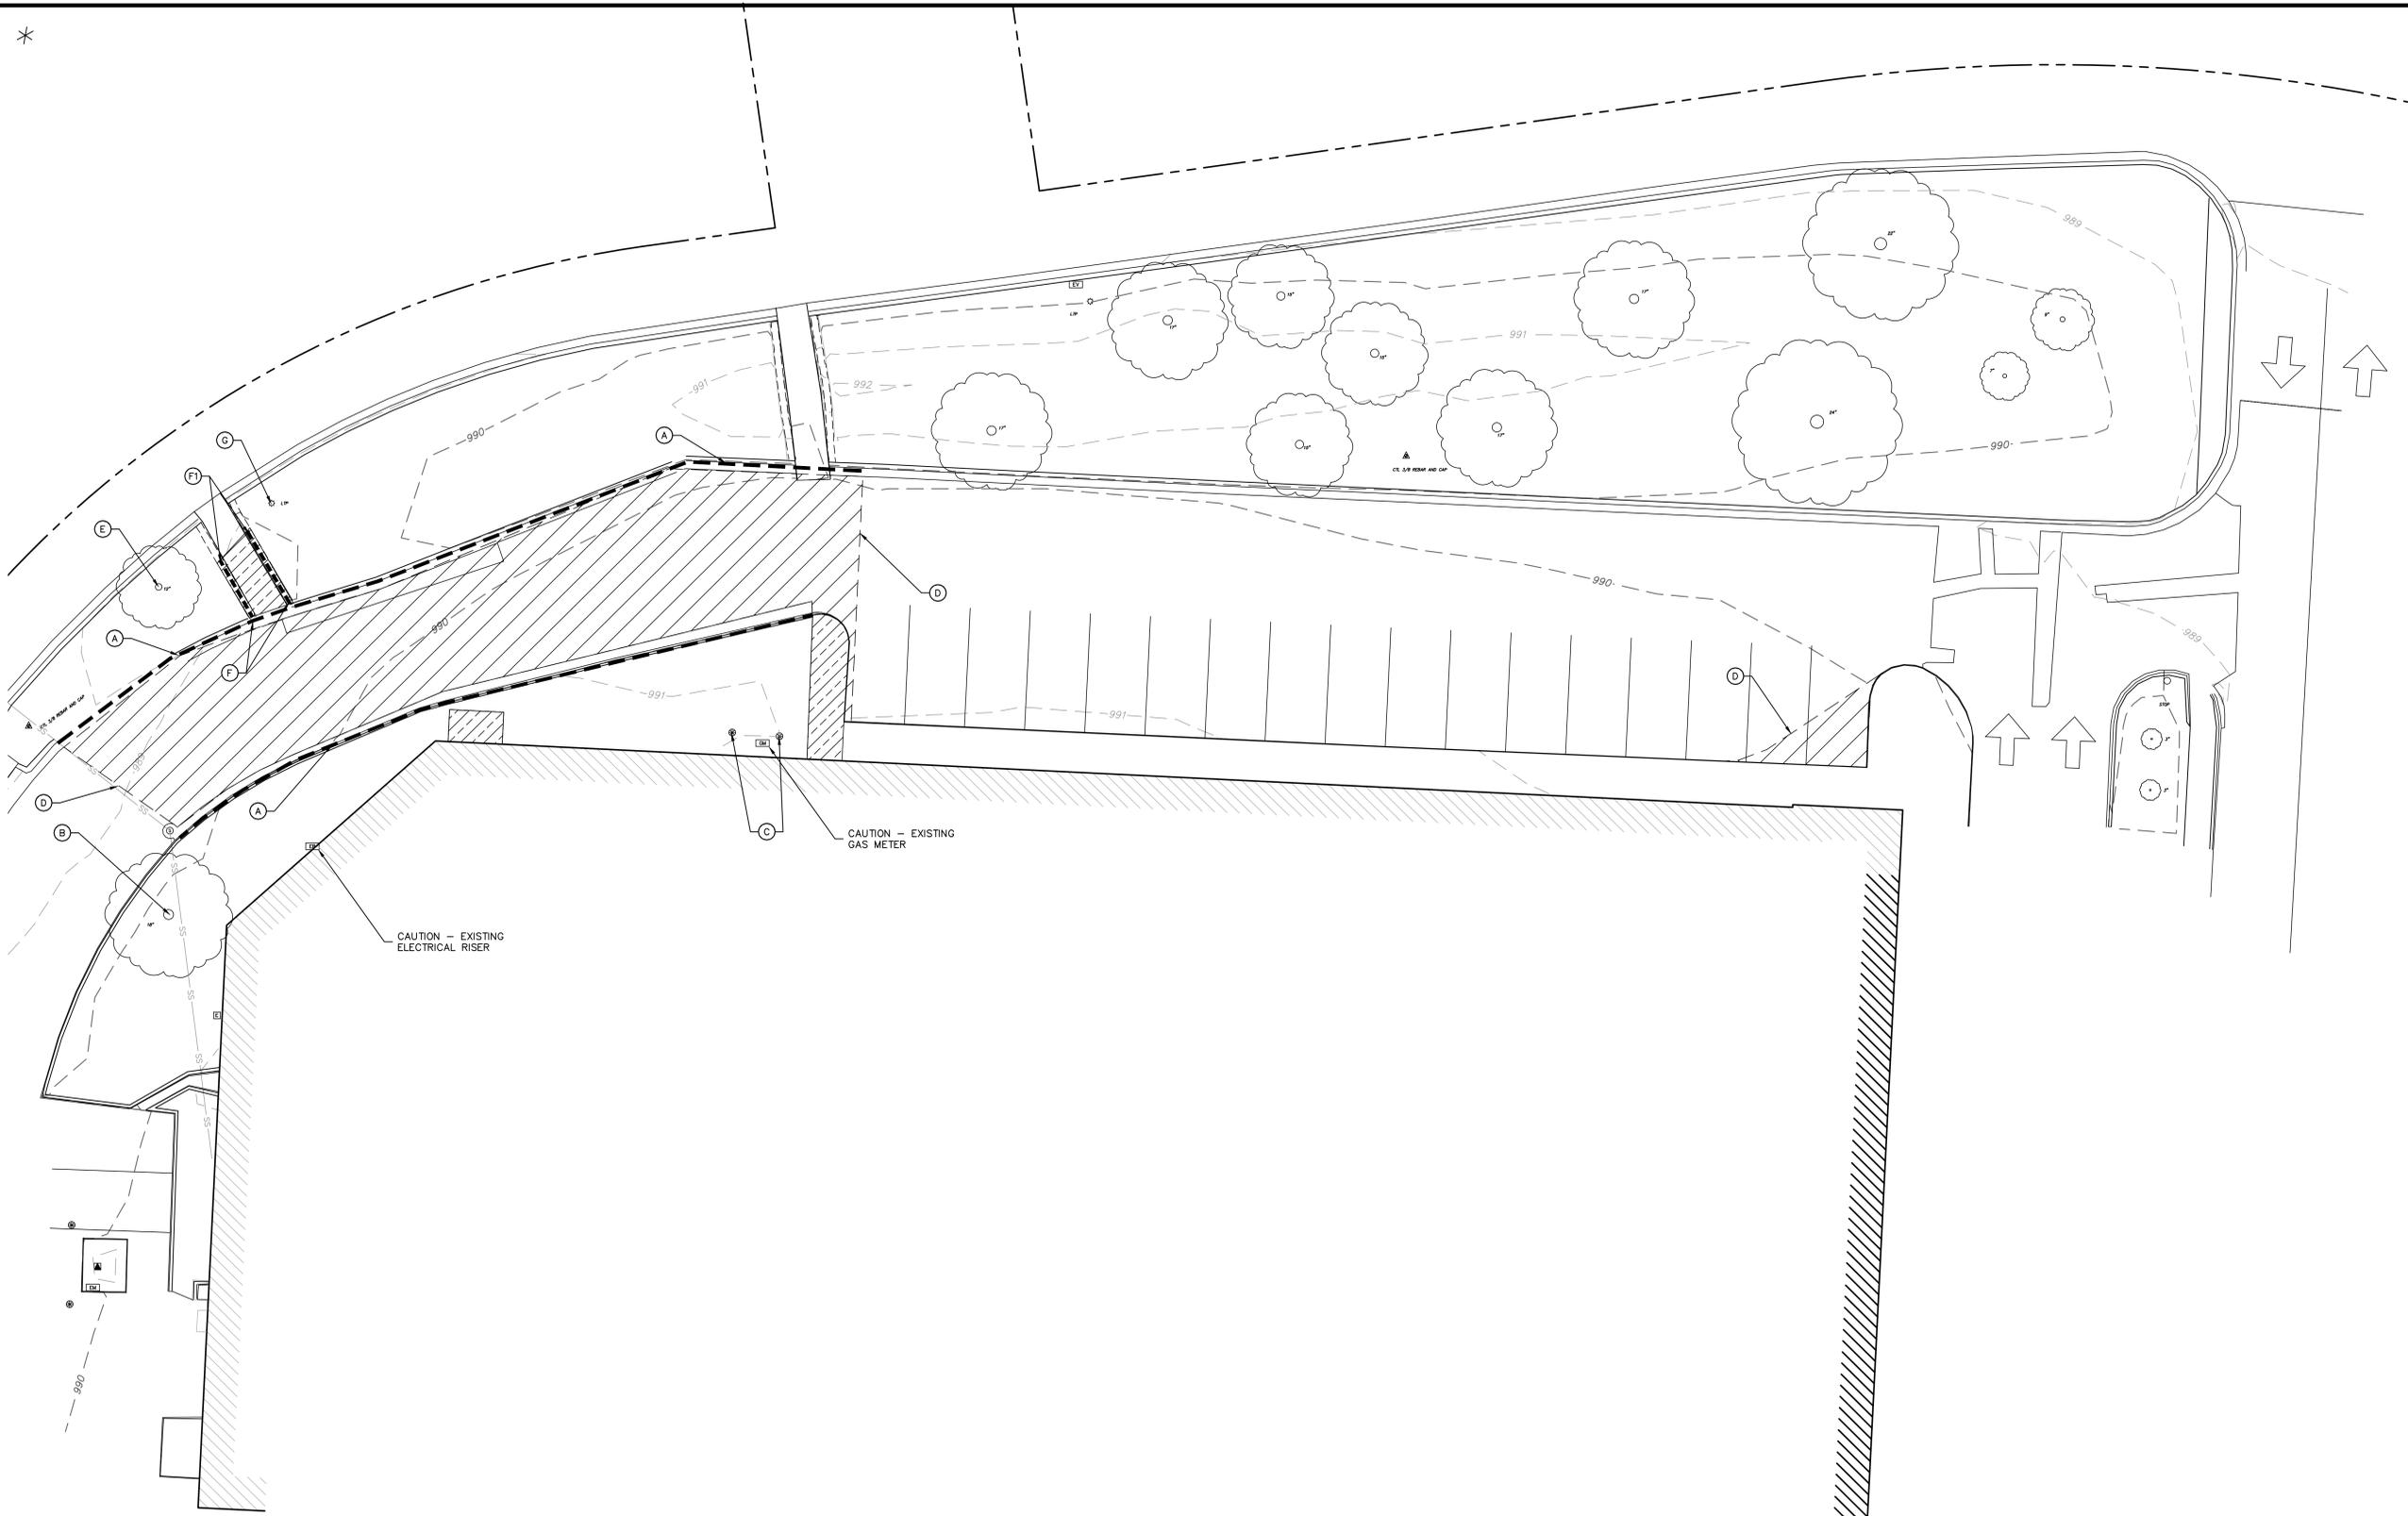- CONTRACTOR TO PROTECT ALL UTILITY, PAVING, BUILDINGS, ETC. OUTSIDE OF LIMITS OF PROPOSED CONSTRUCTION DURING DEMOLITION OPERATIONS.
- EXISTING PAVEMENT SHALL BE REMOVED WHERE REQUIRED FOR PROPOSED CONSTRUCTION, UNLESS OTHERWISE NOTED. SAWCUTS SHALL BE TO FULL DEPTH OF EXISTING PAVEMENT. CONCRETE PAVEMENT SHALL BE REMOVED TO NEAREST EXISTING JOINT WHEN LESS THAN 5' FROM PROPOSED SAWCUT.
- CONTRACTOR SHALL REFER TO PAVING PLAN FOR DETAILS ON LIMITS OF PAVING DEMOLITION.
- ALL DEMOLITION WORK ON THIS CONSTRUCTION SITE SHALL BE IN CONFORMANCE WITH PROJECT SPECIFICATIONS AND CITY OF LEE'S SUMMIT BUILDING CODE.
- THE DEMOLITION PLAN DEPICTS THE ANTICIPATED REMOVALS NECESSARY FOR CONSTRUCTION OF THE PROJECT. MISCELLANEOUS AND MINOR REMOVALS MAY NOT BE SHOWN IN DETAIL BUT ARE CONSIDERED OBLIGATORY TO THE PROJECT. ADDITIONAL REMOVALS MAY BE NECESSARY AND THE CONTRACTOR WILL BE REQUIRED TO REMOVE ALL EXISTING IMPROVEMENTS THAT ARE IN CONFLICT WITH THE PROPOSED CONSTRUCTION AND AS OTHERWISE DIRECTED BY THE OWNER.
- CONTRACTOR SHALL COORDINATE DEMOLITION AND/OR RELOCATION OF EXISTING UTILITIES WITH THE APPROPRIATE UTILITY OWNER AND IN ACCORDANCE WITH THE UTILITY OWNER'S REQUIREMENTS. INTERRUPTIONS IN SERVICE SHALL BE COORDINATED WITH THE UTILITY OWNER AND PROPERTY OWNER(S) IMPACTED. CONTRACTOR SHALL COORDINATE WITH THE RESPECTIVE UTILITY COMPANY FOR PORTIONS OF THE WORK TO BE PERFORMED BY UTILITY COMPANY'S FORCES, AND PROVIDE ADEQUATE NOTICE FOR SCHEDULING. THE CONTRACTOR IS RESPONSIBLE FOR PAYING ALL FEES AND CHARGES, UNLESS OTHERWISE PAID BY OWNER PRIOR TO CONSTRUCTION. UTILITY REMOVAL TRENCHES SHALL BE BACKFILLED AND COMPACTED TO A MINIMUM OF 98% (ASTM D698).
- CONTRACTOR TO COMPLETELY REMOVE TREES DESIGNATED TO BE REMOVED, STUMPS, AND ROOT SYSTEMS.
- PRIOR TO DEMOLITION WORK, EROSION CONTROL DEVICES ARE TO BE INSTALLED. EROSION CONTROL MEASURES SHALL BE ADJUSTED AS DEMOLITION AND CONSTRUCTION SEQUENCING WARRANTS.
- ALL EXISTING UNUSED SERVICE LINES FOR WATER AND WASTEWATER SHALL BE REMOVED PER LOCAL UTILITY COMPANY STANDARDS. ALL EXISTING UNUSED GAS, TELEPHONE, FIBER OR ELECTRIC LINE/SERVICE SHALL BE COORDINATED FOR REMOVAL WITH UTILITY COMPANY.
- THE CONTRACTOR IS RESPONSIBLE FOR DEMOLITION, REMOVAL, AND DISPOSING IN A MANNER APPROVED BY ALL GOVERNING AUTHORITIES FOR ALL STRUCTURES, PADS, WALLS, PANS, FOUNDATIONS, PAVEMENT, UTILITIES, ETC. TO BE DEMOLISHED, SUCH THAT THE IMPROVEMENTS SHOWN ON THE PLANS CAN BE CONSTRUCTED. DEMOLITION AND DISPOSAL PERMITS SHALL BE THE CONTRACTOR'S RESPONSIBILITY. ALL FACILITIES TO BE REMOVED SHALL BE UNDERCUT TO APPROVED GRADE AND BROUGHT UP TO PROPOSED GRADE WITH SUITABLE COMPACTED FILL MATERIAL.
- DURING DEMOLITION OPERATIONS, THE CONTRACTOR MUST PROTECT THE PUBLIC AT ALL TIMES.
- CONTRACTOR SHALL PRESERVE ALL LANDSCAPING NOT TO BE REMOVED FOR CONSTRUCTION. CONTRACTOR SHALL BE RESPONSIBLE FOR RESTORING ALL AREAS DISTURBED BY CONSTRUCTION.

DEMOLITION KEY NOTES	
(A)	REMOVE EXISTING CURB AND GUTTER
(B)	REMOVE EXISTING LANDSCAPE
(C)	REMOVE EXISTING BOLLARDS
(D)	SAWCUT EXISTING ASPHALT
(E)	PROTECT EXISTING TREE
(F)	REMOVE EXISTING MODULAR BLOCK WALL
(F1)	ADJUST EXISTING MODULAR BLOCK WALL AS NECESSARY TO ACCOMMODATE NEW CURB AND PAVING. SEE SHEET C2.0
(G)	REMOVE EXISTING LIGHT POLE AND BASE. SALVAGE POLE AND FIXTURE TO OWNER. SEE SHEET C2.0 FOR RELOCATION OF SAID FIXTURE

LEGEND	
	REMOVE EXISTING CONCRETE SIDEWALK
	REMOVE EXISTING ASPHALT PAVEMENT
	REMOVE EXISTING CURB AND GUTTER



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LOCATION:
LEE'S SUMMIT, MISSOURI 2
AISLES ONLINE


HY-VEE, INC.
 5820 WESTOWN PARKWAY
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TRUE NORTH PLAN NORTH


DEMOLITION PLAN

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SCALE: 1" = 10'	SHEET NUMBER: LS2020-3151
SHEET C1.1	

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EXISTING HY-VEE
 FOOD STORE
 FFE: 990.93

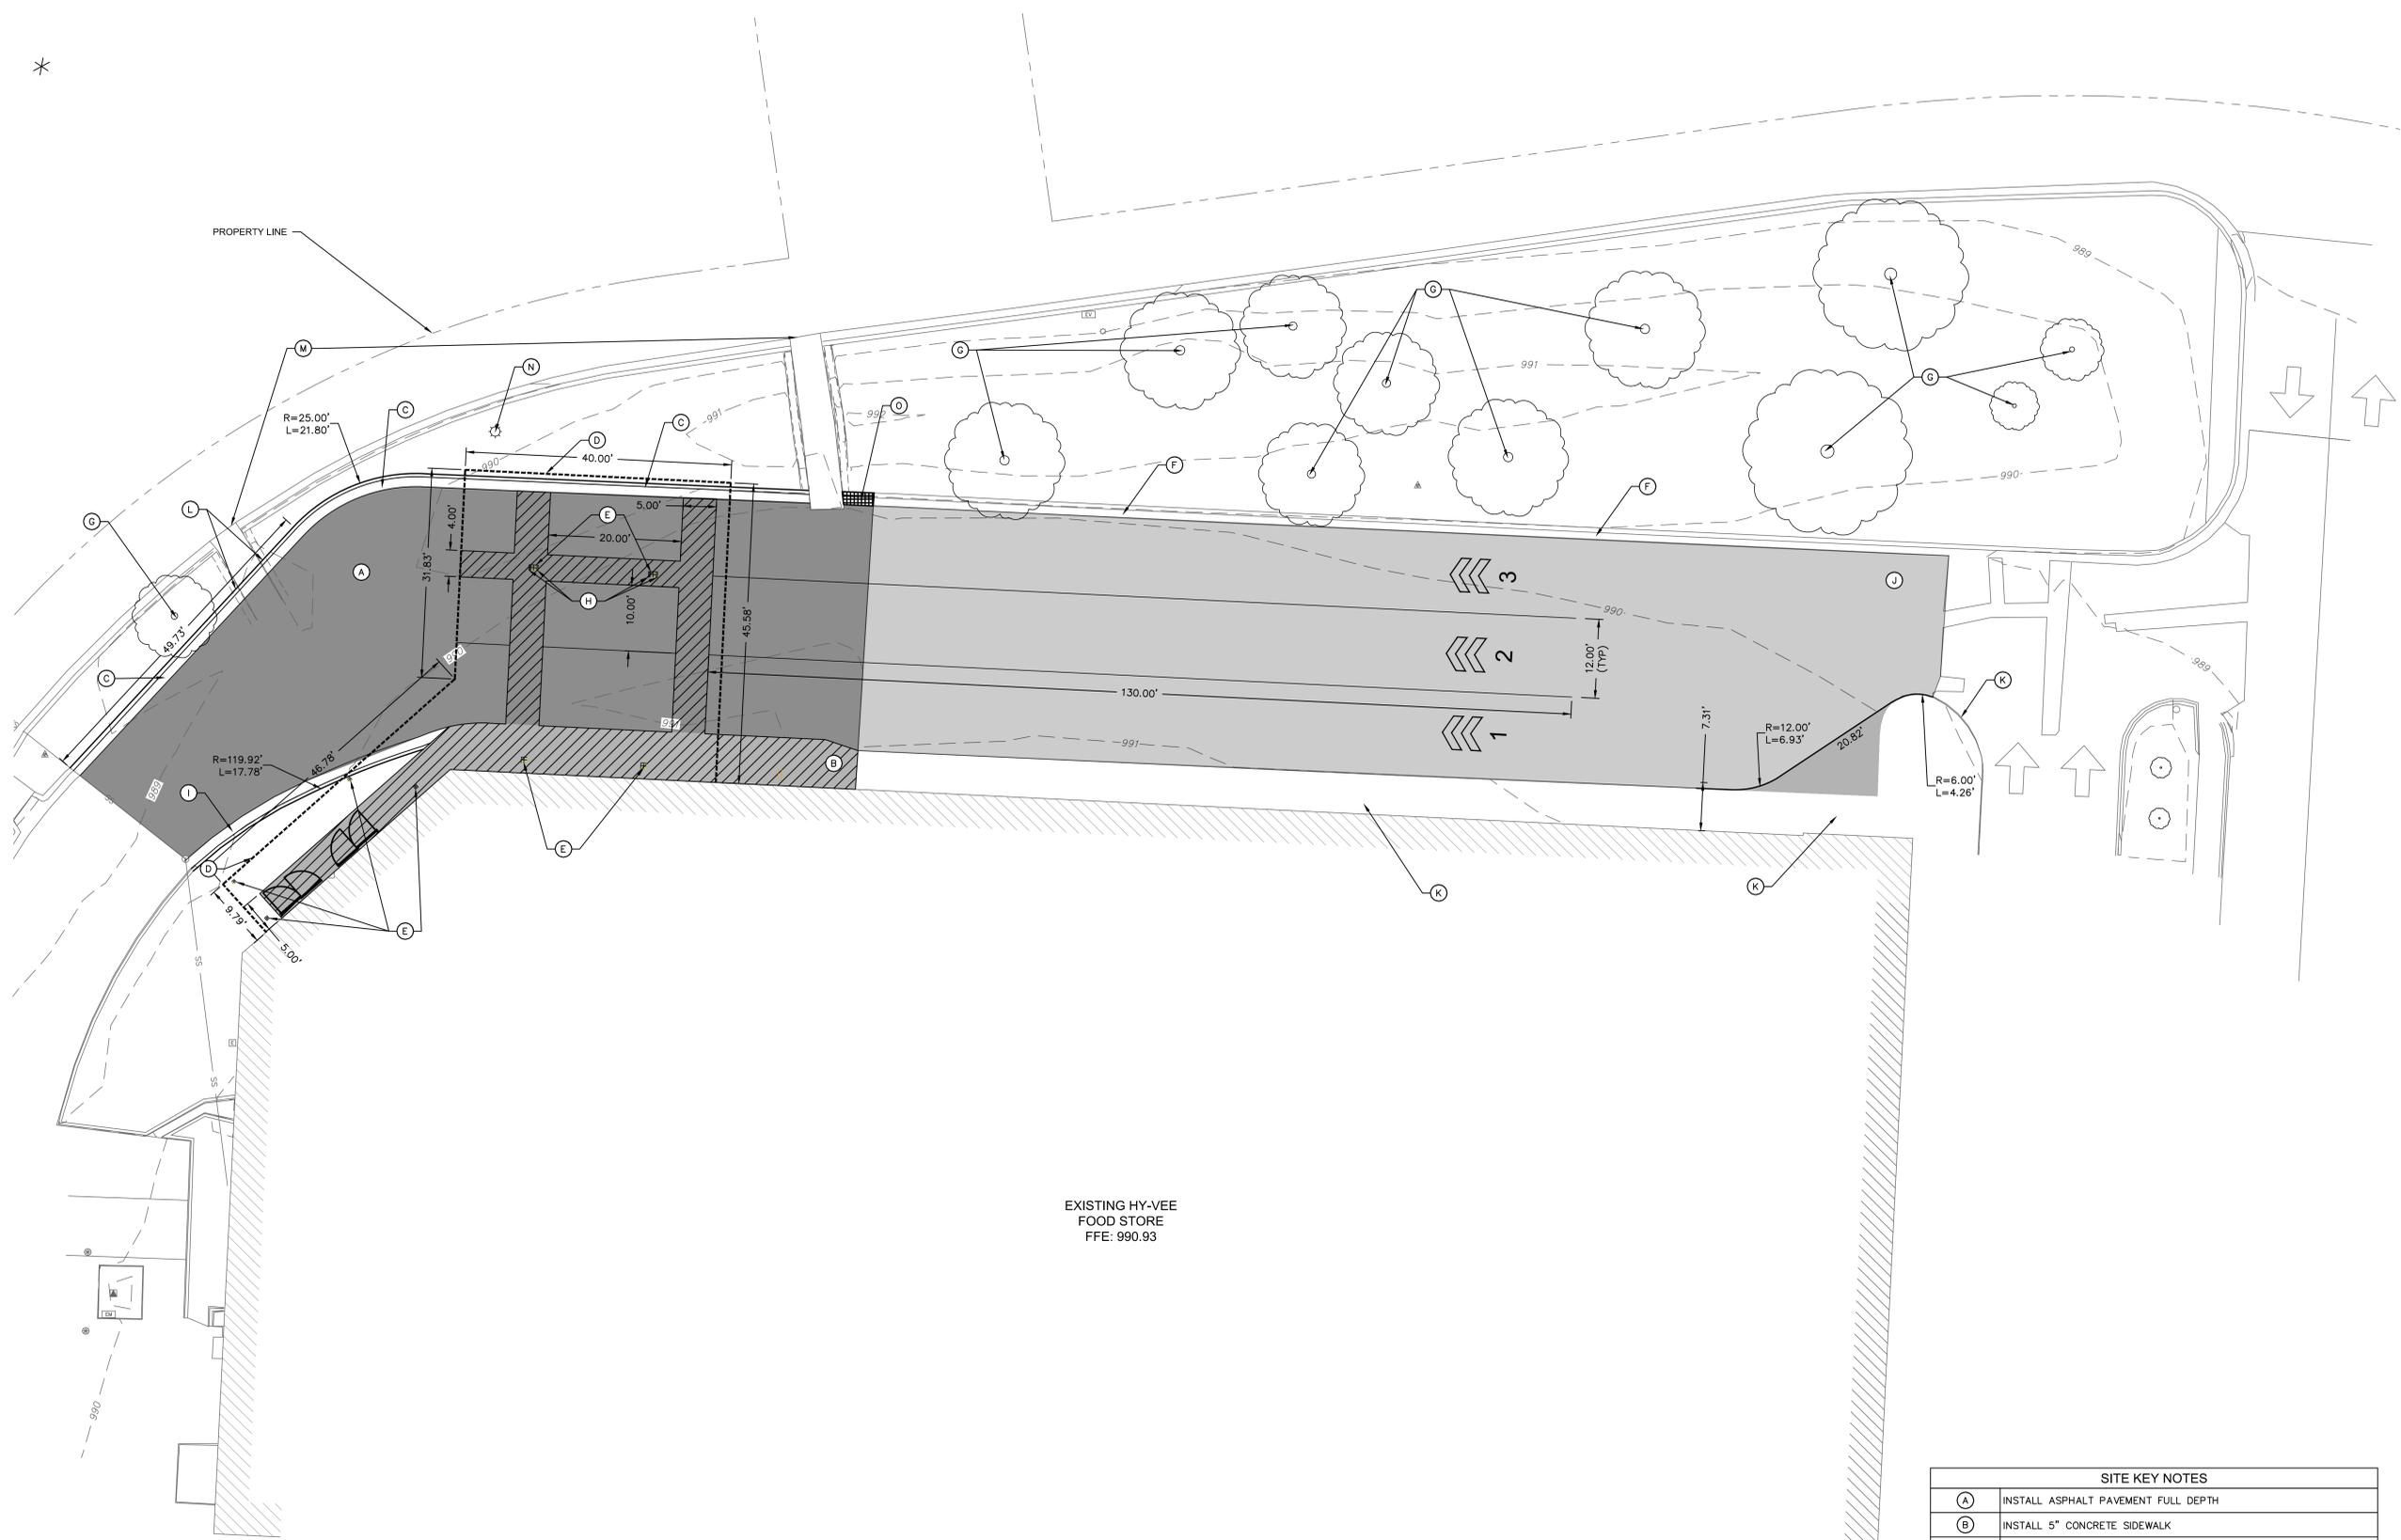

LEGEND

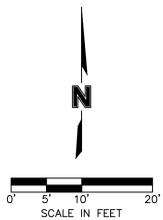	2" MILL & OVERLAY OF ASPHALT SURFACE (APWA TYPE 3-01 PER APWA SECTION 2205)
	6" ASPHALT PAVING
	5' CONCRETE SIDEWALK

SITE KEY NOTES

(A)	INSTALL ASPHALT PAVEMENT FULL DEPTH
(B)	INSTALL 5" CONCRETE SIDEWALK
(C)	INSTALL 6" WET CURB AND GUTTER
(D)	OVERHEAD CANOPY, REFERENCE ARCHITECTURAL PLANS.
(E)	OVERHEAD CANOPY COLUMN, REFERENCE ARCHITECTURAL PLANS.
(F)	EXISTING CURB AND GUTTER TO REMAIN
(G)	EXISTING LANDSCAPE TO REMAIN
(H)	U-SHAPED BOLLARD, REFERENCE PROJECT SPECIFICATIONS.
(I)	INSTALL 6" DRY CURB AND GUTTER
(J)	2" MILL & OVERLAY OF ASPHALT SURFACE
(K)	EXISTING SIDEWALK TO REMAIN
(L)	ADJUST EXISTING MODULAR BLOCK WALL AS NECESSARY TO ALLOW FOR CONSTRUCTION OF NEW CURBS AND PAVING
(M)	CONTRACTOR TO POST SIGN "SIDEWALK TEMPORARILY CLOSED" PER MUTCD STANDARDS. SHOULD BE INSTALLED PRIOR TO ANY CONSTRUCTION ACTIVITIES AND REMOVED AFTER PROJECT ACCEPTANCE
(N)	RELOCATED LIGHT POLE AND FIXTURE, PROVIDE CONCRETE BASE PER MANUFACTURER'S REQUIREMENTS AS EXISTING FIXTURES/BASES
(O)	CURB AND GUTTER TRANSITIONS FROM DRY TO WET CURB

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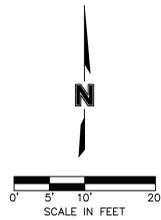
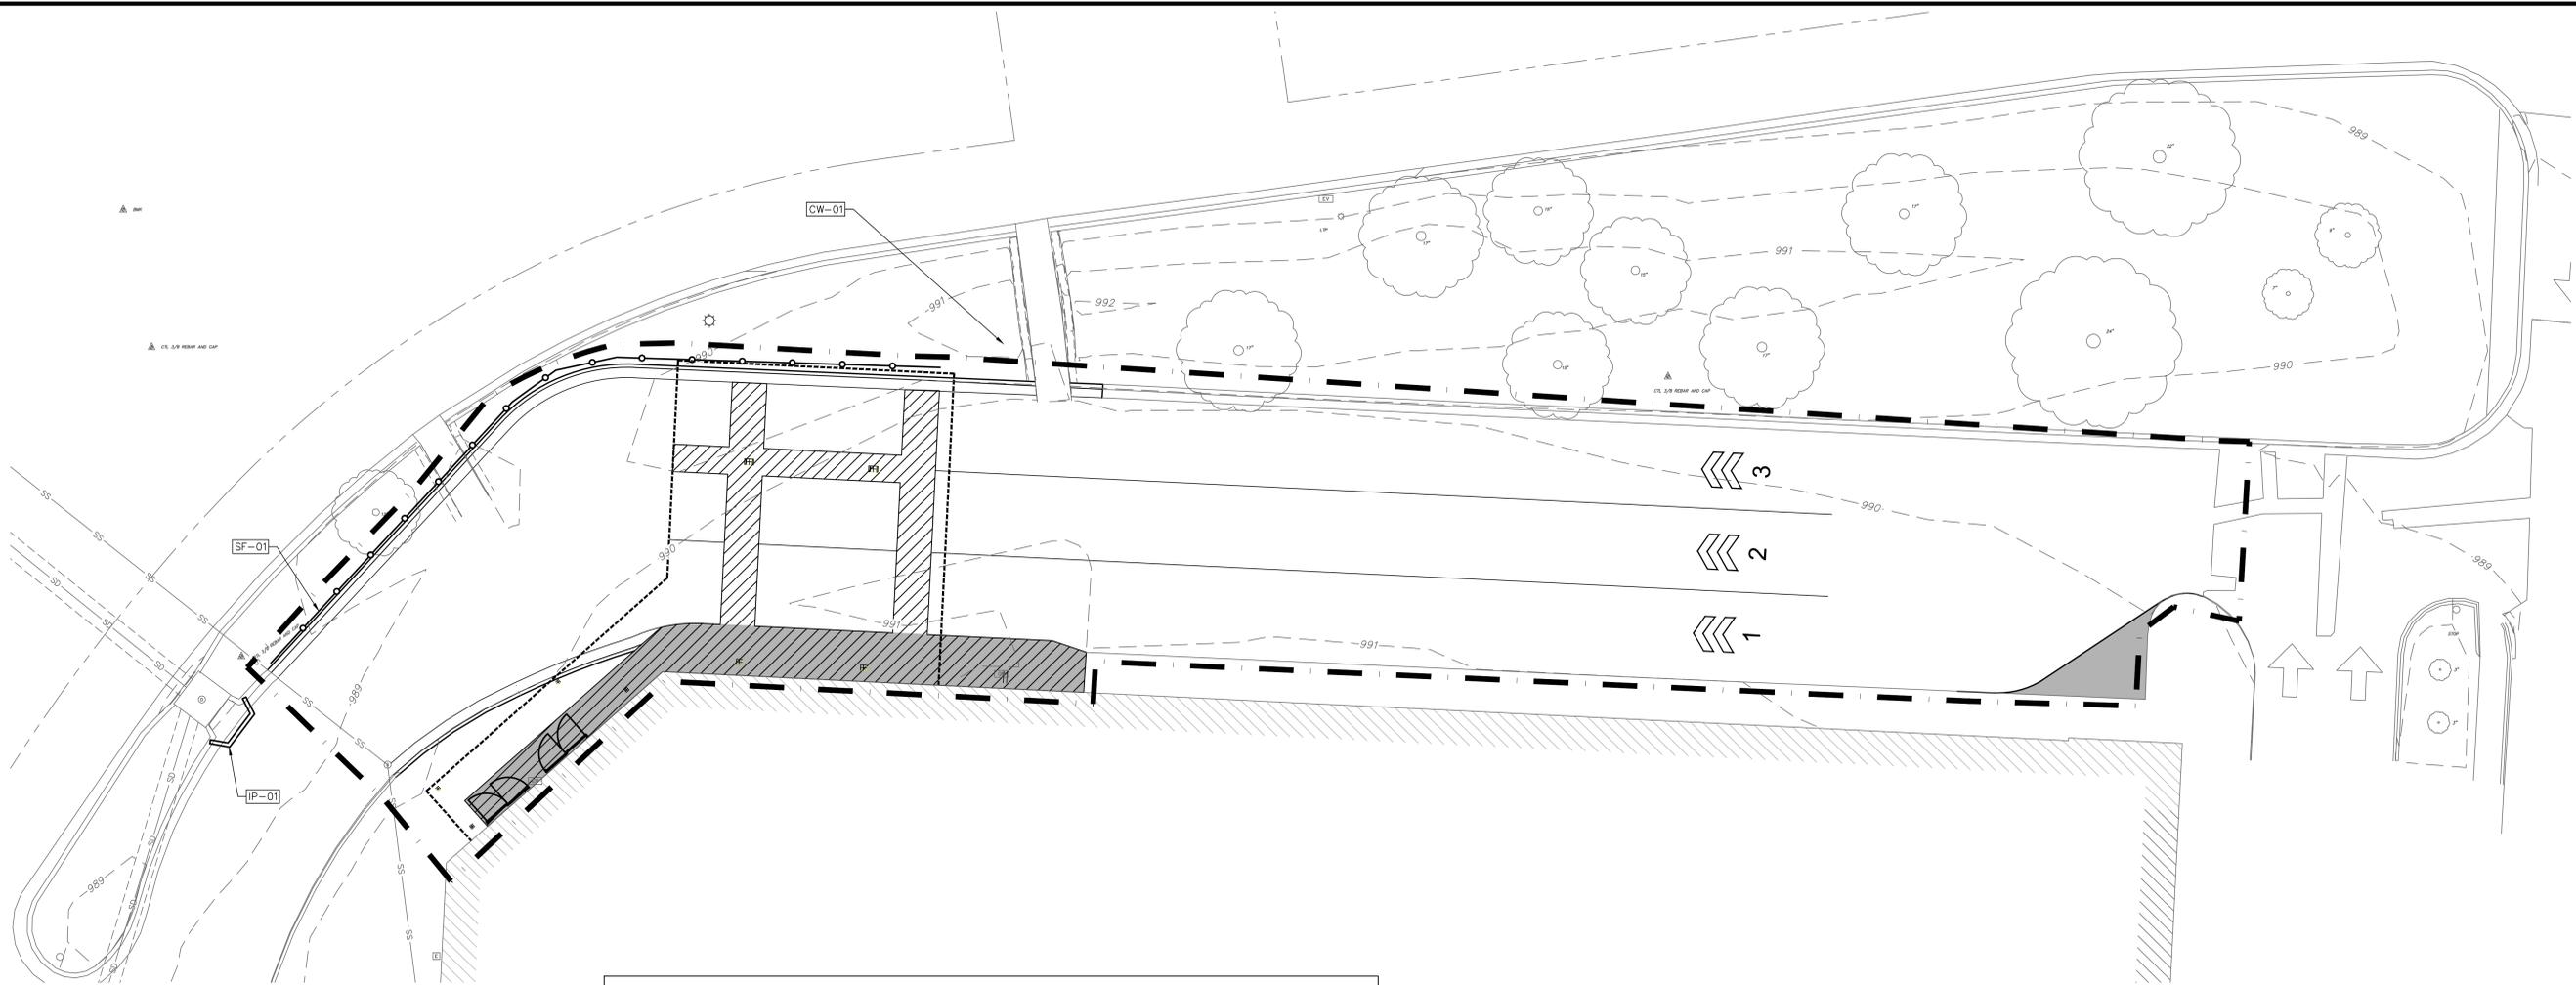
TRUE NORTH

 PLAN NORTH

SITE PLAN

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 SCALE: 1" = 10' JOB NUMBER: LS2020-3151
 SHEET: **C2.0**

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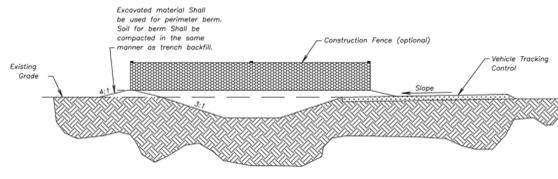


Notes for Concrete Washout:

1. Concrete washout areas shall be installed prior to any concrete placement on site.
2. Concrete washout area shall include a flat subsurface pit sized relative to the amount of concrete to be placed on site. The slopes leading out of the subsurface pit shall be 3:1. The vehicle tracking pad shall be sloped towards the concrete washout area.
3. Vehicle tracking control is required at the access point to all concrete washout areas.
4. Signs shall be placed at the construction site entrance, washout area and elsewhere as necessary to clearly indicate the location(s) of the concrete washout area(s) to operators of concrete truck and pump rigs.
5. A one-place impervious liner may be required along the bottom and sides of the subsurface pit in sandy or gravelly soils.

Maintenance for Concrete Washout:

1. Concrete washout materials shall be removed once the materials have filled the washout to approximately 75% full.
2. Concrete washout areas shall be enlarged as necessary to maintain capacity for washed concrete.
3. Concrete washout water, washed pieces of concrete and all other debris in the subsurface pit shall be transported from the job site in a water-tight container and disposed of properly.
4. Concrete washout areas shall remain in place until all concrete for the project is placed.
5. When concrete washout areas are removed, excavations shall be filled with suitable compacted backfill and topped, any disturbed areas associated with the installation, maintenance, and/or removal of the concrete washout areas shall be stabilized.



CONCRETE WASHOUT

AMERICAN PUBLIC WORKS ASSOCIATION



KANSAS CITY
METRO CHAPTER

CONSTRUCTION ENTRANCE
AND CONCRETE WASHOUT

STANDARD DRAWING
NUMBER ESC-01
ADOPTED:
10/24/2016

Construction Entrance modified from 2015 Overland Park Standard Details for Erosion and Sediment Control; Concrete Washout modified from 2009 City of Great Bend Standard Drawings.

EROSION CONTROL IMPROVEMENT LEGEND

- SF** SILT FENCE MUST BE INSTALLED IN NO GREATER THAN 100' RUNS. THE ENDS OF EACH RUN MUST TURN UPHILL ("V" HOOKS) FOR AN APPROPRIATE DISTANCE TO KEEP WATER FROM FLOWING TO THE NEXT SECTION OF SILT FENCE. (TYPICAL), PER DETAIL SHEET
- IP** INSTALL INLET PROTECTION AT INLET LOCATION, PER DETAIL SHEET
- CW** INSTALL CONCRETE WASHOUT, PER DETAIL SHEET

SITE INFORMATION
TOTAL DISTURBED AREA 0.29 Ac.

ENGINEER
OLSSON
7301 W 133rd STREET,
SUITE 200
OVERLAND PARK, KS 66213
(913) 318-1170

LEGEND

- - - - - EXISTING MINOR CONTOUR
- - - - - EXISTING MAJOR CONTOUR
- - - - - PROPOSED MINOR CONTOUR
- - - - - PROPOSED MAJOR CONTOUR
- - - - - LIMITS OF DISTURBANCE
- - - - - SILT FENCE
- DIRECTION OF FLOW


BMP IMPLEMENTATION SCHEDULE

SPECIFIED BMP	INSTALLATION	REQUIRED MAINTENANCE	REMOVAL
SILT FENCE	IMMEDIATELY FOLLOWING CLEARING AND GRUBBING AROUND PERIMETER	REPAIR WASH-OUTS, DOWNED FABRIC, AND REMOVE SEDIMENT WHEN DEPTH IS 1/2 THE HEIGHT OF THE FABRIC.	85% VEGETATIVE COVER ON UPSTREAM AREAS.
TEMPORARY SEEDING	IMMEDIATELY FOLLOWING MAJOR GRADING AND INSTALLATION OF EROSION CONTROL PRACTICES	RE-SEED AREAS WHICH FAIL TO ESTABLISH VEGETATIVE COVER; CONTROL WEEDS; ENSURE GOOD STAND IS MAINTAINED	
CONCRETE WASHOUT	UPON MOBILIZATION OF UTILITY CONTRACTOR	REMOVE CONCRETE RUBBLE AS REQUIRED TO MAINTAIN FUNCTIONALITY	COMPLETION OF STREET PAVING.
STORM DRAIN INLET PROTECTION	IMMEDIATELY FOLLOWING INSTALLATION OF STORM SEWER	REMOVE SEDIMENT WHEN DEPTH IS 1/2 THE HEIGHT OF THE FABRIC.	COMPLETION OF STREET PAVING.
PERMANENT SEEDING	IMMEDIATELY FOLLOWING FINISHED GRADING AND INSTALLATION OF EROSION CONTROL PRACTICES	RE-SEED AREAS WHICH FAIL TO ESTABLISH VEGETATIVE COVER; CONTROL WEEDS; ENSURE GOOD STAND IS MAINTAINED	N/A
HYDROSEEDING/HYDROMULCHING	IMMEDIATELY FOLLOWING FINISHED GRADING	INSPECT FOR EROSION, ADD MULCH AND/OR SEED AS NECESSARY	N/A
MULCHING		INSPECT FOR EROSION, ADD MULCH AS NECESSARY UNTIL GRASSES ARE FIRMLY ESTABLISHED	N/A

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 5820 WESTOWN PARKWAY
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 TELEPHONE: (515) 267-2800
 FAX: (515) 267-2835
HyVee EMPLOYEE OWNED



EROSION CONTROL PLAN

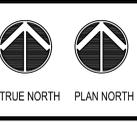DRAWN: HMO DATE: 05/20/2021
 SCALE: JOB NUMBER: LS2020-3151
 1" = 10'-0"
 SHEET: **C3.0**

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EROSION AND SEDIMENT CONTROL GENERAL NOTES

1. CONTRACTOR IS REQUIRED TO IMPLEMENT AND MAINTAIN CONSTRUCTION STORMWATER BEST MANAGEMENT PRACTICES (BMPs) DURING ALL CONSTRUCTION ACTIVITY TO CONTROL POLLUTANTS AND SEDIMENT IN STORMWATER DISCHARGES FROM THE PROJECT SITE.
2. THE PROJECT IS A DYNAMIC SITE WITH CHANGES TO THE CONDITIONS AND DRAINAGE PATTERNS DURING CONSTRUCTION ACTIVITY. CHANGES TO THE DRAINAGE PATTERNS OF THE PROJECT WILL REQUIRE ADDITIONAL BMPs TO BE INSTALLED BY THE CONTRACTOR TO MAINTAIN CONTROL OF POLLUTANTS AND SEDIMENT FROM STORMWATER DISCHARGE FROM THE SITE.
3. THE CONTRACTOR IS RESPONSIBLE FOR MAINTENANCE OF THE EROSION AND SEDIMENT CONTROL BMPs IN AN EFFECTIVE WORKING CONDITION. IF SITE INSPECTIONS INDICATE BMPs ARE NOT OPERATING EFFECTIVELY, MAINTENANCE, REPAIR OR ADDITIONAL BMPs MUST BE PERFORMED WITHIN SEVEN (7) DAYS AND PRIOR TO THE NEXT STORM EVENT.
4. THE CONTRACTOR SHALL HAVE CURRENT COPIES OF THE EROSION AND SEDIMENT CONTROL PLAN ON THE PROJECT SITE AT ALL TIMES.
5. ALL DISTURBED AREAS SHALL BE SEEDED AND MULCHED.



EROSION AND SEDIMENT CONTROL CONSTRUCTION NOTES

1. CONTRACTOR IS RESPONSIBLE FOR THE INSTALLATION, MAINTENANCE AND REMOVAL OF EROSION CONTROL BMPs FOR THE DURATION OF CONSTRUCTION ACTIVITIES UNTIL FINAL STABILIZATION ON THE PROJECT SITE HAS BEEN ACHIEVED.
2. THE STRIPPING STOCKPILE SHALL BE LOCATED ON SITE BY THE GRADING CONTRACTOR AT TIME OF GRADING. THE STOCKPILE SHALL RECEIVE SILT FENCE PERIMETER CONTROL.
3. FOLLOWING SOIL DISTURBANCE, PERMANENT OR TEMPORARY STABILIZATION SHALL BE COMPLETED WITHIN FOURTEEN (14) CALENDAR DAYS TO THE SURFACE OF ALL PERIMETER CONTROLS, TOPSOIL STOCKPILES, AND ANY OTHER DISTURBED OR GRADED AREAS ON THE PROJECT SITE WHICH ARE NOT BEING USED FOR MATERIAL STORAGE, OR ON WHICH ACTUAL EARTH MOVING ACTIVITIES ARE NOT BEING PERFORMED.
4. THE CONTRACTOR SHALL BE RESPONSIBLE FOR THE MAINTENANCE OF THE SEDIMENT CONTROL STRUCTURES UNTIL FINAL SITE STABILIZATION IS ACHIEVED. REFER TO BMPs MAINTENANCE SCHEDULE. UPON FINAL STABILIZATION OF CONTRIBUTING AREAS, BMPs SHALL BE REMOVED BY THE CONTRACTOR. DISTURBANCES WHICH OCCUR DURING REMOVALS OF BMPs SHALL BE REPAIRED BY CONTRACTOR.
5. CONTRACTOR SHALL BE RESPONSIBLE FOR ALL RUNOFF OR EROSION WHICH DISCHARGES FROM THE PROJECT SITE. ANY DAMAGE FROM EROSION AND RUNOFF FROM THE SITE SHALL BE REPAIRED/CLEANED UP BY THE CONTRACTOR WITHOUT ADDITIONAL COST TO THE OWNER.
6. CONTRACTOR MUST CLEAN UP ANY SEDIMENT DISCHARGE OR VEHICLE TRACK OUT WHICH ENTERS PUBLIC STREETS OR PRIVATE ROADWAYS AT THE END OF EACH WORKING DAY AND PRIOR TO ANY RAINFALL EVENTS. REPAIR OR INSTALL ADDITIONAL EROSION CONTROL BMPs AS NECESSARY TO PREVENT FUTURE OCCURRENCES.
7. CONTRACTOR MUST INITIATE STABILIZATION MEASURES AS SOON AS PRACTICABLE IN PORTIONS OF THE PROJECT SITE WHERE CONSTRUCTION ACTIVITIES HAVE TEMPORARILY OR PERMANENTLY CEASED, BUT SHALL NOT EXCEED 14 DAYS AFTER THE CONSTRUCTION ACTIVITY HAS TEMPORARILY OR PERMANENTLY CEASED IN THOSE AREAS. STABILIZATION MEASURES SHALL INCLUDE TEMPORARY OR PERMANENT SEEDING/PLANTINGS AND/OR IMPERVIOUS HARD COVERS (PAVEMENT, ETC.). STORM WATER PIPE OUTLET DISCHARGE CONTROL SHALL BE INCLUDED IN FINAL STABILIZATION MEASURES.

BEST MANAGEMENT PRACTICES (BMP) MAINTENANCE SCHEDULE

THE FOLLOWING MAINTENANCE SCHEDULE HAS BEEN PROVIDED. THE OPERATOR/CONTRACTOR MUST PERFORM ALL NEEDED MAINTENANCE. FURTHERMORE, ALL EROSION CONTROL FEATURE REQUIRING MAINTENANCE MAY NOT BE LISTED BELOW. THE OPERATOR/CONTRACTOR AND INSPECTOR MUST PERFORM THEIR RESPECTIVE DUTIES ON ALL BMPs THAT ARE NOT LISTED BELOW AS WELL.

1. PERMANENT SEEDING - THE MAINTENANCE MEASURES ARE AS FOLLOWS: (8.1) IN GENERAL, A STAND OF VEGETATION CANNOT BE DETERMINED TO BE FULLY ESTABLISHED UNTIL IT HAS BEEN MAINTAINED FOR ONE FULL YEAR AFTER PLANNING; (8.2) NEW SEEDLINGS SHALL BE SUPPLIED WITH ADEQUATE MOISTURE, SUPPLY WATER AS NEEDED, ESPECIALLY LATE IN THE SEASON, IN ABNORMALLY HOT OR DRY CONDITIONS, OR ON ADVERSE SITES, WATER APPLICATIONS SHALL BE CONTROLLED TO PREVENT EXCESSIVE RUNOFF; (8.3) INSPECT ALL SEEDED AREAS FOR FAILURES AND MAKE NECESSARY REPAIRS, REPLACEMENTS, AND RESEEDINGS WITHIN THE PLANTING SEASON, IF POSSIBLE; (8.3A) IF STAND IS INADEQUATE FOR EROSION CONTROL, OVER SEED AND FERTILIZE USING HALF OF THE RATES ORIGINALLY SPECIFIED; (8.3B) IF STAND IS 60% DAMAGED, RE-ESTABLISH FOLLOWING SEEDBED AND SEEDING RECOMMENDATIONS; (8.3C) IF STAND HAS LESS THAN 40% COVER, RE-EVALUATE CHOICE OF PLANT MATERIALS AND QUANTITIES OF LIME AND FERTILIZER, THE SOIL MUST BE TESTED TO DETERMINE IF ACIDITY OR NUTRIENT IMBALANCES ARE RESPONSIBLE, RE-ESTABLISH THE STAND FOLLOWING SEEDBED AND SEEDING RECOMMENDATIONS.
2. MULCHING - ALL MULCHES AND SOIL COVERINGS SHOULD BE INSPECTED PERIODICALLY (PARTICULARLY AFTER RAINSTORMS) TO CHECK FOR EROSION. WHERE EROSION IS OBSERVED IN MULCHED AREAS, ADDITIONAL MULCH SHOULD BE APPLIED. NETS AND MATS SHOULD BE INSPECTED AFTER RAINSTORMS FOR DISLOCATION OR FAILURE. IF WASHOUTS OR BREAKAGE OCCUR, REINSTALL NETTING OR MATTING AS NECESSARY AFTER REPAIRING DAMAGE TO THE SLOPE OR DITCH. INSPECTIONS SHOULD TAKE PLACE UNTIL GRASSES ARE FIRMLY ESTABLISHED. WHERE MULCH IS USED IN CONJUNCTION WITH ORNAMENTAL PLANTINGS, INSPECT PERIODICALLY THROUGHOUT THE YEAR TO DETERMINE IF MULCH IS MAINTAINING COVERAGE OF THE SOIL SURFACE; REPAIR AS NEEDED.

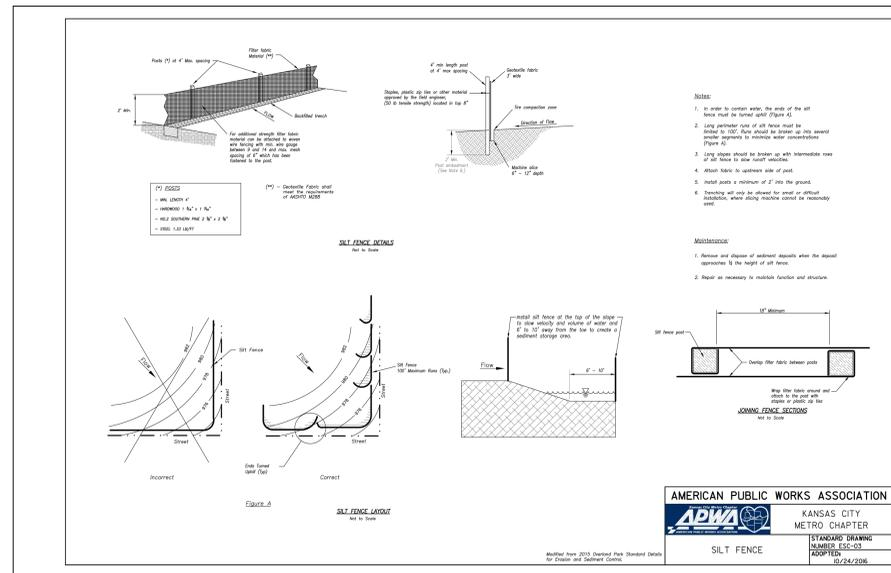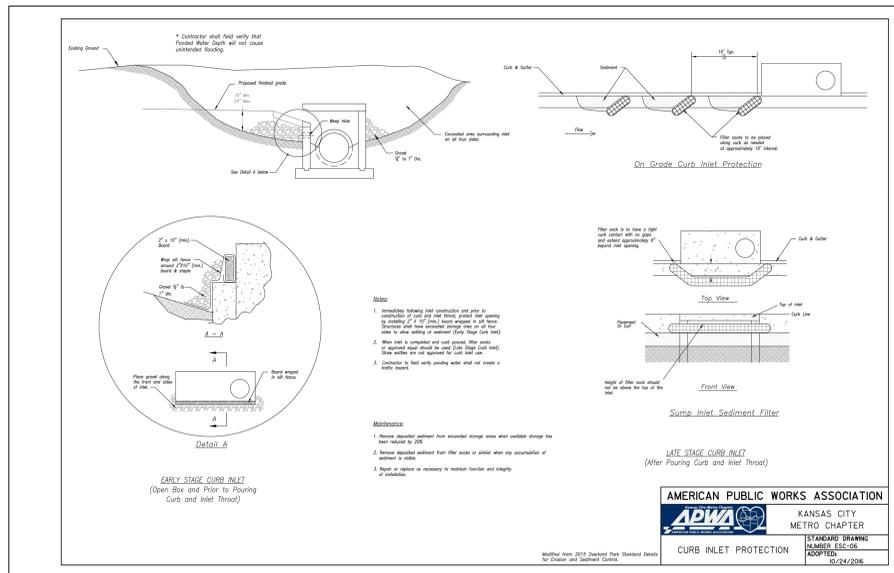

REVISION DATE BY

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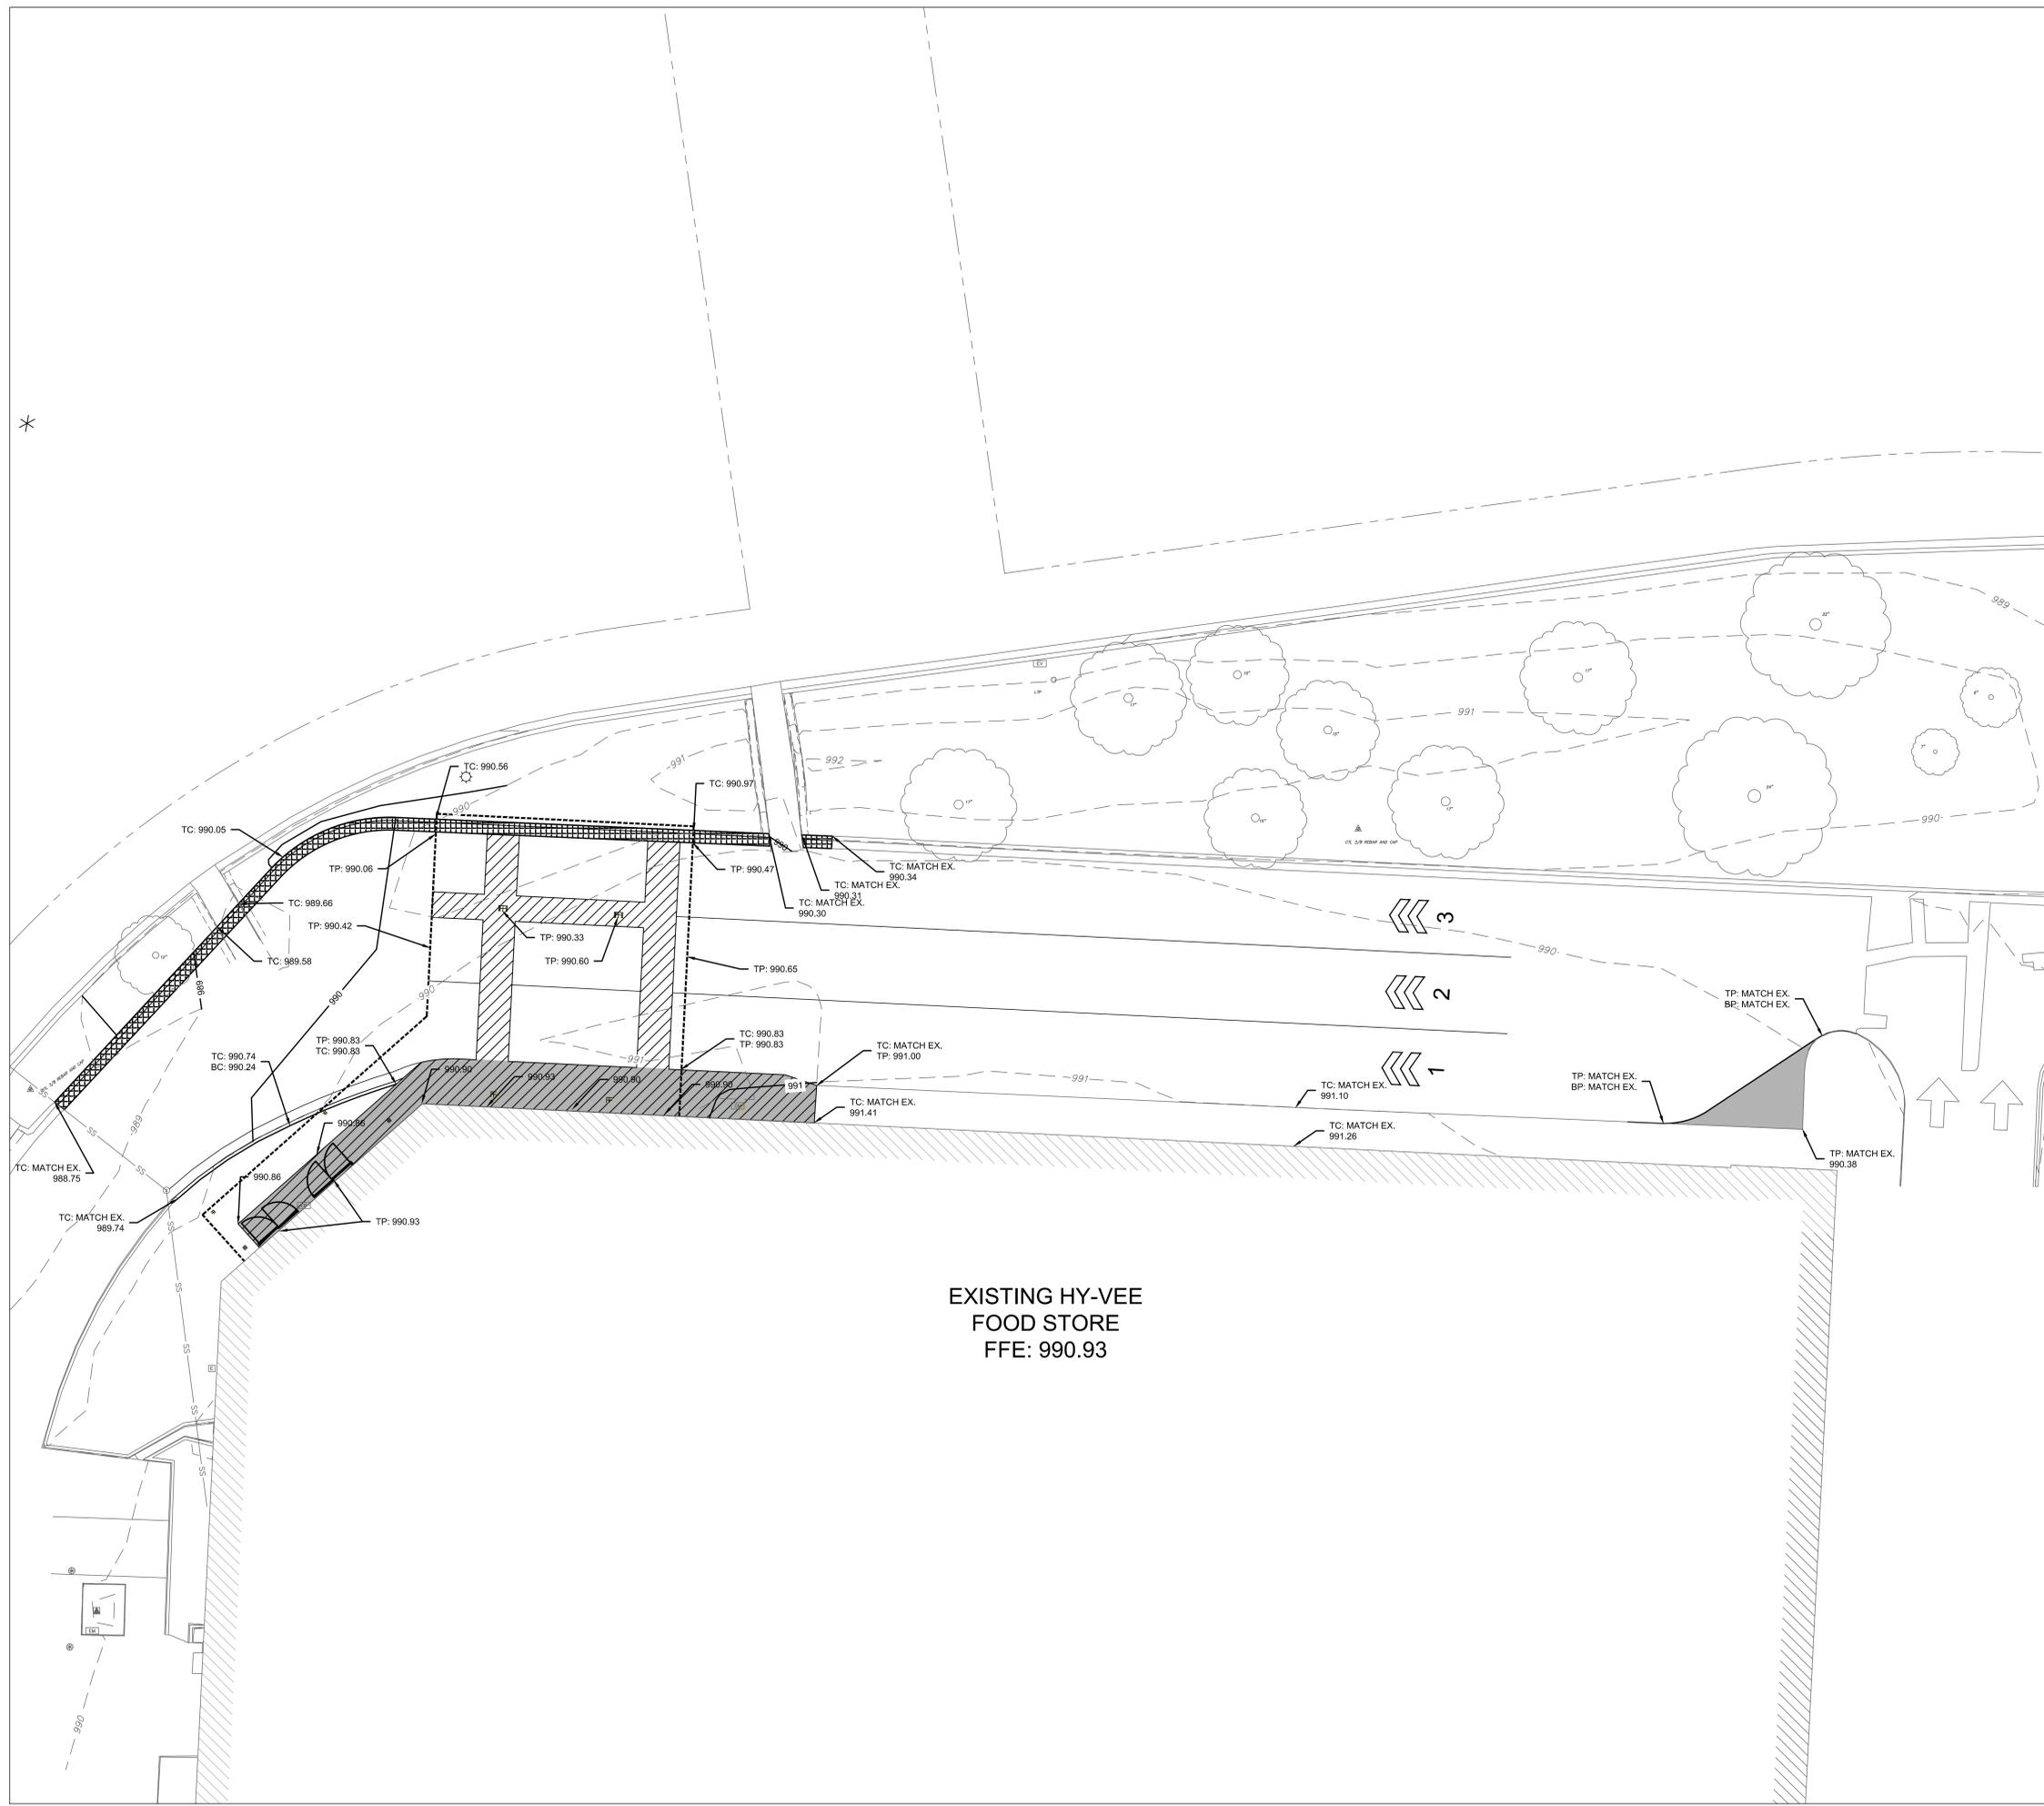
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EROSION CONTROL NOTES

DRAWN: HMO DATE: 05/20/2021
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SHEET: C3.1

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EXISTING HY-VEE
 FOOD STORE
 FFE: 990.93

LEGEND

- - - - -22XX.X- EXISTING MAJOR CONTOUR
- - - - -22XX.X- EXISTING MINOR CONTOUR
- 22XX.X- PROPOSED MAJOR CONTOUR
- 22XX.X- PROPOSED MINOR CONTOUR
- RIDGE LINE
- ▨ WET CURB AND GUTTER
- ▬ DRY CURB AND GUTTER

REVISION	DATE BY

olsson

Missouri Certificate of Authority #001592 TEL 913.318.1170
 7301 W 133rd Street, Suite 200 www.olson.com
 Overland Park, Kansas 66213

LOCATION: **LEE'S SUMMIT, MISSOURI 2**
AISLES ONLINE

HY-VEE, INC.
 5820 WESTOWN PARKWAY
 WEST DES MOINES, IOWA 50266
 TELEPHONE: (515) 267-2900
 FAX: (515) 267-2935

HyVee
 EMPLOYEE OWNED


TRUE NORTH PLAN NORTH

GRADING PLAN

DRAWN: HMO	DATE: 05/20/2021
SCALE: 1" = 10"	JOB NUMBER: LS2020-3151
SHEET:	


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 DATE: May 20, 2021 2:14pm REFS: C:\PBLK_LS20203151 C:\PBASE_LS20203151

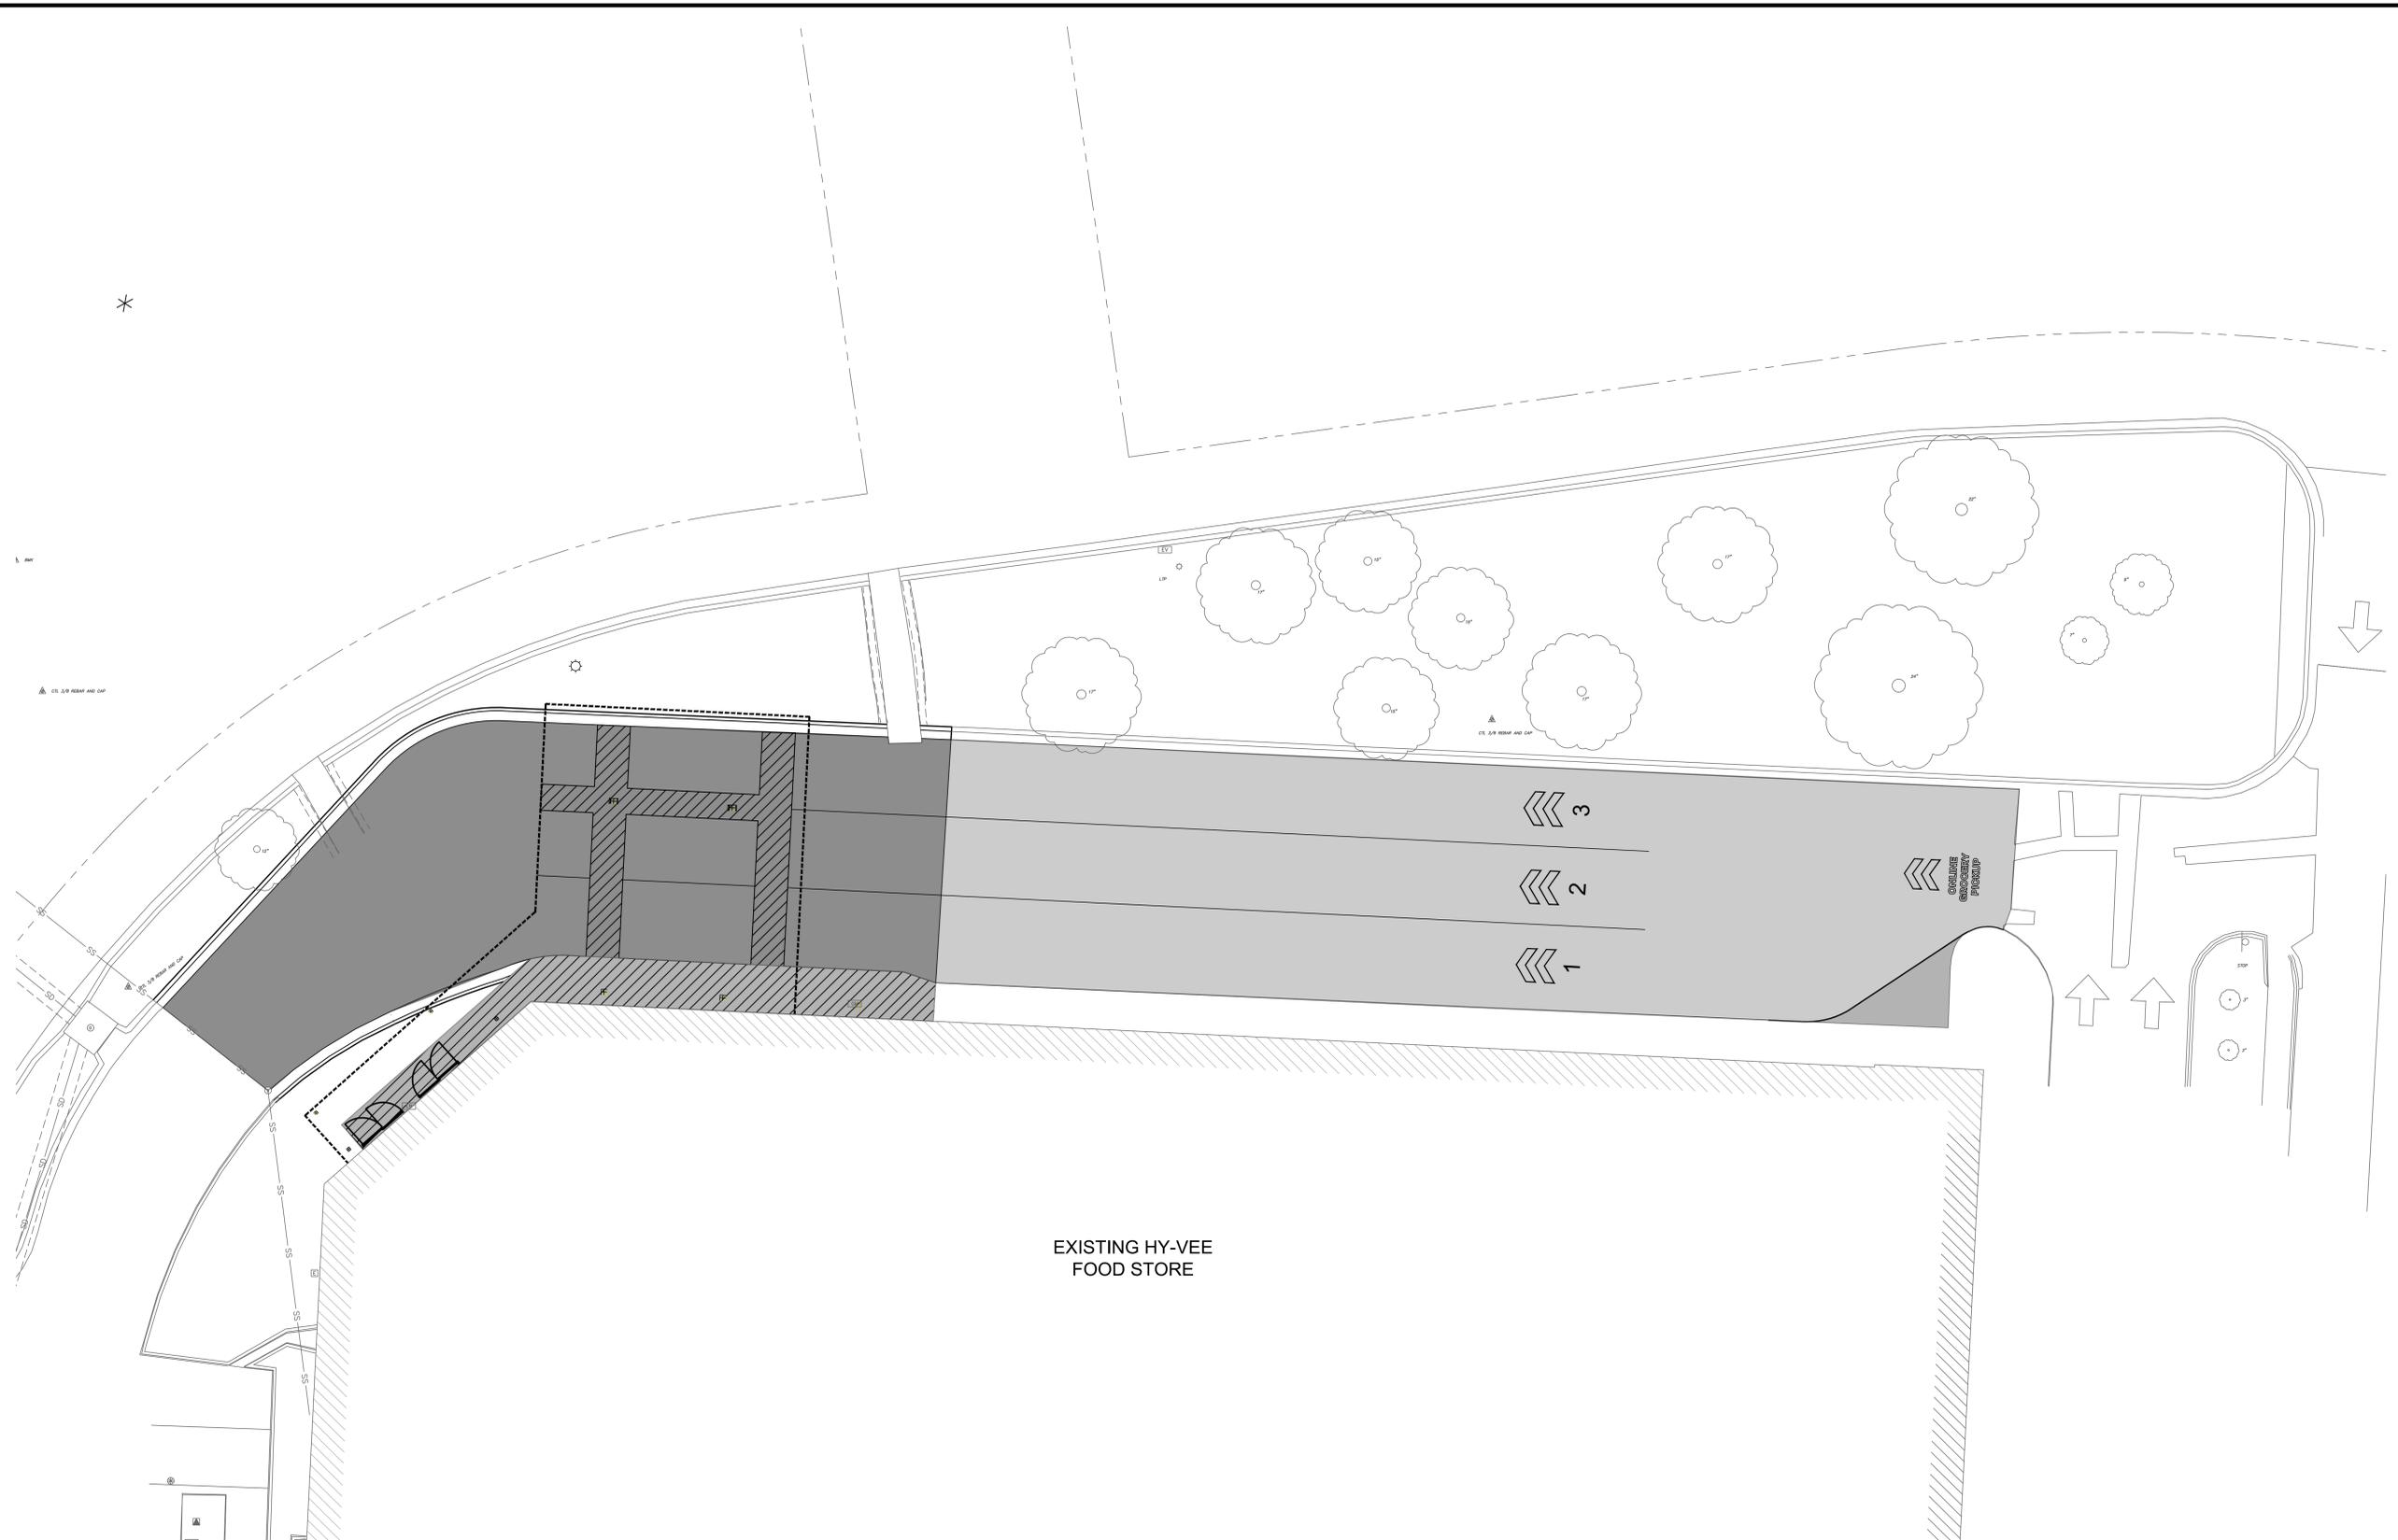

- LEGEND**
- - - - -22XX.X- EXISTING MAJOR CONTOUR
 - - - - -22XX.X- EXISTING MINOR CONTOUR
 - - - - -22XX.X- PROPOSED MAJOR CONTOUR
 - - - - -22XX.X- PROPOSED MINOR CONTOUR
 - — — — — RIDGE LINE
 - [Pattern] 2" MILL & OVERLAY OF ASPHALT SURFACE, APWA TYPE 3-01 PER APWA SECTION 2205
 - [Pattern] 6" ASPHALT PAVING
 - [Pattern] 5" CONCRETE SIDEWALK

GENERAL NOTES
 ALL CONCRETE PAVEMENT ABUTTING THE BUILDING SHALL BE A MINIMUM 2" BELOW FINISH FLOOR ELEVATION (F.F.E.) UNLESS OTHERWISE NOTED ON PLANS

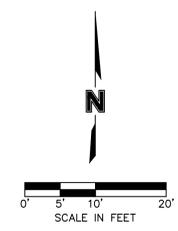


REVISION	DATE BY
△ ASI #1	3.5.21



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HyVee
 EMPLOYEE OWNED

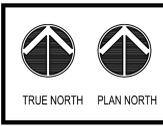


PAVING PLAN

DRAWN: HMO	DATE: 05/20/2021
SCALE: 1" = 10'-0"	SHEET NUMBER: LS2020-3151

C5.0




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 DATE: May 20, 2021 2:14pm REF: C:\P\K\LS2020\3151 C:\P\K\LS2020\3151

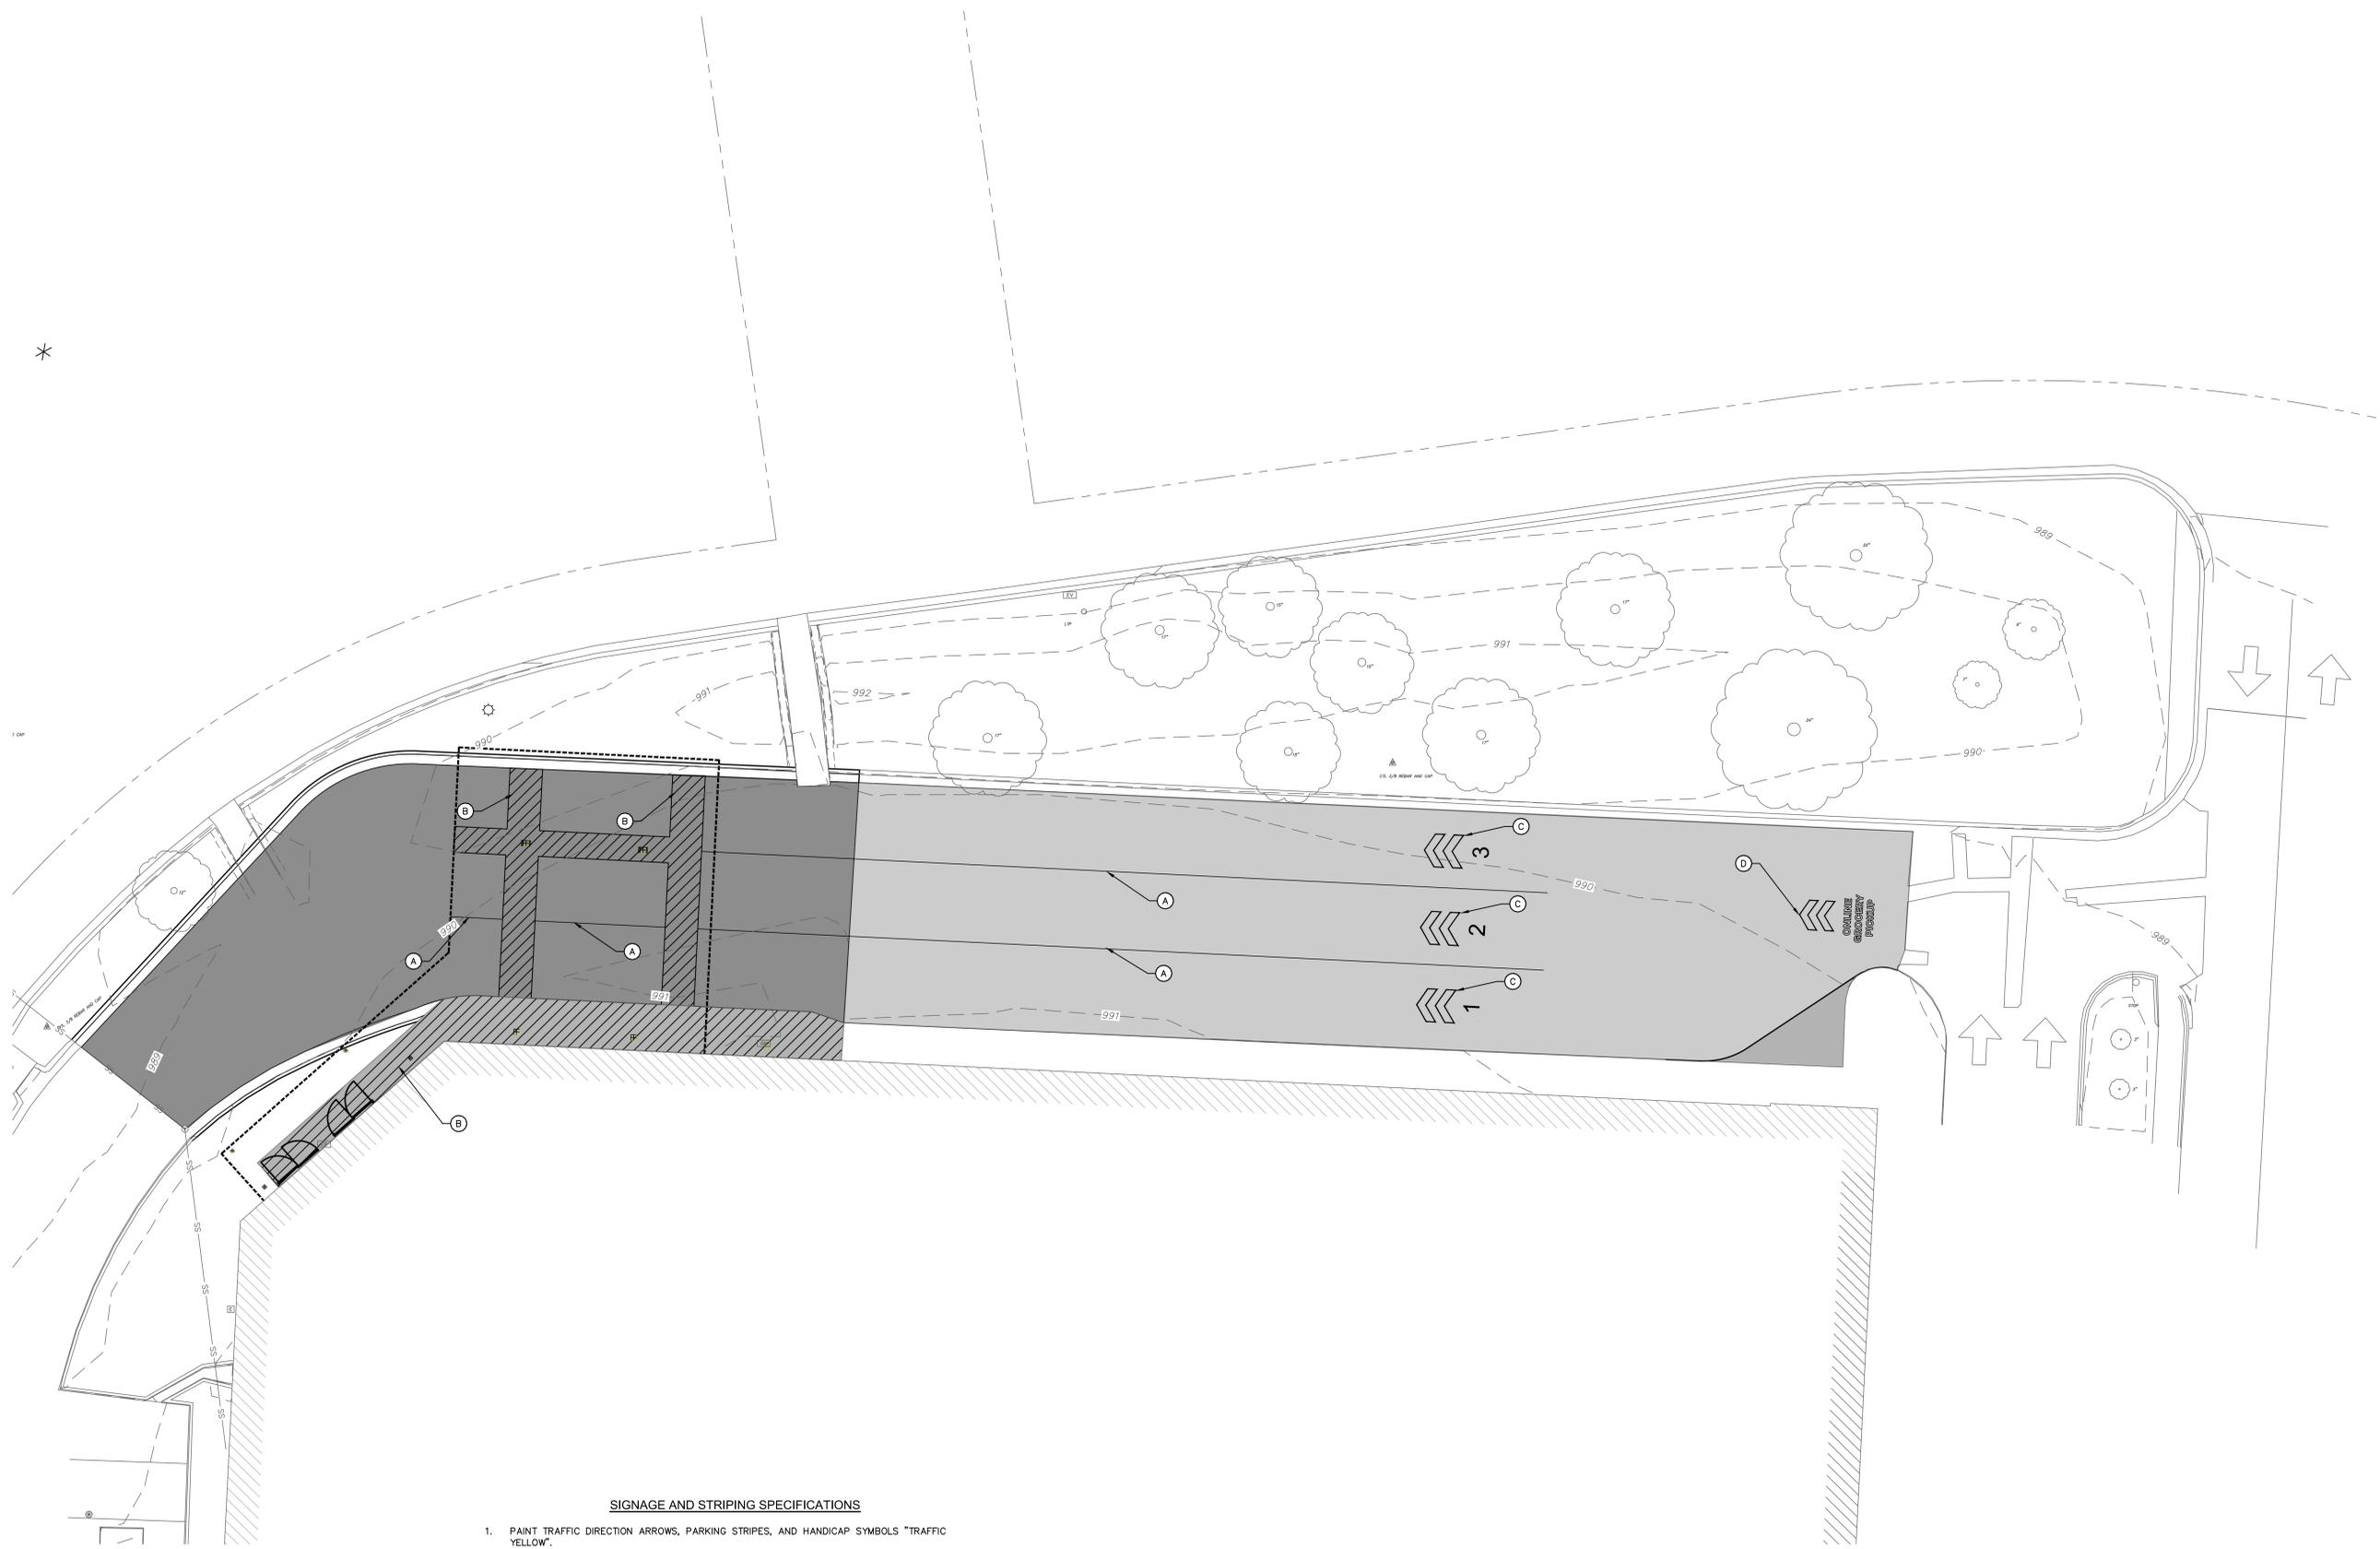

SIGNAGE AND STRIPING SPECIFICATIONS

1. PAINT TRAFFIC DIRECTION ARROWS, PARKING STRIPES, AND HANDICAP SYMBOLS "TRAFFIC YELLOW".
2. PAINT SHALL BE LEAD FREE WATERBORNE TRAFFIC AND HIGHWAY MARKING PAINT UC-3586 YELLOW AS MANUFACTURED BY DIAMOND VOGEL PAINTS OR EQUIVALENT.
3. PROVIDE FOUNDRY GRADE SILICA SAND THAT MEETS A #20 GRADED SAND WHEN TESTED ACCORDING TO ASTM C-136 OR GLASS BEADS THAT MEET FEDERAL SPECIFICATION TT-B-1325, TYPE 1, GRADATION A.
4. BEFORE APPLICATION OF PAINT, PAINTING SURFACE MUST BE DRY AND FREE FROM DIRT, GREASE, OIL, OR OTHER MATERIAL THAT WOULD REDUCE THE BOND BETWEEN THE PAVEMENT AND PAINT. CLEAN THE AREA TO BE PAINTED BY SWEEPING OR COMPRESSED AIR.
5. APPLY PAINT AT LOCATIONS, DIMENSIONS, AND SPACING SHOWN ON PLANS.
6. MIX PAINT IN ACCORDANCE WITH MANUFACTURER'S INSTRUCTIONS AND APPLY AT THE RATE OF 115 SF/GALLON. THE ADDITION OF THINNER WILL NOT BE PERMITTED.
7. APPLY SILICA SAND AT 4LBS/GALLON OF PAINT IMMEDIATELY AFTER THE APPLICATION OF PAINT. SILICA SAND SHALL ADHERE TO THE CURED PAINT PRIOR TO FINAL ACCEPTANCE AND PAYMENT.
8. TREAT GLASS BEADS WITH ADHESION PROMOTING COATINGS AS SPECIFIED BY THE PAINT MANUFACTURER. APPLY GLASS BEADS A 7LBS/GALLON OF PAINT IMMEDIATELY AFTER THE APPLICATION OF PAINT. GLASS BEADS SHALL ADHERE TO THE CURED PAINT PRIOR TO FINAL ACCEPTANCE OF PAYMENT.
9. PROTECT ALL MARKINGS FROM DAMAGE UNTIL PAINT IS DRY.

PAVEMENT MARKING KEY NOTES	
(A)	INSTALL 4-INCH YELLOW PAVEMENT STRIPING. PAINT SHALL MEET OR EXCEED CITY OF LEE'S SUMMIT STANDARD SPECIFICATIONS (TYP.)
(B)	INSTALL 4-INCH YELLOW PAVEMENT STRIPING AT 45°, 2-FOOT O.C. PAINT SHALL MEET OR EXCEED CITY OF LEE'S SUMMIT STANDARD SPECIFICATIONS. (TYP.)
(C)	INSTALL LANE MARKINGS, REFERENCE DETAIL THIS SHEET.
(D)	INSTALL WAYFINDING MARKINGS, REFERENCE DETAIL THIS SHEET.

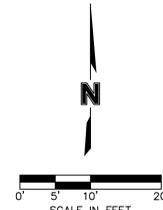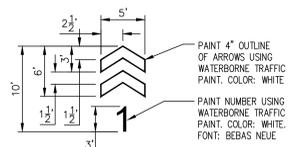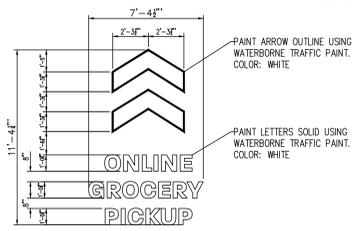

REVISION	DATE BY

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 FAX: (515) 267-2935
HyVee
 EMPLOYEE OWNED


TRUE NORTH PLAN NORTH

PAVEMENT MARKING PLAN

DRAWN: HMO	DATE: 05/20/2021
SCALE: 1" = 10'	SHEET NUMBER: LS2020-3151

SHEET: **C5.1**

DWG: F:\2020\3001-3500\020-315\140-Design\AutoCAD\Preliminary Plans\Sheets\GNVC\140 Lee's Summit 2_HyVee_C_LSC01_LS20203151.dwg
 DATE: May 20, 2021 2:14pm
 USER: hokeefe

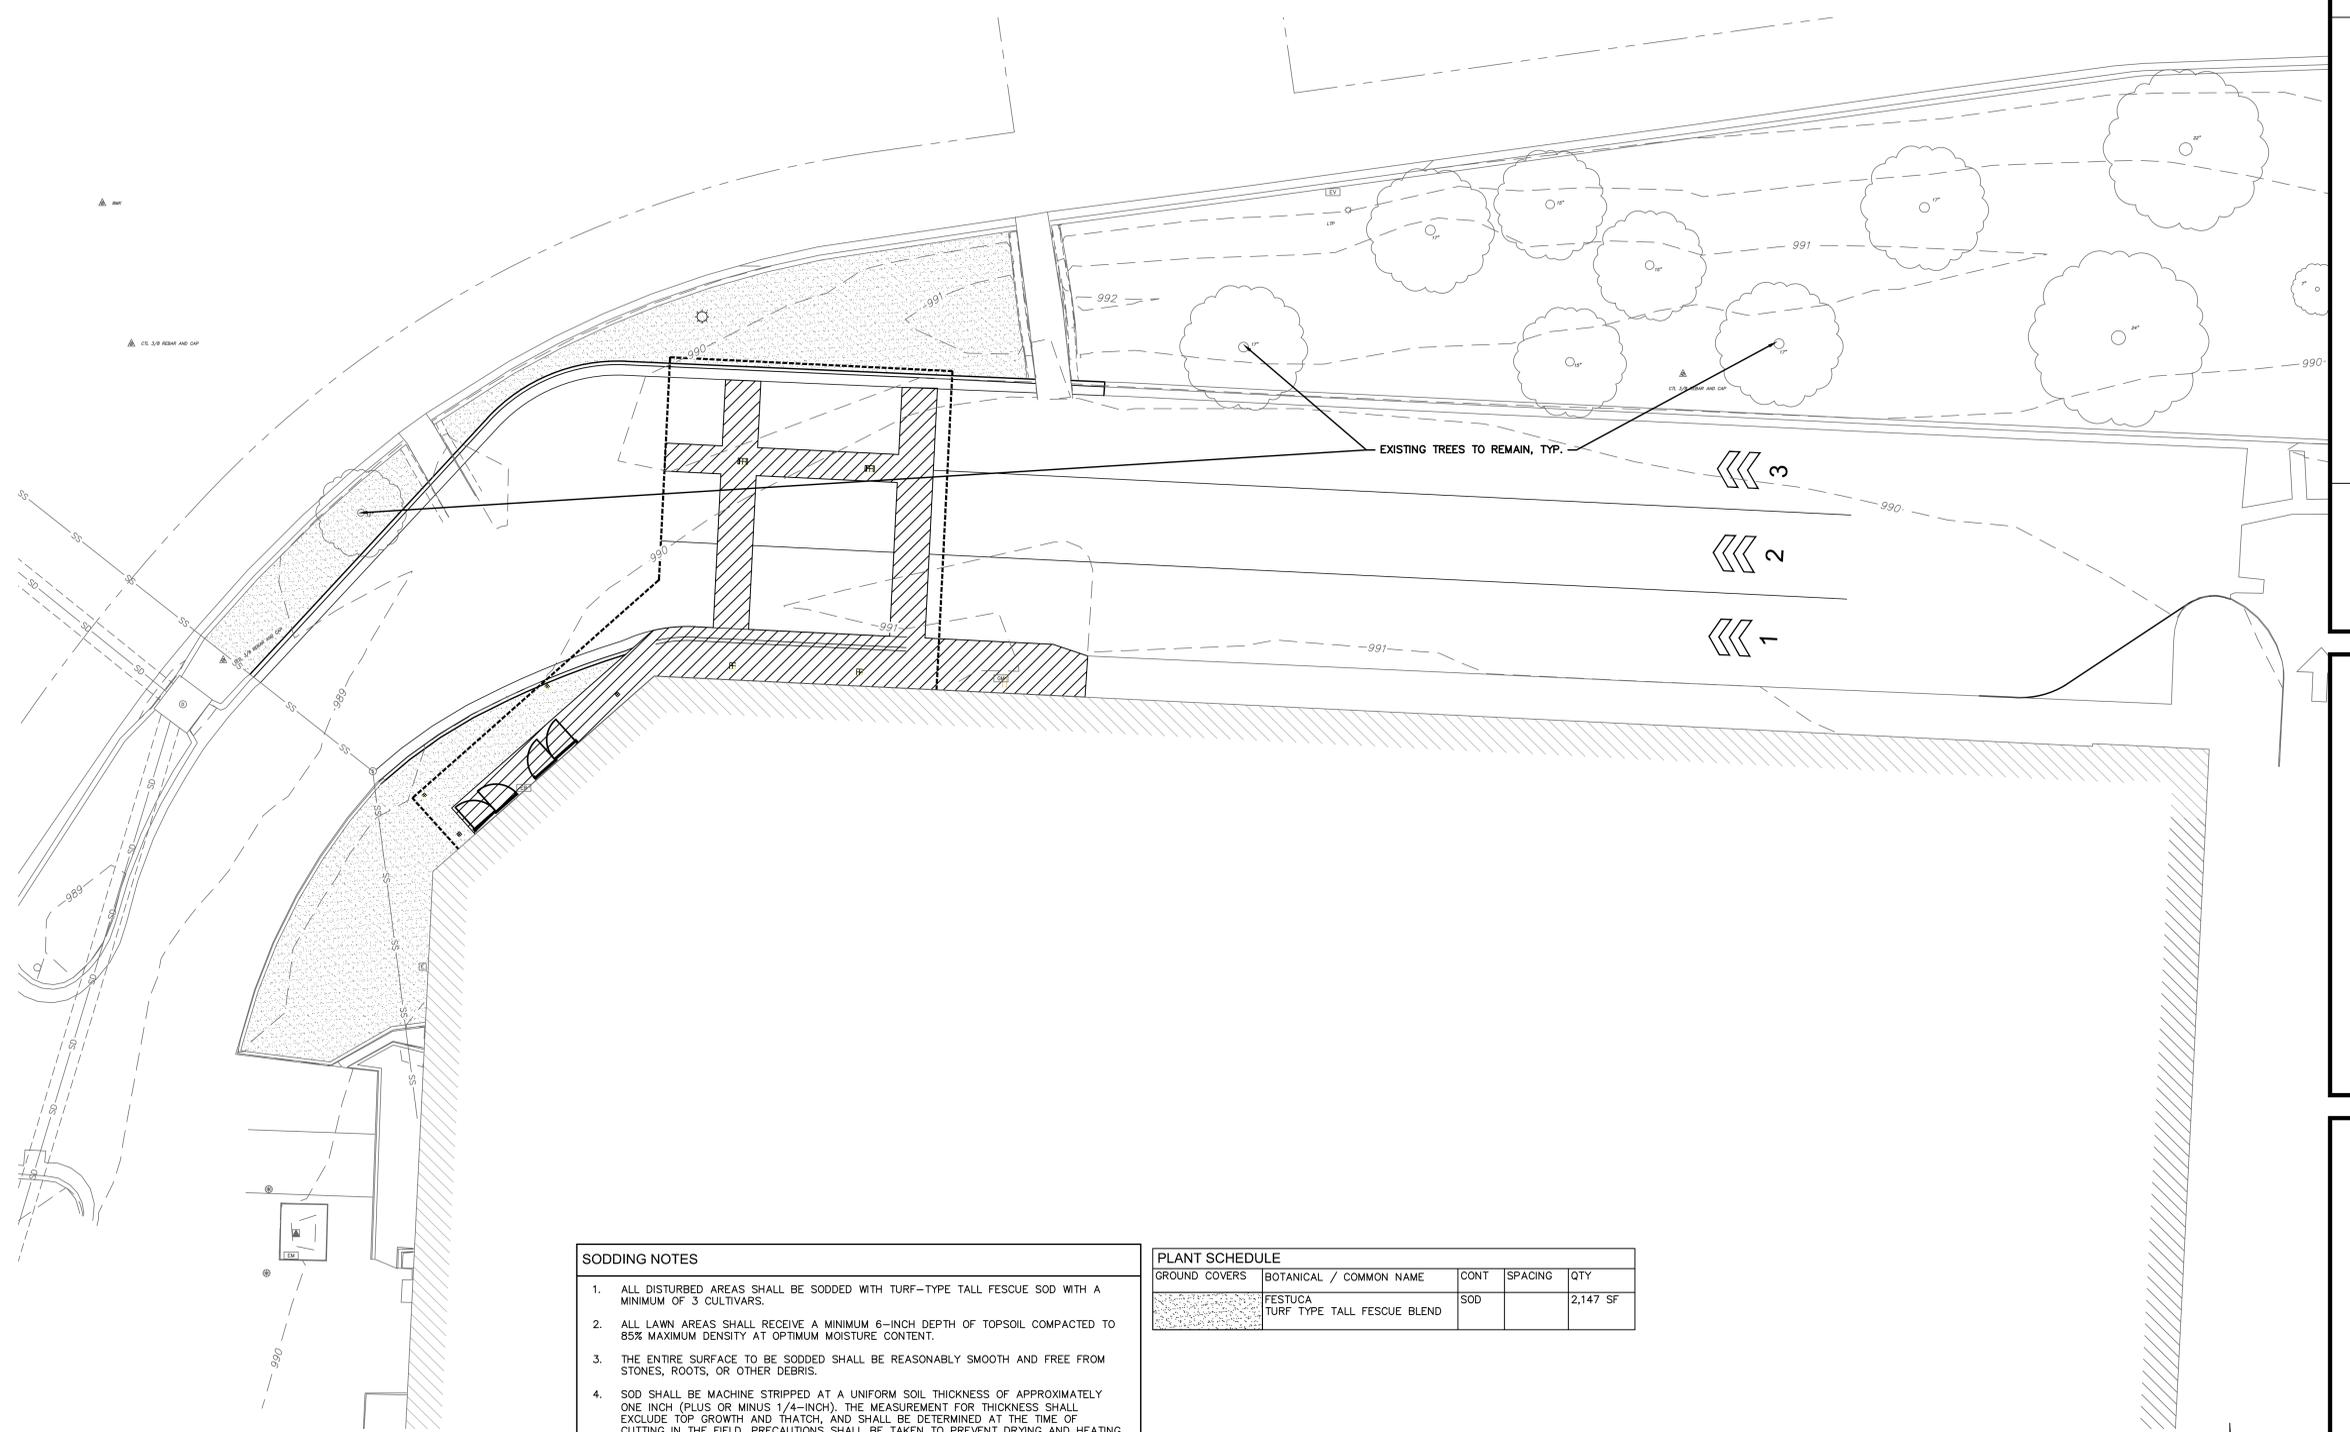

SODDING NOTES

1. ALL DISTURBED AREAS SHALL BE SODDED WITH TURF-TYPE TALL FESCUE SOD WITH A MINIMUM OF 3 CULTIVARS.
2. ALL LAWN AREAS SHALL RECEIVE A MINIMUM 6-INCH DEPTH OF TOPSOIL COMPACTED TO 85% MAXIMUM DENSITY AT OPTIMUM MOISTURE CONTENT.
3. THE ENTIRE SURFACE TO BE SODDED SHALL BE REASONABLY SMOOTH AND FREE FROM STONES, ROOTS, OR OTHER DEBRIS.
4. SOD SHALL BE MACHINE STRIPPED AT A UNIFORM SOIL THICKNESS OF APPROXIMATELY ONE INCH (PLUS OR MINUS 1/4-INCH). THE MEASUREMENT FOR THICKNESS SHALL EXCLUDE TOP GROWTH AND THATCH, AND SHALL BE DETERMINED AT THE TIME OF CUTTING IN THE FIELD. PRECAUTIONS SHALL BE TAKEN TO PREVENT DRYING AND HEATING. SOD DAMAGED BY HEAT AND DRY CONDITIONS, AND SOD CUT MORE THAN 18 HOURS BEFORE BEING INCORPORATED INTO THE WORK SHALL NOT BE USED.
5. HANDLING OF SOD SHALL BE DONE IN A MANNER THAT WILL PREVENT TEARING, BREAKING, DRYING AND OTHER DAMAGE. PROTECT EXPOSED ROOTS FROM DEHYDRATION. DO NOT DELIVER MORE SOD THAN CAN BE LAID WITHIN 24 HOURS.
6. MOISTEN PREPARED SURFACE IMMEDIATELY PRIOR TO LAYING SOD. WATER THOROUGHLY AND ALLOW SURFACE TO DRY BEFORE INSTALLING SOD. FERTILIZE, HARROW OR RAKE FERTILIZER IN THE TOP 1-1/2-INCHES OF TOPSOIL, AT A UNIFORM RATE OF ONE POUND OF NITROGEN PER 1000 SF.
7. BLUEGRASS AND FESCUE SOD MAY BE PLANTED DURING THE PERIODS OF MARCH 1 TO MAY 15 AND SEPTEMBER 1 TO NOVEMBER 15. SOD MAY BE PLANTED DURING THE PERIOD, NOVEMBER 15 TO MARCH 1, WHEN THE SOIL AND SOD IS WORKABLE AND WITH THE APPROVAL OF THE LANDSCAPE ARCHITECT. IF SOD IS PLANTED BETWEEN NOVEMBER 15 AND MARCH 1, THE CONTRACTOR WILL MAINTAIN THE SOD UNTIL 20 DAYS AFTER THE BEGINNING OF THE SPRING SOD SEASON.
8. SOD SHALL BE CAREFULLY PLACED IN THE DIRECTION PARALLEL WITH THE SLOPE OF THE AREA TO BE SODDED. SOD STRIPS SHALL BE BUTTED TOGETHER BUT NOT OVERLAPPED WITH THE SEAMS STAGGERED ON EACH ROW.
9. WHERE THE WIDTH OF THE DISTURBED AREA TO BE SODDED EXCEEDS 18 INCHES, THE AREA SHALL BE WIDENED TO A UNIFORM SIZE BY REMOVING ENOUGH EXISTING TURF FROM BEHIND THE DISTURBED AREA, CREATING AN AREA WHOSE WIDTH IS A MULTIPLE OF 18" (WIDTH OF SOD ROLL) AND CREATE A CLEAN EDGE.
10. FERTILIZER SHALL BE 20-10-5 COMMERCIAL FERTILIZER OF THE GRADE, TYPE, AND FORM SPECIFIED AND SHALL COMPLY WITH THE RULES OF THE STATE OF MISSOURI DEPT. OF AGRICULTURE. FERTILIZER SHALL BE IDENTIFIED ACCORDING TO THE PERCENT N, P, K, IN THAT ORDER.
11. ALL SOD ON SLOPES GREATER THAN 5:1 AND WITHIN DETENTION AREAS SHALL BE STAKED.
12. SATURATE SOD WITH FINE WATER SPRAY WITHIN TWO HOURS OF PLANTING. DURING FIRST WEEK AFTER PLANTING, WATER DAILY OR MORE FREQUENTLY AS NECESSARY TO MAINTAIN MOIST SOIL TO A MINIMUM DEPTH OF FOUR INCHES BELOW SOD.
13. CONTRACTOR SHALL PROVIDE FULL MAINTENANCE FOR SODDED TURF GRASS FOR A PERIOD OF 30 DAYS AFTER THE DATE OF FINAL ACCEPTANCE. AT THE END OF THE MAINTENANCE PERIOD, A HEALTHY, WELL-ROOTED, EVEN-COLORED, VIABLE TURF MUST BE ESTABLISHED. THE TURF GRASS SHALL BE FREE OF WEEDS, OPEN JOINTS, BARE AREAS, AND SURFACE IRREGULARITIES. IMMEDIATELY PRIOR TO ENGINEER'S INSPECTION FOR ACCEPTANCE SOD SHALL BE MOWED.

PLANT SCHEDULE

GROUND COVERS	BOTANICAL / COMMON NAME	CONT	SPACING	QTY
	FESTUCA TURF TYPE TALL FESCUE BLEND	SOD		2,147 SF

REVISION	DATE BY

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HyVee
 EMPLOYEE OWNED


TRUE NORTH PLAN NORTH

LANDSCAPE PLAN

DRAWN: HMO	DATE: 05/20/2021
SCALE: 1" = 10'	SHEET: LS2020-3151

C6.0

REVISION	DATE BY
1	ASJ/KS 01/02/21
2	ASJ/BS 01/02/21
3	ASJ/BS 03/19/21
4	ASJ/RT 04/16/21
5	ASJ/RE 06/16/21

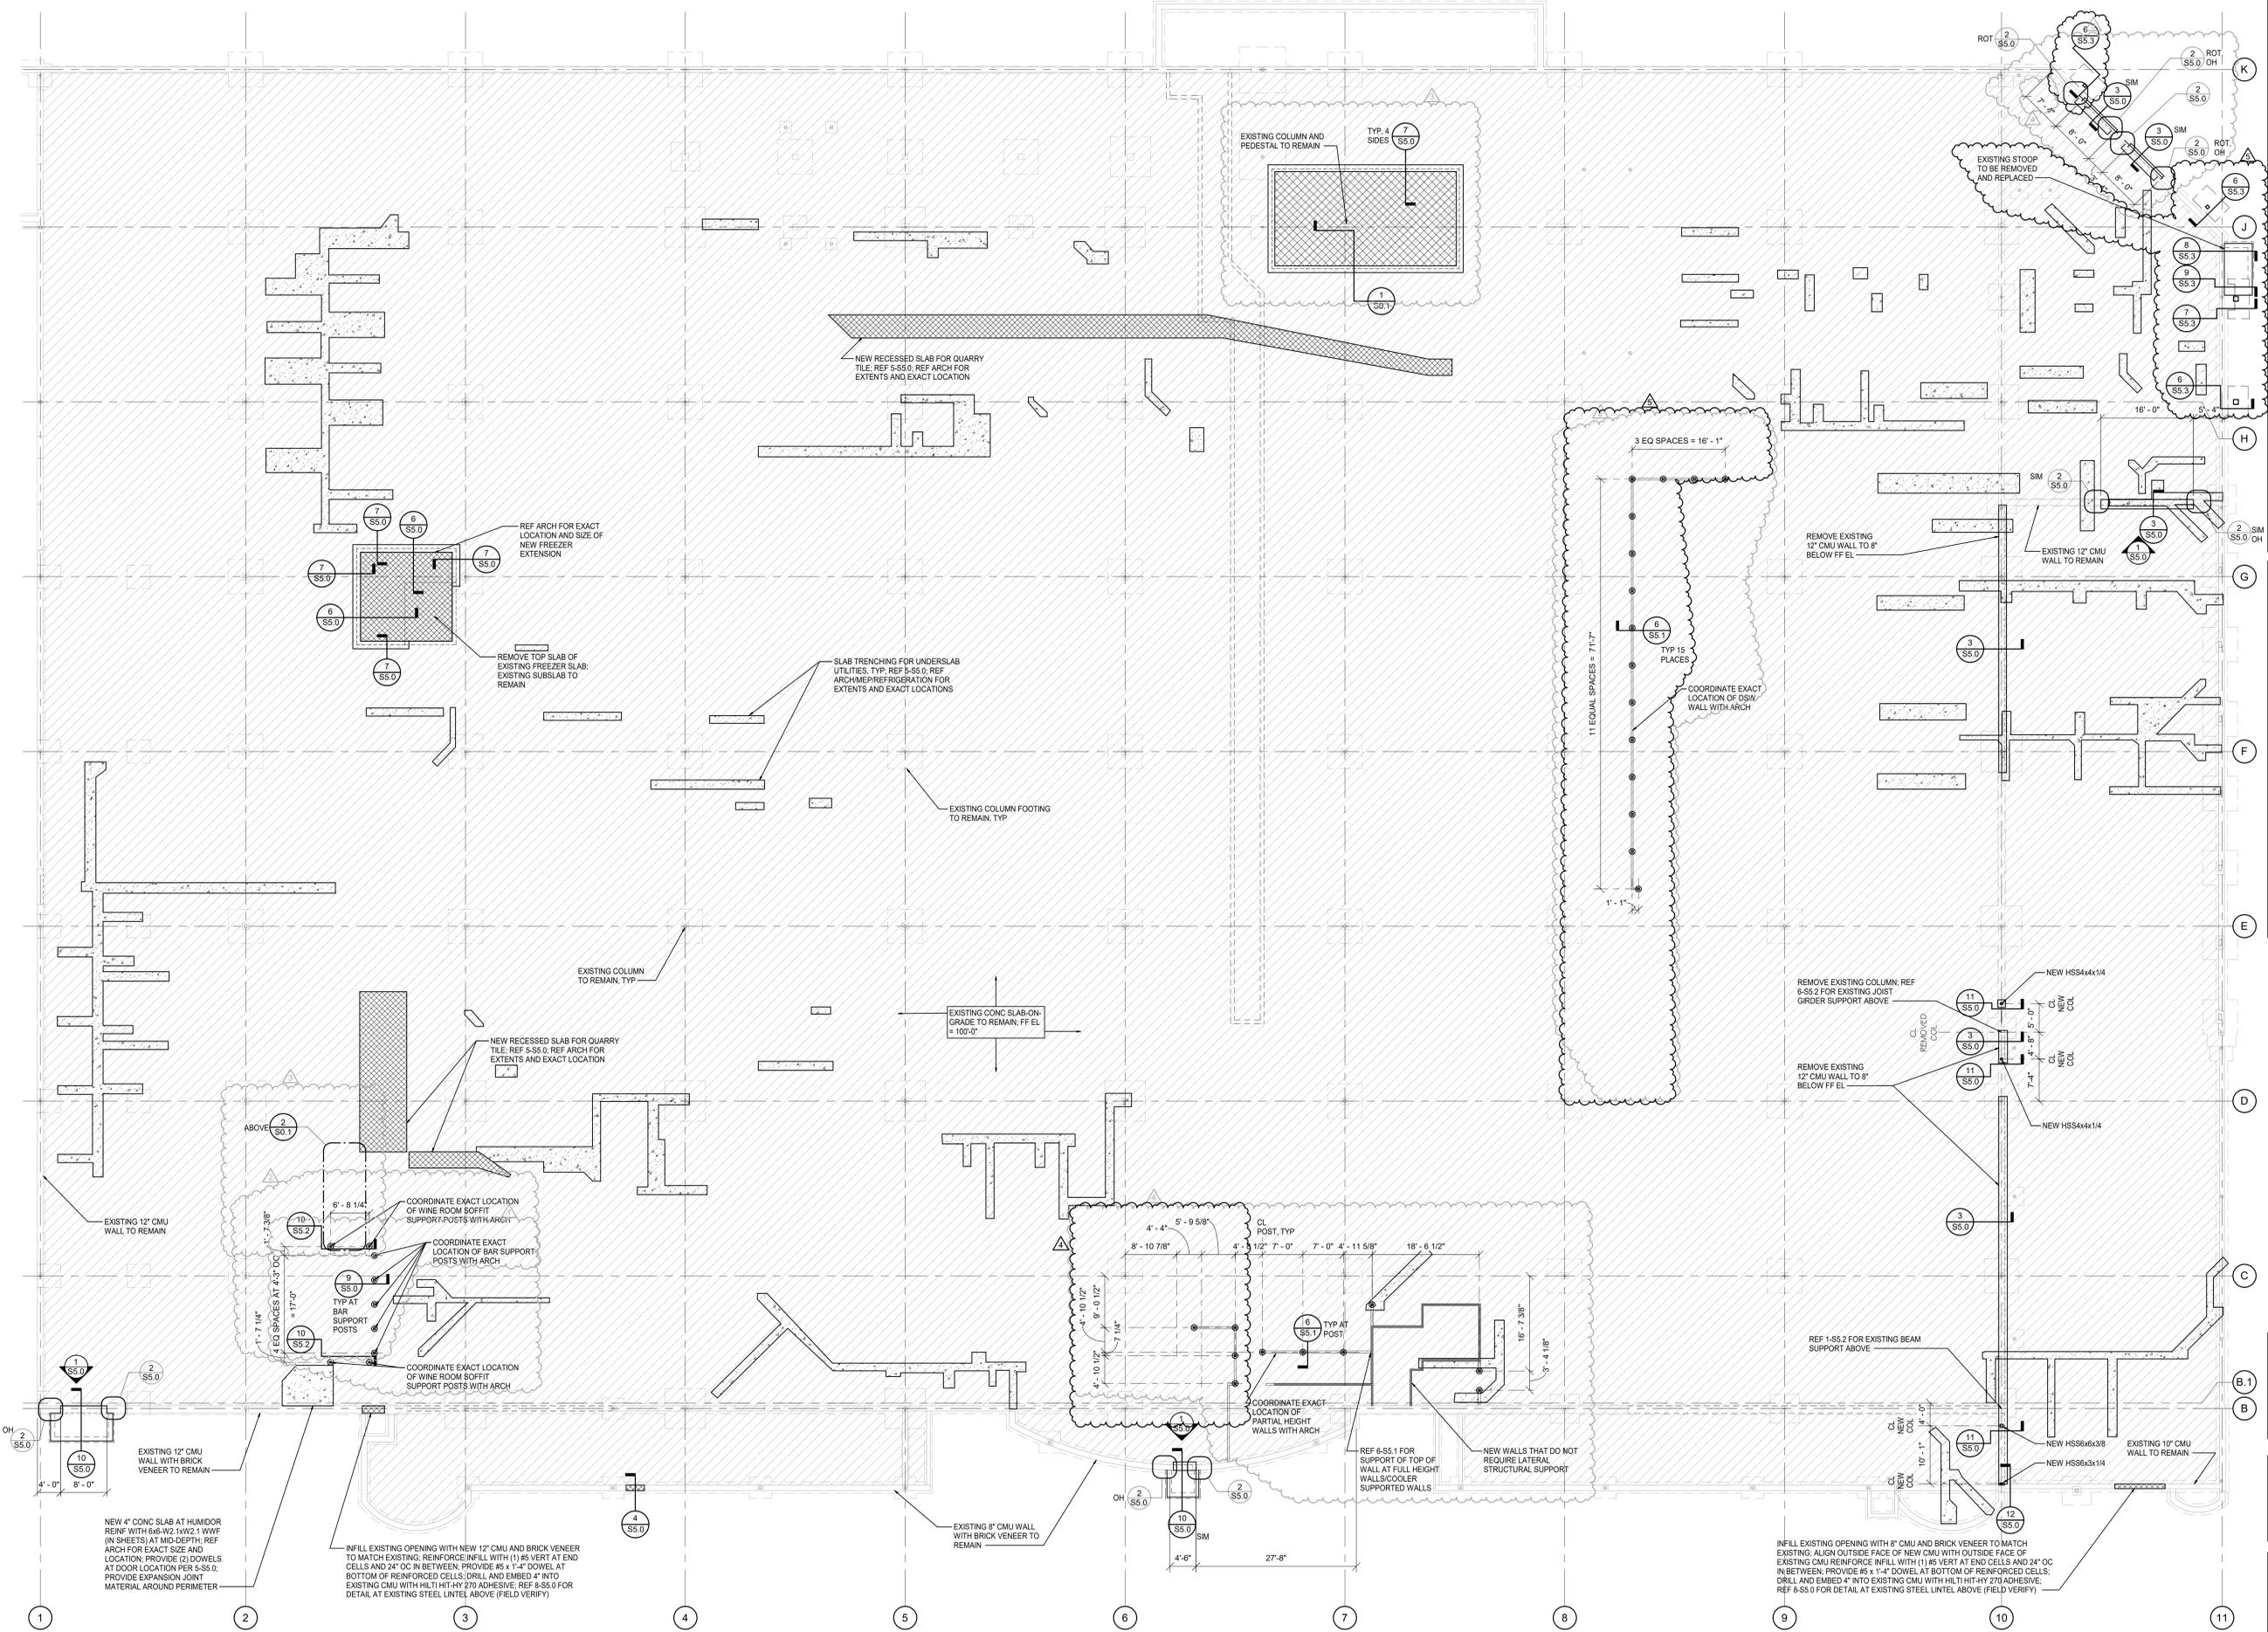


1 FOUNDATION PLAN
SCALE: 3/32" = 1'-0"

JBA JOHNSTON BURKHOLDER ASSOCIATES
consulting structural engineers
590 CENTRAL - KANSAS CITY, MO 64108
816.421.2200 www.jba-usa.com
JBA PROJ # 159315 - 350

PROFESSIONAL SEAL
STATE OF MISSOURI
BART HALVORSON
E-7439
Professional Engineer
05/20/21

LOCATION
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FAX: (515) 267-2636

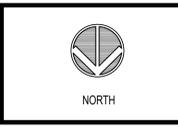

FOUNDATION PLAN

PROJECT MANAGER	CHECKED BY
JSH	BJH
DRAWN BY:	DATE:
JBA	10/20/2020
SCALE:	JOB NUMBER:
3/32" = 1'-0"	20332

SHEET
S1.0


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REVISION		DATE BY
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2	AS:H4	02/02/21
3	AS:H7	04/16/21
4	AS:H8	05/19/21

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 816.421.2200 - www.jba-usa.com
 JBA PROJ # 159315 - 3501

PROFESSIONAL SEAL
 STATE OF MISSOURI
 BART HALVERSON
 LICENSE NO. F-20439
 05/20/21


LOCATION: LEE'S SUMMIT, MO
 HY-VEE INC.
 5820 WESTTOWN PARKWAY
 WEST DES MOINES, IOWA 50386
 (515) 281-2600
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HyVee
 EMPLOYEE OWNED

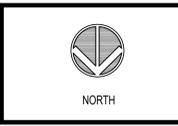


STRUCTURAL SECTIONS & DETAILS

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JSH	Approver
DRAWN BY:	DATE:
Author	10/20/2020
SCALE:	JOB NUMBER:
As indicated	20332


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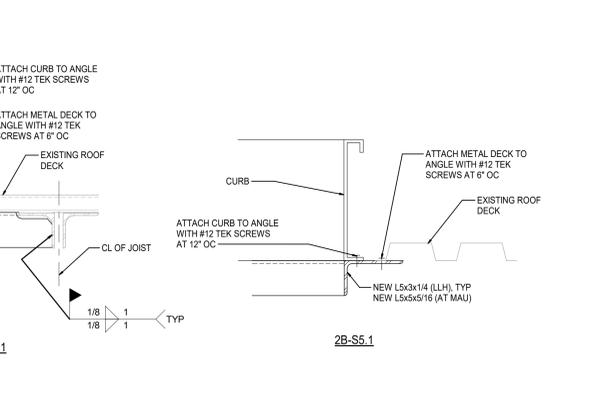
1 SUSPENDED HOOD SUPPORT
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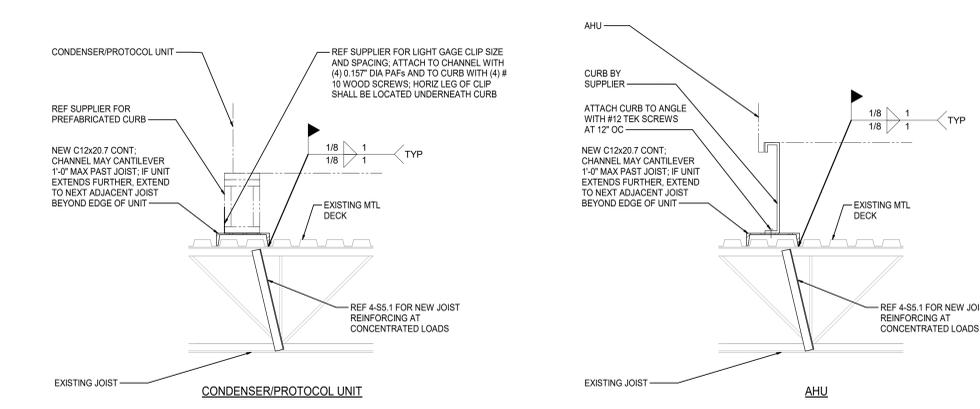
2 RTU/EXHAUST FAN SUPPORT FRAMING
 SCALE: NTS

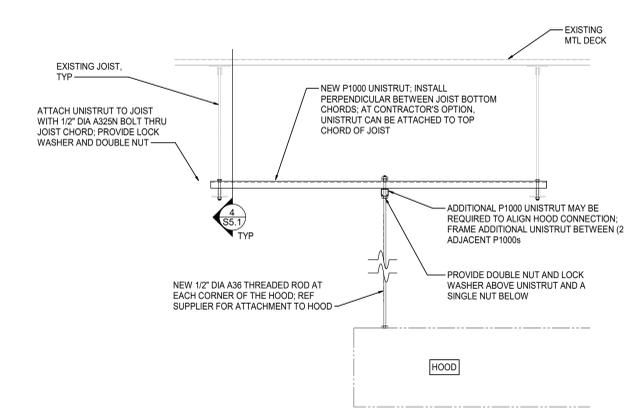


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2B-S5.1

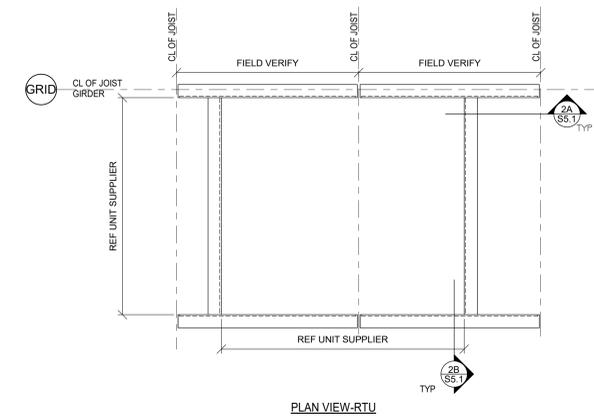

2A-S5.1
2B-S5.1

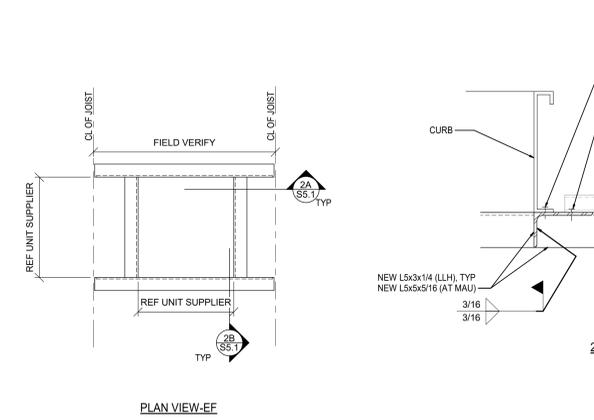


3 CONDENSER/PROTOCOL UNIT/AHU SUPPORT FRAMING
 SCALE: 3/4" = 1'-0"

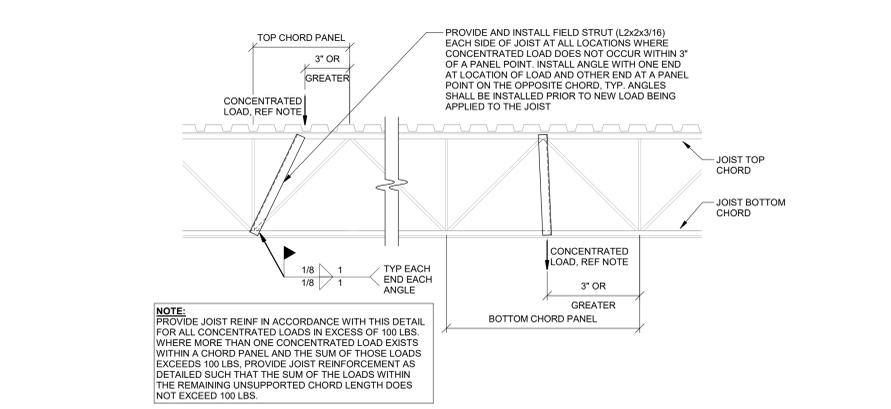

4 JOIST REINFORCING AT CONCENTRATED LOAD
 SCALE: 3/4" = 1'-0"



SECTION 5A - WEB REINF
SECTION 5B - CHORD REINF
SECTION 5C - CHORD REINF SPLICE
SECTION 5D - END WEB REINF

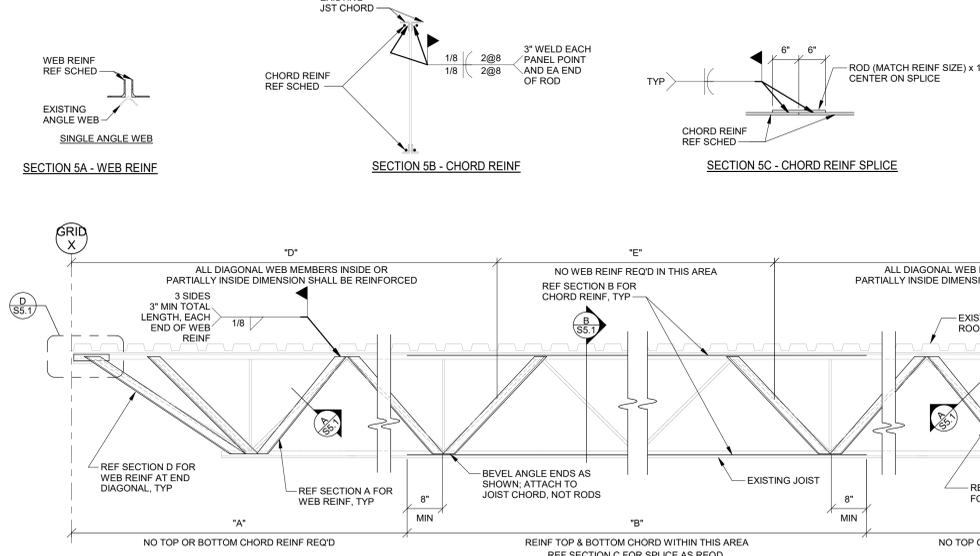


5 JOIST REINFORCEMENT
 SCALE: 3/4" = 1'-0"

JOIST REINFORCEMENT NOTES


- JOIST WEB CONFIGURATION IS SHOWN FOR REFERENCE ONLY. FIELD VERIFY ACTUAL CONFIGURATION AND WEB TYPE.
- ALL PAINT AND DEBRIS SHALL BE CLEANED FROM JOIST BEFORE WELDING REINFORCEMENT.
- STEEL ERECTOR SHALL FIELD CUT REINFORCING TO FIT FROM STOCK LENGTHS.
- EXTEND TOP AND BOTTOM CHORD REINFORCING A MINIMUM OF 8" BEYOND PANEL POINTS.
- INSTALL WEB REINFORCING PRIOR TO CHORD REINFORCING. COPE OUTSTANDING LEG OF WEB REINFORCING AS REQUIRED FOR PLACEMENT OF CHORD REINFORCING.
- IF EXISTING JOIST BRIDGING INTERFERES WITH INSTALLATION OF REINFORCING, REMOVE BRIDGING AND REPLACE IMMEDIATELY UPON COMPLETION OF REINFORCING INSTALLATION. IF BRIDGING TABS FOR BOLTED BRIDGING INTERFERE WITH INSTALLATION OF REINFORCING, REMOVE TABS AND REPLACE IMMEDIATELY UPON COMPLETION OF REINFORCING INSTALLATION. NEW CONNECTIONS SHALL MATCH EXISTING.
- JOISTS SHALL BE REINFORCED PRIOR TO INSTALLATION OF MECHANICAL UNITS OR HANGING LOADS. ROOF SNOW LOAD SHALL BE REMOVED PRIOR TO JOIST REINFORCEMENT. REF 4-S5.1 FOR ADDITIONAL REINFORCEMENT REQUIRED AT CONCENTRATED LOADS.

JOIST MARK	CHORD REINF	WEB REINF	"A"	"B"	"C"	"D"	"E"	"F"	GRID X	GRID Y	NOTES
JR1	-	(2) L2x2x3/16	0'-0"	0'-0"	0'-0"	10'-0"	0'-0"	0'-0"	E	F	1,2,3,6,7
JR2	-	(2) L2x2x3/16	0'-0"	0'-0"	0'-0"	10'-0"	0'-0"	0'-0"	F	E	1,2,3,6,7
JR3	-	(2) L2x2x3/16	0'-0"	0'-0"	0'-0"	10'-0"	0'-0"	0'-0"	G	F	1,2,3,6,7
JR4	-	(2) L2x2x3/16	0'-0"	0'-0"	0'-0"	13'-0"	0'-0"	0'-0"	B,1	D	1,2,3,6,7
JR5	(2) 1/2" DIA RODS	(2) L2x2x3/16	6'-0"	18'-6"	6'-0"	14'-6"	1'-6"	14'-6"	H	J	1,2,3,4,5,6,7

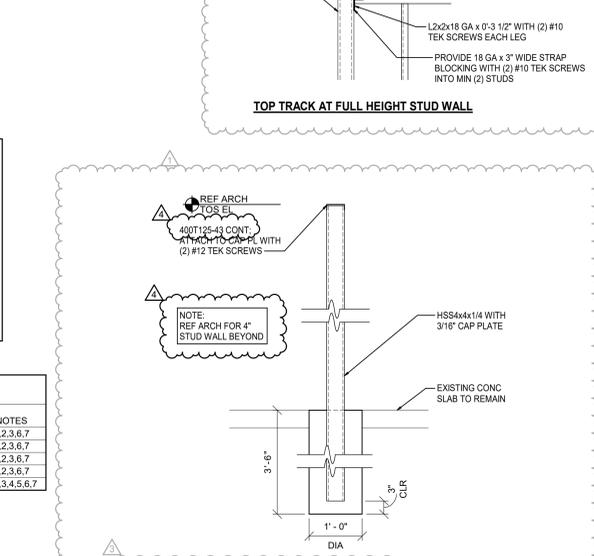


6 DSW/PARTIAL HEIGHT WALL SUPPORT POST
 SCALE: 3/4" = 1'-0"


REVISION		DATE BY
1	ADD #7	04/16/21
2	ADD #8	04/16/21

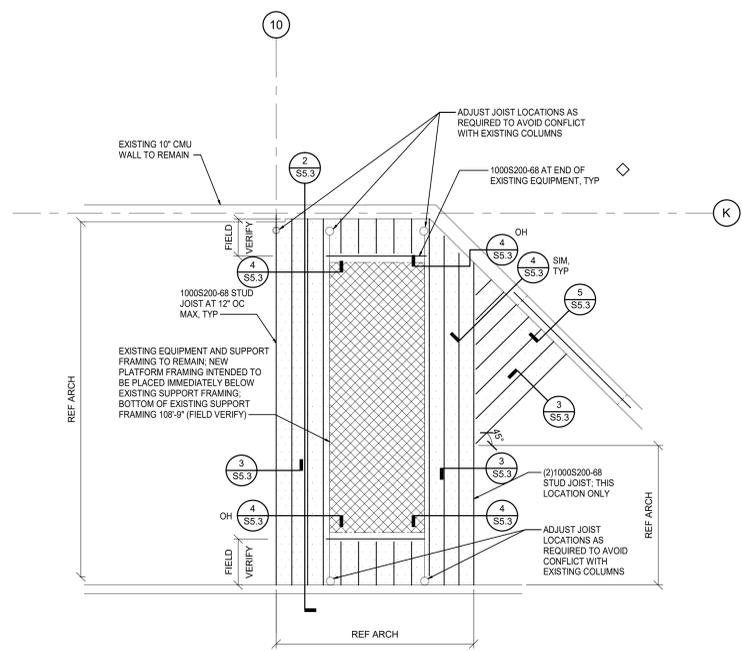

1 PLATFORM FRAMING PLAN
SCALE: 1/4" = 1'-0"

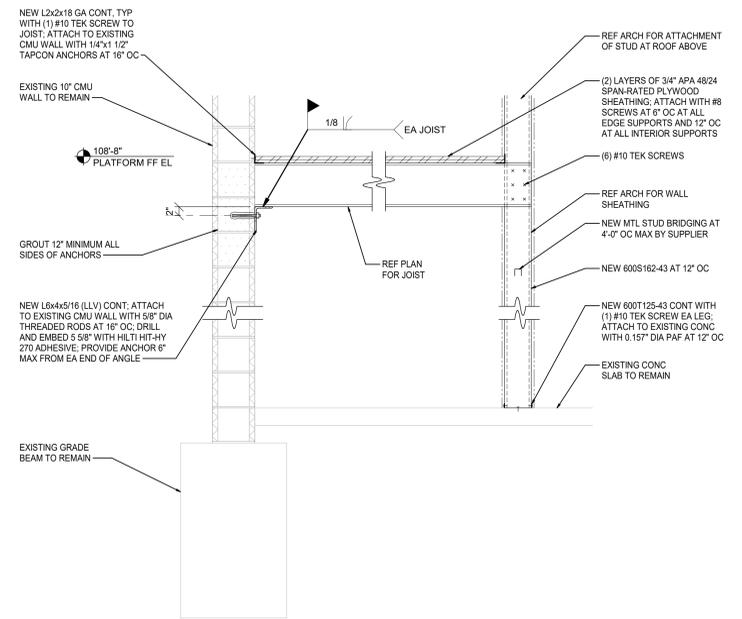


2 PLATFORM FRAMING
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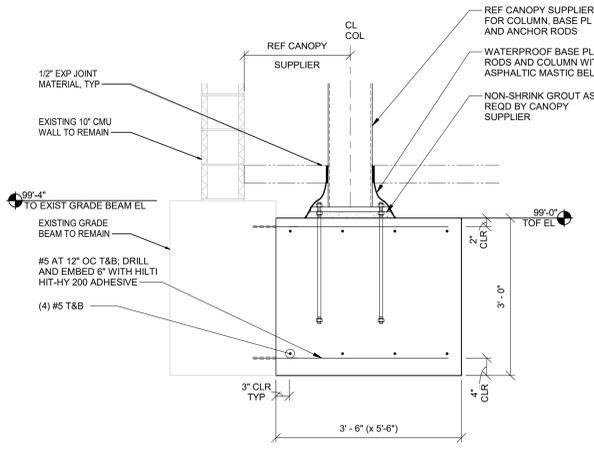


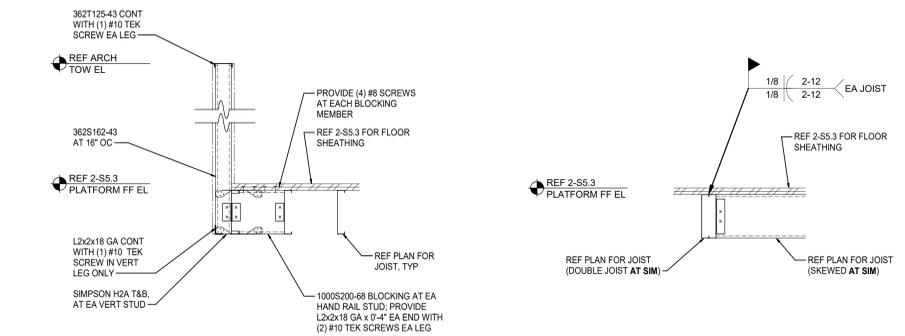3 PLATFORM HAND RAIL
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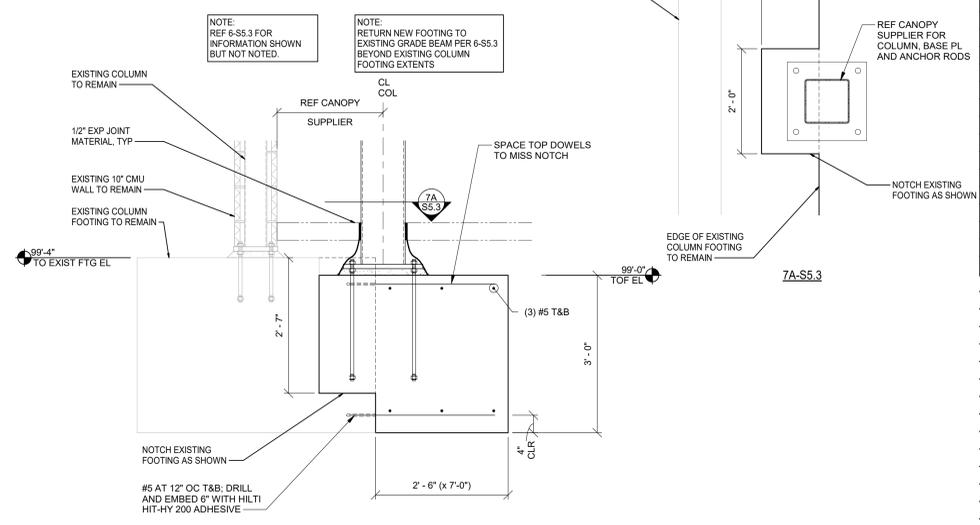
4 PLATFORM FRAMING
SCALE: 3/4" = 1'-0"




5 PLATFORM FRAMING
SCALE: 3/4" = 1'-0"

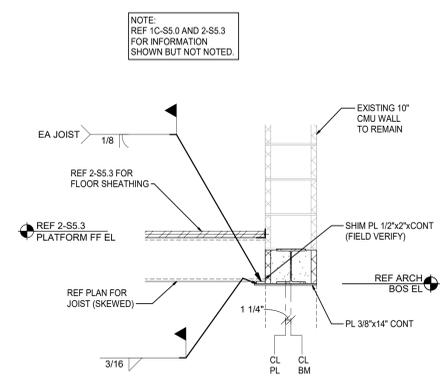


6 AOL CANOPY COLUMN FOOTING
SCALE: 3/4" = 1'-0"



7 AOL CANOPY COLUMN FOOTING
SCALE: 3/4" = 1'-0"

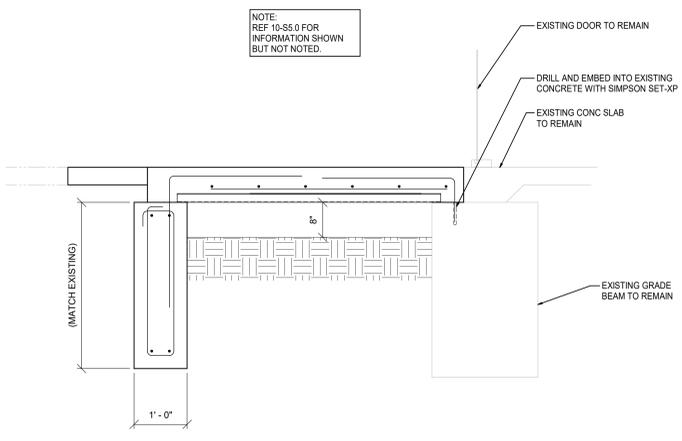

8 FOUNDATION AT STOOP
SCALE: 3/4" = 1'-0"

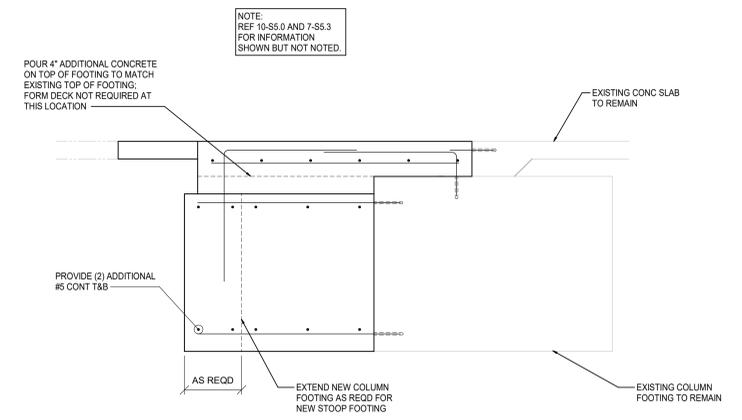


9 STOOP AT NEW FOOTING
SCALE: 3/4" = 1'-0"

JBA JOHNSTON BURKHOLDER ASSOCIATES
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JBA PROJ # 159315 - 350

PROFESSIONAL SEAL
STATE OF MISSOURI
BART HALVORSON
NUMBER E-94439
05/20/21

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EMPLOYEE OWNED

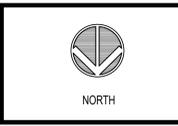

STRUCTURAL SECTIONS & DETAILS

PROJECT MANAGER JSH	CHECKED BY Approver
DRAWN BY Author	DATE 10/20/2020
SCALE As indicated	JOB NUMBER 20332


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5/20/2021 2:45:27 PM

REVISION	DATE BY
2 ASI #2	01/02/21
4 ASI #5	01/12/21
6 ASI #7	04/16/21
7 ASI #8	05/19/21

NOTE: WHERE JUST A PORTION OF A COOLER/FREEZER BOX OR COOLER/FREEZER BOX DOOR IS TO BE REMOVED, THE PARTIAL REMOVAL AND BOTH THE TEMPORARY AND PERMANENT SUPPORT OF THE EXISTING COOLER/FREEZER BOX CEILING ABOVE IS TO BE BY THE REFRIGERATION CONTRACTOR.

- DEMOLITION NOTES**
- 1 REMOVE WALL IN ITS ENTIRETY. PATCH/REPAIR EXISTING ADJACENT SURFACES TO RECEIVE NEW FINISHES.
 - 2 REMOVE FIXTURE IN ITS ENTIRETY. CAP ALL ABANDONED UTILITIES. CONTRACTOR TO VERIFY WITH HY-VEE IF REMOVED EQUIPMENT IS TO BE SALVAGED.
 - 3 REMOVE DOOR AND FRAME IN ITS ENTIRETY.
 - 4 REMOVE COOLER/FREEZER WALLS, CEILINGS, FLOOR AND DOORS IN THEIR ENTIRETY, UNLESS NOTED OTHERWISE.
 - 5 REMOVE PORTION OF CMU WALL, REF STRUC.
 - 6 REMOVE COLUMN, REF STRUC.
 - 7 REMOVE PORTION OF COOLER/FREEZER WALL SHOWN DASHED
 - 8 REMOVE ANY EXIT SIGNAGE ON, ABOVE, OR AROUND DOOR AS THIS DOOR WILL NO LONGER BE DESIGNATED AS AN EMERGENCY EGRESS DOOR. ANY ALARM SYSTEM AND HARDWARE ARE TO REMAIN INTACT.
 - 9 REMOVE PORTION OF EXISTING WALL AS SHOWN IN DASHED LINES & PREP. FOR NEW WORK.

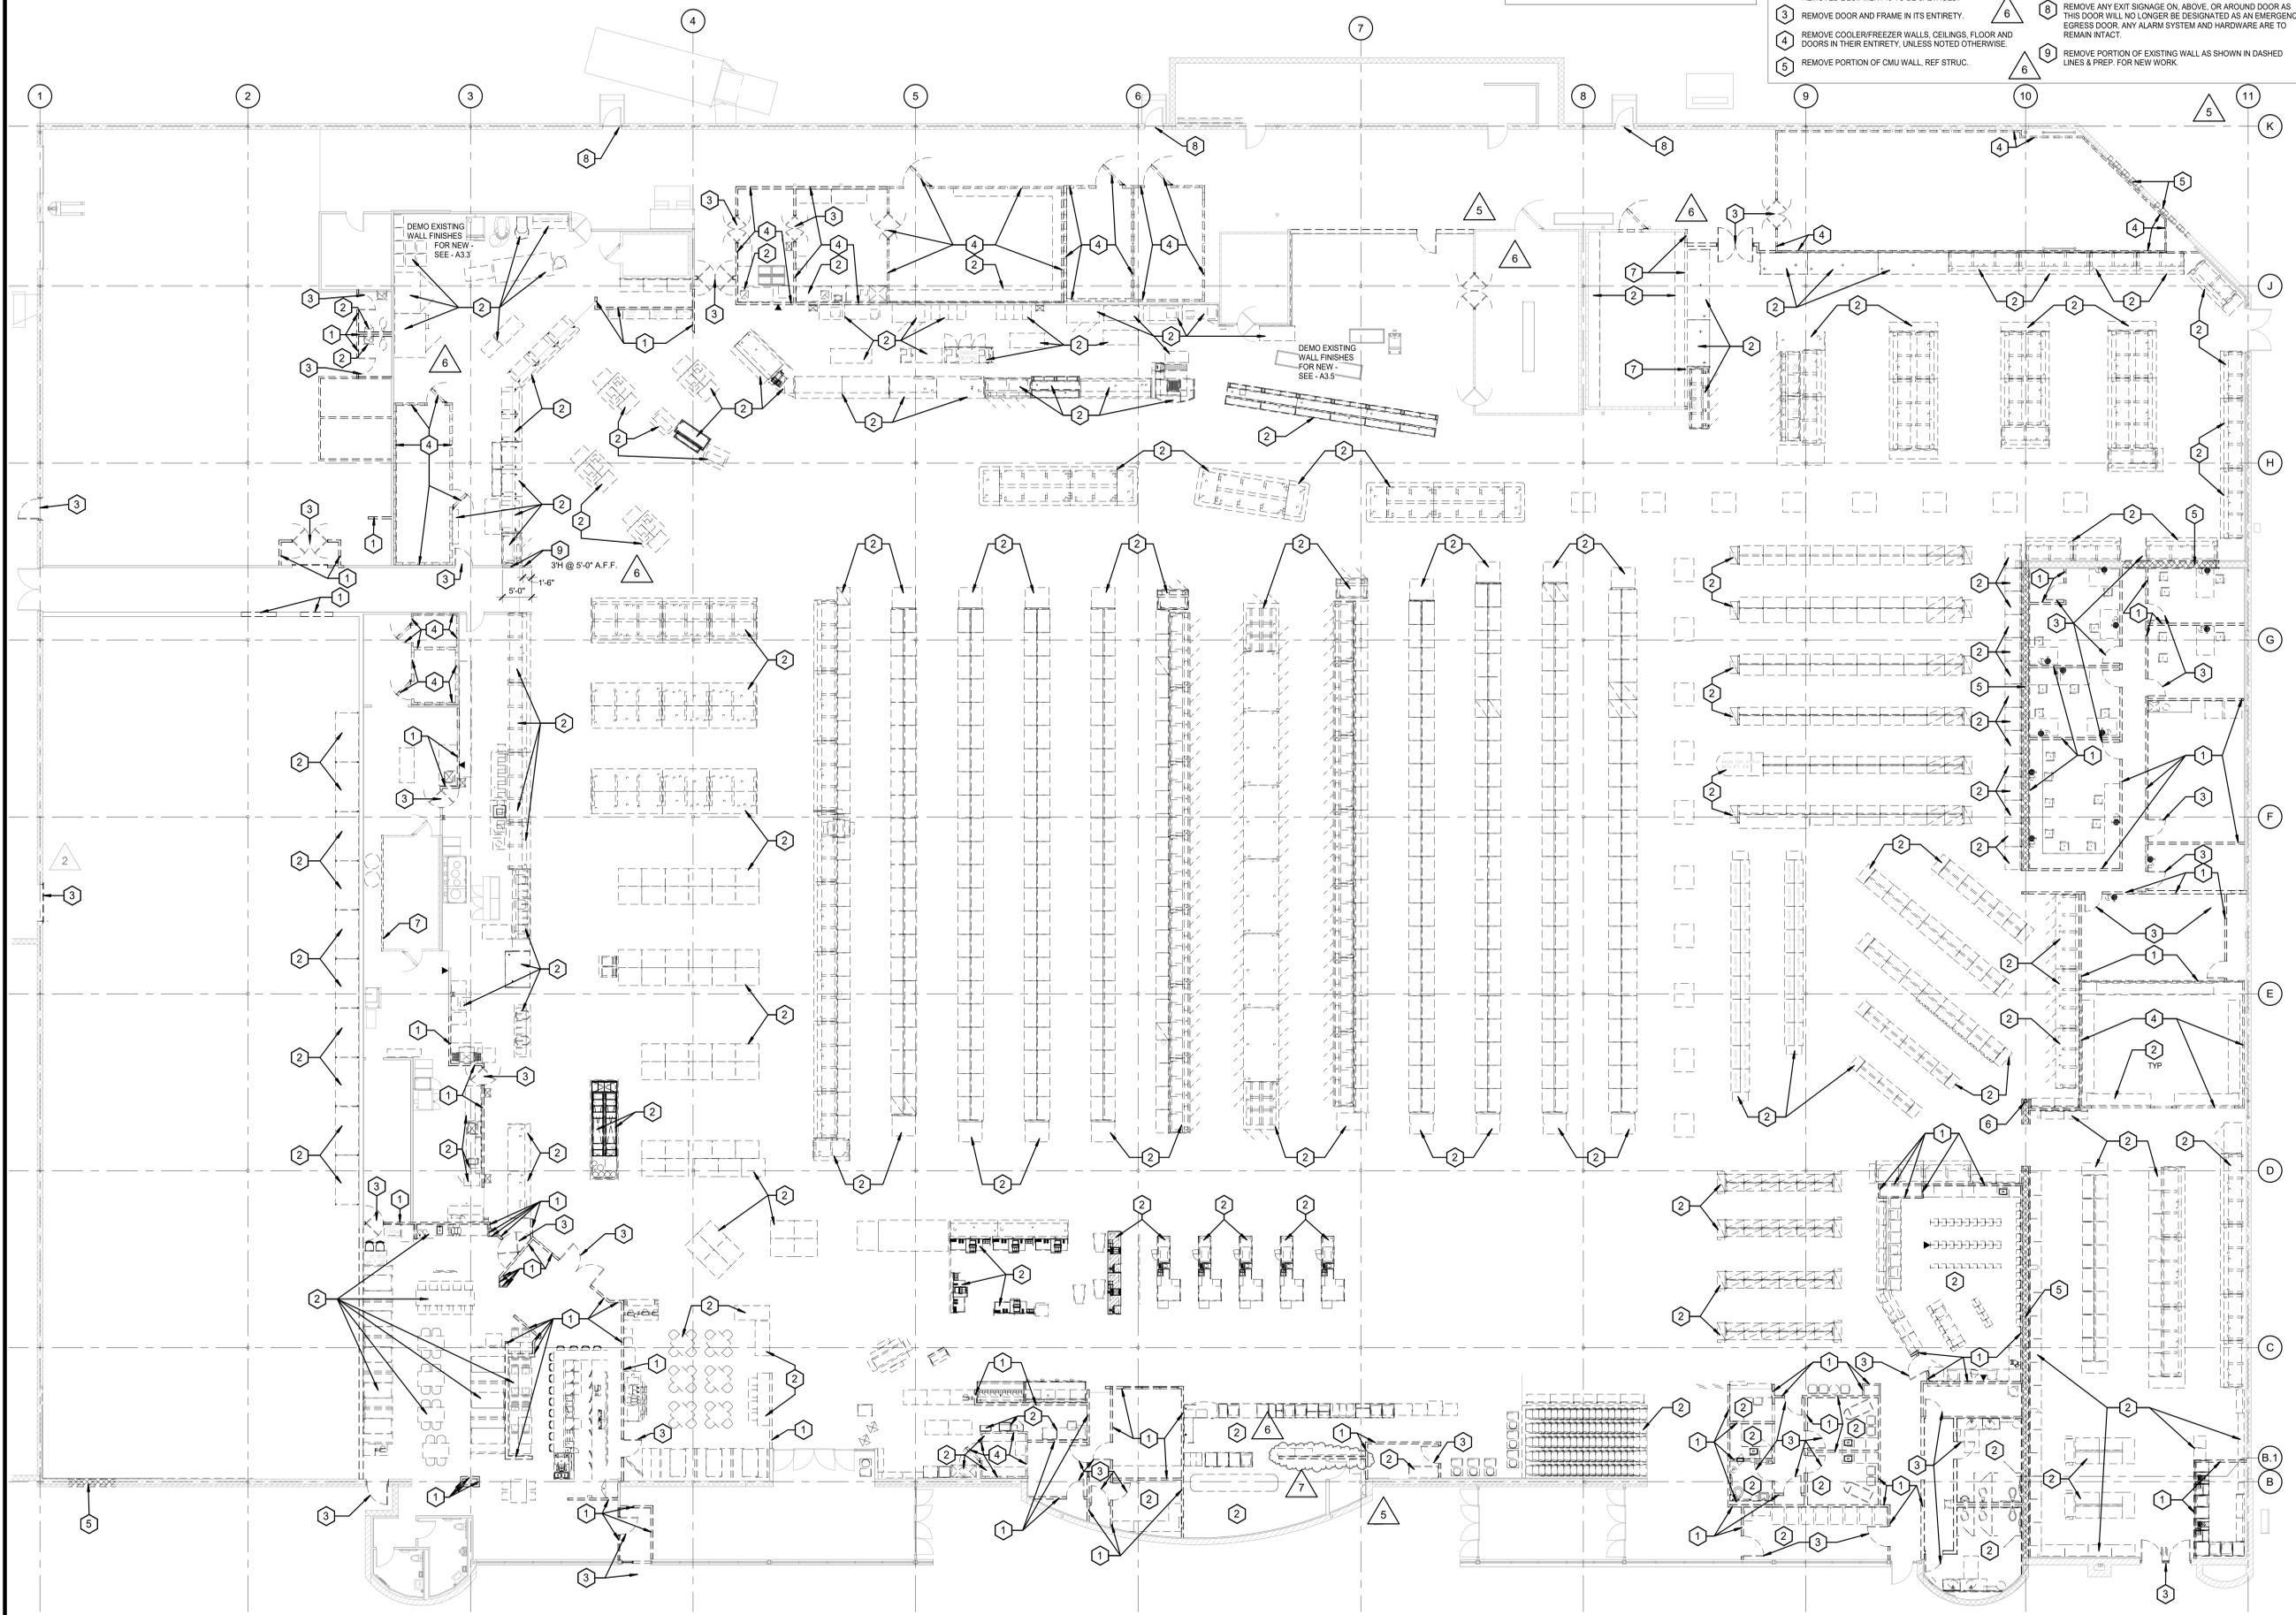

1 DEMOLITION PLAN
SCALE: 3/32" = 1'-0"

5/19/2021 2:55:59 PM

brr

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PROFESSIONAL SEAL


STATE OF MISSOURI
RICHARD A. MAJORS, JR.
NUMBER 207281
EXPIRES 12/31/2021

Richard A. Majors, Jr.
Architect
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Hy-Vee
EMPLOYEE OWNED




**ARCHITECTURAL
DEMOLITION PLAN**

PROJECT MANAGER SB	CHECKED BY JPS
DRAWN BY	DATE 3/19/2021
SCALE As indicated	JOB NUMBER 62930547
SHEET	

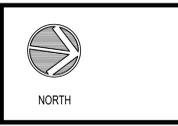AD1.0

REVISION	DATE BY
1 ASI#1	11/20/21
2 ASI#2	01/26/22
3 ASI#3	02/02/22
4 ASI#4	03/16/22
5 ASI#5	04/16/22
6 ASI#7	04/16/22
7 ASI#8	05/19/21

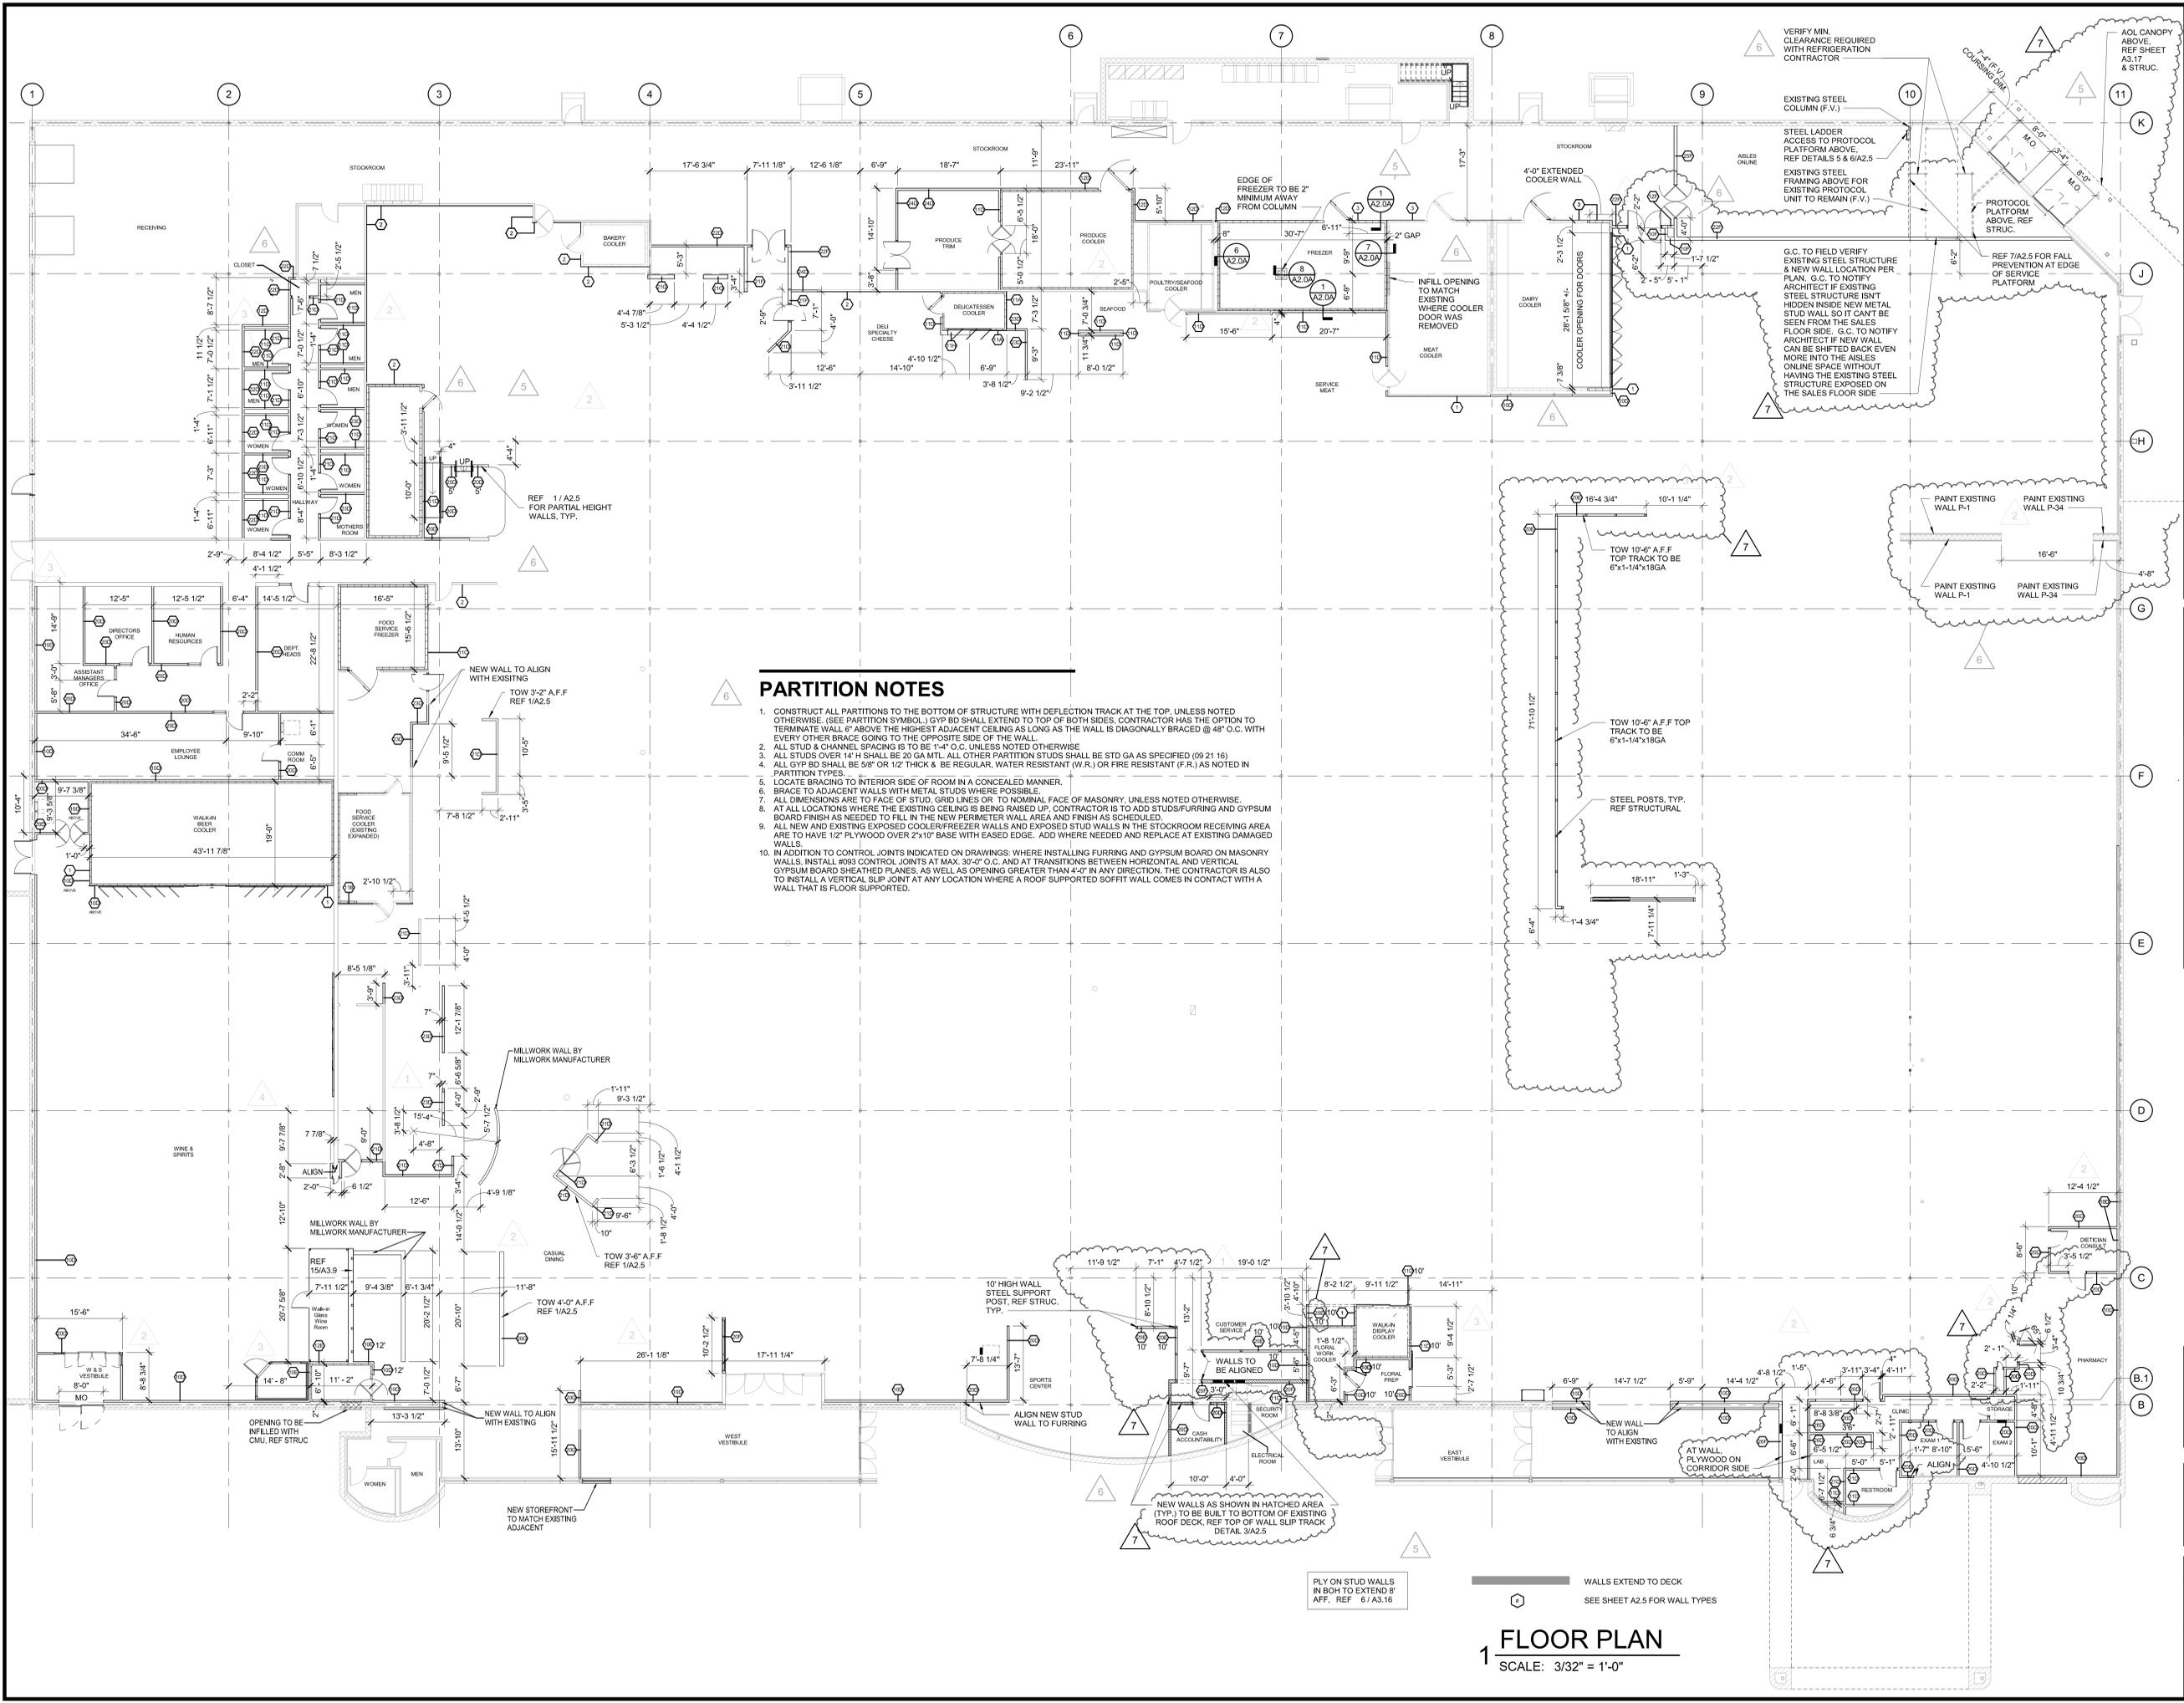

PARTITION NOTES

1. CONSTRUCT ALL PARTITIONS TO THE BOTTOM OF STRUCTURE WITH DEFLECTION TRACK AT THE TOP, UNLESS NOTED OTHERWISE. (SEE PARTITION SYMBOL) GYP BD SHALL EXTEND TO TOP OF BOTH SIDES, CONTRACTOR HAS THE OPTION TO TERMINATE WALL 6" ABOVE THE HIGHEST ADJACENT CEILING AS LONG AS THE WALL IS DIAGONALLY BRACED @ 45° O.C. WITH EVERY OTHER BRACE GOING TO THE OPPOSITE SIDE OF THE WALL.
2. ALL STUD & CHANNEL SPACING IS TO BE 1'-4" O.C. UNLESS NOTED OTHERWISE.
3. ALL STUDS OVER 1/4" H SHALL BE 20 GA MTL. ALL OTHER PARTITION STUDS SHALL BE STD GA AS SPECIFIED (09 21 16)
4. ALL GYP BD SHALL BE 5/8" OR 1/2" THICK & BE REGULAR, WATER RESISTANT (W.R.) OR FIRE RESISTANT (F.R.) AS NOTED IN PARTITION TYPES.
5. LOCATE BRACING TO INTERIOR SIDE OF ROOM IN A CONCEALED MANNER.
6. BRACE TO ADJACENT WALLS WITH METAL STUDS WHERE POSSIBLE.
7. ALL DIMENSIONS ARE TO FACE OF STUD, GRID LINES OR TO NOMINAL FACE OF MASONRY, UNLESS NOTED OTHERWISE.
8. AT ALL LOCATIONS WHERE THE EXISTING CEILING IS BEING RAISED UP, CONTRACTOR IS TO ADD STUDS/FURRING AND GYPSUM BOARD FINISH AS NEEDED TO FILL IN THE NEW PERIMETER WALL AREA AND FINISH AS SCHEDULED.
9. ALL NEW AND EXISTING EXPOSED COOLER/FREEZER WALLS AND EXPOSED STUD WALLS IN THE STOCKROOM RECEIVING AREA ARE TO HAVE 1/2" PLYWOOD OVER 2x10" BASE WITH EASED EDGE. ADD WHERE NEEDED AND REPLACE AT EXISTING DAMAGED WALLS.
10. IN ADDITION TO CONTROL JOINTS INDICATED ON DRAWINGS, WHERE INSTALLING FURRING AND GYPSUM BOARD ON MASONRY WALLS, INSTALL #83 CONTROL JOINTS AT MAX. 30'-0" O.C. AND AT TRANSITIONS BETWEEN HORIZONTAL AND VERTICAL GYPSUM BOARD SHEATHED PLANES, AS WELL AS OPENING GREATER THAN 4'-0" IN ANY DIRECTION. THE CONTRACTOR IS ALSO TO INSTALL A VERTICAL SLIP JOINT AT ANY LOCATION WHERE A ROOF SUPPORTED SOFFIT WALL COMES IN CONTACT WITH A WALL THAT IS FLOOR SUPPORTED.

VERIFY MIN. CLEARANCE REQUIRED WITH REFRIGERATION CONTRACTOR

EXISTING STEEL COLUMN (F.V.)


STEEL LADDER ACCESS TO PROTOCOL PLATFORM ABOVE, REF SHEET A3.17 & STRUC.

EXISTING STEEL FRAMING ABOVE FOR UNIT TO REMAIN (F.V.)

PROTOCOL PLATFORM ABOVE, REF STRUC.

REF 7/A2.5 FOR FALL PREVENTION AT EDGE OF SERVICE PLATFORM

G.C. TO FIELD VERIFY EXISTING STEEL STRUCTURE & NEW WALL LOCATION PER PLAN. G.C. TO NOTIFY ARCHITECT IF EXISTING STEEL STRUCTURE ISN'T HIDDEN INSIDE NEW METAL STUD WALL SO IT CAN'T BE SEEN FROM THE SALES FLOOR SIDE. G.C. TO NOTIFY ARCHITECT IF NEW WALL CAN BE SHIFTED BACK EVEN MORE INTO THE AISLES ONLINE SPACE WITHOUT HAVING THE EXISTING STEEL STRUCTURE EXPOSED ON THE SALES FLOOR SIDE.

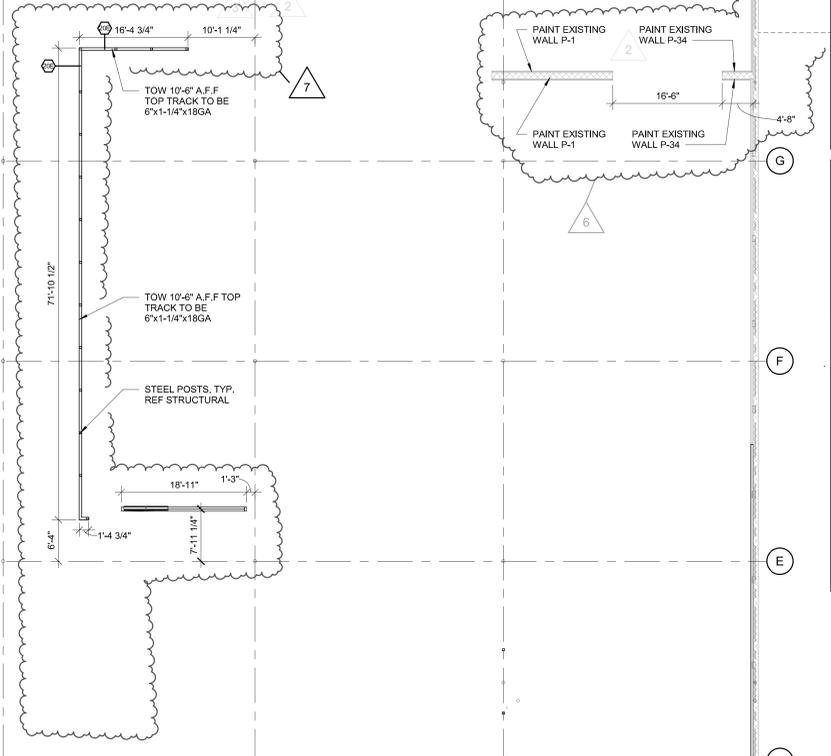

PLY ON STUD WALLS IN BOH TO EXTEND 8" AFF. REF 6/A3.16

WALLS EXTEND TO DECK


SEE SHEET A2.5 FOR WALL TYPES

1 FLOOR PLAN

SCALE: 3/32" = 1'-0"




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FLOOR PLAN

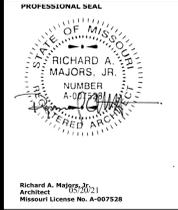PROJECT MANAGER	CHECKED BY
SB	JPS
DRAWN BY: AO	DATE: 3/19/2021
SCALE: 3/32" = 1'-0"	DWG NUMBER: 62930547
SHEET:	A1.0


LEGEND

- FLOOR DESIGNATED IN THIS AREA AS QUARRY TILE. SEE FLOOR FINISH PLAN FOR SPECIFIC FLOORING DESIGNATION. CONTRACTOR TO VERIFY DEPTH OF FLOOR FINISH MATERIAL. CUT CONTROL JOINTS @ 15' O.C. MAXIMUM EACH DIRECTION.
- FLOOR DESIGNATED IN THIS AREA AS EPOXY FLOOR. SEE FLOOR FINISH PLAN FOR SPECIFIC FLOORING DESIGNATION. CONTRACTOR TO VERIFY DEPTH OF FLOOR FINISH MATERIAL. CUT CONTROL JOINTS @ 12' O.C. MAXIMUM EACH DIRECTION.
- FLOOR DESIGNATED IN THIS AREA AS CARPET. SEE FLOOR FINISH PLAN FOR SPECIFIC FLOORING DESIGNATION. CONTRACTOR TO VERIFY DEPTH OF FLOOR FINISH MATERIAL.
- FLOOR DESIGNATED IN THIS AREA AS LVT. SEE FLOOR FINISH PLAN FOR SPECIFIC FLOORING DESIGNATION. CONTRACTOR TO VERIFY DEPTH OF FLOOR FINISH MATERIAL.
- SPECIAL INSULATED FLOOR FOR FREEZERS; SEE DETAIL ON A2.0A. JOINT AT EDGE ONLY.
- VINYL FLOOR TILE - ASPECTA FIVE - WASHED CONCRETE - IRON - 12"x12", REF STARBUCKS DRAWINGS

GENERAL FLOORING NOTES

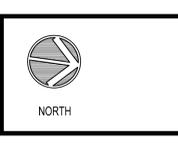- SEE SHEET A2.2 FOR ALL FLOOR FINISH, WALL AND BASE SPECIFICATIONS. SEE A3.7A FOR CLINIC FINISHES.
- AT CLOSE OF PROJECT, FURNISH NOT LESS THAN ONE BOX FOR EACH 50 BOXES, OR FRACTION THERE OF, OF EACH CLASS WEARING SURFACE, COLOR PATTERN, AND SIZE OF CARPET OR RESILIENT TILE INSTALLED.
- PROVIDE 6" VINYL BASE AROUND DOUBLE EXPRESS LANES AND ALL MILLWORK IN NON-FOOD SERVICE DEPARTMENTS (TYPICAL).
- INSTALL ALL CERAMIC AND PORCELAIN FLOOR TILE SO THAT GROUT JOINTS ARE 1/4" MAX.
- INSTALL SCHLUTER RENO-RAMP EDGING AT ALL EXPOSED EDGES OF CERAMIC FLOOR TILE, DEPTH AS REQUIRED.
- DO NOT SEAL CONCRETE ON COOLERS & FREEZERS.
- CONTRACTOR SHALL CUT CONTROL JOINTS IN A TIMELY MANNER TO PREVENT SLAB CRACKING. CONTROL JOINTS ARE TO BE INSTALLED @ 12'-0" O.C. (MAX) OR AS SHOWN ON PLAN.
- INSTALL EPOXY JOINT FILLER FOR ALL BACKROOM SAW & CONSTRUCTION JOINTS.
- DIMENSIONS ARE FROM FACE OF WALL AND CENTERLINE OF COLUMNS (TYPICAL).
- AT CONCRETE SLAB POUR JOINTS - PROVIDE 1/2" Ø SMOOTH GREASED DOWELS AT 18" O.C. FREEZERS AND MEAT COOLER FLOORS WILL NOT HAVE DOWELS AT EDGE JOINTS.
- AT CONCRETE SLAB CONTROL JOINTS - SAW JOINT TO BE 1-1/4" DEEP MINIMUM.
- EPOXY FINISH TO EXTEND TO INTERIOR SIDE OF THRESHOLD TO COVER WOOD TRANSITION @ FREEZERS AND COOLERS.
- FLOORS TO SLOPE TO FLOOR DRAINS WHERE NOTED. MAXIMUM SLOPE OF 1/4" PER FOOT CROSS SLOPE TO MEET ADA & LOCAL CODES.
- AT EXISTING FLOOR SLOPES THAT SLOPE TO EXISTING AREA DRAINS, BUT ARE NO LONGER WITHIN A PREP SPACE, INSTALL EPOXY CONCRETE FLOOR LEVELER TO BRING FINISH FLOOR UP TO BE LEVEL WITH ADJACENT SLABS.

REVISION	DATE BY
1 ASH#1	11/12/20
2 ASH#2	01/08/21
3 ASH#3	01/26/21
4 ASH#4	02/02/21
5 ASH#5	03/16/21
6 ASH#7	04/16/21
7 ASH#8	05/19/21

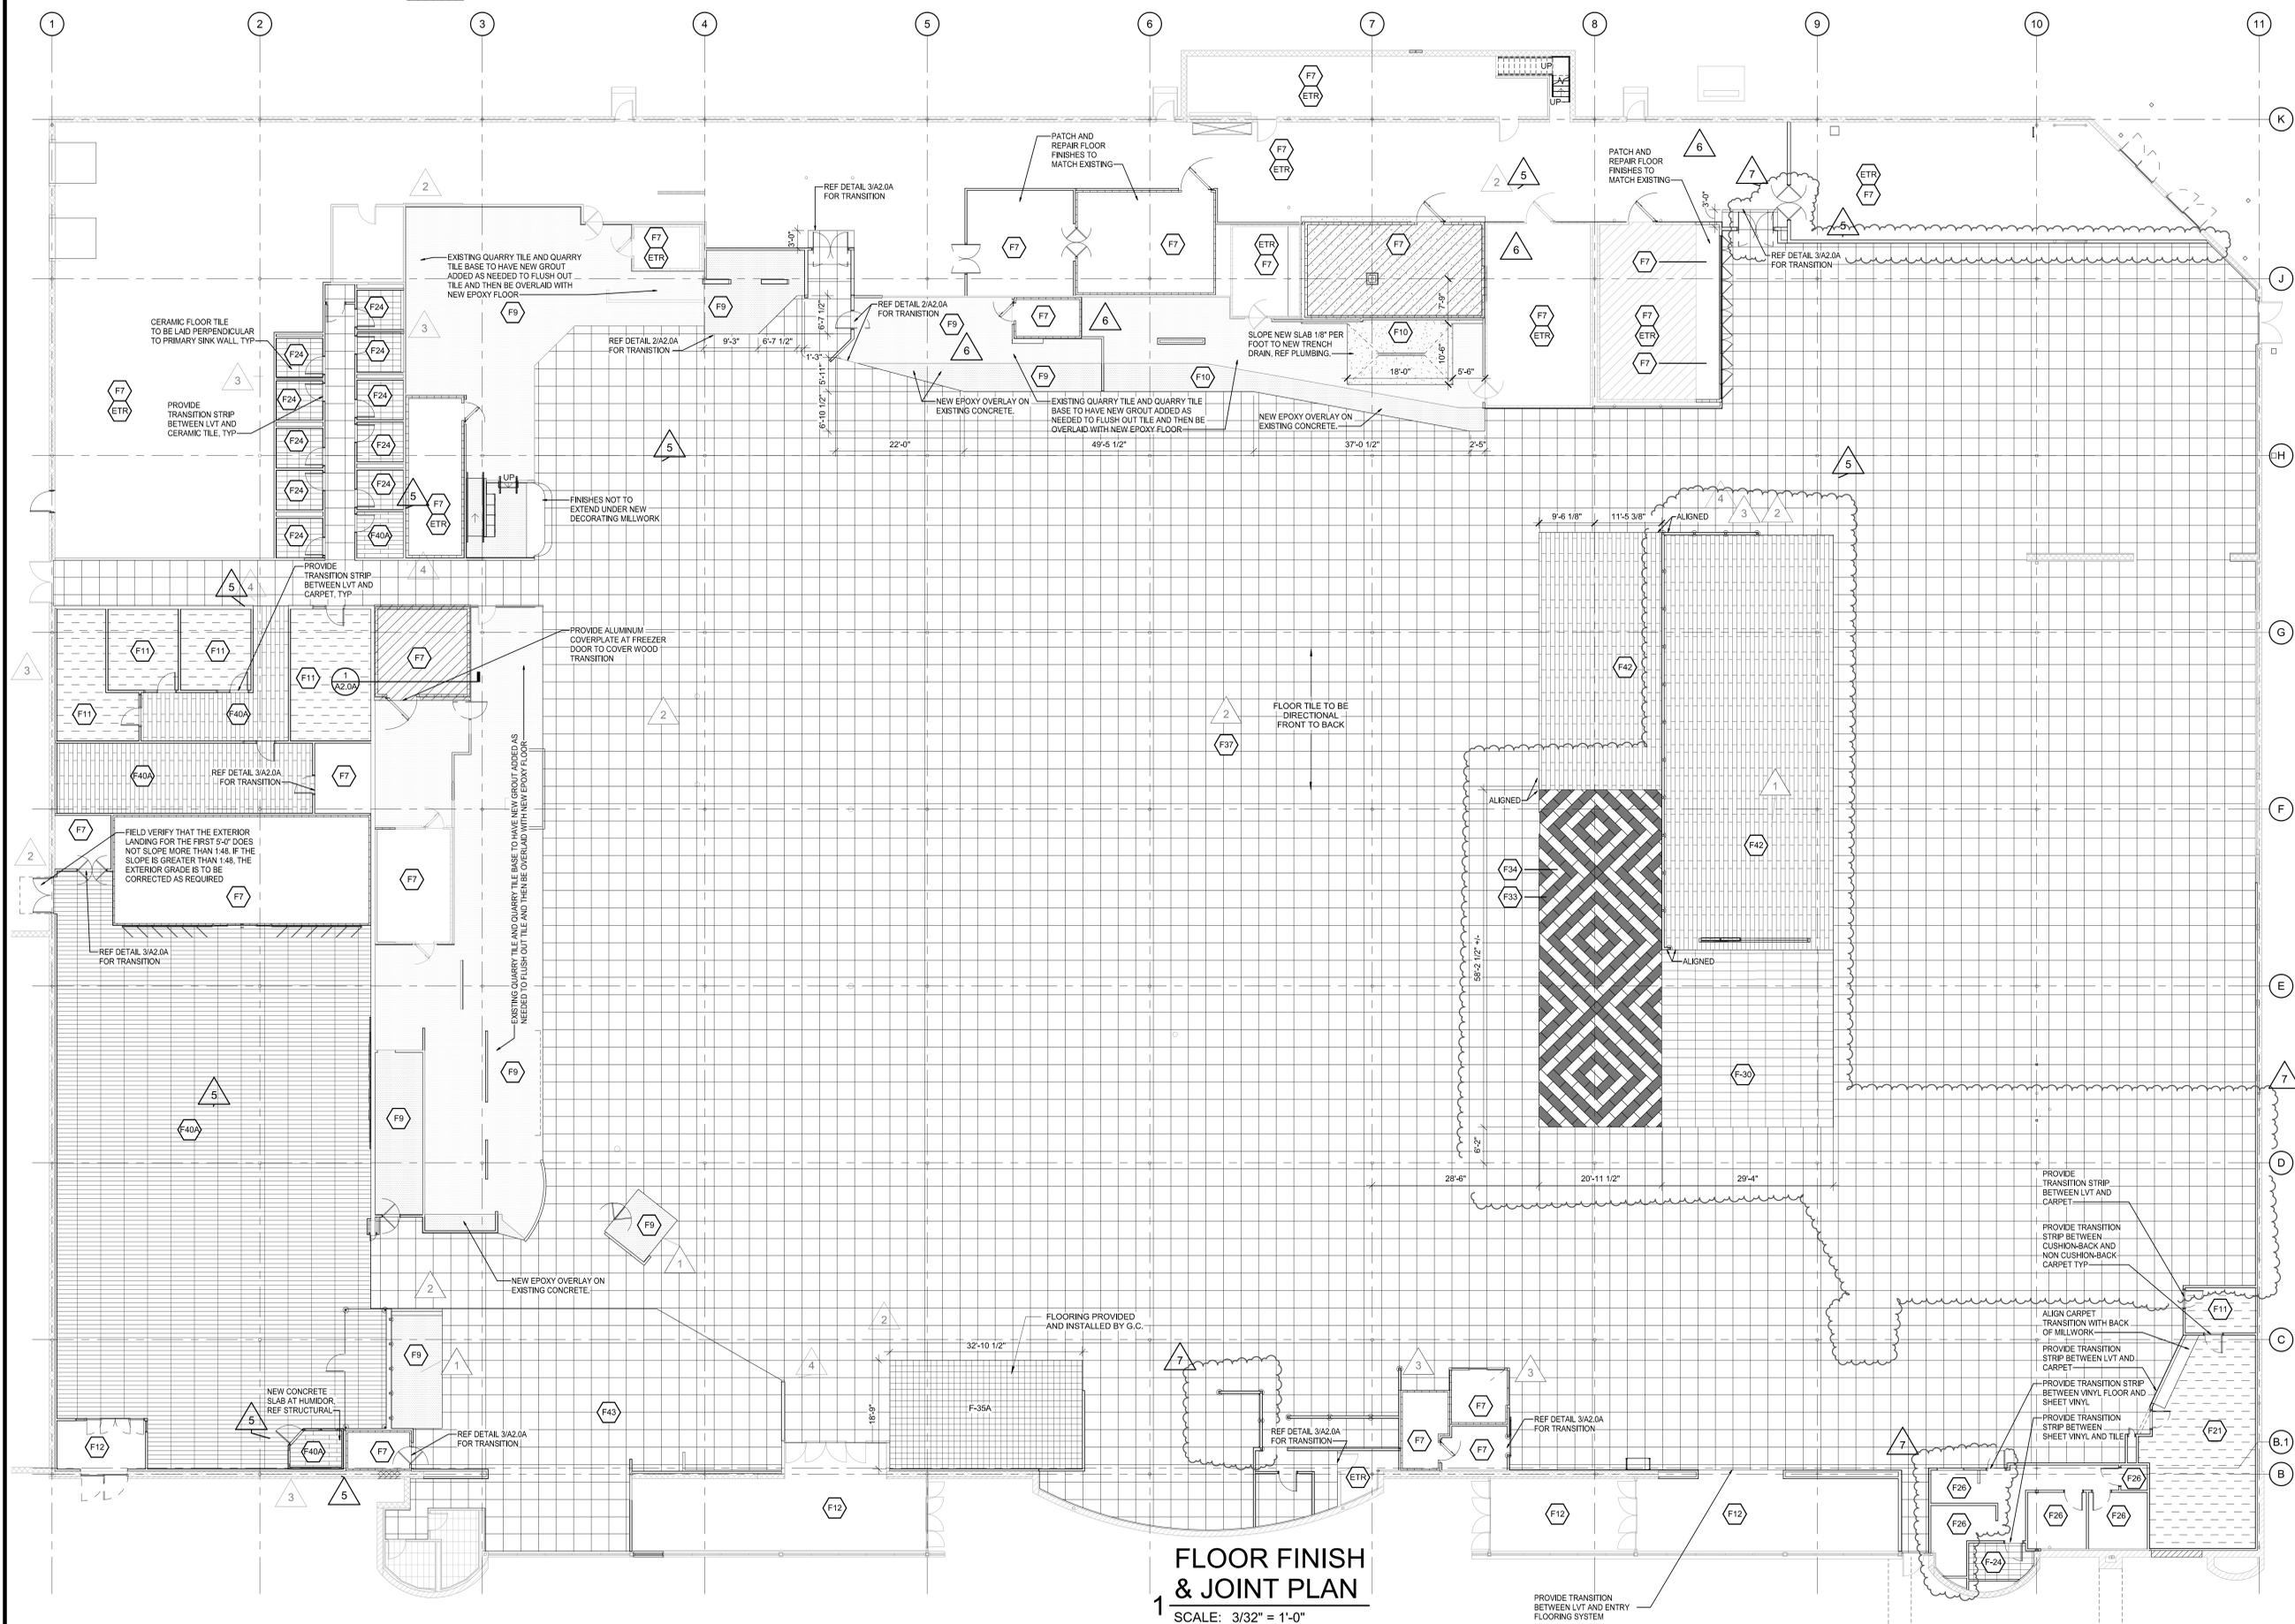


FLOOR FINISH & JOINT PLAN
 1 SCALE: 3/32" = 1'-0"

brr
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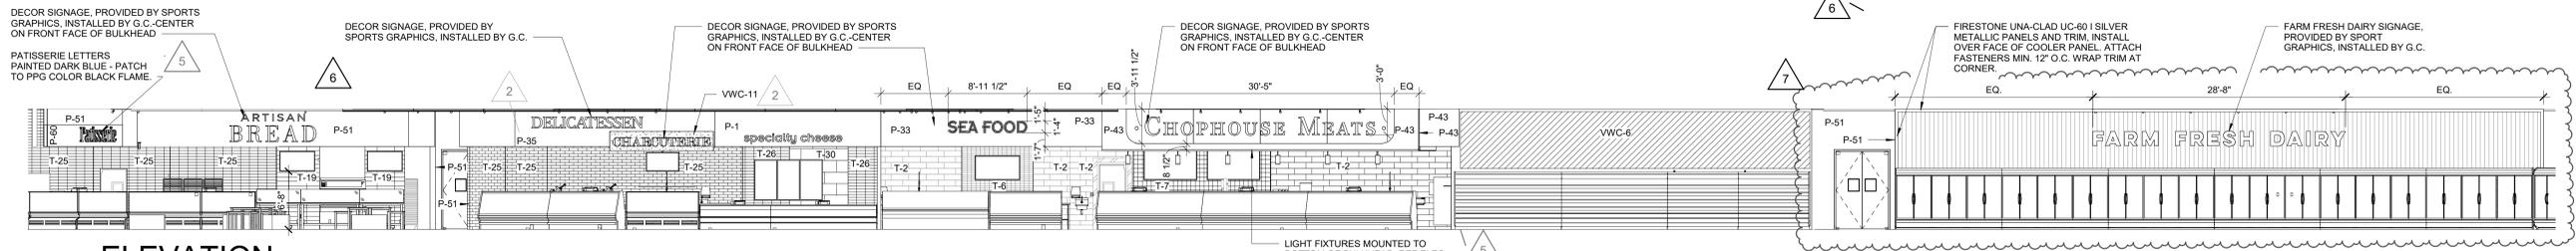
FLOOR FINISH & JOINT PLAN

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SB	JPS
DRAWN BY: AO	DATE: 3/19/2021
SCALE: As indicated	DWG NUMBER: 62930547


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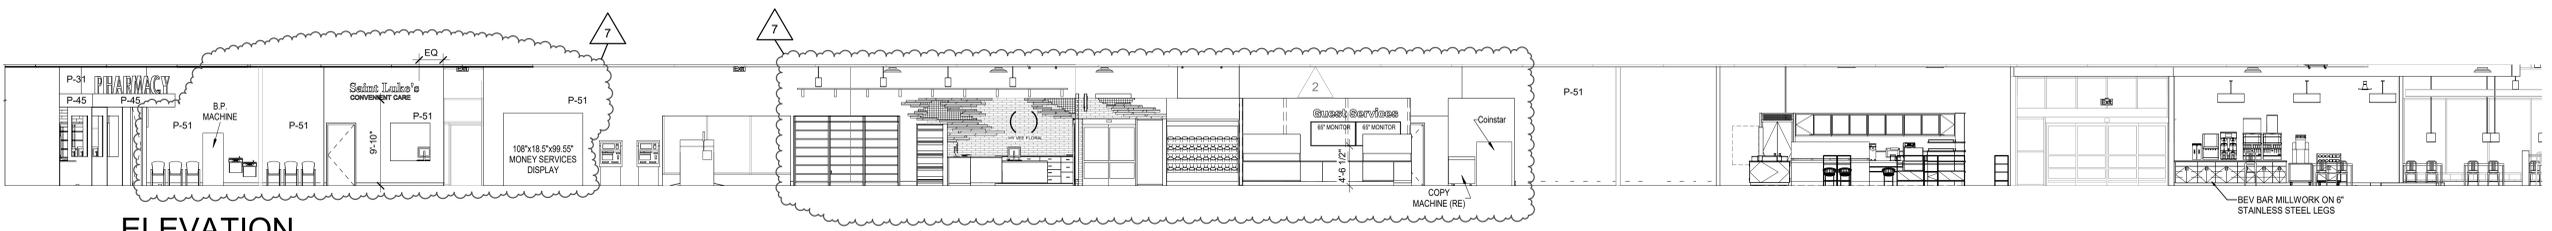
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3 ASI #3	01/26/21
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5 ASI #5	04/16/21
6 ASI #6	04/16/21
7 ASI #8	05/19/21

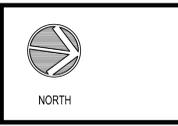


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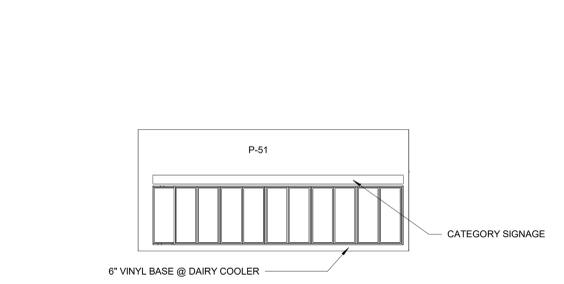
B ELEVATION
SCALE: 1/8" = 1'-0"



C ELEVATION
SCALE: 1/8" = 1'-0"

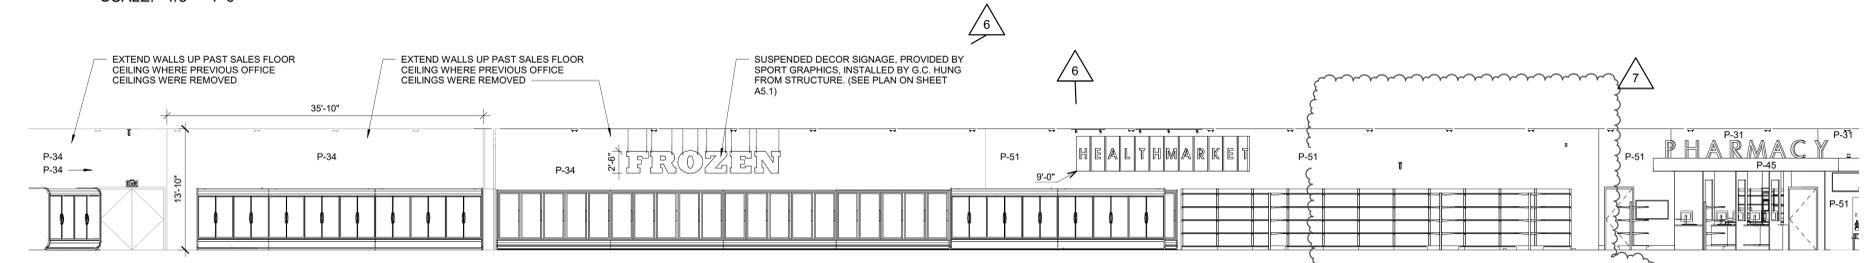

D ELEVATION
SCALE: 1/8" = 1'-0"

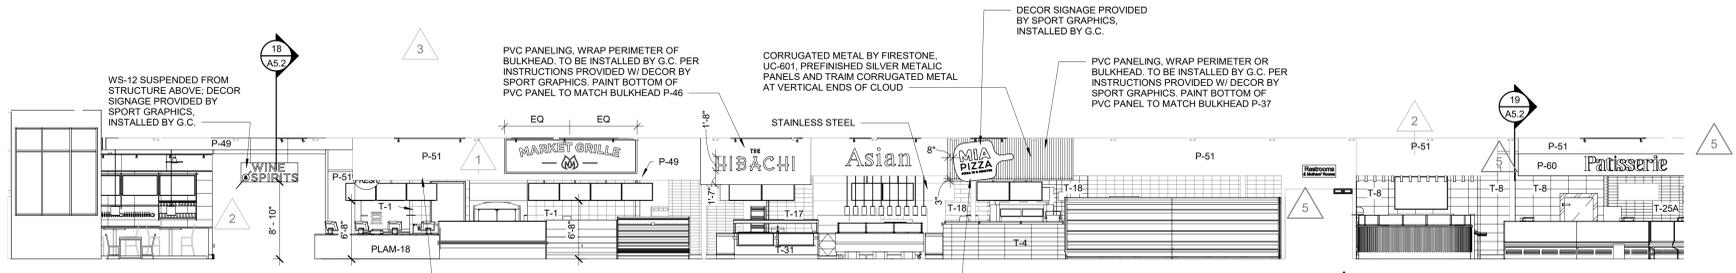


E DAIRY COOLER
SCALE: 1/8" = 1'-0"

TV DISPLAY NOTES:

1. ALL TV DISPLAYS PROVIDED AND INSTALLED BY A+
2. ALL MOUNTING AND ATTACHMENT PROVIDED BY A+
3. CONTRACTOR TO COORDINATE ALL INSTALL LOCATIONS, CONDUIT RUNS, AND ACCESS FOR INSTALLATIONS WITH A+
4. CONTRACTOR TO COORDINATE AND PROVIDE ALL REQUIRED WOOD BLOCKING FOR WALL MOUNTED INSTALLATIONS.

DECOR NOTES:

1. ALL DECOR SIGNAGE IS PROVIDED & INSTALLED BY CONTRACTOR.
2. ALL CURTAIN WALL PAINTING BY CONTRACTOR.
3. INSTALLATION DETAILS WILL BE PROVIDED BY THE DECOR SUPPLIER. VERIFY WITH CONSTRUCTION DOCUMENTS.
4. SALES FLOOR COLUMNS TO BE PAINTED P-2. ALL COLUMNS EXPOSED IN SALES AREA TO BE WRAPPED WITH STAINLESS STEEL TO +40" A.F.F.
5. USE B1 (VINYL BASE) THROUGHOUT STORE UNLESS NOTED OTHERWISE.
6. FOR FINISH SCHEDULE SEE SHEET A2.2

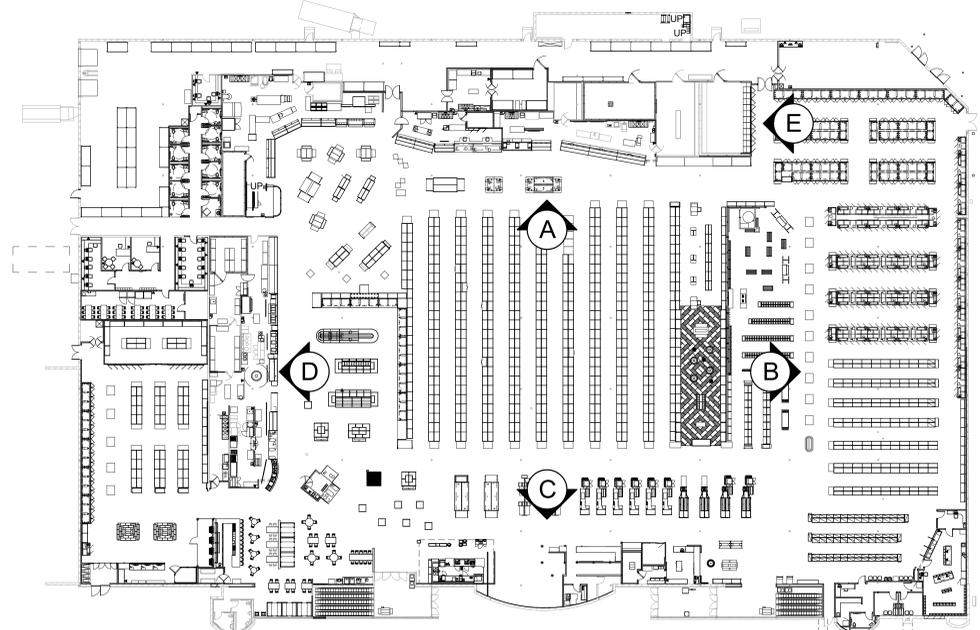

PLAN VIEW
SCALE: N.T.S.

brr

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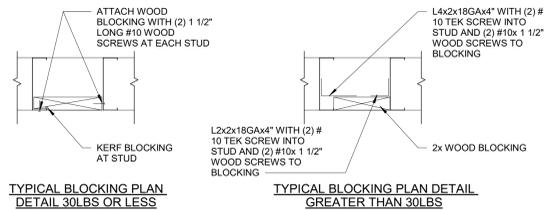


INTERIOR DECOR PLAN


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SB	JPS
DRAWN BY	DATE
AO	3/19/2021
SCALE	JOB NUMBER
As Indicated	62930547
SHEET	

A2.4


REVISION	DATE BY
3 ASI K5	01/20/21
4 ASI H4	03/02/21
6 ASI #7	04/16/21
7 ASI #8	05/19/21



4 TYPICAL WOOD BLOCKING ATTACHMENT DETAIL
SCALE: 1 1/2" = 1'-0"

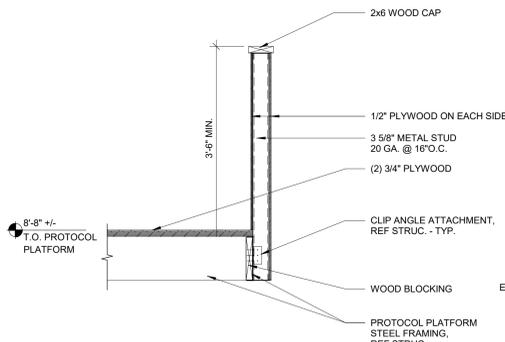


7 GUARDRAILING DETAIL
SCALE: 3/4" = 1'-0"

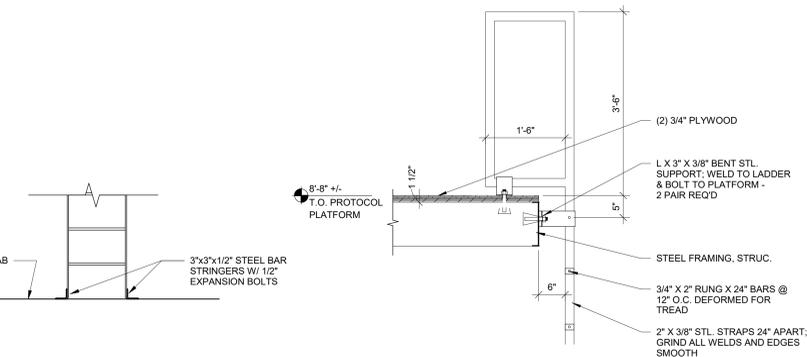

6 LADDER DETAIL
SCALE: 1/2" = 1'-0"


5 LADDER DETAIL
SCALE: 3/4" = 1'-0"

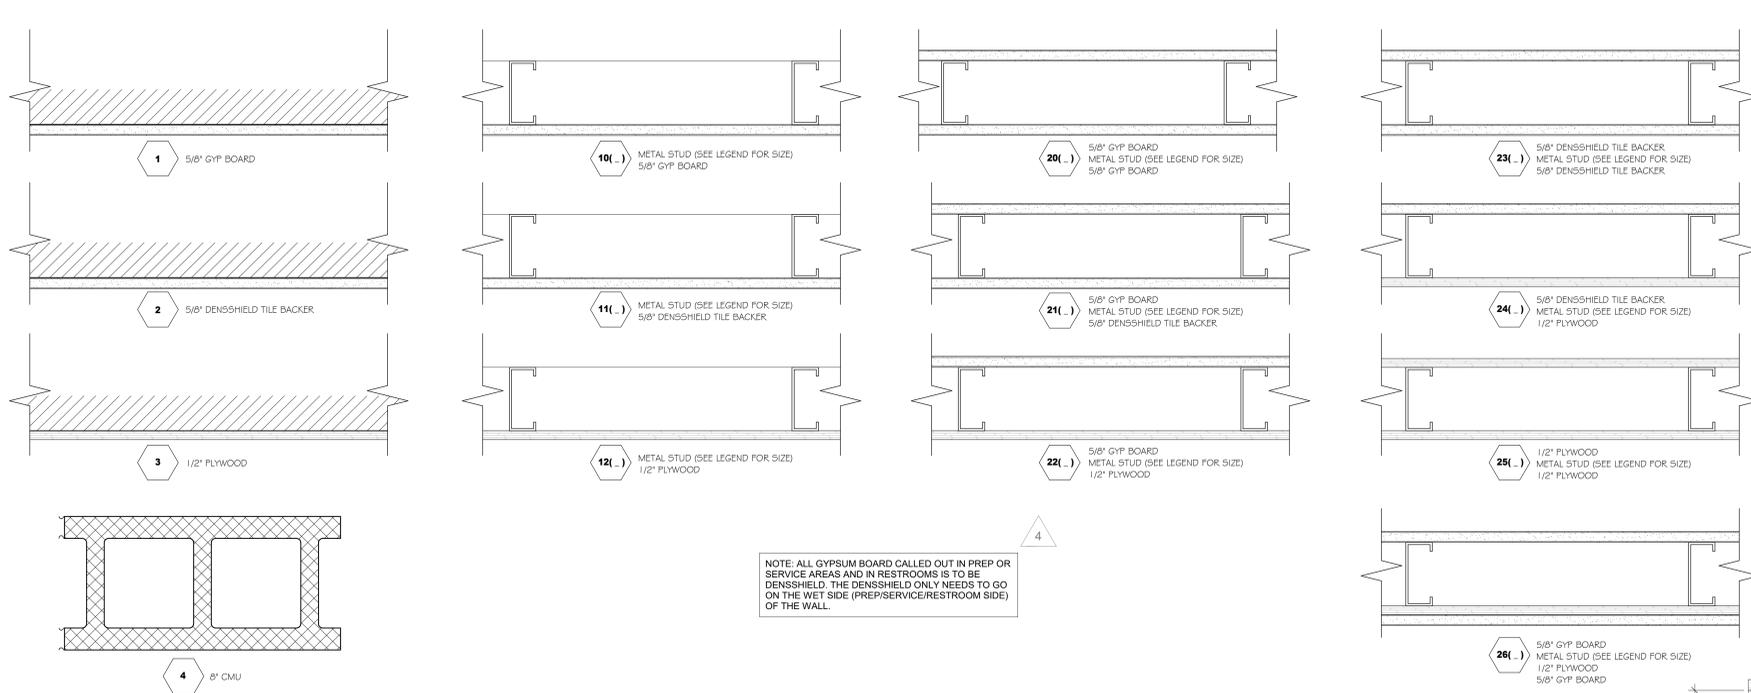


METAL STUD SIZE LEGEND

- A - 7/8"
- B - 1 5/8"
- C - 2 1/2"
- D - 3 5/8"
- E - 4"
- F - 6"
- G - 8"
- H - 10"


NOTE: ALL GYPSUM BOARD CALLED OUT IN PREP OR SERVICE AREAS AND IN RESTROOMS IS TO BE DENSSHIELD. THE DENSSHIELD ONLY NEEDS TO GO ON THE WET SIDE (PREP/SERVICE/RESTROOM SIDE) OF THE WALL.

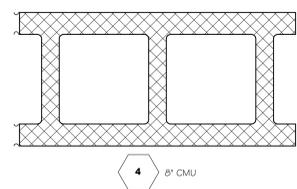


3 NON-RATED DEFLECTION TRACK
SCALE: 1 1/2" = 1'-0"

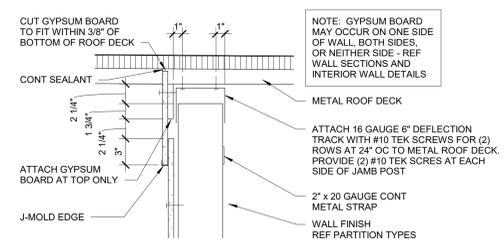

2 HEADER CONNECTION DETAIL
SCALE: 1 1/2" = 1'-0"

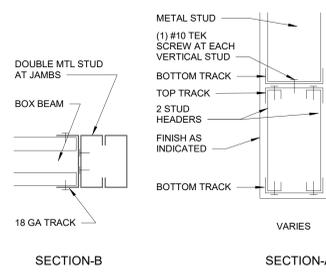

HEADER LENGTH	HEADER MEMBERS	MINIMUM EFFECTIVE PROPERTIES PER STUD
2' TO 6'	(2) 6" X 18 GAUGE	1x = 2,042 Sx = 0,670
6' TO 8'	(2) 6" X 16 GAUGE	1x = 2,518 Sx = 0,839
8' TO 10'	(2) 6" X 14 GAUGE	1x = 3,094 Sx = 1,031
10' TO 12'	(2) 8" X 18 GAUGE	1x = 4,154 Sx = 1,033
12' TO 14'	(2) 8" X 16 GAUGE	1x = 5,110 Sx = 1,277
14' TO 16'	(2) 8" X 14 GAUGE	1x = 6,303 Sx = 1,576
16' TO 18'	(2) 10" X 14 GAUGE	1x = 12,325 Sx = 2,456
18' TO 26'	(2) 12" X 16 GAUGE	1x = 15,730 Sx = 2,334

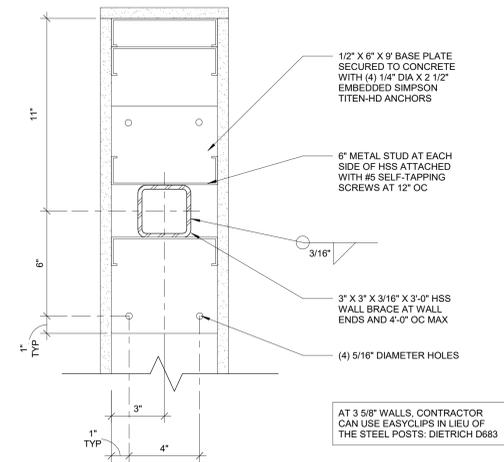

1 PLAN AT KNEE WALL
SCALE: 3" = 1'-0"

brr


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INTERIOR WALL DETAILS

PROJECT MANAGER	SB	CHECKED BY	JPS
DRAWN BY	ADP	DATE	3/19/2021
SCALE	As indicated	DWG NUMBER	62930547


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GENERAL NOTES


FOR FINISH SCHEDULE SEE SHEET A2.2.

BASE & FLOOR TILE - GRANULAR QUARTZ EPOXY - SEE FLOOR FINISH PLAN FOR COLOR DESIGNATION - BASE REFERENCE DETAIL 15/A3.1

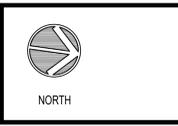
ALL MILLWORK IN FOOD SERVICE AREAS TO HAVE ALL SURFACES FINISHED- NO EXPOSED EDGES OR UNDER SIDES

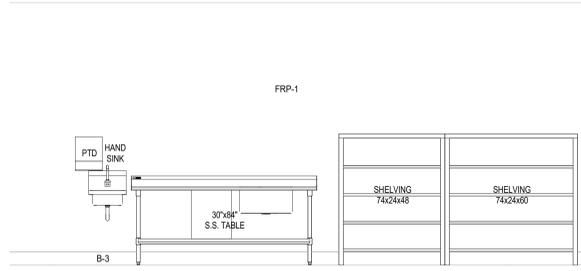

11 ELEVATION
SCALE: 3/8" = 1'-0"

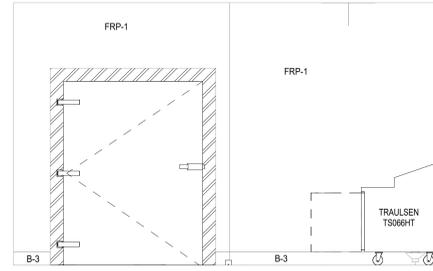


12 ELEVATION
SCALE: 3/8" = 1'-0"

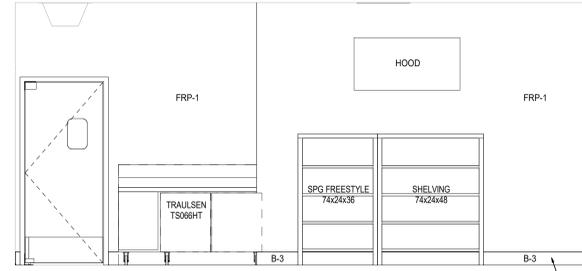


13 ELEVATION
SCALE: 3/8" = 1'-0"


ALL ELEVATION WITH EXISTING QUARRY TILE TO HAVE GROUT ADDED AS NECESSARY TO FLUSH OUT TILE AND THEN BE OVERLAID WITH NEW EPOXY FLOOR, TYP.

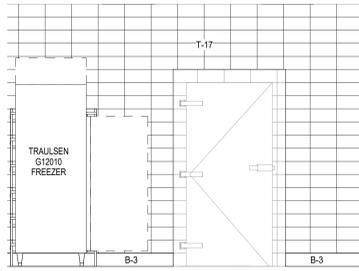


8 ELEVATION
SCALE: 3/8" = 1'-0"

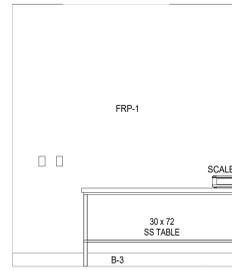


9 ELEVATION
SCALE: 3/8" = 1'-0"

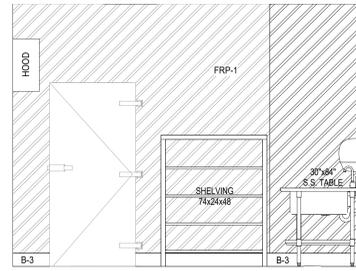


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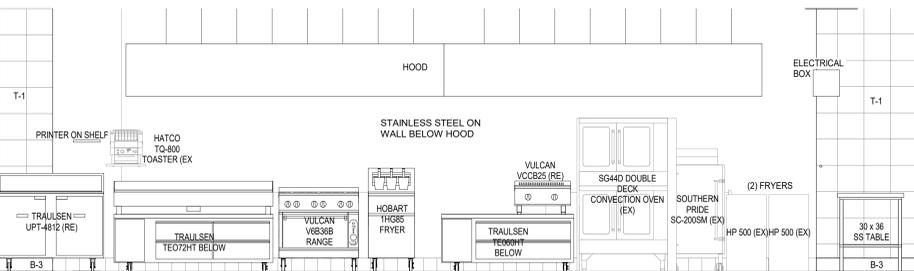
5 ELEVATION
SCALE: 3/8" = 1'-0"

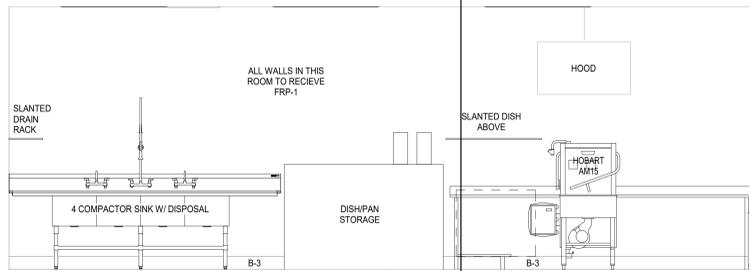


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SCALE: 3/8" = 1'-0"

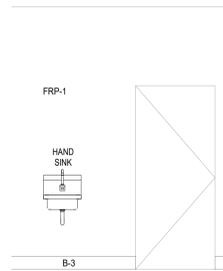


7 ELEVATION
SCALE: 3/8" = 1'-0"

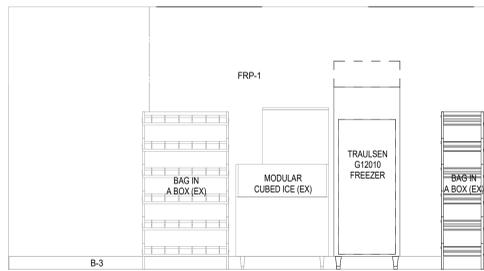


4 ELEVATION
SCALE: 3/8" = 1'-0"

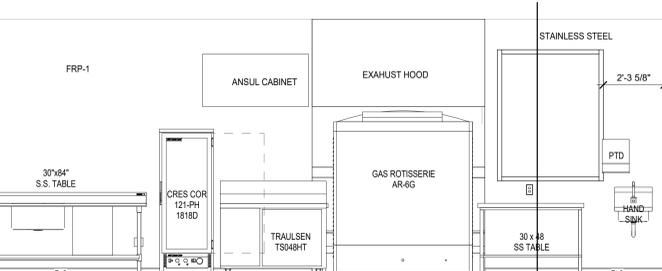

3 ELEVATION
SCALE: 3/8" = 1'-0"

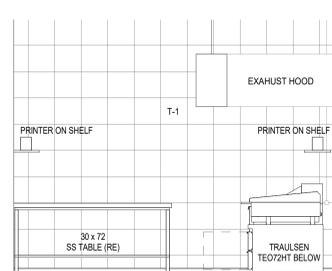

2 ELEVATION
SCALE: 3/8" = 1'-0"

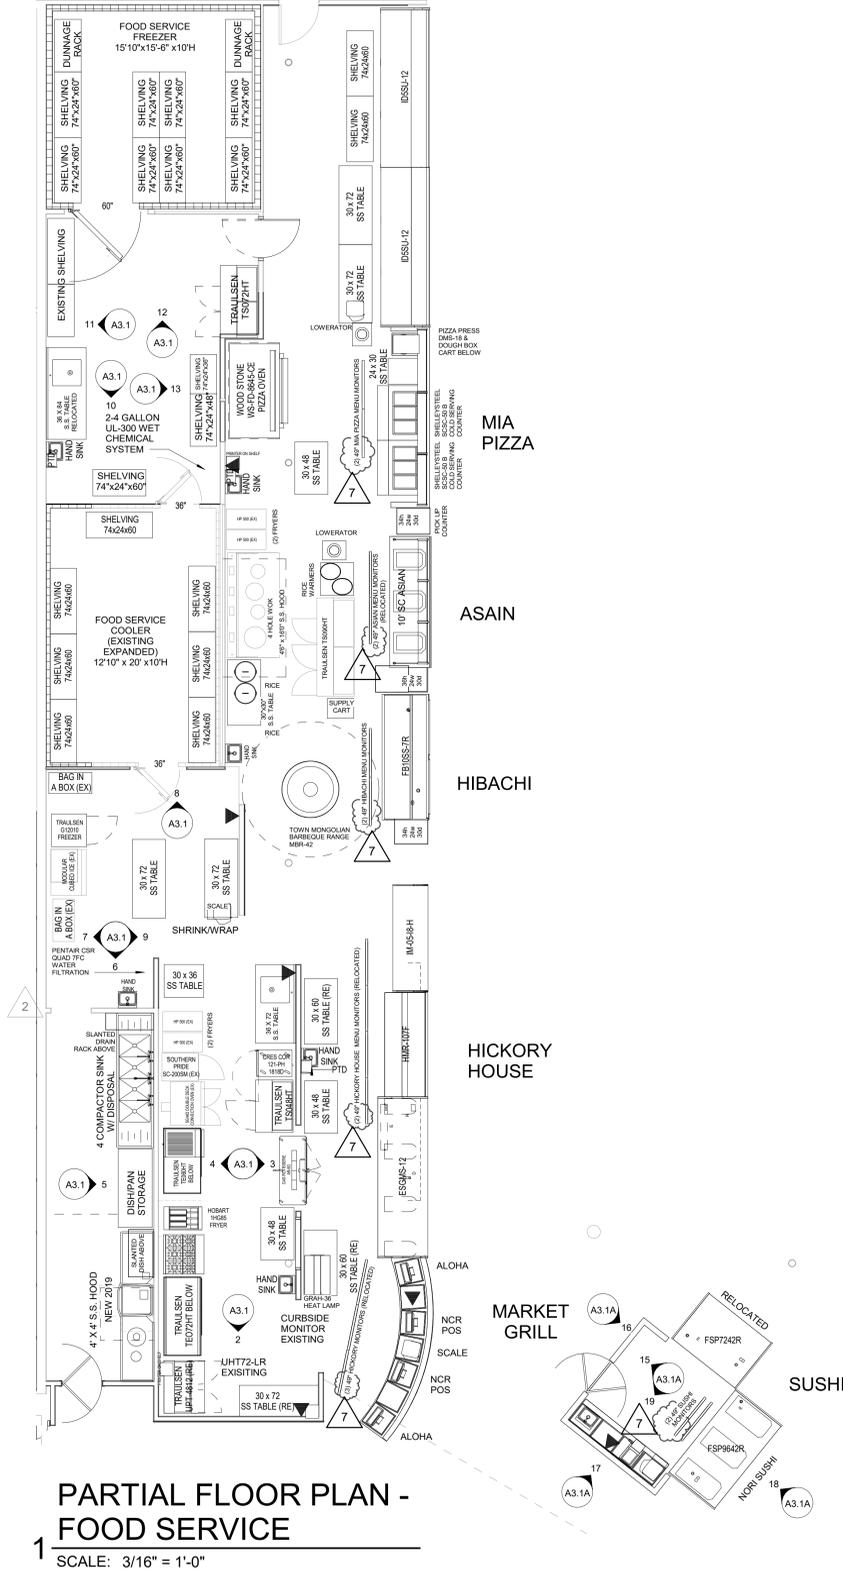

PARTIAL FLOOR PLAN - FOOD SERVICE
SCALE: 3/16" = 1'-0"



Architect of Record:
BRR Architecture, Inc.
Kansas City 8331 Metcalf Avenue
Phoenix 300 Overland Park, KS 66204
Houston 1900 West Loop South
Philadelphia 1500 Market Street
Austin 1100 West 17th Street
Chicago 1100 West 17th Street



LOCATION: LEE'S SUMMIT, MO #2
HY-VEE INC.
5820 WEST TOWN PARKWAY
WEST DES MOINES, IOWA 50266
PHONE: (515) 267-2600
FAX: (515) 267-2636
EMPLOYEE OWNED



ENLARGED PLAN & ELEVATIONS - FOOD SERVICE


PROJECT MANAGER: SB
CHECKED BY: JPS
DRAWN BY: AP
DATE: 3/19/2021
SCALE: AS INDICATED
JOB NUMBER: 62930547
SHEET:

A3.1


GENERAL NOTES

FOR FINISH SCHEDULE SEE SHEET A2.2.
MILLWORK CABINETS FURNISHED BY HY-VEE
***NOTE: INSTALL SCHLUTER-RONDEC SATIN ANODIZED ALUMINUM RO 800A STRIP ON ALL OUTSIDE CORNERS WITH CERAMIC TILE
ALL MILLWORK IN FOOD SERVICE AREAS TO HAVE ALL SURFACES FINISHED. NO EXPOSED EDGES OR UNDER SIDES


REVISION	DATE BY
2 ASI K2	01/02/21
5 ASI R5	04/16/21
6 ASI R7	04/16/21
7 ASI R8	05/19/21

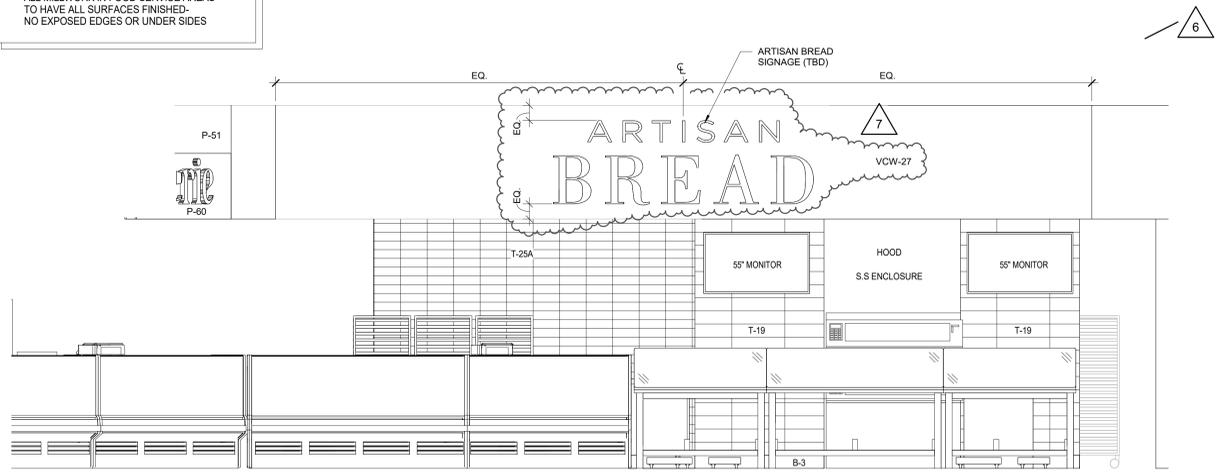


9 ELEVATION
SCALE: 3/8" = 1'-0"

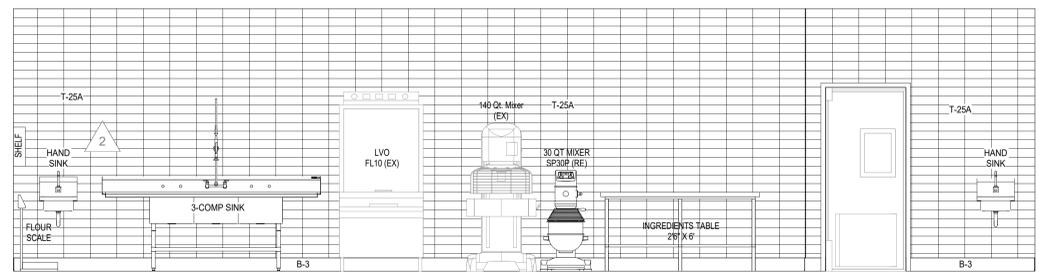


6 ELEVATION
SCALE: 3/8" = 1'-0"

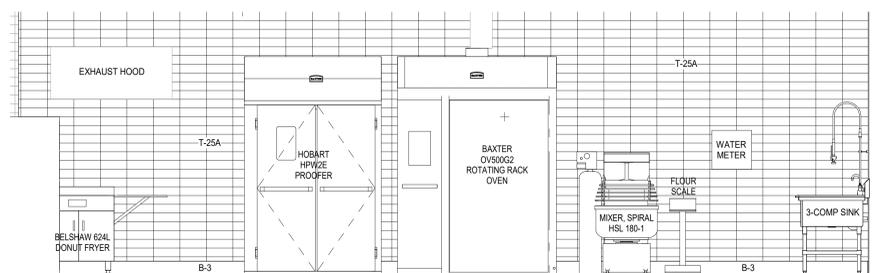


5 ELEVATION
SCALE: 3/8" = 1'-0"

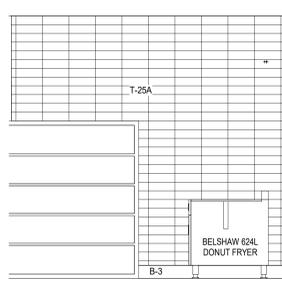


4 ELEVATION
SCALE: 3/8" = 1'-0"

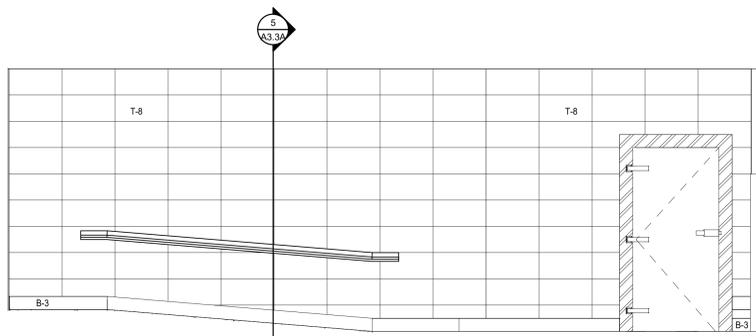


3 ELEVATION
SCALE: 3/8" = 1'-0"

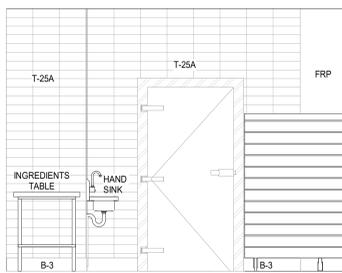


7 ELEVATION
SCALE: 3/8" = 1'-0"

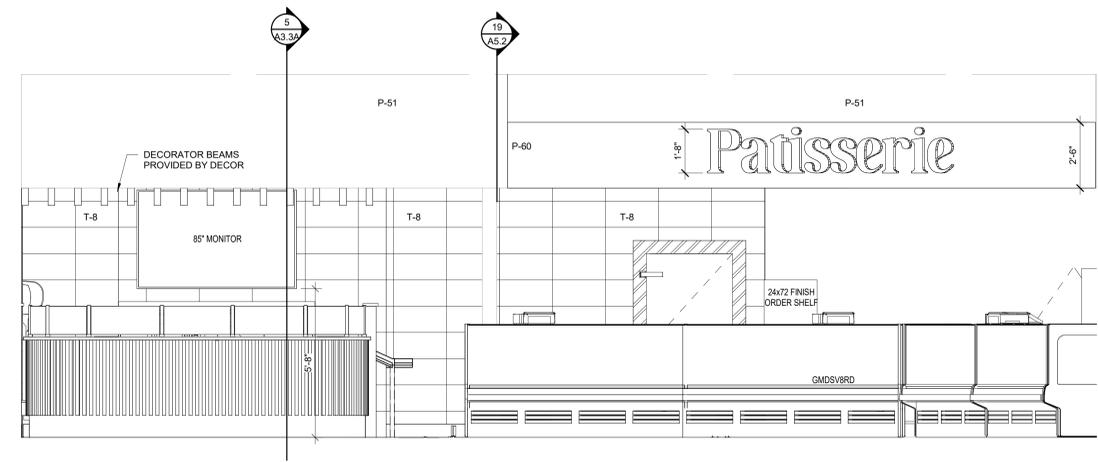

10 ELEVATION
SCALE: 3/8" = 1'-0"

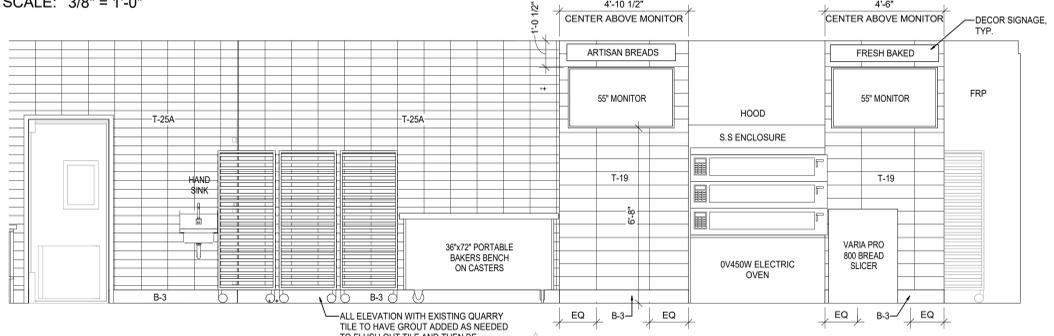

8 ELEVATION
SCALE: 3/8" = 1'-0"

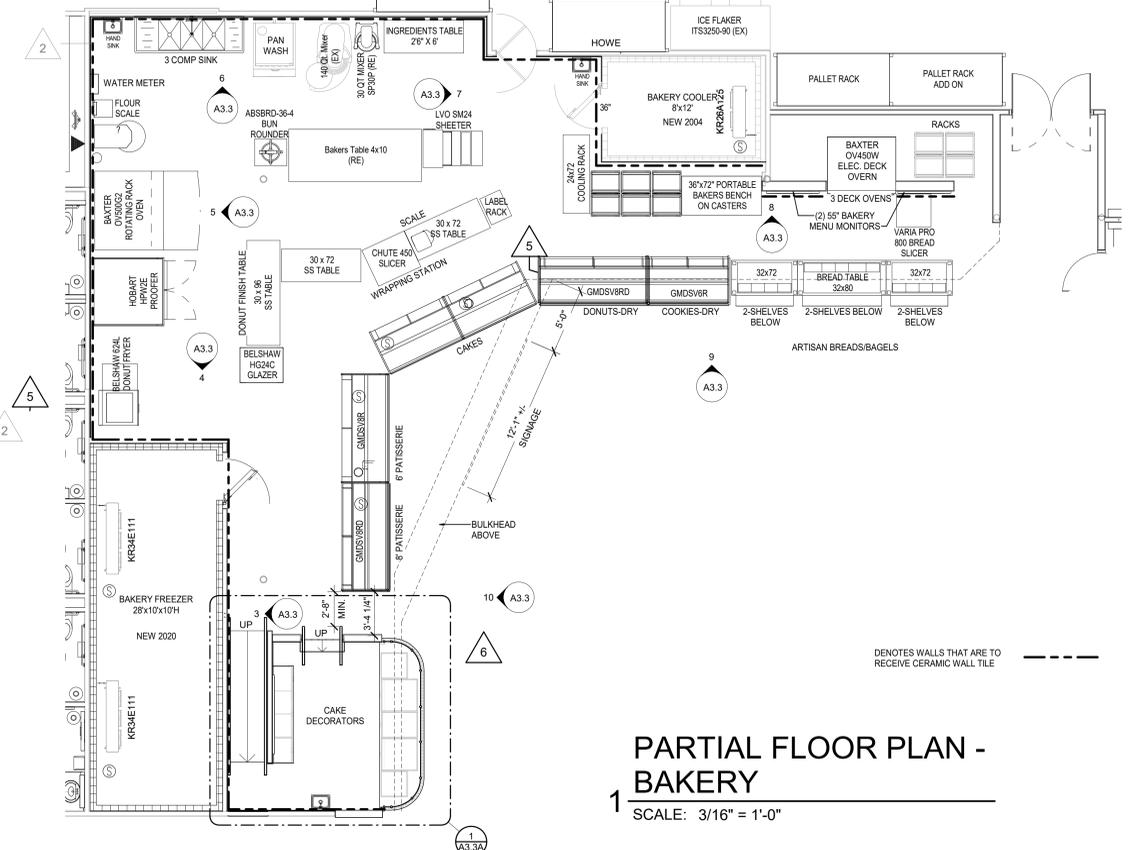

PARTIAL FLOOR PLAN - BAKERY
SCALE: 3/16" = 1'-0"

5/19/2021 2:55:33 PM

brr
Architect of Record:
BRR Architecture, Inc.
Kansas City, MO 64111
Phoenix, AZ 85004
Philadelphia, PA 19106
Austin, TX 78701
Chicago, IL 60601

833 Metcalf Avenue
Suite 300
Overland Park, KS 66204
Tel: 913-262-9995
Fax: 913-262-9044


PROFESSIONAL SEAL
STATE OF MISSOURI
RICHARD A. MAJORS, JR.
NUMBER 1-077811
REGISTERED ARCHITECT

Richard A. Majors, Jr.
Architect License No. 657921
Missouri License No. A-007328

LEE'S SUMMIT, MO #2

HY-VEE, INC.
5820 WESTOWN PARKWAY
WEST DES MOINES, IOWA 50386
TEL: (515) 281-2600
FAX: (515) 281-2636

HyVee
EMPLOYEE OWNED

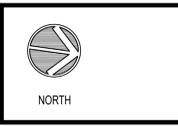


ENLARGED PLAN & ELEVATIONS - BAKERY

PROJECT MANAGER	CHECKED BY
SB	JPS
DRAWN BY:	DATE:
Author	3/19/2021
SCALE:	JOB NUMBER:
As indicated	62930547


SHEET: **A3.3**

REVISION	DATE BY
2 ASI K2	01/08/21
7 ASI #8	06/16/21


GENERAL NOTES
FOR FINISH SCHEDULE SEE SHEET A2.2.

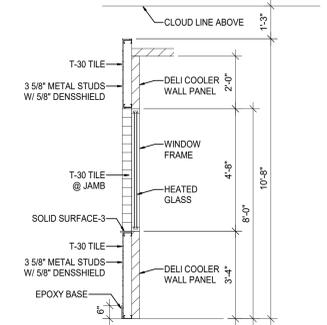


SECTION @ DELI COOLER WINDOW
8 SCALE: 3/8" = 1'-0"

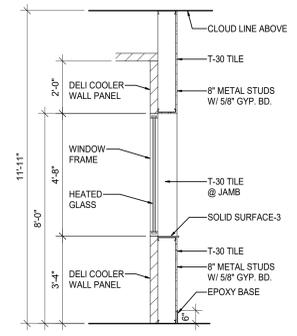


SECTION @ DELI COOLER WINDOW
9 SCALE: 3/8" = 1'-0"

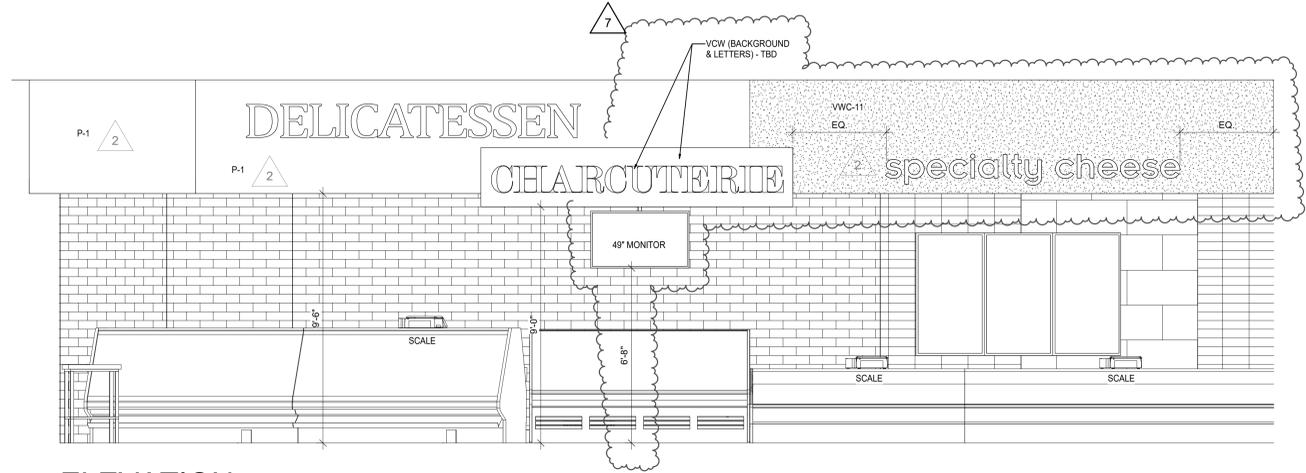


ELEVATION
6 SCALE: 3/8" = 1'-0"

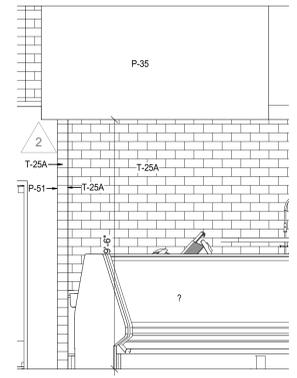


ELEVATION
7 SCALE: 3/8" = 1'-0"

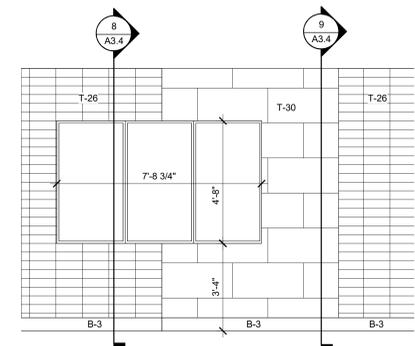


ELEVATION
4 SCALE: 3/8" = 1'-0"

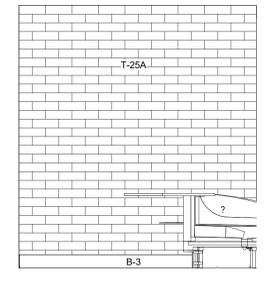


ELEVATION
5 SCALE: 3/8" = 1'-0"

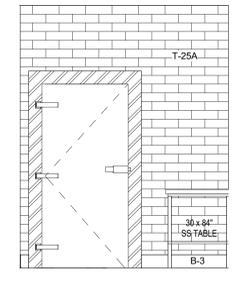

ELEVATION
3 SCALE: 3/8" = 1'-0"

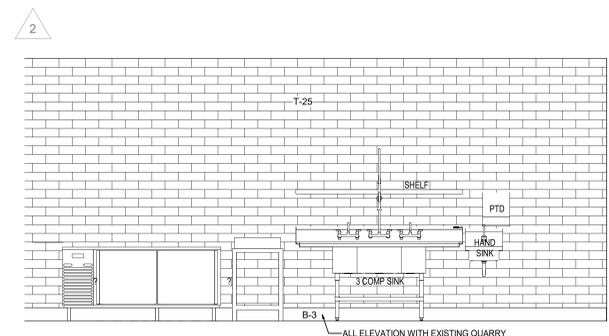

ELEVATION
2 SCALE: 3/8" = 1'-0"

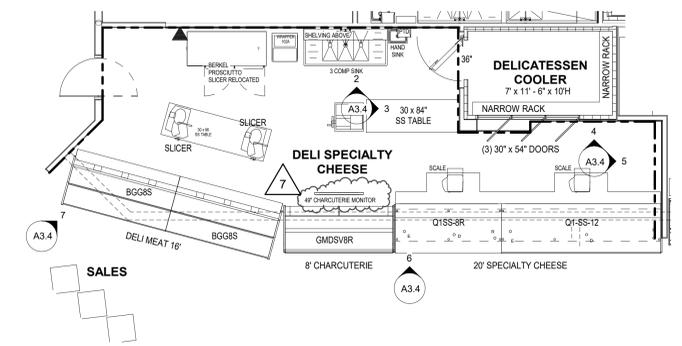


PARTIAL FLOOR PLAN - DELICATESSEN
1 SCALE: 3/16" = 1'-0"

--- DENOTES WALLS THAT ARE TO RECEIVE CERAMIC WALL TILE

brr
Architect of Record: Rich A. Majors
BRR Architecture, Inc.
Kansas City 8131 Metcalf Ave
Berkeley 800 300
Phoenix 300
San Francisco Overland Park, KS 66204
Pittsburgh
Albany Tel: 913-262-9995
Austin Fax: 913-262-9046
Los Angeles
Chicago

PROFESSIONAL SEAL
STATE OF MISSOURI
RICHARD MAJORS JR.
NUMBER A-072811
EXPIRES 12/31/2021
05/20/21

LOCATION
LEE'S SUMMIT, MO #2
HY-VEE INC.
5820 WESTOWN PARKWAY
WEST DES MOINES, IOWA 50386
TEL: (515) 267-2800
FAX: (515) 267-2838
HyVee
EMPLOYEE OWNED

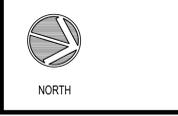

ENLARGED PLAN & ELEVATIONS - DELICATESSEN


PROJECT MANAGER SB	CHECKED BY JPS
DRAWN BY ADP	DATE 3/19/2021
SCALE As indicated	JOB NUMBER 62930547

SHEET:
A3.4


REVISION	DATE BY
2 ASI K2	01/08/21
5 ASI #5	03/19/21
7 ASI #8	05/19/21

GENERAL NOTES


SEE SHEET A2.2 FOR FINISH SCHEDULES
 PROVIDE SCHLUTER RANDEL SATIN ANODIZED ALUMINUM RO-80A TRIM ON ALL OUTSIDE TILE CORNERS
 BASE AND FLOOR TILE
 EXISTING QUARRY TILE TO REMAIN. PATCH AND REPAIR AS NECESSARY.

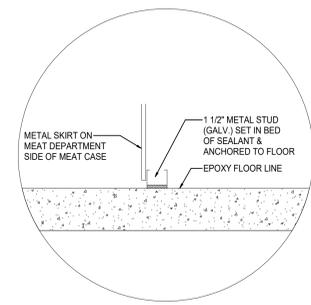


10 SERVICE MEAT CASE BASE DETAIL
 SCALE: 3/8" = 1'-0"

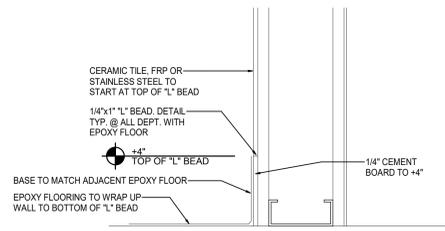


9 SEAFOOD EPOXY BASE DETAIL
 SCALE: 3" = 1'-0" ACCENT WALL ONLY

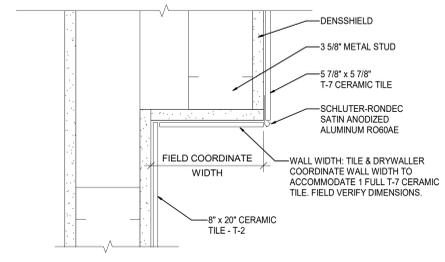


8 MEAT CERAMIC/GYP. BD. CORNER DETAIL
 SCALE: 3" = 1'-0"

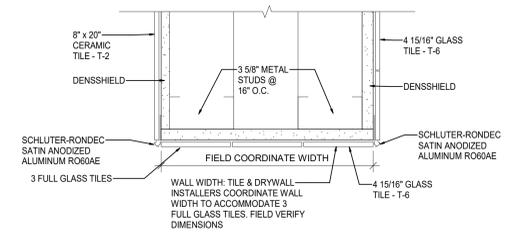


7 SEAFOOD GLASS/CERAMIC/GYP. BD. END WALL DETAIL
 SCALE: 3" = 1'-0"

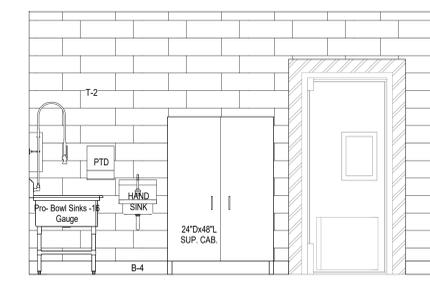


6 ELEVATION
 SCALE: 3/8" = 1'-0"

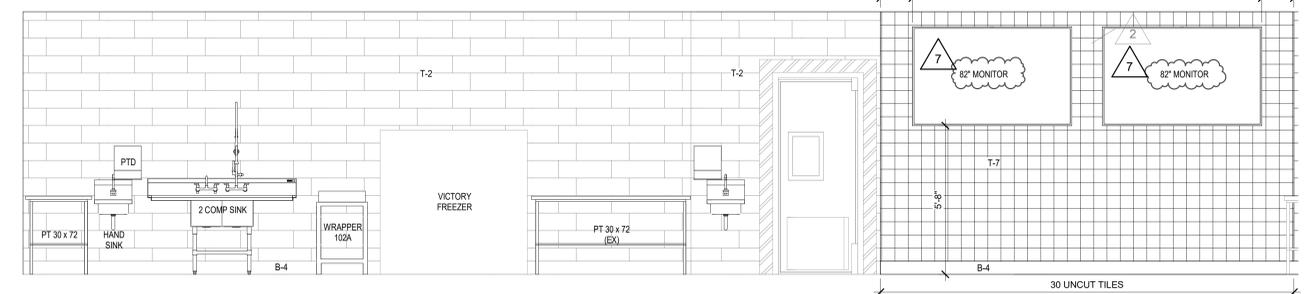


5 ELEVATION
 SCALE: 3/8" = 1'-0"

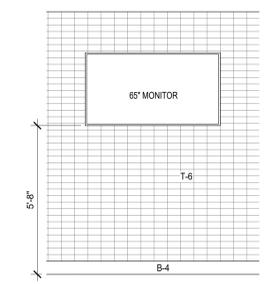


4 ELEVATION
 SCALE: 3/8" = 1'-0"

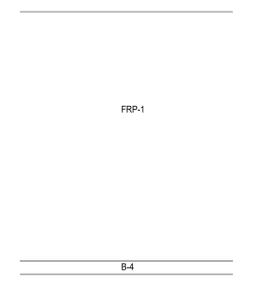

3 ELEVATION
 SCALE: 3/8" = 1'-0"

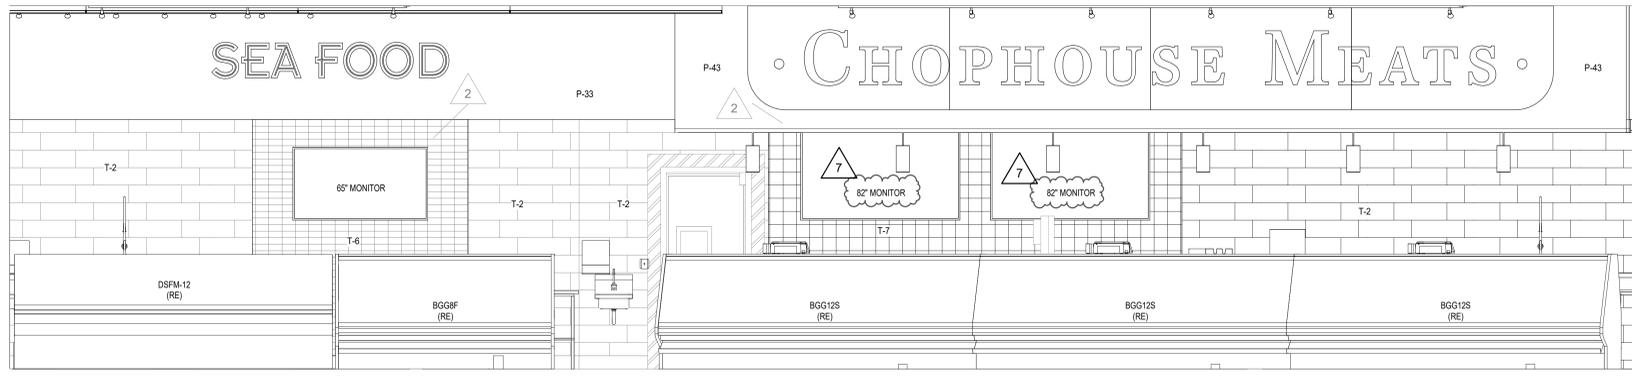

2 ELEVATION
 SCALE: 3/8" = 1'-0"

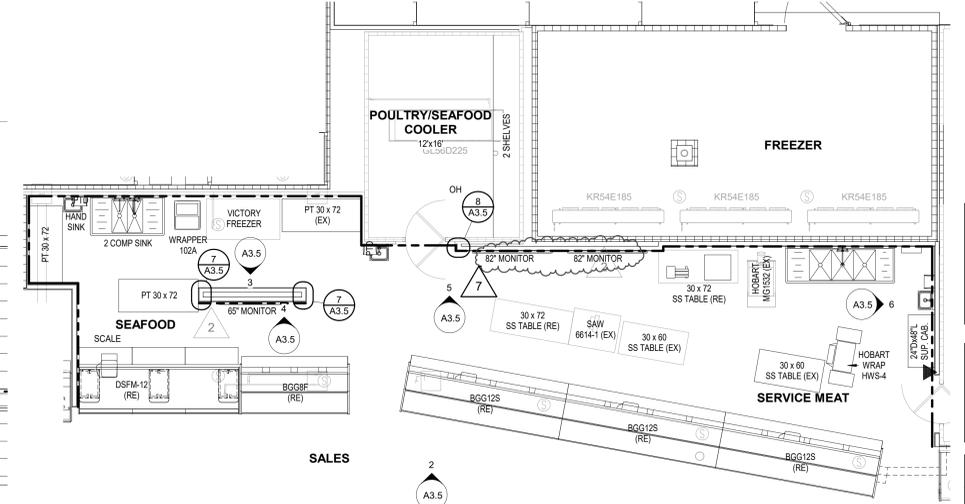

1 PARTIAL FLOOR PLAN - MEAT/SEAFOOD
 SCALE: 3/16" = 1'-0"

brr
 Architect of Record:
 BRR Architecture, Inc.
 Kansas City, MO 64111
 Phoenix, AZ 85004
 Philadelphia, PA 19103
 Austin, TX 78701
 Los Angeles, CA 90001
 Chicago, IL 60601


8131 Metcalf Avenue
 Suite 300
 Overland Park, KS 66204
 Tel: 913-262-9995
 Fax: 913-262-9044

PROFESSIONAL SEAL
 RICHARD A. MAJORS, JR.
 ARCHITECT
 MISSOURI
 NUMBER A-0172811
 EXPIRES 12/31/2021
 RICHARD A. MAJORS, JR.
 ARCHITECT
 MISSOURI LICENSE NO. A-007128

LOCATION
LEE'S SUMMIT, MO #2

HY-VEE INC.
 5820 WESTTOWN PARKWAY
 WEST DES MOINES, IOWA 50386
 (515) 281-2600
 FAX: (515) 267-4636

HyVee
 EMPLOYEE OWNED

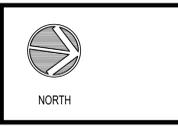

ENLARGED PLAN & ELEVATIONS - MEAT/SEAFOOD

PROJECT MANAGER SB	CHECKED BY JPS
DRAWN BY AP	DATE 3/19/2021
SCALE As indicated	JOB NUMBER 62930547


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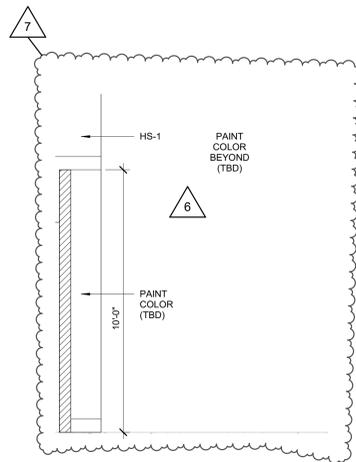
GENERAL NOTES

SEE SHEET A2.2 FOR FINISH SCHEDULES
 MILLWORK CABINETS PROVIDED BY HY-VEE
 ALL OFFICE AREAS, PAINT UNDERCOUNTER
 BRACKETS TO MATCH WALL FINISH


REVISION	DATE BY
1. ASI #1	11/10/20
2. ASI #2	01/08/21
3. ASI #3	03/19/21
4. ASI #4	04/16/21
5. ASI #5	06/16/21




10 ELEVATION
 SCALE: 3/8" = 1'-0"

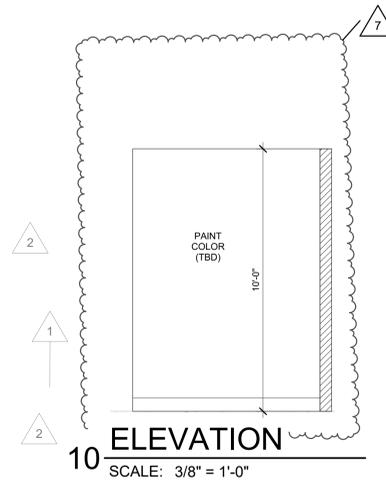


9 ELEVATION
 SCALE: 3/8" = 1'-0"

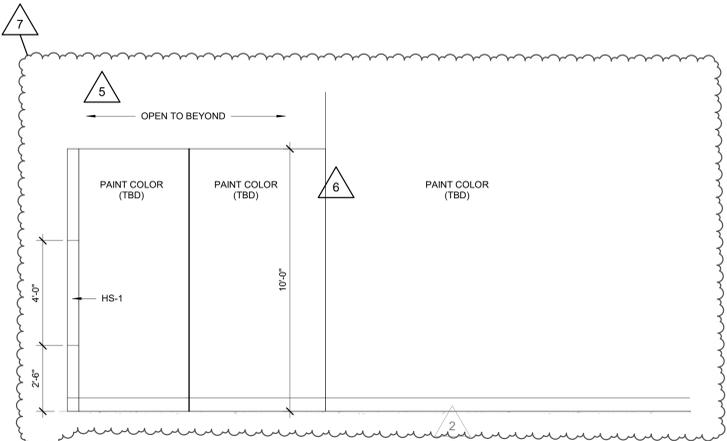


8 ELEVATION
 SCALE: 3/8" = 1'-0"

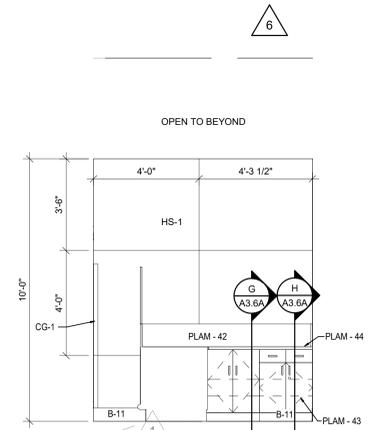


7 ELEVATION
 SCALE: 3/8" = 1'-0"

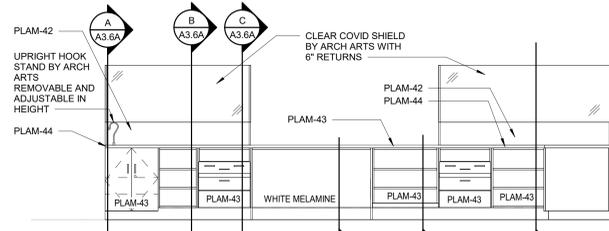


6 ELEVATION
 SCALE: 3/8" = 1'-0"

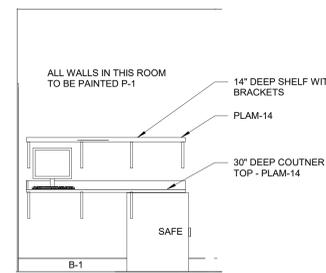


5 ELEVATION
 SCALE: 3/8" = 1'-0"

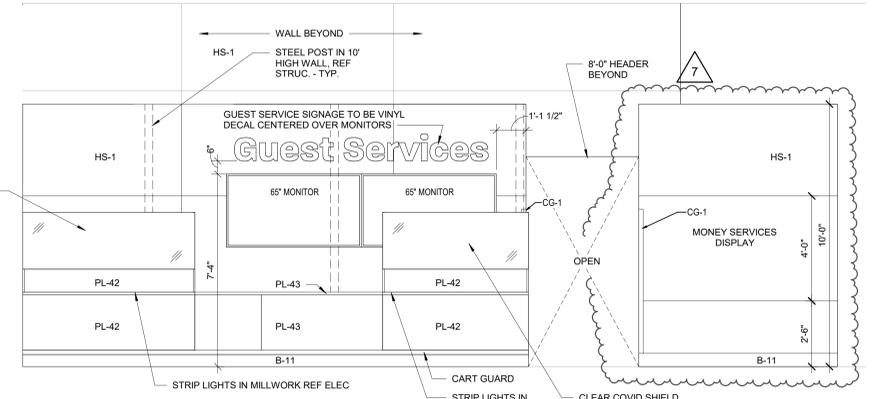


4 ELEVATION
 SCALE: 3/8" = 1'-0"

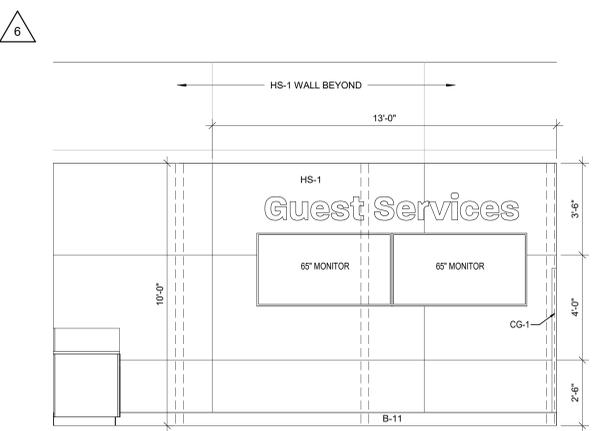

3 ELEVATION
 SCALE: 3/8" = 1'-0"

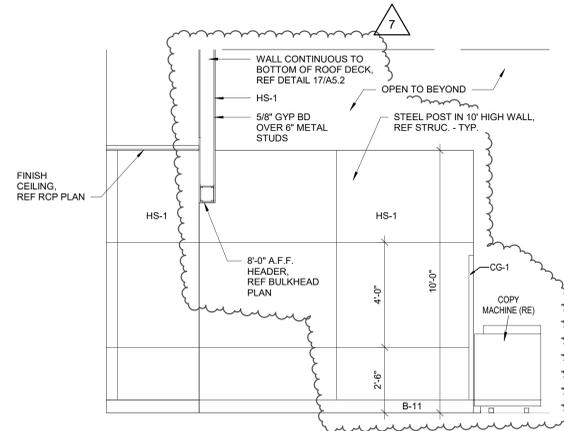

2 ELEVATION
 SCALE: 3/8" = 1'-0"

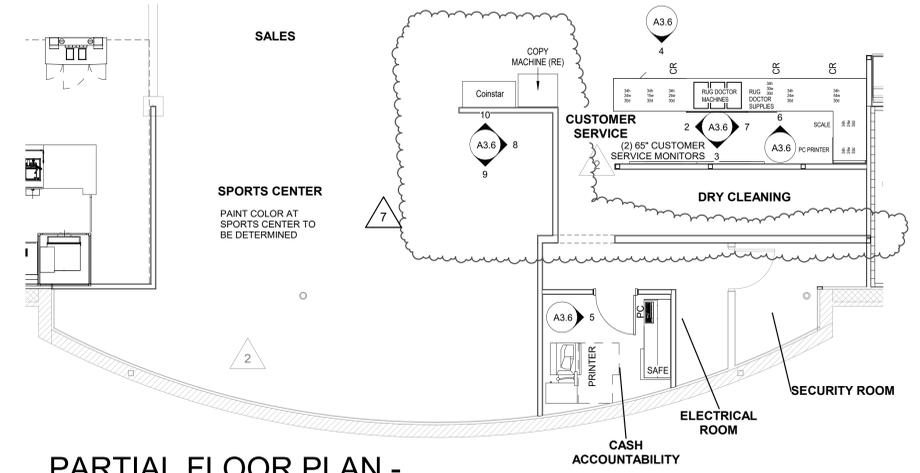

PARTIAL FLOOR PLAN - CUSTOMER SERVICE
 SCALE: 3/16" = 1'-0"


brr
 Architect of Record:
 BRS Architecture, Inc.
 Kansas City 833 Metcalf Avenue
 Overland Park, KS 66204
 Phone: 913-262-9995
 Fax: 913-262-9046

PROFESSIONAL SEAL
 RICHARD A. MAJORS, JR.
 ARCHITECT
 MISSOURI LICENSE #65200328

LOCATION
LEE'S SUMMIT, MO #2

HY-VEE INC.
 5820 WESTTOWN PARKWAY
 WEST DES MOINES, IOWA 50386
 PHONE: (515) 281-2600
 FAX: (515) 281-2636

EMPLOYEE OWNED

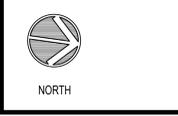


ENLARGED PLAN & ELEVATIONS - CUSTOMER & MONEY SERVICE

PROJECT MANAGER SB	CHECKED BY JPS
DRAWN BY ADP	DATE 3/19/2021
SCALE As indicated	JOB NUMBER 62930547


SHEET:
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5/19/2021 2:55:48 PM


REVISION		DATE BY
1	AS: #1	11/20/20
2	AS: #1	06/16/21

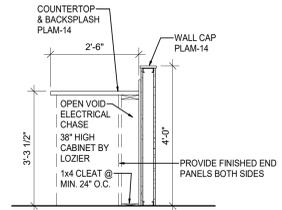


14 FILL COUNTER SECTION
SCALE: 1/2" = 1'-0"

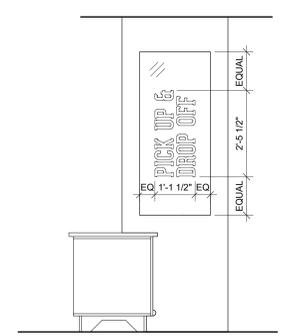


13 FRONT COUNTER SECTION
SCALE: 1/2" = 1'-0"

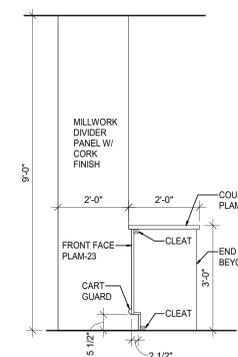


12 FRONT COUNTER SECTION
SCALE: 1/2" = 1'-0"

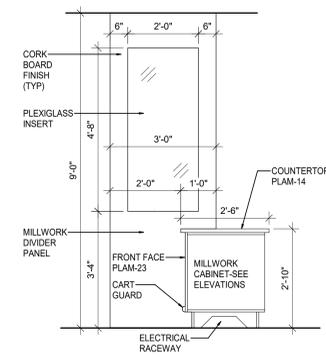


11 FRONT COUNTER SECTION
SCALE: 1/2" = 1'-0"

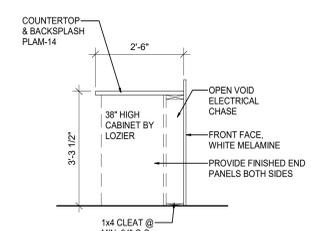


10 FILL COUNTER SECTION
SCALE: 1/2" = 1'-0"

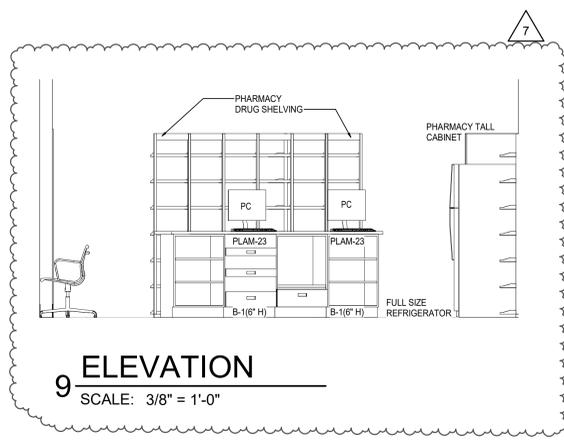


9 ELEVATION
SCALE: 3/8" = 1'-0"

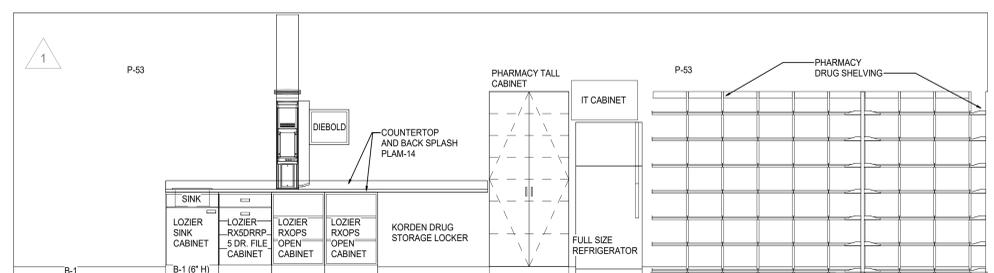


8 ELEVATION
SCALE: 3/8" = 1'-0"

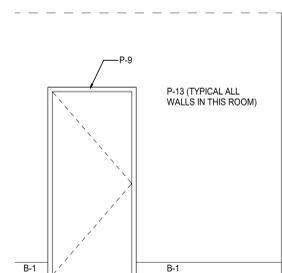


7 ELEVATION
SCALE: 3/8" = 1'-0"

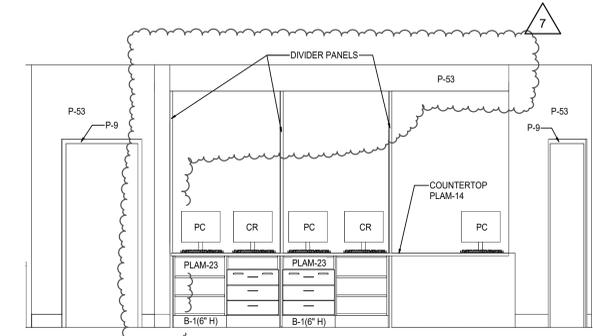


6 ELEVATION
SCALE: 3/8" = 1'-0"

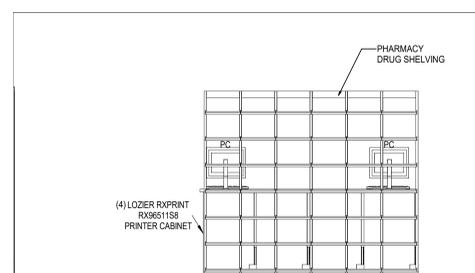


5 ELEVATION
SCALE: 3/8" = 1'-0"

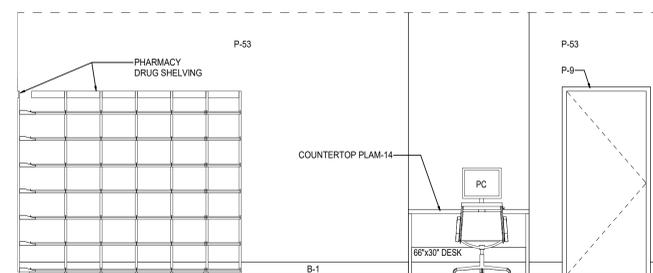

4 ELEVATION
SCALE: 3/8" = 1'-0"

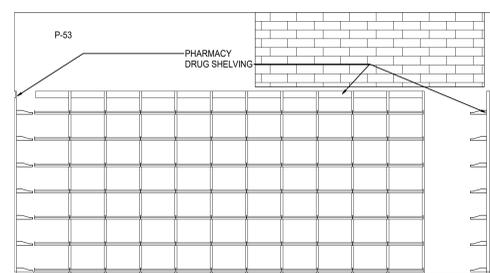


3 ELEVATION
SCALE: 3/8" = 1'-0"

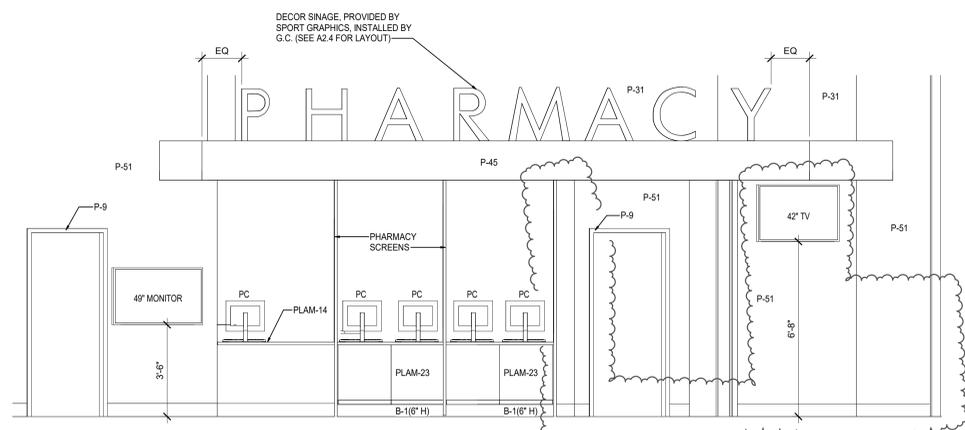

2 ELEVATION
SCALE: 3/8" = 1'-0"

GENERAL NOTES
FOR FINISH SCHEDULE SEE SHEET A2.2.

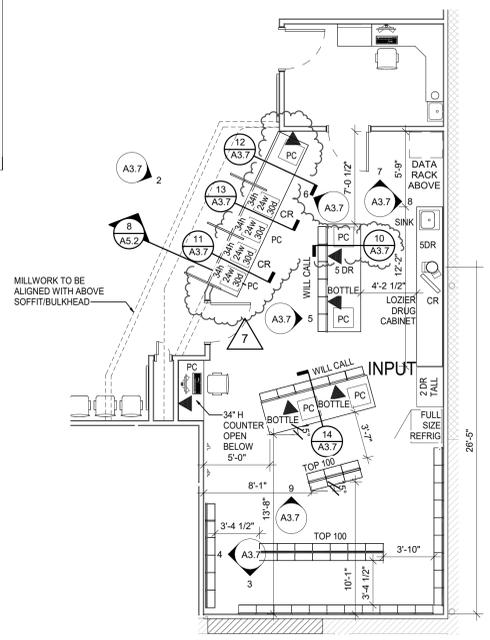

1 PARTIAL FLOOR PLAN - PHARMACY
SCALE: 3/16" = 1'-0"

brr
Architect of Record:
BRR Architecture, Inc.
Kansas City
Phoenix
Philadelphia
Austin
Los Angeles
Chicago

831 Metcalf Avenue
Suite 300
Overland Park, KS 66204
Tel: 913-262-9995
Fax: 913-262-9044


PROFESSIONAL SEAL
STATE OF MISSOURI
RICHARD A. MAJORS, JR.
NUMBER A-072811
EXPIRES 08/31/2023

Richard A. Majors, Jr.
Architect
Missouri License No. A-007528
05/20/21

LOCATION
LEE'S SUMMIT, MO #2

HY-VEE INC.
5820 WESTOWN PARKWAY
WEST DES MOINES, IOWA 50386
TEL: (515) 281-2800
FAX: (515) 281-2838
EMPLOYEE OWNED

HyVee

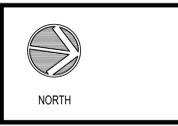

ENLARGED PLAN & ELEVATIONS - PHARMACY

PROJECT MANAGER SB	CHECKED BY Approver
DRAWN BY JR	DATE 3/19/2021
SCALE As indicated	JOB NUMBER 62930547

SHEET:
A3.7

REVISION	DATE BY
3 AS:KS AS:HE	01/26/21 06/16/21


GENERAL NOTES

SEE SHEET A2.2 FOR FINISH SCHEDULES


FOR OFFICES AND STORAGE ROOMS NOT ELEVATED, PAINT WALLS P-16, BASE B1 AND HOLLOW METAL FRAMES P-9

FOR HALLWAYS NOT ELEVATED, PAINT WALLS P-12, BASE B1 AND HOLLOW METAL FRAMES P-9


AT ALL OFFICE AREAS, PAINT UNDERCOUNTER BRACKETS TO MATCH WALL FINISH

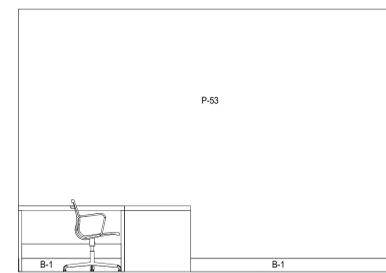


17 ELEVATION
SCALE: 3/8" = 1'-0"

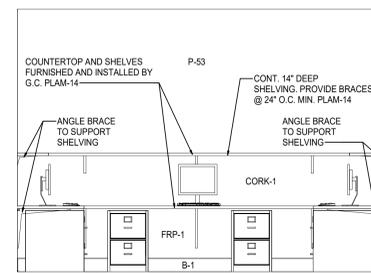


18 ELEVATION
SCALE: 3/8" = 1'-0"

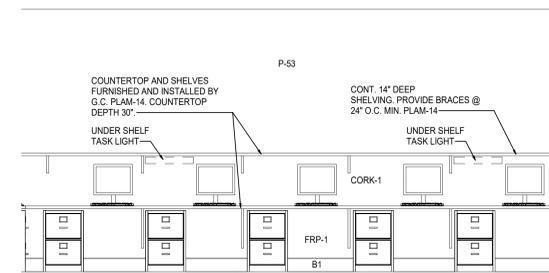


19 ELEVATION
SCALE: 3/8" = 1'-0"

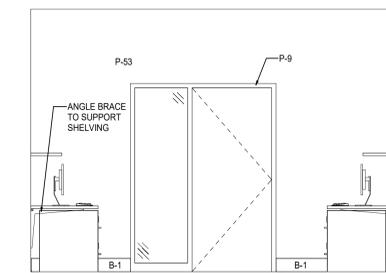


20 ELEVATION
SCALE: 3/8" = 1'-0"

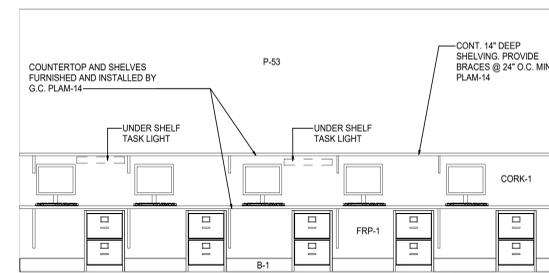


21 ELEVATION
SCALE: 3/8" = 1'-0"

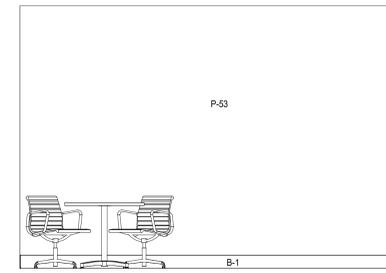


11 ELEVATION
SCALE: 3/8" = 1'-0"

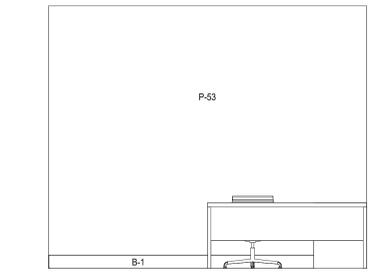


12 ELEVATION
SCALE: 3/8" = 1'-0"

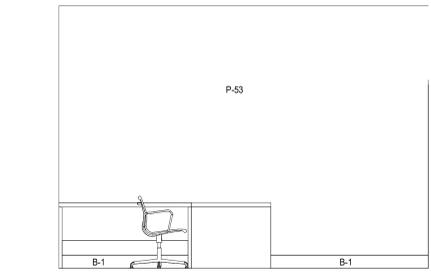


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SCALE: 3/8" = 1'-0"

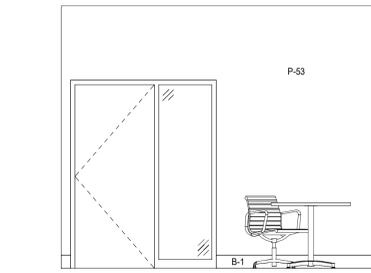


14 ELEVATION
SCALE: 3/8" = 1'-0"

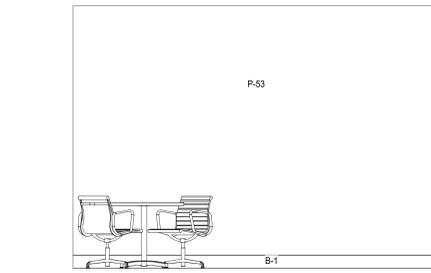


15 ELEVATION
SCALE: 3/8" = 1'-0"

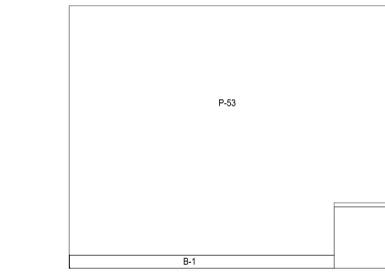


16 ELEVATION
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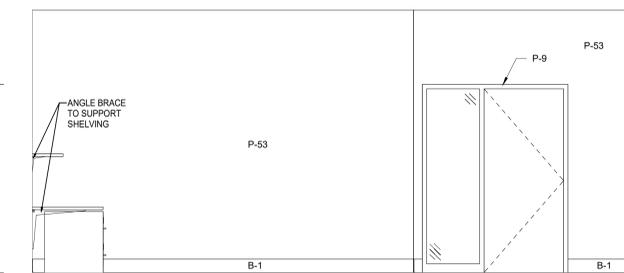
6 ELEVATION
SCALE: 3/8" = 1'-0"

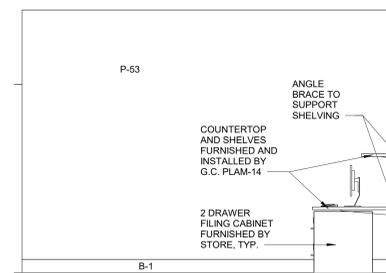


7 ELEVATION
SCALE: 3/8" = 1'-0"

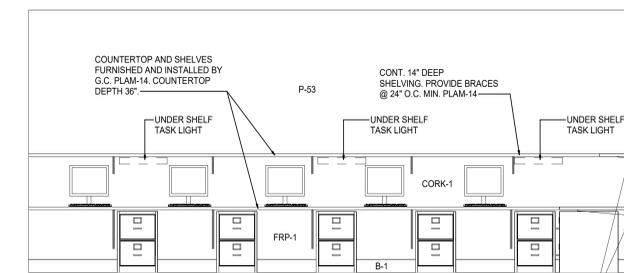


8 ELEVATION
SCALE: 3/8" = 1'-0"

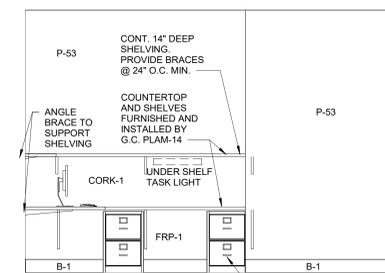


9 ELEVATION
SCALE: 3/8" = 1'-0"

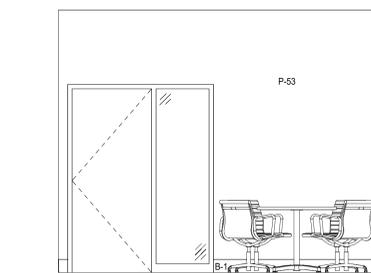


10 ELEVATION
SCALE: 3/8" = 1'-0"

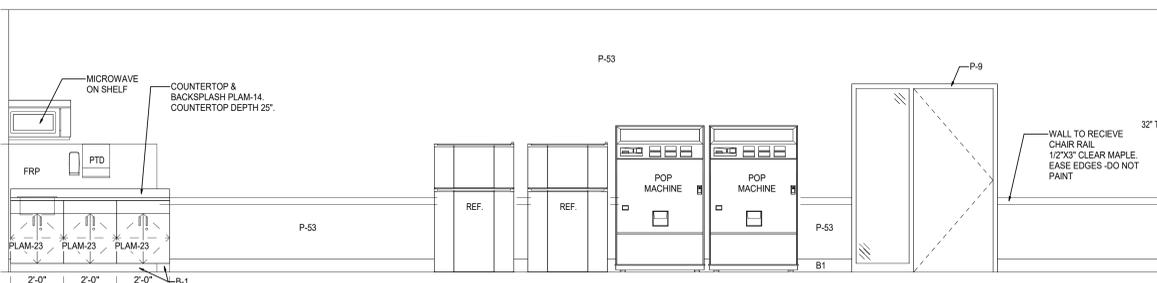

4 ELEVATION
SCALE: 3/8" = 1'-0"

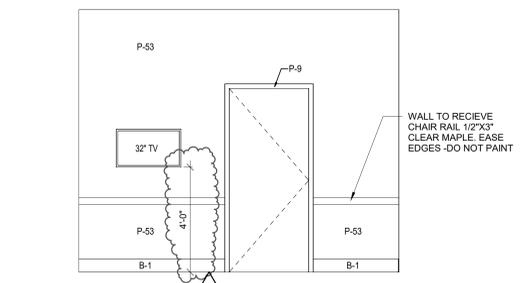


5 ELEVATION
SCALE: 3/8" = 1'-0"

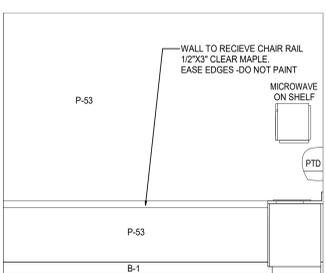

3 ELEVATION
SCALE: 3/8" = 1'-0"



2 ELEVATION
SCALE: 3/8" = 1'-0"

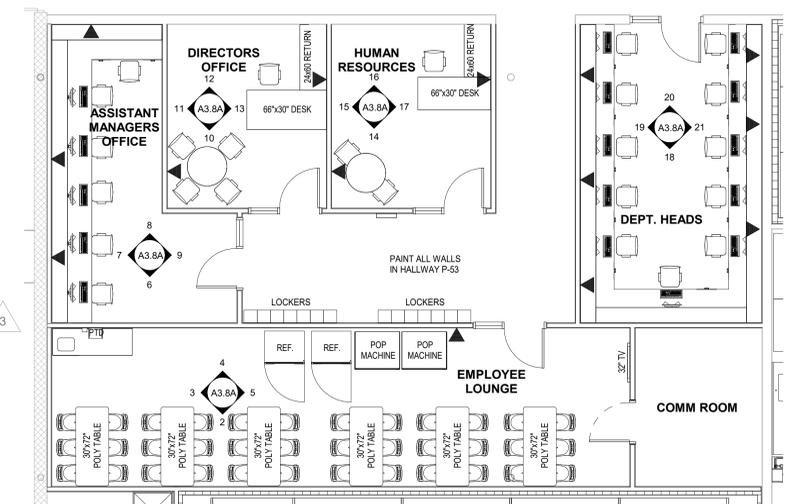

1 OFFICES
SCALE: 3/16" = 1'-0"

brr

Architect of Record:
BRS Architecture, Inc.
Kansas City
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San Francisco
Seattle
Austin
New York
Los Angeles
Chicago

8331 Metcalf Avenue
Suite 300
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Tel: 913-262-9995
Fax: 913-262-9046

PROFESSIONAL SEAL


STATE OF MISSOURI
RICHARD A. MAJORS, JR.
NUMBER
EXPIRES

Richard A. Majors, Jr.
Architect
Missouri License No. A-007328
06/23/21

LOCATION
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HY-VEE INC.
5820 WESTOWN PARKWAY
WEST DES MOINES, IOWA 50386
TEL: (515) 281-2600
FAX: (515) 267-4636

HyVee
EMPLOYEE OWNED

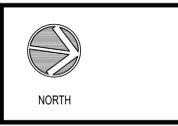



ENLARGED PLAN
& ELEVATIONS -
MISC. OFFICES

PROJECT MANAGER SB	CHECKED BY JPS
DRAWN BY AP	DATE 3/19/2021
SCALE As indicated	JOB NUMBER 62930547

SHEET:
A3.8A


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REVISION	DATE BY
2	ASJ/KS 01/08/21
3	ASJ/KS 01/09/21
5	ASJ/KS 03/19/21
6	ASJ/KS 04/16/21
7	ASJ/KS 06/16/21

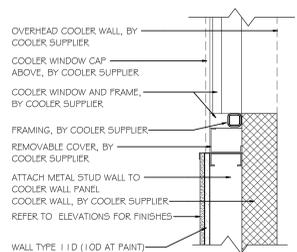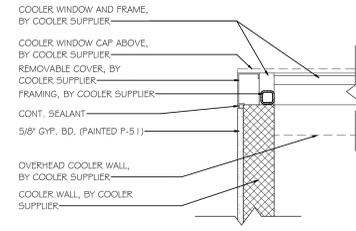


14 DISPLAY COOLER PLAN DETAIL
 SCALE: 1 1/2" = 1'-0"


13 DISPLAY COOLER PLAN DETAIL
 SCALE: 1 1/2" = 1'-0"

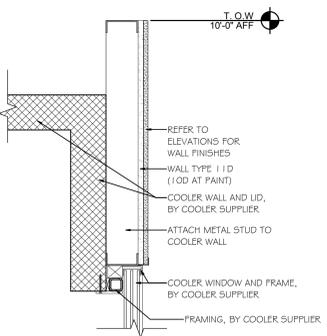


12 FLORAL SECTION
 SCALE: 1 1/2" = 1'-0"

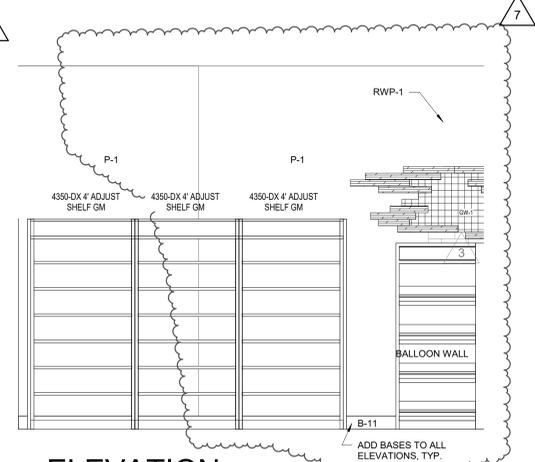


11 ELEVATION
 SCALE: 3/8" = 1'-0"

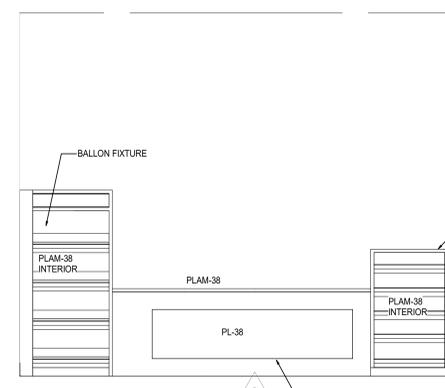


10 ELEVATION
 SCALE: 3/8" = 1'-0"

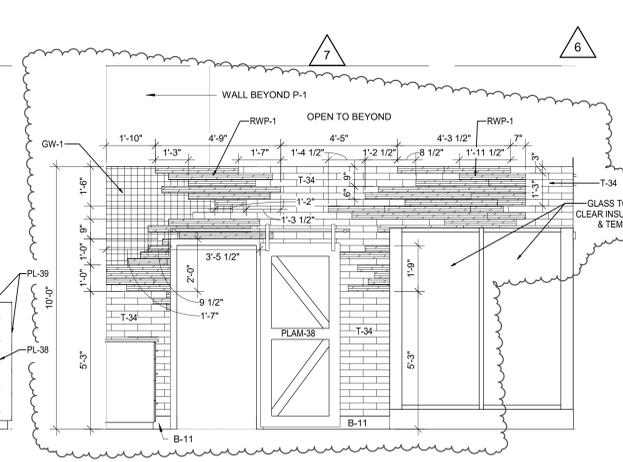


9 ELEVATION
 SCALE: 3/8" = 1'-0"

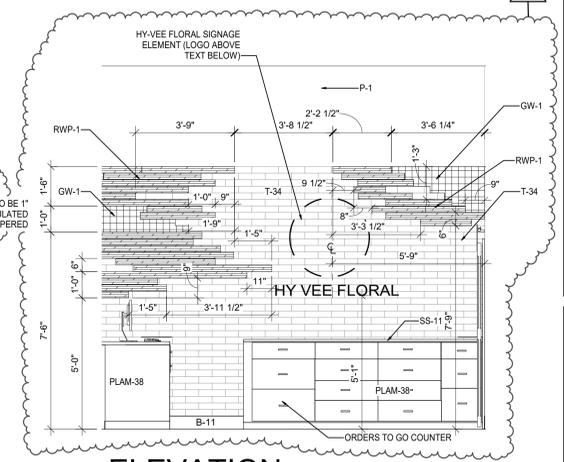


8 ELEVATION
 SCALE: 3/8" = 1'-0"

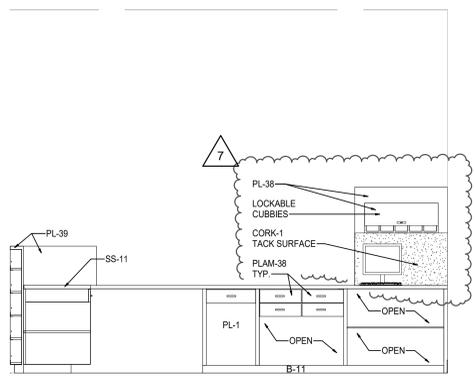


7 ELEVATION
 SCALE: 3/8" = 1'-0"

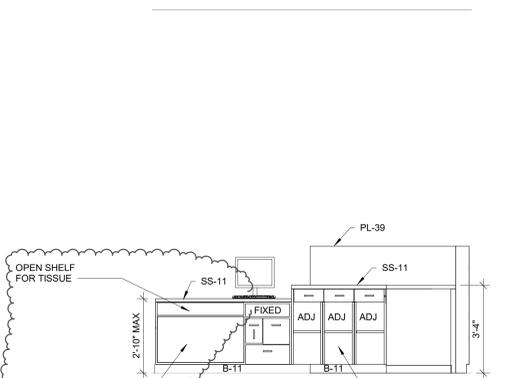


6 ELEVATION
 SCALE: 3/8" = 1'-0"

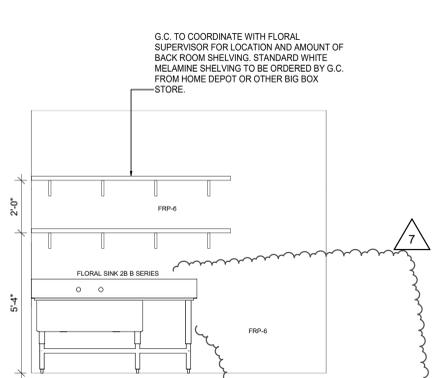


5 ELEVATION
 SCALE: 3/8" = 1'-0"

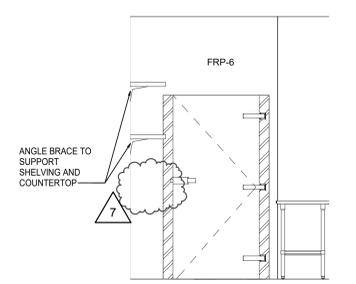


4 ELEVATION
 SCALE: 3/8" = 1'-0"

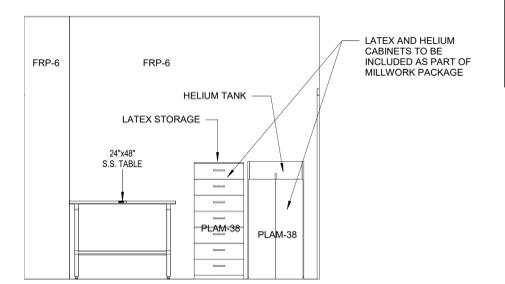

3 ELEVATION
 SCALE: 3/8" = 1'-0"

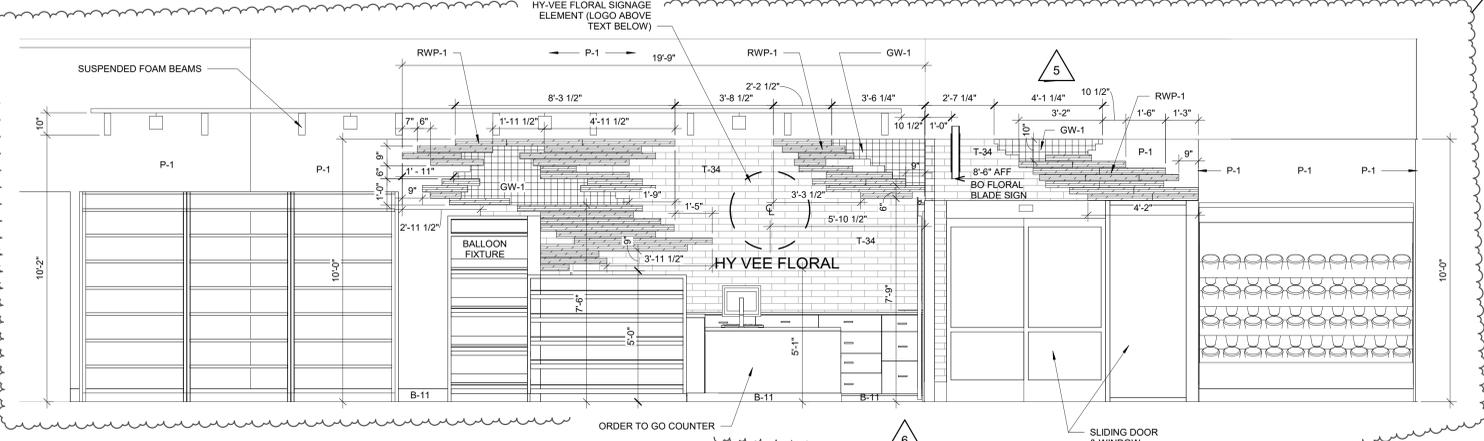

2 ELEVATION
 SCALE: 3/8" = 1'-0"

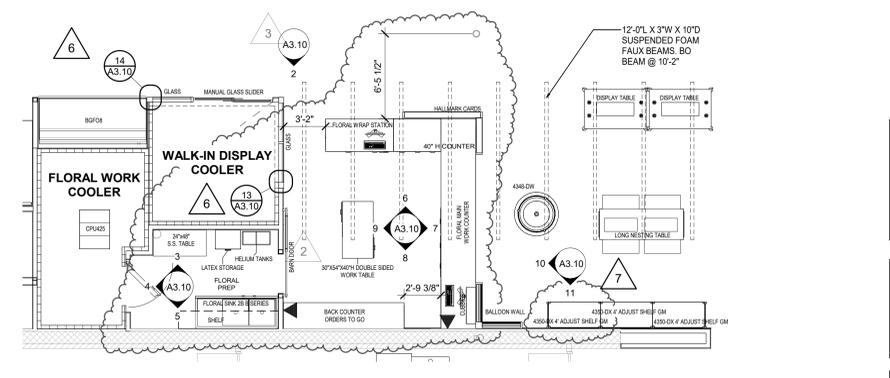

1 PARTIAL FLOOR PLAN - FLORAL
 SCALE: 3/16" = 1'-0"

GENERAL NOTES
 FOR FINISH SCHEDULE SEE SHEET A2.2

brr
 Architect of Record:
 BRR Architecture, Inc.
 Kansas City, MO 64111
 Phoenix, AZ 85004
 Philadelphia, PA 19103
 Austin, TX 78701
 Los Angeles, CA 90001
 Chicago, IL 60601

8131 Metcalf Avenue
 Suite 300
 Overland Park, KS 66204
 Tel: 913-262-9995
 Fax: 913-262-9046


PROFESSIONAL SEAL
 RICHARD A. MAJORS, JR.
 ARCHITECT
 LICENSE NO. 000000000

Richard A. Majors, Jr. (2/1/21)
 Architect
 Missouri License No. A-007528

LOCATION
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HY-VEE, INC.
 5820 WESTTOWN PARKWAY
 WEST DES MOINES, IOWA 50386
 TEL: (515) 281-2600
 FAX: (515) 267-2636


Hy-Vee
 EMPLOYEE OWNED

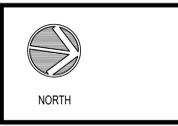


ENLARGED PLAN & ELEVATIONS - FLORAL

PROJECT MANAGER	SB	CHECKED BY	JPS
DRAWN BY	AO	DATE	3/19/2021
SCALE	As indicated	DWG NUMBER	62930547
SHEET	A3.10		


REVISION	DATE BY
7	ASB
6	ASB

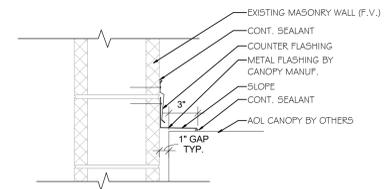


7 **DETAIL**
SCALE: 1 1/2" = 1'-0"

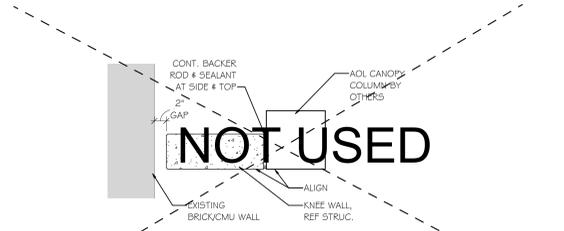


6 **KNEE WALL ENLARGED PLAN**
SCALE: 1" = 1'-0"

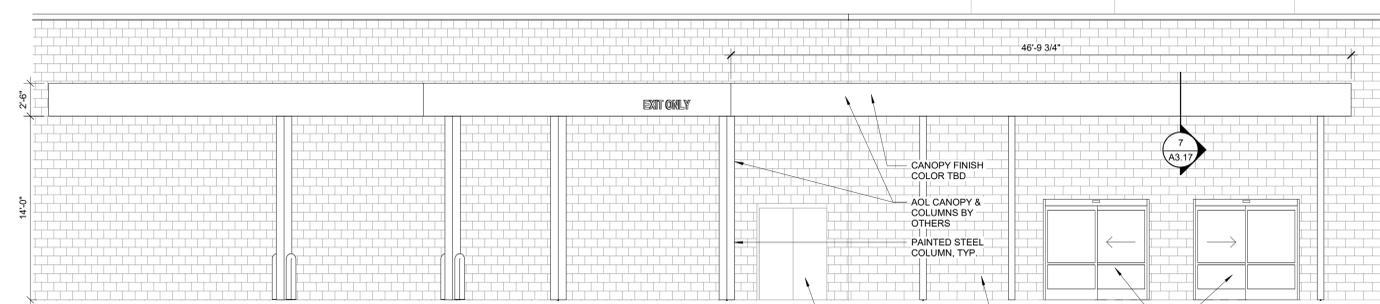


5 **ELEVATION 04**
SCALE: 3/16" = 1'-0"

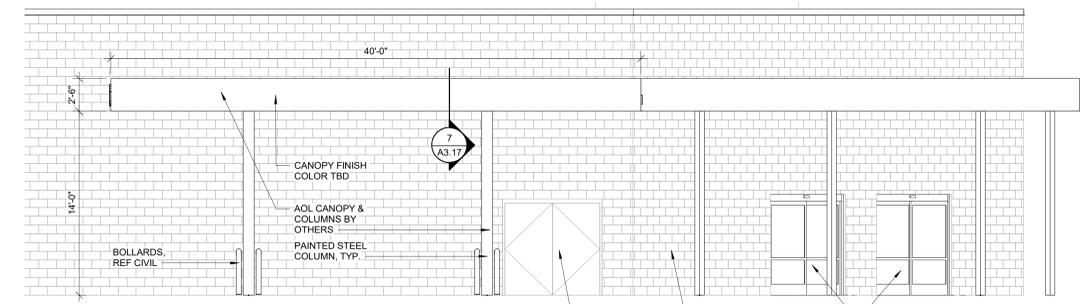


4 **ELEVATION 03**
SCALE: 3/16" = 1'-0"

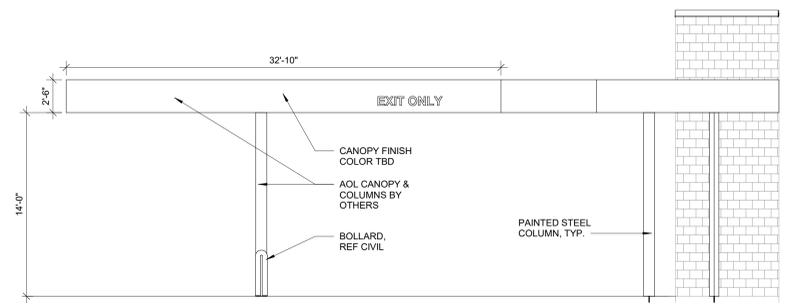

3 **ELEVATION 02**
SCALE: 3/16" = 1'-0"

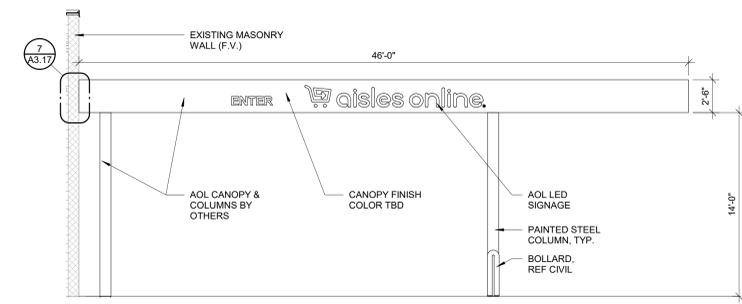

2 **ELEVATION 01**
SCALE: 3/16" = 1'-0"

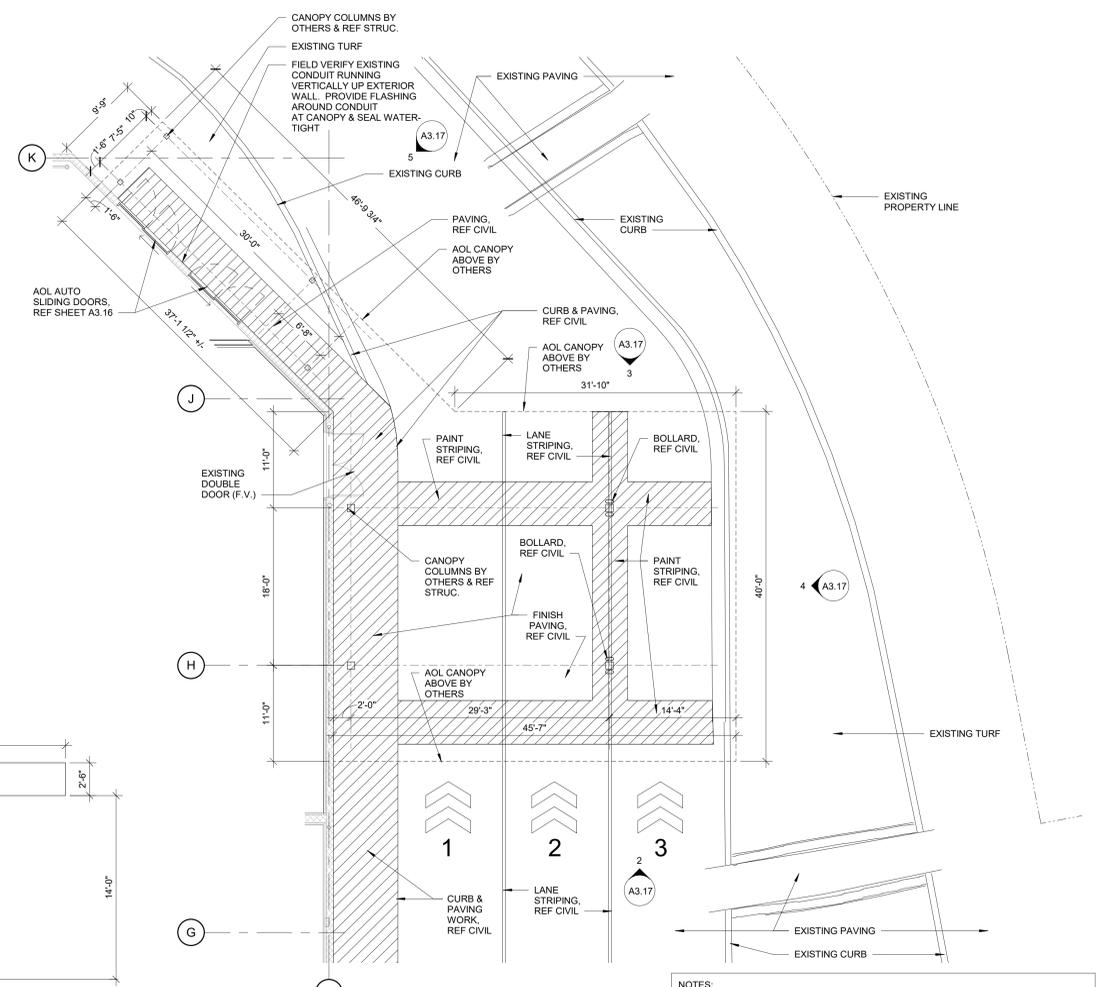

1 **AOL CANOPY PLAN**
SCALE: 1/8" = 1'-0"

NOTES:
1) ALL EXTERIOR PAVING, CURB, PAINT STRIPING, & ETC. SCOPE OF WORK, REF CIVIL
2) AOL CANOPY COLUMN FOOTINGS, REF STRUC.
3) AOL CANOPY & COLUMNS BY OTHERS

brr

Architect of Record:
BRS Architecture, Inc.
Kansas City 8131 Metcalf Avenue
Berkeley Suite 300
Phoenix San Francisco
Philadelphia
Atlanta Tel: 913-262-9995
Austin Fax: 913-262-9044
Los Angeles
Chicago


PROFESSIONAL SEAL
STATE OF MISSOURI
RICHARD A. MAJORS, JR.
NUMBER A-97281-1
LICENSED ARCHITECT

Richard A. Majors, Jr.
Architect
Missouri License No. 20072328

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PHONE (515) 281-2800
FAX (515) 281-2838

HyVee
EMPLOYEE OWNED

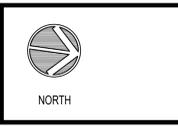


AOL CANOPY PLAN & ELEVATIONS

PROJECT MANAGER	CHECKED BY
SB	JPS
DRAWN BY	DATE
DIN	3/19/2021
SCALE	JOB NUMBER
As indicated	62930547

SHEET: **A3.17**

REVISION	DATE BY
1	AS1 #1 11/12/20
2	AS1 #2 01/08/21
3	AS1 #3 01/26/21
4	AS1 #4 03/19/21
5	AS1 #5 04/16/21
6	AS1 #6 04/16/21
7	AS1 #8 05/19/21

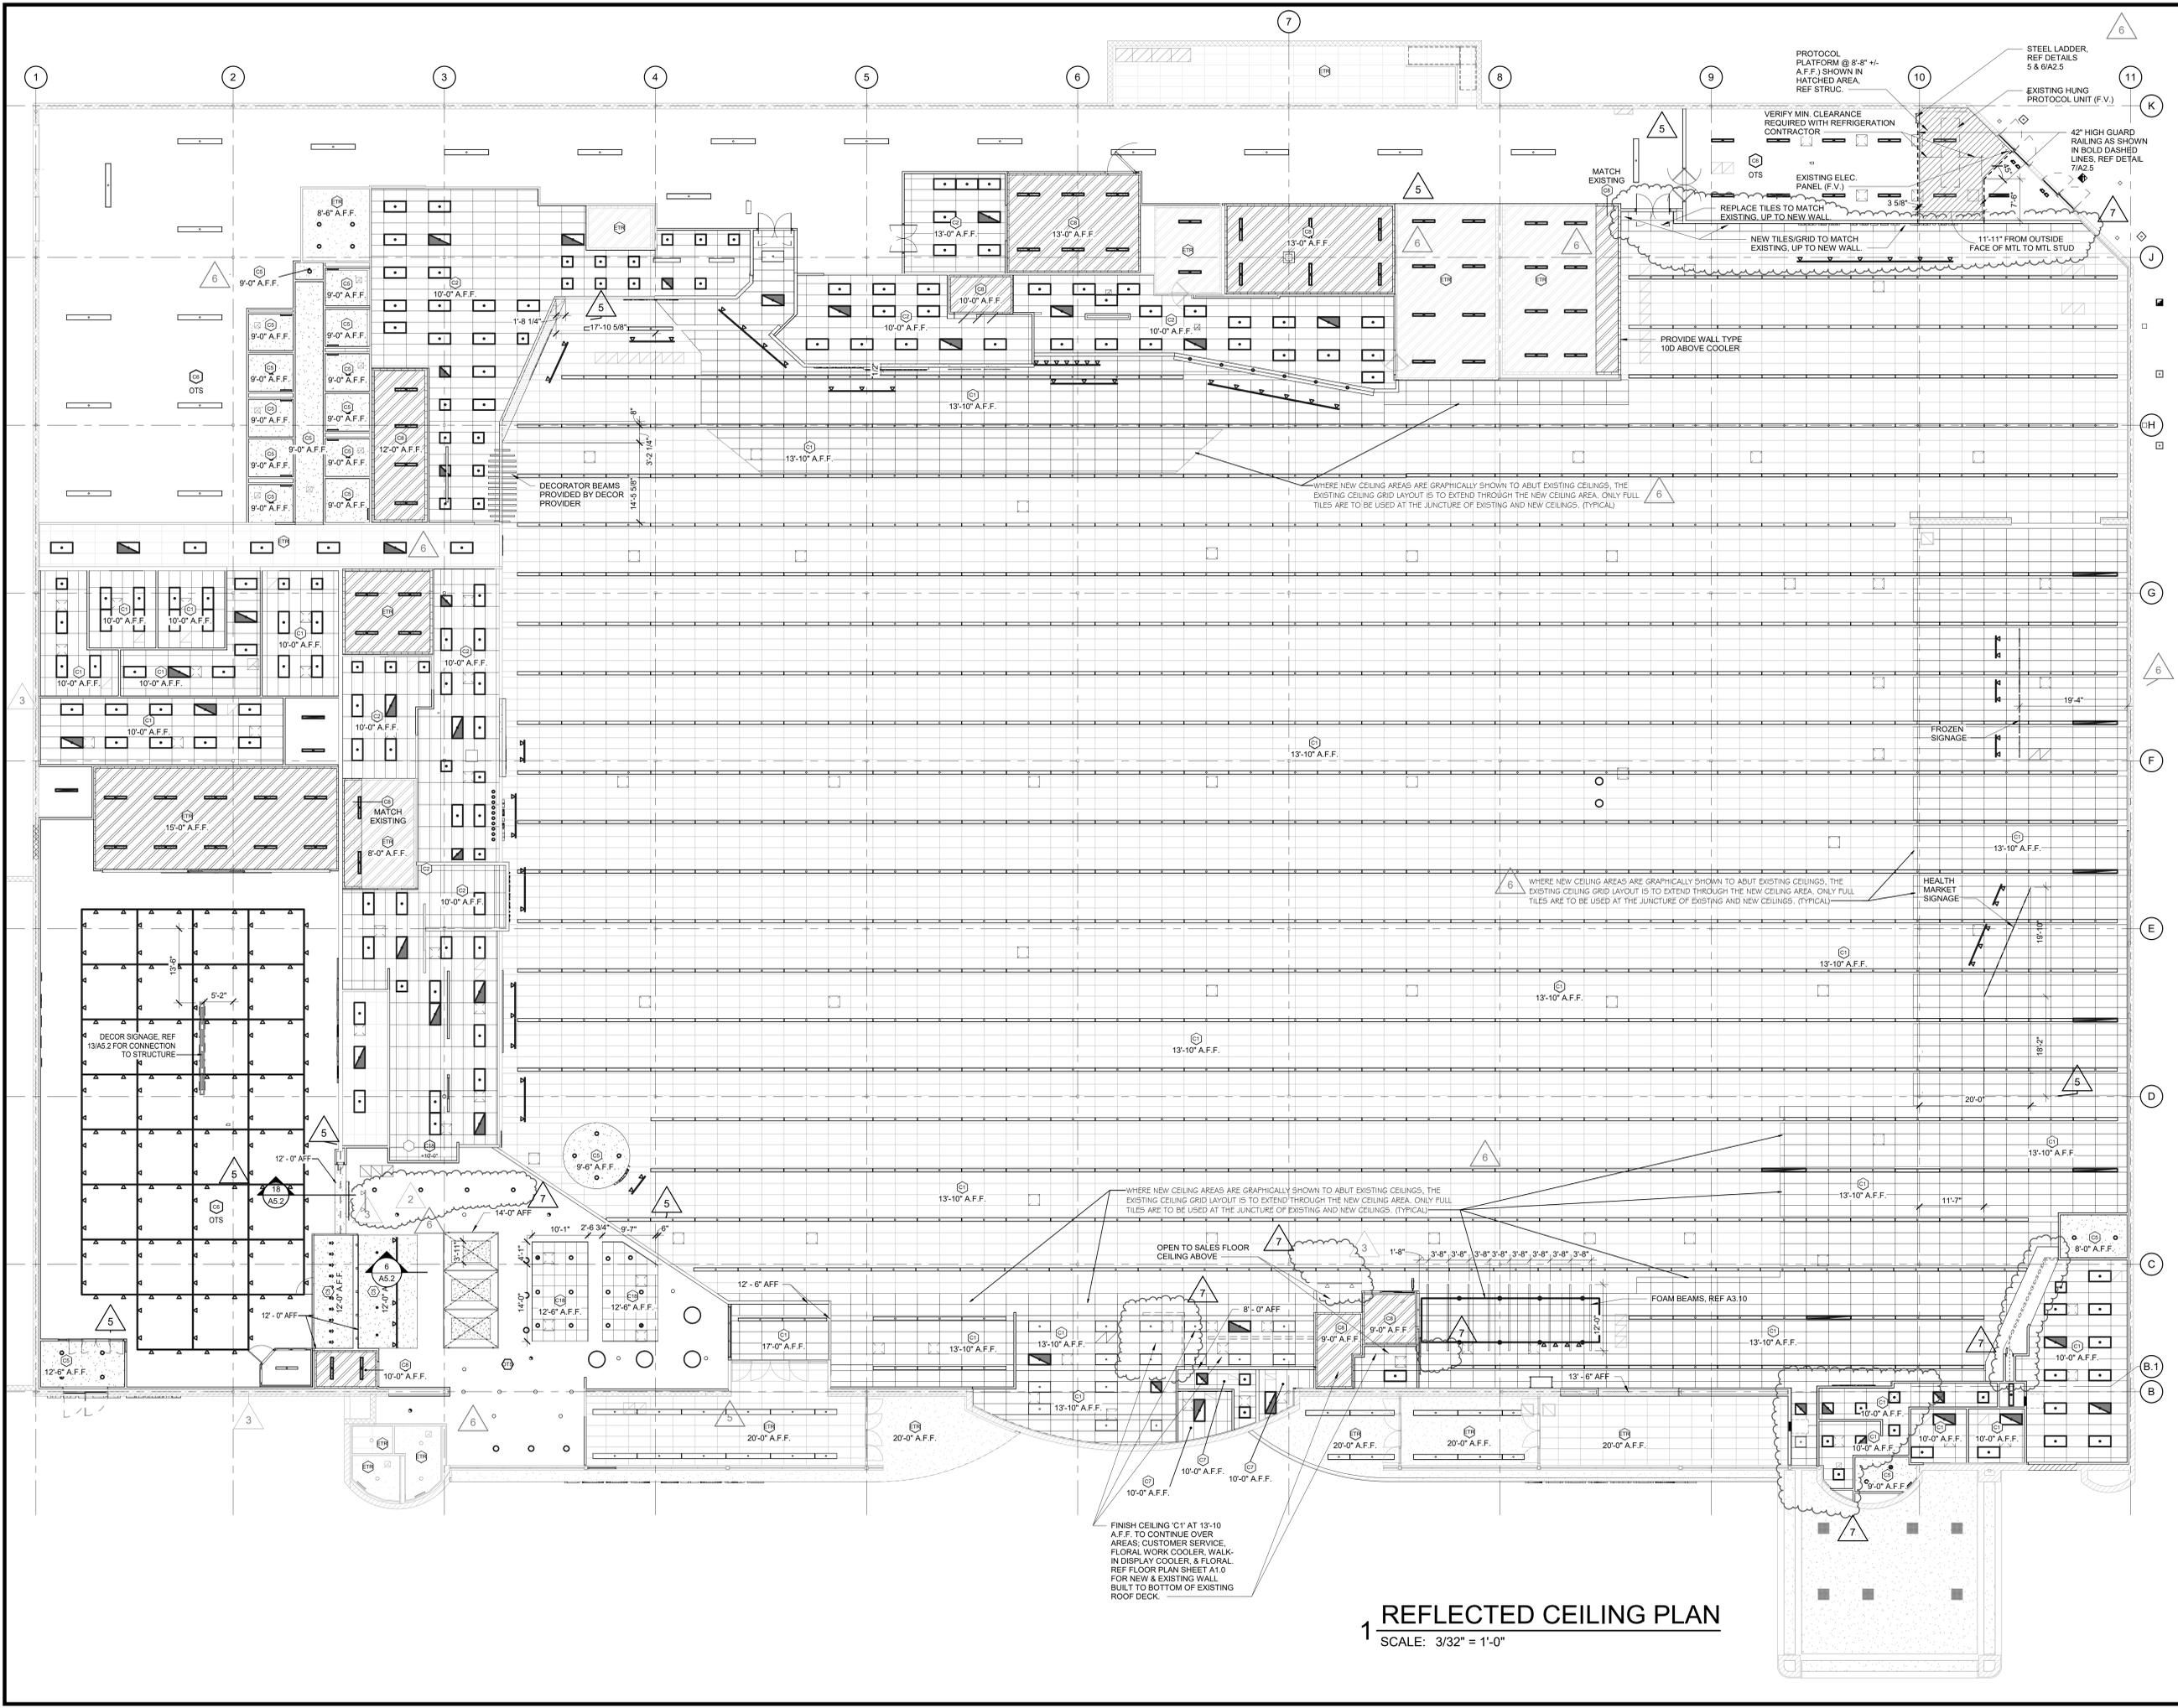

1 REFLECTED CEILING PLAN
SCALE: 3/32" = 1'-0"

brr

Architect of Record:
BRS Architecture, Inc.
Kansas City 8331 Metcalf Avenue
Suite 300
Overland Park, KS 66204
Phone: 913-262-9995
Fax: 913-262-9046


PROFESSIONAL SEAL
STATE OF MISSOURI
RICHARD A. MAJORS, JR.
NUMBER A-072818
EXPIRES 12/31/2022

Richard A. Majors, Jr. [21]
Architect License No. A-007328

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LEE'S SUMMIT, MO #2

HY-VEE INC.
5820 WESTOWN PARKWAY
WEST DES MOINES, IOWA 50386
PHONE: (515) 281-2600
FAX: (515) 267-2636

Hy-Vee
EMPLOYEE OWNED

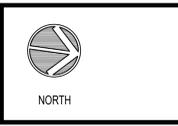


REFLECTED
CEILING PLAN

PROJECT MANAGER	CHECKED BY
SB	JPS
DRAWN BY:	DATE:
AO	3/19/2021
SCALE:	JOB NUMBER:
3/32" = 1'-0"	62930547

SHEET:
A5.1

5/20/2021 1:00:54 PM


REVISION	DATE BY
2 ASI #2	01/02/21
5 ASI #5	04/16/21
6 ASI #7	04/16/21
7 ASI #8	05/19/21

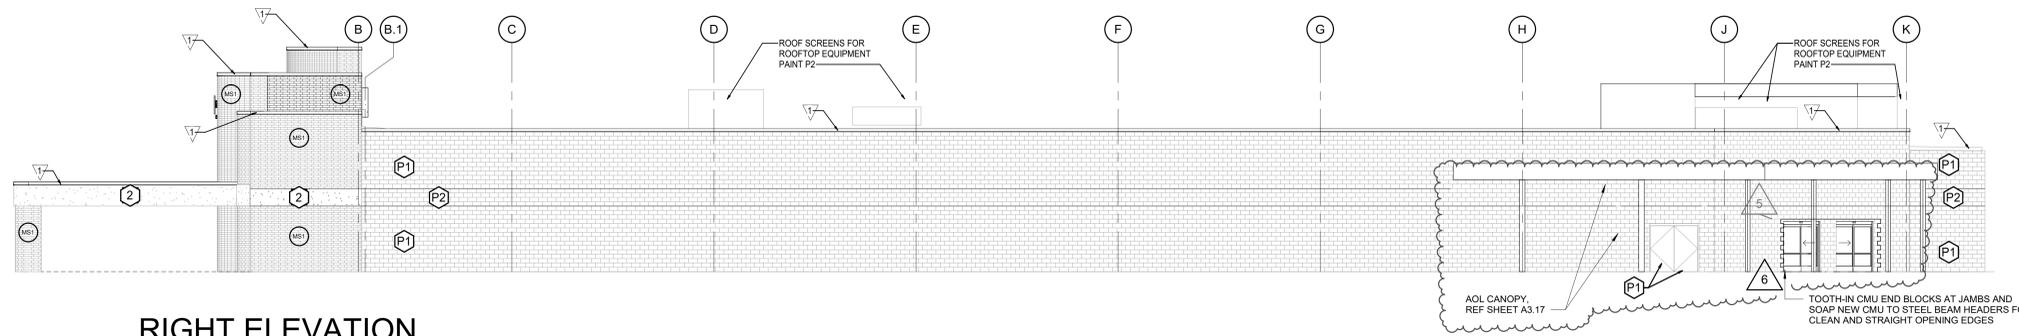


1 RIGHT ELEVATION
SCALE: 3/32" = 1'-0"

- MASONRY STAIN COLORS:**
- M81 COLOR TO MATCH KANSAS BRICK AND TILE #530 FLASH FACE SET
 - M82
- PAINT COLORS:**
- P1 MATCH S.W. #7527 "MAISON BLANCHE"
 - P2 MATCH S.W. #7527 "NANTUCKET DUNE"
 - P3 MATCH NEW BRICK COLOR - KANSAS BRICK AND TILE #530 FLASH FACE SET
 - P4 ALL EXISTING STOREFRONT MULLIONS ARE TO BE PAINTED TO MATCH "ANODIZED ALUMINUM" PER SPECS
- METAL FLASHINGS:**
- REFINISHED METAL WALL CAP COLOR TO MATCH S.W. #7526 MAISON BLANCHE
- EXTERIOR METAL ASSEMBLIES:**
- PAINT ALL EXTERIOR PIPE BOLLARDS TO MATCH MAIN BRICK COLOR - P3


TUCKPOINT EXISTING BRICK AS NEEDED. COORDINATE LOCATIONS WITH HY-VEE.

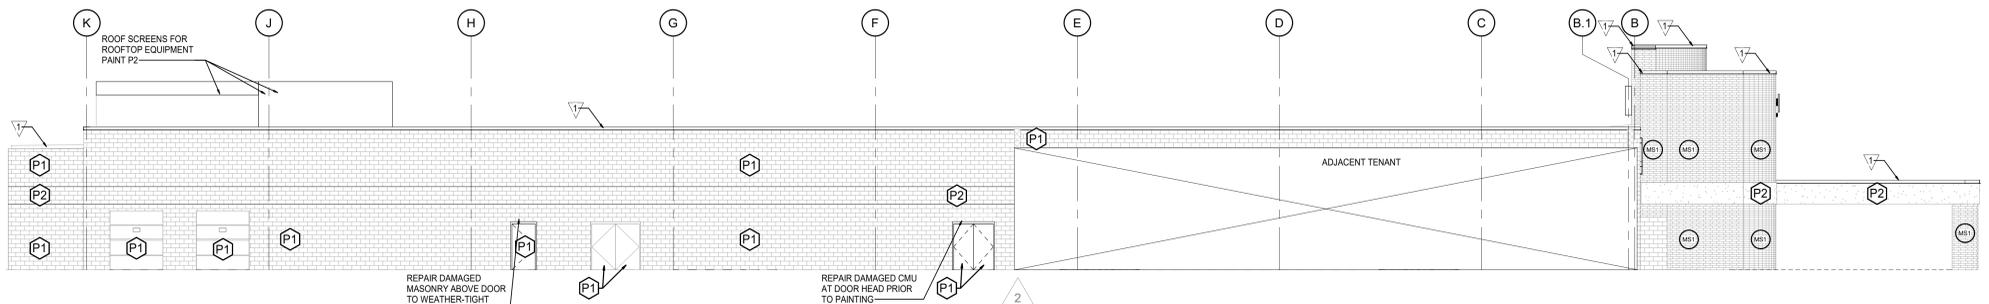


2 LEFT ELEVATION
SCALE: 3/32" = 1'-0"

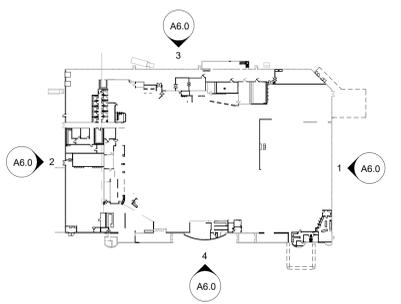

KEY PLAN
SCALE: N.T.S.

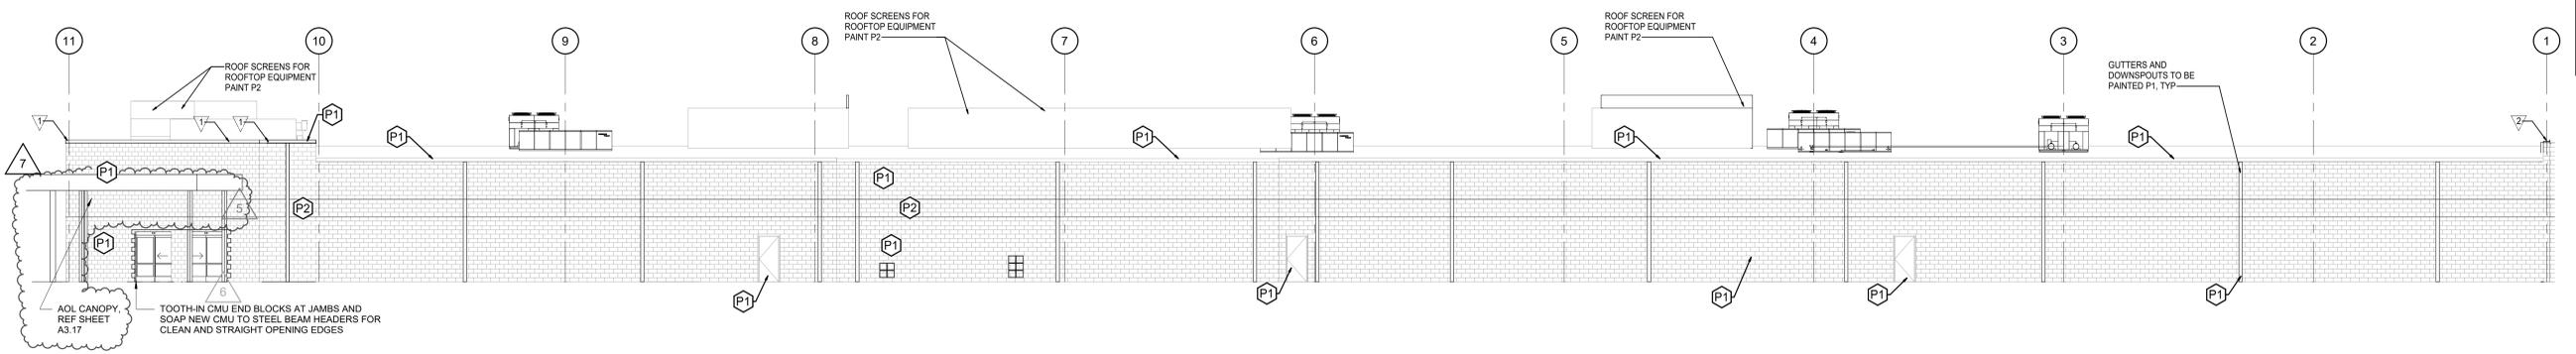

3 REAR ELEVATION
SCALE: 3/32" = 1'-0"

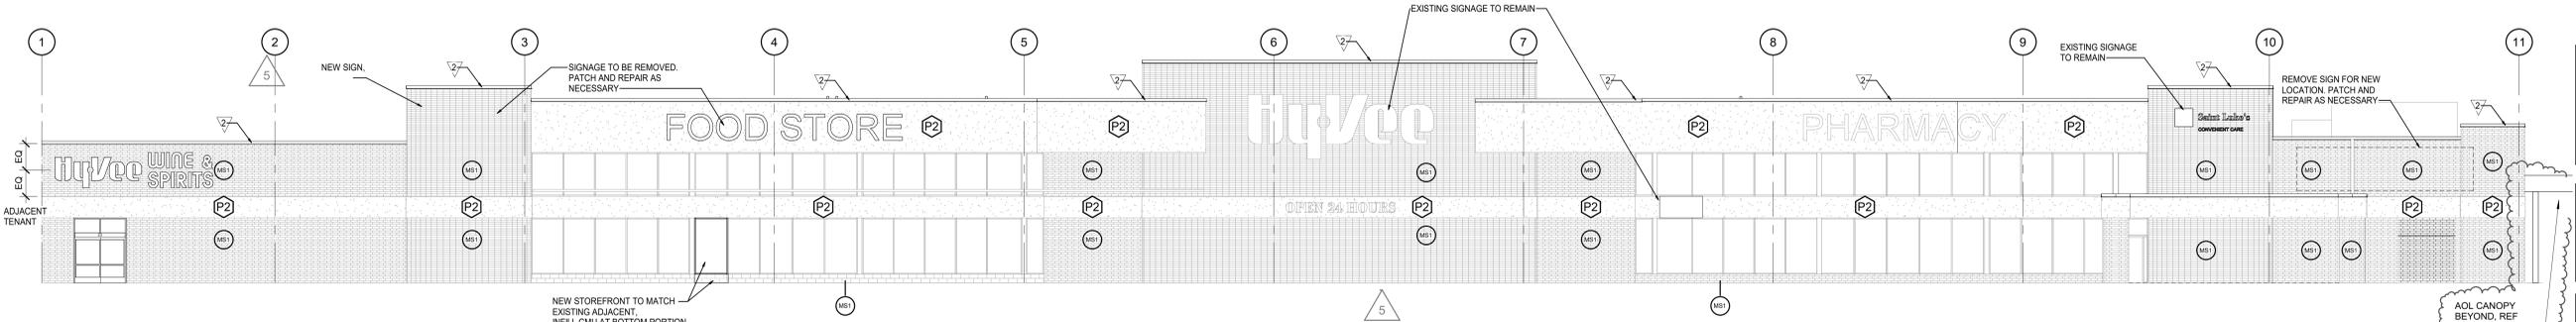

4 FRONT ELEVATION
SCALE: 3/32" = 1'-0"

brr


Architect of Record:
BRS Architecture, Inc.
Kansas City 8333 Metcalf Avenue
Overland Park, KS 66204
Tel: 913-262-9095
Fax: 913-262-9044

PROFESSIONAL SEAL
STATE OF MISSOURI
RICHARD A. MAJORS, JR.
NUMBER 4-07381
EXPIRES 12/31/2021
Richard A. Majors, Jr.
Architect
Missouri License No. A-007328

LOCATION
LEE'S SUMMIT, MO #2

HY-VEE INC.
5820 WESTOWN PARKWAY
WEST DES MOINES, IOWA 50386
TEL: (515) 281-2600
FAX: (515) 267-4636

HyVee
EMPLOYEE OWNED

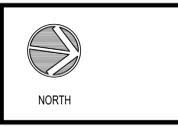

EXTERIOR ELEVATIONS

PROJECT MANAGER SB	CHECKED BY JPS
DRAWN BY SB	DATE 3/19/2021
SCALE As indicated	JOB NUMBER 62930547


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REVISION	DATE BY
4 ASI #4	2/5/21
5 ASI #5	3/19/21
6 ASI #7	4/21/21
7 ASI #8	5/19/21

FROZEN/DAIRY						
Condition	Dept	General Description	Qty	Vendor	Manufacturer	Manf Model
NEW	FD1	CASE	5	HUSSMANN	HUSSMANN	RLN-2
NEW	FD2	CASE	14	HUSSMANN	HUSSMANN	RLN-5
NEW	FD3	CASE	5	HUSSMANN	HUSSMANN	RLN-5
NEW	FD4	CASE	57	HUSSMANN	HUSSMANN	EO08U-12
NEW	FD5	CASE	5	HUSSMANN	HUSSMANN	DOPL-8
NEW	FD6	CASE	6	HUSSMANN	HUSSMANN	EO08U-8
NEW	FD7	CASE	15	HUSSMANN	HUSSMANN	RLN-3
NEW	FD8	MILK WOODRIF	1	BLOF CORP	BLOF CORP	
NEW	FD9	COOLER, DAIRY	1			
NEW	FD10	COOLER DOORS - DAIRY	1			
QUANTITY: 20						

ENLARGED EQUIPMENT PLAN HEALTH MARKET


SCALE: 1/8" = 1'-0"

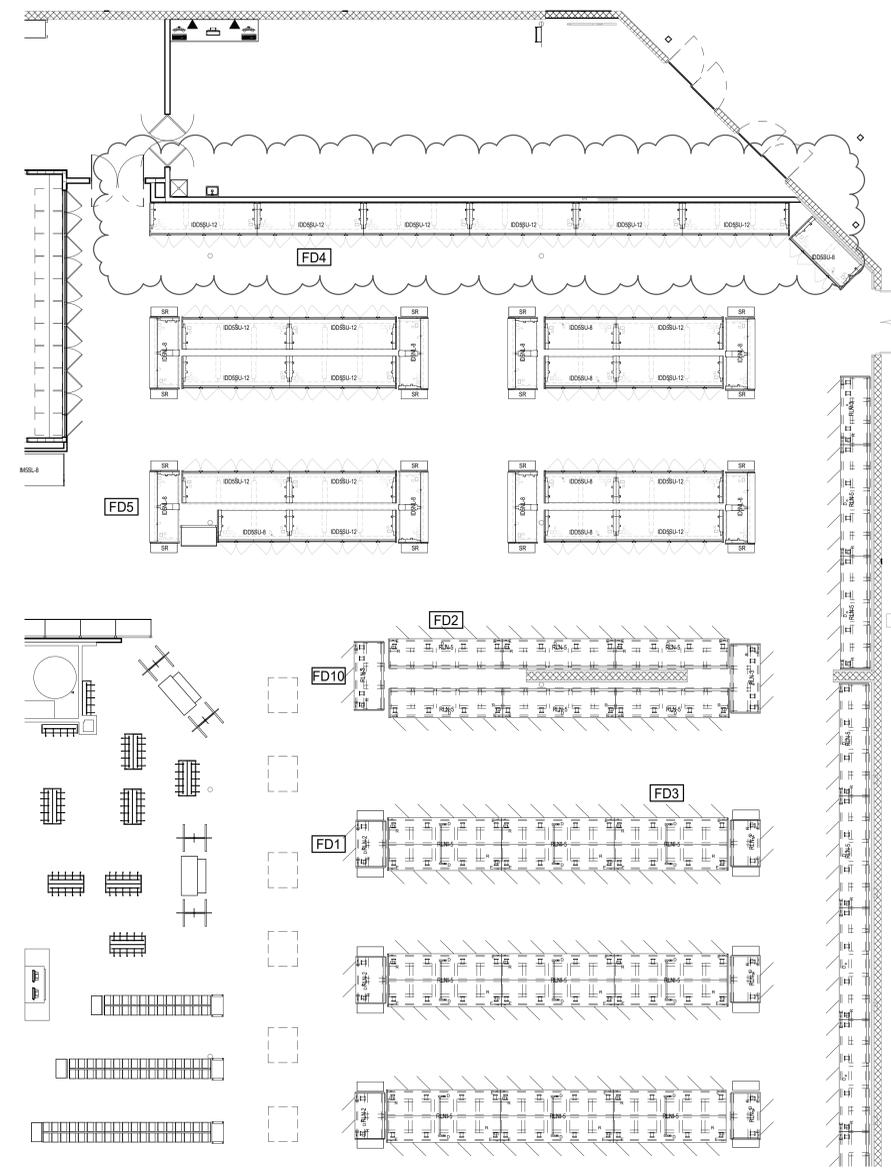

EQUIPMENT PLAN FROZEN/DAIRY

SCALE: 1/8" = 1'-0"


SEAFOOD						MEAT							
Condition	Dept	General Description	Qty	Vendor	Manufacturer	Manf Model	Condition	Dept	General Description	Qty	Vendor	Manufacturer	Manf Model
NEW	S1	SCALE, WIRELESS	1	HOBART CORPORATION	HOBART	HTI-7LS	NEW	M1	PATTY MACHINE	1	DUPREY	BRD	P200
NEW	S10	MEAT SEAL	1	HUSSMANN	HUSSMANN	100A	NEW	M2	TRANSFER	1	HOBART	HOBART	
NEW	S15	POLY TABLE	2	JOHN BOOS	JOHN BOOS	3-COMP SINK	NEW	M4	WRAP STATION	1	HOBART	HOBART	HTI-7LS
NEW	S99	SEAFOOD - SINK	1	JOHN BOOS	JOHN BOOS	3-COMP SINK	NEW	M8	SCALE, WIRELESS	3	HOBART CORPORATION	HOBART	HTI-7LS
RELOCATED	S200	CASE	1	BORGSEN	BORGSEN	3-COMP SINK	NEW	M9	CASE, REFRIG, SE OPEN	2	HUSSMANN	HUSSMANN	MSSL-12
NEW	S201	CASE	1	HUSSMANN	HUSSMANN	DOPLM-12	NEW	M10	CASE, REFRIG, SE OPEN	2	HUSSMANN	HUSSMANN	MSSL-8
							NEW	M11	CASE	1	HUSSMANN	HUSSMANN	PWGL-8
							NEW	M19	MEAT - SINK	1	JOHN BOOS	JOHN BOOS	3-COMP SINK
							EXISTING	M203	COOLER - MEAT	1			
							EXISTING	M204	FREEZER - MEAT	1	HOBART	HOBART	BE14-1
							EXISTING	M205	MEAT SAW	1	HOBART	HOBART	MU1032
							RELOCATED	M206	MIXER/HENDER	1	HOBART	HOBART	BE10-2

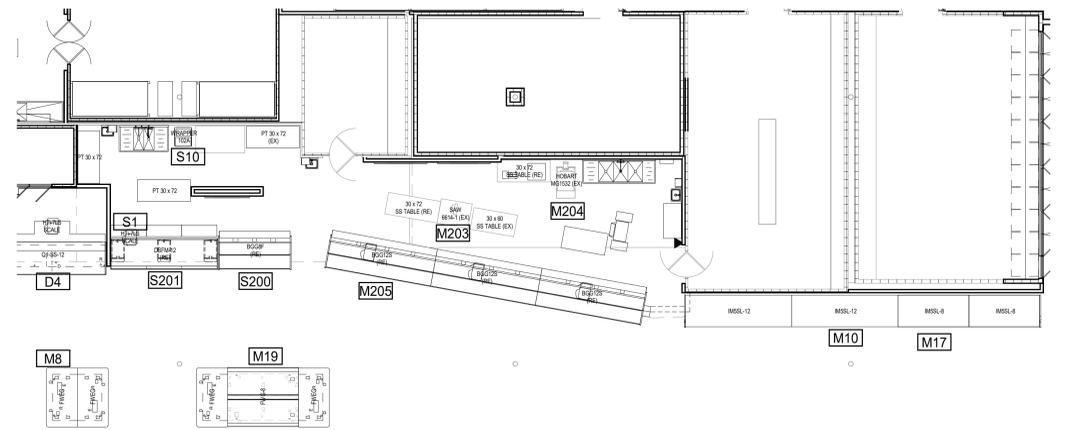

EQUIPMENT PLAN MEAT/SEAFOOD

SCALE: 1/8" = 1'-0"


DELI						
Condition	Dept	General Description	Qty	Vendor	Manufacturer	Manf Model
NEW	D1	SLICER	1	HOBART CORPORATION	HOBART	2012-1
NEW	D2	SCALE, WIRELESS	3	HOBART CORPORATION	HOBART	HTI-7LS
NEW	D4	CASE	1	HUSSMANN	HUSSMANN	Q1-SS-12R
NEW	D6	WRAPPER	1	HUSSMANN	HUSSMANN	100A
NEW	D8	CASE	1	HUSSMANN	HUSSMANN	Q1-SS-12R
NEW	D10	SS TABLE	2	JOHN BOOS	JOHN BOOS	30M
NEW	D13	SLICER, SEMI AUTO	1	HOBART	HOBART	GM55VBD
NEW	D14	CASE	1	STRUCTURAL CONCEPTS	STRUCTURAL CONCEPTS	GM55VBD
NEW	D17	CASE	2	BORGSEN	BORGSEN	
NEW	D99	DELI SINK	1	JOHN BOOS	JOHN BOOS	3-COMP PLATTER SINK
NEW	D100	COOLER, DELI	1			
NEW	D101	COOLER DOORS - DELI	1			QUANTITY: 3

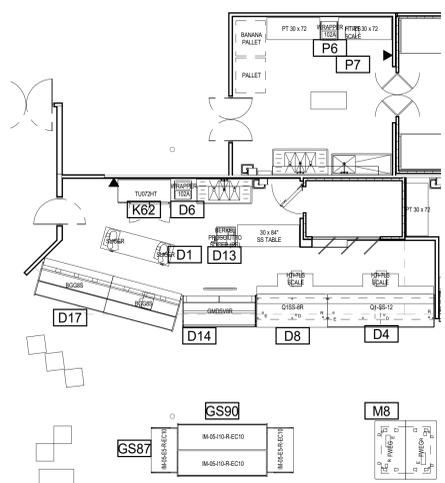

EQUIPMENT PLAN DELI

SCALE: 1/8" = 1'-0"

BAKERY						
Condition	Dept	General Description	Qty	Vendor	Manufacturer	Manf Model
NEW	B1	SCALE, WIRELESS	1	HOBART CORPORATION	HOBART	HTI-7LS
NEW	B2	PROOFER, BAKERY	1	HOBART CORPORATION	BAKERY	HPWZE
NEW	B3	CRAN, BAKERY RACK	1	HOBART CORPORATION	BAKERY	OVN002
NEW	B7	INGREDIENTS TABLE	1	JOHN BOOS	JOHN BOOS	SB410
NEW	B8	DOUGH FEEDER	1	HORIZON	HELLSHAW	BAK
NEW	B10	DOUGH GLAZER	1	HORIZON	HELLSHAW	HS24C
NEW	B12	PROOFER, BAKERY	1	ASE	AMBER304	10040
NEW	B13	SHRETTER	1	LVO MFG.	SK04	
NEW	B15	SS TABLE	2	JOHN BOOS	JOHN BOOS	30M
NEW	B18	BREAD SLICER	1	JAC, INC.	JAC, INC.	VARIA PRO 860
NEW	B20	SS TABLE	1	JOHN BOOS	JOHN BOOS	30M
NEW	B24	CASE	5	STRUCTURAL CONCEPTS	STRUCTURAL CONCEPTS	GM55VBD
NEW	B26	OPEN BAKERY RACK	1	BAKERY	BAKERY	OVN002
NEW	B31	BAKER'S BENCH W/ CASTERS	1	JOHN BOOS	JOHN BOOS	OVN50
NEW	B36	MICROWAVE	1	HUSSMANN	AMANN	RS10
NEW	B40	BLACK RACK	2	JAC	JAC	99" BLACK RACK
NEW	B41	BLACK RACK	2	JAC	JAC	99" BLACK RACK
NEW	B42	CASE	2	STRUCTURAL CONCEPTS	STRUCTURAL CONCEPTS	GM55VBD
NEW	B55	FLOUR FLOUR SCALE	1	JAC	JAC	DE 530
NEW	B59	CHUTE SLICER	1	JAC	JAC	CHUTE 150
NEW	B60	SPIRAL MIXER	1	HOBART	HOBART	HLS 100-1
NEW	B66	BAKERY - POT FILLER	1	JOHN BOOS	JOHN BOOS	POT FILLER
NEW	B69	BAKERY - SINK	1	JOHN BOOS	JOHN BOOS	3-COMP SINK
NEW	B101	FREEZER - BAKERY	1	JOHN BOOS	JOHN BOOS	SB2-S18RS3270
RELOCATED	B200	TABLE 4' X 12'	1	JOHN BOOS	JOHN BOOS	APR016.3
EXISTING	B202	PAN WASHER	1	LVO MFG.	LVO MFG.	FL 10E
EXISTING	B203	MIXER	1	HOBART	HOBART	HL1400-1

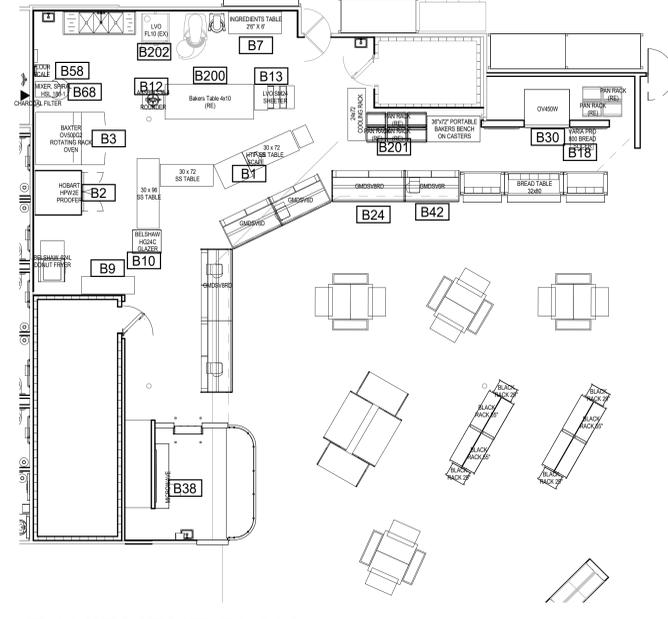

EQUIPMENT PLAN BAKERY

SCALE: 1/8" = 1'-0"

LOCATION:
LEE'S SUMMIT #2 HY-VEE
LEE'S SUMMIT, MO
HY-VEE, INC.
5820 WESTOWN PARKWAY
WEST DES MOINES, IOWA 50266
TELEPHONE: (515) 267-2600
FAX: (515) 267-2550

Hy-Vee
EMPLOYEE OWNED

NORTH PLAN NORTH

ENLARGED EQUIPMENT PLAN


DRAWN: Author DATE: MAY 2017
SCALE: 1/8" = 1'-0" JOB NUMBER:
SHEET: EQ1.1

REFER TO EQUIPMENT BOOKLET FOR ADDITIONAL INFORMATION

REVISION	DATE	BY
2	ASI #2	1/8/21
3	ASI #3	1/22/21
4	ASI #4	2/5/21
6	ASI #7	4/21/21
7	ASI #8	5/19/21


WINE & SPIRITS						
Condition	Dept	General Description	Qty	Vendor	Manufacturer	Manf Model
NEW	WS1	FREEZER	1	TRUE	TRUE	GM-49F
NEW	WS3	CASE	1	HUSSMANN	HUSSMANN	HP14-2
NEW	WS5	CASE	5	HUSSMANN	HUSSMANN	EDS5U-12
NEW	WS15	NO-DRINKY CHAIR - LEFT	3	KPI	KPI	
NEW	WS16	KPI 3000 COMPUTER CABINET	1	KPI	KPI	72" LENGTH
NEW	WS18	COOLER - BEER	1	KPI	KPI	
NEW	WS19	COOLER DOORS - BEER	1			QUANTITY: 13

FLORAL						
Condition	Dept	General Description	Qty	Vendor	Manufacturer	Manf Model
NEW	FL	FLORAL	1	BORGES	BORGES	SCF08
NEW	FL100	COOLER - FLORAL	1			
NEW	FL101	COOLER - FLORAL DISPLAY	1			

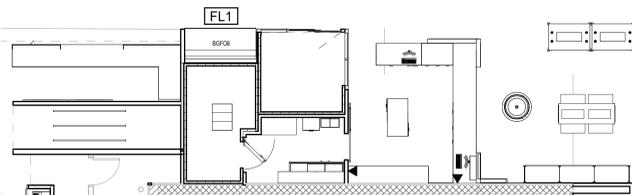

**EQUIPMENT PLAN
FLORAL**
5 SCALE: 1/8" = 1'-0"

PRODUCE						
Condition	Dept	General Description	Qty	Vendor	Manufacturer	Manf Model
NEW	P2	CASE	1	JBI	JBI	RS5063
NEW	P3	ISLT TABLE	2	JOHN BOOS	JOHN BOOS	
NEW	P4	CASE	2	HUSSMANN	HUSSMANN	EDS5L-8
NEW	P6	PROPAGER	1	HUSSMANN	HEAT SEAL	TSSA
NEW	P7	SCALE WIRELESS	1	HOBART	HOBART	HTF-LS
NEW	P8	CASE	6	HUSSMANN	HUSSMANN	EDS5L-12
NEW	P9	CASE	2	HUSSMANN	HUSSMANN	EDS5L-8
NEW	P12	CASE	1	HUSSMANN	HUSSMANN	EDS5L-8
NEW	P14	CASE	1	HUSSMANN	HUSSMANN	EDS5L-8
NEW	P15	CASE	1	HUSSMANN	HUSSMANN	EDS5L-8
NEW	P16	PRODUCE BIN	34	JBI	JBI	BD3343
NEW	P17	PRODUCE BIN	10	JBI	JBI	BD3343
NEW	P18	PRODUCE BIN	5	JBI	JBI	BD3343
NEW	P19	PRODUCE BIN	10	JBI	JBI	BD3343
NEW	P20	PRODUCE BIN	4	JBI	JBI	BD3343
NEW	P21	PRODUCE BIN	8	JBI	JBI	BD3343
NEW	P22	PRODUCE BIN	4	JBI	JBI	BD3343
NEW	P23	PRODUCE BIN	3	JBI	JBI	BD3343
NEW	P24	PRODUCE BIN	3	JBI	JBI	BD3343
NEW	P25	PRODUCE BIN	3	JBI	JBI	BD3343
NEW	P26	PRODUCE BIN	3	JBI	JBI	BD3343
NEW	P27	PRODUCE BIN	3	JBI	JBI	BD3343
NEW	P28	PRODUCE - BIN	1	JOHN BOOS	JOHN BOOS	1 COMP SINK W/ DRAINBOARD
NEW	P29	PRODUCE - PLATTER BIN	1	JOHN BOOS	JOHN BOOS	3 COMP SINK
NEW	P30	COOLER - PRODUCE	1			

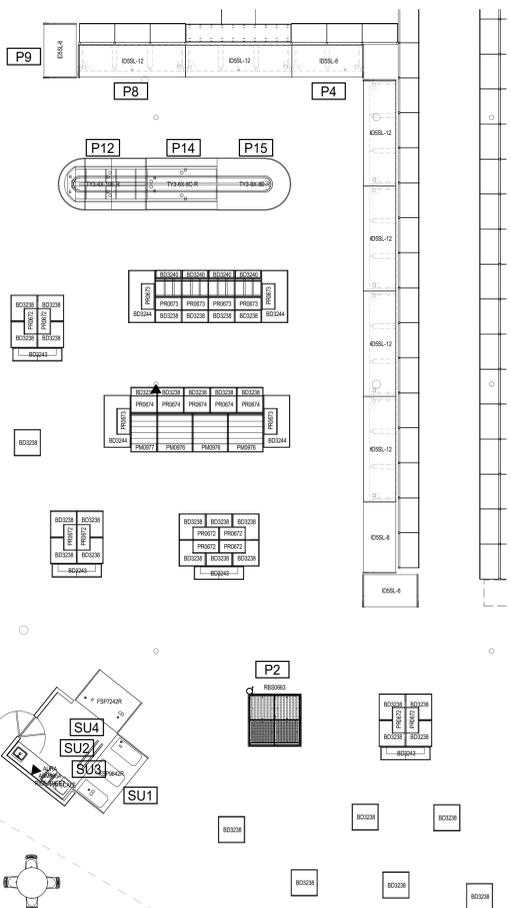

**EQUIPMENT PLAN
PRODUCE**
3 SCALE: 1/8" = 1'-0"


SUSHI						
Condition	Dept	General Description	Qty	Vendor	Manufacturer	Manf Model
NEW	SU1	SUSHI PREP	1	STRUCTURAL CONCEPTS	STRUCTURAL CONCEPTS	FSF942R
NEW	SU2	RICE SHEET	1	SCORAL TRELLEN	AUTEC	ASB805A
NEW	SU3	SCALE WIRELESS	1	HOBART	HOBART	HTF-75
NEW	SU4	SUSHI PREP	1	STRUCTURAL CONCEPTS	STRUCTURAL CONCEPTS	FSF7242R

ASIAN						
Condition	Dept	General Description	Qty	Vendor	Manufacturer	Manf Model
NEW	A1	4-HOLE WORK	1	HUSSMANN	TOWNS	
NEW	A2	BL. RICE WASHER	2	WASSERSTEIN	ZOENHER	THA-3035
NEW	A3	TABLE PREP	1	TRAILSEN	TRAILSEN	TR800H1
NEW	A11	SS TABLE	1	JOHN BOOS	JOHN BOOS	TR800H1
NEW	A12	TABLE PREP	1	TRAILSEN	TRAILSEN	TR800H1
NEW	A13	TABLE PREP	1	TRAILSEN	TRAILSEN	TR800H1
NEW	A15	CASE, HOT. SERVICE	1	STRUCTURAL CONCEPTS	STRUCTURAL CONCEPTS	TP SC ASIAN


MIA PIZZA						
Condition	Dept	General Description	Qty	Vendor	Manufacturer	Manf Model
NEW	MP1	OVEN, DECK	1	DUREY EQUIPMENT	WOODSTONE	FD-844-RFL-LR
NEW	MP2	SS TABLE	1	JOHN BOOS	JOHN BOOS	
NEW	MP4	DOUGH PRESS W/STAND	1	DUREY	KRESS	DM
NEW	MP5	COLD COUNTER	2	SHELLEY STEEL	SHELLEY STEEL	SCSC-50
NEW	MP6	CONVEYOR	1	WASSERSTEIN	EMERG	8110
RELOCATED	MP9	SS TABLE	1	JOHN BOOS	JOHN BOOS	
RELOCATED	MP9	30 ST FLOOR MIXER	1	GLORIE FOOD EQUIP COMPANY		SPSP

C-STORE						
Condition	Dept	General Description	Qty	Vendor	Manufacturer	Manf Model
RELOCATED	CS6	CAPPUCINO 3 HEAD	1	INTERNATIONAL		37900-0023
RELOCATED	CS11	ICE MAKING TUBER	1	ILB REFRIG	CARNEIRO	WCC-700
RELOCATED	CS12	ICE MACHINE	1	HUSSMANN	HUSSMANN	WCC-700

KITCHEN						
Condition	Dept	General Description	Qty	Vendor	Manufacturer	Manf Model
NEW	K1	OIL MANAGEMENT	1	RTI	RTI	BL-2V
NEW	K4	SCALE WIRELESS	1	HOBART	HOBART	HTF-75
NEW	K5	FRIGIDIC CONVEYOR	1	FRIGIDIC	FRIGIDIC	FRS-SS-TR
NEW	K13	SLAD BAR	1	STRUCTURAL CONCEPTS	STRUCTURAL CONCEPTS	FSF7242R
NEW	K15	COFFEE BREWERS	1	WALKER CURTIS	WALKER CURTIS	TR10T
NEW	K16	HEAT RAIL	1	HALCO	HALCO	GH44-36
NEW	K17	SS TABLE	1	JOHN BOOS	JOHN BOOS	
NEW	K20	SS TABLE	3	JOHN BOOS	JOHN BOOS	
NEW	K23	DISHWASHER	1	HOBART	HOBART	AM15
NEW	K26	FRYER	1	HOBART	HOBART	HF460
NEW	K29	BAG IN A BOX	2			
NEW	K34	HOLDING CABINET	1	HUSSMANN	GRECOR	121PH18180
NEW	K42	UNDERCOUNTER	1	HOBART	TRAILSEN	TR800H1
NEW	K45	CASE	1	HUSSMANN	HUSSMANN	EDS45-12
NEW	K51	MICROWAVE RANGE	1	HUSSMANN	HUSSMANN	ME42
NEW	K52	FREEZER	1	TRAILSEN	TRAILSEN	G12010
NEW	K53	SS TABLE	1	JOHN BOOS	JOHN BOOS	
NEW	K56	CASE HOT	1	TRIGITY	HENRY PENNY	HMB-101F
RELOCATED	K59	UNDERCOUNTER	1	HOBART	TRAILSEN	TR800H1
NEW	K62	UNDERCOUNTER FRIDGE	1	HOBART	TRAILSEN	TR800H1
NEW	K65	GRIDDLE	1	HOBART	VULCAN	972
NEW	K69	COO	1	HOBART	CORPORATION	COO
NEW	K70	ROTISSERIE	1	DUREY	AL TO SHAM	AK40
NEW	K77	KITCHEN CULINARY TABLE	1	JOHN BOOS	JOHN BOOS	CULINARY TABLE
NEW	K88	KITCHEN DISH TABLE	1	JOHN BOOS	JOHN BOOS	CUSTOM DISH TABLE
NEW	K89	KITCHEN SINK	1	JOHN BOOS	JOHN BOOS	4-COMP SINK
NEW	K100	COOLER - KITCHEN	1			
NEW	K101	FRIGIDIC - KITCHEN	1			
NEW	K114	CASE	1	HUSSMANN	HUSSMANN	ME45-36H
NEW	K136	DISPENSER	1	FRESHLY SQUEEZED	FRS	120
NEW	K138	JUICER	1	FRESHLY SQUEEZED	FRS	240
NEW	K140	BREAD SODA	1	PERI	CORNELIUS	250 RESERVE
NEW	K200	TABLE PREP	1	TRAILSEN	TRAILSEN	TR800H1
NEW	K202	CONVEYOR	1	HOBART	VULCAN	VOCC80
EXISTING	K203	OVEN, SLOTTED STACK	1	HOBART	HOBART	SC440
NEW	K204	BAKERS	1	SUPPLY EQUIPMENT COMPANY	SOUTHERN PRIDE	SC-2038M
NEW	K205	FRYERS	4	HOBART	HOBART	HF460
NEW	K206	SCALE WIRELESS	2	HOBART	HOBART	HTF-75
EXISTING	K207	ICE MAKING COMBO	1	HUSSMANN	GLANVILLE	CG41030
NEW	K208	DISHWASHER	1	GLASTENDER	GLASTENDER	DEGR 24-RS
NEW	K209	4 COMP SINK	1	GLASTENDER	GLASTENDER	FSB-4L-S
RELOCATED	K210	WASTE CHUTE	1	GLASTENDER	GLASTENDER	DWBS-12
RELOCATED	K211	SINK	1	GLASTENDER	GLASTENDER	DWBS-12
RELOCATED	K212	LIQUOR DISPLAY	1	GLASTENDER	GLASTENDER	LSD-24

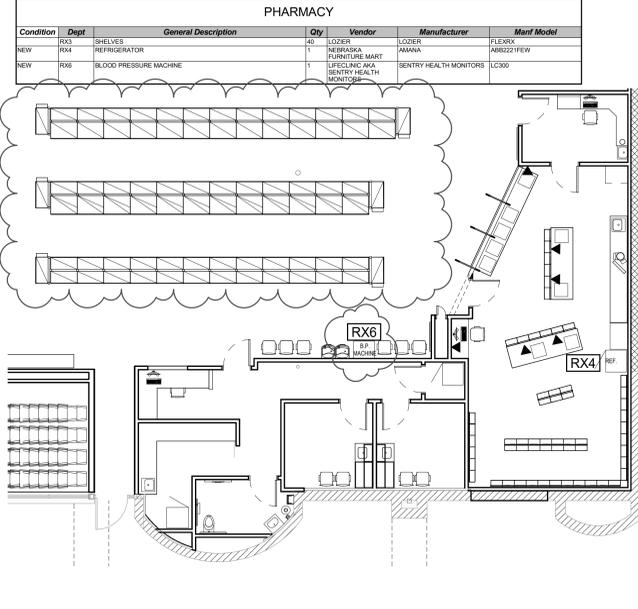


**EQUIPMENT PLAN
PHARMACY**
2 SCALE: 1/8" = 1'-0"

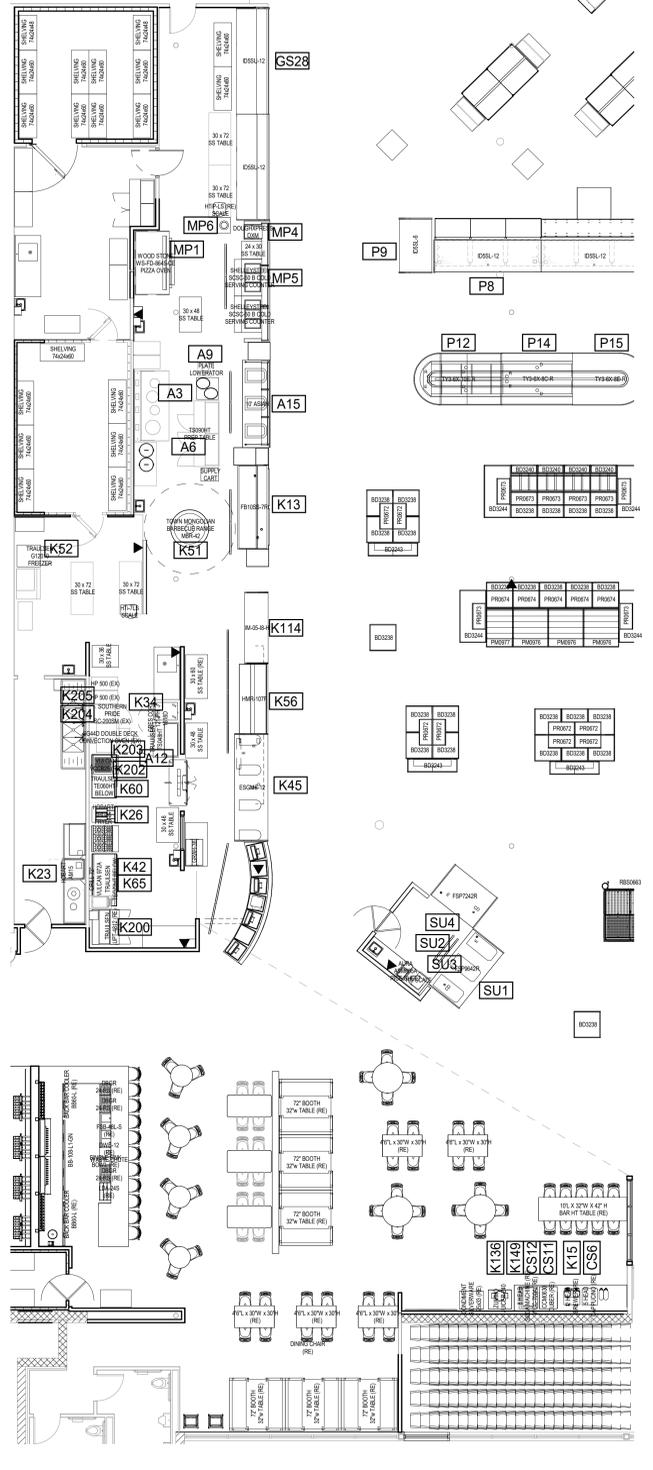


**EQUIPMENT PLAN
KITCHEN/ITALIAN/ASIAN/SUSHI**
1 SCALE: 1/8" = 1'-0"

**EQUIPMENT PLAN
WINE AND SPIRITS**
6 SCALE: 1/8" = 1'-0"

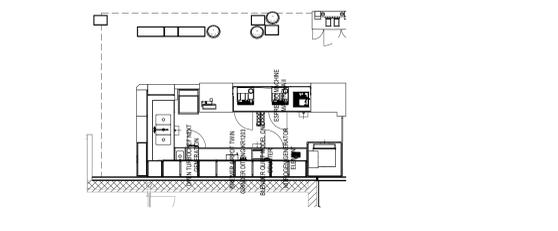

**EQUIPMENT PLAN
COFFEE**
4 SCALE: 1/8" = 1'-0"


LOCATION:
LEE'S SUMMIT #2 HY-VEE
LEE'S SUMMIT, MO
HY-VEE, INC.
5820 WESTOWN PARKWAY
WEST DES MOINES, IOWA 50386
TELEPHONE: (515) 267-2600
FAX: (515) 267-2555

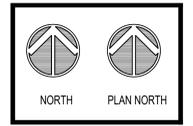

ENLARGED EQUIPMENT PLAN

DRAWN: Author DATE: MAY 2017
SCALE: 1/8" = 1'-0" JOB NUMBER:
SHEET: EQ1.2

REFER TO EQUIPMENT BOOKLET FOR ADDITIONAL INFORMATION

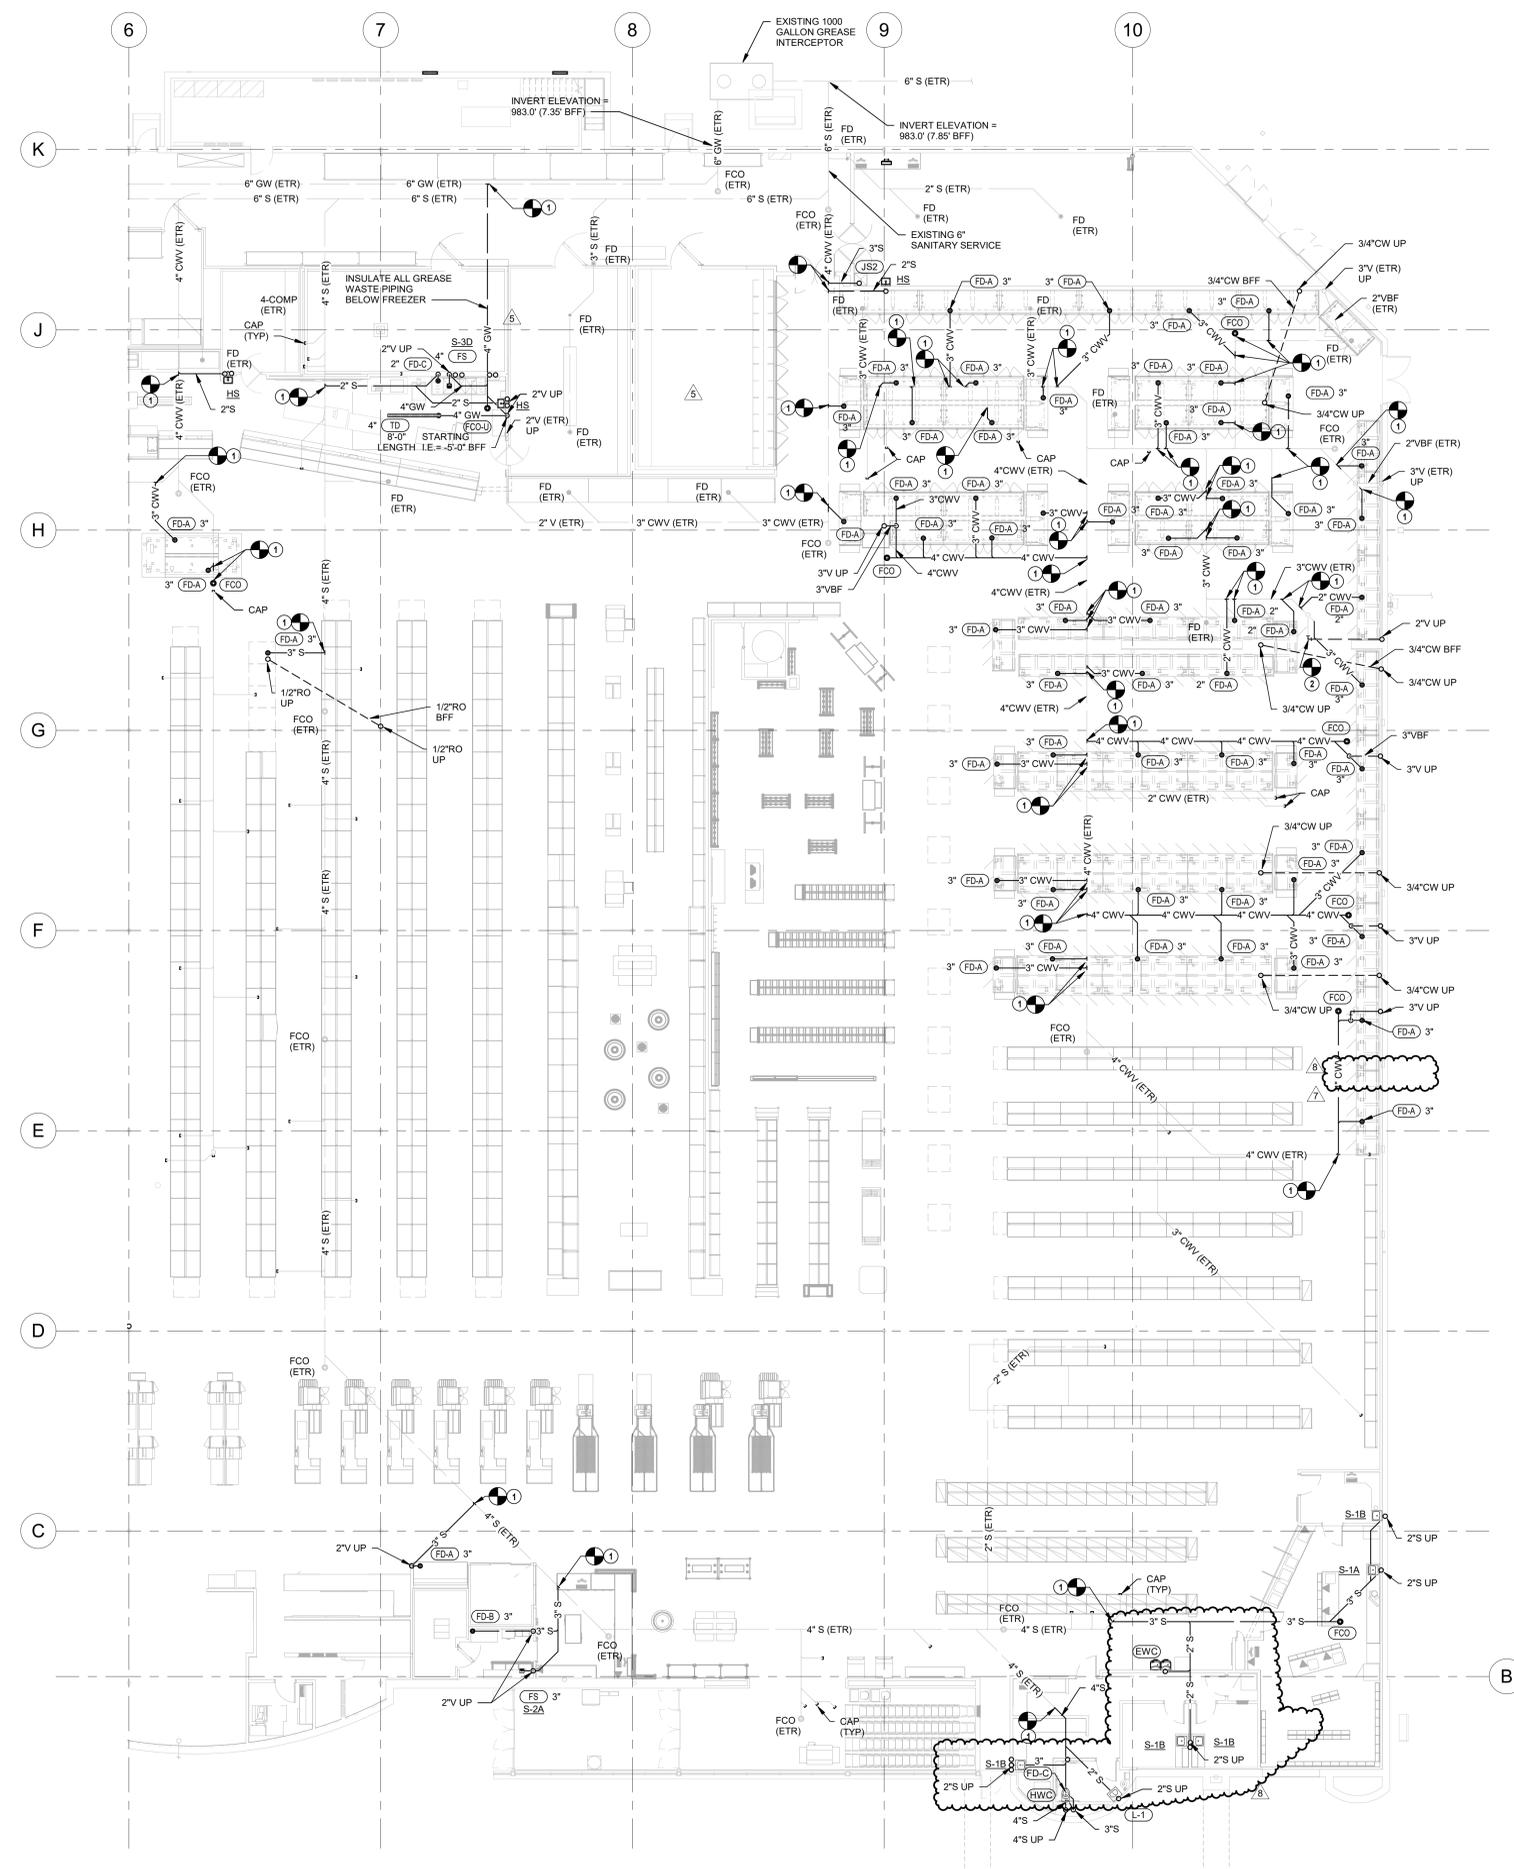

1 UNDERFLOOR PLUMBING PLAN - B
3/32" = 1'-0"

PLUMBING GENERAL NOTES

1. FURNISH AND INSTALL PLUMBING SYSTEMS IN ACCORDANCE WITH LOCAL AND STATE PLUMBING CODES.
2. ALL FLOOR DRAINS, FLOOR SINKS, AND TRENCH DRAINS OUTLETS AND BRANCH SANITARY ARE 3" UNLESS NOTED OTHERWISE.
3. ALL FLOOR CLEANOUTS ARE TO BE ACCESSIBLE AND NOT BENEATH MILLWORK, CASEWORK, SHELVES OR OTHER OBSTRUCTIONS. CLEANOUTS SHALL BE THE SAME SIZE AS PIPING BEING SERVED AND AT THE TRANSITION OF PIPE SIZE.
4. COORDINATE UNDERFLOOR PIPING ROUTING WITH REFRIGERATION AND ELECTRICAL CONTRACTORS.

PLUMBING PLAN NOTES

1. CONNECT NEW SANITARY/GREASE WASTE PIPING INTO EXISTING PIPING. FIELD VERIFY EXACT LOCATION, SIZE AND INVERT PRIOR TO START OF WORK.
2. CONNECT NEW VENT PIPING TO EXISTING VENT PIPING AS FIELD CONDITIONS REQUIRE. FIELD VERIFY EXACT SIZE AND LOCATION PRIOR TO START OF WORK.

REVISION		DATE BY
1	ADD	03/19/21
2	ADD	04/16/21
3	ADD	05/20/21


HENDERSON ENGINEERS
 8345 LENEXA DRIVE, SUITE 300
 LENEXA, KS 66214
 TEL 913.742.5000 FAX 913.742.5001
 WWW.HENDERSONENGINEERS.COM

1950003081
 MO. CORPORATE NO. E-5560
 EXPIRES 12/31/2021

PROFESSIONAL SEAL
 STATE OF MISSOURI
 JOSHUA N. HOVER
 PE-2017008503
 05/20/2021
 LICENSE # PE-2017008503

LOCATION
LEE'S SUMMIT, MO #2
 310 SW WARD RD
 HY-VEE, INC.
 5820 WESTOWN PARKWAY
 WEST DES MOINES, IOWA 50386
 TEL: (515) 281-2600
 FAX: (515) 267-4335


HyVee
 EMPLOYEE OWNED

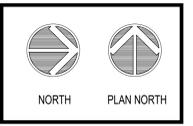

UNDERFLOOR PLUMBING PLAN - B

PROJECT MANAGER	CHECKED BY
SL	HEI
DRAWN BY:	DATE:
HEI	10/19/2020
SCALE:	JOB NUMBER:
AS NOTED	62830547

SHEET:
P1.0B

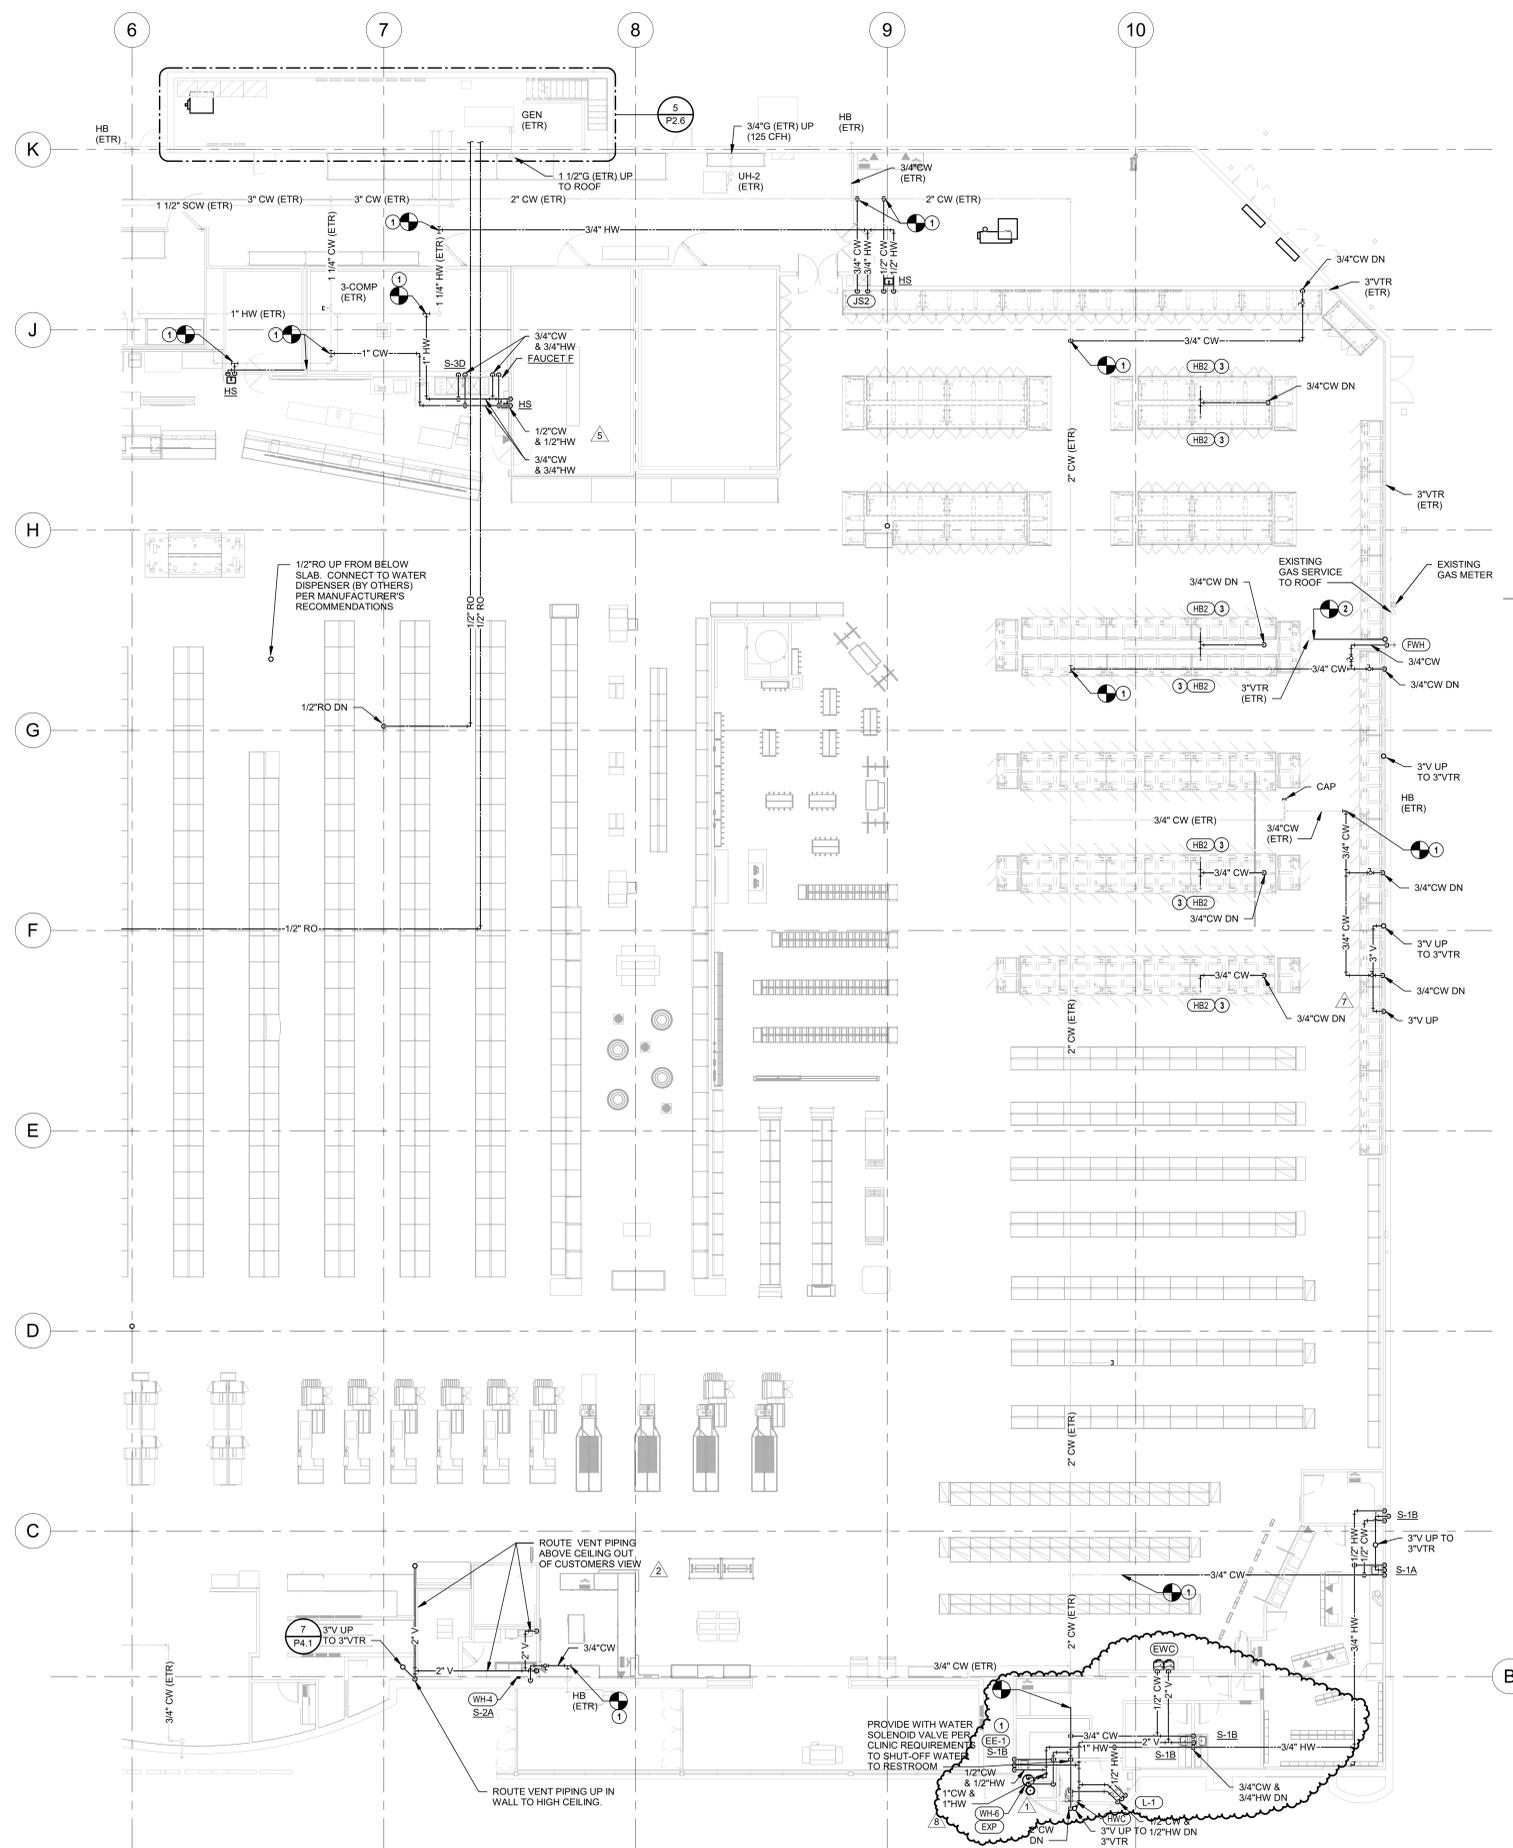

1 PLUMBING FLOOR PLAN - B
3/32" = 1'-0"

PLUMBING GENERAL NOTES

- FURNISH AND INSTALL PLUMBING SYSTEMS IN ACCORDANCE WITH LOCAL AND STATE PLUMBING CODES.
- ALL FLOOR DRAINS, FLOOR SINKS, AND TRENCH DRAINS OUTLETS AND BRANCH SANITARY ARE 3" UNLESS NOTED OTHERWISE.
- ALL FLOOR CLEANOUTS ARE TO BE ACCESSIBLE AND NOT BENEATH MILLWORK, CASEWORK, SHELVES OR OTHER OBSTRUCTIONS. CLEANOUTS SHALL BE THE SAME SIZE AS PIPING BEING SERVED AND AT THE TRANSITION OF PIPE SIZE.
- COORDINATE UNDERFLOOR PIPING ROUTING WITH REFRIGERATION AND ELECTRICAL CONTRACTORS.
- ROUTE BRANCH PIPING 12" ABOVE THE ACCESSIBLE CEILING.

PLUMBING PLAN NOTES

- CONNECT NEW DOMESTIC WATER PIPING TO EXISTING PIPING. FIELD VERIFY EXACT LOCATION AND SIZE PRIOR TO START OF WORK.
- CONNECT NEW VENT PIPING INTO EXISTING VTR. FIELD VERIFY EXACT LOCATION AND SIZE PRIOR TO START OF WORK.
- ROUTE CW PIPING ON TOP OF CASE. INSTALL AND SECURELY FASTEN HB2 IN CENTER OF CASE ARRANGEMENT.

REVISION	DATE BY
1 ASH	11/10/20
2 ASH	01/07/21
3 ASH	03/19/21
4 ASH	04/16/21
5 ASH	06/02/21


HENDERSON ENGINEERS
 8345 LENEXA DRIVE, SUITE 300
 LENEXA, KS 66214
 TEL 913.742.5000 FAX 913.742.5001
 WWW.HENDERSONENGINEERS.COM

1950003081
 MO. CORPORATE NO. E-5560
 EXPIRES 12/31/2021

PROFESSIONAL SEAL
 STATE OF MISSOURI
 JOSHUA N. HOVER
 PE-2017008503
 05/20/2021
 LICENSE # PE-2017008503

LOCATION
LEE'S SUMMIT, MO #2
 310 SW WARD RD
 HY-VEE, INC.
 5820 WESTOWN PARKWAY
 WEST DES MOINES, IOWA 50386
 TEL: (515) 267-2600
 FAX: (515) 267-2636


HyVee
 EMPLOYEE OWNED

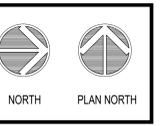

PLUMBING FLOOR PLAN - B

PROJECT MANAGER	CHECKED BY
SL	HEI
DRAWN BY:	DATE:
HEI	10/19/2020
SCALE:	JOB NUMBER:
AS NOTED	62830547

SHEET:
P2.0B

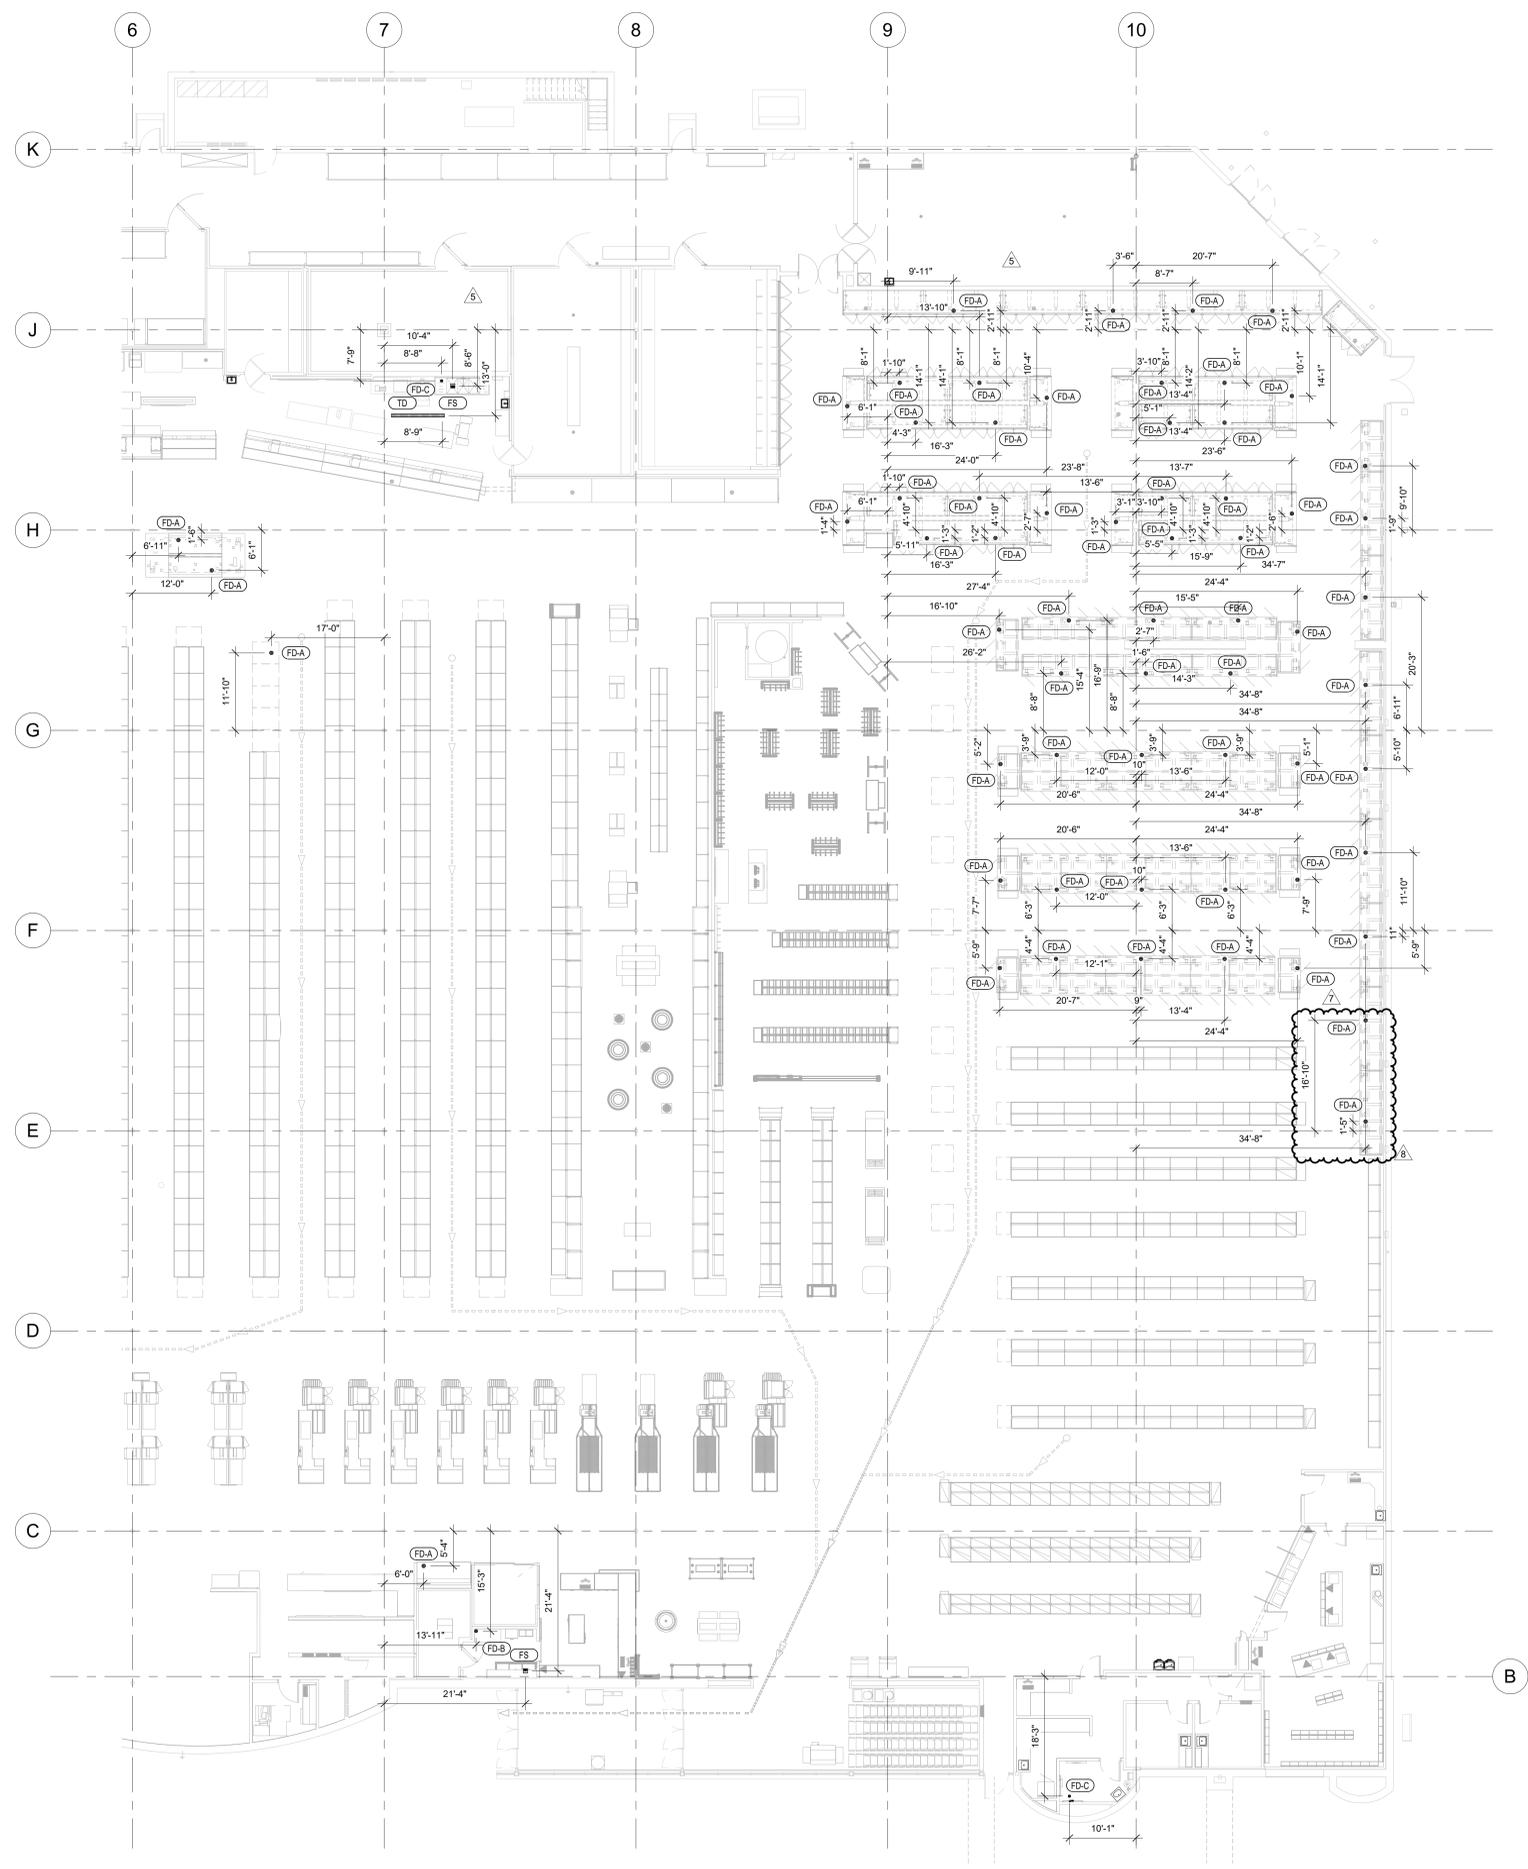

1 PLUMBING STUBUP PLAN - B
 3/32" = 1'-0"

REVISION		DATE BY
3	ASI #5	03/19/21
7	ASI #7	04/16/21
8	ASI #8	05/20/21

HENDERSON ENGINEERS
 8345 LENEXA DRIVE, SUITE 300
 LENEXA, KS 66214
 TEL 913.742.5000 FAX 913.742.5001
 WWW.HENDERSONENGINEERS.COM

1950003081
 MO. CORPORATE NO. E-5560
 EXPIRES 12/31/2021


PROFESSIONAL SEAL

JOSHUA N. HOVER
 LICENSE # PE-2017008503
 05/20/2021

LOCATION
LEE'S SUMMIT, MO #2
 310 SW WARD RD

HY-VEE INC.
 5820 WESTOWN PARKWAY
 WEST DES MOINES, IOWA 50386
 TEL: (515) 281-2600
 FAX: (515) 267-4335

HyVee
 EMPLOYEE OWNED

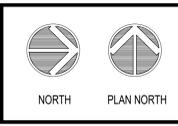

PLUMBING
 STUB-UP PLAN - B

PROJECT MANAGER	CHECKED BY
SL	HEI
DRAWN BY:	DATE:
HEI	10/19/2020
SCALE:	JOB NUMBER:
AS NOTED	62830547

SHEET:
PE1.0B

PANELBOARD: B (EXISTING)														
BUS AMPS: 225A		FED FROM: MDP1		LINE-SIDE LUGS: MECHANICAL										
MAIN SIZE/TYPE: MLO		AIC RATING: CONTRACTOR TO VERIFY AND NOTIFY EOR		EQUIPMENT GROUND BUS										
VOLTS/PHASE: 208Y/120V, 3PH, 4W		SERVICES: LIGHTING		LOCATION: ELECTRICAL ROOM										
SECTION: 1		MOUNTING SURFACE		MOUNTING SURFACE										
CKT NO.	DESCRIPTION	VOLTAMPS/PHASE			WIRE NO.	BKR NO.	P	BKR	WIRE NO.	VOLTAMPS/PHASE			DESCRIPTION	CKT NO.
		A	B	C						A	B	C		
R 1	LTG - DELICHEESE	420			12	20	1	1	20	1,344			LTG - WINE AND SPIRITS TRK 1	2
R 3	LTG - DELICHEESE TRACK	147			12	20	1	1	20	1,554			LTG - WINE AND SPIRITS TRK 2	4
R 5	LTG - PRODUCE TRIM		252		12	20	1	1	20		400		LTG - WINE AND SPIRITS VEST.	6
R 7	LTG - MEAT/SEAFOOD				12	20	1	1	20	1,200			SALES AREA LTG	8
R 9	LTG - MEAT/SEAFOOD TRACK	732			12	20	1	1	20	1,200			SALES AREA LTG	10
R 11	LTG - MEAT CASE PENDANTS	189			12	20	1	1	20	1,200			SALES AREA LTG	12
R 13	LTG - ALI ANONY				12	20	1	1	20	1,200			SALES AREA LTG	14
R 15	LTG - PIZZASUM TRACK	126			12	20	1	1	20	1,200			SALES AREA LTG	16
R 17	LTG - PIZZASUM				12	20	1	1	20	1,200			SALES AREA LTG	18
R 19	LTG - FOOD SERVICE ROOM	348			12	20	1	1	20	1,200			SALES AREA LTG	20
R 21	LTG - KITCHEN/CONF FOODS	756			12	20	1	1	20	1,200			SALES AREA LTG	22
R 23	LTG - CONF FDS/MIKT EXP/SUSHI				12	20	1	1	20	1,200			BACK ROOM LTG	24
R 25	LTG - EXT HALL	294			12	20	1	1	20	1,200			BACK RM CLO FAN & HEATER	26
R 27	LTG - BAKERY 1		624		12	20	1	1	20	1,200			ELEC ROOM LTG	28
R 29	LTG - BAKERY 2				12	20	1	1	20	1,200			TUNNEL LTG & BUNKER DEMO	30
R 31	LTG - BAKERY 3	780			12	20	1	1	20	500			SYS 9 BUNKER	32
R 33	LTG - BAKERY/DECADENT TRACK		189		12	20	1	1	20	500			SYS 11 BUNKER	34
R 35	LTG - WINE ROOM FLR STRIPS		160		12	20	1	1	20		180		LTG - WINE ROOM DOWNLTS	36
R 37	LTG - AISLES ONLINE	450			12	20	1	1	20	646			LTG - DAIRY/FROZEN/HLTH TRK	38
R 39	LTG - EXT. WALL PANTS				12	20	1	1	20	1,000			LTG - CANDY CARDS TRACK 1	40
R 41	EQUIPPED SPACE				1	1	1	1	20	12			LTG - CANDY CARDS TRACK 2	42
SUBTOTAL		3,504	2,031	2,143						7,290	7,854	6,380		
TOTAL PHASE A - VA		10,794			DF					CONN. VA	DF			
TOTAL PHASE B - VA		9,885			LOAD					CONN. VA	DF			
TOTAL PHASE C - VA		8,523			COOLING	1.00				CONN. VA	DF			
TOTAL PNLBD - VA		29,202			HEATING	1.00				CONN. VA	DF			
AMPS		81			SIGNDISP	1.25				CONN. VA	DF			
AMPS					KITCHEN	1.25				CONN. VA	DF			
AMPS					RECEPTACLES	1.0/5				CONN. VA	DF			
AMPS					MOTORS	1.00				CONN. VA	DF			
AMPS					LRG MOTOR	1.25				CONN. VA	DF			
AMPS					SHOW WNDW	1.25				CONN. VA	DF			
AMPS					LTG TRACK	1.00				CONN. VA	DF			

PANELBOARD NOTES											
TOTAL PHASE A - VA 10,794											
TOTAL PHASE B - VA 9,885											
TOTAL PHASE C - VA 8,523											
TOTAL PNLBD - VA 29,202											
AMPS 81											

PANELBOARD: E (EXISTING)														
BUS AMPS: 225A		FED FROM: MDP1		LINE-SIDE LUGS: MECHANICAL										
MAIN SIZE/TYPE: MLO		AIC RATING: CONTRACTOR TO VERIFY AND NOTIFY EOR		EQUIPMENT GROUND BUS										
VOLTS/PHASE: 208Y/120V, 3PH, 4W		SERVICES: KITCHEN/DELI		LOCATION: DRY STORAGE										
SECTION: 1		MOUNTING SURFACE		MOUNTING SURFACE										
CKT NO.	DESCRIPTION	VOLTAMPS/PHASE			WIRE NO.	BKR NO.	P	BKR	WIRE NO.	VOLTAMPS/PHASE			DESCRIPTION	CKT NO.
		A	B	C						A	B	C		
R 1	DELI BOOSTER HEATER	3,759			8	40	3		2	50	6	3,445	HICKORY HOUSE HOT CASE 2	2
R 3	HIBACHI 10' COLD CASE	270			12	20	1	1	20			500	KITCHEN ROTISSERIE	6
R 5	PIZZA DEEP WELL	500			12	20	1	1	20			500	EXISTING LOAD	8
R 7	PIZZA RCPT	500			12	20	1	1	20			500	EXISTING LOAD	10
R 9	DELI DISPOSAL	500			12	20	1	1	20	1,400			KITCHEN HEAT RAIL	14
R 11	DELI DISHWASHER EX FAN EFS	1,000			12	20	1	1	20			1,176	KITCHEN REF TABLE (BACK RM)	16
R 13	WEST BAKERY FRZR FANS	1,000			12	20	1	1	20			500	EXISTING LOAD	18
R 15	BAKERY WEST COIL FRZR FANS	500			12	20	1	1	20			360	KITCHEN CONV RCPT 1	22
R 17	JUICE BAR ISO GROUND	500			12	20	1	1	20			540	KITCHEN CONV RCPT 2	24
R 19	JUICE BAR RCPT	500			12	20	1	1	20	2,496			HOT WELLS	26
R 21	EXISTING LOAD	500			12	20	1	1	20			2,496	EXISTING LOAD	28
R 23	HICKORY HOUSE HOT CASE 1	3,077			8	40	2	1	20			500	DELI DISPOSAL	30
R 25	PIZZA DEEP WELL	71			12	20	1	1	20			500	WINE TASTING RCPT	34
R 27	CHINESE HOT WELL	7475			3	100	2	1	20			500	WINE TASTING RCPT	36
R 29	EXISTING LOAD	500			12	20	1	1	20			1,920	KITCHEN HOLDING CABINET	38
R 31	BAKERY FRZR	500			12	20	1	1	20			500	KITCHEN REF TABLE	40
R 33	BAKERY FRZR	500			12	20	1	1	20			500	PRODUCE COLUMN RCPT	42
SUBTOTAL		16,581	9,836	14,234						10,761	9,653	3,760		
TOTAL PHASE A - VA		27,342			LOAD					CONN. VA	DF			
TOTAL PHASE B - VA		19,489			COOLING	1.00				CONN. VA	DF			
TOTAL PHASE C - VA		17,994			HEATING	1.25				CONN. VA	DF			
TOTAL PNLBD - VA		64,825			SIGNDISP	1.25				CONN. VA	DF			
AMPS		180			KITCHEN	1.25				CONN. VA	DF			
AMPS					RECEPTACLES	1.0/5				CONN. VA	DF			
AMPS					MOTORS	1.00				CONN. VA	DF			
AMPS					LRG MOTOR	1.25				CONN. VA	DF			
AMPS					SHOW WNDW	1.25				CONN. VA	DF			
AMPS					LTG TRACK	1.00				CONN. VA	DF			

PANELBOARD NOTES											
TOTAL PHASE A - VA 27,342											
TOTAL PHASE B - VA 19,489											
TOTAL PHASE C - VA 17,994											
TOTAL PNLBD - VA 64,825											
AMPS 180											

PANELBOARD: H (EXISTING)														
BUS AMPS: 225A		FED FROM: MDP1		LINE-SIDE LUGS: MECHANICAL										
MAIN SIZE/TYPE: MLO		AIC RATING: 10000 FULLY RATED		EQUIPMENT GROUND BUS										
VOLTS/PHASE: 208Y/120V, 3PH, 4W		SERVICES: MEAT & SEAFOOD POWER		LOCATION: ELECTRICAL ROOM										
SECTION: 1		MOUNTING SURFACE		MOUNTING SURFACE										
CKT NO.	DESCRIPTION	VOLTAMPS/PHASE			WIRE NO.	BKR NO.	P	BKR	WIRE NO.	VOLTAMPS/PHASE			DESCRIPTION	CKT NO.
		A	B	C						A	B	C		
R 1	CORD DROP	1,921			12	20	1	1	20			500	CORD DROP	2
R 3	MEAT SAW		1,921		12	20	1	1	20			500	CORD DROP	4
R 5	SPARE				1	1	1	1	20				SPARE	6
R 7	TRASH COMPACTOR	4,803			12	20	1	1	20				SPARE	8
R 9	EXISTING LOAD	4,803			12	20	1	1	20			360	SPARE	10
R 11	UH-4 (ELEC ROOM)	500			12	20	1	1	20	500			SERVICE MEAT RCPT	12
R 13	SPARE				12	20	1	1	20			500	MEAT WRAPPER	14
R 15	EXISTING LOAD				12	20	1	1	20			500	MEAT TENDERIZER	16
R 17	BAKERY VARIA PRO SLICER	367			12	20	1	1	20			540	MEAT SCALERS	18
R 19	RCPT - ALARM BY COMPACT.		367		12	20	1	1	20			500	PHL Q CONTACTOR	20
R 21	BAKERY SCREENS				3	50	6			4,491		4,491	MAU-2 FANS	24
R 23	DELICHEESE REF. TABLE		360		12	20	1	1	20			725	DELICHEESE HEAT WRAP	26
R 25	DELICHEESE REF. TABLE		756		12	20	1	1	20			500	DELICHEESE SLICER 1	28
R 27	MAU-2 CONDENSERS 1		1,345		12	20	1	1	20			500	DELICHEESE SLICER 2	30
R 29	MAU-2 CONDENSERS 2		1,345		12	20	1	1	20			1,000	MEAT & CHEESE RCPT	32
R 31	MAU-2 CONDENSERS 3		2,570		12	20	1	1	20			1,000	PANINI PRESS	34
R 33	MAU-2 CONDENSERS 4		2,570		12	20	1	1	20			500	DELICHEESE RCPT	36
R 35	MAU-2 CONDENSERS 5		2,570		12	20	1	1	20			500	DELICHEESE RCPT	38
R 37	MAU-2 CONDENSERS 6		2,570		12	20	1	1	20			500	DELICHEESE RCPT	40
R 39	MAU-2 CONDENSERS 7		2,570		12	20	1	1	20			500	DELICHEESE RCPT	42
SUBTOTAL		12,066	11,366	12,262						7,491	7,216	7,391		
TOTAL PHASE A - VA		19,497			LOAD					CONN. VA	DF			
TOTAL PHASE B - VA		18,582			COOLING	1.00				CONN. VA	DF			
TOTAL PHASE C - VA		19,653			HEATING	1.25				CONN. VA	DF			
TOTAL PNLBD - VA		57,732			SIGNDISP	1.25				CONN. VA	DF			
AMPS		160			KITCHEN	1.25				CONN. VA	DF			
AMPS					RECEPTACLES	1.0/5				CONN. VA	DF			
AMPS					MOTORS	1.00				CONN. VA	DF		</	

REVISION		DATE BY
2	ADD	01/02/21
3	ADD	01/02/21
4	ADD	02/05/21
5	ADD	03/19/21
6	ADD	04/16/21
8	ADD	05/20/21

PANELBOARD: L (EXISTING)														
BUS AMPS: 225A														
MAIN SIZE/TYPE: MLO														
VOLTS/PHASE: 208Y/120V, 3PH, 4W														
SECTION: 1														
CKT NO.	DESCRIPTION	VOLTAMPS/PHASE			WIRE NO.	BKR AMP	P	BKR WIRE NO.	VOLTAMPS/PHASE			DESCRIPTION	CKT NO.	
		A	B	C					A	B	C			
1	EM LTG - OFFICES/EXT HALL	400			12	20	1	20	EX	500			XFMR FOR LOUVERS	2
3	SALES AREA LT FIXT		750		EX	20	1	20	EX		500		EXISTING LOAD	4
5	SALES AREA LT FIXT		750		EX	20	1	20	EX		500		EXISTING LOAD	6
7	LANDING LIGHT		750		EX	20	1	20	EX	5,530				8
9	SALES AREA LT FIXT		750		EX	20	1	3	80	EX	4,530		PNLBD K	10
11	SALES AREA LT FIXT		750		EX	20	1	20	EX		6,890			12
13	SALES AREA LT FIXT		750		EX	20	1	20	EX	750	750		DAIRY COVER LIGHTS	14
15	SALES AREA LT FIXT		750		EX	20	1	20	EX				DAIRY COVER LIGHTS	16
17	FRONT ENTRY LT FIXT		750		EX	20	1	20	EX		750		DAIRY COVER LIGHTS	18
19	FRONT ENTRY LT FIXT		750		EX	20	1	20	EX	750	750		DAIRY COVER LIGHTS	20
21	EM LTG - BAKERY/DELIS/MEAT/LO			1,138	EX	20	1	20	EX		750		DAIRY COVER LIGHTS	22
23	BACKROOM LTS			750	EX	20	1	20	EX		500		SPRINKLER BELL	24
25	EM LTG - MARKET GRILLE/W/S		250		EX	20	1	20	EX	500			TELE BOARD RCPT	26
27	SALES AREA LIGHTS			750	EX	20	1	20	EX					28
29	SALES AREA LIGHTS			750	EX	20	1	3	30				SPARE	30
31	BACKROOM LTS			750	EX	20	1	20	EX					32
33	EM LTG - KITCHEN/ASIAN/PIZZA			398	EX	20	1	20	EX		500		EXISTING LOAD	34
35	EM LTG - CUST RSR/HALL			398	EX	20	1	20	EX		500		FIRE ALARM PANEL	36
37	PNLBD LL			5,190	EX	30	1	20	EX		500		TIME CLOCK	38
39				5,164	EX	30	1	20	EX		500		TELE & INTERCOM PANEL	40
41				5,072	EX	30	1	20	EX		750		SCAN RM & HALLWAY LT	42
SUBTOTAL		8,840	9,700	9,220						8,830	7,530	9,890	SUBTOTAL	
TOTAL PHASE A - VA		17,370			LOAD	CONN. VA	DF	LOAD	CONN. VA	DF				
AMPS		145			COOLING		1.00	REFRIG		1.00				
HEATING		0			SIGNDISP		1.25	KITCHEN		1.25				
LIGHTING		3,622	1.25		KITCHEN		1.00			1.00				
RECEPTACLES		8,280	10.0		EXISTING		32.778	1.00						
MOTORS		159	1.00		LRG MOTOR		1.25							
SUPP HEAT		53,710	1.00		SHOW WNDW		1.25							
MISC EQUIP		9,030	1.00		LTG TRACK		1.00							
TOTAL DEMAND														54,816 VA
TOTAL PNLBD - VA														182 A
AMPS		149												

PANELBOARD: N (NEW)														
BUS AMPS: 225A														
MAIN SIZE/TYPE: MLO														
VOLTS/PHASE: 208Y/120V, 3PH, 4W														
SECTION: 1														
CKT NO.	DESCRIPTION	VOLTAMPS/PHASE			WIRE NO.	BKR AMP	P	BKR WIRE NO.	VOLTAMPS/PHASE			DESCRIPTION	CKT NO.	
		A	B	C					A	B	C			
1	W VESTIBULE CART SANITIZER	1,200			12	20	1	20	EX	5,356			RTU-11 (CUST SERV/IAOL)	2
3	DOOR INTRUSION RCPT		360		EX	20	1	30	6	5,356				4
5	SECURITY & TV RCPT		500		EX	20	1	20	EX	5,356				6
7	EXISTING LOAD		500		EX	20	1	20	EX					8
9	EXISTING LOAD		500		EX	20	1	20	EX		500			10
11	EXISTING LOAD		500		EX	20	1	20	EX		1,000			12
13	SALES FLOOR 10' RCPTS	1,440			EX	20	1	20	EX	500				14
15	BULK FOOD SCALES		360		EX	20	1	20	EX	2,496				16
17	WH-A		4,150		EX	20	1	40	2	2,496				18
19	CUSTOMER SERVICE SCREENS		360		EX	20	1	20	EX	500				20
21	CUSTOMER SERVICE SCREENS		360		EX	20	1	20	EX	500				22
23	FAN EFF-8		500		EX	20	1	20	EX	500				24
25	ELECTRIC WATER COOLER		500		EX	20	1	20	EX	360				26
27	WH-4 B		4,150		EX	20	1	40	2	360				28
29	WH-4 B		4,150		EX	20	1	40	2	360				30
31	BEAUTY SHELVING MONITOR		180		EX	20	1	20	EX	360				32
33	BEAUTY SHELVING 1		1,200		EX	20	1	20	EX	500				34
35	BEAUTY SHELVING 2		1,200		EX	20	1	20	EX	500				36
37	BEAUTY SHELVING 3		1,200		EX	20	1	20	EX	1,200				38
39	EXISTING LOAD		500		EX	20	1	20	EX	500				40
41	EXISTING LOAD		500		EX	20	1	20	EX	360				42
SUBTOTAL		9,170	7,430	11,500						8,276	10,212	10,572	SUBTOTAL	
TOTAL PHASE A - VA		17,446			LOAD	CONN. VA	DF	LOAD	CONN. VA	DF				
AMPS		145			COOLING		1.00	REFRIG		1.00				
HEATING		18,088	1.00		SIGNDISP		1.25	KITCHEN		1.25				
LIGHTING		3,600	1.25		KITCHEN		1.00			1.00				
RECEPTACLES		6,000	10.0		EXISTING		12.192	1.00						
MOTORS		184	1.00		LRG MOTOR		1.25							
SUPP HEAT		16,800	1.00		SHOW WNDW		1.25							
MISC EQUIP		2,700	1.00		LTG TRACK		1.00							
TOTAL DEMAND														58,060 VA
TOTAL PNLBD - VA														161 A
AMPS		159												

PANELBOARD: T (EXISTING)														
BUS AMPS: 100A														
MAIN SIZE/TYPE: MLO														
VOLTS/PHASE: 208Y/120V, 3PH, 4W														
SECTION: 1														
CKT NO.	DESCRIPTION	VOLTAMPS/PHASE			WIRE NO.	BKR AMP	P	BKR WIRE NO.	VOLTAMPS/PHASE			DESCRIPTION	CKT NO.	
		A	B	C					A	B	C			
1	SPARE				20	1	20	EX		1,200			TRUCK OUTLET HEATER?	2
3	SPARE				20	1	20	EX		1,000			HVAC CONTROL PANEL	4
5	SPARE				20	1	20	EX		1,000			KCPL/INNOVATOR	6
7	CHEESE CASE FANS		500		EX	20	1	20	EX	1,000			KCPL/INNOVATOR	8
9	EQUIPPED SPACE				1	1	20	EX		360			FROZEN CASE RCPT 1	10
11	SPARE				20	1	20	EX		360			FROZEN CASE RCPT 2	12
13	DEMO		3,843		EX	20	1	20	EX	360			FROZEN CASE RCPT 3	14
15	MOTOR ROOM HEATER		3,843		EX	40	1	20	EX	360			FROZEN CASE RCPT 4	16
17	EQUIPPED SPACE				1	1	20	EX		1,000			SPARE	18
19	EQUIPPED SPACE				7	1	20	EX		1,000			CULLIGAN WATER SYSTEM	20
21	DEMO		500		EX	20	1	20	EX				SPARE	22
23	SW FROZEN RCPT				EX	20	1	20	EX					24
25			7,686		EX	30	1	20	EX	500			DAIRY COLUMN RCPT	26
27	WALK IN FREEZER		7,686		EX	30	1	20	EX	500			DAIRY RCPT	28
29			7,686		EX	30	1	20	EX	500			T STAFF SOLENOID MEAT COF.	30
SUBTOTAL		12,029	12,029	12,029						4,960	2,220	1,860	SUBTOTAL	
TOTAL PHASE A - VA		18,089			LOAD	CONN. VA	DF	LOAD	CONN. VA	DF				
AMPS		134			COOLING		1.00	REFRIG		1.00				
HEATING		14,249	0		SIGNDISP		1.25	KITCHEN		1.25				
LIGHTING		119	0		KITCHEN		1.00			1.00				
RECEPTACLES		13,889	1.440		EXISTING		42.787	0.80						
MOTORS		116	1.00		LRG MOTOR		1.25							
SUPP HEAT		44,227	1.00		SHOW WNDW		1.25							
MISC EQUIP		123	1.00		LTG TRACK		1.00							
TOTAL DEMAND														35,670 VA
TOTAL PNLBD - VA														99 A
AMPS		123												

PANELBOARD: KK (NEW)														
BUS AMPS: 125A														
MAIN SIZE/TYPE: MLO														
VOLTS/PHASE: 208Y/120V, 3PH, 4W														
SECTION: 1														
CKT NO.	DESCRIPTION	VOLTAMPS/PHASE			WIRE NO.	BKR AMP	P	BKR WIRE NO.	VOLTAMPS/PHASE			DESCRIPTION	CKT NO.	
		A	B	C					A	B	C			
1	DIRECTORS OFFICE CLEAN	360			12	20	1	20	EX	1,200			HUMAN RESOURCES CLEAN	2
3	ASST MANAGER CLEAN 1		360		EX	20	1	20	EX		360			

PANELBOARD: VV (EXISTING)

FED FROM: MDP1
 AIC RATING: 10000 FULLY RATED
 CONTRACTOR TO VERIFY AND NOTIFY EOR
 EQUIPMENT GROUND BUS

MAIN SIZE/TYP: MLO
 SERVES: BACK OF HOUSE
 MOUNTING: RECESSED
 VOLTS/PHASE: 208Y120V, 3PH, 4W
 LOCATION: DRY STORAGE

SECTION: 1

CKT NO.	DESCRIPTION	VOLTAMPS/PHASE			WIRE NO.	BKR NO.	P	BKR WIRE NO.	VOLTAMPS/PHASE			DESCRIPTION	CKT NO.							
		A	B	C					A	B	C									
EX 1	BACKROOM LIGHTS	1,200			EX	20	1	1	20	EX	1,000	UNIT HEATERS	2							
EX 3	BACKROOM LIGHTS		1,200		EX	20	1	1	20	EX	300	DSO ROOM RCPTS	4							
EX 5	BACKROOM LIGHTS		1,200		EX	20	1	1	20	EX	252	CS-1	6							
EX 7	BACKROOM LIGHTS	1,200			EX	20	1	1	20	EX	1,200	POP STORAGE LTG	8							
EX 9	DOCK RCPT		500		EX	20	1	1	20	EX	1,200	POP STORAGE LTG	10							
EX 11	EQUIPPED SPACE				EX	20	1	1	20	EX	500	DSO ROOM AC	12							
EX 13	EQUIPPED SPACE				EX	20	1	1	20	EX	500	EXISTING LOAD	14							
EX 15	EAST DOCK LEVELER	1,921			EX	20	3	1	20	EX	1,000	FLOOR MACHINE RCPT	16							
EX 17	EAST DOCK LEVELER	1,921			EX	20	1	1	20	EX	1,000	EMP. LOUNGE MICROWAVE	18							
EX 19	WEST DOCK LEVELER	1,921			EX	20	1	1	20	EX		SPARE	20							
EX 21	WEST DOCK LEVELER	1,921			EX	20	3	1	20	EX	500	TF-1	22							
EX 23	EQUIPPED SPACE				EX	20	1	1	20	EX	500	TF-2	24							
EX 25	EQUIPPED SPACE	4,804			EX	20	1	1	20	EX	1,000	BAKERY OVEN & AROMA FAN	26							
EX 27	SOUTH COMPACTOR		4,804		EX	50	3			EX	456	BAKERY OVEN & AROMA FAN	28							
EX 29	EQUIPPED SPACE				EX	20	1	1	20	EX	456	KEF-8	30							
EX 31	RCPTS SOUTH ENTRY	500			EX	20	1	1	20	EX	500	H-8 HOOD CONTROL	34							
EX 33	RCPTS SOUTH ENTRY	500			EX	20	1	1	20	EX	270	HIBACHI COOL BAR	36							
EX 35	RCPTS SOUTH ENTRY	500			EX	20	1	1	20	EX	500	H-2 HOOD CONTROL	38							
EX 37	RCPTS SOUTH ENTRY	500			EX	20	1	1	20	EX	180	CHECKOUT PRINTER	40							
EX 39	RCPTS SOUTH ENTRY	500			EX	20	1	1	20	EX		RCPT BACK DOOR/COKE MACH	42							
EX 41	RCPT ALARM BACK ROOM				EX	20	1	1	20	EX	1,000	RCPT BACK DOOR/COKE MACH	42							
SUBTOTAL													12,046	11,346	10,846		4,656	4,196	3,678	

TOTAL PHASE A - VA	LOAD	CONN. VA	DF	LOAD	CONN. VA	DF
16,702	COOLING	1.00	REFRIG	1.00		
139	HEATING	0	SIGN/DISP	1.25		
15,542	LIGHTING	1.25	KITCHEN	1.00		
130	RECEPTACLES	540	10/5	EXISTING	42,730	1.00
14,824	MOTORS	1,620	1.00	LRG MOTOR	1.25	TOTAL DEMAND
124	SUPP HEAT	1.00	SHOW WNDW	1.25		47,068 VA
47,068	MISC EQUIP	1,000	1.00	LTG TRACK	1.00	131 A

PANELBOARD NOTES

PANELBOARD: W (EXISTING)

FED FROM: MDP1
 AIC RATING: 10000 FULLY RATED
 CONTRACTOR TO VERIFY AND NOTIFY EOR
 EQUIPMENT GROUND BUS

MAIN SIZE/TYP: MLO
 SERVES: DELI
 MOUNTING: RECESSED
 VOLTS/PHASE: 208Y120V, 3PH, 4W
 LOCATION: DRY STORAGE

SECTION: 1

CKT NO.	DESCRIPTION	VOLTAMPS/PHASE			WIRE NO.	BKR NO.	P	BKR WIRE NO.	VOLTAMPS/PHASE			DESCRIPTION	CKT NO.							
		A	B	C					A	B	C									
1		1,741			1	20	EX	500			RTU #3 SMOKE DETECTOR	2								
EX 3	MAU-1 CONDENSER 1		1,741		EX	20	3	1	20	EX	500	BAGV BOX	4							
EX 5	EXISTING LOAD				EX	20	1	1	20	EX	500	EXISTING LOAD	6							
EX 7	EXISTING LOAD	2,570			EX	20	1	1	20	EX	500	EXISTING LOAD	8							
EX 9	MAU-1 CONDENSER 2		2,570		EX	30	3	20	12		793	EXISTING LOAD	10							
EX 11	EXISTING LOAD				EX	20	1	1	20	EX	793	KEF-2	12							
EX 13	EXISTING LOAD	733			EX	20	3	1	20	EX		EQUIPPED SPACE	16							
EX 15	KEF-1A		733		EX	20	1	1	20	EX	500	CHINESE FRYER PRINTER	18							
EX 17	EXISTING LOAD				EX	20	1	1	20	EX	500	ASIAN/HIBACHI TV MENUS	20							
EX 19	KEF-1B	456			EX	20	3	1	20	EX	500	HICKORY/REGISTERS TV MENUS	22							
EX 21	EXISTING LOAD				EX	20	1	1	20	EX	1,600	PIZZA REF TABLE	24							
EX 23	EXISTING LOAD	6,725			EX	20	1	1	20	EX	500	KITCHEN HOT LAMPS	26							
EX 25	EXISTING LOAD				EX	20	1	1	20	EX	1,120	KITCHEN REACH IN FREEZER	28							
EX 27	RTU-3 (DINING)		6,725		EX	70	3	1	20	EX	360	PIZZA TVS	30							
EX 29	EQUIPPED SPACE				EX	20	1	1	20	EX	480	PIZZA OVEN VIA HCP	32							
EX 31	EQUIPPED SPACE	500			EX	20	1	1	20	EX	1,150	PIZZA SCALE AND LOWERATOR	34							
EX 33	RCOF TOP #3 GFI				EX	20	1	1	20	EX	756	PIZZA SCALE AND LOWERATOR	36							
EX 35	EQUIPPED SPACE	7,686			EX	20	1	1	20	EX	500	H-2 HOOD CONTROL	38							
EX 37	EXISTING LOAD				EX	80	3	1	20	EX	500	PIZZA COLLAR RCPT	40							
EX 39	EXISTING LOAD				EX	20	1	1	20	EX		SPARE	42							
EX 41	EXISTING LOAD				EX	20	1	1	20	EX		SPARE	42							
SUBTOTAL													19,911	20,411	19,911		4,029	4,563	4,753	

TOTAL PHASE A - VA	LOAD	CONN. VA	DF	LOAD	CONN. VA	DF
23,940	COOLING	1.00	REFRIG	1.00		
200	HEATING	0	SIGN/DISP	1.25		
24,974	LIGHTING	1.25	KITCHEN	1.00		
190	RECEPTACLES	1,860	10/5	EXISTING	47,233	1.00
206	MOTORS	19,635	1.00	LRG MOTOR	1.25	TOTAL DEMAND
73,578	SUPP HEAT	1.00	SHOW WNDW	1.25		72,123 VA
204	MISC EQUIP	1,000	1.00	LTG TRACK	1.00	202 A

PANELBOARD NOTES

PANELBOARD: X (EXISTING)

FED FROM: MDP1
 AIC RATING: 10000 FULLY RATED
 CONTRACTOR TO VERIFY AND NOTIFY EOR
 EQUIPMENT GROUND BUS

MAIN SIZE/TYP: MLO
 SERVES: KITCHEN
 MOUNTING: RECESSED
 VOLTS/PHASE: 208Y120V, 3PH, 4W
 LOCATION: DRY STORAGE

SECTION: 1

CKT NO.	DESCRIPTION	VOLTAMPS/PHASE			WIRE NO.	BKR NO.	P	BKR WIRE NO.	VOLTAMPS/PHASE			DESCRIPTION	CKT NO.							
		A	B	C					A	B	C									
R 1	CHINESE PRINTERS		360		EX	20	1	1	20	EX	4,323	BAKERY PROOFER	2							
R 3	CHINESE REC WARMER/LOW.				EX	20	1	1	20	EX	4,323	BAKERY PROOFER	4							
R 5	CHINESE REC TABLE				EX	20	1	1	20	EX	4,323	BAKERY PROOFER CONTROL	6							
R 7	EXISTING LOAD	2,954			EX	20	1	1	20	EX	900	BAKERY FLOOR BOXES	8							
R 9	DELI DISHWASHER		2,954		EX	30	3	1	20	EX	360	BAKERY FLOOR BOXES	10							
R 11	EXISTING LOAD				EX	20	2	2	20	EX	1,664	BACK RM ICE MACHINE	12							
R 13	PANINI PRESS	1,664			EX	20	2	2	20	EX	600	WH-1 A	14							
R 15	EXISTING LOAD				EX	20	1	1	20	EX	600	WH-1 B	16							
R 17	KITCHEN OIL SYSTEM				EX	20	1	1	20	EX	600	WH-1 B	18							
R 19	EXISTING LOAD	500			EX	20	1	1	20	EX	500	EXISTING LOAD	20							
R 21	EXISTING LOAD				EX	20	1	1	20	EX	1,664	EXISTING LOAD	22							
R 23	EXISTING LOAD				EX	20	1	1	20	EX	1,664	EXISTING LOAD	24							
R 25	EXISTING LOAD	500			EX	20	1	1	20	EX	5,440	MAU-1 FANS	26							
R 27	PRODUCE BUG LIGHT				EX	20	1	1	20	EX	5,440	MAU-1 FANS	28							
R 29	WINE TASTING RCPT				EX	20	1	1	20	EX	5,440	MAU-1 FANS	30							
R 31	WINE TASTING RCPT	500			EX	20	1	1	20	EX	500	CLG RCPT FRUIT & JUICE RCPT	32							
R 33	BAKERY WRAPPER	500			EX	20	1	1	20	EX	1,375	CHINESE HEAT LAMPS 1	34							
R 35	BAKERY SCALES 2				EX	20	1	1	20	EX	1,375	CHINESE HEAT LAMPS 2	36							
R 37	BAKERY DISPLAY CASE	500			EX	20	1	1	20	EX	9,607	BAKERY PAN WASH	38							
R 39	TV RCPT				EX	20	1	1	20	EX	9,607	BAKERY PAN WASH	40							
R 41	TV RCPT				EX	20	1	1	20	EX	9,607	BAKERY PAN WASH	42							
SUBTOTAL													6,978	7,118	7,214		22,534	23,369	24,673	

TOTAL PHASE A - VA	LOAD	CONN. VA	DF	LOAD	CONN. VA	DF
29,512	COOLING	1.00	REFRIG	1.00		
246	HEATING	0	SIGN/DISP	1.25		
36,487	LIGHTING	1.25	KITCHEN	1.00		
254	RECEPTACLES	2,750	10/5	EXISTING	15,049	0.80
31,887	MOTORS	25,182	1.00	LRG MOTOR	1.25	TOTAL DEMAND
91,886	SUPP HEAT	1,200	1.00	SHOW WNDW	1.25	80,003 VA
255	MISC EQUIP	1,820	1.00	LTG TRACK	1.00	224 A

PANELBOARD NOTES


PANELBOARD: AA1 (EXISTING)

FED FROM: MDP1
 AIC RATING: 10000 FULLY RATED
 CONTRACTOR TO VERIFY AND NOTIFY EOR
 EQUIPMENT GROUND BUS

MAIN SIZE/TYP: MLO
 SERVES: FRONT OF HOUSE
 MOUNTING: RECESSED
 VOLTS/PHASE: 208Y120V, 3PH, 4W
 LOCATION: CUSTOMER SERVICE

SECTION: 1

CKT NO.	DESCRIPTION	VOLTAMPS/PHASE			WIRE NO.	BKR NO.	P	BKR WIRE NO.	VOLTAMPS/PHASE			DESCRIPTION	CKT NO.
		A	B	C					A	B	C		
EX 1	JEWELRY GONDOLA	500			EX	20	1	1	20	EX	500	DRY CLEAN & POSTAL IG	2
EX 3	GONDOLA		500		EX	20	1	1	20	EX	1,000	2014 WATER DISP	4
EX 5	POP MACHINE RCPTS				EX	20	1	1	20	EX	500	DEMO RCPT WEST END	6
EX 7	POP MACHINE RCPTS	1,000			EX	20	1	1	20	EX	1,000	EXISTING LOAD	8
EX 9	EXISTING LOAD				EX	20	1	1	20	EX	1,000	EXISTING LOAD	10
EX 11	EXISTING LOAD				EX	20	1	1	20	EX	1,000	EXISTING LOAD	12
EX 13	EXISTING LOAD	1,000			EX	20	1	1	20	EX	1,000	EXISTING LOAD	14
EX 15	EXISTING LOAD				EX	20	1	1	20	EX	1,000	COFFEE GRINDER	16
EX 17	EXISTING LOAD	1,000			EX	20	1	1	20	EX	3,328	EXISTING LOAD	18
EX 19	EXISTING LOAD				EX	20	1	1	20	EX	1,000	EXISTING LOAD	20
EX 21	EXISTING LOAD				EX	20	1	1	20	EX	1,000	EXISTING LOAD	22
EX 23	EXISTING LOAD	1,664</											

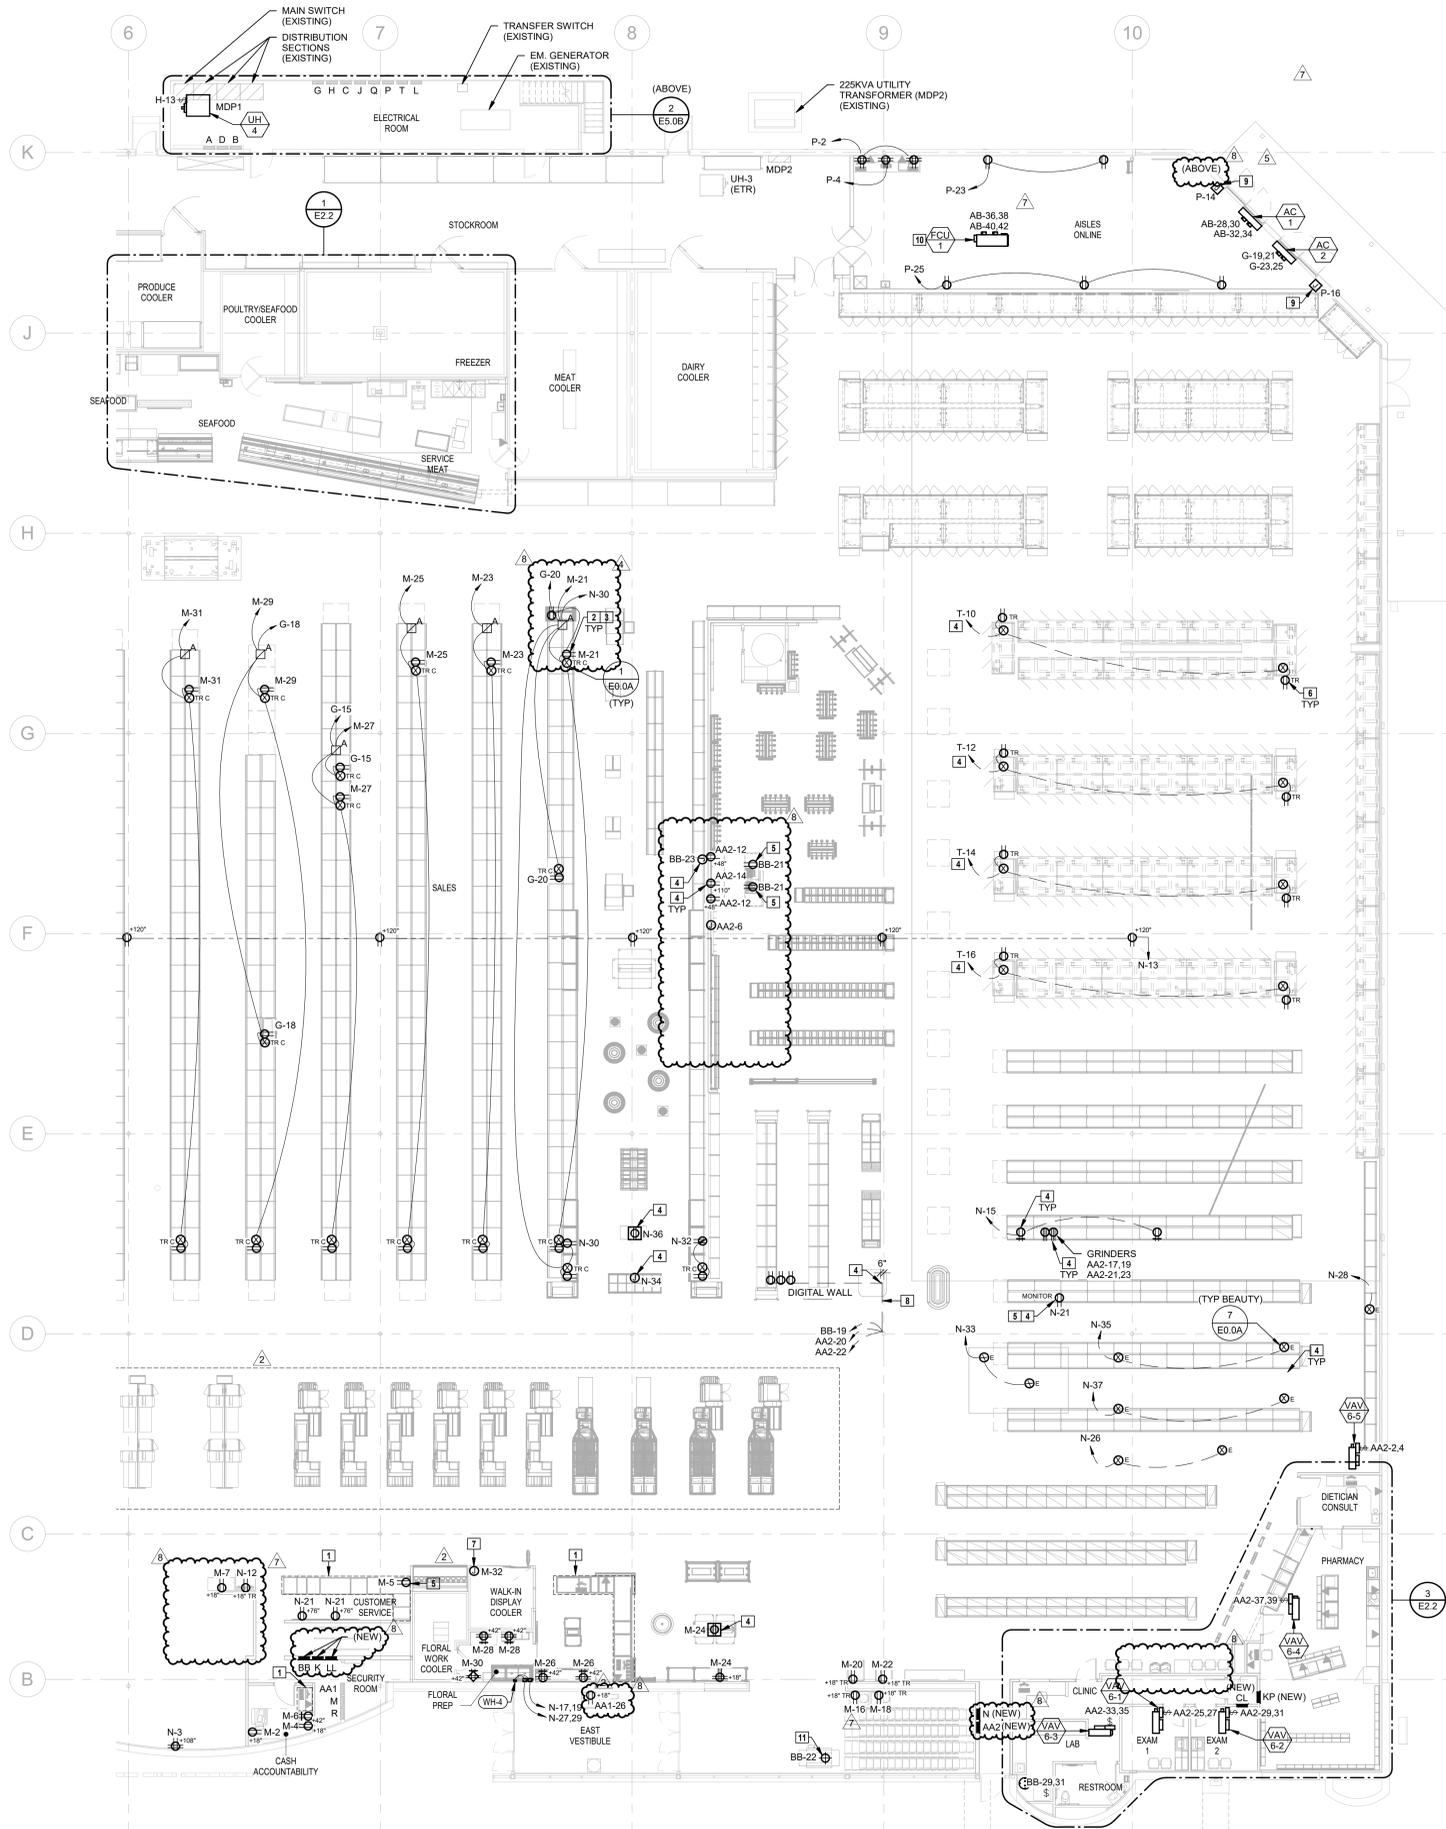

- ELECTRICAL PLAN NOTES**
- REFER TO SHEET E4.4 (SHEET BY OTHERS) FOR POWER & SYSTEMS SCOPE OF WORK.
 - REVISE AND EXTEND CIRCUITRY FOR RELOCATED/REPLACED EQUIPMENT. COORDINATE EXACT CONDUIT ROUTING WITH TENANT AND OTHER TRADES. EXISTING DEVICES AND RELATED CIRCUITRY MAY BE REUSED IF IN GOOD CONDITION, OTHERWISE REPLACE.
 - PROVIDE RECEPTACLE AND JUNCTION BOX MOUNTED BELOW SHELVING AND CONNECT TO POWER POLE VIA CONCEALED FLEXIBLE METAL CONDUIT. COORDINATE REQUIREMENTS WITH OWNER PRIOR TO ROUGH-IN.
 - ROUTE CONDUIT(S) CONCEALED UNDER SLAB TO NEAREST FULL HEIGHT WALL FOR CONTINUATION. COORDINATE STUB-UP LOCATION WITH OWNER AND OTHER TRADES PRIOR TO ROUGH-IN. REFER TO PEI.1 ELECTRICAL STUBUP PLAN FOR MORE INFORMATION.
 - INSTALL RECEPTACLE(S) AND DATA BOXES IN AN ACCESSIBLE LOCATION UNDER COUNTER IN MILLWORK. LOCATE SUCH THAT DRAWERS AND DIVIDERS DO NOT BLOCK ACCESS TO DEVICE. COORDINATE LOCATION WITH OWNER AND OTHER TRADES PRIOR TO ROUGH-IN.
 - RECEPTACLES MOUNTED IN THE BASEPLATE OF THE CASE. ROUTE ELECTRICAL FROM CASE ROUGH-IN LOCATION. COORDINATE MOUNTING OF RECEPTACLE WITH CASE SUPPLIER AND REFRIGERATION CONTRACTOR.
 - IF SWITCH IS NOT FURNISHED WITH AUTO DOOR THEN PROVIDE ON/OFF SERVICE SWITCH AND RELATED CIRCUITRY WITHIN SIGHT OF MOTOR PER CODE. COORDINATE REQUIREMENTS WITH DOOR INSTALLER AND OWNER PRIOR TO ROUGH-IN.
 - EXTEND 1" CONDUIT UNDER FLOOR FROM WALL TO DIGITAL SHOE WALL WITH THREE 120V CIRCUITS FOR MONITORS.
 - IF SWITCH IS NOT FURNISHED WITH AUTO DOOR THEN PROVIDE ON/OFF SERVICE SWITCH AND RELATED CIRCUITRY WITHIN SIGHT OF MOTOR PER CODE. COORDINATE REQUIREMENTS WITH DOOR INSTALLER AND OWNER PRIOR TO ROUGH-IN.
 - PROVIDE INTERLOCK OF INDOOR UNIT WITH OUTDOOR UNIT IN ACCORDANCE WITH MANUFACTURER'S RECOMMENDATIONS. COORDINATE REQUIREMENTS WITH OTHER TRADES PRIOR TO ROUGH-IN.
 - PROVIDE TWIST-LOCK RECEPTACLE IN VESTIBULE CEILING AND EXTEND A FLEXIBLE CORD WITH CORD STRAIN RELIEF ON EACH END DOWN TO 7" AFF. CART STERILIZER SHALL PLUG INTO END OF FLEXIBLE CORD.
 - PROVIDE WEATHERPROOF JUNCTION BOX, WEATHERPROOF LOCKABLE DISCONNECT SWITCH, AND 120V CIRCUIT AT DIRECTED LOCATION BY SIGN SUPPLIER FOR CONNECTION TO STOREFRONT SIGNAGE. VERIFY ELECTRICAL REQUIREMENTS WITH SIGN SUPPLIER PRIOR TO ROUGH-IN AND ADJUST ELECTRICAL PROVISIONS AS NECESSARY. PROVIDE CONDUIT THROUGH WALL AS NEEDED FOR CONNECTION(S) TO SIGN.

1 ELECTRICAL PLAN - PART B
3/32" = 1'-0"

REVISION	DATE BY
2 ASH	01/07/21
4 ASH	03/02/21
5 ASH	03/19/21
7 ASH	04/16/21
8 ASH	06/23/21

HENDERSON ENGINEERS
8345 LENEKA DRIVE, SUITE 300
LENEKA, KS 66214
TEL 913.742.5000 FAX 913.742.5001
WWW.HENDERSONENGINEERS.COM

1950003081
MO. CORPORATE NO. E-5560
EXPRESS 12/31/2021


PROFESSIONAL SEAL

STATE OF MISSOURI
VINCENT G. MASILIONS
NUMBER PE-2008009670
PROFESSIONAL ENGINEER

05/20/2021
VINCENT G. MASILIONS
LICENSE # PE-2008009670

LOCATION
LEE'S SUMMIT, MO #2
310 SW WARD RD
HY-VEE INC.
5820 WESTOWN PARKWAY
WEST DES MOINES, IOWA 50386
TEL: (515) 267-2600
FAX: (515) 267-2636

HyVee
EMPLOYEE OWNED

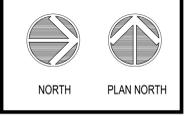


ELECTRICAL PLAN - PART B

PROJECT MANAGER	CHECKED BY
SL	HEI
DRAWN BY: HENDERSON	DATE: 10/19/2020
SCALE: AS NOTED	JOB NUMBER: 62830547


SHEET:
E2.0B

LOCATION	AMOUNT AND SIZE	HEIGHT	MOUNTING
SUSHI	(2) 49" MONITORS	B/O MONITOR +6'-8"	POLE
MARKET GRILLE EXPRESS	(3) 49" MONITORS	B/O MONITOR +6'-8"	POLE
HICKORY HOUSE	(4) 49" MONITORS	B/O MONITOR +6'-8"	POLE
HIBACHI	(2) 49" MONITORS	B/O MONITOR +6'-8"	POLE
ASIAN	(2) 49" MONITORS	B/O MONITOR +6'-8"	POLE
MIA PIZZA	(2) 49" MONITORS	B/O MONITOR +6'-8"	POLE
BAKERY CAKE	(1) 65" MONITOR	B/O MONITOR +5'-8"	WALL - BOX +9'-0"
BAKERY BREAD	(2) 55" MONITORS	B/O MONITOR +6'-8"	WALL - BOX +8'-8"
MEAT	(1) 82" MONITOR	B/O MONITOR +5'-8"	WALL - BOX +6'-8"
SEAFOOD	(1) 65" MONITOR	B/O MONITOR +6'-8"	WALL - BOX +9'-0"
SEASONS	(1) 55" MONITOR	MONITOR ON KIOSK	WALL - BOX +18"
DIETITIAN	(1) 49" MONITOR	B/O MONITOR +4'-3"	WALL - BOX +5'-3"
GREETING CARDS	(1) 49" MONITOR	VARIES	WALL
BASIN	(1) 65" MONITOR	B/O MONITOR +5'-2"	WALL - BOX +7'-6"
CUSTOMER SERVICE	(2) 65" MONITORS	B/O MONITOR +4'-7"	WALL - BOX +6'-4"
APPAREL	(1) 82" MONITOR	B/O MONITOR +6'-2"	WALL - BOX +9'-2"


- ELECTRICAL PLAN NOTES**
- REVISE AND EXTEND CIRCUITRY FOR RELOCATED/REPLACED EQUIPMENT. COORDINATE EXACT CONDUIT ROUTING WITH TENANT AND OTHER TRADES. EXISTING DEVICES AND RELATED CIRCUITRY MAY BE REUSED IF IN GOOD CONDITION, OTHERWISE REPLACE.
 - EXISTING KITCHEN EQUIPMENT TO REMAIN.
 - REFER TO SHEET E4.4 (SHEET BY OTHERS) FOR POWER & SYSTEMS SCOPE OF WORK.
 - INSTALL RECEPTACLE(S) AND DATA BOXES IN AN ACCESSIBLE LOCATION UNDER COUNTER IN MILLWORK. LOCATE SUCH THAT DRAWERS AND DIVIDERS DO NOT BLOCK ACCESS TO DEVICE. COORDINATE LOCATION WITH OWNER AND OTHER TRADES PRIOR TO ROUGH-IN.
 - KITCHEN EXHAUST HOOD CONTROL PANEL REFER TO KITCHEN ELECTRICAL PLANS AND HOOD PLANS WITHIN MECHANICAL SET FOR MORE INFORMATION.
 - ROUTE CONDUIT(S) CONCEALED UNDER CAB TO NEAREST FULL HEIGHT WALL FOR CONTINUATION. COORDINATE STUB-UP LOCATION WITH OWNER AND OTHER TRADES PRIOR TO ROUGH-IN. REFER TO PE1.1 ELECTRICAL STUBUP PLAN FOR MORE INFORMATION.
 - RELOCATED KITCHEN EQUIPMENT. CONTRACTOR TO RELOCATE EQUIPMENT POWER DEVICES.
 - REFER TO ELECTRONIC MENU MONITOR BOARD SCHEDULE ON THIS SHEET FOR MORE INFORMATION.

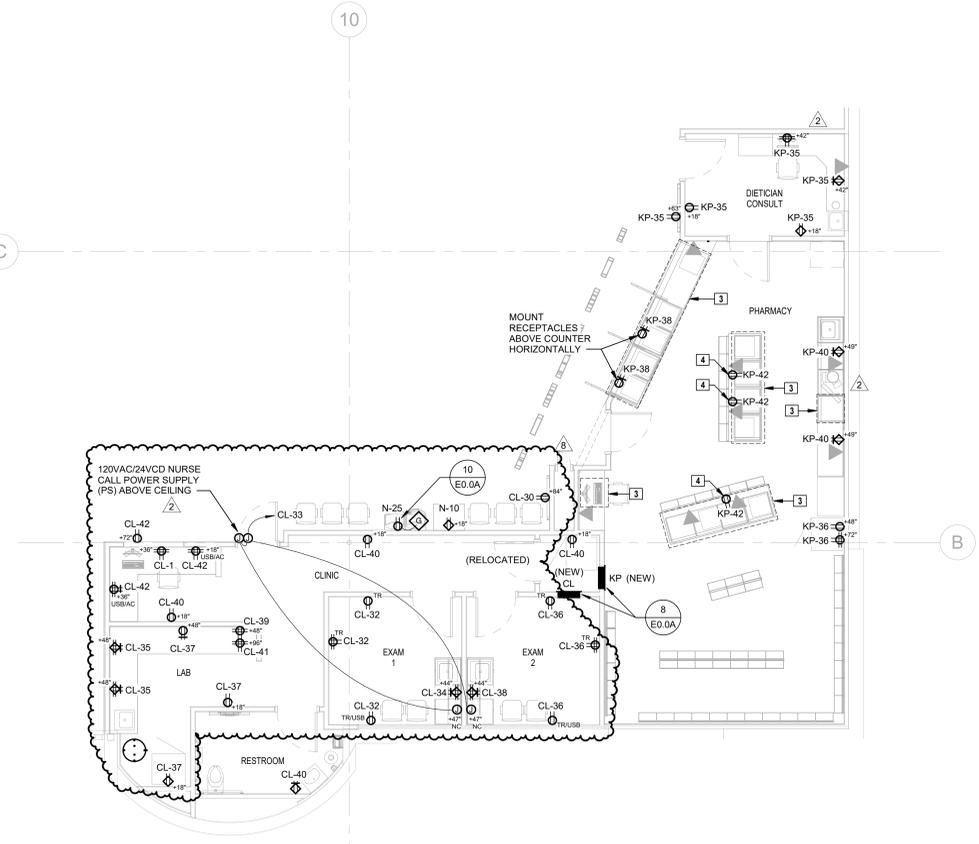

3 PARTIAL ELECTRICAL POWER PLAN - PHARMACY
 3/16" = 1'-0"

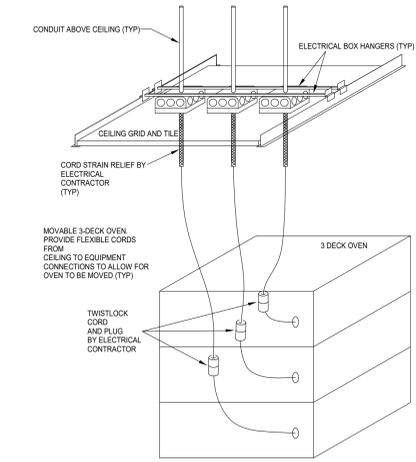

2 3 DECK OVEN ELECTRICAL DETAIL
 NTS

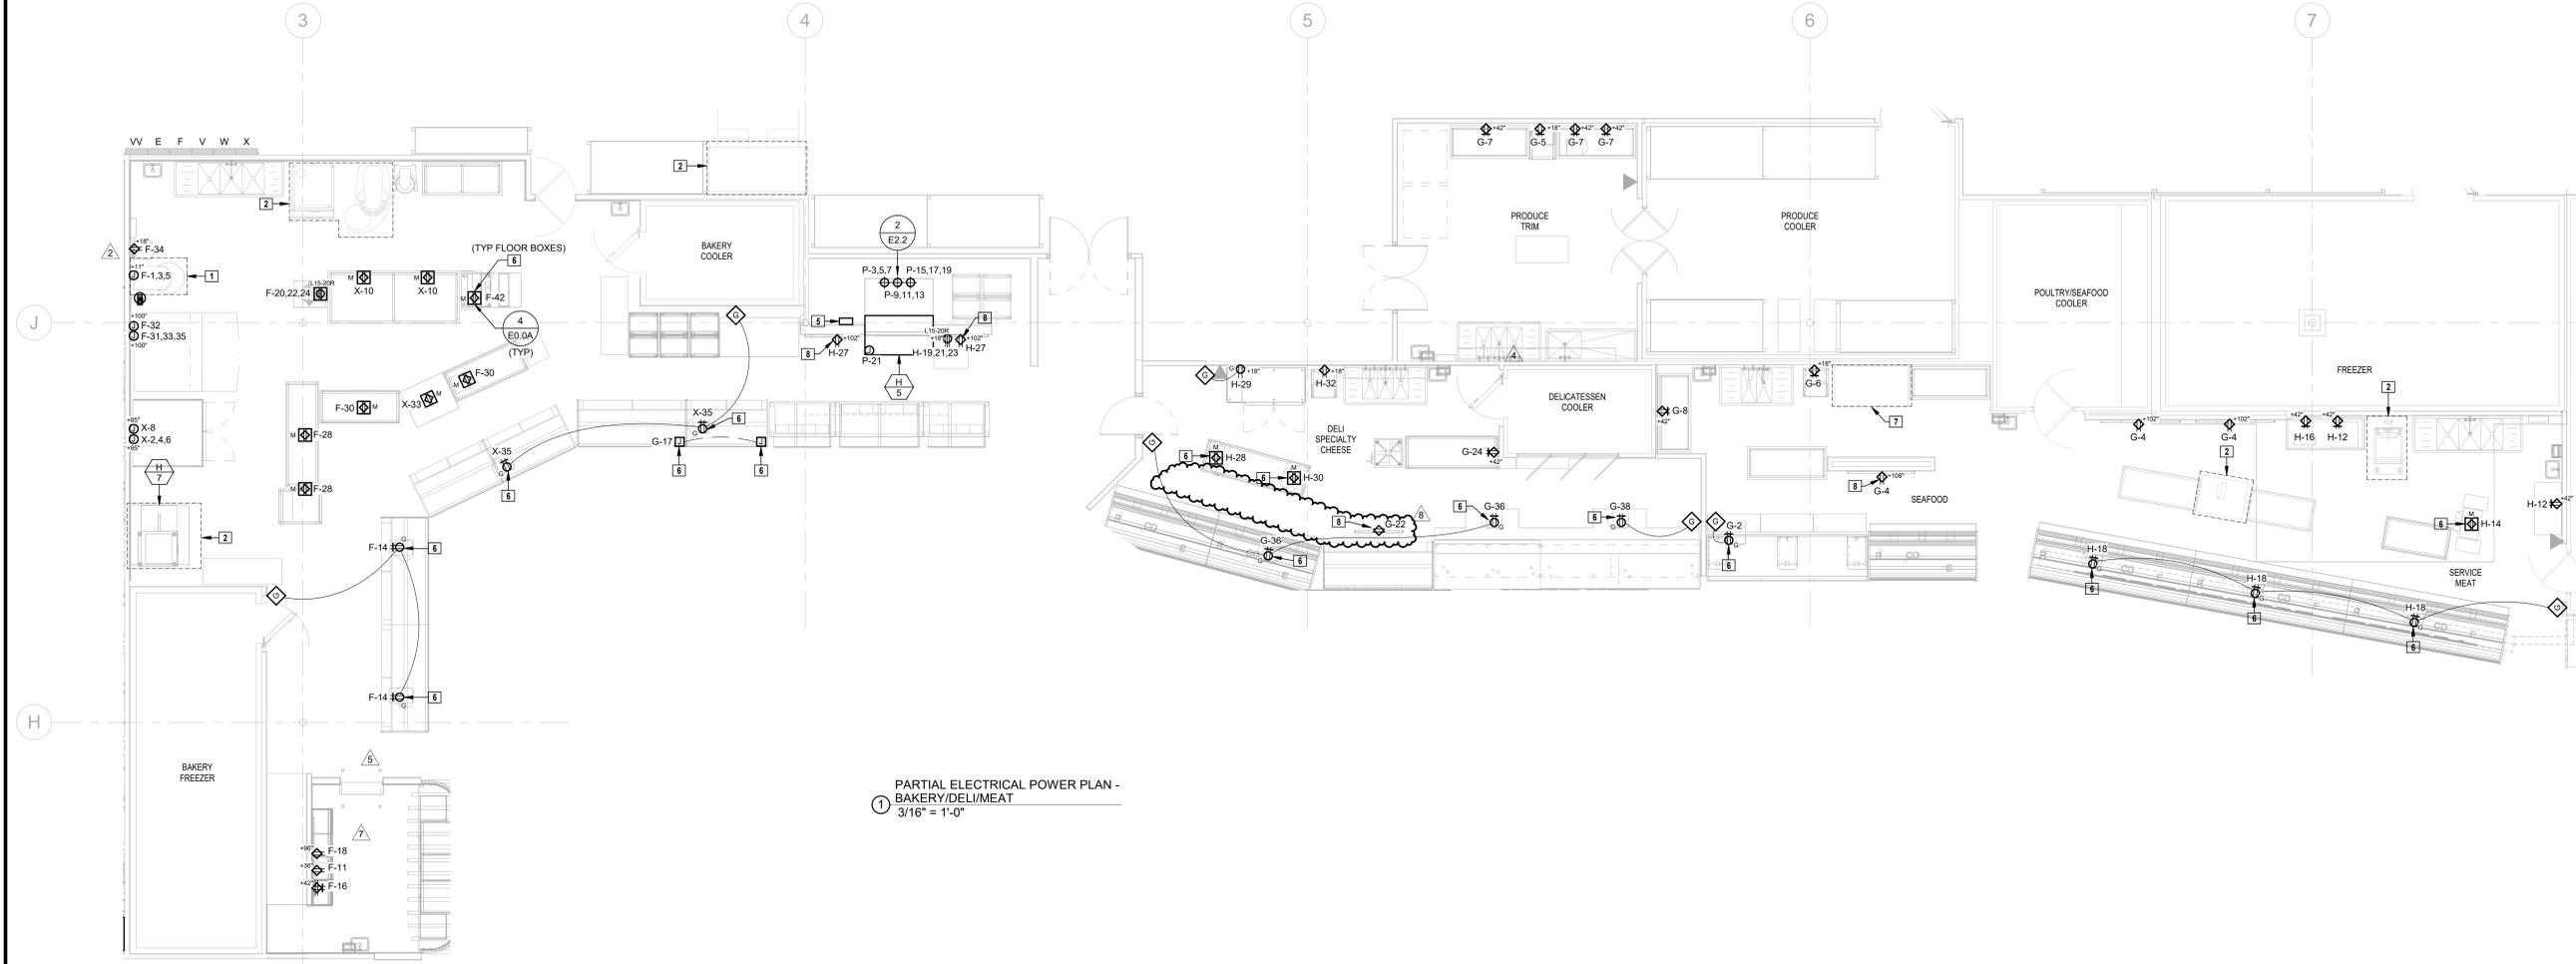


1 PARTIAL ELECTRICAL POWER PLAN - BAKERY/DELI/MEAT
 3/16" = 1'-0"

HENDERSON ENGINEERS
 8345 LENEKA DRIVE, SUITE 300
 LENEKA, KS 66214
 TEL 913.742.5000 FAX 913.742.5001
 WWW.HENDERSONENGINEERS.COM

PROFESSIONAL SEAL
 STATE OF MISSOURI
 VINCENT G. MASILIONS
 NUMBER PE-2008009670
 PROFESSIONAL ENGINEER
 05/20/2021
 VINCENT G. MASILIONS
 LICENSE # PE-2008009670

LOCATION
LEE'S SUMMIT, MO #2
 310 SW WARD RD
 HY-VEE INC.
 5820 WESTOWN PARKWAY
 WEST DES MOINES, IOWA 50326
 TEL 515.281.5200 FAX 515.267.4636
HyVee
 EMPLOYEE OWNED

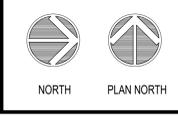


ELECTRICAL PART PLANS

PROJECT MANAGER: SL
 CHECKED BY: HEI
 DRAWN BY: HENDERSON
 DATE: 10/19/2020
 SCALE: AS NOTED
 JOB NUMBER: 62830547
 SHEET:

E2.2

REVISION	DATE BY
2 AS#	01/07/21
3 AS#	03/19/21
4 AS#	04/16/21
5 AS#	06/03/21

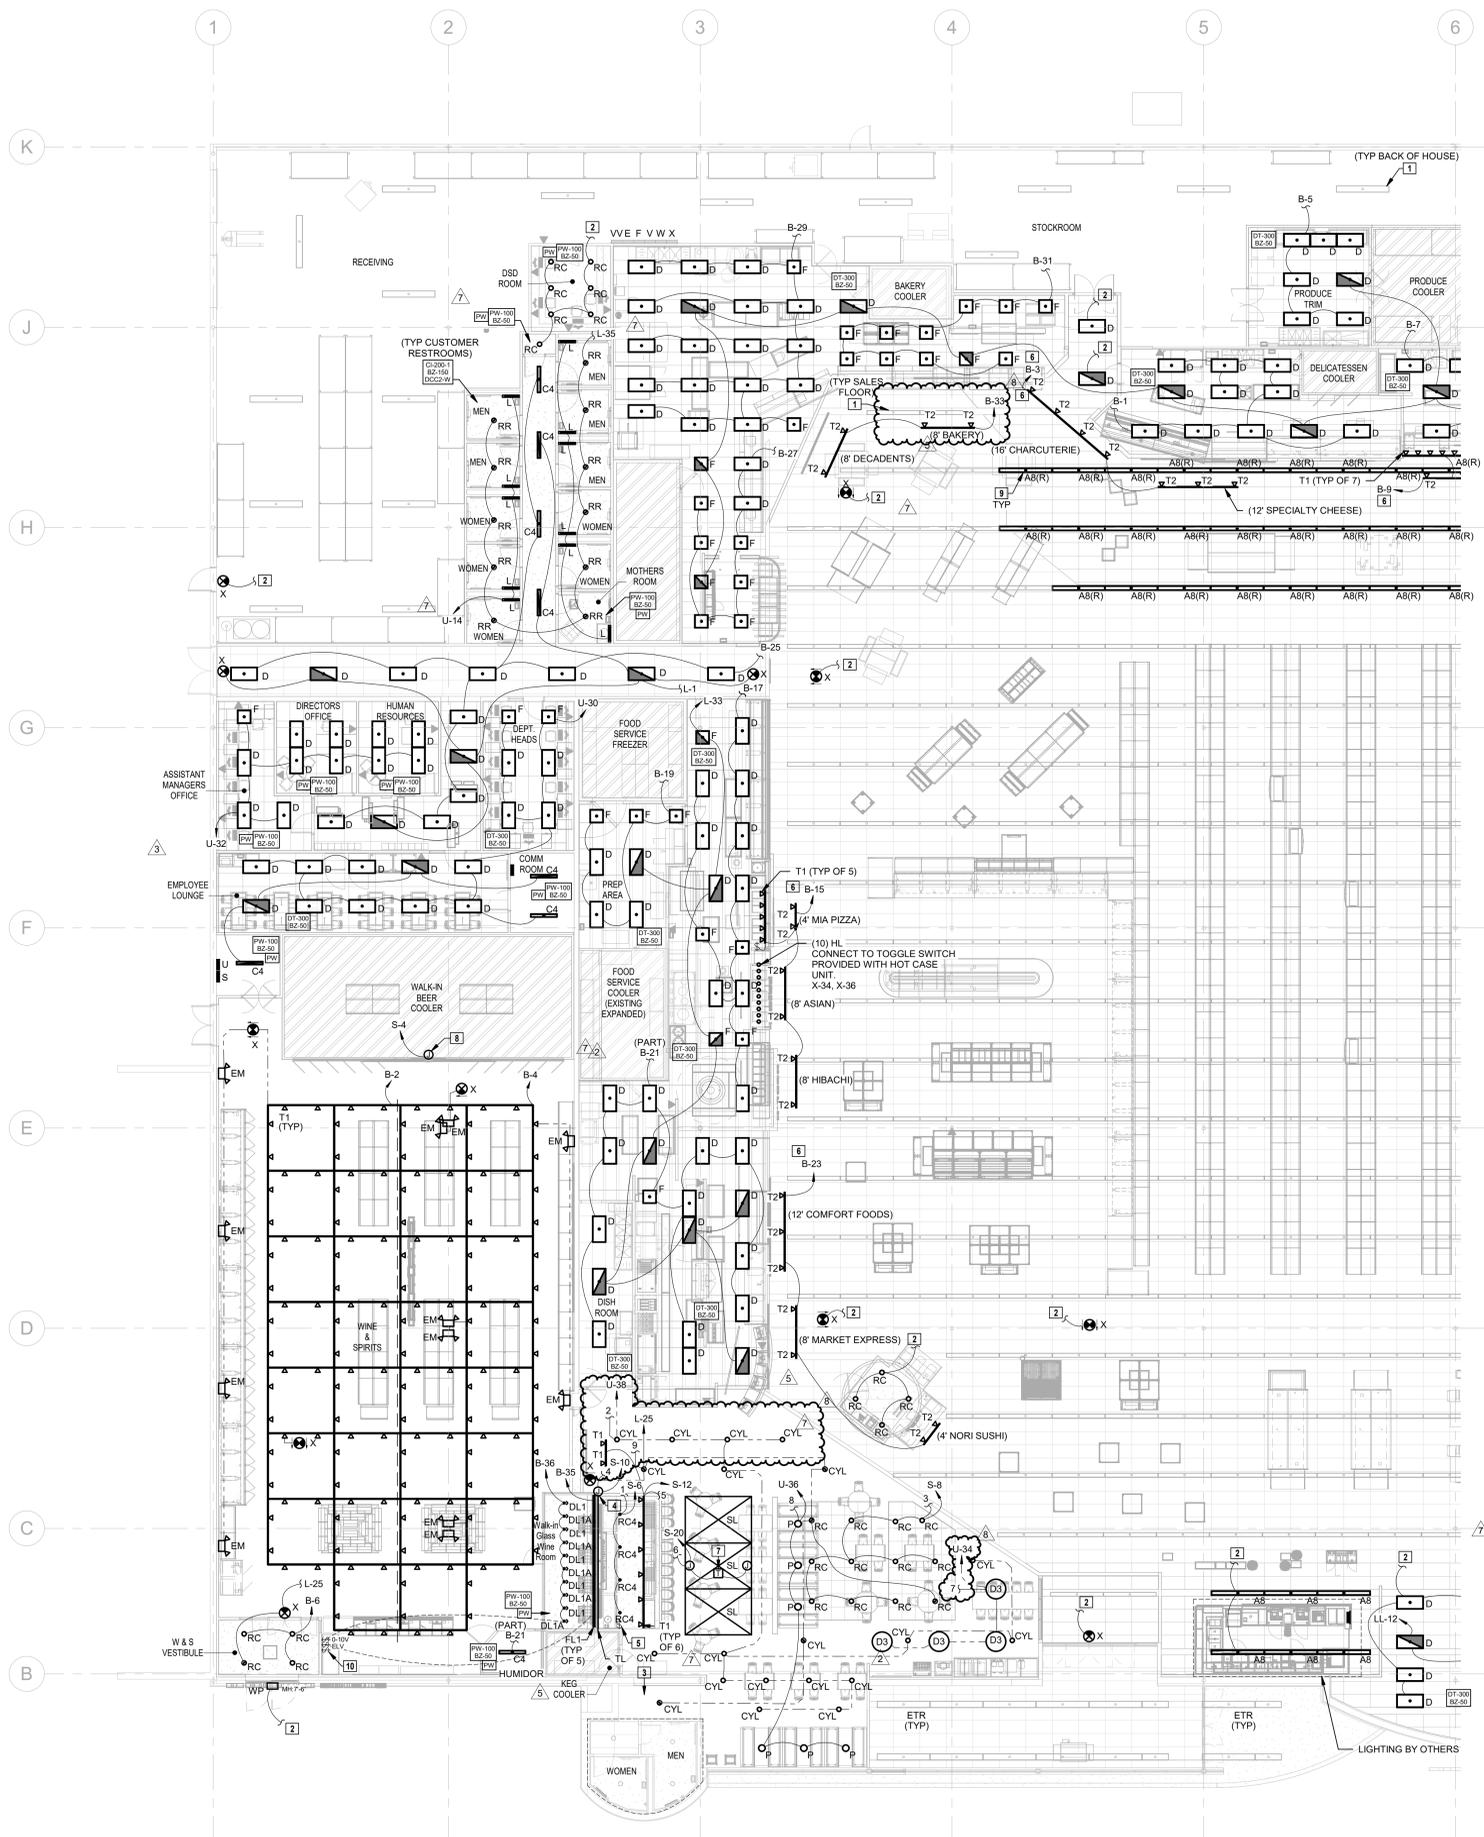

LIGHTING GENERAL NOTES:

- THE EMERGENCY LIGHTING SYSTEM HAS BEEN DESIGNED TO PROVIDE AN INITIAL FLOOR ILLUMINANCE LEVEL OF 1 FC AVERAGE, 0.1 FC MINIMUM AND NO MORE THAN A 40:1 MAXIMUM RATIO ALONG THE EMERGENCY EGRESS PATHS. WHERE APPLICABLE, ADJUST AIMING OF EMERGENCY LIGHTS AS REQUIRED TO PROVIDE PROPER ILLUMINATION AT FLOOR AVOIDING OBSTACLES AND SHADOWS AFTER STORE SET-UP IS COMPLETE.
- WALL MOUNTED EXITS SIGNS SHALL BE MOUNTED 12" ABOVE DOOR FRAME AND CENTERED ABOVE DOOR OPENINGS. UNLESS NOTED OTHERWISE, CEILING MOUNTED EXIT SIGNS SHALL BE SUSPENDED TO 12'-0" AFF IN CUSTOMER AREAS OPEN TO STRUCTURE. AT BOTTOM OF BAR JOISTS IN BACKROOM AREAS AND ON FINISHED CEILING WHERE APPLICABLE. UNLESS NOTED OTHERWISE, EXIT SIGNS SHALL BE READILY VISIBLE FROM DIRECTION OF EGRESS TRAVEL. COORDINATE FINAL EXIT SIGN LOCATIONS WITH AHJ AND OWNER.
- PROVIDE LABEL AT EACH MANUAL LIGHT SWITCH INDICATING THE LIGHT FIXTURE(S) THAT THE SWITCH CONTROLS AND THE RESPECTIVE "NLBD-CKT#" DESIGNATION. A SINGLE LIGHT SWITCH FOR A SMALL ROOM DOES NOT NEED TO INDICATE THE SPACE CONTROLLED SINCE IT IS INTUITIVELY OBVIOUS. COORDINATE LABEL REQUIREMENTS WITH THE OWNER PRIOR TO INSTALLATION. REFER TO THE SPECIFICATIONS FOR MORE INFORMATION.
- ALL REMOTELY LOCATED LIGHT FIXTURE POWER SUPPLIES SHALL BE LOCATED IN AN ACCESSIBLE LOCATION WITH PROPER VENTILATION IN ACCORDANCE WITH MANUFACTURER'S RECOMMENDATIONS. CONCEAL DEVICES AND RELATED WIRING FROM CUSTOMER/PUBLIC VIEW. PROVIDE ENCLOSURE IF REQUIRED. COORDINATE LOCATION AND ENCLOSURE TYPE WITH ARCHITECT AND OWNER PRIOR TO INSTALLATION.
- PER 2017 NEC 700.2 AND 700.24, ALL DIRECTLY CONTROLLED LUMINAIRES USED FOR EMERGENCY ILLUMINATION AND ALL APPLICABLE CONTROLS SHALL HAVE UL LISTED OR EQUIVALENT NRTL LISTING. IF EMERGENCY LUMINAIRE OR CONTROL MANUFACTURER DOES NOT HAVE APPROPRIATE LISTING THE EMERGENCY LUMINAIRE SHALL NOT BE CONNECTED TO 0-10V DIMMING SYSTEM.

LIGHTING GENERAL NOTES (GROCERY):

- ALL LIGHT FIXTURES OVER OPEN FOOD AREAS, COFFIN CASES AND FOOD PREP AREAS SHALL BE LED TYPE OR PROVIDED WITH PROTECT-A-LAMP COVERS OR EQUIVALENT SHIELDED OR SHATTERPROOF LAMPS. VERIFY THAT ALL AREAS ARE PROPERLY PROTECTED AFTER STORE SET-UP IS COMPLETE. LIGHT FIXTURES IN FOOD PROCESSING AREAS SHALL BE EASILY CLEANABLE AND SUITABLE FOR THE LOCATION. USE PRODUCTS WITH THE APPROPRIATE NATIONAL SANITATION FOUNDATION (NSF) CERTIFICATION IF REQUIRED BY THE AHJ.
- COORDINATE FINAL LIGHT FIXTURE LOCATIONS IN WALK-IN COOLERS AND FREEZERS WITH REFRIGERATION COILS AND OTHER TRADES.

LIGHTING SUPPLEMENTAL SPECIFICATIONS:

- REFER TO THE ARCHITECTURAL DRAWINGS FOR LIGHT FIXTURE LOCATIONS, MOUNTING HEIGHTS, TRACK LENGTHS AND ADDITIONAL MOUNTING INFORMATION. CONTRACTOR SHALL BE RESPONSIBLE FOR INSURING THAT COORDINATION AND CONFLICT ISSUES ARE RESOLVED PRIOR TO INSTALLATION OF LIGHT FIXTURES; CONTACT ARCHITECT/ENGINEER IMMEDIATELY IF THERE ARE DISCREPANCIES.
- THROUGH WIRING OF RECESSED LIGHT FIXTURES, IN SUSPENDED CEILINGS, IS NOT PERMITTED. CONNECT EACH LIGHT FIXTURE BY A WHIP TO A JUNCTION BOX. PROVIDE CABLE WHIPS OF SUFFICIENT LENGTH TO ALLOW TESTING OR RELOCATING EACH LIGHT FIXTURE WITHIN A 5'-0" RADIUS OF ITS INDICATED LOCATION. CABLE WHIPS SHALL NOT EXCEED 6'-0" OF UNSUPPORTED LENGTHS.
- PROVIDE A NEUTRAL CONDUCTOR TO ALL WALL MOUNTED LINE VOLTAGE LIGHT SWITCHES, UNLESS NOTED OTHERWISE. IF NEUTRAL TERMINATION IS NOT REQUIRED FOR THE DEVICE THEN CAP CONDUCTOR AND TAG AS "NEUTRAL FOR FUTURE USE."
- COORDINATE ALL OCCUPANCY/VACANCY SENSOR SETTINGS WITH OWNER AND ADJUST AS NECESSARY FOR PROPER OPERATION. SETTINGS MUST COMPLY WITH AHJ AND LOCAL ENERGY CODE REQUIREMENTS.
- DO NOT INSTALL OCCUPANCY/VACANCY SENSORS WITHIN 48" OF AIR DIFFUSER OR SIMILAR OBSTRUCTION THAT MAY OVERLY AFFECT THE SENSOR PERFORMANCE. COORDINATE FINAL SENSOR LOCATIONS WITH OTHER TRADES AND INSTALL IN ACCORDANCE WITH MANUFACTURER'S RECOMMENDATIONS.

LIGHTING DESIGN RESPONSIBILITY GENERAL NOTES:

- THE LOCATION AND SELECTION OF THE LIGHT FIXTURES WERE MADE BY OTHERS AND ARE OUTSIDE OF THE SCOPE OF WORK OF HENDERSON ENGINEERS, UNLESS NOTED OTHERWISE. HENDERSON ENGINEERS' SCOPE OF SERVICES IS LIMITED TO PROVIDING LIGHTING POWER CIRCUIT AND CONTROL DESIGN AND CODE COMPLIANCE CALCULATIONS. THE USE OF THE SEAL AND SIGNATURE ON THIS SHEET APPLIES TO HENDERSON ENGINEERS' SCOPE OF SERVICES ONLY.

LIGHTING FLOOR PLAN NOTES


- REPLACE EXISTING LAMP(S) IN THIS AREA WITH LED REPLACEMENT WITH INTEGRATED DRIVER OF SIMILAR LUMEN OUTPUT. LED REPLACEMENT SHALL BE COMPATIBLE WITH EXISTING BALLAST(S), SOCKETS AND CONTROLS. PROVIDE LED REPLACEMENT BY GE, PHILLIPS, OR OTHER APPROVED NRTL LISTED PRODUCT. PROVIDE SUBMITTAL OF PROPOSED LED REPLACEMENT TO ENGINEER AND OWNER FOR REVIEW PRIOR TO ORDER. REPAIR OR REPLACE ANY DAMAGED SOCKETS OR BALLASTS TO ENSURE PROPER OPERATION. FINAL INSTALLATION SHALL MEET ALL CODE REQUIRED LIGHT LEVEL REQUIREMENTS AND SHALL FUNCTION PROPERLY WITH EXISTING CONTROLS.
- CONNECT TO EXISTING AREA LIGHT FIXTURE CIRCUIT AND CONTROLS. MAINTAIN CONNECTION TO EXISTING NORMAL LIGHTING AND EMERGENCY LIGHTING CIRCUITS FOR PROPER OPERATION. EXISTING RACEWAY, CIRCUITRY AND RELATED APPURTENANCES MAY BE REUSED IF IN GOOD CONDITION AND NEW DESIGN CRITERIA CAN BE MET, OTHERWISE REPLACE.
- EXISTING ROOMSPACE TO REMAIN. COORDINATE REMODEL WORK WITH CONSTRUCTION PHASE AND OVERALL PLAN FOR REMODEL OF STORE.
- VERIFY LOCATION OF LED LIGHTING CONTROLLER (MAGNETIC DIMMABLE DRIVER). LOCATE CONTROLLED IN ACCESSIBLE LOCATION. ROUTE LOW VOLTAGE CABLE IN WALL SPACE TO LED LIGHTING BEHIND ACRYLIC DISPLAY.
- MARKET GRILLE SWITCHBANK. COORDINATE FINAL LOCATION WITH HY-VEE PRIOR TO ROUGH-IN. REFER TO ZIE3.1.
- TRACK LIGHTING TO BE CONTROLLED VIA EXISTING LIGHTING CONTROL PANEL.
- LOCATE TRANSFORMER IN ACCESSIBLE LOCATION ABOVE CEILING ELEMENT. COORDINATE EXACT LOCATION AND REQUIREMENTS WITH HY-VEE PRIOR TO ROUGH-IN.
- PROVIDE JUNCTION BOX FOR BEER COOLER SIGNAGE. COORDINATE EXACT LOCATION AND REQUIREMENTS WITH HY-VEE PRIOR TO ROUGH-IN.
- RELOCATE LIGHT FIXTURE(S) AS SHOWN AND REVISE AND EXTEND RELATED CIRCUITRY.
- WINE AND SPIRITS SWITCHBANK. COORDINATE FINAL LOCATION WITH HY-VEE PRIOR TO ROUGH-IN. REFER TO ZIE3.1.

① LIGHTING FLOOR PLAN - PART A
3/32" = 1'-0"

HENDERSON ENGINEERS
8345 LENEXA DRIVE, SUITE 300
LENEXA, KS 66214
TEL 913.742.5000 FAX 913.742.5001
WWW.HENDERSONENGINEERS.COM

PROFESSIONAL SEAL
STATE OF MISSOURI
VINCENT G. MASLIONS
NUMBER PE-200800670
EXPIRES 12/31/2021
05/20/2021
VINCENT G. MASLIONS
LICENSE # PE-200800670

LOCATION
LEE'S SUMMIT, MO #2
310 SW WARD RD
HY-VEE INC.
5820 WESTTOWN PARKWAY
WEST DES MOINES, IOWA 50266
TEL: (515) 267-2800
FAX: (515) 267-4838
EMPLOYEE OWNED

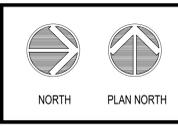

LIGHTING FLOOR PLAN - PART A

PROJECT MANAGER	CHECKED BY
SL	HEI
DRAWN BY:	DATE:
HENDERSON	10/19/2020
SCALE:	JOB NUMBER:
AS NOTED	62830547

SHEET:
E3.0A

MARKET GRILLE and CASUAL DINING LIGHTING FIXTURE SCHEDULE										UPDATED 12-13-19		(NOT ALL FIXTURES LISTED MAY APPLY TO THIS PROJECT)	
SYMBOL	MARK	TYPE	MANUFACTURER/MODEL #	LOCATION	VOLTAGE	DIMMER	MFR	NOTES					
TL	TAPELIGHT	TAPELIGHT	TUBE LIGHTING DSH-H24V-XX-4-108H-DR80-24V	BAR	120V	STYLE- LINE SWITCH		SEE INTERIOR ELEVATION OF BAR FOR TAPELIGHT LOCATIONS					
RC	RC	RECESSED CAN	1.6R02AN20VALR02084VALR020	OVERHEAD	120V	SR120ZTLUV	PHILIPS						
D1	D1	DRUM	CONTECH RLM82DR1	OVERHEAD	120V	SR1000VAWHITE		(2) 15 WATT LAMPS, MAX.					
D2	D2	DRUM	CONTECH RLM82DR1	OVERHEAD	120V	SR1000VAWHITE		(2) 15 WATT LAMPS, MAX.					
D3	D3	DRUM	CONTECH RLM82DR1	OVERHEAD	120V	SR1000VAWHITE		(2) 15 WATT LAMPS, MAX.					
D4	D4	DRUM	CONTECH RLM82DR1	OVERHEAD	120V	SR1000VAWHITE		(4) 15 WATT LAMPS, MAX.					
D4	D4	DRUM	CONTECH RLM82DR1	OVERHEAD	120V	SR1000VAWHITE		(4) 15 WATT LAMPS, MAX.					
B1	B1	SPOT LIGHT	CONTECH LIGHTING CTL 808V	OVERHEAD TRACK	120V	SR1000VAWHITE		VERIFY MOUNTING HEIGHTS					
F1	F1	FLOOD LIGHT	CONTECH LIGHTING CTL 808V	OVERHEAD TRACK	120V	SR1000VAWHITE		VERIFY MOUNTING HEIGHTS AND METHODS					
P	P	PENDANT	TECH LIGHTING 70MMX18 MIN SIGNAL PENDANT	TABLE LIGHTS	120V	SR1000VAWHITE		TECH LIGHTING					
CYL	CYL	CYLINDER	CONTECH CUL120MMX12-P4-CLR-S-CBK18-S	CYLINDER: PART AND EMERGENCY LIGHTING	120V	SR1000VAWHITE		VERIFY MOUNTING HEIGHT					
SUSP	SUSP	SUSPENDED LIGHTING (2 INDIVIDUAL RUNS)	TUBE LIGHTING, INC BPS-3073M-12-WVLED-FRSM-GD-BK-BLS	OVERHEAD AT BAR	120V			SUSPEND LIGHTING STRINGS BETWEEN CORNERS OF FRAMEWORK WITH 3/16" DIAMETER STAINLESS STEEL SUSPENSION CABLE. INSTALL MODEL T-1023-24-1 150W TRANSFORMER IN ACCESSIBLE LOCATION.					
RC4	RC4	RECESSED CAN	PHILIPS LIGHTOLIER LBR16AN20VALR1084VALR020	OVERHEAD	120V	SR120ZTLUV D-10 VOLT		150W LUMEN FIXTURE. PROVIDE DIMMER SWITCH					

REFER TO ENERGY MANAGEMENT CONSULTANTS (EMC) DRAWINGS AND SCHEDULES FOR COMPLETE LIST OF LIGHTING REQUIREMENTS INCLUDING LAMP SPECIFICATIONS, BALLASTS, AND MISCELLANEOUS COMPONENTS.

FOR THE RECESSED LIGHTING FIXTURES AND CYLINDER FIXTURES CONNECTED TO THE EMERGENCY LIGHTING PANEL, FURNISH AND INSTALL A PHILIPS BODINE GENERATOR TRANSFER DEVICE (GTD) TO POWER THE FIXTURE WHEN ENERGIZED FROM THE GENERATOR.

LIGHTING FIXTURE SCHEDULE									
SYMBOL	TYPE	EMC LABEL	MANUFACTURER/MODEL #	WATTS	VA	VOLTAGE	LOCATION	NOTES	
A8	# SALES LIGHTING FIXTURE - LED	GD8LD	GE L-15-18-B-A2-D9-P-45-V-Q-C8-WHITE	101		120	SALES LIGHTING	LED FIXTURE	
B8	# SALES LIGHTING FIXTURE	GD8	PHILIPS TR422-UNV-120-23- EB0B232PLUNVDRH4000-P218-WH-FA	146-27		120	SALES LIGHTING	OPEN CEILING E6HKH HANGERS, 78878001 1KA END CAPS	
B4	4' SALES LIGHTING FIXTURE	GD4	PHILIPS TR422-UNV-120-10- EB0B232PLUNVDRH4000-P218-WH-FA	70-14		120	SALES LIGHTING	OPEN CEILING E6HKH HANGERS, 78878001 1KA END CAPS	
C4	134 BACKROOM UTILITY FIXTURE	PG4	PHILIPS B232-120-10-EB-8232PLUNVDRH4000-P218-WH-FA	58	64	120	BACKROOMS		
CP	LED CANOPY LUMINAIRE	LFI	CRUS-SC-LED-SLV-30-UE-WHT	38	40	120	ADJ. CANOPY	VERIFY ACCESSORIES AND FINISH	
CYLW	CYLINDER	CONTECH	CYL120MMX12-P4-CLR-S-CBK18-S	21	23	120	FLORAL	VERIFY MOUNTING HEIGHT	
D1	2X4 LED FIXTURE	LED	PHILIPS ZFC04B-840-D-UNV-DM	44	48	120	SEE PLAN	LED FIXTURE (W/ 10' AFF)	
EM	WALL MOUNTED EMERGENCY LIGHT	LED ENT	PHILIPS ZFC04B-840-D-UNV-DM	44	48	120	SEE PLAN	LED FIXTURE	
F	2X2 LED FIXTURE	LED2	PHILIPS ZFC04B-840-D-UNV-DM	54	60	120	SEE PLAN	LED FIXTURE - BACK OF HOUSE	
D	2X4 LED FIXTURE - FLAT PANEL		PHILIPS 2 FFE 42B 840 4 DS UNV DM	38	42	120	SEE PLAN	LED FIXTURE - BACK OF HOUSE	
DL1	2' SQUARE RECESSED ADJUSTABLE DOWNLIGHT	TECH	E35-FF-LJ-930-4-A-010E35-F15-B-0-W	18	20	120	WINE ROOM	25 DEGREE BEAM SPREAD AIMED AT 7' AFF	
DL1A	2' SQUARE RECESSED ADJUSTABLE DOWNLIGHT	TECH	E35-FF-LJ-930-4-A-010E35-F15-B-0-W	18	20	120	WINE ROOM	45 DEGREE BEAM SPREAD AIMED AT 7' AFF	
FC	150W TEMP. FREEZER/COOLER FIXTURE	HO	KINGSBANK LDX-VT-D-4-24	47	52	120	COOLERS FREEZERS	LED FIXTURE. SEE DRAWING E5.0	
FL1	FLOOR MOUNT LINEAR GRAZING FIXTURE	COLORMETRICS	523-00095-411-108-00047-00120-000124-00	32	35	120	WINE ROOM	FLOOR MOUNT. COORDINATE INSTALLATION WITH ARCHITECTURAL DRAWINGS	
L	MIRROR LIGHT	RW	WAC LIGHTING WS-622F-30-AL	22	24	120	RESTROOMS	ABOVE MIRROR	
X	EXIT LIGHT	E	MCPHILLEN DB81 VERVEM	3.4	3.4	120	ALL AREAS		
RC	RECESSED CAN LIGHTING FIXTURE	LEDC	PHILIPS LBR20AN20VALR02084VALR020	22	24	120	DEPARTMENTS	LED FIXTURE	
RR	RESTROOM RECESSED CAN FIXTURE	RR	PHILIPS LBR20AN20VALR02084VALR020	22	24	120	MOTHERS ROOM RESTROOMS	LED FIXTURE	
PH	PHARMACY RECESSED CAN FIXTURE	LEDC	PHILIPS LBR16AN20VALR1084VALR020	22	24	120	PHARMACY	LED FIXTURE	
P2	PENDANT LIGHT FIXTURE AT MEAT CASES	P	DAYBRITE VP110C-RAB-C180-J-BX COVER L0700000-308-2209-120V	9.5	10	120	MEAT DEPT	INSTALL OVER CASES, E.C. TO PAINT COVER WITH GALVANIZED PAINT TO MATCH FIXTURE	
PT	PENDANT LIGHT FIXTURE - DSW & JOE FRESH	TECH LIGHTING	POWELL STREET PENDANT 120V/2700K/WW/LED88 LAVIT TRACK CONNECTOR	150	160	120	DSW & JOE FRESH CHECKOUT	SEE PLAN FOR TRACK LENGTHS	
HEAT	HEAT LAMPS (ABOVE ASIAN CASE)	HATCO	DL-700 (RADIANT RED)	250	275	120	ASIAN CASE	120V VOLT. MOUNT OVER CASE	
T1	BAKERY CASE WALL / SEAFOOD TRACK LIGHTING	LED	CONTECH CTL193 H-4-S LA-10-S LA-2-S	21	23	120	SEAFOOD	SEE PLAN FOR TRACK LENGTHS	
T2	DEPARTMENT TRACK LIGHTING	LED	CONTECH CTL193 H-4-S (SILVER)	35	38	120	DEPARTMENT TRACK LIGHTING	SEE PLAN FOR TRACK LENGTHS	
T3B	CANDY/CARDS TRACK LIGHTING	LED	CONTECH CTL193 H-4-S (BLACK TRACK) LA-10-S (STARTER)	21	23	120	DEPARTMENT TRACK LIGHTING	SEE PLAN FOR TRACK LENGTHS	
T3W	CANDY/CARDS TRACK LIGHTING	LED	CONTECH CTL193 H-4-S (WHITE TRACK) LA-10-WH (STARTER)	21	23	120	DEPARTMENT TRACK LIGHTING	LED	
T4	CANDY/CARDS TRACK LIGHTING	LED	BRUNNICK CUSTOM STEM FIXTURE CONTECH LA-117 CONNECTOR	60	60	120	DEPARTMENT	LED	
WP	EXTERIOR WALL FIXTURE	LED	W SIGNIFY LPW32-78WZ	71	74	120	EXTERIOR	LED	

REFER TO ENERGY MANAGEMENT CONSULTANTS (EMC) DRAWINGS AND SCHEDULES FOR COMPLETE LIST OF LIGHTING REQUIREMENTS INCLUDING LAMP SPECIFICATIONS, BALLASTS, AND MISCELLANEOUS COMPONENTS.


LIGHTING CONTROLS		(NOT ALL DEPARTMENTS LISTED MAY APPLY TO THIS PROJECT)	
AREA	CONTROLS		
MAIN SALES FLOOR	LIGHTING DIMMING PANEL		
WINE AND SPIRITS	LIGHTING DIMMING PANEL		
DINING AREAS and BAR	DIMMER SWITCHES (SEE SPECIFIC SCHEDULE AND DIAGRAMS FOR DIMMING CONTROLS)		
KITCHEN	WATTSSTOPPER DT-300 OCCUPANCY SENSORS WITH 82-50 POWER PACKS	PH100	05/20
ASIAN KITCHEN	WATTSSTOPPER DT-300 OCCUPANCY SENSORS WITH 82-50 POWER PACKS	PH100	05/20
BAKERY	WATTSSTOPPER DT-300 OCCUPANCY SENSORS WITH 82-50 POWER PACKS	PH100	05/20
MEAT DEPT	WATTSSTOPPER DT-300 OCCUPANCY SENSORS WITH 82-50 POWER PACKS	PH100	05/20
CHEESE ISLAND	WATTSSTOPPER DT-300 OCCUPANCY SENSORS WITH 82-50 POWER PACKS	PH100	05/20
PHARMACY	WATTSSTOPPER DT-300 OCCUPANCY SENSORS WITH 82-50 POWER PACKS	PH100	05/20
PHARMACY CONSULT. ROOM	WATTSSTOPPER DT-300 OCCUPANCY SENSORS WITH 82-50 POWER PACKS	PH100	05/20
DEPT HEADS OFFICE	WATTSSTOPPER DT-300 OCCUPANCY SENSORS WITH 82-50 POWER PACKS	PH100	05/20
ASSISTANT MANAGER OFFICE	WATTSSTOPPER DT-300 OCCUPANCY SENSORS WITH 82-50 POWER PACKS	PH100	05/20
EMPLOYEE LOUNGE	WATTSSTOPPER DT-300 OCCUPANCY SENSORS WITH 82-50 POWER PACKS	PH100	05/20
CASH ACCOUNTABILITY	WATTSSTOPPER DT-300 OCCUPANCY SENSORS WITH 82-50 POWER PACKS	PH100	05/20
PRODUCE PREP/PAK	WATTSSTOPPER DT-300 OCCUPANCY SENSORS WITH 82-50 POWER PACKS	PH100	05/20
SCAN ROOM OFFICE	WATTSSTOPPER DT-300 OCCUPANCY SENSORS WITH 82-50 POWER PACKS	PH100	05/20
ACCOUNTING OFFICE	WATTSSTOPPER DT-300 OCCUPANCY SENSORS WITH 82-50 POWER PACKS	PH100	05/20
COMMUNICATIONS CLOSET	WATTSSTOPPER DT-300 OCCUPANCY SENSORS WITH 82-50 POWER PACKS	PH100	05/20
WINE and SPIRITS STORAGE	WATTSSTOPPER DT-300 OCCUPANCY SENSORS WITH 82-50 POWER PACKS	PH100	05/20
CLINIC/EXAM ROOMS	WATTSSTOPPER DT-300 OCCUPANCY SENSORS WITH 82-50 POWER PACKS	PH100	05/20
HOME COOKING ROOM	WATTSSTOPPER DT-300 OCCUPANCY SENSORS WITH 82-50 POWER PACKS	PH100	05/20
HR OFFICE	WATTSSTOPPER PW-100 WALL SWITCH WITH INTEGRAL 82-50 POWER PACK	PH100	05/20
DEPT/AN OFFICE	WATTSSTOPPER PW-100 WALL SWITCH WITH INTEGRAL 82-50 POWER PACK	PH100	05/20
DIRECTORS OFFICE	WATTSSTOPPER PW-100 WALL SWITCH WITH INTEGRAL 82-50 POWER PACK	PH100	05/20
ACCOUNTING STORAGE	WATTSSTOPPER PW-100 WALL SWITCH WITH INTEGRAL 82-50 POWER PACK	PH100	05/20
JANITORS CLOSET	WATTSSTOPPER PW-100 WALL SWITCH WITH INTEGRAL 82-50 POWER PACK	PH100	05/20
MOTHERS ROOM	WATTSSTOPPER PW-100 WALL SWITCH WITH INTEGRAL 82-50 POWER PACK	PH100	05/20
PHARMACY STORAGE	WATTSSTOPPER PW-100 WALL SWITCH WITH INTEGRAL 82-50 POWER PACK	PH100	05/20
BACK STOREROOM/DOCK (W/ SKYLIGHTS)	WATTSSTOPPER LS-102 OCCUPANCY SENSORS WITH 82-50 POWER PACKS	PH100	05/20
INDIVIDUAL RESTROOMS	WATTSSTOPPER C-200-1 CEILING MOUNTED OCCUPANCY SENSOR (EACH RESTROOM OR HALL) WITH 82-50 POWER PACK AND OCCUPANCY WALL CONTROL	PH100	05/20
FREEZERS and COOLERS (W/ BEER COOLER)	WATTSSTOPPER CB-100 OCCUPANCY SENSORS WITH 82-50 POWER PACKS (VERIFY LOCATION OF 82-50 POWER PACK. INSIDE OR OUTSIDE OF FREEZER/COOLER)	PH100	05/20
BEER COOLER	STYLE LINE WALL SWITCH		
WINE TASTING ROOM	STYLE LINE WALL SWITCH		
FRONT ELECTRIC ROOM	STYLE LINE WALL SWITCH		
VESTIBULES	NO CONTROLS (TO BE SWITCHED BY PANELBOARD BREAKER)		
DEPT HEADER TRACK LIGHTS	NO CONTROLS (TO BE SWITCHED BY PANELBOARD BREAKER)		
CONSULTANTS			

1. COORDINATE ALL LIGHTING CONTROLS WITH DRAWINGS PREPARED BY ENERGY MANAGEMENT CONSULTANTS.


2. ANY AREA NOT LISTED ABOVE SHALL BE CONTROLLED BY A STYLE LINE WALL SWITCH.



2 'MARKET GRILLE' LIGHTING SWITCH LAYOUT
E3.1 SCALE: NONE

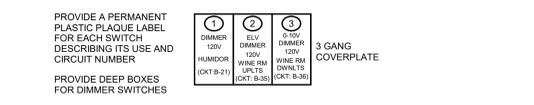

3 'WINE & SPIRITS' LIGHTING SWITCH LAYOUT
E3.1 SCALE: NONE

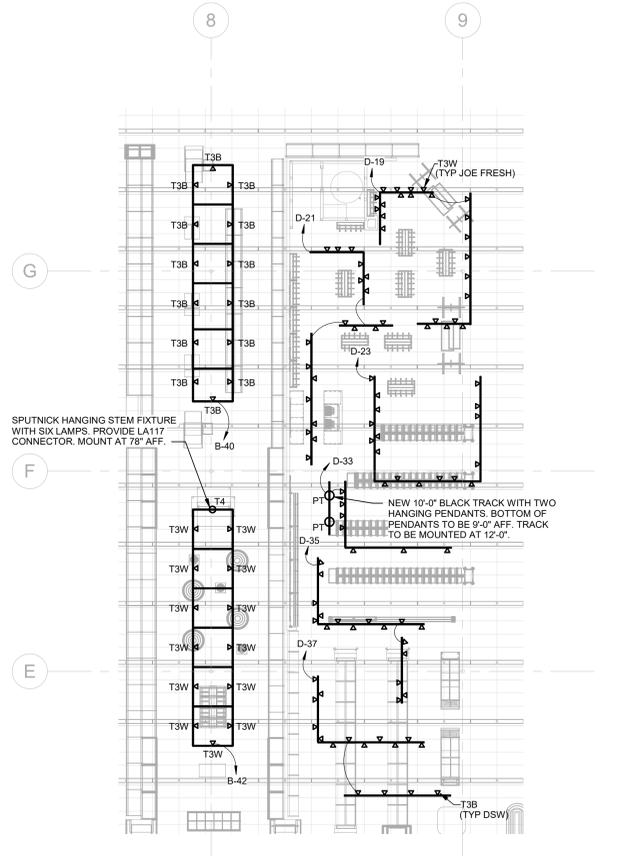

1 LIGHTING FLOOR PLAN - GREETING
CARDS/CANDY/JOE FRESH/DSW
3/32" = 1'-0"

REVISION

2	ASR	01/07/21
6	ASR	03/16/21
7	ASR	04/16/21
8	ASR	05/20/21

HENDERSON ENGINEERS
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1950003081
MO. CORPORATE NO. E-5560
EXPRESS 12/31/2021

PROFESSIONAL SEAL
STATE OF MISSOURI
VINCENT G. MASLIONS
NUMBER PE-2008006970
EXPIRES 12/31/2021

05/20/2021
VINCENT G. MASLIONS
LICENSE # PE-2008006970

LEE'S SUMMIT, MO #2
310 SW WARD RD
HY-VEE, INC.
5820 WESTTOWN PARKWAY
WEST DES MOINES, IOWA 50386
TEL 515.281.2600 FAX 515.267-2600

Hy-Vee
EMPLOYEE OWNED


LIGHTING SCHEDULES AND DETAILS

PROJECT MANAGER SL	CHECKED BY HEI
DRAWN BY HENDERSON	DATE 10/19/2020
SCALE AS NOTED	JOB NUMBER 62830547

SHEET: **E3.1**

ELECTRICAL DEMO PLAN NOTES

- 1 MAIN REMODEL AREA ALL EQUIPMENT TO BE REMOVED OR DEMOLISHED IN THIS AREA AS INDICATED. COORDINATE REMODEL WITH CONSTRUCTION PHASE AND NEW LIGHTING/POWER PLANS FOR WORK.
- 2 EXISTING ROOMSPACE TO REMAIN. COORDINATE REMODEL WORK WITH CONSTRUCTION PHASE AND OVERALL PLAN FOR REMODEL OF STORE.
- 3 REMOVE ALL EXISTING SALES FLOOR PERIMETER LIGHTING. PROTECT AND STORE LIGHT FIXTURES FOR REUSE DURING REMODEL.
- 4 REVISE AND EXTEND CIRCUITRY FOR RELOCATED/REPLACED EQUIPMENT. COORDINATE EXACT CONDUIT ROUTING WITH TENANT AND OTHER TRADES. EXISTING DEVICES AND RELATED CIRCUITRY MAY BE REUSED IF IN GOOD CONDITION, OTHERWISE REPLACE.
- 5 DEMOLISH CIRCUITRY FOR RELOCATED/REPLACED EQUIPMENT.

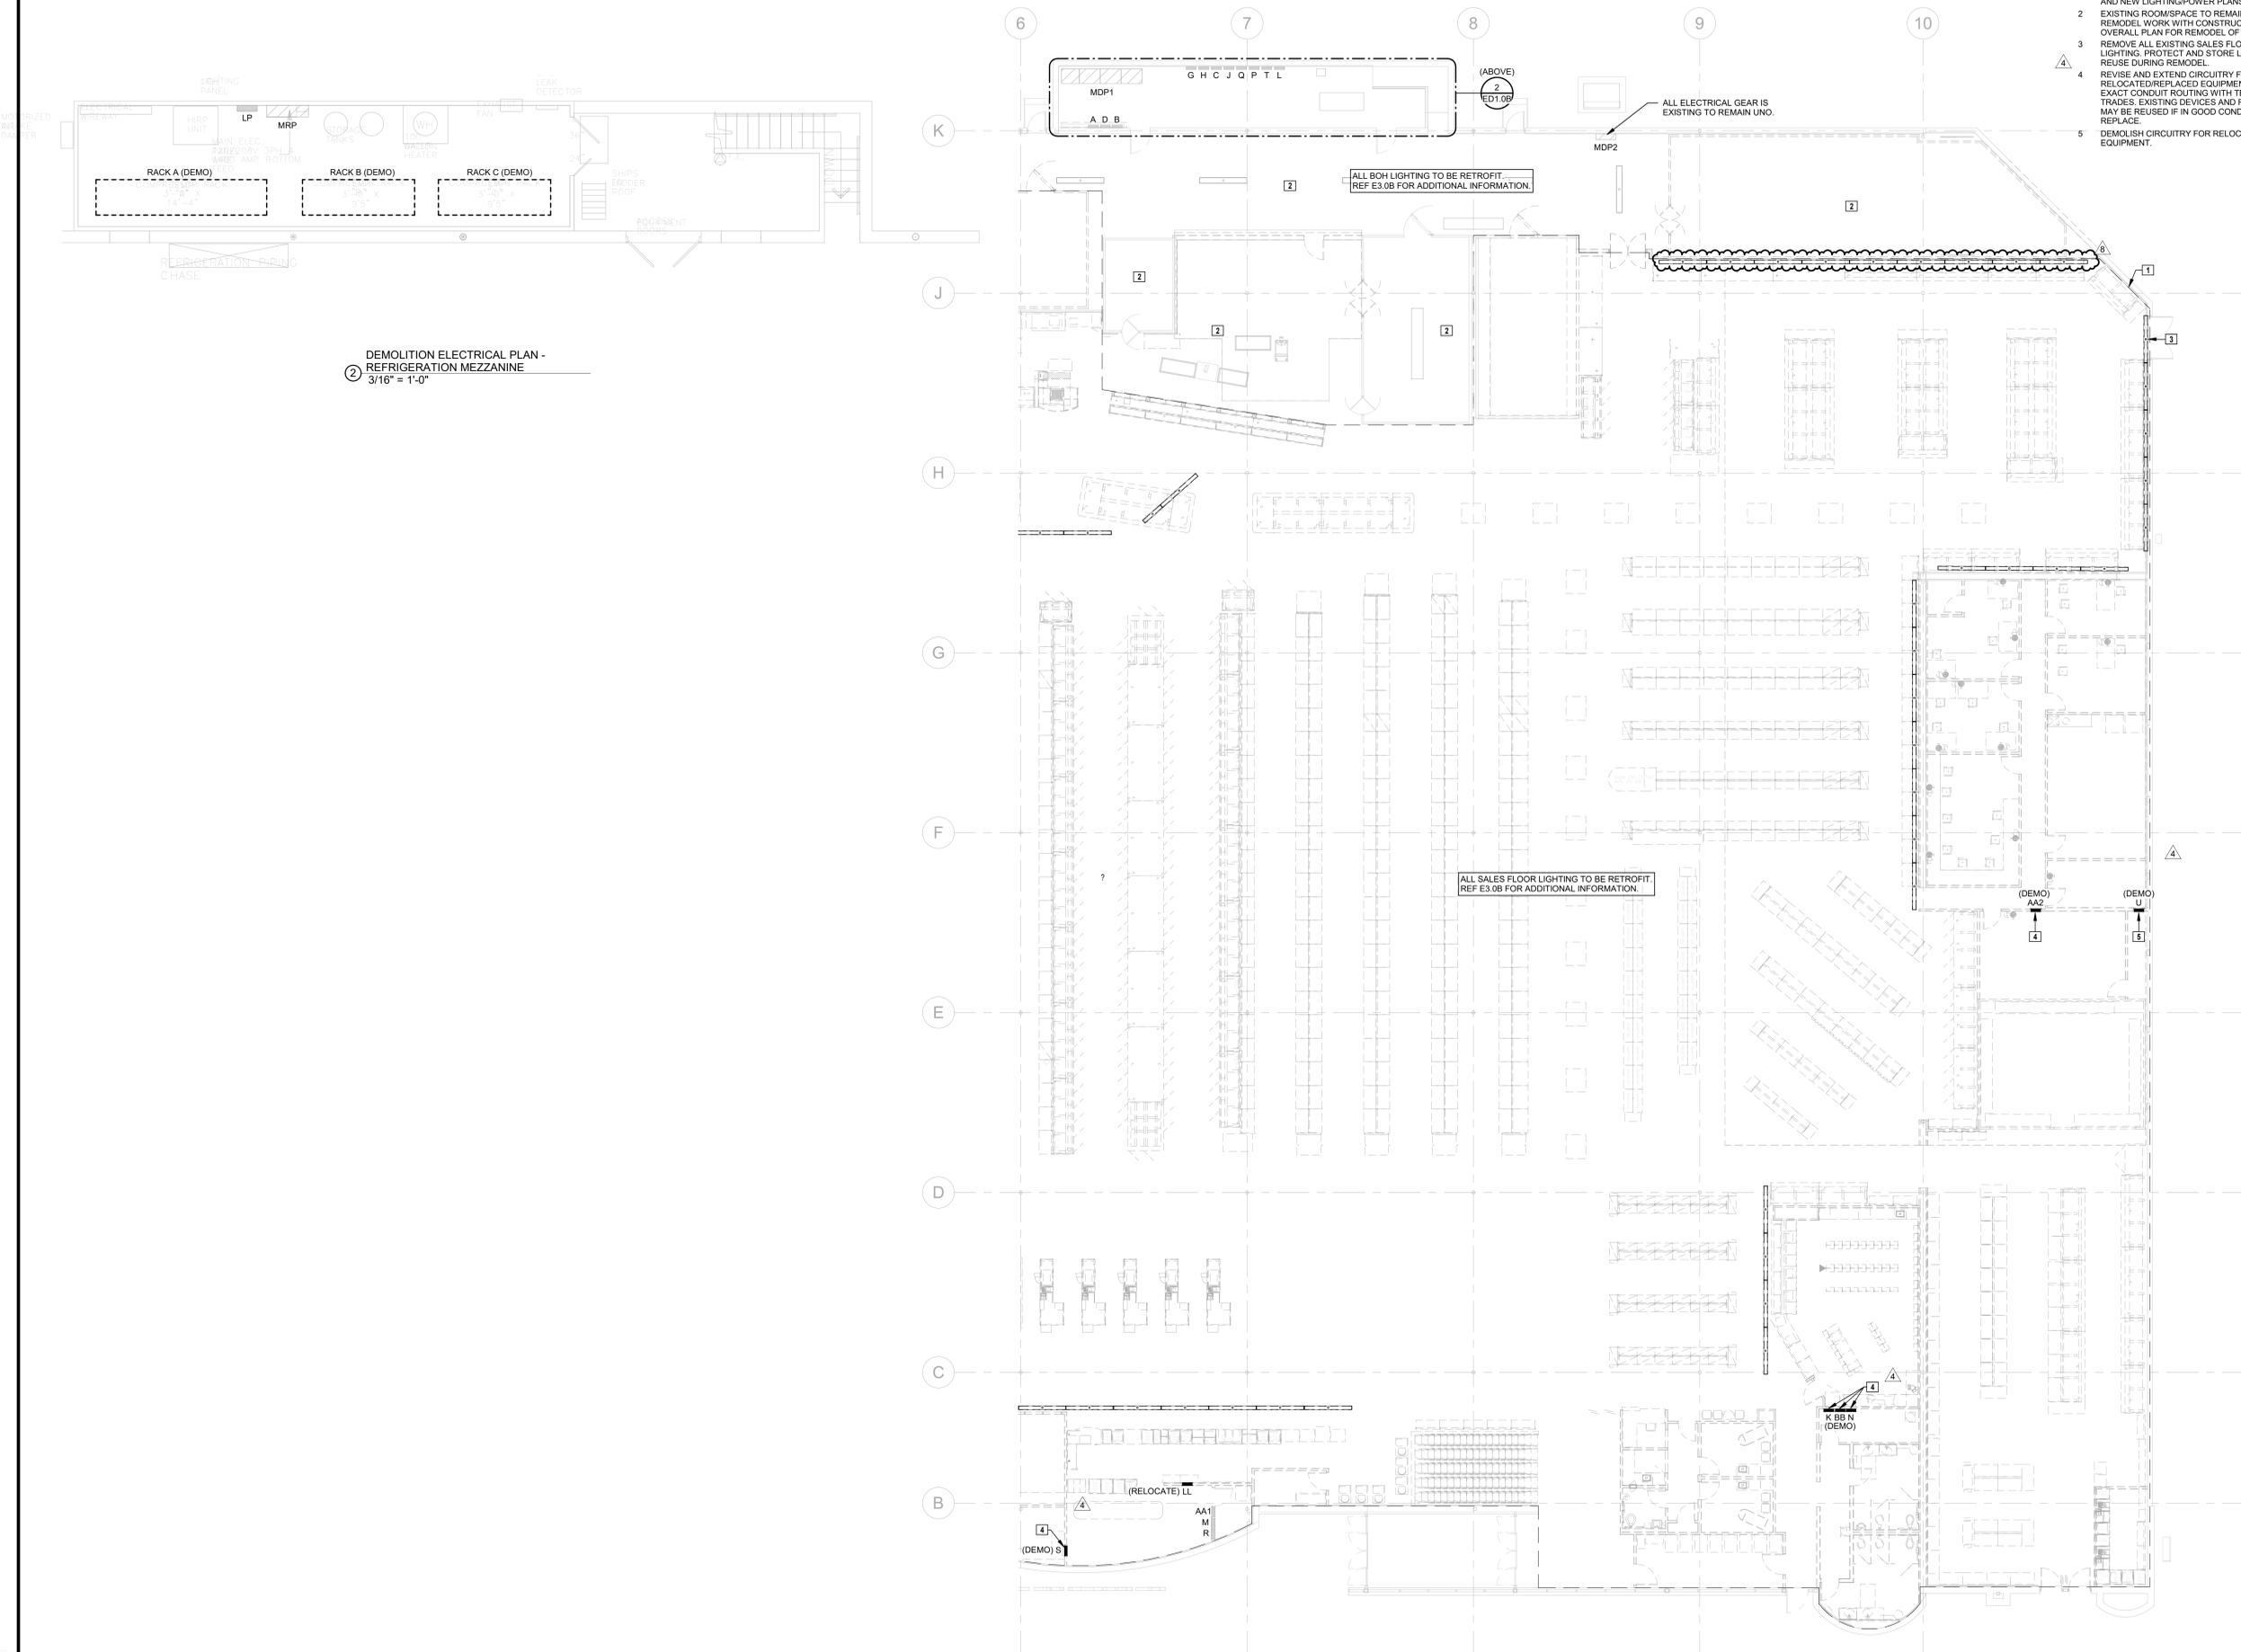


DEMOLITION ELECTRICAL PLAN - REFRIGERATION MEZZANINE
3/16" = 1'-0"

1 ELECTRICAL DEMOLITION PLAN PART B
3/32" = 1'-0"

HENDERSON ENGINEERS
 8345 LENEKA DRIVE, SUITE 300
 LENEKA, KS 66214
 TEL 913.742.5000 FAX 913.742.5001
 WWW.HENDERSONENGINEERS.COM

PROFESSIONAL SEAL
 STATE OF MISSOURI
 VINCENT G. MASILIONIS
 NUMBER PE-2008009670
 EXPIRES 12/31/2021
 05/20/2021
 VINCENT G. MASILIONIS
 LICENSE # PE-2008009670

LOCATION
LEE'S SUMMIT, MO #2
 310 SW WARD RD
 HY-VEE, INC.
 5820 WESTOWN PARKWAY
 WEST DES MOINES, IOWA 50386
 TEL: (515) 267-2800
 FAX: (515) 267-2835
HyVee
 EMPLOYEE OWNED

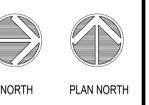

ELECTRICAL DEMOLITION PLAN - PART B

PROJECT MANAGER SL	CHECKED BY HEI
DRAWN BY HENDERSON	DATE 10/19/2020
SCALE AS NOTED	JOB NUMBER 62830547

SHEET: **ED1.0B**

COMMUNICATIONS PLAN NOTES:


1. REFER TO E2.0 SHEETS FOR CIRCUIT AND ADDITIONAL INFORMATION.
2. 2" CONDUIT WITH FULWIRE FOR OWNER FURNISHED REMOTE READER, COORDINATE LOCATION WITH OWNER.
3. 2" CONDUIT WITH FULWIRE TO TOWER PROCESSOR FOR COMMUNICATIONS CABLE.
4. CUSTOMER SERVICE CONDUIT STUB UP LOCATION. ALL CONDUITS ROUTED TO THIS LOCATION AND BRANCH CIRCUITS, TELEPHONE AND NCR CABLES TO BE ROUTED IN CASEWORK AS REQUIRED. VERIFY NUMBER AND SIZE OF CONDUITS.
5. 1" CONDUIT WITH FULWIRE FOR COMPUTER LOOP AND CABLE T.V. ROUTE CONDUIT TO ABOVE CEILING.
6. PROVIDE 4" CONDUIT FOR TELEPHONE SERVICE AND 2" CONDUIT FOR CABLE TV OUT TO 5' BEYOND BUILDING LINE.
7. PULL ONE CAT6 CABLE FOR EACH CASH REGISTER, ONE CAT6 CABLE FOR EACH CATALINA PRINTER, ONE CAT6 CABLE FOR EACH LANE HAWK AND ONE CAT6 CABLE FOR EACH TELEPHONE.

- NOTES:
1. ALL EXPOSED WIRING TO BE IN 1" CONDUIT UNLESS OTHERWISE NOTED.
 2. PULLSTRUNG REQUIRED IN ALL UNDERGROUND CONDUIT.
 3. ALL UNDERGROUND CONDUIT TO HAVE WATER REMOVED BEFORE CABLING CONTRACTOR WORK BEGINS.

COMMUNICATIONS PLAN SYMBOLS:

- ▼ TELEPHONE DATA OUTLET - CAT6
- ▽ TELEPHONE OUTLET - CAT6
- ▽ COMPUTER DATA OUTLET - CAT6
- ▽ CATALINA DATA OUTLET - CAT6
- ⊗ REGISTER DATA OUTLET - CAT6
- ⊕ JUNCTION BOX
- AP WIRELESS AP - CAT6 CABLE TO TELEPHONE CLOSET
- PS POINT OF SALE - (2) DATA REQUIRED
- PK PRINTER - (2) DATA REQUIRED - BOX @ +7'2"
- MD MOTION DETECTOR


REVISION	DATE	BY
RSJ #2 - UPDATE WASG COUNTER LOCATION	1/8/21	RSJ
ASJ #4 - UPDATE COMM ROOM LOCATION AND COAX NOTE. ADD CONDUIT FOR DGM WALL	2/2/21	RSJ
ASJ #7 - RELOCATE ADJ. ROOM, UPDATE CUSTOMER SERVICE AREA, UPDATE CASH REGISTER AREA.	4/21/21	RSJ
RSJ #8 - RELOCATE DGM, BEAUTY, JOE FRESH	7/19/21	RSJ

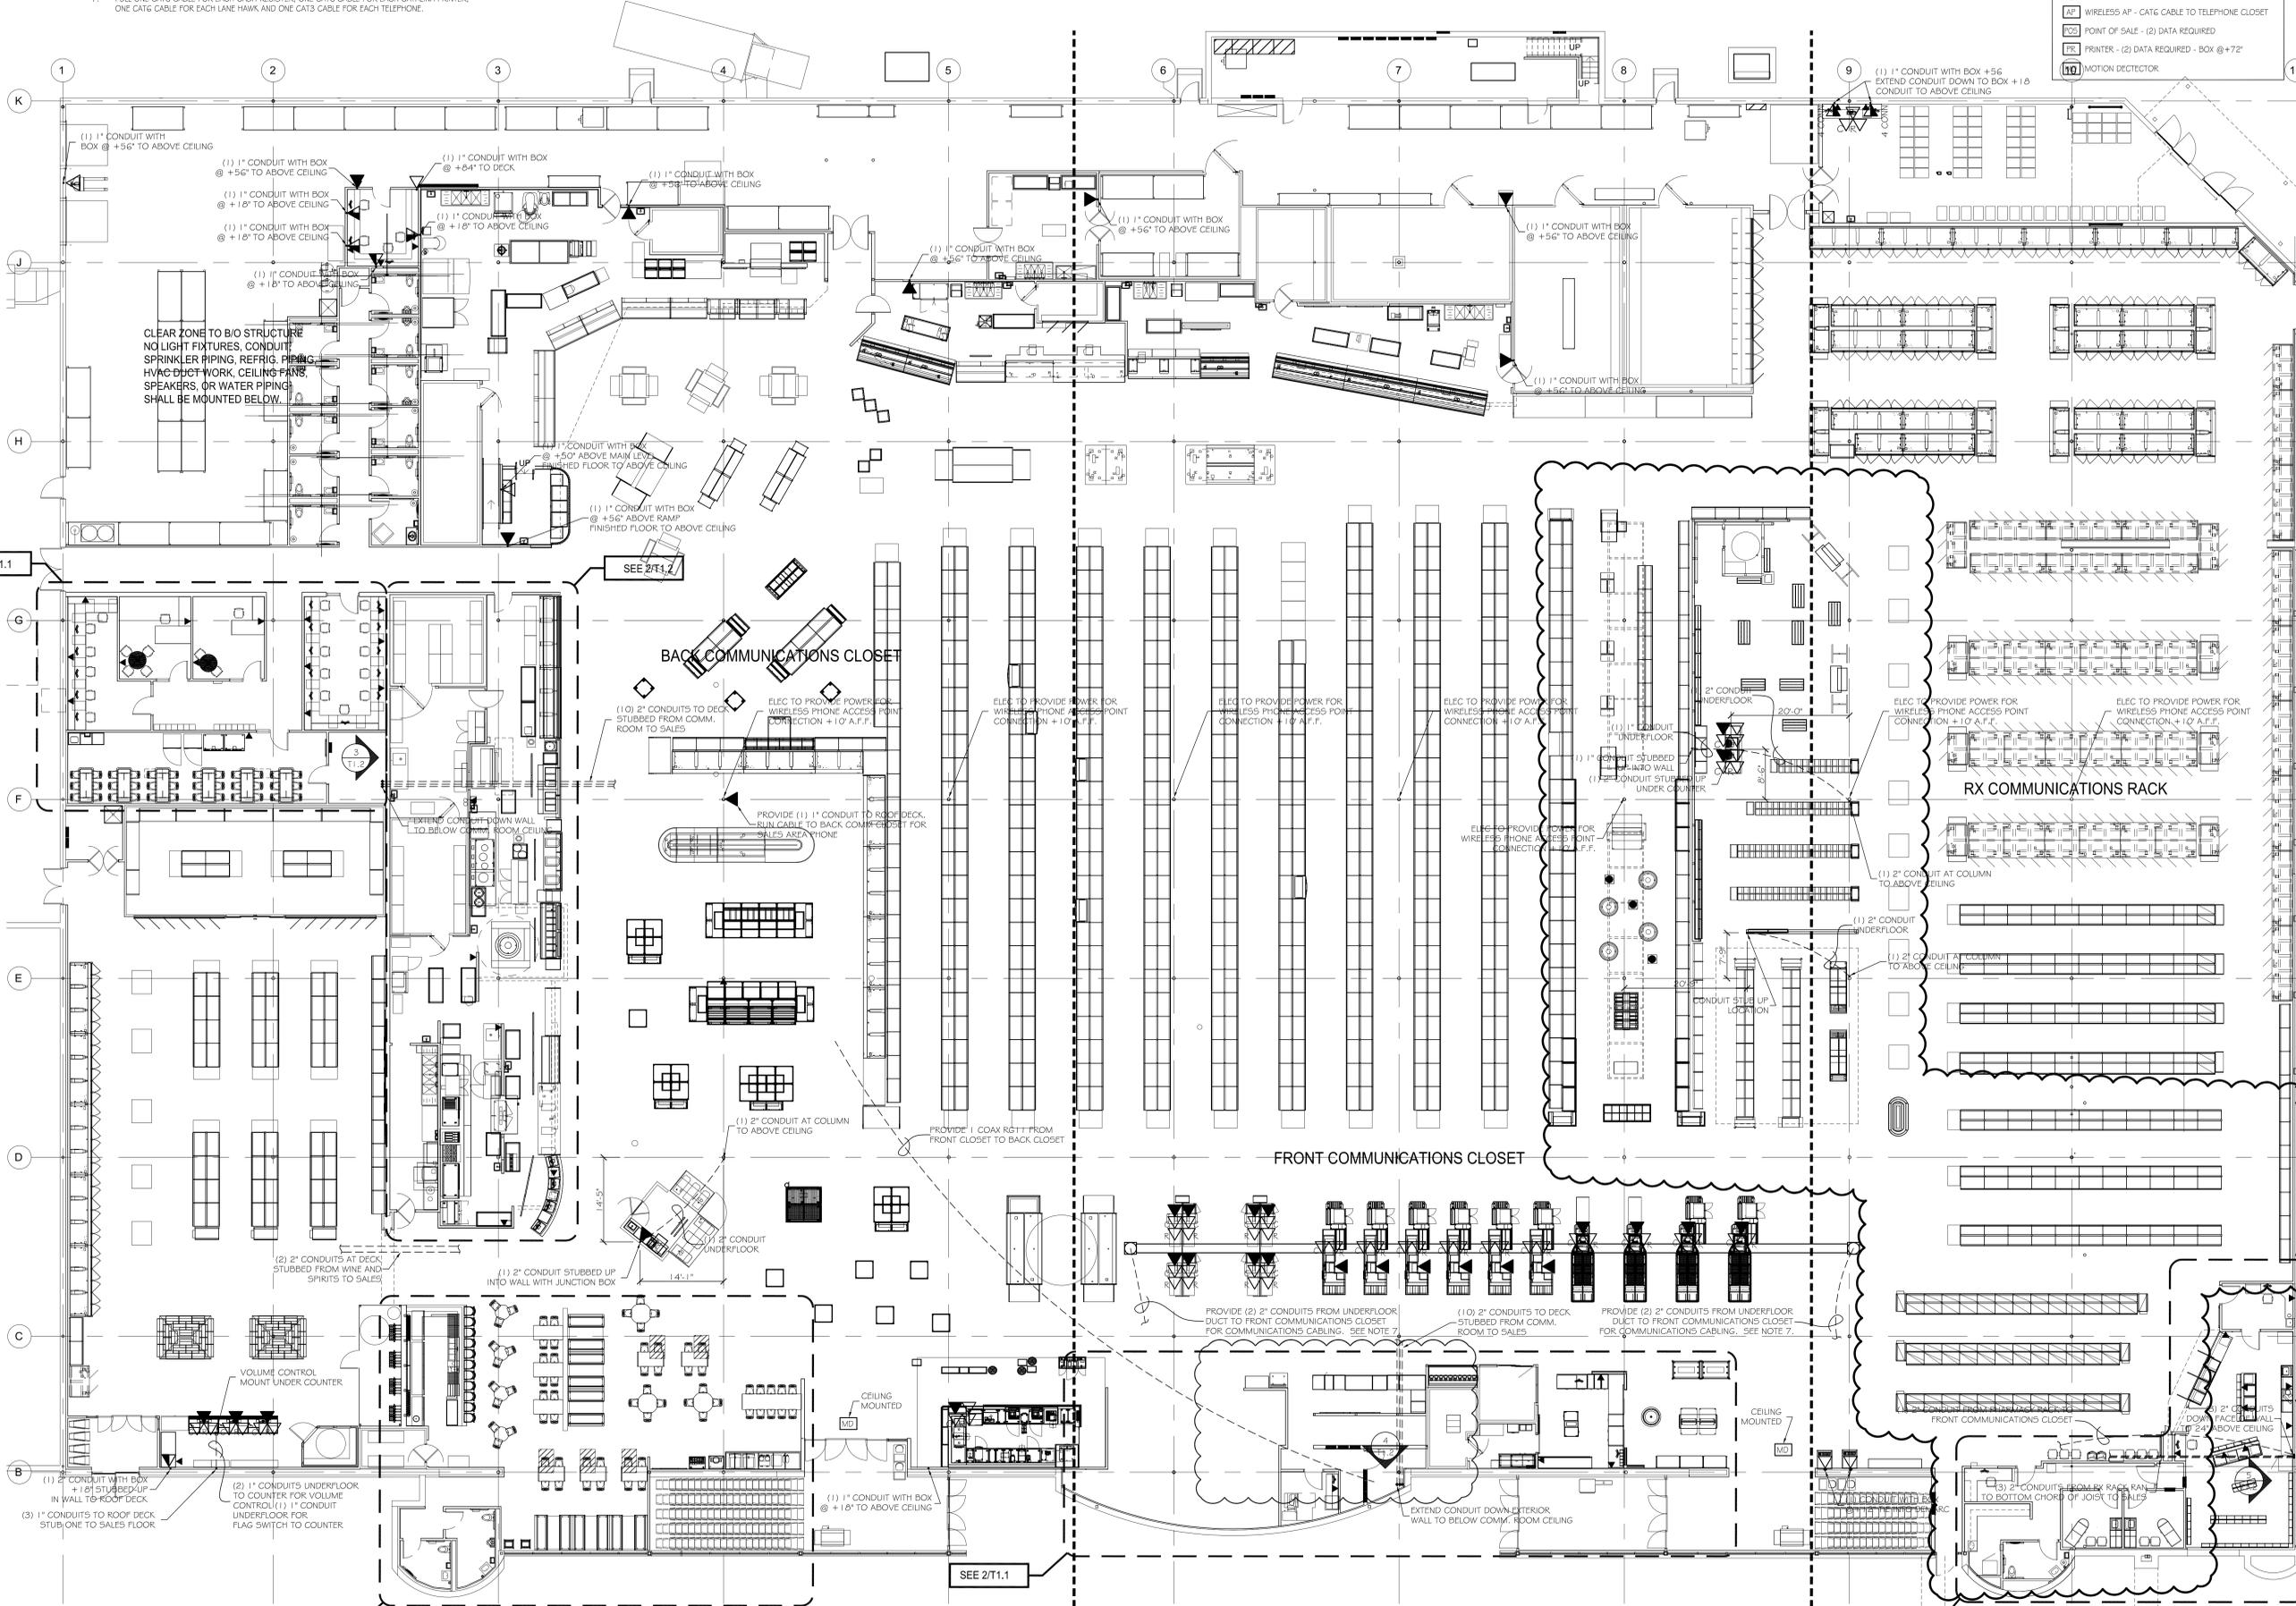

LOCATION: LEES SUMMIT #2, MO

HY-VEE INC.
5820 WESTOWN PARKWAY
WEST DES MOINES, IOWA 50266
TEL: (515) 281-2800
FAX: (515) 281-2835

Hy-Vee
EMPLOYEE OWNED

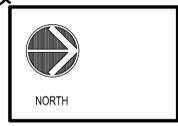

COMMUNICATIONS PLAN

DATE: OCT 2020
SCALE: 3/32" = 1'-0"
JOB NUMBER:

T1.0

1 COMMUNICATIONS PLAN
SCALE: 3/32" = 1'-0"


ELECTRONIC VIDEO BOARD SCHEDULE			
LOCATION	QUANTITY AND SIZE	HEIGHT	MOUNTING
DSW	(1) 49" MONITOR	VARIES	WALL
DSW	(1) 49" MONITOR	VARIES	WALL
ELECTRONIC VIDEO BOARD SCHEDULE			
LOCATION	QUANTITY AND SIZE	HEIGHT	MOUNTING
SUSHI	(2) 49" MONITORS	BO MONITOR +6'-0"	POLE
MARKET GRILLE EXPRESS	(3) 49" MONITORS	BO MONITOR +6'-0"	POLE
HICKORY HOUSE	(4) 49" MONITORS	BO MONITOR +6'-0"	POLE
HIBACHI	(2) 49" MONITORS	BO MONITOR +6'-0"	POLE
ASIAN	(2) 49" MONITORS	BO MONITOR +6'-0"	POLE
MIA PIZZA	(2) 49" MONITORS	BO MONITOR +6'-0"	POLE
BAKERY BRAD	(2) 55" MONITORS	BO MONITOR +6'-0"	WALL - BOX +8'-0"
MEAT	(2) 55" MONITORS	BO MONITOR +9'-0"	WALL - BOX +8'-0"
SEAFOOD	(1) 65" MONITOR	BO MONITOR +6'-0"	WALL - BOX +9'-0"
GRITTING CORDS	(1) 49" MONITOR	VARIES	WALL
BEAUTY	(1) 50" MONITOR	VARIES	WALL
CUSTOMER SERVICE	(2) 65" MONITOR	BO MONITOR +4'-7"	WALL - BOX +6'-4"
APPAREL	(1) 42" MONITOR	BO MONITOR +6'-2"	WALL - BOX +9'-2"

TELEVISION SCHEDULE			
LOCATION	SIZE	HEIGHT	MOUNTING
TV1	55" MONITOR	BO MONITOR +7'-3"	WALL MOUNT - BOX +9'-3"
TV2	55" MONITOR	BO MONITOR +7'-3"	WALL MOUNT - BOX +9'-3"
TV3	55" MONITOR	BO MONITOR +7'-3"	WALL MOUNT - BOX +9'-3"
TV4	55" MONITOR	BO MONITOR +7'-3"	WALL MOUNT - BOX +9'-3"
TV5	NOT USED		
TV6	NOT USED		
TV7	NOT USED		
TV8	55" MONITOR	BO MONITOR +4'-0"	WALL MOUNT - BOX +6'-0"
TV9	32" MONITOR	BO MONITOR +4'-0"	WALL MOUNT - BOX +5'-11"

- AUDIO-VIDEO PLAN SYMBOLS:**
- Ⓧ DINING AND GRILLE
TV - (1) COAX CABLE
(1) CAT 6
 - Ⓧ MOTHERS ROOM AND BREAK ROOM
TV - (1) COAX
 - Ⓧ TRAINING ROOM
TV - (1) COAX CABLE
(2) CAT 6
(1) 1/2" SHIELD
 - Ⓧ MENU BOARD
VIDEO MONITOR - (2) CAT 6
AV TOUCH PANEL - (1) CAT 6
MOUNT AT +56" TO CENTER

REVISION		DATE
ASG #1 - UPDATE BAR TV'S AND SCHEDULE		1/2/21
ASG #2 - RELOCATE ASL FROM UPDATE CUSTOMER SERVICE AREA, REMOVE SEASONS FROM UPDATE OCCUPANCY STUDY		10/2/20
ASG #3 - RELOCATE TV'S FROM UPDATE CUSTOMER SERVICE AREA		10/2/20
ASG #4 - RELOCATE TV'S FROM UPDATE CUSTOMER SERVICE AREA		10/2/20
ASG #5 - RELOCATE TV'S FROM UPDATE CUSTOMER SERVICE AREA		10/2/20
ASG #6 - RELOCATE TV'S FROM UPDATE CUSTOMER SERVICE AREA		10/2/20
ASG #7 - RELOCATE TV'S FROM UPDATE CUSTOMER SERVICE AREA		10/2/20
ASG #8 - RELOCATE TV'S FROM UPDATE CUSTOMER SERVICE AREA		10/2/20
ASG #9 - RELOCATE TV'S FROM UPDATE CUSTOMER SERVICE AREA		10/2/20
ASG #10 - RELOCATE TV'S FROM UPDATE CUSTOMER SERVICE AREA		10/2/20
ASG #11 - RELOCATE TV'S FROM UPDATE CUSTOMER SERVICE AREA		10/2/20
ASG #12 - RELOCATE TV'S FROM UPDATE CUSTOMER SERVICE AREA		10/2/20
ASG #13 - RELOCATE TV'S FROM UPDATE CUSTOMER SERVICE AREA		10/2/20
ASG #14 - RELOCATE TV'S FROM UPDATE CUSTOMER SERVICE AREA		10/2/20
ASG #15 - RELOCATE TV'S FROM UPDATE CUSTOMER SERVICE AREA		10/2/20
ASG #16 - RELOCATE TV'S FROM UPDATE CUSTOMER SERVICE AREA		10/2/20
ASG #17 - RELOCATE TV'S FROM UPDATE CUSTOMER SERVICE AREA		10/2/20
ASG #18 - RELOCATE TV'S FROM UPDATE CUSTOMER SERVICE AREA		10/2/20
ASG #19 - RELOCATE TV'S FROM UPDATE CUSTOMER SERVICE AREA		10/2/20
ASG #20 - RELOCATE TV'S FROM UPDATE CUSTOMER SERVICE AREA		10/2/20

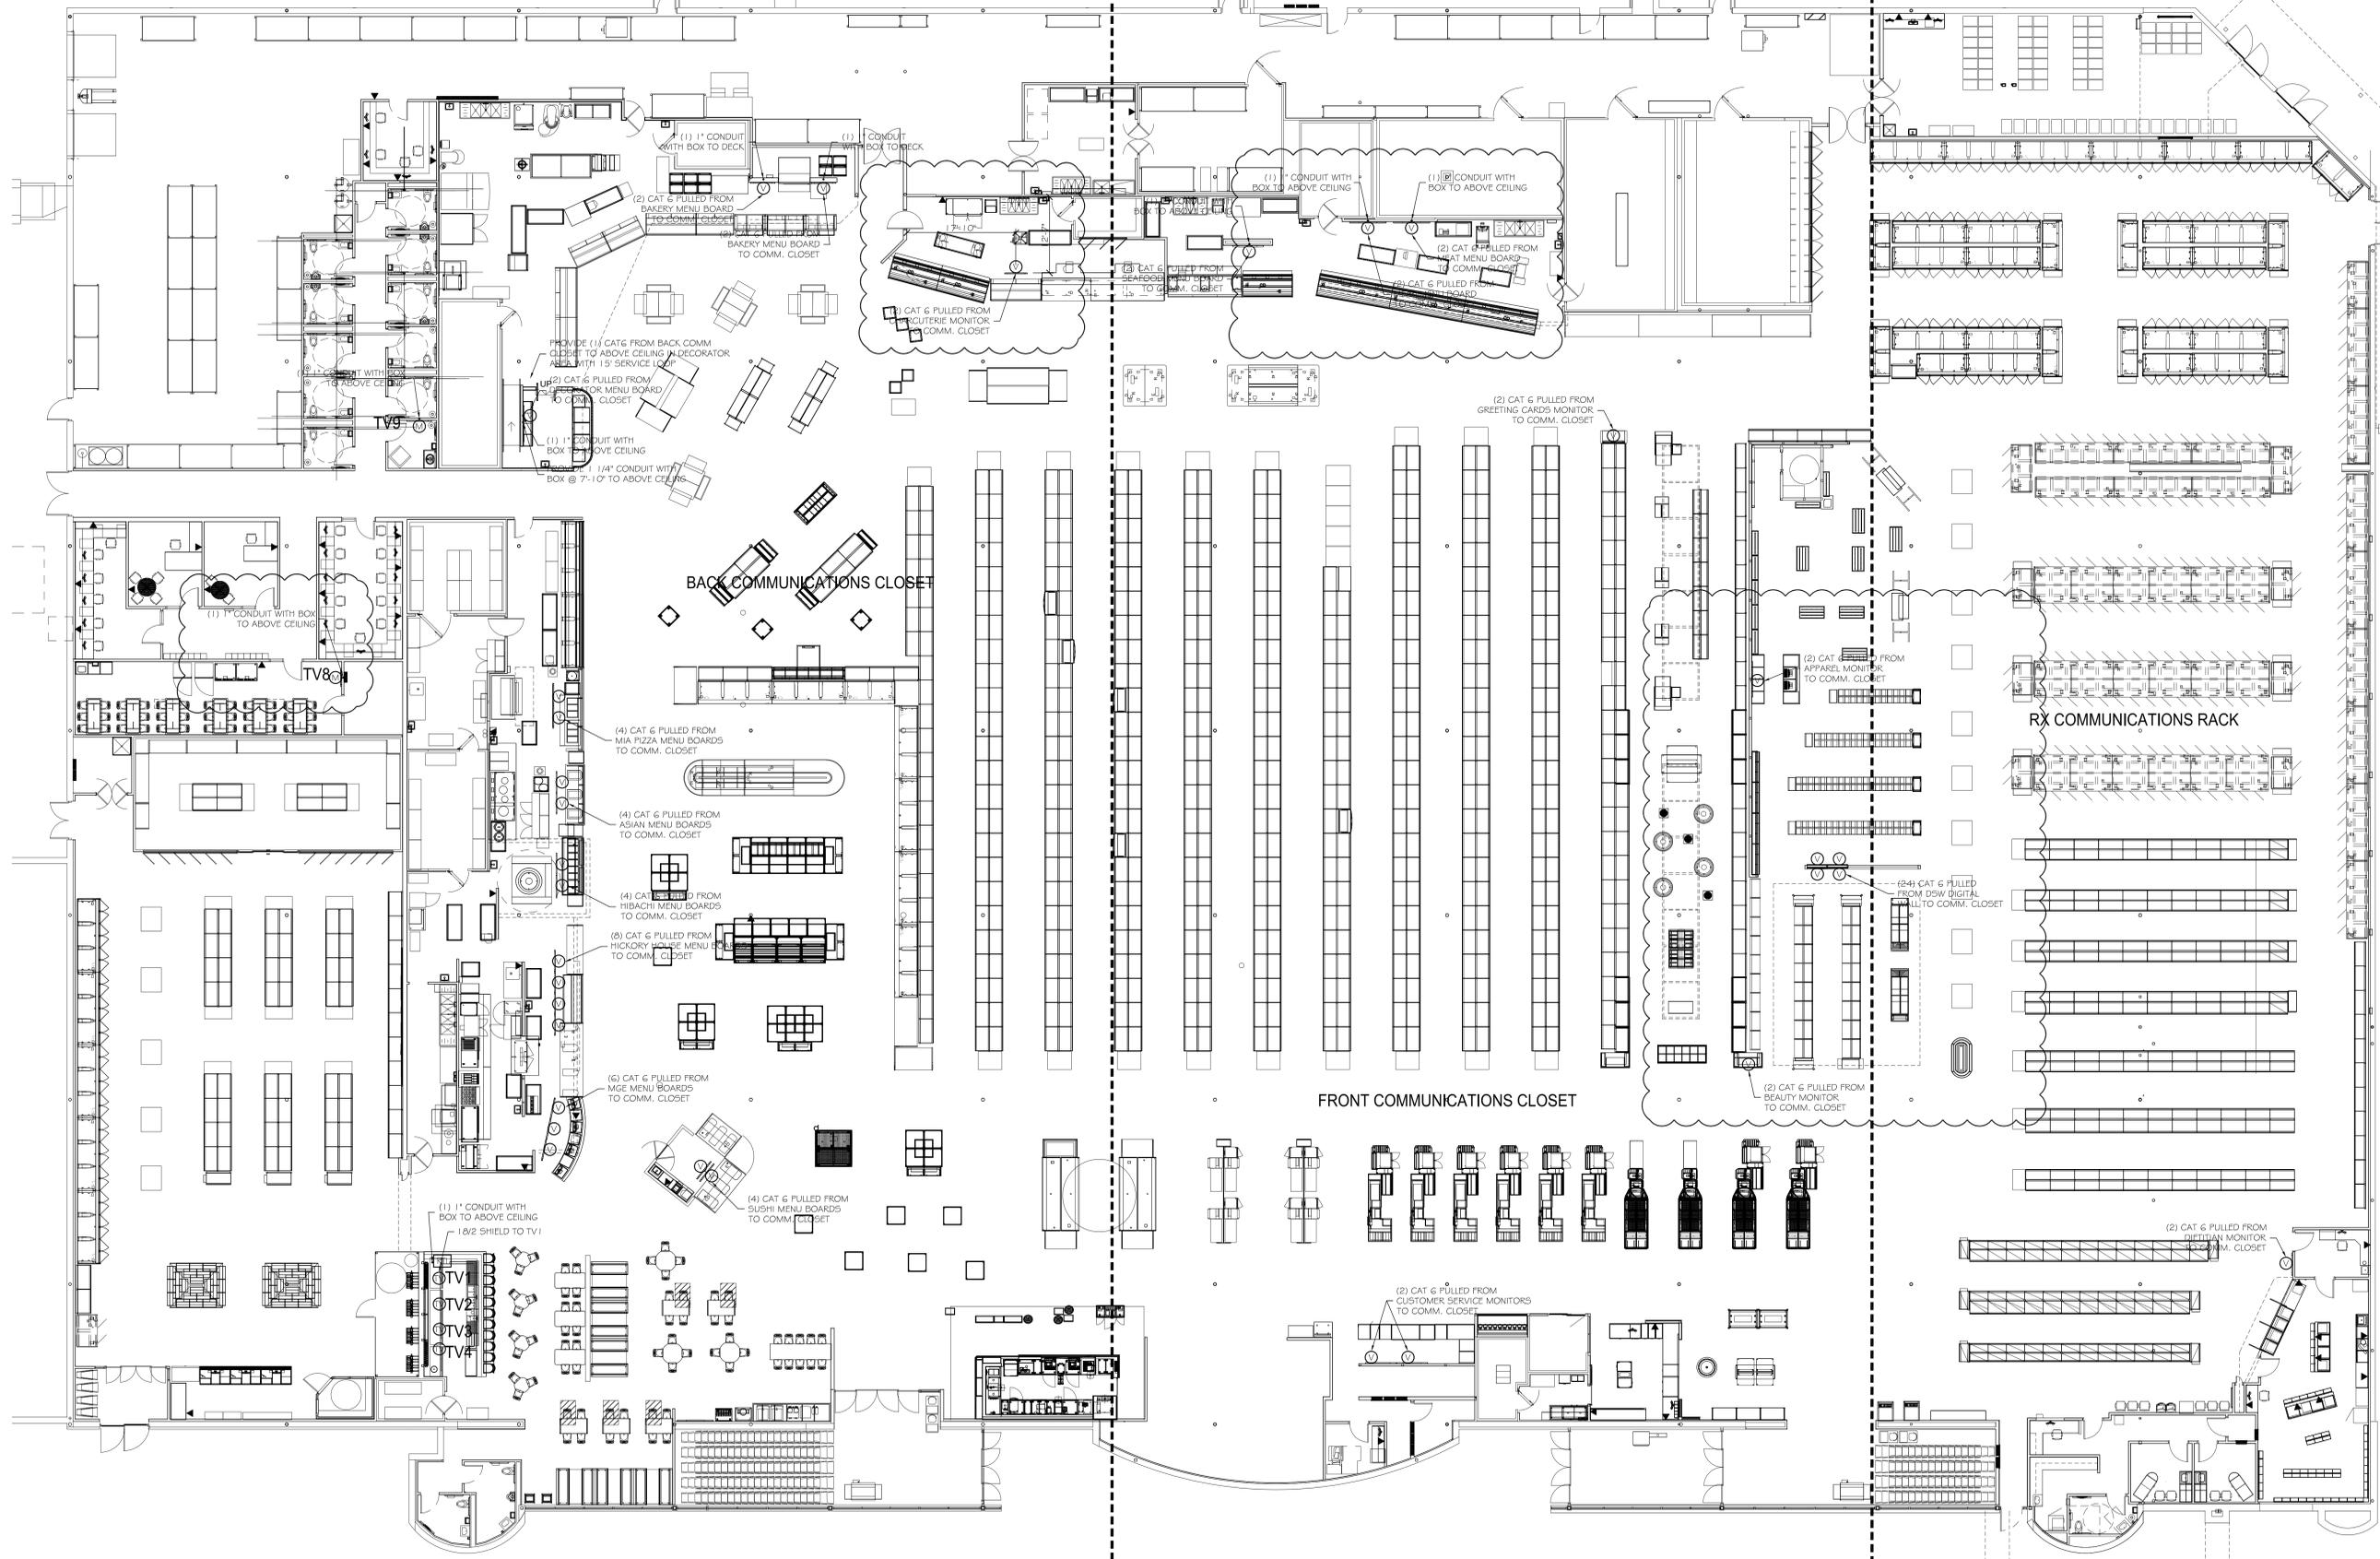

1 AUDIO/VIDEO PLAN
SCALE: 3/32" = 1'-0"

LOCATION: LEES SUMMIT #2, MO

HY-VEE INC.
5820 WESTTOWN PARKWAY
WEST DES MOINES, IOWA 50266
TELEPHONE: (515) 287-2800
FAX: (515) 287-2835

Hy-Vee
EMPLOYEE OWNED

NORTH

AUDIO/VIDEO PLAN

DATE: OCT 2020
JOB NUMBER:
SCALE: 3/32" = 1'-0"
SHEET:

T3.0