


LEE'S SUMMIT MO

TENANT INTERIOR BUILD OUT

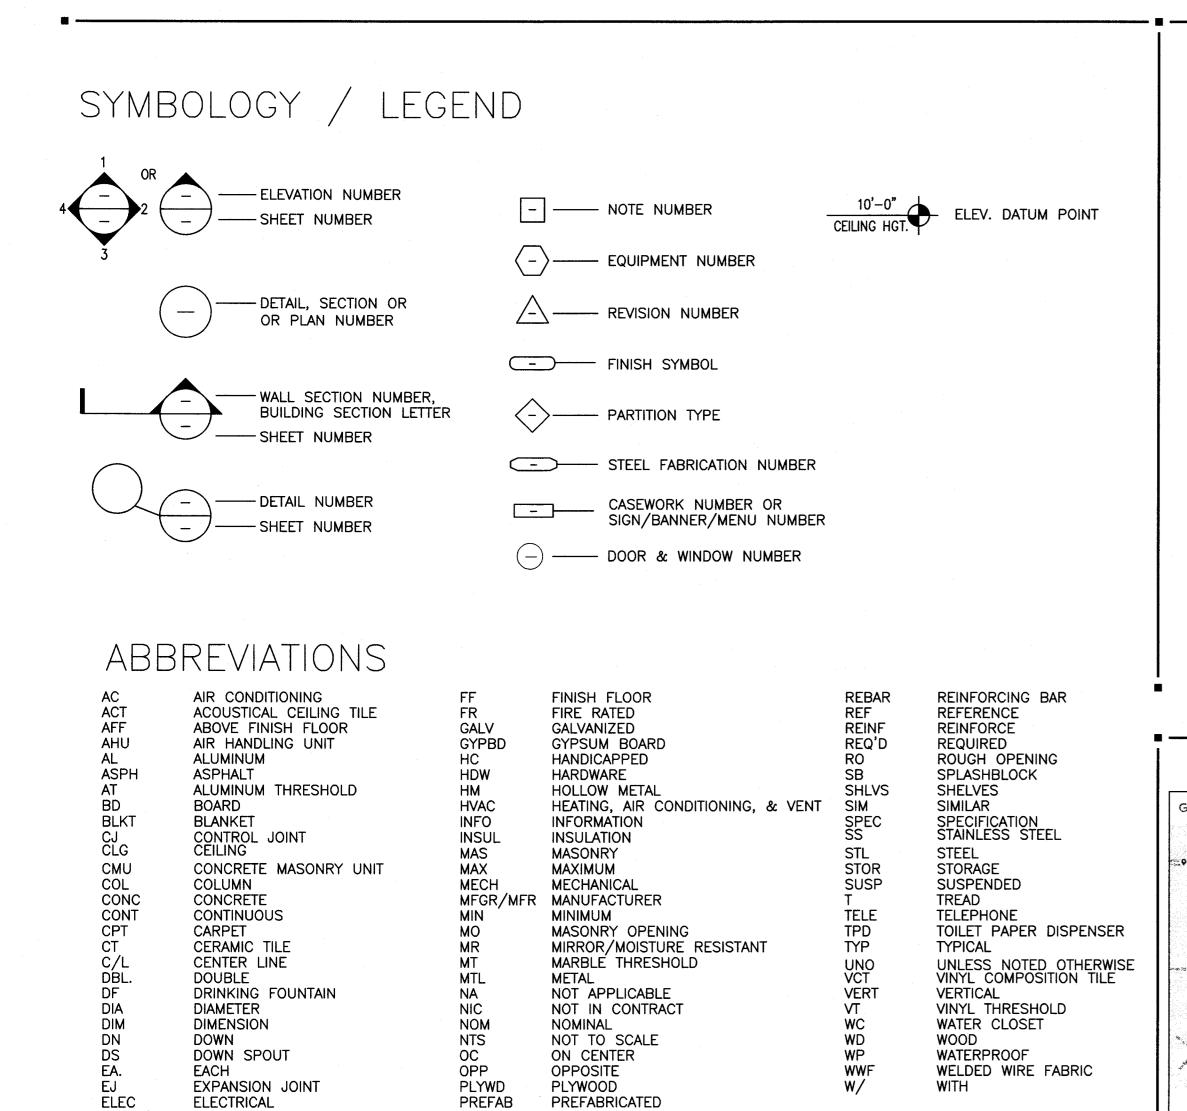

POUNDS PER SQUARE FOOT PAINT / PRESSURE TREATED

QUARRY TILE

RISER/RADIUS

ELEV./E

EXIST

ELEVATION

EQUAL

EXISTING

FLOOR DRAIN

FIRE EXTINGUISHER

CONTACTS:

PETLAND INC.

250 RIVERSIDE STREET CHILLICOTHE, OHIO 45601 CONTACT: TJ EVANS PHONE: 740-775-2464

ARCHITECT:

R GARY GLUECK 3797 LOOP ROAD NASHVILLE NC 27856 PHONE: 252-459-5900

ENGINEER:
EMR LLC
PO BOX 213 (MAILING)
4140 HWY 30 WEST
ANNVILLE, KENTUCKY 40402
PHONE: 606-364-2886
FAX: 606-364-5100

LOCAL CONTACTS:


BUILDING DEPARTMENT:

816-969-1200
WATER DEPARTMENT:


WATER DEPARTMENT: 816-969-1900

ELECTRIC: 816-554-9382

816-554-9382 <u>GAS DEPT:</u> 1-800-582-1234

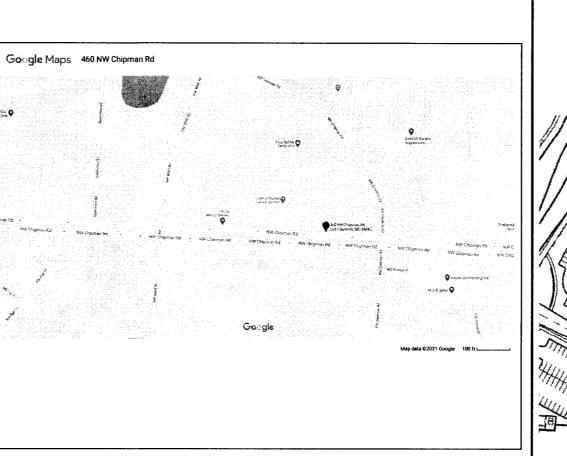

LOCATION MAP

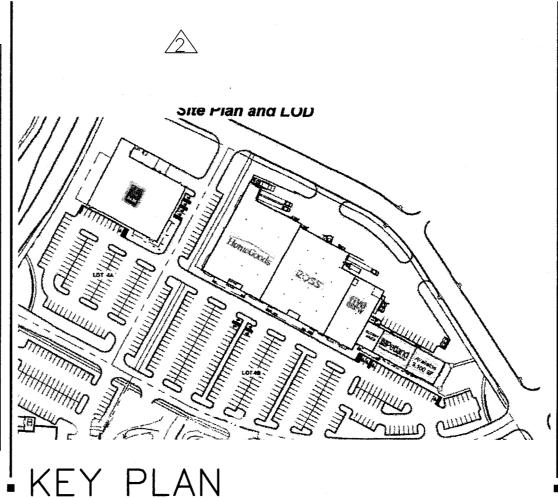

SHEET INDEX

SHT. NO.	DESCRIPTION						
CS	COVER SHEET						
-	ARCHITECTURAL DRAWINGS						
AA	SPECIFICAITONS & L/L SCOPE OF WORK						
C1	CODE ANALYSIS & EXIT PLAN						
D1	DEMO PLAN						
A1	FLOOR PLAN - NEW CONDITIONS						
A2	REFLECTED CEILING PLAN, ROOM FINISH, DOOR & COLOR SCHEDULES						
A3	DIMENSION PLAN						
A4	MISC. DETAILS						
A5	INTERIOR ELEVATIONS & WINDOW SCHEDULE						
MECHANICAL DRAWINGS							
М1	MECHANICAL FLOOR PLAN						
M2	HVAC SCHEDULES & DETAILS						
	PLUMBING DRAWINGS						
P1	PLUMBING PLAN & NOTES						
P2	PLUMBING DRAIN PLAN & NOTES						
P3	PLUMBING RISER PLAN						
P4	PLUMBING FIXTURE SCHEDULE & NOTES						
P5	PLUMBING GAS PLAN						
	ELECTRICAL DRAWINGS						
E1	LIGHTING PLAN						
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E3	ELECTRICAL SCHEDULE, DETAILS						

RELEASE FOR
CONSTRUCTION
AS NOTED ON PLANS REVIEW
DEVELOPMENT SERVICES
LEE'S SUMMIT, MISSOURI


R. Gary Glueck

Architecture Planning

Nashville, NC 27856

Phone: 252-459-5900

Email: Plans4u2@yahoo.com

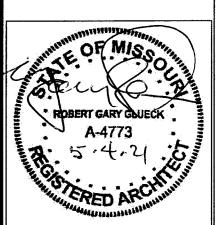

ROBERT G GLUECK MISSOURI LICENSE NUMBER: A-4773

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SPECIFICATIONS ARE OWNED WITHOUT PRIOR WRITTEN
CONSENT. ANY UNAUTHORIZED USE OR DISCLOSURE OF THE
PROPRIETARY INFORMATION CONTAINED HEREIN MAY SUBJECT
SUCH PERSONS TO:
CHILLICOTHE DH 45601

THE CONTRACTOR SHALL
VERIFY AND BE
RESPONSIBLE FOR ALL
DIMENSIONS AT JOB SITE.

Plans and Specifications for PETLAND LEE'S SUMMIT 464 NW CHIPMAN RD LEES SUMMIT MO 64063

DRAWING HIS	TORY:
ISSUED FOR	DATE
2 SITE PLAN	4-13-202
	·
DRAWN BY: STAFF	
CHECKED BY: STA	FF

DATE: 1/08/2020

SHEET NO.

PROJECT

GENERAL SPECIFICATIONS

A. <u>GENERAL</u>

THE USE OF THESE DOCUMENTS IS RESTRCITED TO THE ORIGINAL SITE FOR WHICH THEY WERE PREPARED. REUSE OR REPRODUCTION OF THE DOCUMENTS (WHOLE OR IN PART) FOR ANY OTHER PURPOSE IS PROHIBITED. TITLE TO THESE DOCUMENTS IN PRIMA FACIE EVIDENCE OF THE ACCEPTANCE OF THESE RESTRICTIONS.

THE A.I.A. GENERAL CONDITIONS, CURRENT EDITION, SHALL APPLY TO THE PROJECT. A COPY OF THE CONDITIONS IS AVAILABLE AT THE OFFICES OF PETLAND INC.

- GENERAL CONTRACTORS TO HAVE A JOB PHONE ON PREMISES DURING ENTIRE CONSTRUCTION PERIOD. IF STORE PHONE IS USED BY GENERAL CONTRACTOR OR HIS SUBCONTRACTORS. A PREDETERMINED SUM WILL BE DEDUCTED FROM THE CONTRACT
- 4. GENERAL CONTRACTOR IS TO VERIFY ALL DIMENSIONS AND FIELD CONDITIONS WITH THE DRAWINGS, IN PARTICULAR, CEILING HEIGHTS, OVERALL WALL DIMENSIONS, CEILINGS. CAPACITY OF ELECTRICAL SYSTEM FOR NEW LIGHTING LAYOUT ETC. GENERAL CONTRACTOR IS TO REPORT IMMEDIATELY TO THE DESIGNER ANY VARIANCES OR FIELD CONDITIONS THAT MAY CAUSE CONSTRUCTION PROBLEMS PRIOR TO COMMENCING WORK.

GENERAL CONTRACTOR IS TO BE FAMILIAR WITH ALL SHOPPING CENTER CRITERIA. WORKING CONDITIONS PERTAINING TO BARRICADES, NOISE, DUST, TRASH REMOVAL, ETC. COORDINATE WITH SHOPPING CENTER MANAGER.

- GENERAL CONTRACTOR TO COORDINATE INTERRUPTION OF EXISTING BUILDING FIRE PROTECTION SYSTEM WITH BUILDING LANDLORD. CONTRACTOR TO PAY ALL SHUTDOWN FEES AND RELATED CHARGES.
- 7. GENERAL CONTRACTOR TO FILE ALL REQUIRED INSURANCE CERTIFICATES WITH CENTER AND
- GENERAL CONTRACTOR IS RESPONSIBLE FOR A SITE INSPECTION AT THE TIME OF THE BID AND SHALL NOTIFY OWNER'S DESIGNER OF ANY DISCREPANCIES BETWEEN CONDITIONS AND THE DRAWINGS.

9. ALL MATERIALS, EQUIPMENT, WORKMANSHIP, WORKING CONDITIONS, AND CONSTRUCTION METHODS SHALL COMPLY WITH THE LATEST APPLICABLE SECTIONS OF LOCAL, MUNICIPAL, STATE, AND FEDERAL CODES AND REQUIREMENTS OF THE LANDLORD.

- 10. GENERAL CONTRACTOR SHALL NOT REJECT ANY FIXTURE/MATERIAL DELIVERIES UNLESS THEY FIRST CALL THE PROJECT MANAGER (740)-253-2198.
- 11. EXISTING PLUMBING, HEATING, VENTILATING, AIR CONDITIONING, FIRE PROTECTION, AND ELECTRICAL WORK AFFECTED BY CONSTRUCTION SHALL BE REMOVED AND, WHEN REQUIRED, RELOCATED BY APPLICABLE SUBCONTRACTOR FOR SUCH WORK.
- 12. GENERAL CONTRACTOR SHALL GUARANTEE INCLUDING BY HIS/HER SUBCONTRACTORS ALL MATERIALS AND WORKMANSHIP FOR A PERIOD OF ONE YEAR AFTER THE DATE OF FINAL ACCEPTANCE OF THE PROJECT, AND AGREES TO CORRECT OR REPLACE PROMPTLY, WITHOUT COST TO THE OWNER, ANY DEFECTIVE MATERIALS AND WORKMANSHIP.
- GENERAL CONTRACTOR TO CONCENTRATE ON AQUARIUM ROOM TO BE DONE FOUR WEEKS INTO JOB, INCLUDING PLUG MOLD WHICH HAS A (6) WEEK LEAD TIME.
- 14. GENERAL CONTRACTOR TO PROVIDE A PALLET JACK, STANDARD FORKLIFT AND OPERATOR TO BE USED THROUGHOUT MERCHANDISE WEEK FOR MERCHANDISE AND FIXTURE DELIVERIES, COORDINATE WITH PROJECT MANAGER.

B. <u>DEMOLITION (IF REQUIRED)</u>

- THE GENERAL CONTRACTOR SHALL VISIT THE SITE AT TIME OF BID AND REPORT CONDITIONS WHICH MAY CAUSE CONSTRUCTION PROBLEMS. ANY VARIANCES OR WORK NOT INDICATED ON THE DRAWINGS BUT REQUIRED TO COMPLETE THE PROJECT SHALL BE REPORTED TO THE DESIGNER AND PETLAND PRIOR TO COMMENCEMENT OF CONSTRUCTION.
- 2. ALL SALVAGEABLE EQUIPMENT SHALL BECOME THE PROPERTY OF THE CONTRACTOR FOR DISPOSAL EXCEPT AS NOTED. ALL DEBRIS AND MATERIAL TO BE ABANDONED SHALL BE DISPOSED OF BY THE CONTRACTOR. NOTE THE EXISTING HEATER TO BE RETURNED TO THE LANDLORD PROPERTY MANAGER
- DEMOLITION WORK TO BE COMPLETE WITH AS LITTLE DISRUPTION TO OTHER AREAS AS POSSIBLE. CONTRACTOR TO REMOVE DEBRIS WITHOUT IT COLLECTING WITHIN THE PREMISES.
- 4. INTERIOR DEMOLITION TO INCLUDE ALL EXISTING MATERIALS, FIXTURING HARDWARE, ETC. AS REQUIRED TO ACCOMMODATE NEW CONSTRUCTION. PATCH AND PREP ADJACENT SURFACES TO REMAIN AND FINISH TO MATCH AS REQUIRED.
- 5. PROVIDE DUMPSTER OR OTHER TRASH DEVICE AND COORDINATE WITH LANDLORD LOCATION. CLEAN UP ALL DIRT OR DEBRIS THAT MAY OCCUR FROM THIS OPERATION. FAILURE TO DO SO WILL RESULT IN OTHER FORCES PERFORMING THIS AT CONTRACTOR'S EXPENSE.
- PROTECT ALL AREAS OF THE STORE INCLUDING PUBLIC AREAS FROM ANY DAMAGE WHICH MAY ARISE FROM THE WORK. THE CONTRACTOR SHALL BE RESPONSIBLE FOR CORRECTING OR PAYING FOR ANY DAMAGE ARISING FROM THIS WORK.
- DEMOLITION AND NEW WORK SHALL TAKE PLACE IN ACCORDANCE AND ALL REGULATIONS AND GUIDELINES, INCLUDING ANY WORK WHICH MAY TAKE PLACE OR BE DIRECTED TO TAKE PLACE OVERNIGHT. THE COST FOR WHICH SHALL BE INCLUDED IN THE BASE BID. VERIFY WITH LANDLORD'S REP FOR REQUIREMENTS.
- 8. MODIFY EXISTING SPRINKLER SYSTEM AS REQUIRED FOR NEW WALL CONSTRUCTION.
- ALL WORK TO CONFORM TO CODE.
- 10. REMOVE ALL FLOOR FINISHES, CARPET, CERAMIC TILE, VINYL FLOOR, BASE.
- 11. THE CONTRACTOR SHALL REMOVE, REPAIR, RESTORE AND REPLACE WHERE ANY SUCH ACTION IS NECESSARY OR INDICATED ON THE DRAWINGS OR AS REQUIRED. CUT ALL NECESSARY OPENINGS FOR ANY REQUIRED PURPOSE AND REPAIR, WHERE NECESSARY, AFTER CUTTING, INSOFAR AS POSSIBLE, ALL PROTRUSIONS, MARKS. CRACKS, OR OTHER EVIDENCE OF A DEFICIENT OR DAMAGED CONDITION SHALL BE ELIMINATED, UNLESS SPECIFICALLY NOTED OTHERWISE. ANY PARTS WHICH ARE SPLIT, CRACKED, CHIPPED, SPALLED, BROKEN, MISSING, OR OUT OF LINE OR ADJUSTMENT, MECHANICALLY OR STRUCTURALLY UNSAFE OR UNSOUND, BENT, TORN OR OTHERWISE DEFICIENT OR INJURED IN ANY MANNER, SHALL BE REMOVED, REPLACED, RESTORED OR SATISFACTORILY REPAIRED AS DIRECTED BY THE OWNER.

STORE PREPARATION

- ALL MATERIALS SPECIFIED ARE TO BE IN ACCORDANCE WITH MANUFACTURER'S INSTRUCTIONS AND SPECIFICATIONS. GENERAL CONTRACTOR IS TO CONSTRUCT PROJECT IN ACCORDANCE WITH THE DOCUMENTS. ANY DEVIATION FROM THE INTENT OF THE DOCUMENTS WITHOUT DESIGNER'S APPROVAL ARE AT THE CONTRACTOR'S OWN RISK.
- WALL FURRING AND FRAMING
- WALLS TO BE FRAMED OUT WITH 20 GAUGE, 3-5/8" METAL STUDS AS SHOWN ON DRAWINGS.
- 2. LAYOUT, CUT, FIT AND ERECT FRAMING FOR ROUGH AND FINISHED WORK. INSTALL BLOCKING, NAILERS. FURRING AND OTHER ROUGH AND FINISHED MATERIALS AS REQUIRED. BRACE, PLUMB AND LEVEL MEMBERS IN TRUE ALIGNMENT AND RIGIDLY SECURE IN PLACE WITH SUFFICIENT SCREWS AND BOLTS AS NECESSARY.
- 3. FURNISH AND INSTALL ALL GROUNDS OR BLOCKING REQUIRED TO RECEIVE STORE FIXTURES.
- 4. FURNISH AND INSTALL ALL ROUGH HARDWARE, ANCHORS, BOLTS, ETC..., AS REQUIRED FOR CARPENTRY WORK.

D. <u>DRYWALL</u>

- ALL DRYWALL IS TO BE TAPED, THREE COAT SPACKLE AND SANDED PRIOR TO INSTALLATION OF FINISHED MATERIALS ALL CORNERS AND EDGES TO HAVE METAL BEADS. BEDDED AND SANDED FOR FINISH. ALL WORK TO CONFIRM TO U.S. GYPSUM STANDARD SPECIFICATIONS OR EQUAL. VISIBLE JOINTS WILL NOT BE ACCEPTABLE.
- SPRINKLER & FIRE ALARM
- 1. GENERAL CONTRACTOR TO PROVIDE SPRINKLER & FIRE ALARM SYSTEM. IN ACCORDANCE WITH APPLICABLE CODES.
- 2. SPRINKLER & FIRE ALARM PROTECTION DRAWINGS TO BE SUBMITTED AT A LATER DATE.
- ALL WORK TO CONFIRM TO CODE.
- F. <u>FIRE EXTINGUISHERS</u>
- 1. GENERAL CONTRACTOR TO PROVIDE AND INSTALL TYPE ABC FIRE EXTINGUISHERS AS REQUIRED BY LOCAL AUTHORITIES, (ONE MINIMUM NEAR SALES DESK.)
- 15. SALES AREA TO BE OPEN TO BOTTOM OF ROOF DECK (UNLESS NOTED OTHERWISE).
- 16. DRYWALL CEILING TO BE 5/8" DRYWALL (SMOOTH FINISH) ON USG SUSPENSION SYSTEM. (MAY
- 17. BLACK CEILING TILE (FOR AQUARIUM ROOM) HAS A LEAD TIME.
- 18. WHITE CEILING TILE IN KENNEL, ISO ROOM, OFFICE, RESTROOMS, CORRIDOR, COMMUNITY ROOM, PUPPY RUN, & STORAGE/UTILITY ROOM (UNLESS NOTED OTHERWISE).
- H. <u>VINYL TILE FLOORING AND VINYL BASE</u>
- 19. VINYL BASE AT LAVATORIES AND CORRIDOR TO BE 4" COVE, VINYL BASE AT CARPETED RISERS TO BE 4" STRAIGHT.
- 20. VINYL BASE TO BE INSTALLED ACCORDING TO MANUFACTURER'S SPECIFICATIONS. ALL SURFACES ARE TO BE TURNED OVER TO OWNER CLEAN, WITHOUT MASTIC SMEARS OR SEEPAGE. ALL BASE JOINTS AND CORNERS TO BE TIGHT AND TRUE WITHOUT GAPS. SEAM ADHESIVE TO
- 21. THE GENERAL CONTRACTOR SHALL EXAMINE EXISTING SLAB CONDITIONS TO DETERMINE TO WHAT EXTENT FLOOR PREPARATION, LEVELING, CHIP HAMMERING, ETC. WILL BE NECESSARY TO FURNISH A SMOOTH, LEVEL SUBSTRATE WITH EDGES FLOATED FOR THE PROPER INSTALLATION OF ALL FLOORING MATERIALS. THE COST OF SUCH WORK TO THE EXTENT THAT IT CAN BE DETERMINED DURING THE BID PROCESS SHALL BE THE RESPONSIBILITY OF THE CONTRACTOR. UNEVEN SUBSTRATE WILL NOT BE ACCEPTED AS AN EXCUSE FOR POORLY INSTALLED FLOORING
- 22. VINYL COMPOSITION TILE IS TO HAVE FIVE (5) COATS OF WAX.
- 23. UPON COMPLETION OF THE GENERAL CONTRACTOR'S WORK, THEY ARE TO MAKE ARRANGEMENTS TO HAVE THE FLOORS CLEANED AND WAXED. THE GENERAL CONTRACTOR ALSO NEEDS TO SET UP AN ADDITIONAL VISIT FROM THE FLOOR CLEANING COMPANY TO COME BACK TO THE STORE ON THE THURSDAY EVENING OF MERCHANDISING WEEK TO BUFF THE FLOORS ONCE AGAIN.
- CARPET (DRY TANK DISPLAYS, STACK OUTS, AND RISERS)
- 1. CARPET TO BE SUPPLIED BY THE GENERAL CONTRACTOR.
- 2. GENERAL CONTRACTOR TO PROVIDE PROPERLY PREPARED FLOOR SURFACE, WITHOUT HOLES, CRACKS, OR BUMPS FOR GLUE-DOWN CARPET INSTALLATION.
- 3. CARPET TO BE INSTALLED IN ACCORDANCE WITH MANUFACTURER'S RECOMMENDATIONS, USING LATEX BASE MASTIC. ALL SEAMS TO BE TIGHT AND STRAIGHT, PANELS ARE TO RUN IN SAME DIRECTION. ALL SEAMS TO RECEIVE ROBERT'S LIQUID SEAM SEALER, CLEAR.
- 4. ALL DEBRIS TO BE REMOVED FROM PREMISES. ALL LARGE PIECES (48" OR LARGER) TO BE ROLLED AND STORED IN WORKROOM. CARPET TO BE TURNED OVER TO OWNER CLEAN, WITHOUT STAINS, SNAGS, OR DAMAGE DUE TO CONSTRUCTION WORK.
- J. PLASTIC LAMINATE
- 1. PLASTIC LAMINATES TO BE INSTALLED PER MANUFACTURER'S SPECIFICATIONS. ALL EDGES TO BE FLUSH, TRUE AND STRAIGHT, WITHOUT GAPS. ADJACENT LAMINATED PANELS TO BE CONCEAL SPLINED AT JOINTS. GLOSS FINISH TO BE INSTALLED OVER MEDIUM DENSITY PARTICLE BOARD. SPACKLE AND SAND SMOOTH TO AVOID TELEGRAPHING OF FASTENER LOCATIONS, BACKER EDGES,
- 2. ALL LAMINATE SURFACES. EDGES AND ADJACENT MATERIALS TO BE FREE OF ADHESIVES. MARKINGS, CHIPS, AND SURFACE BLEMISHES. REMOVE WRAPPINGS.

DIVISION 1 - GENERAL REQUIREMENTS AND CONDITIONS

- 1. THE WORK SHALL BE LAID OUT FROM THE DIMENSIONS SHOWN ON THE DRAWINGS ONLY. (DO NOT SCALE THE DRAWINGS)
- 2. THE CONTRACTOR SHALL WORK FROM THE MOST RECENT DRAWINGS SUPPLIED BY THE OWNER DESIGNER. WORK SHALL BE PERFORMED BASED UPON LANDLORD APPROVED PLANS AFTER WRITTEN DIRECTION BY OWNER OR DESIGNER.
- 3. VERIFY ALL LINES, LEVELS, INTERFERENCE, FIELD DIMENSIONS AND CONDITIONS WITH THE DRAWING AND REPORT ANY ERRORS, OMISSIONS, OR DISCREPANCIES TO THE DESIGNER PRIOR TO COMMENCING WORK.
- 4. THE GENERAL CONTRACTOR IS TO REPORT TO THE DESIGNER ANY VARIANCES OF FIELD CONDITIONS THAT MAY CAUSE CONSTRUCTION PROBLEMS PRIOR TO COMMENCING WORK. FAILURE TO REPORT TO THE DESIGNER FOR INTERPRETATION SUCH CONDITIONS OR COVERING OVER A CONDITION WHICH SUBSEQUENTLY CAUSES ANY DELAY OR ADDITIONAL COST SHALL BE THE RESPONSIBILITY OF THE CONTRACTOR, WHO SHALL BE HELD FOR ANY DAMAGES RESULTING THERE FROM.
- 5. ANY CONFLICT BETWEEN DETAIL, DIMENSION, MATERIAL OR SPECIFICATION IS TO BE ADDRESSED TO THE DESIGNER FOR INTERPRETATION, ANY SUCH CONFLICT NOT SO RESOLVED AND CORRECTION IS LATER REQUIRED SHALL BE AT THE CONTRACTOR'S EXPENSE.
- 6. THE CONTRACTOR SHALL BE RESPONSIBLE FOR HIS LAYOUT AND FOR THAT OF HIS SUB-TRADES. ALL DIMENSIONS INDICATED AS HOLD DIMENSIONS SHALL BE MAINTAINED. ANY VARIANCES FROM THESE WILL BE AT THE RISK OF THAT TRADE OR CONTRACTOR.
- 7. VERIFY ANY EQUIPMENT CLEARANCES PRIOR TO LAYOUT. HE SHALL BE HELD RESPONSIBLE FOR ANY DAMAGE TO OR ADDITIONAL COST FOR FAILURE TO DO SUCH LAYOUT.
- 8. PRIOR TO THE COMMENCEMENT OF CONSTRUCTION THE CONTRACTOR SHALL VERIFY ALL OVERALL DIMENSIONS, COLUMN LOCATIONS AND REPORT THESE TO THE DESIGNER.
- 9. THE CONTRACTOR SHALL REPORT THE WORK OF HIS FORCES WITH SUB-TRADES, LANDLORD AND OWNER. ANY FAILURE TO PROPERLY COORDINATE WHICH RESULTS IN ADDITIONAL COST INCLUDING ANY DEMOLITION OF CONSTRUCTION IN PLACE SHALL BE BOURNE BY THE CONTRACTOR.

- 10. ALL MATERIAL SPECIFIED IS TO BE INSTALLED IN ACCORDANCE WITH MANUFACTURER'S INSTRUCTIONS AND SPECIFICATIONS. GENERAL CONTRACTOR IS TO CONSTRUCT PROJECT IN ACCORDANCE WITH THE DOCUMENTS.
- 11. THE DESIGNER IS SOLE INTERPRETER, ARBITER OF THE DOCUMENTS. ANY DEVIATION FROM THE INTENT OF THE DOCUMENTS, WITHOUT THE DESIGNER'S APPROVAL IS AT THE CONTRACTOR'S OWN RISK AND MAY RESULT IN CORRECTION AT THE CONTRACTOR'S EXPENSE (MATERIALS AND
- 12. THE DRAWINGS, SPECIFICATIONS, AND OTHER DOCUMENTS PREPARED BY THE DESIGNER ARE INSTRUMENTS OF THE DESIGNER'S SERVICE THROUGH WHICH THE WORK TO BE EXECUTED BY THE CONTRACTOR IS DESCRIBED. NEITHER THE CONTRACTOR, SUBCONTRACTOR, SUB-SUBCONTRACTOR, MATERIAL OR EQUIPMENT SUPPLIER SHALL OWN OR CLAIM A COPYRIGHT IN THE DRAWINGS, SPECIFICATIONS, AND OTHER DOCUMENTS PREPARED BY THE DESIGNER UNLESS OTHERWISE INDICATED. THE DESIGNER SHALL BE DEEMED THE AUTHOR OF THEM AND WILL RETAIN ALL COMMON LAW, STATUTORY, AND OTHER RESERVED RIGHTS, IN ADDITION TO THE COPYRIGHT. BY THE DESIGNER, AND COPIES THEREOF FURNISHED TO THE CONTRACTOR ARE FOR USE SOLELY WITH RESPECT TO THIS PROJECT.
- 13. SHOULD THE DRAWINGS AND SPECIFICATIONS BE CONTRADICTORY, OR SHOULD THERE BE ERRORS IN EITHER, THE CONTRACTOR SHALL REFER THE MATTER TO THE DESIGNER FOR EXPLANATION AND SHALL ABIDE BY THEIR DECISION.
- 14. THE CONTRACTOR SHALL TAKE FIELD MEASUREMENTS, VERIFY FIELD CONDITIONS, AND SHALL CAREFULLY COMPARE SUCH FIELD MEASUREMENTS AND CONDITIONS AND OTHER INFORMATION KNOWN TO THE CONTRACTOR WITH THE CONTRACT DOCUMENTS BEFORE COMMENCING ACTIVATES. ERRORS, INCONSISTENCIES OR OMISSIONS DISCOVERED SHALL BE REPORTED TO THE DESIGNER AT ONCE.

PERMITS, FEES, AND NOTICES

- 1. UNLESS OTHERWISE PROVIDED IN THE CONTRACT DOCUMENTS, THE CONTRACTOR SHALL SECURE AND PAY FOR THE BUILDING PERMIT AND OTHER PERMITS AND GOVERNMENTAL FEES, LICENSES AND INSPECTIONS NECESSARY FOR PROPER EXECUTION AND COMPLETION OF THE WORK WHICH ARE CUSTOMARILY SECURED AFTER EXECUTION OF THE CONTRACT AND WHICH ARE LEGALLY ACQUIRED WHEN BIDS ARE RECEIVED OR NEGOTIATIONS CONCLUDED. A COPY OF SUCH SHALL BE FURNISHED TO THE OWNER.
- THE CONTRACTOR SHALL COMPLY AND GIVE NOTICE AS REQUIRED BY LAWS, ORDINANCES, RULES, REGULATIONS, AND LAWFUL ORDERS OF PUBLIC AUTHORITIES BEARING ON PERFORMANCE OF THE
- 3. ALL WORK IS TO PERFORMED IN ACCORDANCE WITH ALL GOVERNING CODES, ORDINANCES, AND AUTHORITIES HAVING JURISDICTION INCLUDING BUT NOT LIMITED TO HANDICAP CODES.

- MILLWORK TO SUPPLIED BY THE MILLWORK CONTRACTOR AND BY THE GENERAL CONTRACTOR AS INDICATED ON DRAWINGS.
- 2. FIELD ASSEMBLE OF SUPPLIED MILLWORK MAY BE REQUIRED. FOLLOW SHOP DRAWINGS ACCOMPANYING MILLWORK.
- ALL MILLWORK TO BE ASSEMBLED IN FIELD TO BE SCRIBED AND JOINED ACCURATELY.
- 4. FASTENING TO BE CONCEALED AND JOINTS INCONSPICUOUS.
- 5. MAKE ALL JOINTS IN A PERMANENT MANNER MAINTAINING A UNIFORM FLUSH, TIGHT CONNECTION USING A COMBINATION OF SCREWS, DOWELS, AND GLUE.
- 6. WHERE BLIND FASTENING IS IMPOSSIBLE AND NAILS ARE REQUIRED DRILL HOLES UNIFORMLY, SET AND PUTTY HEADS, BLIND NAIL IF POSSIBLE.
- 7. ALL CUT ENDS OF MILLWORK TO BE FILLED FINISHED TO MATCH PREFINISHED FACES.
- 8. GENERAL CONTRACTOR IS RESPONSIBLE FOR ALL OFF LOADS.
- 9. SEAL ALL HOLES BETWEEN KENNELS WITH SILICON.
- 10. GENERAL CONTRACTOR TO PROVIDE PALLET JACK, STANDARD FORKLIFT AND OPERATOR FOR MERCHANDISE AND FIXTURE DELIVERIES, COORDINATE WITH PROJECT MANAGER.

PAINTING

- 1. CONTRACTOR TO CONFIRM SUITABILITY OF ALL WALLS TO RECEIVE PAINT AND WALL COVERING IN A FIRST CLASS MANNER. REPAIR OR REPLACEMENT OF A POOR FINISH DUE TO INSTALLATION OVER AN UNSUITABLE SURFACE IS THE PAINTING CONTRACTOR'S RESPONSIBILITY.
- 2. ALL SURFACES TO BE PRIMED PER MANUFACTURER'S RECOMMENDATIONS SUITABLE AND COMPATIBLE WITH SURFACE AND FINISH SPECIFIED.
- 3. ALL MATERIAL AND WORKMANSHIP SHALL PRODUCE A FIRST CLASS INSTALLATION OF UNIFORM
- 4. ALL PAINTED SURFACES TO RECEIVE THREE (3) COATS OF LATEX BASE PAINT. NOTE: PAINTED SURFACE TO BE SMOOTH ROLLED OR BRUSHED WITH NO SKIPS, LAPS, OR STREAKS. SEE COLOR SCHEDULE FOR MANUFACTURER'S DESIGNATIONS.
- PAINTING CONTRACTOR TO FILL AND TOUCH UP ALL NAIL HOLES IN ALL WOOD TRIMS AND MOLDINGS.
- 6. FERROUS METAL (EXPOSED STEEL, SPRINKLER LINES, AND
- DUCTWORK (1) PRIME COAT SHERWIN WILLIAMS "DTM" ACRYLIC
- PRIMER/FINISH (B66W1) (2) FINISH COATS - WATERBORNE ACRYLIC SHERWIN WILLIAMS
- DRY FALLWHITE (B42W1 SERIES) "FLAT"

CLEAN UP AND FINAL INSPECTION

- 1. ALL PUNCH LIST ITEMS TO BE COMPLETED WITHIN TEN (10) WORKING DAYS OF RECEIPT.
- 2. PREMISES TO BE TURNED OVER CLEAR OF ALL DEBRIS, PACKING BOXES, WRAPPING, AND EXCESS MATERIALS.
- 3. ALL MIRROR GLASS TO BE CLEANED OF PROTECTIVE PADS, MASTIC AND MARKINGS.
- 4. ALL ELECTRICAL PANELS AND BREAKERS TO BE PROPERLY AND CLEARLY MARKED AND PROVIDE NINE (9) LOCKOUT CLIPS (ALARM SYSTEM, NIGHT LIGHT, EXIT SIGN, TIME CLOCK, STOREFRONT TRACK TIME CLOCK, ALL CASHWRAP OUTLETS AND THREE EXTRA.)
- 5. A COMPLETE LIST OF SUB NAMES, ADDRESSES, AND TELEPHONE NUMBERS TO BE SUBMITTED TO
- 6. CONTRACTOR TO SET UP A CLEANING CREW DURING THE WEEK OF CONSTRUCTION, PRIOR TO MERCHANDISING WEEK.
- 7. CONTRACTOR TO SET UP A CLEANING CREW ON THE THURSDAY OF MERCHANDISING WEEK.
- 8. THE JOB SUPERINTENDENT STAYS THROUGH MERCHANDISING AND TRAINING WEEK AND IS PRESENT FOR GRAND OPENING.
- 9. THE CONTRACTOR IS TO INFORM THE FRANCHISEE OR PETLAND WHEN THE CONSTRUCTION HAS PROGRESSED TO THE POINT WHERE IT WILL BE POSSIBLE TO SET UP PHONE AND INTERNET

LANDLORD'S

LANDLORD APPROVAL IS REQUIRED WITHIN TWO WEEKS OF RECEIPT OF THESE DOCUMENTS OR THEY ARE DEEMED APPROVED BY THE LANDLORD.

TENANT'S TAKING SPACE IN AS-IS CONDITION


R. Gary Glueck Architecture

Nashville, NC 27856

Planning

RELEASE FOR CONSTRUCTION **AS NOTED ON PLANS REVIEW** DEVELOPMENT SERVICES LEE'S SUMMIT, MISSOUR

Phone: 252-459-5900 Email: Plans4u2@yahoo.com

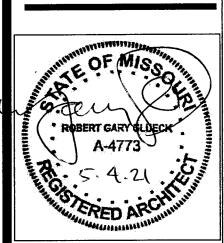

MISSOURI LICENSE NUMBER: A-4773

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THE CONTRACTOR SHALL VERIFY AND BE RESPONSIBLE FOR ALL DIMENSIONS AT JOB SITE.

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> > DRAWING HISTORY:

ISSUED FOR DATE DRAWN BY: STAFF CHECKED BY: STAFF DATE: 1/08/2020 PROJECT | SHEET NO.

TEANANT NAME: PETLAND LOCATION: LEES SUMMIT MO ADDRESS: 464 NW CHIPMAN RD

CODE INFORMATION

BUILDING CODES:

2018 INTERNATIONAL BUILDING CODE 2018 INTERNATIONAL PLUMBING CODE 2018 INTERNATIONAL MECHANICAL CODE 2018 FIRE CODE 2017 NFPA 70 NATIONAL ELECTRICAL CODE ICC/ANSI A117.1-2009 ACCESSIBLE AND USABLE BUILDING AND FACILITIES

OCCUPANCY CLASSIFICATION:

GROUP M (MERCANTILE)

BUILDING CONSTRUCTION TYPE:

(NON SEPARATED, FULLY SPRINKLERED)

TOTAL AREA: _____

3208 SQ. FT.

EGRESS CONPONENTS:

OCCUPANCY: M (MERCANTILE) SPRINKLERED: YES

REQUIRED 86'-2"/3 =28'-9 " 250'-0" MAX EXIT ACCESS SEPARATION EXIT TRAVEL DISTANCE COMMON PATH OF EGRESS

AREAS W/LESS THEN 50 OCCUPANTS 75'-0" MAX ALL OTHER AREAS

EGRESS CALCS:

MAIN FOOR OCCUPANT LOAD: 3208 SQ. FT./ 60 SQ. FT. PER PERSON = 53.46 PEOPLE

TOTAL OCCUPANT LOAD: PEOPLE

PROVIDED

EXIT ROUTE

48

97'-6"

MIN. EGRESS WIDTH: 53.46 PEOPLE X .2 IN PER = 10.7".

10.7"/ 36" PER DOOR = (1) 36" DOOR OR EQUIVALENT (4 - 36" DOORS PROVIDED) MIN. # OF 36IN. DOORS:

OCCUPANT LOAD: SALES AREA: BUSINESS AREA:

2365/60 = 40843/100 = 8


______ TOTAL 48
DESCRIPTION OF USE: MIXED, WITH MERCANTILE BEING PRINCIPAL.

EGRESS PLAN LEGEND

TOTALS

ROOM NO.	USE	OCC. CLASS	SIZE SQ. FT.	SQ. FT./PERSON	NO. PERSONS
100	RETAIL SALES	М	2365	60	39
110	KENNEL	В	390	100	4
130-131	RESTROOMS	В	130	100	1
140	SUPPORT CARE CENTER	В	168	100	2
150	OFFICE	В	70	100	1
160	HALLWAY	В	85	100	1

3208

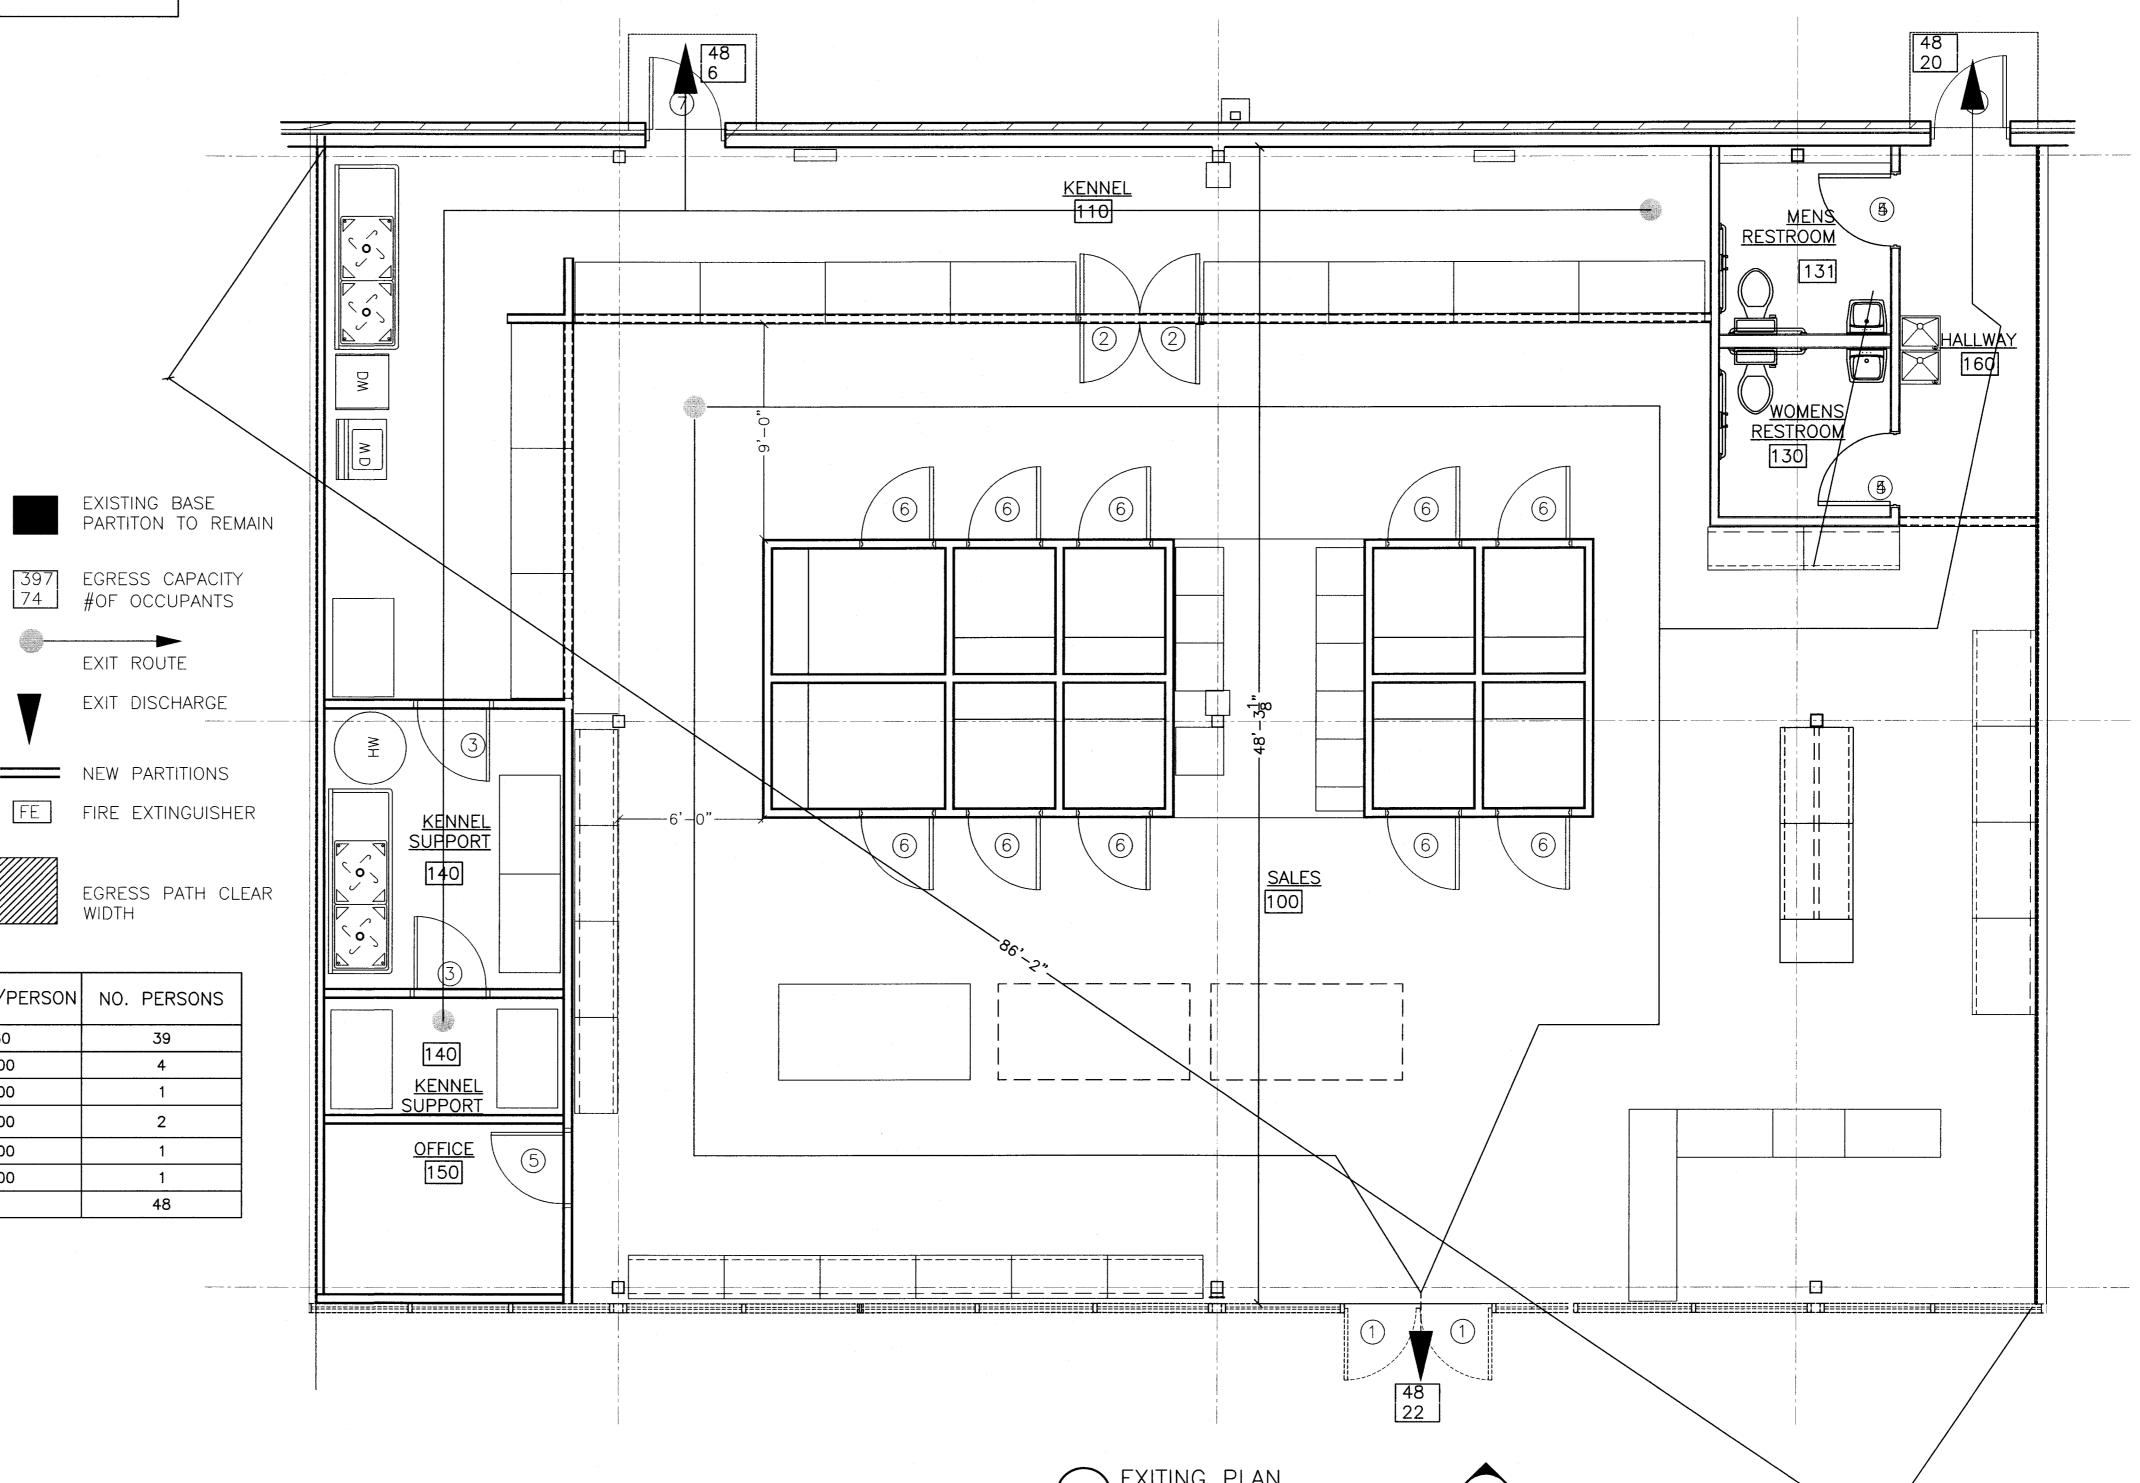


CONSTRUCTION
AS NOTED ON PLANS REVIEW
DEVELOPMENT SERVICES

R. Gary Glueck

Architecture Planning

3797 Loop Road Nashville, NC 27856

Email: Plans4u2@yahoo.com

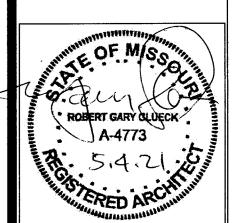

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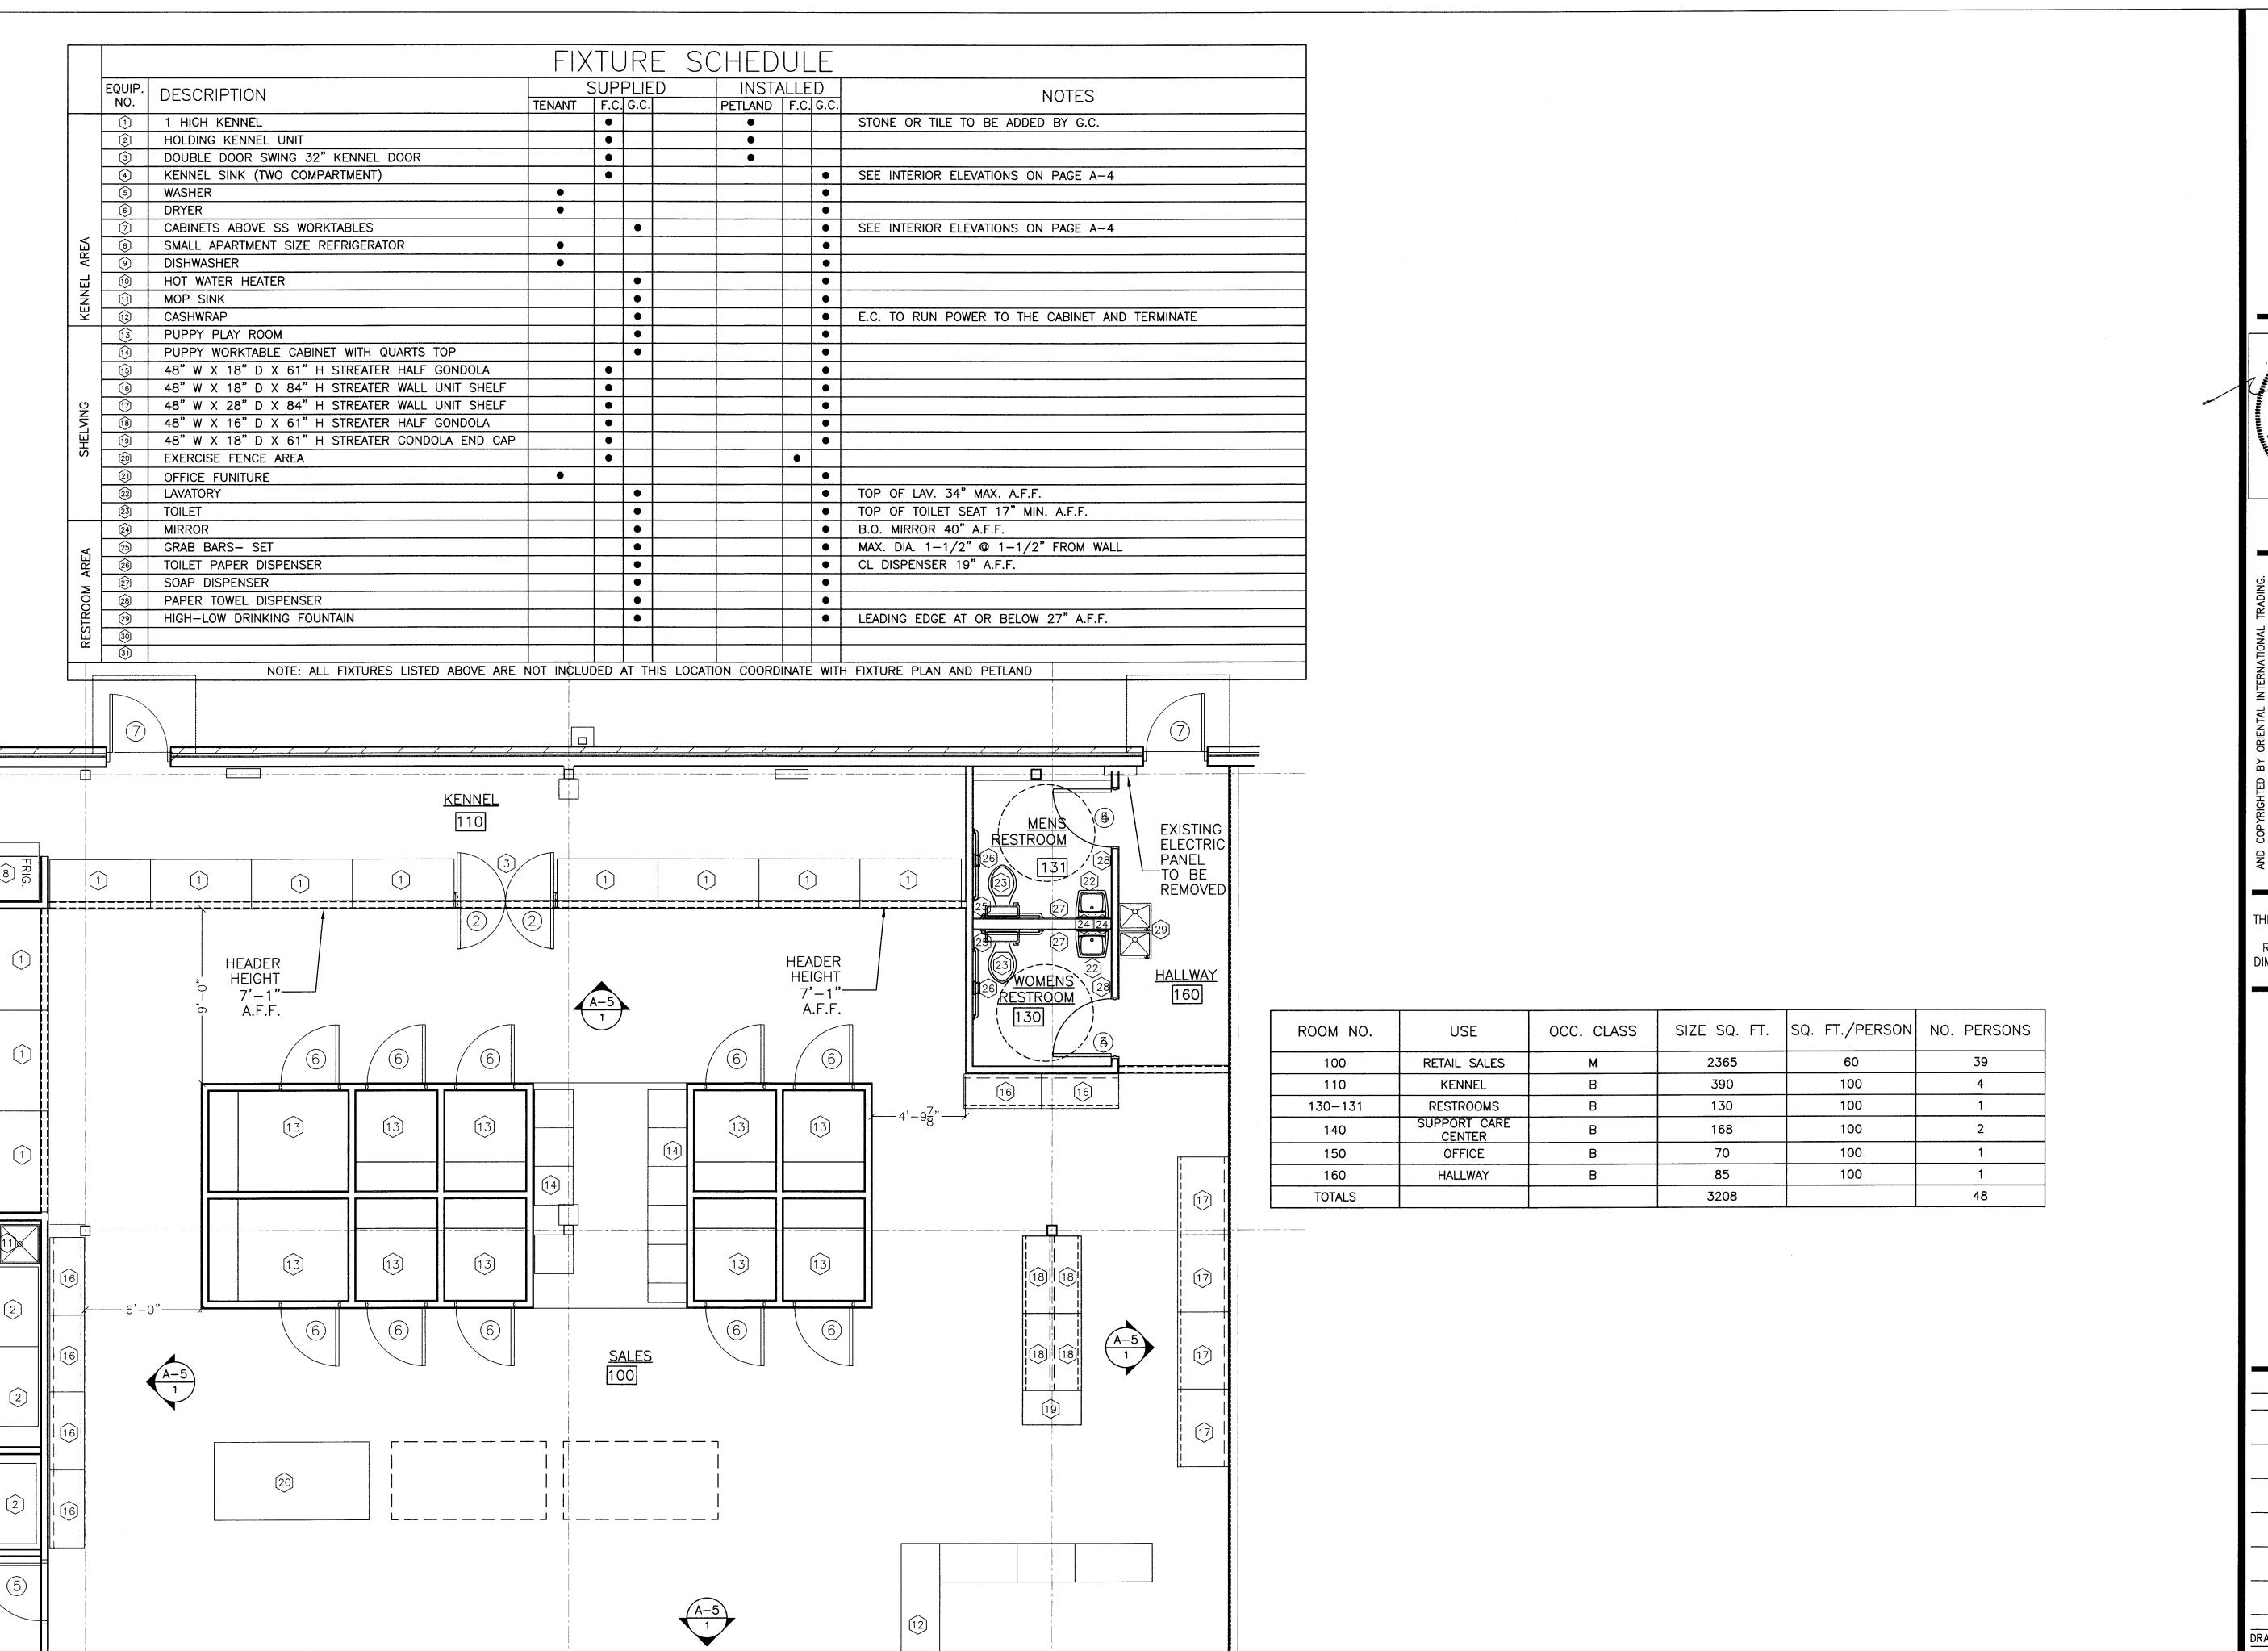
THE CONTRACTOR SHALL VERIFY AND BE RESPONSIBLE FOR ALL DIMENSIONS AT JOB SITE.

> for SUMMI Specifications AND and Plans

DRAWING HISTORY:									
ISSUED FOR	DATE								
3 ADDRESS CORRECTION	5-4-2021								

DRAWN BY: STAFF CHECKED BY: STAFF DATE: 1/08/2020

PROJECT SHEET NO.



KENNEL SUPPORT

140

KENNEL SUPPORT

> OFFICE 150

> > 15

FIXTURE FLOOR PLAN


RELEASE FOR
CONSTRUCTION
AS NOTED ON PLANS REVIEW
DEVELOPMENT SERVICES
LEE'S SUMMIT, MISSOURI

R. Gary Glueck

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Planning

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TEL. 740-775-2464


THE CONTRACTOR SHALL
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RESPONSIBLE FOR ALL
DIMENSIONS AT JOB SITE.

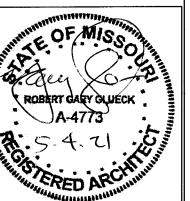Plans and Specifications for PETLAND LEE'S SUMMIT

DRAWING	DRAWING HISTORY							
ISSUED FO	₹	DATE						

DRAWN BY: S	TAFF							
CHECKED BY:								
DATE: 1/	08/	2020						
PROJECT 3658	SH	EET NO. A-1						

	CEILING PLAN CODED NOTES
NOTE	DESCRIPTION
1	NEW OPEN CEILING, HEIGHT TO THE BOTTOM OF DECK PAINT P-7 P-8.
2	NEW 2' X 4' ACOUSTICAL CEILING TILE AND GRID @ 8'-0" A.F.F. (SEE FINISH SCHEDULE FOR TILE/PAINT COLORS).
3	NEW 2' X 4' ACOUSTICAL CEILING TILE AND GRID @ 11'-0" A.F.F. (SEE FINISH SCHEDULE FOR TILE/PAINT COLORS).
4	

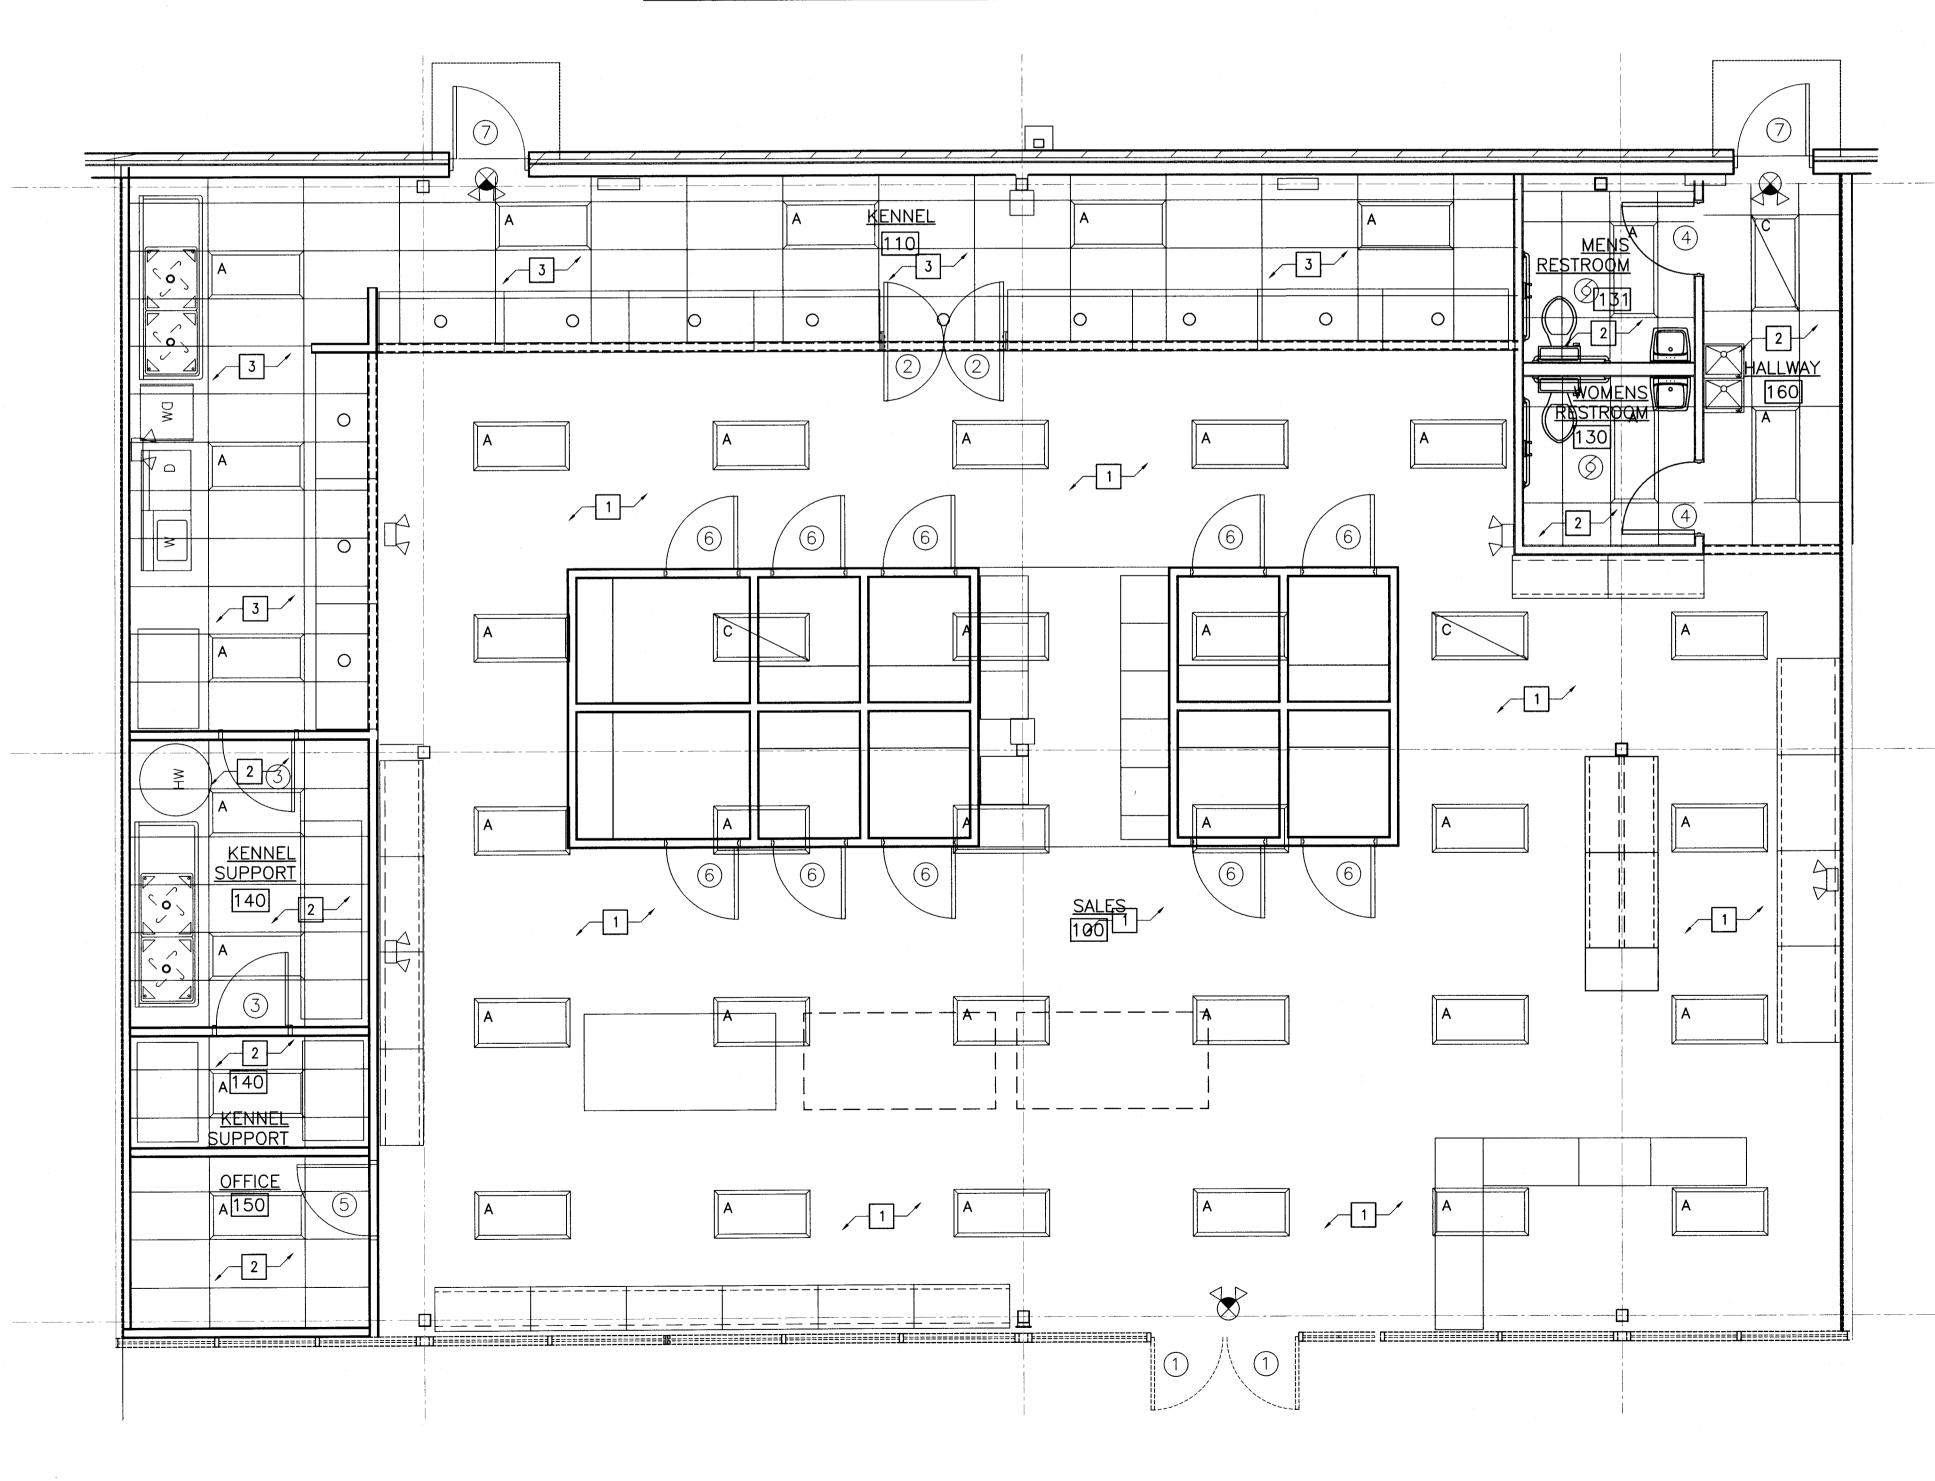

[CEILING LEGEND								
	NEW 24" X 48" RECESSED LED 5000K LIGHT FIXTUR (SEE ELECTRICAL).								
	O NEW LED CEILING RECESSED CAN LIGHT FIXTURE (SEE ELECTRICAL).								
	C	(NIGHT LIGHT) NEW 24" X 48" RECESSED LED 5000K LIGHT FIXTURE (SEE ELECTRICAL).							
	\bigcirc	EXHAUST FAN IN ISO ROOM & RESTROOMS.							
		COMBINATION EMERGENCY LIGHT/EXIT SIGN							
	A	EMERGENCY LIGHT							
		RETURN AIR GRILLE							
		SUPPLY AIR DIFFUSER							


	PAINT COLORS (SHE	COLOR SCH ERWIN-WILLIAMS)	V.C.T. FLOOR/BASE
P-1	BURNT ORANGE INTERIOR PROMAR 200 ZERO VOC EG-SHEL CUSTOM MANUAL MATCH CCE*COLORANT W1-WHITE R2-MAROON Y1-YELLOW ONE GALLON	ARCHITECTURAL ACRYLIC LATEX STANDALONE OZ 32 64 128 - 26 2 43 27 ULTRADEEP	ARMSTRONG PARALLEL USA 20 SERIES OR EQUIVALENT LVT-1 (6" X 48" LONG BEACH OAK (J5240) VB-1 JOHNSONITE VINYL COVEBASE BLACK 4" H. X .080"
P-2	B20T02654 BALANCED BEIGE SW7037 HGSW2486	650186950	REGULAR EDGE CEILING TILE GRID — 15/16" EXPOSED TEE SYSTEM, WHITE
P-3	TEAL PEIXES INTERIOR PROMAR 200 ZERO VOC EG-SHEL	ARCHITECTURAL ACRYLIC LATEX STANDALONE	
	CUSTOM MANUAL MATCH CCE*COLORANT W1-WHITE G2-NEW GREEN L1-BLUE Y1-YELLOW ONE GALLON	OZ 32 64 128 2 38 2 8 1 - 2 8 - 9 1 -	FIBERGLASS REINFORCED PANEL LASCO BOARD OR EQUAL COMMERICAL GRADE .090 FLEX FLAT
P-5	B20T0654 PURE WHITE INTERIOR PROMAR 200 EG-SHEL SHER-COLOR FORMULA	PROFESSIONAL LATEX COROB SW-10000	FRP-1 #488 WHITE ENH PEB/SM, M/ WHITE TOP CAP & CRNR MLDG. (12' SHEETS MAY REQUIRE LEAD TIME) FIXTURES STREATER #KM DECOR WHITE VALANCE - BROWN HDPE
	BAC COLORANT R3-MAGENTA Y1-YELLOW ONE GALLON B20W02251	OZ 32 64 128 1 1 EXTRA WHITE 640354114P-6	END PANELS — BROWN HDPE
P-7	(1) PRIME COAT SHERWII "DTM" ACRYLIC PRIMER/F		
P-8	(2) FINISH COATS — WAT ACRYLIC SHERWIN WILLIAI DRY—FALLWHITE (B42W1	MS	
	N-WILLIAMS OF CHILLICOTHE IT# 6577-1181-8 FOR PAI (740)-774-47 FAX (740)-773-05	INT COLORS '50	

RELEASE FOR
CONSTRUCTION
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DEVELOPMENT SERVICES
LEE'S SUMMIT, MISSOURI

R. Gary Glueck

Architecture Planning

3797 Loop Road Nashville, NC 27856 Phone: 252-459-5900 Email: Plans4u2@yahoo.com

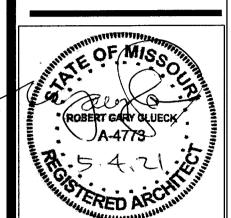

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THE CONTRACTOR SHALL
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Plans and Specifications for PETLAND LEE'S SUMMIT 464 NW CHIPMAN RD LEES SUMMIT MO 64063

ISSUED FOR	DATE
DRAWN BY: STAFF	
CHECKED BY: STA	FF

DATE: 1/08/2020

PROJECT SHEET NO. 3658 A-2

DRAWING HISTORY:

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AS NOTED ON PLANS REVIEW LEE'S SUMMIT, MISSOUR

Architecture Planning

R. Gary Glueck

3797 Loop Road Nashville, NC 27856 Phone: 252-459-5900 Email: Plans4u2@yahoo.com

ROBERT GARY SLUECK

ROBERT G GLUECK MISSOURI LICENSE NUMBER:

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4

Specifications AND and Plans

DRAWING HISTORY: ISSUED FOR DATE

RAWN BY: STAFF

CHECKED BY: STAFF DATE: 1/08/2020

PROJECT | SHEET NO. 3658 A-3

NO. TYPE DESCRIPTION HARDWARE ON EACH DOOR: PUSH/PULLBAR (NEW) PAIR 3'-0" X 7'-0" ALL EXTERIOR DOORS TO BE KEYED ALIKE. CYLINDER LOCK, 1-1/2" PAIR BUTT ALUM. FRAME EXTERIOR WOOD TO BE REFINISHED DOOR W/SAFETY GLASS HINGES, WEATHER STRIPPING SUPPLIED BY PETLAND & INSTALLED DOUBLE SWING HINGE, KICK PLATE PAIR OF 2'-8" X 7'-0" GLASS BY PETLAND. (NEW) SOLID CORE WITH BUTT HINGES, LEVER HANDLE, 18" X 18' PAINT P-5 HOLLOW METAL FRAME VENTED LOUVER, SINGLE 3'-0" LOUVERS, 18" X 18" VISION PANELS, X 7'-6" WOOD DOORSTOP & TOP THROW BOLT 3 BUTT HINGES. LEVER HANDLE, PRIVACY PAINT PUBLIC SIDE OF ALL DOORS P-1 OR (NEW) SOLID CORE 3'-0" X 4 HOLLOW METAL FRAME SET, DOORSTOP, HOOK, CLOSER & KICK ROOM COLOR & NON PUBLIC SIDE P-5 7'-0" WOOD 3 BUTT HINGES, LEVER HANDLE, PASSAGE PAINT PUBLIC SIDE OF ALL DOORS P-1 & (NEW) SOLID CORE 3'-0" X 5 SET, DOORSTOP, HOOK, CLOSER & KICK | HOLLOW METAL FRAME NON PUBLIC SIDE P-5 7'-0" WOOD SUPPLIED BY G.C. & INSTALLED SINGLE 3'-0" X 4'-0" GLASS DOUBLE SWING HINGE, BY G.C. ALL EXTERIOR DOORS TO BE KEYED ALIKE. PAINT INSIDE P-1 & EXTERIOR TO MATCH EXTERIOR OF THE BUILDING. PHENOLIC EMERGENCY EXIT ALARM DEVICE (DETEX) ADHESIVE LETTERS SHALL BE PROVIDED AND (EXISTING) 3'-0" X 7'-0" TO BE KEY OPERATED FROM EXTÈRIOR, HOLLOW METAL FRAME INSTALLED BY G.C. ON EXTERIOR TO IDENTIFY HOLLOW METAL CLOSER, KICK PLATE, WEATHER STRIPPING, STORE. LETTERS SHALL BE 3" HIGH WHITE PEEPHOLE LETTERS, SIGN SHALL READING: "PETLAND" **KENNEL** 110 MEN'S RESTROOM DEMISING 1 HR FIRE RATED HEADER HEIGHT HEADER WALL DETAILS HEIGHT <u> ✓wom∉nš</u> #1 ON PAGE RESTROOM A.F.F. A.F.F. 130 6 6 100 G.C.'S SPRINKLER CONTRACTOR TO SUBMIT SPRINKLER DRAWINGS TO CITY SHOWING **EXISTING** MODIFICATIONS TO EXISTING HEAD LAYOUT. DEMISING 1 HR FIRE RATED WALL DETAILS #1 ON PAGE G.C. TO OBTAIN INSPECTION TO VERIFY IF ROOF LEAKS ARE PRESENT. BRING LEAKS TO THE ATTENTION OF THE LANDLORD. NEW DOUBLE DOORS IN ALL LEAKS SHALL BE REPAIRED \prec A>NEW LOCATION REMOVE PRIOR TO CONSTRUCTION. EXISTING SINGLE DOOR AND INFILL

DOOR & WINDOW SCHEDULE

FRAME

NOTES

ROOM FINISH SCHEDULE BASE ROOM FLOOR WALLS CEILING NOTES EXISTING ALUM./GLASS STOREFRONT SECTION EXISTING 2' X 4' (AT MIDDLE) SEE PLANS. DRYWALL, PAINT 100 SALES AREA NEW LVT FLOORING ACOUSTICAL CEILING TILE IN 4" VINYL VB-1 COLORS REFER TO ELEVATIONS ON SHEET WHITE GRID AT 13'-0" A.F.F NEW 2' X 4' ACOUSTICAL DRYWALL WITH FRP-1 AT ALL WALLS TO CEILING TILE IN WHITE GRID KENNEL NEW LVT FLOORING 4" VINYL VB-1 8'-0" A.F.F. AT 11'-0" A.F.F. NEW 2' X 4' ACOUSTICAL FRP-1 TO 4'-0" A.F.F. DRYWALL 130/131 **LAVATORIES** CEILING TILE IN WHITE GRID NEW LVT FLOORING 4" VINYL VB-1 PAINT P-5 AT 8'-0" A.F.F. DRYWALL COVERED WITH NEW 2' X 4' ACOUSTICAL SUPPORT CARE 140 FRP-1 AT ALL WALLS NEW LVT FLOORING CEILING TILE IN WHITE GRID 4" VINYL VB-1 CENTER (INSIDE 8'-0" & OUTSIDE 8'-0" A.F.F.) AT 8'-0" A.F.F. NEW 2' X 4' ACOUSTICAL 150 OFFICE DRYWALL, PAINT P-5 NEW LVT FLOORING CEILING TILE IN WHITE GRID 4" VINYL VB-1 AT 8'-0" A.F.F. EXISTING 2' X 4' 160 DRYWALL, PAINT P-5 ACOUSTICAL CEILING TILE IN HALLWAY NEW LVT FLOORING 4" VINYL VB-1 WHITE GRID AT 13'-0" A.F.F.

EXISTING

EXISTING

DEMISING 1 HR

FIRE RATED

WALL DETAILS

#1 ON PAGE

FIRE RATED

10'-39"

SUPPORT

SUPPORT

140

150

IEW INSULATED

ABOVE STORE

WINDOWS TO BE BLACKED OUT FROM INSIDE BEFORE

WALL IS BUILT TO HIDE

WALL TO BE

BUILT 6'

FRON

WINDOWS

INSULATION

HEADER

HEIGHT

DIMENSION PLAN

A.F.F

1 HOUR RATED METAL PARTITION [WALL LEGEND 6" METAL STUD DESCRIPTION "EXISTING WALLS" REFER TO PARTITION LEGEND ONE LAYERS EACH SIDE F" TYPE X GYPS "NEW WALLS" REFER TO PARTITION LEGEND "NEW SOFFIT WALLS" REFER TO PARTITION LEGEND EXISTING DEMISING WALL DETAIL DEMISING 1 HR PARTITION LEGEND WALL DETAILS #1 ON PAGE NOTE DESCRIPTION TYPE "A" - EXISTING PARTITIONS. TYPE "B" BY G.C. 5/8" DRYWALL EACH SIDE OF 3-5/8" 20 GAUGE METAL STUDS @ 16" O.C. TO ROOF DECK. TYPE "C" - BY G.C. 5/8" DRYWALL EACH SIDE OF 3-5/8" 20 GAUGE METAL STUDS @ 16" O.C. TO 6" ABOVE DROP CEILING. SEE DETAIL 9, SHEET A-4. TYPE "D" - BY G.C. 5/8" DRYWALL EACH SIDE OF 6" 20 GAUGE METAL STUDS @ 16" O.C. TO 6" ABOVE DROP CEILING. SEE DETAIL 9, SHEET A-4. TYPE "E" - (NEW PLUMBING WALL OVER DEMISING WALL) BY G.C. 5/8" DRYWALL AND TREATED PLYWOOD FROM 4'-0" A.F.F. TO 8'-0" A.F.F & FRP ON ONE SIDE OF 6" 20 GAUGE METAL STUDS @ 16" O.C. TO 6" ABOVE DROP CEILING VERTICAL CONTROL JOINTS @ 30'-0" O.C. INSULATE WITH SOUND

GENERAL NOTES

WARRANTIES.


1. ALL DIMENSIONS ARE TO FACE OF STUD TO FACE OF STUD. UNLESS TAKEN FROM EXISTING WALLS THEN TAKEN FROM FACE OF DRYWALL. 2. ALL INTERIOR PARTITIONS ARE 3-5/8" METAL STUDS UNLESS NOTED

ATTENUATING BATT INSULATION. SEE DETAIL 3, SHEET A-4.

TYPE "F" - (SOFFIT WALL) BY G.C. 5/8" DRYWALL EACH SIDE OF 3-5/8" 20

GAUGE METAL STUDS @ 16" O.C. TO METAL DECK SEE DETAIL 4, SHEET A-4

- OTHER WISE. 3. GENERAL CONTRACTOR TO VERIFY ALL NEW WALLS WITH FIXTURE
- CONTRACTOR DRAWINGS.
- 4. G.C. TO CONTACT AND COORDINATE SIGNAGE WITH PETLAND'S SIGN CONTRACTOR.
- 5. G.C. TO CONTACT AND COORDINATE ANY NEW ROOF OPENINGS/ INSTALL WITH LANDLORD ROOFING CONTRACTOR AND INSTALL ANY NEW ROOF TOP EQUIPMENT SO AS NOT TO VOID ANY ROOF
- ALL FREESTANDING FURNITURE WILL BE INSTALLED BY G.C.. ALL WET WALLS TO HAVE WATER RESISTANT GYP. BOARD.
- ALL EMERGENCY LIGHTS AND EXIT SIGNS TO BE CEILING MOUNTED
- UNLESS NOTED OTHER WISE.
- G.C. TO VERIFY GYP. BD. IS EXISTING AT ALL DEMISING WALLS. IF GYP. BD. IS NOT PRESENT, G.C. TO PROVIDE GYP. BD. & FINISH.

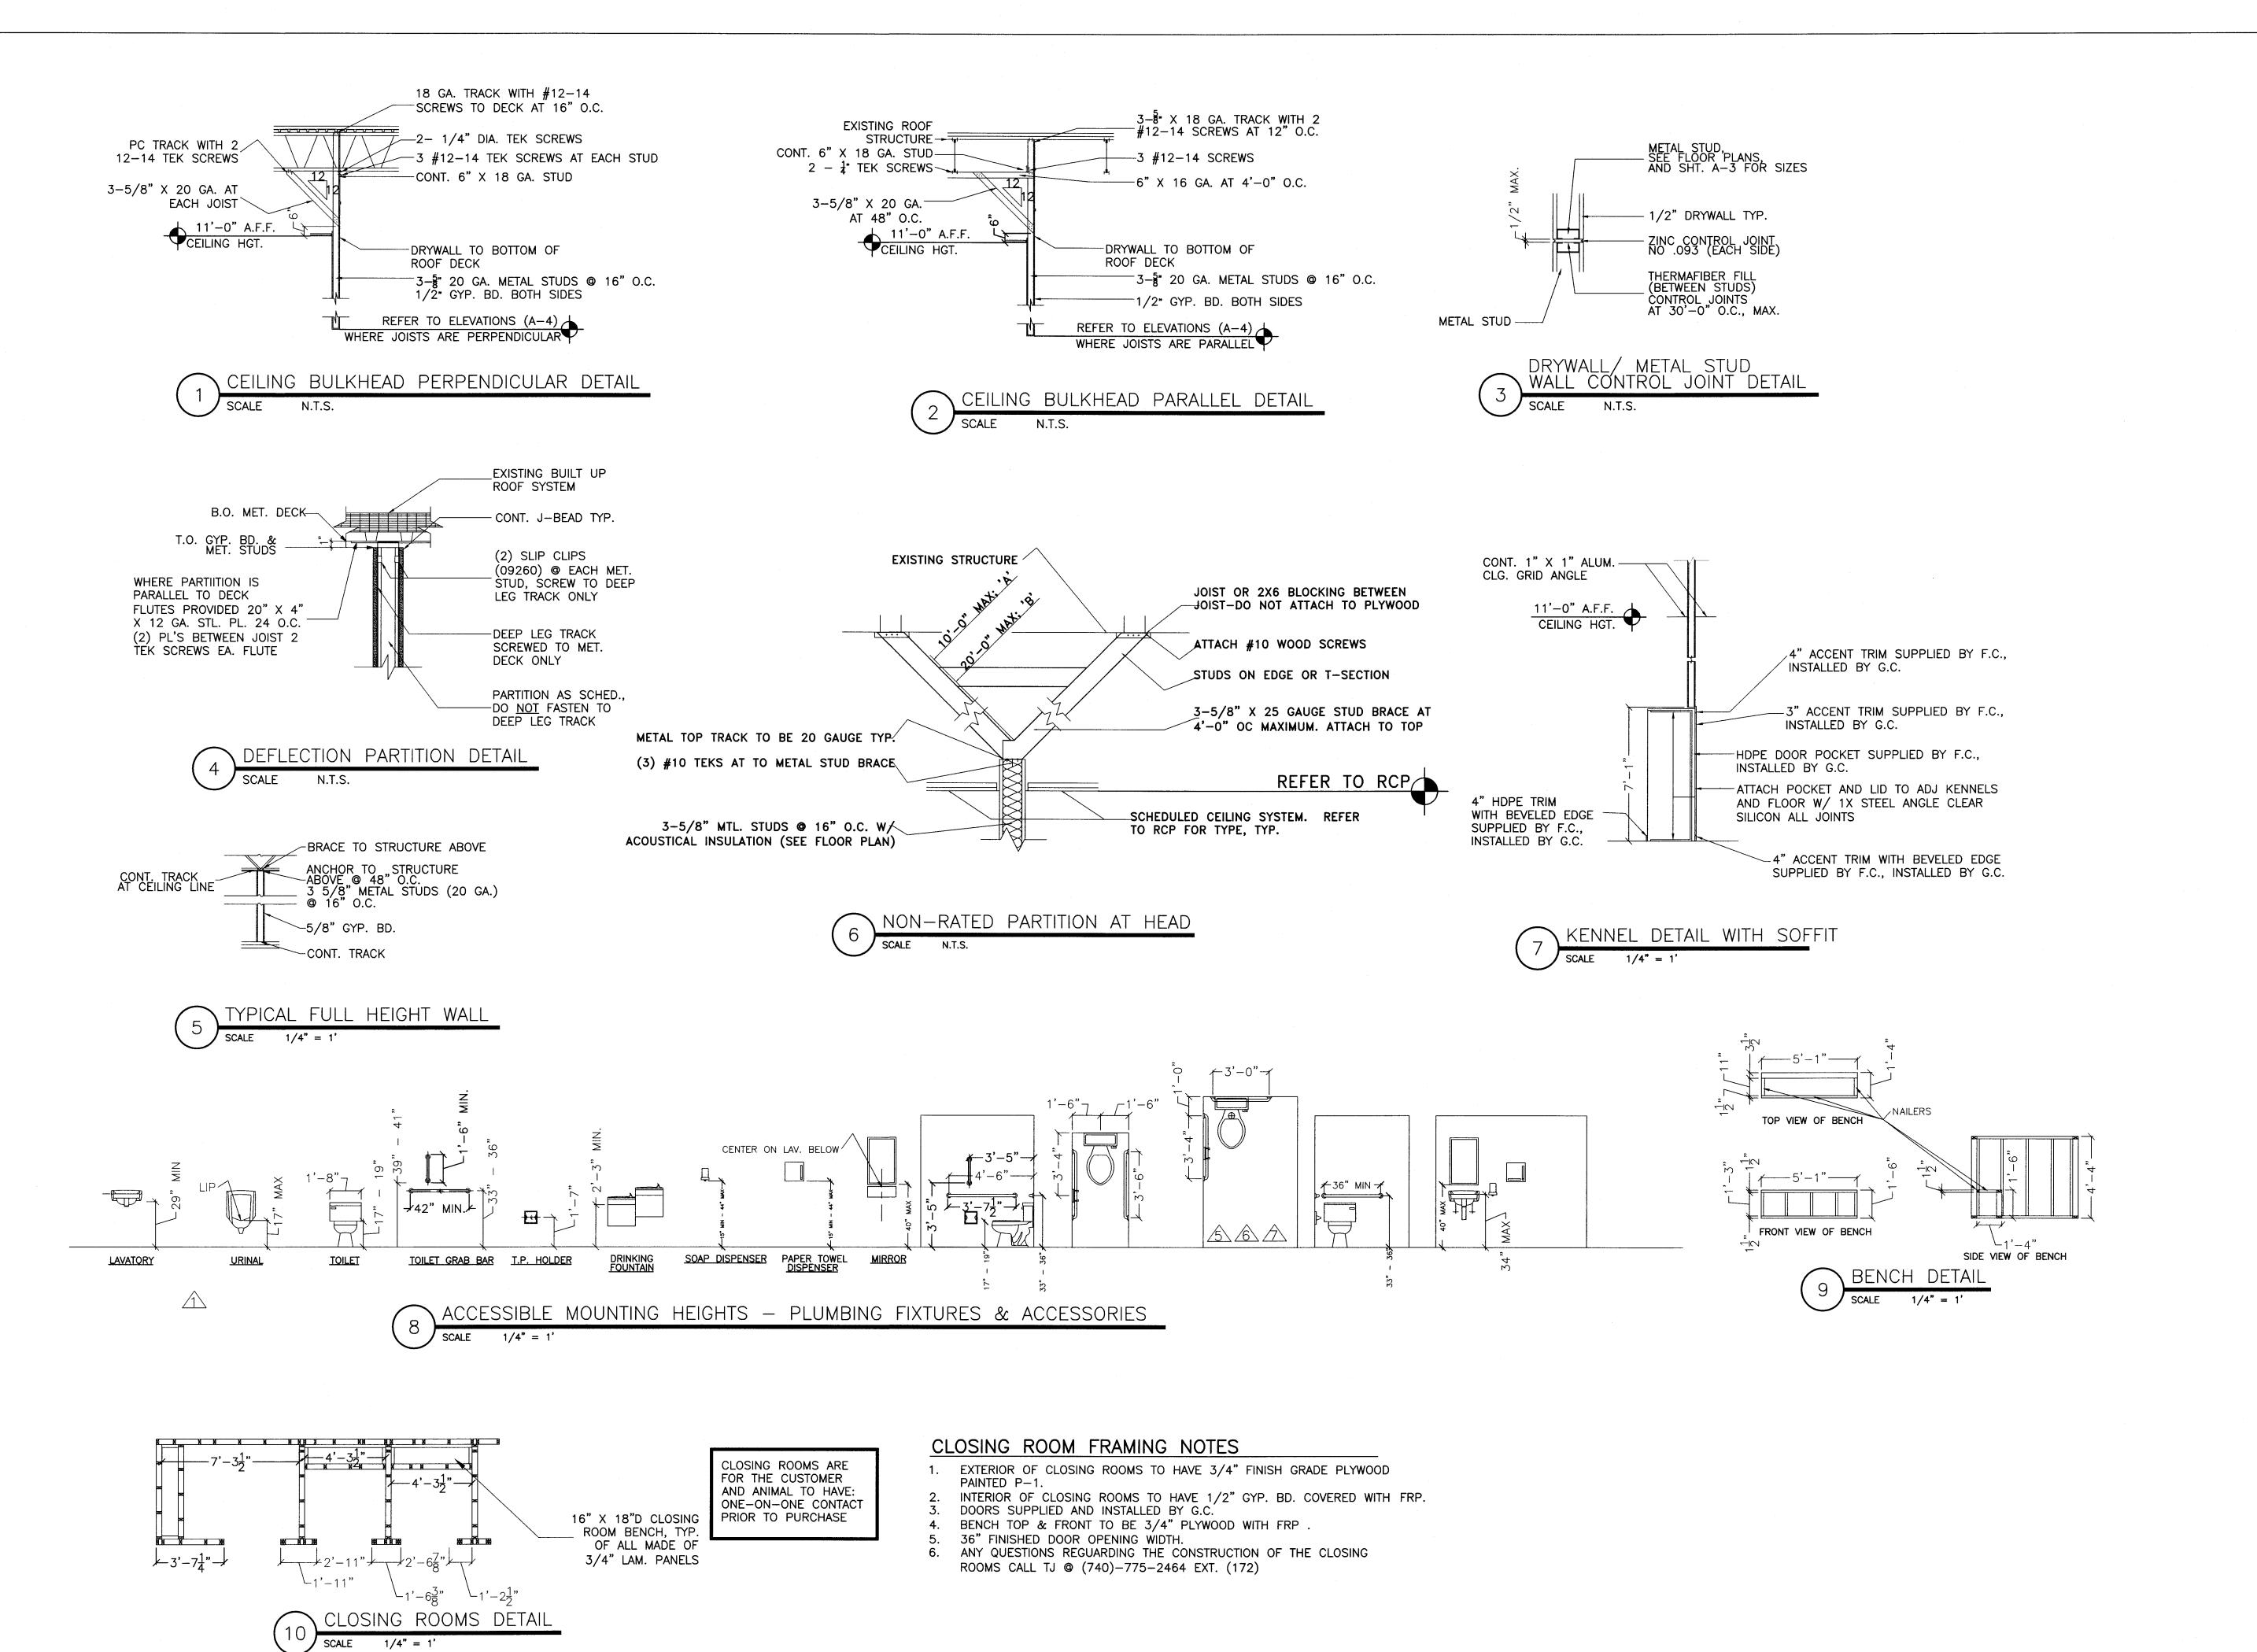


RELEASE FOR CONSTRUCTION
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R. Gary Glueck Architecture

Planning

3797 Loop Road Nashville, NC 27856

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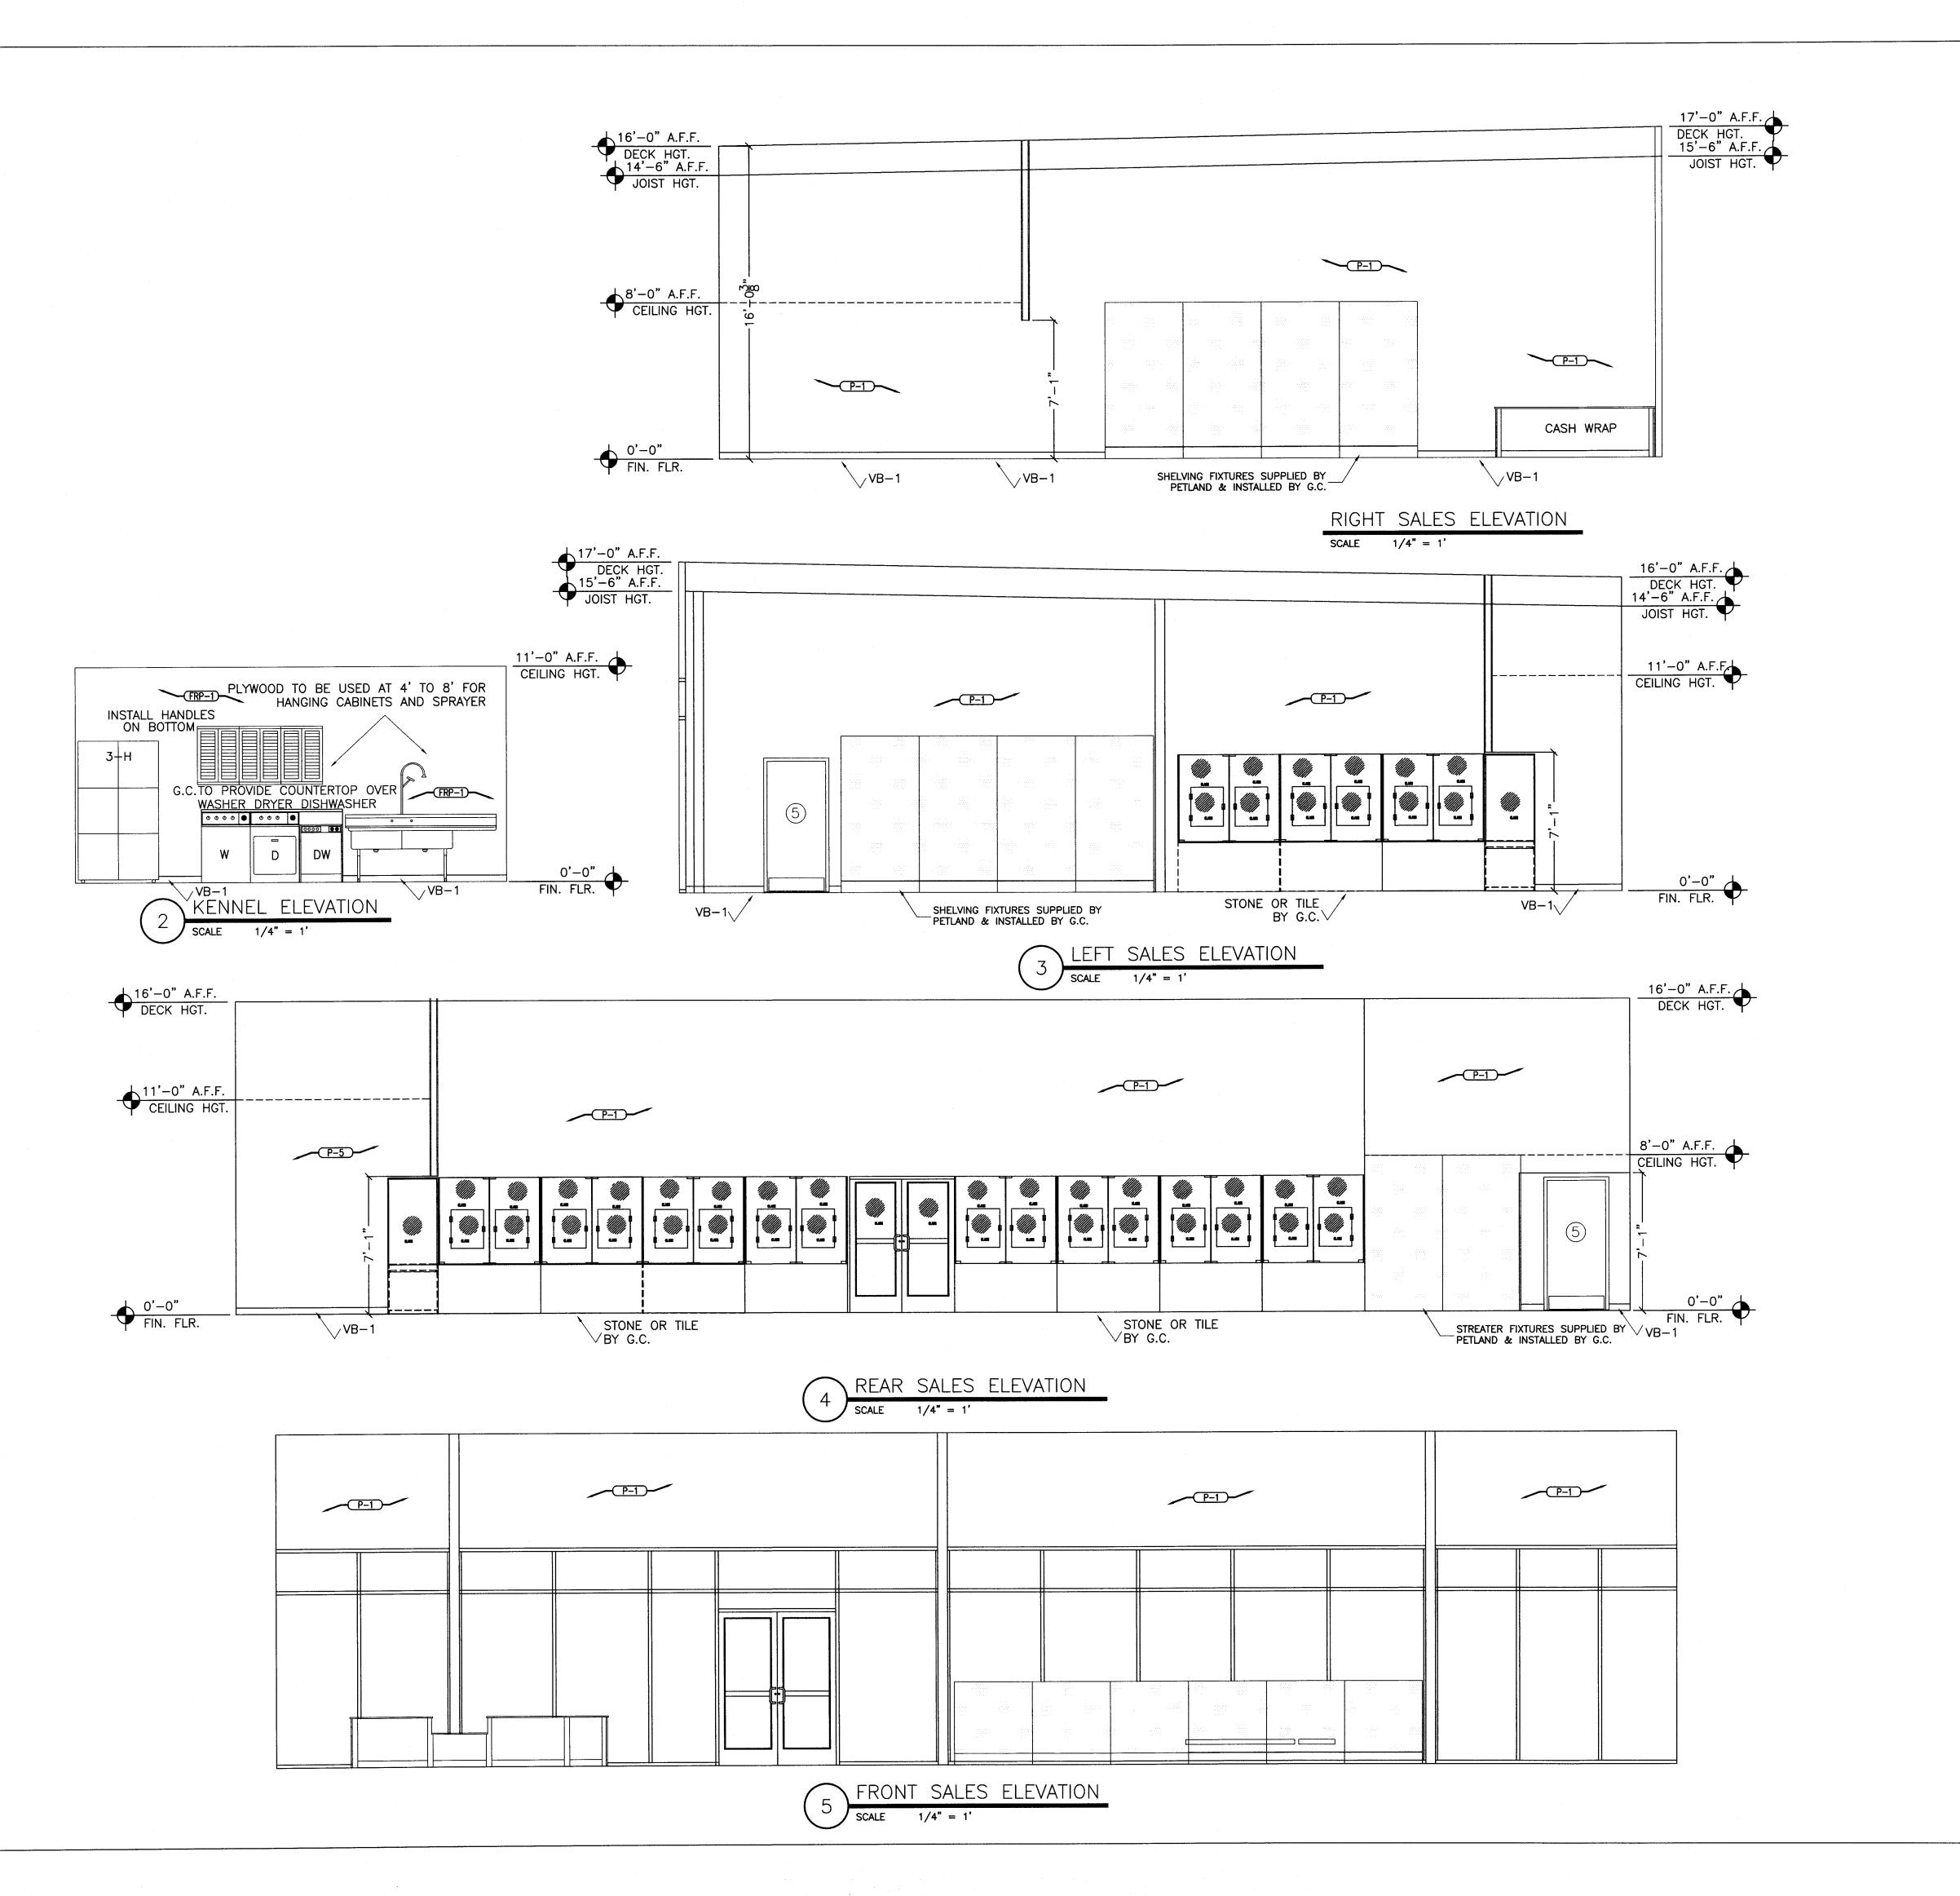
VERIFY AND BE RESPONSIBLE FOR ALL DIMENSIONS AT JOB SITE.

> for SUMM Specifications AND and 464 LEES Plans

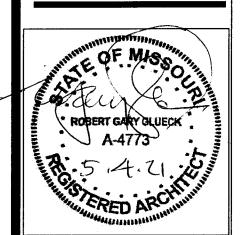DRAWING HISTORY: ISSUED FOR DATE 1 RESTROOM DETAIL 4-13-2021 CORRECTIONS

> DATE: 1/08/2020 PROJECT SHEET NO.

DRAWN BY: STAFF CHECKED BY: STAFF




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LEE'S SUMMIT, MISSOURI

R. Gary Glueck

Architecture
Planning

3797 Loop Road Nashville, NC 27856

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CDNTACT TJ EVANS
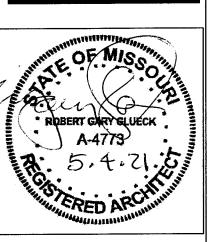
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DIMENSIONS AT JOB SITE.

Plans and Specifications for PETLAND LEE'S SUMMIT 464 NW CHIPMAN RD LEES SUMMIT MO 64063

DRAWING HIS	TORY:
ISSUED FOR	DATE
DDAMAL DV. STAFF	
DRAWN BY: STAFF CHECKED BY: STA	
CHECKED DT: STA	r F
DATE: 1/08/	/2020

PROJECT SHEET NO.

AIR BALANCE: -CFM										
CFM SUPPLY AIR -	<u>RTU-1</u> 2,000	<u>RTU-2</u> 2,000	<u>RTU-3</u> 2,000	<u>TOTALS</u> 6,000						
CFM OUTSIDE AIR -	400	400	400	1,200						
CFM RETURN AIR —	1,600	1,600	1,600	4,800						
CFM EXHAUST AIR -	2,060	N/A	N/A	2,060						

M.C. SHALL VERIFY EXACT LOCATION FOR THERMOSTATS WITH OWNER PRIOR TO INSTALLATION.




DRYER VENTING: M.C. SHALL BE RESPONSIBLE FOR RUNNING ALL DUCTWORK FOR THE DRYER EXHAUST SYSTEM. ALL CONCEALED DRYER DUCTING MUST BE RIGID METAL ALUMINUM MINIMUM OF 4" IN DIAMETER, SMOOTH 30 GA. CLEAN, UNOBSTRUCTED, FRICTIONLESS DUCTS (NO FLEXIBLE DUCT ALLOWED IN CONCEALED AREAS). SEAL ALL JOINTS WITH FOIL BACKED PRESSURE SENSITIVE DUCT TAPE MEETING THE REQUIREMENTS OF UL 181. DUCT JOINTS SHALL BE INSTALLED SO THAT THE MALE END OF THE DUCT POINTS IN THE DIRECTION OF THE AIRFLOW. DO NOT USE RIVETS OR SCREWS IN JOINTS OR ANYWHERE ELSE IN THE DUCT AS THIS WILL ENCOURAGE LINT COLLECTION.

DRYER BOX RECEPTACLE SHALL BE METAL AND BE INSTALLED AS LOW AS POSSIBLE AS TO PERMIT THE PROPER AND SAFE COLLECTION OF THE DRYER TRANSITION HOSE. DRYER BOX SHOULD BE RESTING ON THE BOTTOM PLATE AND BE LOCATED AT OR NEAR THE CENTERLINE OF THE PROPOSED DRYER APPLIANCE. RIGID DUCT SHOULD PENETRATE DRYER BOX PORT 2" TO PROVIDE FOR FUTURE CONNECTION AND STORAGE OF TRANSITION HOSE. BASEBOARD SHALL BE "BUTTED" UP TO THE FIXED EXTENSION RIM AND SLIGHTLY BACK CUT. DRYER BOX SHOULD BE CAULKED AND THEN PAINTED WITH THE TRIM PAINT. FOR USAGE IN A ONE HOUR WALL ASSEMBLY, UL REQUIRES THAT BATT INSULATION BE STUFFED AROUND THE DRYER BOX AND IN THE ENTIRE

WALL CAVITY CELL.
LENGTH OF CONCEALED RIGID METAL DUCTING SHALL NOT EXCEED 25'-0". DEDUCT 5'-0" FROM THE ALLOWABLE LENGTH FOR EVERY 3.5" RADIUS 90 DEGREE ELBOW AND 2'-6" FOR EVERY 45 DEGREE FITTING. DRYER VENTING SHALL BE INDEPENDENT OF ANY OTHER SYSTEMS. TERMINATION OF DRYER VENTING MUST BE TO THE EXTERIOR WITH A PROPER HOOD OR ROOF JACK EQUIPPED WITH A BACK DRAFT DAMPER. SMALL ORIFICE METAL SCREENING SHALL NOT BE INSTALLED TO PREVENT ACCUMULATION OF LINT AND BLOCKAGES. THE HOOD OPENING SHOULD POINT DOWN AND EXHIBIT 12" OF CLEARANCE BETWEEN THE BOTTOM OF THE HOOD AND THE GROUND OR OTHER OBSTRUCTION. ROUTE DUCTING TO ROOF VIA A BOOSTER FAN. INSTALL BOOSTER FAN PER MANUFACTURERS REQUIREMENTS.

SEE DETAIL THIS SHEET FOR ROUTING CLARIFICATION.

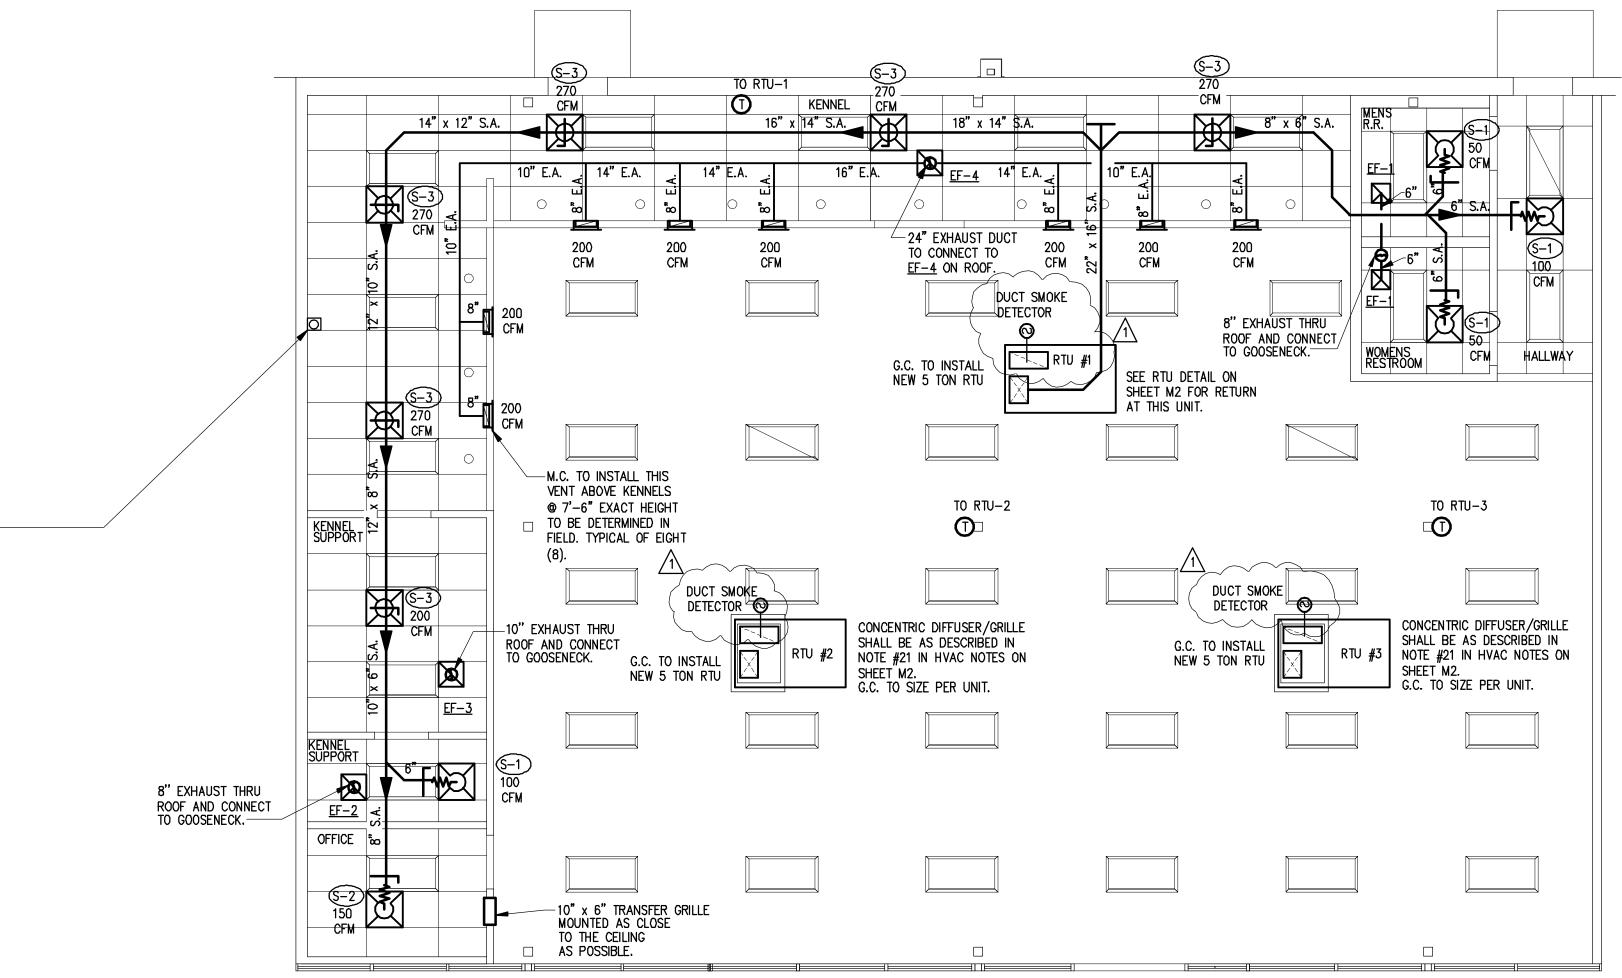

1 HVAC PLAN



CONNECT TO EXISTING

S APPROVED DUCT TYPE SMOKE DETECTOR

THERMOSTAT

P-# PLUMBING FIXTURE DESIGNATOR

CFM CUBIC FEET PER MINUTE

NOT TO SCALE

RTU ROOFTOP UNIT

MECHANICAL EQUIPMENT DESIGNATOR

AIR DISTRIBUTION DEVICE DESIGNATOR

SUPPLY AIR DIFFUSER

RETURN AIR GRILLE


→ FLEXIBLE DUCT

MANUAL VOLUME DAMPER

DUCT TRANSITION


REGTANGULAR DUCT (WIDTH X DEPTH)


FIRE DAMPER

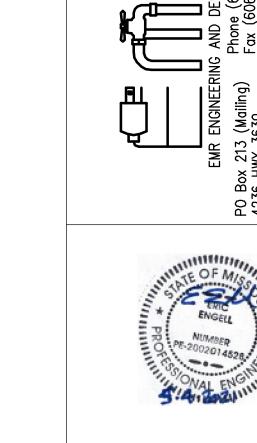

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AS NOTED ON PLANS REVIEW

LEE'S SUMMIT, MISSOURI

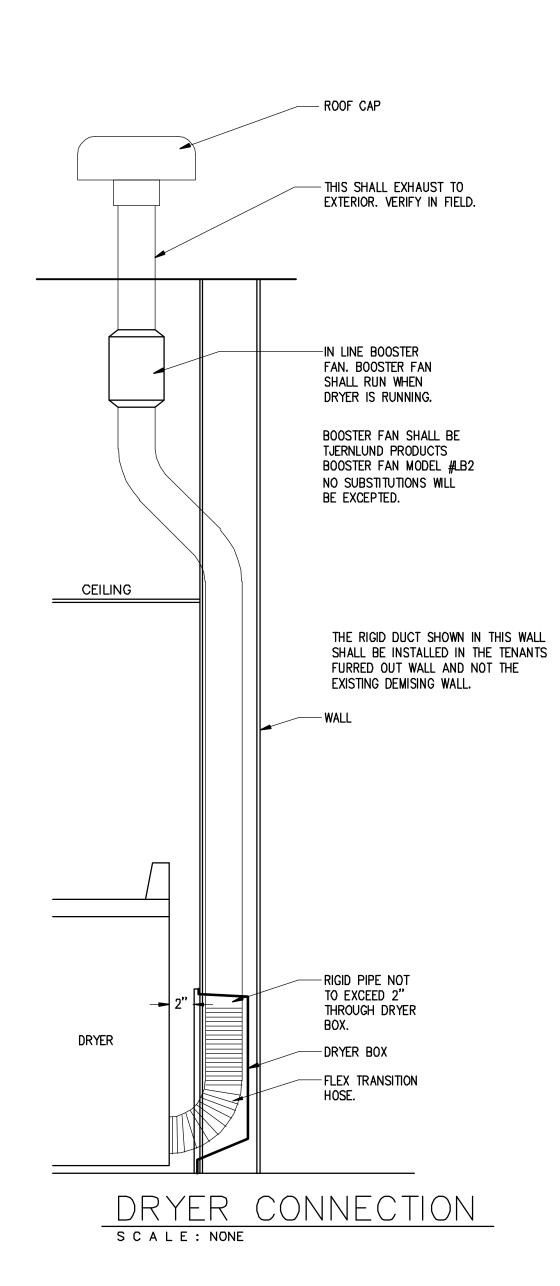

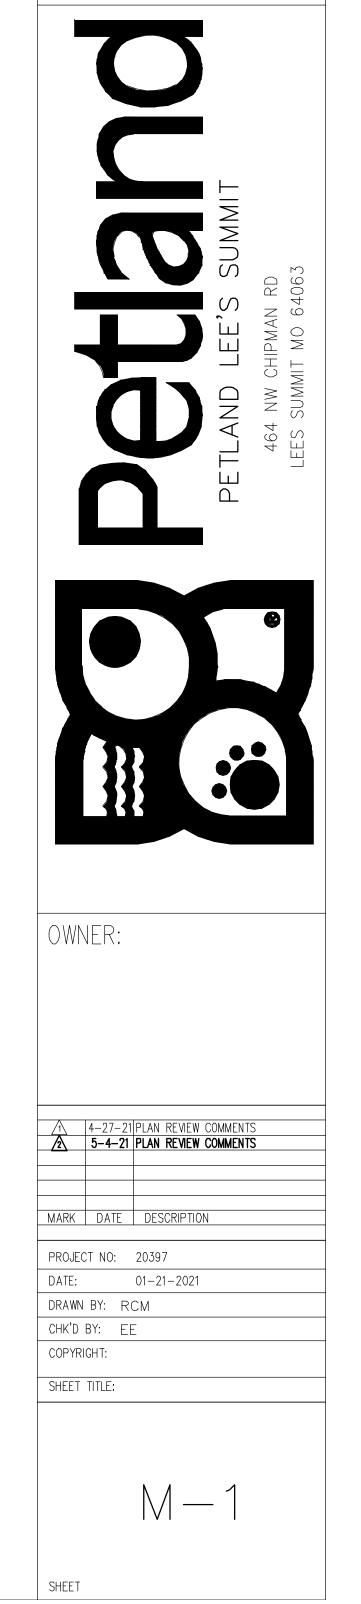

HVAC GENERAL NOTES:

- 1. CONTRACTOR SHALL PROVIDE ALL LABOR, MATERIALS, TOOLS AND EQUIPMENT TO INSTALL A COMPLETE AND OPERATING HEATING AND COOLING SYSTEM.
- 2. CONTRACTOR SHALL PROVIDE ALL REQUIRED HVAC PERMITS. 3. THE CONTRACTOR SHALL COMPLY WITH NFPA-90A AND ALL
- 4. ALL HVAC WORK TO BE PERFORMED SHALL BE IN COMPLIANCE WITH ALL STATE AND LOCAL CODES.
- 5. FLEXIBLE DUCT SHALL COMPLY WITH SMACNA, ALL LOCAL CODES, U.L. RATING, AND NOT EXCEED FIVE FEET IN LENGTH. SHEET METAL DUCT, WHERE REQUIRED BY LOCAL CODES, SHALL BE LINED WITH 1" MATT FACED DUCTLINER IN THE FIRST 10 (TEN) FEET OF THE RETURN AND SUPPLY DUCT STARTING FROM THE HVAC UNIT. AFTER THE FIRST 10 (TEN) FEET THE USE OF 1" DUCT WRAP SHALL BE ACCEPTABLE. WORK MATERIAL TO BE VERIFIED WITH CEILING ASSEMBLY RATING. FIBERGLASS DUCTBOARD DUCTWORK IS ACCEPTABLE. IF LOCAL CODES AND INSPECTION WILL ALLOW IT.
- 6. THE ELECTRICAL CONTRACTOR SHALL PROVIDE ALL SWITCHES, DISCONNECTS AND CONTROL WIRING.

APPLICABLE CODES.

- 7. ALL DUCT SIZES ARE CLEAR INSIDE DIMENSIONS, ALLOW FOR DUCT INSULATION. 8. THE CONTRACTOR SHALL PROVIDE A WRITTEN GUARANTEE THAT SHALL WARRANT ALL WORKMANSHIP AND MATERIALS FOR ONE (1) YEAR FROM THE FINAL WORK ACCEPTANCE BY THE OWNER AND A FIVE YEAR WARRANTY ON THE COMPRESSOR.
- 9. FILTERS SHALL BE OF THE DISPOSABLE TYPE AND HAVE INITIAL SHARE WEIGHT ARRESTANCE OF 10% AND A CLEAN PRESSURE DROP OF 0.15 WC. PROVIDE TWO SETS, ONE DURING CONSTRUCTION AND ONE FOR USE AFTER OCCUPANCY.

- 10. CONTRACTOR SHALL INSTALL ALL NECESSARY OFFSETS, BENDS, AND TRANSITIONS REQUIRED TO PROVIDE A COMPLETE SYSTEM AT NO ADDITIONAL COST TO THE OWNER.
- 1 1. COORDINATE LOCATION OF ALL CEILING DIFFUSERS, GRILLES AND REGISTERS IN THE FIELD WITH THE ELECTRICIAN TO PREVENT CONFLICT WITH LIGHTS AND ARCHITECTURAL ELEMENTS.
- 12. ALL WORK OF THIS TRADE SHALL BE COORDINATED WITH ALL OTHER TRADES TO AVOID ANY INTERFERENCES THAT MAY DELAY PROGRESS DURING CONSTRUCTION.
- 13. THE G.C MECHANICAL SUB-CONTRACTOR SHALL TEST AND BALANCE TO THE AIR QUANTITIES ON THE PLAN AND PROVIDE A T & B REPORT.
- 14. CONTRACTOR SHALL INSTALL THERMOSTAT IN ACCORDENCE WITH THERMOSTAT SPEC'S.
- 15. CONTRACTOR SHALL INSTALL MANUAL BALANCING DAMPERS AT ALL SUPPLY AIR BRANCH DUCTWORK RUN OUTS.

16. CONTRACTOR SHALL INSTALL TURNING VANES AT ALL DUCTWORK TEES AND 90

- 17. CONTRACTOR SHALL INSTALL A DUCT-TYPE MOUNTED SMOKE DETECTOR, FOR UNIT SHUTDOWN, IN THE RETURN AIR DUCTWORK PLENUM AT ROOFTOP UNITS. THE CONTRACTOR SHALL VERIFY THE COMPATIBLE TYPE OF DETECTION DEVICE TO USE WITH THE
- BUILDING OPERATIONS MANAGER. 18. ALL SHEET METAL DUCTWORK SHALL COMPLY WITH SMACNA STANDARDS. ALL
- DUCTWORK JOINTS SHALL BE TAPED AND SEALED. 19. CONTRACTOR SHALL PROVIDE EQUIPMENT OF THE SCHEDULED CAPACITIES DESIGNED.

PACKAGE ROOFTOP UNIT SCHEDULE (gas heat/elec. cool)												
MARK	MFG/MODEL	TONS	CFM	OUTSIDE AIR CFM	EER	ENTERING AIR CONDITIONS	COOLING CAPAC	CITY (MBH) SENSIBLE	HEATING CAF	PACITY (BTU) OUTPUT	ELECTRICAL VOLT / PH / HZ	REMARKS
RTU 1, 2 & 3	CARRIER 48HCDA06B2M5-DF1F0	5	2000	400	1 (/)	80 F DB / 67 F WB 9 95 F AMBIENT	60.4	48.0	50,000/ 72,000	41,000/ 56,000	208V / 3 / 60	1, 2, & 3

ACCESSORY OPTIONS: 1) ECONOMIZER 2) GRAVITY BACK DRAFT, 3) STANDARD CARRIER PACKAGE, 4) LOW HEAT MODEL, 5) HAIL GUARDS.

ADDITIONAL FEATURES TO PROVIDE ON UNIT:

1. AUTOMATIC HEATING/COOLING CHANGEOVER 2. LOW AMBIENT COOLING CAPACITY KIT WITH HAIL GAURDS

SUBSTITUTIONS WILL BE ALLOWED FOR THESE UNITS. SPEC SHEETS MUST BE SUBMITTED FOR APPROVAL. 3. ALL THERMOSTATS SHALL BE HONEYWELL TH8321WF1001

AND MOUNTED AT 48" A.F.F. ABSOLUTELY NO SUBSTITUTIONS.


	EXHAUST FAN SCHEDULE									
MARK	AREA SERVED	MANUFACTURER MODEL		CFM	E.S.P. ("W.C.)	MOTO WATTS	OR V/PH	BAROMETRIC DAMPER	ACCESSORIES	
EF-1	RESTROOM	GREENHECK	SP-A90	80	1/4"	30	120/1	YES	GRAVITY DAMPER	
EF-2	KENNEL SUPPORT	GREENHECK	SP-A190	150	1/4"	113	120/1	YES	1,2,3,4,5,6,7,8,9	
EF-3	KENNEL SUPPORT	GREENHECK	SP-A290	250	1/4"	81	120/1	YES	1,2,3,4,5,6,7,8,9	
EF-4	KENNEL	LOREN COOK	SCED-135C11D	1500	1/4"	528	120/1	YES	1,2,3,4,5,6,7,8,9	


ACCESSORIES


- 1 DISCONNECT 2 - ROOF MOUNTED
- 4 RAIN CAP 5 - GRAVITY BACK PRESSURE DAMPER
- 6 CONSTANT ON FAN 3 - ROOF CURB
 - MAGNETIC STARTER (BY G.C) 8 - ON/OFF SWITCH

PLUMBER TO PROVIDE AN INDIRECT WASTE OPENING TO WITHIN 2'-0" OF COOLING COILS AND EVAPORATORS FOR CONDENSATE. THIS INDIRECT WASTE LINE SHALL BE 1 1/4" DWV MIN., TRAPPED, VENTED AND RUN TO HOUSE SIDE OF ACTIVE TRAP AS PER SECTION #314 AMENDED. A MEMPHIS PATTERN DEEP SEAL TRAP CAN BE USED IN LIEU OF ACTIVE TRAP. THIS 12" DEEP SEAL TRAP, WITH CLEAN OUTS PLACED DIRECTLY ON TOP OF EACH LEG OF SAID TRAP, CAN CONNECT TO A SINGLE VERTICAL VENT RISER WITH NO OFFSETS OR OTHER VENT TIE BACKS BELOW THIS POINT. THIS WILL ALSO INCLUDE ALL THE ROOF TOP UNITS.


	GRILLE, I	REGISTER	& DIF	FUSER S	SCHED	ULE	
MARK	MATERIAL	DEVICE SIZE	CFM RANGE MIN/MAX	INLET SIZE	AIR PATTERN	MOUNTING	TYPE
S-1	PAINTED STEEL	24" x 24"	0/100	6"	4-WAY	LAY-IN	SUPPLY
S-2	PAINTED STEEL	24" × 24"	100/175	8"	4-WAY	LAY-IN	SUPPLY
S-3	PAINTED STEEL	24" × 24"	175/275	10"	4-WAY	LAY-IN	SUPPLY

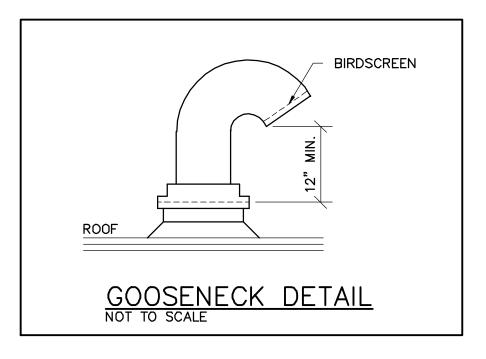

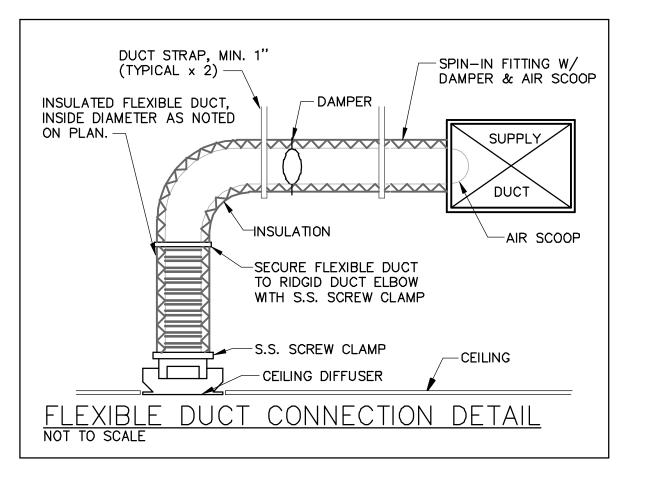


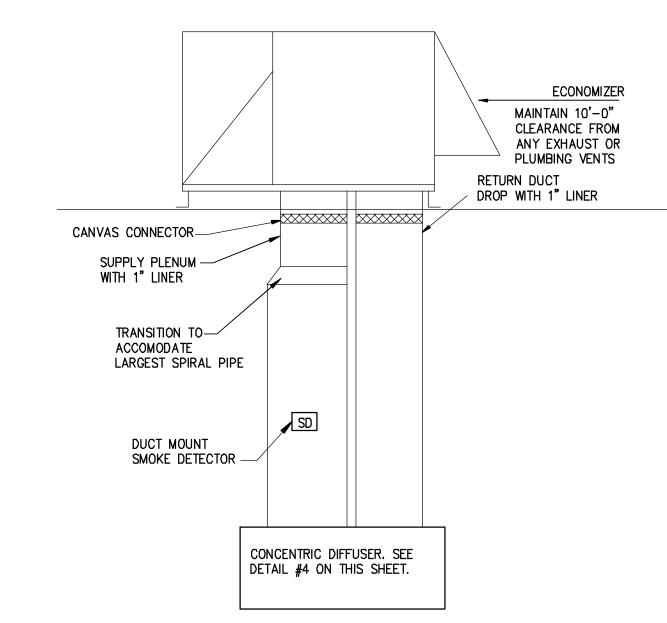

DUCT FROM CONCENTRIC PACKAGE DETAIL SCALE: NTS

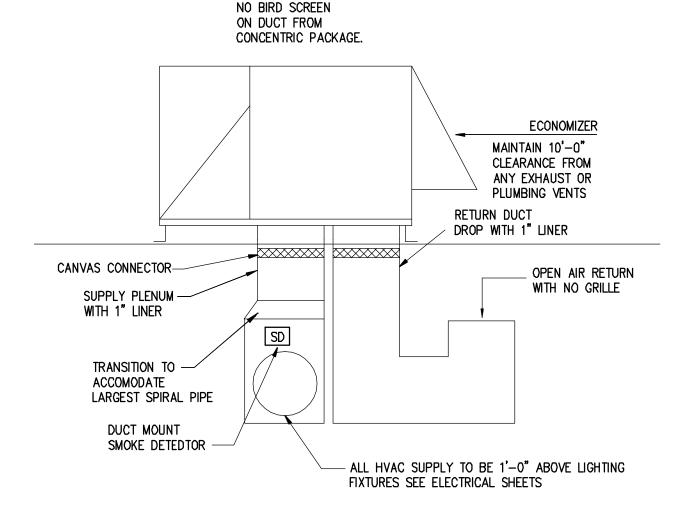

RETURN DUCT DETAIL FOR OPEN RETURN S C A L E : N.T.S.

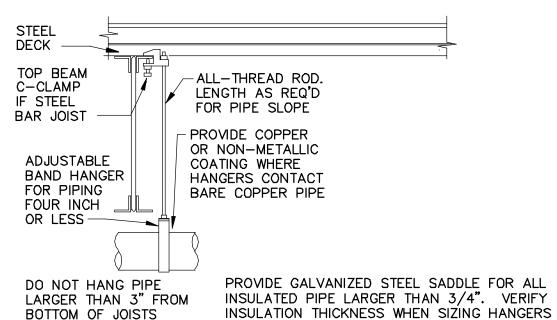


PROVIDE UPPER ATTACHMENT AS REQUIRED FOR CASES NOT SHOWN HERE. DO NOT INSTALL HANGER INSIDE INSULATION OR OTHERWISE PENETRATE VAPOR BARRIER. DO NOT HANG ONE PIPE FROM ANOTHER EXCEPT IN CHASES. TRAPEZE HANGERS MAY BE USED FOR MULTIPLE PARALLEL PIPES. HANGER SPACING FOR PIPE SIZE: COPPER: 4"=12'; 3"=11'; 2-1/2"=10'; 2"=9'; 1-1/2"=8'; 1-1/4"=7'; 1"=6'; 3/4"=6'; 1/2"=5'. CAST IRON: 10' AND ONE NEAR ALL JOINTS. STEEL: 4"=14'; 3"=12'; 2-1/2"=11'; 2"=10' 1-1/2"=9'; 1"=7'; 3/4"=6'; 1/2"=5'. LOCATE HANGERS AS CLOSE AS POSSIBLE TO TURNS AND TEES OF PIPE. PROVIDE SUPPLEMENTARY STEEL STRUTS BETWEEN JOISTS IF REQUIRED. LOCATE HANGERS TO TAKE LOAD OFF OF EQUIPMENT CONNECTIONS. ANCHOR WATER PIPE AGAINST SWAYING DUE TO CHANGES IN WATER VELOCITY. PROVIDE SEISMIC BRACING IF/AS REQUIRED BY LOCAL AUTHORITIES. CHAINS OR PERFORATED STRAP IRON OR STEEL IS NOT ACCEPTABLE. REFER TO CODES AND SPECS FOR FURTHER INFORMATION.

PIPE HANGER

S C A L E: N.T.S.

SUPPLY AND RETURN TRANSITION, CONNECTING RTU'S TO CONCENTRIC DIFFUSER, SHALL BE WITH INSULATED METAL. CONCENTRIC AND CONNECTED TRANSITION SHALL BE PAINTED BLACK TO MATCH CEILING.

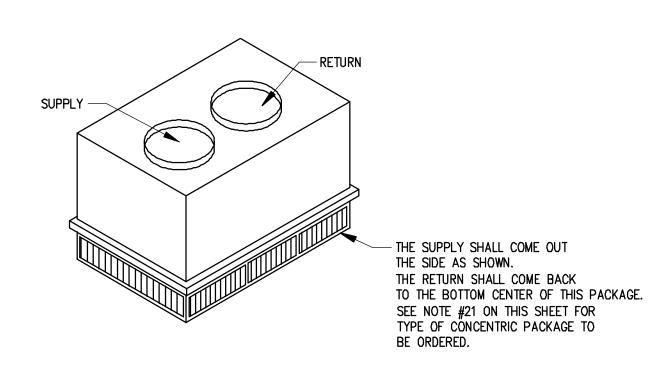

CONCENTRIC PACKAGE DETAIL

NOTES:

SPRINKLER NOTE:

ANY CHANGE TO THE EXISTING SPRINKLER SHALL

BE DONE BY A LANDLORD APPROVED SPRINKLER

DESIGN WILL BE SUBMITTED UNDER SEPARATE

CONTRACTOR, AT TENANTS EXPENSE. ALL SPRINKLER

SUBMITTAL BY A LICENSED SPRINKLER CONTRACTOR

WHICH WILL SUBMIT SHOP DRAWINGS FOR APPROVAL.

G.C. SHALL THE PLANS AND SUBMIT FOR PERMITTING.


SCALE: NTS

ROOF WORK AND REFLASHING FOR HVAC EQUIPMENT, PLUMBING VENTS, PENETRATIONS, ETC., SHALL BE PROVIDED BY A LANDLORD APPROVED ROOFING CONTRACTOR ONLY. TENANT'S CONTRACTOR SHALL CONTACT LANDLORD REGARDING THE MEANS OF TOILET EXHAUST. IF THE TOILET IS TO BE VENTED ELSEWHERE IT WILL BE BY THE CONTRACTOR. TO A LOCATION APPROVED BY THE LANDLORD, WITHOUT ANY ADDITIONAL EXPENSE TO THE TENANT.

LEE'S SUMMIT, MISSOURI

RELEASE FOR CONSTRUCTION AS NOTED ON PLANS REVIEW



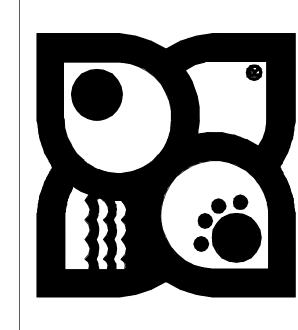


OWNER:

1 4-27-21 PLAN REVIEW COMMENT 5-4-21 PLAN REVIEW COMMENTS MARK DATE DESCRIPTION PROJECT NO: 20397 01-21-2021 DRAWN BY: RCM CHK'D BY: EE COPYRIGHT: SHEET TITLE:

M-2


PLUMBING SYMBOL LEGEND _____ - ____CW ___ - ___ COLD WATER (CW) ----- TFW ----- TEMPERED FILTERED WATER SHUT-OFF VALVE CHECK VALVE

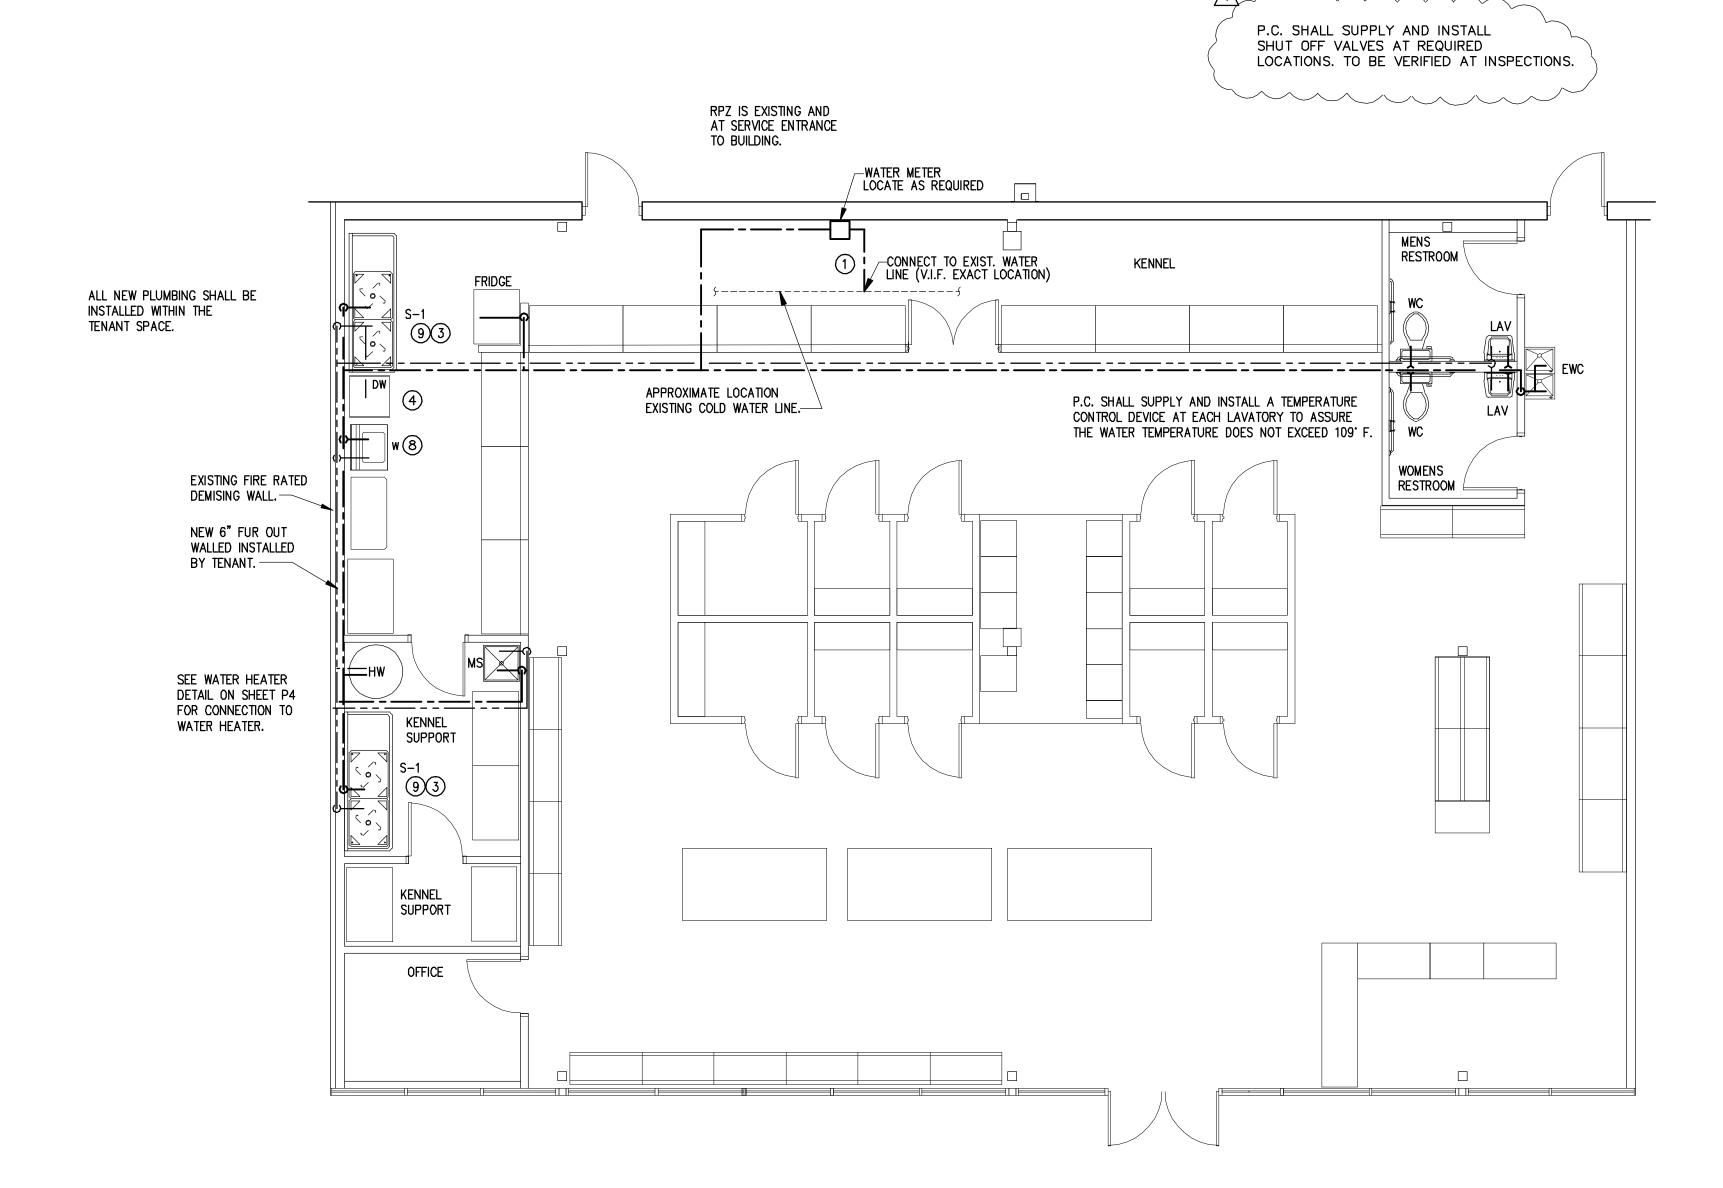

DOMESTIC WATER PLAN

GENERAL PLUMBING NOTES


- EXAMINATION OF CONTRACT DOCUMENTS AND SITE WORK, THE BIDDER IS REQUIRED, BEFORE SUBMITTING HIS/HER PROPOSAL, TO VISIT THE PROPOSED WORK AND FAMILIARIZE HIM/HERSELF WITH THE NATURE AND EXTENT OF THE WORK AND ANY LOCAL CONDITIONS THAT MAY IN ANY MANNER AFFECT THE WORK TO BE DONE AND EQUIPMENT MATERIAL AND LABOR REQUIRED. THEREFORE, SINCE THE WORK INVOLVES EXISTING BUILDINGS, SYSTEMS AND FACILITIES, SPECIAL CONSIDERATION SHALL BE GIVEN TO THE EXAMINATION OF WORKING CONDITIONS, EXISTING FACILITIES AND ALL BUILDING STRUCTURES TO FAMILIARIZE HIMSELF/ HERSELF WITH ALL EXISTING CONDITIONS. SLIGHT VARIATION OF ROUTING AND/OR CONSTRUCTION (SHOULD BE ANTICIPATED BY THIS CONTRACTOR) TO AVOID CONFLICTS WITH OTHER TRADES, ARE EXPRESSLY INCLUDED AS PART OF THE WORK WHENEVER REQUIRED AT NO ADDITIONAL COST TO THE OWNER. NEGLIGENCE ON THE PART OF THE CONTRACTOR WILL IN NO WAY RELIEVE HIM/HER OF THE OBLIGATION AND RESPONSIBILITIES ASSUMED UNDER THIS CONTRACT.
- C.W. & H.W. PIPING SHALL BE COPPER TYPE 'M' ABOVE GRADE, TYPE 'K' BELOW GRADE, WITH 1" THICK FOAM INSULATION WITH VAPOR BARRIER AND ASJ JACKET. PEX WILL BE AN APPROVED EQUAL.
- WASTE AND VENT LINES SHALL BE CAST IRON NO-HUB ABOVE GROUND, PUSH-ON JOINT WITH NEOPRENE GASKET UNDERGROUND. PVC MAY BE USED WHERE APPROVED BY CODE.
- 4. INSULATE P-TRAP LINE AND WATER LINES UNDER TOILET ROOM LAVATORY IN ACCORDANCE WITH A.D.A. GUIDELINES.
- PROVIDE A WATER HAMMER ARRESTOR AT EVERY QUICK CLOSURE VALVE OR FAUCET.
- PROVIDE SHUT OFF VALVES AT EACH PLUMBING FIXTURE WATER SUPPLY.
- CONTRACTOR SHALL COORDINATE ALL WORK WITH OTHER TRADES.
- 8. ALL PLUMBING PIPING SHALL BE PRESSURE TESTED AND CHLORINATED.
- 9. CONTRACTOR SHALL PAY ALL FEES AND RELATED CHARGES FOR PERMITS, LICENSES, ETC. REQUIRED FOR INSTALLATION OF PLUMBING
- 10. CONTRACTOR SHALL PROVIDE SHOP DRAWINGS FOR ALL FIXTURES

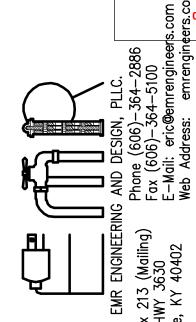

RELEASE FOR CONSTRUCTION
AS NOTED ON PLANS REVIEW DEVELOPMENT SERVICES LEE'S&UMMIT, MIS\$OURI





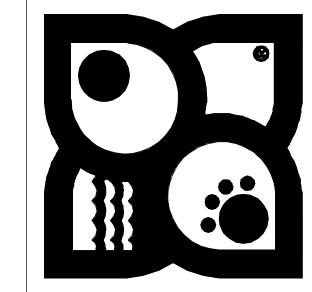


OWNER:

PLUMBING CODED NOTES:

- 1) NEW DOMESTIC WATER SERVICE WITH SHUT OFF FROM EXISTING METER.
- 2 EXTEND SANITARY SEWER TO EXISTING SEWER LINE. PC TO VERIFY SIZE & LOCATION IN THE FIELD PRIOR TO START OF WORK. VERIFY SEWER IS ACTIVE PRIOR TO CONNECTING.
- INSTALL AND MAKE FINAL CONNECTIONS TO KENNEL SINK FURNISHED BY FIXTURE CONTRACTOR. PROVIDE VACUUM BREAKER ON WALL FOR FAUCET AS NOTED ON DETAIL. SEE KENNEL SINK AND DISPOSAL CONNECTION DETAIL ON DWG. P-4.
- ROUTE PIPING DOWN INSIDE WALL TO POINT OF CONNECTION TO DISHWASHER. PROVIDE SHUT OFF VALVE. EXTEND DISHWASHER DRAIN TO WYE DRAIN CONNECTION ON TAILPIECE OF KENNEL SINK.
- (5) PROVIDE 1/4" TURN BALL VALVE 3/4" WITH 3/4" NIPPLE AT 1'-8" A.F.F. FOR EACH CONNECTION
- (6) PEX PIPING MAY BE USED INSTEAD OF COPPER PROVIDED THE LOCAL JURISDICTION WILL APPROVE IT.
- GUY GRAY WASHING MACHINE SUPPLY AND DRAIN FIXTURE NO. NWBBED200TS, WITH TOP WATER SUPPLIES AND 2" DRAIN, FURNISHED AND INSTALLED BY P.C.
- GARBAGE DISPOSAL IN-SINK-ERATOR 444, 3/4 HP STAINLESS STEEL GRIND ELEMENTS, 120V-1
- PHASE, 8.1 AMPS. FURNISHED AND INSTALLED BY P.C.

5-4-21 PLAN REVIEW COMMENTS MARK DATE DESCRIPTION PROJECT NO: 20397 01-21-2021 DRAWN BY: RCM CHK'D BY: EE COPYRIGHT: SHEET TITLE:

14-27-21|PLAN REVIEW COMMENT

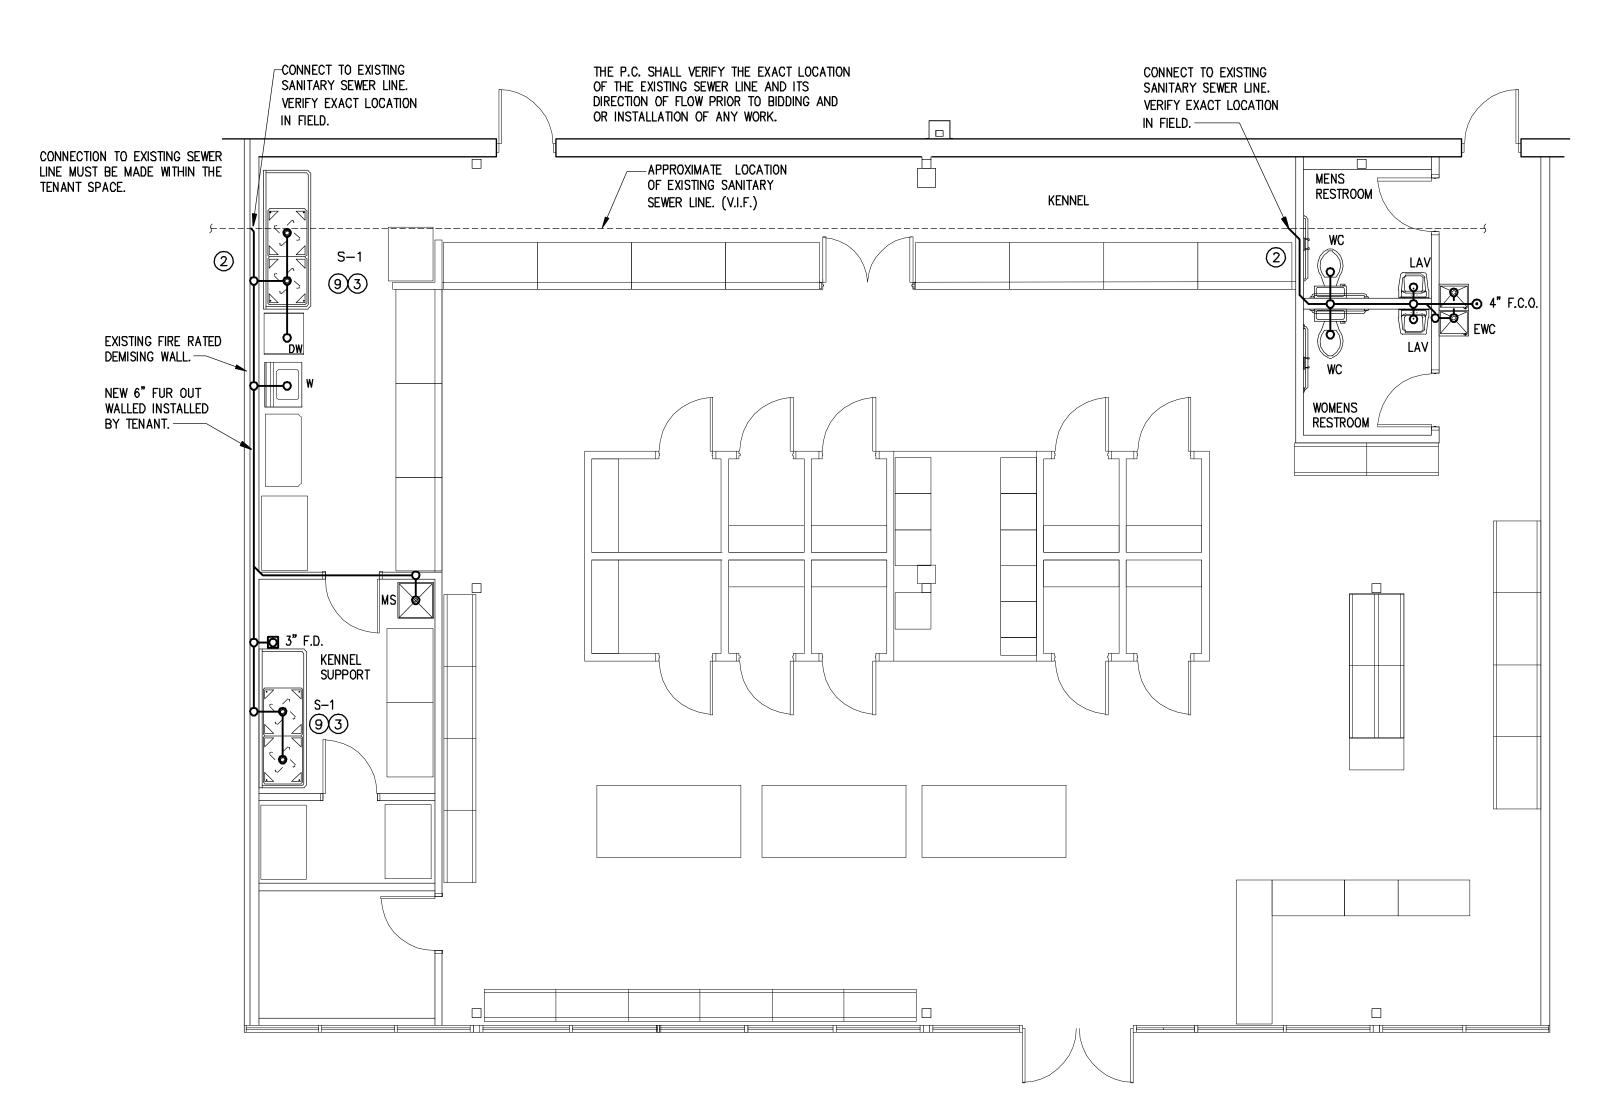


SANITARY SEWER PLAN

s c a l e: 3/16" = 1'-0"

GENERAL PLUMBING NOTES


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- I. INSULATE P-TRAP LINE AND WATER LINES UNDER TOILET ROOM LAVATORY IN ACCORDANCE WITH A.D.A. GUIDELINES.
- 5. PROVIDE A WATER HAMMER ARRESTOR AT EVERY QUICK CLOSURE VALVE OR FAUCET.
- PROVIDE SHUT OFF VALVES AT EACH PLUMBING FIXTURE WATER SUPPLY.
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RELEASE FOR
CONSTRUCTION
AS NOTED ON PLANS REVIEW

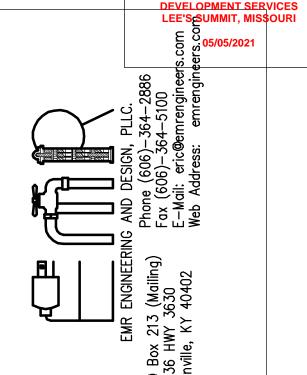


PETLAND LEE'S SUMMIT
464 NW CHIPMAN RD



PLUMBING CODED NOTES:

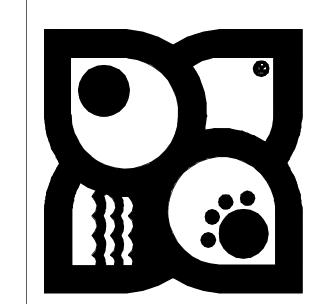- 1 NEW 1 1/4" DOMESTIC WATER SERVICE WITH SHUT OFF FROM EXISTING METER.
- EXTEND SANITARY SEWER TO EXISTING SEWER LINE. PC TO VERIFY SIZE & LOCATION IN THE FIELD PRIOR TO START OF WORK. VERIFY SEWER IS ACTIVE PRIOR TO CONNECTING.
- ROUTE PIPING DOWN INSIDE WALL TO POINT OF CONNECTION TO DISHWASHER. PROVIDE SHUT OFF VALVE. EXTEND DISHWASHER DRAIN TO WYE DRAIN CONNECTION ON TAILPIECE OF KENNEL SINK.
- 5 NOT USED
- 6 NOT USED
- 7 PROVIDE VACUUM BREAKER ON WALL FOR FAUCET AS NOTED ON DETAIL, SEE KENNEL SINK AND DISPOSAL
- B GUY GRAY WASHING MACHINE SUPPLY AND DRAIN FIXTURE NO. NWBBED200TS, WITH TOP WATER SUPPLIES AND 2" DRAIN, FURNISHED AND INSTALLED BY P.C.
- GARBAGE DISPOSAL IN-SINK-ERATOR 444, 3/4 HP STAINLESS STEEL GRIND ELEMENTS, 120V-1 PHASE, 8.1 AMPS. FURNISHED AND INSTALLED BY P.C.

P-2

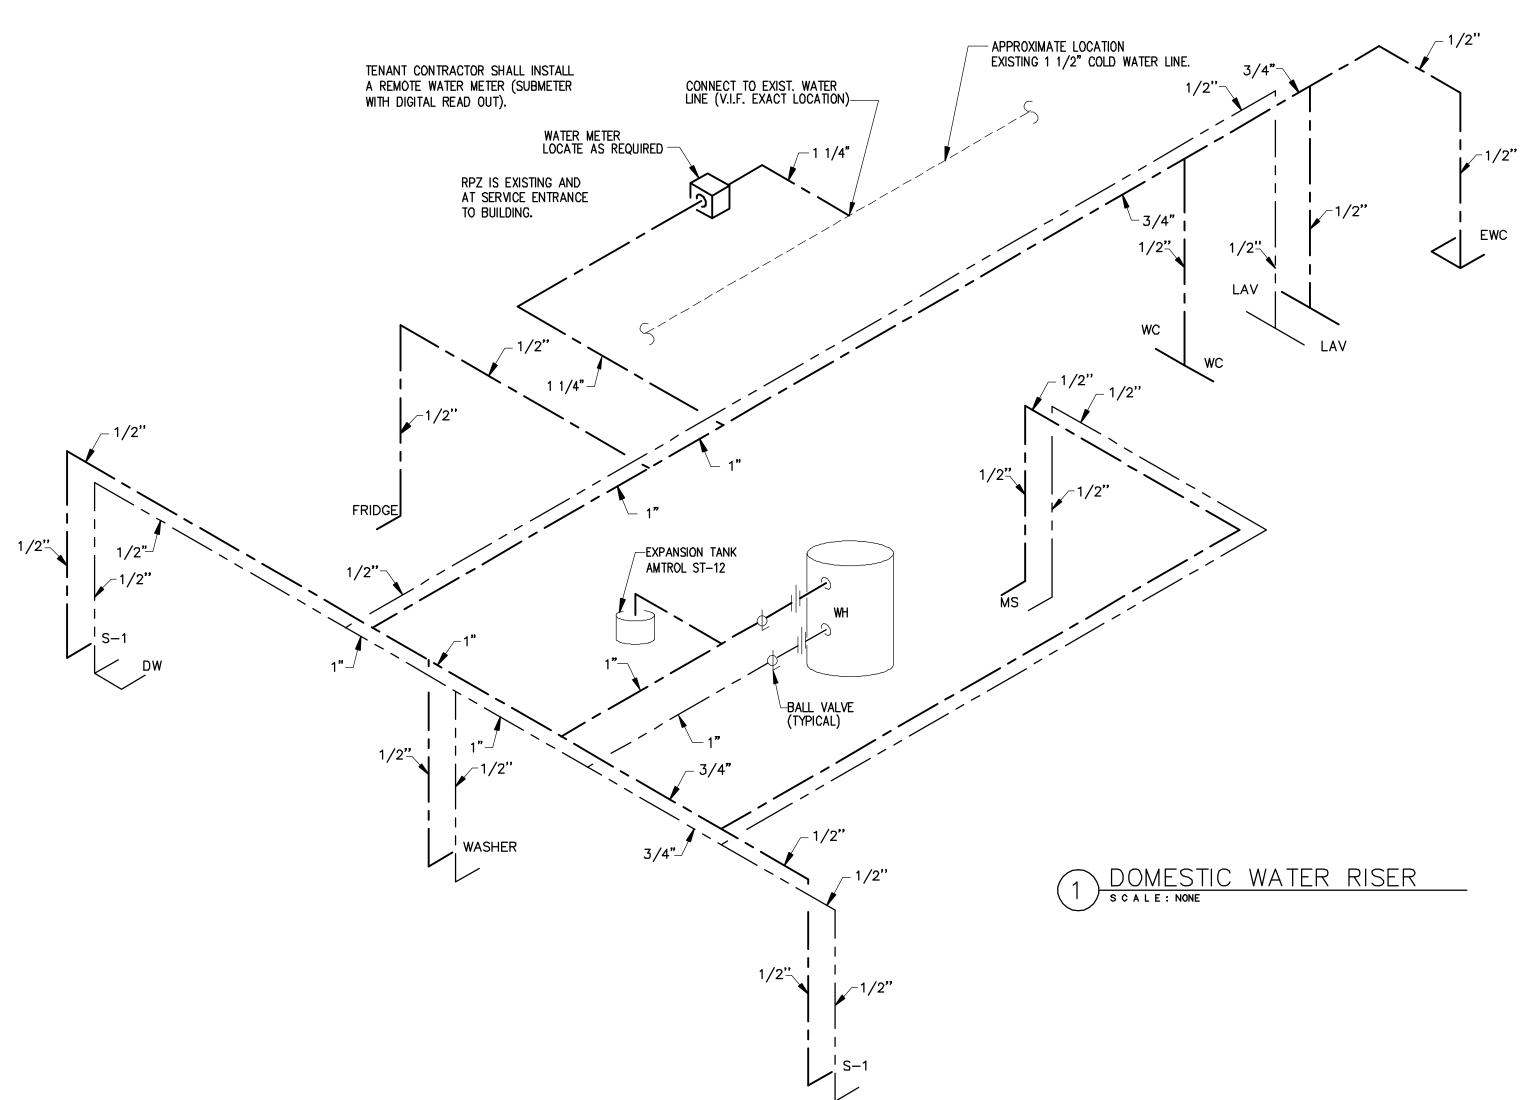





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- 8. ALL PLUMBING PIPING SHALL BE PRESSURE TESTED AND CHLORINATED.
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- 10. CONTRACTOR SHALL PROVIDE SHOP DRAWINGS FOR ALL FIXTURES AND EQUIPMENT.

PLUMBING SYMBOL LEGEND




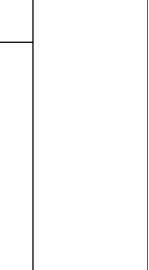

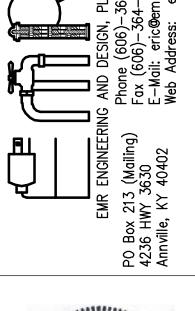RELEASE FOR
CONSTRUCTION
AS NOTED ON PLANS REVIEW



PETLAND LEE'S SUMMIT
464 NW CHIPMAN RD

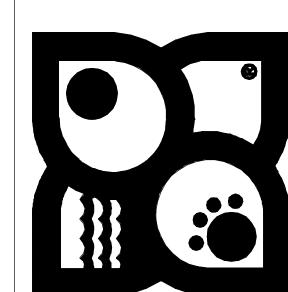


I OWNER:

		PLAN REVIEW COMMENTS
<u>/2\</u>	5-4-21	PLAN REVIEW COMMENTS
MARK	DATE	DESCRIPTION
PROJEC	CT NO:	20397
DATE:		01-21-2021
DRAWN	BY: R	CM
CHK'D	BY: EE	
CHIND		


P - 3

SHEET


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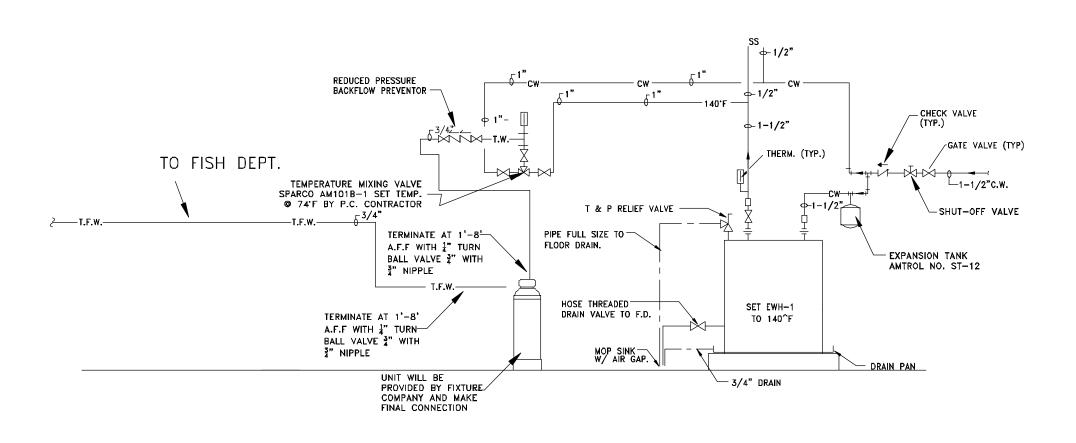
				۲	LOMBIN	NG FIXTURE SCHEDULE
MARK	FIXTURE	C.W.	H.W.	SAN	VENT	
WC	WATER CLOSET	1/2"		4"	2"	AMERICAN STANDARD CADET NO. 2998.012 FLOOR MOUNTER TANK TYPE SIPHON JET WITH WHITE OPEN FRONT COMMERCIAL GRADE SEAT WITH CHECK HINGE. TANK LEVER SHALL BE ON WIIDE SIDE OF TOILET AREA
LAV	LAVATORY	1/2"	1/2"	1-1/2"	1-1/2"	AMERICAN STANDARD LUCERNE NO. 0355.012 WALL HUNG WITH NO. 2385.403 (0.5 G.P.M.) SINGLE LEVER FAUCET, WITH GRID DRAIN AND TAILPIECE, MOUNTED AT HANDICAPPED HEIGHT. INSULATE HOT WATER, COLD WATER, AND SANITARY PIPING BELOW LAV WITH TRUEBRO INSULATION.
S-1	SINK	1/2"	1/2"	3"	1-1/2"	KENNEL SINK SUPPLIED BY PETLAND AND INSTALLED BY PLUMBING CONTRACTOR
EWC	WATER COOLER	1/2"		1-1/2"	1-1/2"	BARRIER FREE, SPLIT LEVEL WATER COOLER (ADA COMPLIANT) 8.0 GPH, 1/5 HP, 120/1/60, COLOR BY PETLAND
W	WASHER	1/2"	1/2"	1 1/2"	1-1/2"	MODEL #T.B.D.
D	DRYER			1 1/2"	1-1/2"	MODEL #T.B.D.
FD	FLOOR DRAIN			3"	1-1/2''	ZURN MODEL #FD2210-PV4
WH	GAS WATER HEATER	1"	1"	4"	4"	STATE MODEL NO. AOSMITH, CYCLONE—BTH199 80 GAL., 199,000 BTU'S ASME RATED T & P RELIEF VALVE
FCO	FLOOR CLEANOUT			4"		ZURN MOD. #Z-1400 ADJUSTABLE TYPE FURNISH WITH NICKEL BRONZE SCORITATED TOP

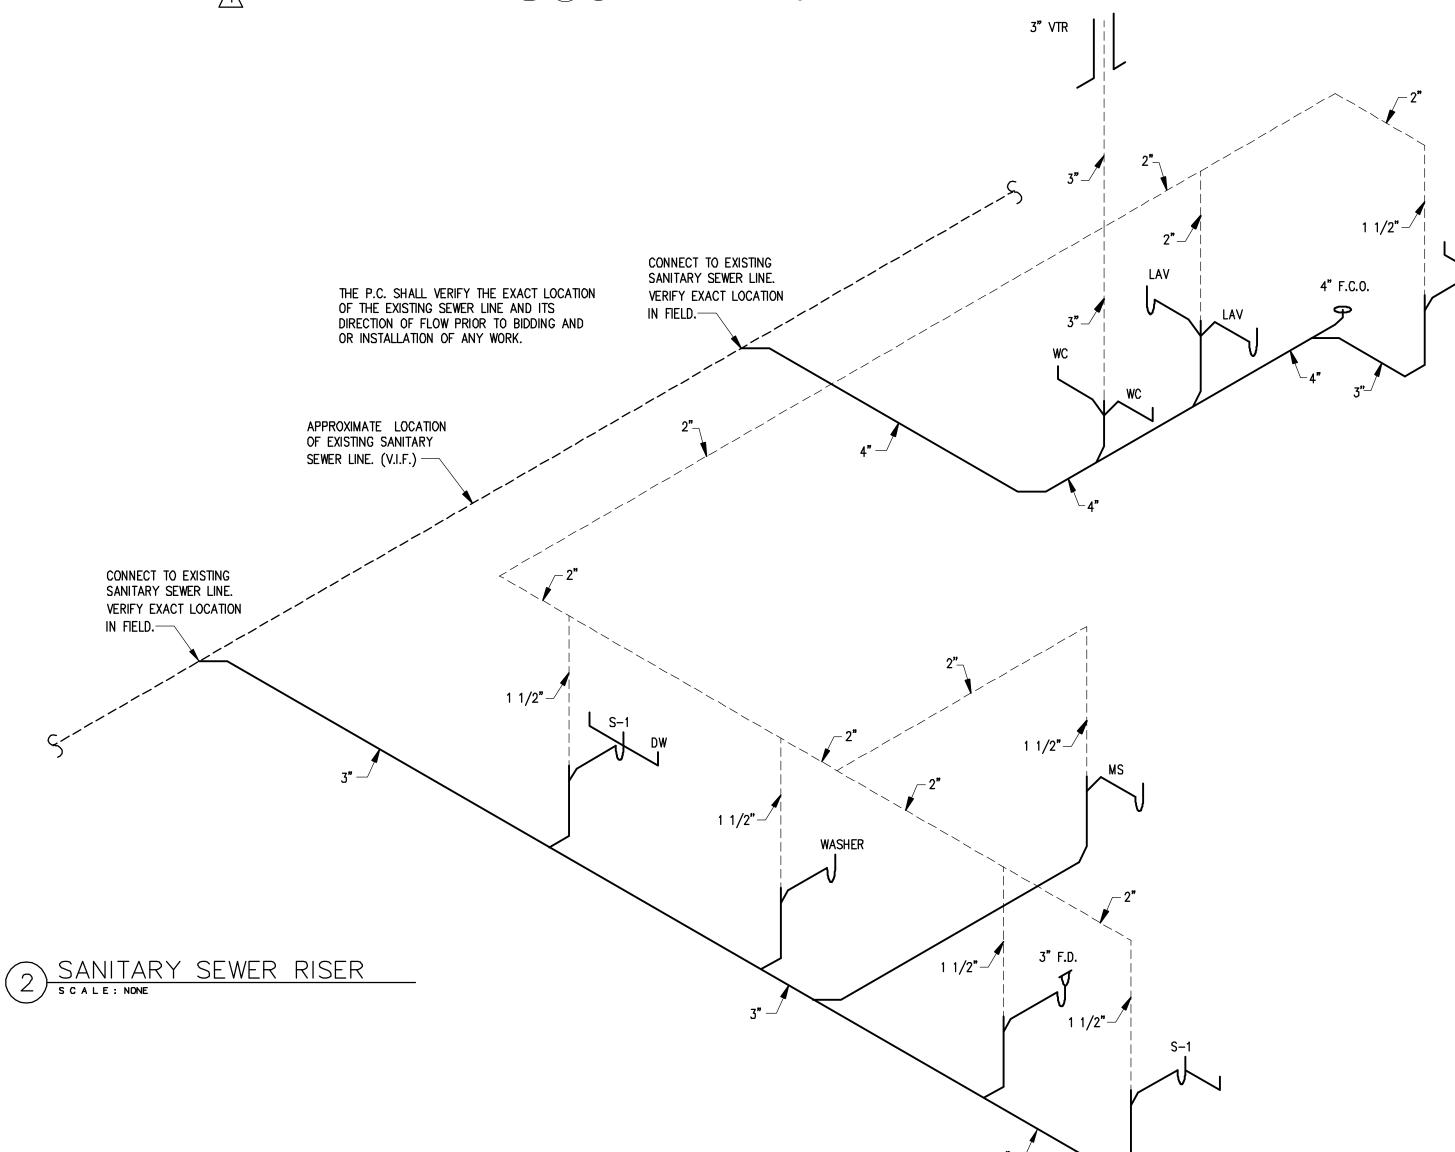


ROOFTOP GAS AND CONDENSATE DETAIL

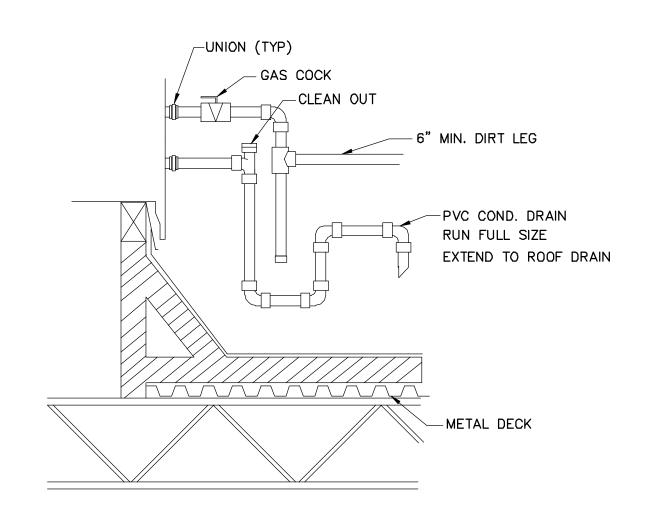



KENNEL SINK/DISPOSAL CONNECTION DETAIL s c a l e : nts

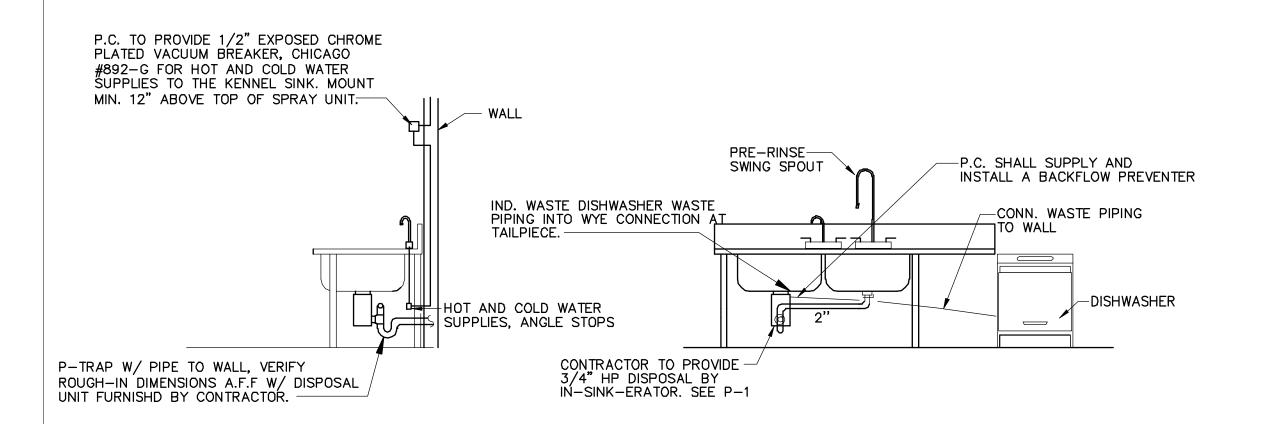


WATER PIPING RISER

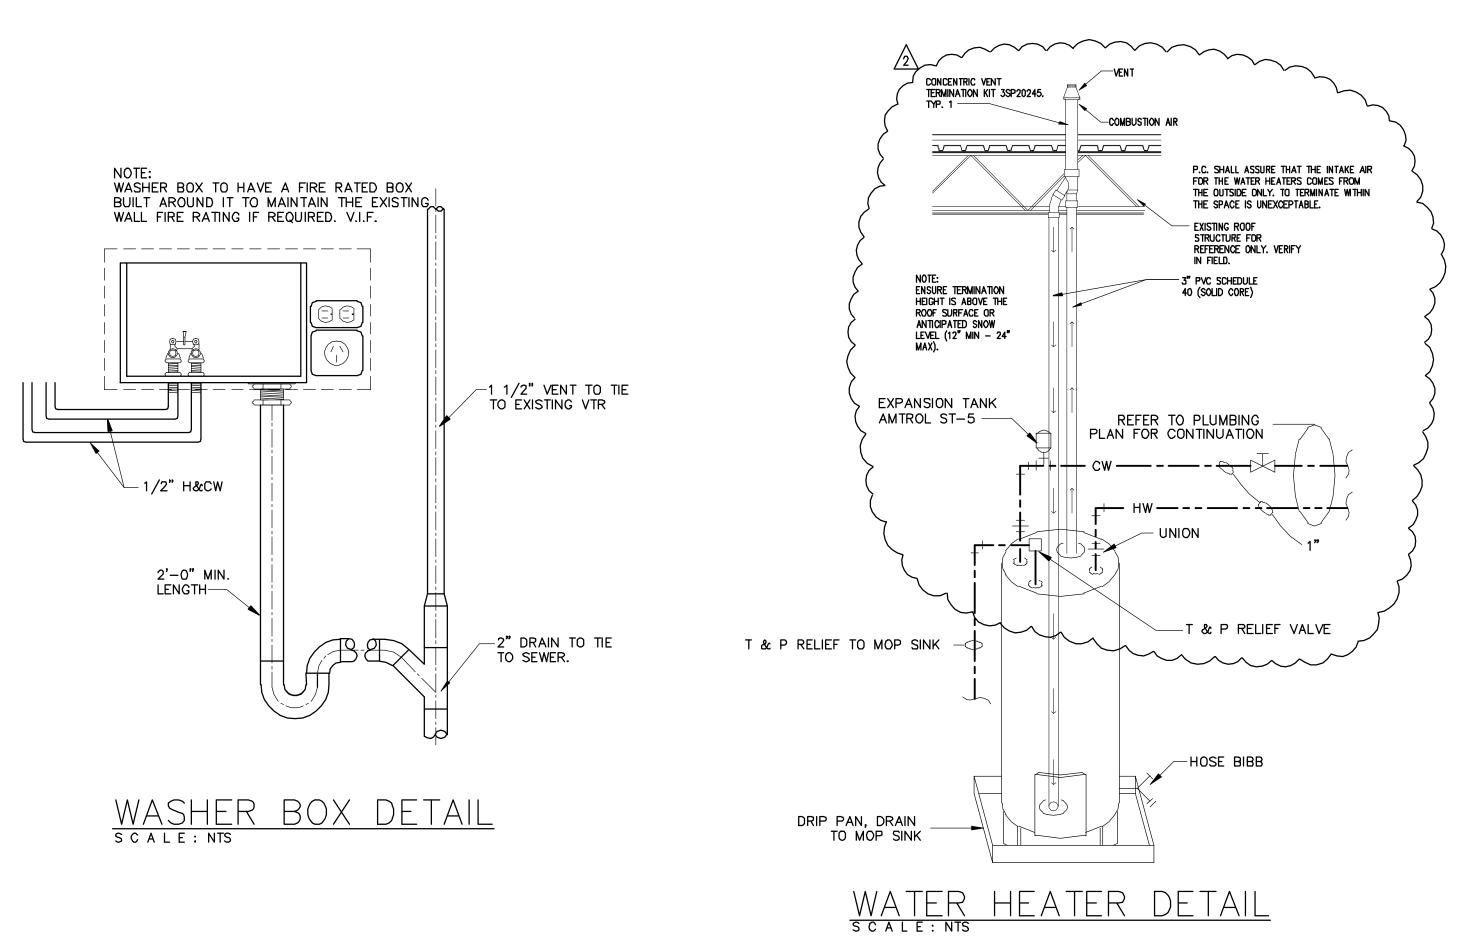

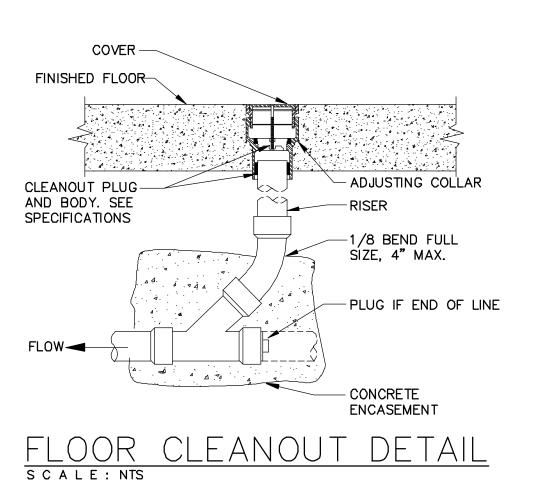


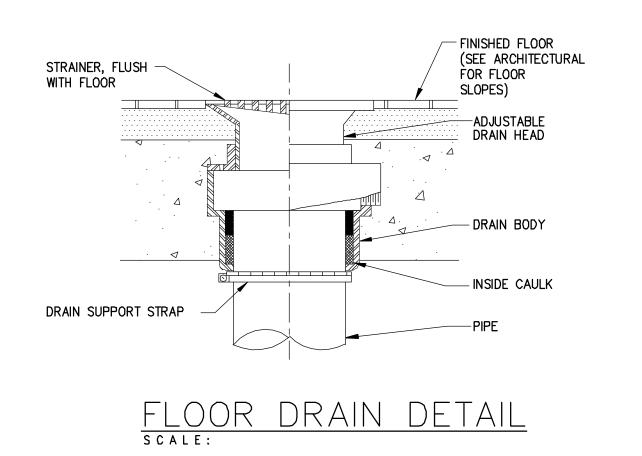

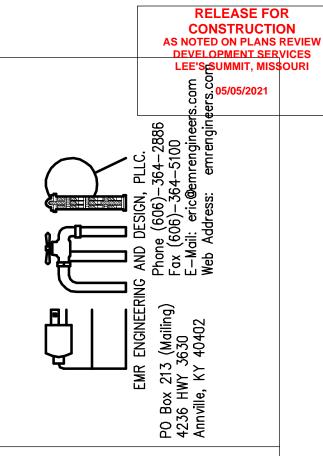






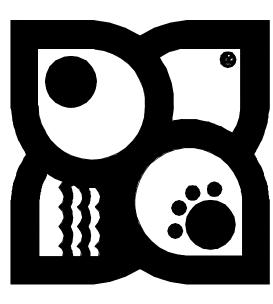

OWNER:

1	4-27-21	PLAN REVIEW COMMENTS
<u> </u>	5-4-21	PLAN REVIEW COMMENTS
MARK	DATE	DESCRIPTION
PROJEC	CT NO:	20397
DATE:		01-21-2021
DRAWN	BY: R	CM
CHK'D	BY: EE	- -
COPYRI	GHT:	
SHEET	TITLE:	
		P_1

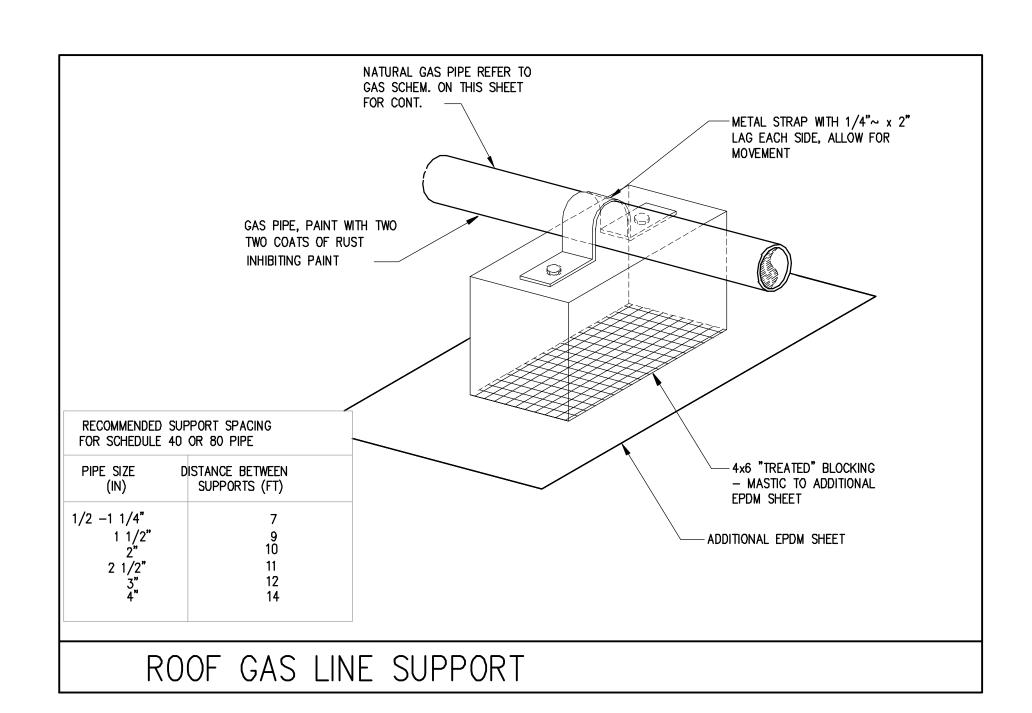


EXTEND 3/4" PVC CONDENSATE LINE FROM ROOFTOP UNIT TO NEAREST ROOF DRAIN.

RUN GAS PIPING ON TREATED BLOCKS PER SCHED. CLAMP PIPING TO BLOCKS.

P.C. TO UPGRADE GAS METER IF EXISTING IS NOT RATED FOR THE ADDITIONAL LOAD. VERIFY IN FIELD


ALL GAS EQUIPMENT SHALL BE CONNECTED TO MAIN WITH SIZE REQUIRED PER MANUFACTURER RECOMMENDATIONS.

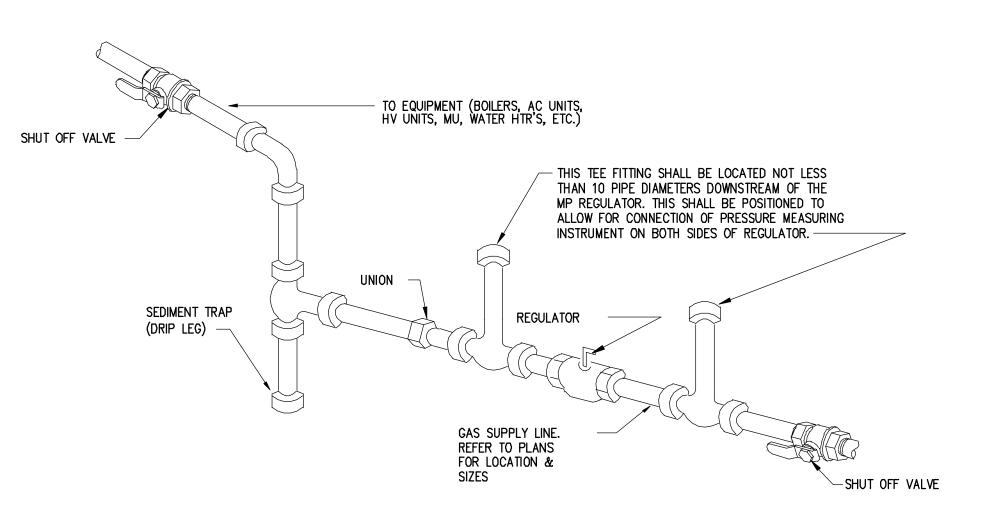

TYPICAL GAS PIPING CONNECTION DETAIL FOR THE INSTALLATION OF PRESSURE REGULATORS S C A L E: NONE

> IF MEDIUM OR GREATER PRESSURE EXISTS AND PRESSURE REGULATORS ARE REQUIRED, THE P.C. SHALL SUPPLY AND INSTALL A VENT TO THE EXTERIOR OR A VENT LIMITING DEVICE FOR ALL MEDIUM PRESSURE REGULATORS LOCATED WITHIN THIS SPACE. V.I.F.

NOTES: ROOF WORK AND REFLASHING FOR HVAC EQUIPMENT, PLUMBING VENTS, PENETRATIONS, ETC., SHALL BE PROVIDED BY A LANDLORD APPROVED ROOFING CONTRACTOR ONLY. TENANT'S CONTRACTOR SHALL CONTACT LANDLORD REGARDING THE MEANS OF TOILET EXHAUST. IF THE TOILET IS TO BE VENTED ELSEWHERE IT WILL BE BY THE CONTRACTOR. TO A LOCATION APPROVED BY THE LANDLORD, WITHOUT ANY ADDITIONAL EXPENSE TO THE TENANT.

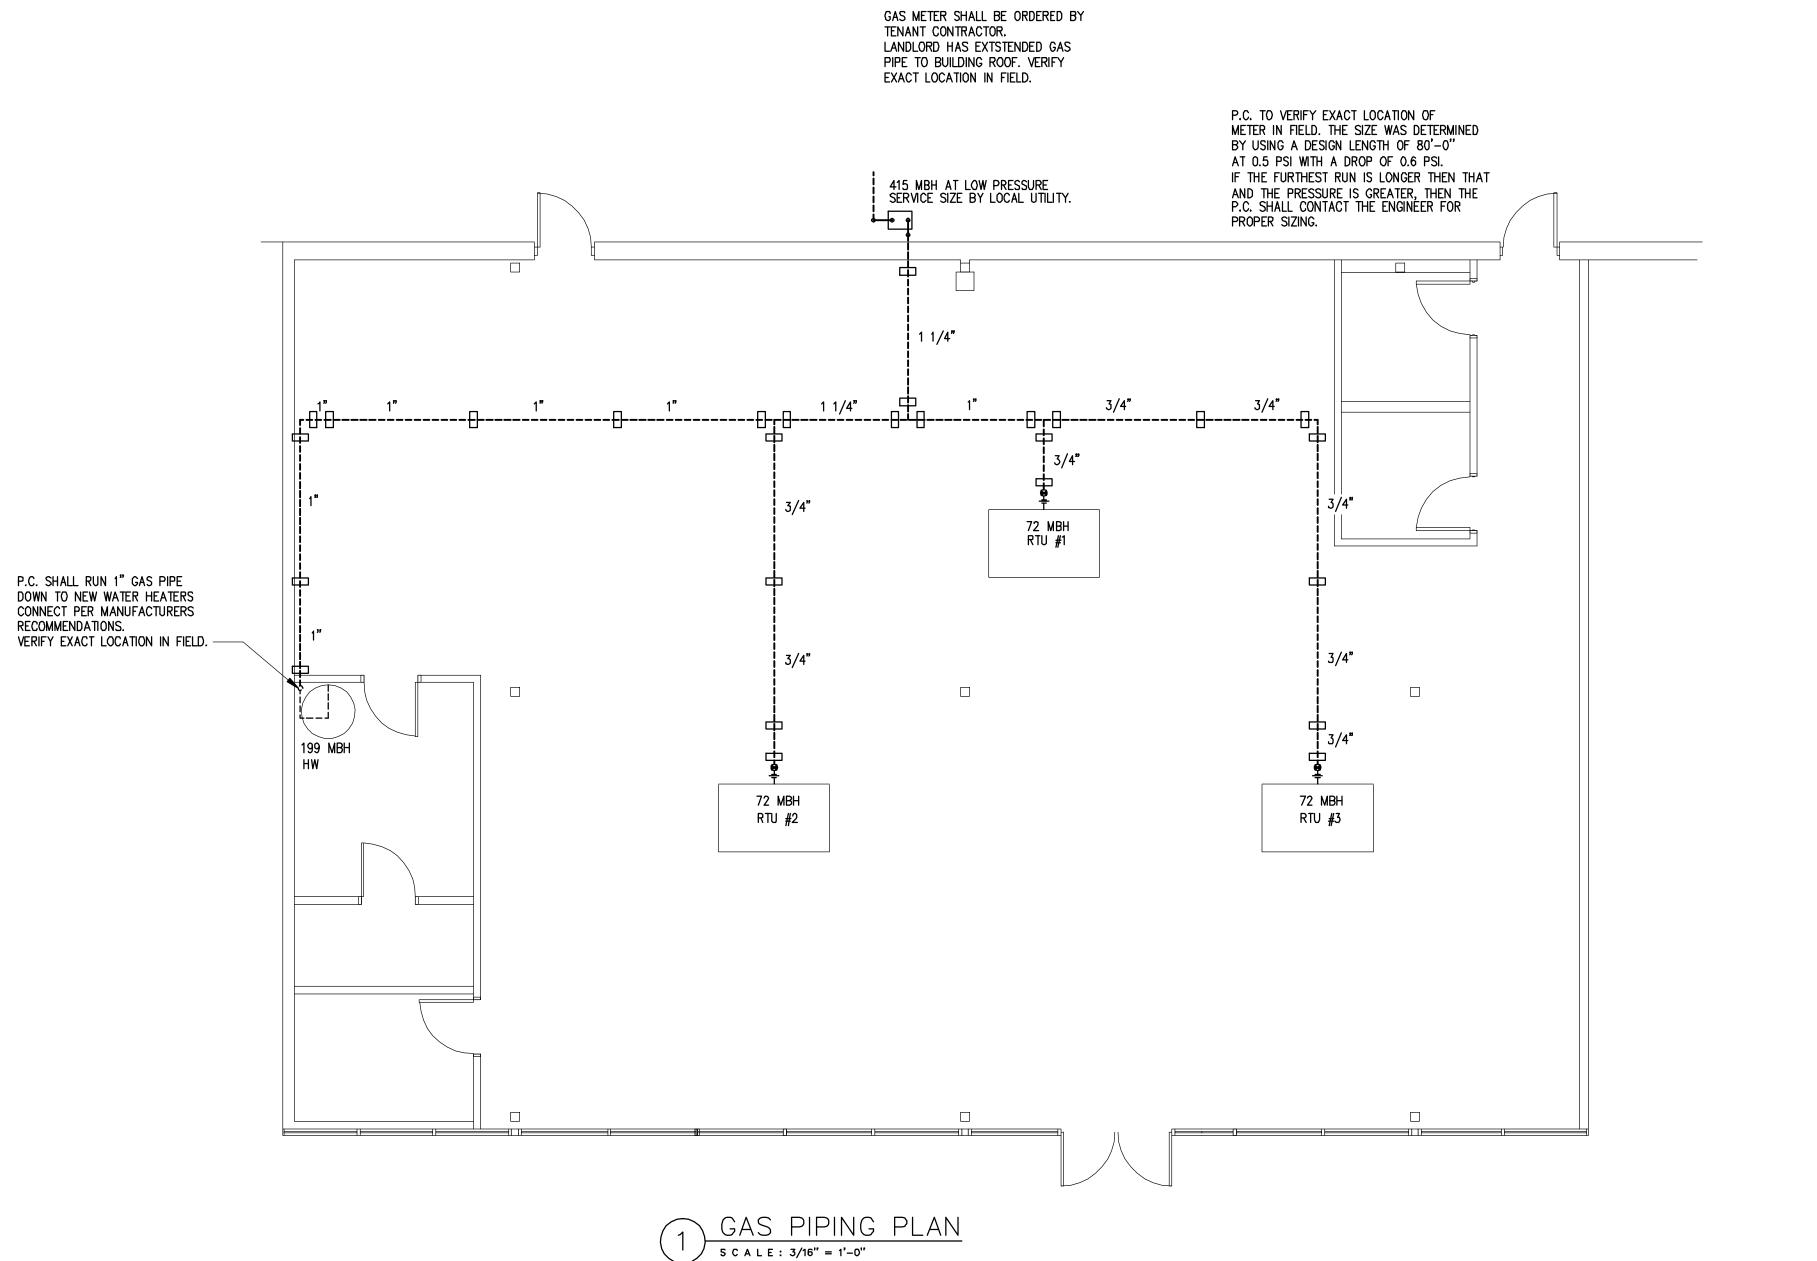




RELEASE FOR CONSTRUCTION
AS NOTED ON PLANS REVIEW

DEVELOPMENT SERVICES
LEE'S&UMMIT, MISSOURI



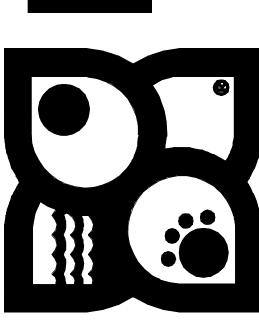


OWNER:

1		PLAN REVIEW COMMENTS
<u>/2\</u>	5-4-21	PLAN REVIEW COMMENTS
	D. T.	DECORPORTION !
MARK	DATE	DESCRIPTION
PROJEC	CT NO:	20397
DATE:		01-21-2021
DRAWN	BY: R	CM

CHK'D BY: EE COPYRIGHT:

SHEET TITLE:

P-5

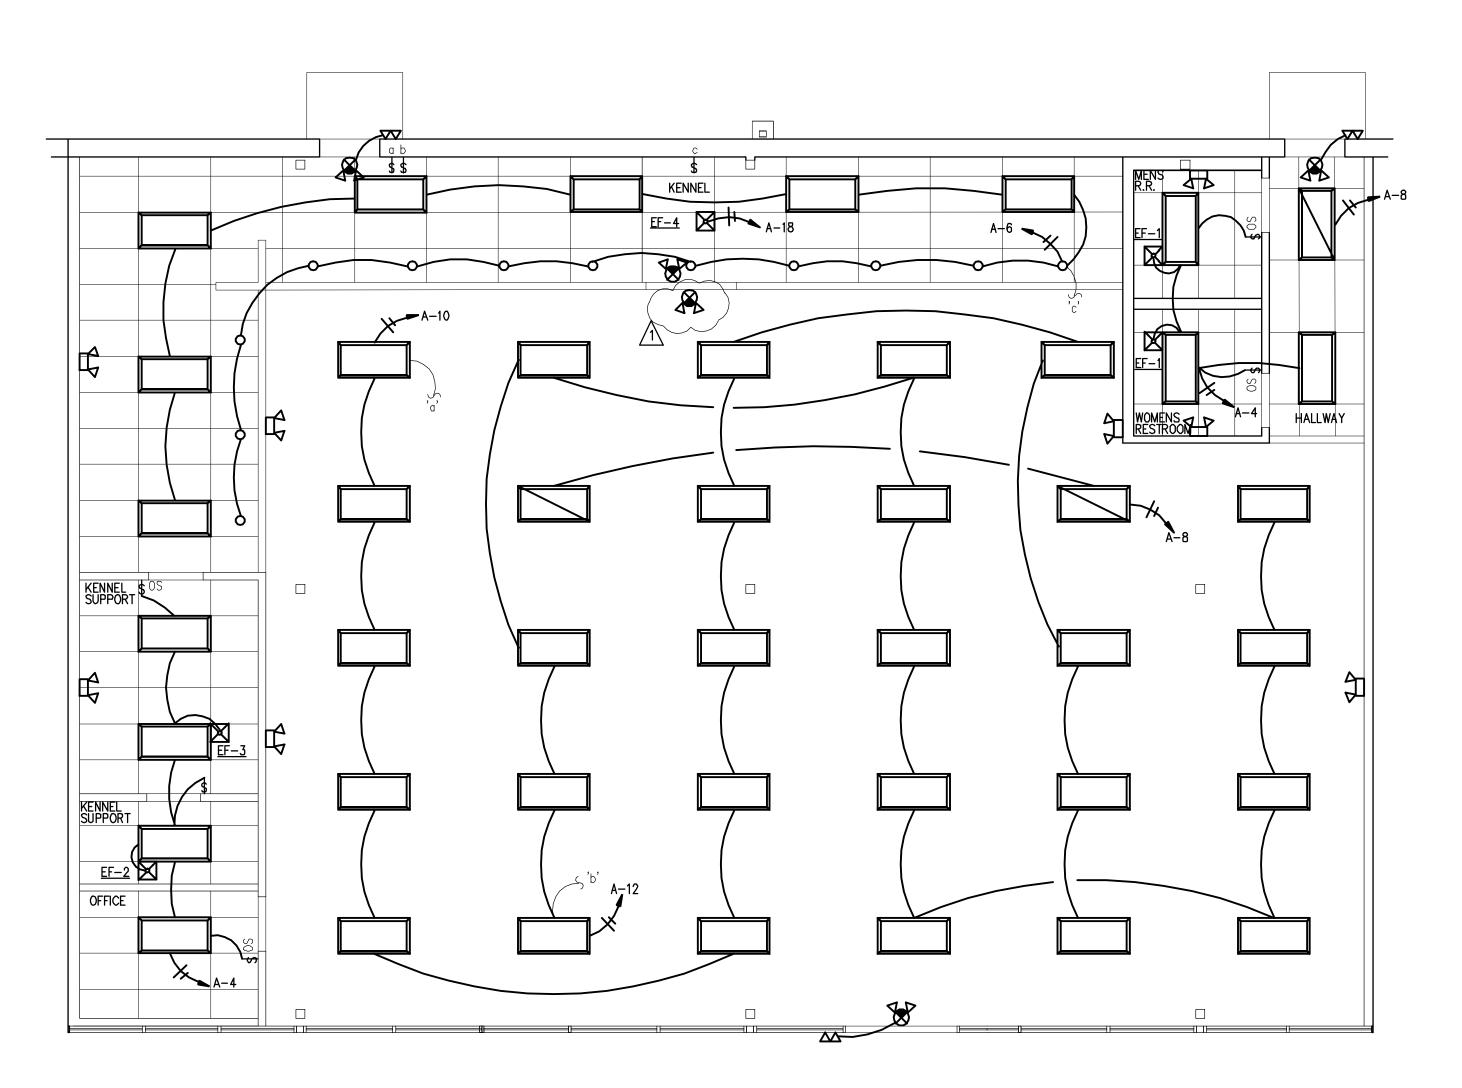

1 ELECTRICAL LIGHTING PLAN
SCALE: 3/16" = 1'-0"

EMERGENCY AND EXIT LIGHTS SHALL BE CONNECT TO THE SAME CIRCUIT THAT SERVES THE LIGHTS THAT ARE IN THE SAME AREA THAT THE EMERGENCY AND EXIT LIGHTS ARE IN AND SHALL BE CONNECTED AHEAD OF ANY LOCAL SWITCHES.

	LIGHT FIXTU	T 3	UNEDULE <lamps< th=""><th></th><th>LTG. FIXT.</th></lamps<>		LTG. FIXT.
FIX. SYM.	LIGHT DISCRIPTION	WATTS	QTY. — WATTS TYPE.	MOUNTING	SCHEDULE NOTES
Ç	E-CONOLIGHT MODEL - E-XML1W (2) TWO ADJUSTABLE HEADS	1.8	FURNISHED W/ FIXTURE	WALL OR CEILING SURFACE	EMERGENCY LIGHT WITH BATTERY NOTES: B & C
	E-CONOLIGHT EXIT LIGHT MODEL - E-XCL2RRCW SINGLE FACE	3.4	FURNISHED W/ FIXTURE	WALL OR CEILING SURFACE	L.E.D. EXIT SIG WHITE HOUSING RED LETTERS W/EMERGENCY BATTERY NOTE: B & C
	E-CONOLIGHT EXTERIOR EMERGENCY LIGHT MODEL - E-XHL2DW DUAL LIGHT, 3.6 WATTS (USE E-XHL-2WG IN WET LOCATION AREAS)		FURNISHED W/ FIXTURE	WALL SURFACE	EMERGENCY LIGHT WITH BATTERY NOTES: B & C
	2'-0" X 4'-0" LED CEILING LIGHT HERMITAGE C-TR-CFP24-50L-50K-WH	41	41 WATT LED	LAYIN CEILING	NOTES: A & B
	NIGHT LIGHT 2'-0" X 4'-0" LED CEILING LIGHT HERMITAGE C-TR-CFP24-50L-50K-WH	41	41 WATT LED	LAYIN CEILING	NOTES: A, B & D
0	CAN LIGHTS	50	50 WATT LED	LAYIN CEILING	

A. NEW LED LAMP


B FIXTURE PROVIDED WITH DUAL VOLTAGE 120/277V POWER SUPPLY. VERIFY VOLTAGE FOR EACH FIXTURE LOCATION.

C LIGHT FIXTURE SHALL HAVE BATTERY BACK—UP AND WIRED AHEAD OF LIGHTS ON SAME CIRCUIT. THE BATTERY BACK—UP SHALL ALLOW THIS FIXTURE TO REMAIN ON FOR A MIN. OF 90 MINUTES DURING LOSS OF POWER.

D LIGHT FIXTURE SHALL REMAIN ON DURING NON-BUSINESS WORKING HOURS.


\$ A SWITCH WITH A LOWER CASE LETTER WILL
CONTROL THE LIGHT FIXTURE WITH THE SAME
LOWER CASE LETTER.

\$ OC A SWITCH WITH THIS REFERENCE WILL BE EQUIPPED WITH AN OCCUPANCY SENSOR.

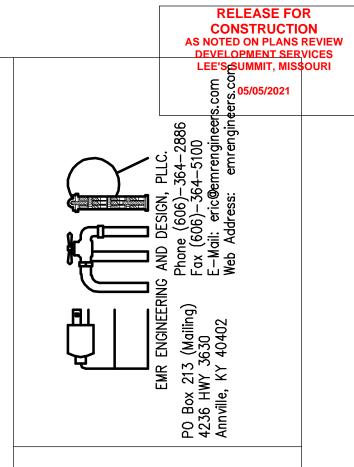



PETLAND LEE'S SUMMIT
464 NW CHIPMAN RD

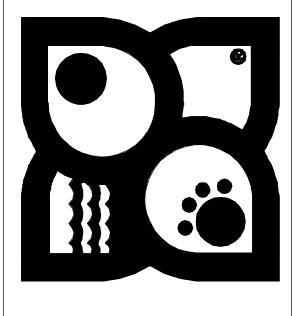


OWNER:

<u> </u>		PLAN REVIEW COMMENTS PLAN REVIEW COMMENTS
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MARK	DATE	DESCRIPTION
PROJEC	CT NO:	20397
DATE:		01-21-2021
DRAWN	BY: R	CM
CHK'D	BY: E	=

E — 1

SHEE.

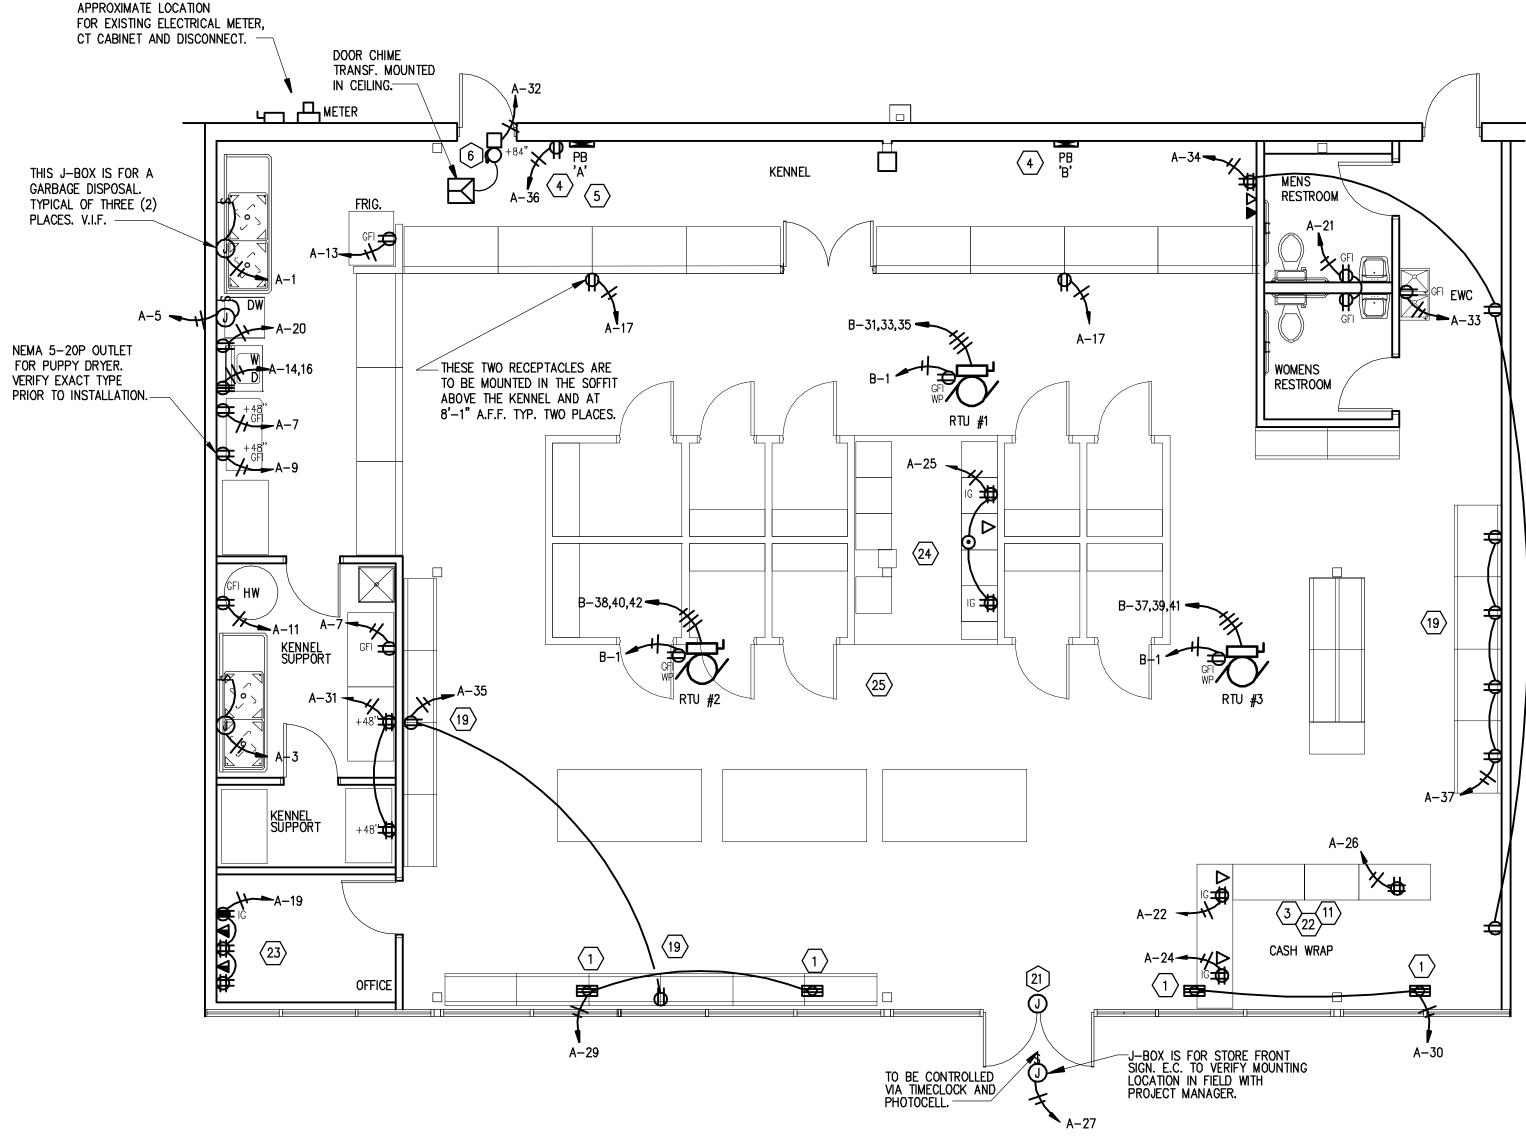


1 ELECTRICAL POWER PLAN
scale: 3/16" = 1'-0"

SYMBOL LEGEND

S	SPEAKER		
 	DOUBLE DUPLEX RECEPTACLE		ELECTRICAL PANEL
J	JUNCTION BOX WITH FLUSH COVER	/0/	SINGLE OR THREE-PHASE MOTOR - HP INDICATED
$^{G} \Phi$	DUPLEX RECEPTACLE - GROUND FAULT INTERRUPTER TYPE	▼	TELEPHONE OUTLET MOUNTED AT 18" A.F.F.
•	DUPLEX RECEPTACLE - FLOOR MTD - VERIFY LOCATION	₩	WALL MOUNTED TELEPHONE OUTLET MOUNTED AT 60" A.F.F.
•	RECEPTACLE MTD 6" ABOVE COUNTER OR 48"AFF	∇	COMBINATION TELEPHONE/DATA OUTLET
Ψ	DUPLEX RECEPTACLE - MTD 18" AFF (TO BE VERIFIED)	$\mathbb{S}_{\mathtt{D}}$	DUCT SMOKE DETECTOR
Д	SPECIAL PURPOSE RECEPTACLE - MTD. AT 18" AFF, SEE DWG		BELOW FLOOR CONDUIT
~	FOR AMPERAGE AND VOLTAGE	E.C.	ELECTRICAL CONTRACTOR
•	PUSH BUTTON SWITCH MOUNT AT 60" A.F.G.	HVAC	HEATING, VENTILATING, AIR CONDITIONING CONTRACTOR
0)	DOOR BELL OR BUZZER - MOUNTING AT 84" A.F.F.	AFF	ABOVE FINISHED FLOOR
S ₃	THREE WAY SWITCH	AFG	ABOVE FINISHED GRADE
S	SWITCH - SINGLE POLE	WP	WEATHER PROOF
(C)	VOLUME CONTROL	 IG	ISOLATED GROUND
II	3 WIRES, 1 NEUTRAL		
/III	4 WIRES , 1 NEUTRAL	RTU	ROOF TOP UNIT
A-1	HOME RUN PANEL AND CIRCUIT NUMBER,2-#12, #12G.,	C.	CONDUIT
- 1 -	3/4" C. TO A 20A-1P C/B TYPICALLY	G.	GROUND
5	"RUN CONTINUES" INDICATION	мсв	MAIN CIRCUIT BREAKER
	BACK BOARD	MLO	MAIN LUG ONLY
\boxtimes_{I}	FUSED DISCONNECT SWITCH	EF	EXHAUST FAN
S	MAGNETIC MOTOR STARTER - H.O.A. TYPE	TV	TELEVISON CABLE OUTLET WITH CABLE TO OFFICE

POWER PLAN CODED NOTES:


- 1) STORE FRONT SHOW WINDOW OUTLETS MOUNTED IN CEILING OR IN BULKHEAD AS DIRECTED.
- 2 NOT USED
- 3 DEVICE LOCATED IN CASEWORK. COORDINATE EXACT LOCATION WITH DESIGNER.
- 4 SEE DISTRIBUTION DIAGRAM ON DRAWING E-3.
- TELEPHONE BACKBOARD. PROVIDE RECEPTACLE AND GROUNDING. EXTEND 1 1/2" CONDUIT FOR TELEPHONE SERVICE FROM LANDLORD'S TELEPHONE CABINET TO THIS LOCATION. COORDINATE WITH TENANT COORDINATOR.
- 6 PROVIDE AND INSTALL LOW VOLTAGE DELIVERY BUZZER SYSTEM. LOCATE PUSH-BUTTON AT REAR DOOR. TRANSFORMER AND BUZZER IN RECEIVING AREA. CONNECT TO RECEPTACLE CIRCUIT AS INDICATED.
- $\overline{7}$ not used
- $\langle 8 \rangle$ not used
- 9 not used
- (10) NOT USED
- PROVIDE TELEPHONE OUTLET WITH TELEPHONE CABLE FROM CASH WRAP TO OFFICE. DATA OUTLET TO BE BLANK FOR TENANT INSTALLED SYSTEM. LOCATE DEVICES IN CASEWORK FOR CASH WRAP AS DIRECTED BY DAS PRIOR TO ROUGH—IN.
- $\langle 12 \rangle$ not used
- (13) NOT USED
- (14) NOT USED
- (15) NOT USED
- (16) NOT USED
- 17 NOT USED
- (18) NOT USED
- 19 36" FLEX CONNECTION TO DUPLEX OUTLET MOUNTED IN BASE OF DISPLAY UNIT. COORDINATE LOCATION OF DUPLEX OUTLET WITH KNOCKOUT IN DISPLAY UNIT. SEE DETAIL "A" ON DRAWING E-3.
- 20 NOT USED
- 21 E.C. TO PROVIDE 1" CONDUIT FROM OFFICE CEILING TO FRONT EXIT DOOR WITH PULL STRING. TERMINATE AT 120" A.F.F. WITH JUNCTION BOX.
- 22 RUN 3 CAT 5 CABLES TO OFFICE PATCH PANEL AND 1 CAT 5 CABLE TO TELEPHONE BACKBOARD
- RUN 2" CONDUIT FROM ABOVE CEILING DOWN TO SHELVE AT 70" A.F.F. TO PATCH PANEL FOR DATA (VERIFY IN FIELD)
- 24 RUN 3 CAT 5 CABLE TO FRONT OFFICE PATCH PANEL
- E.C. TO INSTALL SPEAKERS THROUGH OUT STORE, VERIFY QUANITY AND LOCATION WITH OWNER. VOLUME CONTROL TO BE INSTALLED IN OFFICE.

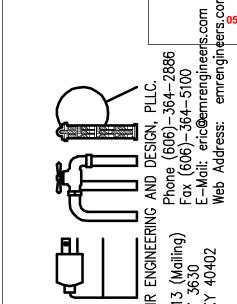

RELEASE FOR
CONSTRUCTION
AS NOTED ON PLANS REVIEW



PETLAND LEE'S SUMMIT

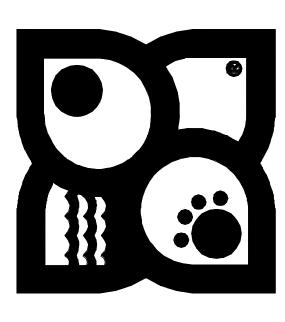

OWNER:

4-27-21 PLAN REVIEW COMMENTS

5-4-21 PLAN REVIEW COMMENTS

MARK DATE DESCRIPTION

PROJECT NO: 20397

DATE: 01-21-2021

DRAWN BY: RCM

CHK'D BY: EE

COPYRIGHT:
SHEET TITLE:

E-2

NOTES:


- THE CONTRACTOR SHALL, FURNISH ALL LABOR MATERIALS AND EQUIPMENT FOR THE COMPLETE INSTALLATION
- 2. NOT USED
- 3. ALL SWITCHES ARE TO BE @ 46" AFF. AND ARE TO BE 20A 120/277V 'T' RATED SPEC. GRADE TYPE.
- 4. ALL WORK SHALL CONFORM TO THE REQUIREMENTS OF THE 2014 EDITION OF THE NEC AND THE LATEST EDITION OF ALL LOCAL CODES AND ORDINANCES.
- 5. WORKMANSHIP SHALL BE FIRST QUALITY AND IN ACCORDANCE WITH BEST PRACTICES FOR THE TRADE BY SKILLED WORKERS.
- 6. LOCATIONS SHOWN ARE APPROXIMATE. CONTRACTOR SHALL COORDINATE ACTUAL LOCATIONS WITH OTHER TRADES AND THE OWNER OF THE OWNERS AUTHORIZED REPRESENTATIVE.
- 7. UNLESS OTHERWISE NOTED, CONDUCTOR INSULATION SHALL BE TYPE THHN, RATED 600V AC AND 75 DEG. C. CONDUCTORS FOR USE IN POWER AND LIGHTING CIRCUITS NO. 10 AND SMALLER SHALL BE SOLID, NO. 8 AND LARGER CONDUCTORS SHALL BE STRANDED. CONDUCTORS FOR USE IN CONTROL AND SIGNAL CIRCUITS SHALL BE NO. 14 STRANDED, ALL CONDUCTORS SHALL BE COPPER.
- 8. CONDUIT RUNS SHALL BE INSTALLED PER STATE AND LOCAL CODES.
- 9. ALL MATERIALS SHALL BE NEW, WITH U.L. APPROVED LABELS.
- 10. ALL ELECTRICAL EQUIPMENT AND SYSTEMS SHALL BE TESTED AND ADJUSTED FOR PROPER OPERATION. COMPLETE WRING SYSTEM SHALL BE FREE OF SHORT AND OPEN CIRCUITS.
- 11. COLOR OF DEVICES AND DEVICE PLATES SHALL BE COORDINATED WITH WALL COLOR AND SHALL BE COMPATIBLE WITH WALL COLORS.
- 12. THE CONTRACTOR SHALL OBTAIN AND PAY ALL FEES AND PERMITS REQUIRED FOR THE CONSTRUCTION OF THE PROJECT.
- 13. THE CONTRACTOR SHALL FURNISH THE CERTIFICATE OF ELECTRICAL INSPECTION TO THE OWNER AT THE COMPLETION OF THIS PROJECT.
- 14. ALL ELECTRICAL EQUIPMENT SHOWN SHALL BE ELECTRICALLY PROTECTED AND PROPERLY WIRED IN ACCORDANCE WITH THE NEC. COORDINATE LOCATIONS AND ELECTRICAL DATA WITH THE OWNER.
- 15. FLEXIBLE METAL RACEWAYS 6 FEET OR LESS IN LENGTH SHALL BE PROVIDED TO ALL ELECTRICAL EQUIPMENT SUBJECT TO VIBRATION OF MOVEMENT AND FOR ALL MOTORS. LIQUID TIGHT RACEWAYS SHALL BE USED IN WET LOCATIONS.
- 16. REUSE EXISTING ELECTRICAL SERVICE AND PANELS AS SHOWN.
- 17. ALL EXISTING CONDUIT AND CONDUCTORS THAT ARE NOT TO BE USED IN THE REMODEL MUST BE REMOVED, OBSOLETE AND DILAPIDATED WIRING AND EQUIPMENT SHALL NOT BE REUSED.

		ELECTR	IC	AL	PAN	EL (SC	HEDULE		
	FEED POS	SITION	_ M	OUNTI	NG F	PANEL	NO.	A ENCLOSURE _	225A MAIN BREAKER	
SEF	RVICE VOLTAGE	120/208V/3PH/4W	_P	ANEL [DESCRI	PTION	Ę	EXISTING 225MP PANEL		
СВ	WIRE & CONDUIT	LOAD SERVED	CKT#	LO,	AD WA	TTS	CKT#	LOAD SERVED	WIRE & CONDUIT	СВ
OA /	2-#12 THW & 1 #12 G, 3/4" C.	GARBAGE DISPOSAL	1	1000			2	STORE FRONT SIGN	2-#12 THW & 1 #12 G, 3/4" C.	20A -
OA IP	2-#12 THW & 1 #12 G, 3/4" C.	GARBAGE DISPOSAL	3	1200	1000 527	1000	4	OFFICE & R.R. LIGHTS	2-#12 THW & 1 #12 G, 3/4" C.	20A
JA 1P	2-#12 THW & 1 #12 G, 3/4" C.	DISHWASHER	5	720	327	1000 887	6	KENNEL LIGHTS	2-#12 THW & 1 #12 G, 3/4" C.	20A 1P
) <u>A</u>	2-#12 THW & 1 #12 G, 3/4" C.	KENNEL RECEPTS.	7	720 123	1000	007	8	NIGHT LIGHTS	2-#12 THW & 1 #12 G, 3/4" C.	20A 1P
1 <u>P</u>	2-#12 THW & 1 #12 G, 3/4" C.	PUPPY DRYER	9	123 (1000 574	100	10	SALES AREA LIGHTS	2-#12 THW & 1 #12 G, 3/4" C.	20A 1P
1 <u>P</u>	2-#12 THW & 1 #12 G, 3/4" C.	WATER HEATER	11	500	3/4	180 533	12	SALES AREA LIGHTS	2-#12 THW & 1 #12 G, 3/4" C.	20A 1P
JA 1P	2-#12 THW & 1 #12 G, 3/4" C.	KENNEL FRIDGE	13	1500	190	333	14	DRYER	3-#12 THW & 1 #12 G, 3/4" C.	20A
1P	2-#12 THW & 1 #12 G, 3/4" C.	PANEL BOARD RECEPT.	15	1300 (180 1500	760	16			2P
71 _P	2-#12 THW & 1 #12 G, 3/4" C.	SOFFIT RECEPTS.	17	900	1500	360 1656	18	KENNEAL EXHAUST FAN	2-#12 THW & 1 #12 G, 3/4" C.	20A 1P
1P	2-#12 THW & 1 #12 G, 3/4" C.	OFFICE RECEPTS.	19	500	360	1030	20	WASHER	2-#12 THW & 1 #12 G, 3/4" C.	1P
1P	2-#12 THW & 1 #12 G, 3/4" C.	RESTROOMS RECEPTS.	21		360	540	22	CASHWRAP QUAD	2-#12 THW & 1 #12 G, 3/4" C.	20A 1P
1P	2-#12 THW & 1 #12 G, 3/4" C.	EWC	23	900	300	360	24	CASHWRAP QUAD	2-#12 THW & 1 #12 G, 3/4" C.	20A 1P
1P	2-#12 THW & 1 #12 G, 3/4" C.	FLOOR RECEPTS./QUADS	25	360	1200	300	26	CASHWRAP QUAD	2-#12 THW & 1 #12 G, 3/4" C.	20A 1P
1P	2-#12 THW & 1 #12 G, 3/4" C.	STORE FRONT SIGN	27		100	360	28	TIME CLOCK	2-#12 THW & 1 #12 G, 3/4" C.	20A 1P
1P	2-#12 THW & 1 #12 G, 3/4" C.	CEILING RECEPTS.	29	720	100	720	30	CEILING RECEPTS.	2-#12 THW & 1 #12 G, 3/4" C.	20A
77 _{1P}	2-#12 THW & 1 #12 G, 3/4" C.	SUPPORT RM. QUADS	31	100	190	/20	32	DOOR BUZZER	2-#12 THW & 1 #12 G, 3/4" C.	20A 1P
JA 1P	2-#12 THW & 1 #12 G, 3/4" C.	SUPPORT RM. RECEPT.	33	.00 (180 720	540	34	MISC. RECEPTS.	2-#12 THW & 1 #12 G, 3/4" C.	20A
JA 1P	2-#12 THW & 1 #12 G, 3/4" C.	MISC. RECEPTS.	35	720	/20	540	36	RTU RECEPTS.	2-#12 THW & 1 #12 G, 3/4" C.	20A 1P
JA 1P	2-#12 THW & 1 #12 G, 3/4" C.	MISC. RECEPTS. SPACE	37 39	8712	o	J-10	38 40	 PANEL 'B'	4-#4/0 THW & 1 #2 G, 2 1/2" C.	225Å
		SPACE	41	-	8712	0	42	1,,,,,,,,,,,,,,,,,,,,,,,,,,,,,,,,,,,,,,		3P
TC	TIME CLOCK	TOTAL		17955	16413	8712 16388	 	I		V JE

TOTAL LOAD KVA/AMPS <u>50.8/141.0</u> DEMAND <u>50,756</u> PROTECTED LOAD-AMPS <u>176.3/225AT</u>


TOTAL LOAD WATTS <u>50,756</u>

SEH	RVICE VOLTAGE						<u>[</u>	EXISTING 225AMP PANEL		
СВ	WIRE & CONDUIT	LOAD SERVED	CKT#	Ø A	AD WA	øC øC	CKT#	LOAD SERVED	WIRE & CONDUIT	
3P	4-#8 THW & 1 #10 G, 1" C.	RTU-1	1 3 5	2904 2904 2904	2904 2904	2904 2904	6	RTU-2	4-#8 THW & 1 #10 G, 1" C.	4
	4-#8 THW & 1 #10 G, 1" C.	RTU-3	9	0	2904 0	2904		SPACE SPACE SPACE		+
3P		SPACE SPACE	13		0 0	0 } o	14 16	SPACE SPACE		
		SPACE SPACE SPACE	1 / 19 21	0	} o	Ō	18 20 22	SPACE SPACE SPACE		
		SPACE SPACE	23 25	0	0 } o	0	24 26	SPACE		
		SPACE SPACE SPACE	27 29 31	0	0	0	28 30 32			
		SPACE SPACE SPACE	33 35 37		0	0				
		SPACE SPACE	37 39 41	0	0	0	40	SPACE SPACE		
Н	HACR BREAKER		LS	8712	8712	0 8712			•	

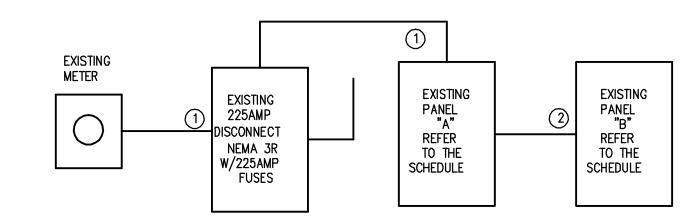


- 1 EXISTING TO BE REUSED AS IS
- (4) #4/0 THW
 (2) #2 COPPER GRO
- RISER DIAGRAM


 S C A L E : N.T.S.

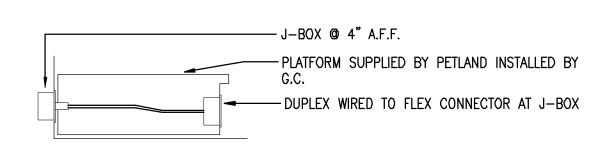



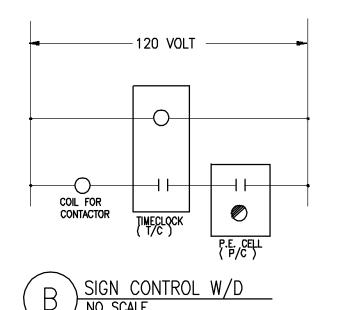

* LOCK-ON BREAKER

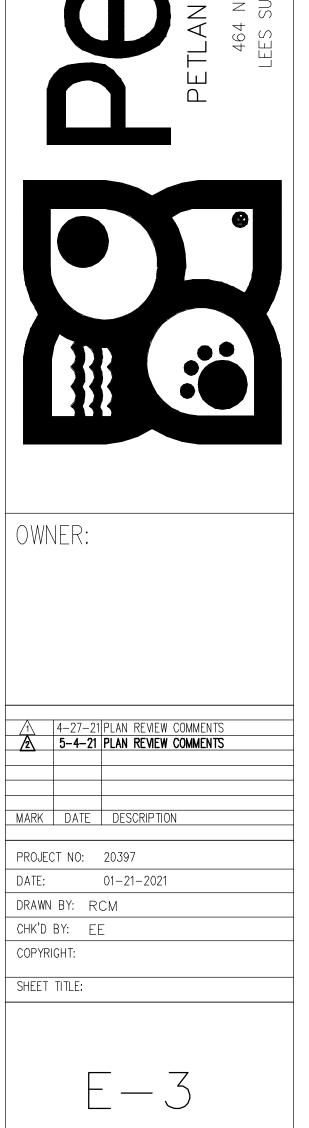

SHEET

RELEASE FOR
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