


NOTE: THESE DRAWINGS REFLECT A WOOD RAMP/DECK/STEPS ON A NATURAL SURFACE OF GRASS OR DIRT.


RAMPS / HANDRAILS

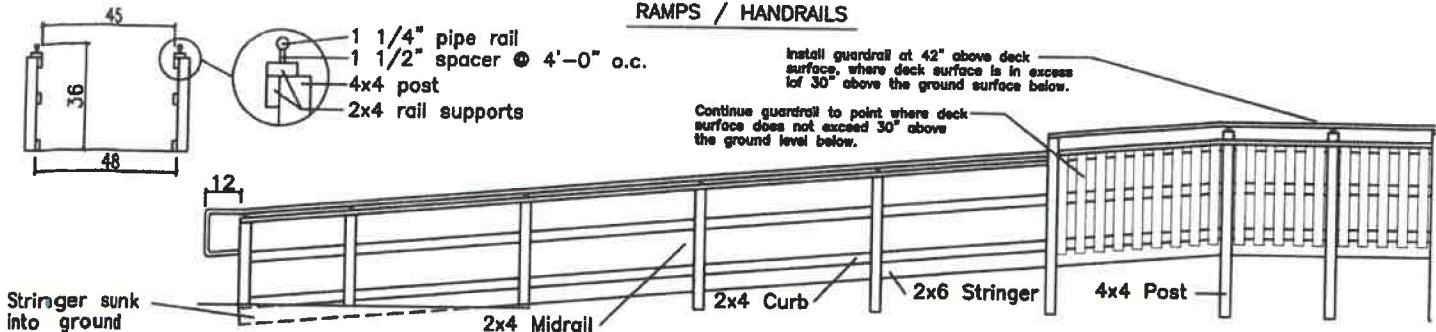


Ramp / Handrail Notes:

- 1) Changes in level up to $\frac{1}{4}$ " may be vertical, between $\frac{1}{4}$ "– $\frac{1}{2}$ " must be beveled, with a slope not to exceed 1:2, and any change in level greater than $\frac{1}{2}$ " must be accomplished by means of a ramp.
- 2) The maximum slope for a ramp is 1:12. The maximum rise for any unbroken run shall be 30". The maximum cross-slope for any ramp surface shall be 1:50.
- 3) The minimum clear width for a ramp 30'-0" or less in length shall be 36", and any ramp with a run longer than 30'-0" shall have a minimum clear width of 44".
- 4) Any change in level greater than 6" shall have handrails on both sides.
- 5) If a ramp changes direction at a landing, the minimum landing size shall be 60" by 60".
- 6) Ramps shall have level landings at the top and bottom of each run.
- 7) Handrails shall be provided on both sides of ramp segments. The inside handrail on switchback or dogleg ramps shall always be continuous.
- 8) If handrails are not continuous, they shall extend at least 12" beyond the top and bottom of the ramp segment, and shall be parallel with the ground or floor surface.
- 9) The clear space between a handrail and a wall shall be 1 1/2".
- 10) Gripping surfaces shall be continuous. In Louisiana, they must provide for a "power grip" in which the fingers may be wrapped around the handrail, as opposed to a "pinch grip", in which the handrail is squeezed between the thumb and fingers.
- 11) The top of handrails shall be mounted between 34"-38" above the ramp surface. Where a handrail is to be used primarily by children, the top of the handrail may be lowered to 28"-32".
- 12) Ends of handrails shall be either rounded, or returned smoothly to the floor, wall, or post.
- 13) Handrails shall not rotate within their fittings.
- 14) Handrails shall be between 1 1/4"-1 1/2" diameter, or shall provide an equivalent gripping surface.
- 15) A handrail and any wall or other surface adjacent to it shall be free of any sharp or abrasive elements.
- 16) Ramps and landings with drop-offs shall have curbs, walls, railings, or projecting surfaces which prevent people from slipping off the ramp. Curbs shall be a minimum of 2" high.
- 17) Handrail edges shall have a minimum radius of 1/8".


LANDINGS

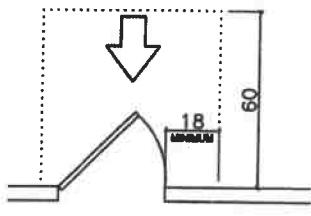

FRONTAL APPROACH

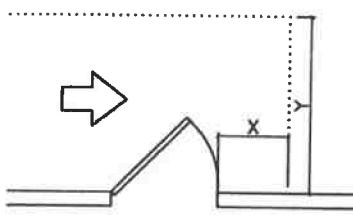




HINGE SIDE APPROACH
X=36" min. if Y=60"
X=42" min. if Y=54"

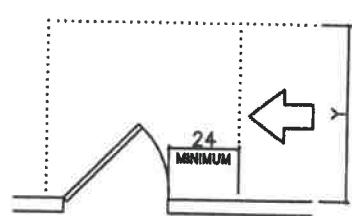

LATCH SIDE APPROACH
Y=48" Minimum
Y=54" minimum if door has closer

Landing Notes:

- 1) Landings shall be at least as wide as the ramp leading to it.
- 2) Landings at the top and bottom of each ramp or ramp run shall have a minimum of 60" clear in the direction of travel.
- 3) If ramps change direction at landings, the minimum landing size shall be 60" x 60".
- 4) Landings at doors must be level. Where a door swings onto the landing, the width of landing between the latch side of the door, and the railing is to be determined as shown in the pictures above.





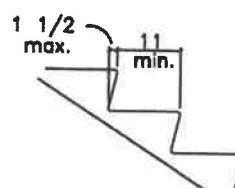
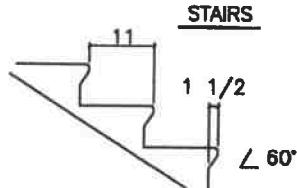
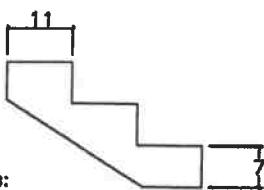


Step Notes:

- 1) Treads and risers are to be uniform in depth and height, and are to be a minimum of 11" deep, and a maximum of 7" high.
- 2) Stair nosings shall not be abrupt. The radius of curvature at the leading edge of the tread shall be no greater than 1/2".
- 3) Risers shall be sloped, or the underside of the nosing shall have an angle not less than 60° from horizontal.
- 4) Stair nosings shall not project more than 1 1/2".
- 5) Tread depth is to be measured horizontally from nosing to nosing.
- 6) Stairs must have a minimum clear width of 44". Handrails may project a maximum of 3 1/2", but can't reduce the 44" width.
- 7) Handrails at stairs shall be either continuous, or shall extend at least 12" beyond the top riser, and extend at least 12" plus the width of one tread beyond the bottom riser. At the top the extension shall be parallel with the floor or ground surface. At the bottom, the handrail is to continue to slope for a distance of one tread depth beyond the bottom riser, then become horizontal. Handrail mounting height is measured from edge of stair nosing.
- 8) Gripping surfaces shall not be interrupted by newel posts, other construction elements, or obstructions.
- 9) Handrails at stairs shall meet all of the requirements listed above in the ramp / handrail section.

LTR	REVISION	BY	DATE	DRAWN BY:	TITLE:	SCALE:	DWG. NO.	DATE:
				SGD	Decks, Steps, Ramps, and Handrails	3/16" = 1'-0"	DECK STPS & RAMPS DETAILS	12/20/2001

 <p>By York at 4:20pm 6/16/2020 PE201609311 NUMBER PROT#</p> <p>(Structural Aspects Only)</p>	PALOMAR MODULAR BUILDINGS LLC CONSTRUCTION LTD SOURCE STRUCTURE	DATE: 6/9/2020 SCALE: 1/8" = 1'-0" BY DATE: RR 2/7	DESCRIPTION BY DATE	PLAT DRUM BR. I-1 DRUM BR. NM	CHEREGD BY: CEILING GRID / HVAC LAYOUT SERIAL #: 2279-2280				
 <p>MISSOURI PUBLIC SERVICE COMMISSION APPROVED 07/02/2020 MANUFACTURED HOUSING</p>									
 <p>PFS APPROVED DATE 6/23/20 PFS CORPORATION Cottage Grove, WI</p>									
<p>NOTE: DUCTING IS CLASS 1, U.L. 181 LISTED FLEXIBLE FIBERGLASS DUCTING. NOTE: RETURN AIR IS DIRECT TO THE UNIT THROUGH THE WALL.</p> <table border="1" style="margin-left: auto; margin-right: auto;"> <tr> <td style="padding: 5px; text-align: center;"> SYMBOL LEGEND </td> </tr> <tr> <td style="padding: 5px; text-align: center;">  2' x 4' LED LIGHT (44 WATTS) </td> </tr> <tr> <td style="padding: 5px; text-align: center;">  24" x 24" SUPPLY DIFFUSER </td> </tr> <tr> <td style="padding: 5px; text-align: center;">  PROGRAMMABLE THERMOSTAT </td> </tr> </table>						SYMBOL LEGEND	 2' x 4' LED LIGHT (44 WATTS)	 24" x 24" SUPPLY DIFFUSER	 PROGRAMMABLE THERMOSTAT
SYMBOL LEGEND									
 2' x 4' LED LIGHT (44 WATTS)									
 24" x 24" SUPPLY DIFFUSER									
 PROGRAMMABLE THERMOSTAT									
<p>1 CEILING GRID / HVAC LAYOUT SCALE: 1/8" = 1'-0"</p>									

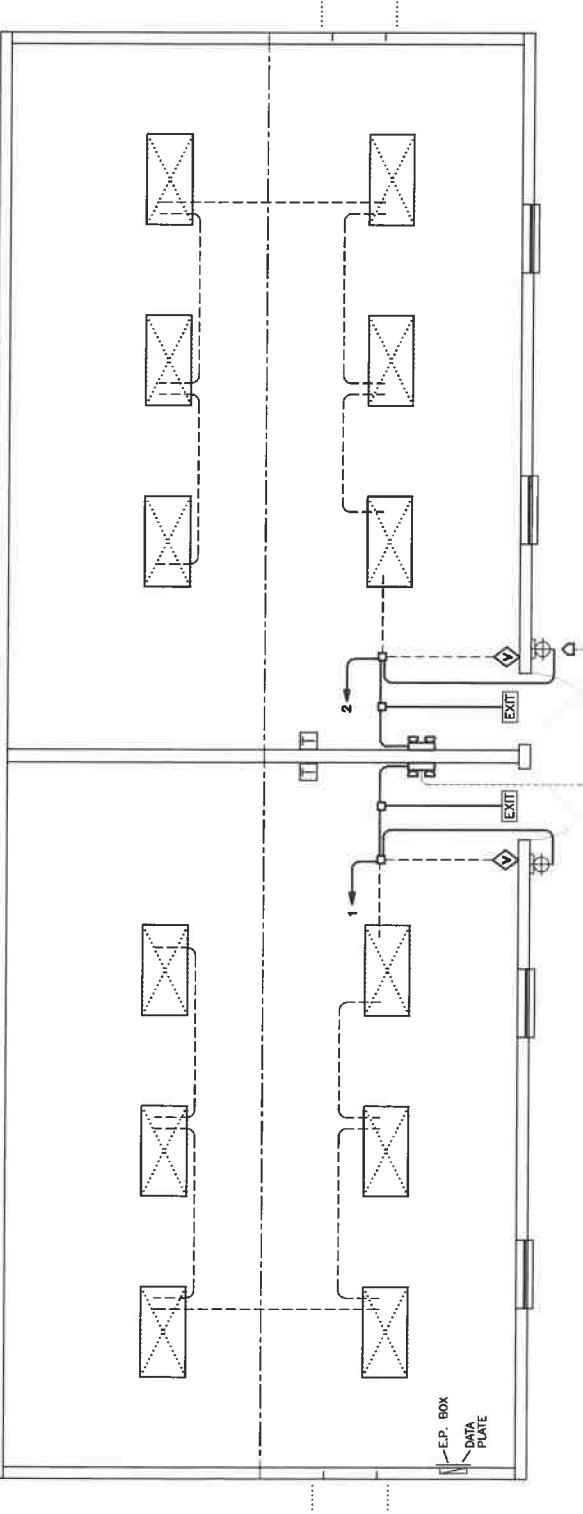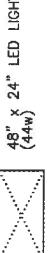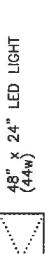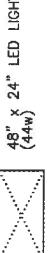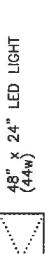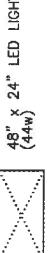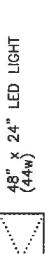 <p>By Yuri at 12:06 PM, 6/11/2020 (Structural Aspects Only)</p>	PALOMAR MODULAR STRUCTURE CONSTRUCTION LLC 701, 105 S SUMMIT RD STE 200-101 LEES SUMMIT, MO 64063 PHONE: 816-252-0555 FAX: 816-252-0555 EMAIL: info@palomar-modular.com WEBSITE: www.palomar-modular.com NUMBER: DE-201605131 DATE: 6/9/2020 BY DATE: 1'-0" DESCRIPTION: 1'-0" x 1'-0" x 1'-0" DRAWN BY: NM CHECKED BY: SERIAL #: 2279-2280	DRY CLASROOM BUILDING DRY CLASROOM BUILDING 24x4 DRY CLASSROOM UHGING SCHMIDT DATE: 6/11/2020 SHEET NO.: E-1 SCALE: 1/8" = 1'-0" STRUCTURAL ASPECTS ONLY NO. 2279-2280								
 <p>The diagram shows a lighting circuit for a modular structure. It features a main power source at the top right, connected to a junction box. From the junction box, a single line runs across the structure. Along this line, there are several light fixtures represented by dashed rectangles with 'X' patterns. Some fixtures have small arrows indicating they are controlled by occupancy sensors. A data plate is shown near the bottom center. Two exit signs are also indicated along the main line. A legend on the right side provides symbols for various electrical components.</p>										
<table border="1" style="width: 100%; border-collapse: collapse;"> <tr> <td colspan="2" style="text-align: center; padding: 5px;">ELECTRICAL SYMBOL LEGEND</td> </tr> <tr> <td style="width: 50%; padding: 5px;">  48" x 24" LED LIGHT $(4.4w)$ </td> <td style="width: 50%; padding: 5px;">  RECEPTACLE  GFI RECEPTACLE  TAMPER-RESISTANT RECEPTACLE  WEATHER-PROOF GFI RECEPTACLE </td> </tr> <tr> <td style="padding: 5px;">  VANDAL-PROOF EXTERIOR LED LIGHT ON PHOTOCELL (22w) </td> <td style="padding: 5px;">  7-DAY PROGRAMMABLE THERMOSTAT w/ OCCUPANT OVERRIDE  OCCUPANCY SENSOR SWITCH IP15  PHONE / DATA STUB-IN </td> </tr> <tr> <td colspan="2" style="padding: 5px;">  JUNCTION BOX  ELECTRICAL DIST. PANEL  EXIT  LED EXIT LIGHT w/ BATTERY BACK-UP  EMERGENCY LIGHT w/ BATTERY BACK-UP & REMOTE HEAD  EXTERIOR REMOTE HEAD </td> </tr> </table>			ELECTRICAL SYMBOL LEGEND		 48" x 24" LED LIGHT $(4.4w)$	 RECEPTACLE  GFI RECEPTACLE  TAMPER-RESISTANT RECEPTACLE  WEATHER-PROOF GFI RECEPTACLE	 VANDAL-PROOF EXTERIOR LED LIGHT ON PHOTOCELL (22w)	 7-DAY PROGRAMMABLE THERMOSTAT w/ OCCUPANT OVERRIDE  OCCUPANCY SENSOR SWITCH IP15  PHONE / DATA STUB-IN	 JUNCTION BOX  ELECTRICAL DIST. PANEL  EXIT  LED EXIT LIGHT w/ BATTERY BACK-UP  EMERGENCY LIGHT w/ BATTERY BACK-UP & REMOTE HEAD  EXTERIOR REMOTE HEAD	
ELECTRICAL SYMBOL LEGEND										
 48" x 24" LED LIGHT $(4.4w)$	 RECEPTACLE  GFI RECEPTACLE  TAMPER-RESISTANT RECEPTACLE  WEATHER-PROOF GFI RECEPTACLE									
 VANDAL-PROOF EXTERIOR LED LIGHT ON PHOTOCELL (22w)	 7-DAY PROGRAMMABLE THERMOSTAT w/ OCCUPANT OVERRIDE  OCCUPANCY SENSOR SWITCH IP15  PHONE / DATA STUB-IN									
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<div style="border: 1px solid red; padding: 5px; display: inline-block;">  APPROVED PFS CORPORATION <small>Cottage Grove, WI</small> </div>										
PUBLIC SERVICE COMMISSION APPROVED 07/02/2020 MANUFACTURED HOUSING										

PALOMAR
MODULAR STRUCTURES LLC
CONSTRUCTION LLC
PO BOX 262-163
7925 20th Street SW
Seattle, WA 98106-1630
PHONE: 206-988-1630
FAX: 206-988-1631
E-MAIL: info@modularstructures.com

DATE: 6/9/2020 BY DATE: 6/11/2020
DESIGNER: PALOMAR BUILDINGS LLC BY: DRAWMAN BY: NM
SCALE: 1/8" = 1'-0" CHECKED BY:
PLOT NO: 2020-0609131 DRAWN BY: NM
SERIAL #: 2Z9-2280

DRY CLASROOM UTILIZING
EE'S DISTRIBUTION SCHEMATIC
POWER SOURCE: 120V/240V, 3-WIRE, SINGLE PHASE
ELECTRICAL CONDUIT: ELECTRICAL NON-METALLIC TUBING
ELECTRICAL WIRING: MIN. #12 THIN COPPER WITH GROUND
GROUNDING ON SITE: PER 2014 NEC ARTICLE 250-50

STRUCTURAL ASPECTS ONLY
By Yurt at 4:26:06 PM, 6/11/2020

MISSOURI
PUBLIC SERVICE
COMMISSION
APPROVED
MANUFACTURED
HOUSING
07/02/2020

PFS CORPORATION
DATE 6/23/20
Cottage Grove, WI

POWER DISTRIBUTION SCHEMATIC
SHEET NO. E-2
SCALE: 1/8" = 1'-0"
DRAWN BY: NM
CHECKED BY:
PLOT NO: 2020-0609131
DRAWN BY: NM
SERIAL #: 2Z9-2280

ELECTRICAL SYMBOL LEGEND

48" x 24" LED LIGHT (44w)	RECEPTACLE	7-DAY PROGRAMMABLE THERMOSTAT w/ OCCUPANT OVERRIDE	JUNCTION BOX
VANDAL-PROOF EXTERIOR LED LIGHT ON PHOTOCELL (22w)	GFI RECEPTACLE	OCCUPANCY SENSOR SWITCH IPV15	ELECTRICAL DIST. PANEL
DATA PLATE	TAMPER-RESISTANT RECEPTACLE	PHONE / DATA STUB-IN	LED EXIT LIGHT w/ BATTERY BACK-UP
EP. BOX	WEATHER-PROOF GFI RECEPTACLE		EMERGENCY LIGHT w/ BATTERY BACK-UP & REMOTE HEAD
DATA PLATE			EXTERIOR REMOTE HEAD

NOTE:
BUILDING IS: 120/240V, 3-WIRE, SINGLE PHASE.
ELECTRICAL CONDUIT: ELECTRICAL NON-METALLIC TUBING.
ELECTRICAL WIRING: MIN. #12 THIN COPPER WITH GROUND.
GROUNDING ON SITE: PER 2014 NEC ARTICLE 250-50.

SCALE: 1/8" = 1'-0"
DRAWN BY: NM
CHECKED BY:
PLOT NO: 2020-0609131
DRAWN BY: NM
SERIAL #: 2Z9-2280

POWER DISTRIBUTION SCHEMATIC
SHEET NO. E-2
SCALE: 1/8" = 1'-0"
DRAWN BY: NM
CHECKED BY:
PLOT NO: 2020-0609131
DRAWN BY: NM
SERIAL #: 2Z9-2280

ELECTRICAL SYMBOL LEGEND

48" x 24" LED LIGHT (44w)	RECEPTACLE	7-DAY PROGRAMMABLE THERMOSTAT w/ OCCUPANT OVERRIDE	JUNCTION BOX
VANDAL-PROOF EXTERIOR LED LIGHT ON PHOTOCELL (22w)	GFI RECEPTACLE	OCCUPANCY SENSOR SWITCH IPV15	ELECTRICAL DIST. PANEL
DATA PLATE	TAMPER-RESISTANT RECEPTACLE	PHONE / DATA STUB-IN	LED EXIT LIGHT w/ BATTERY BACK-UP
EP. BOX	WEATHER-PROOF GFI RECEPTACLE		EMERGENCY LIGHT w/ BATTERY BACK-UP & REMOTE HEAD
DATA PLATE			EXTERIOR REMOTE HEAD

NOTE:
BUILDING IS: 120/240V, 3-WIRE, SINGLE PHASE.
ELECTRICAL CONDUIT: ELECTRICAL NON-METALLIC TUBING.
ELECTRICAL WIRING: MIN. #12 THIN COPPER WITH GROUND.
GROUNDING ON SITE: PER 2014 NEC ARTICLE 250-50.

PAPALOMAR\Drawing\2279-80 - Lees Summit\12464 DRY CLASSROOM ZDwg, 6/11/2020 3:51:11 PM, NMiler

MISSOURI PUBLIC SERVICE COMMISSION		APPROVED 07/02/2020		MANUFACTURED HOUSING	
NOTE: WHERE LEFT OR RIGHT CLASSROOM IS CALLED OUT, THE CALLOUT IS AS VIEWED FROM THE EXTERIOR OF THE BUILDING STANDING AT THE EXTERIOR DOORS.		200			
WIRE SIZE & FEET		GROUND BAR			
Service Conduits: 10 Service Guard: 6		NEUTRAL			
AWG #3/0		Conductors - 2 Phase and 1 Neutral			
IMC, RMC or PVC		1 1/2 Inch			
2484 DRY CLASROOM BLDG		TOTAL PANEL LOAD:			
DATE: 6/9/2020		Total Watts: 31446 watts			
SCALE: N.T.S.		Voltage: 240 v			
DRAFT BY: NM		Total Amps: 131.02 amps			
ELECTRICAL CALCULATIONS		LOAD CALC:			
MAIN BREAKER		ITEM			
SINGLE PHASE		WIRE SIZE			
150 AMP		WIRE SIZE			
MAIN BREAKER		WIRE SIZE			
20 1 2 LIGHTS, RIGHT CLASSROOM		12 LED Troffer			
20 3 4 RECEP'TS, RIGHT CLASSROOM, EXTERIOR		0 Compact Fluorescent			
60 5 6 HVAC UNIT, RIGHT CLASSROOM		0 Fluorescent T12 Lamp			
2P 7 8 2P 3-TON / 10kW		2 End CFL Lamp			
9 10 20 FIRE ALARM CONTROL PANEL		0 Barber Fan 80 cfm			
11 12 20		14 Receptacle circuit			
13 14		0 Receptacle Digital			
15 16		0 Receptacle Dedicated			
17 18		0 Receptacles Circuits			
19 20		0 Receptacles Heat Tape			
21 22		0 Water Heater (240v)			
23 24		0 Water Cooler			
25 26		0 Rts. Microwave			
27 28		0 Rts. Microwave			
29 30		0 Emergency Light			
31 32		2 Emergency Light			
33 34		2 Exit Signs			
35 36		1 Alarm Panel			
37 38		2 Bed Trif. 120v (240v) All Hendrie 3 Ton 110v (240v)			
39 40		12/200			
41 42		0			
MISSOURI PUBLIC SERVICE COMMISSION		200			
APPROVED 07/02/2020		AWG #3/0			
MANUFACTURED HOUSING		Service Conduit Size for:			
1 1/2 Inch		IMC, RMC or PVC			
1 Neutral		WIRE SIZE & FEET			
Service Conduits: 10 Service Guard: 6		GROUND BAR			
1 Neutral		NEUTRAL			
1 1/2 Inch		WIRE SIZE & FEET			
Service Conduits: 10 Service Guard: 6		GROUND BAR			
1 Neutral		NEUTRAL			
1 1/2 Inch		WIRE SIZE & FEET			
Service Conduits: 10 Service Guard: 6		GROUND BAR			
1 Neutral		NEUTRAL			
1 1/2 Inch		WIRE SIZE & FEET			
Service Conduits: 10 Service Guard: 6		GROUND BAR			
1 Neutral		NEUTRAL			
1 1/2 Inch		WIRE SIZE & FEET			
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1 Neutral		NEUTRAL			
1 1/2 Inch		WIRE SIZE & FEET			
Service Conduits: 10 Service Guard: 6		GROUND BAR			
1 Neutral		NEUTRAL			
1 1/2 Inch		WIRE SIZE & FEET			
Service Conduits: 10 Service Guard: 6		GROUND BAR			
1 Neutral		NEUTRAL			
1 1/2 Inch		WIRE SIZE & FEET			
Service Conduits: 10 Service Guard: 6		GROUND BAR			
1 Neutral		NEUTRAL			
1 1/2 Inch		WIRE SIZE & FEET			
Service Conduits: 10 Service Guard: 6		GROUND BAR			
1 Neutral		NEUTRAL			
1 1/2 Inch		WIRE SIZE & FEET			
Service Conduits: 10 Service Guard: 6		GROUND BAR			
1 Neutral		NEUTRAL			
1 1/2 Inch		WIRE SIZE & FEET			
Service Conduits: 10 Service Guard: 6		GROUND BAR			
1 Neutral		NEUTRAL			
1 1/2 Inch		WIRE SIZE & FEET			
Service Conduits: 10 Service Guard: 6		GROUND BAR			
1 Neutral		NEUTRAL			
1 1/2 Inch		WIRE SIZE & FEET			
Service Conduits: 10 Service Guard: 6		GROUND BAR			
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1 1/2 Inch		WIRE SIZE & FEET			
Service Conduits: 10 Service Guard: 6		GROUND BAR			
1 Neutral		NEUTRAL			
1 1/2 Inch		WIRE SIZE & FEET			
Service Conduits: 10 Service Guard: 6		GROUND BAR			
1 Neutral		NEUTRAL			
1 1/2 Inch		WIRE SIZE & FEET			
Service Conduits: 10 Service Guard: 6		GROUND BAR			
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Service Conduits: 10 Service Guard: 6		GROUND BAR			
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1 1/2 Inch		WIRE SIZE & FEET			
Service Conduits: 10 Service Guard: 6		GROUND BAR			
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Service Conduits: 10 Service Guard: 6		GROUND BAR			
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1 1/2 Inch		WIRE SIZE & FEET			
Service Conduits: 10 Service Guard: 6		GROUND BAR			
1 Neutral		NEUTRAL			
1 1/2 Inch		WIRE SIZE & FEET			