Verizon

KCYC LEE SUMMIT DOUGLAS - A

LEES SUMMIT - STREET LIGHT ID TAG: 5G09 2-2 NE DOUGLAS RD LEES SUMMIT. MO 64086

> PROJECT ID# 16054113 VERIZON PSLC# 602128

PROJECT SUMMARY PROJECT TEAM VICINITY MAP SHEET **DESCRIPTION** APPLICANT/LESSEE PROPERTY INFORMATION: APPLICANT AGENT: AJM MANAGER: TITLE SHEET LAT (Decimal): 38.937919° (NAD 83) LONG (Decimal): -94.378458° (NAD 83) LAT (Deg.Min.Sec): 38° 56' 16.5084" N LONG (Deg.Min.Sec): 94° 22' 42.4488" W vertzon/ GENERAL NOTES NAME: KPGco ADDRESS: 3305 HWY 60 W, FARIBAULT NAME: NOEL MAXEY PHONE: (949) 973-2380 GN-1 10740 NALL AVENUE GENERAL NOTES GN-2 MN 55021 OVERLAND PARK, KS 66211 CONTACT: NIKKI GAST SITE SURVEY 816 266 2378 POLE OWNER: LEES SUMMIT UTILITY COORDINATION PLAN LEES SUMMIT APPLICANT'S REPRESENTATIVE A-3 EXISTING SITE PLAN NAME: KPGco ADDRESS: 3305 HWY 60 W. FARIBAULT UTILITY COMPANY: **ENGINEER:** PROPERTY OWNER A-4 NEW SITE PLAN LEE'S SUMMIT, MISSOURI AJM CONSULTING CONTACT: NIKKI GAST 4400 F FRONT ST A-5 ELEVATION PLANS ADDRESS: 1931 NEWPORT BLVD PUBLIC R.O.W. 816.266.2378 SUITE "C", COSTA MESA CA, 92627 STEPHEN HEATH NOEL MAXEY CONTACT: MICHAEL PARK PHONE: 816-732-4160 A-6 DETAILS nikki.gast@kgpco.con ENGINEED: DETAILS CONTACT: PHONE: PROPERTY LOCATION: CONSTRUCTION INFORMATION: (949) 973-2380 DETAILS noel@ajm-consult.com AREA OF CONSTRUCTION: N/A ELECTRICAL DETAILS JURISDICTION: LEES SUMMIT COLINTY STRUCTURAL ENGINEER CITY ELECTRICAL DETAILS POLE OWNER: PUBLIC R.O.W. NAME: LEE'S SUMMIT, MISSOURI PROVIDED BY: VALMONT CITY ELECTRICAL DETAILS 12661 CORRAL PL ADDRESS: TYPE OF CONSTRUCTION: N/A SINGLE LINE DIAGRAM & GROUNDING E-4 SANTA FE SPRINGS. ACCESSIBILITY REQUIREMENTS: STRUCTURAL ANALYSIS & DETAILS FACILITY IS UNMANNED AND NOT FOR HUMAN HABITATION. HANDICAPPED ACCESS TCP-1 TRAFFIC CONTROL PLAN **CONFIDENTIAL AND PROPRIETARY** TRAFFIC CONTROL PLAN **UNDERGROUND LOCATES** PEDESTRIAN CONTROL PLAN PCP-1 NOT FOR DISCLOSURE OUTSIDE VERIZON WIRELESS INC WITHOUT WRITTE **GENERAL CONTRACTOR NOTES** ONE CALL SYSTEM www.mo1call.org DO NOT SCALE DRAWINGS IF NOT FULL SIZE (24 X 36) MISSOURI STATUTE ONTRACTOR SHALL VERIFY ALL PLANS AND EXISTING DIMENSIONS AND CONDITIONS ON THE JOB SITE AND HALL IMMEDIATELY NOTIFY THE ARCHITECT / ENGINEER IN WRITING OF ANY DISCREPANCIES BEFORE ROCEEDING WITH THE WORK OR BEAR THE RESPONSIBILITY FOR THE SAME. Know what's below. Call before you dig. REQUIRES MIN OF 2 WORKING DAYS NOTICE BEFORE YOU EXCAVATE

SCOPE OF WORK

THESE DRAWINGS DEPICT A PORTION OF A SMALL CELL TELECOMMUNICATIONS NETWORK, TO BE CONSTRUCTED, IN THE PUBLIC RIGHT OF WAY PURSUANT TO THE AUTHORITY GRANTED BY THE JURISDICTION.

CODE COMPLIANCE EQUIPMENT TO BE REMOVED:

(1) EXISTING 37'-4" STREET LIGHT

EQUIPMENT TO BE INSTALLED:

- NEW 40'-0" STREET LIGHT
- NEW COMMSCOPE OMNI ANTENNA
- NEW ERICSSON 8843 RRU
- NEW FRICSSON 4449 RRU
- NEW COMMSCOPE CABINET AT GRADE LEVEL
- NEW FIBER PULL BOX AT GRADE LEVEL

STRUCTURAL DESIGN, ENGINEERING, AND CALCULATIONS,

	ı	ISSUE STATUS				
ı	REV	DATE	DESCRIPTION	BY		
ı	Α	04/27/2020	90% CD - FOR REVIEW	NM		
ı	В	06/29/2020	90% CD - REVISED	MM		
ı	С	07/22/2020	90% CD - REVISED	NM		
ı	D	08/18/2020	100% CD	NM		
ı	Е	09/17/2020	100% CD - REVISED	TRS		
ı	F	09/30/2020	100% CD - REVISED	TRS		
ı						
ı						

1931 Newport Blvd. Suite C Costa Mesa, CA 92627-2250 Phone: 949-973-2380



3305 HWY 60 W, FARIBAULT, MN. 5502

PROPRIETARY INFORMATION

THE INFORMATION CONTAINED IN THIS SET OF DRAWINGS IS PROPRIETARY & CONFIDENTIAL TO VERIZON WIRELESS ANY USE OR DISCLOSURE OTHER THAN AS IT RELATES TO VERIZON WIRELESS IS STRICTLY PROHIBITED



SMALL CELL PROJECT

PRFI IMINARY OF M. STEPHEN D. HEATH NUMBER E-27797 PROFESS 10

SUMMIT DOUGLAS - A

LEES SUMMIT - STREET LIGHT NE DOUGLAS RD LEES SUMMIT, MO 64086

SHEET TITLE:

TITLE SHEET

T-1

APPROVALS

VERIZON PM DATE APPLICANT

PROPERTY OWNER

FROM: KANSAS CITY INTERNATIONAL AIRPORT

- HEAD SOLITHWEST ON COOKINGHAM DR TOWARD INTERNATIONAL CIR
- HEAD SOUTHWEST ON COOKINGHAM DIX TOWARD
 CONTINUE STRAIGHT ONTO INTERNATIONAL CIR
 KEEP RIGHT TO CONTINUE ON COOKINGHAM DR
 CONTINUE ONTO NW 120TH ST
- USE THE RIGHT 2 LANES TO MERGE ONTO I-29 S/US-71 S VIA THE RAMP TO KANSAS CITY
- MERGE ONTO I-29 S/US-71 S KEEP LEFT TO CONTINUE ON US-71, FOLLOW SIGNS FOR INTERSTATE 70 E/U.S. 40 E/SAINT LOUIS

DATE

- CONTINUE ONTO 1-70 E/US-71 S
 KEEP LEFT AT THE FORK TO CONTINUE ON 1-70 E/US-40 E, FOLLOW SIGNS FOR ST LOUIS
 TAKE EXIT 15A TO MERGE ONTO 1-470 S/MO-291 S TOWARD LEE'S SUMMIT
 TAKE EXIT 9 FOR DOUGLAS ST

- 12. USE ANY LANE TO TURN LEFT ONTO NE DOUGLAS ST
- 13. POLE # 5G09 2-2 WILL BE ON THE LEFT

DRIVING DIRECTIONS

- ALL WORK AND MATERIALS SHALL BE PERFORMED AND INSTALLED IN ACCORDANCE WITH THE CURRENT EDITIONS OF THE CODES AS ADOPTED BY THE LOCAL
 - INTERNATIONAL BUILDING CODE (2018)
 - INTERNATIONAL MECHANICAL CODE (2018)
 NATIONAL ELECTRIC CODE (2017)
 INTERNATIONAL FIRE CODE (2018)
 NATIONAL ELECTRIC SAFETY CODE (NESC)

 - NATIONAL FIRE PROTECTION AGENCY (NFPA) 70

 - AMERICAN ASSOCIATION OF STATE HIGHWAY AND TRANSPORTATION OFFICIALS (AASHTO) STANDARD SPECIFICATIONS FOR STRUCTURAL SUPPORTS FOR HIGHWAY SIGNS, LUMINAIRES AND TRAFFIC SIGNALS, 6TH EDITION.
 - AMERICAN PUBLIC WORKS ASSOCIATION (APWA) AND ANY SUPPLEMENTAL CHANGES
 - AMERICAN WITH DISABILITIES ACT (ADA) OF 1990.

 AMERICAN WITH DISABILITIES ACT (ADA) OF 1990.

 AMERICAN NATIONAL STANDARDS INSTITUTE (ANSI), A117.1 ACCESSIBLE AND USABLE BUILDINGS AND FACILITIES STANDARD.

 EVERGY, ELECTRICAL SERVICE STANDARD (LATEST EDITION)
 - OCCUPATIONAL SAFETY AND HEALTH ACT (OSHA) OF 1970
 - NATIONAL FIRE PROTECTION AGENCY (NFPA) 70E, STANDARD FOR ELECTRICAL SAFETY IN THE
 - NATIONAL FIRE PROTECTION AGENCT (NEFA) / DE, STANDARD FOR ELECTRICAL SALE CONTROL OF THE MORPHACE (LATEST EDITION).
 SECTION 9.5 INTERSECTION SIGHT DISTANCE, IN THE AASHTO GREEN BOOK, 6TH EDITION.

COMPLETED BY VERIZON WIRELESS/VALMONT

GENERAL NOTES

- A. THE CONTRACTOR SHALL BE RESPONSIBLE FOR SURVEY MONUMENT AND/OR VERTICAL CONTROL BENCHMARKS WHICH ARE DISTURBED OR DESTROYED BY CONSTRUCTION. A LAND SURVEYOR MUST FIELD LOCATE, REFERENCE, AND/OR PRESERVE ALL HISTORICAL OR CONTROLLING MONUMENTS BY A LAND SURVEYOR. A CORNER RECORD OR RECORD OF SURVEY, AS APPROPRIATE, SHALL BE FILED AS REQUIRED BY THE PROFESSIONAL LAND SURVEYORS ACT.
- IMPORTANT NOTICE: CALL LINDERGROUND SERVICE ALERT TOLL FREE 1-800-344-7233. THREE DAYS BEFORE YOU DIG. THE CONTRACTOR SHALL OBTAIN LOCATES FOR STREET LIGHTING, TRAFFIC SIGNAL AND FIBER OPTIC CONDUITS/CABLES.
- CONTRACTOR SHALL BE RESPONSIBLE FOR THE POT HOLE AND LOCATING OF ALL EXISTING UTILITIES THAT CROSS THE PROPOSED TRENCH LINE AND MUST MAINTAIN A 1' MIN VERTICAL CLEARANCE.
- IF ANY EXISTING HARDSCAPE OR LANDSCAPE INDICATED ON THE APPROVED PLANS IS DAMAGED OR REMOVED DURING DEMO OR CONSTRUCTION, IT SHALL BE REPAIRED AND/OR REPLACED IN KIND PER THE APPROVED PLANS.
- CONTRACTOR SHALL REPLACE OR REPAIR ALL CITY INFRASTRUCTURE DAMAGED DURING CONSTRUCTION.
- THIS PROJECT WILL BE INSPECTED BY ENGINEERING AND FIELD ENGINEERING DIVISION.
- MANHOLES OR COVERS SHALL BE LABELED VERIZON, EXCEPT FOR MANHOLES OR COVERS PLACED ON BEHALF OF THE MUNICIPALITY FOR THEIR EQUIPMENT.
- CONTRACTOR SHALL IMPLEMENT AN EROSION CONTROL PROGRAM DURING THE PROJECT CONSTRUCTION ACTIVITIES. THE PROGRAM SHALL MEET THE APPLICABLE REQUIREMENTS OR THE STATE WATER RESOURCE CONTROL BOARD.
- THE CONTRACTOR SHALL HAVE EMERGENCY MATERIALS AND EQUIPMENT ON HAND FOR UNFORESEEN SITUATIONS, SUCH AS DAMAGE TO UNDERGROUND WATER, SEWER, AND STORM DRAIN FACILITIES WHEREBY FLOWS MAY GENERATE EROSION AND SEDIMENT POLLUTION.

SPECIAL NOTES

- A. INDEMNIFICATION CLAUSE: THE CONTRACTOR AGREES AND SHALL: ASSUME SOLE AND COMPLETE RESPONSIBILITY OF THE JOB SITE CONDITIONS DURING THE COURSE OF CONSTRUCTION OF THIS PROJECT, INCLUDING THE SAFETY OF ALL PERSONS AND PROPERTIES. THAT THESE REQUIREMENTS SHALL APPLY CONTINUOUSLY AND NOT BE LIMITED TO NORMAL WORKING HOURS AND CONDITIONS THE CONTRACTOR FURTHER AGREES TO DEFEND INDEMNITY AND HOLD VERIZON, REPRESENTATIVES. AND ENGINEERS HARMLESS FROM ANY AND ALL LIABILITY, REAL OR ALLEGED IN CONNECTION WITH THE PERFORMANCE OF THE WORK ON THIS PROJECT
- ALL WORK SHALL CONFORM TO THE LATEST STANDARD "SPECIFICATIONS FOR PUBLIC WORKS CONSTRUCTION' AS ADOPTED BY THE CITY, COUNTY OR STATE AS MODIFIED BY STANDARD PLANS AND
- THE EXISTENCE AND LOCATION OF UTILITIES AND OTHER AGENCY'S FACILITIES AS SHOWN HERON ARE OBTAINED BY A SEARCH OF AVAILABLE RECORDS. OTHER FACILITIES MAY EXIST. THE CONTRACTORS SHALL VERIFY PRIOR TO THE START OF CONSTRUCTION AND SHALL USE EXTREME CARE AND PROTECTIVE MEASURES TO PREVENT DAMAGE TO THESE FACILITIES. THE CONTRACTOR IS RESPONSIBLE FOR THE PROTECTION OF ALL UTILITY OF AGENCY FACILITIES WITHIN THE LIMITS OF WORK, WHETHER THEY ARE SHOWN ON THIS PLAN OR NOT.
- THE CONTRACTOR SHALL NOTIFY THE CITY, COUNTY OR STATE ENGINEER INSPECTION DEPARTMENT, AT LEAST TWO DAYS PRIOR TO START OF ANY WORK REQUIRING THEIR INVOLVEMENT.
- THE CITY, COUNTY OR STATE SHALL SPECIFY THE EXPIRATION PERIOD OF THE PERMIT FOR THIS CONSTRUCTION PROJECT.
- THE MINIMUM COVER FOR ALL CONDUITS PLACED LINDERGROUND SHALL BE 36 INCHES TO THE FINISHED GRADE AT ALL TIMES.
- THE CONTRACTOR SHALL TUNNEL ALL CURB AND GUTTER AND BORE ALL CONCRETE DRIVEWAYS AND WALKWAYS AT THE DIRECTION OF THE CITY, COUNTY OR STATE ENGINEER.
- ALL A.C. AND/OR CONCRETE PAVEMENT SHALL BE REPLACED AT THE DIRECTION OF THE CITY. COUNTY, OR STATE ENGINEERS ALL SHRUBS, PLANTS OR TREES THAT HAVE BEEN DAMAGED OR DISTURBED DISTURBED DURING THE
- COURSE OF THE WORK, SHALL BE REPLANTED AND/OR SO AS TO RESTORE THE WORK SITE TO ITS ORIGINAL CONDITION THE CONTRACTOR WILL BE RESPONSIBLE FOR THE PROCESSING OF ALL APPLICANT PERMIT FORMS
- ALONG WITH THE REQUIRED LIABILITY INSURANCE FORMS. CLEARLY DEMONSTRATING THAT VERIZON, THE CITY, COUNTY OR STATE IS ALSO INSURED WITH THE REQUIRED LIABILITY INSURANCE FOR THIS CONSTRUCTION PROJECT
- VAULTS, PEDESTALS, CONDUITS AND OTHER TYPES OF SUBSTRUCTURE ARE EITHER SPECIFIED ON THIS PLAN OR WILL BE SPECIFIED BY THE CONSTRUCTION ENGINEER. ANY AND ALL DEVIATIONS FROM THE SPECIFIED TYPES OF MATERIAL MUST BE APPROVED BY THE SYSTEM ENGINEER, IN WRITING BEFORE INSTALLATION THEREOF. ANY EQUIPMENT OR MATERIALS PLACED ON BEHALF OF THE GOVERNING MUNICIPALITY (STREET LIGHT MATERIALS FOR EXAMPLE) WILL BE SAID MUNICIPALITY'S APPROVED MATERIALS LIST.
- THE CONTRACTOR SHALL VERIFY THE LOCATION OF ALL EXISTING UTILITIES INCLUDING SEWER LATERALS & WATER SERVICES TO INDIVIDUAL LOTS BOTH VERTICAL AND HORIZONTAL PRIOR TO COMMENCING IMPROVEMENT OPERATIONS.
- M. CONTRACTOR SHALL MAKE EXPLORATION EXCAVATIONS AND LOCATE EXISTING FACILITIES SUFFICIENTLY AHEAD OF CONSTRUCTION TO PERMIT REVISIONS TO PLANS IF A REVISION IS NECESSARY BECAUSE OF LOCATION OF UTILITIES.
- THE LOCATIONS OF ALL EXISTING UTILITIES SHOWN ON THESE PLANS ARE FROM EXISTING RECORDS AND CORROBORATED. WHERE POSSIBLE. WITH FIELD TIES. THE CONTRACTOR IS RESPONSIBLE FOR CONFIRMING THE LOCATIONS SHOWN BOTH HORIZONTAL AND VERTICALLY PRIOR TO CONSTRUCTION, IF EXISTING LOCATION VARY SUBSTANTIALLY FROM THE PLANS. THE ENGINEER SHOULD BE NOTIFIED TO MAKE ANY CONSTRUCTION CHANGES REQUIRED.
- O. ALL MATERIAL USED IN CONSTRUCTION THAT WILL BE OWNED AND MAINTAINED BY THE CITY SHALL BE FROM THE APPROVED MATERIALS LIST.

EROSION AND SEDIMENT CONTROL NOTES

TEMPORARY EROSION/SEDIMENT CONTROL PRIOR TO COMPLETION OF FINAL IMPROVEMENTS, SHALL BE PERFORMED BY THE CONTRACTOR OR QUALIFIED PERSON AS INDICATED BELOW:

- A. ALL REQUIREMENTS OF THE CITY, COUNTY AND STATE "STORM WATER STANDARDS" MUST BE INCORPORATED INTO THE DESIGN AND CONSTRUCTION OF THE PROPOSED GRADING/IMPROVMENTS CONSISTENT WITH THE APPROVED STORM WATER POLITITION PREVENTION PLAN (SWPP) WATER QUALITY TECHNICAL REPORT (WQTR), AND/OR WATER POLLUTION CONTROL PLAN (WPCP).
- FOR STORM DRAIN INLETS, PROVIDE AS GRAVEL BAG SILT BASIN IMMEDIATELY UPSTREAM INLET AS INDICATED ON DETAILS.
- FOR INLETS LOCATED AT SUMPS ADJACENT TO THE TOP OF SLOPES. THE CONTRACTOR SHALL ENSURE WATER DRAINING TO THE SUMP IS DIRECTED INTO THE INLET AND THAT A MINIMUM OF 1.00' FREEBOARD EXISTS AND IS MAINTAINED ABOVE THE TOP OF THE INLET. IF FREEBOARD IS NOT PROVIDED BY GRADING SHOWN ON THESE PLANS THE CONTRACTOR SHALL PROVIDE IT VIA TEMPORARY MEASURES, I.E. GRAVEL BAGS OF DIKES.
- THE CONTRACTOR OR QUALIFIED PERSON SHALL BE RESPONSIBLY FOR CLEANUP OF SILT AND MUD ON ADJACENT STREETS AND STORM DRAIN SYSTEM DUE TO CONSTRUCTION ACTIVITY
- THE CONTRACTOR OR QUALIFIED PERSON SHALL CHECK AND MAINTAIN ALL LINED AND UNLINED DITCHES AFTER EACH RAINFALL.
- THE CONTRACTOR SHALL REMOVE SILT AND DERRIS AFTER EACH MAJOR RAINEALL
- FOUIPMENT AND WORKERS FOR EMERGENCY WORK SHALL BE MADE AVAILABLE AT ALL TIMES DURING THE RAINY SEASON. ALL NECESSARY MATERIALS SHALL BE STOCK PILED ON SITE CONVENIENT LOCATIONS TO FACILITATE RAPID CONSTRUCTION OR TEMPORARY DEVICES WHEN RAIN IS IMMINENT
- THE CONTRACTOR SHALL RESTORE ALL EROSION/SEDIMENT CONTROL DEVICES TO WORKING ORDER TO THE SATISFACTION OF THE CITY ENGINEER OR RESIDENT ENGINEER AFTER EACH RUN-OFF PRODUCING RAINFALL
- THE CONTRACTOR SHALL INSTALL ADDITIONAL FROSION/SEDIMENT CONTROL MEASURES AS MAY BE REQUIRED BY THE RESIDENT ENGINEER DUE TO UNCOMPLETED GRADING OPERATIONS OR UNFORESEEN CIRCUMSTANCES, WHICH MAY ARISE.
- THE CONTRACTOR SHALL BE RESPONSIBLE AND SHALL TAKE THE NECESSARY PRECAUTIONS TO PREVENT PUBLIC TRESPASS ONTO AREAS WHERE IMPOUNDED WATERS CREATE A HAZARDOUS
- K. ALL EROSION/SEDIMENT CONTROL MEASURES PROVIDED PER THE APPROVED GRADING PLAN SHALL BE INCORPORATED HERON. ALL EROSION/SEDIMENT CONTROL FOR INTERIM CONDITION SHALL BE DONE TO THE SATISFACTION OF THE RESIDENT ENGINEER.
- GRADED AREAS AROUND THE PROJECT PERIMETER MUST DRAIN AWAY FROM THE FACE OF THE SLOPE AT THE CONCLUSION OF EACH WORK DAY.
- ALL REMOVABLE PROTECTIVE DEVICES SHOWN SHALL BE IN PLACE AT THE END OF EACH WORKING DAY WHEN RAIN IMMINENT
- THE CONTRACTOR SHALL ONLY GRADE, INCLUDING CLEARING AND GRUBBING FOR THE AREAS FOR WHICH THE CONTRACTOR OR QUALIFIED PERSON CAN PROVIDE EROSION/SEDIMENT CONTROL

ROW GROUND CONSTRUCTION NOTES

- GC TO REMOVE/CLEAN ALL DEBRIS, NAILS, STAPLES, OR NON-USED VERTICALS OFF THE POLE.
- STANDARDS AND REGULATIONS.
- ALL LANDSCAPING TO BE RESTORED TO ORIGINAL CONDITION OR BETTER
- METERING CABINET REQUIRES 3' CLEARANCE AT DOOR OPENING.

- GROUND TESTED AT 5 OHMS OR LESS
- 5/8" X 10'-0" ROD, CADWELD BELOW GRADE.
- #6 WIRE FOR GROUNDING OR BONDING.
- WOOD MOLDING, STAPLED EVERY 3' AND AT EACH END.

STANDARD CONDUIT NOTES

- FOR UNDERGROUND USE SCHEDULE 40 CONDUIT.
- FOR RISERS USE SCHEDULE 80 CONDUIT.
- PLACE 2" GALVANIZED STEEL CONDUIT FOR ANY CONDUIT UNDER 3".
- CONVERT 4" CARRIER CONDUIT TO 3" AT BASE OF POLE.
- SCH 80 FROM TOP OF STUB UP
- ALL CONDUIT SHALL BE MANREL TESTED AND EQUIPPED WITH 3/8" PULL ROPE.
- SAND BEDDING MINIMUM 1" UNDER CONDUITS, AND 6" SANDSHADING ON TOP REQUIRED.
- ALL TRENCHED ELECTRICAL SERVICE CONDUITS FROM POWER COMPANY, WHETHER FROM POLES,
- IN STREET SLURRY TO GRADE AND MILL DOWN 1-1/2" FOR AC CAP.
- IN DIRT SLURRY 18" FROM GRADE, AND FILL WITH 95% COMPACTION NATIVE SOIL FOR BALANCE.
- PLACE WARNING TAPE IN TRENCH 12" ABOVE ALL CONDUITS AND #18 WARNING TAPE ABOVE GROUND

ROW GROUND CONSTRUCTION NOTES

- FILL ALL HOLES LEFT IN POLE OF REARRANGEMENT OF CLIMBERS
- 90° SHORT SWEEPS UNDER ANTENNA ARM. ALL CABLES MUST ONLY TRANSITION ON THE INSIDE OR
- USE 90° CONNECTOR AT CABLE CONNECTION TO ANTENNAS.
- ANTENNA. WHICH IS 24" AWAY FROM CENTER OF POLE.
- FILL VOID AROUND CABLES AT CONDUIT OPENING WITH FOAM SEALANT TO PREVENT WATER

- A. 120/240 OR 120/208 POWER REQUIRED FOR 1-PHASE, 3-WIRE SERVICE.
- ALL CONSTRUCTION SHALL BE IN ACCORDANCE WITH MUNICIPAL, COUNTY, STATE, AND FEDERAL
- CALL DIG SAFE USA 72 HOURS PRIOR TO EXCAVATING AT (800) 344-7483
- ALL EQUIPMENT TO BE BONDED.
- CAULK CABINET BASE AT PAD.

STANDARD GROUNDING NOTES

- GROUNDS 3' FROM POLE.

- GC TO STUB UP POLE 10' W/ 3" POWER CONDUIT, POWER CO. TO CONVERT FROM 3" SCH. 80 TO 2" $\,$

- TRANSFORMERS, OR OTHER LOCATIONS; WILL BE SLURRY BACKFILLED.

- NO BOLT THREADS TO PROTRUDE MORE THAN 1-1/2".
- ALL CLIMB STEPS NEXT TO CONDUITS SHALL HAVE EXTENDED STEPS.
- CABLE NOT TO IMPEDE 15" CLEAR SPACE OFF POLE FACE (12:00)
- BOTTOM OF ARMS (NO CABLE ON TOP OF ARMS)
- USE CABLE CLAMPS TO SECURE CABLE TO ARMS; PLACE 2" CARRIER CABLE ID TAGS ON BOTH SIDES OF
- PLACE GPS ANTENNA ON ARM WITH SOLITHERN SKY EXPOSLIRE AT MINIMUM 6' FROM TRANSIT
 - USE 1/2" CABLE ON ANTENNAS UNLESS OTHERWISE SPECIFIED.

ISSUE STATUS REV DATE DESCRIPTION A 04/27/2020 90% CD - FOR REVIEW NN B 06/29/2020 90% CD - REVISED NI C 07/22/2020 90% CD - REVISED NM

D 08/18/2020 100% CD E 09/17/2020 100% CD - REVISED F 09/30/2020 100% CD - REVISED

AJM Consulting

1931 Newport Blvd. Suite O Costa Mesa, CA 92627-2250 Phone: 949-973-2380



3305 HWY 60 W, FARIBAULT, MN. 55021

PROPRIETARY INFORMATION

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SMALL CELL PROJECT

PRFI IMINARY OF M **STEPHEN** D. HEATH NUMBER E-27797 PROFESSION

DATE: 04-27-2020

SUMMIT LEES SUMMIT - STREET LIGHT

NE DOUGLAS RD LEES SUMMIT, MO 64086

SHEET TITLE: **GENERAL NOTES**

GENERAL NOTES

FLECTRICAL

- A. CONTRACTOR SHALL REVIEW THE THE CONTRACT DOCUMENTS PRIOR TO ORDERING THE ELECTRICAL EQUIPMENT AND STARTING THE ACTUAL CONSTRUCTION. CONTRACTOR SHALL ISSUE A WRITTEN NOTICE OF ALL FINDINGS TO THE ENGINEER LISTING ANY DISCREPANCIES OR CONFLICTING INFORMATION.
- 8. ELECTRICAL PLANS, DETAILS AND DIAGRAMS ARE DIAGRAMMATIC ONLY. VERIFY EXACT LOCATIONS AND MOUNTING HEIGHTS OR ELECTRICAL EQUIPMENT WITH OWNER PRIOR TO INSTALLATION.
- C. EACH CONDUCTOR OF EVERY SYSTEM SHALL BE PERMANENTLY TAGGED IN EACH PANELBOARD, PULLBOX, JUNCTION BOX, SWITCH BOX, ETC. THE TYPE OF TAGGING METHODS SHALL BE IN COMPLIANCE WITH OCCUPATIONAL SAFETY AND HEALTH ADMINISTRATION (OSHA).
- D. ALL MATERIALS AND EQUIPMENT SHALL BE NEW AND IN GOOD WORKING CONDITION WHEN INSTALLED AND SHALL BE OF THE BEST GRADE AND OF THE SAME MANUFACTURER THROUGHOUT FOR EACH CLASS OR GROUP OF EQUIPMENT. MATERIALS SHALL BE LISTED "UL" WHERE APPLICABLE. MATERIALS SHALL MEET WITH APPROVAL OF ALL GOVERNING BODIES HAVING JURISDICTION. MATERIALS SHALL BE MANUFACTURED IN ACCORDANCE WITH APPLICABLE STANDARDS ESTABLISHED BY ANSI, NEMA, NBFU AND "UL" LISTED.
- . ALL CONDUIT SHALL HAVE A PULL CORD.
- F. PROVIDE PROJECT MANAGER WITH ON SET OF COMPLETE ELECTRICAL "AS-INSTALLED" DRAWINGS AT THE COMPLETION OF THE JOB, SHOWING ACTUAL DIMENSIONS, ROUTINGS, AND CIRCUITS.
- G. ALL CIRCUIT BREAKERS, FUSES AND ELECTRICAL EQUIPMENT SHALL HAVE AN INTERRUPTING SHORT
 CIRCUIT CURRENT TO WHICH THEY MAY BE SUBJECTED. AN A MIN OF 10 000 AIC
- H. THE ENTIRE ELECTRICAL INSTALLATION SHALL BE GROUNDED AS REQUIRED BY IBC, NEC AND ALL APPLICABLE CODES.
- PATCH, REPAIR, AND PAINT ANY AREA THAT HAS BEEN DAMAGED IN THE COURSE OF THE ELECTRICAL
- PLASTIC PLATES FOR ALL SWITCHES, RECEPTACLES, TELEPHONE AND BLANKED OUTLETS SHALL HAVE ENGRAVED LETTERING WHERE INDICATED ON THE DRAWINGS. WEATHERPROOF RECEPTACLES SHALL HAVE SIERRA #WPD-8 LIFT COVER PLATES

SERVICE AND DISTRIBUTION

- A. STREETLIGHTING DISTRIBUTION CABLE MUST BE #2, #4, #6, OR #8 AWG CU RHW/USE, 600V, COPPER STRANDED AND COLOR CODED BLACK, RED (OR BLACK) AND GREEN (APWA 2802.8) FOR A GROUNDED 240V SYSTEM (SINGLE PHASE)
- B. STREETLIGHTING DISTRIBUTION CABLE SHALL BE INSTALLED IN SCH 40, 2" PVC CONDUIT OR IN PREASSEMBLED "CABLE-IN-DUCT". ALL CONDUIT RUNS SHALL BE PLACED 24" FROM BACK OF CURB WHERE POSSIBLE AND AT A MIN DEPTH OF 24"
- C. STREETLIGHT CABLE USED WITHIN THE POLES SHALL BE 3 #10, TYPE RHW/USE, 600 VOLTS RATED COPPER, UL LISTED AND COLOR CODED RED, BLACK, AND GREEN ACCORDING TO THE NEC.
- D. PROVIDE AND INSTALL IN EACH POLE BASE, 3 SINGLE-POLE, SET-SCREW, IN-LINE, BREAKAWAY, FUSEHOLDERS. USE BUSSMAN (OR APPROVED EQUAL) MODEL NO. HEB-JW-RYC AND HEB-JW-RLC-J (LAST POLE). FOR THE 2 "HOT" BREAKAWAY CONDUCTORS, PLACE A 10 AMP KTK FUSE IN EACH BREAKAWAY FUSEHOLDER AND A NNB COPPER SLUG IN THE SYSTEM GROUND FUSEHOLDER.
- E. WIRE AND CABLE CONDUCTORS SHALL BE COPPER, 600V, TYPE THHN OR THWN, WITH A MIN SIZE OF #12 AWG, COLOR CODED UNLESS OTHERWISE NOTED.
- F. METER SOCKET AMPERES, VOLTAGE, NUMBER OF PHASES SHALL BE NOTED ON THE DRAWINGS.
 MANUFACTURED BY MILBANK OR APPROVED EQUAL, AND SHALL BE UTILITY COMPANY APPROVED.
- G. RIGID CONDUIT SHALL BE UL LABEL GALVANIZED ZINC COATED WITH GALVANIZED ZINC INTERIOR AND SHALL BE USED WHEN INSTALLED IN OR UNDER CONCRETE SLABS, IN CONTACT WITH THE EARTH, UNDER PUBLIC ROADWAYS, IN MASONRY WALLS OR EXPOSED ON BUILDING EXTERIOR. RIGID CONDUIT IN CONTACT WITH EARTH SHALL BE 1/2 LAPPED WRAPPED WITH HUNTS WRAP PROCESS NO. 3.
- H. FLEXIBLE METALLIC CONDUIT SHALL HAVE UL LISTED LABEL AND MAY BE USED WHERE PERMITTED BY CODE. FITTINGS SHALL BE "JAKE" OR "SQUEEZE" TYPE. ALL FLEXIBLE CONDUITS SHALL HAVE FULL LENGTH GROUND WIRE.
- IT IS REQUIRED AND WILL BE THE RESPONSIBILITY OF THE ELECTRICAL CONTRACTOR TO NOTIFY 811 OR OTHER SUCH UTILITY LOCATING AGENCY 3 DAYS BEFORE DIGGING.

- J. CONTRACTOR TO COORDINATE WITH UTILITY COMPANY FOR CONNECTION OF TEMPORARY AND PERMANENT POWER TO THE SITE, THE TEMPORARY POWER AND ALL HOOKUP COSTS ARE TO BE PAID BY THE CONTRACTOR
- K. ALL ELECTRICAL EQUIPMENT SHALL BE LABELED WITH PERMANENT ENGRAVED PLASTIC LABELS WITH WHITE ON BLUE BACKGROUND LETTERING (MIN LETTER HEIGHT SHALL BE 1/4"). NAMEPLATES SHALL BE FASTENED WITH STAINLESS STEEL SCREWS. NOT ADHESIVE.
- L. UPON COMPLETION OF WORK, CONTINUITY, SHORT CIRCUIT AND FALL POTENTIAL GROUNDING TESTS BY AN INDEPENDENT TESTING SERVICE ENGAGED BY THE CONTRACTOR SHALL BE SUBMITTED FOR APPROVAL. SUBMIT TEST REPORTS TO THE PROJECT MANAGER. CLEAN PREMISES OF ALL DEBRIS RESULTING FROM WORK AND LEAVE WORK IN A COMPLETE AND UNDAMAGED CONDITION.
- M. GROUNDING ELECTRODE SYSTEM: FOR SURFACE PREPARATION ALL CONNECTIONS SHALL BE MADE TO BARE METAL. ALL PAINTED SURFACES SHALL BE FIELD INSPECTED AND MODIFIED TO ENSURE PROPER CONTACT. NO WASHERS ARE ALLOWED BETWEEN THE ITEMS BEING GROUNDED. ALL CONNECTIONS ARE TO HAVE A NON-OXIDIZING AGENT APPLIED PRIOR TO INSTALLATION.
- N. IF CONDUCTORS MUST RUN THROUGH CONDUIT, BOTH ENDS OF CONDUIT SHALL BE GROUNDED. SEAL BOTH ENDS OF CONDUIT WITH SILICONE CAULK.
- O. EXTERNAL CONNECTIONS: ALL BURIED GROUNDING CONNECTIONS SHALL BE MADE BY THE EXOTHERMIC WELD PROCESS. CONNECTIONS SHALL INCLUDE ALL CABLE TO CABLE, SPLICES, TEES, CROSSES, ETC. ALL CABLE TO GROUND RODS, GROUND ROD SPLICES AND LIGHTING PROTECTION SYSTEMS ARE TO BE AS INDICATED, ALL MATERIALS USED (MOLDS, WELDING METAL, TOOLS, ETC.) SHALL BE BY "ULTRAWELD" AND INSTALLED PER MANUFACTURERS RECOMMENDATIONS.
- P. ALL ABOVE GRADE GROUNDING AND BONDING CONDUCTORS SHALL BE CONNECTED BY TWO HOLE CRIMP TYPE (COMPRESSION) CONNECTIONS (EXCEPT FOR THE ACEG AND GROUND ROD). MECHANICAL CONNECTIONS, FITTINGS OR CONNECTIONS THAT DEPEND SOLEY ON SOLDER SHALL NOT BE USED. ALL CABLE TO CABLE CONNECTIONS SHALL BE HIGH PRESSURE DOUBLE CRIMP TYPE CONNECTIONS. CONNECTIONS TO STRUCTURAL STEEL SHALL BE EXOTHERMIC WELDS.
- Q. GROUND RODS: ALL GROUND RODS SHALL BE 5/8-INCH DIAMETER x 10'-0" LONG "COPPERWELD" OR APPROVED EQUAL, OF THE NUMBER AND LOCATIONS INDICATED. GROUND RODS SHALL BE DRIVEN FULL LENGTH VERTICAL IN UNDISTURBED EARTH.
- R. GROUND CONDUCTORS: ALL GROUND CONDUCTORS SHALL BE STANDARD TINNED SOLID BARE COPPER ANNEALED, AND OF SIZE INDICATED ON DRAWINGS UNLESS OTHERWISE NOTED.
- S. LUGS SHALL BE 2-HOLE, LONG BARREL, STRAND COPPER UNLESS OTHERWISE SPECIFIED IN THE CONTRACT DOCUMENTS. LUGS SHALL BE THOMAS AND BETTS SERIES #54 BE OR EQUIVALENT.

 535 MCM DLO 	54880BE
2. 262 MCM DLO	54872BE
3. #1/0 DLO	54862BE
4. #4/0 THWN & BARE	54866BE
5. #2/0 THWN	54862BE
6. #2 THHN	54207BE
7. #6 DLO	54205BE

T. WHEN THE DIRECTION OF THE CONDUCTOR MUST CHANGE, IT SHALL BE DONE GRADUALLY. THE CURVATURE OF THE TURN SHALL BE DONE IN ACCORDANCE WITH THE FOLLOWING CHART:

MINIMUM BENDING GROUNDING CONDUCTOR SIZE	RADIUS TO INSIDE ED
NO. 6 AWG TO NO. 4 AWG	6 INCHES
NO. 2 AWG TO NO. 1/0 AWG	8 INCHES
NO. 2/0 AWG TO 4/0 AWG	12 INCHES
NO. 250 MCM TO 750 MCM	24 INCHES

U. GROUNDING RESISTANCE TEST REPORT: UPON COMPLETION OF THE TESTING FOR EACH SITE, A TEST REPORT SHOWING RESISTANCE IN OHMS MUST BE SUBMITTED. TWO (2) SETS OF TEST DOCUMENTS FROM THE INDEPENDENT TESTING SERVICE ARE TO BE BOUND AND SUBMITTED WITHIN ONE (1) WEEK OF WORK

POLES, POSTS, AND STANDARDS (SINGLE MAST & SELF SUPPORTING TOWERS

- LIGHTNING ROD AND EXTENSION PIPE INCLUDING ALL APPURTENANCES, TO BE FURNISHED BY VERIZON. IF REQUIRED.
- B. GROUNDING: GROUND METAL POLES WITH A MINIMUM OF #2 AWG TINNED SOLID BARE COPPER CONDUCTOR USING EXOTHERMIC CONNECTION TO TOWER BASE PLATE.

TELECOMMUNICATIONS WIRING COMPONENTS (COAXIAL ANTENNA CABLE

- A. ALL MATERIALS, PRODUCTS OR PROCEDURES INCORPORATED INTO WORK SHALL BE NEW AND OF STANDARD COMMERCIAL QUALITY
- B. ALL MATERIALS AND PRODUCTS SPECIFIED IN THE CONTRACT DOCUMENTS SHALL BE SUPPLIED BY THE CONTRACTOR UNLESS NOTED OTHERWISE.
- COAXIAL CABLE: INSTALL COAXIAL CABLE AND TERMINATIONS BETWEEN ANTENNAS AND EQUIOMENT PER MANUFACTURERS RECOMMENDATIONS WITH COAXIAL CABLES SUPPORTED AT NO MORE THAN 3'-0" O.C. WEATHERPROOF ALL CONNECTORS BETWEEN THE ANTENNA AND EQUIPMENT PER MANUFACTURERS REQUIREMENTS. TERMINATE ALL COAXIAL CABLE THREE FEET (3') IN EXCESS OF EQUIPMENT LOCATION UNLESS OTHERWISE STATED.
- D. COAXIAL LENGTHS LESS THAN OR EQUAL TO 100 FEET SHALL BE 7/8"
- E. ALL COAXIAL CABLE GROUNDING KITS ARE TO BE INSTALLED ON STRAIGHT RUNS OF COAXIAL CABLE (NOT WITHIN BENDS)
- F. TO PROVIDE EASY IDENTIFICATION AND UNIFORM MARKING OF ANTENNA CABLING, PLASTIC TAGS SHALL BE USED AT THE FOLLOWING LOCATIONS: FIRST LOCATION IS AT THE END OF THE COAX NEAREST THE ANTENNA (WHERE THE COAXIAL CABLE AND JUMPER ARE CONNECTED). SECOND LOCATION IS AT THE END OF THE COAX NEAREST THE EQUIPMENT.
- G. USE ANDREW CABLE TIES (PT.# 27290) TO SECURE IDENTIFICATION TAGS.
- I. TESTING: LESSEE SHALL PROVIDE AN INDEPENDENT TESTING AGENCY TO PERFORM THE COAXIAL SWEEP TEST & REPORT. THE CONTRACTOR IS TO PROVIDE ONE CLIMBER/QUALIFIED PERSONNEL TO ASSIST IN ANY REPAIRS AND WEATHERPROOFING ONCE THE TEST IS COMPLETE. THE CONTRACTOR IS TO PROVIDE LESSEE WITH A MINIMUM OF 48 HOURS NOTICE PRIOR TO THE TIME OF THE SWEEP TEST

ISSUE STATUS

Ш	REV	DATE	DESCRIPTION	BY
Ш	Α	04/27/2020	90% CD - FOR REVIEW	NM
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Ш	С	07/22/2020	90% CD - REVISED	NM
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Ш	Е	09/17/2020	100% CD - REVISED	TRS
Ш	F	09/30/2020	100% CD - REVISED	TRS
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Consulting

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3305 HWY 60 W, FARIBAULT, MN. 55021 PHONE: 913.219.1065

PROPRIETARY INFORMATION

THE INFORMATION CONTAINED IN THIS SET OF DRAWINGS IS PROPRIETARY & CONFIDENTIAL TO VERIZON WIRELESS ANY USE OR DISCLOSURE OTHER THAN AS IT RELATES TO VERIZON WIRELESS IS STRICTLY PROHIBITED



SMALL CELL PROJECT

PRELIMINARY



DATE: 04-27-2020


KCYC LEE SUMMIT DOUGLAS - A


LEES SUMMIT - STREET LIGHT NE DOUGLAS RD LEES SUMMIT. MO 64086

SHEET TITLE:

GENERAL NOTES

GN-2

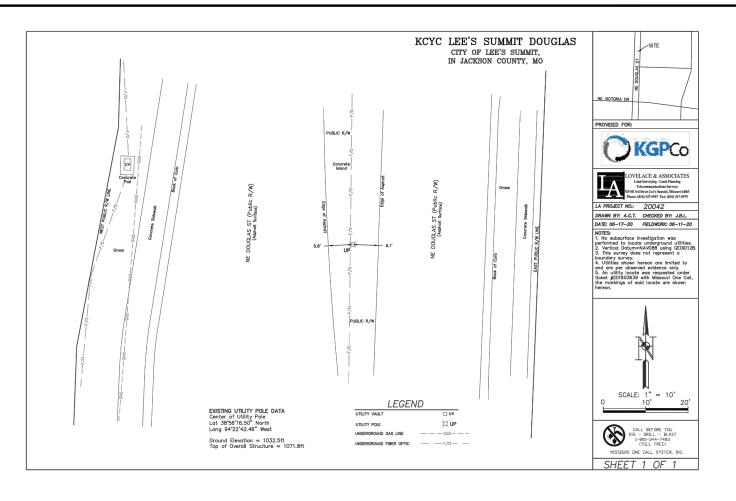

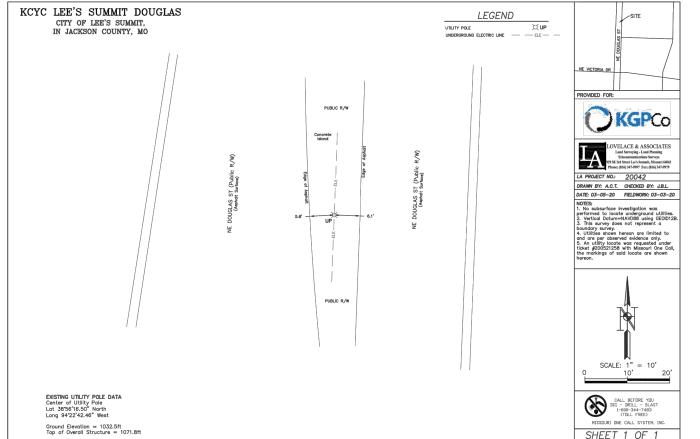

ISSUE STATUS REV DATE DESCRIPTION BY A 04/27/2020 90% CD - FOR REVIEW NM B 06/29/2020 90% CD - REVISED NM C 07/22/2020 90% CD - REVISED NM D 08/18/2020 100% CD E 09/17/2020 100% CD - REVISED TRS F 09/30/2020 100% CD - REVISED TRS

AJM Consulting

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10740 NALL AVENUE OVERLAND PARK, KS. 66211 PHONE: 800-264-6620

SMALL CELL PROJECT

PRELIMINARY



KCYC LEE SUMMIT DOUGLAS - A

LEES SUMMIT - STREET LIGHT NE DOUGLAS RD LEES SUMMIT, MO 64086

SHEET TITLE:

SITE SURVEY

Evergy

- Point of service will be new pole mounted transformer on pole # 1325936
- Install 15kVA transformer and secondary riser on pole # 1325936

Joint Use

No make ready required

Foreman:

YES / NO Built as designed:

Initials: Date:

Verizon Contractor

Install 85ft of conduit to new meter pedestal which will be west of site

Note: Refer to construction drawing for wire sizes and specifications




Foreman:

YES / NO Built as designed:

Initials: Date:

- This utility plan was generated without the use of a survey. Property lines, dimensions, power and telco utility point connections/routes and easements shown on these plans are estimated
- City of Lee's Summit approved contractor is required to remove old street light pole and install new bracket arm and street light head
- All Evergy facilities are designed to be in right of way or utility easement
- Coordinate with Black & McDonald to make secondary connections on Evergy facilities
- Supply Black & McDonald electrical permitting and city clearance inspection to install meter

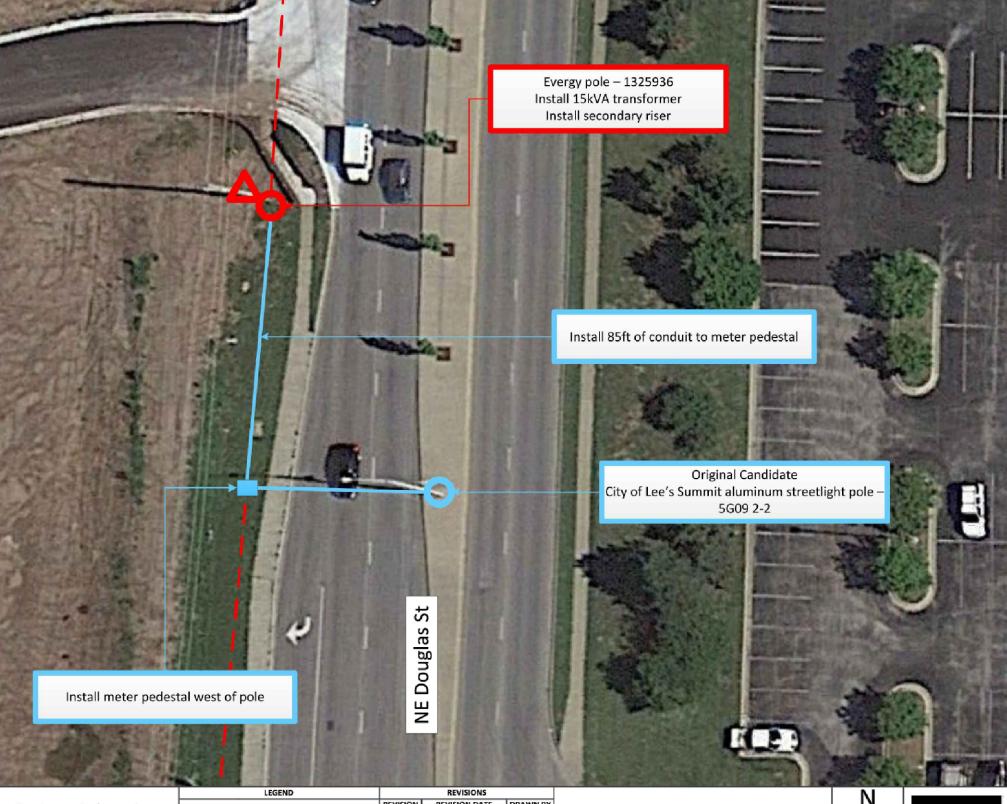

ISSUE STATUS REV DATE DESCRIPTION

A 04/27/2020 90% CD - FOR REVIEW B 06/29/2020 90% CD - REVISED C 07/22/2020 90% CD - REVISED NM 100% CD - REVISED

Costa Mesa, CA 92627-2250 Phone: 949-973-2380



PROPRIETARY INFORMATION



SMALL CELL PROJECT

PRELIMINARY STEPHEN D. HEATH NUMBER E-27797

DATE: 04-27-2020

KCYC LEE **SUMMIT** DOUGLAS - A

EES SUMMIT - STREET LIGHT NE DOUGLAS RD LEES SUMMIT. MO 64086

SHEET TITLE:

UTILITY **COORDINATION PLAN**


A-2



Black&McDonald

6001 Front St

Kansas City, MO 64120

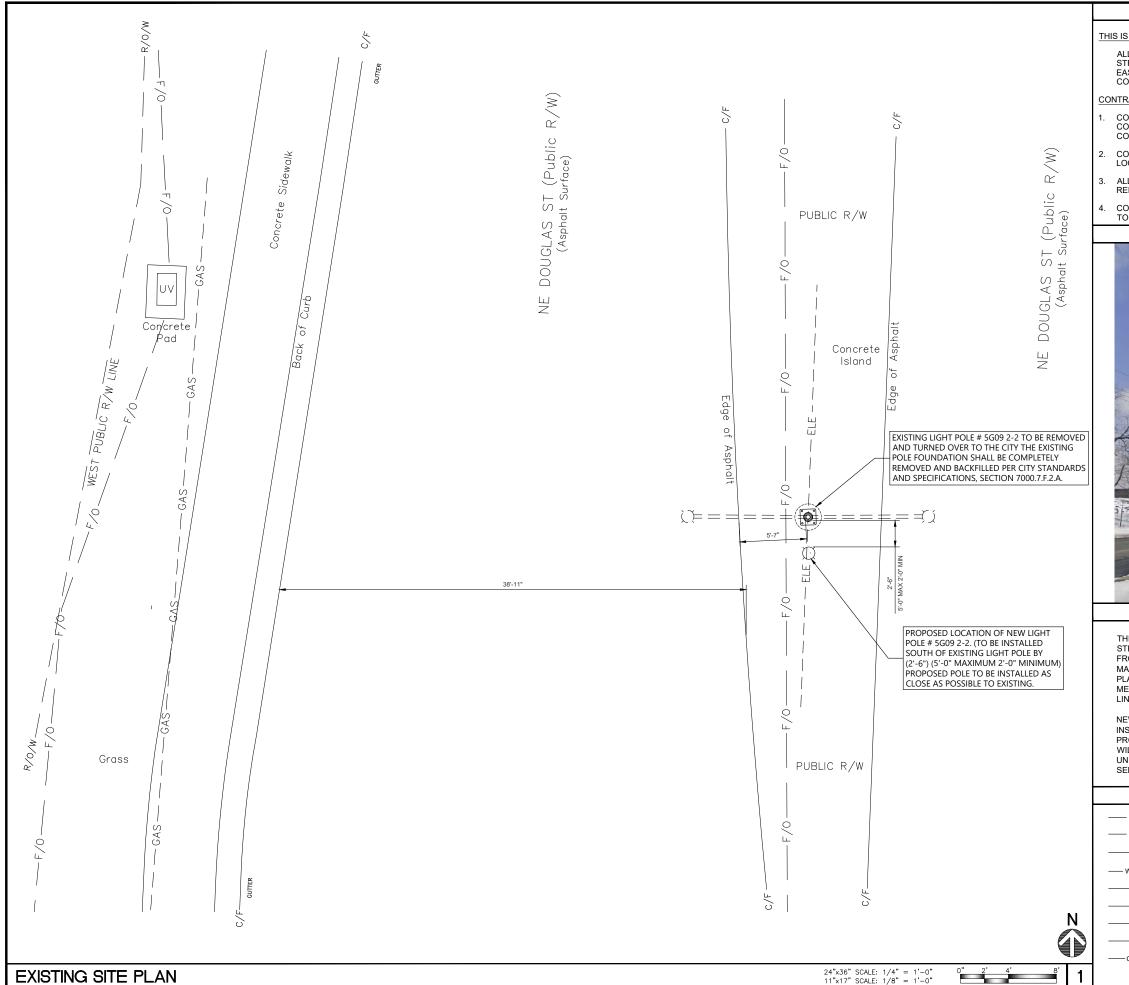

NOTES

THIS IS NOT A SITE SURVEY:

ALL PROPERTY BOUNDARIES, ORIENTATION OF TRUE NORTH & STREET HALF-WIDTHS ARE APPROXIMATE. ALL PROPERTY LINES, EASEMENTS, & SETBACKS SHALL BE VERIFIED PRIOR TO START OF CONSTRUCTION.

CONTRACTOR NOTES:

- CONTRACTOR SHALL REPAIR ALL DAMAGES RESULTING FROM CONSTRUCTION BACK TO PRE-CONSTRUCTION CONDITIONS AT COMPLETION OF WORK.
- 2. CONTRACTOR SHALL COORDINATE SITE ACCESS AND STAGING LOCATIONS WITH LANDLORD.
- ALL STREET LIGHT POLES WILL REQUIRE A NEW FOUNDATION. REFERENCE TO STRUCTURAL PLANS PROVIDED BY OTHERS.
- CONTRACTOR TO FIELD VERIFY EXACT LOCATION OF ALL EQUIPMENT TO MEET SYSTEM REQUIREMENTS.

EXHIBIT PHOTO




UTILITY NOTE:

THE LOCATIONS AND EXISTENCE OF ANY UNDERGROUND PIPES, STRUCTURES OR CONDUITS SHOWN ON THIS PLAN WERE OBTAINED FROM LOVELACE & ASSOCIATES AND ARE APPROXIMATE. THERE MAY BE EXISTING UTILITIES OTHER THAN THOSE SHOWN ON THIS PLAN. THE CONTRACTOR IS REQUIRED TO TAKE PRECAUTIONARY MEASURES TO PROTECT THE UTILITY LINES SHOWN AND ANY OTHER LINES SHOWN ON THIS PLAN.

NEW UTILITY SERVICE FROM TELCO POC TO VERIZON WIRELESS INSTALLED FIBER PULL BOX TO BE DETERMINED BY UTILITY PROVIDER. UPON SERVICE CONTRACT AWARD, THE FIBER PROVIDER WILL DESIGN, CONSTRUCT, AND INSTALL UTILITY INFRASTRUCTURE UNDER THEIR RIGHTS/SEPARATE PERMIT AND WILL COORDINATE SERVICE ACTIVATION WITH VERIZON WIRELESS.

UTILITY LEGEND

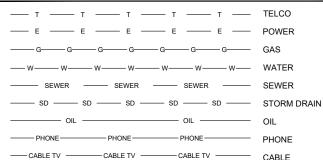

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MLG

Consulting

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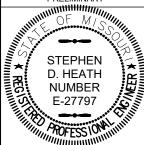
PROPRIETARY INFORMATION

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PRELIMINARY




DATE: 04-27-2020

KCYC LEE SUMMIT DOUGLAS - A

LEES SUMMIT - STREET LIGHT NE DOUGLAS RD LEES SUMMIT, MO 64086

SHEET TITLE:

EXISTING SITE PLAN

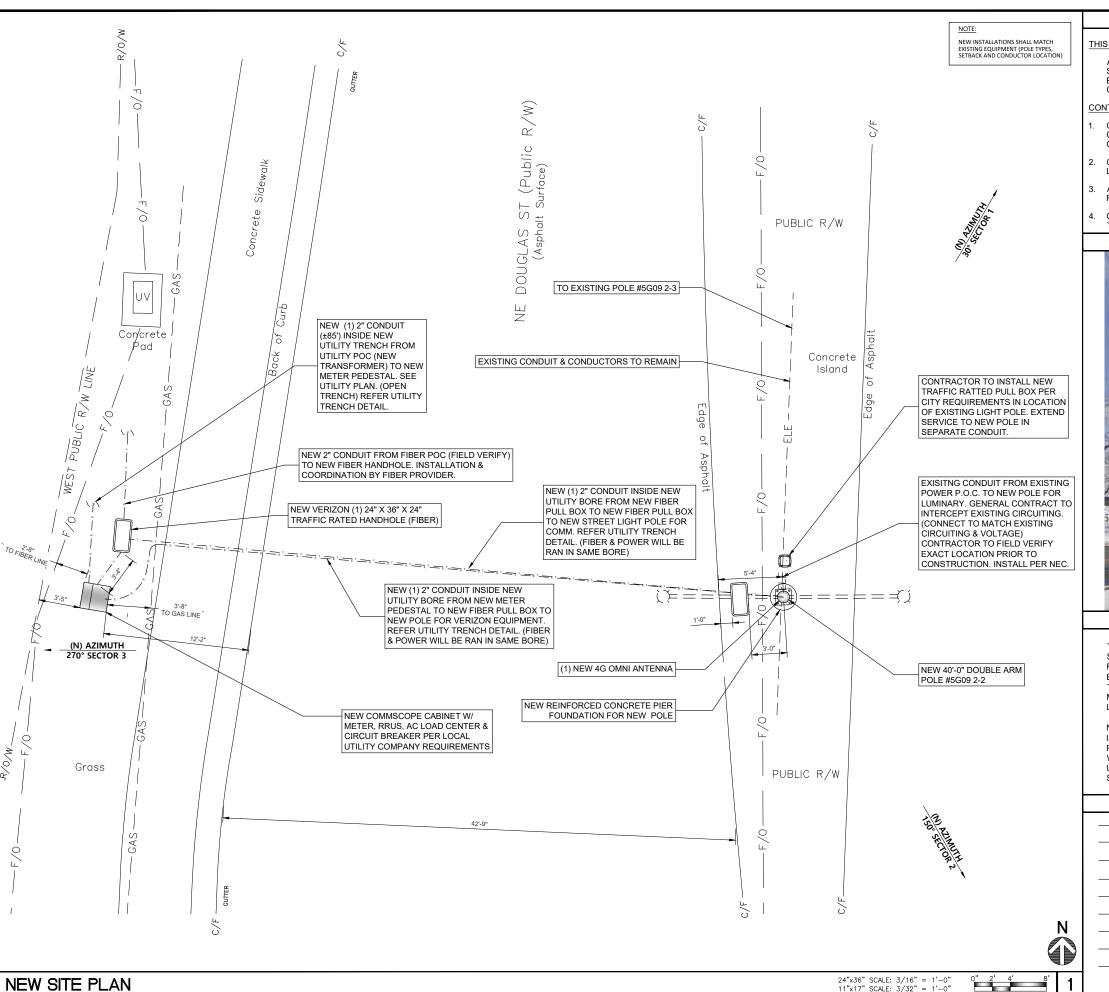

NOTES

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- CONTRACTOR TO FIELD VERIFY EXACT LOCATION OF ALL EQUIPMENT TO MEET SYSTEM REQUIREMENTS.

EXHIBIT PHOTO



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UTILITY LEGEND

— т — т — т — т — т —	TELCO
— E — E — E — E —	POWER
GGGGG	GAS
wwwwwww	WATER
SEWER SEWER	SEWER
SD SD SD SD	STORM DRAIN
	OIL
PHONE——PHONE——PHONE——	PHONE
CABLE TV CABLE TV CABLE TV	CABLE

ISSUE STATUS

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n MLF

Consulting

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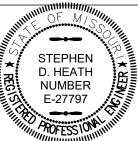
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SMALL CELL PROJECT

PRELIMINARY




DATE: 04 27 2020


KCYC LEE SUMMIT DOUGLAS - A


LEES SUMMIT - STREET LIGHT NE DOUGLAS RD LEES SUMMIT, MO 64086


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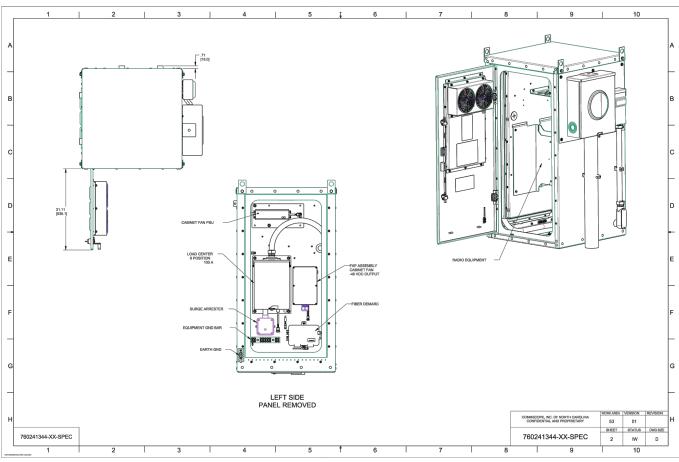
NEW SITE PLAN



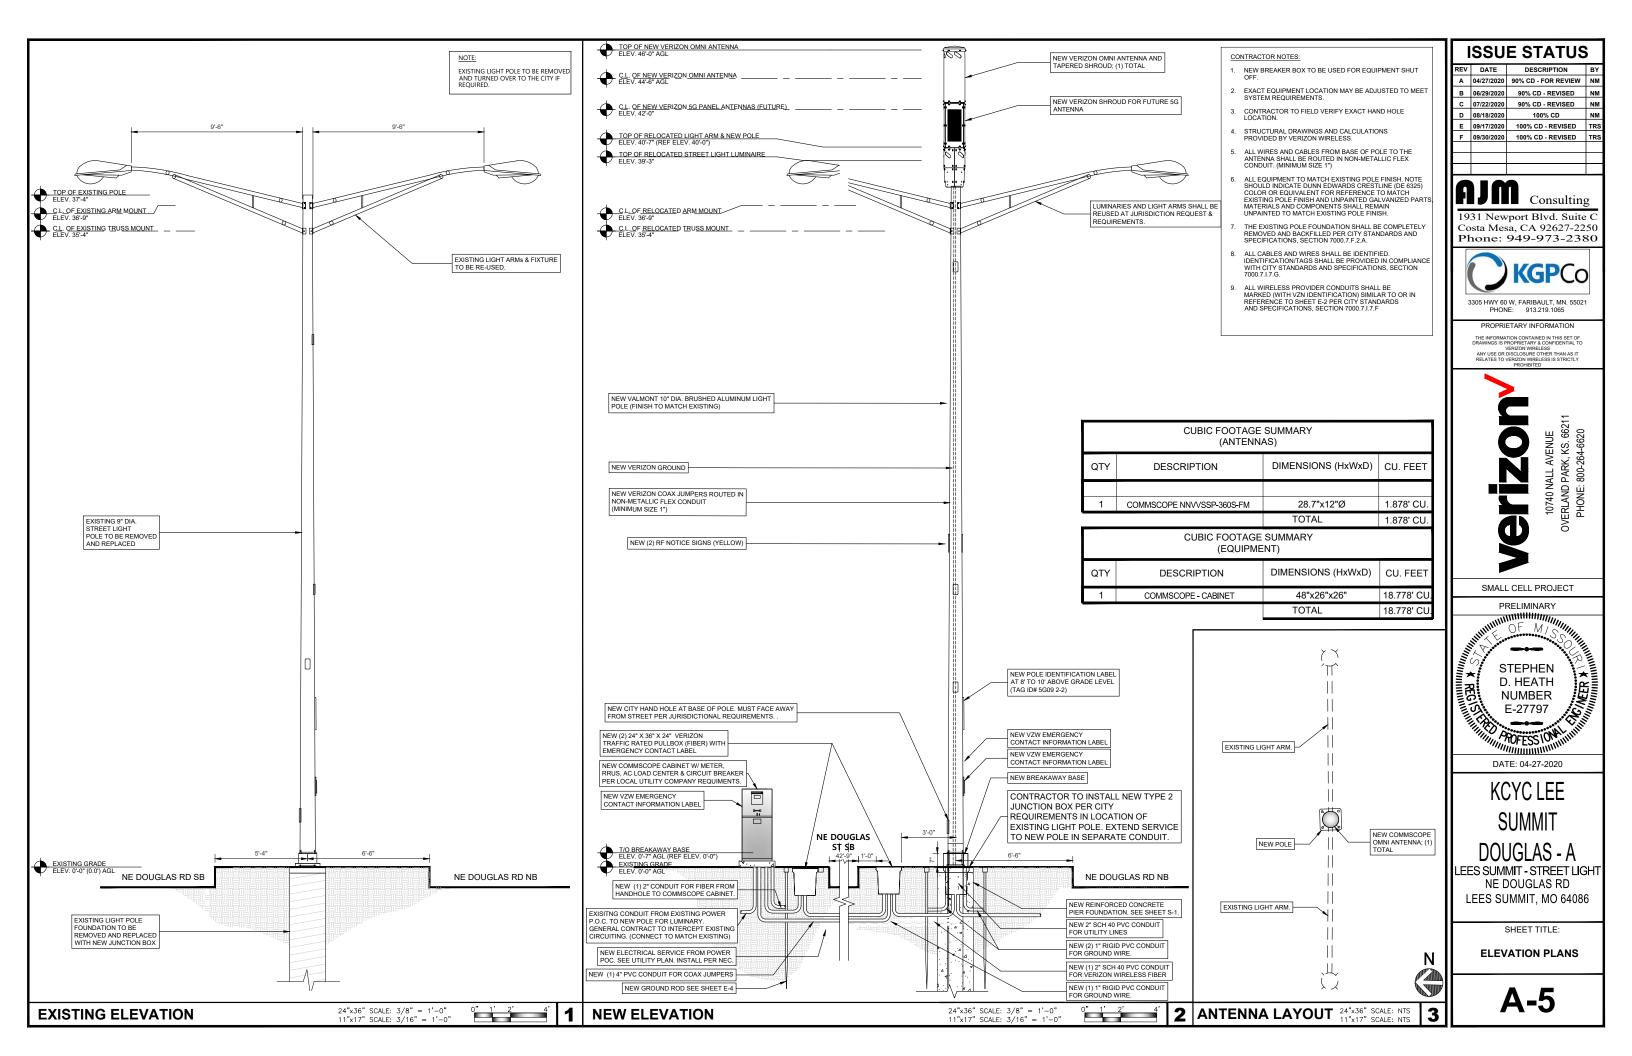

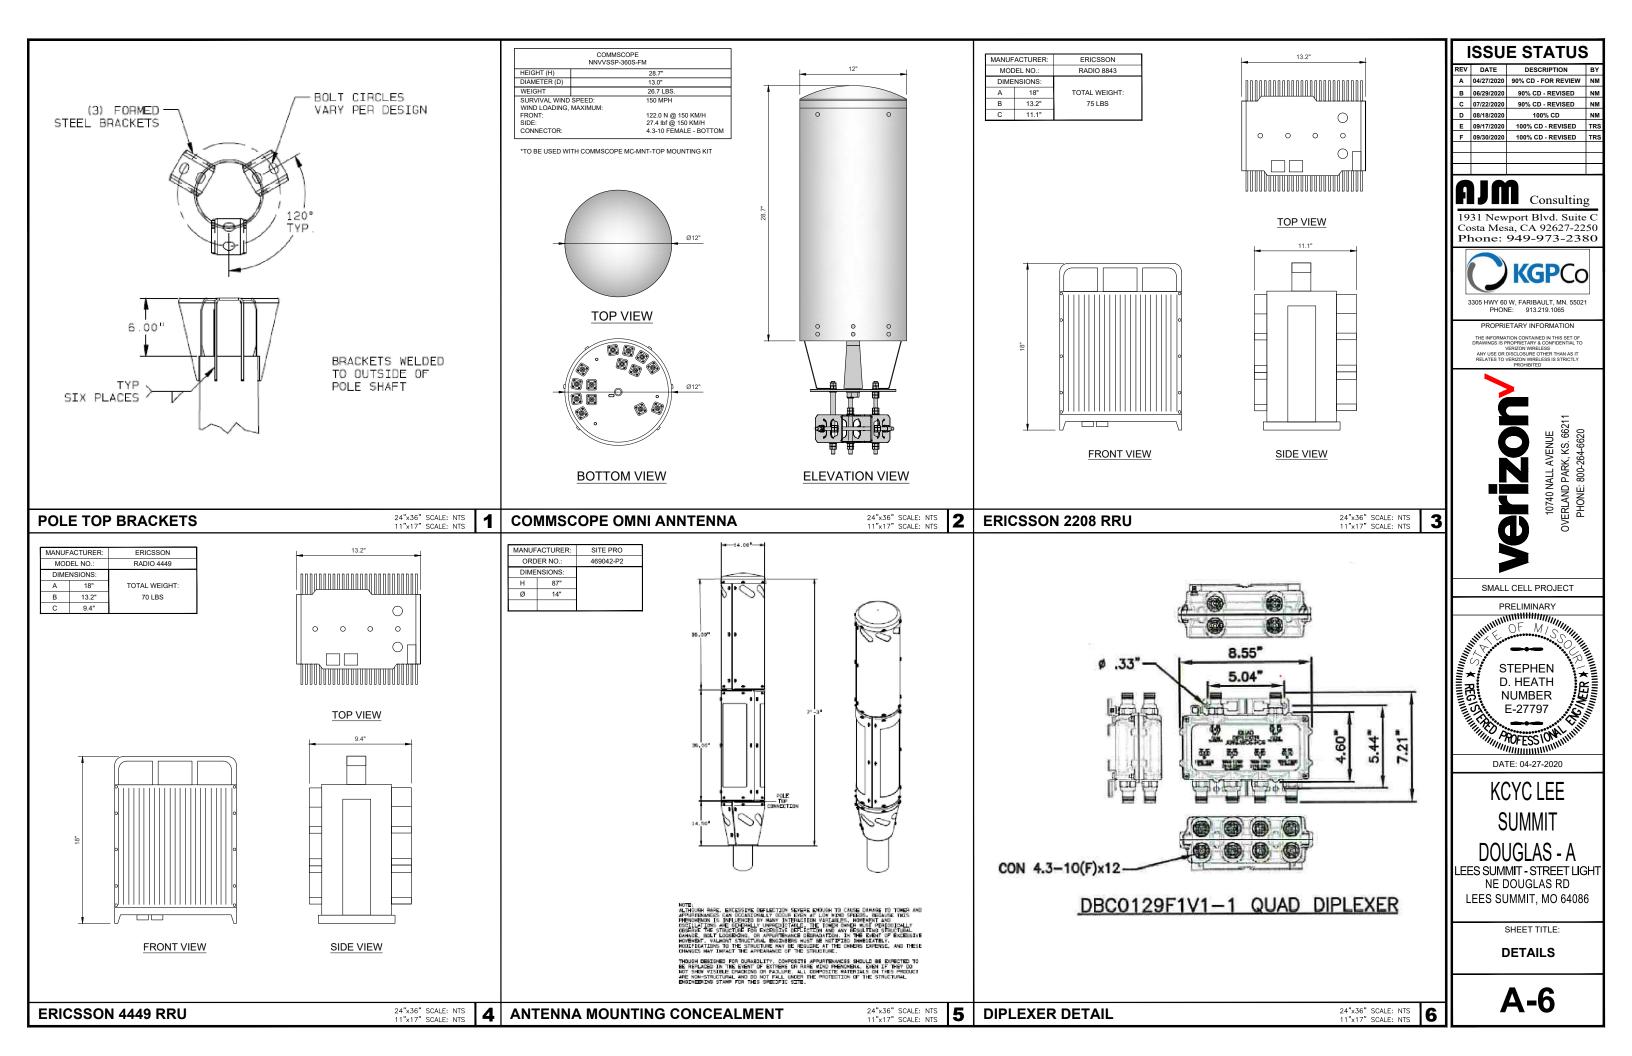

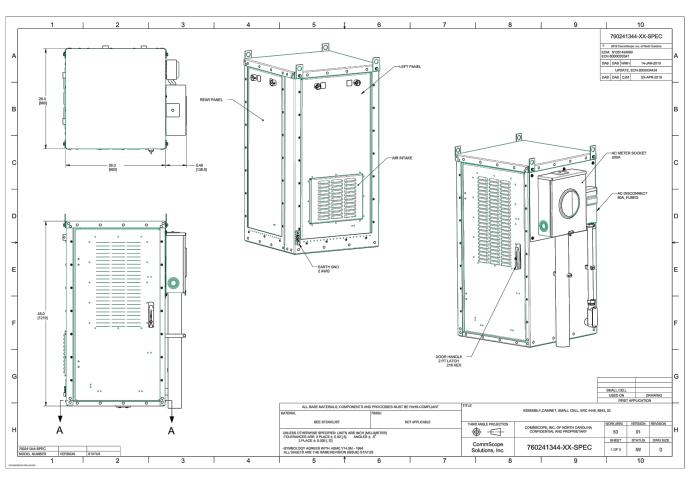

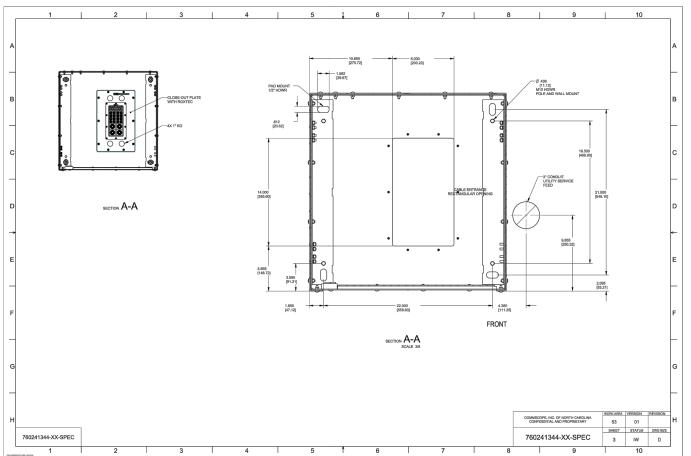



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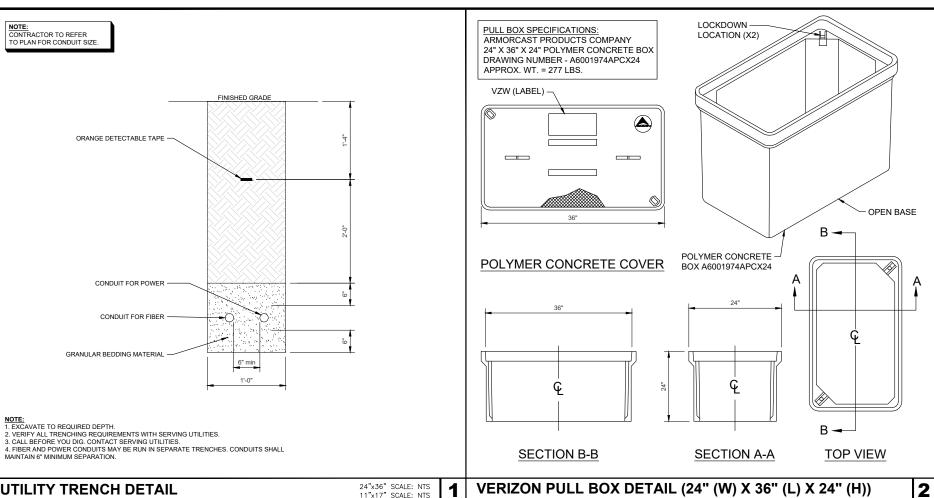
STEPHEN D. HEATH NUMBER E-27797 PROFESSION

KCYC LEE SUMMIT DOUGLAS - A

LEES SUMMIT - STREET LIGHT NE DOUGLAS RD LEES SUMMIT, MO 64086

SHEET TITLE:

DETAILS



24"x36" SCALE: NTS 11"x17" SCALE: NTS **VERIZON PULL BOX DETAIL (24" (W) X 36" (L) X 24" (H)) UTILITY TRENCH DETAIL** INSTALLATION OF CPAD—S PER MANUFACTURERS STANDARDS 0 NOTE: COMPOSITE FIBERGLASS MATERIAL 45.2 0 - 29.3

NOTE: RF NOTICE SIGN FOR MINI MACROS (>40 WATT OUTPUT POWER FROM ANTENNAS)

SECTOR/NODE:



SIGN PLACEMENT: AFFIX TO THE STRUCTURE 11-12' BELOW THE COMMERCIAL RF ANTENNA(S)

verizon /

Ш	ISSUE STATUS			
II	REV	DATE	DESCRIPTION	BY
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SMALL CELL PROJECT

PRELIMINARY

OF MI STEPHEN D. HEATH NUMBER E-27797 PROFESS 10N

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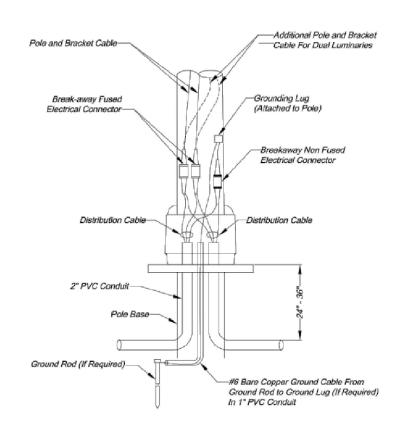
SHEET TITLE:

DETAILS


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14.75

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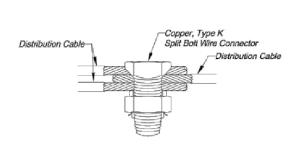


POLE WIRING DETAILS



SECONDARY SERVICE CONNECTION DETAILS

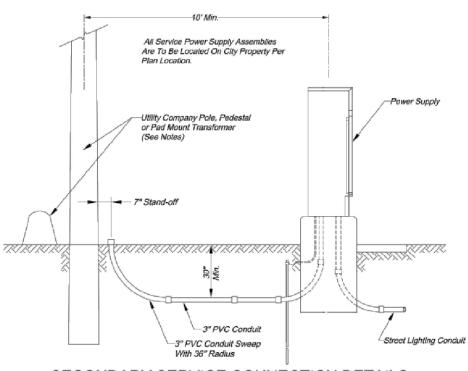- 1. Contractor shall install a conduit stub 24" to 6" above ground at utility poles. Conduit shall be stubbed to the side of the pole that will allow a direct run up the pole to the transformer without crossing other utility lines or cables. The end of the conduit shall be capped.
- 2. Contractor shall install conduit in a trench to within 24" of pedestals or pad mount transformers and leave a 36" x 36" x 36" access hole in the ground. Contractor shall keep open trench covered and promptly backfill access hole when service is completed.



SPLICE KIT DETAILS

- 1. To be used only in junction or pull boxes where circuits branch or "tee".
- 2. All splices shall be protected with a resin splice kit (not shown) installed in accordance with the manufacturer's recommendations.





(1)

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Checked By: JW Date: 08/21/2009

5 OF 5

SMALL CELL PROJECT

ISSUE STATUS REV DATE DESCRIPTION A 04/27/2020 90% CD - FOR REVIEW NM B 06/29/2020 90% CD - REVISED NM C 07/22/2020 90% CD - REVISED NM

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D 08/18/2020

E 09/17/2020


PRELIMINARY OF M. **STEPHEN** D. HEATH NUMBER E-27797

DATE: 04-27-2020


SUMMIT DOUGLAS - A

LEES SUMMIT - STREET LIGHT NE DOUGLAS RD LEES SUMMIT, MO 64086

> SHEET TITLE: CITY ELECTICAL **DETAILS**

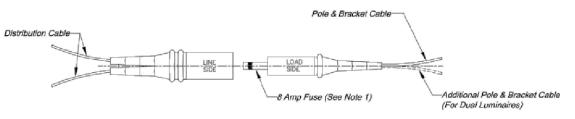


BREAK-AWAY FUSED ELECTRICAL CONNECTORS

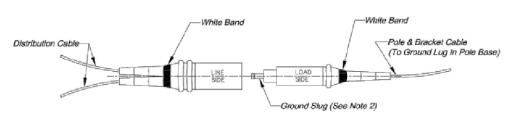


BREAK-AWAY NON FUSED ELECTRICAL CONNECTOR

NOTES:


- 1. Fuse remains in "Load Side" after break-away.
- 2. Ground "Slug" remains in "Load Side" after break-way.
- 3. Connectors shall have set screw type terminals to attach cables.

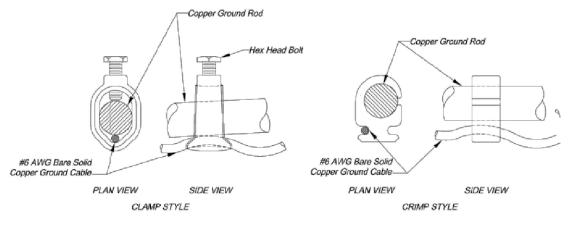

GROUND ROD CONNECTION DETAILS

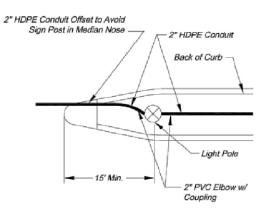


STREET LIGHT POLE IN MEDIAN

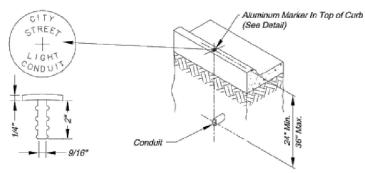

CONDUIT MARKING DETAIL


NOTES:

- 1. An aluminum marker shall be placed in the top of the curb directly over the conduit.
- 2. Markers shall be installed by drilling the curb and expoxying the marker in place. If installed in a sidewalk or curb ramp, the top of the marker shall be flush with the concrete surface.
- 3. No direct payment shall be made for conduit markers; they are subsidiary to the installation

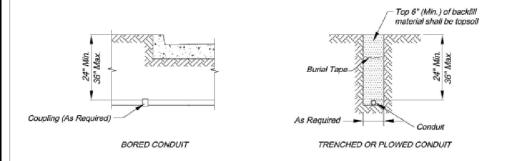


CONDUIT LOCATIONS


- 1. Backfill under paved surfaces shall be flowable fill.
- 2. The conduit shall not be covered unless inspected and approved by the City Engineer, so as to ensure proper depth, correct conduit material, and proper conduit end treatment.

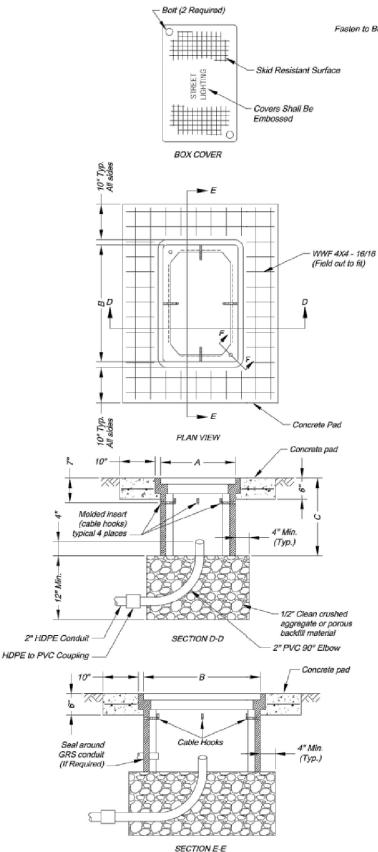

PULL OR JUNCTION BOX DETAILS

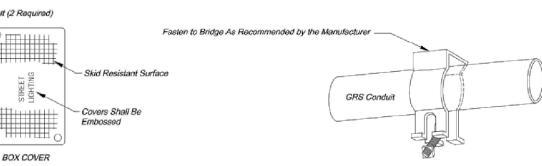

CONDUIT HANGER

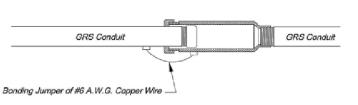

EXPANSION FITTING


GRS CONDUIT DETAILS

NOTES:

- 1. All conduits installed above ground shall be GRS.
- 2. Conduit attached to bridges shall have expansion fittings installed at each end of the bridge and at each expansion joint on the bridge.
- 3. All GRS conduits shall be electrically bonded by a grounding bushing and ground wire as detailed.
- 4. Install the conduit and connector assembly to permit a 1/2" minimum longitudinal travel in either direction.

Number of Enterina/Exitina	Вох	Minimum Box Dimensions		
Conduits	Type	Α	В	С
1-2	Type 1 Junction Box	12"	12"	12"
3-4	Type 2 Junction Box	12"	18"	12"
> 4	Class 1 Pull Box	17"	30"	22"

All dimensions shown are nominal

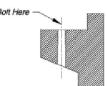

SECTION F-F

NOTES:

- Lift opening required on all covers.
- 2. Preformed box walls may be either flared or vertical. The bottom of boxes shall be open to below.
- may be interior or exterior. The extension shall be compatible and from the same manufacturer.
- 5. A Class 1 Pull Box shall be installed adjacent to each 4-Circuit Power Supply.

B 06/29/2020 90% CD - REVISED NM C 07/22/2020 90% CD - REVISED NM D 08/18/2020 100% CD E 09/17/2020 100% CD - REVISED 100% CD - REVISED

ISSUE STATUS REV DATE DESCRIPTION A 04/27/2020 90% CD - FOR REVIEW NM

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PROPRIETARY INFORMATION

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GREEN STREET AIT, MISSOURI 64063 1800 FAX: (816) 969-

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CONDUIT

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3 OF 5

RD

SMALL CELL PROJECT

PRELIMINARY STEPHEN D. HEATH NUMBER E-27797 PROFESSIO

DATE: 04-27-2020

SUMMIT DOUGLAS - A

LEES SUMMIT - STREET LIGHT NE DOUGLAS RD LEES SUMMIT. MO 64086

SHEET TITLE:

CITY ELECTRICAL DETAILS


E-2

Drawn By: JH Checked By: JW Date: 08/21/2009 3. If an extension is used with a preformed box, the lip of the extension

4. Cable hooks are to be included with Class 1 Pull Boxes only.

CONTRACTOR NOTES:

- NEW BREAKER BOX TO BE USED FOR EQUIPMENT SHUT OFF.
- EXACT EQUIPMENT LOCATION MAY BE ADJUSTED TO MEET SYSTEM REQUIREMENTS.
- 3. CONTRACTOR TO FIELD VERIFY EXACT HAND HOLE LOCATION.
- 4. STRUCTURAL DRAWINGS AND CALCULATIONS PROVIDED BY VERIZON WIRELESS.
- 5. ALL WIRES AND CABLES FROM BASE OF POLE TO THE ANTENNA SHALL BE ROUTED IN NON-METALLIC FLEX CONDUIT. (MINIMUM SIZE 1")
- ALL EQUIPMENT TO MATCH EXISTING POLE FINISH. NOTE SHOULD INDICATE DUINN EDWARDS CRESTLINE (DE 6325) COLOR OR EQUIVALENT FOR REFERENCE TO MATCH EXISTING POLE FINISH AND UNPAINTED GALVANIZED PARTS, MATERIALS AND COMPONENTS SHALL REMAIN UNPAINTED TO MATCH EXISTING POLE FINISH.
- 7. THE EXISTING POLE FOUNDATION SHALL BE COMPLETELY REMOVED AND BACKFILLED PER CITY STANDARDS AND SPECIFICATIONS, SECTION 7000.7.F.2.A.
- ALL CABLES AND WIRES SHALL BE IDENTIFIED.
 IDENTIFICATION/TAGS SHALL BE PROVIDED IN COMPLIANCE WITH CITY STANDARDS AND SPECIFICATIONS, SECTION 7000.7.1.7.G.
- ALL WIRELESS PROVIDER CONDUITS SHALL BE MARKED (WITH VZN IDENTIFICATION) SIMILAR TO OR IN REFERENCE TO SHEET E-2 PER CITY STANDARDS AND SPECIFICATIONS, SECTION 7000.7.1.7.F

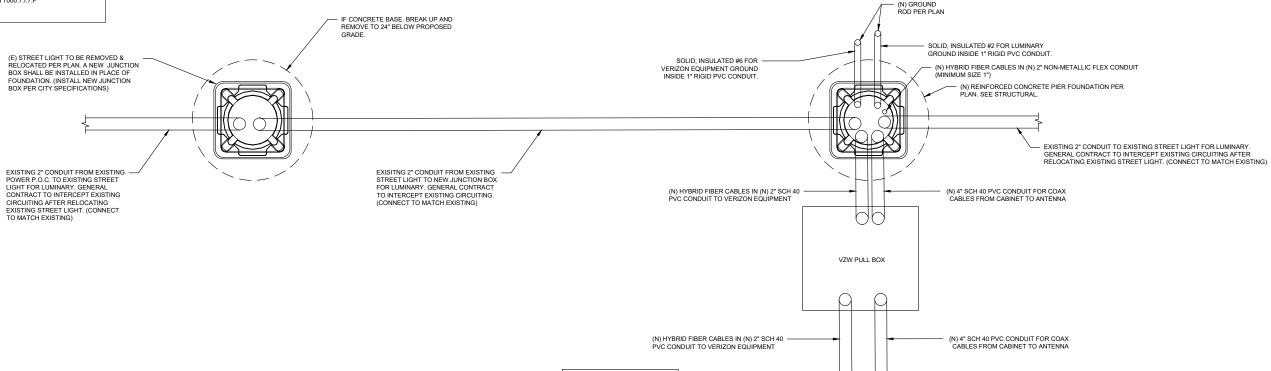

VZW PULL BOX

NOTE:

(N) GROUND

(N) COMMSCOPE

ROD PER PLAN

SOLID, INSULATED #6 FOR

VERIZON EQUIPMENT GROUND INSIDE 1" RIGID PVC CONDUIT.

(N) 2" SCH 40 PVC CONDUIT CONDUIT FROM UTILITY SERVICE TO (N) METER PEDESTAL. SEE UTILITY COORDINATION PLAN.

- ALL STREETLIGHT CONDUCTORS SHALL BE TAGGED
 WITH A LABEL READING "STREETLIGHT"."ALL STREETLIGHT
 CONDUCTORS SHALL BE TAGGED WITH A LABEL READING
 "STREETLIGHT"

 "STREETLIGHT"
- ALL CONDUCTORS (AC OR DC) IN THE POLE OR RACEWAY SHALL HAVE AN INSULATION RATING EQUAL TO AT LEAST THE MAXIMUM CIRCUIT VOLTAGE APPLIED OR SHALL BE PHYSICALLY SEPARATED BY LISTED MEANS.
- 3. ALL LIGHTS ON BRANCH CIRCUIT ARE TO REMAIN OPERATIONAL DURING CONSTRUCTION
- THE EXISTING POLE FOUNDATION SHALL BE COMPLETELY REMOVED AND BACKFILLED PER CITY STANDARDS AND SPECIFICATIONS, SECTION 7000.7.F.2.A

ISSUE STATUS

		DAIL	DECORUM MORE	ο.
ı	Α	04/27/2020	90% CD - FOR REVIEW	NM
	В	06/29/2020	90% CD - REVISED	NM
ı	С	07/22/2020	90% CD - REVISED	NM
	D	08/18/2020	100% CD	NM
	Е	09/17/2020	100% CD - REVISED	TRS
	F	09/30/2020	100% CD - REVISED	TRS

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PROPRIETARY INFORMATION

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SMALL CELL PROJECT

10740 NALL AVENUE OVERLAND PARK, KS. 66211 PHONE: 800-264-6620

PRELIMINARY



DATE: 04-27-2020

KCYC LEE SUMMIT DOUGLAS - A

LEES SUMMIT - STREET LIGHT NE DOUGLAS RD LEES SUMMIT, MO 64086

SHEET TITLE:

STREET LIGHT CIRCUIT PLAN


E-3

STREET LIGHT CIRCUIT PLAN

24"x36" SCALE: NTS
11"x17" SCALE: NTS

(N) 2" SCH 40 PVC CONDUIT FOR FIBER LINE BY VZW

(N) HYBRID FIBER CABLES IN (N) 2" SCH 40 - PVC CONDUIT TO VERIZON EQUIPMENT

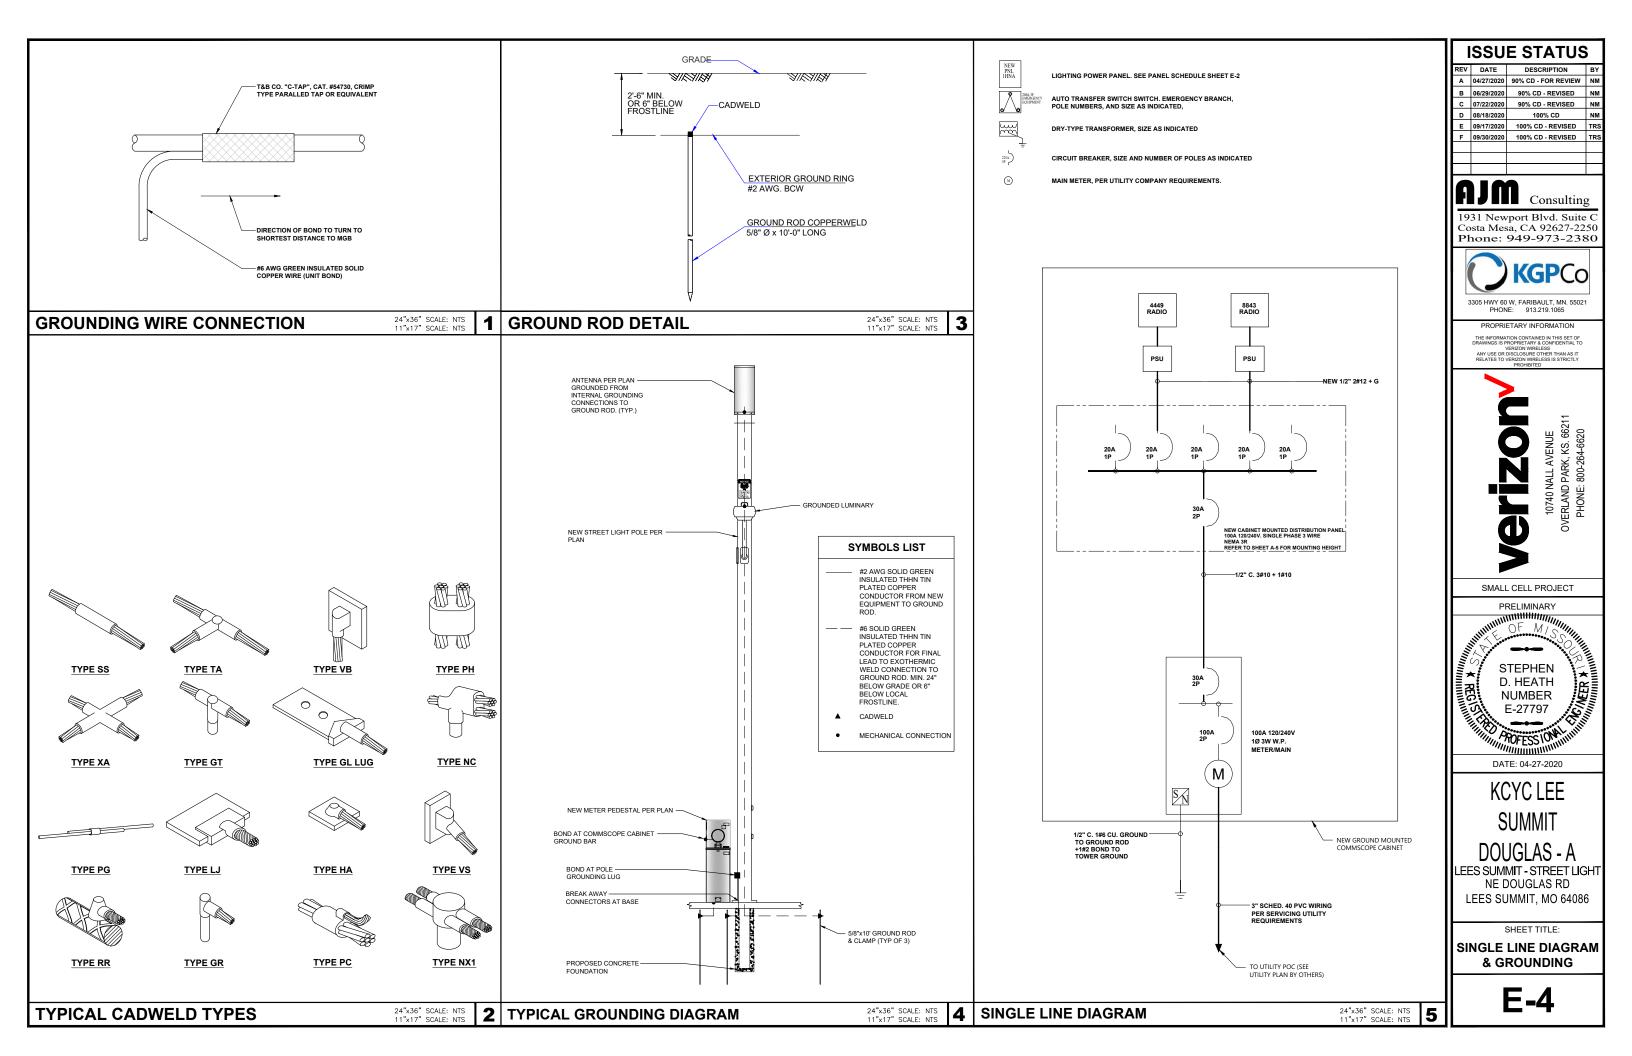

verizon fuze RFDS

Flores, Caesar - caesar.flores@verizonwireless.com - 5/4/2020 13:38:29

roject Details	
Carrier Aggregation:	false
MPT Id:	·
eCIP-0:	false
Project Name:	Full Relo
FUZE Project ID:	16054113
Designed Sector Carrier 4G:	N/A
Designed Sector Carrier 5G:	N/A
Additional Sector Carrier 4G:	N/A
Additional Sector Carrier 5G:	N/A
SiteTraker Project Id:	a4K0H000000wSw8UAE
RFDS Project Scope:	- New small cell
	- 4G 8843 for AWS, 4449 for 700, 850 LTE
Suffix:	


cation Infor	mation
	Site ID: 616581870
	E-NodeB ID:
	PSLC: 602128
	Switch Name:
	Tower Owner:
	Tower Type: Public Lighting Structure
	Site Type: NODE
	Street Address: NE Douglas Rd
	City: Lees Summit
	State: MO
	Zip Code: 64086
	County: Jackson
	Latitude: 38.937919 / 38° 56' 16.5084" N
	Longitude: -94.378458 / 94° 22' 42.4488" W

Adde	1																		
700	850	1900	AWS	AW53	28 GHz	31 GHz	39 GHz	CBRS	LAA	N77	Make	Model	Centerline	Tip Height	Azimuth	RET	4xRx	Inst. Type	Quantity
LTE	LTE		LTE								CCMMSCOPE	NNVVSSP-360S-FM	41.75	42.9	0(D1)	false	false	PHYSICAL	1
Remo	ved																		
700	850	1900	AWS	AWS3	28 GHz	31 GHz	39 GHz	CBRS	LAA	N77	Make	Model	Centerline	Tip Height	Azimuth	RET	4xRx	Inst. Type	Quantity
												No data available.							
Retail	ned																		
700	850	1900	AWS	AWS3	28 GHz	31 GHz	39 GHz	CBRS	LAA	N77	Make	Model	Centerline	Tip Height	Azimuth	RET	4xRx	Inst. Type	Quantity
												No data available.							

Added																		
Equipment Type	Location	700	850	1900	AWS	AWS3	28 GHz	31 GHz	39 GHz	CBRS	LAA	N77	Make	Model	Cable Length	Cable Size	Install Type	Quantity
Diplexer	Tower												Kaelus	AWS/PCS quad diplexer DBC0129F1V1-1			PHYSICAL	1
Mount	Tower												Commscope	Top Concealment SSC- 760236966E2			PHYSICAL	1
RRU	Tower	LTE	LTE										Ericsson	4449			PHYSICAL	1
RRU	Tower				LTE								Ericsson	8843			PHYSICAL	1
Removed																		
Equipment Type	Location	700	850	1900	AWS	AWS3	28 GHz	31 GHz	39 GHz	CBRS	LAA	N77	Make	Model	Cable Length	Cable Size	Install Type	Quantity
No data available.																		
Retained																		
Equipment Type	Location	700	850	1900	AWS	AWS3	28 GHz	31 GHz	39 GHz	CBRS	LAA	N77	Make	Model	Cable Length	Cable Size	Install Type	Quantity

Service Info



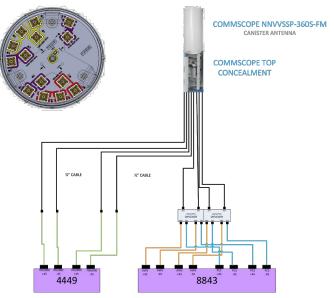

- 8843 and/or 4449 and (1) quad diplexer to be installed 10-15 ft above the ground up on the pole

ISSUE STATUS

	330	LSIAIUS	<u> </u>
REV	DATE	DESCRIPTION	BY
Α	04/27/2020	90% CD - FOR REVIEW	NM
В	06/29/2020	90% CD - REVISED	NM
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PROPRIETARY INFORMATION


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SMALL CELL PROJECT

PRELIMINARY



DATE: 04-27-2020

KCYC LEE SUMMIT DOUGLAS - A

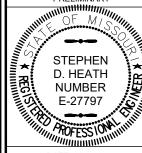
LEES SUMMIT - STREET LIGHT NE DOUGLAS RD LEES SUMMIT, MO 64086


SHEET TITLE:

RFDS

RF-1

24"x36" SCALE: NTS 11"x17" SCALE: NTS **RADIO FREQUENCY DATA SHEET**

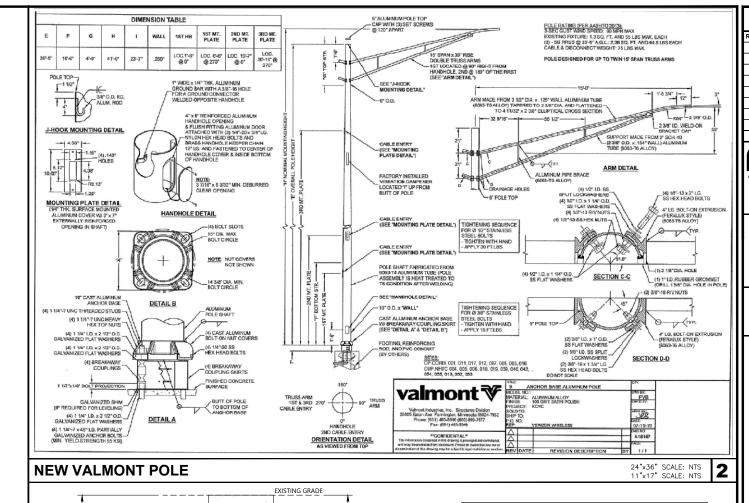

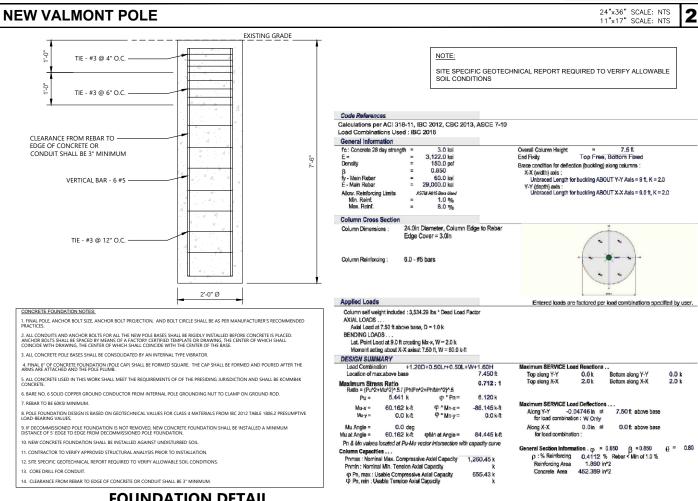

ISSUE STATUS REV DATE DESCRIPTION BY A 04/27/2020 90% CD - FOR REVIEW NM B 06/29/2020 90% CD - REVISED NM C 07/22/2020 90% CD - REVISED NM D 08/18/2020 100% CD E 09/17/2020 100% CD - REVISED F 09/30/2020 100% CD - REVISED

AJM Consulting

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10740 NALL AVENUE OVERLAND PARK, KS. 66211 PHONE: 800-264-6620 **(1)**

SMALL CELL PROJECT

PRELIMINARY OF Mi STEPHEN D. HEATH NUMBER E-27797 PROFESSIONAL


KCYC LEE SUMMIT DOUGLAS - A

LEES SUMMIT - STREET LIGHT NE DOUGLAS RD LEES SUMMIT. MO 64086

SHEET TITLE:

STRUCTURAL DETAILS

S-1

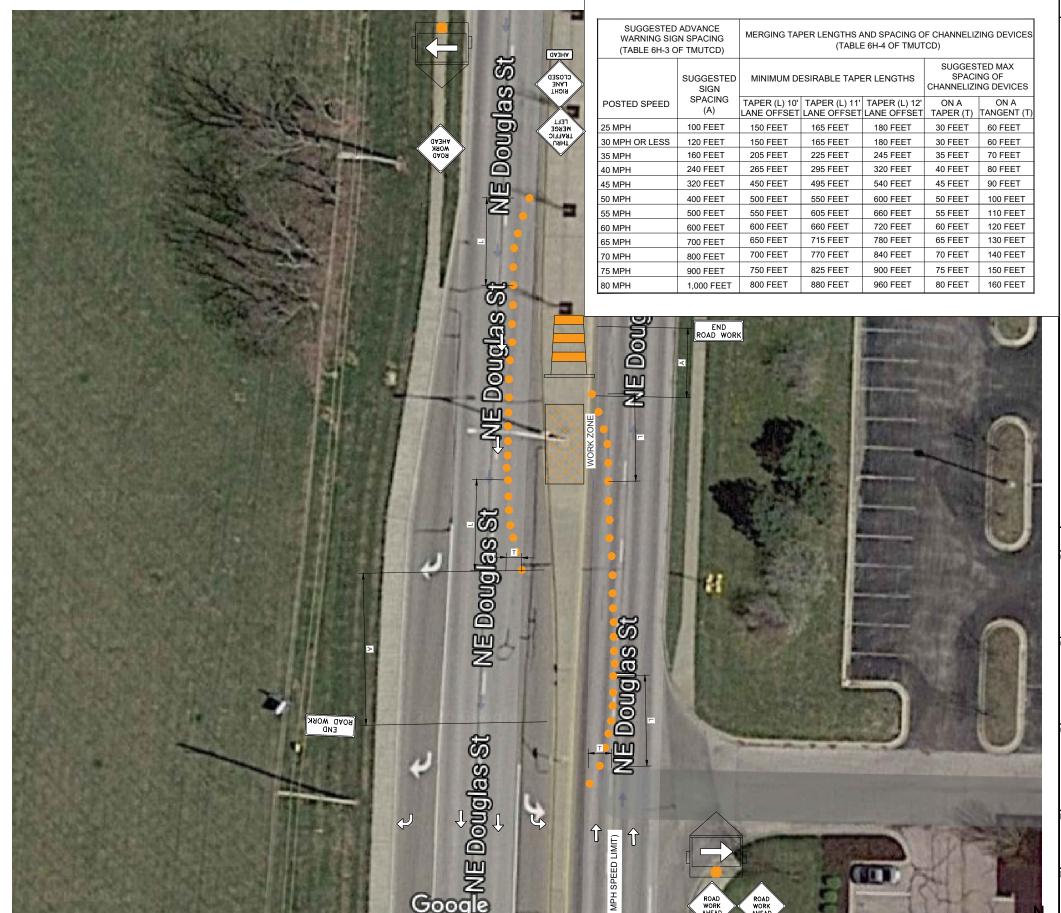

TRAFFIC CONTROL PLAN

GENERAL NOTES

THIS IS NOT A SITE SURVEY:

ALL PROPERTY BOUNDARIES, ORIENTATION OF TRUE NORTH AND STREET HALF-WIDTHS ARE APPROXIMATE. ALL PROPERTY LINES, EASEMENTS, AND SETBACKS SHALL BE VERIFIED PRIOR TO START OF CONSTRUCTION.

UNDERGROUND UTILITIES:

EXISTING UNDERGROUND UTILITIES ARE NOT SHOWN. CONTRACTOR TO LOCATE AND PROTECT ALL EXISTING UNDERGROUND UTILITIES DURING CONSTRUCTION.

CONTRACTOR NOTES:

- 1. REFER TO AND COMPLY WITH ALL JURISDICTIONAL CODES AND REQUIREMENTS.
- VEHICLE-MOUNTED SIGNS SHALL BE MOUNTED IN A MANNER SUCH THAT THEY ARE NOT OBSCURED BY EQUIPMENT OR SUPPLIES. SIGN LEGENDS ON VEHICLE-MOUNTED SIGNS SHALL BE COVERED OR TURNED FROM VIEW WHEN WORK IS NOT IN
- SHADOW AND WORK VEHICLES SHALL DISPLAY HIGH-INTENSITY ROTATING, FLASHING, OSCILLATING, OR STROBE LIGHTS.
- VEHICLE HAZARD WARNING SIGNALS SHALL NOT BE USED INSTEAD OF THE VEHICLE'S HIGH-INTENSITY ROTATING. FLASHING, OSCILLATING, OR STROBE LIGHTS
- WHEN CROSSWALKS OR OTHER PEDESTRIAN FACILITIES ARE CLOSED OR RELOCATED, TEMPORARY FACILITIES SHALL BE DETECTABLE AND SHALL INCLUDE ACCESSIBILITY FEATURES CONSISTENT WITH THE FEATURES PRESENT IN THE EXISTING PEDESTRIAN FACILITY.
- THIS DRAWING IS DIAGRAMMATIC & FOR INFORMATION PURPOSE ONLY. ALL WORK PERFORMED ON PROJECT AND MATERIALS INSTALLED SHALL BE IN STRICT COMPLIANCE WITH ALL APPLICABLE CODES, REGULATIONS, AND ORDINANCES CONTRACTOR SHALL GIVE ALL NOTICES AND COMPLY WITH ALL LAWS, ORDINANCES, RULES, REGULATIONS AND LAWFUL ORDERS OF ANY PUBLIC AUTHORITY, MUNICIPAL AND UTILITY COMPANY SPECIFICATIONS, AND LOCAL AND STATE JURISDICTIONAL CODES BEARING ON THE PERFORMANCE OF THE WORK.
- IF EXISTING CONDITIONS VARY FROM THE DRAWINGS THEN CONTRACTOR SHALL COMPLY WITH THE SPECIFIC "TYPICAL APPLICATION" AS NOTED IN JURISDICTIONAL REQUIREMENTS.

3 **LEGEND** ROAD WORK AHEAD CENTER LANE CLOSED RIGHT LANE CLOSED END ROAD WORK AHEAD AHEAD 48 X 24 48 X 48 48 X 48 YIELD SIDEWALK CLOSED USE OTHER SIDE 48 X 48 36 X 36 48 X 36 48 X 48 THRU TRAFFIC MERGE LEFT VISIBILITY 48 X 48 WORK ZONE TRIANGLE PLASTIC DRUM SIGN PLASTIC DRUM BARRICADE FLAGGER

ISSUE STATUS REV DATE DESCRIPTION A 04/27/2020 90% CD - FOR REVIEW B 06/29/2020 90% CD - REVISED NI C 07/22/2020 90% CD - REVISED NM

D 08/18/2020 100% CD E 09/17/2020 100% CD - REVISED F 09/30/2020 100% CD - REVISED

Consulting

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3305 HWY 60 W, FARIBAULT, MN. 55021

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SMALL CELL PROJECT

PRELIMINARY OF M **STEPHEN** D. HEATH NUMBER E-27797 PROFESS 10N

DATE: 04-27-2020

KCYC LEE SUMMIT DOUGLAS - A

LEES SUMMIT - STREET LIGHT NE DOUGLAS RD LEES SUMMIT, MO 64086

SHEET TITLE:

TRAFFIC CONTROL **PLAN**

24"x36" SCALE: NTS 11"x17" SCALE: NTS

VEHICLE

FLASHING SIGN

DIRECTION

OF TRAFFIC

HEAVY WORK

ATTENUATOR (TMA)

RAILER MOUNTED TRUCK MOUNTED FLASHING ARROW

TCP-1

TRAFFIC CONTROL GENERAL NOTES


- ALL CHANNELIZING DEVICES SHALL BE IN ACCORDANCE WITH THE 2009 EDITION OF THE MANUAL ON UNIFORM TRAFFIC CONTROL DEVICES.
- 2. ALL TRAFFIC CONTROL DEVICES SHALL HAVE WORKING VISIBLE WARNING LIGHTS AS REQUIRED IN ACCORDANCE
- 3. WITH THE 2009 EDITION OF MUTCD.
- 4. FOR TEMPORARY SITUATIONS, WHEN IT IS NOT FEASIBLE TO REMOVE AND RESTORE PAVEMENT MARKINGS,
- 5. CHANNELIZATION MUST BE MADE DOMINANT BY USING A VERY CLOSE DEVICE SPACING. THIS IS ESPECIALLY
- 6. IMPORTANT IN LOCATIONS OF CONFLICTING INFORMATION, SUCH AS WHERE TRAFFIC IS DIRECTED OVER A DOUBLE
- 7. YELLOW CENTERLINE. IN SUCH LOCATIONS, CHANNELIZING DEVICE SPACING OF 10 FEET IS REQUIRED.
- 8. FOR LONG TERM STATIONARY WORK, ALL CONFLICTING PAVEMENT MARKINGS MUST BE REMOVED AND
- 9. CENTERLINE STRIPING PROVIDED WHERE TWO WAY TRAFFIC IS IN ADJACENT LANES.
- CONTRACTOR SHALL PROVIDE SIDEWALK CLOSURE, CROSSWALK CLOSURE AND/OR WALKWAY BYPASS WHEREVER
 PEDESTRIAN MOVEMENTS ARE AFFECTED BY CONSTRUCTION ACTIVITIES. ALL SIDEWALKS AND CROSSWALKS SHALL BE
- ACCESSIBLE WHEN CONTRACTOR IS NOT WORKING UNLESS OTHERWISE APPROVED BY THE CITY TRAFFIC ENGINEER.
- 12. THE USE OF TRAILER MOUNTED ARROW DISPLAYS MAY BE REQUIRED ON ALL LANE CLOSURES. THE CONTRACTOR SHALL PROVIDE ONE(1) STAND-BY UNIT IN GOOD WORKING CONDITION AT THE JOB SITE, READY FOR USE, IF HIS OPERATION REQUIRES 24-HOUR A DAY CLOSURE SET-UPS AND IF REQUIRED.
- 3. CITY TRAFFIC ENGINEER AND/OR INSPECTORS MAY REQUIRE ADDITIONAL TRAFFIC CONTROL DEVICES.
- 4. EXTEND CHANNELIZATION DEVICES INTO SHOULDER WHERE APPLICABLE.
- 5. DISTANCES NOTES IN PLAN SHOULD BE INCREASED FOR CONDITIONS THAT WOULD AFFECT STOPPING.
- 16. MAINTAIN A MINIMUM LANE WIDTH OF 10'.
- 17. FLAGGERS SHALL BE IN CONSTANT RADIO CONTACT.
- 18. NO CONGREGATING AROUND FLAGGER STATIONS.
- 19. CONTRACTOR TO VERIFY POSTED SPEED LIMIT.
- 20. THE SIDEWALK ON SIDE WHERE WORK WILL BE DONE SHALL BE CLOSED TO PEDESTRIANS DURING CONSTRUCTION.
- 21. ALL TEMPORARY TRAFFIC CONTROL SIGNAGE, LAYOUTS AND PROCEDURES SHALL COMPLY WITH LOCAL JURISDICTIONAL REQUIREMENTS AND THE LATEST EDITION OF MUTCD, WHICHEVER IS MORE STRINGENT.
- 22. PRIOR TO ANY CONSTRUCTION, TRAFFIC CONTROL SIGNS AND DEVICES SHALL BE IN PLACE.
- 23. TRAFFIC CONTROL DEVICES FOR LANE CLOSURES INCLUDING SIGNS, CONES, BARRICADES, ETC. SHALL BE PLACED AS SHOWN ON PLANS. SIGNS SHALL NOT BE PLACED WITHOUT ACTUAL LANE CLOSURES AND SHALL BE IMMEDIATELY REMOVED UPON REMOVAL OF THE CLOSURES.
- 24. TAPER SHALL BE LOCATED TO MAXIMIZE THE VISIBILITY OF THEIR TOTAL LENGTH.
- THERE SHALL BE NO WORKERS, EQUIPMENT, OR OTHER VEHICLE IN THE BUFFER SPACE OR THE ROLL AHEAD SPACE.
- 26. DRIVEWAYS AND/OR SIDE STREETS ENTERING THE ROADWAY AFTER THE FIRST ADVANCE WARNING SIGN SHALL BE PROVIDED WITH AT LEAST ONE W20-1 SIGN (UTILITY WORK AHEAD) AS A MINIMUM.
- 27. CONES MAY BE SUBSTITUTED FOR BARRELS/DRUMS AND INSTALLÉD UPON THE APPROVAL OF THE AUTHORITY HAVING JURISDICTION PROVIDED THEY COMPLY WITH MUTCD.
- 28. FOR LONG-TERM STATIONARY WORK, THE DOUBLE YELLOW CENTER LINE AND/OR LANE LINES SHOULD BE REMOVED BETWEEN THE CROSSWALK LINES.
- 29. CONTRACTOR TO COMPLY WITH THE LATEST EDITION OF THE TEXAS MANUAL ON UNIFORM TRAFFIC CONTROL DEVICES(MUTCD)
- 30. FAILURE TO COMPLY WITH ALL ITEMS LISTED ABOVE WILL RESULT IN A \$500/DAY FINE.
- 31. PLACE VEHICLE IN BETWEEN AERIAL LIFT/TOW-BEHIND AND THE ONCOMING TRAFFIC.

FIGURE 6F-1. HEIGHT AND LATERAL LOCATION OF SIGNS




A - RURAL AREA OR BUSINESS, COMMERCIAL, OR RESIDENTIAL AREA (WITHOUT CURB)

MIN. 4 RETROREFLECTIVE BANDS (2 WHITE AND 2 ORANGE)

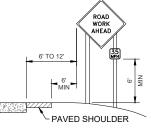


B - RURAL AREA WITH ADVISORY SPEED PLAQUE

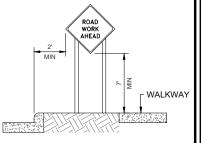

C - BUSINESS, COMMERCIAL, OR RESIDENTIAL AREA

FIGURE 6F-7. CHANNELIZING DEVICES

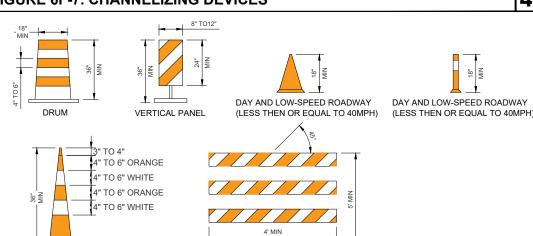

TYPE 3 BARRICADE

NOT USED

24"x36" SCALE: NTS
11"x17" SCALE: NTS

V DATE DESCRIPTION E

REV	DATE	DESCRIPTION	BY
Α	04/27/2020	90% CD - FOR REVIEW	NM
В	06/29/2020	90% CD - REVISED	NM
С	07/22/2020	90% CD - REVISED	NM
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PROPRIETARY INFORMATION

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3

4

SMALL CELL PROJECT

STEPHEN D. HEATH NUMBER E-27797

DATE: 04-27-2020

KCYC LEE SUMMIT DOUGLAS - A

LEES SUMMIT - STREET LIGHT NE DOUGLAS RD LEES SUMMIT. MO 64086

SHEET TITLE:

TRAFFIC CONTROL PLAN

TCP-2



PEDESTRIAN CONTROL PLAN

GENERAL NOTES

THIS IS NOT A SITE SURVEY:

ALL PROPERTY BOUNDARIES, ORIENTATION OF TRUE NORTH AND STREET HALF-WIDTHS ARE APPROXIMATE. ALL PROPERTY LINES, EASEMENTS, AND SETBACKS SHALL BE VERIFIED PRIOR TO START OF CONSTRUCTION.

UNDERGROUND UTILITIES:

EXISTING UNDERGROUND UTILITIES ARE NOT SHOWN. CONTRACTOR TO LOCATE AND PROTECT ALL EXISTING UNDERGROUND UTILITIES DURING CONSTRUCTION.

CONTRACTOR NOTES:

- REFER TO AND COMPLY WITH ALL JURISDICTIONAL CODES AND REQUIREMENTS.
- VEHICLE-MOUNTED SIGNS SHALL BE MOUNTED IN A MANNER SUCH THAT THEY ARE NOT OBSCURED BY EQUIPMENT OR SUPPLIES. SIGN LEGENDS ON VEHICLE-MOUNTED SIGNS SHALL BE COVERED OR TURNED FROM VIEW WHEN WORK IS NOT IN
- SHADOW AND WORK VEHICLES SHALL DISPLAY HIGH-INTENSITY ROTATING, FLASHING, OSCILLATING, OR STROBE LIGHTS.
- VEHICLE HAZARD WARNING SIGNALS SHALL NOT BE USED INSTEAD OF THE VEHICLE'S HIGH-INTENSITY ROTATING. FLASHING, OSCILLATING, OR STROBE LIGHTS
- WHEN CROSSWALKS OR OTHER PEDESTRIAN FACILITIES ARE CLOSED OR RELOCATED, TEMPORARY FACILITIES SHALL BE DETECTABLE AND SHALL INCLUDE ACCESSIBILITY FEATURES CONSISTENT WITH THE FEATURES PRESENT IN THE EXISTING PEDESTRIAN FACILITY.
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- IF EXISTING CONDITIONS VARY FROM THE DRAWINGS THEN CONTRACTOR SHALL COMPLY WITH THE SPECIFIC "TYPICAL APPLICATION" AS NOTED IN JURISDICTIONAL REQUIREMENTS.

3 SMALL CELL PROJECT **PRELIMINARY**

ROAD WORK AHEAD CENTER LANE CLOSED RIGHT LANE CLOSED END ROAD WORK 48 X 48 AHEAD 48 X 24 48 X 48 48 X 48 YIELD SIDEWALK CLOSED USE OTHER SIDE 48 X 48 36 X 36 48 X 36 48 X 48 THRU TRAFFIC MERGE LEFT

VISIBILITY 48 X 48 WORK ZONE TRIANGLE PLASTIC DRUM SIGN PLASTIC DRUM BARRICADE FLAGGER

FLASHING SIGN



CONTROL PLAN

STEPHEN

D. HEATH NUMBER

E-27797

PROFESSION

DATE: 04-27-2020

KCYC LEE

SUMMIT

DOUGLAS - A

LEES SUMMIT - STREET LIGHT NE DOUGLAS RD LEES SUMMIT, MO 64086

> SHEET TITLE: **PEDESTRIAN**

ISSUE STATUS

REV DATE DESCRIPTION

C 07/22/2020

D 08/18/2020

E 09/17/2020

A 04/27/2020 90% CD - FOR REVIEW

B 06/29/2020 90% CD - REVISED N

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Phone: 949-973-2380

3305 HWY 60 W, FARIBAULT, MN. 55021 PHONE: 913.219.1065

PROPRIETARY INFORMATION

THE INFORMATION CONTAINED IN THIS SET OF DRAWINGS IS PROPRIETARY & CONFIDENTIAL TO VERIZON WIRELESS ANY USE OR DISCLOSURE OTHER THAN AS IT RELATES TO VERIZON WIRELESS IS STRICTLY PROHIBITED

KGPCo

90% CD - REVISED NN

100% CD

100% CD - REVISED

100% CD - REVISED

DIRECTION OF TRAFFIC HEAVY WORK

VEHICLE

TRUCK MOUNTED FLASHING ARROW

ATTENUATOR (TMA)

PCP-1

24"x36" SCALE: NTS 11"x17" SCALE: NTS