SummitWoods Crossing - 1740 white box

issue date rev. num. rev. date rev. desc.

01/05/2021


01/05/2021

1 1/25/2021 city comments

CADSTONE STUDIO

:: ARCHITECTURE ::
:: Duane Hicks ::
1213 W 32nd Street, Independence, MO 64055
816-550-0130

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applicable codes
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o. o o o o	
building code:	2018 international building code
mechanical code:	2018 international/mechanical code
plumbing code:	2018 international plumbing code
electrical code:	2017 național electrical code
gas code:	2018 international fuel gas code
fire prevention:	2018 international fire code
life safety:	icc/ansi - A117.1
energy code:	2012 international energy conservation code

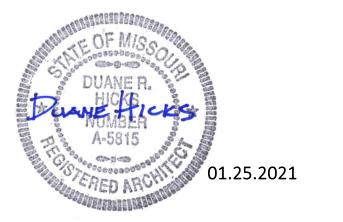project address|

1740 NW Chipman Road

Lee's Summit, MO 64081


<u>scopel</u>

tenant interior finish for white box conditions for landlord. Tenant improvment drawings provided by Tenant under separate submittal

deferred submittals

fire sprinkler modifications - fire sprinkler contractor sign shop and awning shop drawings - sign and awning company

project location|

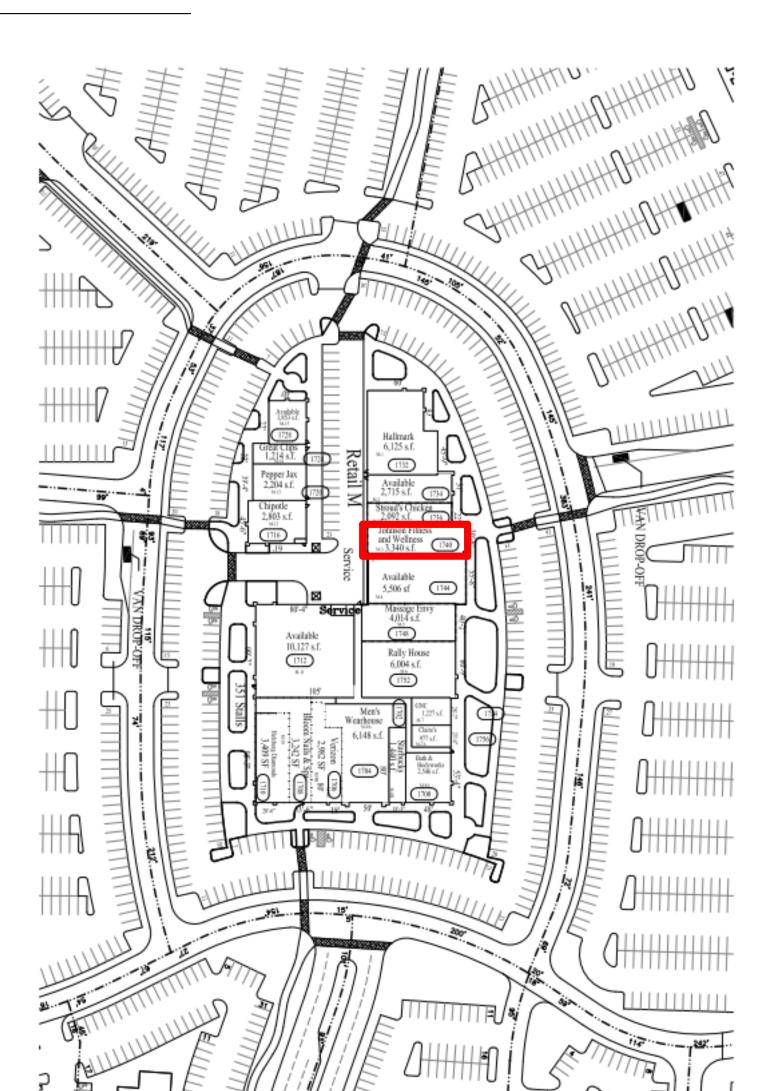

sheet number sheet name

cover sheet


mechanical elecrical plumbing

reflected ceiling plan details - door schedules

mechanical plan ground floor

plumbing plan ground floor plumbing notes & schedules

architectural

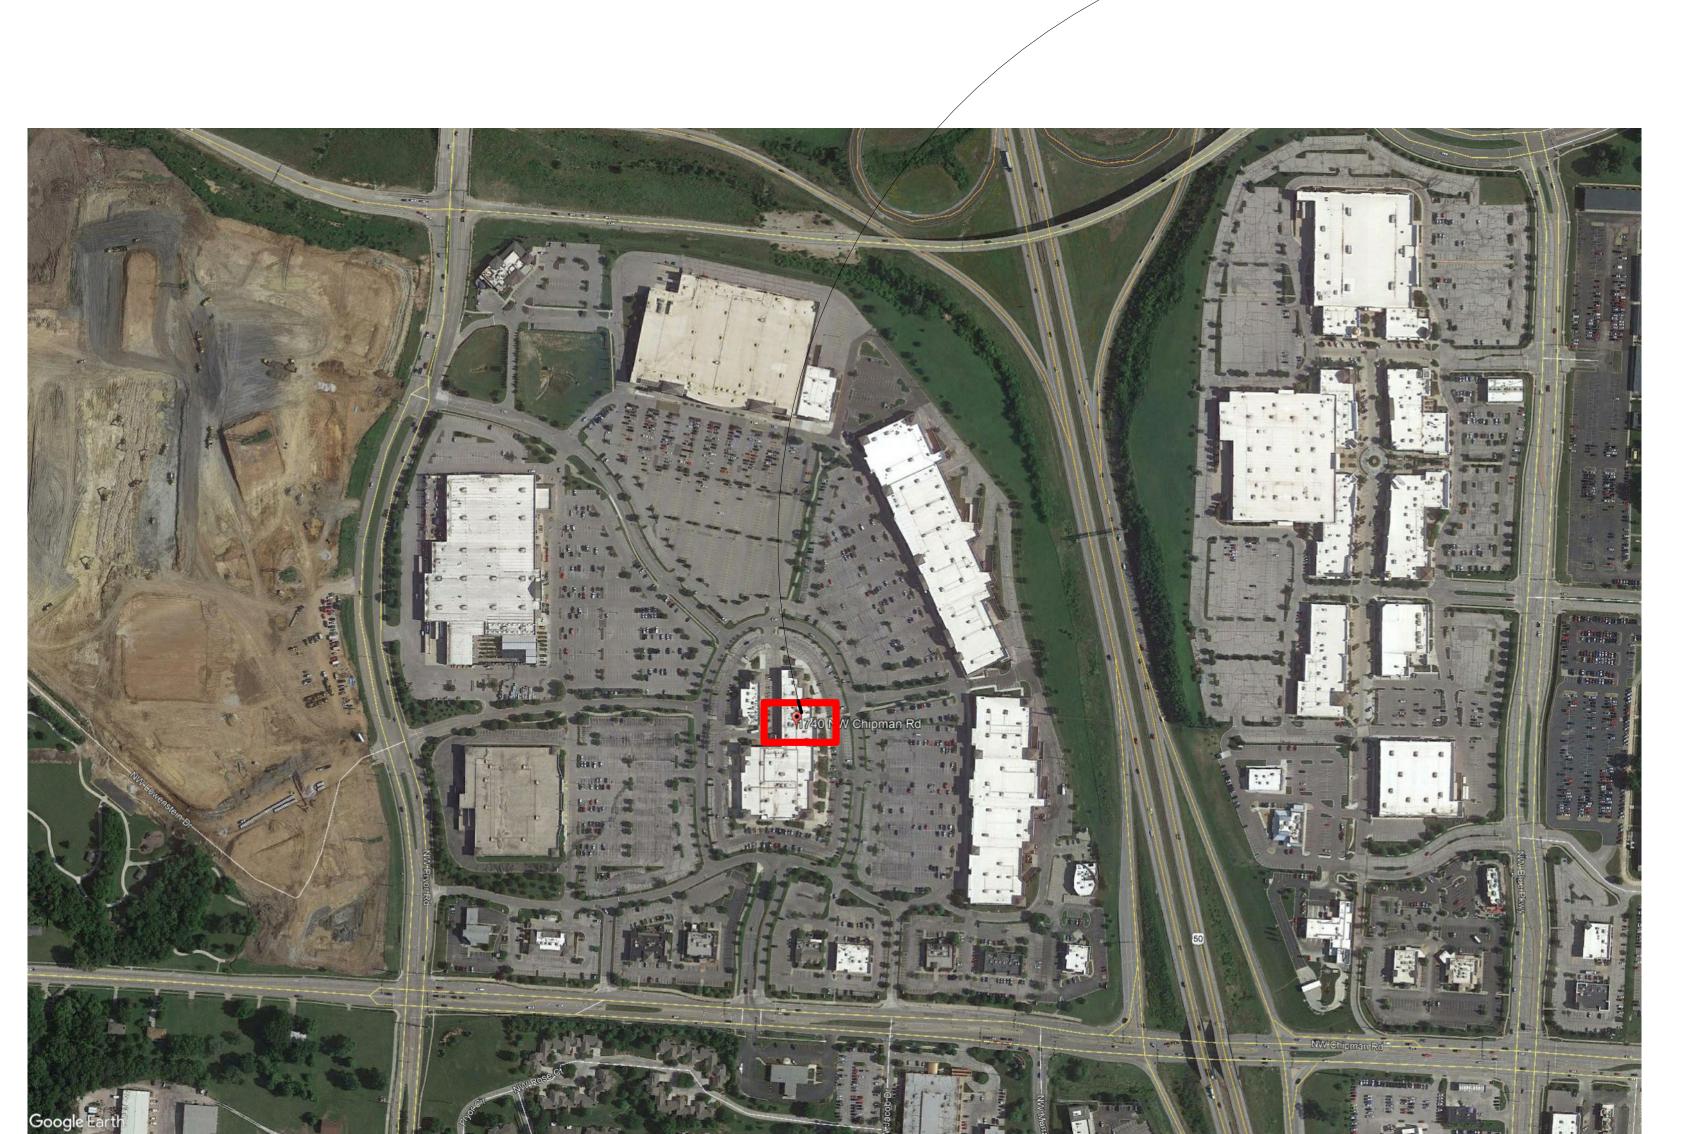

1740 white box

1740 NW Chipman Road Lee's Summit, MO 64081

1 1/25/2021 city comments

SHEET NAME COVER Sheet

area of

work

ARCH PROJECT NO. SHEET DATE

Project Number 01/05/2021
SHEET NO. PROJECT PHASE

OCS1.00 Permit

code review| project type: project name current zoning occupancy construction type: allowable building stories: actual building stories: allowable building height: sprinkler height increase actual building height: base allowable building area: sprinkler area increase actual tenant space area fire-resistance rating requirements [table 601] primary structural members bearing walls exterior interior nonbearing walls and partitions - interior floor construction and associated secondary members roof construction and associated secondary members fire separation between occupancies M Fire alarm Contractor to provide design and obtain permits for any moving and addition of sprinkler heads and/or lines All fire alarm monitoring devices to be connected to Landlord fire alarms system. Contractor to install/modify existing fire alarm systems necessary per local code - coordinate with licensed Fire Alarm Contractor - voice alarm systems shall comply with IBC 907.2.1.1 - fire sprinkler Contractor to submit equipment with modifications to remaining system defferred submittal

maximum allowable travel distance - 250' actual maximum travel distance - 119'-8"

Tenant interior finish and minor exterior remodel

Fully sprinklered in accordance with IBC 903.3.1.1 &

Maximum height increase 20'-0" (table 506.2) (no

Tenant finish within existing shopping center building

1740 white box for Landlord

M(section 302) no change

4 stories (table 504.4) (no change)

No change to existing building shell

existing to remain [0 hour minimum]

1 hour minimum provided

75' [table 504.3] (no change)

Type IIB (no change)

1 story (no change)

30'-4"' (no change)

3,340 sf leased space

PDU

NFPA 13

change)

occupant load calculation

room nun	nber room name	area	area per d	occupant occupant l	oad exit width	required exit location
100	sales	2,617 SF	60 SF	44	8.8"	1
101	stockroom	513 SF	300 SF	2	0.4"	2
102	[e] mens	44 SF	0 SF			1
103	[e] womens	45 SF	0 SF			1
		3.219 SF		46	9.2"	

exit locations table


location	exit width required	exit width provided	no. of occupants	
1	8.8"	72"	4	.4
2	0.4"	36"		2
	9.2"	108"	4	-6

plumbing analysis

total occupant load	user	ratio	water closets	urinals	lavatories	drinking fountains	service sink
46	occupants						
	required				1 per 750	1 per1000	1 required
23	male	1 per 500	1		1	1	
23	female	1 per 500	1		1	1	
	provided					bottle water will be provided in	1
						lieu of drinking fountain	
	male		1	-	1		
	female		1		1		

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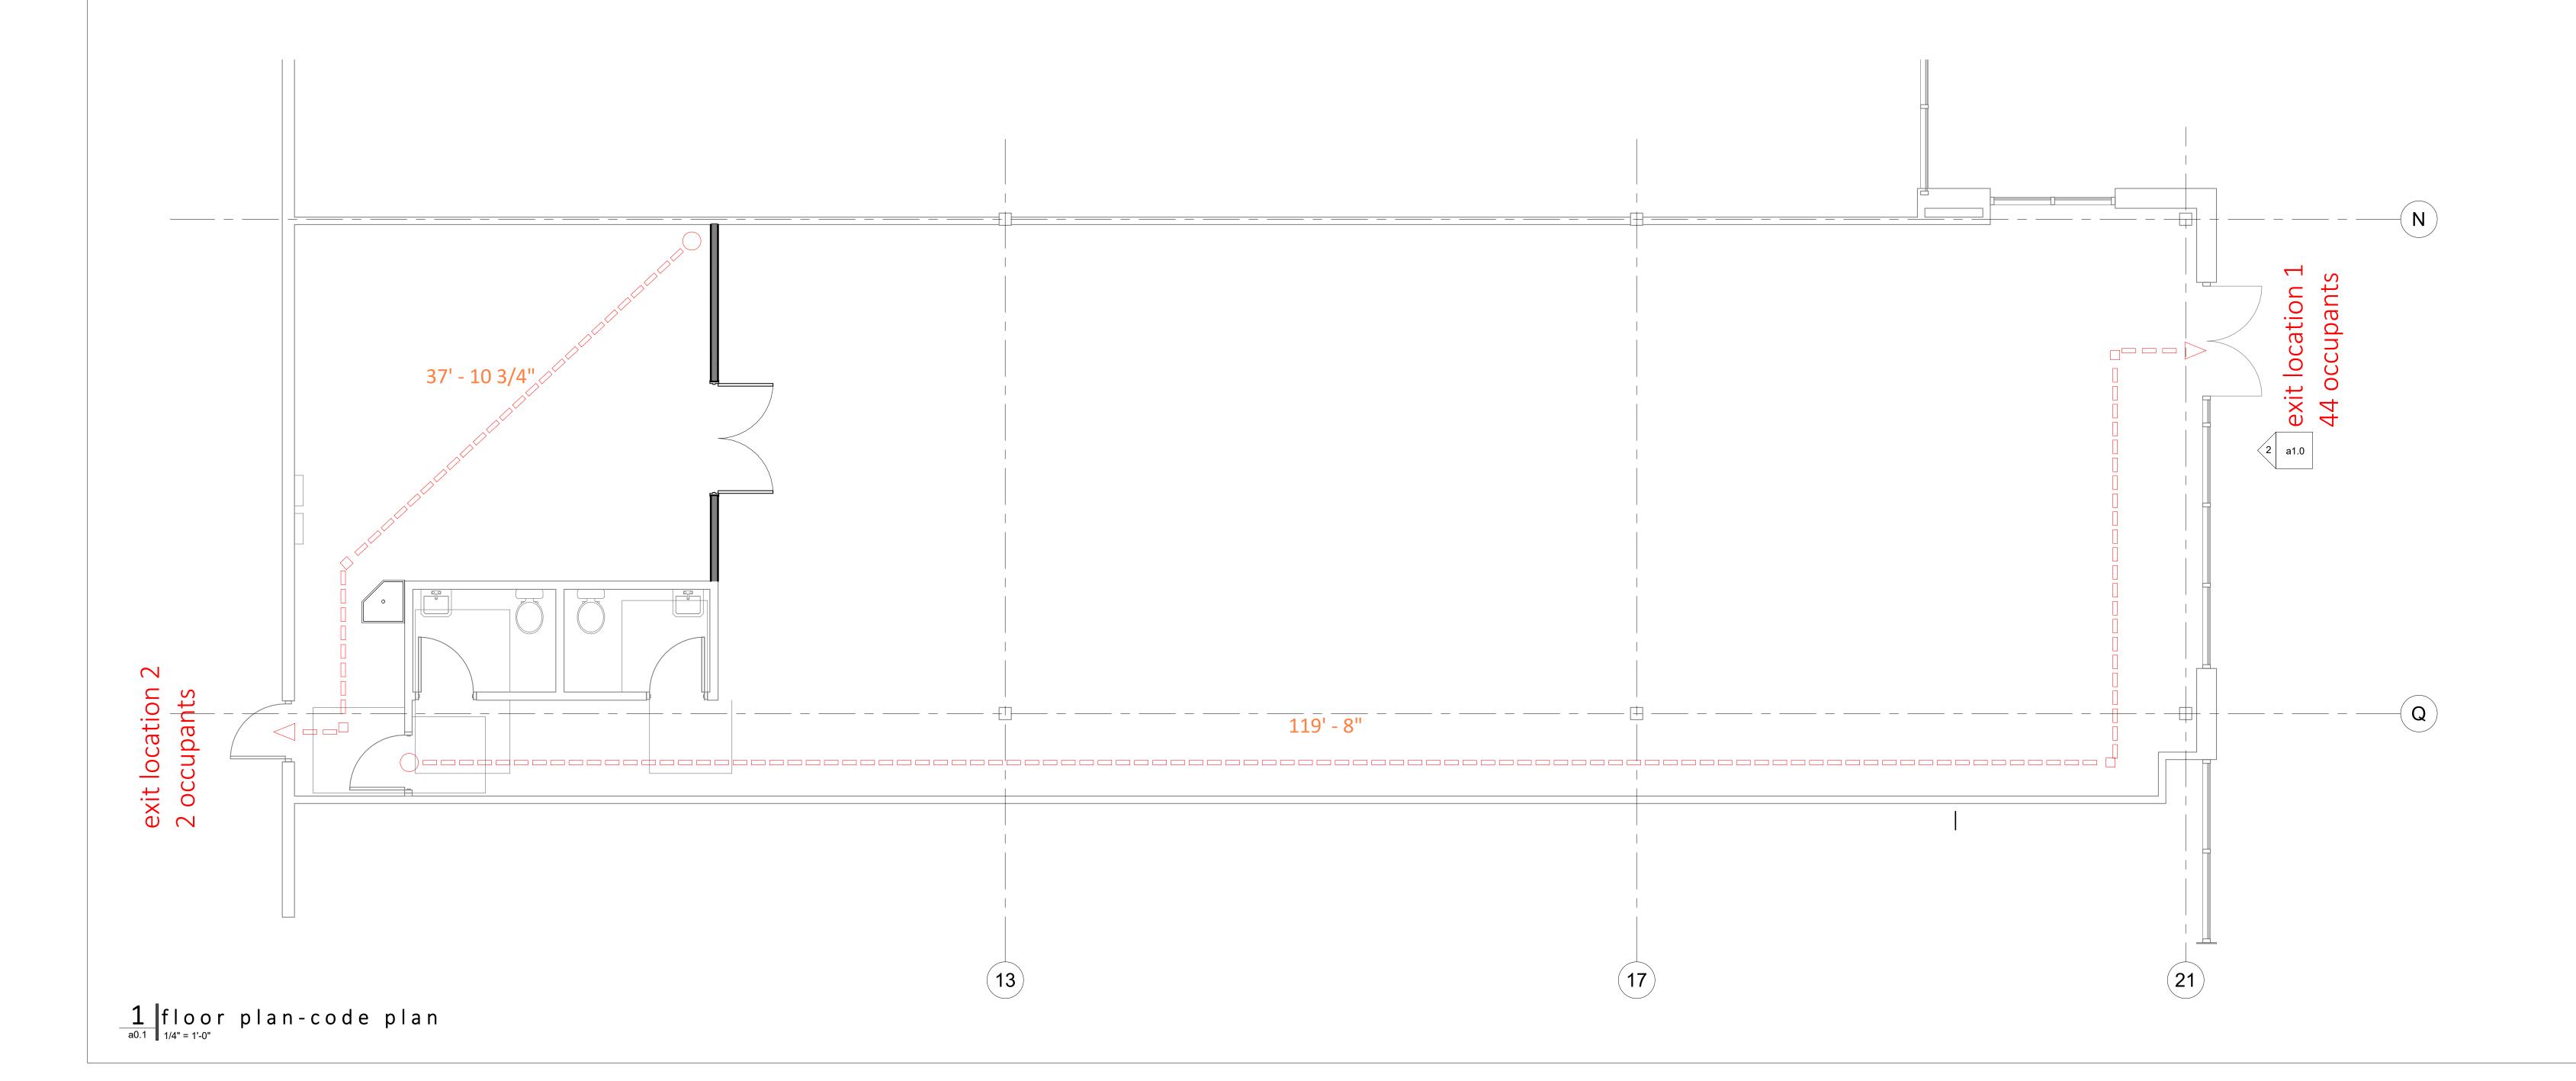
1740 white box


1740 NW Chipman Road Lee's Summit, MO 64081

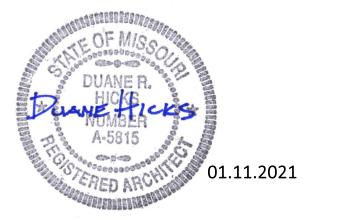sheet NAME code sheet

ARCH PROJECT NO.

01/05/2021 a0.1 Permit



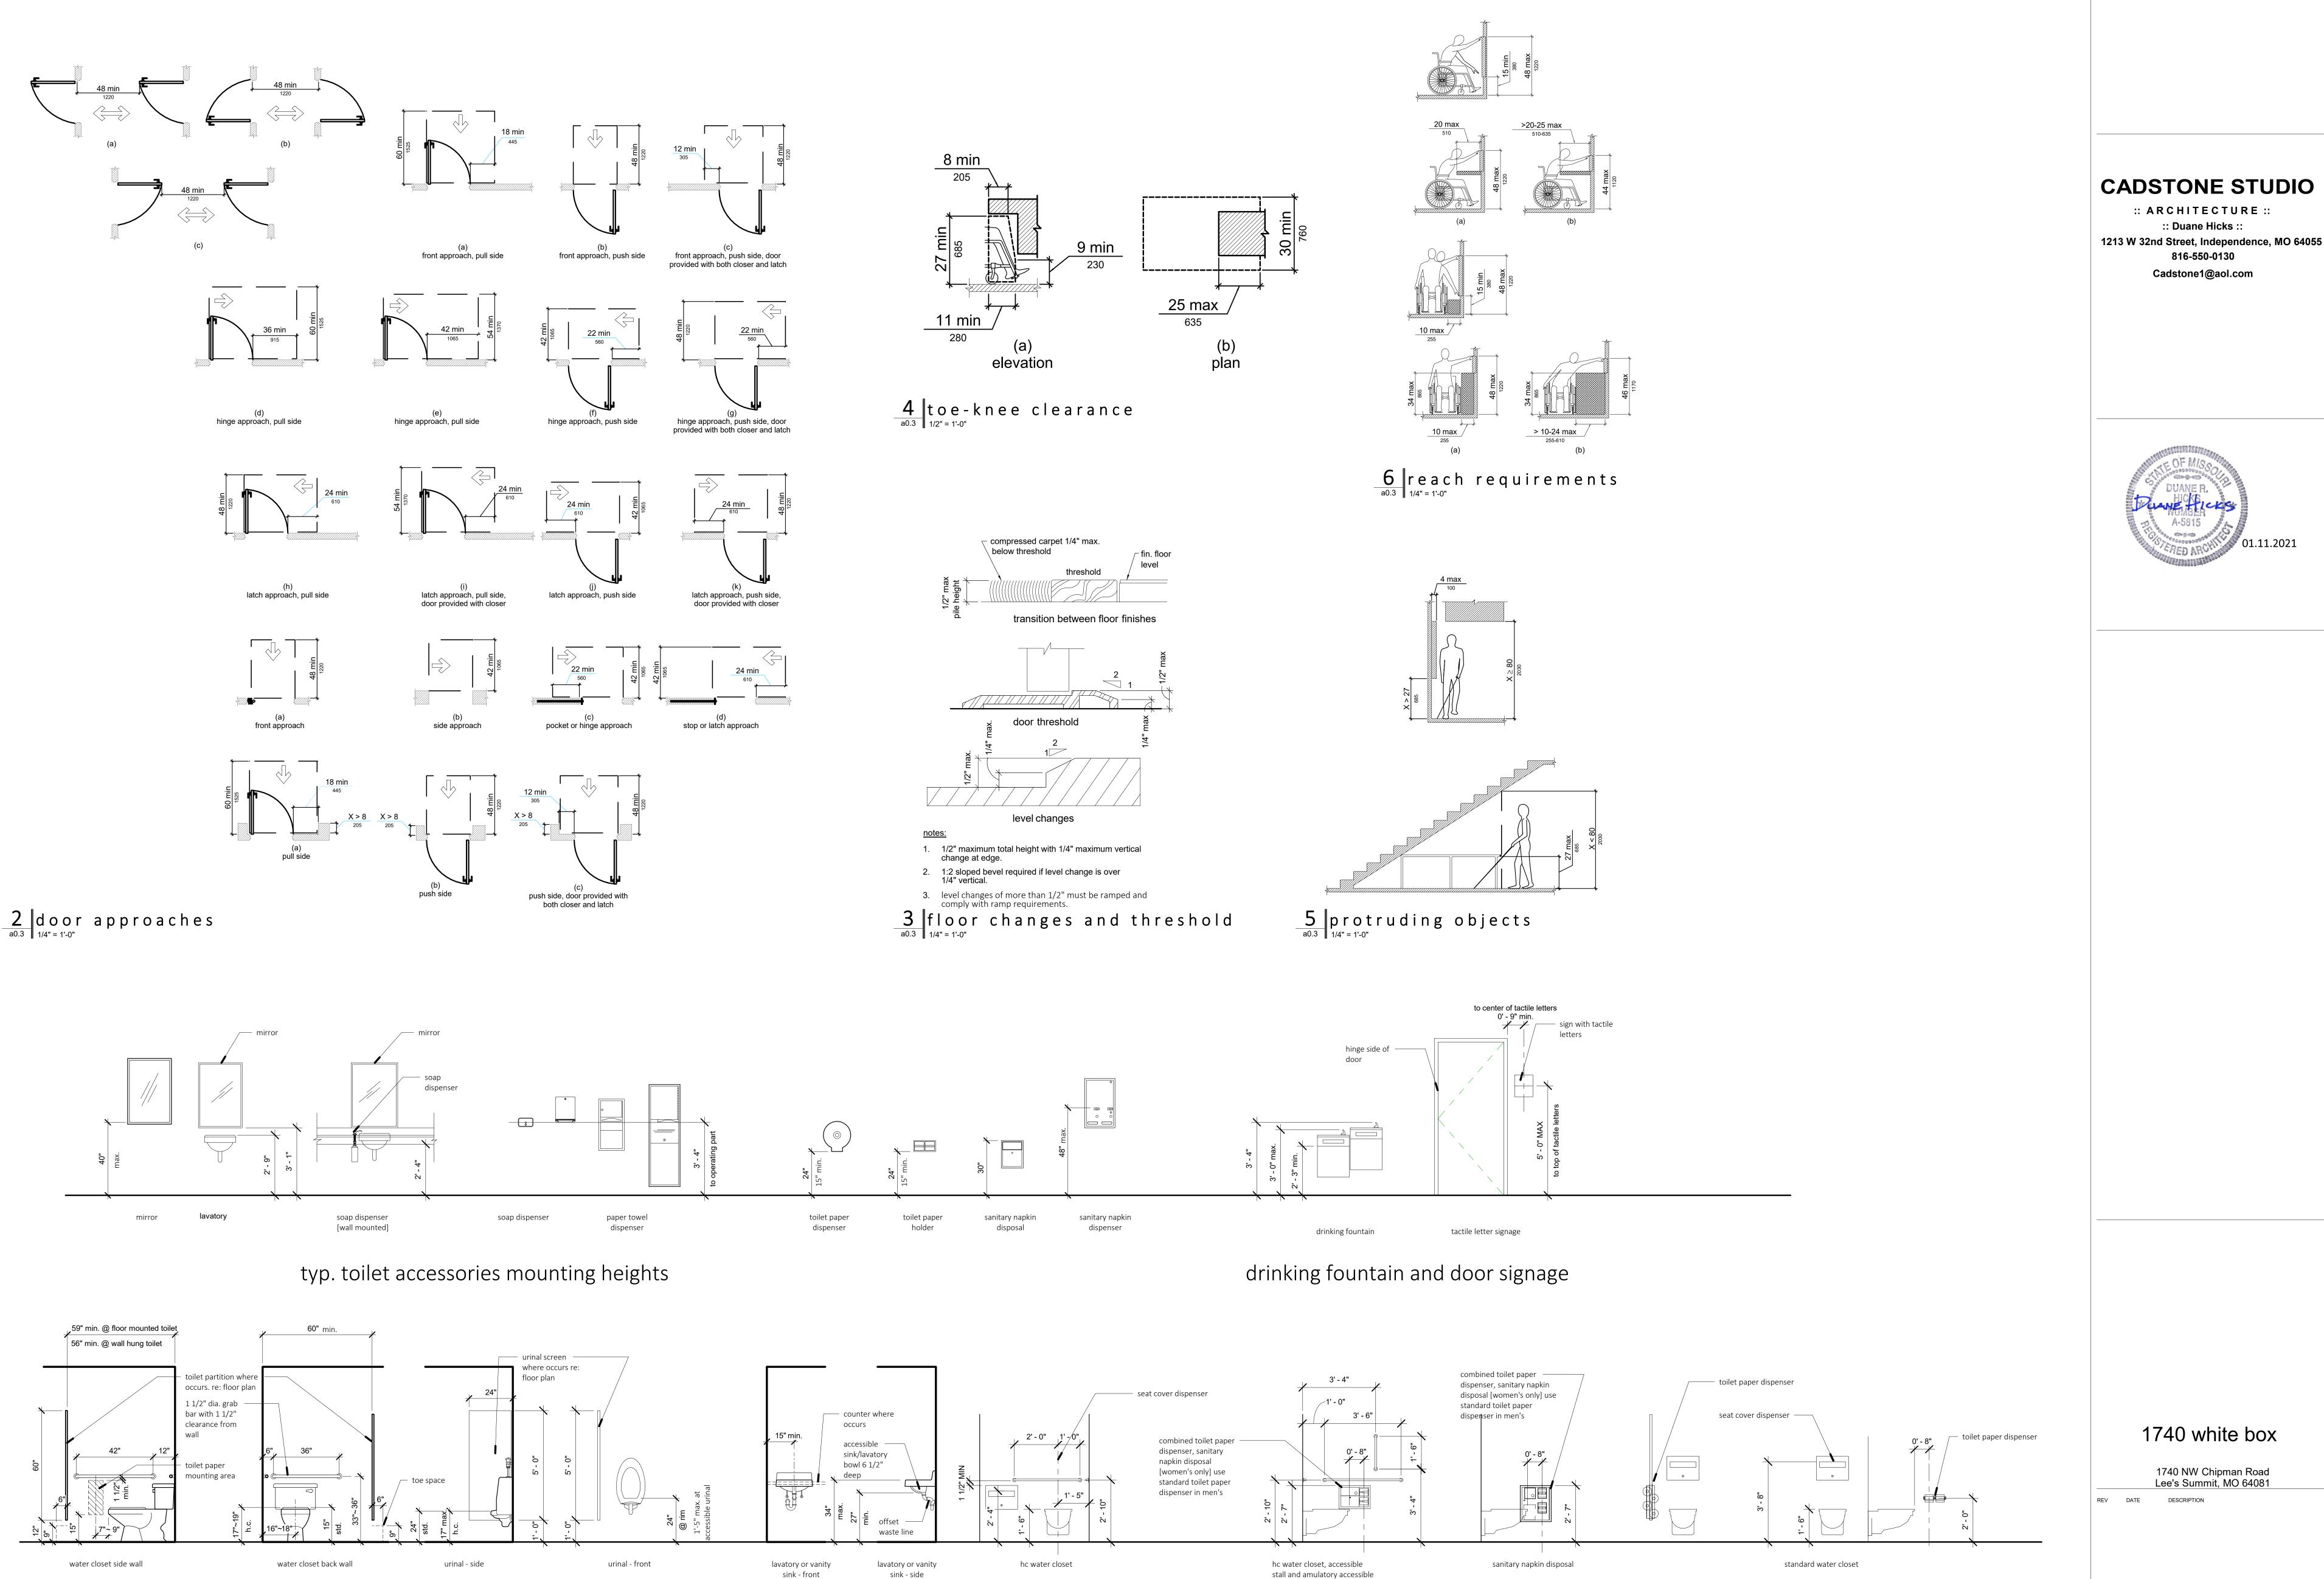

general accessibility diagrams

1740 white box

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ARCH PROJECT NO. 01/05/2021 PROJECT PHASE a0.3 Permit

1/(a0.3) typical accessible heights

typ. plumbing fixtures and accessories mounting heights

key notes-demolition general notes - demolition Remove any existing kitchen equipment remaining in space. Cap any utilities back to source u.n.o. Remove existing kitchen hood and exhaust. g.c. to patch and repair roof to match existing conditions. Contractor shall All work shall conform to the requirements of all local laws, codes, and regulations of all authorities having jurisdiction; in case of conflict between requirements, the most restrictive shall apply. use Landlord required roofing contractor to retain all existing warranties. Remove existing walk in cooler, including but not limited to shelving inside, condensor etc. back to source. 2 The Contractor shall field check all relevant conditional and dimensions and notify the architect of any discrepancies with the drawings prior to construction. Remove existing 3 compartment sink, hand sink and additional shelving. Remove existing hot water heater, cap lines Existing conditions and elevations are derived from field measurements and are shown to assist the bidders only. No and prepare for new hot water heater per plumbing drawings. claim is made to their validity. The Contractor and Subcontractors shall visit the side prior to submitting a bid and provide Remove existing walls in its entirety. Patch and repair any adjacent building materials to remain. Ensure any rated for all existing conditions. No allowance will be made resulting from failure to carry out such an examination. elements maintain existing ratings throughout. Prior to the start of construction or demolition, the Contractor shall coordinate with the Landlord rep. or on site Remove all existing floor finishes througout space except for existing restroom (to remain). Take down to existing floor management and any adjacent tenants if work will impact their daily operations. slab and shall be smooth finish ready for new flooring surfaces. Remove section of storefront system adjacent to existing door. Prepare for new 3' door to match existing and provide Contractor shall acquaint themselves with all Landlord/Developer requirements and shall comply full with such. new sidelight adjacent to new door. The work involved shall be the entire responsibility of the Contractor who shall ensure that such work is properly carried out by his forces of their Subcontractors. The contractor shall confirm that all items are covered. Remove all existing shelving, hardware, cabinets, tables/chairs/booths, checkout counters and any fixtures left in space. Protect exisiting conditions from damage and repair damage due to construction operations at no cost to owner. Not Used 8 Demolition work shall be executed in an orderly and careful manner and demolished materials shall become the property Remove existing furr out and wood plank/bar shelves back to existing demising wall. Ensure demising wall is patched of the contractor for off-site disposal at their expense, in a legal manner. and repaired to meet all rated wall assemblies. Demolition contractor shall dispose of all removed materials at an appropriate location. The Contractor shall confirm the Remove existing data cables, electrical conduits and lines back to source. exact location with the Landlords on site representative Remove existing drop ceiling soffit bar lights and any additional hardware back to source. Perform work by means that will not produce noise, vibration, odors, or dust which could affect operations or use by Remove all existing ACT ceiling and lights throughout. other tenants. Contractor shall provide adequate protection of work, materials, fixtures, etc. from loss, damage, fire, theft, etc. Remove all existing lighting in ceiling throughout. Remove conduit and electrical lines back to source. Remove existing walls as indicated. Patch and repair all remaining walls and soffits for as new finish. Remove and replace Remove all existing duct work throughout u.n.o on mechanical plans, remove back to source. existing concrete slab or sidewalk and prepare for new work. 17 Existing restrooms to remain. When existing finishes are to be removed from existing substrate, the remaining substrate shall be patched and/or repaired and prepared to receive new finish as required by the manufacturer's recommendations. Verify all existing steel columns, bases and foundations are in acceptable condition. Notify the architect immidiately if 15 Where removal of walls are indicated, remove existing electrical devices, related wiring and conduit back to the source to faciltate removal. Salvage all hornstrobes, emergency lighting, FE cabinets and thermostats for reuse on this project. Contractor shall include removal of all abandoned conduit and wiring above ceilings. 16 Contractor is responsible for patching and repairing any and all fireproofing [to match or exceed existing] material and thickness, whether caused by Contractor or not. 2 demo plan $\frac{1}{a0.5}$ demo-reflected ceiling plan

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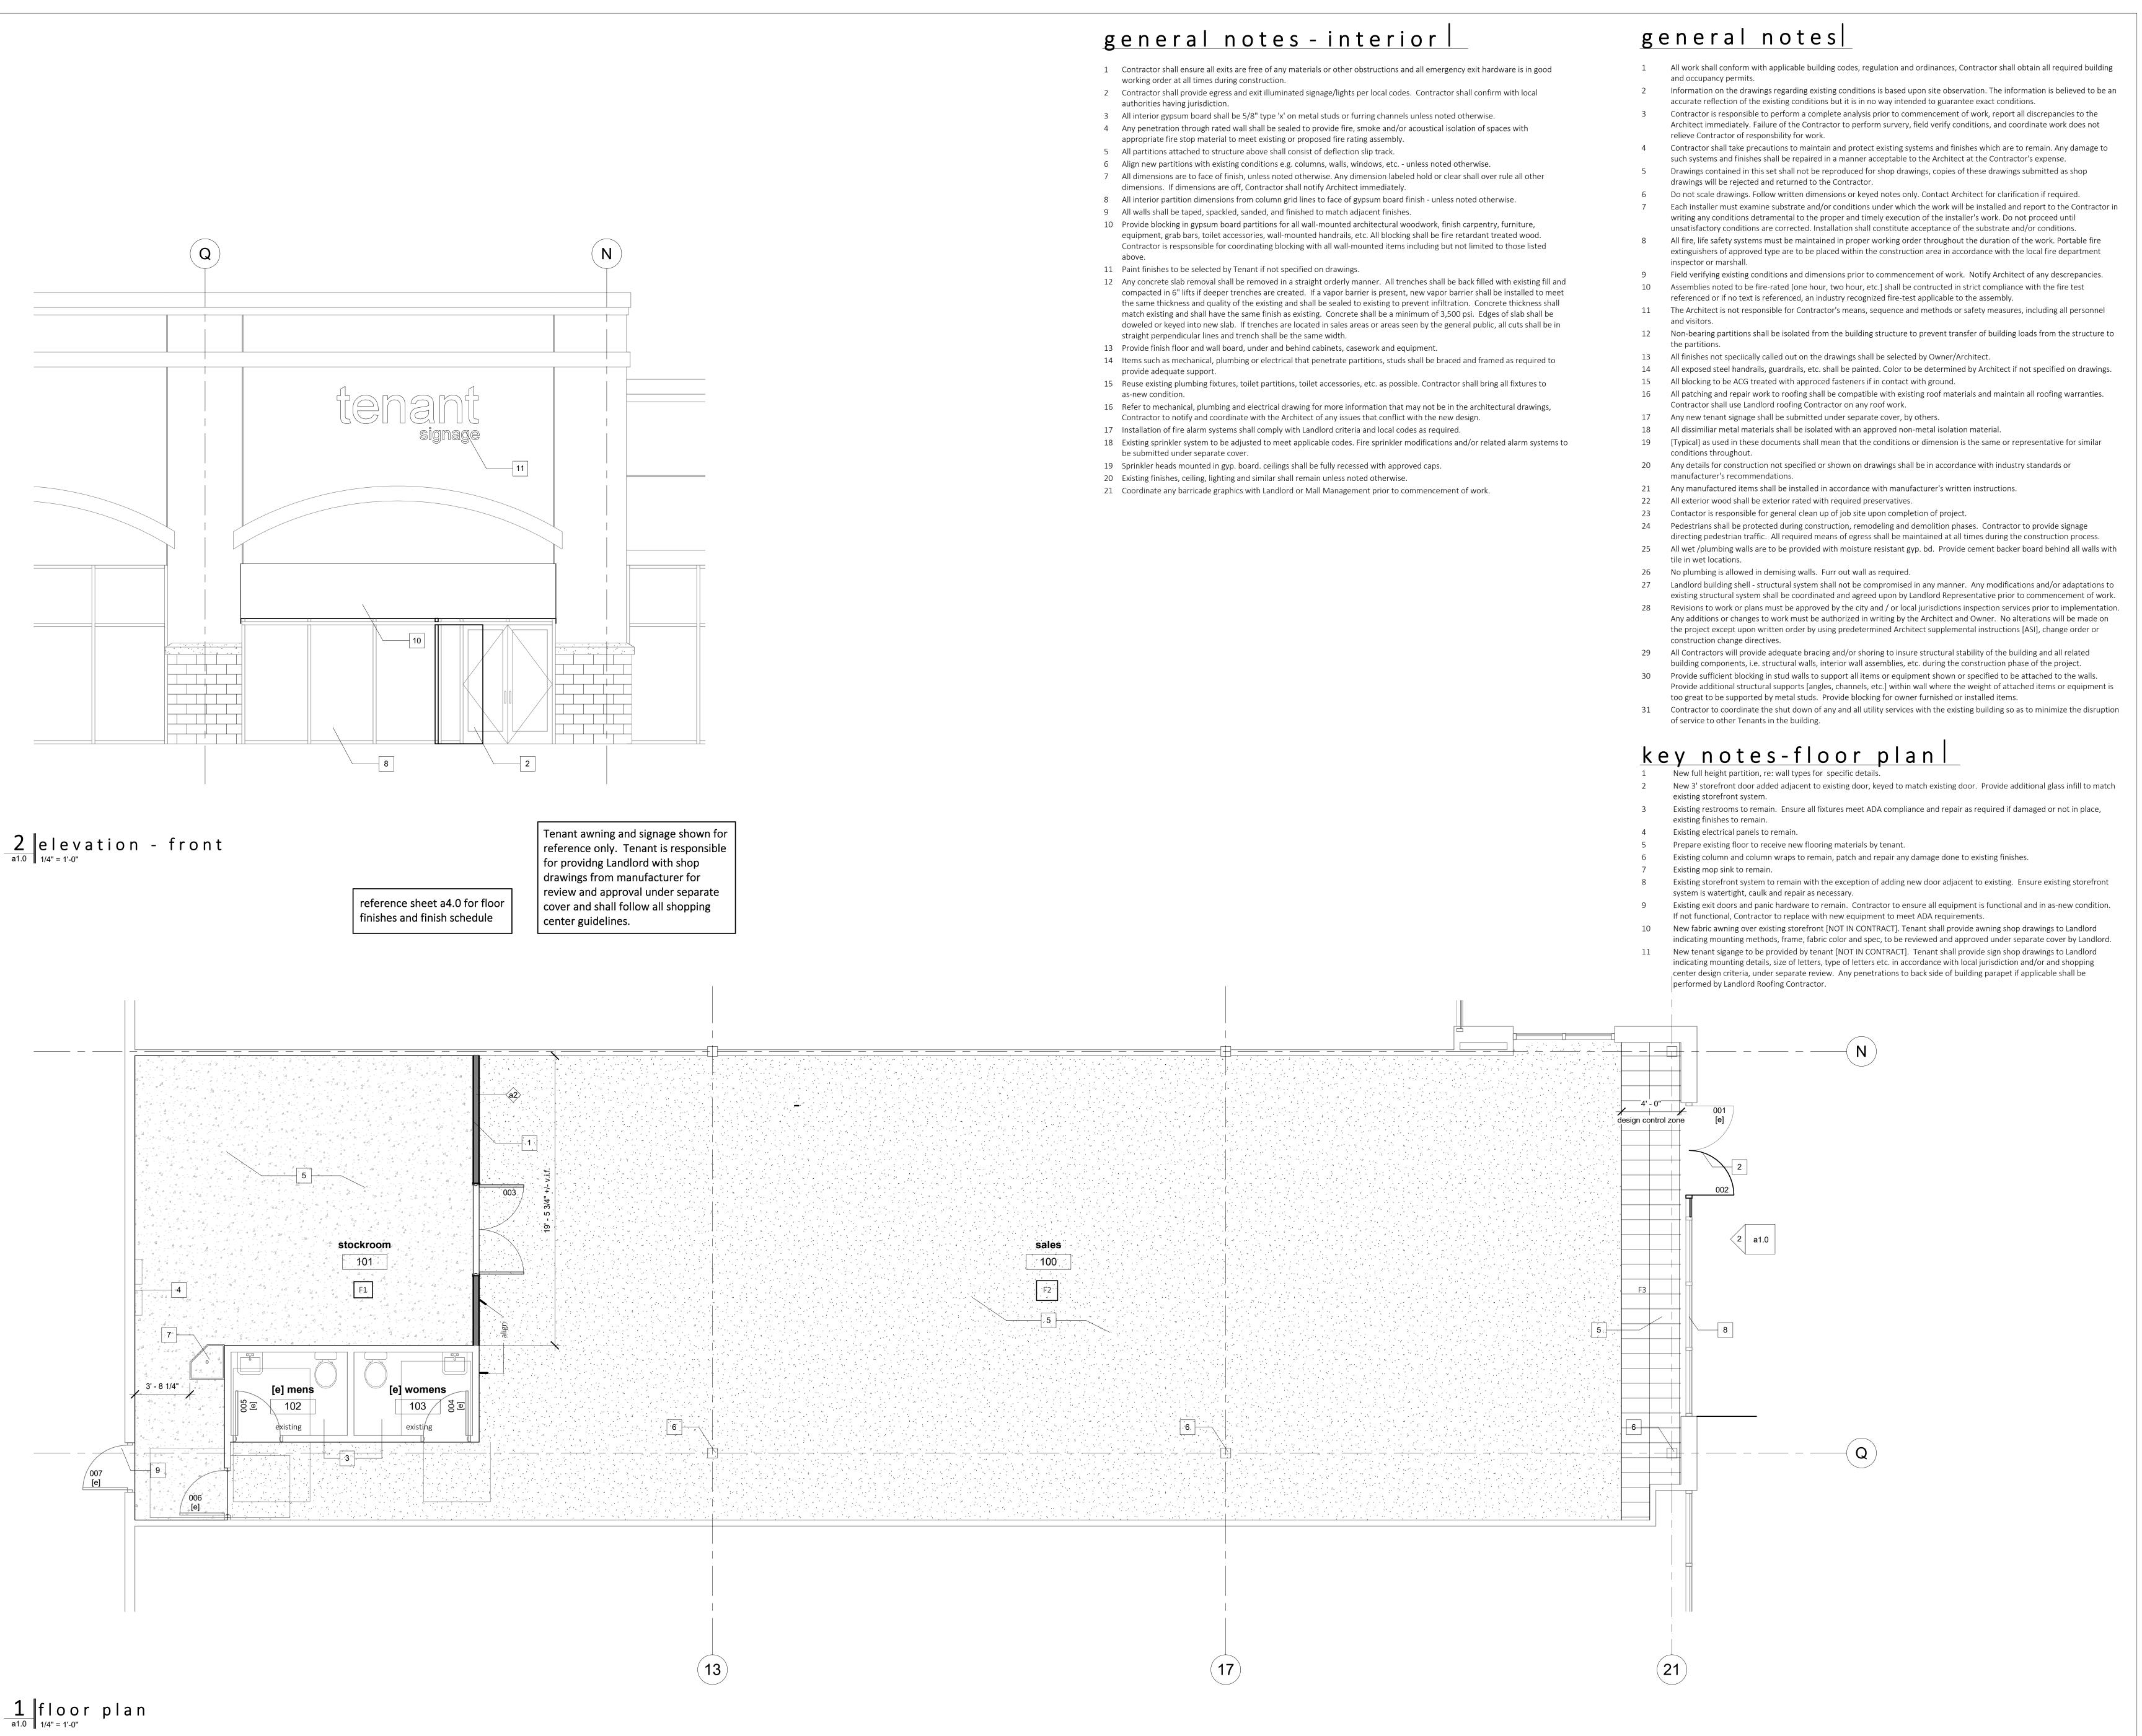
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1740 white box

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demo floor plan

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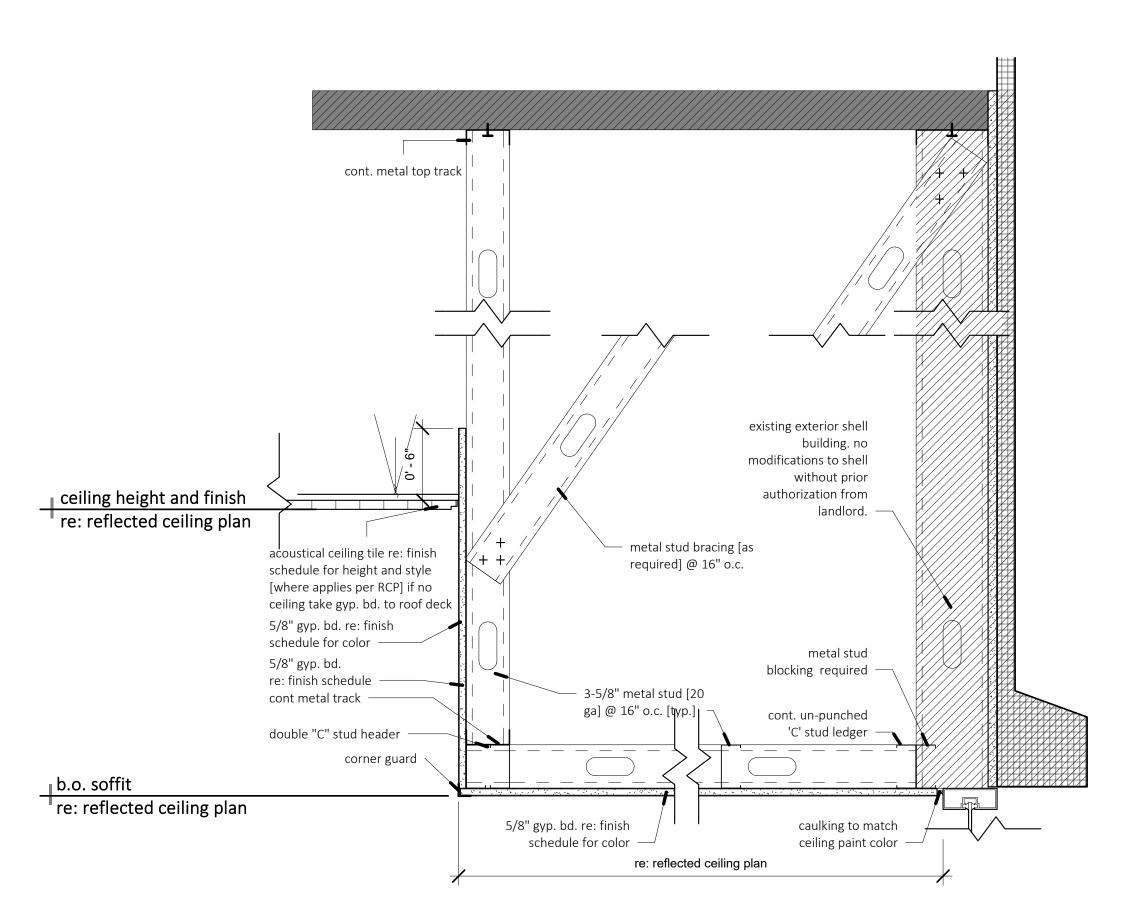
1740 white box

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floor plan


ARCH PROJECT NO.

01/05/2021




2 soffit - ceiling detail@storefront

all lighting per electrical drawings.

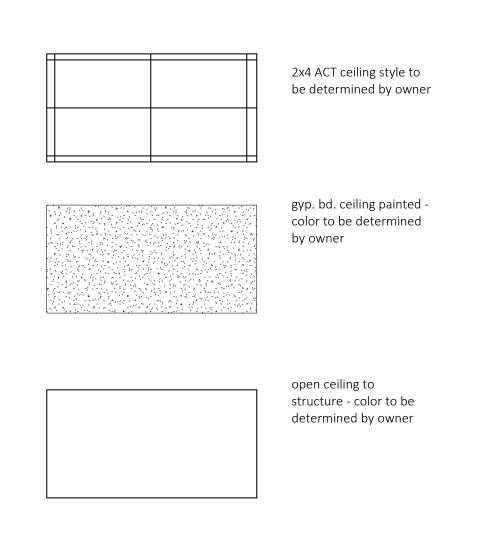


reflected ceiling plan legend

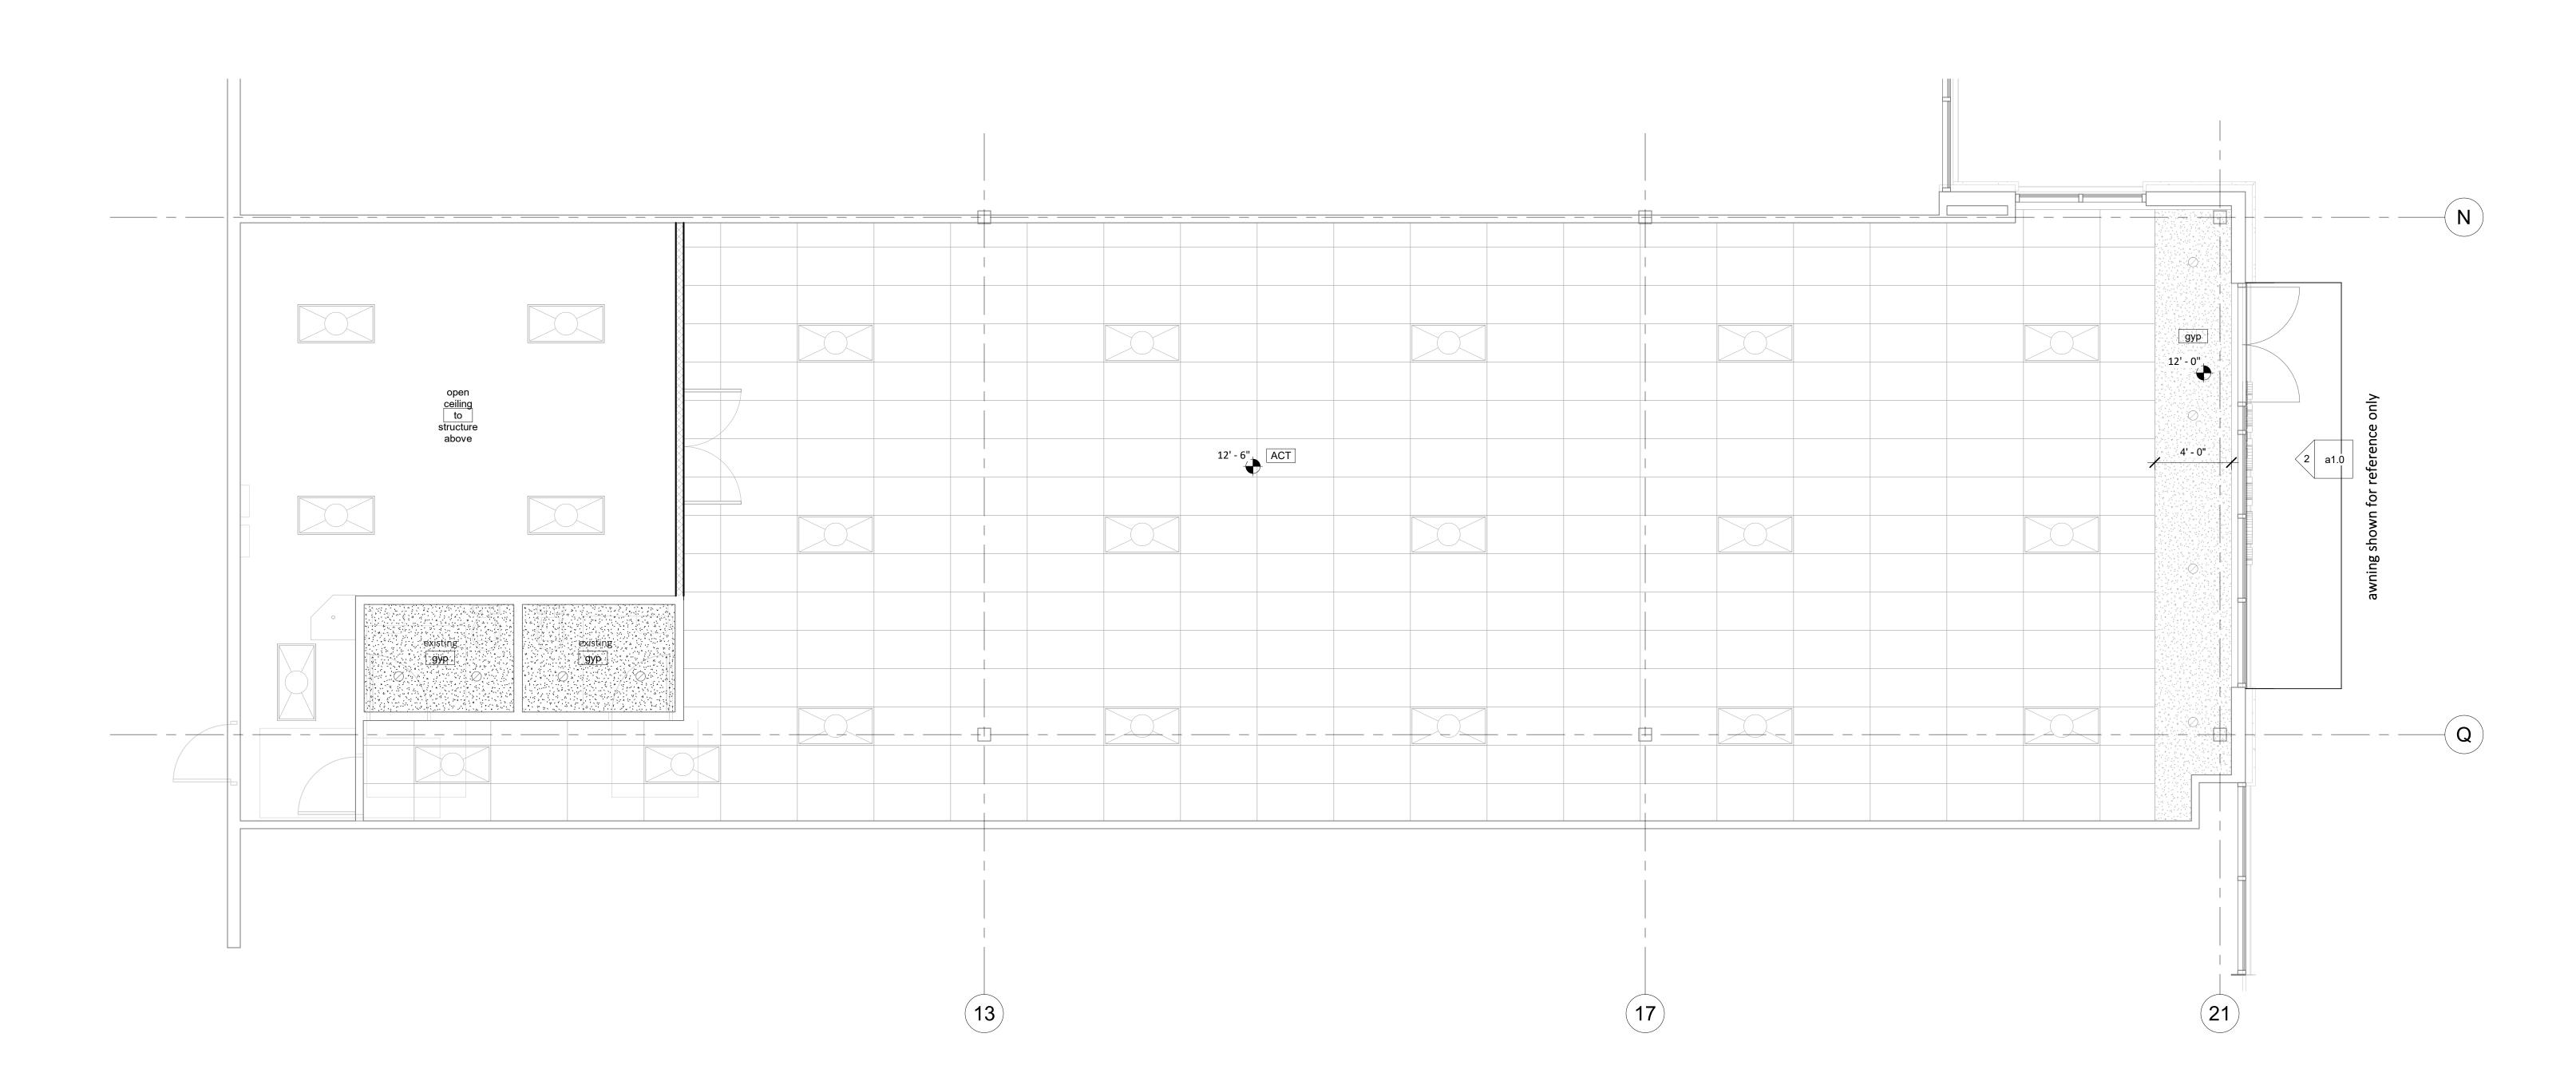

1/4 floor plan-reflected ceiling plan

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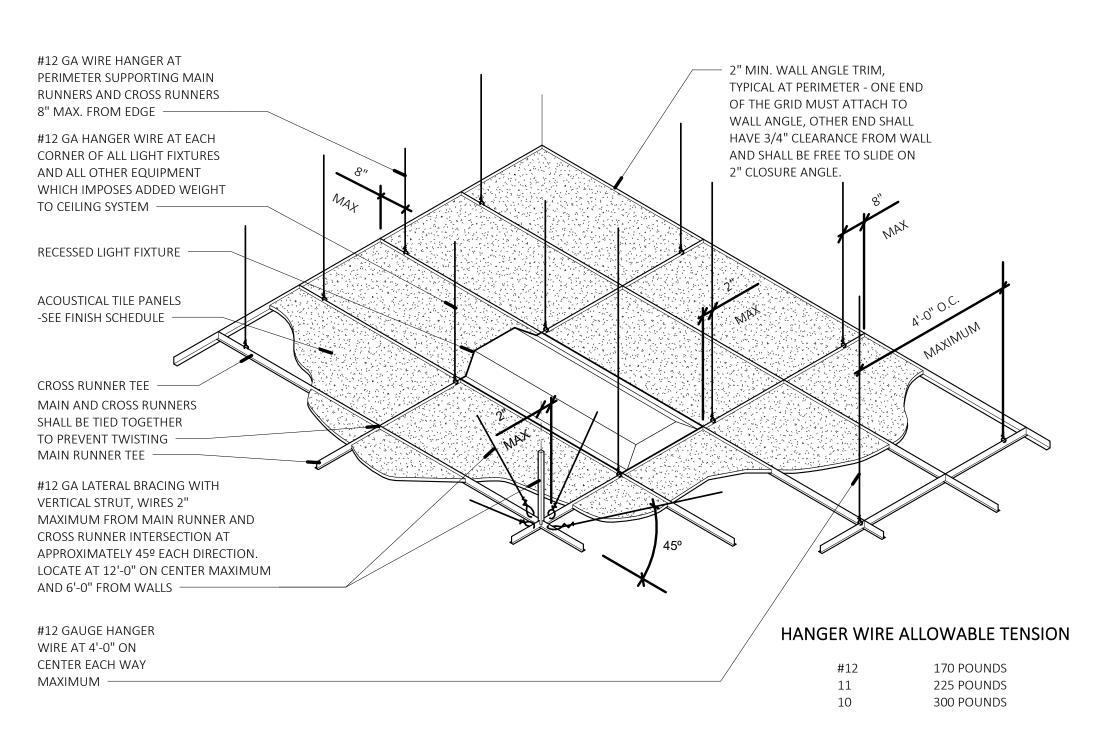


1740 white box
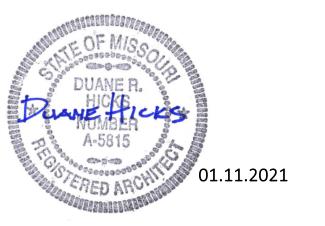
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reflected ceiling plan

a1.2




2 suspended ceiling detail

BXUV.U419 Fire Resistance Ratings - ANSI/UL 263

Design/System/Construction/Assembly Usage Disclaimer Authorities Having Jurisdiction should be consulted in all cases as to the particular requirements covering the installation and use of UL Certified products,

equipment, system, devices, and materials. Authorities Having Jurisdiction should be consulted before construction. Fire resistance assemblies and products are developed by the design submitter and have been investigated by UL for compliance with applicable

requirements. The published information cannot always address every construction nuance encountered in the field. When field issues arise, it is recommended the first contact for assistance be the technical service staff provided by the product manufacturer noted for the design. Users of fire resistance assemblies are advised to consult the general Guide Information for each product category and each group of assemblies. The Guide Information includes specifics concerning alternate materials and alternate methods of construction. Only products which bear UL's Mark are considered Certified.

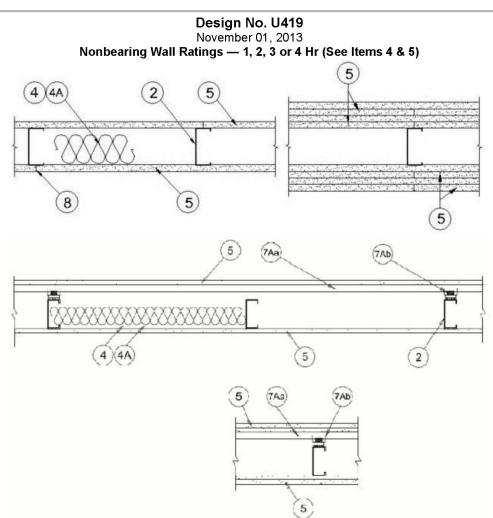

1. Floor and Ceiling Runners — (Not shown) — For use with Item 2 - Channel shaped, fabricated from min 25 MSG corrosion-protected steel, min depth to accommodate stud size, with min 1-1/4 in. long legs, attached to floor and ceiling with fasteners 24 in. OC max. 1A. Framing Members* - Floor and Ceiling Runner — Not shown - In lieu of Item 1 — For use with Item 2B, proprietary channel shaped runners, 3-5/8 in.

deep attached to floor and ceiling with fasteners 24 in. OC max. CALIFORNIA EXPANDED METAL PRODUCTS CO — Viper25™ Track CRACO MFG INC — SmartTrack™ MARINO/WARE, DIV OF WARE INDUSTRIES INC — Viper25™ Track

1B. Framing Members* - Floor and Ceiling Runner — Not shown - In lieu of Item 1 — For use with Item 2C, proprietary channel shaped runners, 1-1/4 in. wide by 3-5/8 in. deep fabricated from min 0.020 in. thick galv steel, attached to floor and ceiling with fasteners spaced 24 in. OC max. CALIFORNIA EXPANDED METAL PRODUCTS CO — Viper20™ Track MARINO/WARE, DIV OF WARE INDUSTRIES INC — Viper20™ Track PHILLIPS MFG CO L L C — Viper20™ Track

1C. Framing Members*— Floor and Ceiling Runners — (Not shown) — In lieu of Item 1 - Channel shaped, attached to floor and ceiling with fasteners 24 ALLSTEEL & GYPSUM PRODUCTS INC — Type SUPREME Framing System

CONSOLIDATED FABRICATORS CORP, BUILDING PRODUCTS DIV — Type SUPREME Framing System QUAIL RUN BUILDING MATERIALS INC — Type SUPREME Framing System SCAFCO STEEL STUD MANUFACTURING CO — Type SUPREME Framing System STEEL CONSTRUCTION SYSTEMS INC — Type SUPREME Framing System UNITED METAL PRODUCTS INC — Type SUPREME Framing System


1D. Floor and Ceiling Runners — (Not shown)—For use with Item 2A- Channel shaped, fabricated from min 20 MSG corrosion-protected or galv steel, min depth to accommodate stud size, with min 1 in. long legs, attached to floor and ceiling with fasteners spaced max 24 in. OC.

1E. Framing Members*— Floor and Ceiling Runners — (Not shown, As an alternate to Item 1) — For use with Items 2E, 5F or 5G or 5I only, channel shaped, fabricated from min. 0.015 in. (min bare metal thickness) galvanized steel, attached to floor and ceiling with fasteners 24 in. OC. max. CLARKDIETRICH BUILDING SYSTEMS — CD ProTRAK DMFCWBS L L C — ProTRAK

MBA BUILDING SUPPLIES INC — ProTRAK RAM SALES L L C — Ram ProTRAK SOUTHEASTERN STUD & COMPONENTS INC — ProTRAK STEEL STRUCTURAL SYSTEMS L L C — Tri-S ProTRAK

parallel to deck

PHILLIPS MFG CO L L C — Viper25™ Track

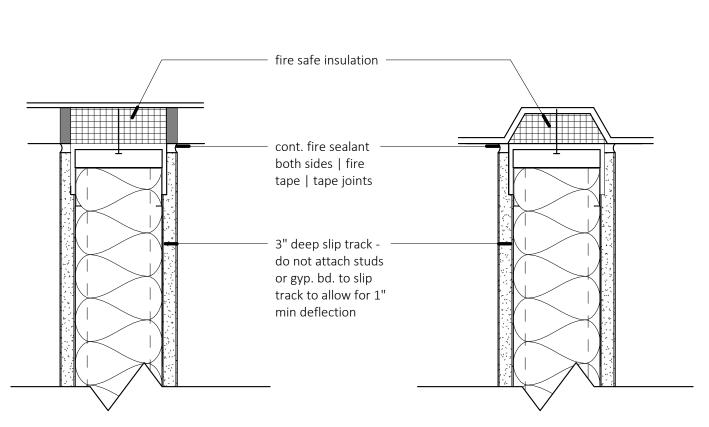

perpendicular to deck

wall sheathing wall thickness insulation type u.n.o. wall type stud size 3 5/8" 4 7/8" 5/8" gyb bd [typ 'x' rated per UL u419] sound batt insulation 3 5/8" 4 7/8" 5/8" gyb bd [both sides] sound batt insulation 5/8" gyb bd [one side] sound batt insulation b 1 5/8" gyb bd [typ 'x' rated per UL u419] 7 1/4" sound batt insulation b 2 7 1/4" 5/8" gyb bd [both sides] sound batt insulation 6 5/8" 5/8" gyb bd [one side] sound batt insulation

full height partition | full height studs, full height gyp. bd. interior walls not going to deck | 6" above adjacent tallest ceiling | bracing to deck as required

demising or corridor wall only | use sound attenuation batt insulation in all demising walls set runner track in continious acoustical sealent | wall assembly to be rated per UL u419 u.n.o.

CEILING NOTES

SUSPENDED CEILING SHALL COMPLY WITH THE REQUIREMENTS OF THE 2009 IBC SECTION 1613, METAL SUSPENDED SYSTEMS FOR ACOUSTICAL TILE AND FOR LAY-IN PANEL CEILINGS, AND INCLUDING BUT NOT LIMITED TO CURRENT MOA REQUIREMENTS FOR LATERAL FRAME BRACING AND LIGHT FIXTURE SUPPORTS.

THE SUSPENDED CEILING SYSTEM, MECHANICAL DUCTWORK AND LIGHTING FIXTURES SHALL BE POSITIVELY ATTACHED FROM THE STRUCTURE ABOVE.

HANGER WIRES ARE TO BE ATTACHED TO STRUCTURE ABOVE WITH AN APPROVED HANGER ATTACHMENT DEVICE.

ALL LIGHTING FIXTURES SHALL BE POSITIVELY ATTACHED TO THE SUSPENDED CEILING SYSTEM. THE ATTACHMENT DEVICE SHALL HAVE A CAPACITY OF 100 PERCENT OF THE LIGHTING FIXTURE WEIGHT ACTING IN ANY DIRECTION. THE ATTACHMENT SHALL CONSIST OF FOUR EQUALLY SPACED ATTACHMENT POINT USING SCREWS, RIVETS, BOLTS OR OTHER APPROVED POSITIVE ATTACHMENT DEVICES. IN ADDITION THE FOLLOWING SHALL BE PROVIDED.

LIGHT FIXTURES WEIGHING LESS THAN 10 POUNDS SHALL HAVE (1) #12 GAUGE WIRE CONNECTED TO THE CENTER OF THE FIXTURE HOUSING AND THE STRUCTURE ABOVE. THIS WIRE MAY BE INSTALLED SLACK

LIGHT FIXTURES WEIGHING 10 POUNDS OR MORE BUT LESS THAN 56 POUNDS SHALL HAVE (2) #12 GAUGE HANGER WIRES CONNECTED FROM OPPOSITE CORNERS OF THE FIXTURE HOUSING TO THE STRUCTURE ABOVE. THESE WIRES MAY BE SLACK.

LIGHT FIXTURES WEIGHING 56 POUNDS OR MORE SHALL BE INDEPENDENTLY SUPPORTED DIRECTLY FROM THE STRUCTURE ABOVE, BY APPROVED HANGERS. IN ADDITION, OTHER APPLICABLE REQUIREMENTS OF THE COUNTY BUILDING CODE AND RULES FOR EARTHQUAKE RESISTANT ELECTRICAL SYSTEM COMPONENTS SHALL APPLY.

EXCEPTIONS:

4 lateral bracing at roof deck

section at ceiling

plan view

section at floor


finish floor per finish plan

1. LIGHT FIXTURES THAT ARE NOT COMPONENTS OF A STAND-BY OR EMERGENCY LIGHTING SYSTEM AND WEIGH LESS THAN 20 POUNDS AND POWERED USING APPROVED FLEXIBLE CABLE ASSEMBLIES NO LESS THAT 3 FEET LONG CONNECTED TO SUCH FIXTURES, ARE NOT REQUIRED TO HAVE THE ADDITIONAL SUPPORT WIRE(S) DESCRIBED ABOVE. SUCH FIXTURES ARE REQUIRED TO BE POSITIVELY ATTACHED TO THE CEILING GRID AS DESCRIBED ABOVE.

2. LIGHT FIXTURES INSTALLED IN THE EXISTING CEILING GRID OF EXISTING BUILDINGS ARE NOT REQUIRED TO HAVE THE ADDITIONAL VERTICAL SUPPORT WIRES DESCRIBED ABOVE, WHEN ALL OF THE FOLLOWING CONDITIONS ARE MET.

A) THE LIGHT FIXTURE(S) ARE REPLACING FIXTURE(S) THAT ARE DAMAGED, DILAPIDATED OR INOPERATIVE AS PART OF GENERAL MAINTENANCE, AND

B) THE EXISTING CEILING GRID IS CAPABLE OF PROVIDING ADEQUATE

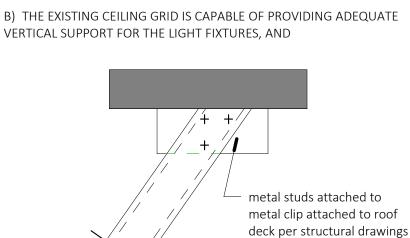

roof deck above

bracing to structure above as

req. re: structural drawings

ceiling per plan and schedule

5/8" gyp. bd. sheathing | tape,

sanded, ready for paint both

schedule for size and thickness

sound attenuation batt insulation

metal stud bracing as req.

continuous metal runner track

set with hilti X-DNI powder driven

pins .145 dia. x 3/4" long at 12"

o.c., or approved equal attachment method

sides [u.n.o.] re wall type

- metal studs re: wall type

schedule

per schedule

cont. deflection slip track at structure

C) EXISTING LIGHT FIXTURES ARE NOT PROVIDED WITH THE ADDITIONAL VERTICAL SUPPORT WIRES DECRIBED ABOVE, AND

D) THE LIGHT FIXTURES ARE POSITIVELY ATTACHED TO THE CEILING GRID AS DESCIBED ABOVE.

MECHANICAL AIR TERMINALS (GRILLS, DIFFUSERS, ETC.): NEW AND REPLACED MECHANICAL AIRE TERMINALS MUST BE POSITIVELY ATTACHED TO THE CEILING GRID WITH AN ATTACHMENT CAPABLE OF CARRYING 100 PERCENT OF THE WEIGHT OF THE MECHANICAL AIR TERMINAL ACTING IN ANY DIRECTION. THIS ATTACHMENT SHALL CONSIST OF FOUR EQUALLY SPACED ATTACHMENT POINTS USING SCREWS, RIVETS, BOLTS OR APPROVED POSITIVE ATTACHMENT DEVICES. IN ADDITION, THE FOLLOWING SHALL BE PROVIDED.

AIR TERMINALS WEIGHING 20 POUNDS OR MORE BUT LESS THAN 56 POUNDS SHALL HAVE TWO #12 GAUGE WIRES CONNECTING OPPOSITE CORNERS OF THE MECHANICAL AIR TERMINAL DEVICE TO THE STRUCTURE ABOVE. THESE WIRES MAY BE INSTALLED SLACK.

MECHANICAL AIR TERMINALS WEIGHING 56 POUNDS OR MORE SHALL BE INDEPENDENTLY SUPPORTED DIRECTLY FROM THE STRUCTURE ABOVE, BY APPROVED HANGERS. IN ADDITION, OTHER APPLICABLE REQUIREMENTS OF THE COUNTY BUILDING CODE AND RULES FOR EARTHQUAKE RESISTANT MECHANICAL SYSTEM COMPONENTS SHALL APPLY.

EXCEPTIONS:

MECHANICAL AIR TERMINALS (GRILLS, DIFFUSERS, ETC.) INSTALLED IN THE EXISTING CEILING GRID OF EXISTING BUILDINGS ARE NOT REQUIRED TO HAVE THE ADDITIONAL VERTICAL SUPPORT WIRES DESCRIBED ABOVE, WHEN ALL OF THE FOLLOWING CONDITIONS ARE MET.

A) THE MECHANICAL AIR TERMINAL(S) ARE REPLACING TERMINAL(S) THAT ARE DAMAGED, DILAPIDATED OR INOPERATIVE AS PART OF GENERAL MAINTENANCE, AND

B) THE EXISTING CEILING GRID IS CAPABLE OF PROVIDING ADEQUATE VERTICAL SUPPORT FOR THE MECHANICAL AIR TERMINALS, AND

C) EXISTING MECHANICAL AIR TERMINALS ARE NOT PROVIDED WITH THE ADDITIONAL VERTICAL SUPPORT WIRES DECRIBED ABOVE, AND

D) THE MECHANICAL AIR TERMINALS ARE POSITIVELY ATTACHED TO THE CEILING GRID AS DESCIBED ABOVE.

SPRINKLER HEADS AND OTHER PENETRATIONS OF CEILING TILE SHALL HAVE A 2" OVERSIZE RING, SLEEVE, OR ADAPTOR THROUGH THE CEILING TILE TO ALLOW FOR FREE MOVEMENT OF AT LEAST 1" IN ALL HORIZONTAL DIRECTIONS. AS AN ALTERNATIVE TO OVERSIZED HOLES AT SPRINKLER HEADS, LISTED FLEXIBLE SPRINKLER CONNECTIONS THAT ARE ATTACHED TO THE CEILING GRID MAY BE USED.

LATERAL FORCE BRACING: WHEN THE AREA OF THE NEW OR REPLACED CEILING GRID EXCEEDS 1,000 SF IN AREA, SUCH GRID SHALL BE PROVIDED WITH LATERAL FORCE BRACING SYSTEM OF SPLAYED WIRES AND STRUTS PLACED AT A MAXIMUM OF 12 FEET ON CENTER IN BOTH DIRECTIONS WITH THE FIRST POINT WITHIN 6 FEET FROM EACH WALL. THIS LATERAL FORCE BRACING SYSTEM SHALL BE INSTALLED AS FURTHER DESCRIBED BELOW.

THESE SPLAYED WIRES SHALL CONSIST OF FOUR #12 GAUGE WIRES SECURED TO THE MAIN RUNNER WITHIN 2 INCHES OF THE CROSS RUNNER INTERSECTION. THESE WIRES SHALL BE SPLAYED 90º FROM EACH OTHER AND INSTALLED AT AN ANGLE NOT EXCEEDING 45° FROM THE PLANE OF THE CEILING.

IN ADDITION, A VERTICAL STRUT SHALL BE PROVIDED NEAR THE CONNECTION OF THE SPLAYED WIRES DESCRIBED ABOVE. THIS STRUT SHALL BE FASTENED TO THE MAIN RUNNER AND EXTENDED AND FASTENED TO THE STRUCTURAL MEMBERS SUPPORTING THE ROOF OR FLOOR ABOVE. THE STRUT SHALL BE ADEQUATE TO RESIST THE VERTICAL COMPONENT INDUCED BY BRACING WIRES. THESE SPLAYED WIRES AND STRUTS SHALL BE PLACED AT A MAXIMUM OF 12 FEETON CENTER IN BOTH DIRECTIONS WITH THE FIRST POINT WITHIN 6 FEET FROM EACH WALL.

WHEN THE AREA OF THE NEW OR REPLACED CEILING GRID EXCEEDS 2,500 SF, THERE SHALL BE A SEPARATION JOINT TO SEPERATE GRIDS INTO AREAS NO GREATER THAN 2,500 SF. COORDNINATE LOCATION OF SEPERATION JOINT WITH ARCHITECT.

#12 GAUGE HANGER WIRE SHALL ATTACH THE GRID MEMBER TO THE STRUCTURE ABOVE WITHIN 2" OF EACH CORNER OF EACH FIXTURE. TANDEM

#12 GAUGE VERTICAL HANGER WIRES WITH NOT LESS THAN 3 TIGHT TURNS. #12 GAUGE BRACING WIRES WITH 4 TIGHT TURNS. MAKE ALL TIGHT TURNS WITHIN A DISTANCE OF 1-1/2".

CEILING SYSTEM TO MEET A CLASS 1 FLAME SPREAD IN THE CORRIDORS AND A CLASS 2 FLAME SPREAD IN ALL OTHER AREAS.


FIXTURES MAY UTILIZE COMMON WIRES.

SLICES AND INTERSECTIONS OF RUNNERS SHALL BE ATTACHED WITH MECHANICAL INTERLOCKING CONNECTORS SUCH AS POP RIVETS, SCREWS, PINS, OR PLATES WITH BENT TABS OR OTHER APPROVED CONNECTORS.

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Comments

PROVIDED BY TENANT

5/8" gyp. bd. ceiling

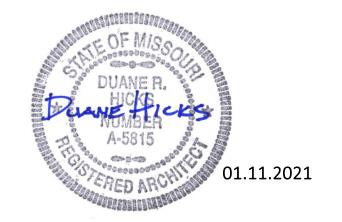owner to select colors

before ordering paint

open ceiling to deck above

2x4 ACT, color and style by owner

all paint colors to be coordinated on site with owner

 $S_{a4.0}$ wall penetration - duct

ceiling

gyp.


open

floor F1 un-sealed concrete F2 carpet - PROVIDED BY TENANT F3 tille - PROVIDED BY TENANT B1 6" rubber base PROVIDED BY TENANT B2 no base Construction Frame F2 F2/F3 B1 A1 A1 A1 A1 B2 A F2 (e) mens Existing	ceiling finish	wall finish	base finish	floor finish	oom name	room number ro	finish	finish callout
F1 un-sealed concrete F2 carpet - PROVIDED BY TENANT F3 tile - PROVIDED BY TENANT F3 tile - PROVIDED BY TENANT F3 for rubber base PROVIDED BY TENANT F4 for rubber base PROVIDED BY TENANT F5 for rubber base PROVIDED BY TENANT F5 for rubber base PROVIDED BY TENANT F6 for rubber base PROVIDED BY TENANT F7 for base F1 for rubber base PROVIDED BY TENANT F7 for base F1 for rubber base PROVIDED BY TENANT F7 for base F1 for rubber base PROVIDED BY TENANT F7 for base F1 for rubber base PROVIDED BY TENANT F7 for base F1 for rubber base PROVIDED BY TENANT F7 for base F1 for rubber base PROVIDED BY TENANT F7 for base F1 for rubber base PROVIDED BY TENANT F7 for base F1 for rubber base PROVIDED BY TENANT F7 for base F1 for rubber base PROVIDED BY TENANT F7	ACT/gyp						1111511	
F2 carpet - PROVIDED BY TENANT F3 tile - PROVIDED BY TENANT base B1 6" rubber base PROVIDED BY TENANT B2 door schedule Construction Fram.	open			·			un-sealed concrete	
base B1 6" rubber base PROVIDED BY TENANT B2 no base door schedule door Construction Frame	existing							
B1 6" rubber base PROVIDED BY TENANT no base no base door schedule door Construction Frame	existing	existing	existing	existing	e] womens	103 [e	tile - PROVIDED BY TENANT	F3
no base door schedule door Construction Fram								base
door Construction Fram						ı	6" rubber base PROVIDED BY TENANT	B1
				ule	sched	door	no base	B2
	9	uction Frame	Construc		door			
walls Room Name number Width Height Thickness Type Mater	ial Hardware Grou	e Material	kness Type	Height Thic	number Width	Room Name		walls

sales	001 [e]	3' - 0"	8' - 0"		alum	alum	existing remain	re-key and provide to tenant
sales	002	3' - 0"	8' - 0"		alum	alum	match existing	
stockroom	003	6' - 0"	7' - 0"	0' - 1 3/4"	mtl	hm	1 (pair)	
womens	004 [e]	3' - 0"	7' - 0"	0' - 1 3/4"	exist	hm	existing to remain	re-key and provide to tenant
mens	005 [e]	3' - 0"	7' - 0"	0' - 1 3/4"	exist	hm	existing to remain	re-key and provide to tenant
hallway	006 [e]	3' - 0"	7' - 0"	0' - 1 3/4"	exist	hm	existing to remain	
stockroom	007 [e]	3' - 0"	7' - 0"	0' - 1 3/4"	metal	hm	existing to remain	re-key and provide to tenant

Group	1			
1	Storeroom Function IC Cylinder	Falcon	B581 Dane	626 Dull Chrome
1	Kick Plate	Trimco	K0050	630 Stainless Steel
3	4.5 x 4.5 BB Hinges	McKinney		TA2714 Dull Chrome 26D
1	Wall Stop	Trimco	1270WX	630 Stainless Steel

6 wall penetration - pipe 3'' = 1'-0''

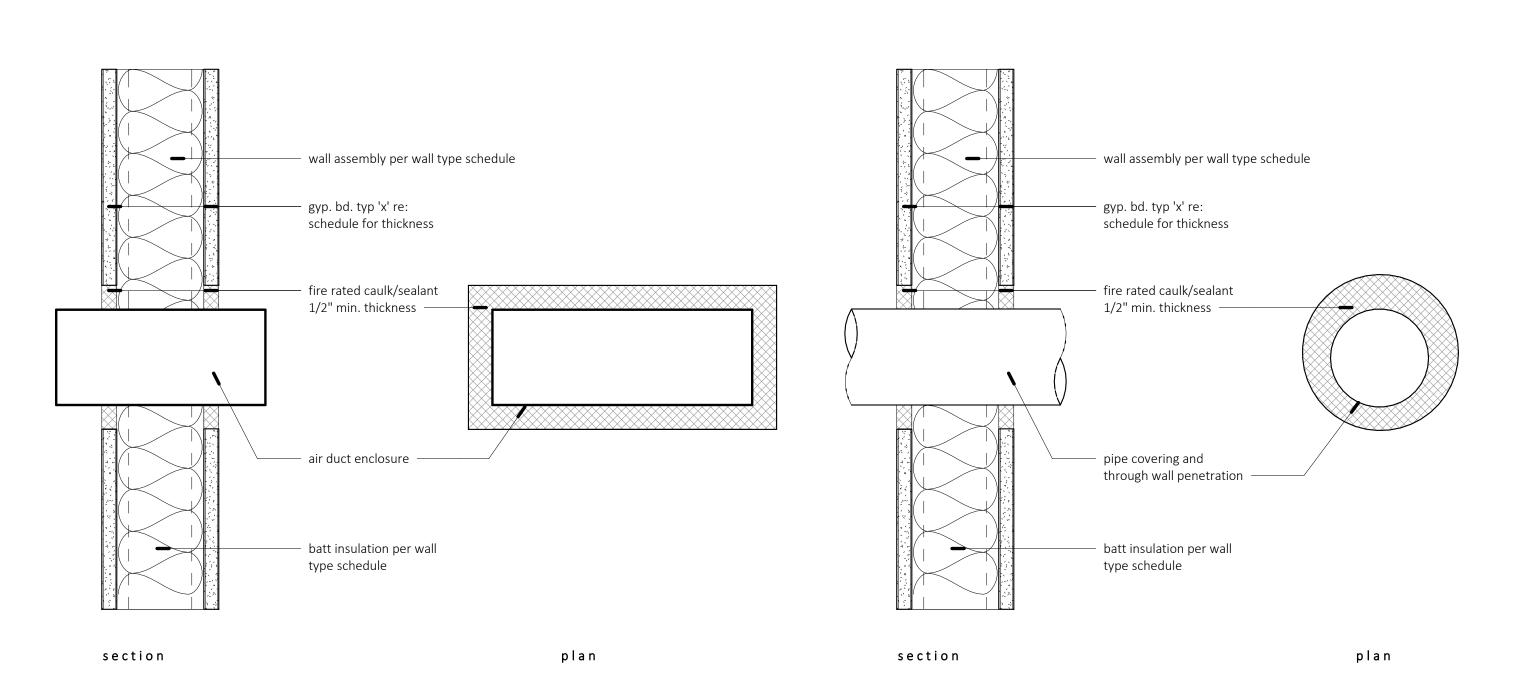

1740 white box

1740 NW Chipman Road Lee's Summit, MO 64081 DESCRIPTION


details - door schedules


SHEET DATE 01/05/2021 PROJECT PHASE Permit

ARCH PROJECT NO. a4.0

1 slip track detail

3 wall type standard

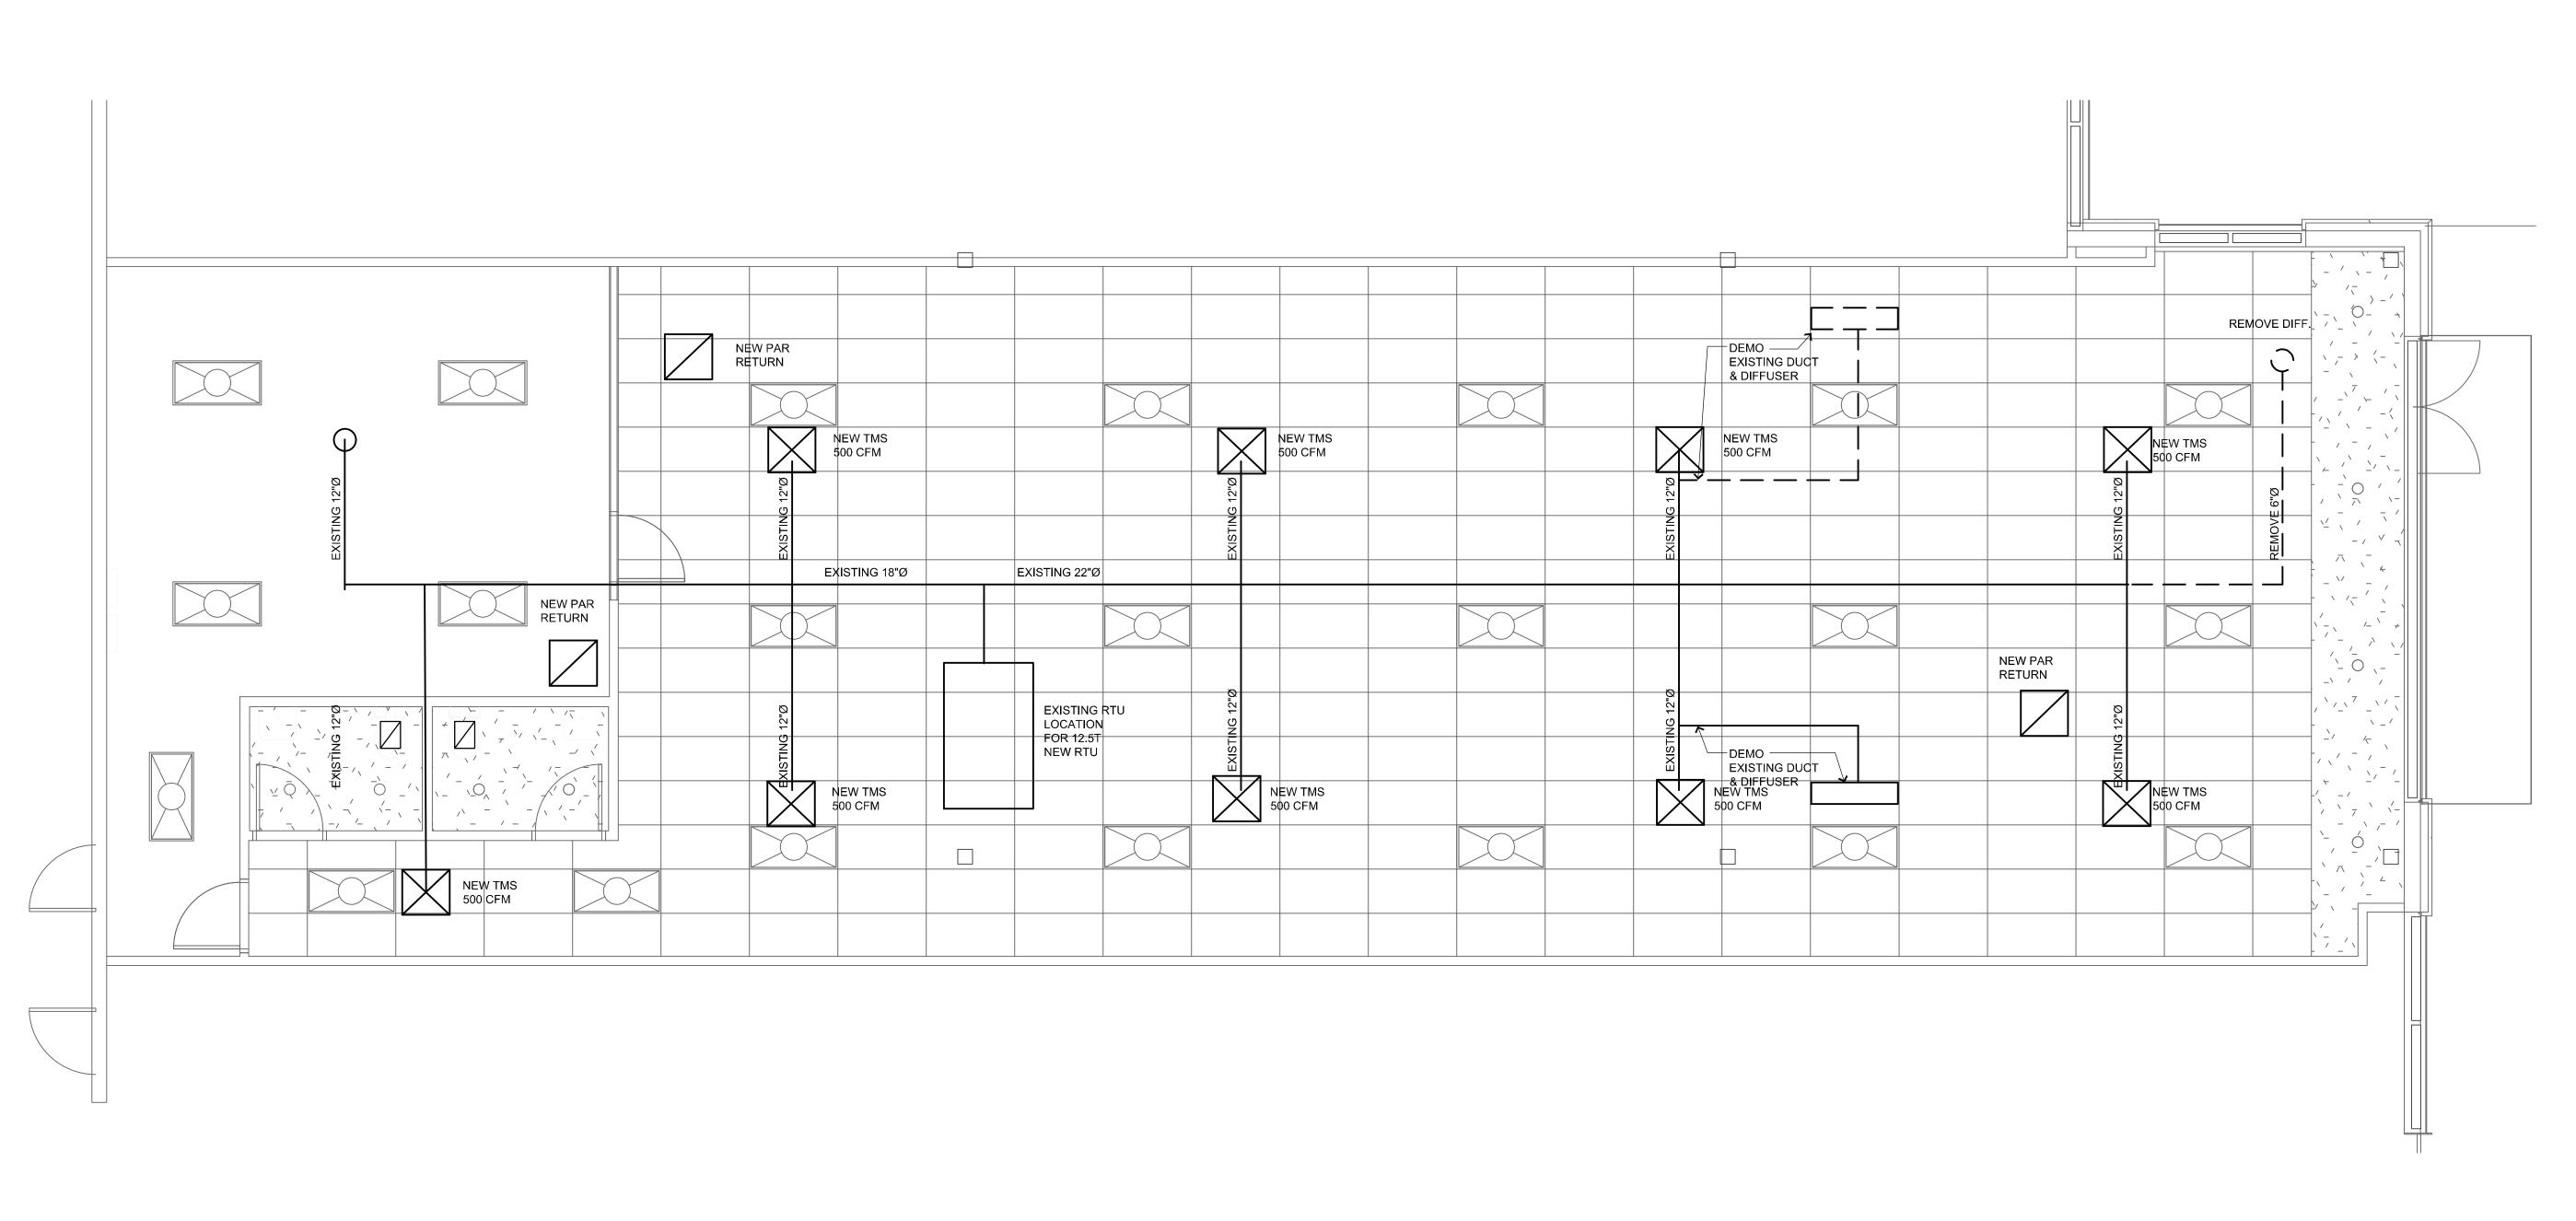

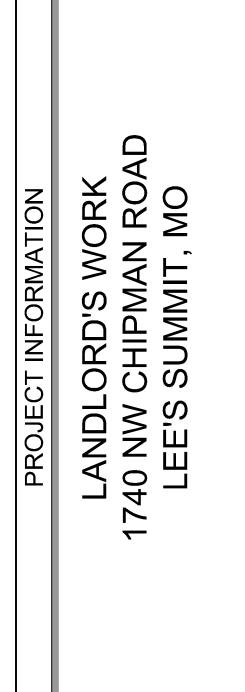

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DAT	E:	12/28/2020
DPA	\/\N RV:	RTM


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MECHANICAL

PLAN

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MECHANICAL NOTES

- 1. ALL WORK PER 2012 INTERNATIONAL MECHANICAL CODE.
 2. ALL CHANGES TO PLANS TO BE SUBMITTED IN WRITING AND
- 2. ALL CHANGES TO PLANS TO BE SUBMITTED IN WRITING AND APPROVED BY ENGINEER BEFORE IMPLEMENTING.

 3. DUCT SIZES SHOWN ARE ACTUAL SHEET METAL SIZES.
- DUCT SIZES SHOWN ARE ACTUAL SHEET METAL SIZES.
 COORDINATE ALL WORK WITH OTHER TRADES AND EXISTING CONDITIONS AS REQUIRED TO PROPERLY INSTALL ALL SYSTEMS AS INTENDED, WITHIN THE CONFINES OF THE SPACES AVAILABLE
- 5. VERIFY CLEARANCES IN ALL AREAS.
- LOCATE DIFFUSERS AS SHOWN, COORDINATE WITH LIGHTING, AND OTHER DEVICES. REF ARCH PLANS FOR EXACT LOCATION OF LIGHTING AND OBSTRUCTIONS.
- 7. ALL SUPPLY DUCTWORK TO BE EITHER RECTANGULAR OR SPIRAL WOUND SHEET METAL CONSTRUCTED TO LOW
- PRESSURE STANDARDS.

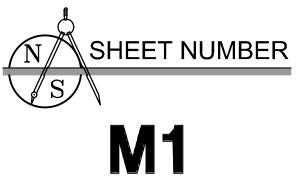 8. DUCT INSTALLATION TO BE AS HIGH AS POSSIBLE IN
- ACCORDANCE WITH SMACNA STANDARDS.

 9. FLEX DUCT SHALL BE UL CLASS 1 AIR DUCT SUITABLE FOR MEDIUM PRESSURE WITH 1/2" FIBERGLASS INSULATION W/ ADJ. 6' MAX LENGTH AND ONLY INSTALLED ON THE DAMPERS WITH CEILING TILE INSTALLED.
- 10. ALL CONTROLS TO BE MANUFACTURED STANDARD DEVICES ELECTRIC/ELECTRONIC. ALL CONTROL WIRING BY ELECTRICAL
- CONTRACTOR. MATCH EXISTING AS MUCH AS POSSIBLE.

 11. TEST & BALANCE PER NEBB STANDARDS, WITH ALL DAMPERS PROPERLY ADJUSTED. ADJUST SYSTEM TO OPERATE IN A PROPERLY COORDINATED MANNER PER MANUFACTURES INSTRUCTIONS.
- 12. DUCT RUN-OUT SIZES NOT SHOWN TO BE THE SAME SIZE AS DIFFUSER NECK SIZE.
- 13. GENERALLY, REUSE EXISTING SUPPLY DUCTS . DAMPER SELECTION TO HAVE NO GREATER THAN NC RATING OR 25. ADJUST SYSTEM TO OPERATE IN A PROPERLY COORDINATED MANNER PER MANUFACTURES INSTRUCTIONS.

REQUIRED AIR FLOWS FROM IMC								
BASIS	SF	SUPPLY	CFM					
ASSUME 15 PEOPLE OF OCC. SPACE 1000 S.F.	2279	7.5CFM/PER	256					
NET OCCUP. AREA	2279	.06 CFM/SF	136					
RESTROOMS		75 CFM EA.	150					
TOTAL REQUIRED O.A.			542					
SUPPLIED BY HVAC			542					


OUTSIDE AIR CALCULATIONS								
UNIT	SUPPLY	RA	OA	EXHAUST	SERVING			
RTU	4500	4018	482		SALES			
	500	440	60		STORAGE			
RR EX FANS				-150	RESTROOMS			
TOTALS	5000	4458	542	-150				
				392 CFM	POSITIVE PRESSURE			


SI	SINGLE PACKAGE AIR CONDITIONING UNIT SCHEDULE									
MARK	MANUF	MODEL NO	TYPE	TOTAL kBTUH	SENSIBLE kBTUH	CFM	HEAT kBTU	FRSH AIR CFM		
UNIT A	UNIT A T.B.D. 12.5-TON UNIT RTU 150 120 5000 255 486									
	1. M.C TO ADJUST RTU FOR PERFORMANCE REQUIRED PER SCHEDULE. 2. M.C. TO RESTRICT OA TO SCHEDULE LISTING.									


EXHAUST FAN SCHEDULE									
MARK NO.									
EF-1,2,	MENIO AND MOMENTO								
	1. FAN EF-1,2 IS TO BE CONTROLLED BY OCCUPANCY SENSOR WITH 15 MINUTE TIME LAG.								

DAMPER AND DIFFUSER SCHEDULE										
MARK NO.	MODEL	MODEL NECK MODULE BORDER CFM								
А	TITUS TMS	12"	24"X24"	3	500 (PER PLAN)					
В	TITUS PAR	22"x22"	24"X24"	3	2009- 440 PLENUM RETURN					

- 1. ALL DIFFUSERS, GRILLS AND EXHAUST SHALL HAVE STANDARD WHITE FINISH AND BE INSULATED.
- M.C. SHALL RE-USE EXISTING DUCTS AND EXHAUST AS MUCH AS POSSIBLE.
 DIFFUSERS IN PLASTER CEILINGS SHALL HAVE PLASTER RING.
- 4. ALL SUPPLY DIFFUSERS SHALL BE EQUIPPED WITH BALANCING DAMPERS.

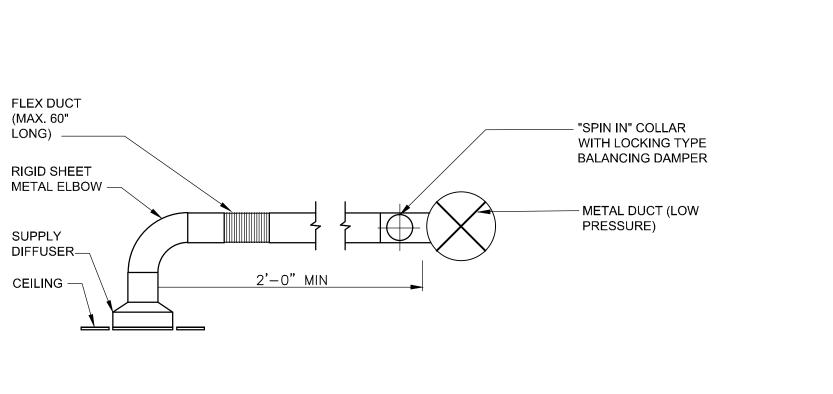


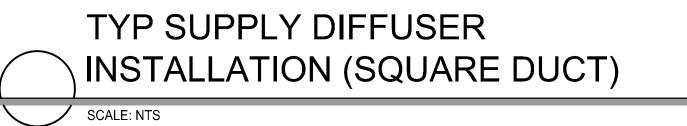

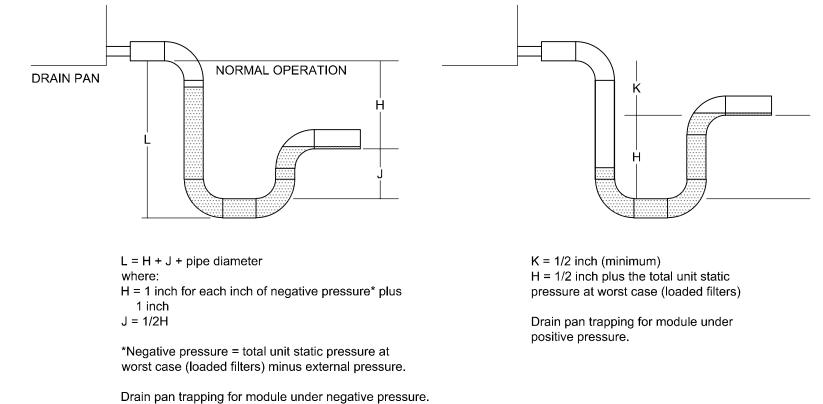



FLOOR DRAIN

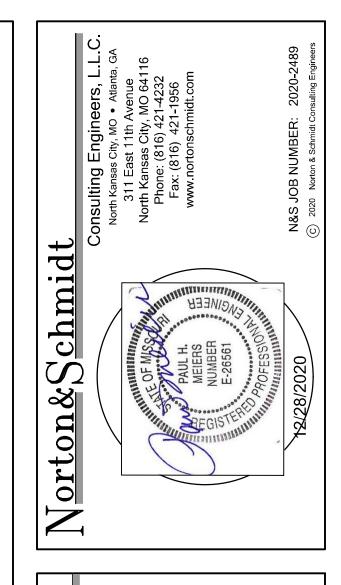

LANDLORD'S WORK
1740 NW CHIPMAN ROAD
LEE'S SUMMIT, MO

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RTM

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CHECKED BY:
ISSUED FOR:


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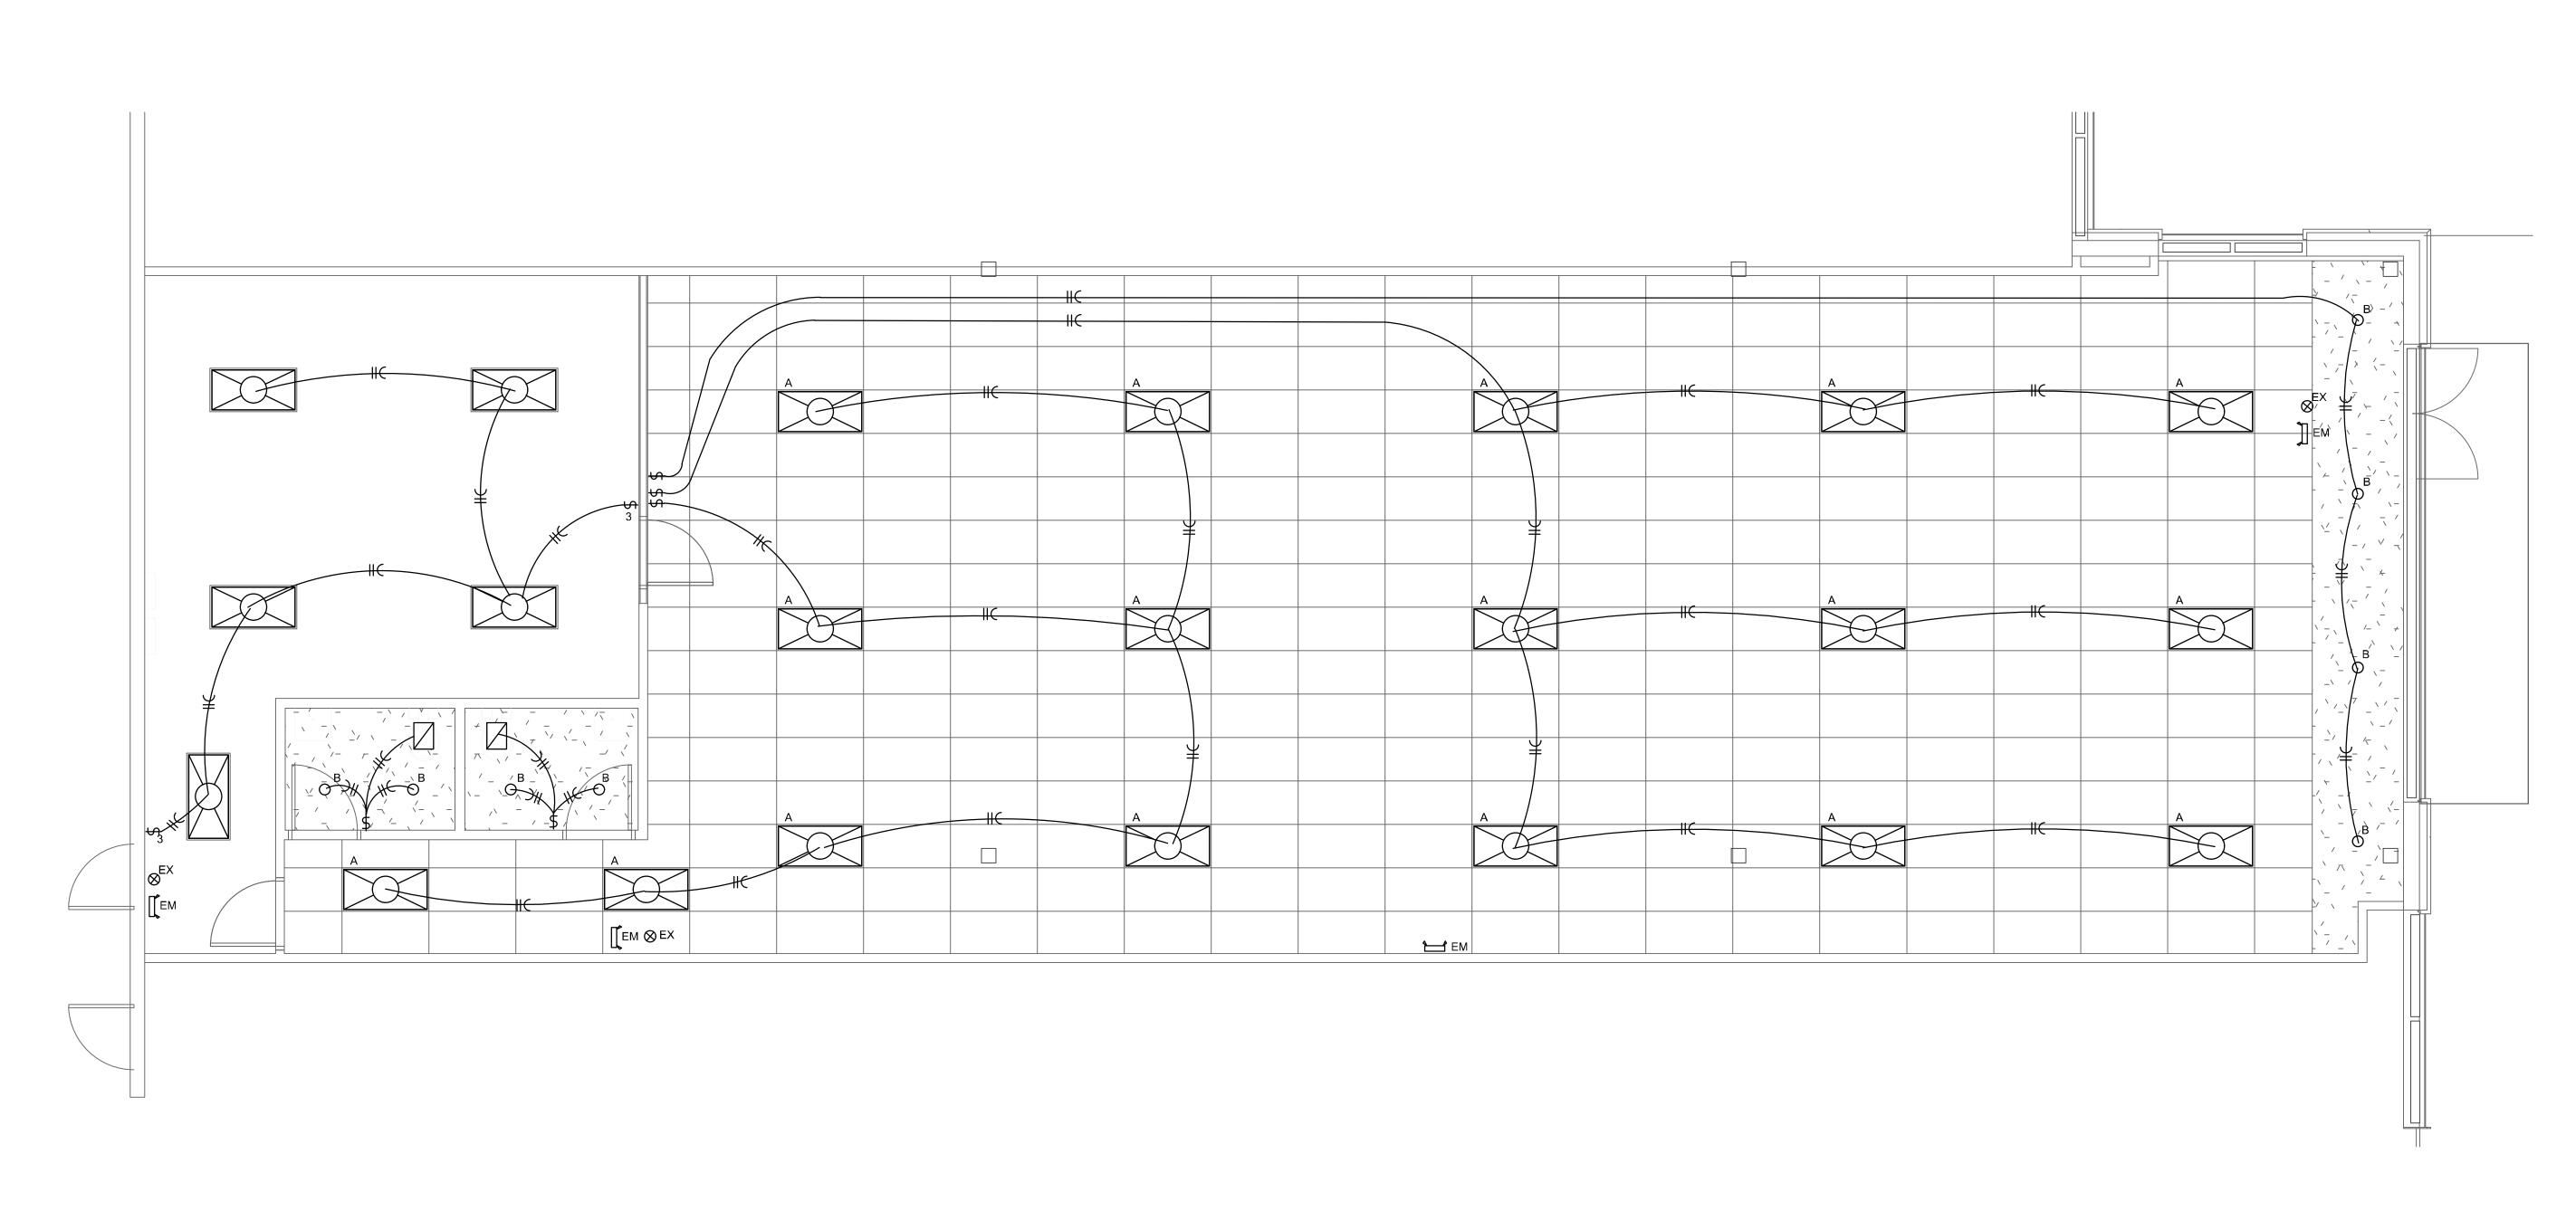
REVIEW


MECHANICAL NOTES & SCHEDULES



M2



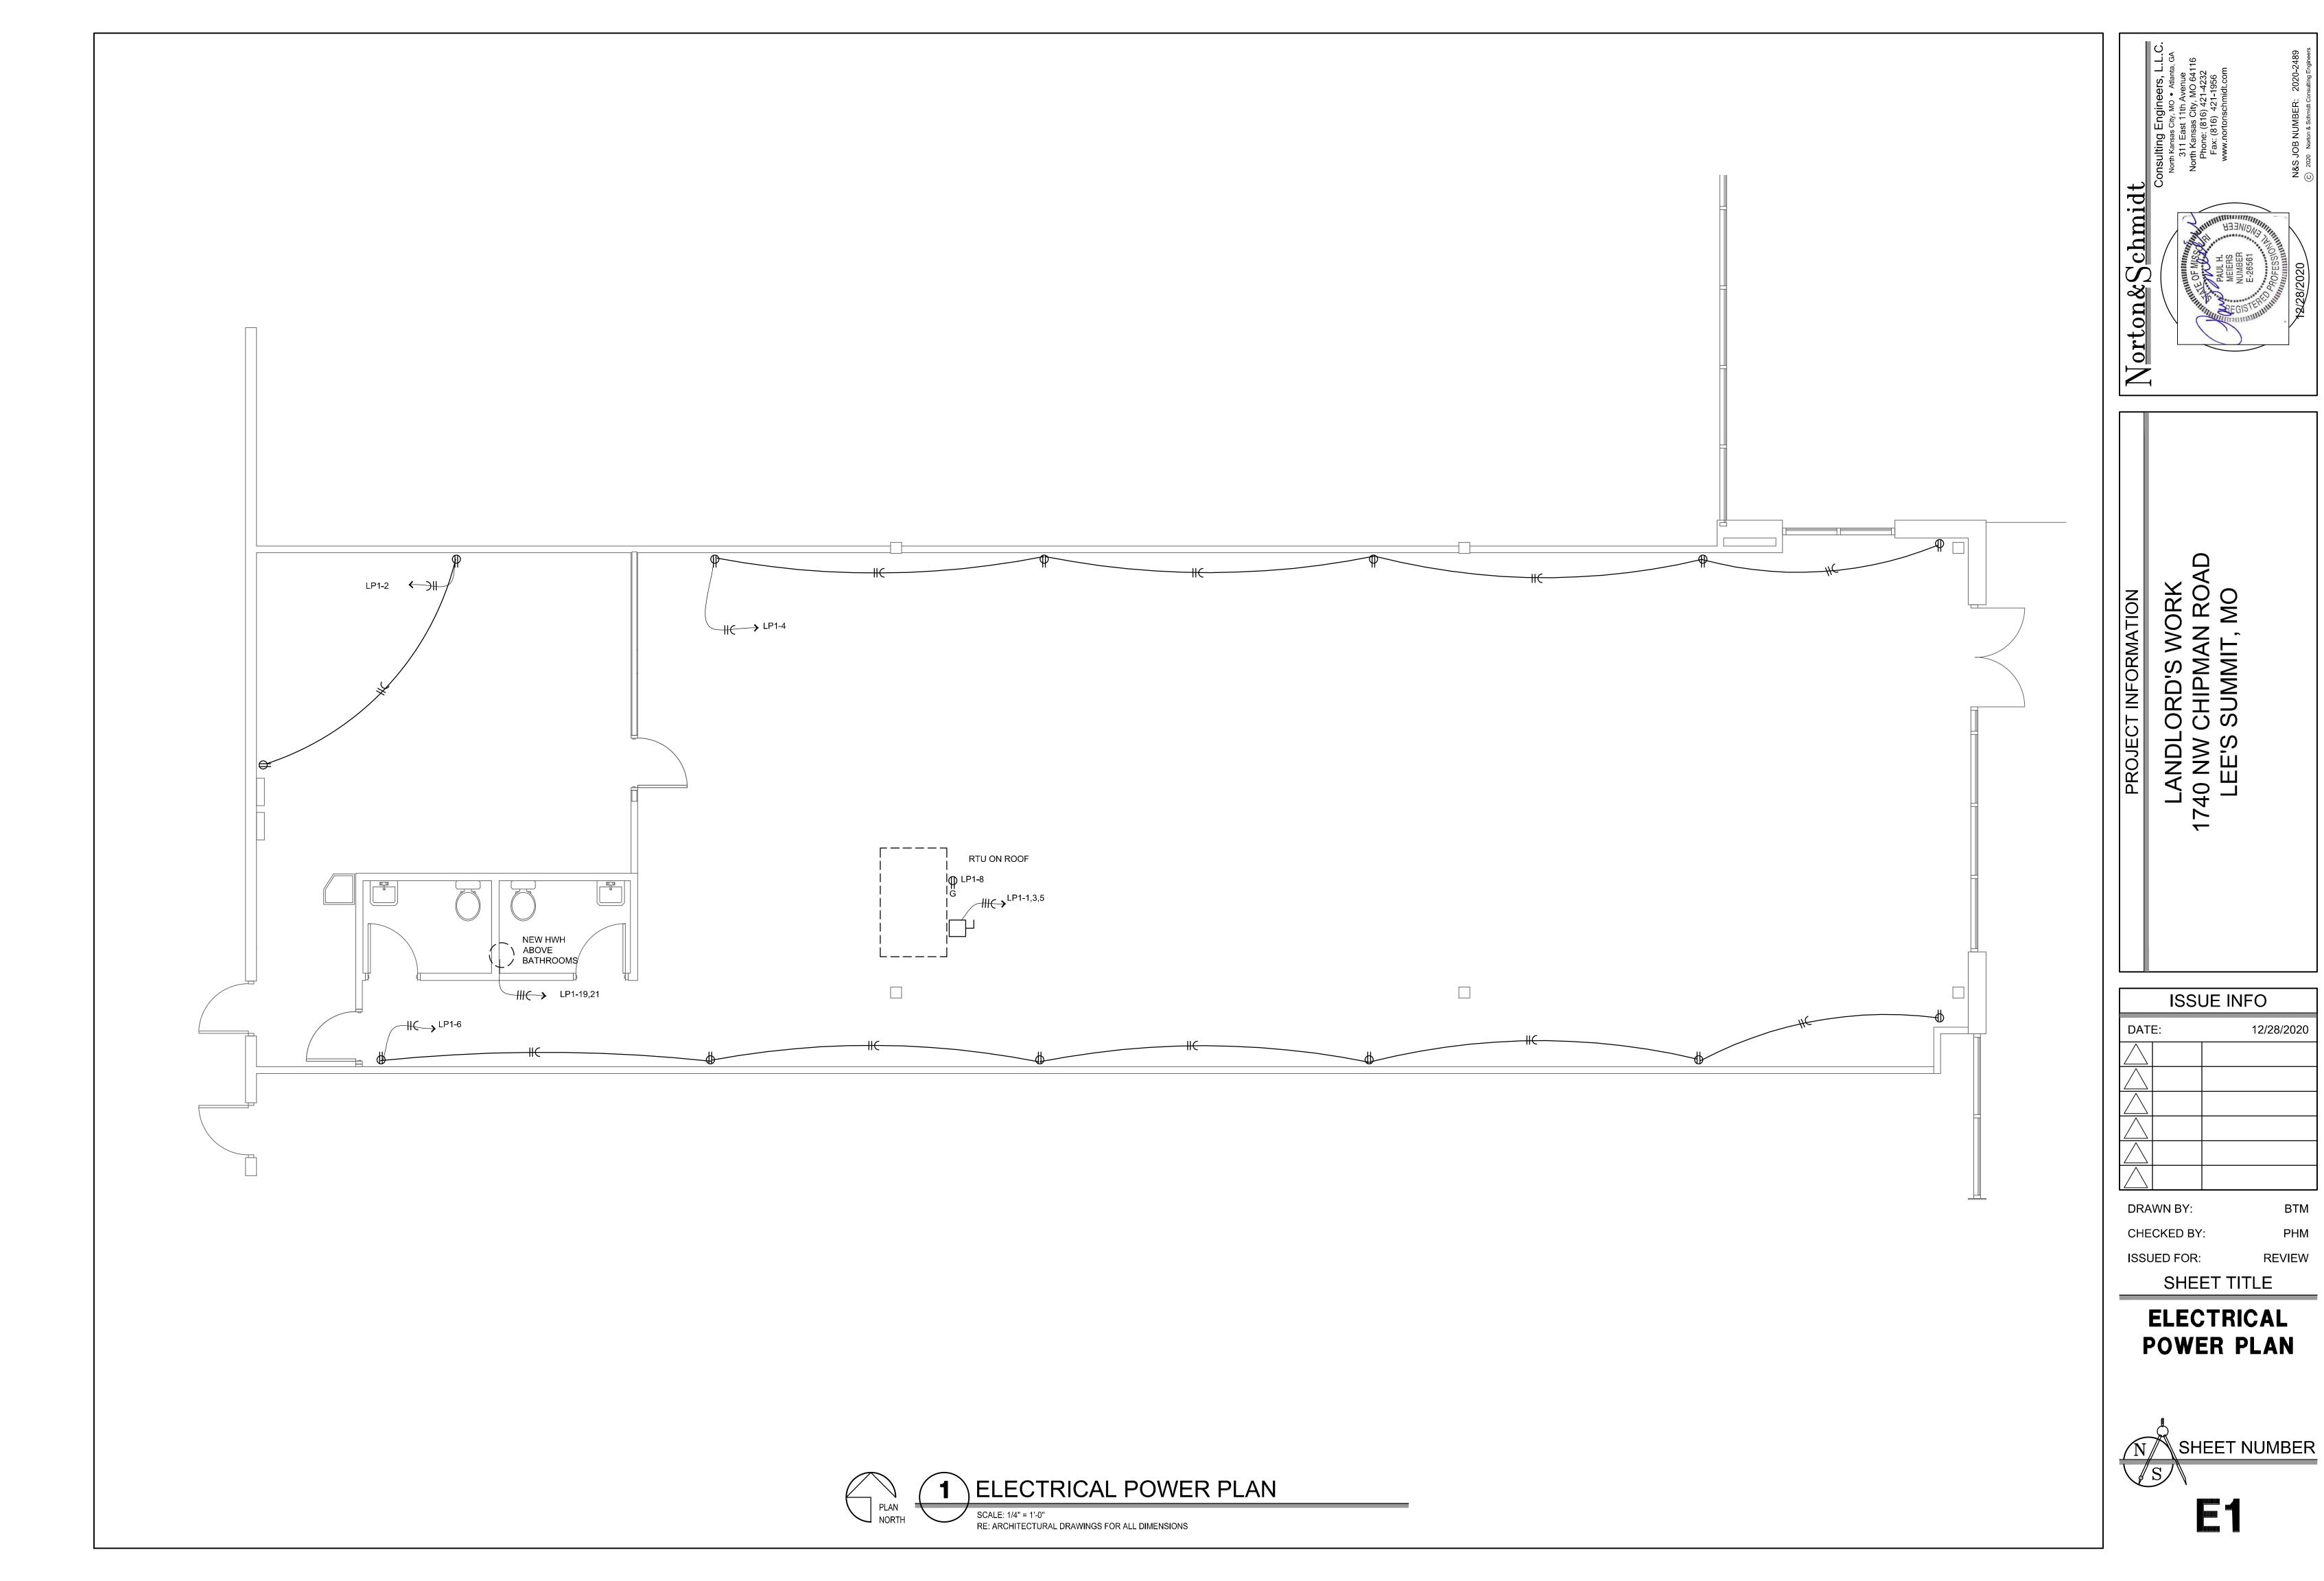

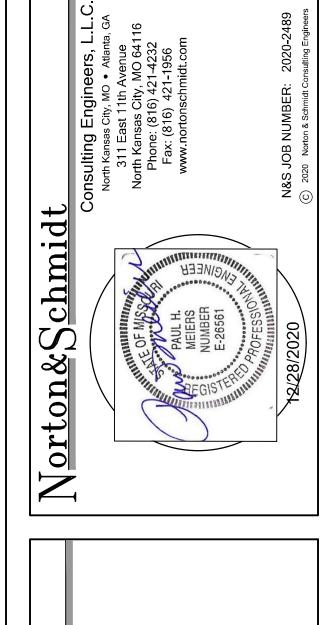

LANDLORD'S WORK
1740 NW CHIPMAN ROAD
LEE'S SUMMIT, MO


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DAT	E:		12/28/2020
DRA	WN BY:		BTM

DRAWN BY:

CHECKED BY: ISSUED FOR:

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ELECTRICAL LIGHTING PLAN

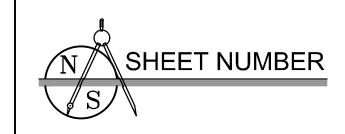

SCALE: 1/4" = 1'-0"
RE: ARCHITECTURAL DRAWINGS FOR ALL DIMENSIONS

ELECTRICAL PLAN NOTES

- 1. USE EXISTING PANEL BOARDS AND CIRCUITS AS MUCH AS POSSIBLE. COORDINATE WITH
- 2. ALL ELECTRICAL WORK TO BE IN ACCORDANCE WITH THE 2017 NATIONAL ELECTRICAL
- CODE.


 3. MINIMUM WIRE SIZE SHALL BE #12 COPPER WITH THHN INSL. WET LOCATIONS SHALL BE
- THWN. BRANCH CIRCUITS SHALL BE WITH 3-M SCOTCHLOK OR T&B "STA-KON" OR EQUAL.

 4. ALL OUTLET AND JUNCTION BOXES SHALL BE STEEL WITH ACCESSORIES AS REQUIRED.


 5. 120V RECEPTACLES SHALL BE HEAVY DUTY 20 AMP, 125 VOLT, DUPLEX NEMA 2-20R, COLOR
- 120V RECEPTACLES SHALL BE HEAVY DUTY 20 AMP, 125 VOLT, DUPLEX NEMA 2-2OR, COLOF WHITE.
 PROVIDE AND INSTALL INSULATED GROUND COPPER GROUND WIRES FOR EACH BRANCH
- CIRCUIT AND FOR GROUNDING EQUIPMENT AS PER NEC.
 7. SWITCHES SHALL BE HEAVY DUTY, 20 AMP, 125 VOLT, COLOR WHITE.
- GENERAL LIGHT LAYOUT IS INDICATED.
 EXIT LIGHTS AND EMERGENCY LIGHTS TO BE ROUTED UN-SWITCHED IN SAME CIRCUIT AS ADJACENT LIGHTS AND UN-SWITCHED TO PANEL, MOUNT EXIT LIGHTS AT CEILING AND
- 10. ELECTRICAL CONTRACTOR SHALL PROVIDE CONTROL WIRING BETWEEN THE EXHAUST FANS AND THEIR RESPECTIVE SWITCHES AND THERMOSTATS.
- 11. WIRING METHODS TO INCLUDE EFFECTIVE GROUND FAULT PATH WITH METALLIC ARMOR OR
- 12. FIRE ALARM STROBE LIGHTS SHALL COMPLY WITH NFPA 72-10.


	LUMINARIES SCHEDULE							
Fixture Mount Type Description Manufacturer / Model Size Finish Wattage/ Voltage Lai								
А	LAYIN	2x4 TROFFER	LIGHTOLIER: 2BLT 2x4 BLBA 30L 3000 ADP 120-LP830	LED	WHITE	23/120	LED	
В	CAN LIGHT		6" LED	LED	WHITE	13/120	LED	
EX	Wall/celing @ 7'-6" aff	LED EXIT	Exitronix/ VEX-U-BP-WB-WH-	7.5"X12.75"	WHITE	3.6W/120V	RED LED	
EM	Wall/celing @ 7'-6" aff	EMER.	Exitronix/ LED-90 R		WHITE	2.2W/120V	LED	

ELECTRICAL RISER NOTES

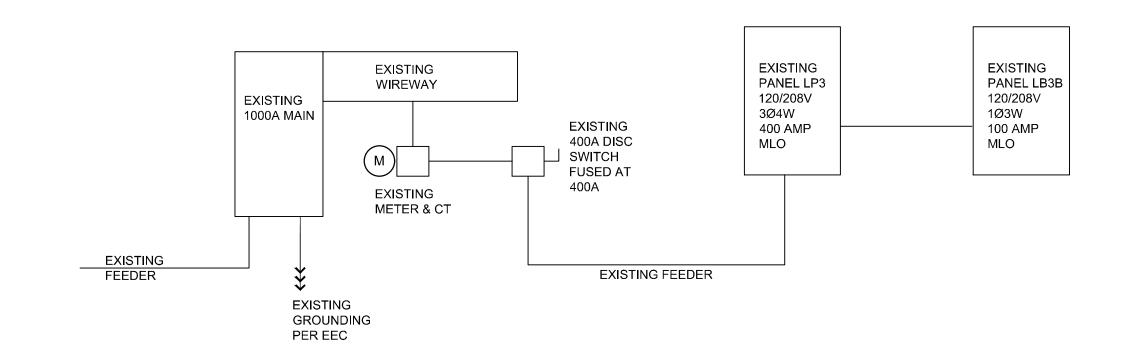

DESCRIPTION	kVA	/phase		_ WIRE	BKR	DOLES	CKT	CKT	POLES	BKR	WIRE	kV	4/phase		DESCRIPTION
DESCRIPTION	А	В	С	SIZE	AMPS	POLES	NR.	NR.	POLES	AMPS	SIZE	Α	В	С	DESCRIPTION
RTU	7.4			6	70	3	1	2	1	20	12	1.9			OUTLETS
RTU		7.4				3	3	4	1	20	12		1.9		OUTLETS
RTU			7.4			3	5	6	1	20	12			1.9	OUTLETS
IGHTS	1.5			12	20	1	7	8	1	20	12	1.9			ROOF OUTLET
IGHTS		1.5		12	20	1	9	10							
IGHTS			1.5	12	20	1	11	12							
EXHAUST FAN	0.83			12	20	1	13	14							
EXHAUST FAN		0.83		12	20	1	15	16							
MERGENCY LITS, EXTS.			1.2	12	20	1	17	18							
ELEC HWH	2.2			10	30	2	19	20							
ELEC HWH		2.2		10	30	2	21	22							
							23	24							
							25	26							
							27	28							
							29	30							
							31	32							
							33	34							
							35	36							
							37	38							
							39	40							
							41	42							
SUBTOTAL										PANEL 22	2,000 AIC	3.8	1.9	1.9	SUBTOTAL

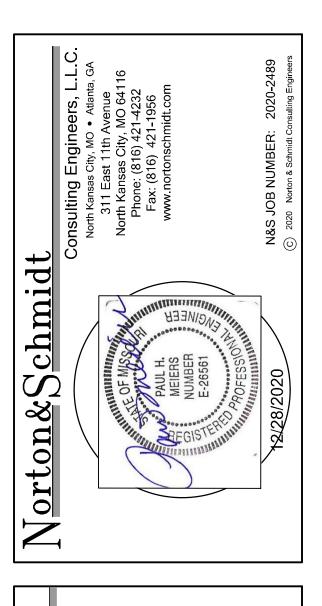

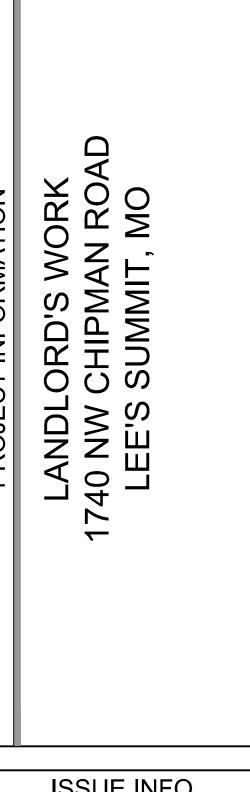

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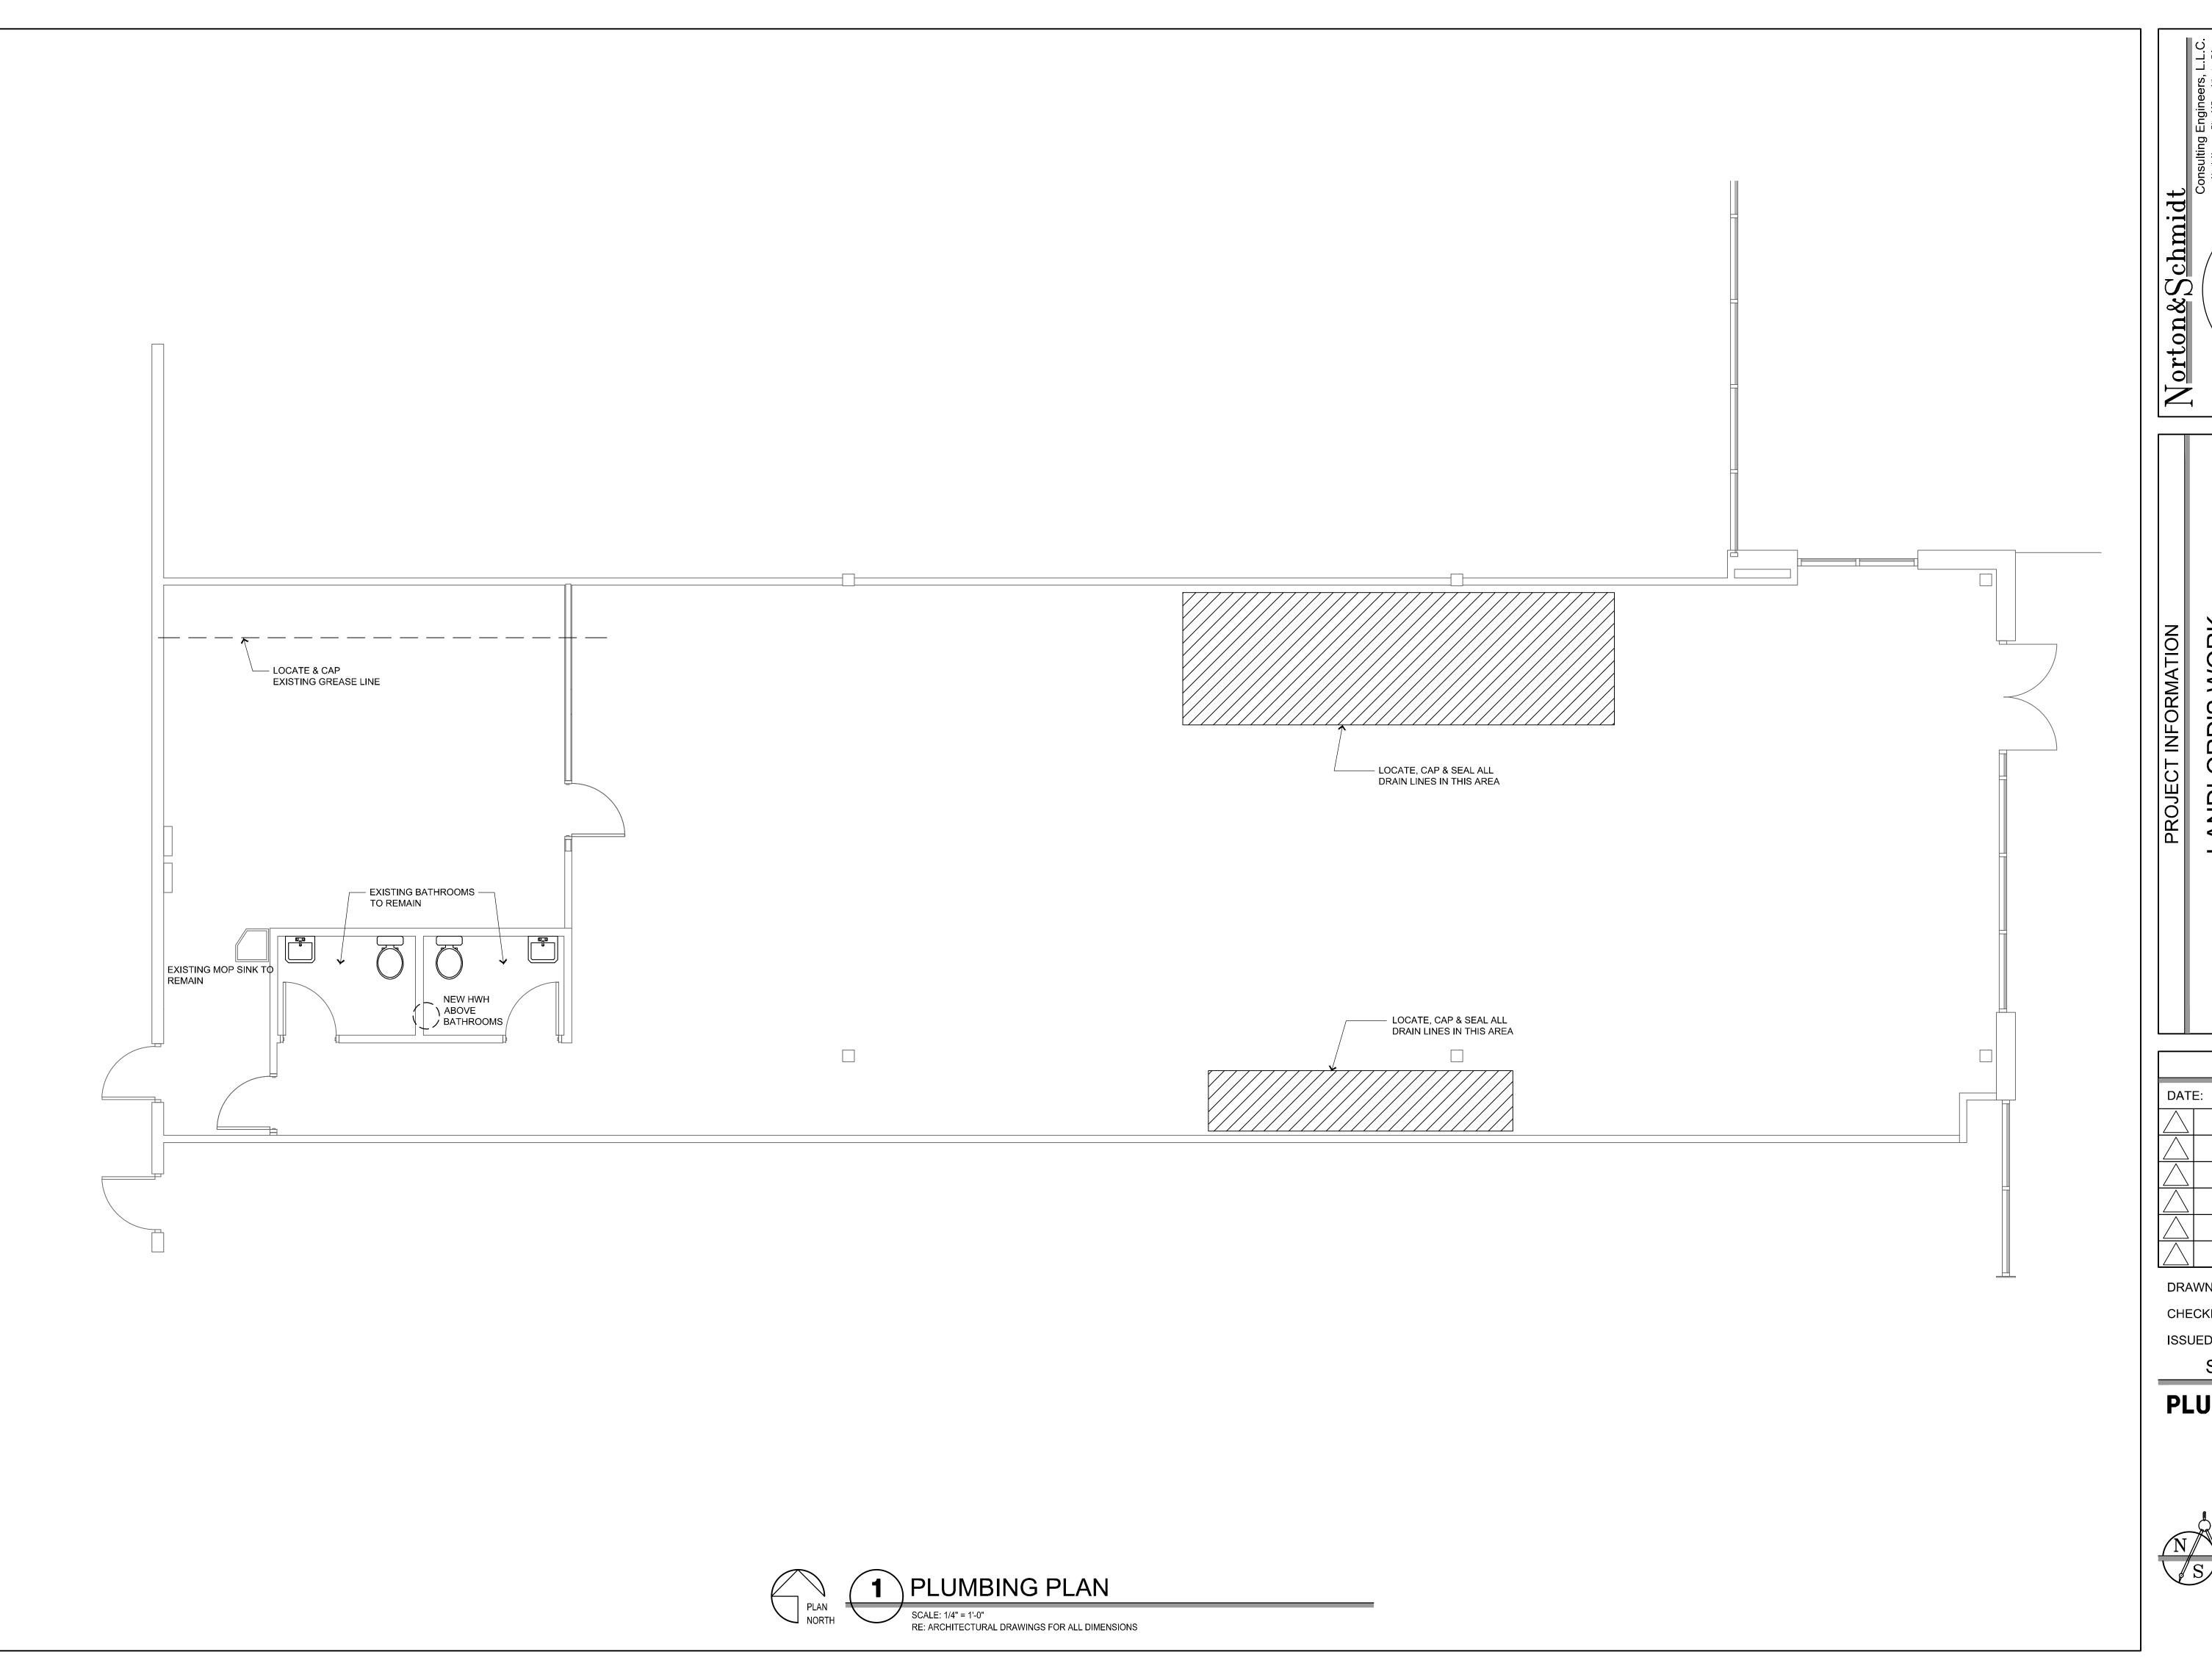
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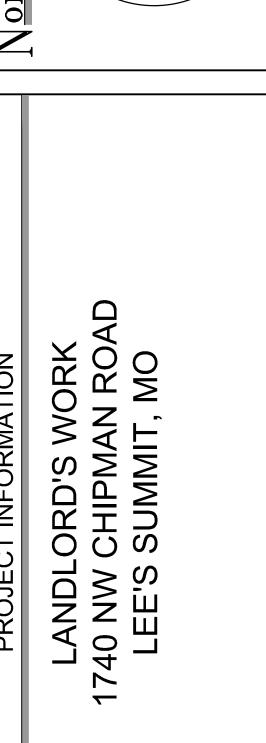
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ELECTRICAL NOTES & SCHEDULES







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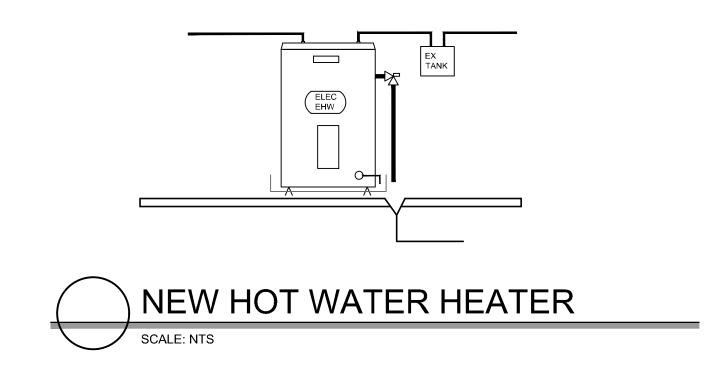
PLUMBING PLAN




PLUMBING NOTES


- 1. COORDINATE WITH ALL OTHER TRADES.
- 2. ALL PIPING TO BE INSTALLED PER THE 2018 INTERNATIONAL PLUMBING CODE.
- PROVIDE STOPS AT ALL PLUMBING CONNECTIONS UNLESS TENANT FURNISHED EQUIPMENT IS SO EQUIPPED WITH INTEGRAL STOPS.
- 4. PROVIDE "P" TRAPS AND CLEANOUTS FOR ALL NEW SINKS, FLOOR DRAINS, FLOOR SINKS, AND LAVATORIES
- 5. ALL NEW SEWER PIPE SHALL MATCH EXISTING SEWER SERVICE, USE ONLY "WYE"
- 6. PROVIDE ALL PIPING CONNECTIONS AS SHOWN ON THE PLANS. VENT LINES IN PLENUM TO BE RATED FOR CODE STIPULATED SMOKE AND FLAME SPREAD. MANUFACTURED IN ACCORDANCE WITH ASTM-F442-89. TYPICAL OF PVC FIRE SPRINKLER PIPE..
- 7. CONNECT TO EXISTING VENT LINE LOCATIONS AND SUPPORT AT 12'-0"OC MAX.
- 8. CONTRACTOR TO FIELD VERIFY ALL EXISTING DRAINS AND ELEVATIONS.
- 9. INSTALL TENANT FURNISHED EQUIPMENT PER MANUFACTURES INSTRUCTIONS.


	PLUMBING	SCHE	DULE		
		DRAIN	VENT	COLD	HOT
SAN S.	PVC DWV OR MATCH EXISTING PLENUM RATED VENT PIPING	1-1/2" - 3"	1-1/2" - 3"		
WATER SERVICE EXISTING	COPPER			1/2" - 3/4"	1/2" - 3/4"
GATE VALVE	A-106 GR. A SCH. 40	6"			
BFP	PRZ 1-1/2" EXISTING				



	PLUMBING SCHEDULE									
-	DRAIN VENT COLD HOT									
wc	WATER CLOSET - FLUSH TANK TYPE-ADA EXISTING	3"	2"	1-1/4"		GERBER ULTRA FLUSH ADA W/ CLOSED SEAT				
LAV-1	WALL MOUNT LAV TYPE-ADA EXISTING	1-1/2"	1-1/2"	1/2"	1/2"	GERBER 19x17 WALL MOUNT LAV FAUCET: MOEN 8430 4" FAUCET				
FD	FLOOR DRAIN EXISTING	2"								
WCO	WALL CLEAN OUT. EXISTING	3-1/2"								
EWH	NEW ELECTRIC HOT WATER HEATER			3/4"	3/4"	NEW 10 GAL ELEC HWH WITH, EXPANSION TANK, THERMOSTATIC CONTROL VALVE. LOCATE ABOVE RR'S. REMOVE 100 GAL HWH AND CAP GAS PIPE.				
MS	MOP SINK WITH FAUCET. EXISTING	2"	1-1/2"	1/2"	1/2"	FIAT MSB-24 24X24X10 MOLDED STONE WITH SS CURB CAPS AND WALL BUARD, #302 COMBINATION DOME STRAINER AND LINT BASKET COLOR #219 #830-AA CHROME PLATED SERVICE FAUCET WITH VACUUM BREAKER INTEGRAL STOPS WALL BRACE PAIL HOOK AND $\frac{3}{4}$ " HOSE THREAD ON SPOUT. WITH INTEGRAL RPZ.				

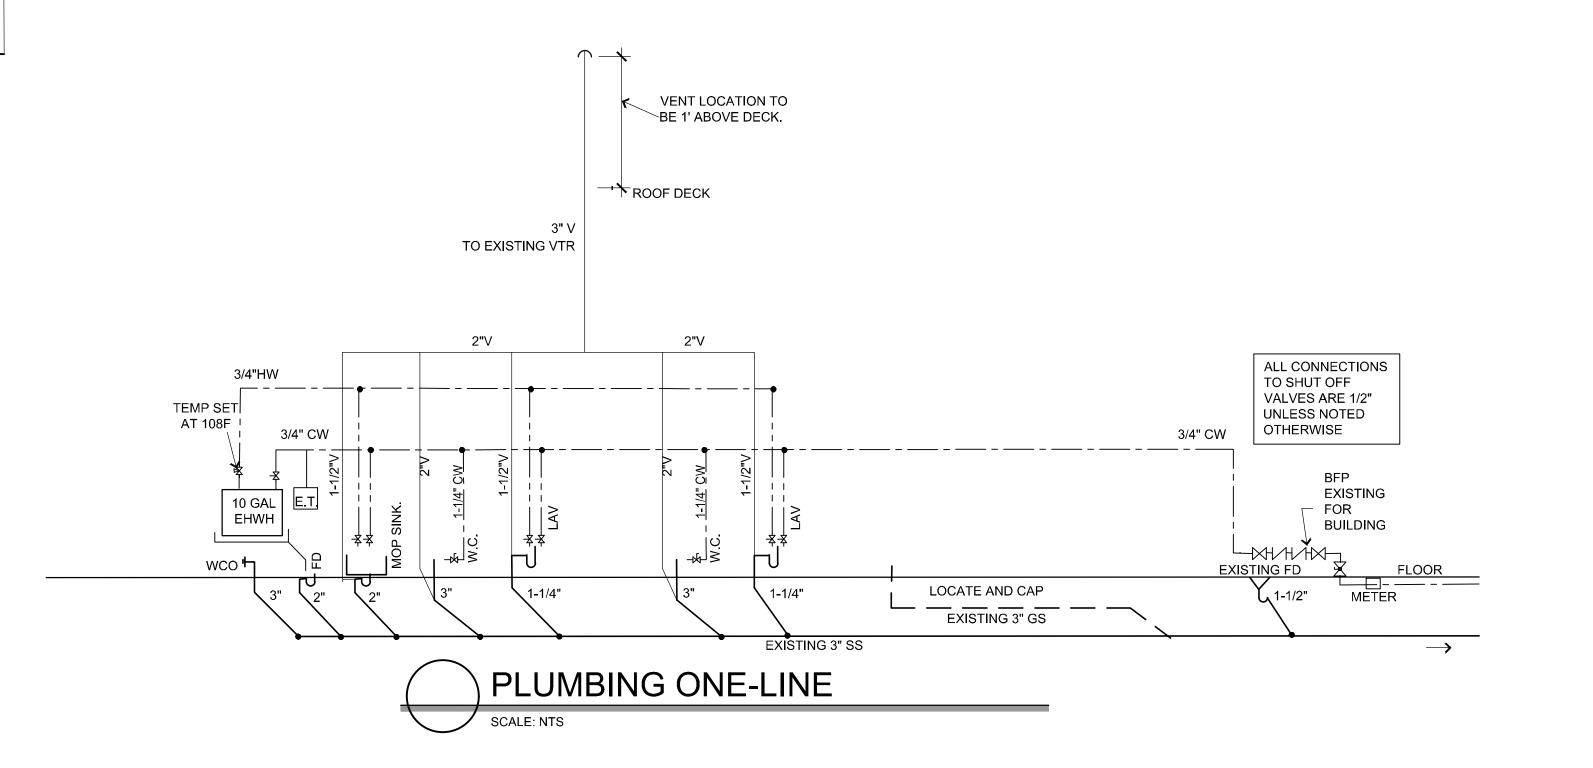

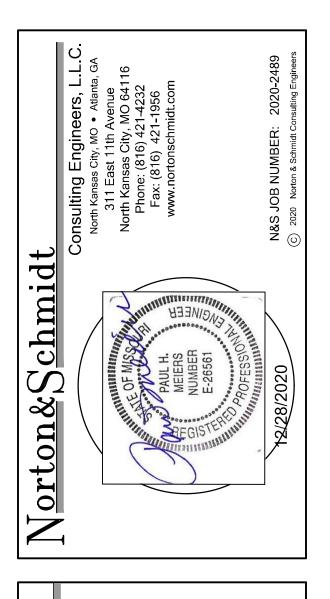

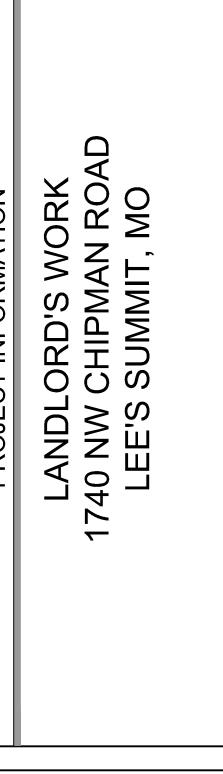

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PLUMBING NOTES & SCHEDULES



P2