PLUMBING, ELECTRICAL, MECHANICAL, AND REFRIGERATION CONTRACTORS SHALL VERIFY ALL CONNECTION AND ROUGH-IN REQUIREMENTS PRIOR TO ROUGH-IN OF SERVICES.

'PROVIDE' SHALL BE DEFINED AS 'TO FURNISH AND INSTALL' ITEM.

REFER TO DRAWING P4.0 FOR 'CROSS CONNECTION AND BACKFLOW PREVENTION' INFORMATION.

'OWNERS VENDOR' SHALL BE DEFINED AS HY-VEE CONSTRUCTION CO., HY-VEE EQUIPMENT PURCHASING, HY-VEE ENGINEERING, HY-VEE SETUP SUPERVISORS, OR APPROVED OTHERS.

FOR EQUIPMENT AND ITEMS FURNISHED BY 'OWNERS VENDOR' AND INSTALLED BY 'PC', 'EC', 'MC', AND 'RC', THE RESPECTIVE CONTRACTOR SHALL RECEIVE, STORE AND PROTECT, SET IN PLACE, ASSEMBLE, AND MAKE FINAL CONNECTIONS

SINKS AND FAUCETS PROVIDED BY HY-VEE ARE PROVIDED WITH HY-VEE SUPPLIED MIXING VALVES. SINKS AND FAUCETS NOT PROVIDED BY HY-VEE SHALL HAVE PLUMBING CONTRACTOR SUPPLIED MIXING VALVES. WHERE REQUIRED.

TO FIXTURE OR EQUIPMENT ITEM INCLUDING PROVIDING BACKING FOR WALL SUPPORTED ITEMS AND CAULKING AND FINAL CLEANING OF ITEM. PROVIDE ALL ROUGH-IN MATERIALS NECESSARY FOR A COMPLETE INSTALLATION.

PLUMBING FIXTURES AND SPECIALTIES (PLUMBING FIXTURES ARE WHITE IN COLOR UNLESS OTHERWISE INDICATED. EQUAL FIXTURES BY KOHLER. CRANE. ZURN. AND ELJER WILL BE APPROVED. SUBSTITUTIONS FOR FLUSH VALVES AND OTHER FIXTURES WILL NOT BE CONSIDERED. WC WATER CLOSET - KOHLER KINGSTON SERIES WALL MOUNTED WATER CLOSET, SLOAN ECOS BATTERY OPERATED CARRIER TO FIT IN 12" WALL FOR SINGLE FIXTURES AND 18" WALL WITH BACK TO BACK FIXTURES. HWC HANDICAP WATER CLOSET - KOHLER KINGSTON SERIES WALL MOUNTED WATER CLOSET INSTALLED AT ADA WC2 WATER CLOSET - KOHLER HIGHLINE SERIES FLOOR MOUNTED WATER CLOSET. SLOAN ECOS BATTERY OPERATED FLUSH VALVE DESIGNED TO FLUSH WITH 1.28 GPF, AND BENEKE #523 SEAT. HWC2 HANDICAP WATER CLOSET - KOHLER HIGHLINE SERIES ADA HEIGHT FLOOR MOUNTED WATER CLOSET. SLOAN ECOS BATTERY OPERATED FLUSH VALVE DESIGNED TO FLUSH WITH 1.28 GPF, AND BENEKE #523 SEAT. UR URINAL - KOHLER BARDON SERIES URINAL, SLOAN HEU SYSTEMS BATTERY OPERATED FLUSH VALVE DESIGNED TO FLUSH WITH ONE PINT OF WATER. PROVIDE SMITH CARRIER. HUR HANDICAP URINAL - KOHLER BARDON SERIES URINAL INSTALLED AT ADA HEIGHT, SLOAN HEU SYSTEMS BATTERY OPERATED FLUSH VALVE DESIGNED TO FLUSH WITH ONE PINT OF WATER. PROVIDE SMITH CARRIER. L-1 LAVATORY - KOHLER K-1728 CHESAPEAKE 19x17 WALL MOUNT LAVATORY, SLOAN #EBF854BDM .5 GPM OPTIMA COMPLIANCE WHERE APPLICABLE. MOUNT WITH RIM @ +31" AFF. L-3A LAVATORY - STARON MODEL A3211 INTEGRAL LAVATORY BOWL, PEARL COLOR, FURNISHED AND INSTALLED WITH VALVE, POP-UP DRAIN, TAILPIECE, TRAP, AND SUPPLIES WITH STOPS. L-3B HANDICAP LAVATORY/MOTHERS ROOM SINK - SAME AS L-3A BUT PROVIDE PIPE INSULATION AND JACKET FOR UNDERCOUNTER WASTE AND WATER PIPING. INSTALL IN ACCORDANCE WITH ADA CODE. (ALL EXPOSED SIDES), AND #65,600 MOP HANGER. JS2 JANITOR'S SINK - MUSTEE #63M 24"x24"x10" H. DURASTONE MOP SINK WITH #63.600A HOSE END SERVICE 1.5 GPM (ALL EXPOSED SIDES), AND #65.600 MOP HANGER. WATTS #600 OR EQUAL SPRING CHECK VALVES IN HW AND CW DROPS TO FAUCET. F1 FAUCET - T&S BRASS #B-673-RC HEAVY DUTY SERVICE SINK FAUCET, 4-1/2" TO WALL TO CENTER OF OUTLET, SIDE OF LAVATORY ROUGH-IN. FWH FREEZEPROOF WALL HYDRANT - JOSAM #71050 3/4" WALL HYDRANT, NON-REMOVABLE VACUUM BREAKER, KEY UNLESS NOTED OTHERWISE. HB1 HOSE BIBB - CHICAGO FAUCET 387 SERIES WITH CHROME FINISH, 3/4" INLET, 3/4" HOSE THREADED OUTLET, AND NON-REMOVABLE VACUUM BREAKER. MOUNT HOSE BIBBS 42" AFF UNLESS NOTED OTHERWISE. HB2 HOSE BIBB - SAME AS 'HB'. HB2 HOSE BIBBS TO BE INSTALLED ON TOP OF CASES FOR CASE WASHDOWN. SEE DRAWING P2.0. HB3 HOSE BIBB - WOODFORD MODEL RHY2 FREEZELESS ROOF HYDRANT, 3/4" MALE HOSE THREAD DUAL CHECK DRAIN, EPDM OR TPO ROOF BOOT. PIPE DRAIN TO NEARBY RECEPTOR. SH SHOWER UNIT - KOHLER MODEL K-12100-C 45"x37.25"x84" BARRIER FREE, WHITE, ADA SHOWER UNIT WITH BRUSHED, EXP EXPANSION TANK - (WH-1) AMTROL AST-30 ASME EXPANSION TANK WITH 55 PSIG PRECHARGE. 2 GPM AT 12' TDH, 120/1/60 VOLT MOTOR. HONEYWELL #L6006C STRAP-ON AQUASTAT CONTROLLER. INTERLOCK OF TIME SWITCH IN SERIES WITH THE AQUASTAT AND RECIRCULATION PUMP. WH-1 100 GALLON WATER HEATER AS MANUFACTURED BY AO SMITH. MODEL #BTH-199 'CYCLONE' 97% EXTRA HIGH EFFICIENCY TANK TYPE WATER HEATER, SEALED COMBUSTION DESIGN. 199,000 BTUH/HR. POWER VENT. 199,000 BTUH/HR. A.O. SMITH AND STATE ARE APPROVED EQUALS. SINGLE LAVATORIES, AND 1 COMPARTMENT SINKS. RATED AT 1650 WATTS, 120V-1PH, .98 ENERGY FACTOR. LOCATED AT BACKROOM JANITORS SINK. PROVIDE WITH MANUFACTURER'S WALL MOUNTING BRACKET AND INSTALL HIGH ON WALL WHERE APPLICABLE. SEE PLAN. WH-6 AO SMITH MODEL DEL30 30 GALLON ELECTRIC WATER HEATER, 208V, 3 PHASE. 3 KW INPUT. PROVIDE AMTROL WH-7 60 GALLON WATER HEATER AS MANUFACTURED BY AO SMITH. MODEL #BTH-120 'CYCLONE' 95% EXTRA HIGH EFFICIENCY TANK TYPE WATER HEATER, SEALED COMBUSTION DESIGN. 120,000 BTUH/HR. TWH TANKLESS WATER HEATER - (FURNISHED BY OWNER, INSTALLED BY PLUMBING CONTRACTOR). NAVIEN PREMIUM CONDENSING TANKLESS GAS WATER HEATER MODEL NPE-240A, 199,900 BTUH, 11.2 GPM. 120 VOLT. 2" PVC COMBUSTION AND EXHAUST VENT. PROVIDE ASME EXPANSION TANK. SV SOLENOID VALVE: NORMALLY OPEN SOLENOID VALVE WITH STAINLESS STEEL BODY. VALVE SHALL BE NSF LISTED FOR USE IN POTABLE WATER SYSTEMS. OPERATING TEMPERATURE OF 32 DEGREE F TO 120 DEGREE F. 120V 1P. PILOT LIGHT SWITCH BY THE E.C. EE-1 EMERGENCY EYE/FACE WASH - DECK MOUNTED, HANDLE ACTIVATED. TWIN PLASTIC SPRAY HEADS WITH CAPS AND

(WH-2) AMTROL AST-20 ASME EXPANSION TANK.

(TWH) AMTROL AST-5 ASME EXPANSION TANK.

(WH-6, WH-7) AMTROL AST-5 ASME EXPANSION TANK.

RETAINING CHAINS/STRAPS MOUNTED ON BRASS SUPPLY ARMS, MINIMUM FLOW RATE OF 3.0 GPM AT 30 PSI,

FCV F LOW CONTROL VALVE: FLOWDESIGN # ICSS "AUTOFLOW", SERIES 300 STAINLESS UNION BODY WITH NICKEL PLATED

POWERS ES OR EQUAL

REFERENCES:

PC PLUMBING CONTRACTOR

ELECTRICAL CONTRACTOR

MC MECHANICAL (HVAC) CONTRACTOR RC REFRIGERATION CONTRACTOR

INTEGRAL FLOW CONTROL FITTING. ANSI Z358.1 COMPLIANT. BRADLEY S19-460EFW OR EQUAL. PROVIDE WITH LEAD

FREE MIXING VALVE CAPABLE OF DELIVERING 3 GPM WITH 10 PSI DIFFERENTIAL. ASSE STANDARD 1071 COMPLIANT.

UNION NUT, STAINLESS STEEL PRESSURE COMPENSATING CARTRIDGE, MEETING NSF 61 ANNEX G, NAMEPLATE AND 1/2 VALVE BODY SIZE UNLESS SHOWN OTHERWISE ON PLANS. PROVIDE 0.5 GPM FLOW RATE CARTRIDGE UNLESS SHOWN

NOTE: NOT ALL PLUMBING FIXTURE LISTED ARE USED ON THIS PROJECT FLUSH VALVE DESIGNED TO FLUSH WITH 1.28 GPF, AND BENEKE #523 SEAT. PROVIDE WITH COMPATIBLE CARRIER. HEIGHT, SLOAN ECOS BATTERY OPERATED FLUSH VALVE DESIGNED TO FLUSH WITH 1.28 GPF, AND BENEKE #523 SEAT. PROVIDE WITH COMPATIBLE CARRIER. CARRIER TO FIT IN 12" WALL FOR SINGLE FIXTURES AND 18" WALL BATTERY OPERATED FAUCET WITH BELOW DECK MIXING VALVE, POP-UP DRAIN, TAILPIECE, TRAP, LAV CARRIER. AND SUPPLIES WITH STOPS. PROVIDE PIPE INSULATION FOR UNDERSINK WASTE AND WATER PIPING FOR ADA COUNTERTOP. PROVIDE SLOAN #EBF854BDM OPTIMA BATTERY OPERATED FAUCET WITH BELOW DECK MIXING APPROVAL BY THE ARCHITECT. LAVATORY OR SINK STANDARD HEIGHT ADA ACCESSIBLE CHILD HEIGHT JANITOR'S SINK - MUSTEE #65M 24"x36"x10" H. DURASTONE MOP SINK WITH #63,600A HOSE END SERVICE 1.5 GPM FAUCET WITH NON-REMOVABLE VACUUM BREAKER, #65.700 HOSE AND HOSE BRACKET. #63401 BUMPER GUARDS STANDARD HEIGHT ADA ACCESSIBLE CHILD HEIGHT WATER CLOSET FAUCET WITH NON-REMOVABLE VACUUM BREAKER, #65.700 HOSE AND HOSE BRACKET. #63401 BUMPER GUARDS STANDARD HEIGHT ADA ACCESSIBLE CHILD HEIGHT FAUCET - MUSTEE MODEL #63.600A HOSE END FAUCET WITH NON-REMOVABLE VACUUM BREAKER. PROVIDE STANDARD HEIGHT ADA ACCESSIBLE CHILD HEIGHT ROUGH CHROME PLATED FINISH, AND 3/4" HOSE THREAD ON OUTLET. PROVIDE #600 WATTS OR EQUAL SPRING CHECK SHOWER VALVES VALVES IN HW AND CW DROPS TO FAUCET. MOUNT FAUCET UNDER COUNTERTOP, 18" AFF, AND ON OUTBOARD STANDARD HEIGHT - MEN ADA ACCESSIBLE OPERATOR, AND LENGTH AS REQUIRED. FURNISH A KEY FOR EACH HYDRANT. MOUNT FWH 18" ABOVE GRADE SHOWER HEADS WOMEN TUB VALVES STANDARD HEIGHT CLINIC SERVICE SINKS SURGEON'S SCRUB-UP SINKS BACKFLOW PREVENTER ON OUTLET WITH INTEGRAL VENT, 1" NPT INLET, ONE PIECE PLUNGER, 1/8" AUTOMATIC ICE MAKER OUTLET BOXES STAINLESS STEEL GRAB BARS, AND FOLDING SEAT. PROVIDE SLOAN OPTIMA PRESSURE BALANCED SHOWER MIXING VALVE AND 1.5 GPM SHOWER HEAD. SHOWER VALVE SHALL COMPLY WITH LEED CERTIFICATION REQUIREMENTS HOSE BIBBS PRV-A PRESSURE REDUCING VALVE - WATTS #115E WITH CAST IRON BODY, STANDARD TRIM, AND 263AP CONTROL PILOT. PROVIDE WATTS #223 3/4" LOW DEMAND AUXILIARY REGULATOR AND BYPASS PIPING. SET PRESSURE REDUCING VALVE AT 60 PSI DELIVERY PRESSURE AND SET AUXILIARY REGULATOR FOR 70 PSI DELIVERY PRESSURE. PROVIDE FLANGED CONNECTION AND DIELECTRIC KIT FOR INSTALLATION IN COPPER PIPING. THE STRAINER OF THE BACKFLOW PREVENTER WILL PROTECT THE PRV AND THE #115E VALVE MAY BE INSTALLED IN EITHER THE HORIZONTAL OR PRV-B PRESSURE REDUCING VALVE - WATTS #U5-LP WATER PRESSURE REDUCING VALVE FOR 10-35 PSI RANGE. SET PRV ADA AMERICANS WITH DISABILITIES ACT AIR HANDLING UNIT ITOMATION SYSTEM CP1 HOT WATER CIRCULATING PUMP - BELL AND GOSSETT #NBF-10 INLINE, LEAD FREE BRONZE CIRCULATING PUMP FOR TS TIME SWITCH INTERMATIC #ET1705CSPST, 7 DAY, ONE CIRCUIT-SINGLE POLE SINGLE THROW, ELECTRONIC TIME SWITCH OR EQUAL BY TORK. TIME SWITCH SHALL BE MOTOR RATED (1 H.P. @ 120 VOLT, SINGLE PHASE), MINIMUM OF 20 SET ONDENSATE PUME (POINTS 14 ON/OFF CYCLES) AND BATTERY BACK UP. COORDINATE WITH DIVISION 16 FOR INSTALLATION AND CPVC CHI ORINATED POLY VINYL CHLORIDE CTILE IRON OWNSPC WH-2 119 GALLON WATER HEATER AS MANUFACTURED BY RHEEM WATER HEATING & HEATING AND COOLING PRODUCTS. WWW.RHEEM.COM. MODEL #HE119-199 'ADVANTAGE PLUS' 95% EFFICIENT SEALED COMBUSTION DESIGN WITH LECTRIC WATER WH-3 EEMAX 'ACCUMIX' MODEL MT004120T WATER HEATER RATED AT 3.5 KW, 120V. LOCATED AT HAND SINKS, BAR SINKS, OOR DRAIN WH-4 EEMAX 'SERIES TWO' MODEL EX1608TC WATER HEATER RATED AT 16.6 KW, 208V. LOCATED AT 2 COMPARTMENT SINKS, WH-5 10 GALLON WATER HEATER AS MANUFACTURED BY AO SMITH. MODEL EJCP10 10 GALLON ELECTRIC WATER HEATER FULL LOAD AMPS

PLUMBING SYMBOLS PLUMBING PLAN NOTE CALLOUT PLUMBING EQUIPMENT DESIGNATION. (CONTRACTOR FURNISHED AND INSTALLED). REFER TO PLUMBING FIXTURE OR EQUIPMENT SCHEDULES EQUIPMENT DESIGNATION (OWNER FURNISHED. CONTRACTOR INSTALLED) MECHANICAL EQUIPMENT DESIGNATION (CONTRACTOR FURNISHED AND INSTALLED UNLESS NOTED OTHERWISE) CONNECTION POINT OF NEW WORK TO EXISTING DETAIL REFERENCE UPPER NUMBER INDICATES DETAIL NUMBER LOWER NUMBER INDICATES SHEET SECTION CUT DESIGNATION STANDARD MOUNTING HEIGHTS REFER TO THE ARCHITECTURAL DRAWINGS FOR PLUMBING FIXTURE MOUNTING HEIGHTS. UNO, INSTALL PLUMBING FIXTURES WITH THE MOUNTING HEIGHTS AS LISTED BELOW WITH FINAL 31" FLOOR TO RIM 34" FLOOR TO RIM 24" FLOOR TO RIM 24" FLOOR TO RIM 17" FLOOR TO RIM 14" FLOOR TO RIM 15" FLOOR TO RIM 17" TO 19" FLOOR TO TOP OF SEAT 10" FLOOR TO RIM WATER COOLER OR DRINKING FOUNTAIN 41" FLOOR TO SPOUT 30" FLOOR TO SPOUT 48" FLOOR TO CENTERLINE 42" FLOOR TO CENTERLINE STANDARD HEIGHT - WOMEN 38" MIN TO 48" MAX FLOOR TO CENTERLINE 6'-6" FLOOR TO CENTERLINE 6'-0" FLOOR TO CENTERLINE 32" FLOOR TO CENTERLINE ADA ACCESSIBLE CENTER BETWEEN GRAB BAR AND TUB RIM 30" FLOOR TO RIM 35" FLOOR TO FRONT RIM 24" FLOOR TO CENTER OF BOX WASHING MACHINE OUTLET BOXES 42" FLOOR TO RIM 42" FLOOR TO CENTERLINE JANITOR'S SINK FAUCET FITTINGS 36" AFF TO CENTERLINE NON FREEZE WALL HYDRANTS 18" AFG TO CENTERLINE UNLESS NOTED OTHERWISE, MOUNTING HEIGHTS LISTED ARE ABOVE FINISHED FLOOR (AFF) OR ABOVE FINISHED GRADE (AFG). MINIMUM NORMALLY C NORMALLY OPEN ABOVE FINISHED GRADE PLUMBING DRAINAGE PRV PRESSURE REDUCING POLYVINYL CHLORIDE TOM OF STRUCTURE REINFORCED CONCRETE PIPE RPM REVOLUTIONS PER **ROOFTOP UNIT** OUARE FEET RAINAGE FIXTURE UNIT STAINLESS STEEL SANITARY SEWER, SOIL TAL DYNAMIC HEAD FLOOR ABOVE FLOOR BELOW UNDERWRITERS LABORATORIES, INC. UNO UNLESS NOTED OTHERWISE UPS UNINTERRUPTIBLE POWER SUPPLY VCP VITRIFIED CLAY PIPE HEAD. HUB DRAIN VARIABLE INVERT ELEVATION INCHES OF **VENT THROUGH ROOF** WATER COLUMN WATER COLUMN MAKE-UP AIR UNIT WSFU WATER SUPPLY FIXTURI MAX MBH MH MAXIMUM

1000 BTU PER HOUR

THIS IS A MASTER LEGEND AND NOT ALL SYMBOLS OR ABBREVIATIONS MAY BE USED PIPING DOMESTIC COLD WATER (CW) ----- OXYGEN OUTLET NITROUS OXIDE OUTLET SCW—SCW—SOFTENED COLD WATER (SCW) DOMESTIC HOT WATER (HW) MEDICAL AIR OUTLET —---- DOMESTIC HOT WATER RECIRC. (HWR) NITROGEN OUTLET MEDICAL VACUUM INLET ____ TRAP PRIMER LINE (T) FLOOR SINK (FS), SIZE & TYPE SOIL PIPING - ABOVE FLOOR (S) FLOOR DRAIN (FD), SIZE & TYPE — —S— — SOIL PIPING - BELOW FLOOR (S) ROOF DRAIN (RD), SIZE & TYPE WASTE PIPING - ABOVE FLOOR (W) BALL VALVE ──────────── CONTROL VALVE — — — W — — WASTE PIPING - BELOW FLOOR (W) FILTERED WATER - ABOVE FLOOR (GW) → SHUTOFF VALVE GREASE WASTE - ABOVE FLOOR (GW) CHECK VALVE —— GW— — GREASE WASTE - BELOW FLOOR (GW) BALANCING VALVE WITH PRESSURE ——CGWV——— COMBINATION GREASE WASTE AND ─────────── WATER METER VENT (CGWV) CWV——— COMBINATION WASTE AND VENT (CWV) STRAINER STORM DRAIN - ABOVE FLOOR (ST) STRAINER WITH BLOWOFF - - - ST- - STORM DRAIN - BELOW FLOOR (ST) RELIEF/SAFETY VALVE OST—OST—OVERFLOW STORM DRAIN - ABOVE SOLENOID VALVE FLOOR (OST) PRESSURE REDUCING VALVE - - -VBG- - VENT BELOW GRADE (VBG) ────────── GAS PRESSURE REGULATOR ─ ─ ─ VBF─ ─ ─ VENT BELOW FLOOR (VBF) THERMOSTATIC MIXING VALVE —ID——— INDIRECT DRAIN (ID) PIPE ANCHOR CDH——— CONDENSATE DRAIN - HIGH EFFICIENCY EXPANSION JOINT RTU (CDH) CONDENSATE DRAIN (CD) BACKFLOW PREVENTER ———ACD——— AUXILIARY CONDENSATE DRAIN (ACD) PRESSURE GAUGE SPD——SPD——SUMP OR SEWAGE PUMP DISCHARGE (SPD) THERMOMETER ————G———— NATURAL GAS (G) ───────── UNION ————G———— NATURAL GAS ON ROOF (G) FLANGE CONNECTION ——MPG—— MEDIUM PRESSURE NATURAL GAS (MPG) HOSE BIBB (HB) ── ── MPG── ── MEDIUM PRESSURE NATURAL GAS NONFREEZE WALL HYDRANT (NW) ON ROOF (MPG) MANUAL / AUTOMATIC AIR VENT OR ——NPW—— NON POTABLE WATER (NPW) VACUUM RELIEF VALVE LPG—LPG—LIQUIFIED PETROLEUM GAS (LPG) PRESSURE / VACUUM SWITCH WS—WS—WATER SERVICE (WS) ____ CLEANOUT FP FIRE PROTECTION (FP) CAP PD——PD—— CONDENSATE PUMP DISCHARGE (PD) ——⊸⊣ WALL CLEANOUT (WCO) — — — EXISTING PIPING TO BE REMOVED ——— FLOOR CLEANOUT (FCO) EXISTING PIPING TO REMAIN ———<u></u> EXTERIOR CLEANOUT (ECO) ──V─── VENT PIPING (V) ELBOW UP ——• ACID WASTE - ABOVE FLOOR (AW) ELBOW DOWN - - AW- - ACID WASTE - BELOW FLOOR (AW) ─────── TEE UP AV——— ACID VENT (AV) TEE DOWN ELBOW UP WITH SHUT-OFF VALVE (SOV) ———MA——— MEDICAL AIR (MA) ELBOW DOWN WITH SHUT-OFF VALVE ———MV——— MEDICAL VACUUM (MV) TEE UP WITH SHUT-OFF VALVE (SOV) N2—N2—NITROGEN (N2) TEE DOWN WITH SHUT-OFF VALVE (SOV ———N2O——— NITROUS OXIDE (N2O) WATER HAMMER ARRESTER (WHA) O2—O2—OXYGEN (O2) WITH PDI SIZES, (A, B, C, D, & E) EVAC/WAGD (EV) RECIRCULATION PUMP CO2—CO2—CARBON DIOXIDE (CO2) ————AI———— MEDICAL AIR INTAKE (AI) ────── GAS COCK VE MEDICAL VACUUM EXHAUST (VE) TRAP PRIMER HE—HE—HELIUM (HE) TRAP PRIMER WITH DISTRIBUTION UNIT ----IA-----INSTRUMENT AIR (IA) INSTRUMENT VACUUM (IV) ———DA——— DENTAL AIR (DA) ———DV——— DENTAL VACUUM (DV) GENERAL PLUMBING NOTES

PLUMBER SHALL PROVIDE 'AS BUILT' DRAWINGS TO OWNER SHOWING HORIZONTAL AND VERTICAL DIMENSIONS OF ALL UNDERFLOOR LINES (SANITARY, WASTE AND VENT. COOLER DRAIN LINES, RAINWATER, DOMESTIC WATER, AND FIRE PROTECTION) INCLUDING LOCATIONS OF DRAINS, CLEANOUTS, AND RISERS. PLUMBER SHALL NOT VARY LINE LOCATIONS WITHOUT PRIOR APPROVAL BY OWNER. THE PLUMBING CONTRACTOR SHALL MAINTAIN AT THE JOBSITE A SET OF 'RECORD' DRAWINGS TO BE MARKED WITH 'AS BUILT' CONDITIONS AS THE PROJECT PROGRESSES. THIS SET OF 'RECORD DRAWINGS' SHALL BE AVAILABLE FOR REVIEW AT THE OWNERS' REQUEST.

CARE SHALL BE TAKEN THAT ALL CLEANOUTS IN THE STORE WILL BE ACCESSIBLE AND NOT UNDER CASES, SHELVING, AND ANY OTHER STATIONARY OBJECT. THE TOP OF CLEANOUT COVERS SHALL NOT BE BELOW, OR AT AN ANGLE TO THE FINISHED FLOOR. ANY CLEANOUT NOT MEETING THESE REQUIREMENTS SHALL BE CORRECTED AT THE EXPENSE OF THE PLUMBING CONTRACTOR.

CARE SHALL BE TAKEN THAT ALL FLOOR DRAINS IN THE STORE WILL BE INSTALLED PLUMB WITH THE FLOOR AND AT THE ELEVATION AS INDICATED ON THE DRAWINGS. ANY FLOOR DRAIN NOT MEETING THESE REQUIREMENTS SHALL BE CORRECTED AT THE EXPENSE OF THE PLUMBING CONTRACTOR.

UNLESS OTHERWISE NOTED, UNDERFLOOR WASTE AND WATER LINES SHALL NOT BE INSTALLED WITHIN 3'-0" OF THE EXTERIOR FACE OF THE MEAT COOLER AND ALL FREEZER WALLS, DRAINS, WASTE LINES, AND WATER LINES SHOWN ON PLAN TO BE WITHIN THESE AREAS SHALL BE INSULATED WITH ARMAFLEX PIPE INSULATION OF 3/4"

i. PAINT ALL EXPOSED GAS AND WATER PIPING USING RUST INHIBITOR PAINT, RUSTOLEUM OR COLOR TO BE SELECTED BY ARCHITECT.

PROVIDE WALL BACKING FOR THE PROPER SUPPORT OF ALL WALL HUNG FIXTURES AND EQUIPMENT INSTALLED BY PLUMBER.

CAULK AND PROVIDE FINAL CLEANING OF FIXTURES AND EQUIPMENT INSTALLED BY PLUMBER

NOTE: NOT ALL DRAINS LISTED ARE USED ON THIS PROJECT DRAINS & DRAINAGE SPECIALTIES (

DRAINS AND DRAINAGE SPECIALTIES ARE BASED ON JOSAM. EQUAL PRODUCTS BY J.R. SMITH, WADE, ANCON AND ZURN FD-A FLOOR DRAIN - JOSAM SERIES #30000-7E1 DRAIN WITH P-TRAP AND 7" ROUND STRAINER, SET TOP OF RIM FLUSH WITH

FD-B FLOOR DRAIN - JOSAM SERIES #30000-6E1 DRAIN WITH P-TRAP AND 6" ROUND STRAINER. SET TOP OF RIM 3/4"

FD-C FLOOR DRAIN - JOSAM SERIES #30000-WT DRAIN WITH P-TRAP AND 5" ROUND STRAINER. SET TOP OF STRAINER AS INDICATED ON DRAWINGS. SIZE AS NOTED.

FD-D FLOOR DRAIN - JOSAM SERIES #30000 DRAIN WITH DEEP SEAL TRAP AND 5" G-SERIES STRAINER (SOLID HINGED COVER WITH SECONDARY INTERNAL STRAINER). SET TOP OF RIM FLUSH WITH FLOOR LINE. SIZE AS NOTED. FS FLOOR SINK - JOSAM SERIES #49000-3 8"x8" FLOOR SINK WITH P-TRAP, C.I. BODY ACID-RESISTING INTERIOR, NIKALOY HALF-GRATE TOP, AND ALUMINUM DOME INTERNAL STRAINER. SIZE AS NOTED. PROVIDE NICKEL BRONZE FUNNEL WITH TALL CONE TOP ON FLOOR SINK AT FLORAL SINK.

RD ROOF DRAIN - JOSAM SERIES #21500-1-2 CAST IRON ROOF DRAIN WITH LOCKING DOME, GRAVEL STOP, LARGE SUMP, DECK CLAMP ASSEMBLY, AND DRAIN RECEIVER. SIZE AS INDICATED ON DRAWINGS.

TD TRENCH DRAIN - FLO-THRU SERIES Z-806 6" MODULAR DRAINAGE SYSTEM WITH END CAPS, BOTTOM OUTLET WITH DOME STRAINER, AND HEAVY DUTY FRAME WITH DUCTILE IRON GRATE, CLASS C RATING. OUTLET SIZE TO BE 3" OR AS INDICATED ON DRAWINGS. EQUAL PRODUCT BY ACO WILL BE APPROVED. TD(SS) STAINLESS STEEL TRENCH DRAIN - ZURN Z-890__-RFS 6" WIDE PRE-SLOPED TRENCH DRAINAGE SYSTEM WITH 1/8" PER

FOOT SLOPE. #16 GAGE TYPE 304 STAINLESS STEEL DRAIN CHANNEL WITH BOLTED FLANGE CONNECTION COMPLETE WITH RUBBER FLANGE GASKET, AND REINFORCED STAINLESS STEEL SLOTTED GRATE. LENGTH AS SHOWN ON PLAN. WHA WATER HAMMER ARRESTOR - JOSAM SERIES #75000 ABSORBOTRON SHOCK ABSORBER. SIZE AS REQUIRED FOR FIXTURE GROUP OR EQUIPMENT. PROVIDE ON CW TO PUBLIC RESTROOMS.

BASKET STRAINER - ZURN SERIES Z-1180 WITH 2" INLET AND OUTLET, SEDIMENT BUCKET, STRAINER, AND TOP

REMOVABLE LID. LOCATE UNIT IN ACCESSIBLE LOCATION FOR STRAINER REMOVAL. FCO JOSAM SERIES #58460-1 CAST IRON FLOOR CLEANOUT WITH SERRATED FINISHED CUT-OFF SECTIONS. BRONZE

INTERNAL PLUG SAME SIZE AS CLEANOUT AREAS FERRULE, AND SATIN FINISH NICKALOY SCORIATED TOP.

FCO-U JOSAM SERIES #58040-22-2 CAST IRON FLOOR CLEANOUT WITH UNFINISHED STRAIGHT BODY FOR CAULKING INTO SOIL PIPE HUB, COUNTERSINK AREAS BRONZE PLUG SAME SIZE AS SOIL PIPE, AND SATIN FINISH BRONZE TOP. SI SOLIDS INTERCEPTOR - ZURN Z-1183 SIZE 800 INTERCEPTOR CONSTRUCTED OF ACID RESISTANT COATED STEEL, ON

AREA JOSAM SERIES #30004-S CAST IRON BODY WITH SQUARE 8x8 NICKALOY STRAINER. DRAIN 4" OPENING. INCREASE PIPE SIZE TO 6". SEE PLAN.

FLOOR INSTALLATION, INTEGRAL TRAP, REMOVABLE BASKET, 4" INLET/OUTLET, LATCHED LID, 50 GPM FLOW, AND 1.35

GI GREASE INTERCEPTOR - JOSAM SERIES #60117-30-85 ACID RESISTING INSIDE AND OUT GREASE INTERCEPTOR WITH 36 GPM RATING AND 70 POUND GREASE CAPACITY, 3" THREADED CONNECTIONS, CASCADE BOTTOM, INTERNAL AIR RELIEF, VISIBLE DOUBLE WALL TRAP, REMOVABLE BAFFLES, ENZYMATIC PORT ON COVER, GASKETED NON-SKID COVER, AND FLOW CONTROL FITTING.

WCO JOSAM SERIES #58910-19 CAST IRON CLEANOUT TEE, COUNTER SUNK PLUG, STAINLESS STEEL ROUND COVER AND SCREW, AND IRON PLUG WITH GASKET SEAL. REFER TO SPECIFICATIONS FOR INSTALLATION.

BACKFLOW PREVENTER SCHEDULE

MODEL DEGREE OF HAZARD APPLICABLE EQUIPMENT WATTS 957 CONTAMINATION WATER SERVICE (2 1/2" & LARGER) (HIGH HAZARD) REDUCED PRESSURE WATTS LF009 IRRIGATION ZONE ASSEMBLY (2" & SMALLER) APPLICABLE KITCHEN WATTS LF719 (LOW HAZARD DUAL CHECK WITH WATTS SS007 WATER COOLED ICE INTERMEDIATE (STAINLESS ATMOSPHERIC VENT STEEL WHERE MACHINES INDICATED) BAG-IN-BOX (S/S ONLY) WATTS LF008 MEAT AND SEAFOOD BFP-3 SPILL RESISTANT DISPENSERS PRESSURE VACUUM WITHOUT AIR GAP BREAKER SPRING HOSE BFP-4 WATTS LF600 POLLUTION (LOW HAZARD) FAUCETS CHECK VALVE COFFEE. TEA. AND ASSE 1022 WATTS SD-3 (LOW HAZARD) CAPPUCCINO EQUIPMEN DUAL CHECK VALVE WITH ATMOSPHERIC VENT BFP-6 REDUCED PRINCIPLE SODA CARBONATORS ASSE 1013 WATTS SSOO9 POLLUTION (LOW HAZARD) ZONE ASSEMBLY (STAINLESS STEEL)

NOTES:

THE PIPING DOWNSTREAM OF BFP-6 SERVING THE SODA CARBONATOR SHALL NOT BE COPPER.

INSTALL BACKFLOW PREVENTER ASSEMBLIES UPRIGHT AND HORIZONTAL AND IN LOCATION FOR SERVICING UNITS.

UPON COMPLETION OF INSTALLATION, TEST AND CERTIFY PROPER OPERATION OF BACKFLOW PREVENTERS BY A QUALIFIED TESTER, PROVIDE A COPY OF TEST RESULTS TO OWNER AND OBTAIN REQUIRED TAGS FOR DEVICES.

ALL HOSE BIBBS (HB), WALL HYDRANTS (FWH), SERVICE SINK FAUCETS (JS), AND FILL FAUCETS (F) SHALL HAVE A NON-REMOVABLE

VACUUM BREAKER FROM THE MANUFACTURER. WHERE APPLICABLE, MULTIPLE DEVICES SHALL NOT BE PROTECTED 'MANIFOLD' STYLE BY A SINGLE BACKFLOW PREVENTER.

PROVIDE DEDICATED BACKFLOW PREVENTER FOR EACH DEVICE.

THE PLUMBING CONTRACTOR SHALL PROVIDE BACKFLOW PREVENTION AS OUTLINED IN THE SCHEDULE ABOVE AND AS REQUIRED BY THE AHJ FOR THE PROJECT. TESTABLE DEVICES SHALL BE LIMITED TO ONLY REQUIRED HAZARDS. ADDITIONAL TESTABLE

DEVICES SHALL BE REMOVED AND REPLACED WITH APPROPRIATE HAZARD PROTECTION.

PLAN NORTH PLUMBING NOTES & SCHEDULES

CONSTRUCTION

REVISE SUMMIT, MIS

8345 LENEXA DRIVE, SUITE 300

LENEXA. KS 66214

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MO. CORPORATE NO: E-556D

EXPIRES 12/31/2020

JOSHUA N.

HOVER

NUMBER

Oct 23 2020 JOSHUA N. HOVER

LICENSE # PE-2017008503

PE-2017008**503**

PROFESSIONAL SEAL

DRAWN BY:

10/19/2020

JOB NUMBER:

62930547

HEI

SCALE:

AS NOTED

GENERAL DEMOLITION NOTES:

- PRIOR TO SUBMITTING BID, VISIT THE JOB SITE AND BECOME FULLY ACQUAINTED WITH THE EXISTING CONDITIONS OF THE PROJECT. REVIEW THE GENERAL NOTES, SPECIFICATIONS AND OTHER DRAWINGS FOR ADDITIONAL REQUIREMENTS WHICH MAY NOT BE SPECIFICALLY CALLED OUT IN THIS PORTION OF THE CONSTRUCTION DOCUMENTS. NOTIFY ARCHITECT, ENGINEER AND/OR OWNER OF CONFLICTS OR DISCREPANCIES PRIOR TO SUBMISSION OF BID.
- EXISTING CONDITIONS WERE TAKEN FROM ORIGINAL DRAWINGS AND SITE VISITS AND MAY NOT REFLECT EXACT "AS-BUILT" CONDITIONS. FIELD VERIFY EXISTING CONDITIONS PRIOR TO SUBMITTING FINAL BIDS. COORDINATE NEW WORK AND DEMOLITION WITH OTHER DISCIPLINES AND EXISTING CONDITIONS PRIOR TO CONSTRUCTION.
- OWNER RETAINS RIGHTS OF SALVAGE FOR EQUIPMENT AND FIXTURES TO BE REMOVED. COORDINATE WITH THE OWNER THE EQUIPMENT AND FIXTURES TO BE SALVAGED AND THE LOCATION FOR STORAGE. AVOID DAMAGE TO EQUIPMENT, FIXTURES AND DEVICES DURING DEMOLITION WORK AND DURING TRANSPORT TO OWNER'S DESIGNATED STORAGE LOCATION.
- REMOVE ITEMS SHOWN HEAVY LINED AND/OR CROSSHATCHED AND/OR NOTED TO BE REMOVED.
- AVOID DAMAGING EXISTING SURFACES AND EQUIPMENT TO REMAIN FOR NEW INSTALLATION. REPAIR ANY DAMAGE CAUSED DURING WORK AT NO EXTRA COST TO THE OWNER.
- SEAL ALL PENETRATIONS THROUGH FLOORS, WALLS, CEILINGS AND ROOFS WHERE PLUMBING COMPONENTS ARE REMOVED AND WHERE THE EXISTING PENETRATION IS NOT USED FOR THE NEW INSTALLATION. REPAIR SURFACES TO MATCH ADJACENT AREAS.
- INSTALL PERMANENT CAPS WHERE PIPING IS REMOVED AND THE EXISTING TAPS ARE NOT USED FOR THE NEW INSTALLATION. INSTALL TEMPORARY CAPS WHERE PIPING IS REMOVED AND THE EXISTING TAPS WILL BE USED FOR THE NEW INSTALLATION TO PROTECT THE INTERIOR SURFACES UNTIL NEW PIPING IS INSTALLED.
- REMOVE PIPE HANGERS, PIPE SUPPORTS AND EQUIPMENT SUPPORTS WHERE PIPING OR EQUIPMENT IS REMOVED AND THE EXISTING HANGERS AND SUPPORTS ARE NOT USED FOR THE NEW INSTALLATION.
- VERIFY THAT EXISTING EQUIPMENT TO REMAIN IS OPERATING PROPERLY. NOTIFY THE ARCHITECT, ENGINEER AND/OR OWNER OF ANY DAMAGED AND/OR MALFUNCTIONING COMPONENTS.
- WHERE SHUTDOWN OF EXISTING ACTIVE PIPING SYSTEMS IS REQUIRED DURING DEMOLITION PHASE OF WORK IN PREPARATION FOR NEW TIE-IN PHASE OF WORK, COORDINATE WITH THE OWNER AND MINIMIZE DOWNTIME. VERIFY EXISTING SYSTEMS, EQUIPMENT, AND COMPONENTS WILL BE PROVIDED WITH BACKUP SERVICE WHERE REQUIRED. NOTIFY OWNER A MINIMUM OF SEVEN (7) DAYS PRIOR TO INTERUPPTION OF SERVICE.

PIPING M	ARKERS	
CLEARLY MARKE THE LABELS SHA	RECIRCULATING HOT WATER, COLD WATER, SOFTENED COLD WATER, AID WITH IDENTIFYING LABELS STATING DIRECTION OF FLOW AND CONTEN LL BE APPLIED AT 8 FEET ABOVE THE FLOOR ON VERTICAL PIPING AND E EXAMPLES OF LABELS ARE AS FOLLOWS:	ITS.
{	DOMESTIC COLD WATER	\$
	DOMESTIC HOT WATER	\$
	SOFT COLD WATER	\$
\	HOT WATER RECIRCULATION	\$
	NATURAL GAS - ?" PSI	\$
	FILTERED WATER	\$
	BLENDED REVERSE OSMOSIS	\$
	REVERSE OSMOSIS	\$
<u></u>	TEMPERED WATER	\$
	NON-POTABLE	3
	IRRIGATION	\$
\	FRYER OIL	\\\\\\\\\\\\\\\\\\\\\\\\\\\\\\\\\\\

KEYED NOTES:

- 1. PERMANENTLY LABEL AT THE CONNECTION POINT.
- 2. LOCATE PIPING IDENTIFICATION AT VALVE LOCATION, AT POINTS WHERE PIPING ENTERS AND LEAVE A PARTITION, AND AT INTERVALS OF 20 FEET ON STRAIGHT RUNS. IN AREAS WITH OPEN STRUCTURE OVER THE SALES FLOOR, PIPING MARKERS NEED ONLY BE INSTALLED AT MAJOR JUNCTURES AND CHANGES OF DIRECTION.

	PIPING APPLICATION SCHE	DULE							
KERS	CVCTEM		DESIGN WORKING PRESSURE (PSI)	MATERIAL	JOINTS	INSULATION APPLICATION			
RCULATING HOT WATER, COLD WATER, SOFTENED COLD WATER, AND GAS PIPING SHALL BE H IDENTIFYING LABELS STATING DIRECTION OF FLOW AND CONTENTS. APPLIED AT 8 FEET ABOVE THE FLOOR ON VERTICAL PIPING AND EVERY 20 FEET	SYSTEM (NOTE 1)	LOCATION				USAGE SIZE RANGE	THICKNESS (IN.)	(N)	
PLES OF LABELS ARE AS FOLLOWS:				TYPE L COPPER "HARD"	SOLDER OR	1-1/4" OR SMALLER	1/2"	ELASTO	
DOMESTIC COLD WATER		ABOVE GRADE	ABOVE GRADE 125	125		MECHANICAL PRESS CONNECTION	1-1/2" & GREATER	1"	FIE
	DOMESTIC COLD WATER FILTERED DRINKING WATER			PEX	PEX MECHANICAL CRIMP	2" OR SMALLER	1"	ELASTOI FIE	
DOMESTIC HOT WATER		BELOW 02-12-	125	TYPE K COPPER "SOFT"	SOLDER	LESS THAN 2 1/2"	-		
		BELOW GRADE	123	DUCTILE IRON PRESSURE WATER PIPE	MECHANICAL OR PUSH-ON	3" & GREATER	-		
SOFT COLD WATER — Y				TVDE L CARDED "LIADD"	SOLDER OR	1-1/4" OR SMALLER	1"	ELASTO	
	DOMESTIC HOT WATER	ABOVE GRADE	125	TYPE L COPPER "HARD"	MECHANICAL PRESS CONNECTION	1-1/2" & GREATER	1"	FI	
HOT WATER RECIRCULATION				PEX	PEX MECHANICAL CRIMP	2" OR SMALLER	1"	ELASTO FII	
NATURAL GAS - ?" PSI	FIRE PROTECTION SERVICE	GENERAL	175	DUCTILE IRON PRESSURE WATER PIPE OR GALVANIZED AS REQUIRED BY NFPA	MECHANICAL OR PUSH-ON	ALL	-		
NATURAL GAS- ? FSI	CANITADVA/FAIT/OTODM	BELOW GRADE	N/A	CAST IRON AND/OR SCH 40 PVC	BELL & SPIGOT, NO HUB, OR SOLVENT	ALL	-		
FILTERED WATER	SANITARY/VENT/STORM	ABOVE GRADE	N/A	CAST IRON, DWV COPPER, AND/OR SCH 40 PVC	BELL & SPIGOT, NO HUB, SOLDER, OR SOLVENT	ALL	1"	FI	
	EQUIPMENT DRAINS	ABOVE GRADE	N/A	DWV COPPER	SOLDER	ALL	1"	FII	
BLENDED REVERSE OSMOSIS	(GRAVITY & PUMPED CONDENSATE)	EXPOSED ABOVE GRADE IN FINISHED AREAS	N/A	CHROME PLATED BRASS PIPE	THREADED	ALL	-		
	GREASE SANITARY	BELOW GRADE	N/A	CAST IRON OR SCH 40 PVC	BELL & SPIGOT, NO HUB, OR SOLVENT	ALL	-		
REVERSE OSMOSIS		BELOW GRADE GAS OUTSIDE BUILDING	125	POLYETHYLENE	ELECTRICAL FUSION	ALL	-		
TEMPERED WATER	NATURAL GAS/GENERATOR EXHAUST	ADOVE ODADE		125 SCH 40 BLACK STEEL	THREADED OR WELDED	SMALLER THAN 2"	-		
TEMI EKES WITEK		ABOVE GRADE	125		WELDED	2 1/2" & GREATER	-		
NON-POTABLE	REVERSE OSMOSIS	RIGID ABOVE GRADE	125	SCH 40 CPVC, PEX, PRIOR APPROVED OTHER	SOLVENT, PEX MECHANICAL CRIMP	ALL	-		
	BLENDED REVERSE OSMOSIS	FLEXIBLE ABOVE GRADE	125	BRAIDED STAINLESS STEEL, PRIOR APPROVED OTHER	THREADED	ALL	-		
IRRIGATION	NOTES:								
FRYER OIL	RETURN AIR PLENUM. 3. INSTALL RIGID CALCIUM SILICATE I	19 FOR COMPLETE INSULATION AND NSERTS AT ALL PIPING HANGERS.) JACKETING REQUIRE	EMENTS. ALL INSULATION SHALL BE PLENU					

- PIPING BRANCHES 2" AND SMALLER MAY BE PEX WHERE PERMITTED BY CODE. USE RED AND BLUE PIPING. INSTALL MANIFOLD DOWNSTREAM OF BRANCH ISOLATION VALVES.
- PIPE SHALL BE CEMENT MORTAR LINED PER ANSI/AWWA STANDARDS. FITTINGS SHALL BE LONG RADIUS, 200 PSI RATED, CEMENT MORTAR LINED. INSULATE RISERS WITHIN 10' OF VENT THROUGH ROOF CONNECTION.
- PIPING MAY BE PVC WHERE NOT INSTALLED IN A RETURN AIR PLENUM. INSULATION ONLY REQUIRED FOR COLD SERVICE PIPING. EQUIPMENT DRAIN PIPING LESS THAN 5' IN LENGTH NEED NOT BE INSULATED.
- PIPING SERVING FOOD SERVICE EQUIPMENT AND EXPOSED TO PUBLIC OR USERS
- 10. ALL NATURAL GAS PIPING LOCATED IN A CEILING RETURN AIR PLENUM SHALL BE WELDED. 1. ALL CONCEALED NATURAL GAS PIPING TO BE WELDED.
- 12. PIPING MAY BE PVC WHERE PERMITTED BY CODE.
- 13. ALTERNATE MATERIALS WILL BE CONSIDERED. SUBMIT ALTERNATES TO ENGINEER FOR APPROVAL PRIOR TO INSTALLATION.

PLUMBING ROUGH-IN SCHEDULE				
FIXTURE TYPE	WASTE	VENT	CW	HW
WC AND HWC	4"	2"	1"	-
UR	2"	1-1/2"	3/4"	
EWC	1-1/2"	1-1/4"	1/2"	
JS	3"	1-1/2"	3/4"	3/4"
LAV'S	2"	1-1/2"	1/2"	1/2"
S-1A,B,C	2"	1-1/2"	1/2"	1/2"
S-2C	2"	1-1/2"	1/2"	1/2"
S-2A	2"	1	1/2"	1/2"
S-2B	2"	1	3/4"	3/4"
S-3'S	2"		3/4"	3/4"
S-4'S	2"	2"	3/4"	3/4"
S-5	2"	2"	3/4"	3/4"
S-6	2"	1-1/2"	3/4"	3/4"
HS	1-1/2"	1-1/2"	1/2"	1/2"
NOTES: UNDERFLOOR SANITARY PIPING SHALL NOT BE SMALLER THAN 2"				

(NOTES 2,3)

ELASTOMERIC FOAM OR **FIBERGLASS**

ELASTOMERIC FOAM OR

FIBERGLASS

ELASTOMERIC FOAM OR

FIBERGLASS

ELASTOMERIC FOAM OR **FIBERGLASS**

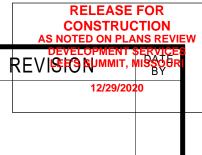
FIBERGLASS

FIBERGLASS

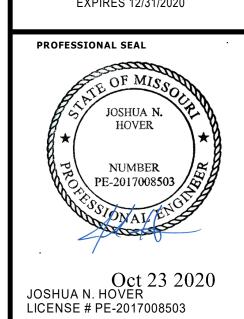
EQUIPMENT				
DESIGNATION	QUANTITY	DESCRIPTION	CFH (EACH)	TOTAL CFH
18	1	CHARBROILER	87	87
20	1	PIZZA OVEN	225	225
23	1	FRYER	150	150
29	1	ROTISSERIE	175	175
32	1	6 BURNER RANGE W/ OVEN	240	240
34	1	MONGALIAN BBQ	123	123
ETR	1	WOK	440	440
ETR	1	CONVECTION OVEN	120	120
ETR	1	BAKERY OVEN	240	240
			TOTAL =	1800
CHANICAL EQUIPMI	ENT			
EQUIPMENT				
DESIGNATION	QUANTITY	DESCRIPTION	CFH (EACH)	TOTAL CFH
RTU-1	1	ROOFTOP UNIT	1000	1000
RTU-2	1	ROOFTOP UNIT	1000	1000
RTU-3	1	ROOFTOP UNIT (ETR)	180	180
RTU-4	1	ROOFTOP UNIT (ETR)	240	240
RTU-5	1	ROOFTOP UNIT (ETR)	240	240
RTU-6	1	ROOFTOP UNIT	120	120
RTU-7	1	ROOFTOP UNIT (ETR)	235	235
RTU-8	1	ROOFTOP UNIT (ETR)	200	200
RTU-9	1	ROOFTOP UNIT	180	180
RTU-10	1	ROOFTOP UNIT	120	120
RTU-11	1	ROOFTOP UNIT	180	180
RTU-12	1	ROOFTOP UNIT	180	180
UH-1	1	UNIT HEATER (ETR)	250	250
UH-2	1	UNIT HEATER (ETR)	125	125
UH-3	1	UNIT HEATER (ETR)	125	125
MAU-1	1	MAKE UP AIR UNIT	356	356
MAU-2	1	MAKE UP AIR UNIT	197	197
WH-1	2	WATER HEATER	199	398
WH	1	WATER HEATER (ETR)	100	100
GEN	1	GENERATOR	894	894
			TOTAL =	6320
URAL GAS SYSTEN	OPERATING PRESSUI		TOTAL =	

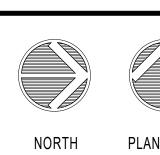
BUILDING TOTAL CONNECTED LOAD =

		CΛ	S DDES	SIIDE D	EGIII ATO	R SCHEDULE FOR	2 DCI CVCTEMC	
MARK	MANUFACTURER /	VALVE	VALVE BODY	MAX. FLOW	INLET PRESSURE	OUTLET PRESSURE	SERVICE	NOTES
IAILAI ZI Z	MODEL#	TYPE	SIZE (INCHES)	RATE CFH	PSI	INCHES WATER COLUMN	SERVICE	NOTES
GPR-1	PIETRO-FIORENTINI 31051	C	1/2"	552	1	7"	ROOFTOP UNIT	A, B, D, E, F, G, H & I
В. С.	DROOP = 1" WATER COLUMN MAXIMU DROOP = 2" WATER COLUMN MAXIMU							
D.	65# ALUMINUM BODY. SCREWED COI		OVERPRESSURE PRO	OTECTION TO 25#				
E.	, , ,				IENT FLOW RATE. REFER	TO EQUIPMENT SHOP DRAWINGS FOR EXACT LO	OADS	
 F.	LISTED TO MEET ANSI Z21.80 / CSA 6.							
G.	GAS PRESSURE REGULATOR INLET I	RESSURE = OPE	ERATING PRESSURE -	DESIGN FRICTION I	OSS			
℧.			ET DDECCUDE					
О. Н.	2PSI MAXIMUM INLET PRESSURE & 1	PSI MIINIMUM INL	LET PRESSURE					



8345 LENEXA DRIVE, SUITE 300 LENEXA, KS 66214 TEL 913.742.5000 FAX 913.742.5001 WWW.HENDERSONENGINEERS.COM MO. CORPORATE NO: E-556D EXPIRES 12/31/2020 PROFESSIONAL SEAL





PLUMBING SCHEDULES

ı	PROJECT MANAGER	CHECKED BY:
ı	SL	HEI
	DRAWN BY:	DATE:
ı	HEI	10/19/2020
	SCALE:	JOB NUMBER:
ı	AS NOTED	62930547
I	SHEET:	

- FURNISH AND INSTALL PLUMBING SYSTEMS IN ACCORDANCE WITH LOCAL AND STATE PLUMBING CODES.
- ALL FLOOR DRAINS, FLOOR SINKS, AND TRENCH DRAINS OUTLETS AND BRANCH SANITARY ARE 3" UNLESS NOTED OTHERWISE.
- 3. ALL FLOOR CLEANOUTS ARE TO BE ACCESSIBLE AND NOT BENEATH MILLWORK, CASEWORK, SHELVES OTHER OBSTRUCTIONS. CLEANOUTS
- SHALL BE THE SAME SIZE AS PIPING BEING SERVED AND AT THE TRANSITION OF PIPE SIZE. COORDINATE UNDERFLOOR PIPING ROUTING WITH REFRIGERATION AND ELECTRCIAL CONTRACTORS.

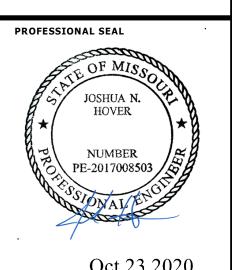
PLUMBING PLAN NOTES

- 1 CONNECT NEW SANITARY/GREASE WASTE PIPING INTO EXISTING PIPING. FIELD VERIFY EXACT LOCATION, SIZE AND INVERT PRIOR TO START OF WORK.
- 2 ROUTE 1"G PIPE UNDERFLOOR IN 4" CONDUIT.
- 3 ROUTE VENT PIPING TIGHT TO COLUMN.

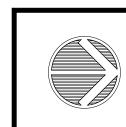
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RELEASE FOR CONSTRUCTION
AS NOTED ON PLANS REVIEW

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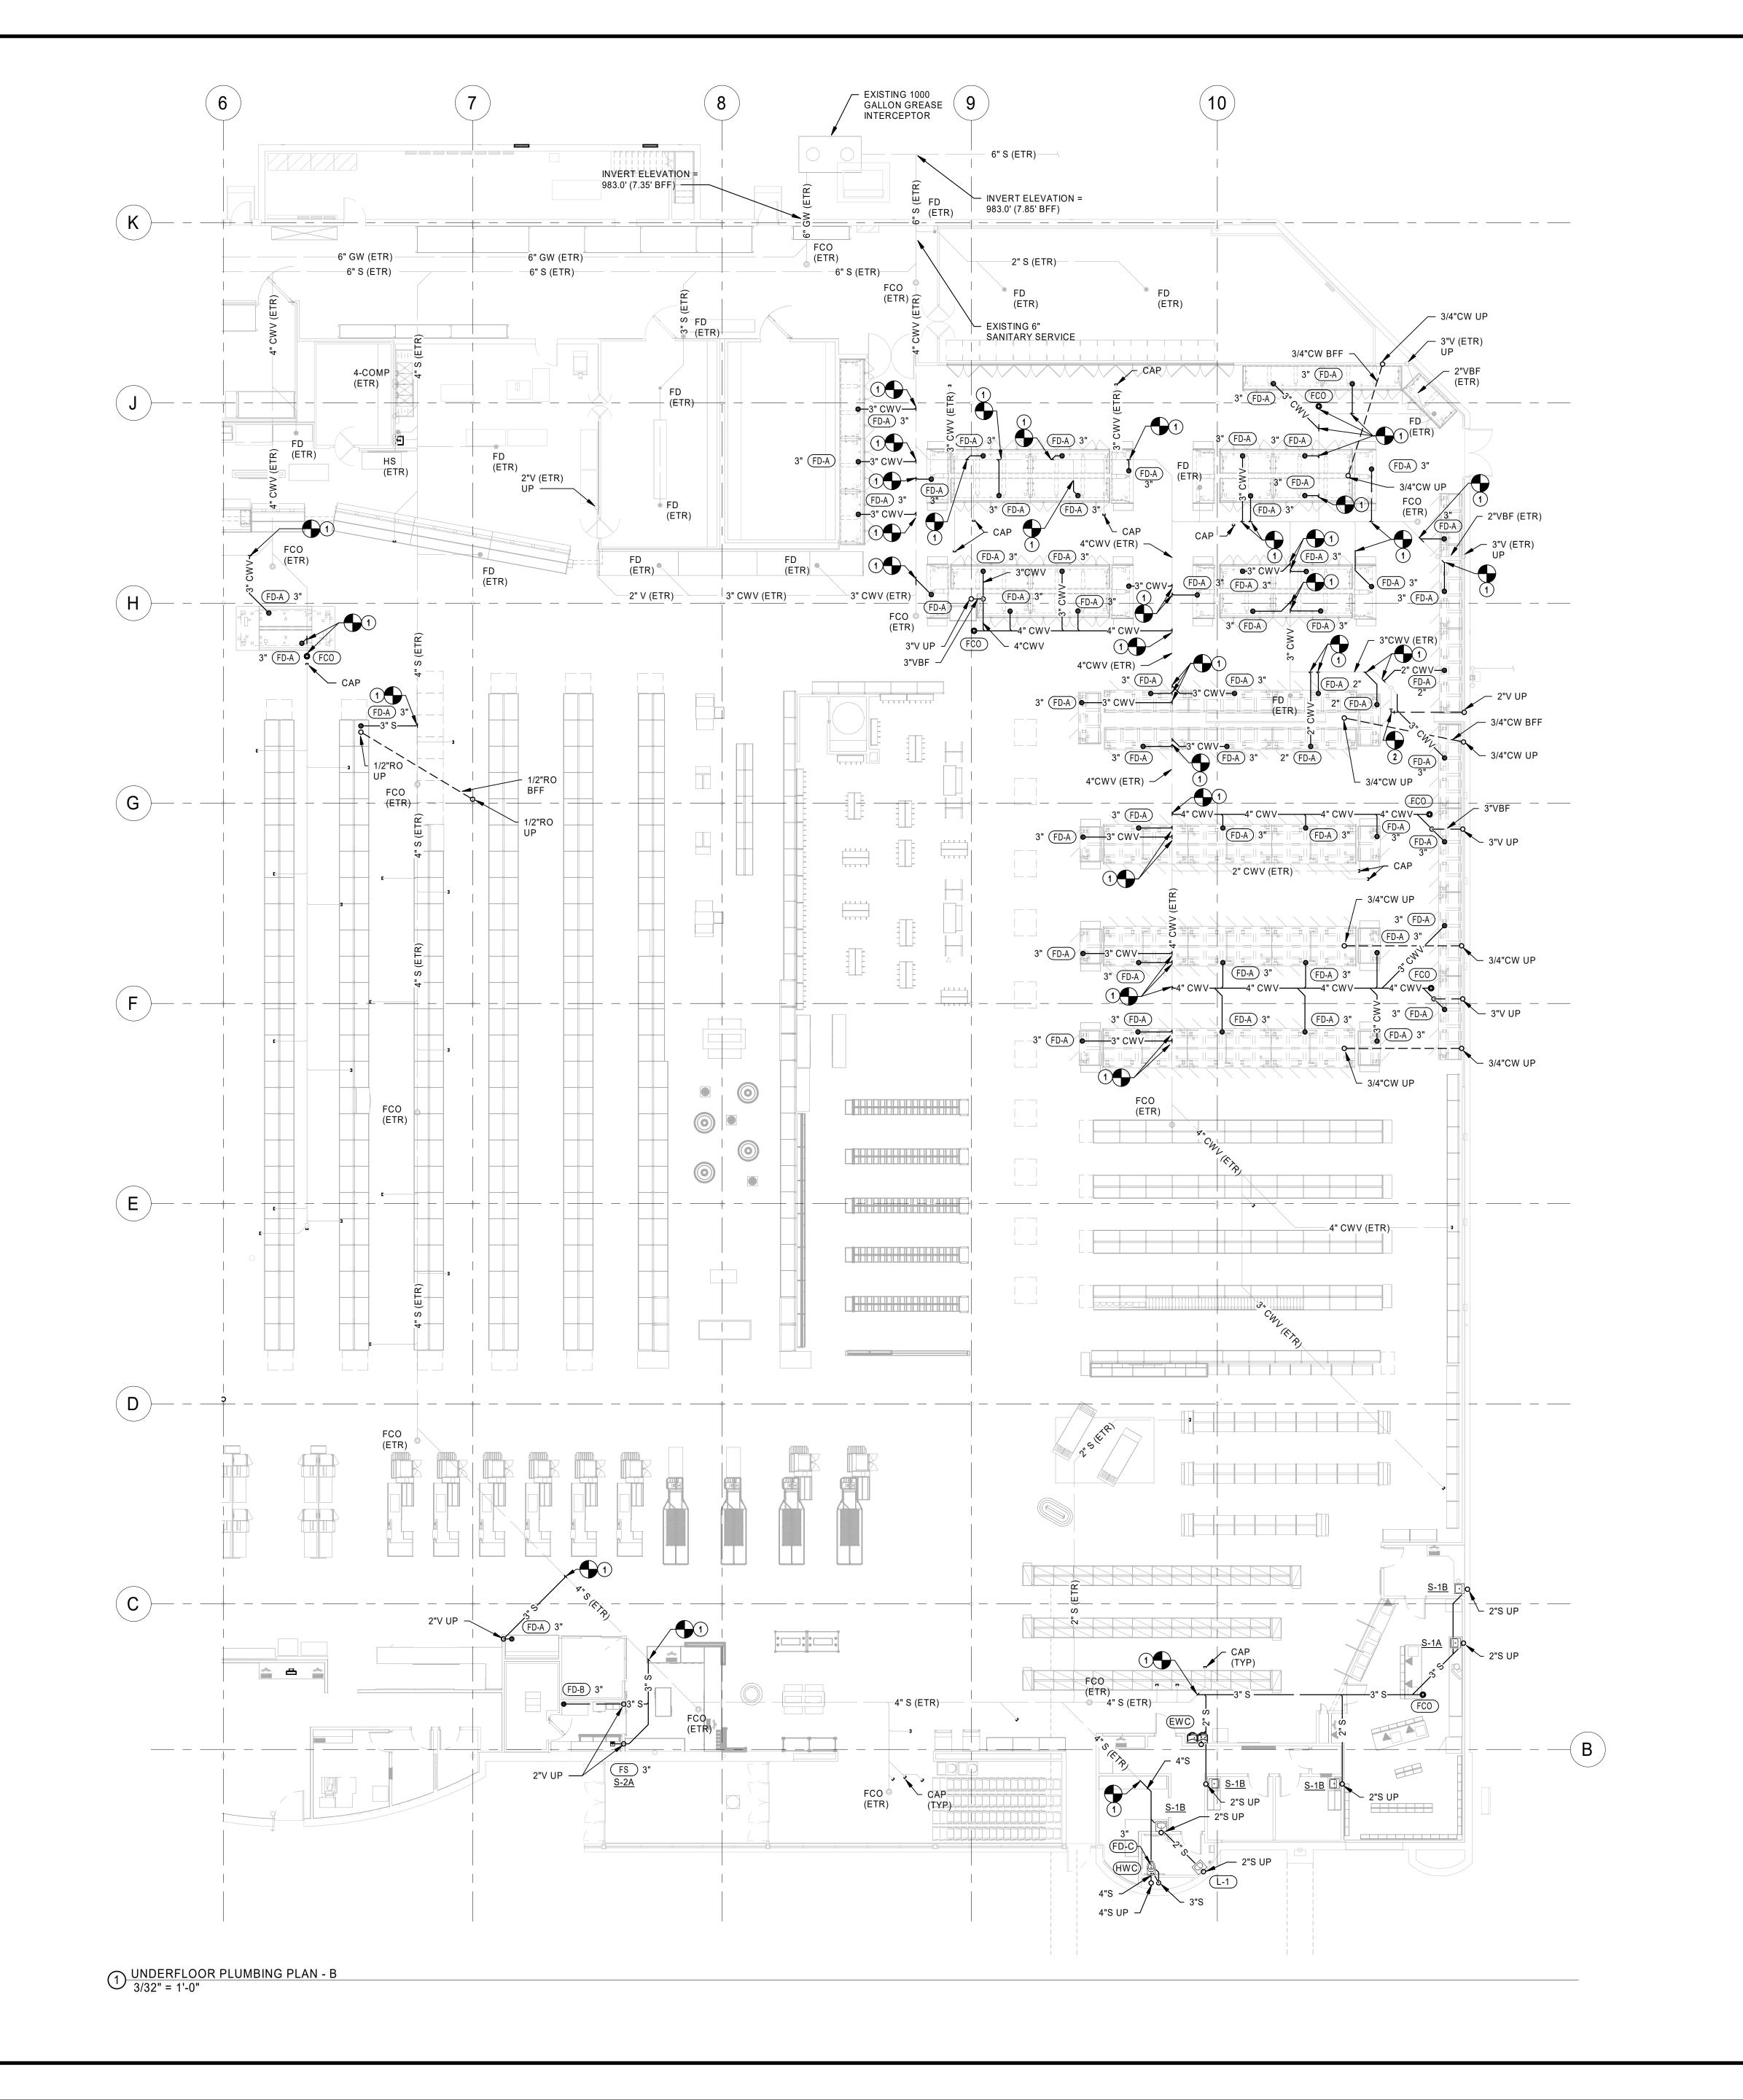
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UNDERFLOOR PLUMBING PLAN -

DRAWN BY: 10/19/2020 SCALE: JOB NUMBER: AS NOTED



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- COORDINATE UNDERFLOOR PIPING ROUTING WITH REFRIGERATION AND ELECTRCIAL CONTRACTORS.

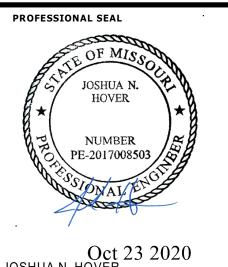
PLUMBING PLAN NOTES

- 1 CONNECT NEW SANITARY/GREASE WASTE PIPING INTO EXISTING PIPING. FIELD VERIFY EXACT LOCATION, SIZE AND INVERT PRIOR TO START OF WORK.
- 2 CONNECT NEW VENT PIPING TO EXISTING VENT PIPING AS FIELD CONDITIONS REQUIRE. FIELD VERIFY EXACT SIZE AND LOCATION PRIOR TO START OF WORK.

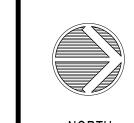
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UNDERFLOOR PLUMBING PLAN -

DRAWN BY: AS NOTED

- FURNISH AND INSTALL PLUMBING SYSTEMS
 IN ACCORDANCE WITH LOCAL AND STATE
- PLUMBING CODES.

 2. ALL FLOOR DRAINS, FLOOR SINKS, AND TRENCH
- DRAINS OUTLETS AND BRANCH SANITARY ARE 3"
 UNLESS NOTED OTHERWISE.

 3. ALL FLOOR CLEANOUTS ARE TO BE ACCESSIBLE
- 3. ALL FLOOR CLEANOUTS ARE TO BE ACCESSIBLE AND NOT BENEATH MILLWORK, CASEWORK, SHELVES OTHER OBSTRUCTIONS. CLEANOUTS SHALL BE THE SAME SIZE AS PIPING BEING SERVED AND AT THE TRANSITION OF PIPE SIZE.
- 4. COORDINATE UNDERFLOOR PIPING ROUTING WITH REFRIGERATION AND ELECTRCIAL CONTRACTORS.
- 5. ROUTE BRANCH PIPING 12" ABOVE THE ACCESSIBLE CEILING.

PLUMBING PLAN NOTES

- 1 1"CW DOWN IN WALL TO STARBUCKS KIOSK. ROUTE IN WALL TO EACH FIXTURE AND CONNECT PER STARBUCKS STANDARDS.
- 2 ROUTE 3/4" FW DOWN IN WALL AND CONNECT TO OVEN. PROVIDE FLEXIBLE COPPER TUBING FROM WALL TO EQUIPMENT PER MANUFACTURER'S REQUIREMENTS.
- PROVIDE ESCUTCHEON AT WALL.

 3 CONNECT NEW DOMESTIC WATER PIPING TO EXISTING PIPING. FIELD VERIFY EXACT LOCATION AND SIZE
- PRIOR TO START OF WORK.

 4 1/2"SCW DOWN. CONNECT 1/2"CW TO HUMIDOR PER MANUFACTURER'S RECOMMENDATIONS.
- 5 ROUTE 1/2"FW TO BAKERY WATER METER AND CONNECT PER MANUFACTURER'S RECOMMENDATIONS.
- 6 CONNECT NEW BAKERY OVEN TO EXISTING WATER AND GAS PIPING AS FIELD CONDITIONS REQUIRE AND PER MANUFACTURER'S RECOMMENDATIONS.
- MANUFACTURER'S RECOMMENDATIONS.

 7 CONNECT NEW PROOFER TO EXISTING WATER PIPING AS FIELD CONDITIONS REQUIRE AND PER
- MANUFACTURER'S RECOMMENDATIONS.

 8 ROUTE CW PIPING ON TOP OF CASE. INSTALL AND
- SECURELY FASTEN HB2 IN CENTER OF CASE ARRANGEMENT.

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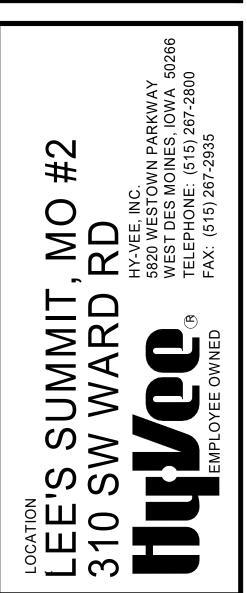
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REVISES NUMBER



Oct 23 2020 JOSHUA N. HOVER LICENSE # PE-2017008503







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ROJECT MANAGER	CHECKED BY:
SL	HEI
DRAWN BY:	DATE:
HEI	10/19/2020
SCALE:	JOB NUMBER:

PLAN - A

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AS NOTED

- 1. FURNISH AND INSTALL PLUMBING SYSTEMS IN ACCORDANCE WITH LOCAL AND STATE
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- COORDINATE UNDERFLOOR PIPING ROUTING WITH REFRIGERATION AND ELECTRCIAL CONTRACTORS.
- ROUTE BRANCH PIPING 12" ABOVE THE ACCESSIBLE

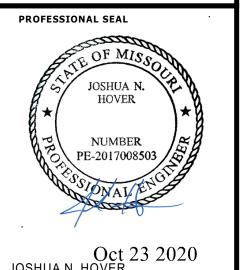
PLUMBING PLAN NOTES

- 1 CONNECT NEW DOMESTIC WATER PIPING TO EXISTING PIPING. FIELD VERIFY EXACT LOCATION AND SIZE PRIOR TO START OF WORK.
- 2 CONNECT NEW VENT PIPING INTO EXISTING VTR. FIELD VERIFY EXACT LOCATION AND SIZE PRIOR TO START OF
- 3 ROUTE CW PIPING ON TOP OF CASE. INSTALL AND SECURELY FASTEN HB2 IN CENTER OF CASE ARRANGEMENT.

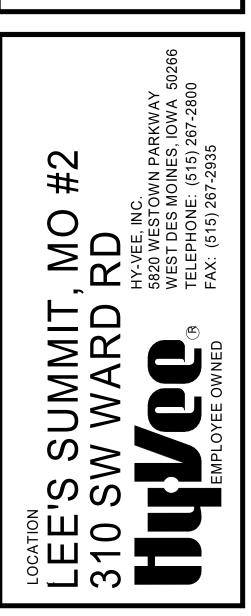
HENDERSON ENGINEERS 8345 LENEXA DRIVE, SUITE 300 LENEXA, KS 66214 TEL 913.742.5000 FAX 913.742.5001 WWW.HENDERSONENGINEERS.COM 1950003081 MO. CORPORATE NO: E-556D EXPIRES 12/31/2020

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PLAN NORTH PLUMBING FLOOR

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PLAN - B

- 1. AVOID ROUTING IN EXTERIOR WALLS WHERE POSSIBLE. ALL PIPING TO BE ON THE WARM SIDE OF THE WALL INSULATION TO PROTECT AGAINST
- FREEZING.

 2. INSTALL ISOLATION VALVES IN ALL FIXTURE BRANCHES AND UNDERFLOOR BRANCH PIPING. ENSURE VALVES ARE INSTALLED IN AN
- 3. VERIFY LOCATION OF ALL EQUIPMENT REQUIRING PLUMBING (APPLIANCES, PLUMBING FIXTURES, HVAC, ETC.) PRIOR TO ROUGHING IN ANY PIPING.

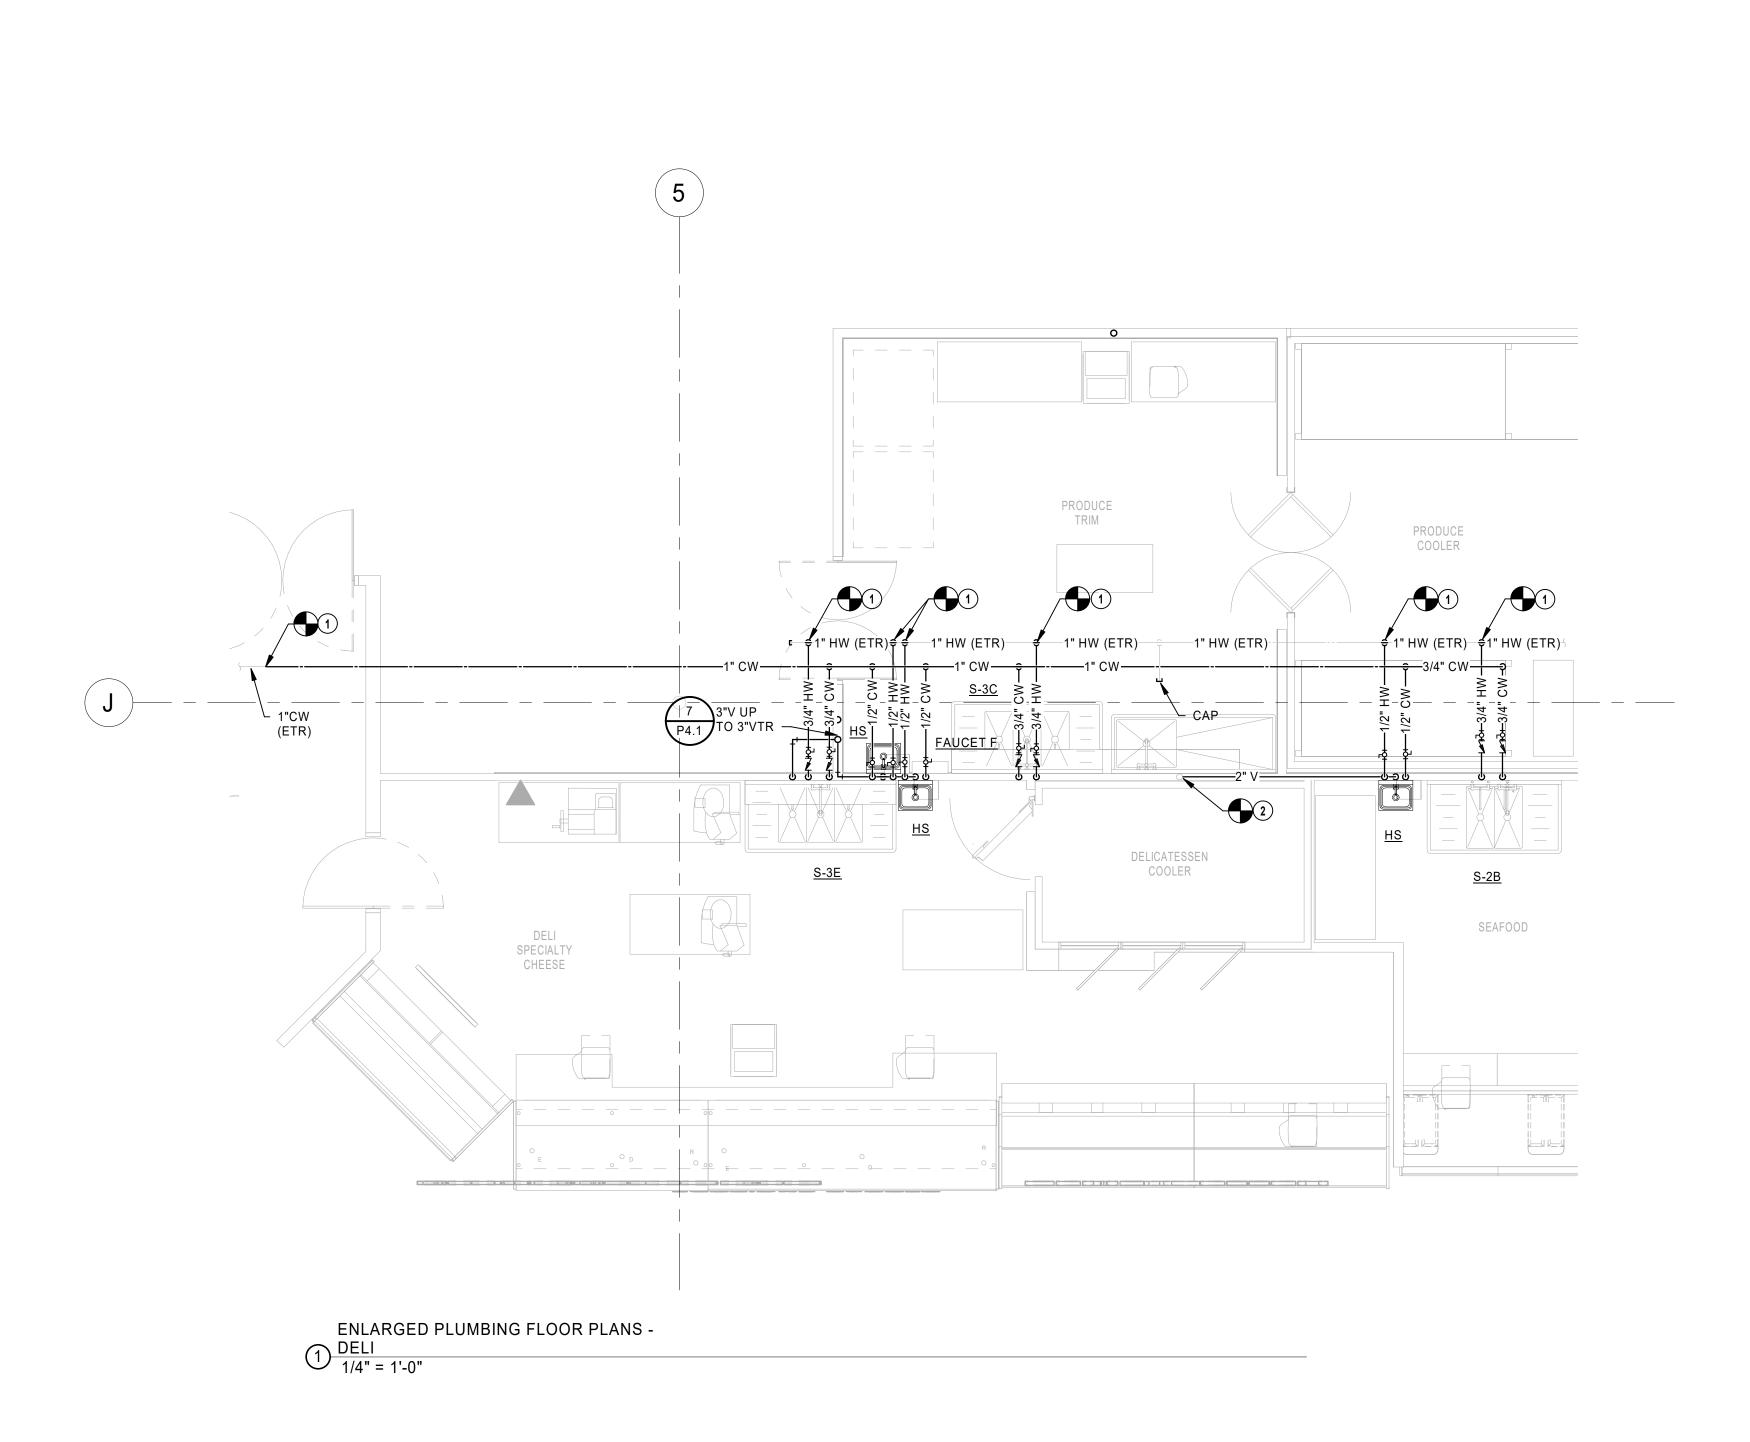
ACCESSIBLE LOCATION.

- 4. PROVIDE BACKFLOW PREVENTERS THROUGHOUT STORE ONLY WHERE REQUIRED BY LOCAL AND STATE CODES. SEE BACKFLOW PREVENTER SPECIFICATIONS ON SHEET P0.0 AND "CROSS CONNECTION & BACKFLOW PREVENTER SCHEDULE" ON SHEET P4.0.
- 5. INSTALL ISOLATION VALVES ON THE INLET AND OUTLET ON ALL POINT OF USE WATER FILTERS.
- COORDINATE PIPE ROUTING WITH OTHER TRADES PRIOR TO INSTALLATION.
- 7. ALL BACKFLOW PREVENTERS INSTALLED IN FOOD PREPARATION AREA MUST HAVE FABRICATED, CLEANABLE, STAINLESS STEEL COVERS.
- 8. ALL INDIRECT DRAIN LINES MUST BE INSTALLED +/6" A.F.F. AND NOT SUPPORTED FROM THE FLOOR.

PLUMBING PLAN NOTES

- CONNECT NEW DOMESTIC WATER PIPING TO EXISTING PIPING. FIELD VERIFY EXACT LOCATION AND SIZE
- PRIOR TO START OF WORK.

 2 CONNECT NEW VENT PIPING TO EXISTING VENT PIPING AS FIELD CONDITIONS REQUIRE. FIELD VERIFY EXACT SIZE AND LOCATION PRIOR TO START OF WORK.
- 3 CONNECT NEW GAS PIPING TO EXISTING PIPING. FIELD VERIFY EXACT LOCATION AND SIZE PRIOR TO START OF

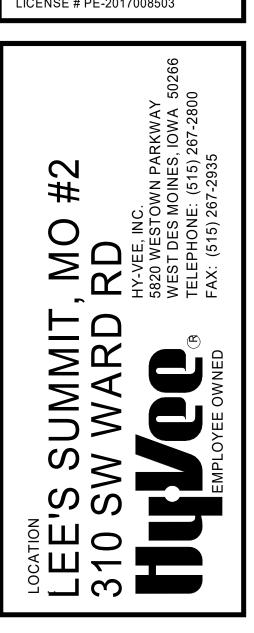


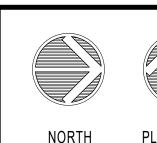


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CONSTRUCTION
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PLUMBING ENLARGED PLANS

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P2.5

1-1/2"SCW HEADER

-3/4" CW (ETR)

WOMEN

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HWC

ENLARGED PLUMBING FLOOR PLANS -

02 RESTROOMS 1/4" = 1'-0" WOMEN

WOMEN

MOTHERS ROOM ___ 1 1/4"HW (ETR)

1 1/4"G HEADER -

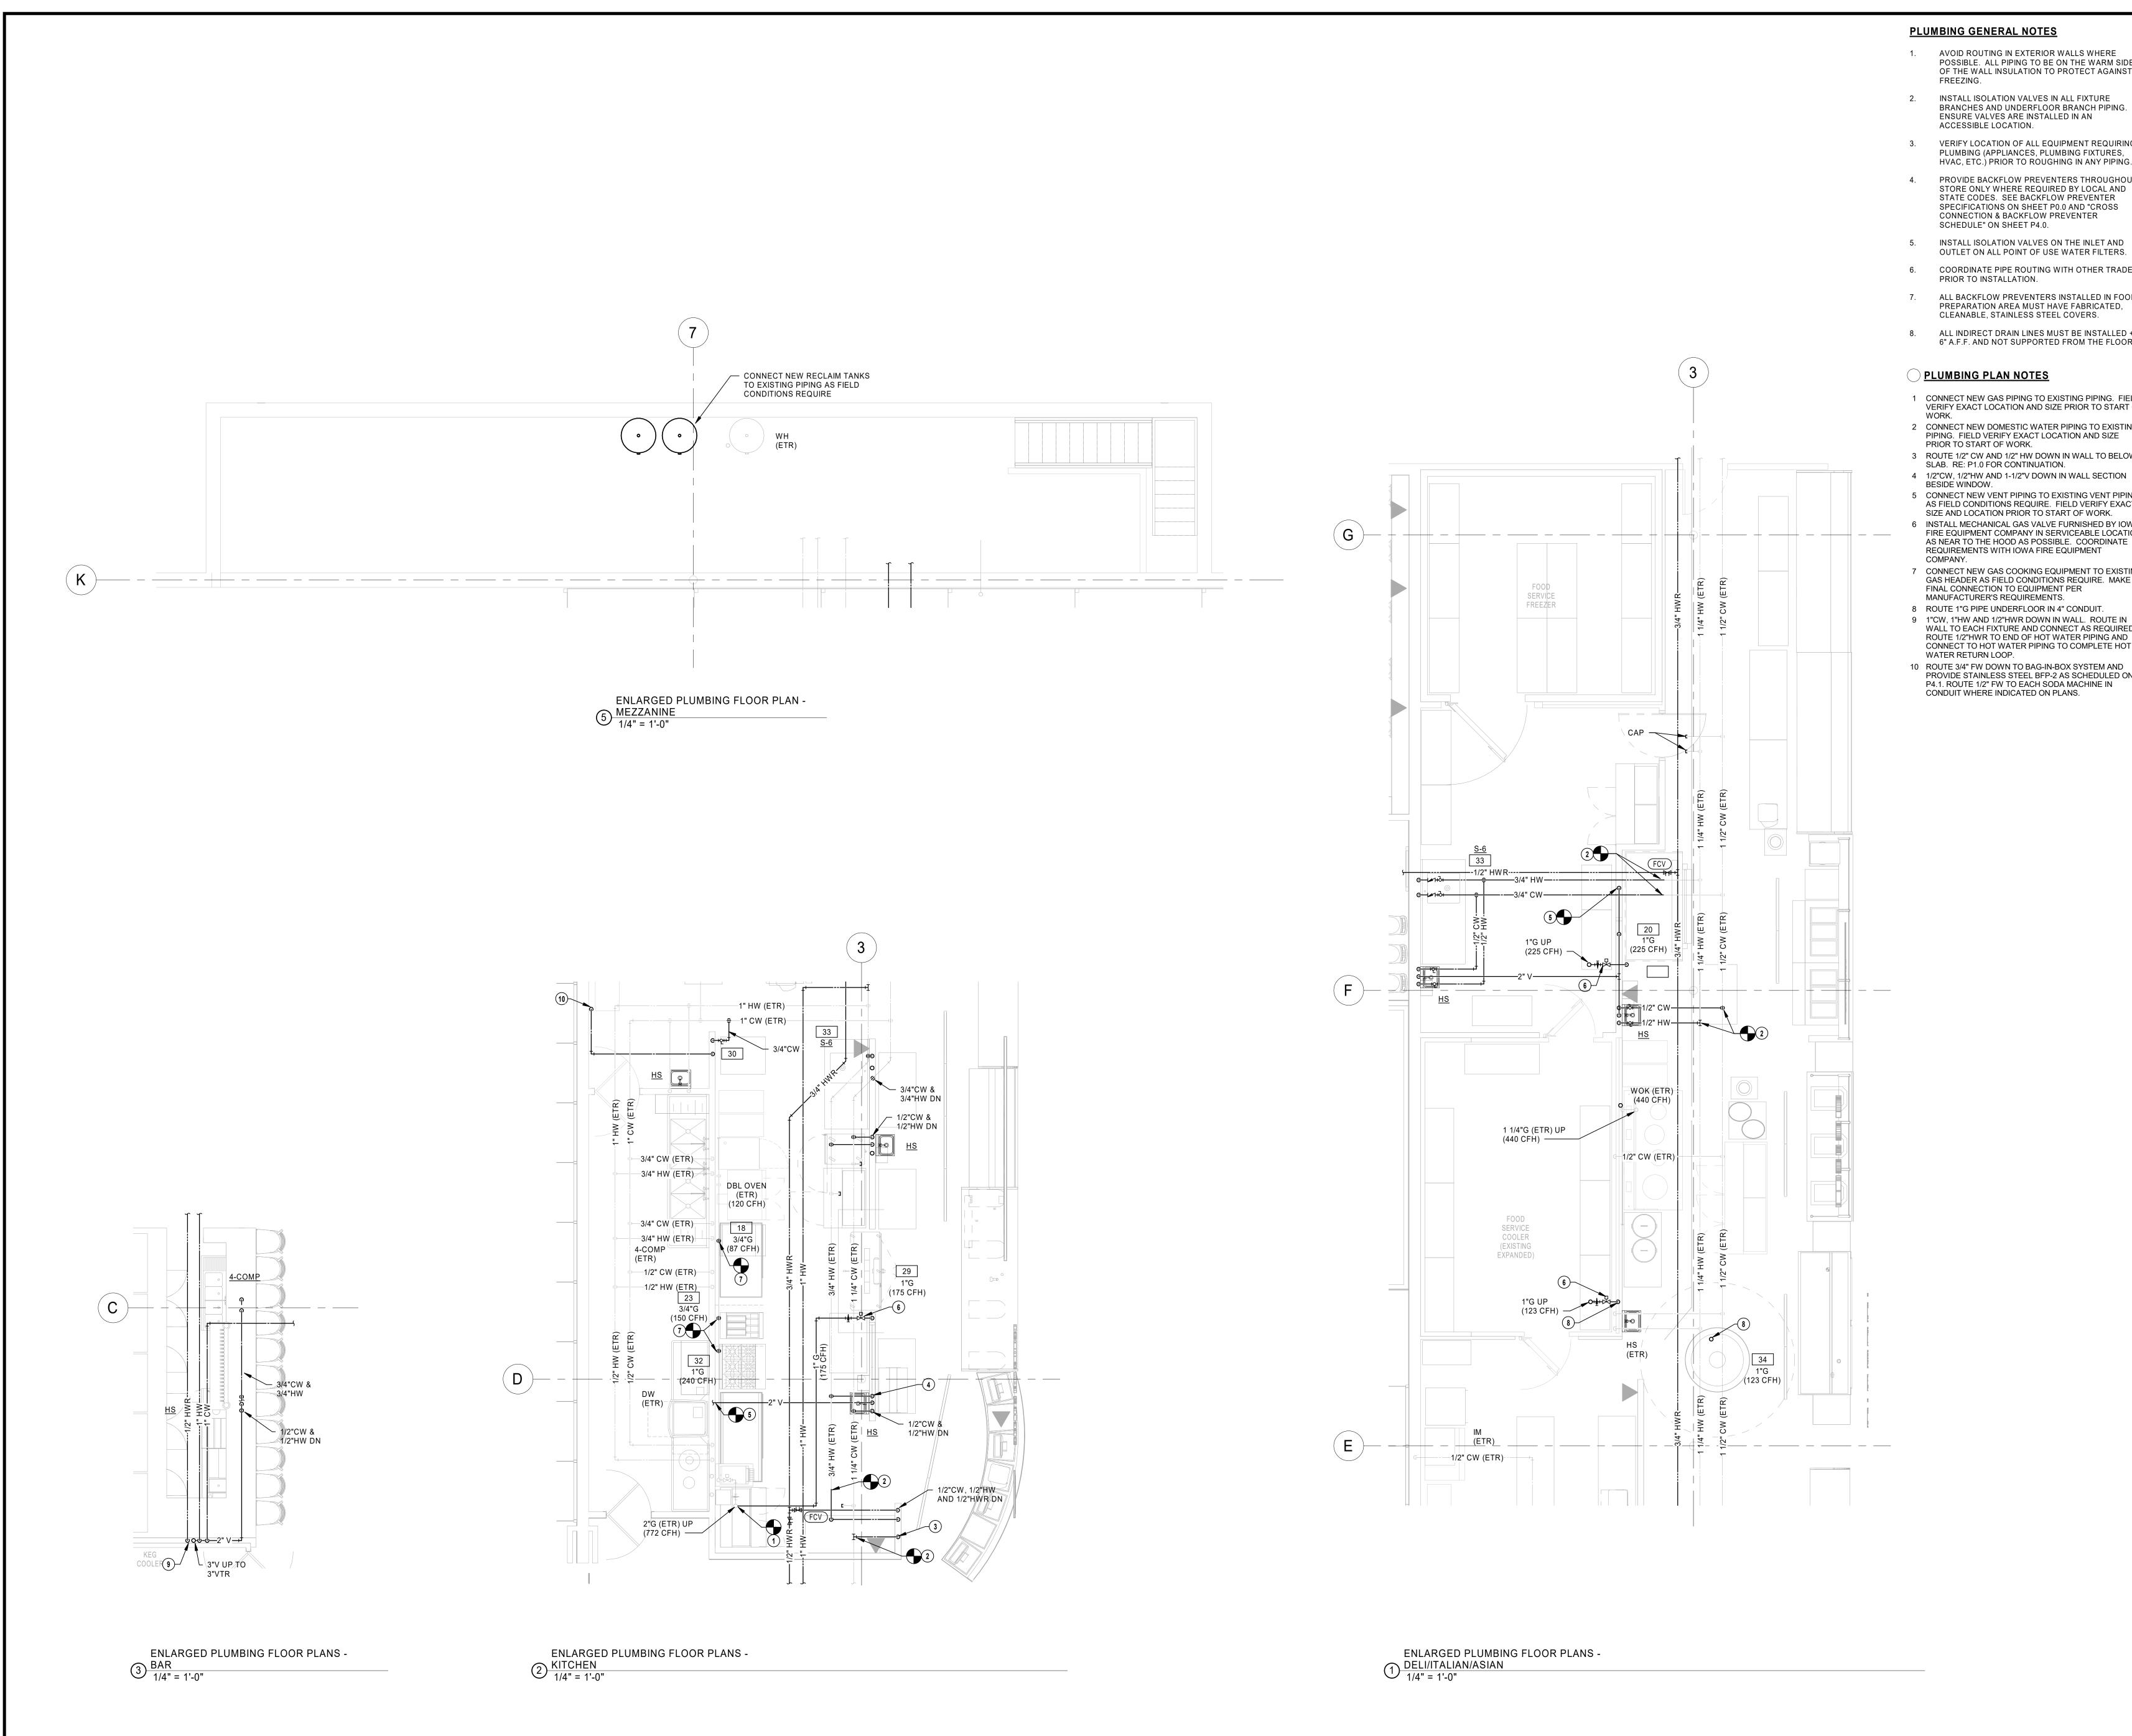
1 1/4"HW DN -

HEADER -

1 1/4"SCW -

1 1/2"CW

H



 AVOID ROUTING IN EXTERIOR WALLS WHERE POSSIBLE. ALL PIPING TO BE ON THE WARM SIDE OF THE WALL INSULATION TO PROTECT AGAINST

INSTALL ISOLATION VALVES IN ALL FIXTURE BRANCHES AND UNDERFLOOR BRANCH PIPING.

ENSURE VALVES ARE INSTALLED IN AN ACCESSIBLE LOCATION. 3. VERIFY LOCATION OF ALL EQUIPMENT REQUIRING

PLUMBING (APPLIANCES, PLUMBING FIXTURES, HVAC, ETC.) PRIOR TO ROUGHING IN ANY PIPING. 4. PROVIDE BACKFLOW PREVENTERS THROUGHOUT

5. INSTALL ISOLATION VALVES ON THE INLET AND OUTLET ON ALL POINT OF USE WATER FILTERS.

6. COORDINATE PIPE ROUTING WITH OTHER TRADES PRIOR TO INSTALLATION.

7. ALL BACKFLOW PREVENTERS INSTALLED IN FOOD PREPARATION AREA MUST HAVE FABRICATED,

8. ALL INDIRECT DRAIN LINES MUST BE INSTALLED +/-6" A.F.F. AND NOT SUPPORTED FROM THE FLOOR.

PLUMBING PLAN NOTES

1 CONNECT NEW GAS PIPING TO EXISTING PIPING. FIELD VERIFY EXACT LOCATION AND SIZE PRIOR TO START OF

2 CONNECT NEW DOMESTIC WATER PIPING TO EXISTING PIPING. FIELD VERIFY EXACT LOCATION AND SIZE

3 ROUTE 1/2" CW AND 1/2" HW DOWN IN WALL TO BELOW SLAB. RE: P1.0 FOR CONTINUATION.

4 1/2"CW, 1/2"HW AND 1-1/2"V DOWN IN WALL SECTION

5 CONNECT NEW VENT PIPING TO EXISTING VENT PIPING AS FIELD CONDITIONS REQUIRE. FIELD VERIFY EXACT SIZE AND LOCATION PRIOR TO START OF WORK. 6 INSTALL MECHANICAL GAS VALVE FURNISHED BY IOWA FIRE EQUIPMENT COMPANY IN SERVICEABLE LOCATION AS NEAR TO THE HOOD AS POSSIBLE. COORDINATE REQUIREMENTS WITH IOWA FIRE EQUIPMENT

7 CONNECT NEW GAS COOKING EQUIPMENT TO EXISTING GAS HEADER AS FIELD CONDITIONS REQUIRE. MAKE FINAL CONNECTION TO EQUIPMENT PER

MANUFACTURER'S REQUIREMENTS. 8 ROUTE 1"G PIPE UNDERFLOOR IN 4" CONDUIT.

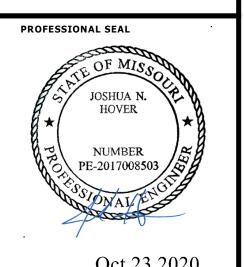
9 1"CW, 1"HW AND 1/2"HWR DOWN IN WALL. ROUTE IN WALL TO EACH FIXTURE AND CONNECT AS REQUIRED. ROUTE 1/2"HWR TO END OF HOT WATER PIPING AND CONNECT TO HOT WATER PIPING TO COMPLETE HOT

10 ROUTE 3/4" FW DOWN TO BAG-IN-BOX SYSTEM AND PROVIDE STAINLESS STEEL BFP-2 AS SCHEDULED ON P4.1. ROUTE 1/2" FW TO EACH SODA MACHINE IN CONDUIT WHERE INDICATED ON PLANS.

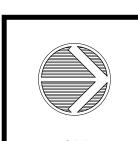
HENDERSON 8345 LENEXA DRIVE, SUITE 300 LENEXA, KS 66214 TEL 913.742.5000 FAX 913.742.5001 WWW.HENDERSONENGINEERS.COM 1950003081 MO. CORPORATE NO: E-556D EXPIRES 12/31/2020

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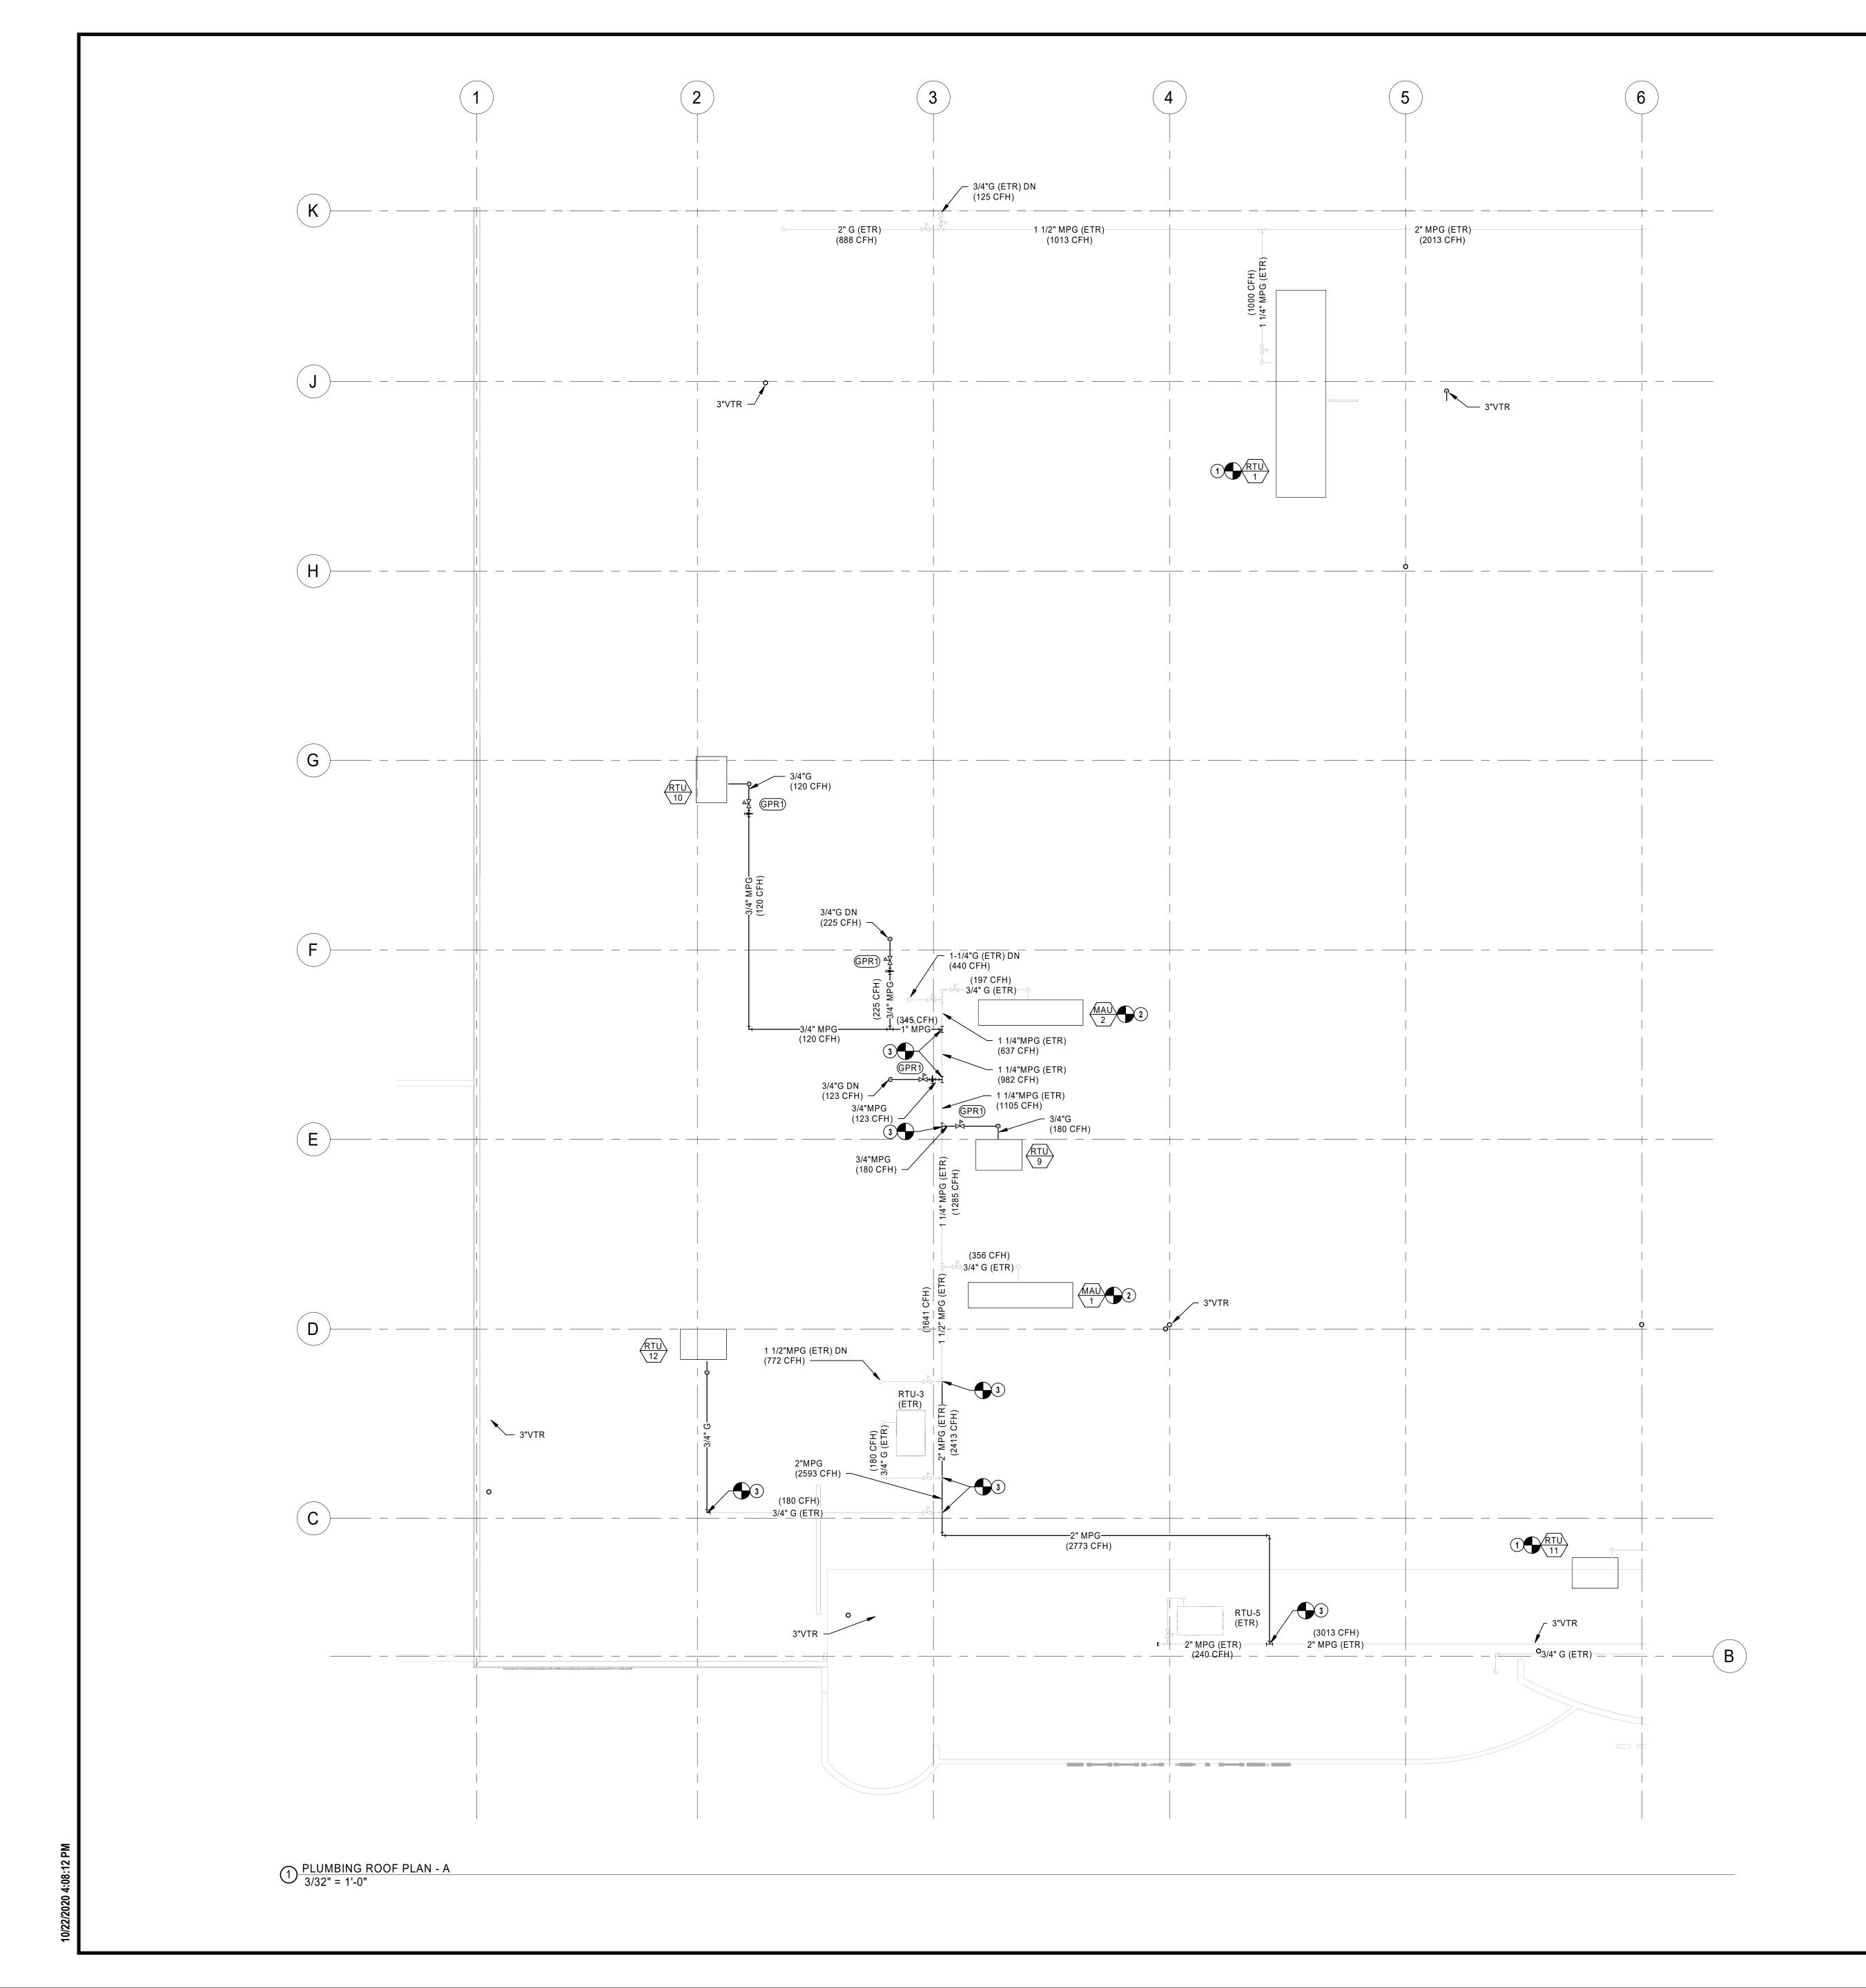




PLUMBING ENLARGED PLANS

DRAWN BY: SCALE: JOB NUMBER: AS NOTED

P2.6



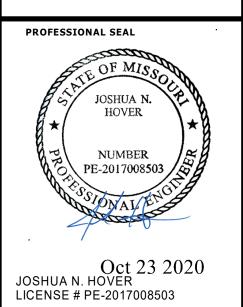
CONNECT NEW ROOFTOP UNIT TO EXISTING GAS PIPING AS FIELD CONDITIONS REQUIRE.

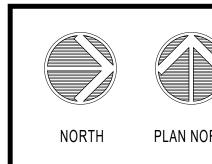
2 CONNECT NEW MAKE-UP AIR UNIT TO EXISTING GAS PIPING AS FIELD CONDITIONS REQUIRE. 3 CONNECT NEW GAS PIPING TO EXISTING PIPING. FIELD VERIFY EXACT LOCATION AND SIZE PRIOR TO START OF WORK.

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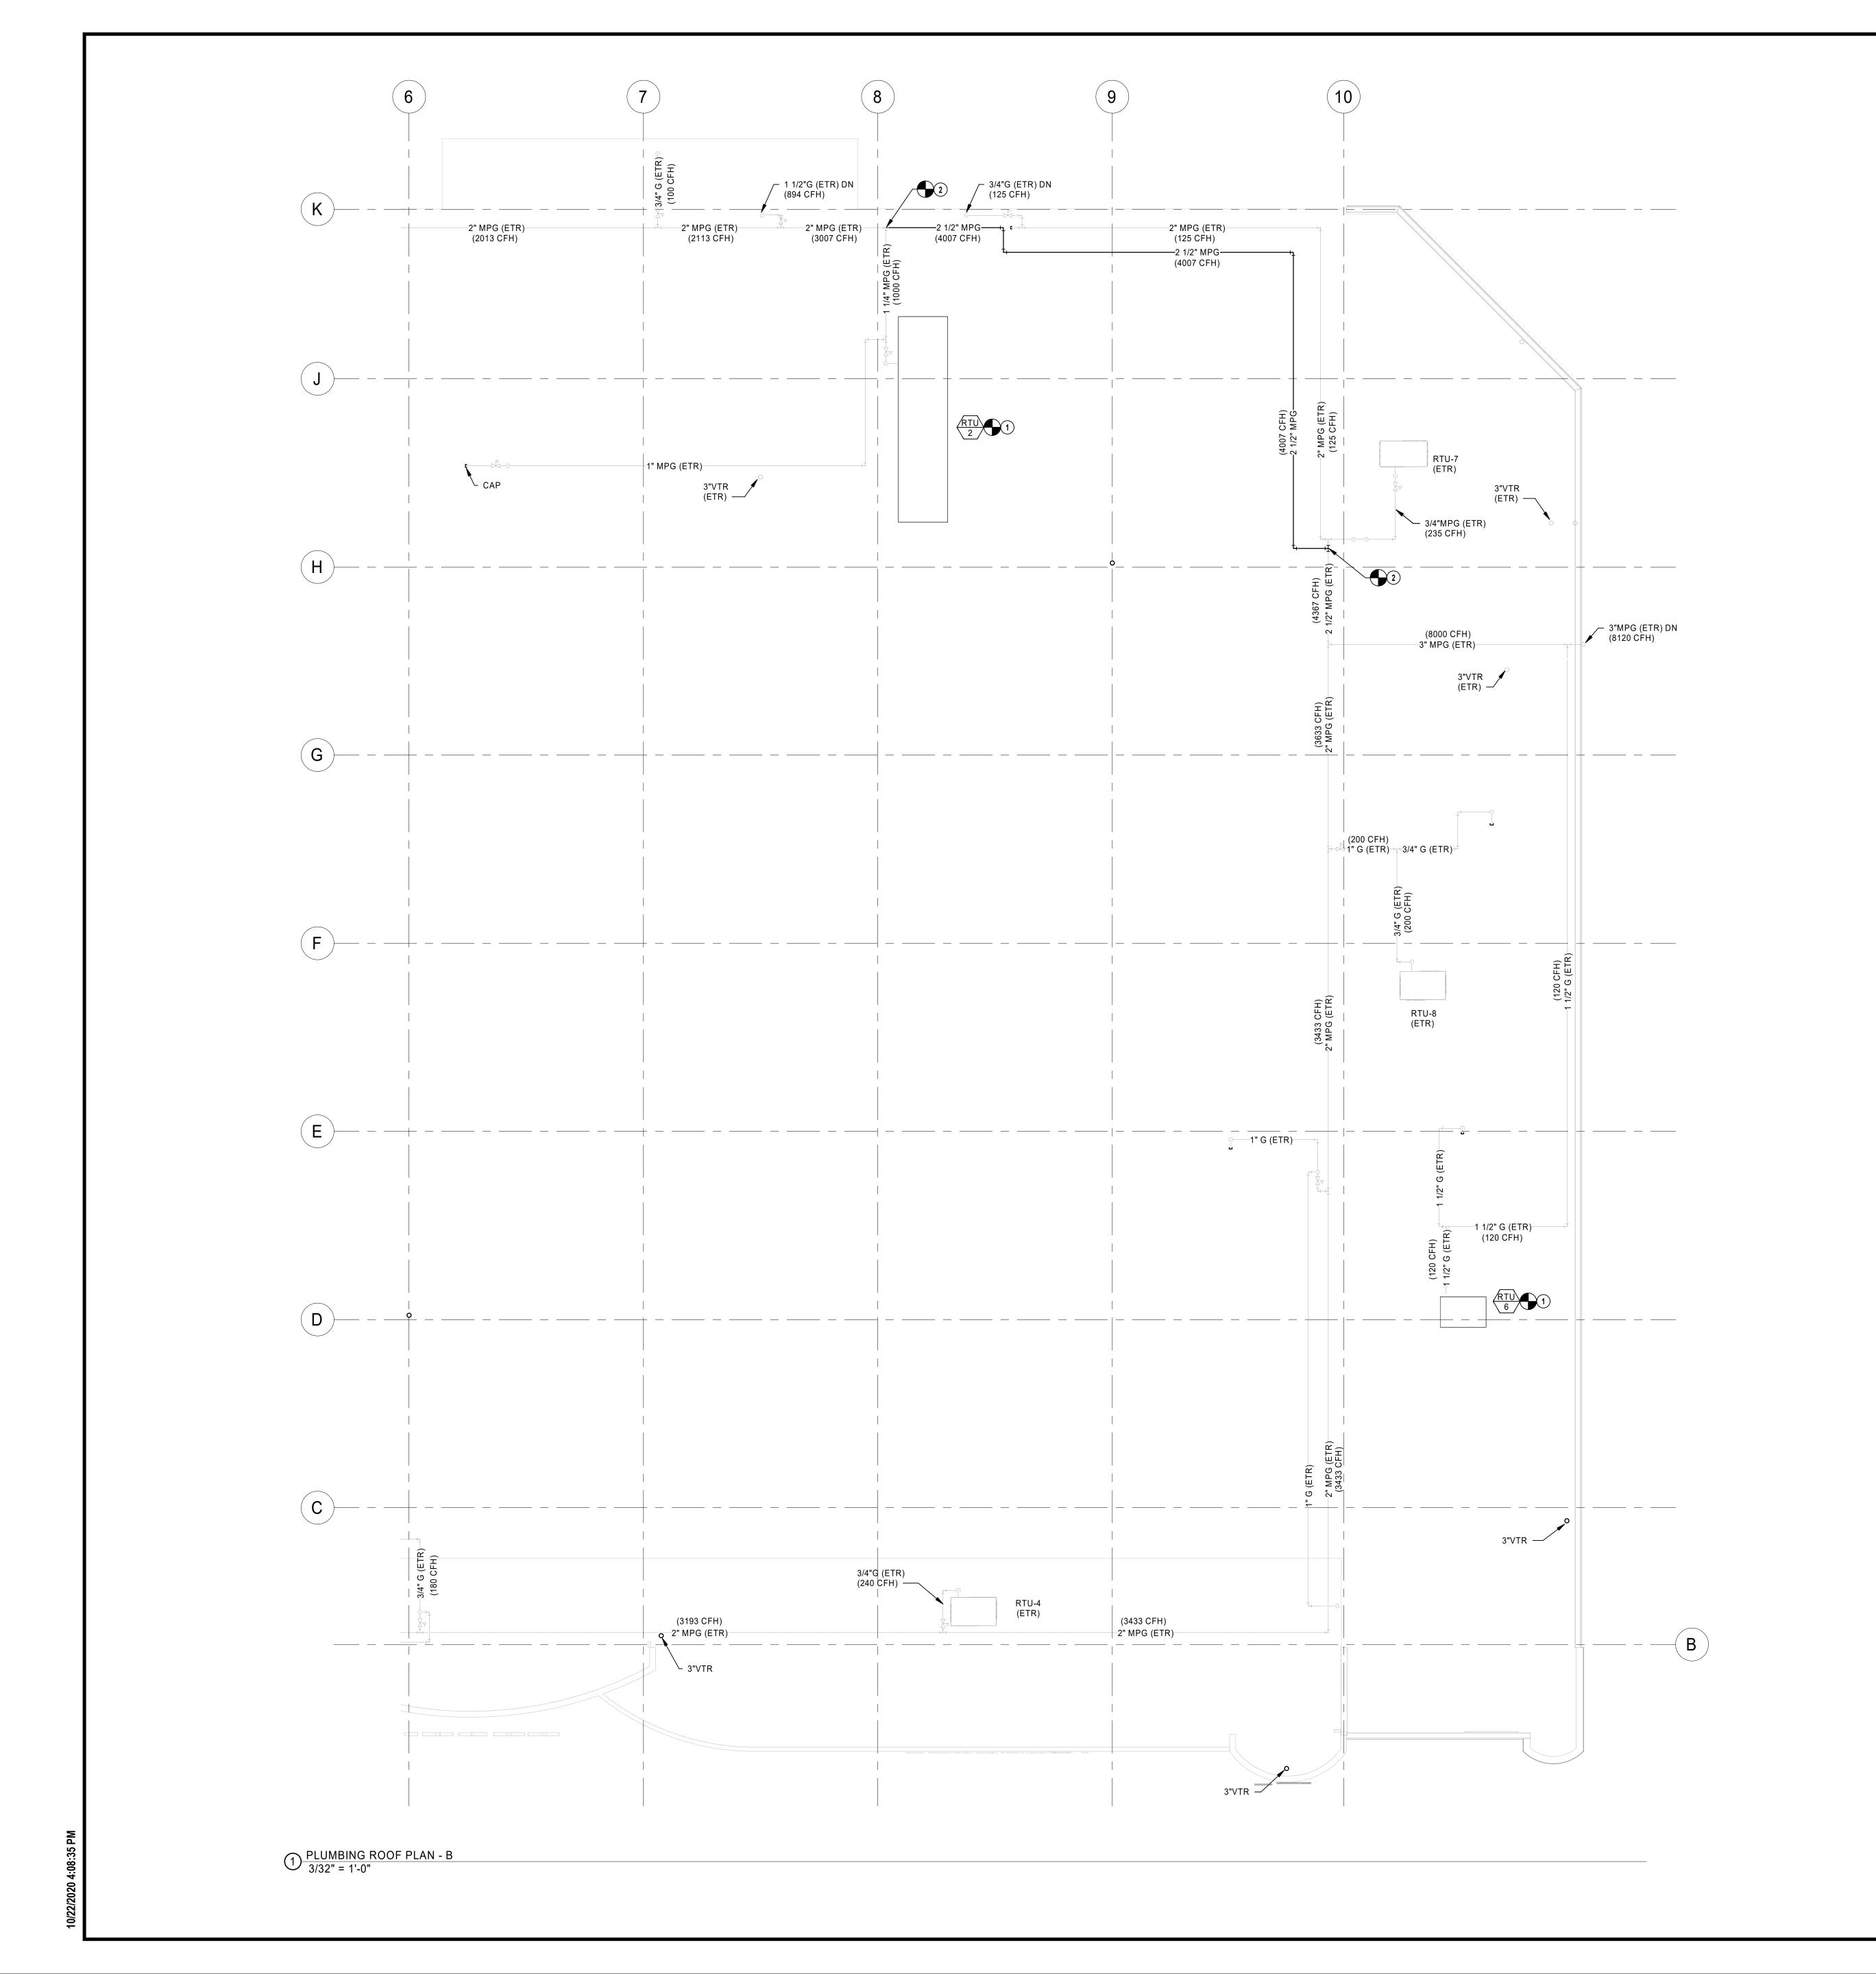
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PLUMBING ROOF PLAN - A

PROJECT MANAGER	CHECKED BY:
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AS NOTED	62930547
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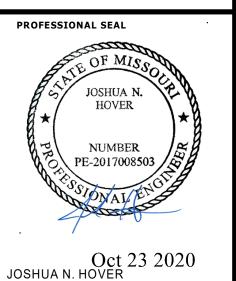
CONNECT NEW ROOFTOP UNIT TO EXISTING GAS PIPING AS FIELD CONDITIONS REQUIRE.

2 CONNECT NEW GAS PIPING TO EXISTING PIPING. FIELD VERIFY EXACT LOCATION AND SIZE PRIOR TO START OF WORK.

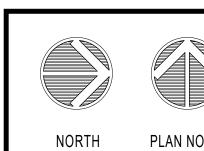
HENDERSON ENGINEERS 8345 LENEXA DRIVE, SUITE 300 LENEXA, KS 66214 TEL 913.742.5000 FAX 913.742.5001 WWW.HENDERSONENGINEERS.COM 1950003081 MO. CORPORATE NO: E-556D EXPIRES 12/31/2020

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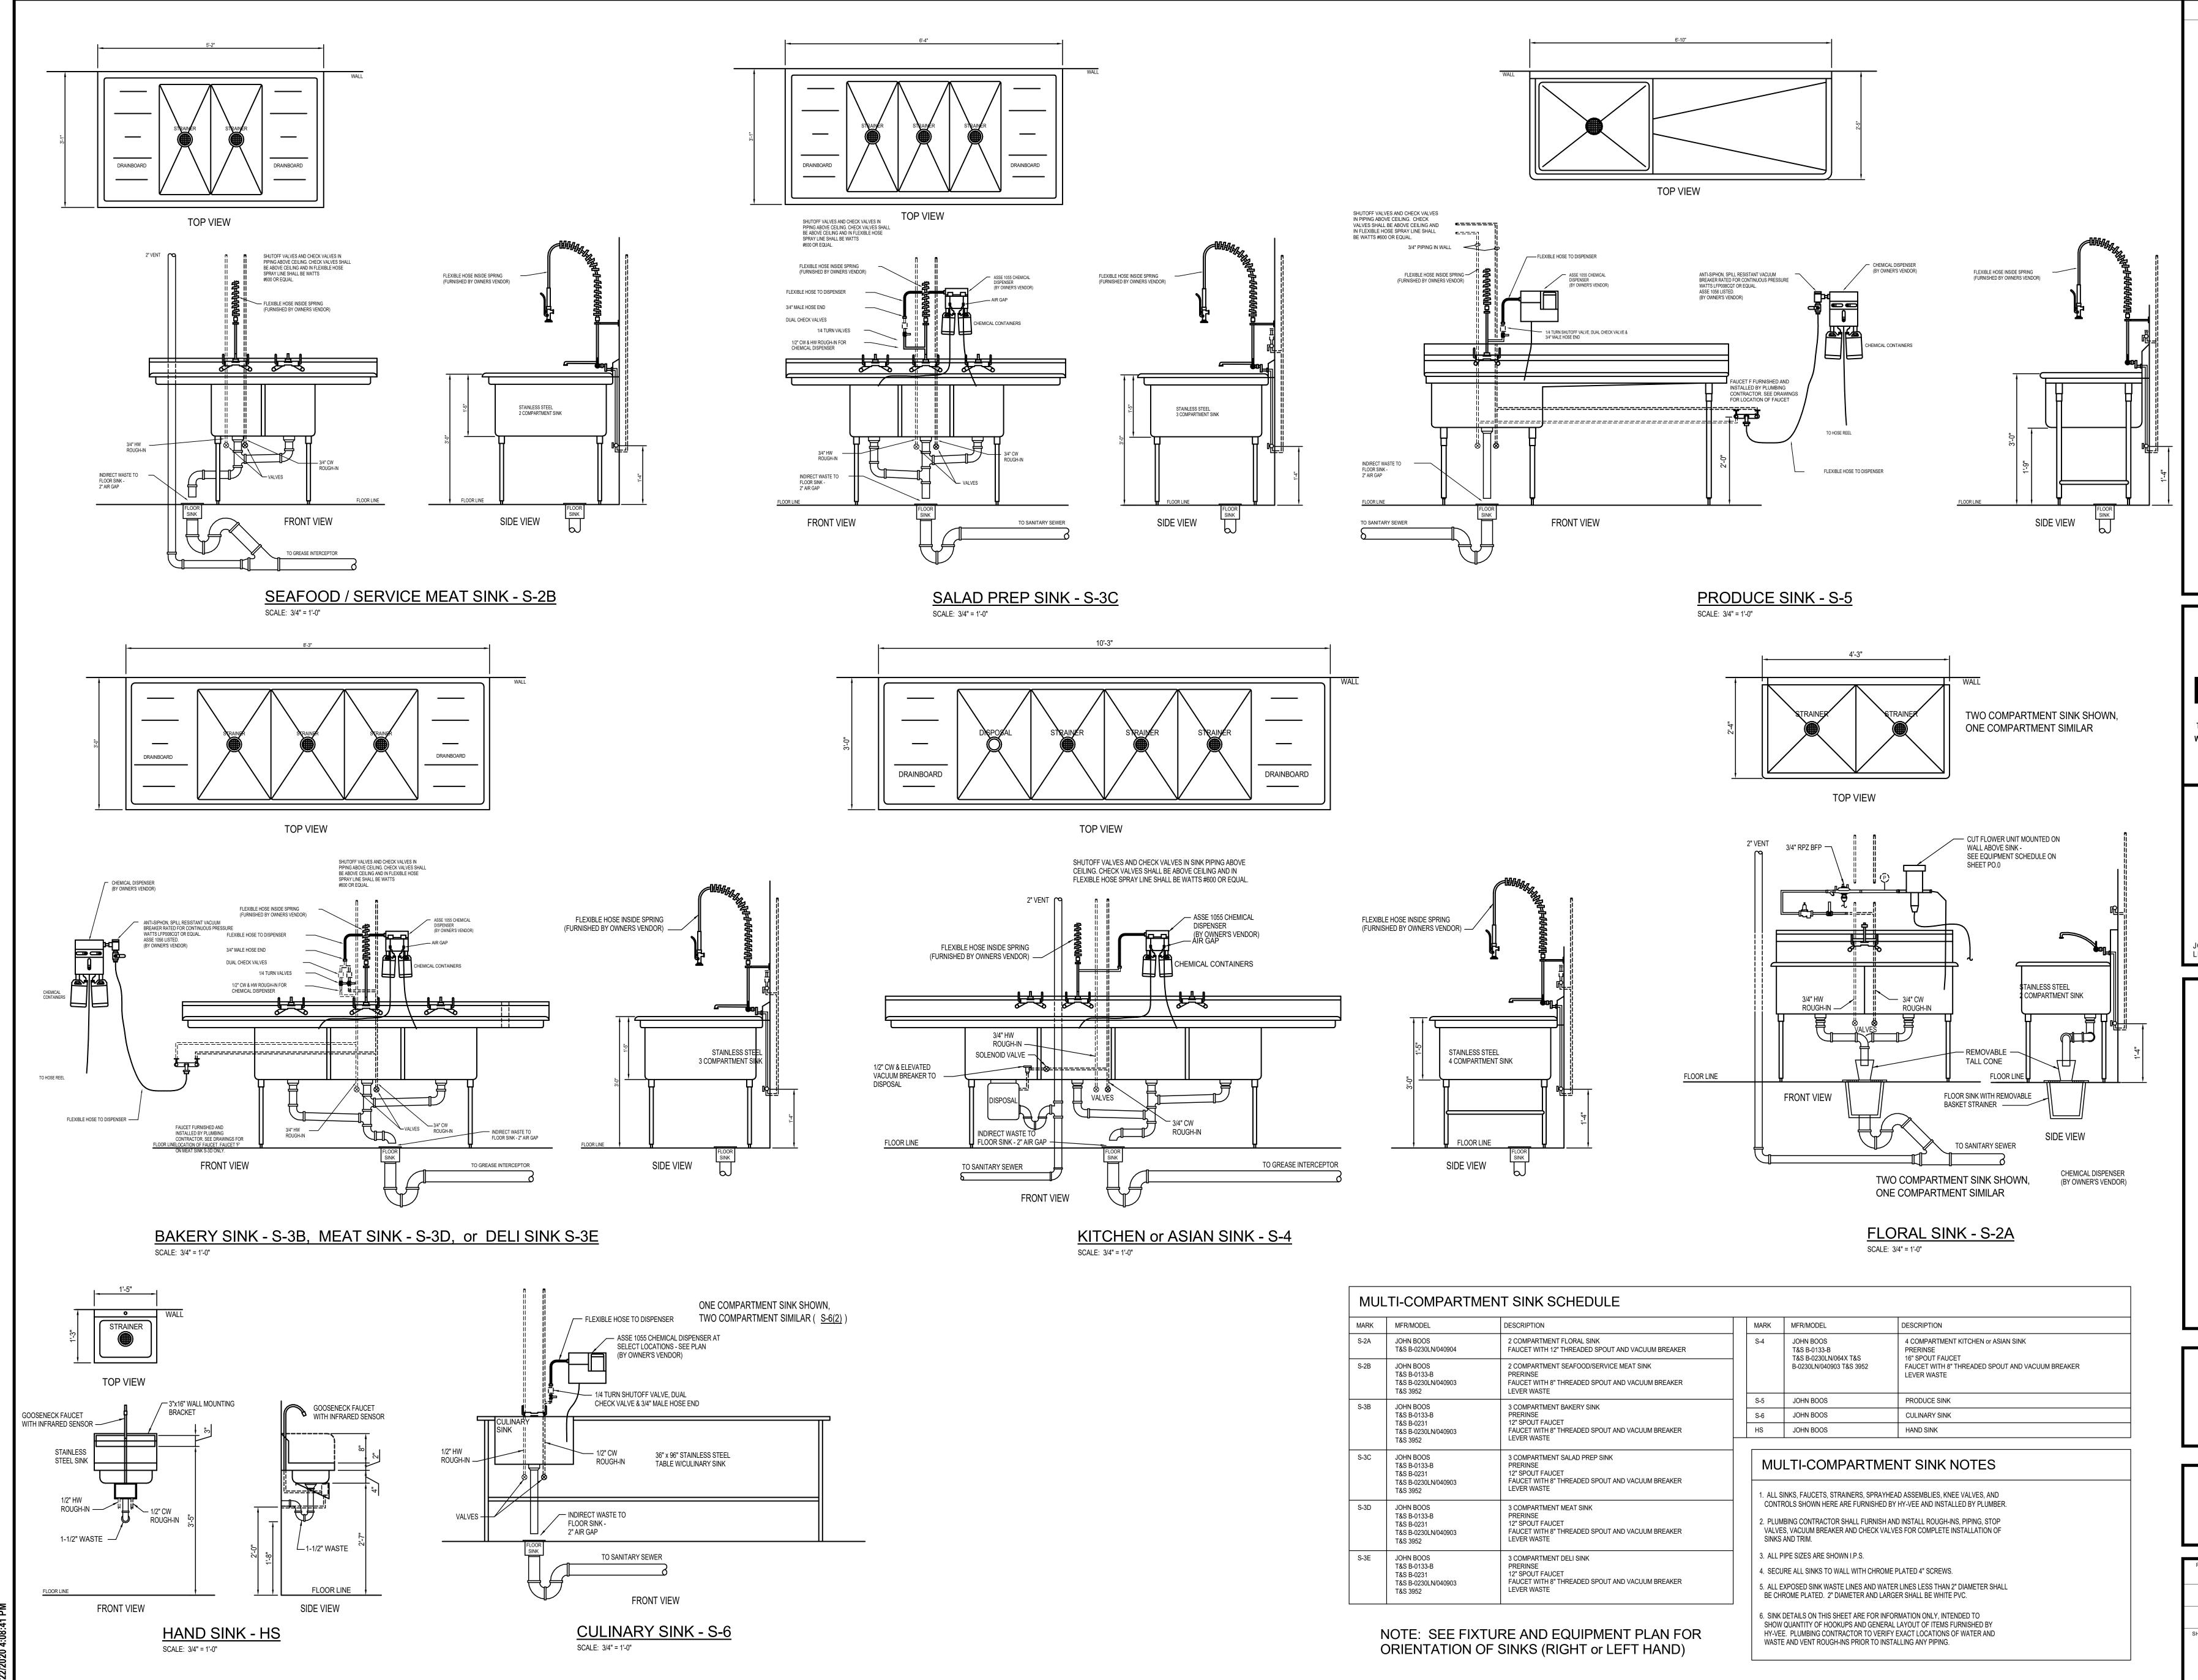


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PLUMBING ROOF PLAN - B

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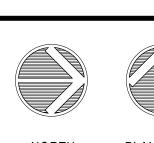


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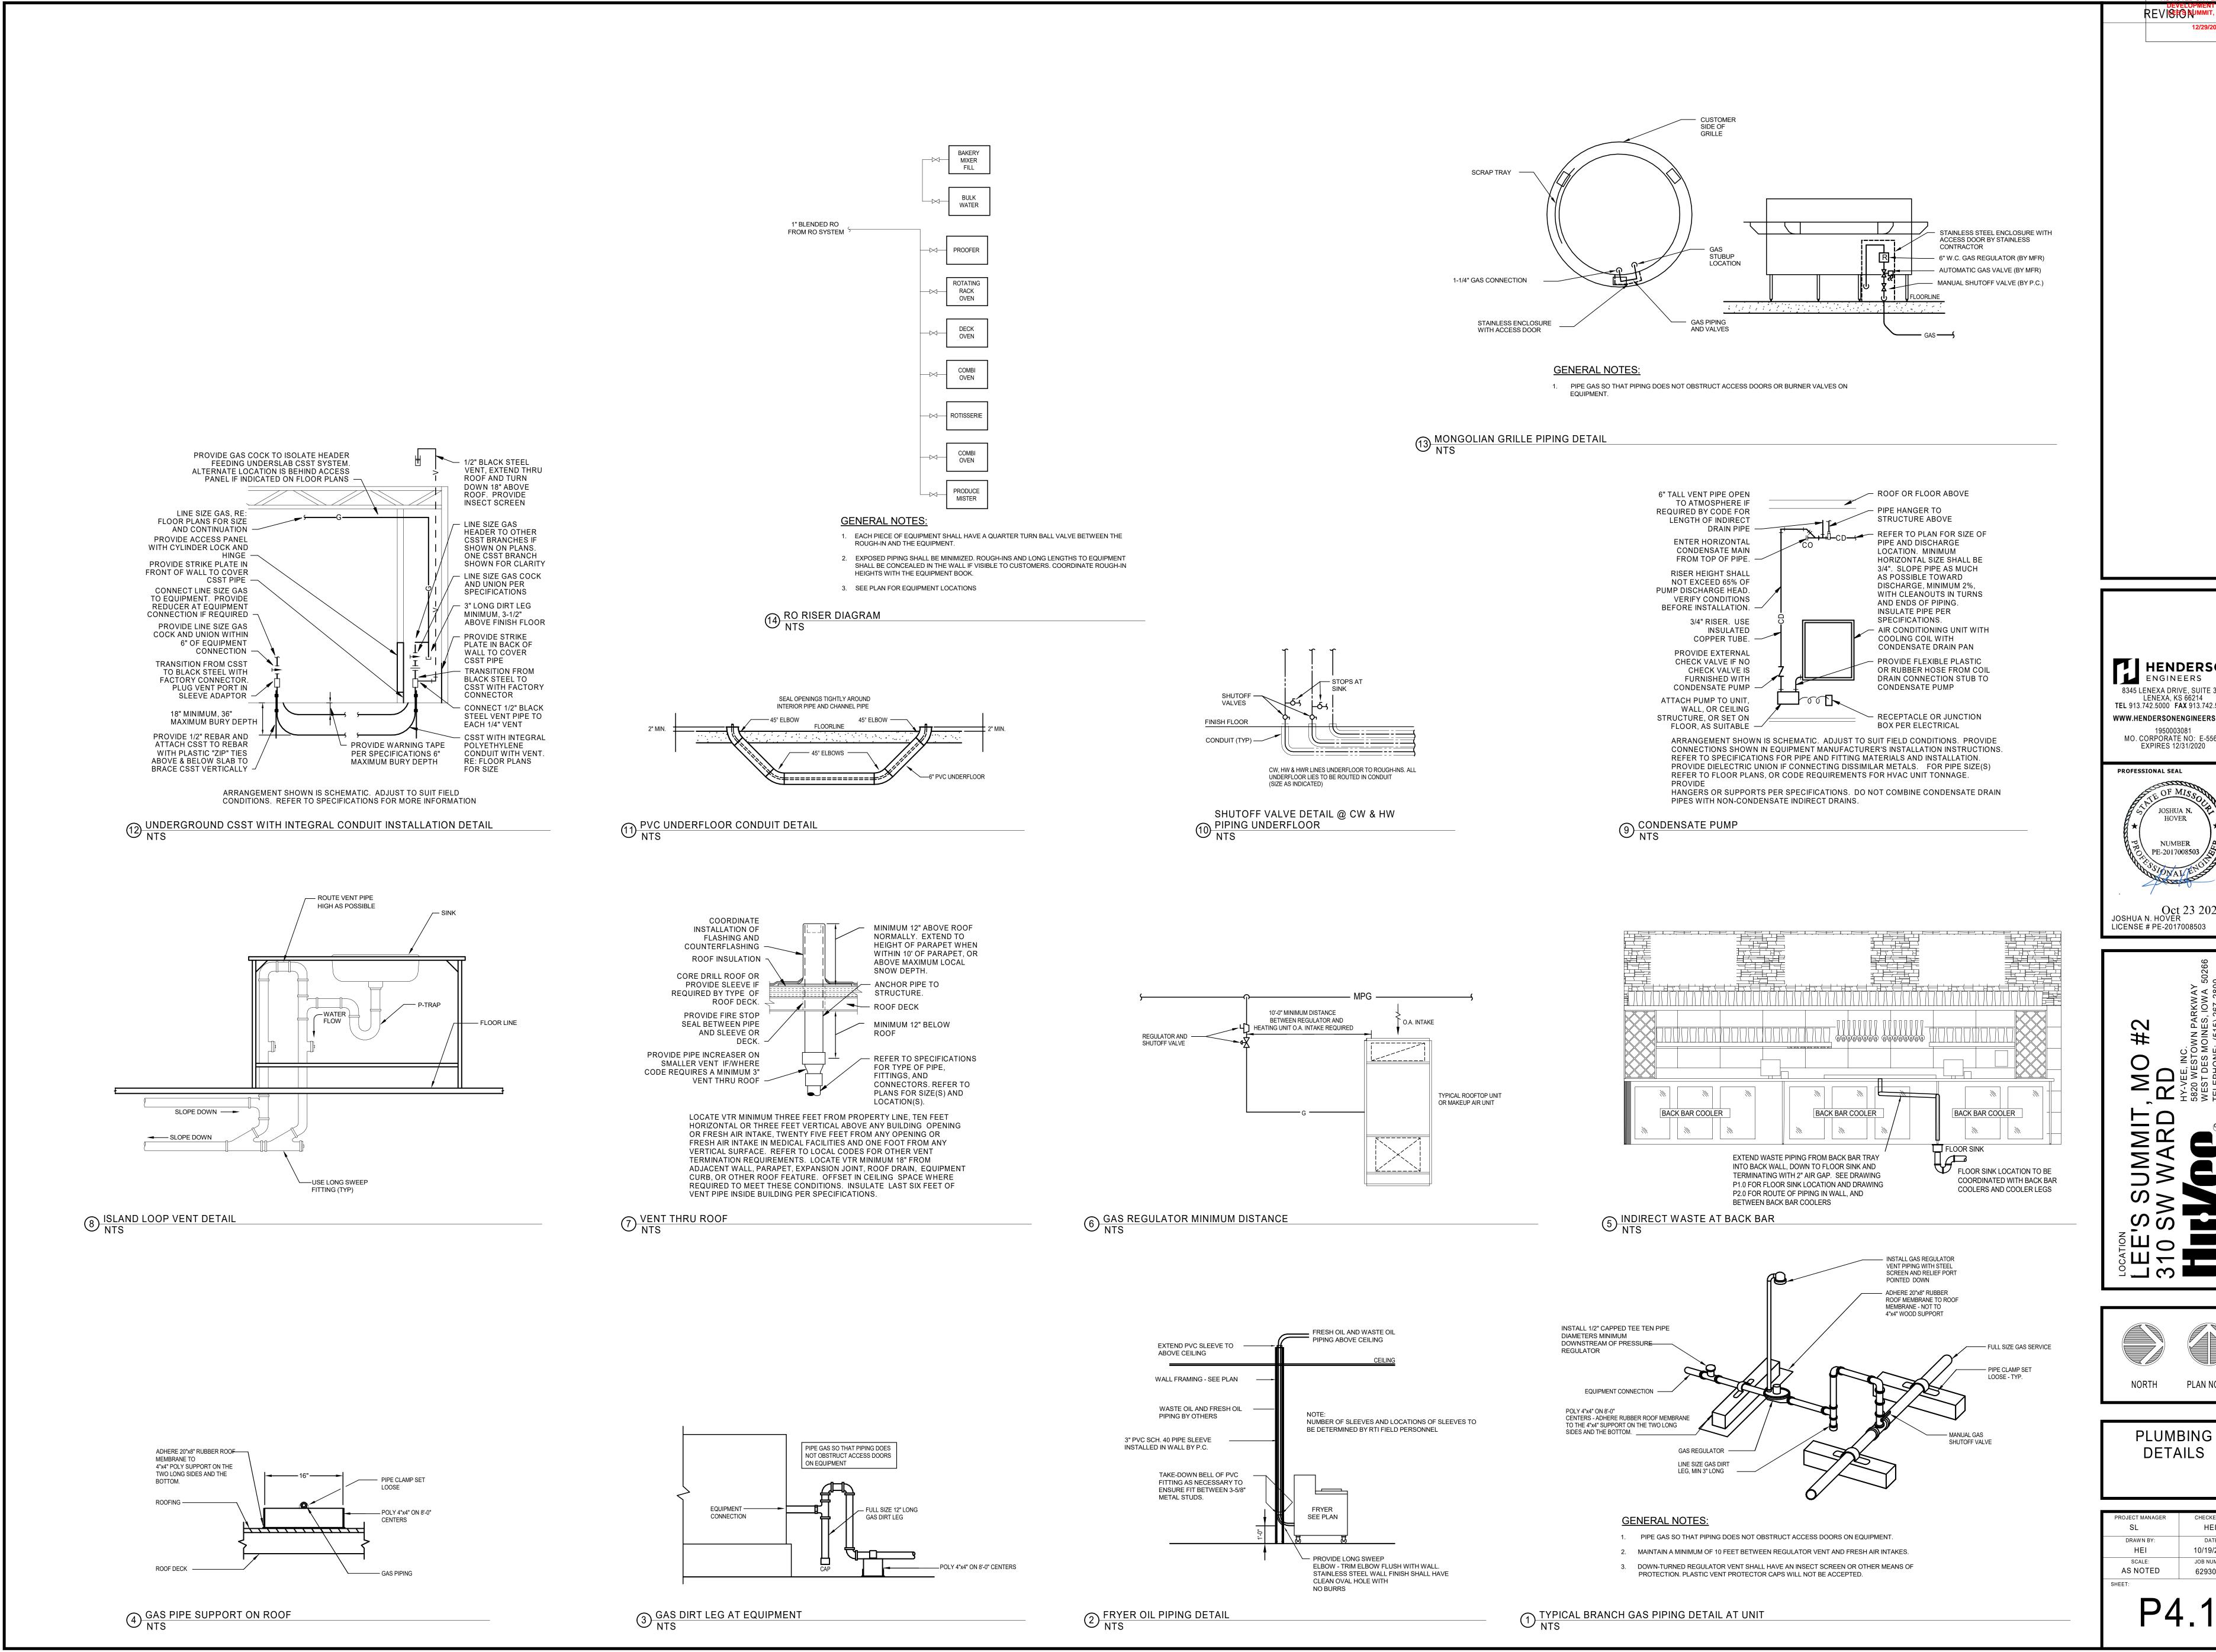
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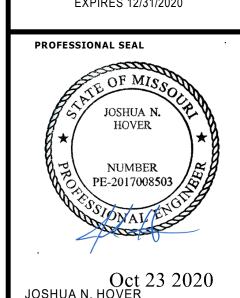
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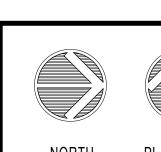


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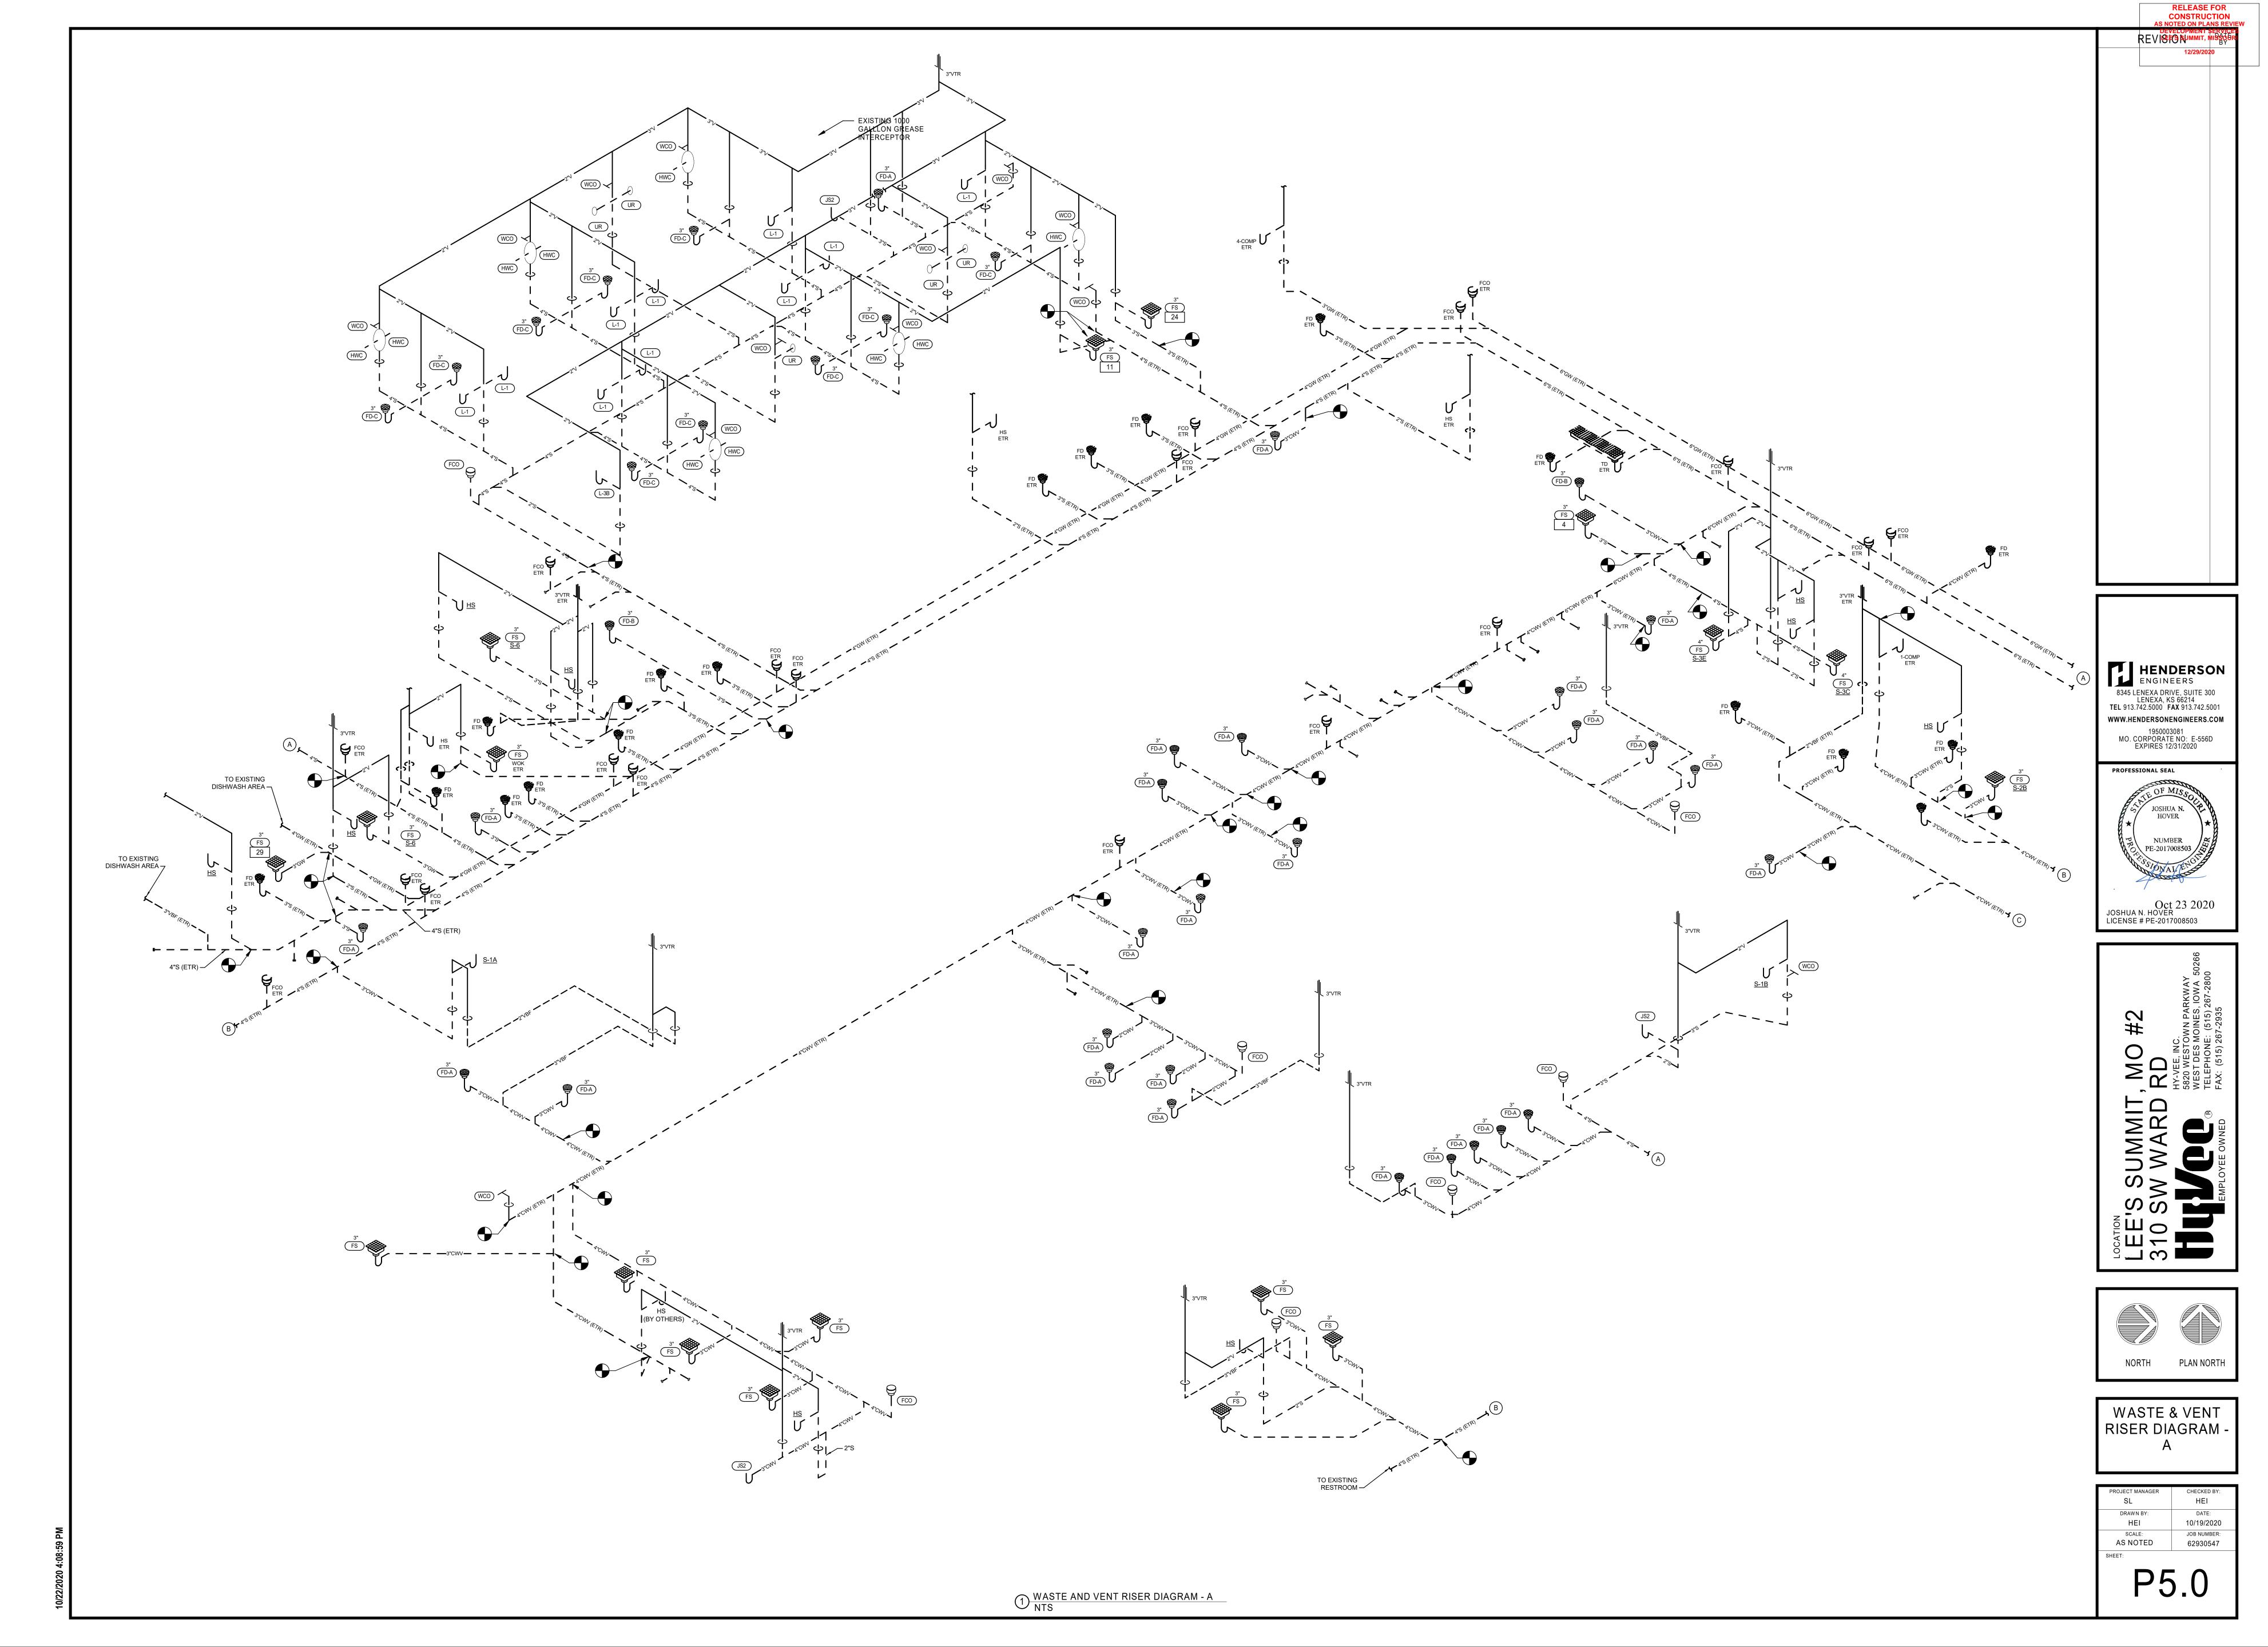


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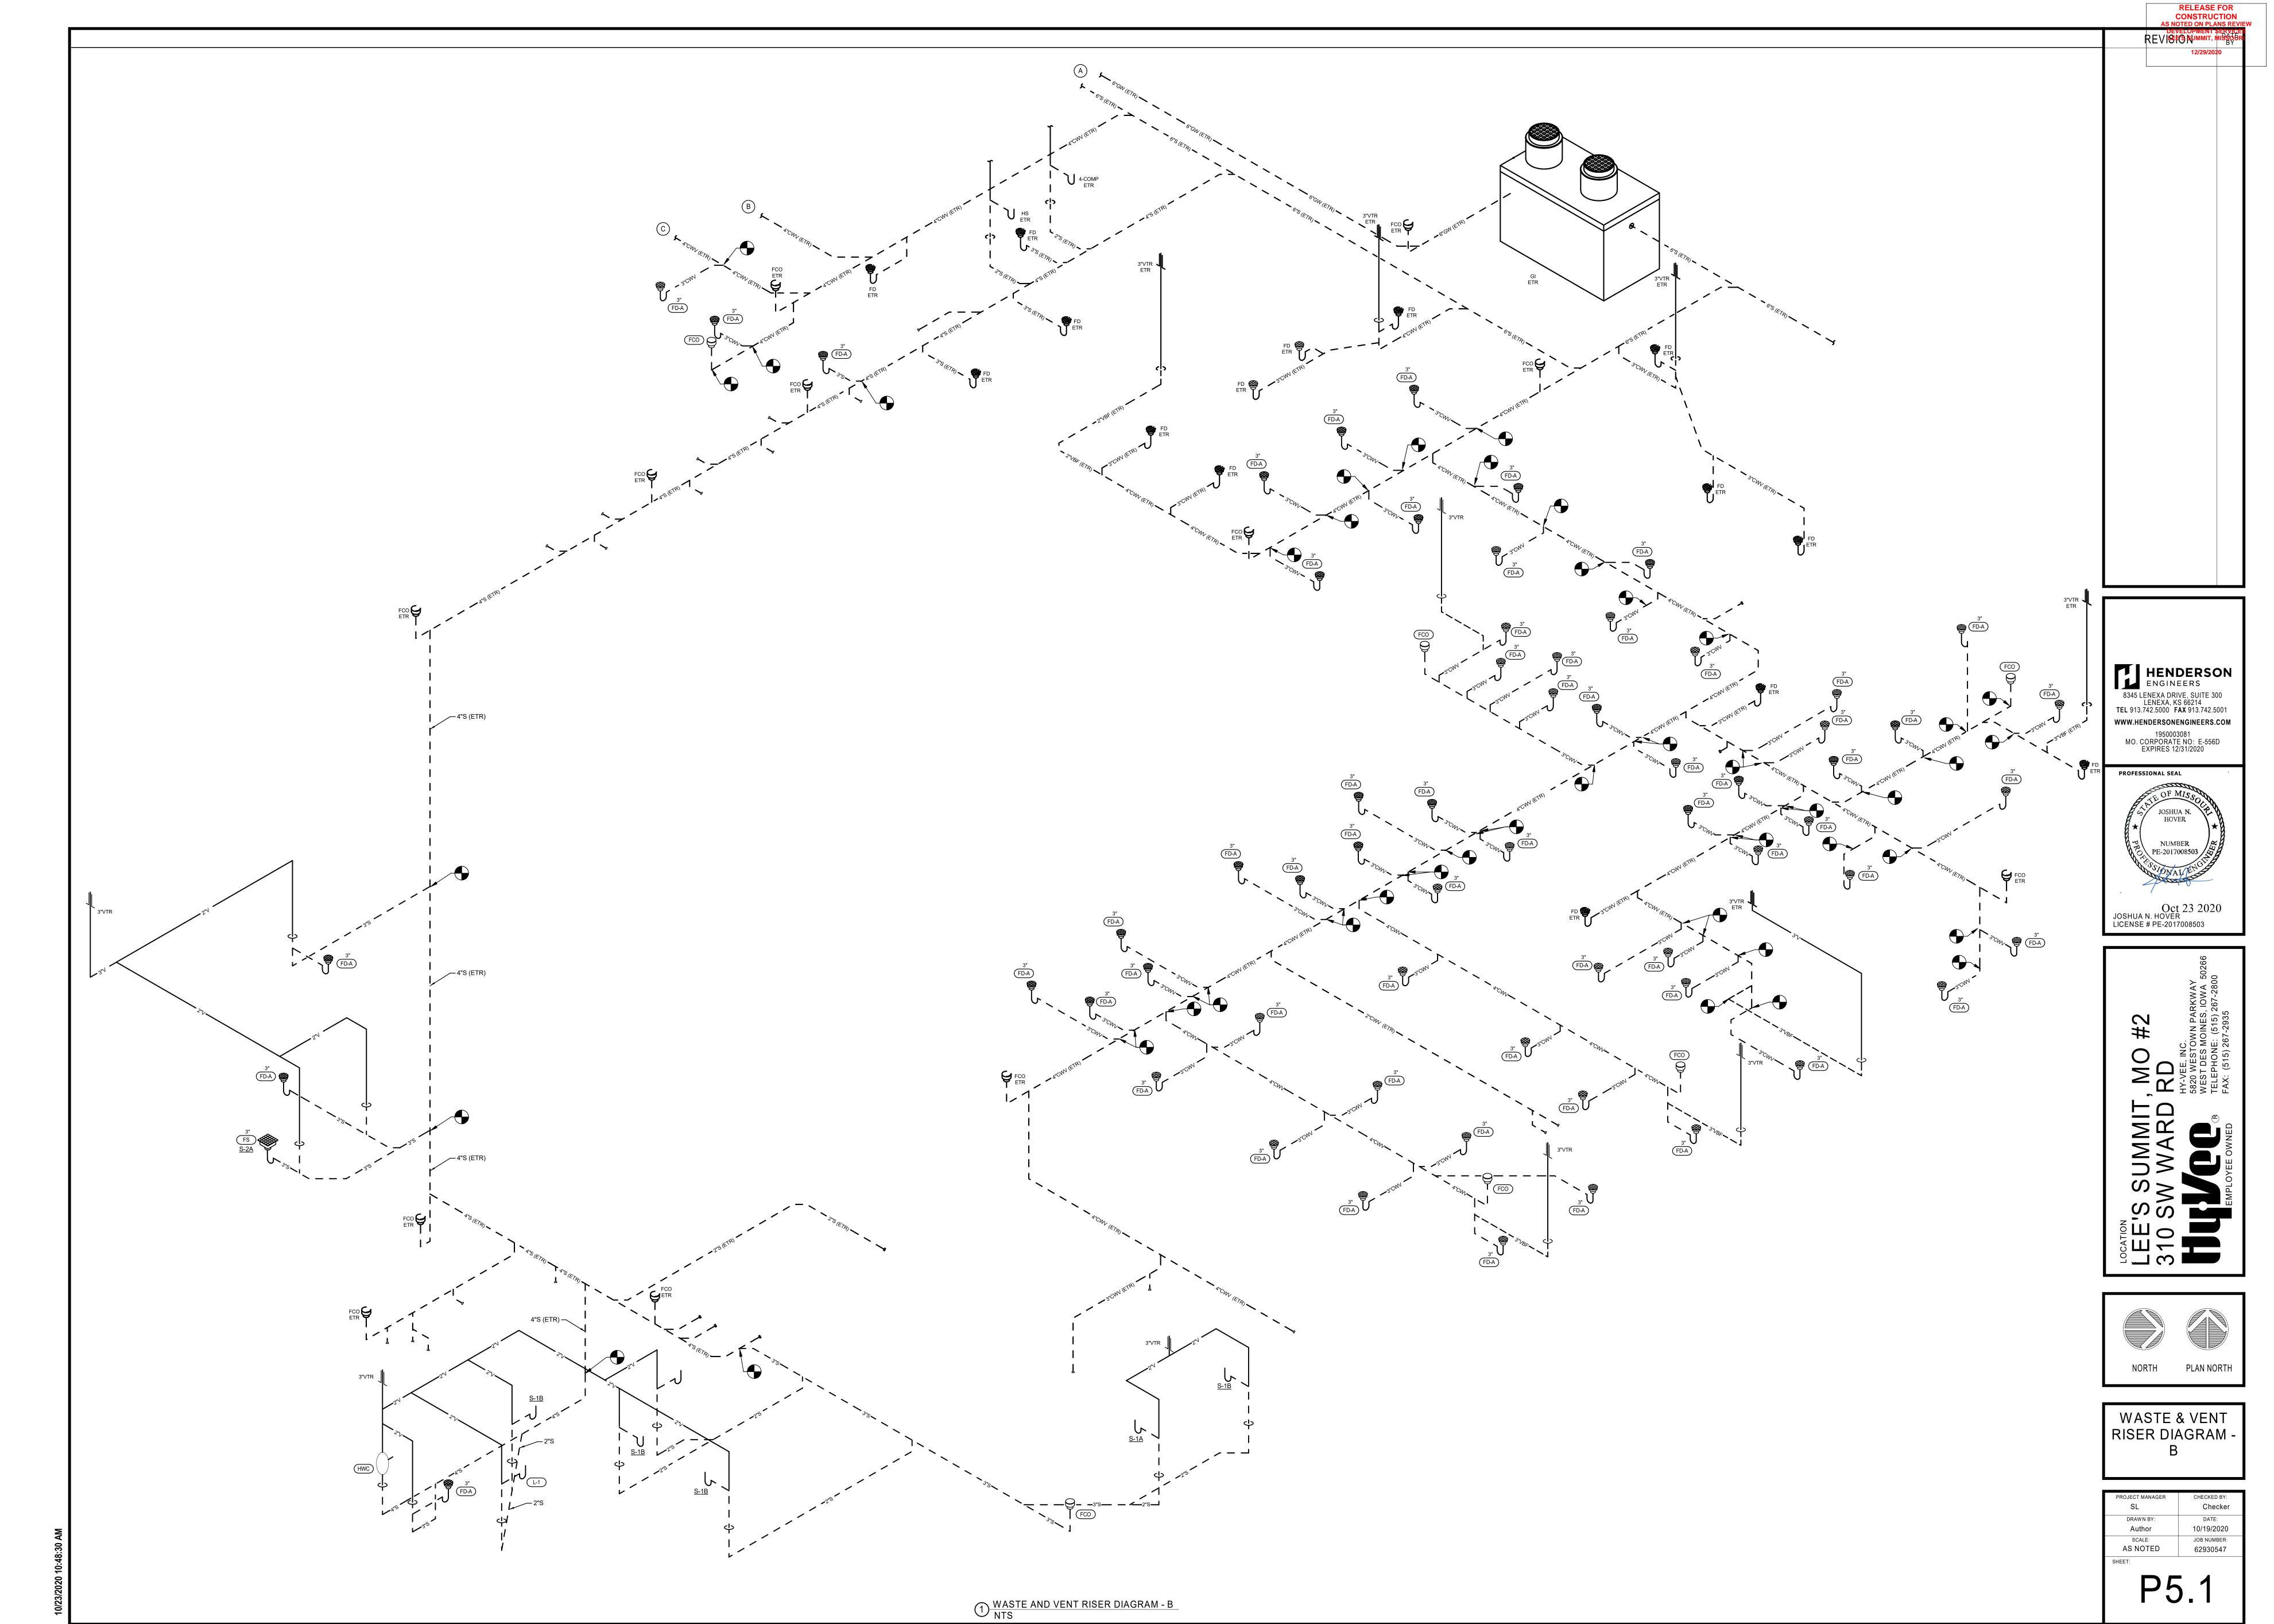


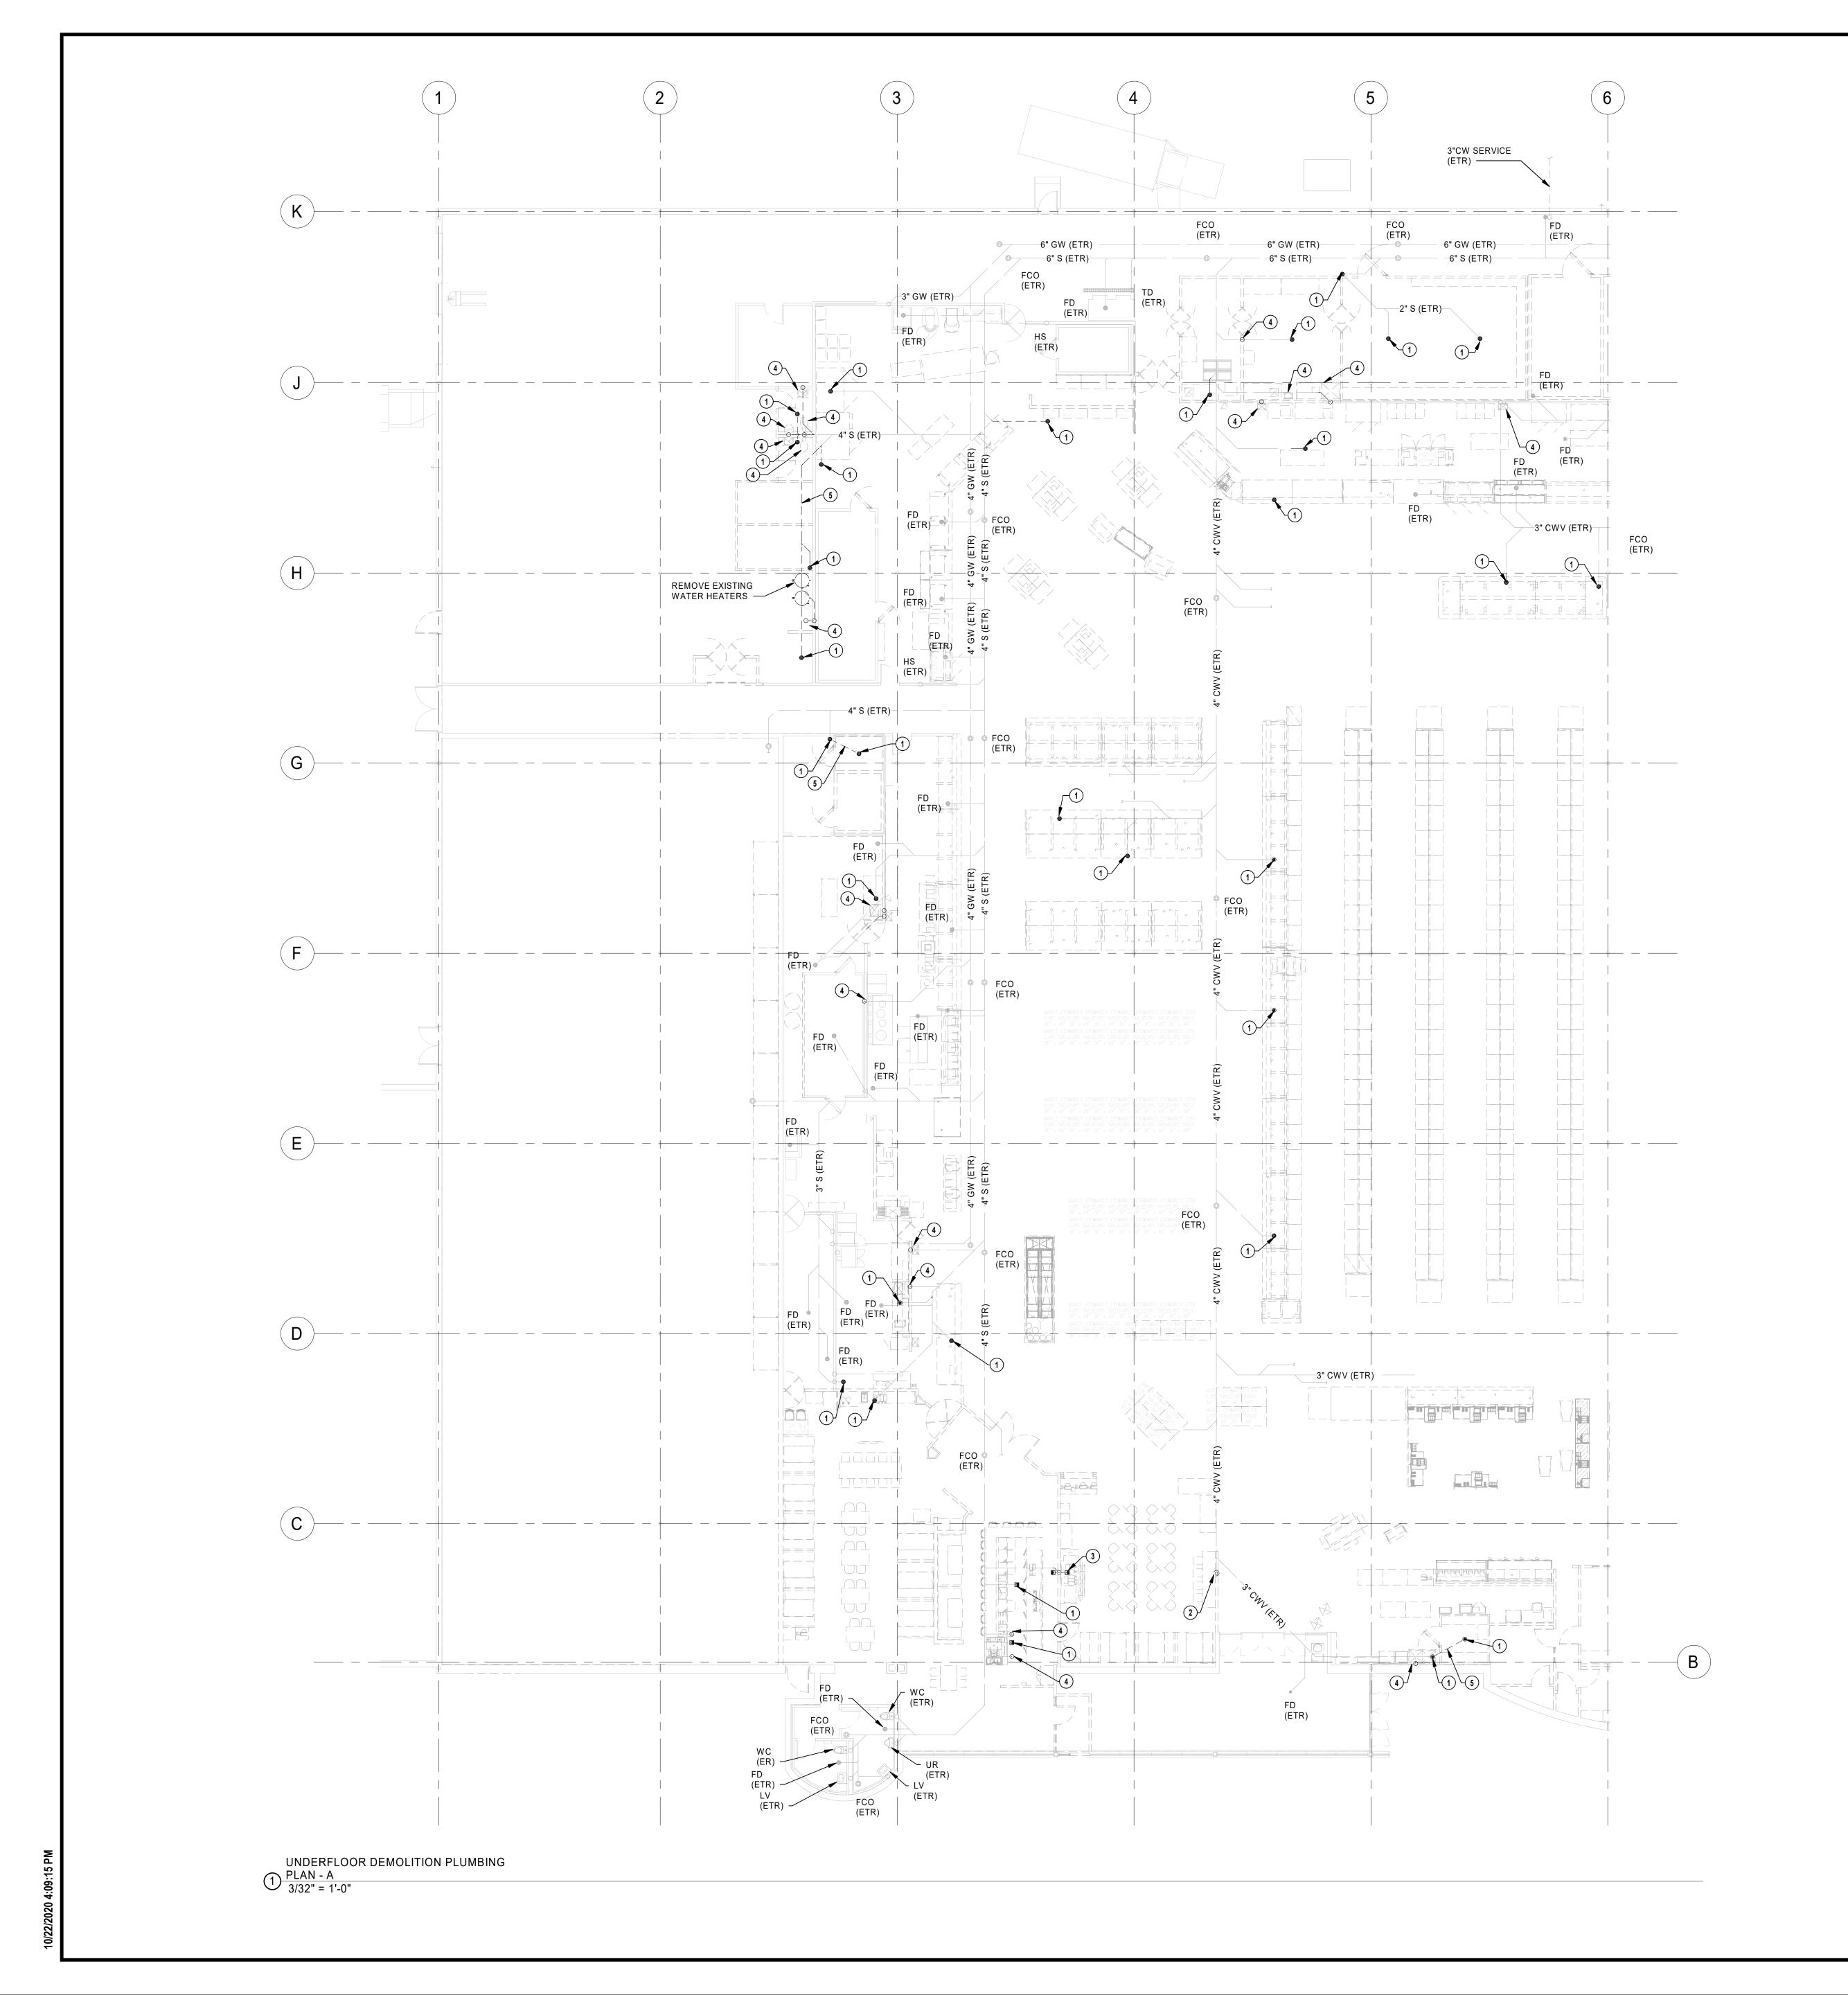
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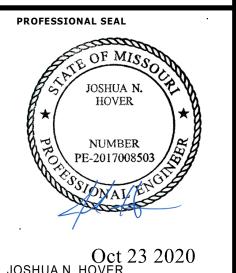
- 1 REMOVE EXISTING FLOOR DRAIN/SINK GRATE, BODY AND TRAP. CAP AND ABANDON WASTE PIPE BELOW FLOOR IF NOT REUSED IN NEW WORK. PATCH FLOOR TO MATCH
- 2 REMOVE EXISTING FLOOR CLEANOUT BODY AND TOP.
- PATCH FLOOR TO MATCH EXISTING. 3 REMOVE EXISTING FLOOR DRAIN GRATE, BODY AND TRAP AS WELL AS PIPING (WASTE AND VENT) TO BELOW FINISHED FLOOR AND TO ACTIVE MAIN'S ABOVE CEILING AND CAP. ABANDON WASTE PIPING BELOW FLOOR, IF NOT USED IN NEW WORK.
- 4 REMOVE EXISTING PLUMBING FIXTURE. CAP AND ABANDON WASTE PIPE BELOW FLOOR IF NOT REUSED IN NEW WORK. PATCH FLOOR TO MATCH EXISTING.
- 5 REMOVE WASTE PIPING AS INDICATED. CAP AND ABANDON

ANY UNUSED WASTE PIPING.

HENDERSON ENGINEERS 8345 LENEXA DRIVE, SUITE 300 LENEXA, KS 66214 TEL 913.742.5000 FAX 913.742.5001 WWW.HENDERSONENGINEERS.COM 1950003081 MO. CORPORATE NO: E-556D EXPIRES 12/31/2020

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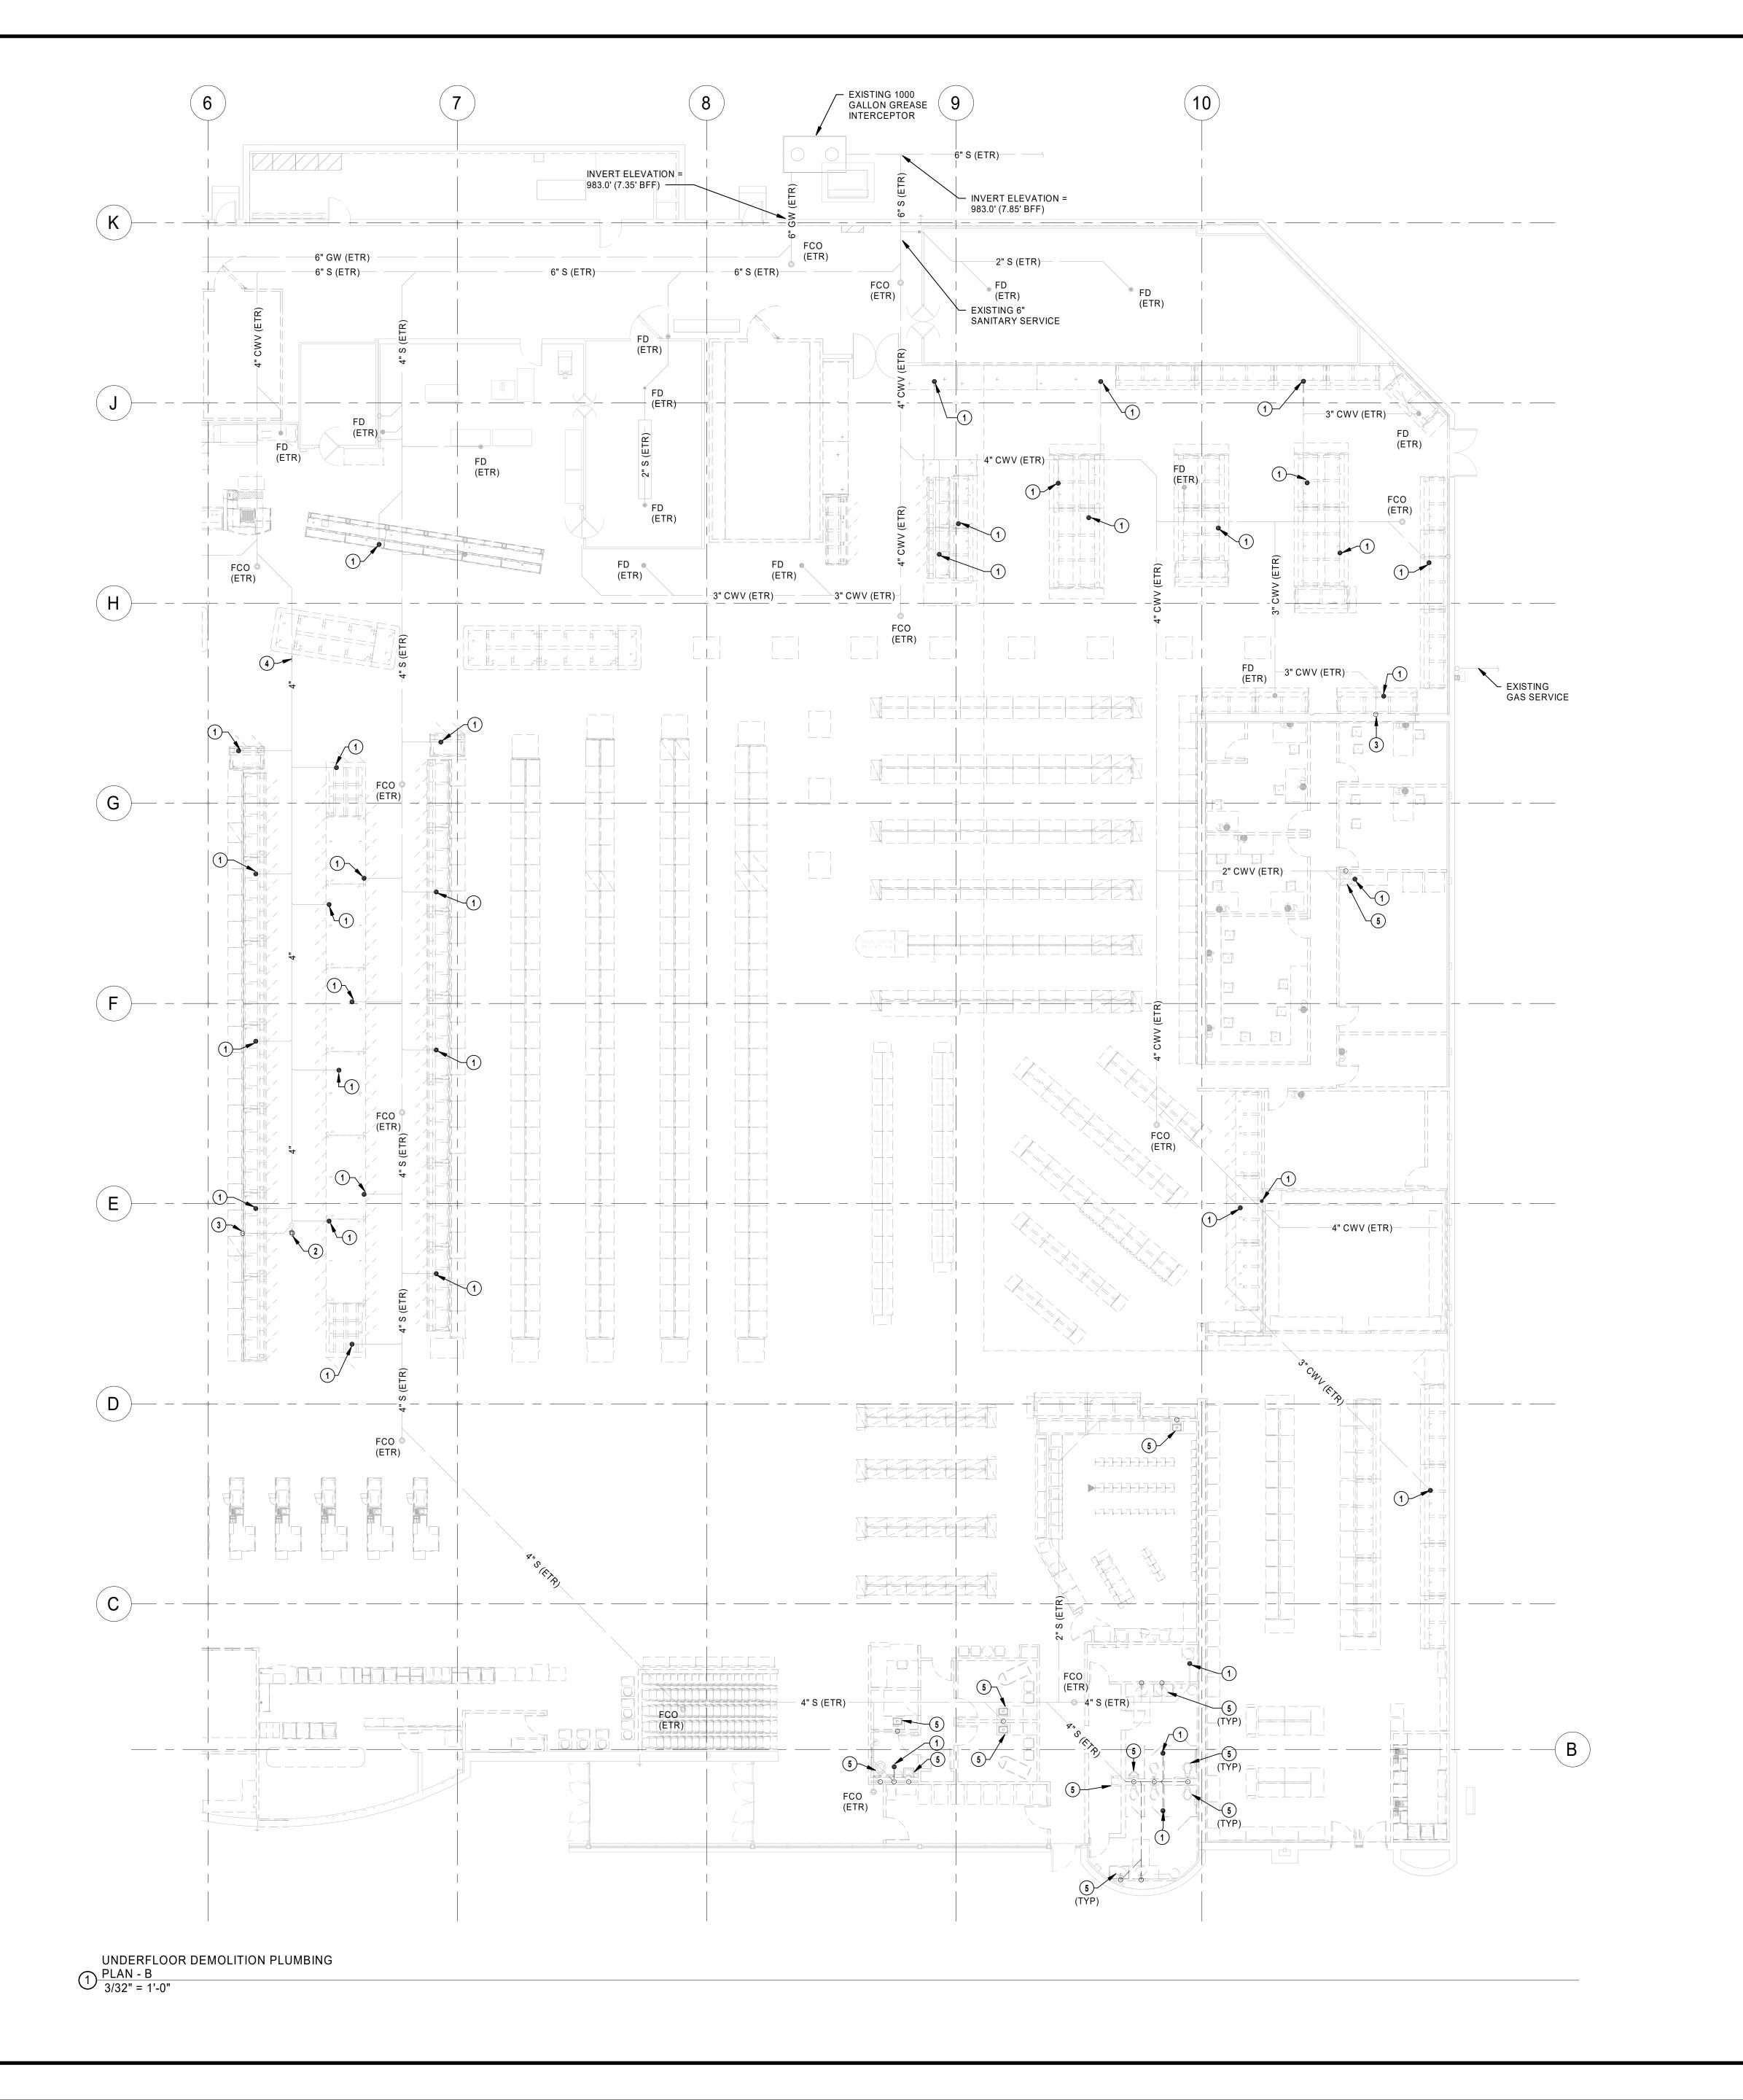


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UNDERFLOOR DEMOLITION PLUMBING PLAN -

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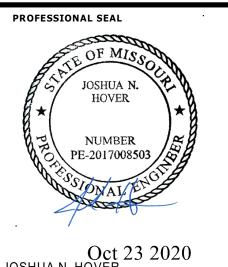


- 1 REMOVE EXISTING FLOOR DRAIN/SINK GRATE, BODY AND TRAP. CAP AND ABANDON WASTE PIPE BELOW FLOOR IF NOT REUSED IN NEW WORK. PATCH FLOOR TO MATCH
- 2 REMOVE EXISTING FLOOR CLEANOUT BODY AND TOP.
- PATCH FLOOR TO MATCH EXISTING. 3 REMOVE EXISTING VENT PIPING BACK TO ACTIVE MAIN AND
- 4 REMOVE WASTE PIPING AS INDICATED. CAP AND ABANDON ANY UNUSED WASTE PIPING.
- 5 REMOVE EXISTING PLUMBING FIXTURE. CAP AND ABANDON WASTE PIPE BELOW FLOOR IF NOT REUSED IN NEW WORK. PATCH FLOOR TO MATCH EXISTING.

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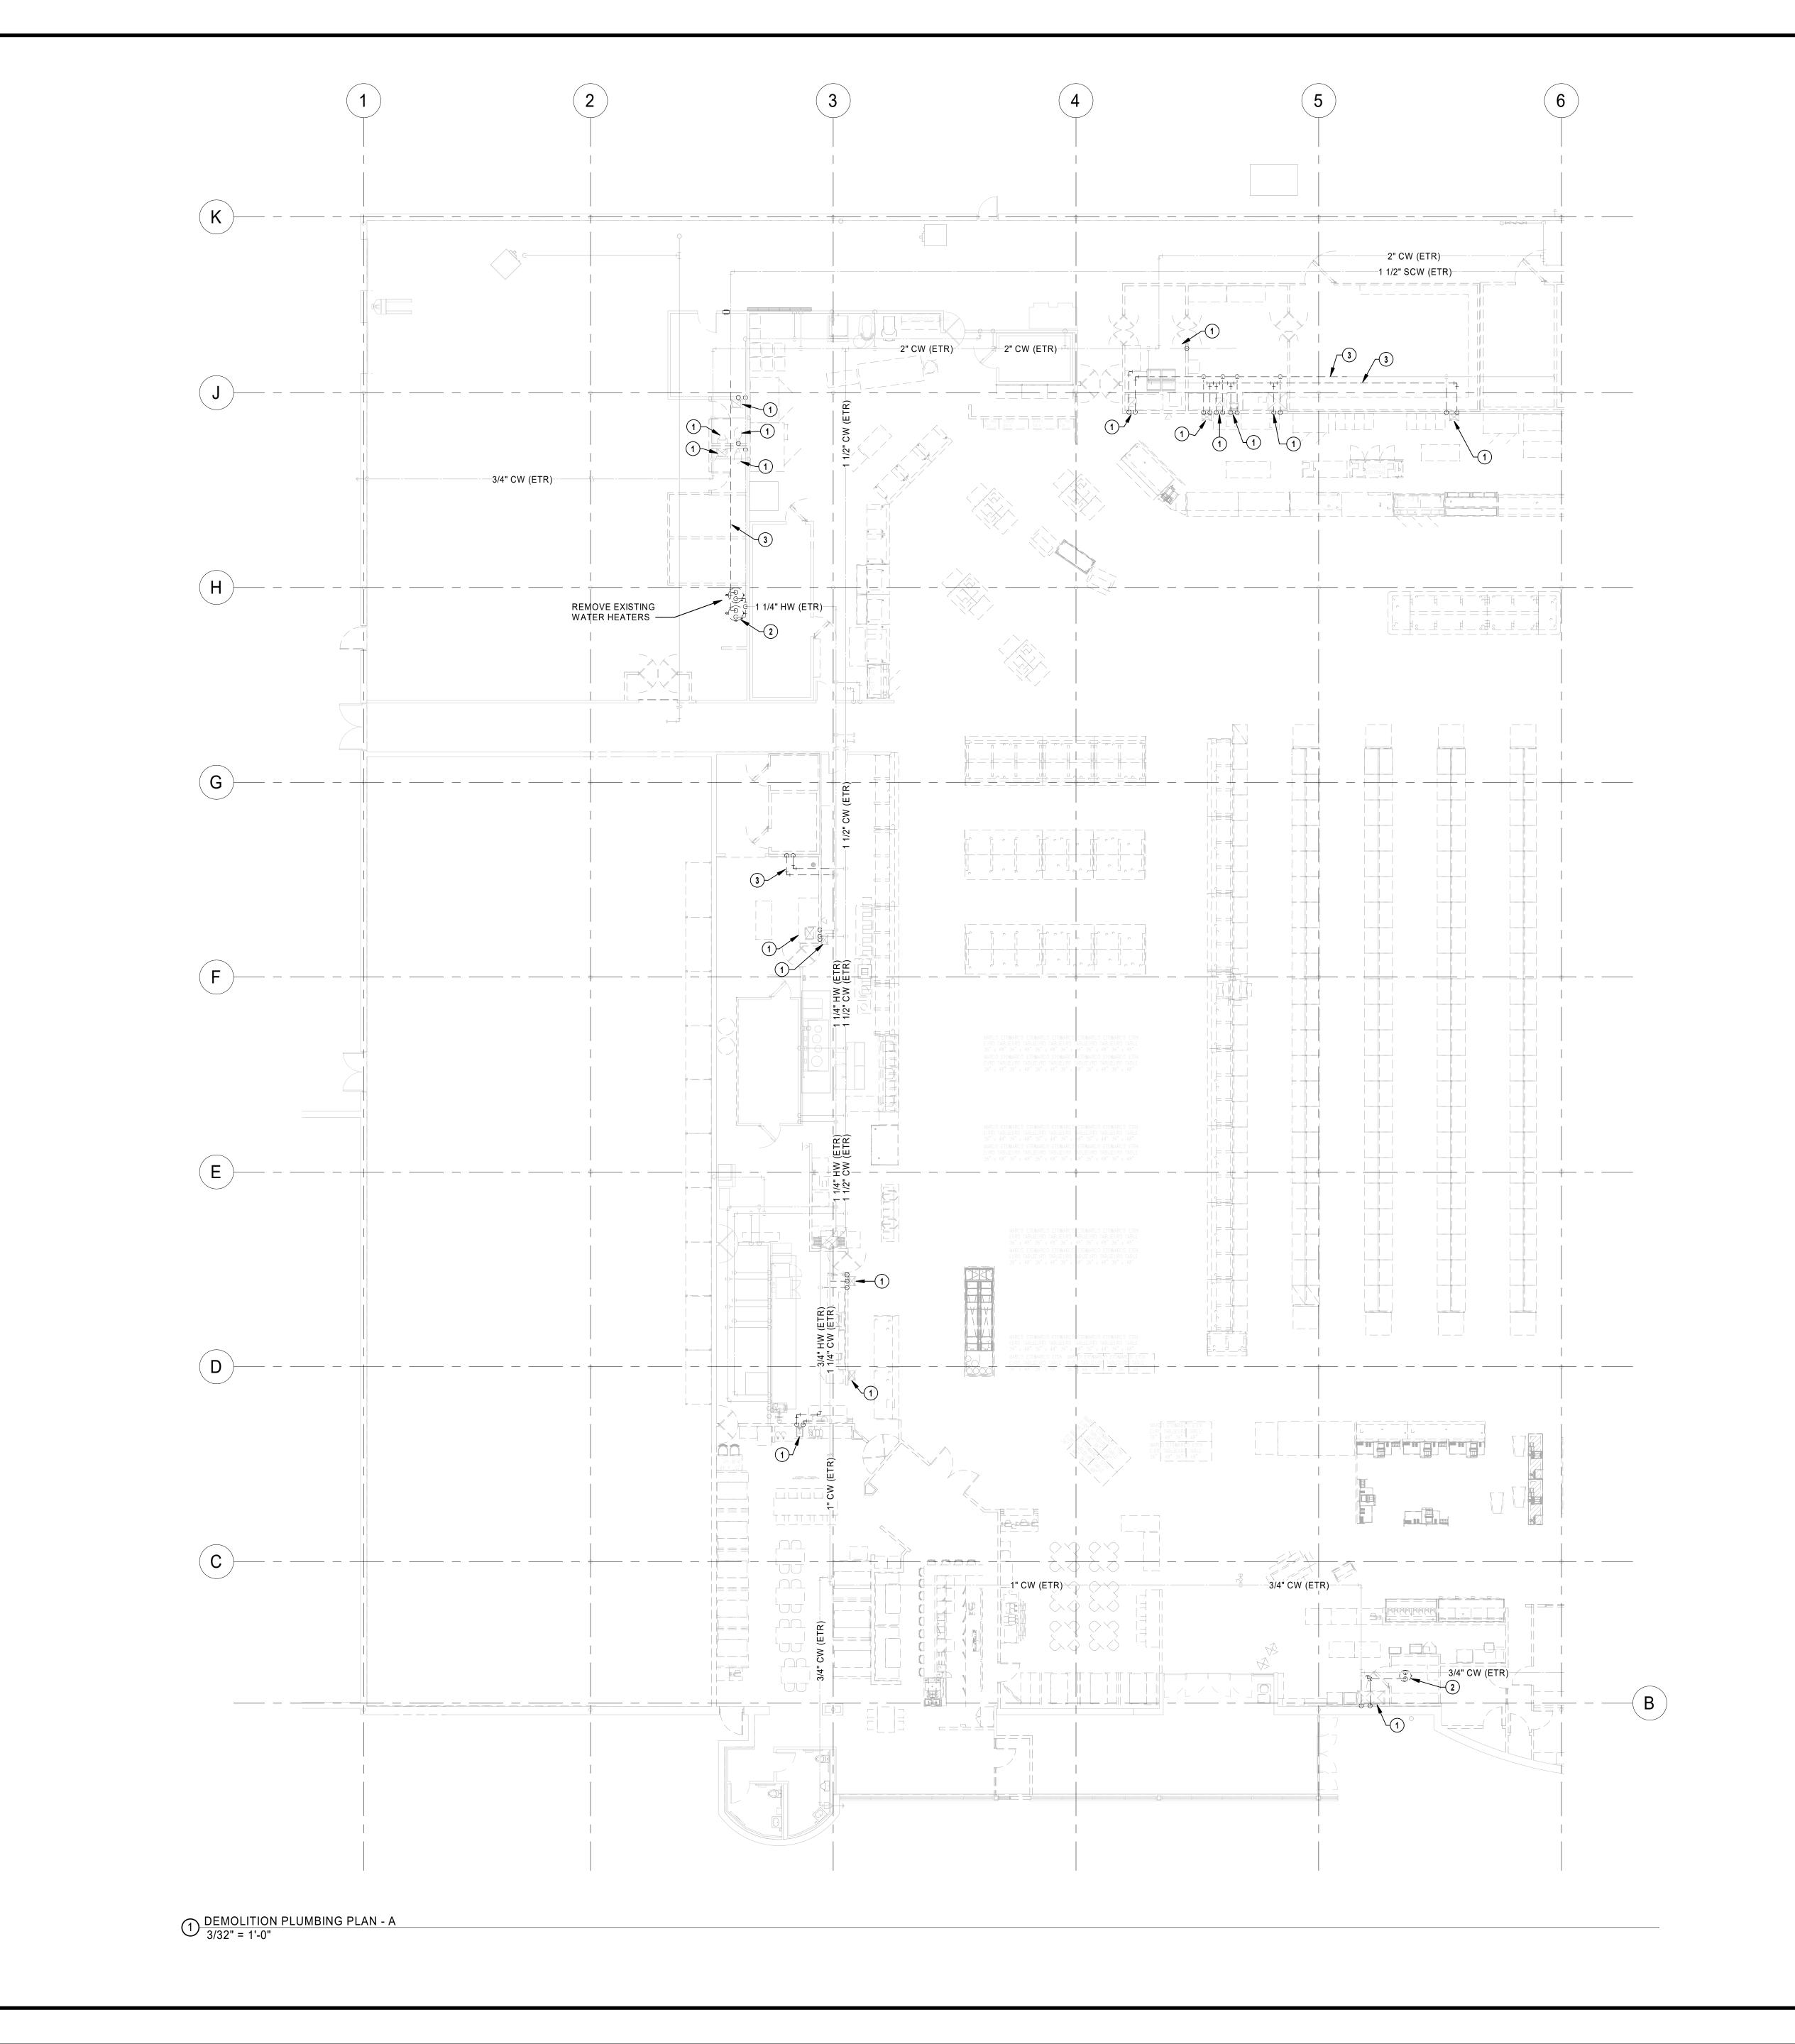
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UNDERFLOOR DEMOLITION PLUMBING PLAN -

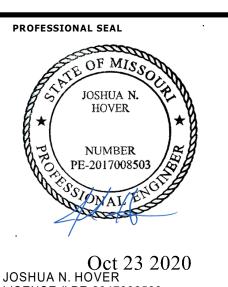
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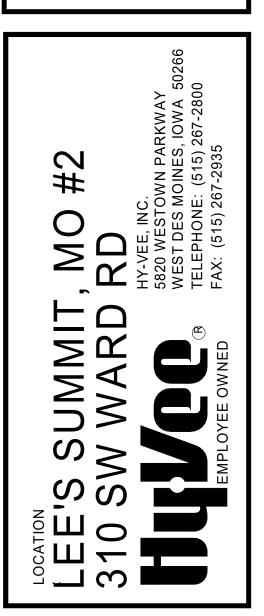
- 1 REMOVE EXISTING PLUMBING FIXTURE AS WELL AS PIPING (VENT, HOT AND COLD WATER) TO BELOW FINISHED FLOOR AND TO ACTIVE MAINS ABOVE CEILING AND CAP.
- 2 REMOVE EXISTING WATER HEATER AS WELL AS PIPING (GAS, HOT AND COLD WATER) TO ACTIVE MAINS ABOVE
- CEILÍNG AND CAP. 3 REMOVE EXISTING PORTION OF WATER PIPING AS INDICATED.

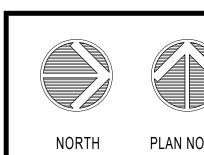
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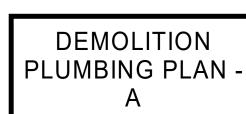




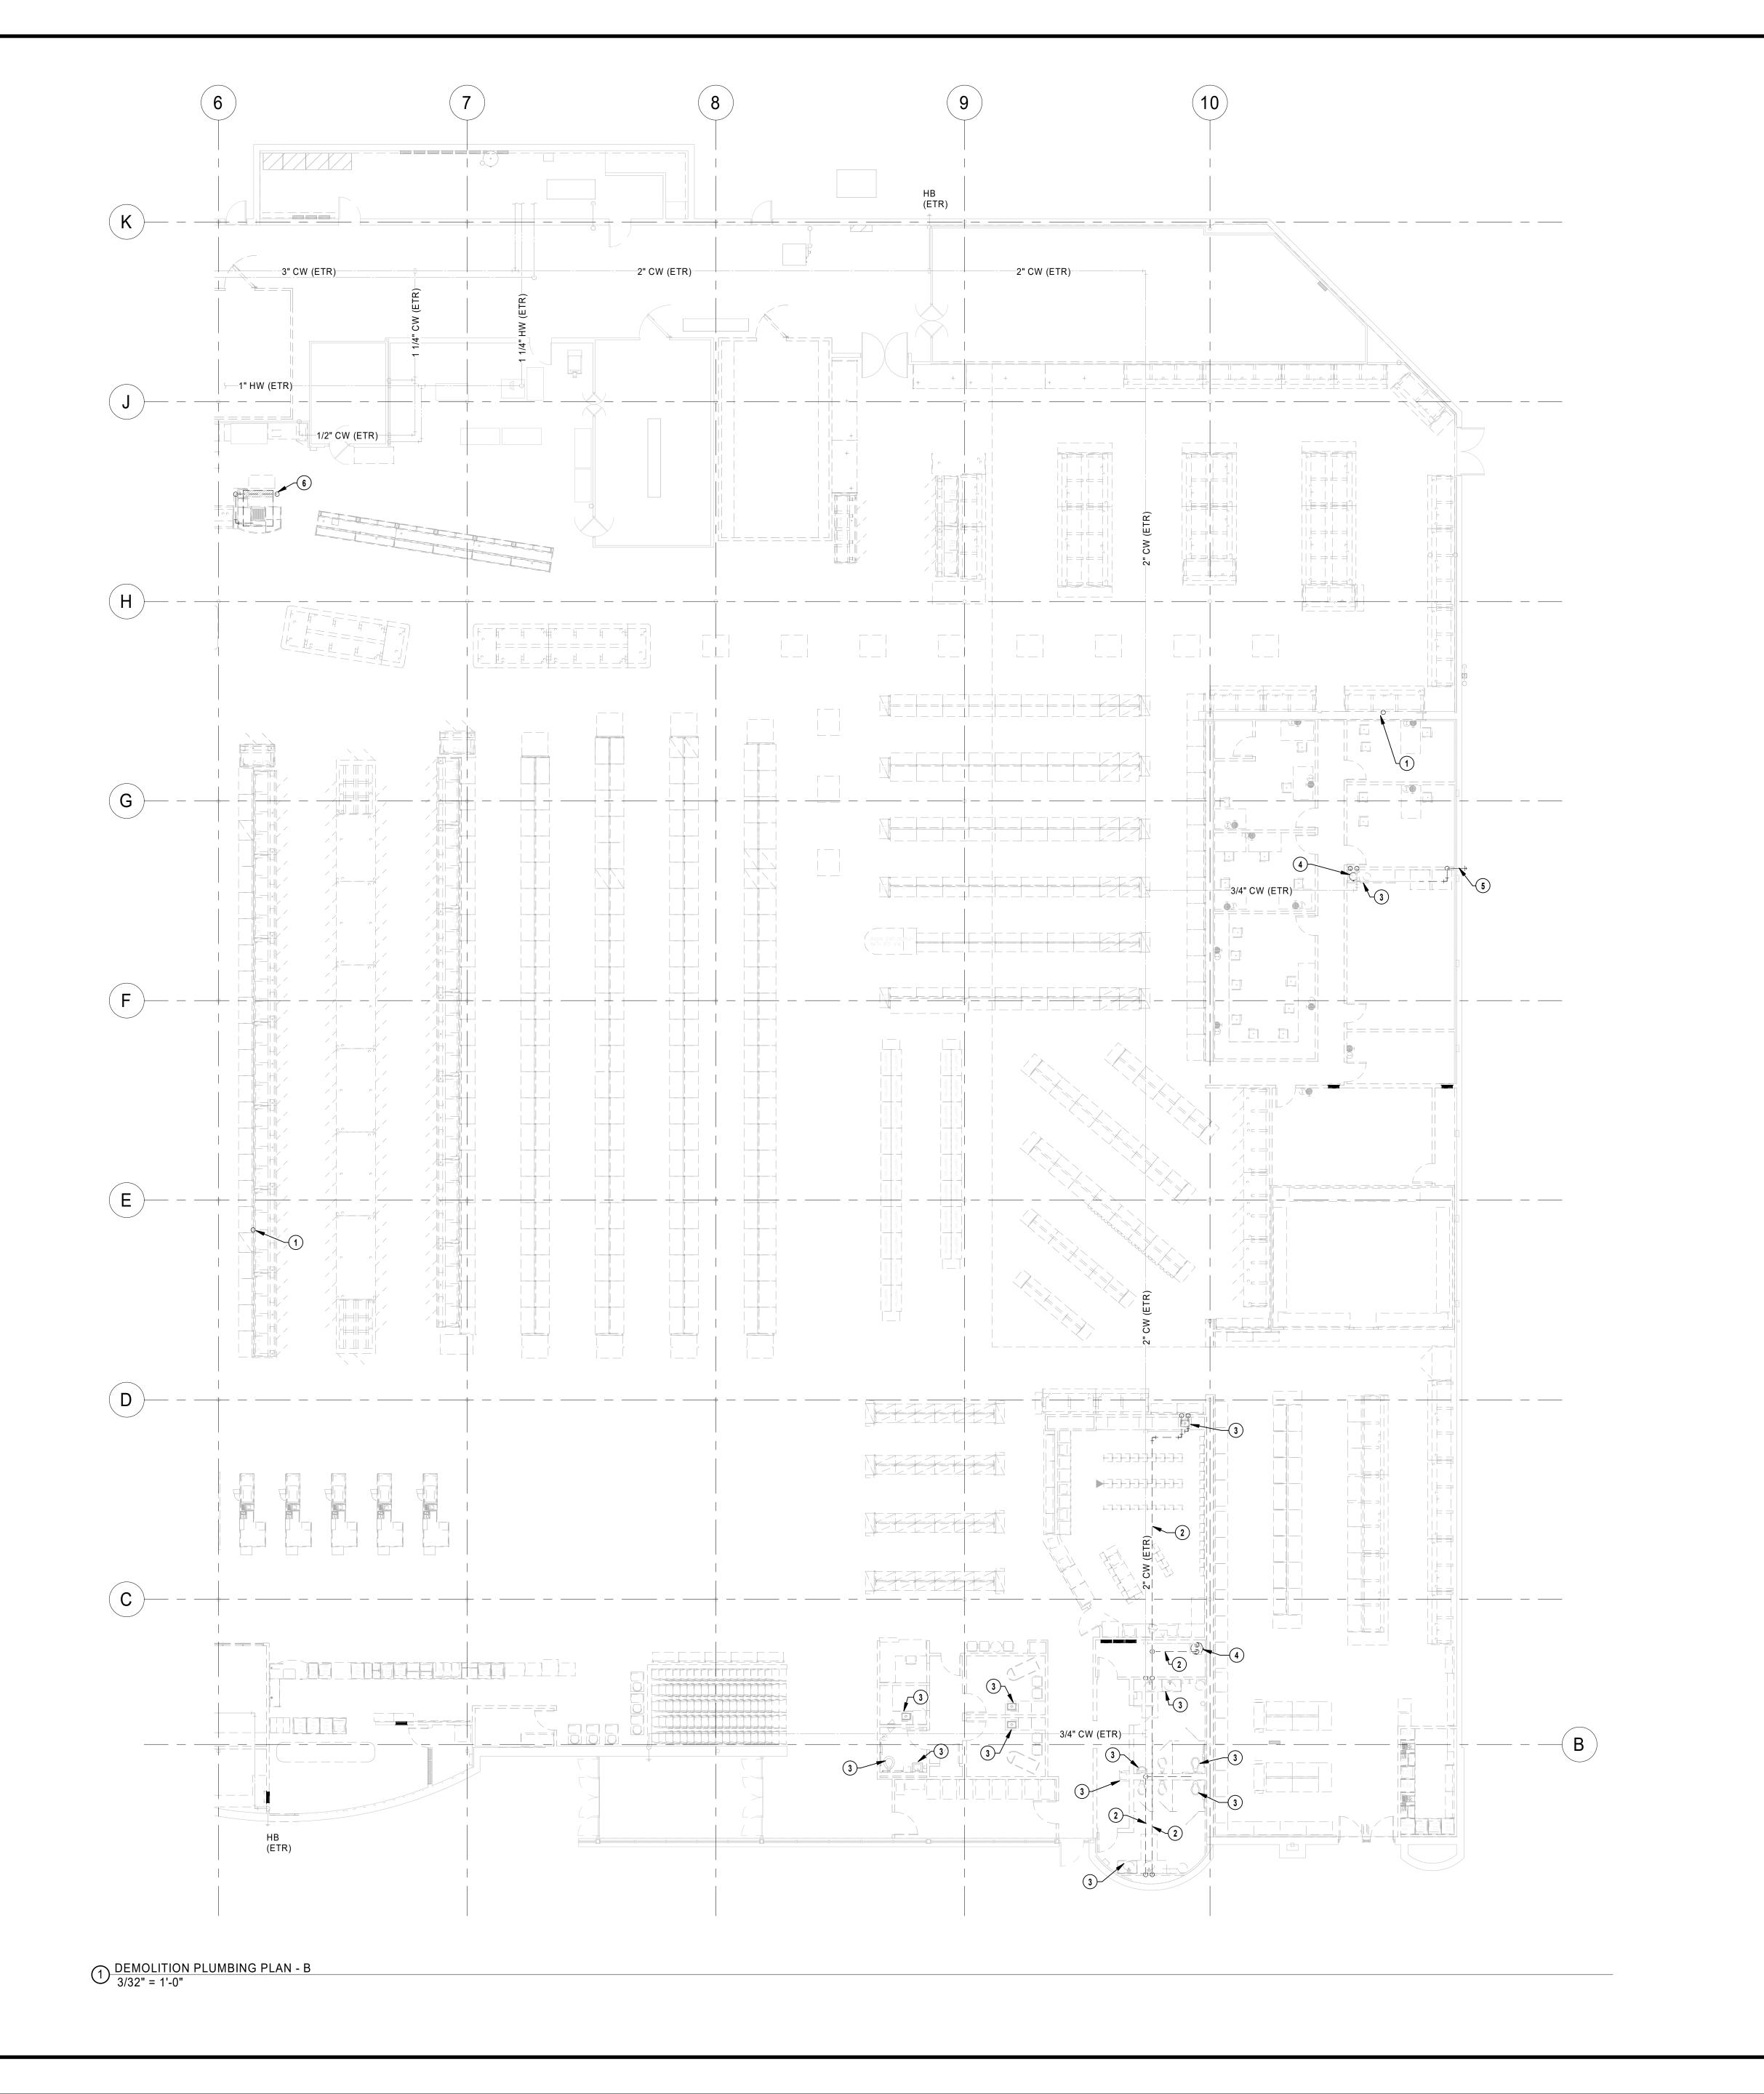
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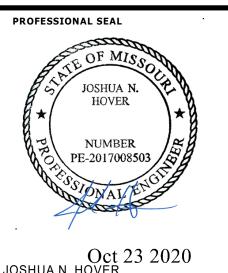
INDICATED.

- 1 REMOVE EXISTING VENT PIPING BACK TO ACTIVE MAIN AND
- 2 REMOVE EXISTING PORTION OF WATER PIPING AS
- 3 REMOVE EXISTING PLUMBING FIXTURE AS WELL AS PIPING (VENT, HOT AND COLD WATER) TO BELOW FINISHED FLOOR
- AND TO ACTIVE MAINS ABOVE CEILING AND CAP. 4 REMOVE EXISTING WATER HEATER AS WELL AS PIPING
- (GAS, HOT AND COLD WATER) TO ACTIVE MAINS ABOVE CEILING AND CAP. 5 REMOVE EXISTING HOSE BIBB AND CAP WATER PIPING ABOVE CEILING BACK TO ACTIVE MAIN. PATCH EXISTING
- WALL TO MATCH EXISTING. 6 REMOVE EXISTING GAS PIPING TO COOK LINE TO ACTIVE MAIN ABOVE CEILING AND CAP.

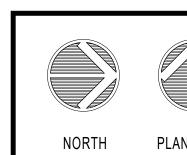
HENDERSON ENGINEERS 8345 LENEXA DRIVE, SUITE 300 LENEXA, KS 66214 TEL 913.742.5000 FAX 913.742.5001 WWW.HENDERSONENGINEERS.COM 1950003081 MO. CORPORATE NO: E-556D EXPIRES 12/31/2020

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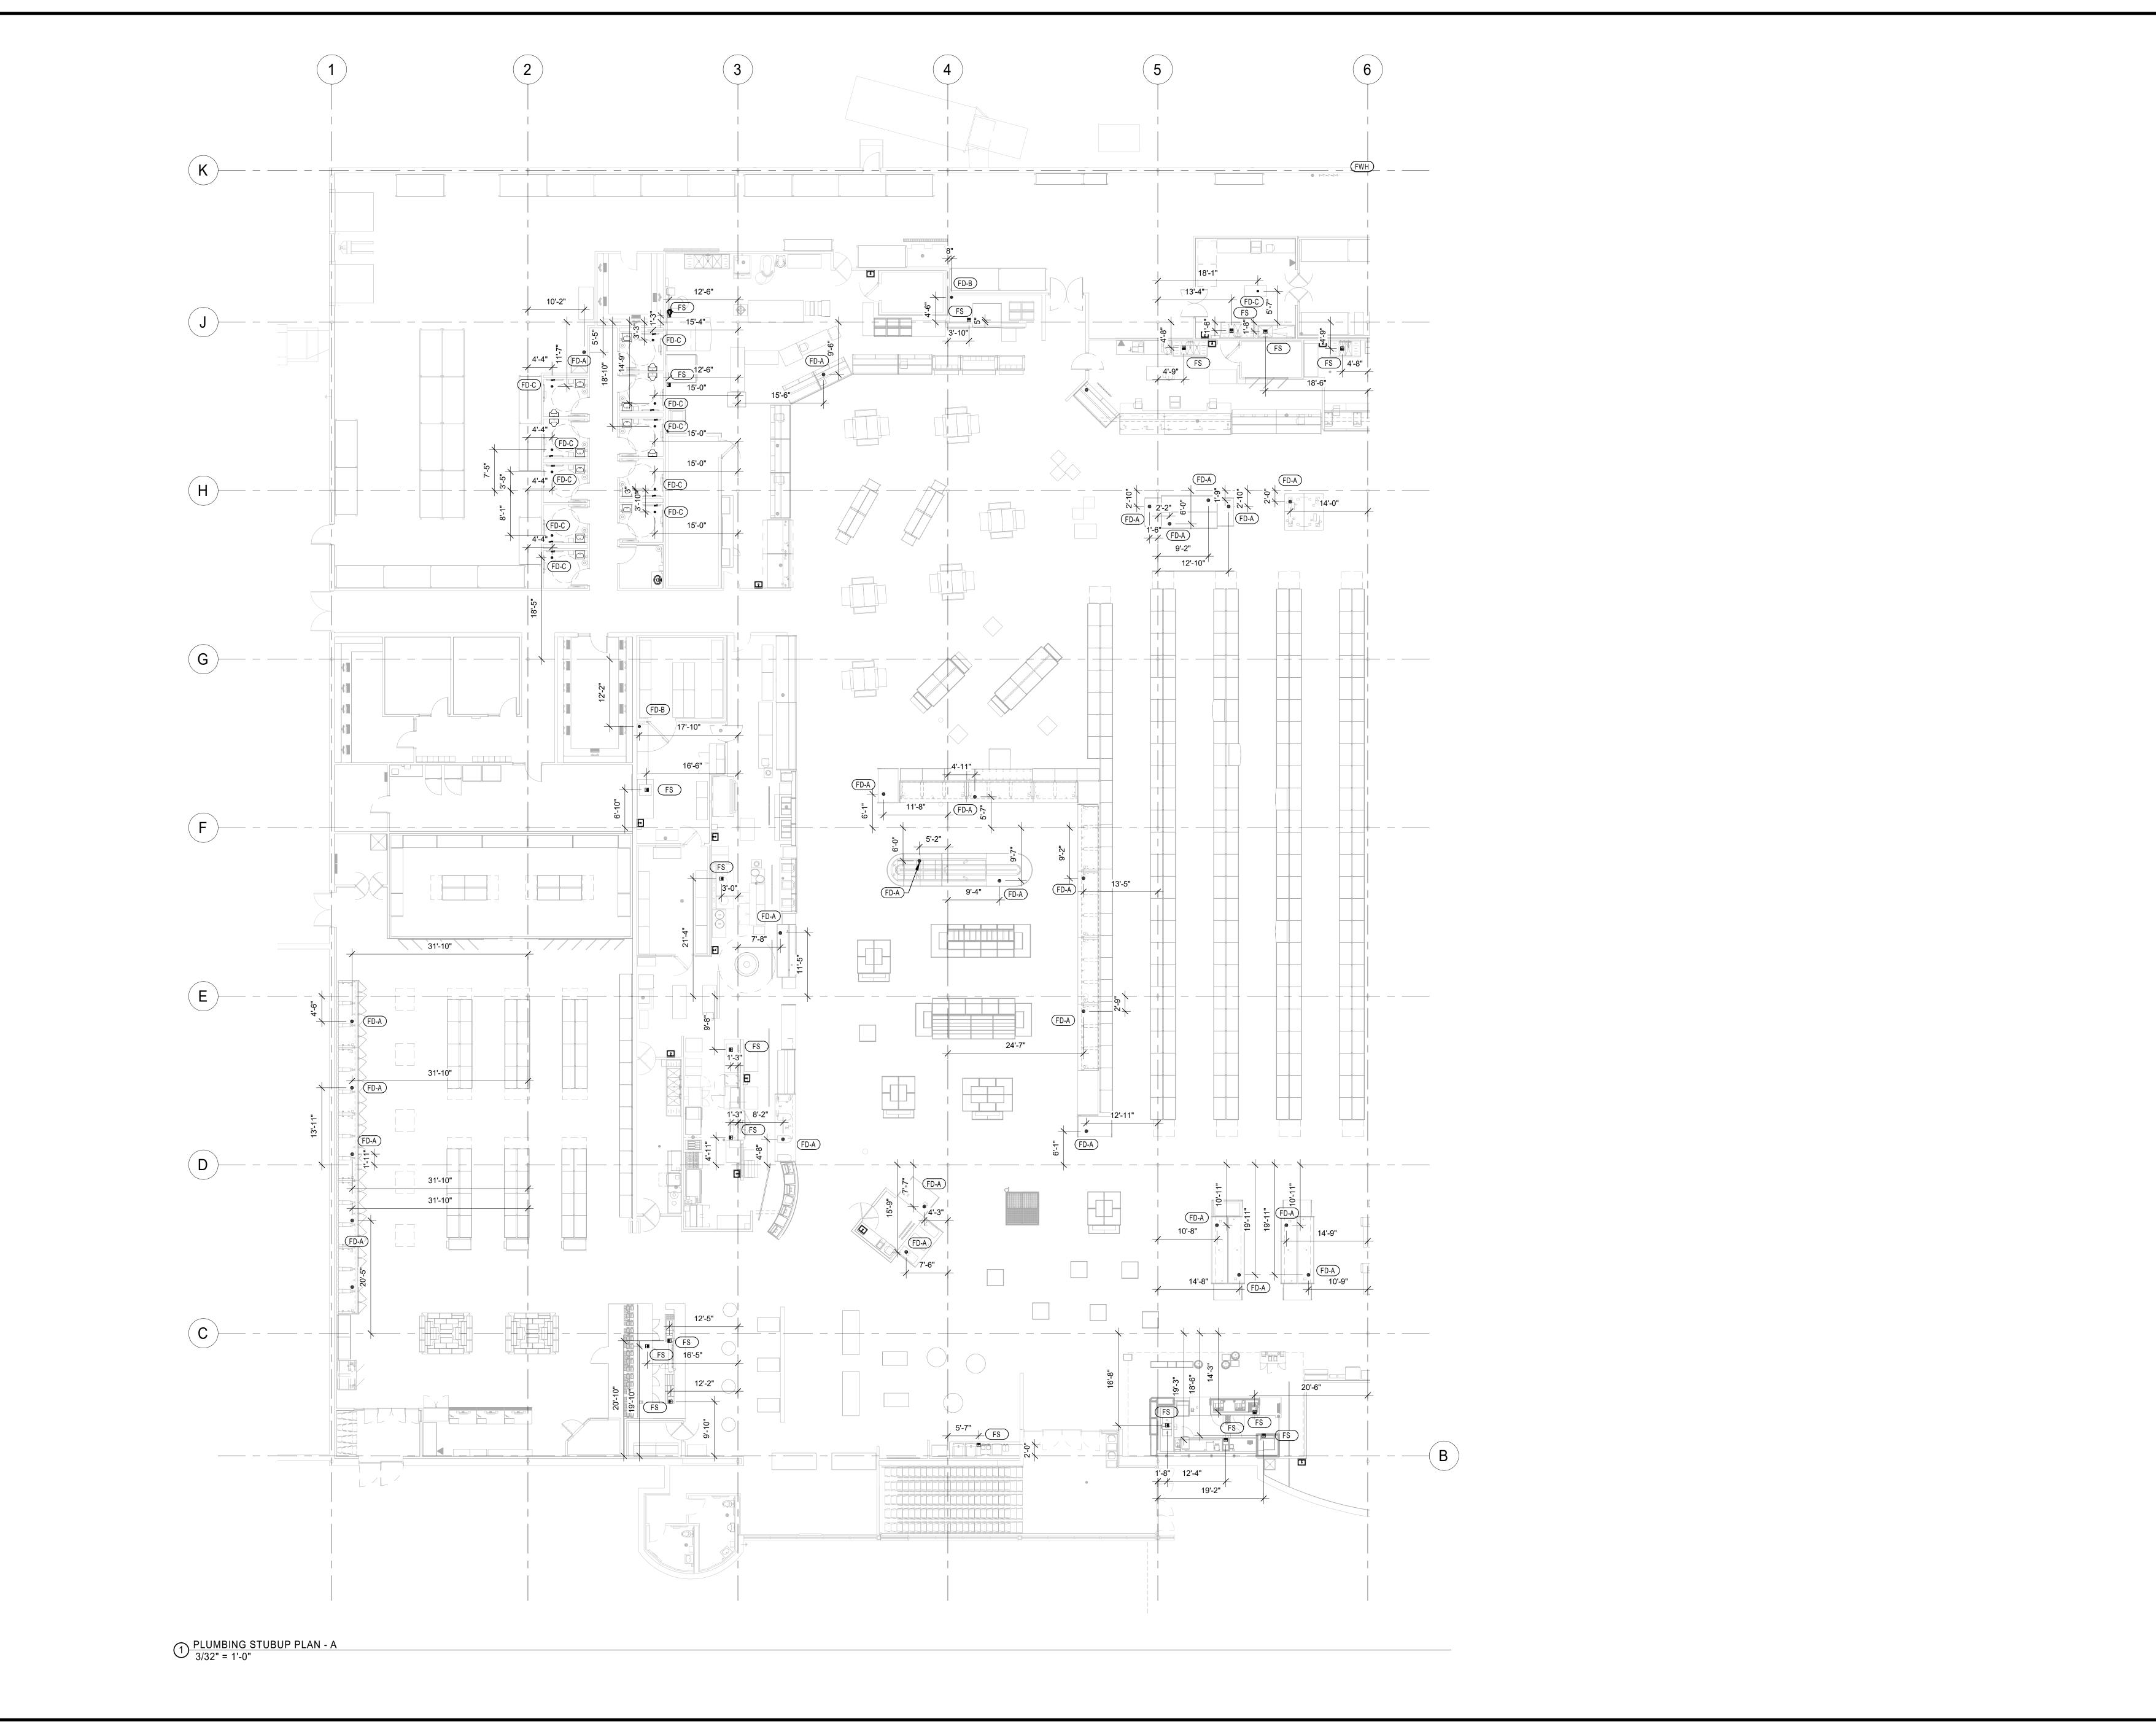


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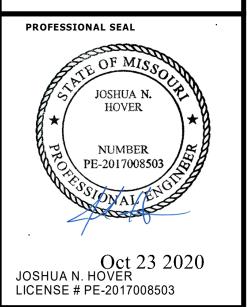
DEMOLITION PLUMBING PLAN -

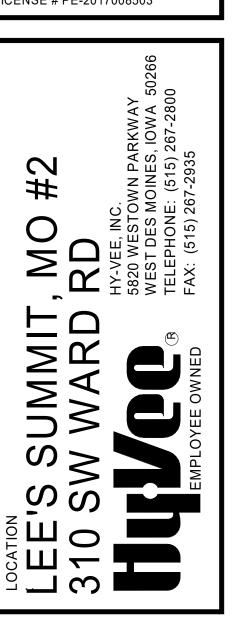
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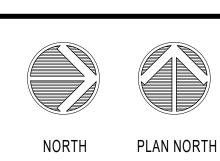












PLUMBING STUB-UP PLAN - A

PROJECT MANAGER

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DRAWN BY:

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10/19/2020

SCALE:

AS NOTED

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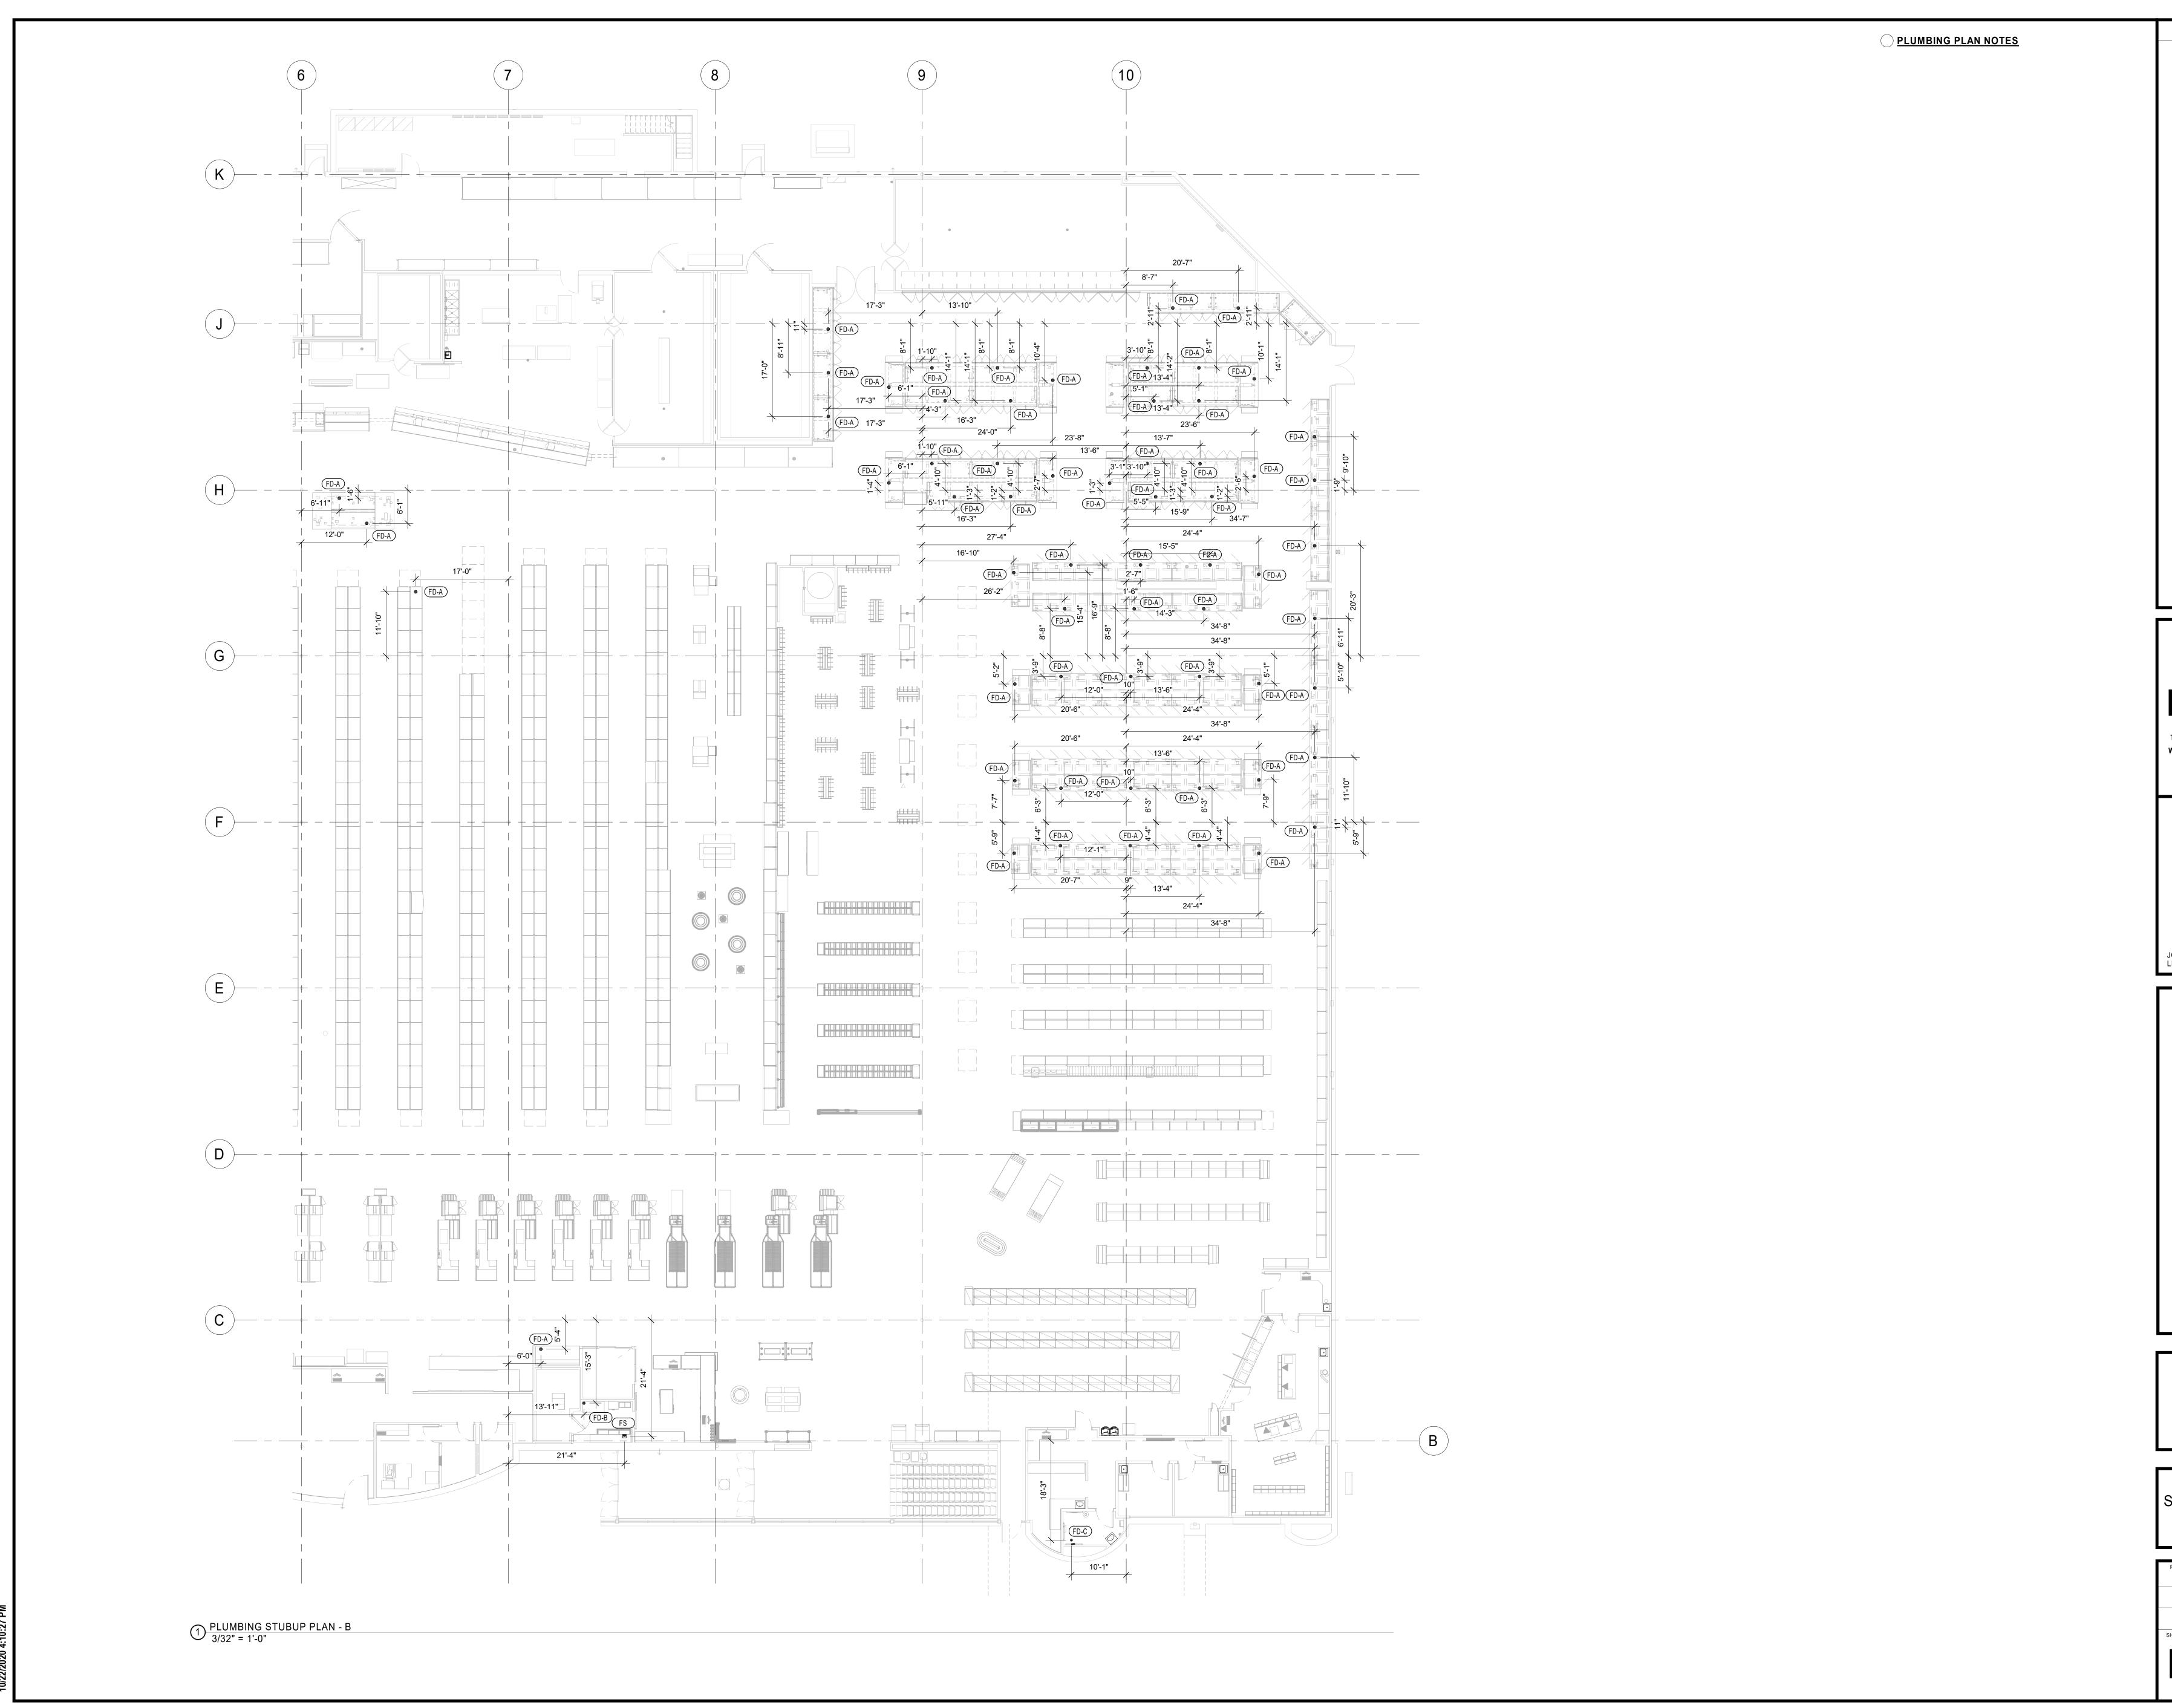
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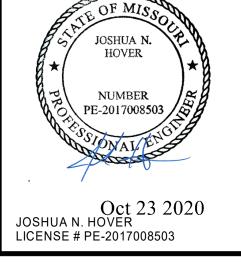


HENDERSON
ENGINEERS

8345 LENEXA DRIVE, SUITE 300
LENEXA, KS 66214
TEL 913.742.5000 FAX 913.742.5001
WWW.HENDERSONENGINEERS.COM

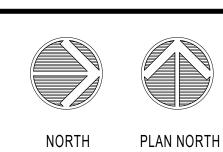
1950003081
MO. CORPORATE NO: E-556D
EXPIRES 12/31/2020

PROFESSIONAL SEAL



LEE'S SUMMIT, MO #2
310 SW WARD RD

HY-VEE, INC.
5820 WEST DES MOINES, IOWA 50266
TELEPHONE: (515) 267-2830
FAX: (515) 267-2935



PLUMBING STUB-UP PLAN - B

PROJECT MANAGER

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DRAWN BY:

HEI

10/19/2020

SCALE:

AS NOTED

CHECKED BY:

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