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# WHATABURGER 20-M LEE'S SUMMIT

LEE'S SUMMIT, MO



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12/22/20  
PROFESSIONAL OF RECORD:  
JASON E. CHRISTOFF No. 20012002143  
EXP. DATE: 12/31/20

REV	DESCRIPTION	DATE

Project No.: 62-40497-01

Client Project No.:

Drawing Title:

## ELECTRICAL SYMBOLS

Date: 12/22/20 Phase: PERMIT SET

Designed: DCU | Drawing No.:

Drawn: DCU

Checked: KFF

## E0.1

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ABBREVIATIONS		ABBREVIATIONS		MOUNTING HEIGHTS:		GENERAL NOTES:	
A,AMP	AMPERE(S)	LT	LONG TIME	UNLESS OTHERWISE INDICATED, OUTLET BOXES IN WALLS SHALL BE LOCATED WITH CENTERLINE AT THE FOLLOWING ELEVATIONS ABOVE THE FINISHED FLOOR LINE. VERIFY ALL HEIGHTS PRIOR TO ACTUAL LAYOUT OF WORK WITH THE GENERAL CONSTRUCTION CONTRACTOR.		1. PROVIDE EACH 120V, 20A BRANCH CIRCUIT FROM LIGHTING AND APPLIANCE PANELBOARDS WITH A SEPARATE NEUTRAL FOR EACH PHASE CONDUCTOR. NO SHARED NEUTRALS ARE PERMITTED UNLESS OTHERWISE INDICATED. BRANCH CIRCUIT HOME RUN WIRING MAY BE COMBINED UP TO MAXIMUM OF (6) CURRENT CARRYING CONDUCTORS IN A CONDUIT SIZED PER NFPA 70.	
AC	ALTERNATING CURRENT	LTG	LIGHTING				
AF	AMPERE FRAME (CIRCUIT BREAKER)	LP	LIGHTING PANEL				
AFF	ABOVE FINISHED FLOOR	M	METER				
AFG	ABOVE FINISHED GRADE	mm	MILLIMETER				
AFU	AMPERE FUSE	mm2	MILLIMETERS SQUARED				
AHU	AIR HANDLING UNIT	MAX	MAXIMUM				
AIC	AMPERE INTERRUPTING CAPACITY	MCB	MAIN CIRCUIT BREAKER				
AL	ALUMINUM	MCC	MOTOR CONTROL CENTER	1.	SWITCH OUTLETS	4 FEET	
AS	AMMETER SWITCH	MCCB	MOLDED CASE CIRCUIT BREAKER	2.	BRACKET OUTLETS (OTHER)	6 FEET-6 INCHES	
AM	AMMETER	MDF	MAIN DISTRIBUTION FRAME	3.	RECEPTACLE OUTLETS (U.O.N.)	1 FOOT-6 INCHES	
AT	AMPERE TRIP (CIRCUIT BREAKER)	MECH	MECHANICAL	4.	RECEPTACLE OUTLETS, MECHANICAL ROOMS	3 FEET	
ATS	AUTOMATIC TRANSFER SWITCH	MFR	MANUFACTURER	5.	RECEPTACLE OUTLETS MOUNTED, ABOVE CASEWORK/CABINETS	4 INCHES ABOVE BACKSPLASH	
AUX	AUXILIARY	MH	MANHOLE	6.	CLOCK OUTLETS	12 INCHES BELOW CEILING	
AV	AUDIO VISUAL	MI	MINERAL-INSULATED	7.	MOTOR STARTERS AND SAFETY SWITCHES	4 FEET-6 INCHES	
AWG	AMERICAN WIRE GAUGE	MIN	MINIMUM	8.	PANELBOARDS (TOP)	6 FEET-6 INCHES	
BAS	BUILDING AUTOMATION SYSTEM	MIC	MEDIA INTERFACE CONNECTOR	MOUNTING HEIGHT NOTES:		2. THESE ARE STANDARD COVER SHEET ABBREVIATION LISTS AND SYMBOLS. DISREGARD UNUSED ABBREVIATIONS AND SYMBOLS.	
BKR	BREAKER	MIN	MINIMUM				
BLDG	BUILDING	MLO	MAIN LUGS ONLY				
BP	BYPASS	MPS	MANUAL PULL STATION				
BSC	BIOLOGICAL SAFETY CABINET	MTD	MOUNTED				
C	CONDUCTOR	MTG	MOUNTING				
C/ CDT	CONDUIT	MTS	MANUAL TRANSFER SWITCH				
CATV	CABLE TELEVISION	MV	MEDIUM VOLTAGE				
CB	CIRCUIT BREAKER	N	NEUTRAL/NORMAL				
CCTV	CLOSED CIRCUIT TELEVISION	NEC	NATIONAL ELECTRICAL CODE				
CKT	CIRCUIT	NC	NORMALLY-CLOSED				
CLG	CEILING	NIC	NOT IN CONTRACT				
CO	CONDUIT ONLY	NL	NIGHT LIGHT				
COAX	COAXIAL CABLE	NO	NORMALLY-OPEN / NUMBER				
COL	COLUMN	NORM	NORMAL				
COMM	COMMUNICATIONS	NTS	NOT TO SCALE				
CP	CONTROL PANEL	NWP	NETWORK PROTECTOR				
CPT	CONTROL POWER TRANSFORMER	OCB	OIL CIRCUIT BREAKER				
CPU	CENTRAL PROCESSING UNIT	OL	OVERLOAD(S)				
CR	CARD READER	OC	ON-CENTER				
CRT	CATHODE RAY TUBE MONITOR	OS	OCCUPANCY SENSOR				
CS	CONTROL SWITCH	P	POLE				
CU	COPPER	PA	PUBLIC ADDRESS SYSTEM				
CUH	CABINET UNIT HEATER	PB	PUSHBUTTON/PULLBOX				
CT	CURRENT TRANSFORMER	PBX	PRIVATE BRANCH EXCHANGE				
D	DEPTH	PC	PHOTOCELL				
DC	DIRECT CURRENT	PDU	POWER DISTRIBUTION UNIT				
DDC	DIRECT DIGITAL CONTROL	PF	POWER FACTOR				
DEMO	DEMOLITION	PFCC	POWER FACTOR CORRECTION CAPACITORS				
DIA	DIAMETER	PH,Ø	PHASE				
DN	DOWN	PNL	PANEL				
DISC	DISCONNECT	PP	POWER PANEL				
DIST	DISTRIBUTION	PR	PAIR				
DWG	DRAWING	PRI	PRIMARY				
E	ELECTRIC / EMERGENCY	PT	POTENTIAL TRANSFORMER				
EC	ELECTRICAL CONTRACTOR, EMPTY CONDUIT	PVC	POLYVINYLCHLORIDE				
EF	EXHAUST FAN	PWR	POWER				
EL	ELEVATION	QTY	QUANTITY				
ELECT,ELEC	ELECTRICAL	RE	REMOVE EXISTING				
ELEV	ELEVATOR	REC,RECPT	RECEPTACLE				
EMT	ELECTRICAL METALLIC TUBING	REPO	REMOTE E.P.O.				
EO	ELECTRICALLY OPERATED	REQ,REQD	REQUIRED				
EOL	END OF LINE DEVICE	RF	RETURN FAN				
EPO	EMERGENCY POWER OFF	RF	READER INTERFACE MODULE				
EQ	EQUAL	RM	ROOM				
EQUIP	EQUIPMENT	RO	REVERSE-OSMOSIS				
ER	EXISTING TO BE RELOCATED	RP	RECEPTACLE PANEL				
EW	ELECTRIC WATER COOLER	RVAT	REDUCED VOLTAGE AUTOTRANSFORMER				
EX	EXISTING TO REMAIN	RTU	REMOTE TERMINAL UNIT				
F	FLUSH	RUPS	ROTARY UPS				
FA	FIRE ALARM	SCA	SHORT CIRCUIT AMPERES				
FCC	FIRE COMMAND CENTER	SD	SMOKE DETECTOR				
FCU	FAN COIL UNIT	SEC	SECONDARY				
FDDI	FIBER DISTRIBUTED DATA INTERFACE	SF	SUPPLY FAN				
FDR	FEEDER	SF6	SULFERHEXAFLORIDE				
FH	FUME HOOD	SPD	SURGE PROTECTIVE DEVICE				
FIP	FIELD INTERFACE PANEL	SPEC	SPECIFICATION				
FXT	FIXTURE	SPKR	SPEAKER				
FLA	FULL LOAD AMPERES	SS	STAINLESS STEEL/SOLID STATE				
FLR,FL	FLOOR	ST	SHUNT TRIP/SHORT TIME				
FLUOR	FLUORESCENT	STD	STANDARD				
FO	FIBER OPTIC	STP	SHIELDED TWISTED PAIR				
FPB	FAN POWERED BOX	STS	STATIC TRANSFER SWITCH				
FSD	FIRE SMOKE DAMPER	SW	SWITCH				
FU	FUSE	SWBD	SWITCHBOARD				
FUT	FUTURE	SWGR	SWITCHGEAR				
FVR	FULL VOLTAGE REVERSIBLE	SYM	SYMMETRICAL				
FVNR	FULL VOLTAGE NON REVERSIBLE	SYS	SYSTEM				
G	GROUND (CONDUCTOR)	T	TRANSFORMER				
GA	GAUGE	TB	TERMINAL BLOCK				
GEN	GENERATOR	TELECOM	TELECOMMUNICATIONS				
GF	GROUND FAULT	TDR	TIME DOMAIN REFLECTOMETER				
GFI	GROUND FAULT CIRCUIT INTERRUPTER	TEF	TOILET EXHAUST FAN				
GND,GRD	GROUND	TEL,TELE	TELEPHONE				
GPS	GENERATOR PARALLELING SWITCHGEAR	TR	TELEPHONE ROOM				
GRC	GALVANIZED RIGID STEEL CONDUIT	TV	TELEVISION				
HH	HAND HOLE	TVSS	TRANSIENT VOLTAGE SURGE SUPPRESSION				
HID	HIGH INTENSITY DISCHARGE	TYP	TYPICAL				
HOA	HAND-OFF-AUTOMATIC SWITCH	UC	UNDER-COUNTER				
HP	HORSEPOWER	UH	UNIT HEATER				
HT	HEIGHT	UL	UNDERWRITERS LABORATORY				
HWP	HOT WATER PUMP	UNO	UNLESS NOTED OTHERWISE				
HV	HIGH VOLTAGE	UON	UNLESS OTHERWISE NOTED				
HZ	HERTZ	UPS	UNINTERRUPTIBLE POWER SUPPLY				
IINST	INSTANTANEOUS	UTP	UNSHIELDED TWISTED PAIR				
ICM	INTERCOM MASTER	V	VOLT(S)				
ICR	INTERCOM REMOTE	VA	VOLT-AMPERES				
IG	ISOLATED GROUND	VAV	VARIABLE AIR VOLUME BOX				
IMC	INTERMEDIATE METAL CONDUIT	VFD	VARIABLE FREQUENCY DRIVE				
INSTR	INSTRUMENT/INSTRUMENTATION	VM	VOLTMETER				
JB,JBX	JUNCTION BOX	VS	VOLTMETER SWITCH				
K	KEY LOCK (KEY INTERLOCK SCHEME)	W	WITH				
KA	KILOAMPERES	W	WIRE/WATT/ WIDTH				
KCM	THOUSAND CIRCULAR MILS	WCR	WITHSTAND CURRENT RATING				
KEF	KITCHEN EXHAUST FAN	WM	WATTMETER				
KW	KILOWATTS	WP	WEATHERPROOF				
KWH	KILOWATT HOUR	WT	WATERTIGHT				
KV	KILOVOLTS	XFMR	TRANSFORMER				
KVA	KILO VOLT-AMPERES	XP	EXPLOSION-PROOF				
KVAR	KVA REACTIVE	ZI	ZONE INTERLOCKING				
L	LOCKING TYPE/LOAD	Δ,Y	DELTA-WYE				
LA	LIGHTNING SURGE ARRESTER	2S2W	TWO SPEED TWO WINDING				
LAB	LABORATORY	2SR2W	TWO SPEED REVERSING TWO WINDING				
LAN	LOCAL AREA NETWORK						



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LEE'S SUMMIT, MO



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JASON E. CHRISTOFF No. 20012002143  
EXP. DATE: 12/31/20

REV	DESCRIPTION	DATE

Project No.: 62-40497-01

Client Project No.:

Drawing Title:

## ELECTRICAL ABBREVIATIONS AND SCHEDULES

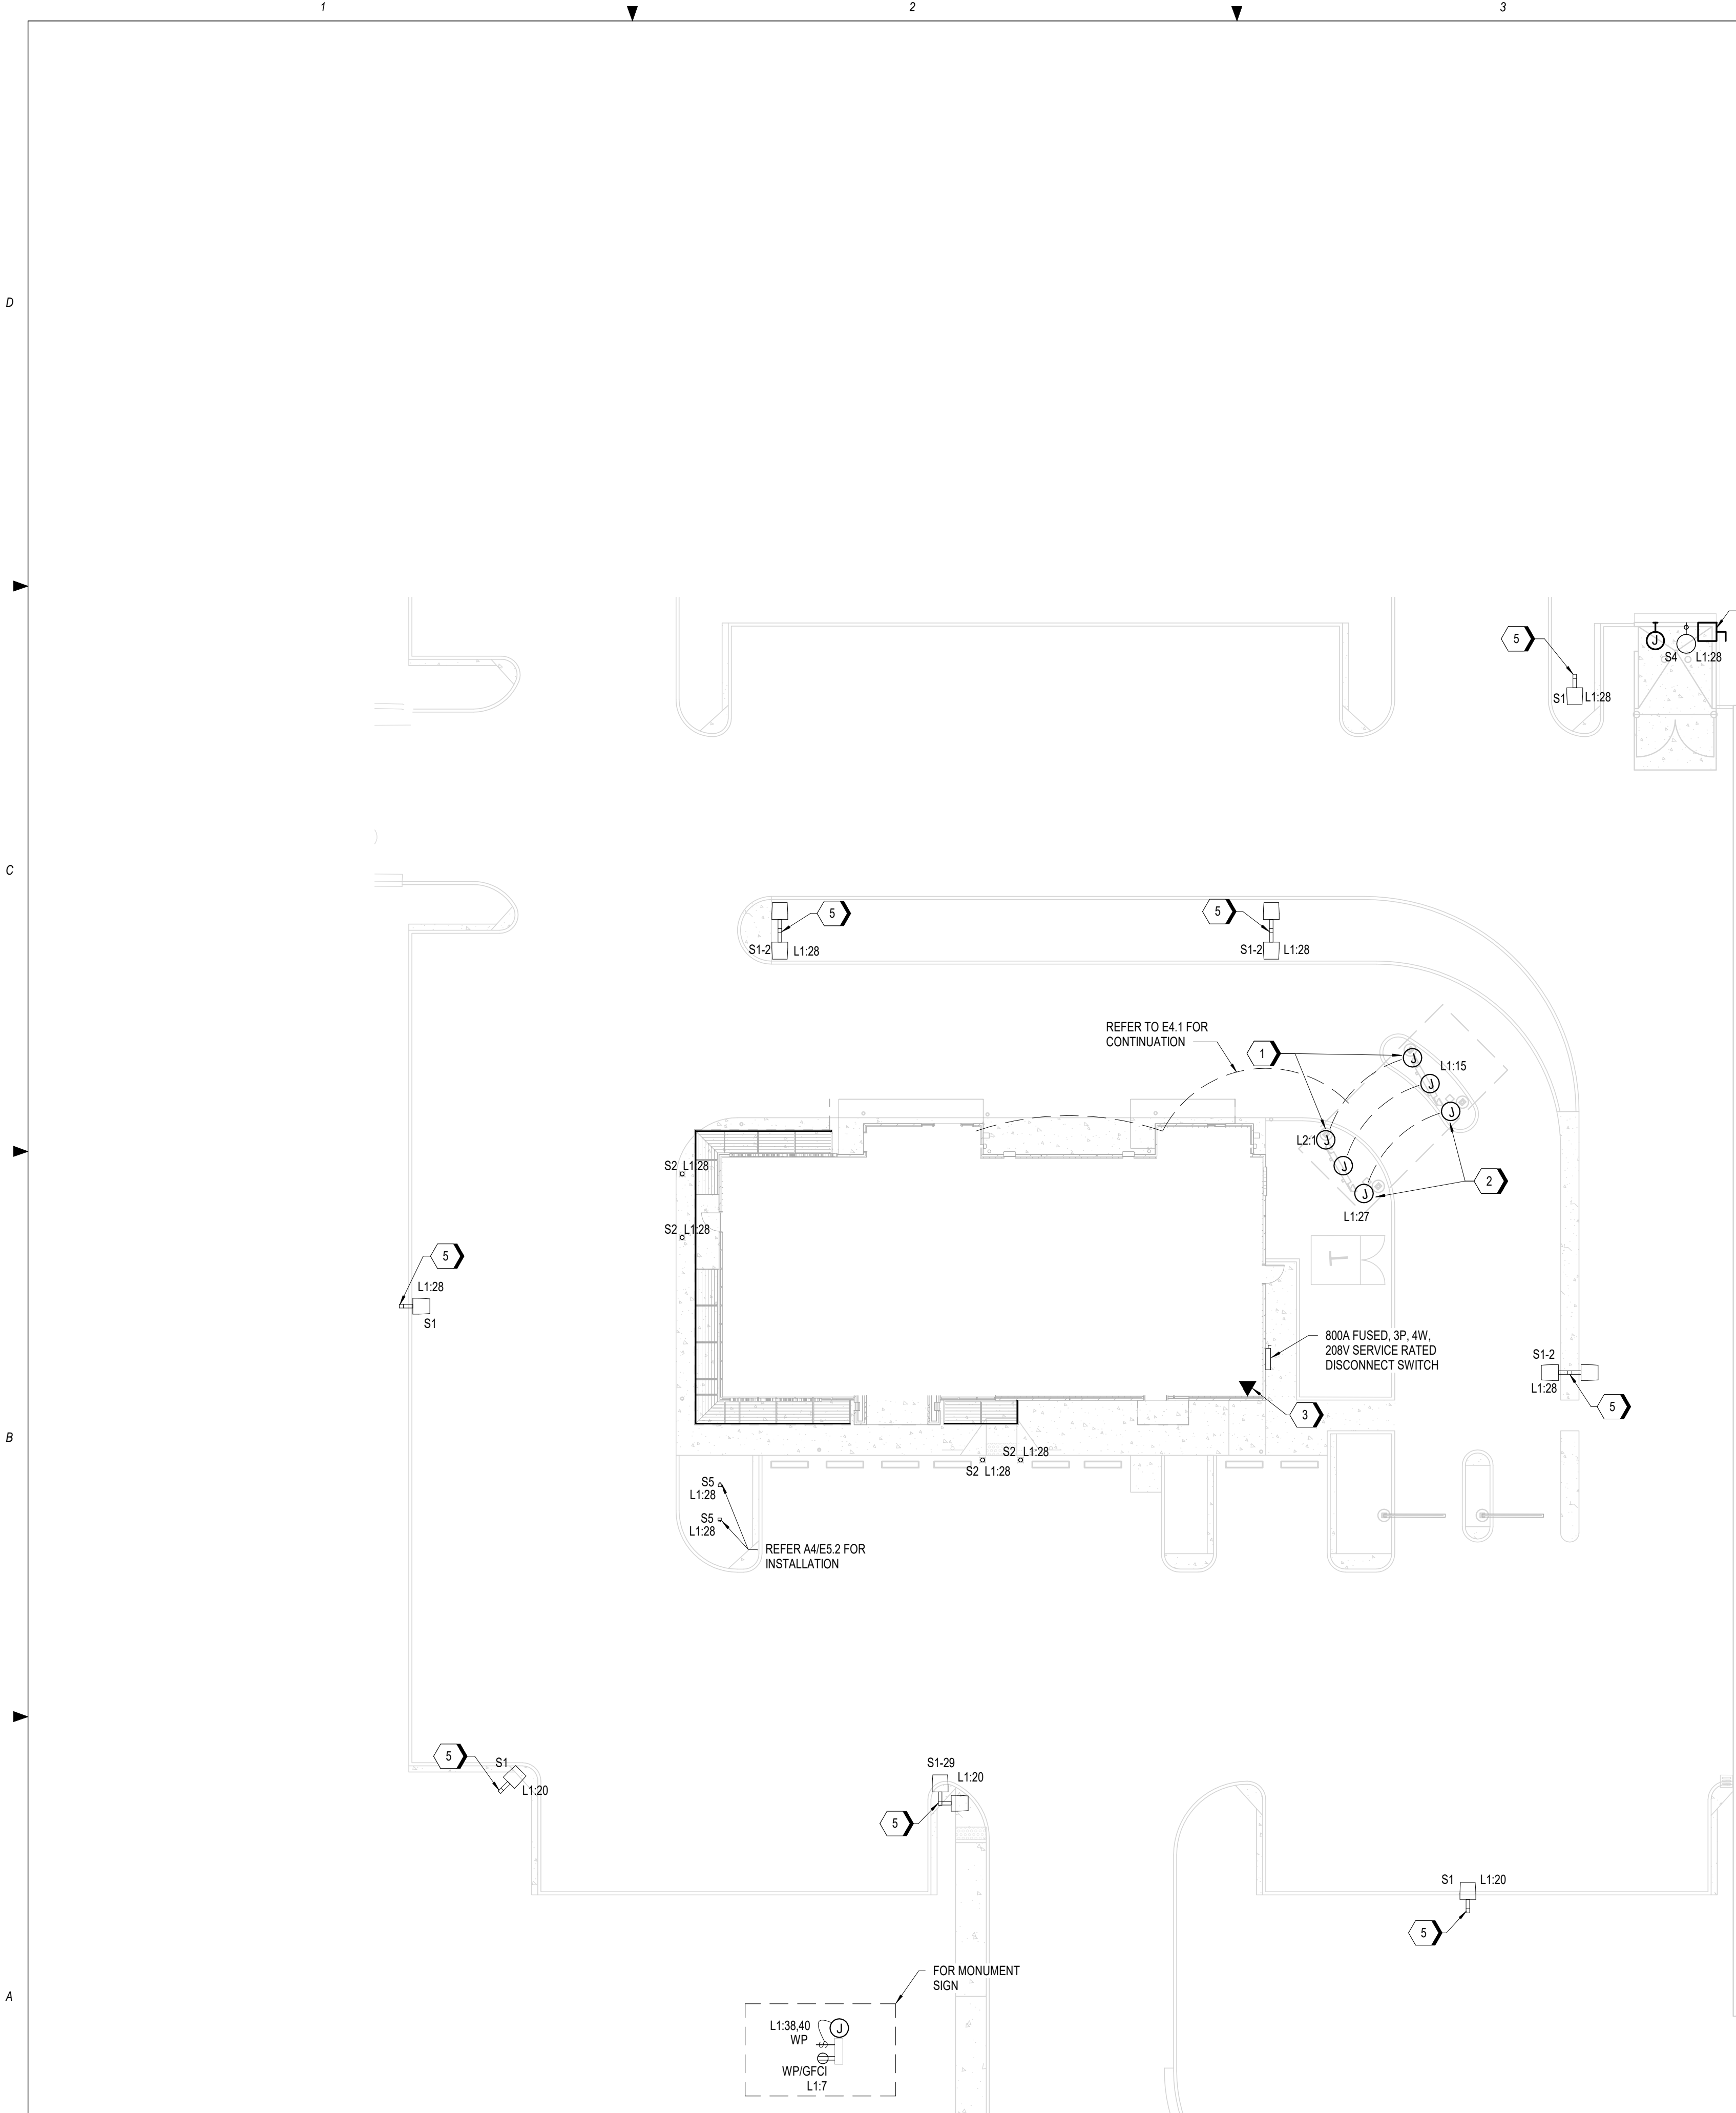
Date: 12/22/20 Phase: PERMIT SET

Designed: DCU

Drawn: DCU

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## GENERAL NOTES

- A. REFER TO SHEET E0.1 AND E0.2 FOR ELECTRICAL SYMBOLS, ABBREVIATIONS, AND GENERAL NOTES.
- B. CIRCUIT SIGNAGE TO NEW BUILDING AS SHOWN.
- C. ELECTRICAL CONTRACTOR SHALL VERIFY UNDERGROUND SERVICE REQUIREMENTS WITH POWER COMPANY.
- D. SIGNAGE TO BE INSTALLED BY SIGN CONTRACTOR. VERIFY EXACT LOCATIONS, LOADS, AND WIRING REQUIREMENTS PRIOR TO INSTALLATION.
- E. ELECTRICAL CONTRACTOR SHALL PROVIDE ALL CONDUIT, WIRING, AND CONNECTIONS FOR SIGNAGE AND PARKING LOT LIGHTS. COORDINATE EXACT LOCATIONS.
- F. ELECTRICAL CONTRACTOR SHALL VERIFY ALL REQUIREMENTS WITH SITE CONTRACTOR.
- G. UNDERGROUND CONDUIT INSTALLATIONS SHALL COMPLY WITH NEC ARTICLE 300.5. UNLESS OTHERWISE NOTED, MINIMUM SIZE FOR CONDUIT SHALL BE 1\".
- H. EXTERIOR LIGHTING AND SIGN LIGHTING SHALL BE CONTROLLED VIA TIME CLOCK AND PHOTOCELL. REFER TO SHEET E5.1 FOR LIGHTING CONTROL WIRING DIAGRAM.

## KEYNOTES

1. EXTERIOR MENU BOARD. PROVIDE 1\" FROM MENU BOARD TO PANEL 'L2' AND PROVIDE 1\" SPARE CONDUIT.
2. 1\" CABLE ELECTRIC SERVICE FOR VEHICLE DETECTOR, AUDIO, AND VIDEO TO BACK OF DRIVE THRU WINDOW SPEAKER POST.
3. TELEPHONE SERVICE IN 2\" UNDERGROUND CONDUIT. ROUTE LINE TO BUILDING AT THIS LOCATION. COORDINATE TELEPHONE SERVICE WITH UTILITY.
4. TRASH COMPACTOR. PROVIDE 30A/240V/3P4W/NEMA 3R DISCONNECT SWITCH WITH 3#10, #10 GND, IN 1\" TO PANEL MDP. STUB UP AGAINST SERVICE YARD WALL.
5. PROVIDE 3/4\" CONDUIT WITH PULL STRING FROM LIGHT POLE BACK TO BUILDING FOR CAMERAS AND ACCESS POINTS. COORDINATE WITH OWNER REPRESENTATIVE FOR ADDITIONAL REQUIREMENTS.



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REV	DESCRIPTION	DATE

Project No.: 62-40497-01

Client Project No.:

Drawing Title:

**ELECTRICAL SITE PLAN**

Date: 12/22/20 Phase: PERMIT SET

Designed: DCU

Drawn: DCU

Checked: KFF

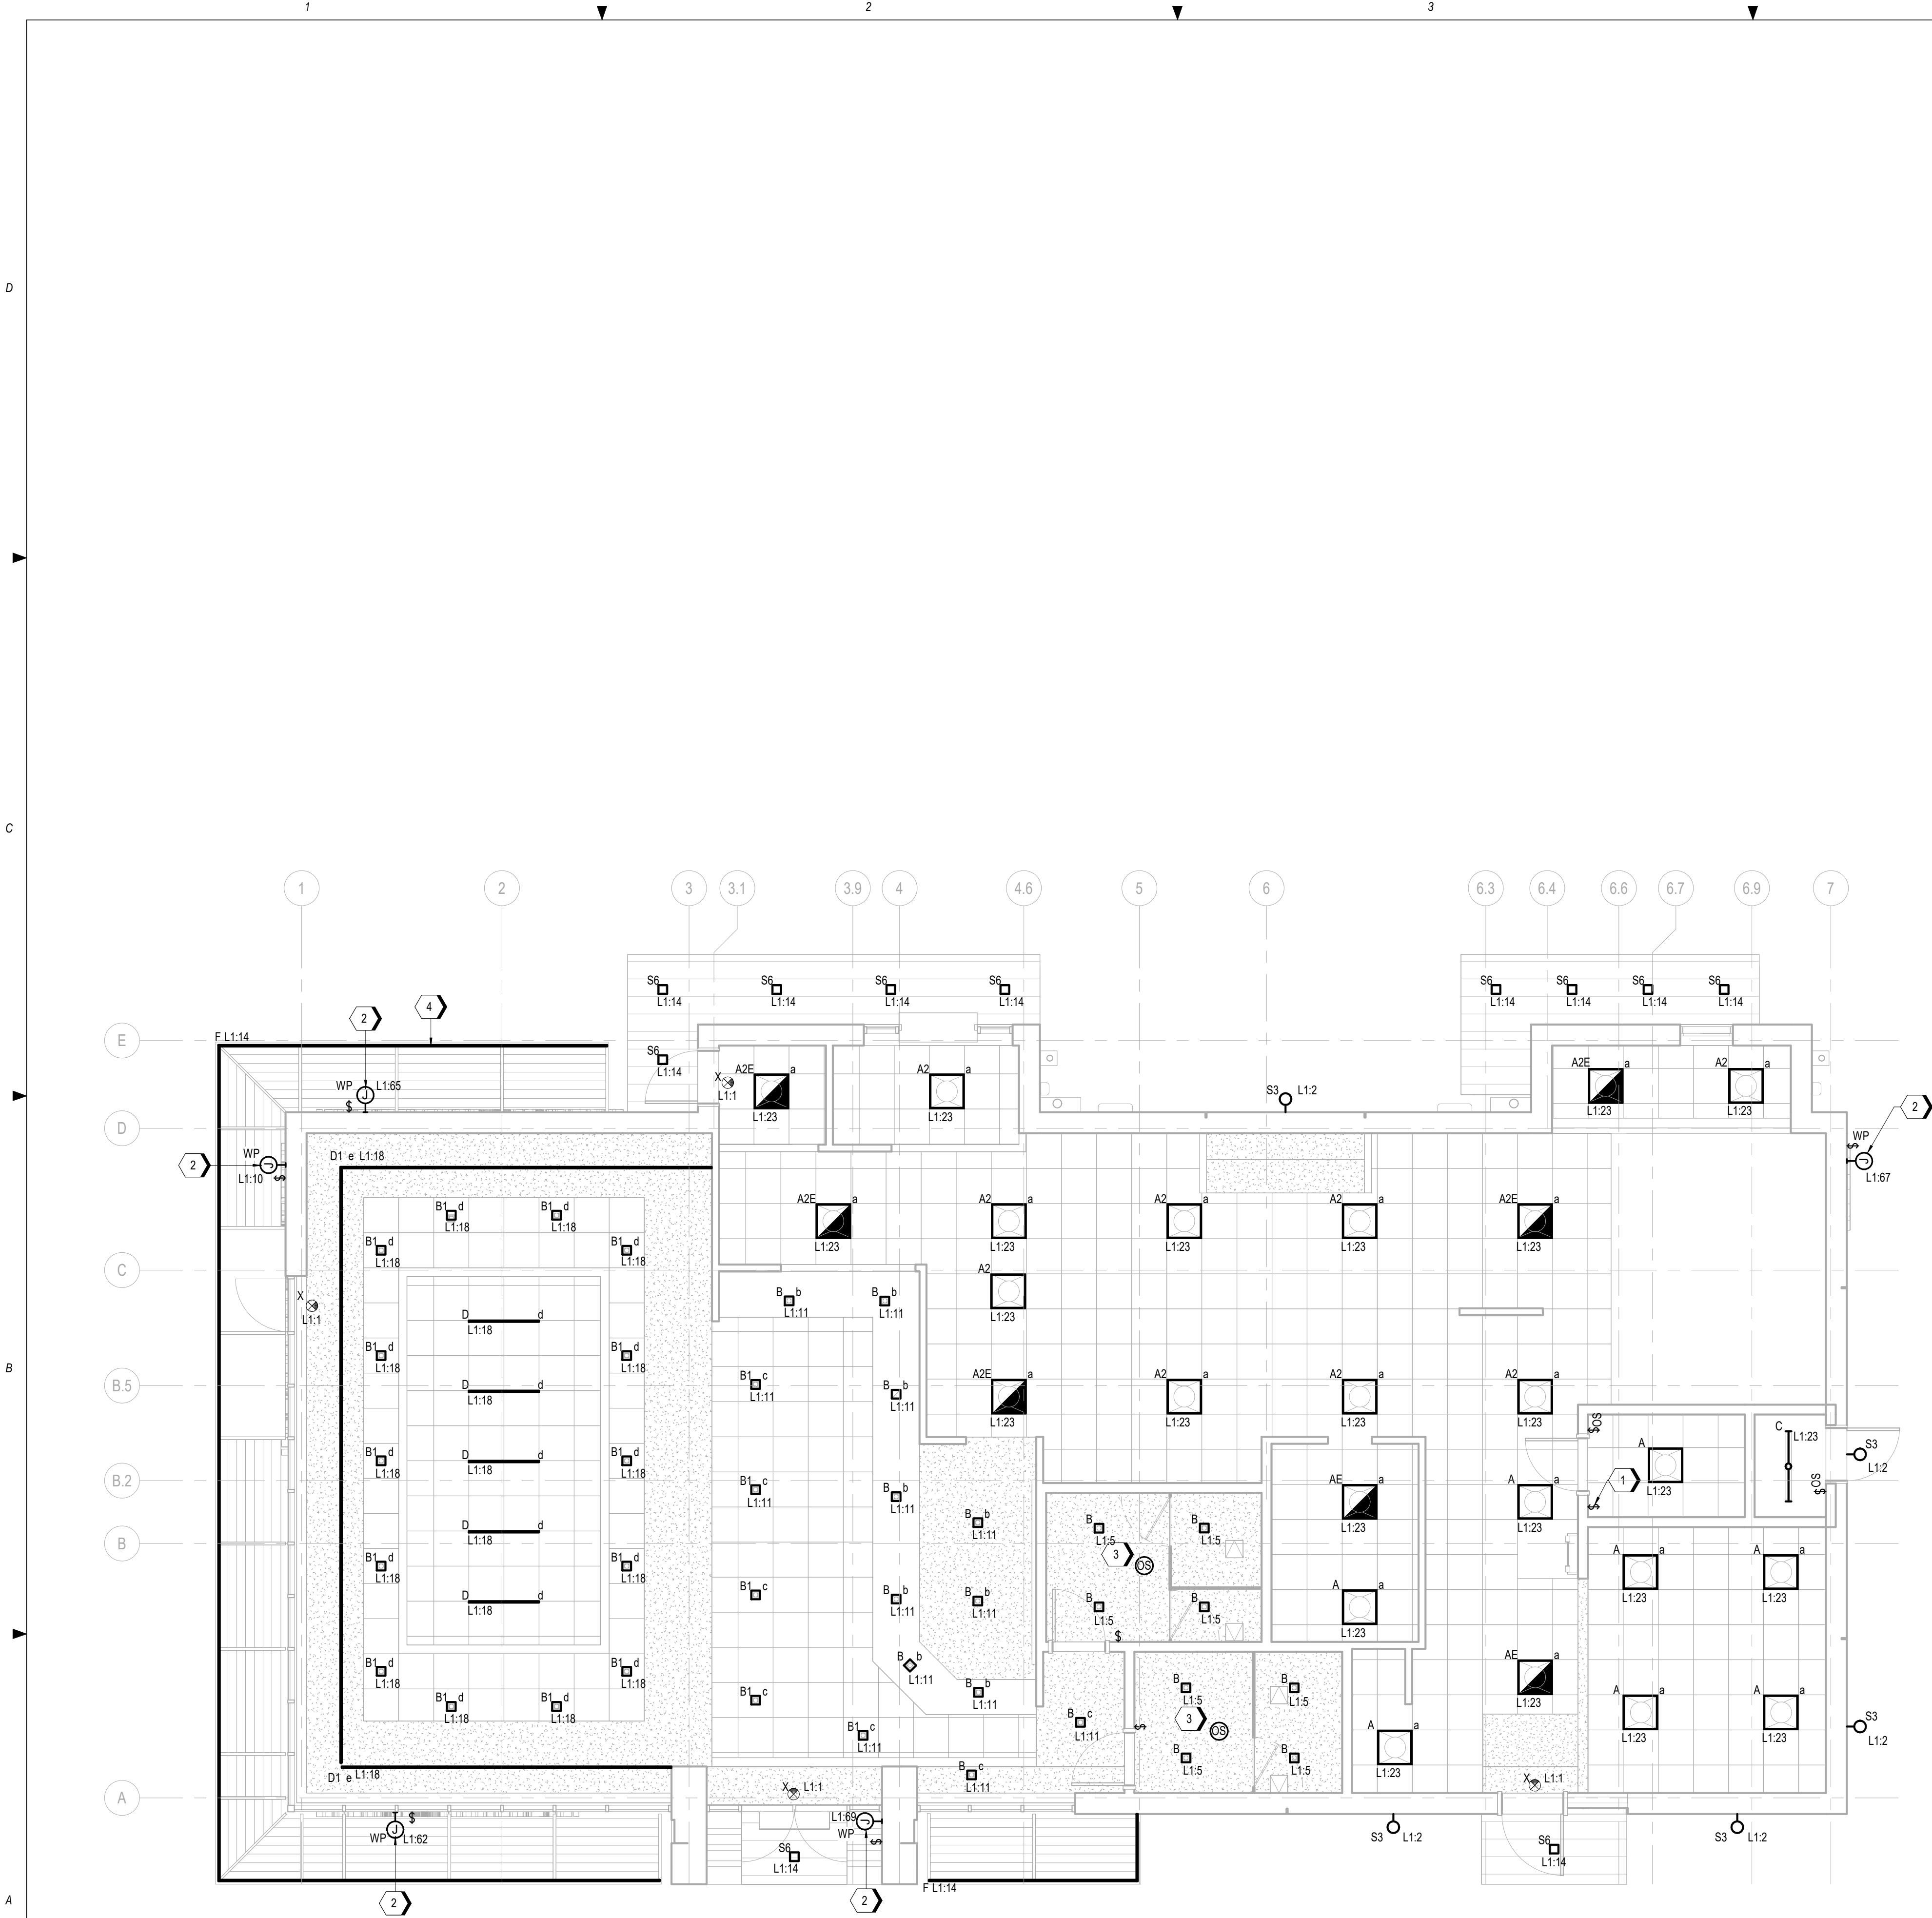
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E1.1



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A1 ELECTRICAL LIGHTING PLAN  
3/16" = 1'-0"

## GENERAL NOTES

- A. REFER TO SHEET E0.1 AND E0.2 FOR ELECTRICAL SYMBOLS, ABBREVIATIONS, AND GENERAL NOTES.
- B. DINING ROOM LIGHTING PLAN CORRESPONDS TO REFLECTED CEILING PLAN, SHEET A1.3. ELECTRICAL CONTRACTOR SHALL REFER TO THE PLANS PROVIDED BY INTERIOR DECOR.
- C. ALL LIGHTING FIXTURES SHALL BE SWITCHED LOCALLY, CONTROLLED BY OCCUPANCY SENSOR OR BMS CONTROLLED UNLESS OTHERWISE NOTED.
- D. SPECIAL SWITCHES SHALL BE INSTALLED AS NOTED.
- E. REFER TO ARCHITECTURAL CEILING PLAN, SHEET A1.3 FOR EXACT LOCATIONS OF ALL LIGHT FIXTURES AND HVAC DIFFUSER LOCATIONS PRIOR TO ANY ELECTRICAL ROUGH-IN.
- F. COORDINATE EXACT LOCATION OF J-BOXES WITH ACTUAL LOCATION OF RESPECTIVE SIGNAGE OR LIGHTING. ALL EXTERIOR SIGNAGE AND LIGHTING SHALL BE CONTROLLED THROUGH A LIGHTING CONTROL PANEL. LIGHTING CONTROL PANEL SHALL HAVE AN 8-POLE, NORMALLY OPEN CONTACTOR. ALL WHATABURGER LOGO BUILDING SIGNS CONNECTED TO OUTDOOR SIGNAGE TERMINALS. SOFFIT RECESSED FIXTURES, AND BACK DOOR LIGHTING ARE CONNECTED TO OUTDOOR LIGHTING TERMINALS.
- G. REFER TO SHEET E1.1 FOR LOCATIONS OF SIGNAGE, PARKING LOT LIGHTING, DRIVE THRU CONDUITS AND SERVICE LOCATION.
- H. ELECTRICAL CONTRACTOR SHALL DETERMINE FINAL CONDUCTOR LENGTHS AND SIZES AS PER N.E.C. SIZE OF CONDUCTORS SHALL BE ADJUSTED FOR VOLTAGE DROP AS REQUIRED BY N.E.C.
- I. ALL PENETRATIONS THROUGH THE WALK IN COOLER/FREEZER ARE TO BE SEALED WITH SILICONE AROUND THE INTERIOR AND EXTERIOR OF THE CONDUITS TO PREVENT CONDENSATION.
- J. ELECTRICAL CONTRACTOR SHALL FEED SIGNAGE AND SECURITY LIGHTING WITH SEPERATE CIRCUITS ON ANY COMMON CONDUIT RUN. FOR EXAMPLE, DO NOT FEED A POLE TOP SECURITY LIGHT IN THE SAME CIRCUIT WITH THE LARGE SIGN. SEPERATE ALL SIGNAGE AND SECURITY LIGHTING.
- K. REFER TO ARCHITECTURAL ELEVATIONS FOR BUILDING SIGN LOCATIONS. COORDINATE ALL J-BOX LOCATIONS WITH SIGN LOCATIONS PRIOR TO INSTALLATION.
- L. REFER TO SHEET E6.1 FOR LIGHT FIXTURE SCHEDULE.

## KEYNOTES

- 1. PROVIDE GRAPHIC LIGHTING CONTROL SCENE SELECTOR SWITCH TO CONTROL SWITCH LEGS "a-e".
- 2. COORDINATE EXACT LOCATION OF JUNCTION BOX FOR EXTERIOR SIGNAGE WITH ACTUAL LOCATION OF EXTERIOR SIGNAGE. PROVIDE SWITCH FOR SIGNAGE IN WEATHER PROOF ENCLOSURE.
- 3. CEILING/WALL MOUNTED OCCUPANCY SENSOR TO CONTROL LIGHTING WITHIN THIS SPACE WITH A MAXIMUM DELAY SETTING OF 30 MINUTES.
- 4. REFER TO VIEW C1 ON SHEET A6.8 FOR TYPE F DETAIL.



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Project No.: 62-40497-01

Client Project No.:

Drawing Title:

**ELECTRICAL LIGHTING PLAN -**  
**FIRST FLOOR**

Date: 12/22/20 Phase: PERMIT SET  
Designed: DCU Drawing No.:  
Drawn: DCU  
Checked: KFF

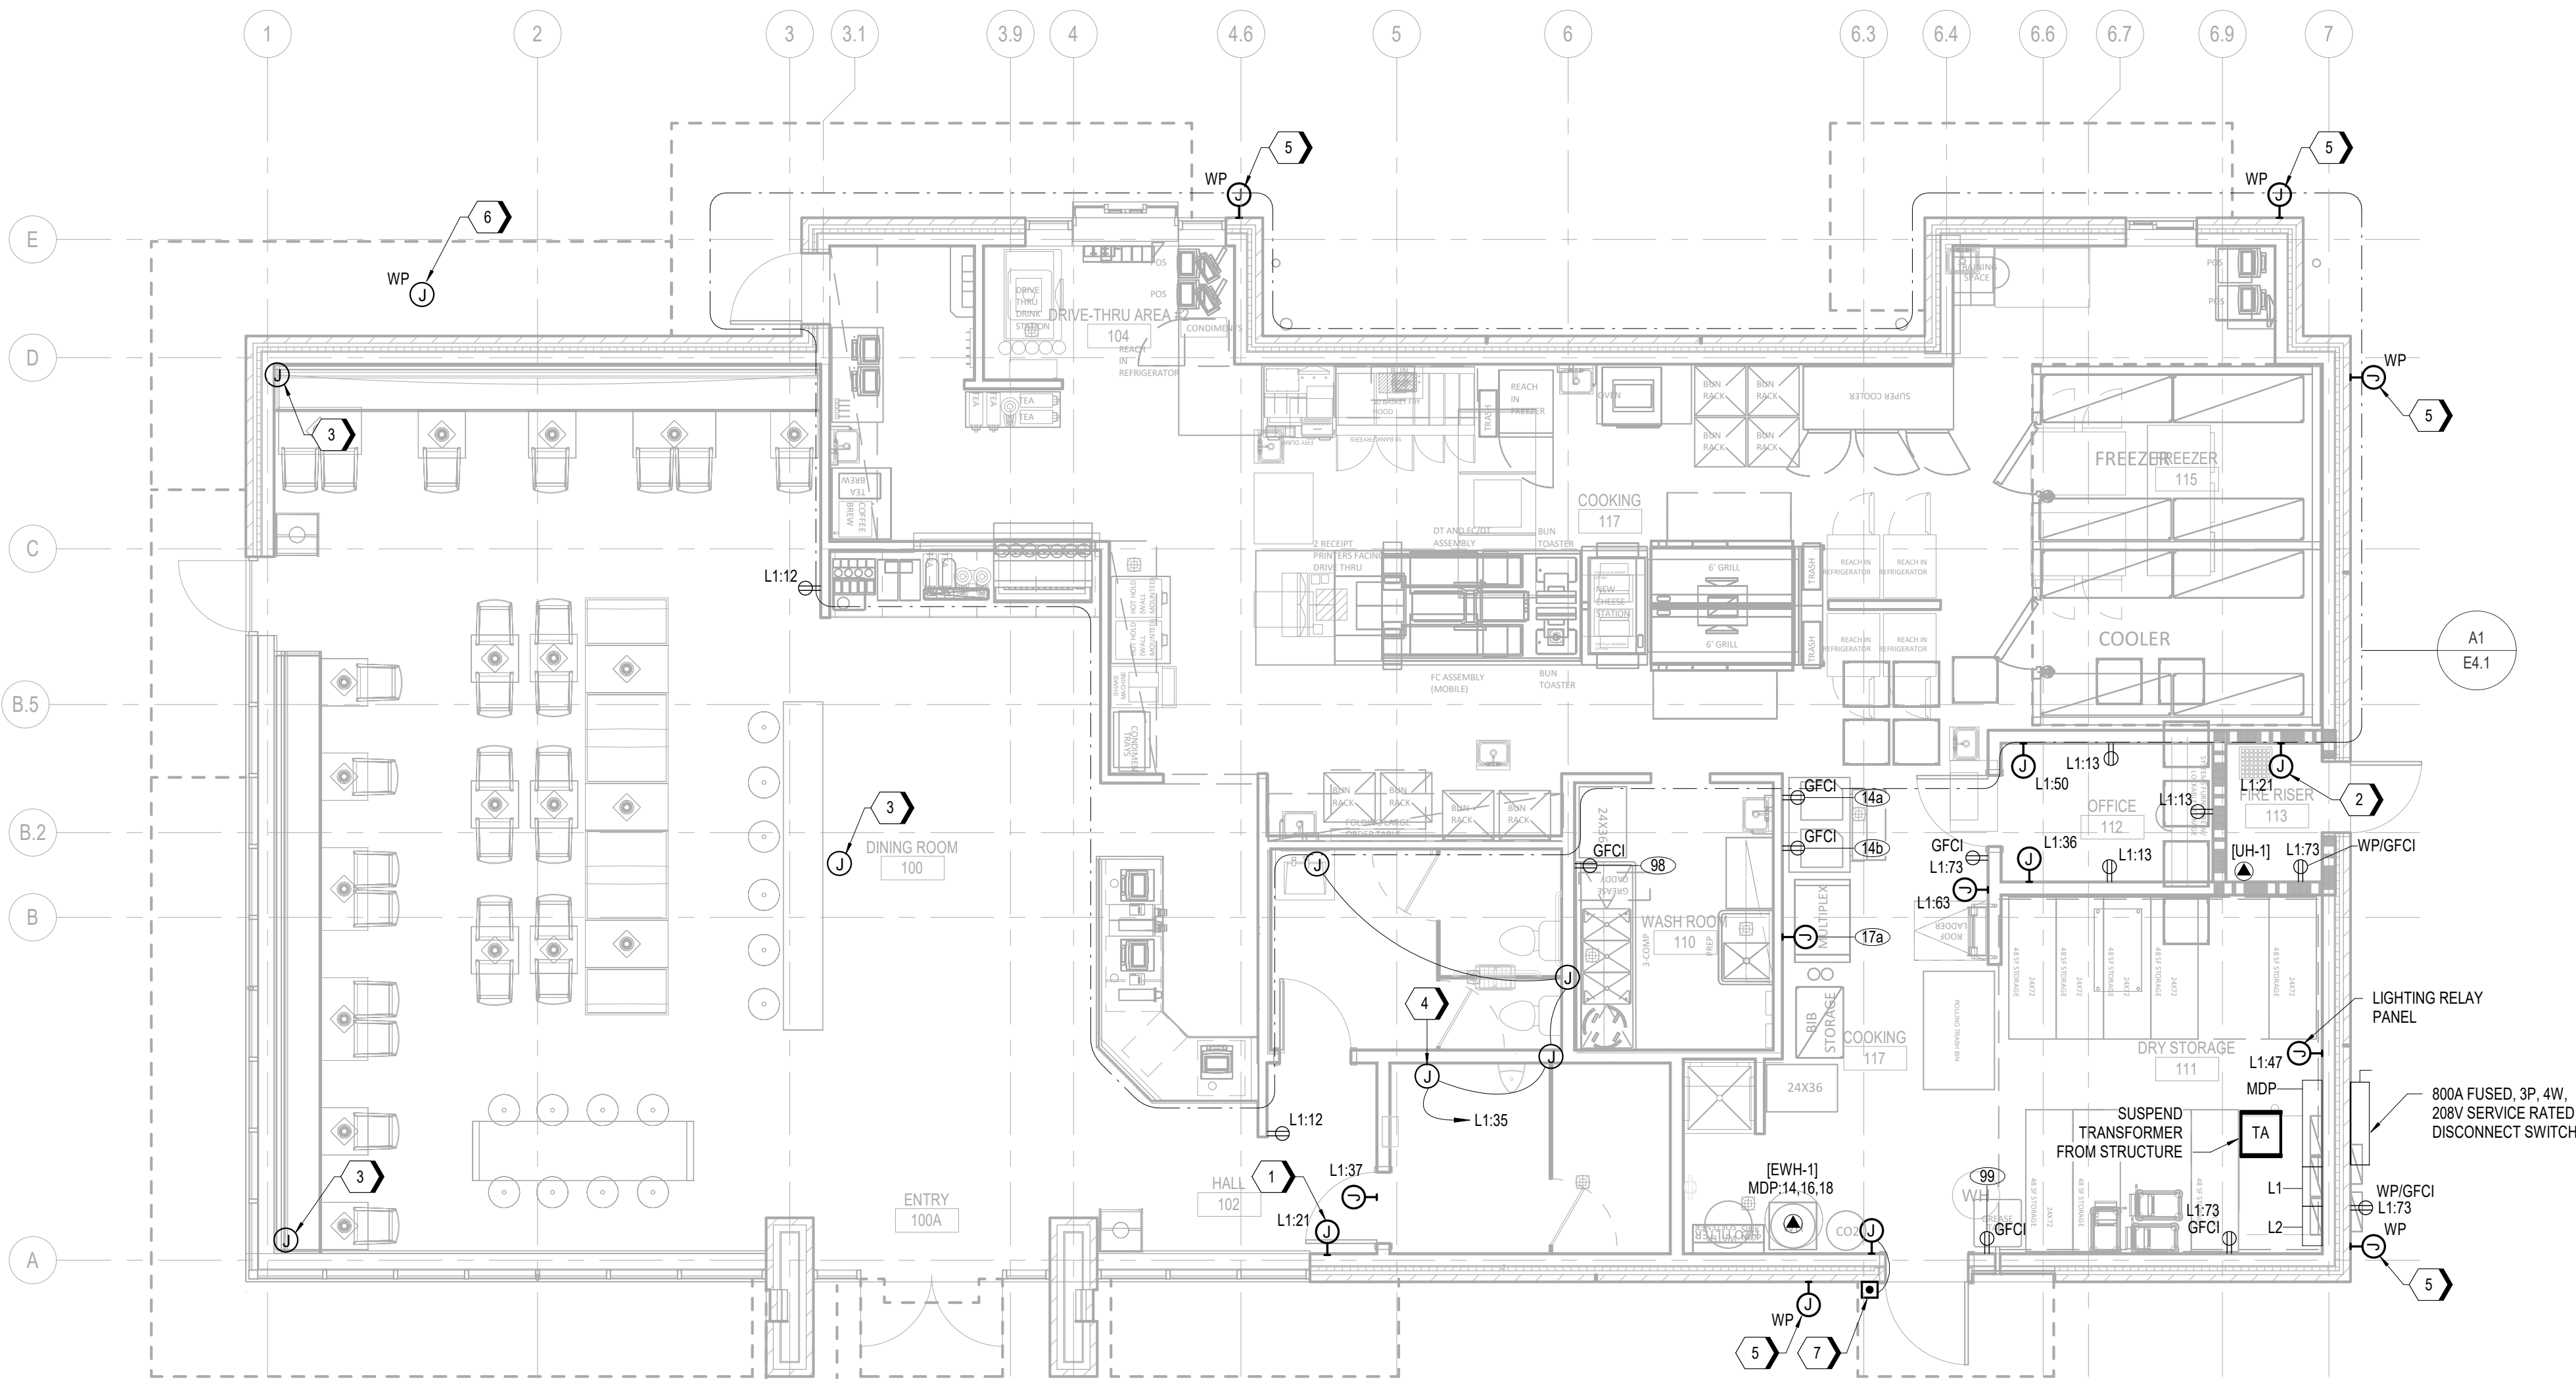
**E2.1**

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A1 ELECTRICAL POWER PLAN

3/16" = 1'-0"



GENERAL NOTES

- REFER TO SHEET E0.1 AND E0.2 FOR ELECTRICAL SYMBOLS, ABBREVIATIONS, AND GENERAL NOTES.
- VERIFY ALL POWER AND TELEPHONE COMPANY REQUIREMENTS PRIOR TO ALL INSTALLATIONS.
- LEAVE A PULL WIRE IN ALL EMPTY CONDUITS.
- ELECTRICAL CONTRACTOR SHALL ROUTE UNDERFLOOR POWER WIRING IN CONDUITS TO KITCHEN PANELS AS REQUIRED.
- ELECTRICAL KITCHEN EQUIPMENT SCHEDULE IS ONLY SHOWN FOR REFERENCE. COORDINATE ALL KITCHEN RECEPTACLES, EQUIPMENT CONNECTIONS, AND INSTALLATION WITH KITCHEN DRAWINGS AND EQUIPMENT SUPPLIER. REFER TO EQUIPMENT SUPPLIER DRAWINGS FOR PRE-WIRED KITCHEN PANELS AND FOR ADDITIONAL EQUIPMENT LISTING AND REQUIREMENTS.
- PANELS SHALL NOT TAKE MORE SPACE THAN ALLOCATED ON PLANS. ONLY SPACES FOR BREAKERS SHALL HAVE KNOCKOUTS IN PANELS. BREAKER CLOSURE PLATES SHALL BE KEPT TO A MINIMUM.
- ELECTRICAL CONTRACTOR SHALL CONNECT ALL INTERNAL WIRING (CORD SETS) BETWEEN VENTILATION STAND AND PASS-THROUGH STAND. CONNECTIONS SHALL BE COMPLETE AND TESTED BEFORE ACCEPTANCE.
- CENTER ISLAND KITCHEN EQUIPMENT IS PROVIDED PREWIRED TO EQUIPMENT CONTRACTORS.
- ALL JUNCTION BOXES SERVING ISOLATED GROUND RECEPTACLES, SHALL BE LABELED "REGISTER."
- ALL ISOLATED GROUND SPLICES SHALL BE MADE WITH CRIMP TYPE CONNECTORS. WIRE NUTS ARE NOT ACCEPTABLE.
- REFER TO KITCHEN EQUIPMENT PLANS FOR EXACT LOCATION OF ELEC. CONDUIT STUB-UPS AT COOK LINES.
- ALL KITCHEN 115 AND 120 VAC RECEPTACLES SHALL BE GFCI PROTECTED PER NEC AND LOCAL AHJ.
- REFER TO SHEET E6.1 FOR KITCHEN EQUIPMENT SCHEDULE.

KEYNOTES

- FIRE ALARM ANNUNCIATOR PANEL. REFER TO FIRE ALARM DRAWINGS FOR FURTHER INFORMATION.
- FIRE ALARM CONTROL PANEL. REFER TO FIRE ALARM DRAWINGS FOR FURTHER INFORMATION.
- PROVIDE CEILING MOUNTED JUNCTION BOX FOR SECURITY. PROVIDE 3/4" CONDUIT WITH NYLON PULL STRING FROM ELECTRICAL PANEL AREA TO JUNCTION BOX.
- PROVIDE STEP-DOWN TRANSFORMER FOR FLUSH VALVES.
- PROVIDE WALL MOUNTED, GASKETED JUNCTION BOX MOUNTED 9'-0" ABOVE GRADE FOR SECURITY. PROVIDE 3/4" CONDUIT WITH NYLON PULL STRING FROM ELECTRICAL PANEL AREA TO JUNCTION BOX.
- PROVIDE CEILING MOUNTED, GASKETED JUNCTION BOX FOR SECURITY. PROVIDE 3/4" CONDUIT WITH NYLON PULL STRING FROM ELECTRICAL PANEL AREA TO JUNCTION BOX.
- PROVIDE BELL AND BUZZER WITH STAINLESS STEEL COVER PLATE. PROVIDE 120/24V CONTROL TRANSFORMER. EDWARDS #156G-3G5/592/620.



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ELECTRICAL POWER PLAN

Date: 12/22/20

Phase: PERMIT SET

Designed: DCU

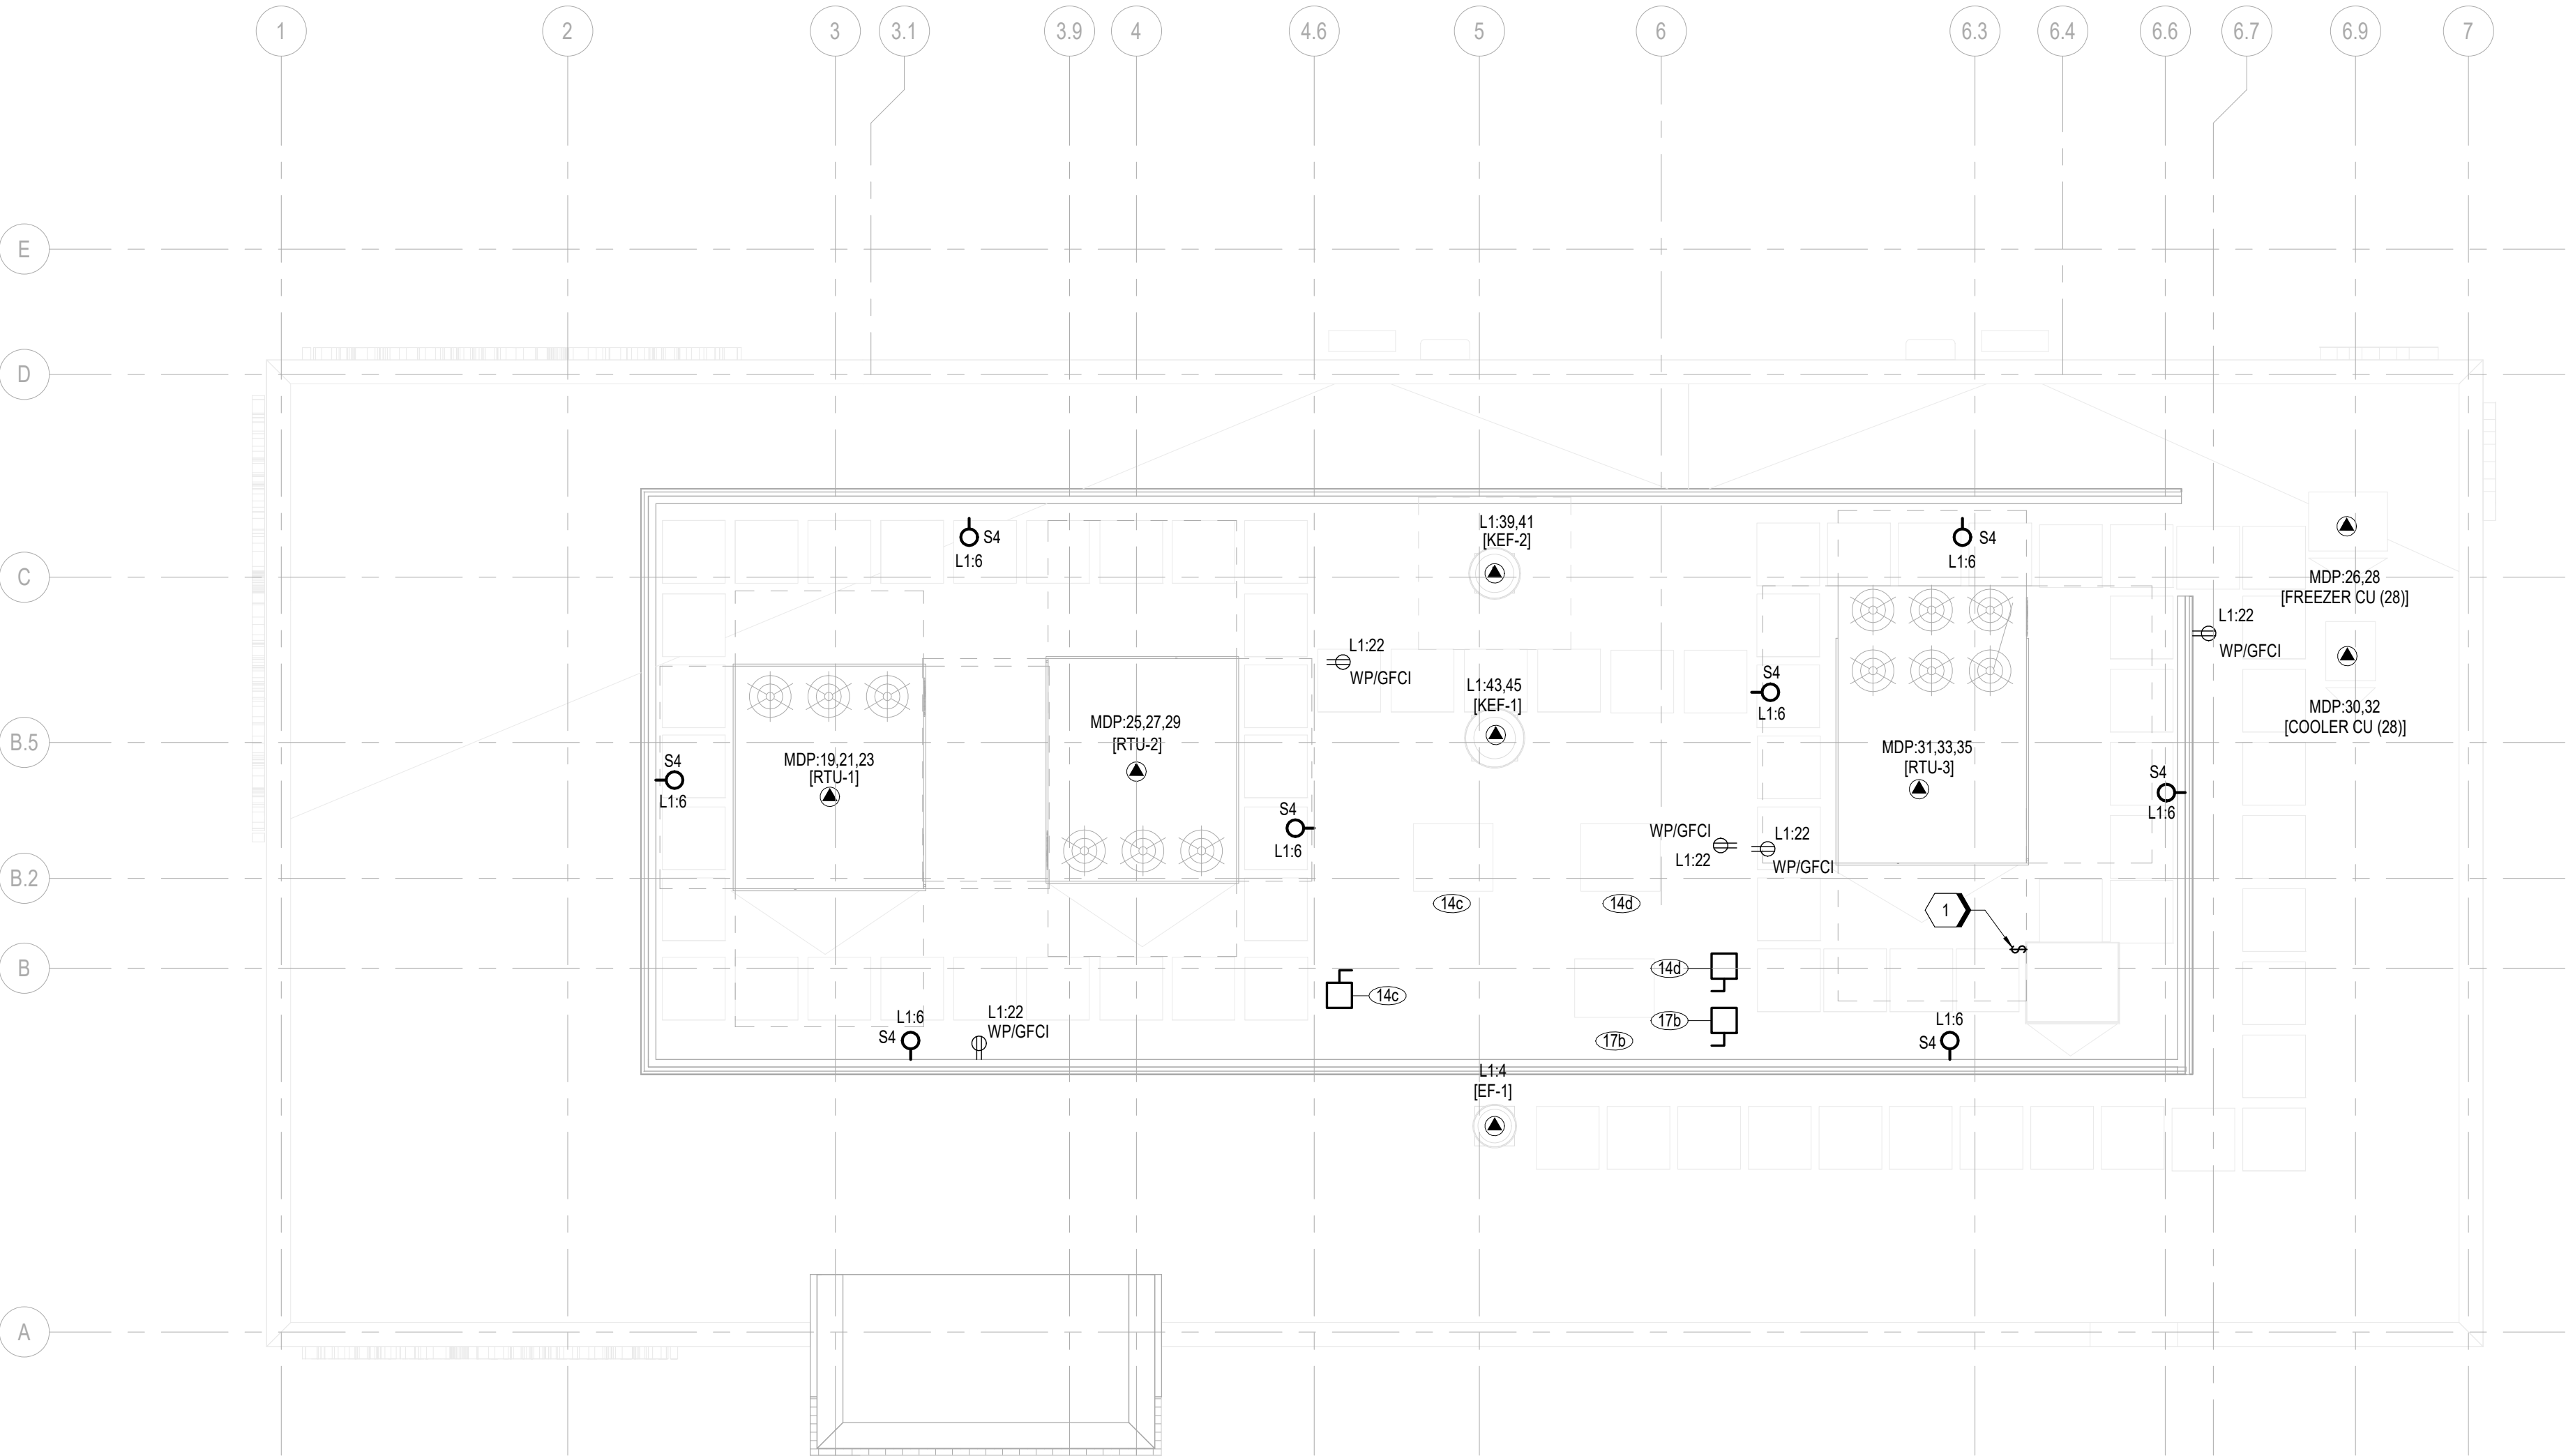
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Drawn: DCU

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E3.1

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A1 ELECTRICAL POWER PLAN - ROOF  
3/16" = 1'-0"

## GENERAL NOTES

- A. REFER TO SHEET E0.1 AND E0.2 FOR ELECTRICAL SYMBOLS, ABBREVIATIONS, AND GENERAL NOTES.
- B. VERIFY ALL POWER AND TELEPHONE COMPANY REQUIREMENTS PRIOR TO ALL INSTALLATIONS.
- C. LEAVE A PULL WIRE IN ALL EMPTY CONDUITS.
- D. ELECTRICAL CONTRACTOR SHALL ROUTE UNDERFLOOR POWER WIRING IN CONDUITS TO KITCHEN PANELS AS REQUIRED.
- E. ELECTRICAL KITCHEN EQUIPMENT SCHEDULE IS ONLY SHOWN FOR REFERENCE. COORDINATE ALL KITCHEN RECEPTACLES, EQUIPMENT CONNECTIONS, AND INSTALLATION WITH KITCHEN DRAWINGS AND EQUIPMENT SUPPLIER. REFER TO EQUIPMENT SUPPLIER DRAWINGS FOR PRE-WIRED KITCHEN PANELS AND FOR ADDITIONAL EQUIPMENT LISTING AND REQUIREMENTS.
- F. PANELS SHALL NOT TAKE MORE SPACE THAN ALLOCATED ON PLANS. ONLY SPACES FOR BREAKERS SHALL HAVE KNOCKOUTS IN PANELS. BREAKER CLOSURE PLATES SHALL BE KEPT TO A MINIMUM.
- G. ELECTRICAL CONTRACTOR SHALL CONNECT ALL INTERNAL WIRING (CORD SETS) BETWEEN VENTILATION STAND AND PASS-THROUGH STAND. CONNECTIONS SHALL BE COMPLETE AND TESTED BEFORE ACCEPTANCE.
- H. CENTER ISLAND KITCHEN EQUIPMENT IS PROVIDED PREWIRED TO EQUIPMENT CONTRACTORS.
- I. ALL JUNCTION BOXES SERVING ISOLATED GROUND RECEPTACLES, SHALL BE LABELED "REGISTER."
- J. ALL ISOLATED GROUND SPLICES SHALL BE MADE WITH CRIMP TYPE CONNECTORS. WIRE NUTS ARE NOT ACCEPTABLE.
- K. REFER TO KITCHEN EQUIPMENT PLANS FOR EXACT LOCATION OF ELEC. CONDUIT STUB-UPS AT COOK LINES.
- L. ALL KITCHEN 115 AND 120 VAC RECEPTACLES SHALL BE GFCI PROTECTED PER NEC AND LOCAL AHJ.
- M. REFER TO SHEET E6.1 FOR KITCHEN EQUIPMENT SCHEDULE.

## KEYNOTES

1. PROVIDE WEATHER PROOF ENCLOSURE FOR ROOF LIGHTING AND SWITCH.



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**WHATABURGER 20-M  
LEE'S SUMMIT**

LEE'S SUMMIT, MO



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12/22/20  
PROFESSIONAL OF RECORD:  
JASON E. CHRISTOFF No. 20012002143  
EXP. DATE: 12/31/20

REV	DESCRIPTION	DATE

Project No.: 62-40497-01

Client Project No.:

Drawing Title:

**ELECTRICAL POWER PLAN -  
ROOF**

Date: 12/22/20 Phase: PERMIT SET

Designed: DCU

Drawn: DCU

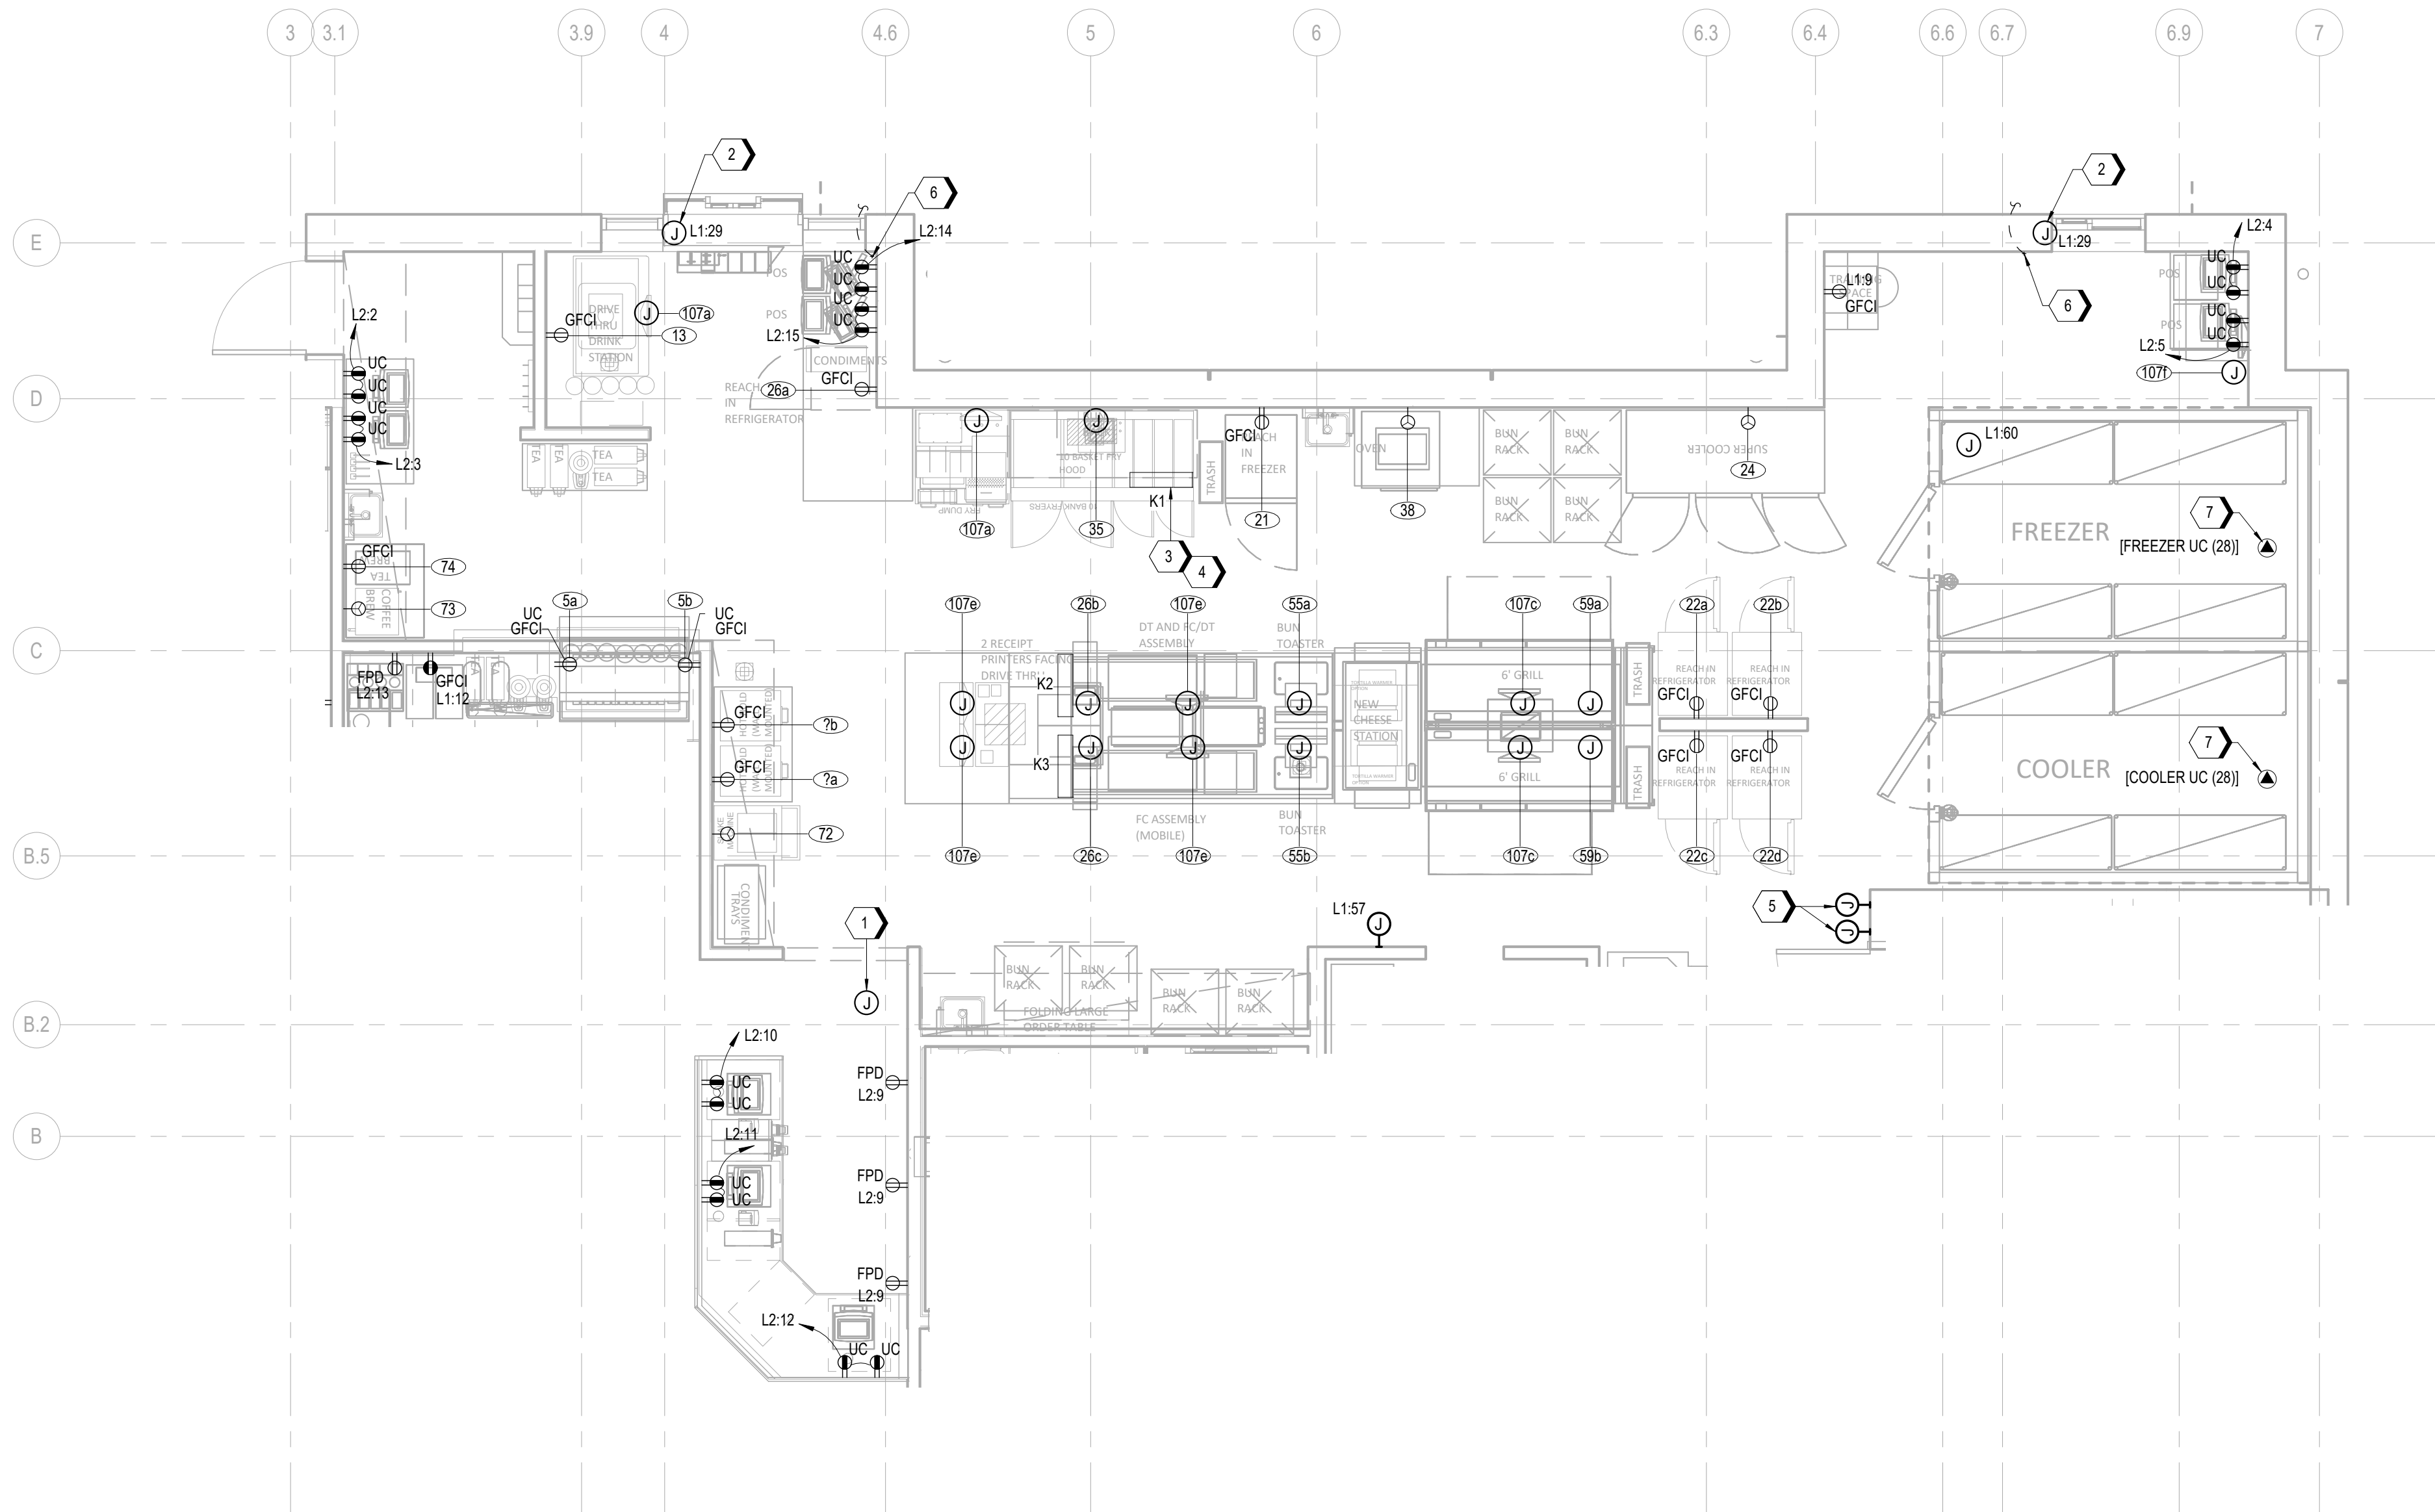
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Drawing No.:

E3.2

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A1 ENLARGED FLOOR PLAN - KITCHEN  
1/4" = 1'-0"

## GENERAL NOTES

- A. REFER TO SHEET E0.1 AND E0.2 FOR ELECTRICAL SYMBOLS, ABBREVIATIONS, AND GENERAL NOTES.
- B. VERIFY ALL POWER AND TELEPHONE COMPANY REQUIREMENTS PRIOR TO ALL INSTALLATIONS.
- C. LEAVE A PULL WIRE IN ALL EMPTY CONDUITS.
- D. ELECTRICAL CONTRACTOR SHALL ROUTE UNDERFLOOR POWER WIRING IN CONDUITS TO KITCHEN PANELS AS REQUIRED.
- E. ELECTRICAL KITCHEN EQUIPMENT SCHEDULE IS ONLY SHOWN FOR REFERENCE. COORDINATE ALL KITCHEN RECEPTACLES, EQUIPMENT CONNECTIONS, AND INSTALLATION WITH KITCHEN DRAWINGS AND EQUIPMENT SUPPLIER. REFER TO EQUIPMENT SUPPLIER DRAWINGS FOR PRE-WIRED KITCHEN PANELS AND FOR ADDITIONAL EQUIPMENT LISTING AND REQUIREMENTS.
- F. PANELS SHALL NOT TAKE MORE SPACE THAN ALLOCATED ON PLANS. ONLY SPACES FOR BREAKERS SHALL HAVE KNOCKOUTS IN PANELS. BREAKER CLOSURE PLATES SHALL BE KEPT TO A MINIMUM.
- G. ELECTRICAL CONTRACTOR SHALL CONNECT ALL INTERNAL WIRING (CORD SETS) BETWEEN VENTILATION STAND AND PASS-THROUGH STAND. CONNECTIONS SHALL BE COMPLETE AND TESTED BEFORE ACCEPTANCE.
- H. CENTER ISLAND KITCHEN EQUIPMENT IS PROVIDED PREWIRED TO EQUIPMENT CONTRACTORS.
- I. ALL JUNCTION BOXES SERVING ISOLATED GROUND RECEPTACLES, SHALL BE LABELED "REGISTER."
- J. ALL ISOLATED GROUND SPLICES SHALL BE MADE WITH CRIMP TYPE CONNECTORS. WIRE NUTS ARE NOT ACCEPTABLE.
- K. REFER TO KITCHEN EQUIPMENT PLANS FOR EXACT LOCATION OF ELEC. CONDUIT STUB-UPS AT COOK LINES.
- L. ALL KITCHEN 115 AND 120 VAC RECEPTACLES SHALL BE GFCI PROTECTED PER NEC AND LOCAL AHJ.
- M. REFER TO SHEET E6.1 FOR KITCHEN EQUIPMENT SCHEDULE.

## KEYNOTES

1. PROVIDE CEILING MOUNTED JUNCTION BOX FOR SECURITY, PROVIDE 3/4" CONDUIT WITH NYLON PULL STRING FROM ELECTRICAL PANEL AREA TO JUNCTION BOX.
2. PROVIDE JUNCTION BOX FOR POWER CONNECTION TO DRIVE-THRU WINDOW. COORDINATE WITH KITCHEN EQUIPMENT DRAWINGS FOR EXACT LOCATION AND CONNECTION REQUIREMENTS.
3. PROVIDE 3/4" UNDERGROUND CONDUIT FOR POWER TO ANSUL FIRE SUPPRESSION SYSTEM.
4. PRE-WIRED KITCHEN ELECTRICAL PANELS FURNISHED BY EQUIPMENT SUPPLIER. ACTUAL LOCATION DETERMINED BY EQUIPMENT SUPPLIER AND SHOWN FOR REFERENCE ONLY. REFER TO KITCHEN EQUIPMENT SUPPLIER FOR ALL INSTALLATION/CONNECTION REQUIREMENTS.
5. INSTALL RACO #294 4" OCTAGON BOX MOUNTED FLUSH IN WALL 48" ABOVE FINISHED FLOOR WITH 1/2" CONDUIT ROUTED TO ABOVE CEILING WITH PULLWIRE FOR ANSUL PULLSTATION.
6. STUB UP 3/4" PVC 88" ABOVE FINISHED FLOOR FOR LOW VOLTAGE FOR DRIVE-THRU SENSOR. REFER TO SHEET E1.1 FOR CONTINUATION.
7. REFER TO KITCHEN EQUIPMENT SUPPLIER FOR TIME CLOCK AND LOCAL DISCONNECTING MEANS IN FREEZER/COOLER.



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REV	DESCRIPTION	DATE

Project No.: 62-40497-01

Client Project No.:

Drawing Title:

**ELECTRICAL ENLARGED  
PLANS**

Date: 12/22/20 Phase: PERMIT SET

Designed: DCU

Drawn: DCU

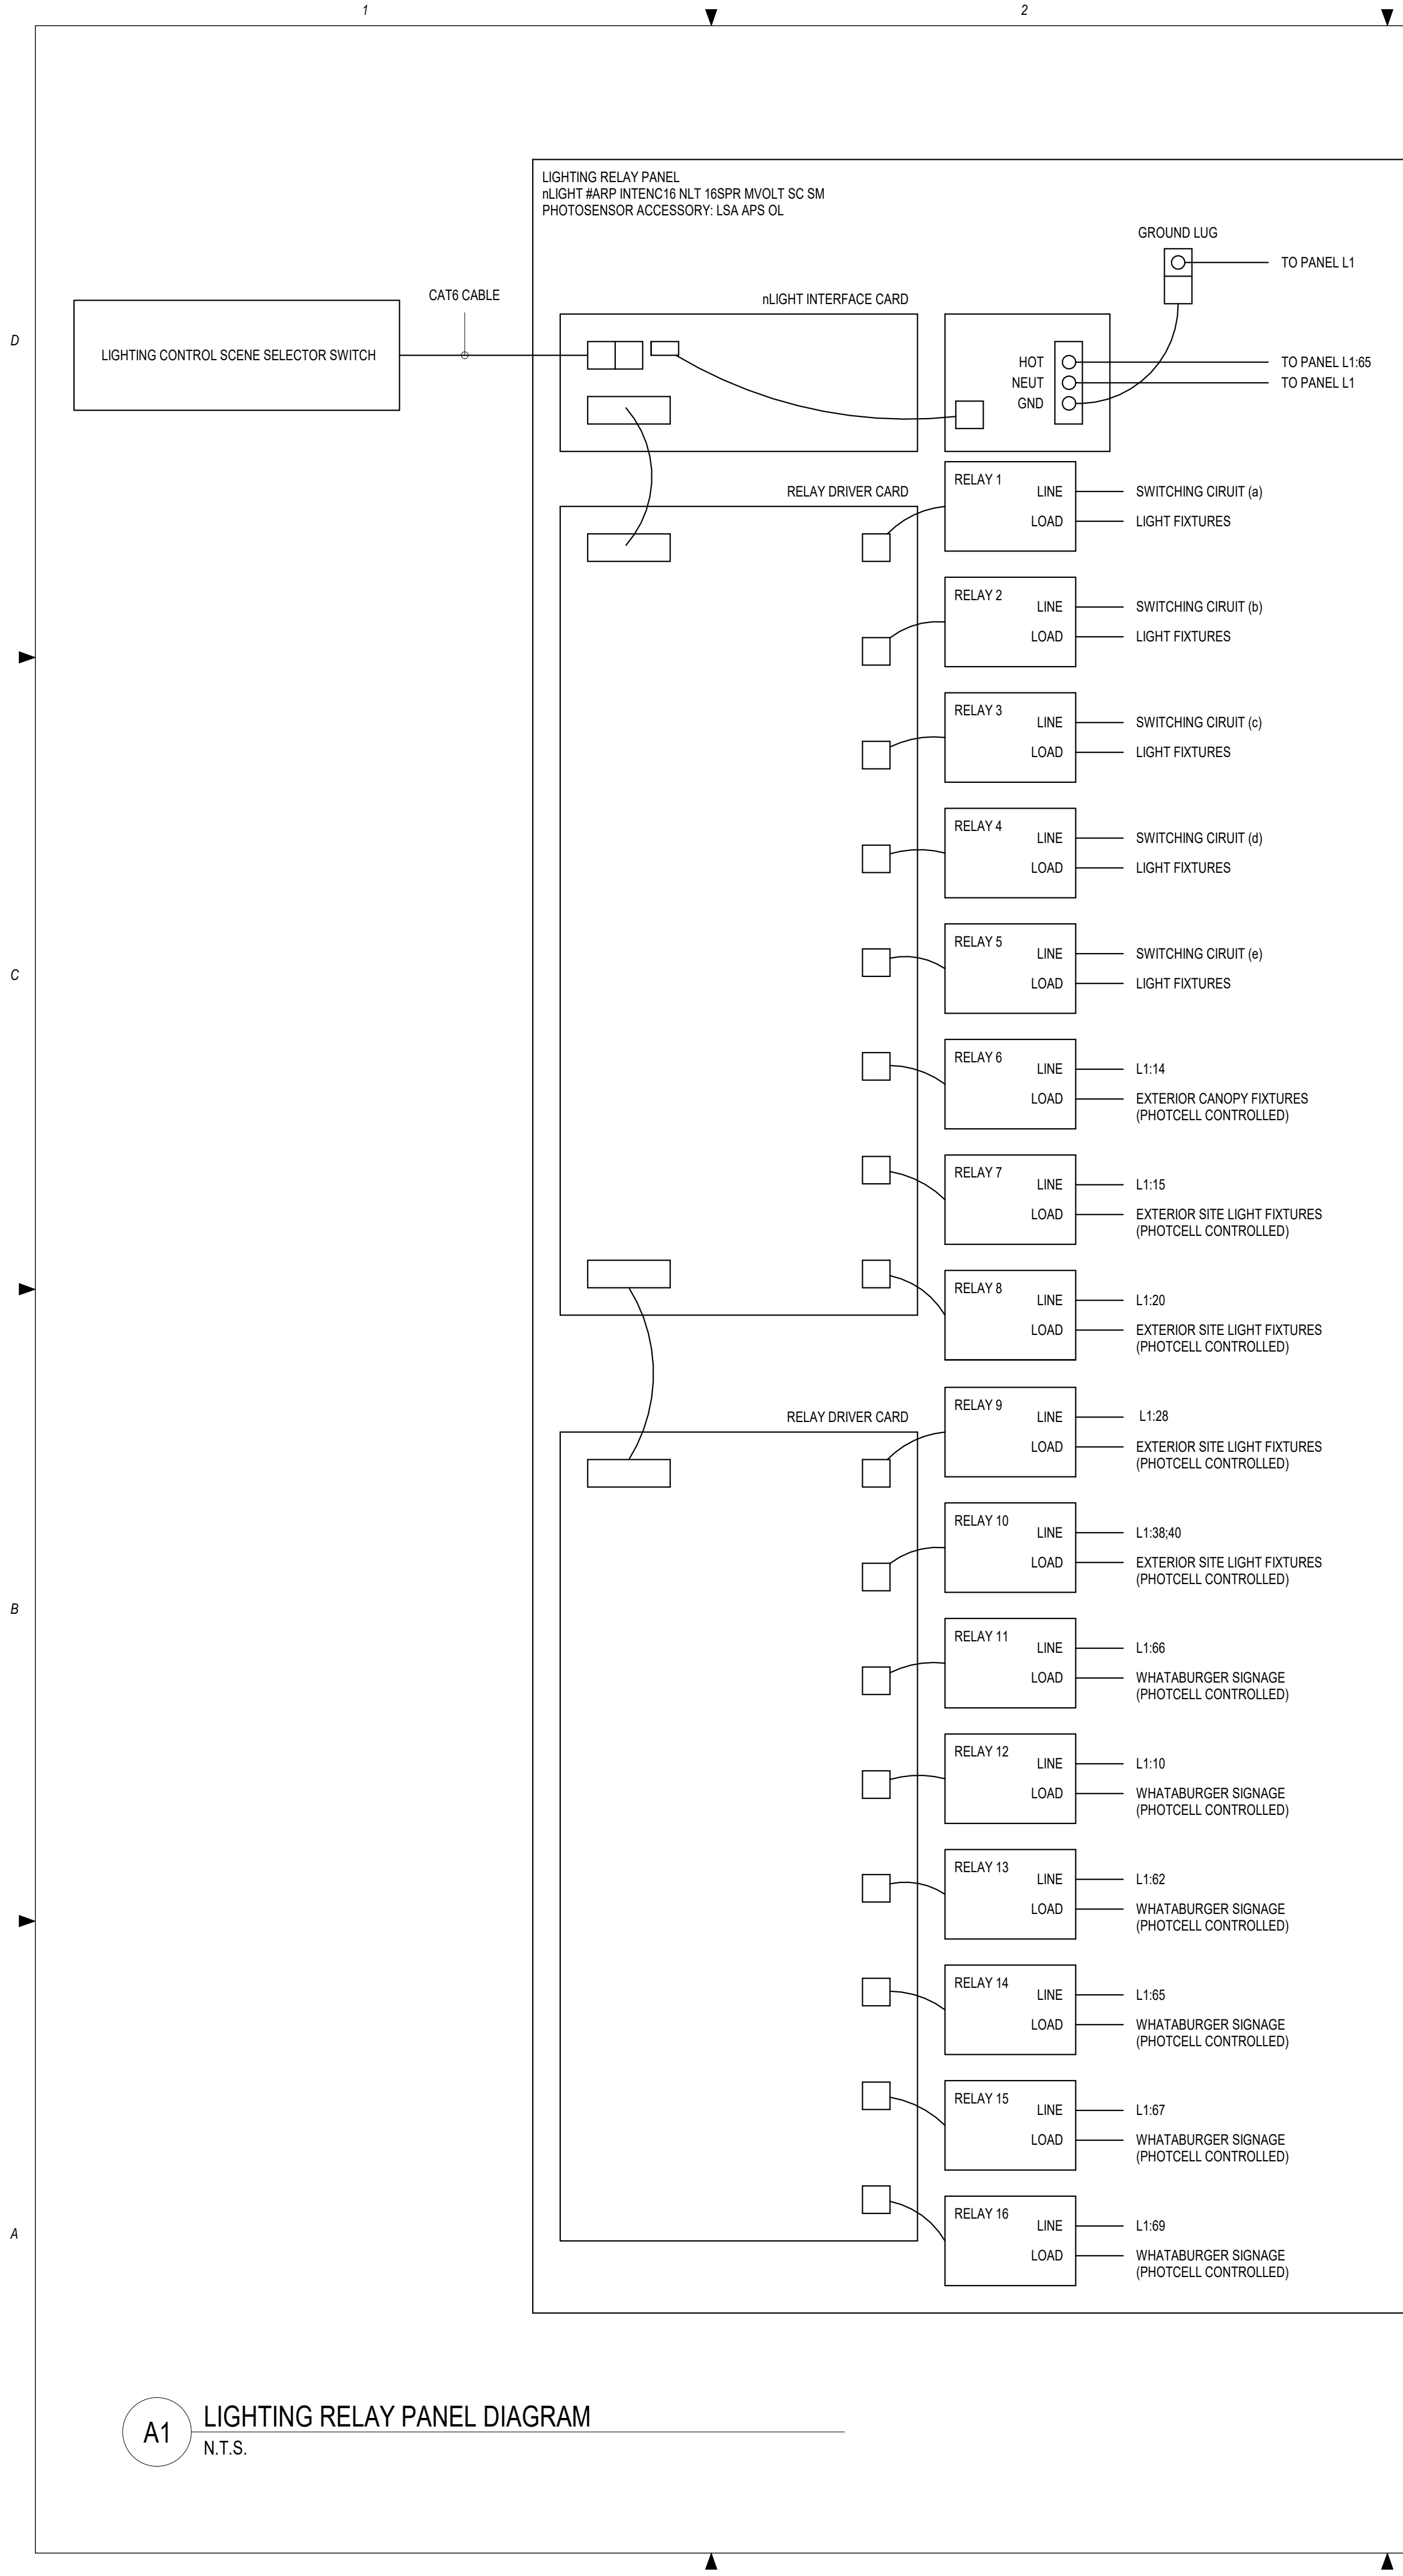
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Drawing No.:

E4.1



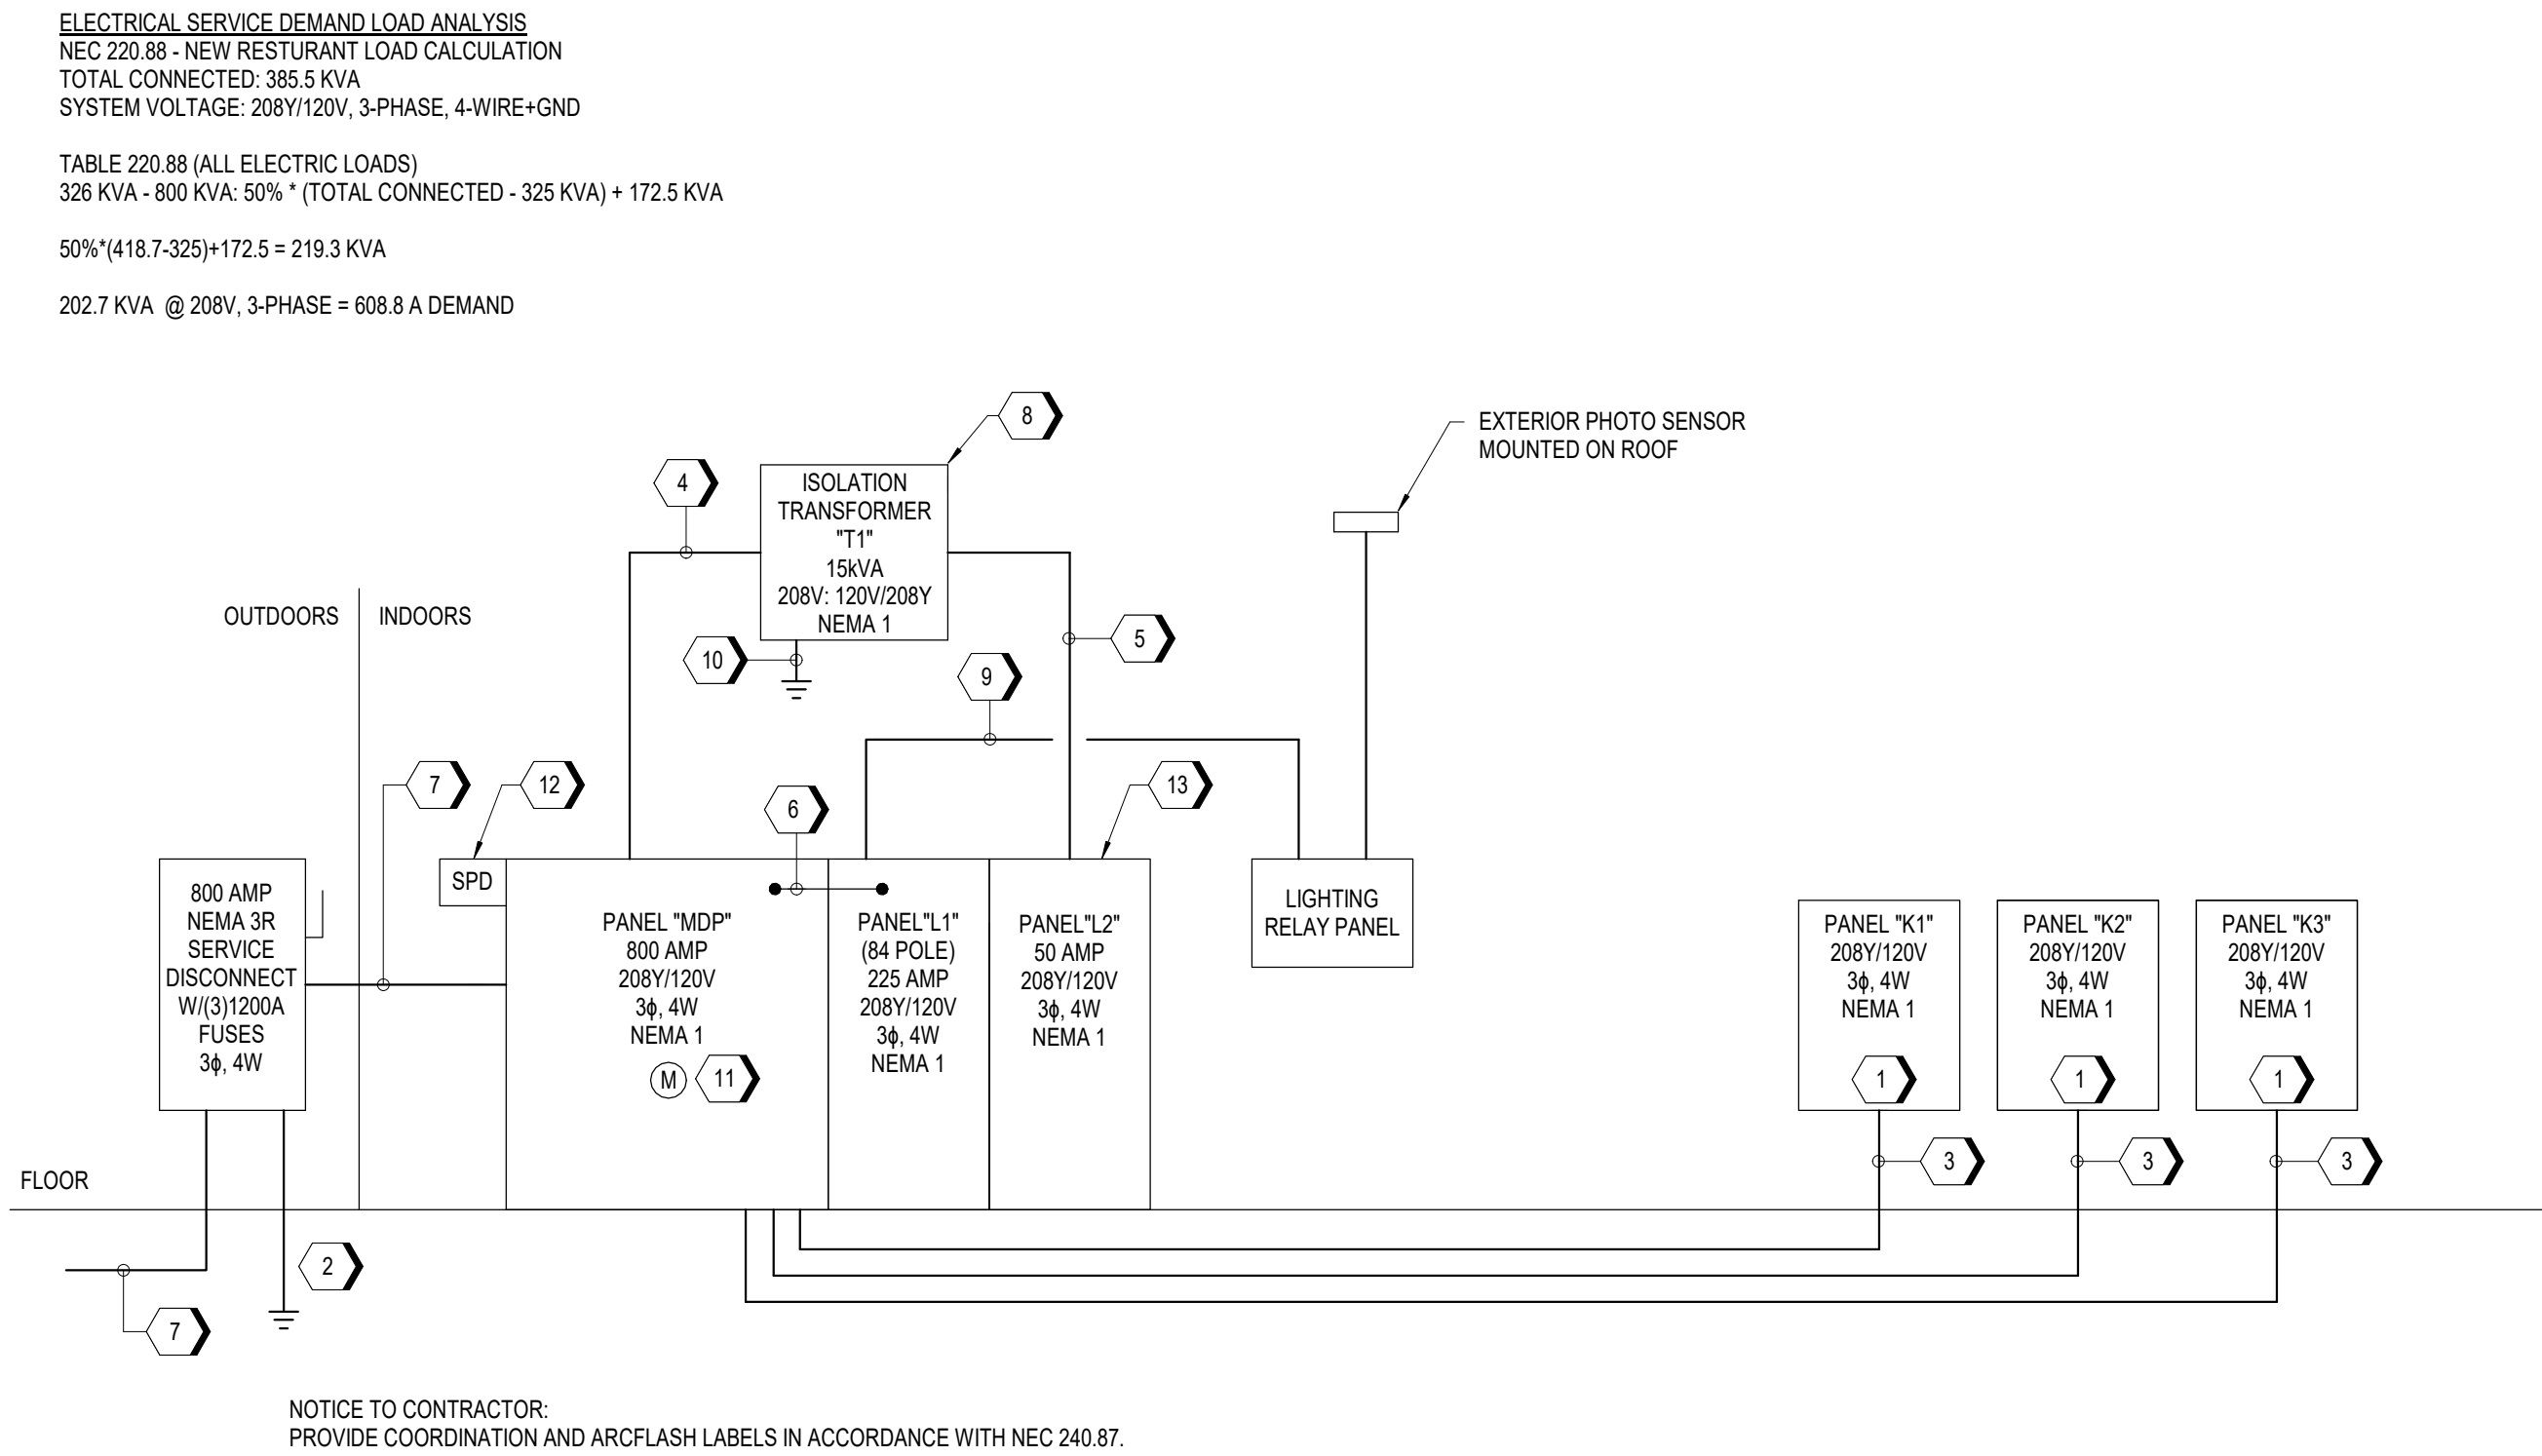
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A1 LIGHTING RELAY PANEL DIAGRAM  
N.T.S.

A3 SINGLE LINE DIAGRAM  
N.T.S.

KEYNOTES	
1	FURNISHED BY KITCHEN EQUIPMENT SUPPLIER. COORDINATE WITH SUPPLIER FOR FINAL LOCATIONS. CIRCUITS ARE PREWIRED TO EQUIPMENT, FEEDERS BY CONTRACTOR, COORDINATE AND RESIZE WHERE REQUIRED.
2	GROUNDING SHALL BE PER NEC. FURNISH AND INSTALL 3/4"x10'-0" GROUND ROD AT A CONCRETE ENCASED ELECTRODE. CONNECT THE BUILDING SERVICE GROUND TO THE GROUND ROD, ENCASED ELECTRODE AND DOMESTIC COLD WATER PIPING WITH BARE #30 COPPER CONDUCTOR. BONDING SHALL BE PER NEC. REFER TO CS/E5.2
3	4#10, #6 GND, IN 2"C.
4	3#6, #10 GND, IN 1"C.
5	4#6, #10 GND, IN 1"C.
6	4#4/0, #4 GND, IN 2-1/2"C.
7	(2 SETS) 4-600 KCMIL #1/0 GND, IN EACH 3-1/2"C.
8	PROVIDE ISOLATION TRANSFORMER. SUSPEND TRANSFORMER FROM STRUCTURE. REFER TO DETAIL B1/E5.2.
9	2#12, #12 GND, IN 3/4"C.
10	#8 GROUNDING ELECTRODE CONDUCTOR.
11	PROVIDE DIGITAL LCD kWh DEMAND METER.
12	PROVIDE 240 kA SURGE PROTECTIVE DEVICE.
13	PROVIDE MODULAR PANELBOARD SYSTEM (SQUARE D CATALOG: MPS) FOR PANELS MDP, L1, AND L2.



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REV	DESCRIPTION	DATE

Project No.: 62-40497-01  
Client Project No.:

Drawing Title:  
**ELECTRICAL DIAGRAMS**

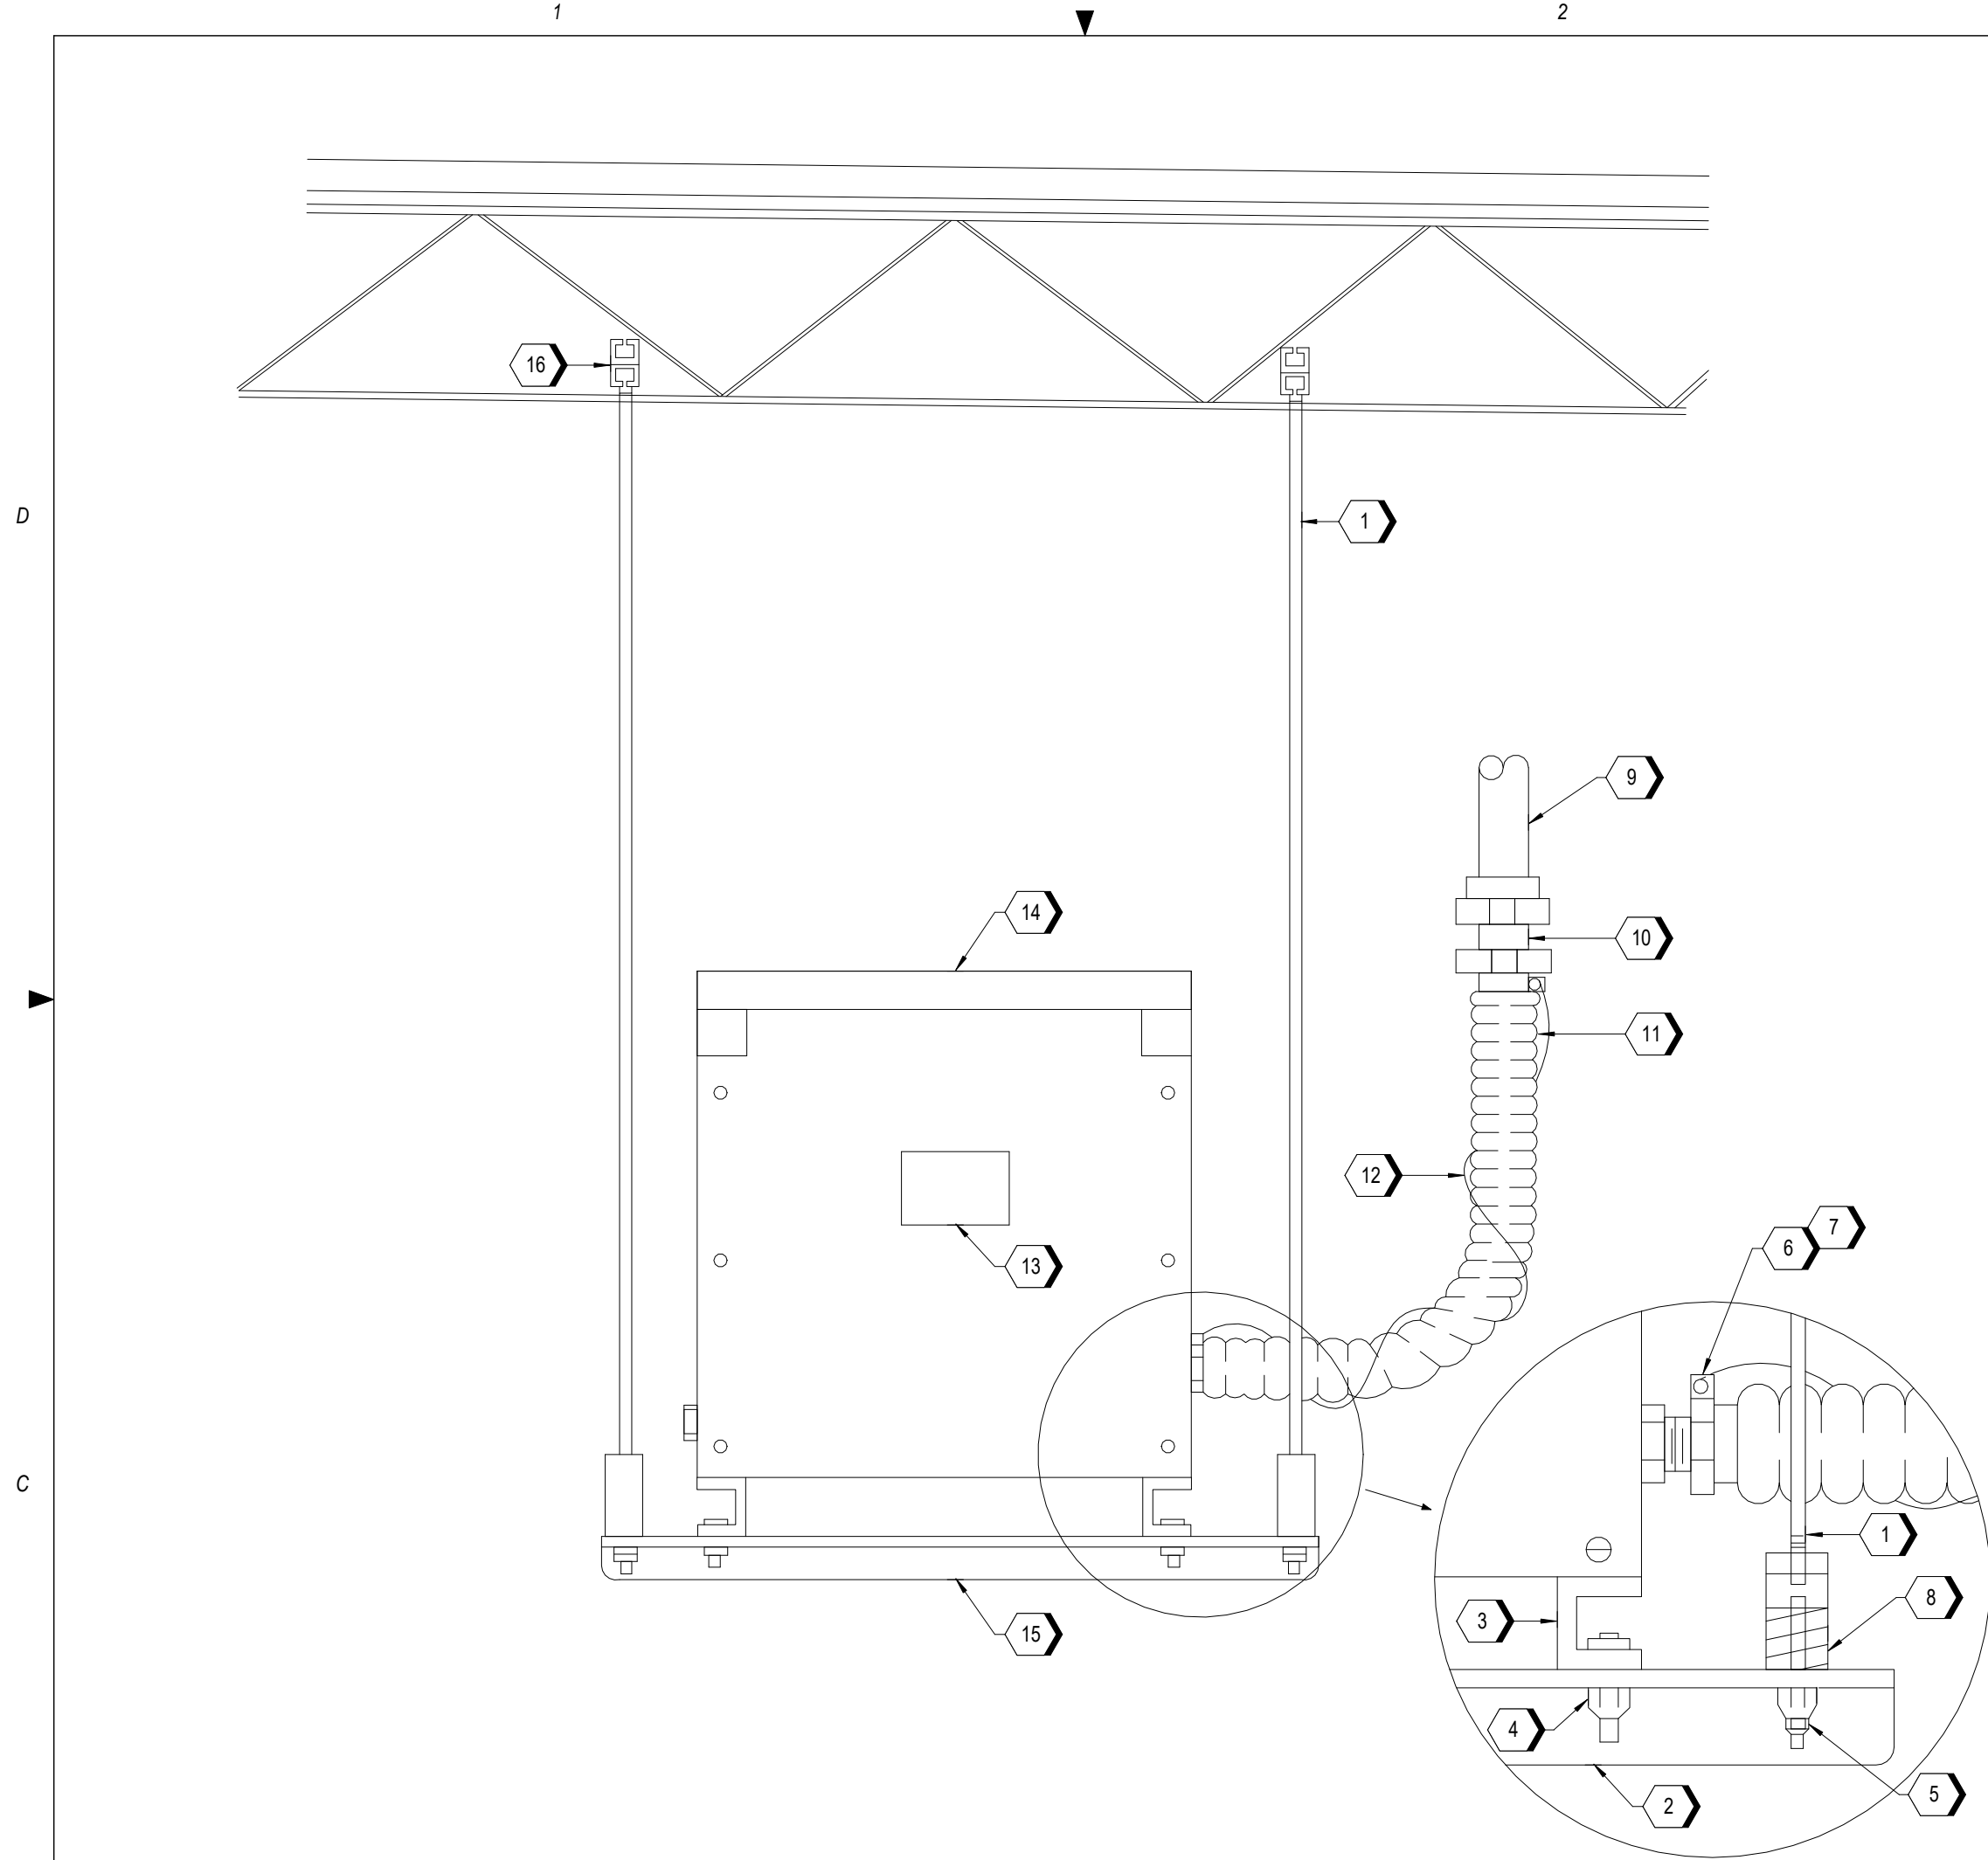
Date: 12/22/20 Phase: PERMIT SET  
Designed: DCU Drawing No.:  
Drawn: DCU  
Checked: KFF

E5.1

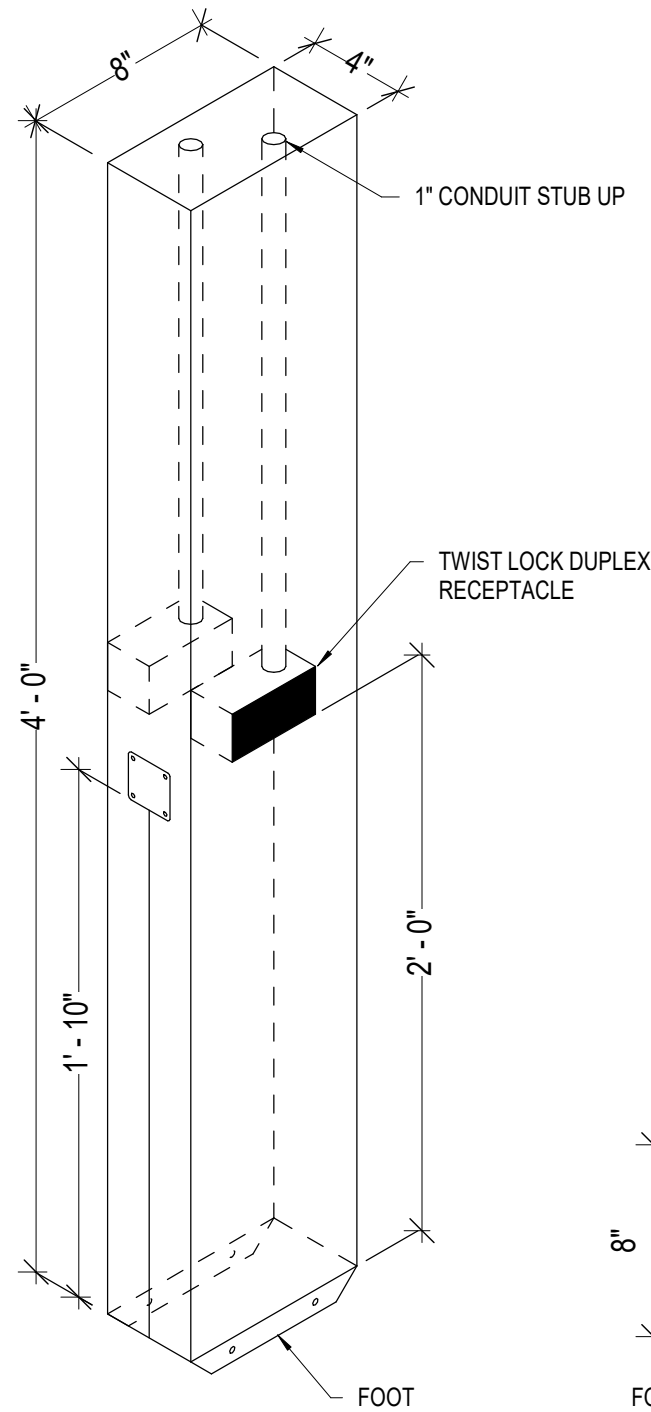


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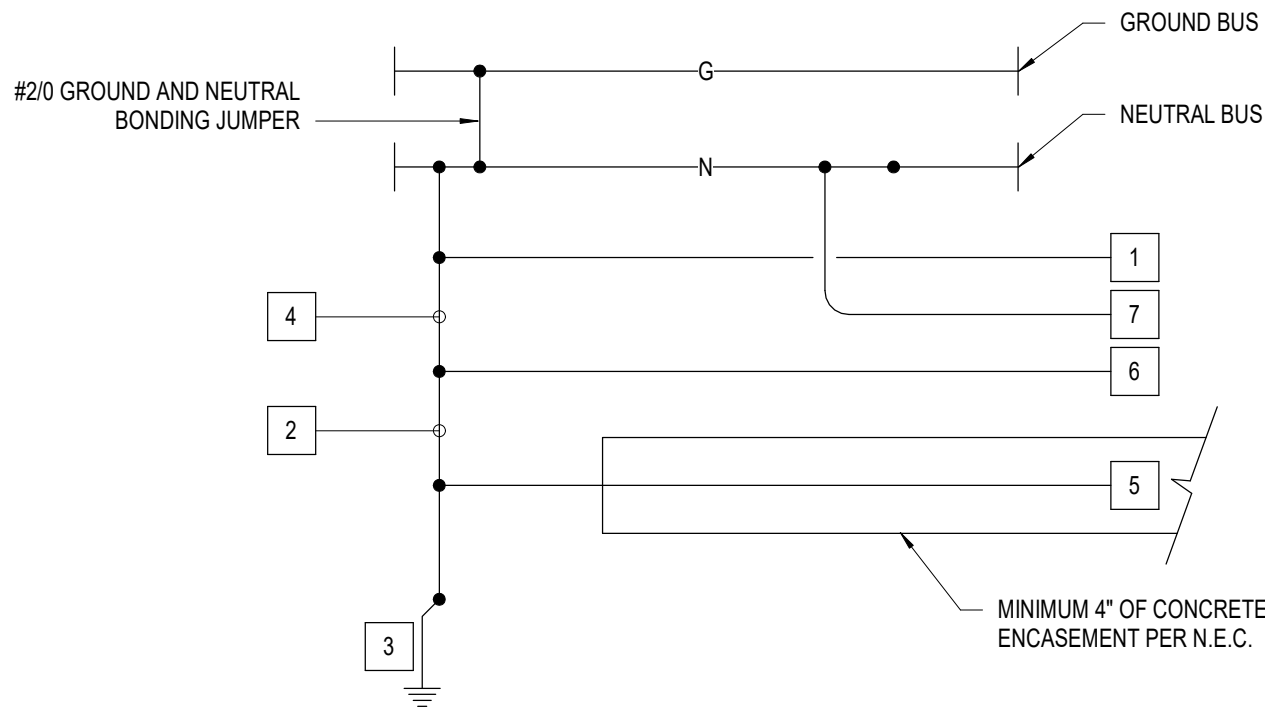
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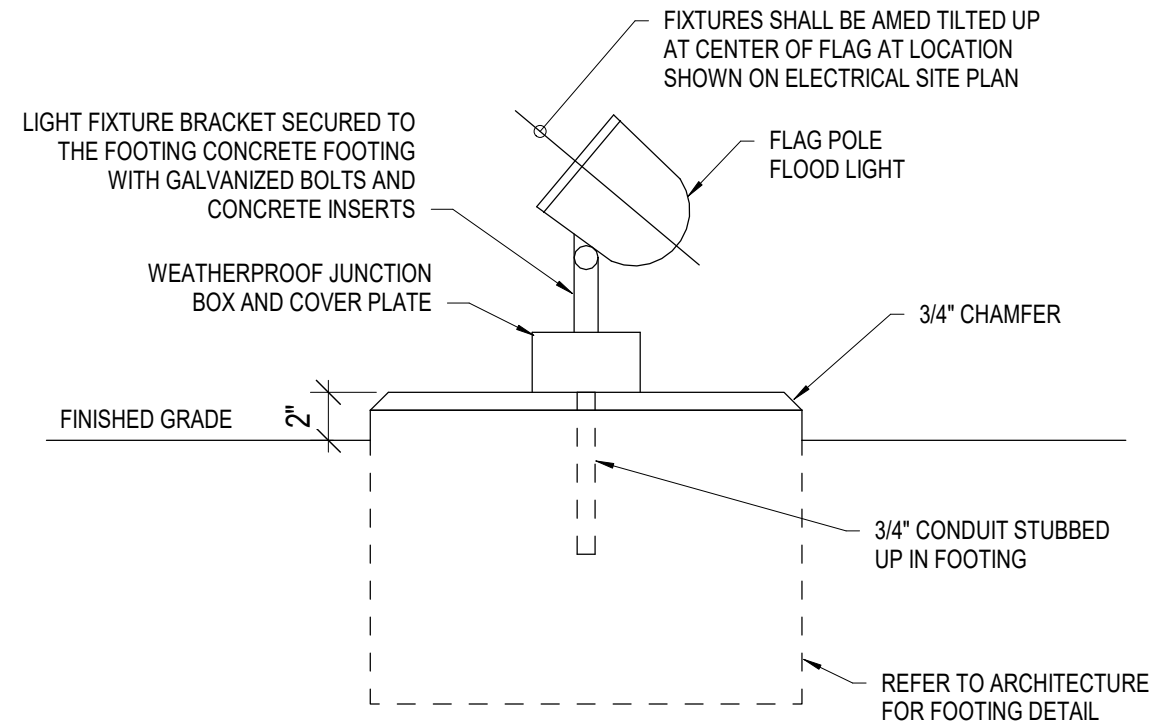
**B1** TRANSFORMER SUSPENSION DETAIL  
N.T.S.



**A3** MONITOR CHASE DETAIL  
1 1/2" = 1'-0"



**C3** SERVICE ENTRANCE GROUNDING DETAIL  
N.T.S.

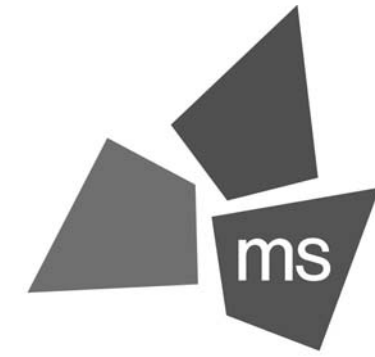


**A4** FLAG POLE FLOOD LIGHT  
N.T.S.

## KEYNOTES

- 1/2" DIAMETER THREADED STEEL ROD SUPPORT FROM STRUCTURE ABOVE.
- ANGLE IRON SUPPORT 3" x 3" TO REQ'D. LENGTH TO SUIT.
- TRANSFORMER BASE CHANNEL.
- 1/2" DIAMETER NUT, BOLT & WASHER 4 REQUIRED.
- 1/2" DIAMETER NUT, LOCKNUT & LOCKWASHER 4 REQUIRED.
- SECONDARY CONNECTION DETAIL, PRIMARY - SIMILAR.
- GROUND CONNECTOR.
- VIBRATION ELIMINATOR 4 REQUIRED.
- RIGID CONDUIT.
- COMBINATION COUPLING.
- LIQUID TIGHT FLEXIBLE METAL CONDUIT 18" MIN.
- EXTERNAL COPPER BONDING WIRE.
- NAMEPLATE-CONNECTION DIAGRAM.
- TRANSFORMER.
- BOTTOM OF SUPPORT OR ANY DEVICE SHALL NOT BE LESS THAN 7'-0" ABOVE FINISHED FLOOR.
- PROVIDE MISCELLANEOUS STEEL SPAN TO THE NEXT JOIST AS REQ'D. TO CONN. TO STRUCTURE. SUBMIT DETAIL FOR STRUCTURAL ENGINEER APPROVAL.

SERVICE GROUNDING NOTES:	
1	PROVIDE 1#30 GROUNDING ELECTRODE CONDUCTOR IN 1" CONDUIT, CONNECTED TO BUILDING STRUCTURAL STEEL.
2	PROVIDE 1#30 GROUNDING ELECTRODE CONDUCTOR IN 1" CONDUIT, CONNECTED TO COPPER CLAD STEEL GROUND ROD
3	PROVIDE A 3/4" DIAMETER X 10'-0" LONG COPPER CLAD STEEL GROUND ROD AND CONNECT TO COLD WATER LINE FOR SERVICE ENTRANCE
4	PROVIDE 1#30 GROUNDING ELECTRODE CONDUCTOR IN 1" CONDUIT
5	PROVIDE 1#30 CONCRETE ENCASED GROUNDING ELECTRODE WITH A MINIMUM LENGTH OF 20'-0".
6	PROVIDE 1#30 GROUNDING ELECTRODE CONDUCTOR TO COLD WATER METAL PIPE GROUND CLAMP.
7	1#6 EQUIPMENT GROUND CONDUCTOR IN 3/4" CONDUIT, CONNECTED TO TELEPHONE TERMINAL BACKBOARD.



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REV	DESCRIPTION	DATE

Project No.: 62-40497-01

Client Project No.:

Drawing Title:

**ELECTRICAL DETAILS**

Date: 12/22/20 Phase: PERMIT SET

Designed: DCU

Drawn: DCU

Checked: R. ORTIZ

Drawing No.:

E5.2

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LIGHTING FIXTURE SCHEDULE									
TYPE	MANUFACTURER	MODEL	DESCRIPTION	LAMP	VOLTAGE	LUMENS	WATTS	MOUNTING	COMMENTS
A	LITHONIA	2GTL 2 20L GZ10 LP840	2X2' RECESSED TROFFER (4000K COLOR TEMPERATURE, 80 CRI)	LED	120 V	2366	18	CEILING	
A2	LITHONIA	2GTL 2 48L GZ10 LP840 ABC	GASKETED 2X2' RECESSED TROFFER (4000K COLOR TEMPERATURE, 80 CRI)	LED	120 V	5112	42	CEILING	
A2E	LITHONIA	2GTL 2 48L GZ10 LP840 E10WLCP ABC	GASKETED 2X2' RECESSED TROFFER WITH EMERGENCY BATTERY PACK (4000K COLOR TEMPERATURE, 80 CRI)	LED	120 V	5112	42	CEILING	
AE	LITHONIA	2GTL 2 20L GZ10 LP840 E10WLCP	2X2' RECESSED TROFFER WITH EMERGENCY BATTERY PACK (4000K COLOR TEMPERATURE, 80 CRI)	LED	120 V	2366	18	CEILING	
B	LITHONIA	LDN4SQ 40/10 L54AR LSS MVOLT GZ10	4" RECESSED SQUARE LED DOWNLIGHT CLEAR, SEMI-SPECULAR REFLECTOR (4000K COLOR TEMPERATURE, 80 CRI)	LED	120 V	877	11	CEILING	
B1	LITHONIA	LDN4SQ 40/15 L54AR LSS MVOLT GZ10	4" RECESSED SQUARE LED DOWNLIGHT CLEAR, SEMI-SPECULAR REFLECTOR (4000K COLOR TEMPERATURE, 80 CRI)	LED	120 V	1268	18	CEILING	
C	LITHONIA	CLX L36 2250LM SEF FDL MVOLT GZ10 40K 80CRI	36" INDUSTRIAL STRIP (4000K COLOR TEMPERATURE, 80 CRI)	LED	120 V	2101	16	SURFACE	
D	MARK	SL4L LOP 4FT FLP (TRIM) 80CRI 40K 600LMF MIN1 120 ZT	4' LINEAR RECESSED SLOT (4000K COLOR TEMPERATURE, 80 CRI)	LED	120 V	2227	23	CEILING	
D1	MARK	SL4L LOP [LENGTH] FLP (TRIM) 80CRI 40K 600LMF MIN1 120 ZT (90DEG CORNERS)	LINEAR RECESSED SLOT, LENGTH AS INDICATED ON DRAWINGS (4000K COLOR TEMPERATURE, 80 CRI)	LED	120 V	600FT		CEILING	6 WATTS PER LINEAR FOOT
F	TARGETTI	DURATAPE IP86 PRAP-W	FLEXIBLE LINEAR LIGHT STRIP FOR CONTINUOUS CONSTANT COLOR	LED	120 V	1111FT		CEILING	4 WATTS PER LINEAR FOOT
S1	TECHLIGHT	CTL-N-35L-T3-1	POLE MOUNTED SINGLE HEAD LED TYPE 3 AREA FIXTURE (4000K COLOR TEMPERATURE)	LED	120 V	34781	249	POLE	FIXTURE MOUNTED AT 25'-0"
S1-2	TECHLIGHT	CTL-N-20L-T3-1	POLE MOUNTED DOUBLE HEAD 180 DEGREES LED TYPE 5 AREA FIXTURE (4000K COLOR TEMPERATURE)	LED	120 V	69484	442	POLE	2 FIXTURES AT 180 DEGREE ORIENTATION MOUNTED AT 25'-0"
S1-29	TECHLIGHT	CTL-N-35L-T5W-1	POLE MOUNTED DOUBLE HEAD 90 DEGREES LED TYPE 3 AREA FIXTURE (4000K COLOR TEMPERATURE)	LED	120 V	39950	294	POLE	2 FIXTURES AT 90 DEGREE ORIENTATION MOUNTED AT 25'-0"
S2	BEGA	99 777 SLV / 84/623 SLV	LED BOLLARD (4000K COLOR TEMPERATURE)	LED	120 V	768	34	BOLLARD	
S3	LITHONIA	DSCW1 10C 530 40K T3M MVOLT PE DDBXD	FAÇADE EXTERIOR WALL PACK	LED	120 V	2010	19	WALL	WALL MOUNTED 12'-0" ABOVE GRADE
S4	LITHONIA	TWS LED P1 50K MVOLT PE DDB	EXTERIOR WALL PACK	LED	120 V	2010	18	WALL	TOP OF FIXTURE, WALL MOUNTED 1'-0" BELOW SCREEN WALL
S5	LITHONIA	OLBF 8 30K DDB	LED FLAG POLE BULLET FLOOD LIGHT	LED	120 V	592	11	FLOOD	
S6	LITHONIA	LDN4 40/15 LQ4AR LSS MVOLT GZ10	4" RECESSED SQUARE LED DOWNLIGHT CLEAR, SEMI-SPECULAR REFLECTOR (4000K COLOR TEMPERATURE, 80 CRI)	LED	120 V	1516	18	CEILING	
X	LITHONIA	LRP 1 RC 120/277 EL N	EXIT SIGN	LED	120 V	5	2	CEILING	

LIGHTING SCHEDULE NOTE:

ELECTRICAL CONTRACTOR BIDDERS MUST CONTACT DAVID GALVIN WITH ARCHITECTURAL LIGHTING ALLIANCE (ALA) FOR ALL LIGHTING AND LIGHTING CONTROLS BIDS AT 214-658-9000.  
CORPORATEACCOUNTS@ALATX.COM WHATABURGER IS A REGISTERED NATIONAL ACCOUNT (NA) VIA ARCHITECTURAL LIGHTING ALLIANCE (ALA) AND HORTON CONTROLS GROUP (HCG).

EQUIPMENT CONNECTION SCHEDULE											
TAG	DISCONNECT RATING (AMP/VOLTAGE/POLE/FUSE/NEMA RATING)	HP	KW	FLA	STARTER TYPE	VOLTAGE/POLES	LOAD	CIRCUIT NUMBER	WIRE & CONDUIT	COMMENTS	
COOLER CU (28)	30/240/2/NF/NEMA 3R	1	-	12	-	208 V/2	2496 VA	MDP-30,32	2#12, #12 GND IN 3/4"	REFER TO EQUIPMENT MANUFACTURER FOR ALL INSTALLATION/CONNECTION REQUIREMENTS.	
COOLER UC (28)	30/240/2/NF/NEMA 3R	-	-	2	-	208 V/2	2767 VA	L1-46,48	2#12, #12 GND IN 3/4"	REFER TO EQUIPMENT MANUFACTURER FOR ALL INSTALLATION/CONNECTION REQUIREMENTS.	
EF-1		1/20	-	-	-	120 V/1	150 VA	L1-4	2#12, #12 GND IN 3/4"	INTEGRAL DISCONNECT PROVIDED BY EQUIPMENT MANUFACTURER	
ENH-1	60/240/3/NF/NEMA 1		10			208 V/3	10000 VA	MDP-14,16,18	3#6, #10 GND IN 3/4"		
FREEZER CU (28)	60/240/2/NF/NEMA 3R	3	-	30	-	208 V/2	6240 VA	MDP-26,28	2#6, #10 GND IN 3/4"	REFER TO EQUIPMENT MANUFACTURER FOR ALL INSTALLATION/CONNECTION REQUIREMENTS.	
FREEZER UC (28)	30/240/2/NF/NEMA 3R	-	-	13.3	-	208 V/2	2767 VA	L1-63,55	2#6, #12 GND IN 3/4"	REFER TO EQUIPMENT MANUFACTURER FOR ALL INSTALLATION/CONNECTION REQUIREMENTS.	
KEF-1	-	3/4	-	-	-	208 V/2	1435 VA	L1-43,45	2#12, #12 GND IN 3/4"	INTEGRAL DISCONNECT PROVIDED BY EQUIPMENT MANUFACTURER	
KEF-2	-	1/4	-	-	-	208 V/2	696 VA	L1-39,41	2#12, #12 GND IN 3/4"	INTEGRAL DISCONNECT PROVIDED BY EQUIPMENT MANUFACTURER	
RTU-1	200/240/3/NF/NEMA 3R	3	-	116.8	VFD	208 V/3	50077 VA	MDP-19,21,23	3#10, #6 GND IN 2"	VFD PROVIDED BY EQUIPMENT MANUFACTURER	
RTU-2	200/240/3/NF/NEMA 3R	3	-	116.8	VFD	208 V/3	50077 VA	MDP-25,27,29	3#10, #6 GND IN 2"	VFD PROVIDED BY EQUIPMENT MANUFACTURER	
RTU-3	200/240/3/NF/NEMA 3R	5	-	116.8	VFD	208 V/3	75296 VA	MDP-31,33,35	3#10, #6 GND IN 2"	VFD PROVIDED BY EQUIPMENT MANUFACTURER	
UH-1	30/240/2/NF/NEMA 1	-	1.5	-	-	208 V/2	1500 VA	MDP-34,36	2#12, #12 GND IN 3/4"		

KITCHEN EQUIPMENT CONNECTION SCHEDULE											
TAG	DESCRIPTION	DISC. MEAN / MOUNTING HEIGHT	HP	KW	FLA	VOLTAGE/POLES	LOAD	CIRCUIT NUMBER	WIRE & CONDUIT	COMMENTS	
5a	DUAL SIDED DRINK DISPENSER	5-20R / -	-	-	-	120 V/1	960 VA	L1-25	2#12, #12 GND IN 3/4"	HOSPITAL GRADE RECEPTACLE, UNDER COUNTER	
5b	DUAL SIDED DRINK DISPENSER	5-20R / -	-	-	-	120 V/1	960 VA	L1-24	2#12, #12 GND IN 3/4"	HOSPITAL GRADE RECEPTACLE, UNDER COUNTER	
13	DRIVE THRU DRINK DISPENSER	5-20R / 24"	-	-	-	120 V/1	624 VA	L1-17	2#12, #12 GND IN 3/4"		
14a	ICE MAKER EVAPORATOR UNIT	5-20R / 66"	-	-	6	120 V/1	720 VA	L1-71	2#12, #12 GND IN 3/4"	HOSPITAL GRADE RECEPTACLE	
14b	ICE MAKER EVAPORATOR UNIT	5-20R / 66"	-	-	6	120 V/1	720 VA	L1-75	2#12, #12 GND IN 3/4"	HOSPITAL GRADE RECEPTACLE	
14c	ICE MAKER CONDENSING UNIT	30A/240V/2P/NF / -	-	-	17.6	208 V/2	3661 VA	L1-52,54	2#10, #10 GND IN 3/4"		
14d	ICE MAKER CONDENSING UNIT	30A/240V/2P/NF / -	-	-	17.6	208 V/2	3661 VA	L1-59,61	2#10, #10 GND IN 3/4"		
17a	MULTI-PLEX REFRIGERATION UNIT	30A/600V/3P/NF / -	-	-	25.2	208 V/3	9079 VA	L1-77,79,81	3#10, #10 GND IN 3/4"		
17b	MULTI-PLEX CONDENSER UNIT	30A/240V/2P/NF / -	-	-	1.3	208 V/2	270 VA	L1-32,34	2#12, #12 GND IN 3/4"		
21	REACH IN FREEZER	5-20R / 76"	1/2	-	11.3	120 V/1	1040 VA	L1-26	2#12, #12 GND IN 3/4"		
22a	REACH IN REFRIGERATOR	5-20R / 76"	1/3	-	8.5	120 V/1	644 VA	L1-70	2#12, #12 GND IN 3/4"		
22b	REACH IN REFRIGERATOR	5-20R / 76"	1/3	-	8.5	120 V/1	644 VA	L1-16	2#12, #12 GND IN 3/4"		
22c	REACH IN REFRIGERATOR	5-20R / 76"	1/3	-	8.5	120 V/1	644 VA	L1-66	2#12, #12 GND IN 3/4"		
22d	REACH IN REFRIGERATOR	5-20R / 76"	1/3	-	8.5	120 V/1	644 VA	L1-68	2#12, #12 GND IN 3/4"		
24	SUPER COOLER	L14-20R / 76"	1	-	11	208 V/2	1830 VA	L1-42,44	2#12, #12 GND IN 3/4"		
26a	UNDER COUNTER REFRIGERATOR	5-20R / -	1/6	-	-	120 V/1	420 VA	L1-8	2#12, #12 GND IN 3/4"		
26b	UNDER COUNTER REFRIGERATOR	- / -	1/6	-	-	208 V/2	420 VA	K2-1,3	-	PREWIRED BY KITCHEN EQUIPMENT MANUFACTURER.	
26c	UNDER COUNTER REFRIGERATOR	- / -	1/6	-	-	208 V/2	420 VA	K3-1,3	-	PREWIRED BY KITCHEN EQUIPMENT MANUFACTURER.	
35	PITCO FRYER	6-50R / -	-	8.3	-	208 V/2	8258 VA	K1-1,3	-	PREWIRED BY KITCHEN EQUIPMENT MANUFACTURER.	
35	PITCO FRYER	6-50R / -	-	8.3	-	208 V/2	8258 VA	K1-4,6	-	PREWIRED BY KITCHEN EQUIPMENT MANUFACTURER.	
35	PITCO FRYER	15-60R / -	-	17	-	208 V/3	19671 VA	K1-14,16,18	-	PREWIRED BY KITCHEN EQUIPMENT MANUFACTURER.	
35	PITCO FRYER	15-60R / -	-	19.7	-	208 V/3	17005 VA	K1-20,22,24	-	PREWIRED BY KITCHEN EQUIPMENT MANUFACTURER.	
38	HALF-SIZED CONVECTION OVEN	15-30R / -	-	7.8	22.1	208 V/3	7800 VA	L1-72,74,76	3#10, #10 GND IN 3/4"		
55a	BUN TOASTER	- / -	-	3.3	-	208 V/2	3300 VA	K2-2,4	-	PREWIRED BY KITCHEN EQUIPMENT MANUFACTURER.	
55b	BUN TOASTER	- / -	-	3.3	-	208 V/2	3300 VA	K3-2,4	-	PREWIRED BY KITCHEN EQUIPMENT MANUFACTURER.	
59a	6" GRILL	- / -	-	36	-	208 V/3	36000 VA	K2-5,7,9	-	PREWIRED BY KITCHEN EQUIPMENT MANUFACTURER.	
59b	6" GRILL	- / -	-	36	-	208 V/3	36000 VA	K3-5,7,9	-	PREWIRED BY KITCHEN EQUIPMENT MANUFACTURER.	
72	SHAKE MACHINE	6-20R / 24"	-	-	13	208 V/2	2704 VA	L1-49,51	2#12, #12 GND IN 3/4"		
73	COFFEE BREWER	L14-30R / 24"	-	5.1	-	208 V/2	5100 VA	L1-56,58	3#10, #10 GND IN 3/4"		
74	TEA BREWER	5-20R / 24"	-	1.65	-	120 V/1	1650 VA	L1-33	2#12, #12 GND IN 3/4"		
99	MOBILE GREASE CADDY	5-20R / -	1/4	-	5.8	120 V/1	696 VA	L1-19	2#12, #12 GND IN 3/4"		
107	GREASE TANK	5-20R / -	-	-	-	120 V/1	500 VA	L1-64	2#12, #12 GND IN 3/4"		
107a	FLAT SCREEN MONITOR	L5-20R / -	-	-	-	120 V/1	360 VA	L2-7	2#12, #12 GND IN 3/4"		
107b	FLAT SCREEN MONITOR	L5-20R / -	-	-	-	120 V/1	360 VA	L2-7	2#12, #12 GND IN 3/4"		
107c	FLAT SCREEN MONITOR	L5-20R / -	-	-	-	120 V/1	360 VA	K2-8	2#12, #12 GND IN 3/4"		
107c	FLAT SCREEN MONITOR	L5-20R / -	-	-	-	120 V/1	360 VA	K3-8	2#12, #12 GND IN 3/4"		
107e	FLAT SCREEN MONITOR	L5-20R / -	-	-	-	120 V/1	360 VA	L2-8	2#12, #12 GND IN 3/4"		
107e	FLAT SCREEN MONITOR	L5-20R / -	-	-	-	120 V/1	360 VA	L2-8	2#12, #12 GND IN 3/4"		
107e	FLAT SCREEN MONITOR	L5-20R / -	-	-	-	120 V/1	360 VA	L2-8	2#12, #12 GND IN 3/4"		
107f	FLAT SCREEN MONITOR	L5-20R / -	-	-	-	120 V/1	360 VA	L2-6	2#12, #12 GND IN 3/4"		
7a	WALL MOUNTED HOT HOLD	5-20R / 24"	-	-	13	120 V/1	1500 VA	L1-30	2#12, #12 GND IN 3/4"		
7b	WALL MOUNTED HOT HOLD	5-20R / 24"	-	-	13	120 V/1	1500 VA	L1-31	2#12, #12 GND IN 3/4"		



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12/22/20  
PROFESSIONAL OF RECORD:  
JASON E. CHRISTOFF No. 20012002143  
EXP. DATE: 12/31/20

REV	DESCRIPTION	DATE

Project No.: 62-40497-01

Client Project No.:

Drawing Title:

ELECTRICAL SCHEDULES

Date: 12/22/20 Phase: PERMIT SET

Designed: DCU

Drawn: DCU

Checked: KFF

E6.1

C:\Backups\Revit\WB-Lees Summit-MO\_Y18\_ELECT\_200921.dgn.rvt 12/23/2020 11:30:14 AM

Panel: MDP													
Location: DRY STORAGE 111				Volts: 120/208 Wye				Mains Type: MLO				A.I.C. Rating: 22,000	
Supply From: SERVICE DISCONNECT				Phases: 3				Bus Rating: 800 A					
Mounting: SURFACE				Wires: 4									
CKT	Circuit Description	Trip	Poles	A		B		C		Poles	Trip	Circuit Description	CKT
1	PANEL 'L1'	225 A	3	24889 VA	4780 VA					3	60 A	PANEL 'L2'	2
3	--	--	--			25512...	3420 VA			--	--	--	4
5	--	--	--					23137 VA	2520 VA	--	--	--	6
7	PANEL 'K1'	150 A	3	19354 VA	14220 VA					3	150 A	PANEL 'K2'	8
9	--	--	--			20483...	13860...			--	--	--	10
11	--	--	--					18394 VA	12180 VA	--	--	--	12
13	PANEL 'K3'	150 A	3	14220 VA	3333 VA					3	40 A	EWB-1	14
15	--	--	--			13860...	3333 VA			--	--	--	16
17	--	--	--					12180 VA	3333 VA	--	--	--	18
19	RTU-1	150 A	3	16692 VA	0 VA					3	30 A	(FUTURE) TRASH COMPACTOR	20
21	--	--	--			16692...	0 VA			--	--	--	22
23	--	--	--					16692 VA	0 VA	--	--	--	24
25	RTU-2	150 A	3	16692 VA	3120 VA					2	50 A	FREEZER CONDENSER	26
27	--	--	--			16692...	3120 VA			--	--	--	28
29	--	--	--					16692 VA	1248 VA	2	15 A	COOLER CONDENSER	30
31	RTU-3	225 A	3	25099 VA	1248 VA					--	--	--	32
33	--	--	--			25099...	750 VA			2	15 A	UH-1	34
35	--	--	--					25099 VA	750 VA	--	--	--	36
37	BUSSED SPACE	--	--	0 VA	0 VA					--	--	BUSSED SPACE	38
39	BUSSED SPACE	--	--			0 VA	0 VA			--	--	BUSSED SPACE	40
41	BUSSED SPACE	--	--					0 VA	0 VA	--	--	BUSSED SPACE	42
Total Load:				143646 VA		142812 VA		132226 VA					
Load Classification		Connected Load		Design Factor		Estimated Demand		Panel Totals					
HVAC		189720 VA		100.00%		189720 VA							
Heating		1500 VA		100.00%		1500 VA				Total Conn. Load: 418682 VA			
Kitchen Equipment		191083 VA		65.00%		124204 VA				Total Est. Demand: 349303 VA			
Lighting		9148 VA		100.00%		9148 VA				Total Conn. Current: 1162 A			
Motor		2281 VA		115.73%		2640 VA				Total Est. Demand Current: 970 A			
Other		6960 VA		100.00%		6960 VA							
Receptacle		10260 VA		98.73%		10130 VA							
Notes: REFER TO SHEET E5.1 FOR LOAD ANALYSIS.													

Panel: L2													
Location: DRY STORAGE 111				Volts: 120/208 Wye				Mains Type: MCB				A.I.C. Rating: 10,000	
Supply From: MDP				Phases: 3				Bus Rating: 100 A					
Mounting: SURFACE				Wires: 4				MCB Rating 50 A					
CKT	Circuit Description	Trip	Poles	A		B		C		Poles	Trip	Circuit Description	CKT
1	EXTERIOR MENU BOARDS	20 A	1	1000 VA	720 VA					1	20 A	POINT OF SALE	2
3	POINT OF SALE	20 A	1			720 VA	720 VA			1	20 A	POINT OF SALE (DRIVE THRU 1)	4
5	POINT OF SALE (DRIVE THRU 1)	20 A	1					720 VA	360 VA	1	20 A	ORDER SCREEN	6
7	ORDER SCREENS	20 A	1	720 VA	1440 VA					1	20 A	ORDER SCREENS	8
9	MENU BOARD	20 A	1			540 VA	720 VA			1	20 A	POINT OF SALE (DINING)	10
11	POINT OF SALE (DINING)	20 A	1					720 VA	720 VA	1	20 A	POINT OF SALE (DINING)	12
13	FLAT PANEL DISPLAY	20 A	1	180 VA	720 VA					1	20 A	POINT OF SALE (DRIVE THRU 2)	14
15	POINT OF SALE (DRIVE THRU 2)	20 A	1			720 VA	0 VA			1	20 A	SPARE	16
17	SPARE	20 A	1					0 VA	0 VA	1	20 A	SPARE	18
19	SPARE	20 A	1	0 VA	0 VA					1	20 A	SPARE	20
21	SPARE	20 A	1			0 VA	0 VA			1	20 A	SPARE	22
23	SPARE	20 A	1					0 VA	0 VA	1	20 A	SPARE	24
25	SPARE	20 A	1	0 VA	0 VA					1	20 A	SPARE	26
27	SPARE	20 A	1			0 VA	0 VA			1	20 A	SPARE	28
29	SPARE	20 A	1					0 VA	0 VA	1	20 A	SPARE	30
31	BUSSED SPACE	--	--	0 VA	0 VA					--	--	BUSSED SPACE	32
33	BUSSED SPACE	--	--			0 VA	0 VA			--	--	BUSSED SPACE	34
35	BUSSED SPACE	--	--					0 VA	0 VA	--	--	BUSSED SPACE	36
37	BUSSED SPACE	--	--	0 VA	0 VA					--	--	BUSSED SPACE	38
39	BUSSED SPACE	--	--			0 VA	0 VA			--	--	BUSSED SPACE	40
41	BUSSED SPACE	--	--					0 VA	0 VA	--	--	BUSSED SPACE	42
Total Load:				4780 VA		3420 VA		2520 VA					
Load Classification				Connected Load		Design Factor		Estimated Demand		Panel Totals			
Kitchen Equipment				2520 VA		65.00%		1638 VA					
Other				1000 VA		100.00%		1000 VA		Total Conn. Load: 10720 VA			
Receptacle				7200 VA		100.00%		7200 VA		Total Est. Demand: 9838 VA			
										Total Conn. Current: 30 A			
										Total Est. Demand Current: 27 A			
Notes:													

Panel: L1													
Location: DRY STORAGE 111				Volts: 120/208 Wye				Mains Type: MLO				A.I.C. Rating: 10,000	
Supply From: MDP				Phases: 3				Bus Rating: 225 A					
Mounting: SURFACE				Wires: 4									
CKT	Circuit Description	Trip	Poles	A		B		C		Poles	Trip	Circuit Description	CKT
1	EXIT LIGHTING	20 A	1	8 VA	95 VA					1	20 A	EXTERIOR LIGHTING	2
3	BELL AND BUZZER	20 A	1			20 VA	150 VA			1	15 A	EF-1	4
5	LIGHTING BATHROOM	20 A	1					85 VA	144 VA	1	20 A	ROOF LIGHTING	6
7	MONUMENT RECEPTACLE	20 A	1	180 VA	420 VA					1	20 A	UNDER COUNTER REFRIGERATOR	8
9	TRAINING SPACE	20 A	1			180 VA	500 VA			1	20 A	"W" SIGNAGE	10
11	LIGHTING SERVER AREA	20 A	1					204 VA	540 VA	1	20 A	GENERAL PURPOSE RECEPTACLE	12
13	OFFICE RECEPTACLES	20 A	1	540 VA	641 VA					1	20 A	EXTERIOR CANOPY LIGHTING	14
15	MENU BOARD LIGHTING	20 A	1			392 VA	644 VA			1	20 A	REACH IN REFRIGERATOR	16
17	DRIVE THRU DRINK DISPENSER	20 A	1					624 VA	692 VA	1	20 A	LIGHTING DINING	18
19	MOBILE GREASE CADDY	20 A	1	696 VA	792 VA					1	20 A	EXTERIOR SITE LIGHTING	20
21	FIRE ALARM CONTROL PANEL	20 A	1			720 VA	900 VA			1	20 A	ROOFTOP RECEPTACLES	22
23	LIGHTING KITCHEN	20 A	1					788 VA	960 VA	1	20 A	DUAL SIDED DRINK DISPENSER	24
25	DUAL SIDED DRINK DISPENSER	20 A	1	960 VA	1040 VA					1	20 A	REACH IN FREEZER	26
27	DRIVE THRU AUDIO RECEPTACLES	20 A	1			1000 VA	1983 VA			1	20 A	EXTERIOR SITE LIGHTING	28
29	DRIVE THRU WINDOW	20 A	1					1000 VA	1500 VA	1	20 A	HOT HOLD	30
31	HOT HOLD	20 A	1	1500 VA	135 VA					2	20 A	MULTIPLEX CONDENSER UNIT	32
33	TEA BREWER	20 A	1			1650 VA	135 VA			--	--		34
35	FLUSH VALVES	20 A	1					200 VA	360 VA	1	20 A	RTU-3 CONTROL PANEL	36
37	RTU-1 CONTROL PANEL	20 A	1	360 VA	500 VA					2	20 A	"WHATABURGER" MONUMENT SIGN	38
39	KEF-2	15 A	2			348 VA	500 VA			--	--		40
41	--	--	--					348 VA	915 VA	2	20 A	SUPER COOLER	42
43	KEF-1	15 A	2	718 VA	915 VA					--	--		44
45	--	--	--			718 VA	1384 VA			2	20 A	COOLER UNIT COOLER	46
47	LIGHTING RELAY PANEL	20 A	1					360 VA	1384 VA	--	--		48
49	SHAKE MACHINE	20 A	2	1352 VA	360 VA					1	20 A	EMERSON SITE SUPERVISOR	50
51	--	--	--			1352 VA	1831 VA			2	30 A	ICE MAKER CONDENSER UNIT	52
53	FREEZER UNIT COOLER	20 A	2					1384 VA	1831 VA	--	--		54
55	--	--	--	1384 VA	2550 VA					2	30 A	COFFEE BREWER	56
57	RTU-2 CONTROL PANEL	20 A	1			360 VA	2550 VA			--	--		58
59	ICE MAKER CONDENSING UNIT	30 A	2					1831 VA	500 VA	1	20 A	HEAT TRACE (CLASS 2 30mA GFCI)	60
61	--	--	--	1831 VA	500 VA					1	20 A	"WHATABURGER" SIGNAGE	62
63	IRRIGATION CONTROLLER	20 A	1			360 VA	500 VA			1	20 A	GREASE TANK	64
65	"WHATABURGER" SIGNAGE	20 A	1					500 VA	644 VA	1	20 A	REACH IN REFRIGERATOR	66
67	"W" SIGNAGE	20 A	1	500 VA	644 VA					1	20 A	REACH IN REFRIGERATOR	68
69	"W" SIGNAGE	20 A	1			500 VA	644 VA			1	20 A	REACH IN REFRIGERATOR	70
71	ICE MAKER EVAPORATOR UNIT	20 A	1					720 VA	2600 VA	3	30 A	OVEN	72
73	GENERAL PURPOSE RECEPTACLE	20 A	1	720 VA	2600 VA					--	--		74
75	ICE MAKER EVAPORATOR UNIT	20 A	1			720 VA	2600 VA			--	--		76
77	MULTIPLEX REFRIGERATION UNIT	30 A	3					3026 VA	0 VA	--	--	BUSSED SPACE	78
79	--	--	--	3026 VA	0 VA					--	--	BUSSED SPACE	80
81	--	--	--			3026 VA	0 VA			--	--	BUSSED SPACE	82
83	BUSSED SPACE	--	--					0 VA	0 VA	--	--	BUSSED SPACE	84
		Total Load:		24889 VA		25512 VA		23137 VA					
Load Classification		Connected Load		Design Factor		Estimated Demand		Panel Totals					
HVAC		5534 VA		100.00%		5534 VA							
Kitchen Equipment		40171 VA		65.00%		26111 VA		Total Conn. Load: 73532 VA					
Lighting		9148 VA		100.00%		9148 VA		Total Est. Demand: 57103 VA					
Motor		2281 VA		115.73%		2640 VA		Total Conn. Current: 204 A					
Other		5600 VA		100.00%		5600 VA		Total Est. Demand Current: 159 A					
Receptacle		3060 VA		100.00%		3060 VA							
Notes:													

D

C

B

A

Panel: K1													
Location: COOKING 117				Volts: 208Y/120V				Mains Type: MLO				A.I.C. Rating: 10,000	
Supply From: MDP				Phases: 3				Bus Rating: 225 A					
				Wires: 4									
CKT	Circuit Description	Trip	Poles	A		B		C		Poles	Trip	Circuit Description	CKT
1	PICTO FRYER SE14TE	50 A	2	4129 VA	0 VA					1	20 A	SPARE	2
3	--	--	--			4129 VA	4129 VA			2	50 A	PICTO FRYER SE14TE	4
5								4129 VA		--	--		6
7	FOOD WARMER	20 A	1	1440 VA	1080 VA					1	15 A	FOIL HEATER	8
9	SPARE	20 A	1			0 VA	0 VA			1	20 A	SPARE	10
11	FOOD WARMER	20 A	1					1080 VA	0 VA	1	20 A	SPARE	12
13	SPARE	20 A	1	0 VA	6557 VA					3	70 A	PICTO FRYER SE14	14
15	SPARE	20 A	1			0 VA	6557 VA			--	--	--	16
17	COMPACT FREEZER	20 A	1					960 VA	6557 VA	--	--	--	18
19	SPARE	20 A	1	0 VA	5668 VA					3	70 A	PICTO FRYER SE184	20
21	SPARE	20 A	1			0 VA	5668 VA			--	--	--	22
23	SPARE	20 A	1					0 VA	5668 VA	--	--	--	24
25	REFRIGERATOR	20 A	1	480 VA	0 VA					1	20 A	SPARE	26
27	SPARE	20 A	1			0 VA	0 VA			1	20 A	SPARE	28
29	SPARE	20 A	1					0 VA	0 VA	1	20 A	SPARE	30
Total Load:				19354 VA		20483 VA		18394 VA					
Load Classification			Connected Load		Design Factor		Estimated Demand		Panel Totals				
Kitchen Equipment			58232 VA		65.00%		37851 VA						
									Total Conn. Load: 58232 VA				
									Total Est. Demand: 37851 VA				
									Total Conn. Current: 162 A				
									Total Est. Demand Current: 105 A				
Notes:													
PROVIDED AND PREWIRED BY KITCHEN EQUIPMENT SUPPLIER.													

Panel: K3													
Location: COOKING 117				Volts: 208Y/120V				Mains Type: MLO				A.I.C. Rating: 10,000	
Supply From: MDP				Phases: 3				Bus Rating: 225 A					
				Wires: 4									
CKT	Circuit Description	Trip	Poles	A		B		C		Poles	Trip	Circuit Description	CKT
1	UNDERCOUNTER REFRIGERATOR	20 A	2	210 VA	1650 VA					2	20 A	BUN TOASTER	2
3	--	--	--			210 VA	1650 VA			--	--	--	4
5	72" GRIDDLE	125 A	3					12000 VA	180 VA	1	15 A	ANSUL FIRE SUPPRESSION	6
7	--	--	--	12000 VA	360 VA					1	20 A	ORDER SCREEN	8
9	--	--	--			12000...	0 VA			1	20 A	SPARE	10
11	SPARE	20 A	1					0 VA	0 VA	1	20 A	SPARE	12
13	SPARE	20 A	1	0 VA	0 VA					1	20 A	SPARE	14
15	SPARE	20 A	1			0 VA	0 VA			1	20 A	SPARE	16
17	SPARE	20 A	1					0 VA	0 VA	1	20 A	SPARE	18
19	SPARE	20 A	1	0 VA	0 VA					1	20 A	SPARE	20
21	SPARE	20 A	1			0 VA	0 VA			1	20 A	SPARE	22
23	SPARE	20 A	1					0 VA	0 VA	1	20 A	SPARE	24
25	SPARE	20 A	1	0 VA	0 VA					1	20 A	SPARE	26
27	SPARE	20 A	1			0 VA	0 VA			1	20 A	SPARE	28
29								0 VA		1	20 A	SPARE	30
Total Load:				14220 VA		13860 VA		12180 VA					
Load Classification			Connected Load		Design Factor		Estimated Demand		Panel Totals				
Kitchen Equipment			40080 VA		80.00%		32064 VA						
Other			180 VA		100.00%		180 VA		Total Conn. Load: 40260 VA				
									Total Est. Demand: 32244 VA				
									Total Conn. Current: 112 A				
									Total Est. Demand Current: 90 A				
Notes:													
PROVIDED AND PREWIRED BY KITCHEN EQUIPMENT SUPPLIER.													

Panel: K2													
Location: COOKING 117				Volts: 208Y/120V				Mains Type: MLO				A.I.C. Rating: 10,000	
Supply From: MDP				Phases: 3				Bus Rating: 225 A					
				Wires: 4									
CKT	Circuit Description	Trip	Poles	A		B		C		Poles	Trip	Circuit Description	CKT
1	UNDERCOUNTER REFRIGERATOR	20 A	2	210 VA	1650 VA					2	20 A	BUN TOASTER	2
3	--	--	--			210 VA	1650 VA			--	--	--	4
5	72" GRIDDLE	125 A	3					12000 VA	180 VA	1	15 A	ANSUL FIRE SUPPRESSION	6
7	--	--	--	12000 VA	360 VA					1	20 A	ORDER SCREEN	8
9	--	--	--			12000...	0 VA			1	20 A	SPARE	10
11	SPARE	20 A	1					0 VA	0 VA	1	20 A	SPARE	12
13	SPARE	20 A	1	0 VA	0 VA					1	20 A	SPARE	14
15	SPARE	20 A	1			0 VA	0 VA			1	20 A	SPARE	16
17	SPARE	20 A	1					0 VA	0 VA	1	20 A	SPARE	18
19	SPARE	20 A	1	0 VA	0 VA					1	20 A	SPARE	20
21	SPARE	20 A	1			0 VA	0 VA			1	20 A	SPARE	22
23	SPARE	20 A	1					0 VA	0 VA	1	20 A	SPARE	24
25	SPARE	20 A	1	0 VA	0 VA					1	20 A	SPARE	26
27	SPARE	20 A	1			0 VA	0 VA			1	20 A	SPARE	28
29	SPARE	20 A	1					0 VA	0 VA	1	20 A	SPARE	30
Total Load:				14220 VA		13860 VA		12180 VA					
Load Classification			Connected Load		Design Factor		Estimated Demand		Panel Totals				
Kitchen Equipment			40080 VA		80.00%		32064 VA						
Other			180 VA		100.00%		180 VA		Total Conn. Load: 40260 VA				
									Total Est. Demand: 32244 VA				
									Total Conn. Current: 112 A				
									Total Est. Demand Current: 90 A				
Notes:													
PROVIDED AND PREWIRED BY KITCHEN EQUIPMENT SUPPLIER.													



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12/22/20  
PROFESSIONAL OF RECORD:  
JASON E. CHRISTOFF No. 20012002143  
EXP. DATE: 12/31/20

REV	DESCRIPTION	DATE

Project No.: 62-40497-01

Client Project No.:

Drawing Title:

ELECTRICAL PANEL  
SCHEDULES

Date: 12/22/20 Phase: PERMIT SET

Designed: DCU

Drawn: DCU

Checked: KFF

Drawing No.:

E7.2