


Quality By Design


ASPHALT SHINGLES ╘╻═┸┲╧┲╧┲╧┲╧┲╧┲╧ BOARD AND BATTEN \uparrow \uparrow STONE VANEER \uparrow \uparrow \uparrow

RELEASE FOR CONSTRUCTION AS NOTED ON PLANS REVIEW CODES ADMINISTRATION LEE'S SUMMIT, MISSOURI

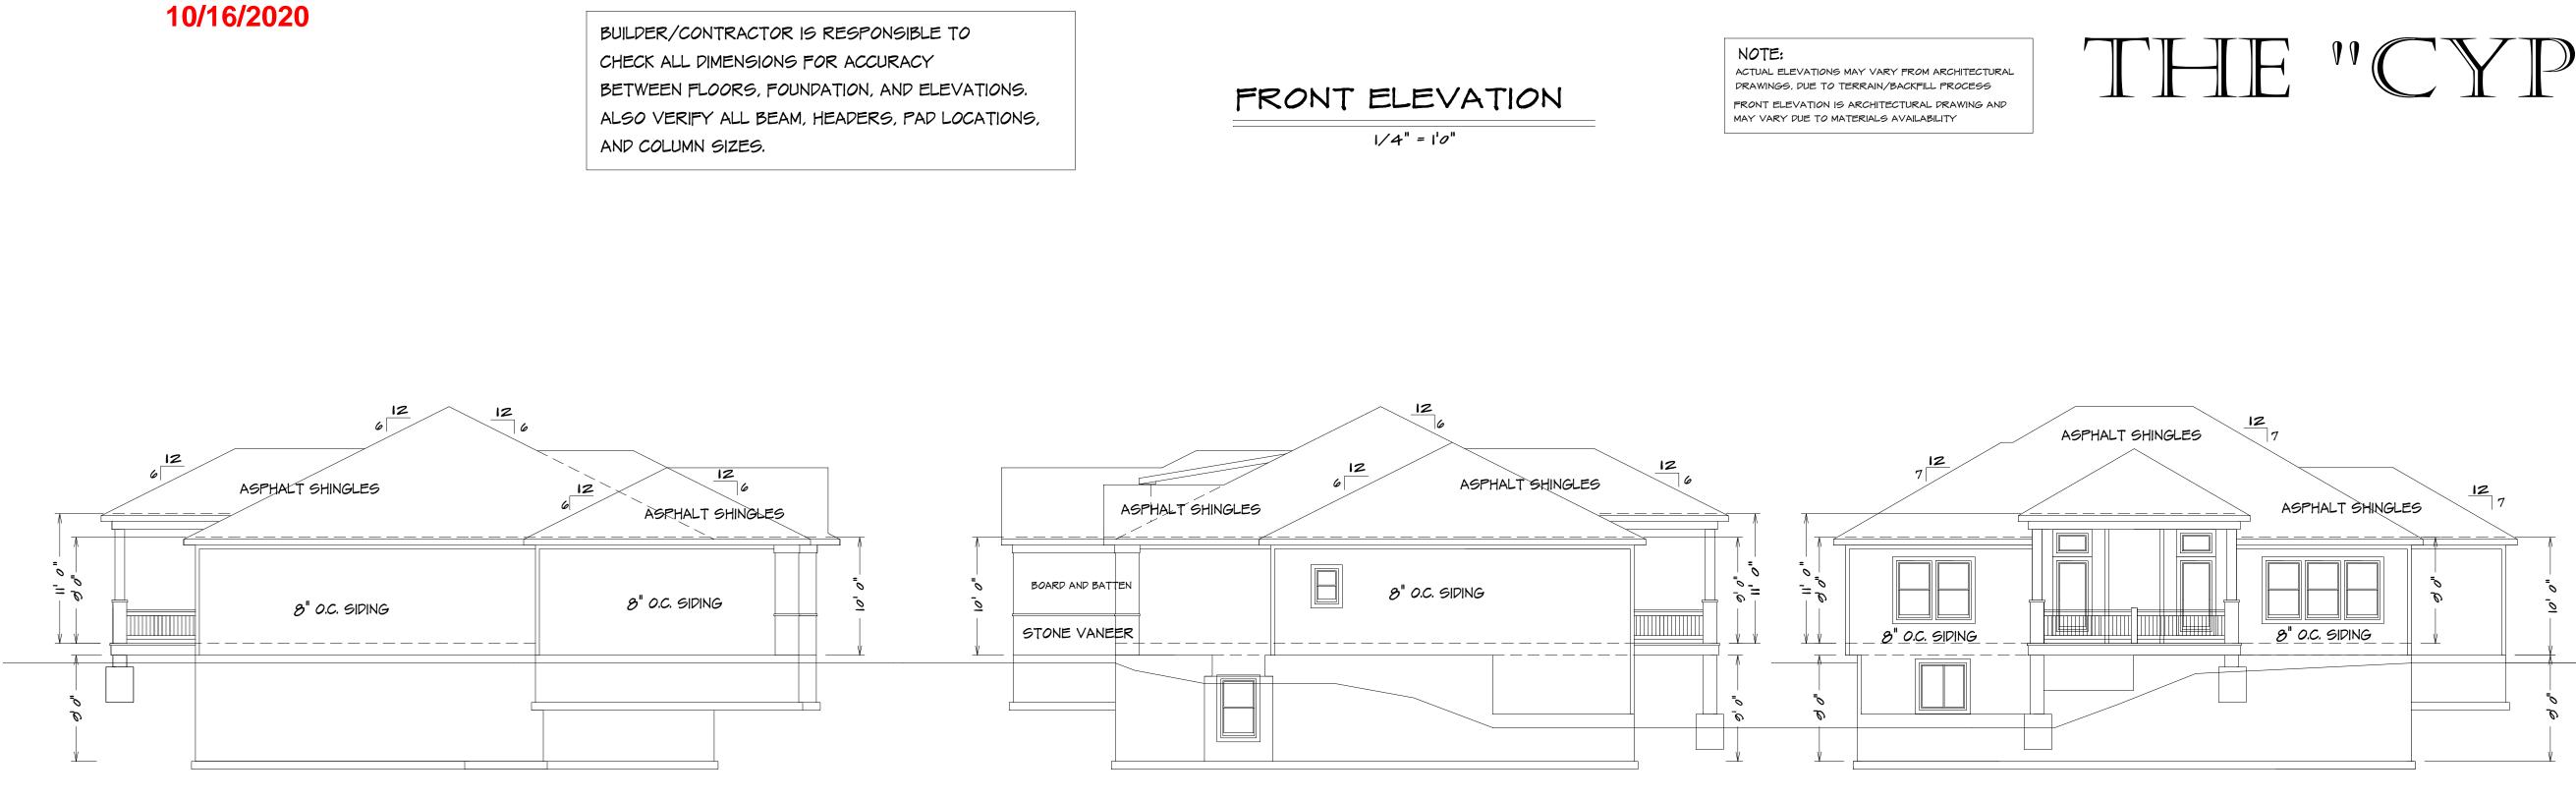

LEFT ELEVATION |/8" = |'0"

KH-6105 (THE CYPRESS) LOT 121

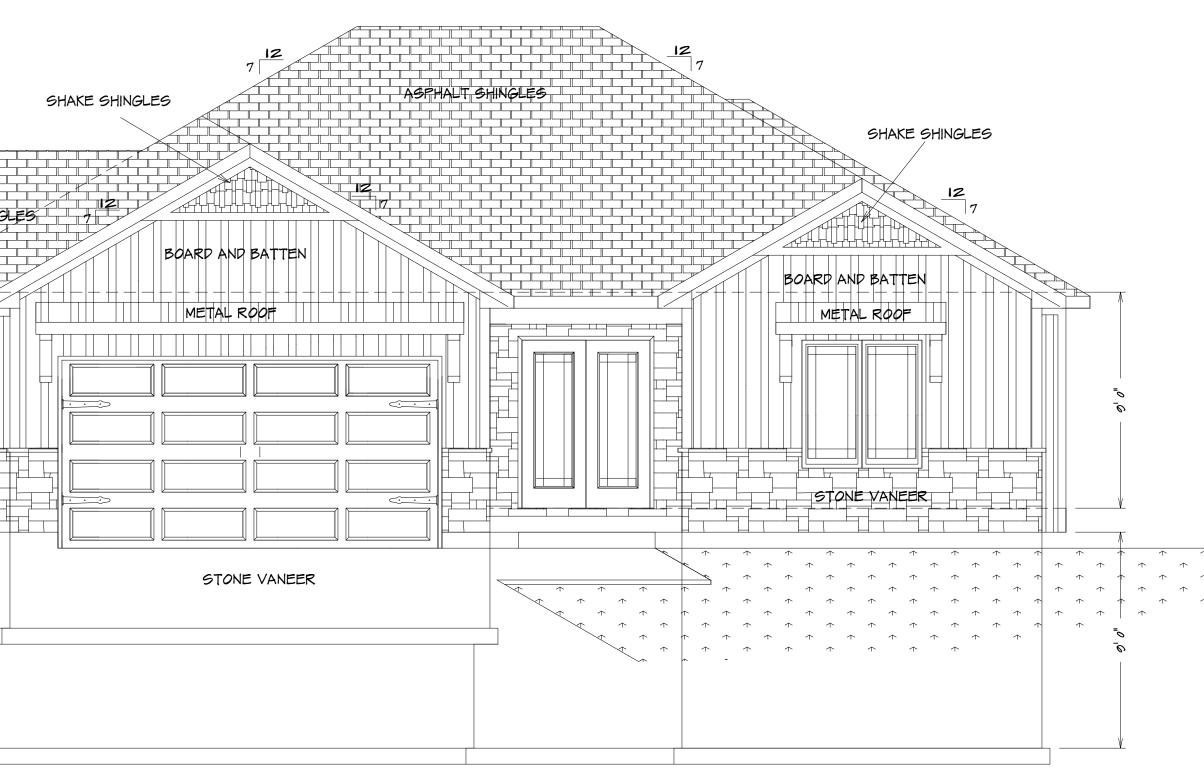



REAR ELEVATION 1/8" = 1'0"



LIVING AREA FIRST FLOOR = 1625 BASEMENT = 1215 COVERED DECK = 186


SQUARE FOOTAGE

UNFINISHED AREA STORAGE BASEMENT = 257 GARAGE = 725 UNDER STOOP = 32

THE "CYPRESS"

1634 SE BLACKSTONE PL. LEES SUMMIT MO LOT IZI NAPA VALLEY

 $\uparrow \uparrow \uparrow$ \uparrow \uparrow \uparrow \uparrow

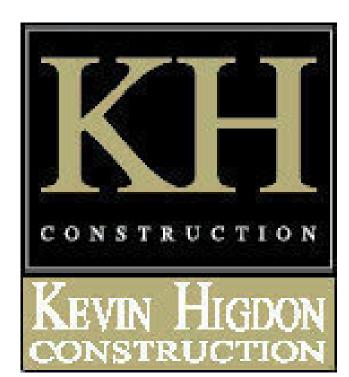


	()		APP	
	PLAN NO.	KH-6105	FILE NAME:	6000 ELEV
	DATE DRAWN:	DATE REVISED:		DESIGNER:
	PHONE:	PHONE:		LOT NO.
	HOME BUYER:	BUILDER:		SUB-DIVISION:
BUILDER&CONTRACTOR IS RESPONSIBLE TO CHECK ALL DIMENSIONS FOR ACCURACY	BETWEEN FLOORS, FOUNPATION, AND ELEVATIONS. ALSO VERIFY ALL BEAM, HEAPERS, PAD LOCATIONS, AND COLUMN SIZES. BUILPER&CONTRACTOR TO CHECK FOR	COMPLIANCE WITH CONTRACTS, CITY, AND NATIONAL COPES. BUILPER®CONTRACTOR ACCEPTS ALL RESPONSIBLITY FOR LOT PLACEMENT, SET-BACKS, AND FLOOP PLAINS.	BUILDER®CONTRACTOR AND HOME OWNER ACCEPTS RESPONSIBLITY FOR ANY AND ALL COPYRIGHT INFRINGMENTS OR RESEMBLANCES TO OTHER COPYRIGHTED FLANS.	BUILPER&CONTRACTOR ACCEPTS RESPONSIBLITY FOR ANY AN ON SITE CHANGES MADE TO STRUCTURE.

N.

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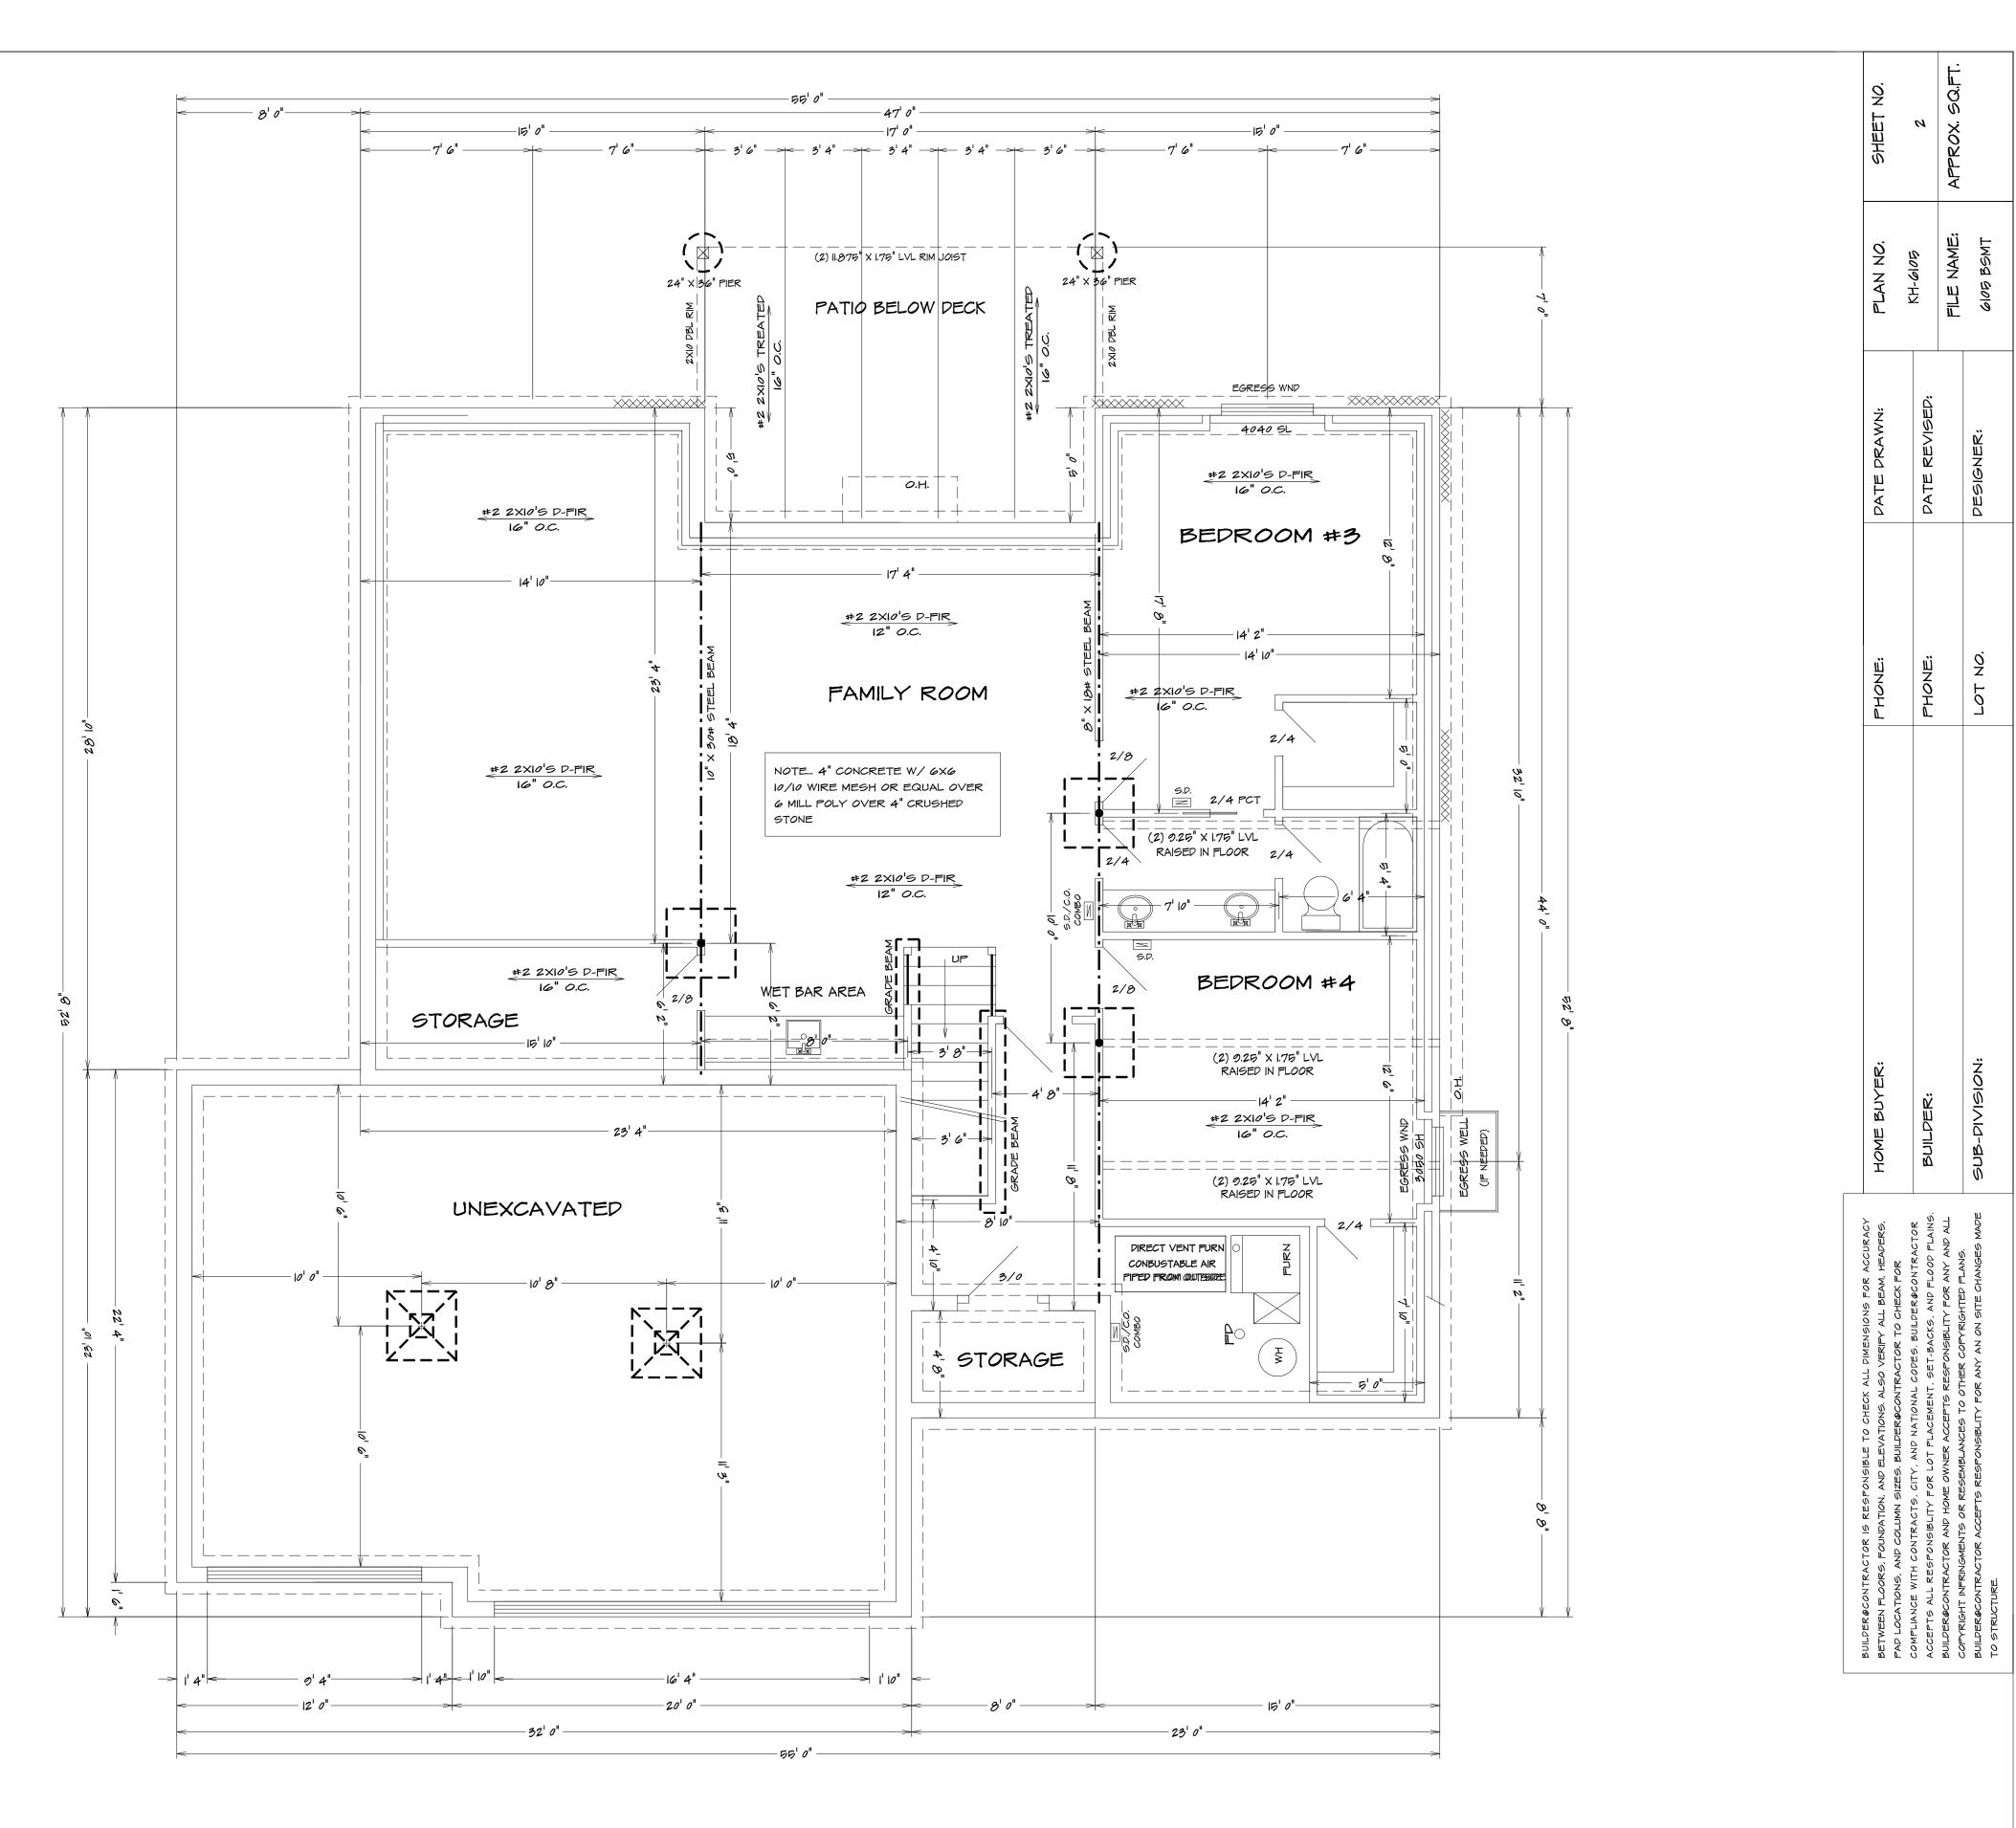
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UFER GOUNDING SECTION

Note...Bridging. Joists exceeding a nominal 2 inches by 12 inches shall be supported laterally by solid blocking, diagonal bridging (wood or metal), or a continuous 1-inch-by-3-inch strip nailed across the bottom of joists perpendicular to joists at intervals not exceeding 8 feet. (R502.7.1)

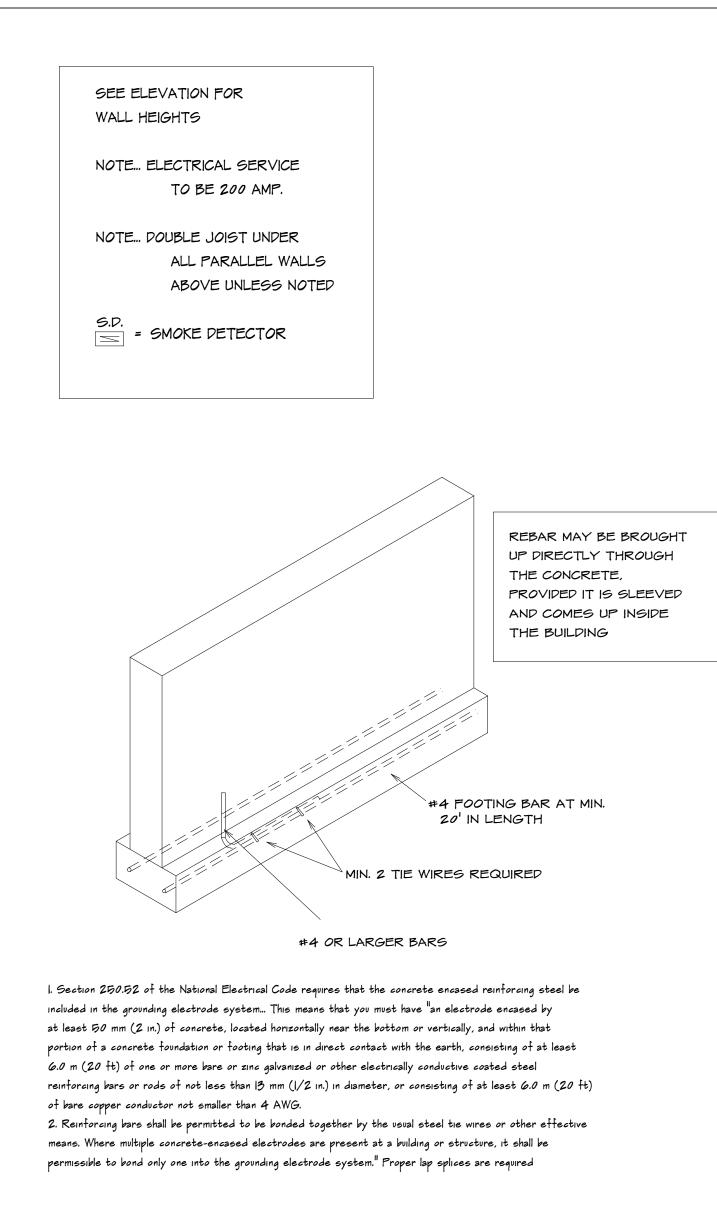KH-6105 (THE CYPRESS) LOT 121




BASEMENT PLAN

RELEASE FOR CONSTRUCTION AS NOTED ON PLANS REVIEW DEVELOPMENT SERVICES LEE'S SUMMIT, MISSOURI SEE ELEVATION FOR WALL HEIGHTS

NOTE... ELECTRICAL SERVICE TO BE 200 AMP.

NOTE... DOUBLE JOIST UNDER ALL PARALLEL WALLS ABOVE UNLESS NOTED

S.D. = SMOKE DETECTOR

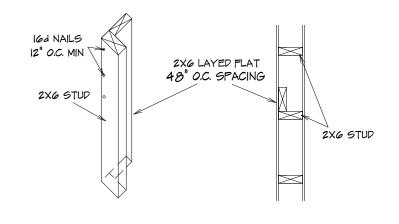

EXTERIOR TALL WALL SECTION 10' TRU 10' UNINTERRUPTED TALL WALLS TO BE CONSTRUCTED WITH 2X6 STUDS 16" O.C. WITH STIFF BACK EVERY 40" O.C.

GENERAL HEADER SPECIFICATIONS:

REQUIRED AREAS NEEDING HEADERS: WINDOWS/DOORS UP TO 38" R.O. WINDOWS/DOORS 38" UP TO 72" R.O. WINDOWS/DOORS 72" UP TO 96" R.O. 8'0" GARAGE DOORS W/CEILING & ROOF LOAD 9'0" GARAGE DOORS W/CEILING & ROOF LOAD 8'0" GARAGE DOORS W/CEILING & ROOF LOAD

9'0" GARAGE DOORS W/SECOND FLOOR

16'0" GARAGE DOOR W/NO SECOND FLOOR

16'0" GARAGE DOORS W/SECOND FLOOR

HEAPER DESCRIPTIONS: (2) #2 D-FIR 2XI0'S (2) #2 D-FIR 2XI0'S W/I/2" GLUE PLY (2) 9 I/2" L.V.L. (2) 9 I/2" L.V.L. (2) 9 I/2" L.V.L. (2) 9 I/2" L.V.L. (2) 1/2" L.V.L. (2) 1/2" L.V.L. (2) 1/2" L.V.L. (2) 1/2" L.V.L.

USE HEADERS FOR OPENINGS ABOVE UNLESS SPECIFIED OTHERWISE.

R312.2.1 Window sills.

In dwelling units, where the opening of an operable window is located more than 72 inches (1820 mm) above the finished grade or surface below, the lowest part of the clear opening of the window shall be a minimum of 24 inches (Gl0 mm) above the fininshed floor of the room in which the window is located. Operable sections of windows shall not permit openings that allow passage of a 4-inch-diameter (102 mm) sphere where such openings are located within 24 inches (Gl0 mm) of the finished floor.

Exceptions:

- I. Windows whose openings will not allow a 4-inch-diameter (102 mm) sphere to pass through the opening when the opening is in its largest opened position.
- 2. Openings that are provided with window fall prevention devices that comply with ASTM F 2090.
- 3. Windows that are provided with window opening control devices that comply with Section R312.2.2.

R312.2.2 Window opening control devices.

Window opening control devices shall comply with ASTM F 2090. The window opening control device, after operation to release the control device allowing the window to fully open, shall not reduce the minimum net clear opening area of the window unit to less than the area required by Section R310.1.1.


Bathrooms, water closet compartments and other similar rooms shall be provided with aggregate glazing area in windows of not less than 3 square feet, one-half of which must be openable. Exception: The glazed areas shall not be required where artificial light and a local exhaust system are provided. The minimum local exhaust rates shall be determined in

accordance with Section MI507.

Exhaust air from the space shall be exhausted directly

to the outdoors.

KH-6105 (THE CYPRESS) LOT 121

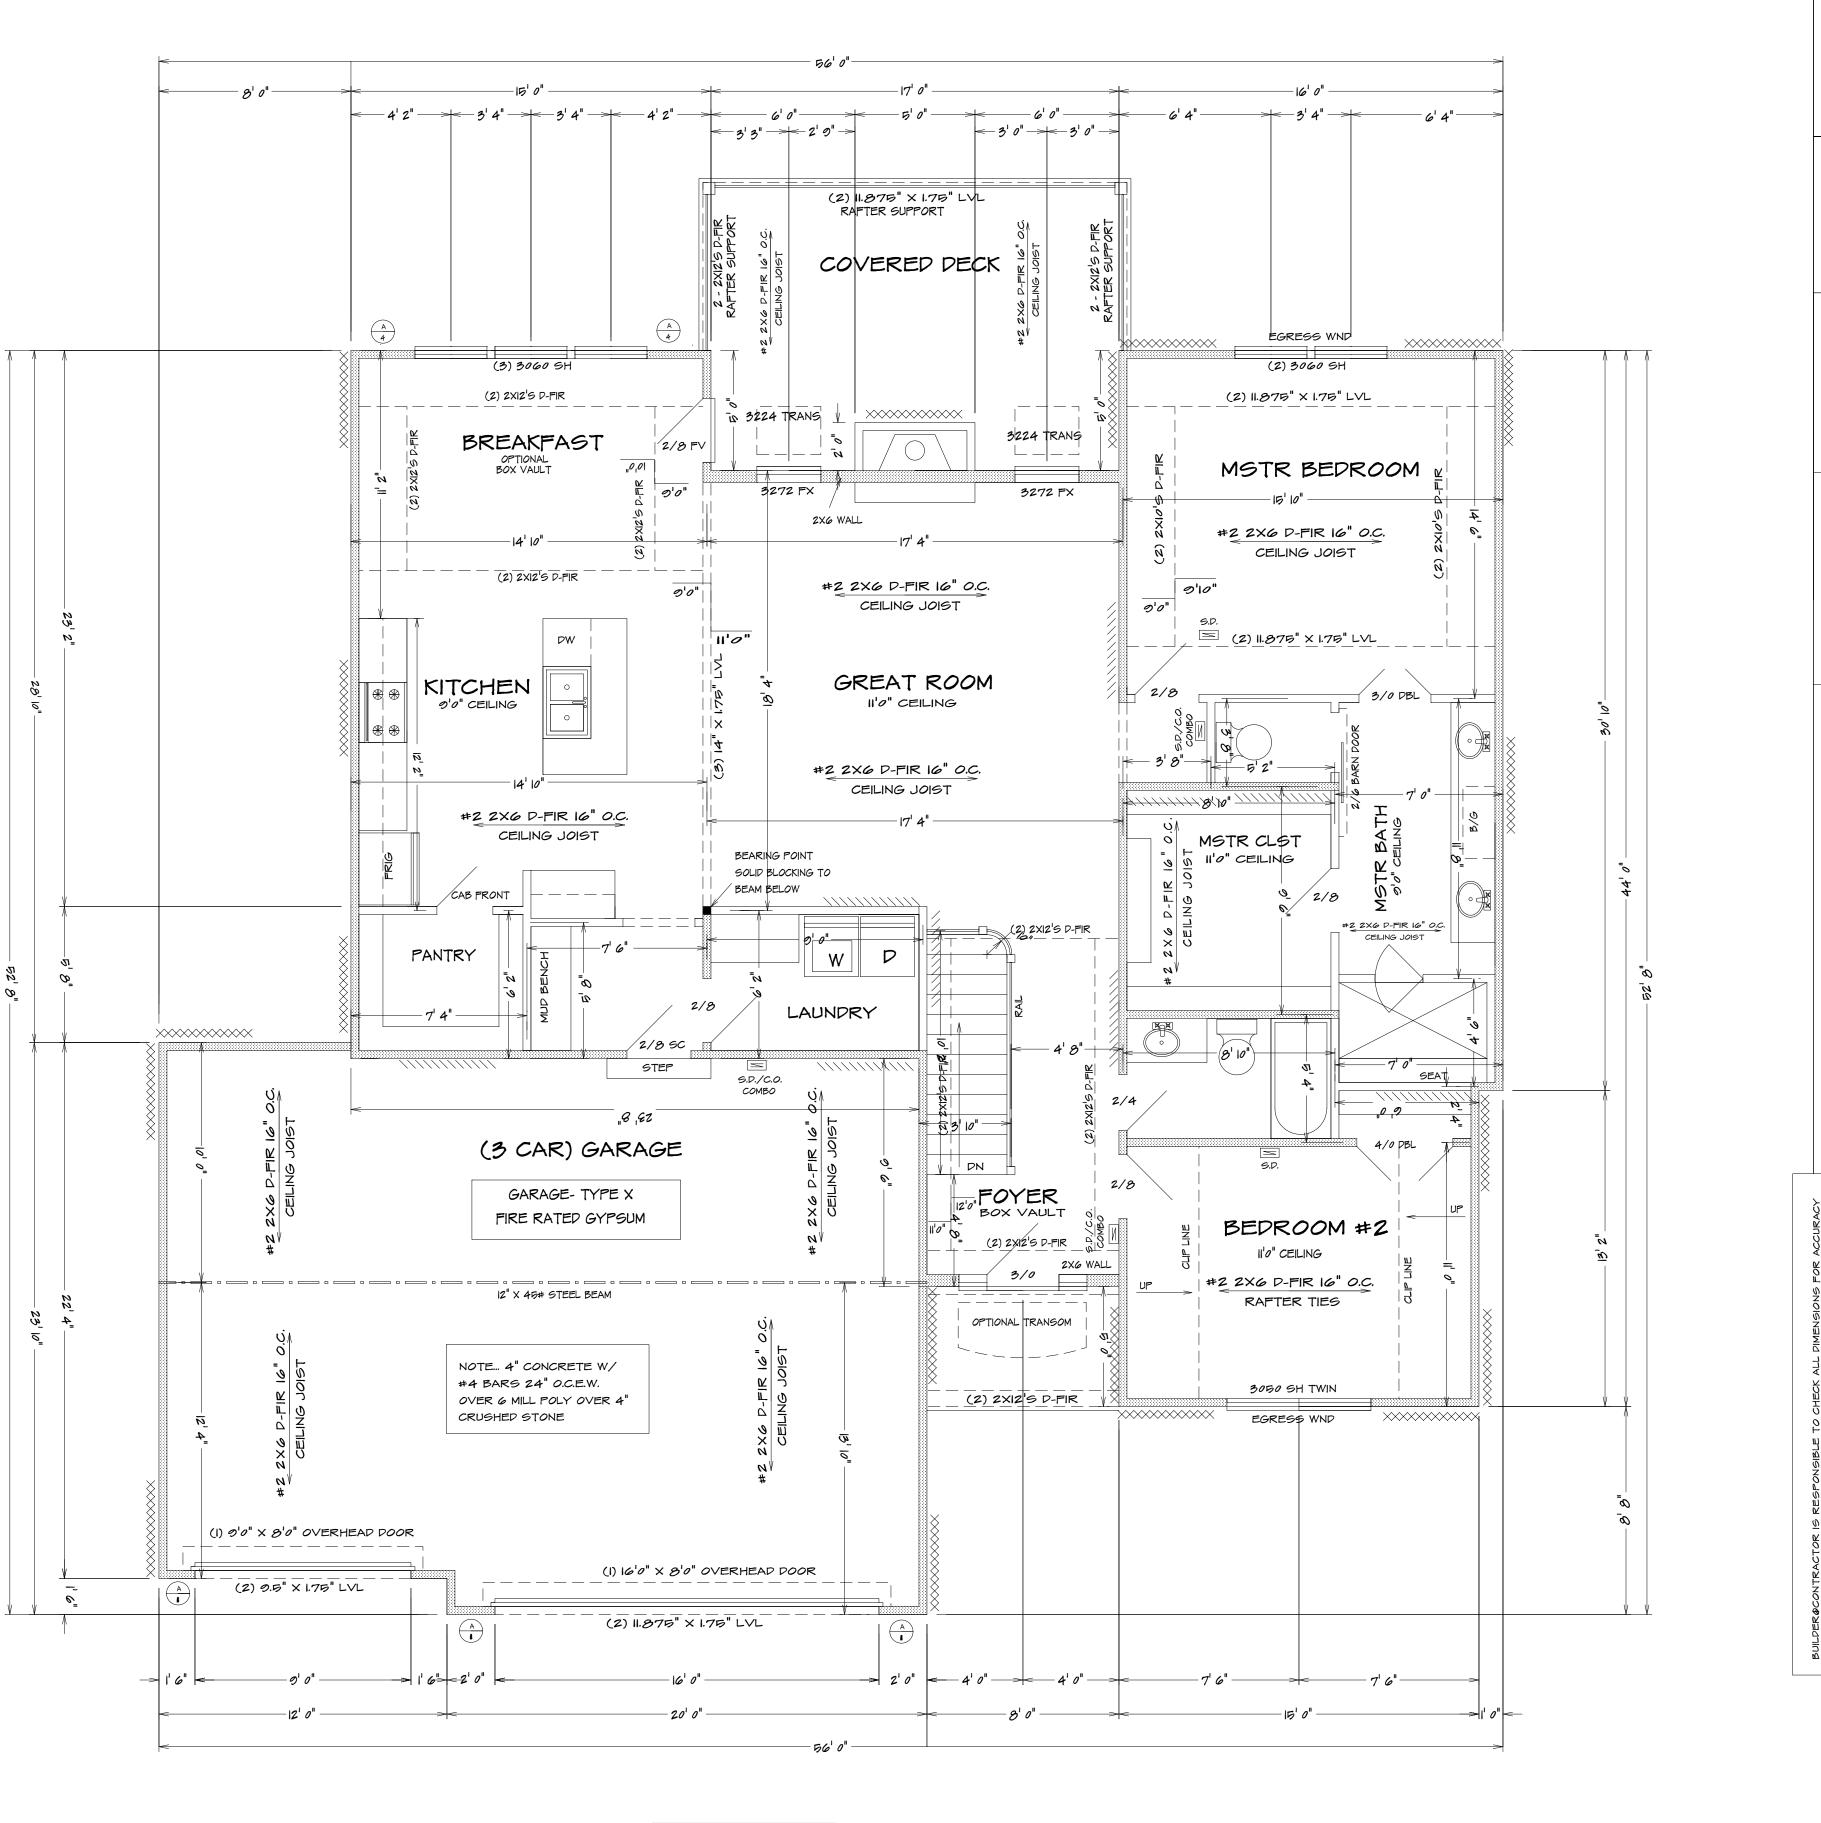

BEARING WALL


FIRST FLOOR PLAN

1/4" =

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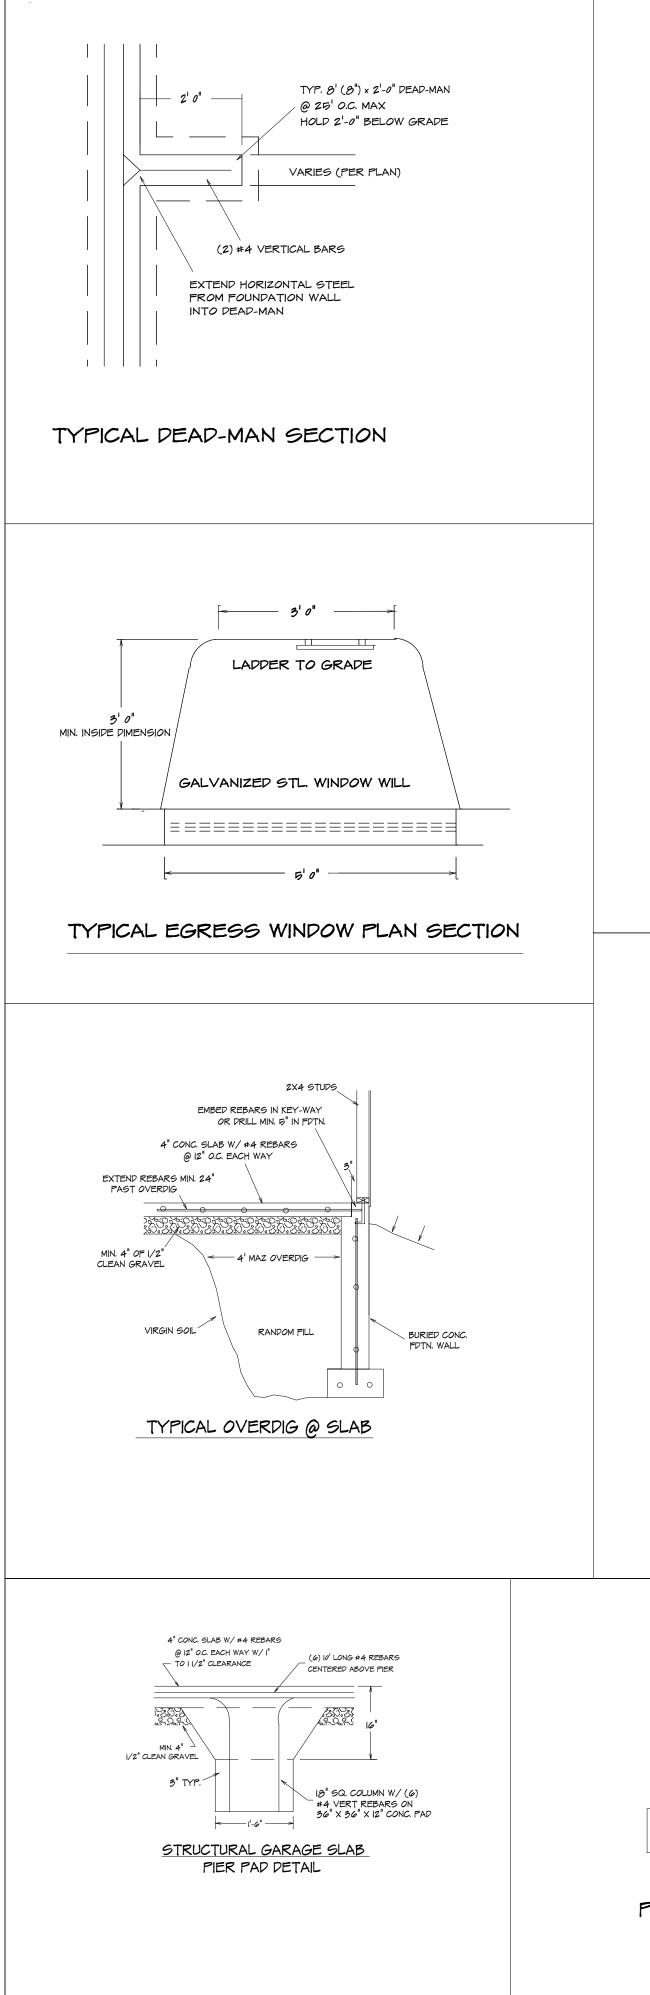
> RELEASE FOR CONSTRUCTION AS NOTED ON PLANS REVIEW DEVELOPMENT SERVICES LEE'S SUMMIT, MISSOURI


> > 10/16/2020

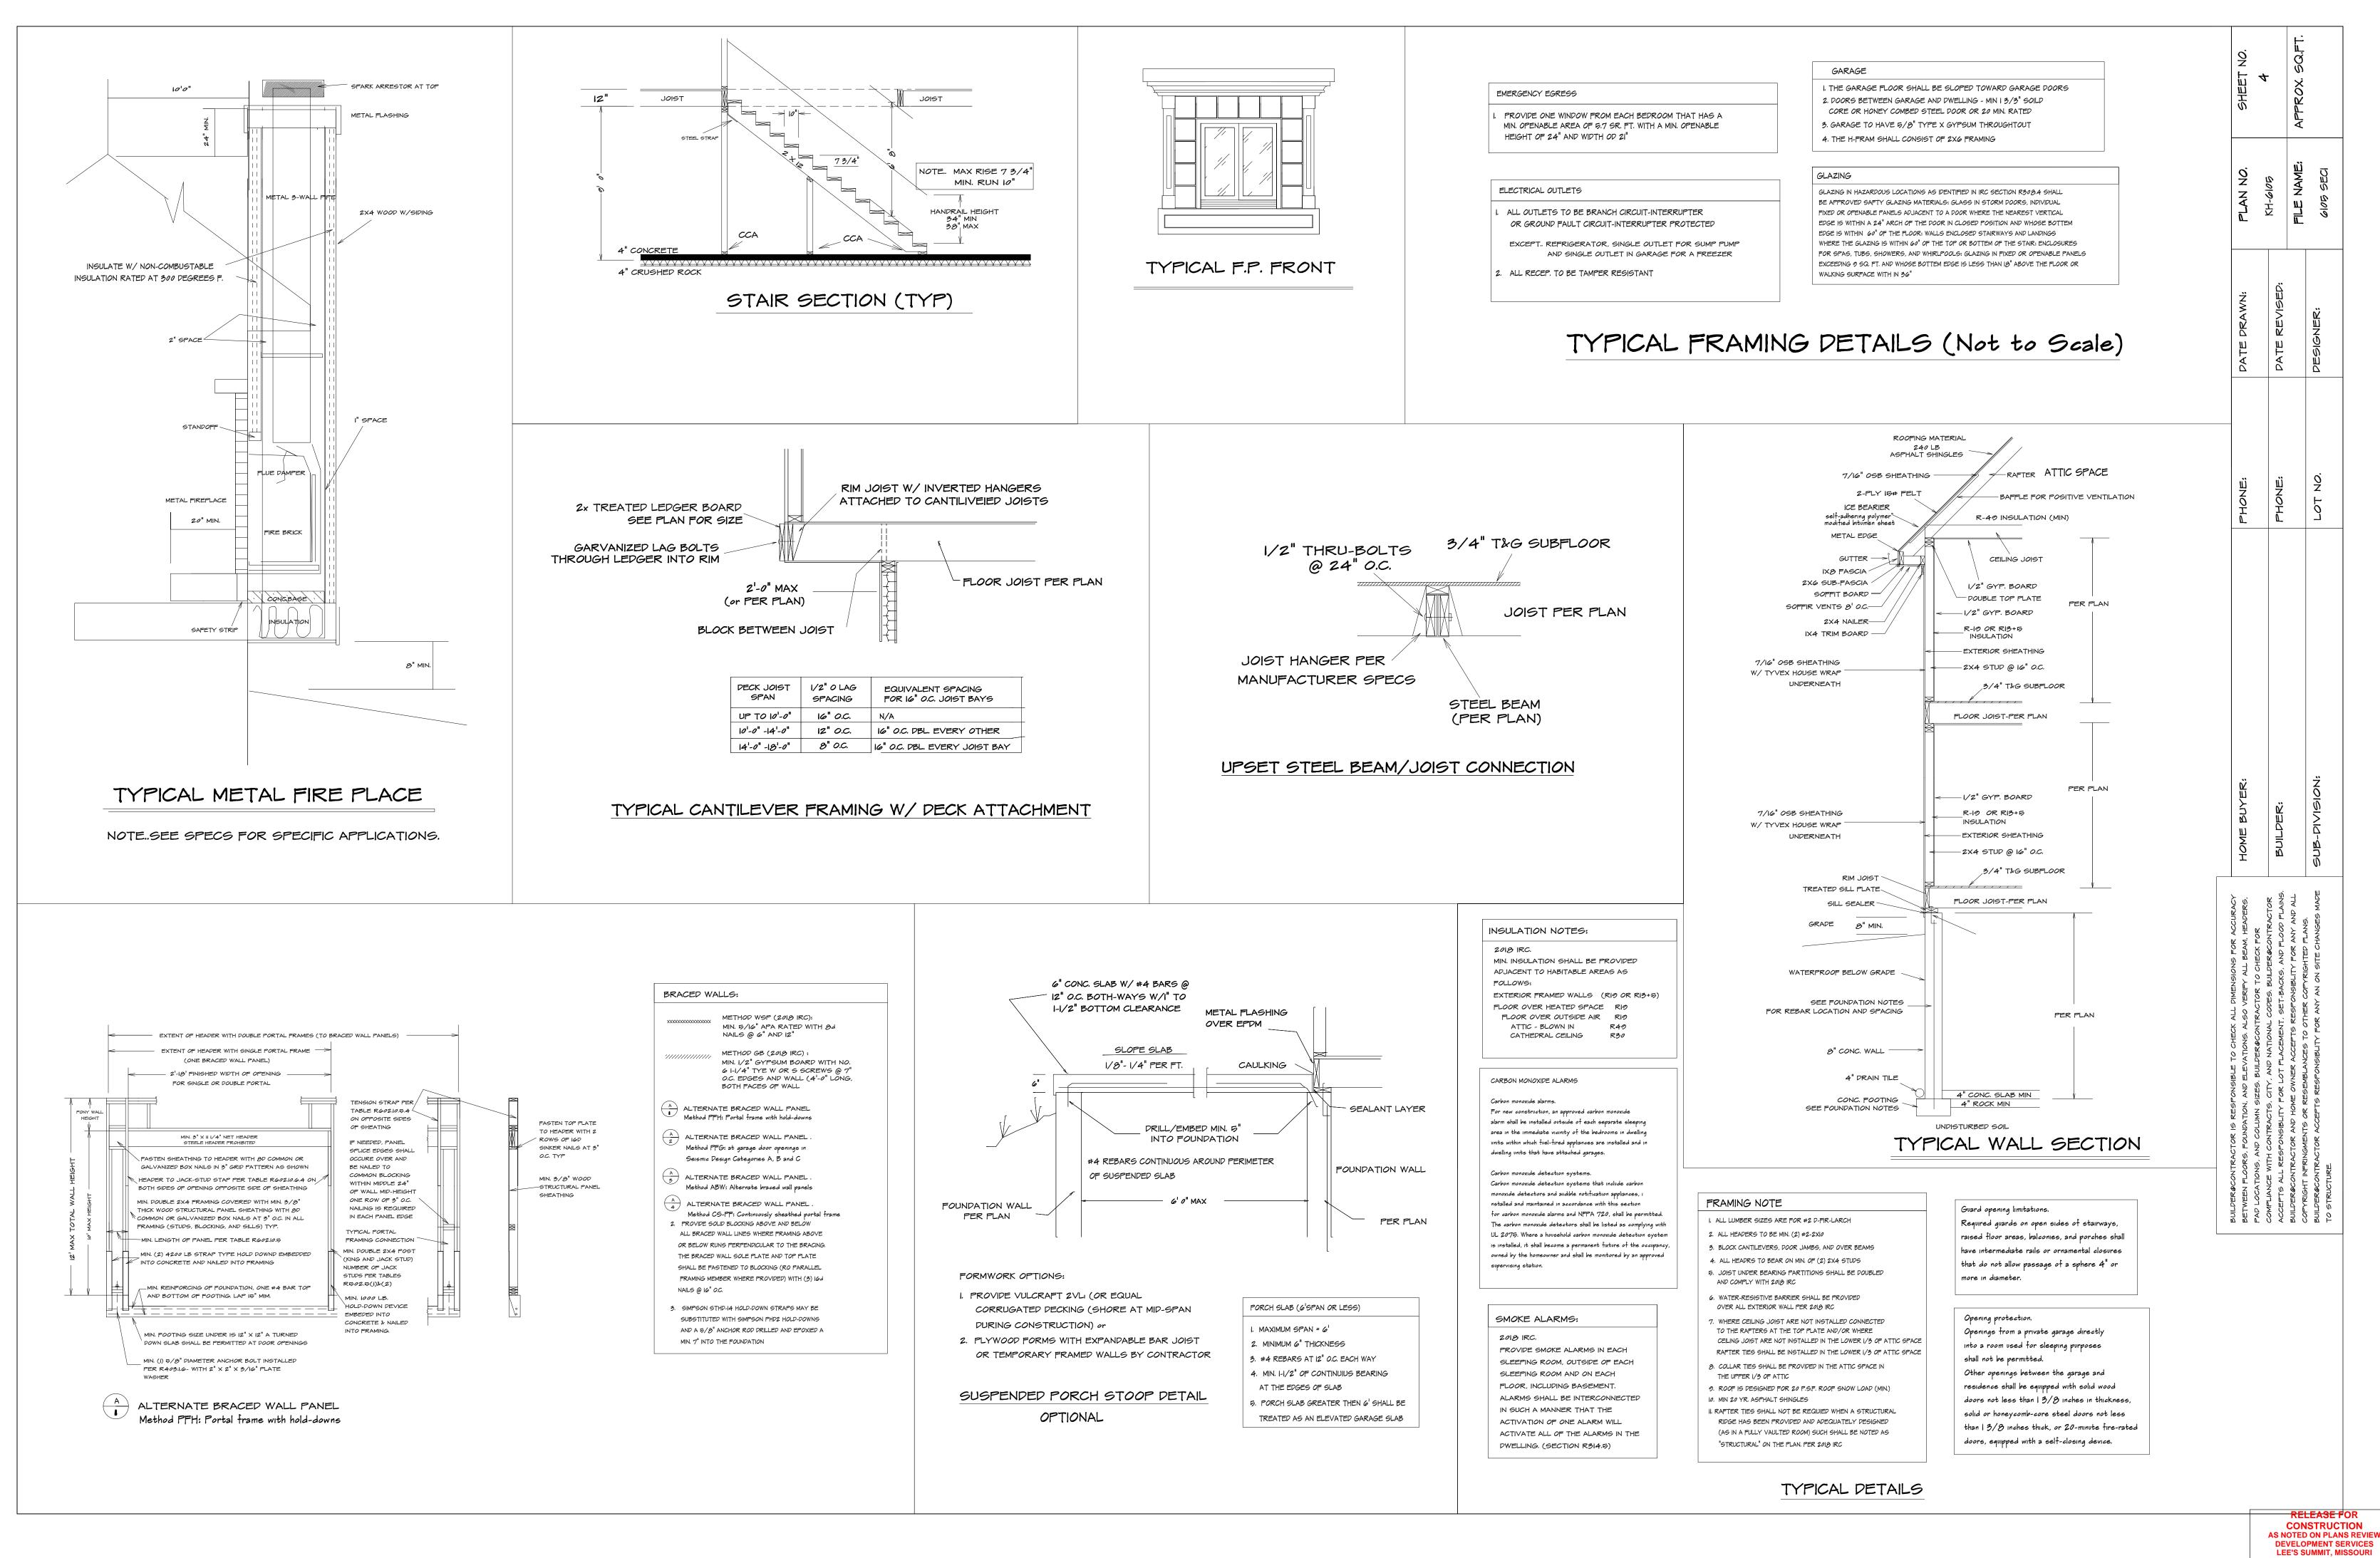


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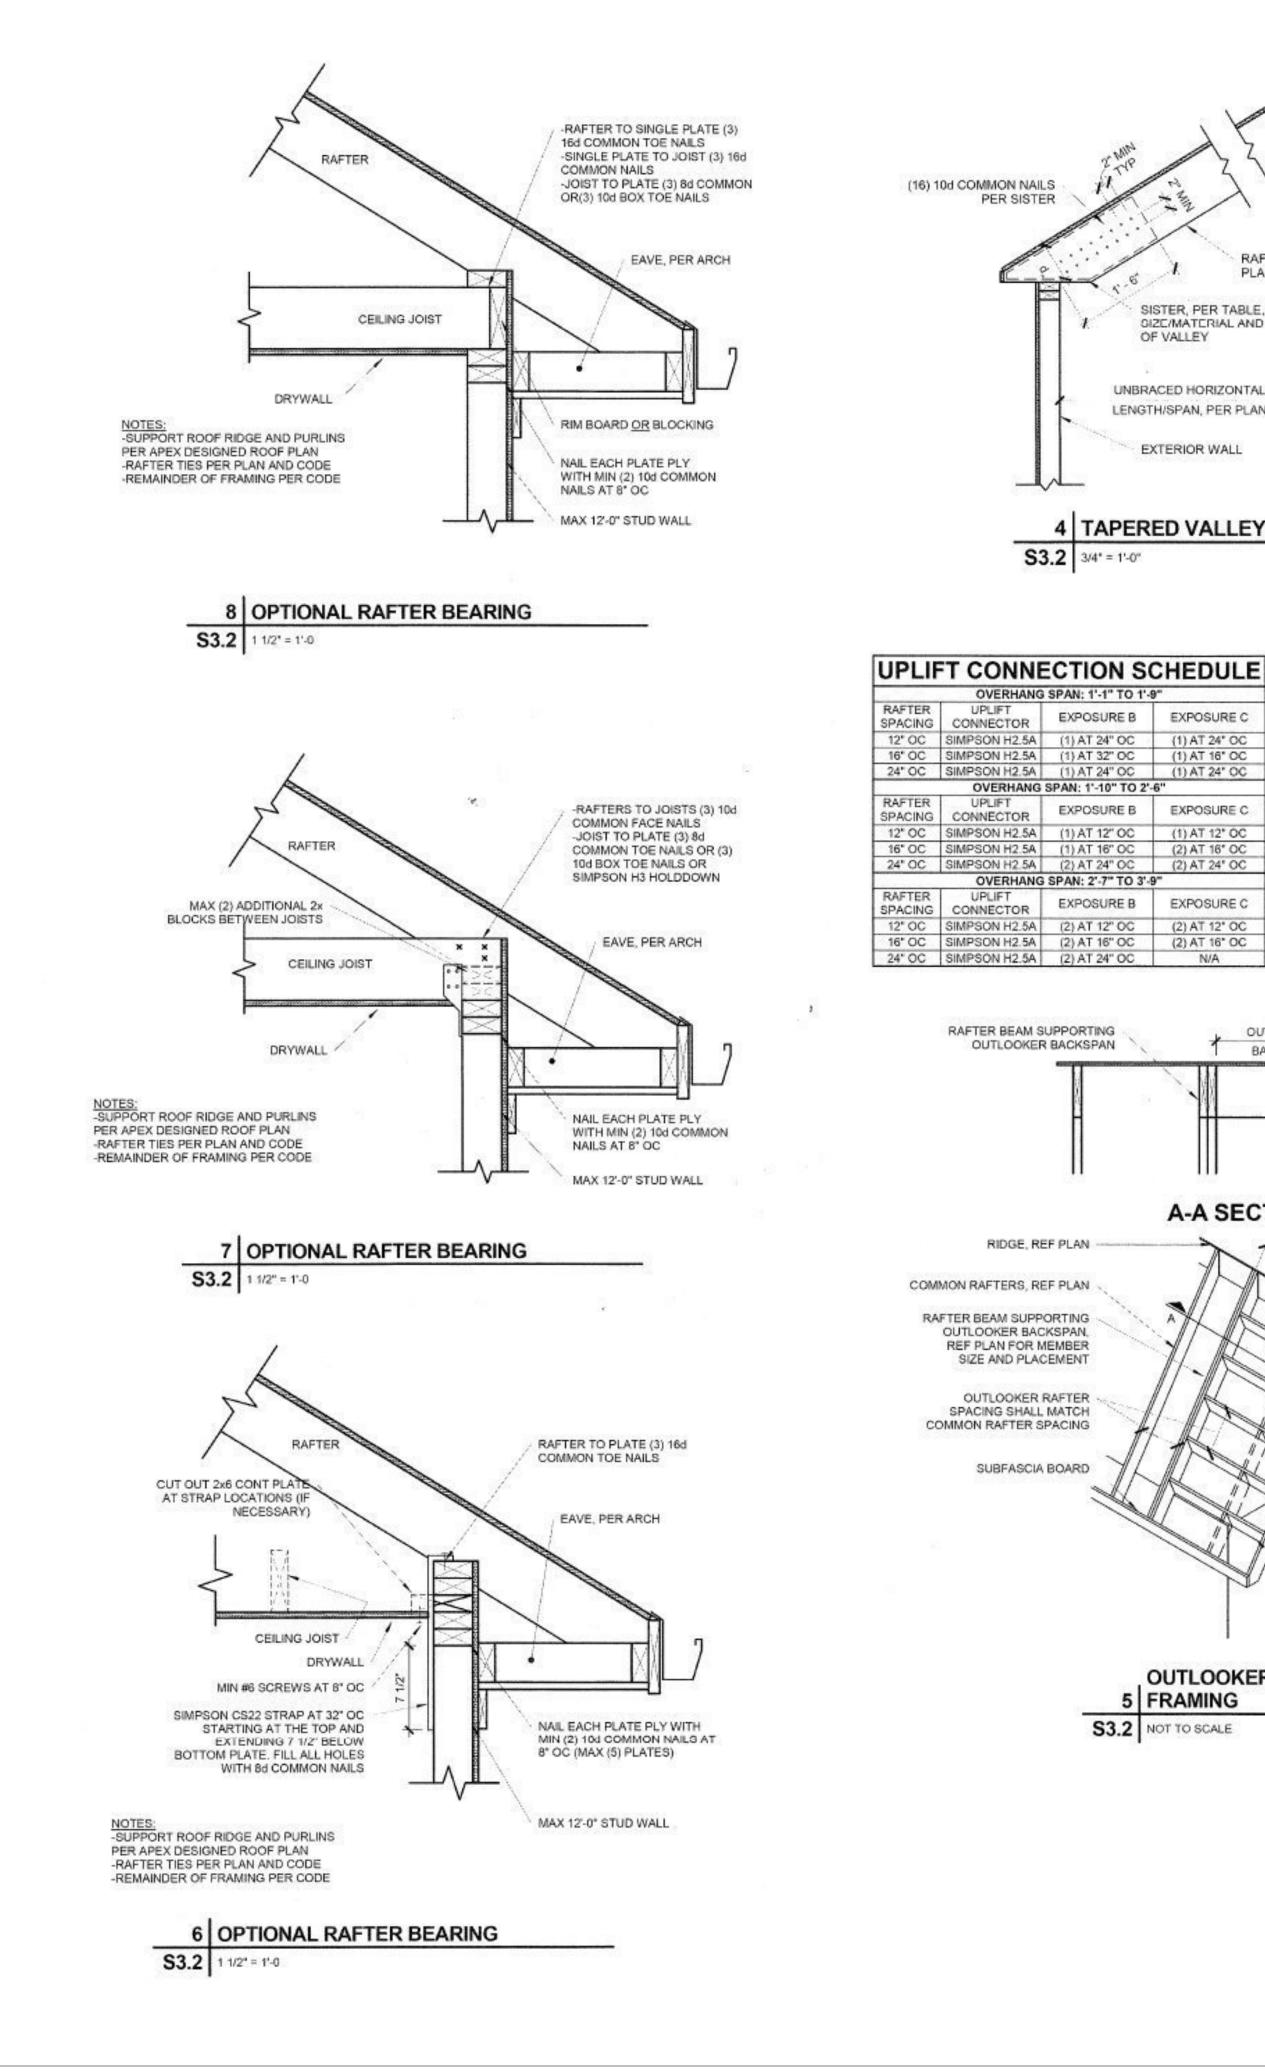





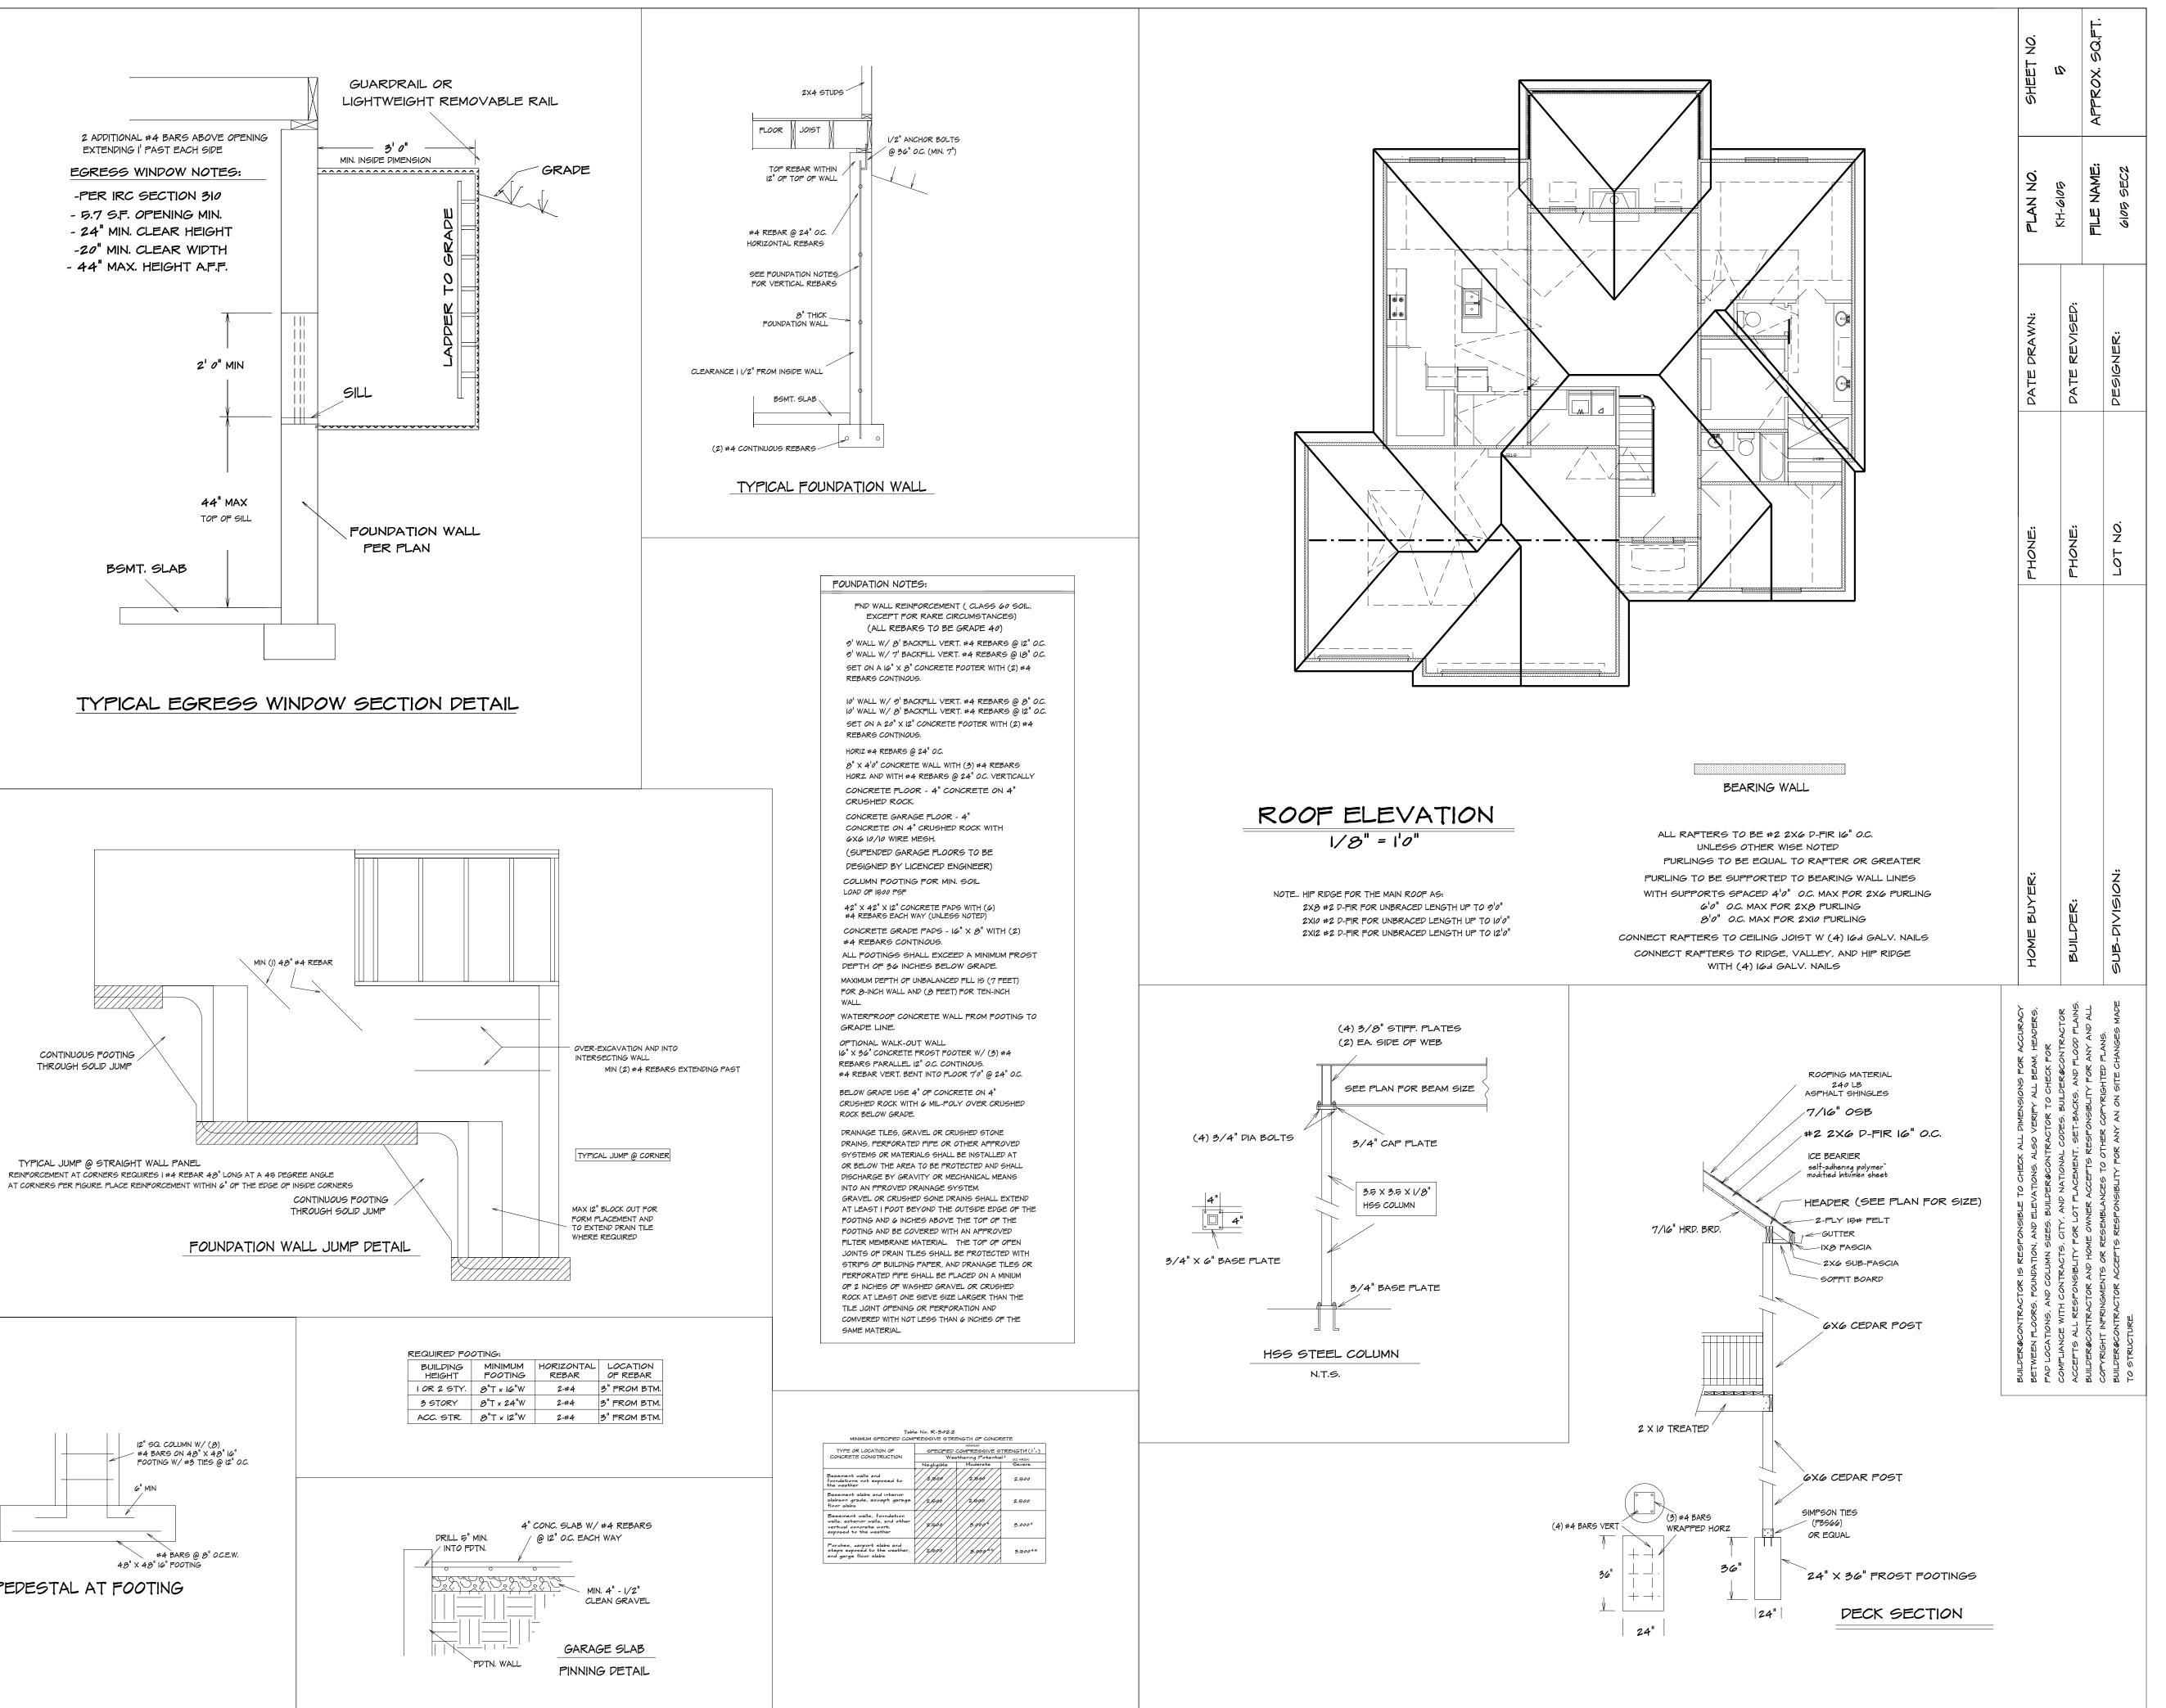

RELEASE FOR CONSTRUCTION AS NOTED ON PLANS REVIEW DEVELOPMENT SERVICES LEE'S SUMMIT, MISSOURI

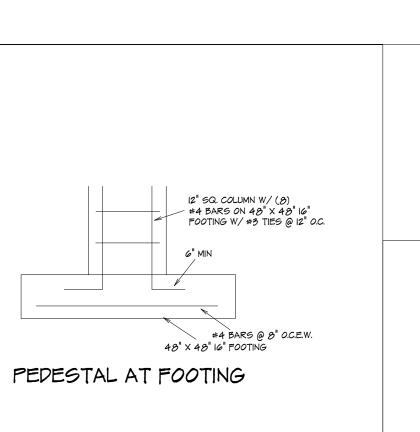10/16/2020



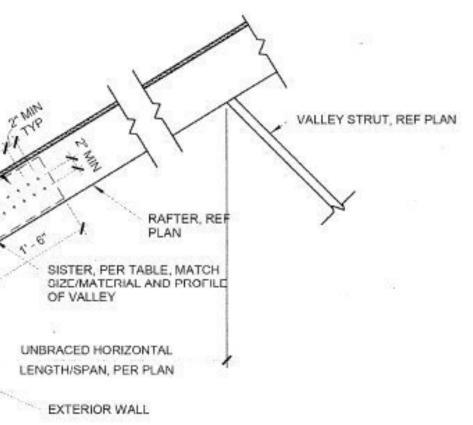

4 TAPERED VALLEY


REQUIRED	NUMBER	OF SISTER	PLIES

R	EQUI	RED	NOWRE	ROFSIS	ERP	LIES	
4			LIGH	T ROOF			
2x VALLEY				LVL VALLEY			
# OF SISTER PLIES	RAFTER SIZE			# OF SISTER	RAFTER SIZE		
	2x6	2x8	2x10	PLIES	2x6	2x8	2x10
0	4'-8"	6'-2"	7"-11"	0	8'-8"	11'-5"	14'-7"
1	9'-5"		•	1			+ -
2		N/A	N/A	2	N/A	N/A	N/A
			HEAV	YROOF			
2x VALLEY				LVL VALLEY			
# OF SISTER PLIES	RAFTER SIZE			# OF SISTER	RAFTER SIZE		
	2x6	2x8	2x10	PLIES	2x6	2x8	2x10
0	3'-6"	4'-7"	5'-11"	0	6'-6"	8'-7"	10'-11'
1	7'-1*	9'-3"		1	13'-1"		
0							

* * N/A 2 * N/A N/A "VALLEYS OF A LENGTH GREATER THAN THAT FOUND IN THE CELL ABOVE ARE CONTROLLED BY BENDING. APPLY THE NUMBER OF SISTER PLIES CORRESPONDING TO THIS ROW.


- THIS TABLE IS INTENDED TO BE USED IN CONJUNCTION WITH THE STAMPED, ENGINEERED PLANS AS THEY ARE DRAWN BY APEX. BRACING LOCATIONS SHALL. DETERMINE HORIZONTAL, UNSUPPORTED SPAN FROM VALLEY BEARING AND BE USED TO DETERMINE THE NUMBER OF SISTERS REQUIRED. BRACING LOCATIONS ARE NOT TO BE INFERRED USING THIS TABLE.
- TABLE VALUES ARE BASED ON A DEPTH OF MEMBER REMAINING, d., EQUAL TO THE DEPTH OF THE RAFTERS. IF & IS OBSERVED TO BE LESS THAN THE DEPTH OF THE RAFTER, THE VALLEY WILL NEED TO BE EITHER REPLACED OR ANALYZED BY APEX. TABLE VALUES ARE VALID FOR TAPERED CUTS ONLY, REF DETAIL 4/S3.2.
- IF MULTI-PLY VALLEY IS SPECIFIED ON PLAN TREAT EACH ADDITIONAL PLY AS A SISTER PLY WHEN LOOKING UP MAX SPAN. MAX 14'-0" HORIZONTAL RAFTER SPAN IN BOTH DIRECTIONS FROM VALLEY.
- ALL HIPS ARE DESIGNED TO BE CONTROLLED BY BENDING. SHEAR AT BEARING WITH MIN 5 1/2" DEPTH DOES NOT CONTROL DESIGN.

OR

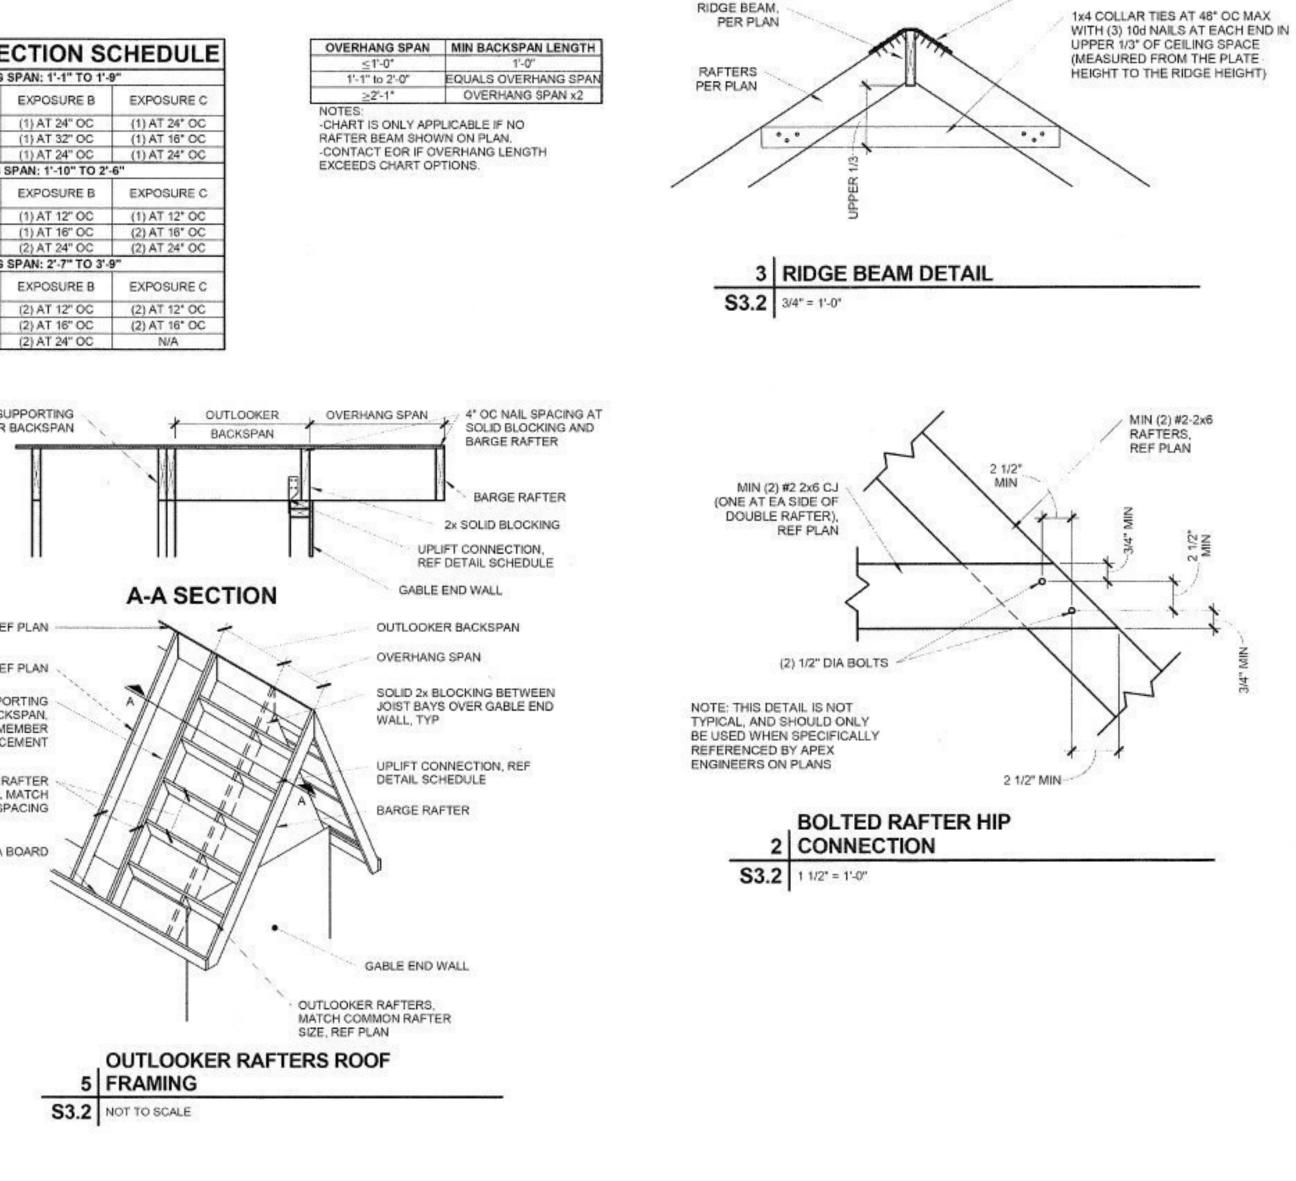



1 1/4" x 20 GAUGE RIDGE STRAPS

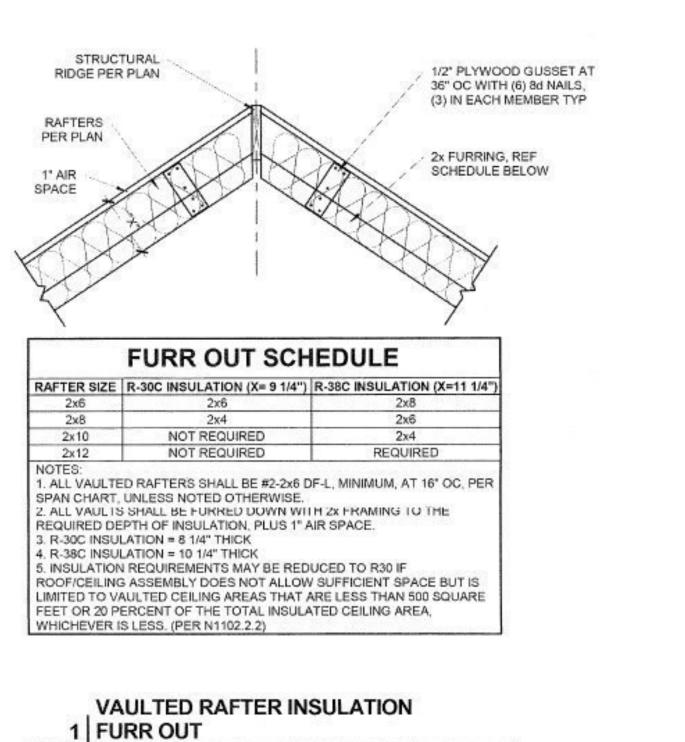

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PLAN

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9

S3.2 3/4" = 1'-0"

RELEASE FOR CONSTRUCTION AS NOTED ON PLANS REVIEW DEVELOPMENT SERVICES LEE'S SUMMIT, MISSOURI