ABBREVIATIONS AIR CONDITIONING ACOUSTICAL CEILING TILE ADJ ADJUSTABLE ABOVE FINISHED FLOOR AMP AMPERE

CAB CABINET

ARCH ARCHITECT

BOH BACK OF HOUSE

CL CENTER LINE CEILING STARBUCKS CM **CONSTRUCTION MANAGER**

CENTER CX COMMISSIONING CXA COMMISSIONING AGENT

DEG DEGREE DET DETAIL DIA DIAMETER DIM DIMENSION DM **STARBUCKS DESIGN MANAGER** DN DOWN

EΑ EACH **ELEVATION** EQ EQUAL EXIST EXISTING

EXT EXTERIOR FF&E FURNITURE, FIXTURE, AND EQUIPMENT FLR FLOOR

FOH FRONT OF HOUSE FOIC FURNISHED BY OWNER, **INSTALLED BY CONTRACTOR** FOIO FURNISHED BY OWNER **INSTALLED BY OWNER**

FT FOOT/FEET GROUND GENERAL CONTRACTOR

GWB GYPSUM WALLBOARD **HOLLOW CORE** HDW HARDWARE HOLLOW METAL

HORIZ HORIZONTAL HR HOUR HEIGHT HVAC HEATING, VENTILATING AND AIR CONDITIONING

I.D. INSIDE DIAMETER

LEED LEADERSHIP IN ENERGY AND ENVIRONMENTAL DESIGN

LANDLORD LOW VOLTAGE

MAX MAXIMUM MEP "MECHANICAL, ELECTRICAL AND PLUMBING"

NOT IN CONTRACT

MFR MANUFACTURER MINIMUM

NIGHT LIGHT NTS NOT TO SCALE OC ON CENTER

PIR PASSIVE INFRARED SENSOR PLC PLACE

RADIUS REF REFERENCE REQ'D REQUIRED

REV REVISION RND ROUND **STARBUCKS** SOLID CORE SQUARE FEET

SHT SHEET SIMILAR SPEC SPECIFICATION

SQ SQUARE TEMP TEMPORARY

VERT VERTICAL VIF VERIFY IN FIELD


UC UNDER COUNTER UNO UNLESS NOTED OTHERWISE

RESPONSIBILITY **LEGEND**

GC GENERAL CONTRACTOR LL LANDLORD

SB STARBUCKS

ARCHITECTURAL SYMBOL LEGEND

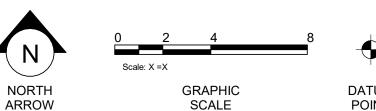

(xx)

SHEET

NOTE

CALLOUT

XXXXX

DESIGN ID

TAG

POINT

XXXX AFF


ABOVE FINISH

FLOOR

HEIGHT TAG

DOOR

TAG

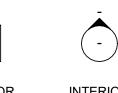

EXTERIOR INTERIOR **ELEVATION ELEVATION CALL-OUT** CALL-OUT

FINISH FACE TO FINISH FACE

REVISION CLOUD DIMENSION

DXXXXXXX (WXXXXX)

WINDOW

TAG

DETAIL

CALL-OUT

PXXX-ES

PAINT


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SECTION


CALL-OUT

REVISION

TAG

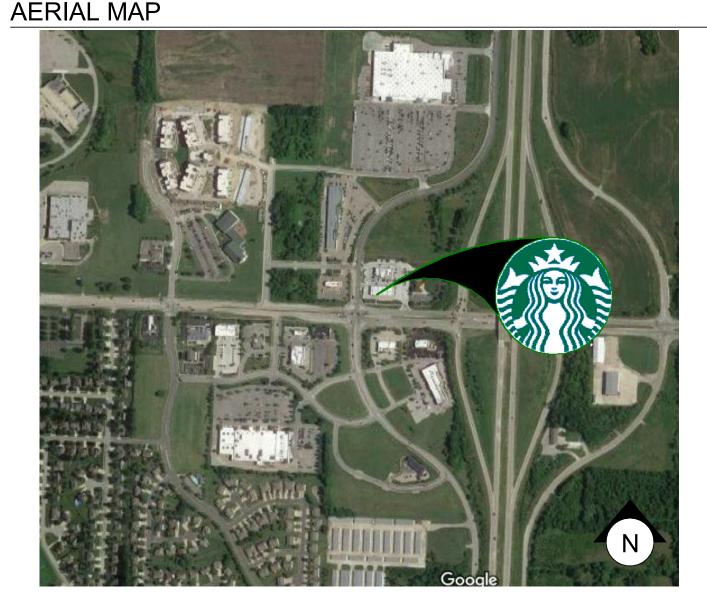

KEY SITE PLAN

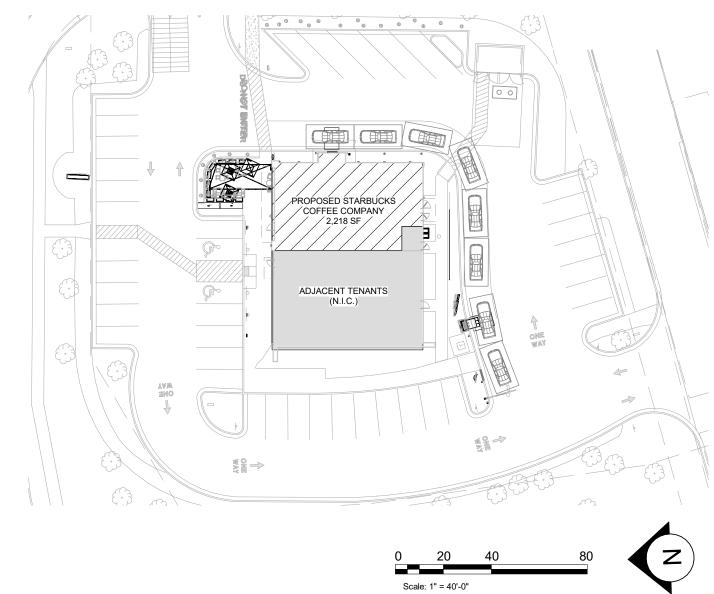

PROJECT CONTACTS

SENIOR DESIGN KATIE GORIN SLONSKI MANAGER: STARBUCKS COFFEE COMPANY 111 N CANAL ST, SUITE 450 CHICAGO, IL 60606 (312) 380-3688 PHONE KGORIN@STARBUCKS.COM

STORE DESIGNER: CHITRA PATEL STARBUCKS COFFEE COMPANY (312) 380-3731 PHONE CHPATEL@STARBUCKS.COM

CONSTRUCTION MATT ISCH MANAGER: STARBUCKS COFFEE COMPANY (214) 674-3225 PHONE MISCH@STARBUCKS.COM

> LANDLORD: NATHAN PALMER 1801 SANDY CREEK LANE, STE. 102 ORLANDO, FL 32826 (614) 586-3303 PHONE NPALMER@LEADERSRE.COM

ARCHITECT OF PETER DUBIN - NORR RECORD: 325 N. LASALLE STREET, SUITE 500 CHICAGO, IL 60654 (312) 424-2400 PHONE PIERINA.BENVENUTO@NORR.COM EDURNE.VEGA@NORR.COM

SDORN@ALKEMEYER.COM

MEP CONSULTANT WILLIAM ALKEMEYER OF RECORD: 353 MARSHALL AVENUE, SUITE 100 ST. LOUIS, MO 63119 (314) 772-1782 PHONE (314) 772-0109 FAX

STRUCTURAL ASHIF PANAKKAT CONSULTANT OF RUBIX CONSULTANTS LLC RECORD: (312) 602-5411 ASHIF@RUBIXC.COM

SCOPE OF WORK

TENANT BUILDOUT TO EXISTING BUILDING. SHELL MODIFICATIONS UNDER SEPARATE PERMIT.

GENERAL NOTES

- 1. THE DRAWINGS AND PROJECT MANUAL TOGETHER CONSTITUTE THE CONTRACT DOCUMENTS FOR CONSTRUCTION. ALL GENERAL REQUIREMENTS ARE TO BE MET AND ALL MATERIALS, FINISHES AND SYSTEMS ARE TO BE INSTALLED AND PERFORM PER SPECIFICATIONS UNLESS OTHERWISE NOTED.
- 2. GENERAL CONTRACTOR SHALL VISIT THE SITE, REVIEW THE BUILDING SHELL DRAWINGS AS SUBMITTED BY THE LANDLORD OR STARBUCKS AND BECOME THOROUGHLY FAMILIAR WITH THE SITE CONDITIONS PRIOR TO CONSTRUCTION.
- 3. GENERAL CONTRACTOR SHALL CONSULT WITH STARBUCKS CONSTRUCTION MANAGER TO RESOLVE ANY CHANGES, OMISSIONS OR PLAN DISCREPANCIES PRIOR TO CONSTRUCTION.
- 4. ALL WORK SHALL BE PERFORMED IN STRICT COMPLIANCE WITH LOCAL, COUNTY, STATE AND FEDERAL CODES AND ORDINANCES.
- 5. GENERAL CONTRACTOR SHALL VERIFY THE LOCATION OF ALL UTILITIES.
- 6. GENERAL CONTRACTOR TO VERIFY ALL DIMENSIONS, INCLUDING CLEARANCES REQUIRED BY OTHER TRADES AND NOTIFY STARBUCKS CONSTRUCTION MANAGER OF ANY DISCREPANCIES PRIOR TO PROCEEDING WITH THE WORK. ALL DIMENSIONS ARE TO THE FACE OF THE FINISHED SURFACE UNLESS NOTED OTHERWISE. ALL DIMENSIONS TO BE TAKEN FROM DESIGNATED DATUM POINT. DO NOT SCALE DRAWINGS.
- 7. GENERAL CONTRACTOR SHALL PATCH AND REPAIR ALL EXISTING WALLS, FLOORS, CEILINGS, OR OTHER SURFACES IDENTIFIED TO REMAIN THAT MAY BECOME DAMAGED DURING THE COURSE OF THE WORK.
- 8. THE GENERAL CONTRACTOR IS RESPONSIBLE FOR OBTAINING PERMITS FOR FIRE PROTECTION, PLUMBING, MECHANICAL, AND ELECTRICAL SYSTEMS PRIOR TO INSTALLATION OF SUCH SYSTEMS
- 9. GENERAL CONTRACTOR SHALL RETAIN ONE SET OF PERMIT PLANS ON-SITE TO DOCUMENT ALL CHANGES MADE DURING CONSTRUCTION. THE RECORD DRAWINGS SHALL BE ISSUED TO THE OWNER AT PROJECT CLOSE-OUT AS DESCRIBED IN THE GENERAL REQUIREMENTS OF THE PROJECT MANUAL.
- 10. GENERAL CONTRACTOR IS RESPONSIBLE FOR COORDINATING DELIVERY OF MATERIALS FROM STARBUCKS CONTRACTED THIRD PARTY LOGISTICS DISTRIBUTION SERVICES AND VENDOR DIRECT SHIPMENTS. SEE THE PROJECT MANUAL FOR ADDITIONAL INFORMATION.
- 11. RESPONSIBILITY FOR SUPPLY AND DELIVERY OF MATERIALS AND EQUIPMENT IS IDENTIFIED IN THE DRAWING SCHEDULE SHEETS UNDER THE COLUMN LABELED "RESPONSIBILITY".
- 12. FOR THE PURPOSE OF THE DOCUMENTS, TO "INSTALL", SHALL MEAN TO PROVIDE ALL FASTENERS, MISCELLANEOUS HARDWARE, BLOCKING, ELECTRICAL CONNECTIONS, PLUMBING CONNECTIONS AND OTHER ITEMS REQUIRED FOR A COMPLETE AND OPERATIONAL INSTALLATION, UNLESS OTHERWISE NOTED.

13. ALL ITEM SUBSTITUTIONS MUST BE APPROVED BY THE STARBUCKS

CONSTRUCTION MANAGER.

SITE INFORMATION							
CODE AUTHORITIES:	CITY OF LEE'S SUMMIT JACKSON COUNTY HEALTH DEPARTMEI						
BUILDING CODE:	2018 INTERNATIONAL BUILDING CODE						
PLUMBING CODE:	2018 INTERNATIONAL PLUMBING CODE						
MECHANICAL CODE:	2018 INTERNATIONAL MECHANICAL COD						
ELECTRICAL CODE:	2017 NATIONAL ELECTRICAL CODE						
FIRE CODE:	2018 INTERNATIONAL FIRE CODE						
HEALTH CODE:	2013 MISSOURI FOOD CODE						
ACCESSIBILITY CODE:	2017 ICC/ANSI A117.1						
ZONING:							

ZONE: CP2 WITH M-150 CORRIDOR DEV. OVERLAY PROPOSED USE: RETAIL SALES AND SERVICES

DEFERRED SUBMITTALS: SIGNAGE

BUILDING INFORMATION

OCCUPANCY TYPE: A2 **BUILDING AREA:** 5,000 SF 2,219 SF **TENANT AREA:** FIRE SPRINKLER: CONSTRUCTION TYPE: II-B

PRCOM20201668 BUILDING PERMIT #:

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G005	ADA DETAILS 2017			
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G007	RENDERINGS			
ARCHITE	CTURAL			
A001	ARCHITECTURAL SITE PLAN			
A002	ARCHITECTURAL SITE DETAILS			
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A102 BUILDING FLOOR PENETRATION PLAN A103 BUILDING ROOF PLAN A201 BUILDING EXTERIOR ELEVATIONS A202 BUILDING EXTERIOR ELEVATIONS A301 BUILDING SECTIONS A401 ENLARGED PLANS & ELEVATIONS A501 BUILDING DETAILS A601 SCHEDULES A602 WINDOW AND DOOR SCHEDULES & DETAILS

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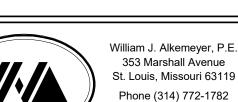
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STARBUCKS TEMPLATE VERSION i2020-01-31





Fax (314) 373-3514

Engineering Consultant

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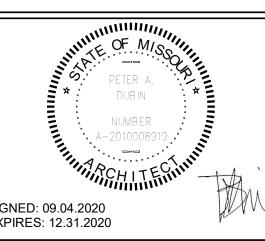
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SIGNED: 09.04.2020 EXPIRES: 12.31.2020

BUIL COFI STORE #: 63039 PROJECT #: 88084-001 ISSUE DATE: SR. DESIGN MANAGER: K. GORIN-SLONSKI PRODUCTION DESIGNER: A.MAUSER

Revision Schedule	

Description

GENERAL INFORMATION

SCALE: AS SHOWN

CHECKED BY:

SHEET NUMBER:

OUTDOOR SEATING				
DESCRIPTION	NUMBER OF ITEMS	TOTAL SEATS		
TABLE TOP, ADA	2	4		
TABLE TOP, SQUARE	6	12		
LOUNGE	2	2		
	TOTAL ACCESSIBLE SEATS	2		
	TOTAL	18		

EGRESS CALCULATION	
EXIT WIDTH REQUIRED - 70 OCC X .20	= 14 IN.
EXIT WIDTH PROVIDED	= 72 IN.
EXITS	= 36 IN. PRIMARY ENTRY, 36 IN. SECONDARY ENTRY
# EXITS REQUIRED	= 2
# EXITS PROVIDED	= 2 + 1 WORKROOM
MAXIMUM ALLOWABLE TRAVEL DISTANCE	= 200' - 0"
MAXIMUM TRAVEL DISTANCE PROVIDED	= 75' - 0"
MINIMUM EXIT SEPARATION	= 69' - 7 1/2" (MAXIMUM DIAGONAL) / 2 = 34' - 9 3/4"
EXIT SEPARATION PROVIDED	= 60' - 4 1/2"

PLUMBING FIXTURE CALCULATION

CCUPANCY	MALE	FEMALE	TOTAL	74	74 (INT. OCCUPANCY) + 18 (PATIO) = 92		
CCUPANCI	46 OCC	46 OCC	46 OCC	74	(IIVI. OCCOP)	4NC1) + 10 (P	A110) - 92
	V	VATERCLOSETS		URINALS	LAVAT	ORIES	WATER FOUNTAIN
FIXTURES	1 PE	R 75 M // 1 PER 7	5 F	N/A	1 PEF	R 200	N/A
FIXTURES	REQUIRED:	1 M	1 F	N/A	1 M	1 F	N/A
	PROVIDED:	1 M	1 F	N/A	1 M	1 F	N/A

HEALTH DEPT. PLAN NOTES

- A. GENERAL CONTRACTOR TO SCHEDULE WITH REFRIGERATION CONTRACTOR TO CONDUCT INITIAL FOOD CASE START-UP AND TESTING. FOR APPROVED CONTRACTOR, CONTACT THE VENDOR.
- B. THE SPACE IS SERVED BY THE MUNICIPAL WATER AND SEWER SYSTEM UNLESS OTHERWISE NOTED.
- C. ALL EQUIPMENT AND INSTALLATION WILL MEET NATIONAL SANITATION FOUNDATION STANDARDS OR
- D. EQUIPMENT UNITS SHALL CONTAIN NO EXPOSED THREADS, EMBELLISHMENTS OR OVERHANGING EDGES THAT SERVE AS PLACES FOR ACCUMULATION OF DUST, **DIRT AND DEBRIS**
- E. WARMING OVEN(S) SHOWN FOR PERMITTING PURPOSES. INSTALLATION AT STORE OPENING TO BE VERIFIED BY STARBUCKS CONSTRUCTION REPRESENTATIVE.
- F. EACH HAND WASHING WILL HAVE A SINGLE SERVICE TOWEL AND SOAP DISPENSER AND ALL HAND SINKS TO HAVE A COMBINATION FAUCET OR PREMIXING FAUCET.
- G. REFERENCE INTERIOR SCHEDULE SHEETS (1600 SERIES) FOR ADDITIONAL INFORMATION.
- H. PROVIDE SNEEZE GUARDS WHERE REQUIRED BY JURISDICTION.
- ALL FOOD STORAGE AND DISPLAY SHELVING SHALL BE A MINIMUM 6" (150MM) ABOVE FINISH FLOOR.

LEGEND

OCCUPANCY

42 OCC

9 OCC

3 OCC

2 OCC

180CC

74 OCC

CAFE: 630 SF / 15

BAR: 436 SF / 200

TOTAL OCC LOAD:

STANDING: 45 SF / 5

WORKROOM: 400 SF/ 300

LINEAR SEATING: 260 IN / 18

←X'-X" (XXMM) → TRAVEL DISTANCE

BARRIER FREE PATH OF TRAVEL

EMERGENCY LIGHT EXIT SIGN

FIRE EXTINGUISHER

30" X 52" CLEAR AREA

ADA ACCESSIBLE SEATING

KEYED NOTES

- 1. THRESHOLDS TO BE BARRIER FREE COMPLIANT PER ALL APPLICABLE CODES.
- 2. BARRIER-FREE PATH OF TRAVEL.
- 3. 30" X 52" CLEAR FOR WHEELCHAIR ACCESS.
- 4. 67" DIAMETER MINIMUM TURN RADIUS FOR WHEELCHAIR ACCESS.
- 5. 32" MINIMUM CLEAR AT RESTROOM DOOR.
- 6. POS TRANSACTION PLANE, CONDIMENT CART TOP AND HAND-OFF PLANE ARE 34 INCHES ABOVE THE FINISHED FLOOR FOR WHEELCHAIR ACCESSIBILITY.
- 7. PROVIDE BARRIER-FREE SIGNAGE AT ACCESSIBLE RESTROOMS PER ALL APPLICABLE CODES.
- PROVIDE TACTILE "EXIT" SIGNAGE.
- 9. PROVIDE INTERNATIONAL SYMBOL OF ACCESSIBILITY SIGN WHERE REQUIRED BY APPLICABLE LAWS OR CODES.

HEALTH DEPT. FINISH SCHEDULE

FLOOR:

WALL:

POLYVINYL FLOORING WALL TILE, BACKSPLASH, FRP, WITH COVED

POLYVINYL BASE CEILING: GYPSUM CEILING

WOOD CLADDING, PAINTED VINYL WALL COVERING,

PAINTED GYP., COVED TILE BASE CEILING: ACOUSTIC CEILING TILES, GYP. SOFFIT

POLYVINYL FLOORING FRP WITH COVED SCHLUTER POLYVINYL BASE CEILING: ACOUSTICAL CEILING TILE

WALL: TILE WITH COVED SCHLUTER BASE CEILING: PAINTED GYP.

MEANS OF EGRESS NOTES

- A. EVERY ROOM OR SPACE THAT IS ASSEMBLY OCCUPANCY SHALL HAVE THE OCCUPANT LOAD OF THE ROOM OR SPACE POSTED IN A CONSPICUOUS PLACE, NEAR THE MAIN EXIT ACCESS DOORWAY. POSTED SIGNS SHALL BE OF AN APPROVED LEGIBLE PERMANENT DESIGN AND SHALL BE MAINTAINED BY THE OWNER AUTHORIZED AGENT. (1004.3)
- B. EGRESS SHALL NOT PASS THROUGH KITCHENS, STORAGE ROOMS, CLOSETS OR SIMILAR SPACES. (1014.2)
- C. PANIC AND FIRE EXIT HARDWARE, WHERE INSTALLED ON DOORS IN THIS BUILDING SHALL SATISFY THE FOLLOWING (1008.1.10):
- 1) THE ACTUATION PORTION OF THE RELEASING DEVICE SHALL EXTEND AT LEAST ONE-HALF OF THE DOOR LEAF WIDTH.
- 2) THE MAXIMUM UNLATCHING FORCE DOES NOT EXCEED 15 POUNDS (6.8 KG).
- 3) PIVOTED OR BALANCED DOORS SHALL BE OF THE PUSH-PAD TYPE WHERE PANIC HARDWARE IS REQUIRED AND THE PAD SHALL NOT EXTEND ACROSS MORE THAN ONE-HALF OF THE DOOR WIDTH, MEASURED FROM THE LATCH SIDE.
- 4) PANIC HARDWARE LISTED IN ACCORDANCE WITH UL 305.
- 5) FIRE EXIT HARDWARE LISTED IN ACCORDANCE WITH UL 10C AND UL 305.
- D. STRUCTURAL ELEMENTS, FIXTURES OR FURNISHINGS SHALL NOT PROJECT HORIZONTALLY FROM EITHER SIDE MORE THAN 4 INCHES (100 MM) OVER ANY WALKING SURFACE BETWEEN 27 INCHES (685 MM) AND 80 INCHES (2030 MM) ABOVE THE WALKING
- EXCEPTION: HANDRAILS SERVING STAIRS AND RAMPS ARE PERMITTED TO PROTRUDE 4 1/2 INCHES (115 MM) FROM THE WALL. (1003.3.3)
- E. THE PATH OF EGRESS TRAVEL EXITS AND WITHIN EXITS IN THIS BUILDING SHALL BE IDENTIFIED BY EXIT SIGNS CONFORMING TO THE REQUIREMENTS OF SECTION 1011 AND
- 1) EXIT SIGNS SHALL BE READILY VISIBLE FROM ANY DIRECTION OF EGRESS TRAVEL.
- 2) EXIT SIGNS SHALL BE LOCATED AS NECESSARY TO CLEARLY INDICATE THE DIRECTION OF EGRESS TRAVEL.

3) NO POINT IN A CORRIDOR SHALL BE MORE THAN 100 FT (30.5 M) OR THE LISTED VIEWING DISTANCE FOR THE SIGN. WHICHEVER IS LESS, FROM THE NEAREST VISIBLE EXIT SIGN.

- WHERE KEY OPERATED LOCKING DEVICES ARE USED, POST A SIGN ON OR ADJACENT TO THE REQUIRED MAIN EXIT DOOR WITH 1 INCH (25 MM) LETTERING STATING THAT "THIS DOOR TO REMAIN UNLOCKED WHEN BUILDING IS OCCUPIED". (1008.1.9.3)
- G. EGRESS DOORS OR GATES SHALL BE OPENABLE FROM THE EGRESS SIDE WITHOUT THE USE OF A KEY, SPECIAL KNOWLEDGE OR EFFORT. DOOR HANDLES, PULLS, LATCHES, LOCKS AND OTHER OPERATING DEVICES SHALL BE INSTALLED 34 INCHES (860 MM) TO 48 INCHES (1220 MM) ABOVE FINISHED FLOOR. MANUALLY OPERATED FLUSH BOLTS OR SURFACE BOLTS ARE NOT PERMITTED. THE UNLATCHING OF ANY DOOR OR LEAF SHALL NOT REQUIRE MORE THAN ONE OPERATION. (1008.1.9)
- H. LANDINGS SHALL BE PROVIDED ON EACH SIDE OF DOORS AND SUCH LANDING SHALL BE AT THE SAME ELEVATION ON EACH SIDE OF THE DOOR LANDINGS SHALL HAVE A WIDTH NOT LESS THAN THE WIDTH OF THE DOOR AND LENGTH MEASURED IN THE DIRECTION OF TRAVEL OF NOT LESS THAN 44 INCHES (11120 MM). (1008.1.5, 1008.1.6)



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STARBUCKS TEMPLATE VERSION i2020-01-31





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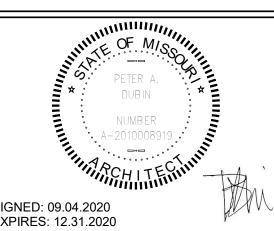
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BID/P

353 Marshall Avenue St. Louis, Missouri 63119 Phone (314) 772-1782 Fax (314) 373-3514

Engineering Consultant



SIGNED: 09.04.2020 EXPIRES: 12.31.2020


BUIL COF STORE #: 63039


PROJECT #: ISSUE DATE: SR. DESIGN MANAGER: K. GORIN-SLONSK PRODUCTION DESIGNER: A.MAUSER CHECKED BY:

Revision Schedule

SHEET TITLE: LIFE SAFETY ACCESSIBILITY PLAN SCALE: AS SHOWN

SHEET NUMBER:

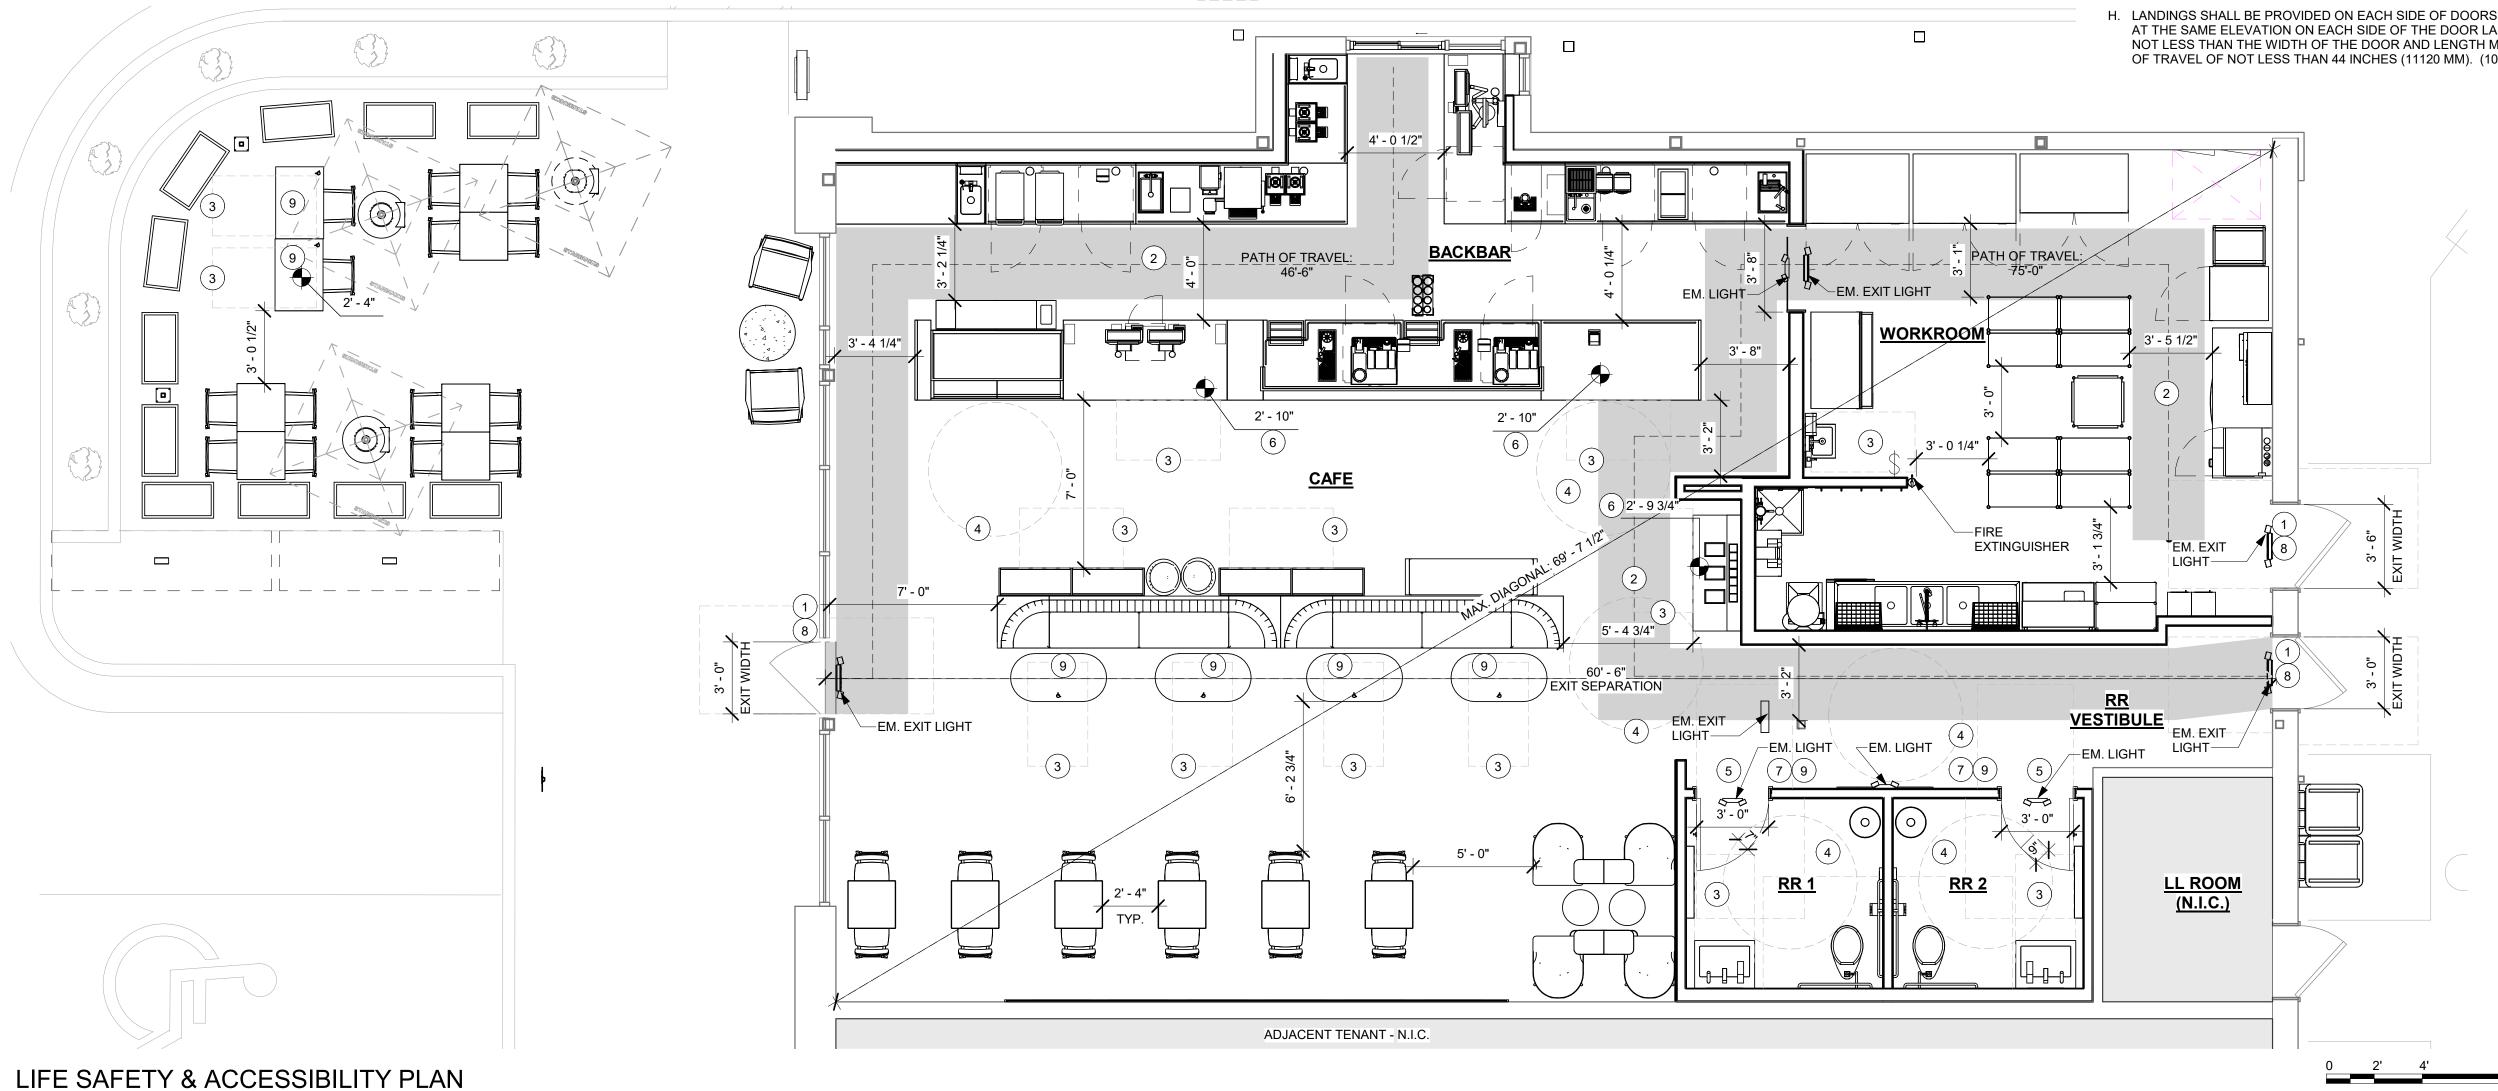

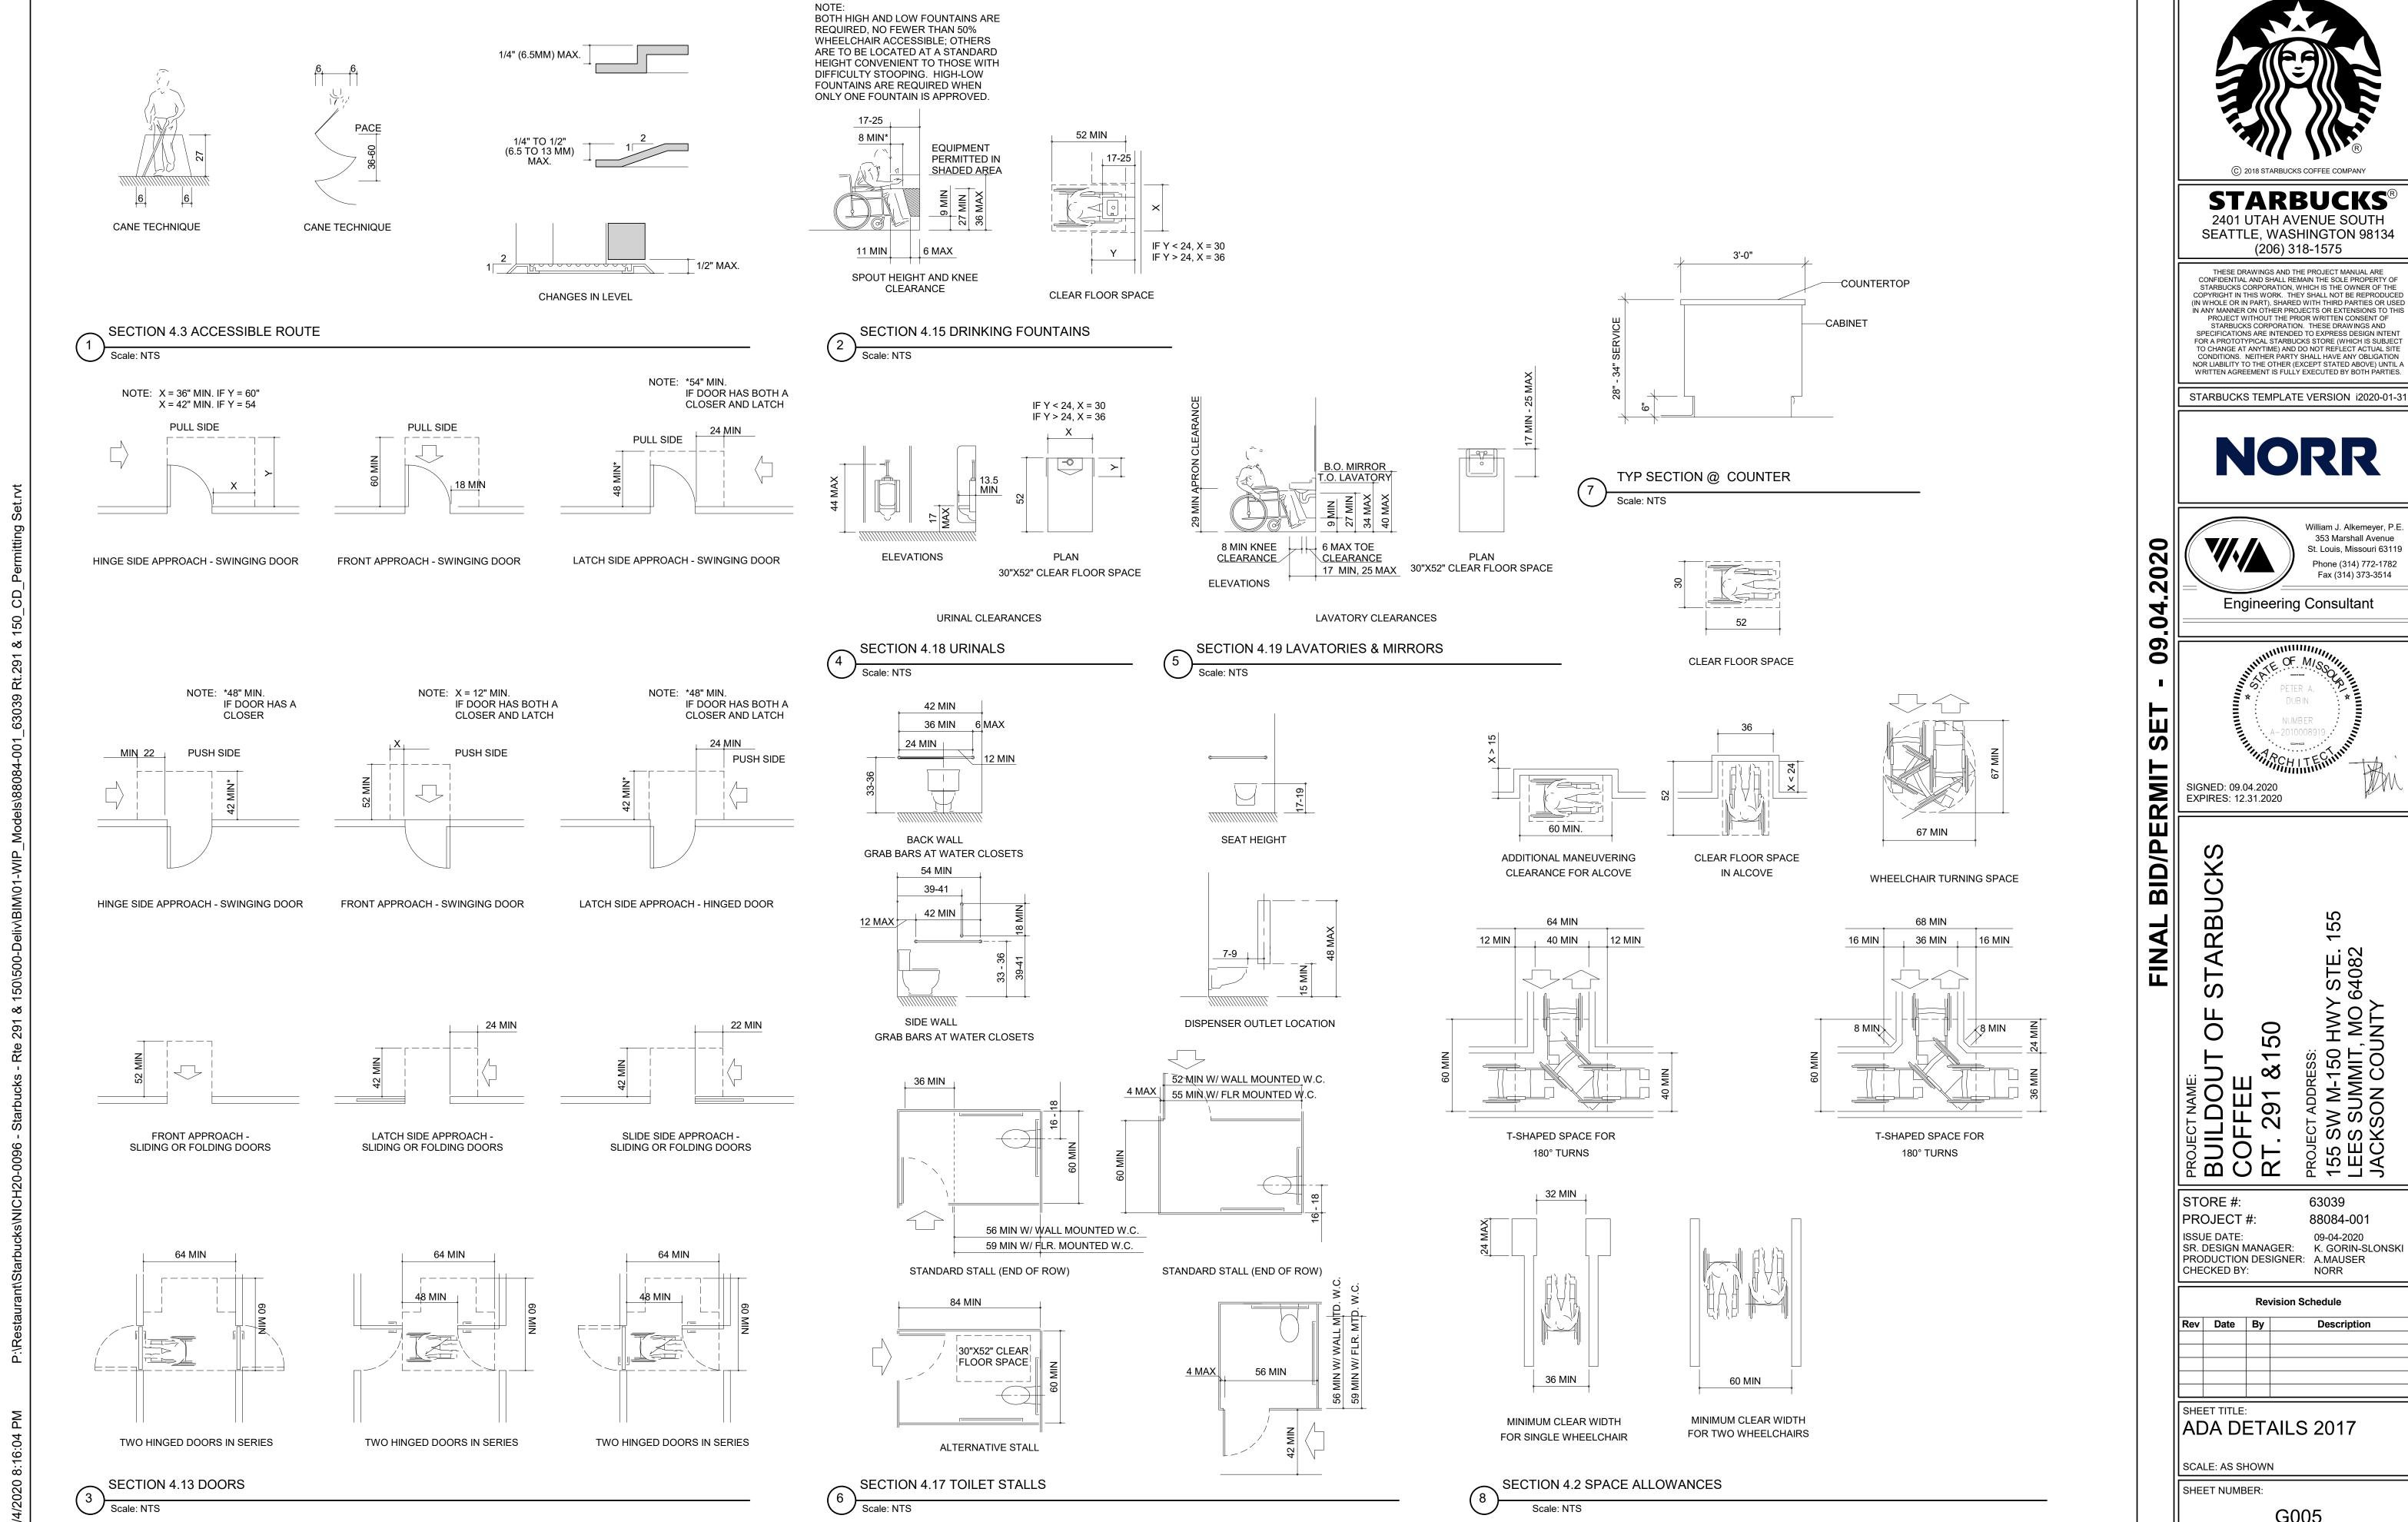



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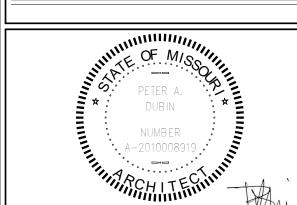
STARBUCKS TEMPLATE VERSION i2020-01-31





William J. Alkemeyer, P.E. 353 Marshall Avenue St. Louis, Missouri 63119 Phone (314) 772-1782 Fax (314) 373-3514

Engineering Consultant



/ STE. 64082

63039 88084-001 09-04-2020

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Description

CAFE VIEW FROM POS

CAFE VIEW FROM ENTRY



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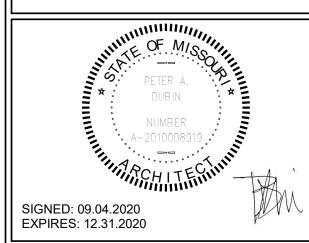
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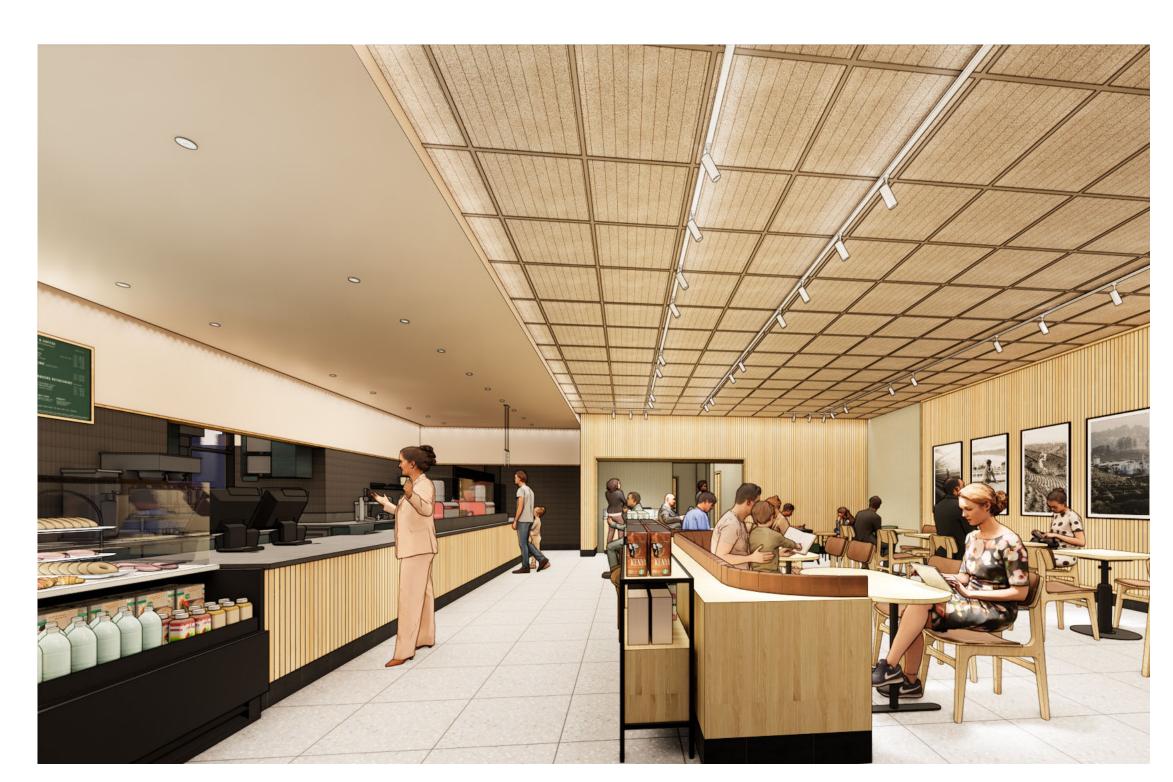


BUILDO COFFEE RT. 291 STORE #: PROJECT #: ISSUE DATE: 09-04-2020
SR. DESIGN MANAGER: K. GORIN-SLONSKI
PRODUCTION DESIGNER: A.MAUSER
CHECKED BY: NORR

Revision Schedule

||3D VIEWS SCALE: AS SHOWN

SHEET NUMBER:



VIEW FROM ENTRY



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VIEW FROM FRONTBAR



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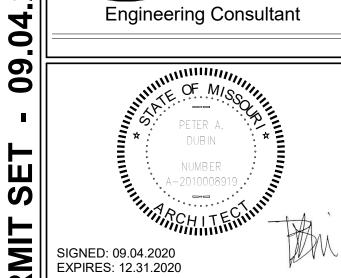
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Engineering Consultant



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STORE #: PROJECT #:

ISSUE DATE: 09-04-2020
SR. DESIGN MANAGER: K. GORIN-SLONSKI
PRODUCTION DESIGNER: A.MAUSER
CHECKED BY: NORR

RENDERINGS

SCALE: AS SHOWN

SHEET NUMBER:

		EXTERIOR SIGNAGE	SCHEDULI	E - "S"	
DESIGN ID	COUNT	DESCRIPTION	FURN. BY	INST. BY	COMMENTS
SIGNAGE - I	DISK			•	
13182	1	SIGN - DISK SF ILLUMINATED FLUSH MOUNTED EVOLVED - 71IN 1805MM	SB	GC/ HILTON	LL TO PROVIDE BLOCKING AND CONDUIT AS REQUIRED
13184	1	SIGN - DISK SF ILLUMINATED FLUSH MOUNTED EVOLVED - 60IN 1525MM	SB	GC/ HILTON	LL TO PROVIDE BLOCKING AND CONDUIT AS REQUIRED
SIGNAGE - I	DRIVE THR	Ú		•	
14091	1	SIGN - DT DIRECTIONAL EXIT SIGN ILLUMINATED ARROW SERIES - 46IN 1170MM	SB	GC	GC TO COORDINATE WITH SBUX VENDOR. LL TO PROVIDE, FOOTING, ANCHOR BOLT AND CONDUIT
14106	1	SIGN - DT CLEARANCE BAR ARROW SERIES FREESTANDING	SB	GC	GC TO COORDINATE WITH SBUX VENDOR. LL TO PROVIDE, FOOTING AND ANCHOR BOLT
SIGNAGE -	OTHER		1	1	
19388	3	SIGN - 10 MINUTE PARKING	SB/LL	GC	FOOTING AND POST BY LL, SIGN BY VENDOR (TUBE ART). GC TO INSTALL.
SIGNAGE - F	PYLON DIS	K	•		
X0044	1	MONUMENT SIGN	SB	GC/ LL	LL TO PROVIDE BASE SIGN, FOOTING, ANCHOR BOLTS AND CONDUITS. SIGN PANELS BY SBUX VENDOR
SIGNAGE - \	NORDMAR	K			
X18498	1	SIGN - WORDMARK STARBUCKS FLUSH MOUNTED - 20IN 510MM	SB	GC/ HILTON	WORDMARK COLOR GREEN: LL TO PROVIDE CONDUIT AND BLOCKING AS REQUIRED

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DESIGN ID	COUNT	DESCRIPTION	FURN. BY	INST. BY	COMMENTS
EXTERIOR N	IENU				
14116	1	MENU BOARD - DT DIGITAL ORDER SCREEN - FLAT BLACK MT0028	SB	SB/GC	SUPPLIER: IT EQUIPMENT VENDOR (ZONES) SCREEN INSTALLER: REGIONAL SIGNAGE VENDOR. ELECTRICAL: GC CONNECTS DOS WHIPS & STUB-UPS TO DCB.
14119	1	MENU BOARD - DT 5 PANEL FREESTANDING - 108X65IN 2745X1650MM - FLAT BLACK MT0028	SB	SB/GC	SUPPLIER: DT SIGNAGE VENDOR (DSA). INSTALLER: REGIONAL SIGNAGE VENDOR. LL TO PROVIDE FOOTING, CONDUIT AND ANCHOR BOLTS
14120	1	MENU BOARD - DT PRE MENU FREESTANDING - 36X65IN 915X1650MM - FLAT BLACK MT0028	SB	SB/GC	SUPPLIER: DT SIGNAGE VENDOR (DSA). INSTALLER: REGIONAL SIGNAGE VENDOR. LL TO PROVIDE FOOTING, CONDUIT AND ANCHOR BOLTS
15700	1	MENU BOARD - DT DIGITAL ORDER SCREEN CONTROL BOX	SB	SB/GC	SUPPLIER: IT EQUIPMENT VENDOR (ZONES INSTALLER: REGIONAL SIGNAGE VENDOR. ELECTRICAL CONNECTION: GC. LL TO PROVIDE FOOTING, CONDUIT AND ANCHOR BOLTS
OTHER					
14103	7	BOLLARD NONILLUMINATED SQUARE - FLAT BLACK MT0028	LL	LL	DSA PHOTOTECH. SEE DTL.
14163	1	DT ORDER POINT CANOPY FREESTANDING - FLAT BLACK MT0028	SB	SB/GC	SUPPLIER: DT SIGNAGE VENDOR (DSA). INSTALLER: REGIONAL SIGNAGE VENDOR. LL TO PROVIDE FOOTING, CONDUIT AND ANCHOR BOLTS
18818	2	LIGHT POLE - 10FT 300CM - FLAT BLACK MT0028	SB	GC	GC TO PROVIDE AIRLINE CABLE AND HOOKS AS NEEDED FOR LIGHT INSTALLATION.
18820	2	LIGHT POLE BASE PLATE - FLAT BLACK MT0028	SB	GC	
X0007	2	VEHICLE DETECTOR LOOP	SB	GC	SUPPLIER: DT AUDIO VENDOR (HME). INSTALLER: GC. LL TO PROVIDE CONDUIT
X0014	2	BIKE RACK - OLYMPIA	LL	LL	FORMS & SURFACES: OLYMPIA BIKE RACK. WWW.FORMS-SURFACES.COM; INSTALL PER MANUFACTURER'S RECOMMENDATIONS.FINISH: STANDARD BLACK TEXTURE.
PLANTER					
X0004	11	CONCRETE PLANTER BOX	LL	LL	CONCRETE PLANTERS WITH IRRIGATION BY LANDLORD. LL TO PROVIDE SPEC TO CM FOR APPROVAL.LL TO PROVIDE LANDSCAPING.COORDINATE WITH OPERATIONS PRIOR TO INSTALLATION.
UMBRELLA					
12147	3	UMBRELLA - BASE 95LB 43KG - FLAT BLACK MT0028	SB	GC	
20073	3	UMBRELLA - WITHOUT VALANCE - 6FT 183CM - GREEN CANVAS WITH WORDMARK F0056	SB	GC	

SITE SCHEDULE - "Y"

GENERAL NOTES

- A. REFER TO EXTERIOR ELEVATIONS ON SHEET A201 FOR BUILDING SIGNAGE LOCATION AND DESIGN ID. REFER TO ELECTRICAL PLANS FOR ELECTRICAL REQUIREMENTS.
- B. LANDSCAPING TO BE PROVIDED PER ZONING CODE AND SUSTAINABILITY REQUIREMENTS.
- C. DRIVE-THRU EQUIPMENT INCLUDING VEHICLE DETECTION LOOP, WIRELESS COMMUNICATION AND MONITORS SHALL BE COORDINATED BY STARBUCKS CONSTRUCTION MANAGER. REFER TO ELECTRICAL DRAWINGS FOR ADDITIONAL REQUIREMENTS.
- D. PROVIDE 6" (150MM) THICK CONCRETE PAVING THE LENGTH OF THE DRIVE-THRU LANE, EXTENT TO INCLUDE DRIVE-THRU ENTRY POINT THROUGH WINDOW STANDING PAD.
- E. GENERAL CONTRACTOR TO APPLY CONCRETE SEALER TO ALL EXTERIOR CONCRETE PATIO AND WALKWAY SURFACES.
- F. GENERAL CONTRACTOR TO VERIFY ALL EXISTING ELEVATIONS AND BUILDING CONDITIONS IN FIELD PRIOR TO START OF CONSTRUCTION.
- G. PROVIDE DETECTABLE WARNING (IF APPLCABLE PER LOCAL CODE) AT TRANSITION FROM SIDEWALK TO DRIVE AISLE.
- H. ACCESSIBLE PARKING SPACES AND ACCESS AISLES SHALL HAVE SURFACE SLOPE NOT TO EXCEED 2% IN ALL DIRECTIONS.
- REFER TO ELECTRICAL DRAWINGS FOR SITE RELATED ELECTRICAL WORK.
- J. SCRAPE AND REPAINT ALL EXISTING PAINTED SITE FEATURES, INCLUDING, BUT NOT LIMITED TO CURBS BOLLARDS, RAILINGS AND SITE LIGHTING BASES.
- K. SEE SHEET A002 FOR ARCHITECTURAL SITE

LEGEND

CONCRETE PAD BY LL

±±±±± LANDSCAPE AREA

KEYED NOTES

- 1. DRIVE-THRU WINDOW AND AIR CURTAIN BY LL.
- 2. LANDSCAPE BUFFER AREA AT PATIO BY LL.
- 3. PROPERTY LINE.
- 4. PROVIDE PROTECTIVE BOLLARDS ON BOTH SIDES OF EXTERIOR UTILITY SERVICES ADJACENT TO VEHICULAR TRAFFIC. EXAMPLES INCLUDE FIRE STAND PIPE, GAS AND ELECTRICAL METERS, SITE TRANSFORMERS, ETC.
- 5. WALL MOUNTED FANS. LL TO PROVIDE POWER IN WALL
- 6. PROVIDE COVERED EXTERIOR ELECTRICAL OUTLETS PER LANDLORD WORK LETTER. SEE EXTERIOR ELEVATIONS FOR MORE INFORMATION.
- 7. INTEROR ROOF ACCESS BY LL. IN LL ROOM.
- 8. 5-PANEL MENU BOARD. LL TO PROVIDE AND INSTALL CONDUIT, FOOTING, AND ANCHOR BOLTS PER LLWL.
- 9. DIGITAL ORDER SCREEN AND CANOPY. REFER TO DOS CONTROL BOX DETAILS FOR MORE INFO. LL TO PROVIDE AND INSTALL CONDUIT, FOOTING, AND ANCHOR BOLTS PER
- 10. PRE-MENU BOARD. LL TO PROVIDE AND INSTALL CONDUIT, FOOTING AND ANCHOR BOLTS PER LLWL.
- 11. FREESTANDING CLEARANCE BAR, LL TO PROVIDE AND INSTALL FOOTING AND ANCHOR BOLTS PER LLWL.
- 12. LL TO PROVIDE PEDESTRIAN CROSSWALK STRIPING, INC. CURB CUTS.
- 13. LL PROVIDED 'DO NOT ENTER' PAVEMENT MARKING.
- 14. LL TO PROVIDE AND INSTALL 5IN SQUARE, NON ILLUMINATED BOLLARDS AS INDICATED PER LLWL. REFER TO SITE DETAILS FOR MORE INFORMATION.
- 15. ADA PARKING, STRIPING, CURB CUTS AND SIGNAGE BY LL
- 16. BUILDING ENTRANCE BY LL.
- 17. 42" REAR EXIT DOOR BY LL.
- 18. INSTALL VEHICLE DETECTOR LOOP @ CENTERLINE FOR ORDER POINT & DRIVE THRU WINDOW. REFER TO SITE DETAILS FOR MORE INFORMATION. LL TO PROVIDE
- 19. BIKE RACK PROVIDED BY LL PER STARBUCKS SPECIFICATIONS.
- 20. TRASH ENCLOSURE BY LL. TRASH SPACE SHALL BE 12'D X 20'W X 7'H.
- 21. ILLUMINATED DRIVE THRU 'EXIT ONLY/ THANK YOU' SIGN. LL TO PROVIDE AND INSTALL CONDUIT, FOOTING AND ANCHOR BOLT CONNECTIONS.
- 22. "MOBILE ORDER PAY PARKING ONLY" SIGN POST AND FOOTING BY LL, SIGN BY SIGNAGE VENDOR.
- 23. MONUMENT SIGN BY LL. SBUX TO PROVIDE PANEL FACES ONLY. BASE SIGN, FOOTING, ANCHOR BOLTS, AND CONDUIT TO BE PROVIDED BY LL.
- 24. DRIVE-THRU LANE TO BE 1'-0" AWAY FROM BUMPOUT PER LL CRITERIA PACKAGE.
- 25. EMPLOYEE PATH AND CURB CUTS TO TRASH ENCLOSURE BY LL PER LLWL.
- 26. INDICATES BUILDING CANOPY ABOVE. TO BE PROVIDED BY
- 27. REAR SCREENING FOR OUTSIDE TRASH BINS BY LL.
- 28. STARBUCKS SIGNAGE VENDOR TO COORDINATE APPROVALS AND PERMITS FOR EXTERIOR SIGNAGE SEPARATELY AS REQUIRED. NOT INCLUDED IN TENANT **BUILDOUT APPLICATION.**
- 29. LL TO PROVIDE KEYED, FROST-FREE RECESSED HOSE BIB PER LLWL. SEE EXTERIOR ELEVATIONS FOR MORE INFORMATION.
- 30. SCHIER GB-75 GREASE INTERCEPTOR BY LL.
- 31. PATIO SEATING AREA BY LL. LL TO PROVIDE IRRIGATED PLANTERS, NATIVE PLANTS, AND LANDSCAPED AREA AS INDICATED. ELECTRICAL FOR FANS/ STRING LIGHTS TO BE PROVIDED BY LL PER LLWL.
- 32. LL TO PROVIDE 6" THICK CONCRETE SURFACE THROUGHOUT LOT AND DRIVE-THRU LANE PER LLWL.

NOTE: SITE PLAN PREPARED IN REFERENCE TO THE LANDLORD CIVIL PLAN DATED: 07/23/20.

NOTE: ALL SIGNAGE UNDER SEPARATE PERMIT, SHOWN FOR COORDINATION PURPOSES ONLY.







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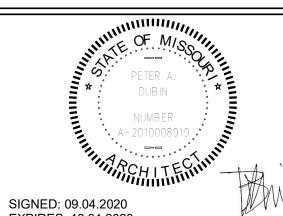
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EXPIRES: 12.31.2020

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09-04-2020 SR. DESIGN MANAGER: K. GORIN-SLONSKI PRODUCTION DESIGNER: A.MAUSER CHECKED BY: NORR

Revision Schedule

Description

ARCHITECTURAL SITE PLAN

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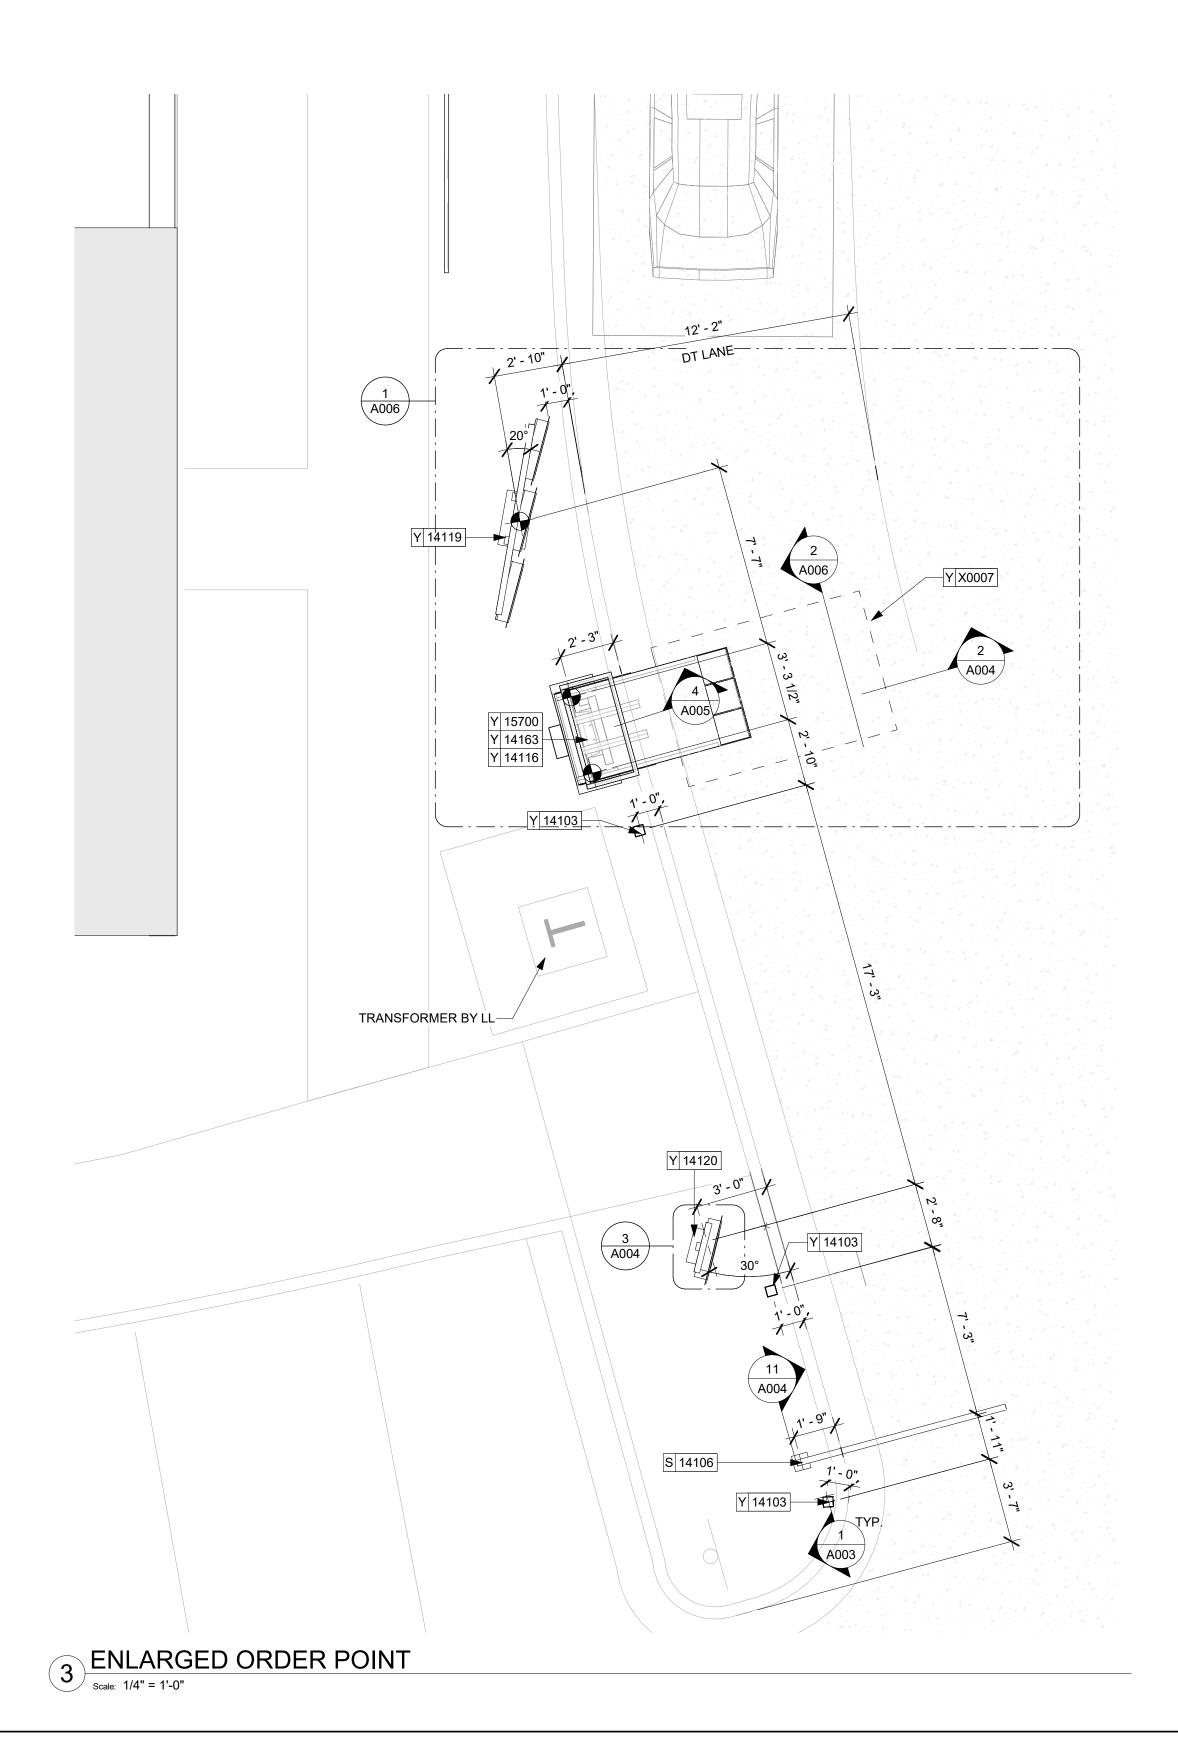
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ADJACENT TENANT

ARCHITECTURAL SITE PLAN - FOR REFERENCE ONLY

ENLARGED PICKUP WINDOW

-INDICATES PLANTER BOXES. LL TO LANDSCAPE BUFFER PROVIDE DRAINAGE, IRRIGATION BEHIND CONCRETE SYSTEM, AND NATIVE PLANTS PER LLWL REQUIREMENTS. LL TO PROVIDE PATIO OUTLET AS SHOWN -LL TO PROVIDE HOSE BIBB M X0042 (11) Y X0004 Y 20073 (3) Y 12147 (3) —LL TO PROVIDE POWER FOR TENANT-PROVIDED FAN A 10017 (2) Y 18820 -INDICATES STRING LIGHTS BY SBUX. LL TO PROVIDE POWER AT POLES AS INDICATES CANOPY-ABOVE L 17796 LENGTH: 85'-4" 12' - 3" 16' - 11"




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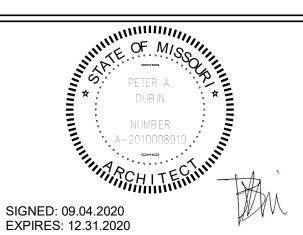
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BUILDO COFFEE RT. 291

STORE #: 63039 PROJECT #: 88084-001 ISSUE DATE: 09-04-2020 SR. DESIGN MANAGER: K. GORIN-SLONSKI PRODUCTION DESIGNER: A.MAUSER CHECKED BY:

ARCHITECTURAL SITE DETAILS SCALE: AS SHOWN


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NOTE: ALL STANDARD FOOTING DETAILS SHOWN FOR REFERENCE ONLY, UNDER LL SCOPE OF WORK. LL TO PROVIDE ENGINEERED DRAWINGS AS NEEDED.

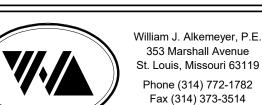

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STORE #: 63039 PROJECT #: 88084-001


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Revision Schedule

ARCHITECTURAL SITE DETAILS SCALE: AS SHOWN

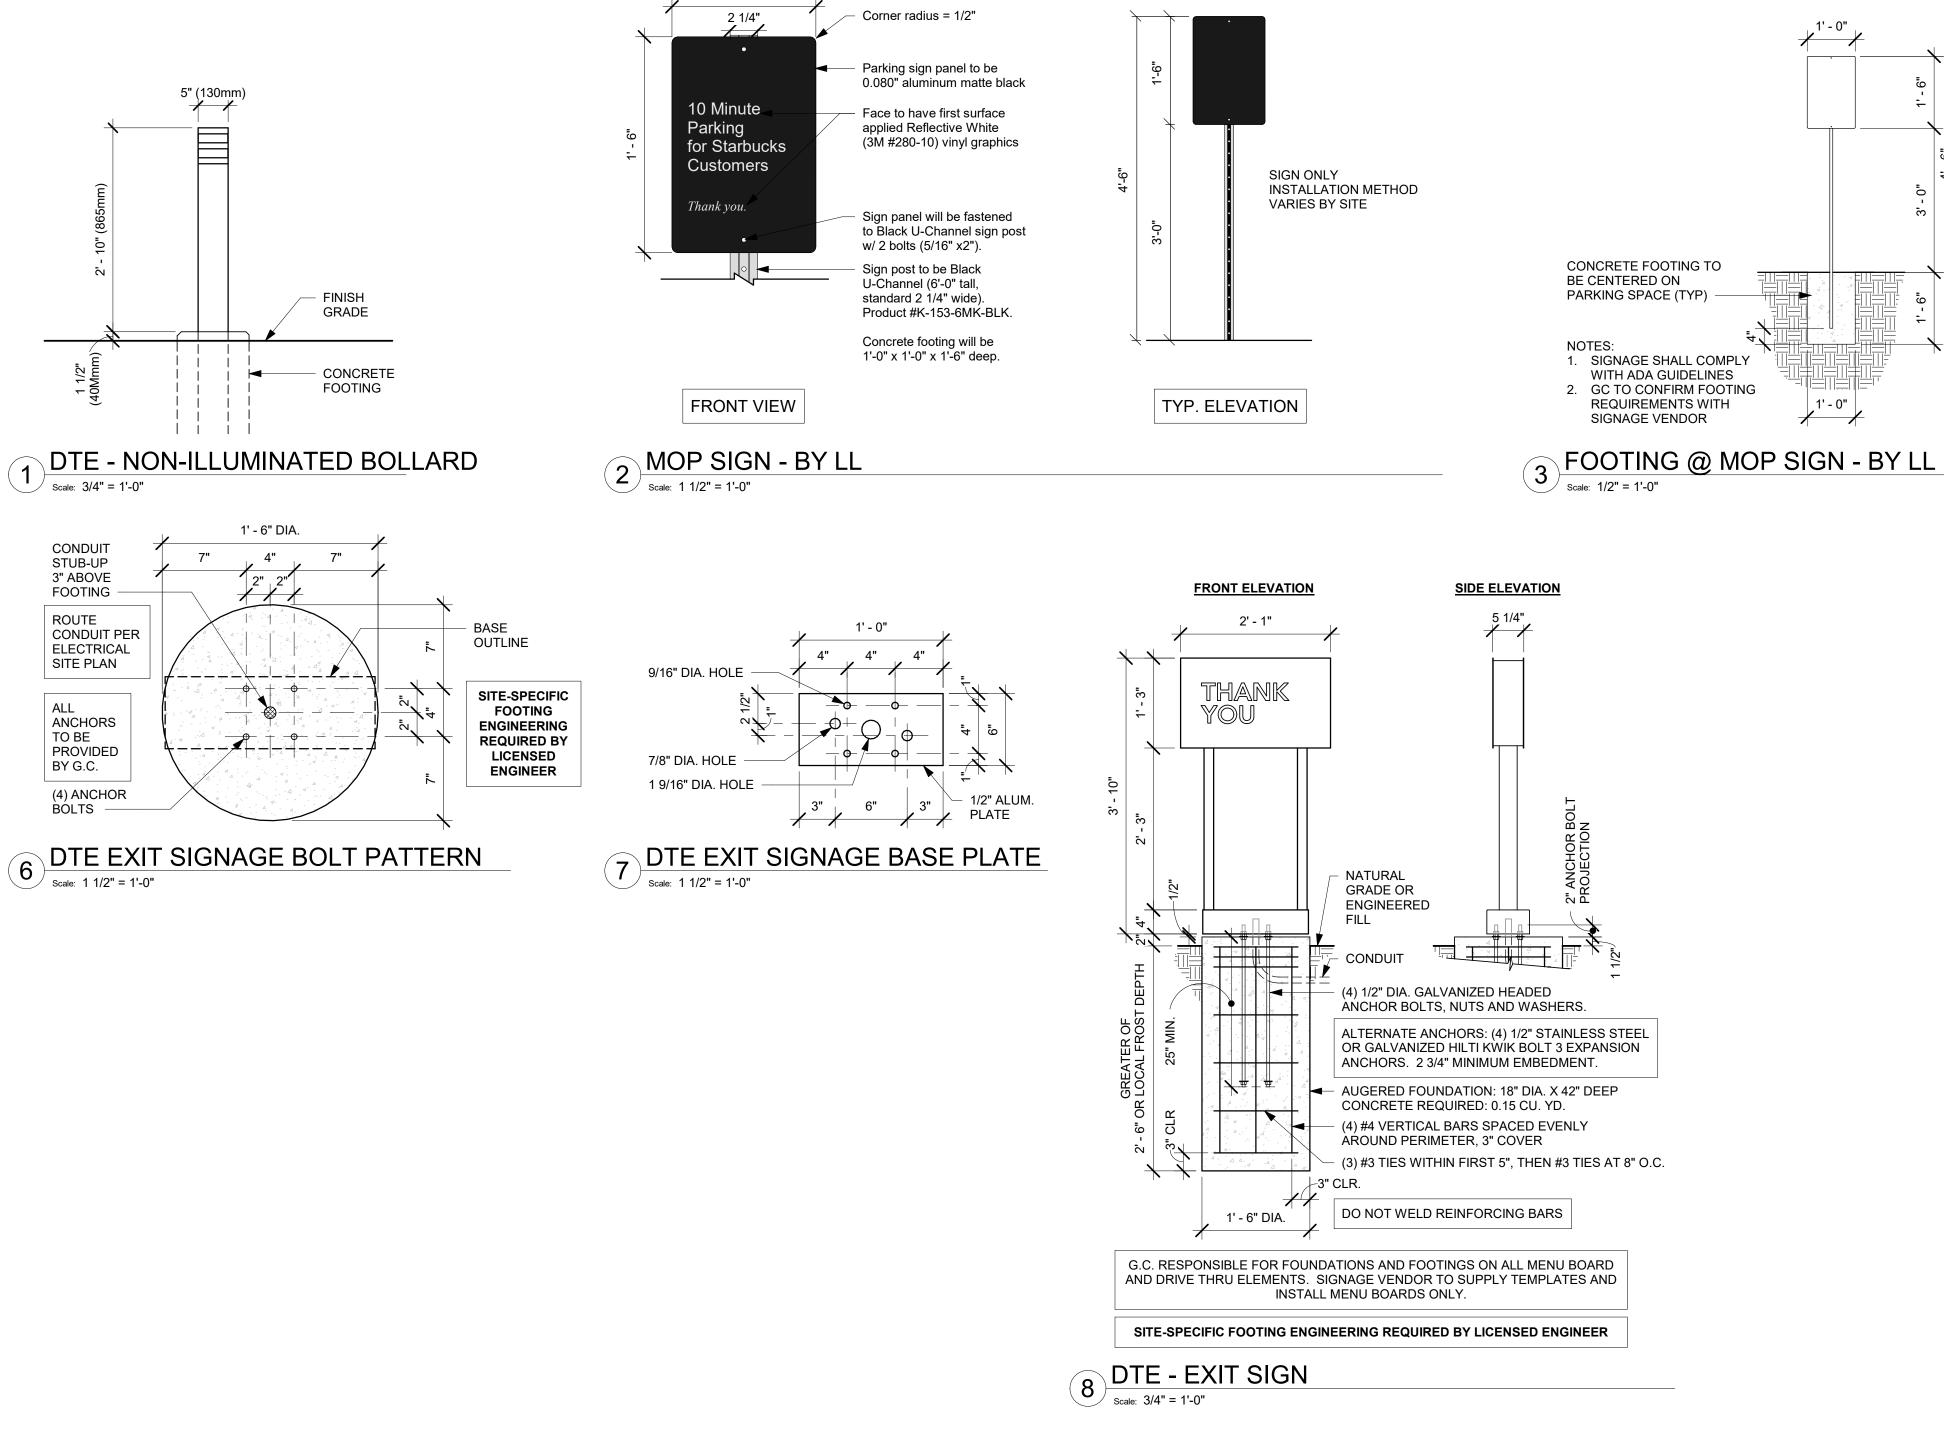SHEET NUMBER:

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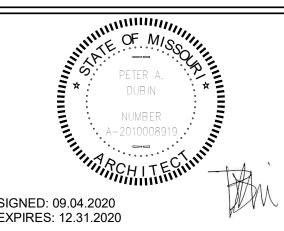
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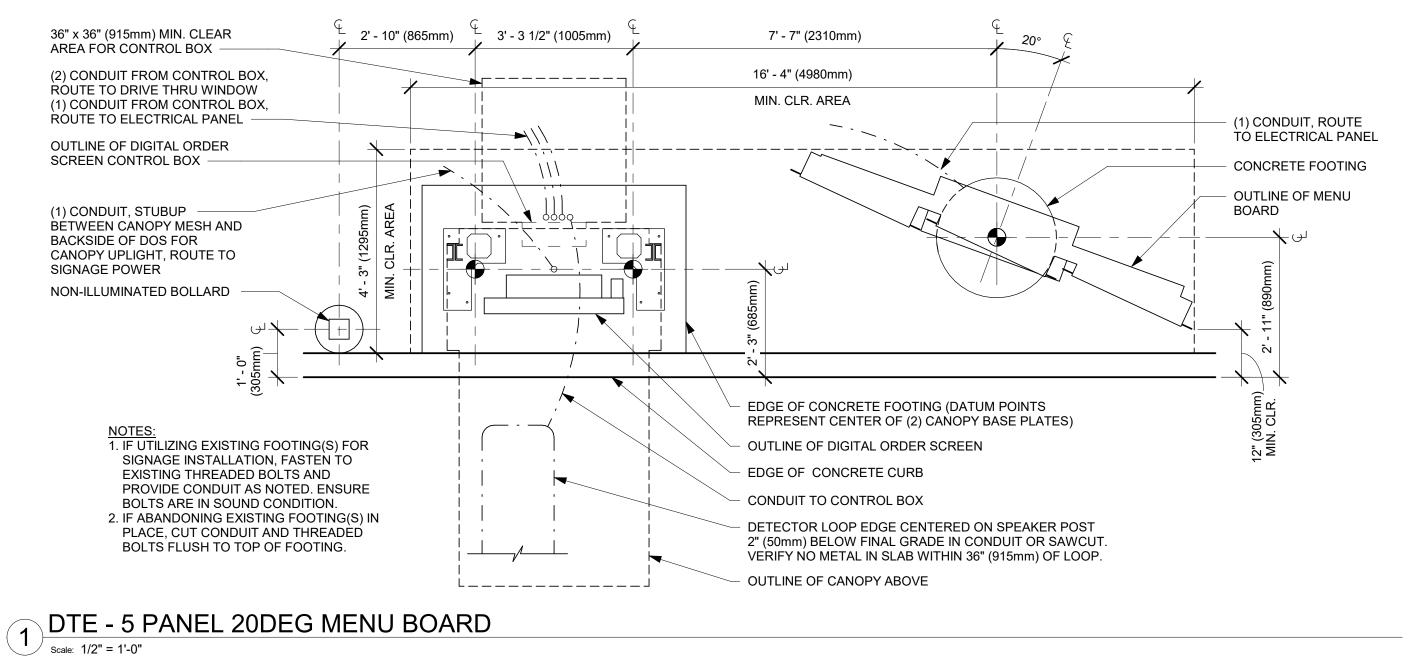
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Revision Schedule

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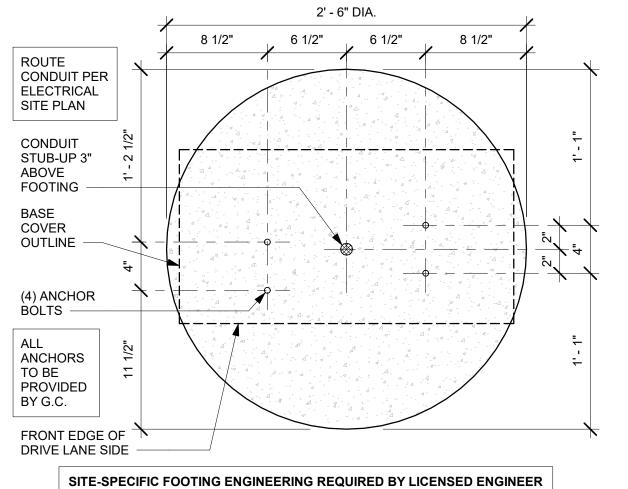
NOTE: ALL SIGNAGE UNDER SEPARATE PERMIT, SHOWN FOR COORDINATION **PURPOSES ONLY**

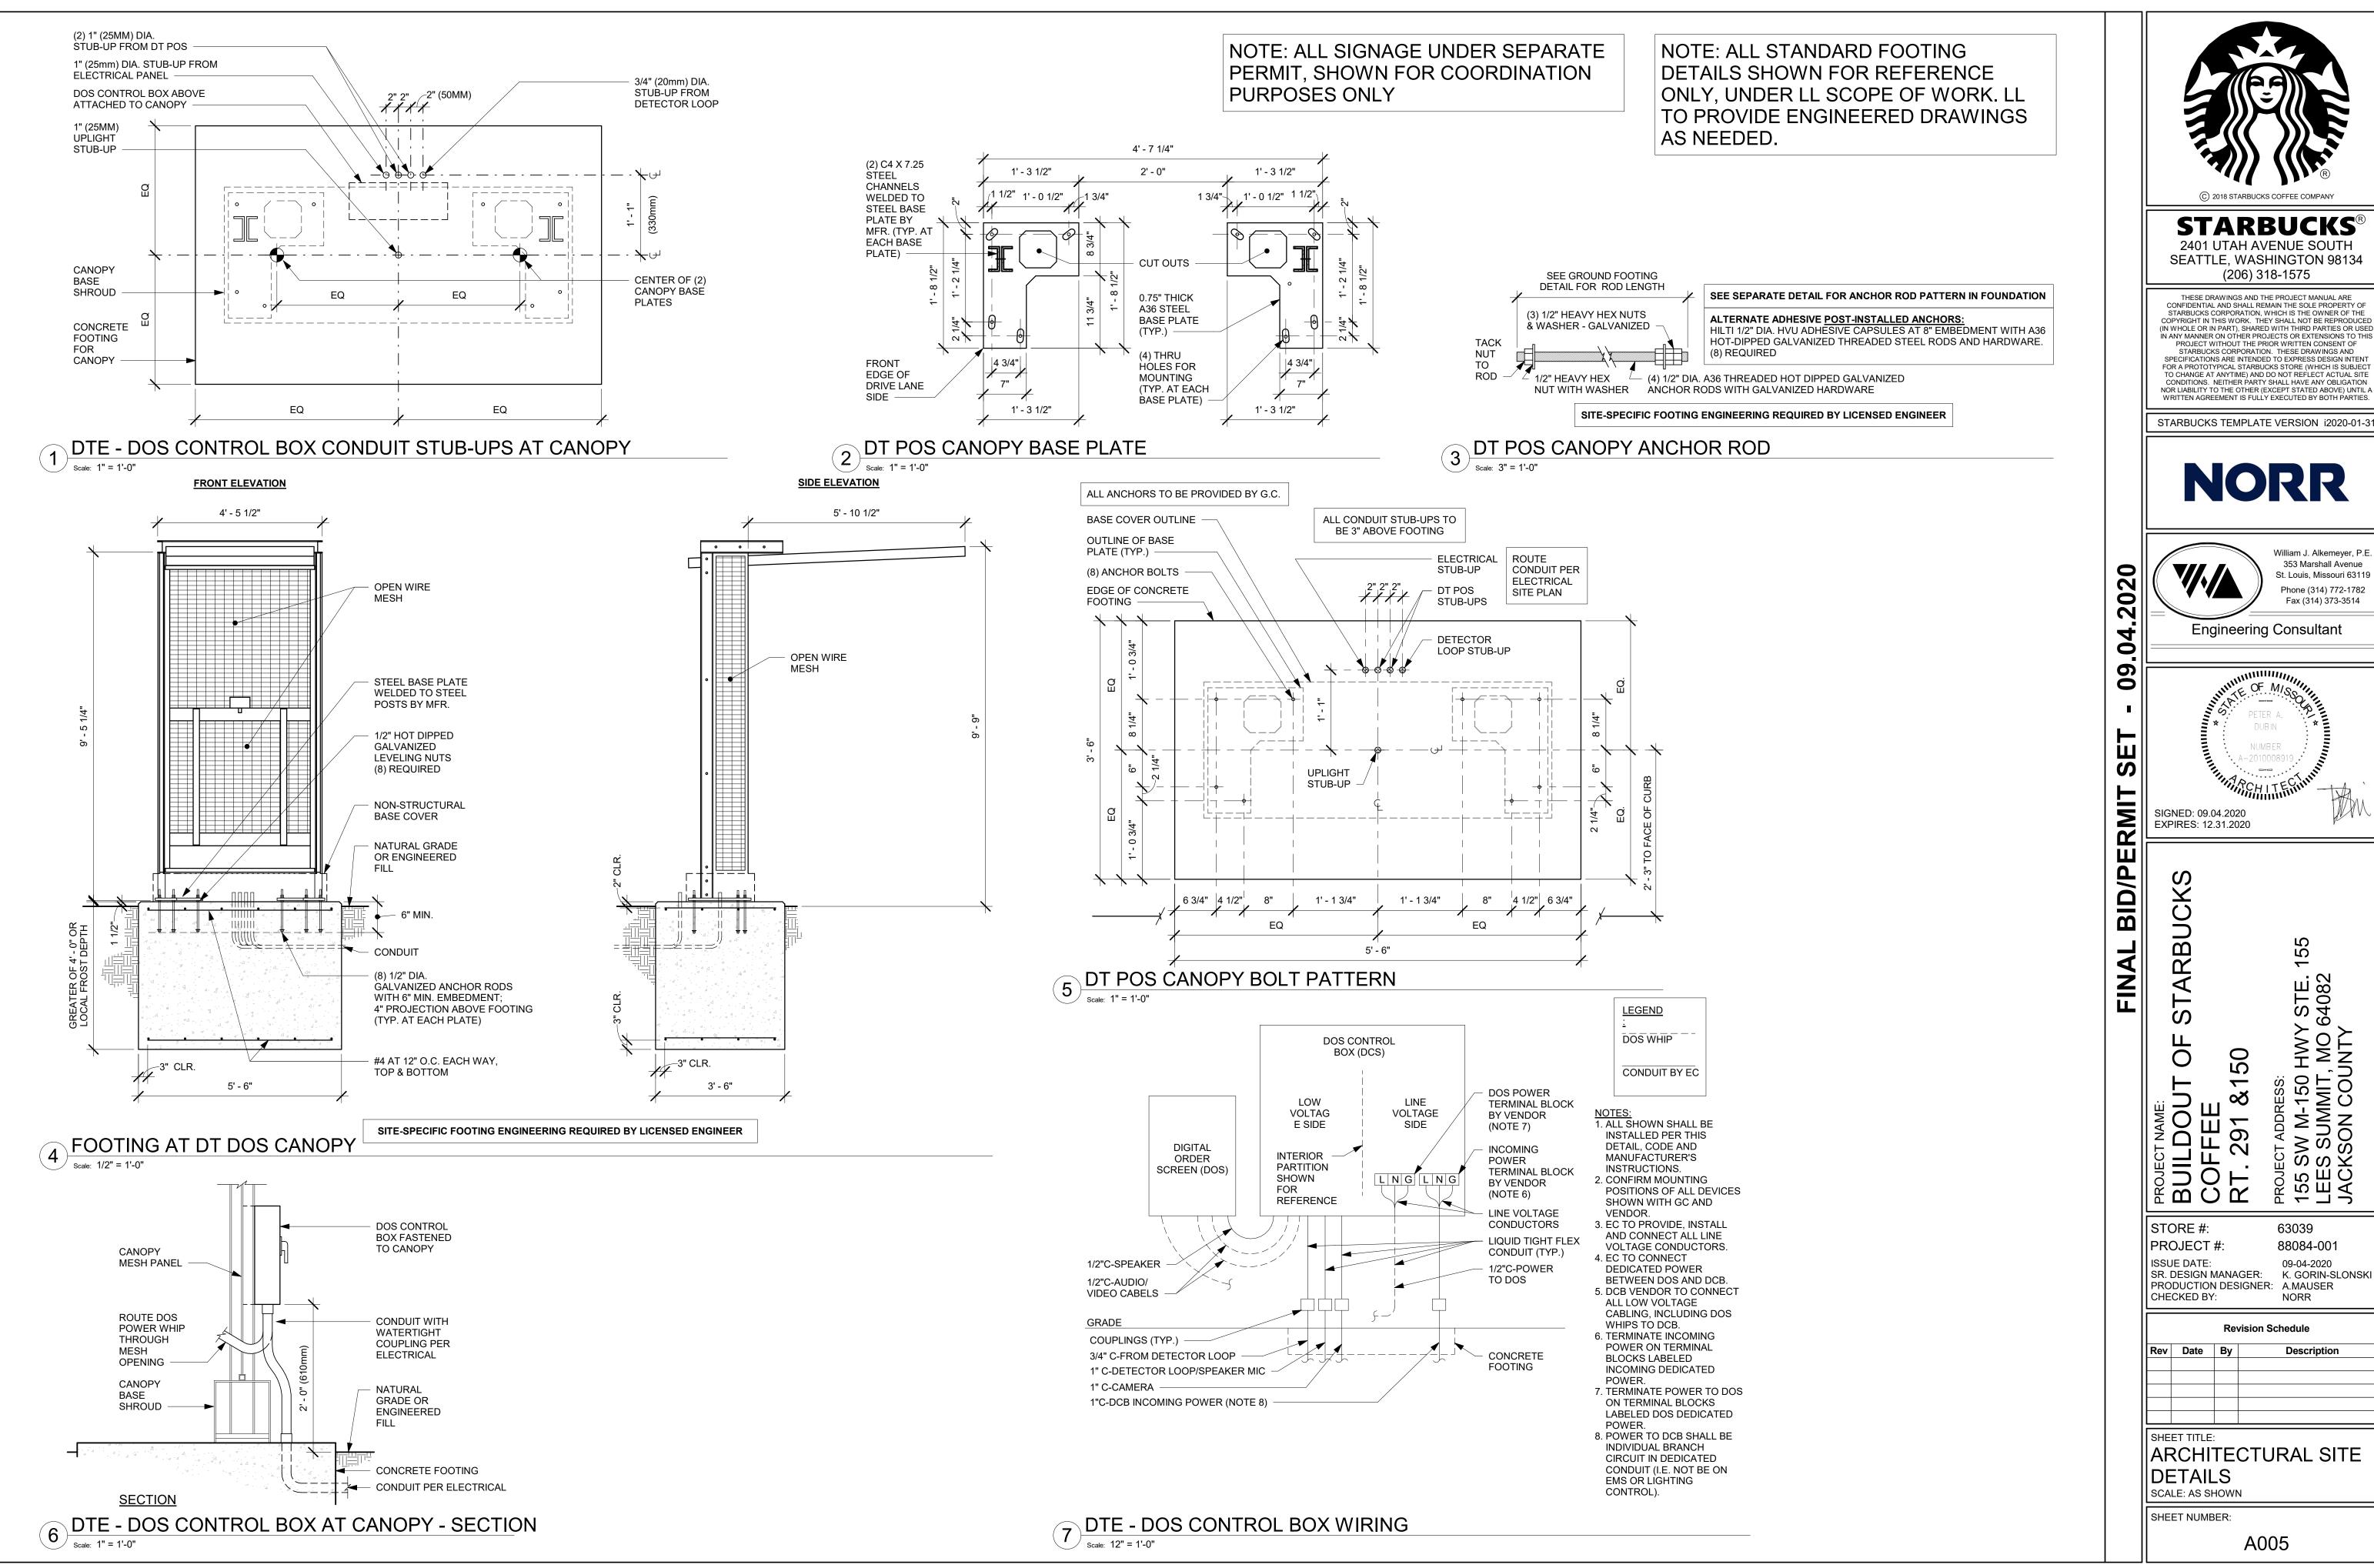NOTE: ALL STANDARD FOOTING DETAILS SHOWN FOR REFERENCE ONLY, UNDER LL SCOPE OF WORK. LL TO PROVIDE ENGINEERED DRAWINGS AS NEEDED.




FRONT ELEVATION SIDE ELEVATION 9' - 0" STEEL MOUNTING BASE PLATE WELDED TO STEEL CHANNELS HOT DIPPED GALVANIZED LEVELING NUTS (4) REQUIRED NON-STRUCTURAL BASE COVER NATURAL GRADE OR **ENGINEERED FILL** CONDUIT (4) 1/2" DIA. X 14" LONG GALVANIZED ANCHOR BOLTS; 4" PROJECTION ABOVE **FOOTING** (3) #3 TIES WITHIN FIRST 5" THEN #3 TIES AT 12" O.C. (8) #6 VERTICAL BAR 2' - 6" SPACED EVENLY 2' - 6" AROUND PERIMETER







5 Soulo: 1 1/2" = 11 0"

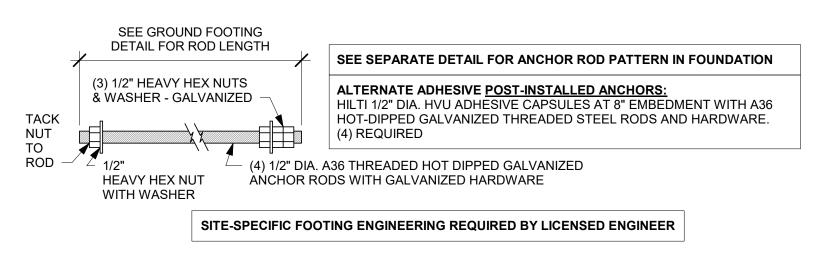

5- PANEL MENU ANCHOR ROD

Scale: 1/2" = 1'-0"

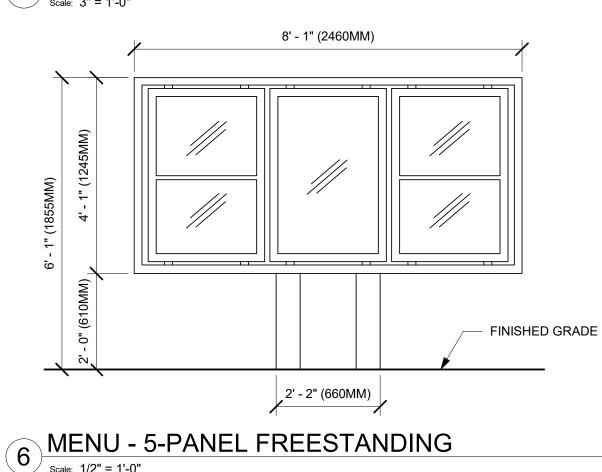

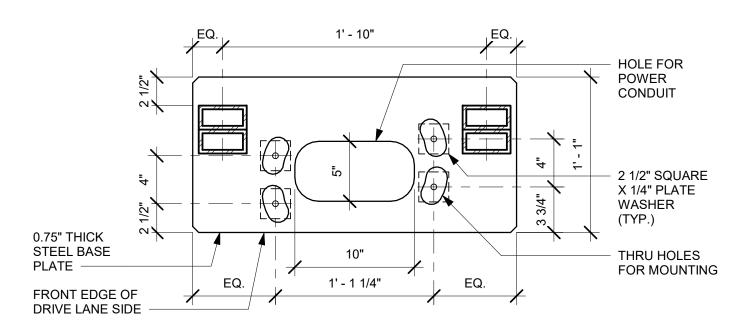

4 5 - PANEL MENU BASE PLATE



G.C. RESPONSIBLE FOR FOUNDATIONS AND FOOTINGS ON ALL MENU BOARD AND DRIVE THRU ELEMENTS. SIGNAGE VENDOR TO SUPPLY TEMPLATES AND INSTALL MENU BOARDS ONLY. SITE-SPECIFIC FOOTING ENGINEERING REQUIRED BY LICENSED ENGINEER 2 5 - PANEL MENU - GROUND FOOTING

Scale: 3/8" = 1'-0"

S Ш BID/P FINAL

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NORR

William J. Alkemeyer, P.E 353 Marshall Avenue St. Louis, Missouri 63119 Phone (314) 772-1782 Fax (314) 373-3514 **Engineering Consultant**

SIGNED: 09.04.2020 EXPIRES: 12.31.2020

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BUIL COFI

STORE #: 63039 PROJECT #: 88084-001 ISSUE DATE: SR. DESIGN MANAGER: K. GORIN-SLONSKI PRODUCTION DESIGNER: A.MAUSER

Revision Schedule

NORR

ARCHITECTURAL SITE DETAILS

SHEET NUMBER:

SCALE: AS SHOWN

CHECKED BY:

A006

1' - 6" (460mm)

<u>PLAN</u>

ELEVATION

10'-1" (3075mm) MAX. CLR.


BOLLARD

3 DTE - DRIVE THRU WINDOW BUMP-OUT
| Scale: 1/4" = 1'-0"



NOTE: ALL SIGNAGE UNDER SEPARATE PERMIT, SHOWN FOR COORDINATION PURPOSES ONLY

NOTE: ALL STANDARD FOOTING DETAILS SHOWN FOR REFERENCE ONLY, UNDER LL SCOPE OF WORK. LL TO PROVIDE ENGINEERED DRAWINGS AS NEEDED.

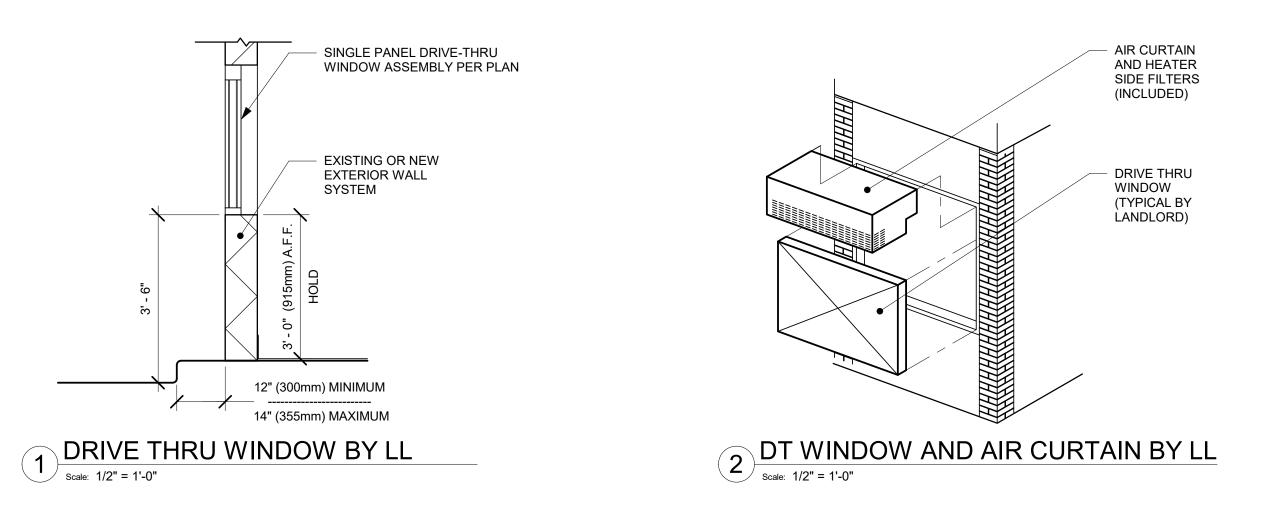

CONCRETE INFILL AT

CONCRETE CURB WINDOW PER PLAN

SIDE WINDOW PER PLAN

DETECTOR LOOP EDGE

CENTERED ON SPEAKER POST 2" (50mm) BELOW FINAL GRADE IN CONDUIT OR SAWCUT. ROUTE (1)

CONDUIT TO DRIVE THRU POS AND TERMINATE NEAR TIMER SIGNAL PROCESSOR (TSP). VERIFY NO METAL IN SLAB WITHIN 36" (915mm)

WINDOW PER PLAN

INTERIOR FINISH

EXTERIOR FINISH


BOLLARD

OF LOOP.


BOLLARD

GRADE

GRADE

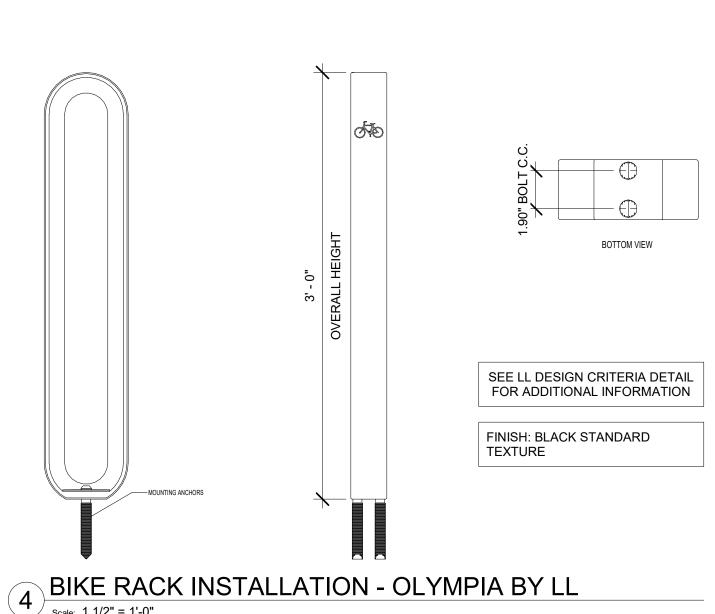

SIGNAGE VENDOR TO CONFIRM WITH SBUX DESIGNER FINAL DESIGN.

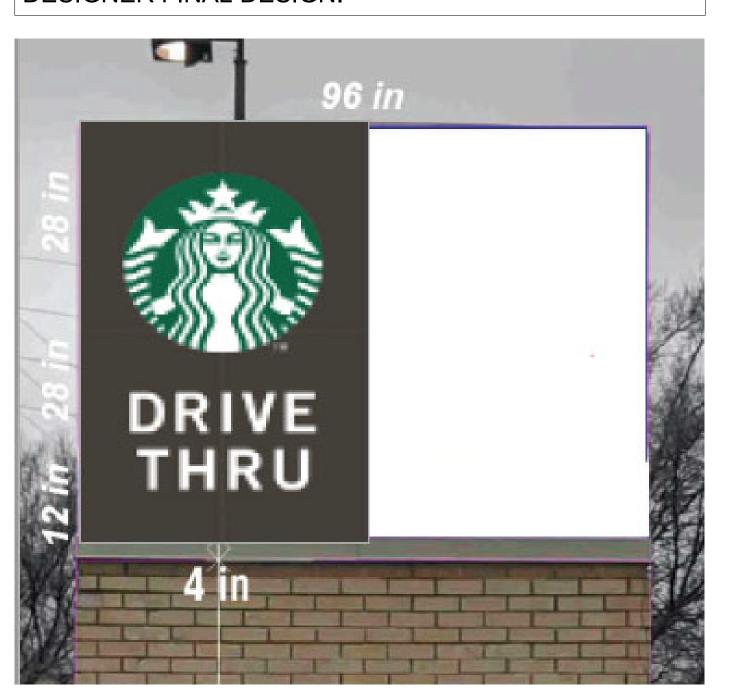

5 X0005 - MONUMENT SIGN Scale: NOT TO SCALE



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STARBUCKS TEMPLATE VERSION i2020-01-31



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FINAL

Engineering Consultant



/ STE. 64082

PROJECT NAME:
BUILDOUT
COFFEE
RT. 291 &

STORE #: 63039 PROJECT #: 88084-001 ISSUE DATE: SR. DESIGN MANAGER: K. GORIN-SLONSKI PRODUCTION DESIGNER: A.MAUSER

Revision Schedule


ARCHITECTURAL SITE

CHECKED BY:

DETAILS SCALE: AS SHOWN

SHEET NUMBER:

A007

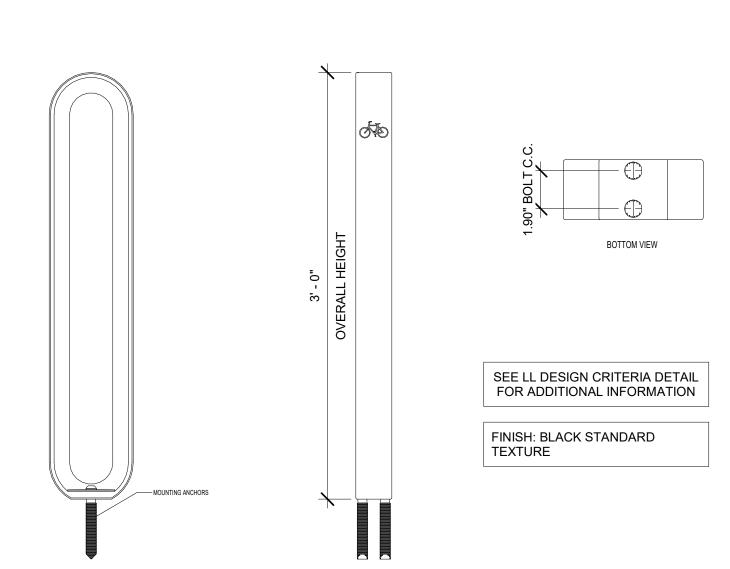

	II	NTERIOR NEW	WALL SCHEDULE
TAG	DESCRIPTION	INSULATION	NOTES
2-P-N	3 5/8" 20 GA STUD FURRING WALL	NONE	PARTIAL HT. WALL. SEE PLAN FOR WALL SHEATHING. 3'-0" AFF
2-T-N	3 5/8" 20 GA STUD FURRING WALL	NONE	TERMINATE 6" ABOVE CEILING. PROVIDE 45 DEGREE METAL STUD BRACING AT 48" O.C. FROM STUD WALL TO STRUCTURE ABOVE. SEE PLAN FOR WALL SHEATHING.
3-T-A	3 5/8" 20 GA STUDS @ 16" O.C.	ACOUSTIC	TERMINATE 6" ABOVE CEILING. PROVIDE 45 DEGREE METAL STUD BRACING AT 48" O.C. FROM STUD WALL TO STRUCTURE ABOVE. SEE PLAN FOR WALL SHEATHING.
3-T-N	3 5/8" 20 GA STUDS @ 16" O.C.	NONE	TERMINATE 6" ABOVE CEILING. PROVIDE 45 DEGREE METAL STUD BRACING AT 48" O.C. FROM STUD WALL TO STRUCTURE ABOVE. SEE PLAN FOR WALL SHEATHING.
4-T-N	6" 20 GA STUDS @ 16" O.C.	NONE	TERMINATE 6" ABOVE CEILING. PROVIDE 45 DEGREE METAL STUD BRACING AT 48" O.C. FROM STUD WALL TO STRUCTURE ABOVE. SEE PLAN FOR WALL SHEATHING.
5-T-N	6" 20 GA STUD FURRING WALL	NONE	TERMINATE 6" ABOVE CEILING. PROVIDE 45 DEGREE METAL STUD BRACING AT 48" O.C. FROM STUD WALL TO STRUCTURE ABOVE. SEE PLAN FOR WALL SHEATHING.

WALL BLOCKING KEY

	BLOCKING					
SYMBOL	ITEM	WEIGHT	HEIGHT A.F.F.	APPROX. WIDTH		
A	WORKROOM HAND SINK	128 LBS (58 KG)	36" TO 40" (915MM TO 1015MM)	30" (760MM) BEHIND SINK		
B	SHELVES ABOVE COMPARTMENT SINK	200 LBS (91 KG)	48" TO 76" (1220MM TO 1930MM)	96" (2440MM) CENTERED ABOVE COMPARTMENT SINK		
C	MENU BOARDS	480 LBS	EXTEND 4" ABOVE AND BELOW EXTENTS OF MENU	EXTENT OF MENUS, EXTEND 4" ON EITHER SIDE. REFER TO BLOCKING DETAIL.		
D	SHELVES AT MANAGER'S DESK	300 LBS (136 KG)	32" TO 96" (810MM TO 2440MM)	48" (1220MM) 3/4 (19MM) ACX PLYWOOD, CENTERED ON SHELVES		
E	EQUIPMENT RACK AT MANAGER'S DESK	300 LBS (136 KG)	44" TO 96" (1120MM TO 2440MM)	28" (710MM) 3/4 (19MM) ACX PLYWOOD, CENTERED ON RACK		
F	DT UPPER CABINET	BLOCK	LOCKING SPECIFICATION FOR FRENCH CLEATING SYSTEM REFER TO DETAILS.			
G	RESTROOM GRAB BARS	200 LBS (91 KG)	30" TO 36" (760MM TO 915MM)	60" (1525MM) AROUND WATER CLOSET		
H	RESTROOM HAND SINK	200 LBS (91 KG)		LATION REQUIRES CONCEALED FER TO MFR'S SPECIFICATION.		
	DIAPER CHANGING STATION	250 LBS (113 KG)	40 1/2" TO 46 1/2" (1030MM TO 1180MM)	32" (810MM) BEHIND STATION		
J	UPPER CBE SHELVING		OCKING SPECIFICATION FOR CBE METAL SHELVES. EFFER TO VENDOR'S SPECIFICATION AND DETAILS.			
K	WATER FILTRATION SYSTEM	TBD BY VENDOR	COORDINATE LOCATION AND EXTENT WITH PENTAIR			
L	ALL ARTWORK, FIXTURES, ACCESSORIES AND CASEWORK FABRICATIONS NOT OTHERWISE NOTED	TBD BY VENDOR (VARIES)				
M	COAT RACK	TBD BY VENDOR	SEE INTERIOR E	ELEVATIONS FOR EXTENTS.		
N	PARTNER LOCKERS	TBD BY VENDOR		ONS FOR MANUFACTURER'S DMMENDATIONS		

WALL SHEATHING KEY

SYMBOL	DESCRIPTION
A	INDICATES SHEATHING TRANSITION
A	5/8" GYP. WALL BOARD (TERMINATE AT 6" ABOVE CEILING)
В	5/8" MOISTURE RESISTANT GYPSUM BOARD (TERMINATE AT 6" ABOVE CEILING)
c	1/2" CEMENTITIOUS BACKER BOARD (TERMINATE AT 6" ABOVE CEILING)
D	5/8" PLYWOOD (TERMINATE AT 6" ABOVE CEILING)

KEYED NOTES

- 1. INSTALL NEW CONCRETE SLAB OVER VAPOR BARRIER OVER EXISTING COMPACTED FILL. REFER TO STRUCTURAL FOR CONNECTION OF NEW SLAB TO EXISTING.
- 2. INSTALL NEW DOORS AS INDICATED. SEE SHEET A601 FOR DOOR AND HARDWARE TYPE.
- 3. ALIGN FACE OF FINISHED WALL.
- 4. SHELF FOR WATER HEATER ABOVE. REFER TO INTERIOR ELEVATION FOR HEIGHT AND DETAILS FOR CONSTRUCTION OF PLATFORM AND SUPPORTING ASSEMBLY.
- 5. ELECTRICAL PANEL LOCATIONS BY LL. MAINTAIN MINIMUM CLEARANCE AS REQUIRED BY CODE.
- 6. FUR OUT INTERIOR FACE OF WALL.
- 7. LANDLORD TO INSTALL NEW HARDWARE ON EXISTING EXTERIOR DOOR. GC TO VERIFY.
- 8. INDICATES HEADER ABOVE

GENERAL NOTES

- A. GENERAL CONTRACTOR TO VERIFY ALL DIMENSIONS AND NOTIFY STARBUCKS CONSTRUCTION MANAGER OF ANY DISCREPANCIES PRIOR TO CONSTRUCTION. ALL DIMENSIONS TO BE TAKEN FROM DESIGNATED DATUM POINT.
- B. GENERAL CONTRACTOR TO PROVIDE FIRE TREATED WOOD STUD BLOCKING, OR EQUIVALENT TO SUPPORT ANY WALL ATTACHMENT AND/OR SIGNAGE.
- C. IF EXISTING EXTERIOR ENTRANCE THRESHOLD EXCEEDS MINIMUM BARRIER FREE PROVISION OF THE CODE, REMOVE AND REPLACE WITH ACCESSIBLE THRESHOLD. RAISED THRESHOLDS AND FLOOR LEVEL CHANGES AT ACCESSIBLE DOORWAYS TO BE BEVELED WITH A SLOPE NO GREATER THAN 1:12.
- D. ALL DIMENSIONS ARE TO FINISHED FACE UNLESS SHOWN OR NOTED OTHERWISE.
- E.. INSTALL MOISTURE RESISTANT GREEN BOARD ON BACKBAR WALL PER PROJECT MANUAL.
- F. ALL DOORS SHALL BE 32" (815MM) MINIMUM CLEAR OPENING WHEN OPENED TO 90 DEGREE POSITION UNLESS OTHERWISE NOTED.
- G. SEE SHEET A601 FOR EXTERIOR DOOR AND WINDOW SCHEDULES.
- H. STARBUCKS VENDOR TO PROVIDE DOOR HARDWARE COMPONENTS AND GC TO INSTALL.
- I. VERIFY ALL EXISTING DOORS, HARDWARE AND FRAMES MEET STARBUCKS AND/OR CODE REQUIREMENTS.
- J. PROVIDE FIRE EXTINGUISHERS AS NOTED ON THE APPROVED PLANS FROM THE CITY.
- K. SEE STRUCTURAL FOR KNEE WALL BRACING.
- L. SEE SHEET A501 FOR BUILDING DETAILS.
- M. REFER TO SHEET I104 FOR FLOOR FINISHES.

GENERAL LEGEND

NEW FULL HEIGHT WALL

NEW PARTIAL HEIGHT WALL

EXISTING WALL

WALL BLOCKING CALL-OUT

XX WALL SHEATHING CALL-OUT



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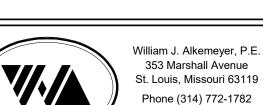
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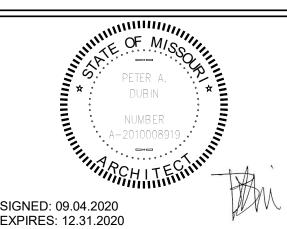
STARBUCKS TEMPLATE VERSION i2020-01-31





Engineering Consultant

Fax (314) 373-3514



SIGNED: 09.04.2020 EXPIRES: 12.31.202

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ECT ADDRESS: SW M-150 HWY STE. 15 S SUMMIT, MO 64082 KSON COUNTY

STORE #: 63039
PROJECT #: 88084-001


ISSUE DATE: 09-04-2020
SR. DESIGN MANAGER: K. GORIN-SLONSKI
PRODUCTION DESIGNER: A.MAUSER
CHECKED BY: NORR

Rev Date By Description

SHEET TITLE:
BUILDING FLOOR PLAN

SCALE: AS SHOWN

SHEET NUMBER:
A101

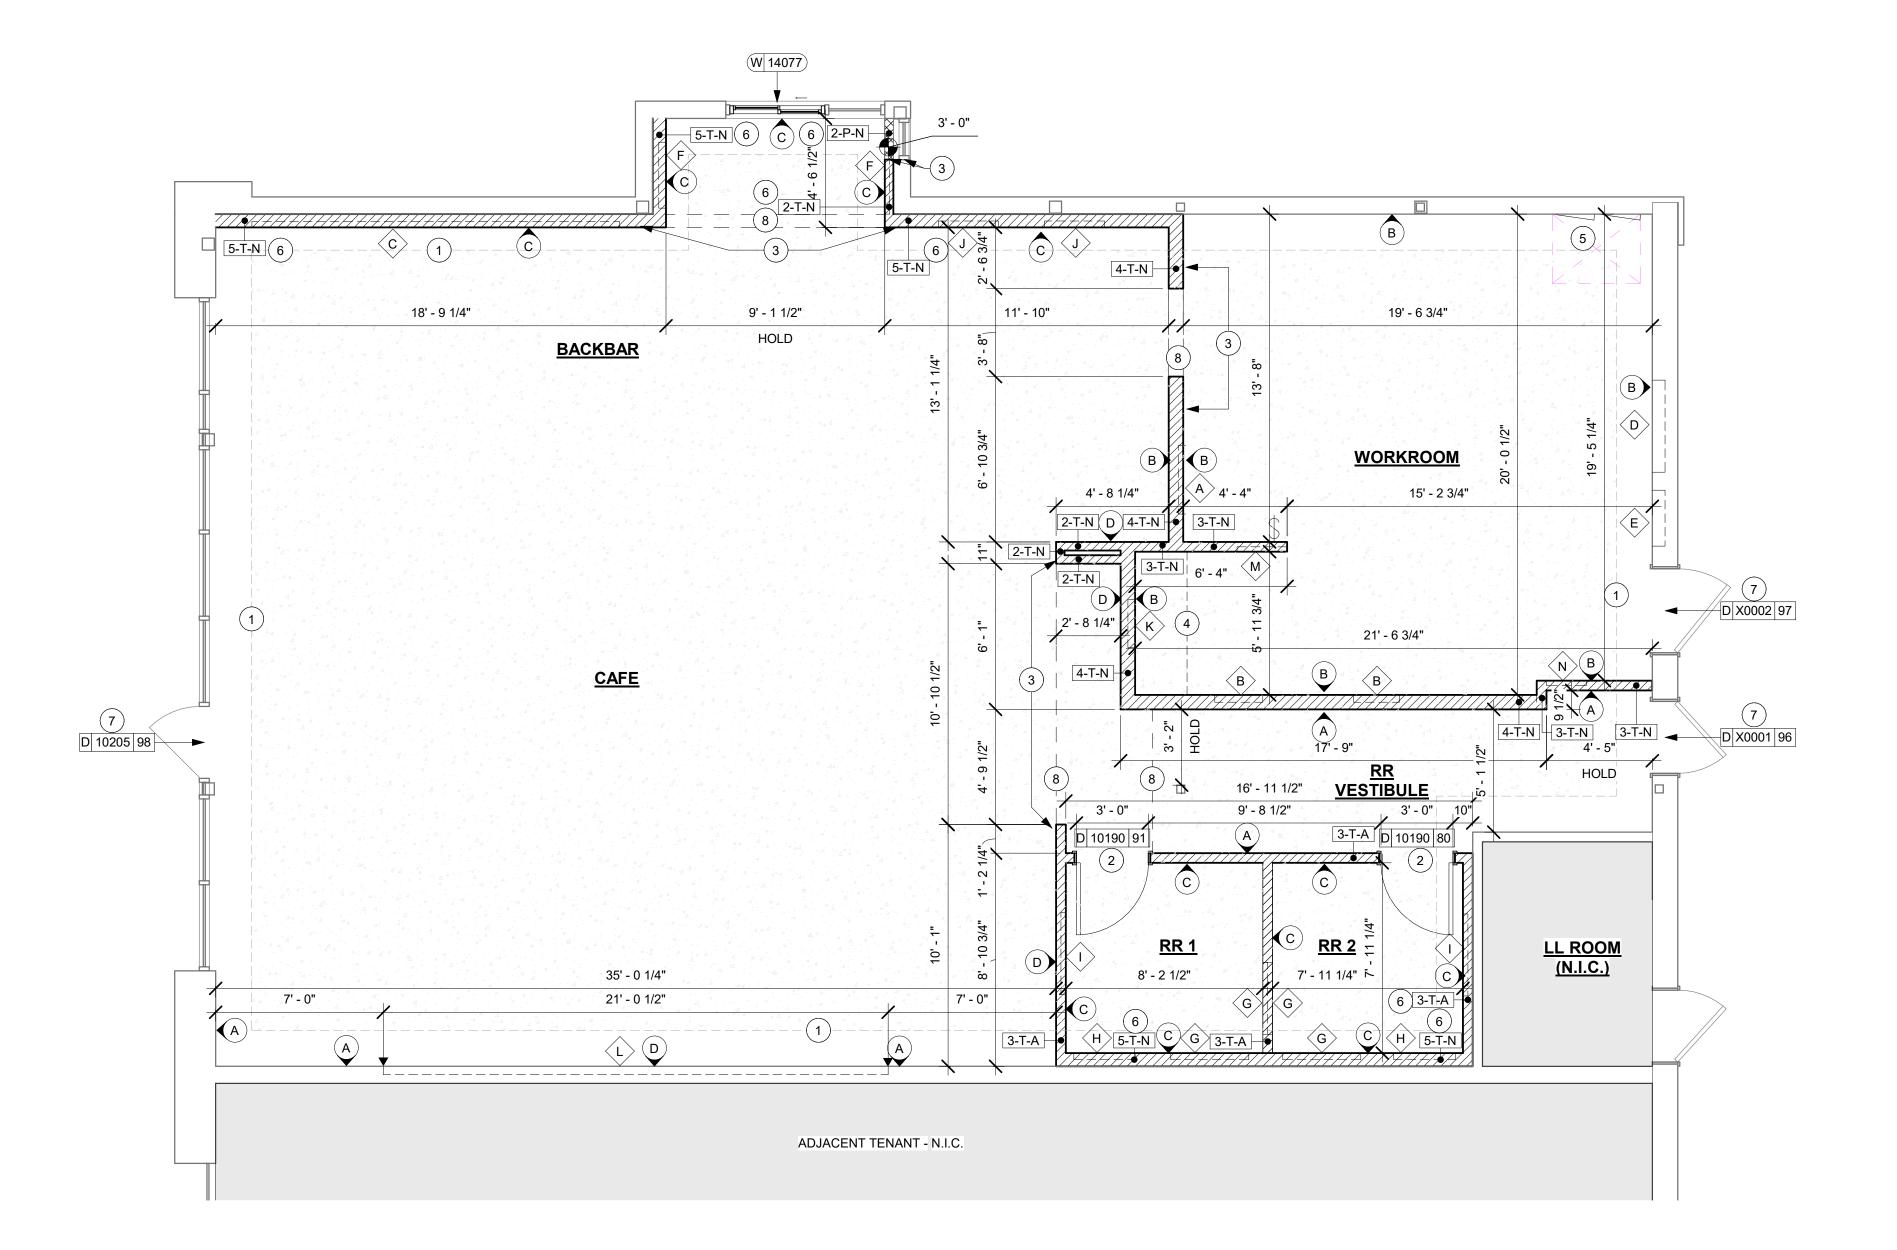



- 1. (3) 1/2" CONDUIT FOR PHONE, DATA, AND POWER FROM POS TO BE ROUTED TO CENTERLINE OF IT RACK AT MANAGERS DESK AS INDICATED. (1) 3/4" CONDUIT FOR DATA AT MANAGER'S DESK. STUB UPS TO BE WITHIN NEW PARTITION WALL. SEE MANAGER'S DESK DETAIL FOR MORE INFORMATION.
- 2. ELECTRICAL PANEL LOCATION BY LL.
- 3. ELECTRICAL STUB-UP LOCATION. SEE ELECTRICAL SHEETS FOR MORE INFORMATION. COORDINATE WITH SPECS FOR EXACT LOCATION.
- 4. PLUMBING STUB-UP LOCATION. SEE PLUMBING SHEETS FOR MORE INFORMATION.
- 5. FLOOR SINK LOCATION. SEE PLUMBING SHEETS FOR MORE INFORMATION.
- 6. FLOOR DRAIN LOCATION. SEE PLUMBING SHEETS FOR MORE INFORMATION.
- 7. GC TO PROVIDE POWER & DATA FOR FUTURE DIGITAL MENU BOARDS PER STARBUCKS STANDARD REQUIREMENTS. REFER TO INTERIOR ELEVATIONS & DETAILS FOR MORE INFORMATION.
- 8. NEW ELECTRICAL WALL OUTLET/ QUAD TO BE INSTALLED AS INDICATED. SEE INTERIOR ELEVATIONS FOR MORE
- 9. NEW SINK CONNECTION. REFER TO PLUMBING SHEETS FOR MORE INFO.
- 10. NEW WASTELINE PENETRATION AS INDICATED. REFER TO PLUMBING SHEETS FOR MORE INFORMATION.
- 11. DATUM FOR BACKBAR.
- 12. DATUM FOR WORKROOM.
- 13. DATUM FOR CAFE.
- 14. SWITCHING LOCATION. SEE ELECTRICAL SHEETS.
- 15. EXTERIOR COVERED GFCI ELECTRICAL OUTLET BY LL.
- 16. EXTERIOR HOSE BIB BY LL.
- 17. LOCATION OF INCOMING WATER SERVICE BY LL.
- 18. FLOOR ELECTRICAL J BOX. REFER TO ELECTRICAL SHEETS AND CUTSHEETS FOR MORE INFORMATION.
- 19. DATUM FOR RESTROOMS.

GENERAL NOTES

- A. ALL STUB-UP DIMENSIONS ARE RELATIVE TO FINISHED WALL LOCATIONS (SHOWN AS OUTLINES ON THIS PLAN). REFER TO FLOOR PLAN FOR WALL PLACEMENT.
- B. FLOOR SINK: REFER TO CUT SHEETS FOR COMPONENT SPECIFICATIONS AND CUTOUT REQUIREMENTS.
- C. WASTE LINE PENETRATIONS: REFER TO PLUMBING PLANS FOR INDIVIDUAL LINE LOCATIONS.
- D. STUB-UP PENETRATIONS: REFER TO ELECTRICAL AND PLUMBING PLANS FOR INDIVIDUAL STUB-UP LOCATIONS.
- E. TOILET FLOOR PENETRATION: REFER TO CUT SHEETS FOR STUB-UP LOCATION RELATIVE TO FINISHED WALL.
- F. PENETRATION TO BE LOCATED ON CENTERLINE OF

WALL OR AS REQUIRED PER CONDITIONS.

- G. TRENCHING OUTLINE FOR GUIDELINE USE ONLY. GENERAL CONTRACTOR TO COORDINATE WITH SPECIFIC TRADES AND SITE CONDITIONS TO DETERMINE
- H. REFER TO SHEET I101 FOR FLOOR FINISHES.

LEGEND

EXISTING WALL CONCRETE LEAVE-OUT



NEW FLOOR SINK

NEW FLOOR DRAIN

FLOOR PENETRATION

NEW WALL DUPLEX RECEPTACLE

NEW QUADPLEX RECEPTACLE

ACTUAL LAYOUT.

PLUMBING PENETRATION AREA

ELECTRICAL PENETRATION AREA

NEW DATA RECEPTACLE

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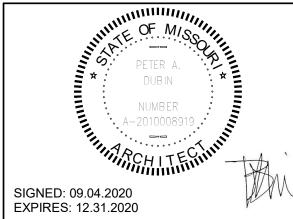
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Engineering Consultant



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OF

BUILDO COFFEE RT. 291

STORE #: 63039 PROJECT #: 88084-001 ISSUE DATE: 09-04-2020 SR. DESIGN MANAGER: K. GORIN-SLONSKI PRODUCTION DESIGNER: A.MAUSER

Revision Schedule

BUILDING FLOOR PENETRATION PLAN SCALE: AS SHOWN

SHEET NUMBER:

CHECKED BY:

A102

(1)(3)7' - 5" 5' - 3" (14) \$ REFER TO PLUMBING & ELECTRICAL SHEETS FOR FULL COORDINATION P 10294 P 10726 RR VESTIBULE <u>CAFE</u> LL ROOM (N.I.C.)

ADJACENT TENANT - N.I.C.

P 10726

P 10294

P 10726

7' - 10"

P 10294

4' - 11"

1' - 5", 2' - 0", 3' - 3"

P 10294

|P 10726

9' - 0"


WORKROOM


FLOOR PENETRATION PLAN

Scale: 1/4" = 1'-0"

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		EXTERIOR SIGNAGE	SCHEDULE	E - "S"	
DESIGN ID	COUNT	DESCRIPTION	FURN. BY	INST. BY	COMMENTS
SIGNAGE - I	DISK		'	!	
13182	1	SIGN - DISK SF ILLUMINATED FLUSH MOUNTED EVOLVED - 71IN 1805MM	SB	GC/ HILTON	LL TO PROVIDE BLOCKING AND CONDUIT AS REQUIRED
13184	1	SIGN - DISK SF ILLUMINATED FLUSH MOUNTED EVOLVED - 60IN 1525MM	SB	GC/ HILTON	LL TO PROVIDE BLOCKING AND CONDUIT AS REQUIRED
SIGNAGE - I	DRIVE THR	Ú	•		
14091	1	SIGN - DT DIRECTIONAL EXIT SIGN ILLUMINATED ARROW SERIES - 46IN 1170MM	SB	GC	GC TO COORDINATE WITH SBUX VENDOR. LL TO PROVIDE, FOOTING, ANCHOR BOLT AND CONDUIT
14106	1	SIGN - DT CLEARANCE BAR ARROW SERIES FREESTANDING	SB	GC	GC TO COORDINATE WITH SBUX VENDOR. LL TO PROVIDE, FOOTING AND ANCHOR BOLT
SIGNAGE -	OTHER				
19388	3	SIGN - 10 MINUTE PARKING	SB/LL	GC	FOOTING AND POST BY LL, SIGN BY VENDOR (TUBE ART). GC TO INSTALL.
SIGNAGE - I	PYLON DISI	K			
X0044	1	MONUMENT SIGN	SB	GC/ LL	LL TO PROVIDE BASE SIGN, FOOTING, ANCHOR BOLTS AND CONDUITS. SIGN PANELS BY SBUX VENDOR
SIGNAGE - V	WORDMAR	K			
X18498	1	SIGN - WORDMARK STARBUCKS FLUSH MOUNTED - 20IN 510MM	SB	GC/ HILTON	WORDMARK COLOR GREEN: LL TO PROVIDE CONDUIT AND BLOCKING AS REQUIRED



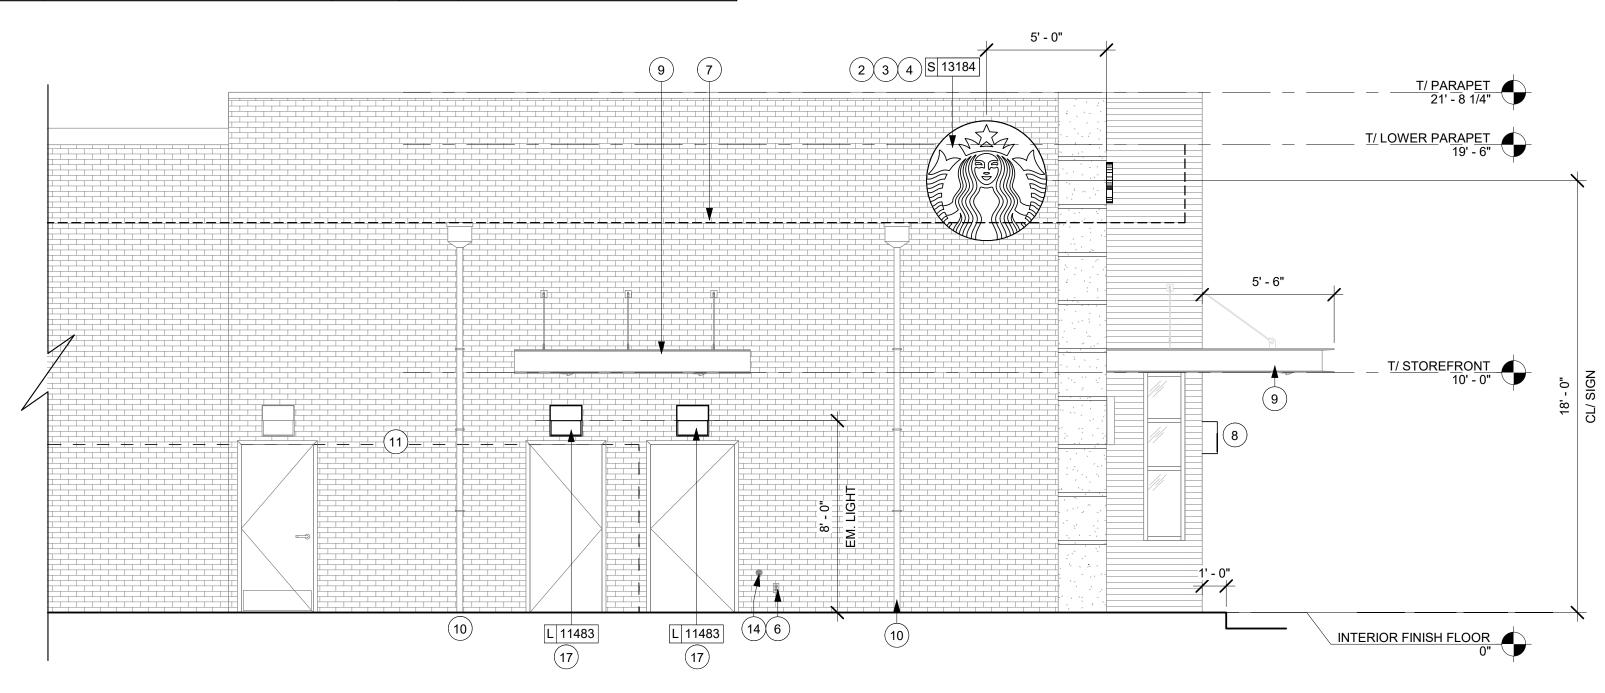

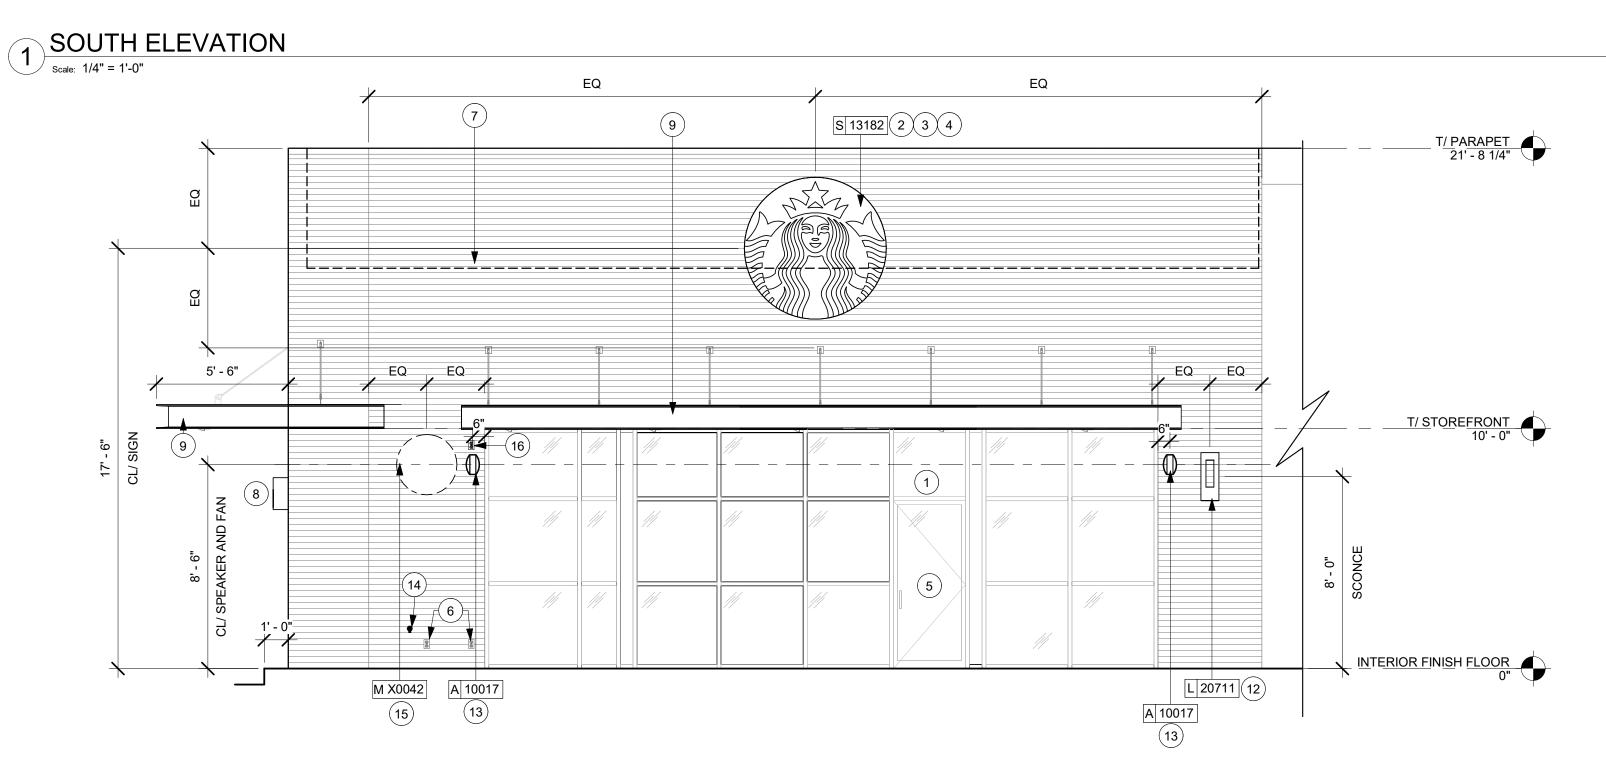- 1. PROVIDE 3" (75MM) HIGH BLACK ACRYLIC STORE ADDRESS ON GLAZING ABOVE MAIN ENTRY DOOR OR PER LOCAL JURISDICTIONAL CODE REQUIREMENTS.
- 2. LL TO PROVIDE J-BOX FOR BUILDING SIGNAGE. COORDINATE LOCATION WITH SIGNAGE VENDOR SHOP
- 3. LL TO PROVIDE SIGNAGE DISCONNECT ON INSIDE FACE OF WALL.
- 4. LL TO PROVIDE 3/4" MARINE GRADE PLYWOOD BLOCKING FOR EXTERIOR SIGNAGE. EXTEND BLOCKING 8" (205MM) MIN. BEYOND EDGE OF SIGNAGE.
- 5. STOREFRONT AND ENTRANCE BY LL.
- 6. LL TO PROVIDE GFI EXTERIOR OUTLET PER WORK LETTER REQUIREMENTS.
- 7. OUTLINE OF ROOF BEYOND.
- 8. DRIVE-THRU WINDOW AND AIR CURTAIN TO BE PROVIDED AND INSTALLED BY LL PER SBUX SPECIFICATIONS.
- 9. STEEL CANOPY. LL TO PROVIDE RECESSED CAN LIGHTING AT ALL CANOPIES, SEE ELECTRICAL DRAWINGS.
- 10. ROOF SCUPPER: CONNECT VERTICAL LEADERS TO UNDERGROUND STORM DRAIN.
- 11. UTILITY SCREEN
- 12. NEW SCONCES PER LL PER LL CRITERIA PACKAGE. LL SCONCES TO MATCH STARBUCKS SPEC.
- 13. EXTERIOR SPEAKER. SEE REFLECTED CEILING PLAN AND BUILDING CANOPY DETAILS.
- 14. LL TO PROVIDE KEYED, FROST-FREE RECESSED LOCKABLE HOSE BIB. SEE PLUMBING DRAWINGS.
- 15. LL TO PROVIDE POWER FOR PATIO FANS.
- 16. LL TO PROVIDE POWER FOR PATIO STRING LIGHTS.
- 17. LL TO PROVIDE SECURITY LIGHTING ABOVE REAR DOOR.

GENERAL NOTES

- A. GENERAL CONTRACTOR TO COORDINATE AND SCHEDULE SIGNAGE INSTALLATION WITH THE SIGNAGE CONTRACTOR PROVIDING A MINIMUM SCHEDULING NOTICE OF 4 WEEKS AND 1 WEEK PRIOR TO SCHEDULED DATE OF INSTALLATION. CONSTRUCTION MANAGER TO PROVIDE GENERAL CONTRACTOR WITH SIGNAGE CONTRACTOR CONTACT INFORMATION.
- B. GENERAL CONTRACTOR SHALL COORDINATE WITH ELECTRICAL CONTRACTOR TO FURNISH AND INSTALL ELECTRICAL CIRCUITS INCLUDING ALL CONDUIT, WIRE, CONNECTIONS AND BREAKER AT PANEL BOARD NECESSARY TO SERVE SIGNAGE.
- C. GENERAL CONTRACTOR TO PROVIDE FIRE TREATED WOOD STUD BLOCKING OR EQUIVALENT TO SUPPORT SIGNAGE.
- D. SIGNAGE CONTRACTOR SHALL VERIFY SIZE AND LOCATION OF ANY AND ALL ALLOWABLE MONUMENT OR POLE SIGNAGE AND PROVIDE SHOP DRAWING(S) PRIOR TO FABRICATION TO THE STARBUCKS DESIGNER FOR APPROVAL.
- E. SIGNAGE CONTRACTOR TO INSTALL SIGNAGE IN COMPLIANCE WITH LOCAL CODES AND OBTAIN PERMIT.
- F. SIGNAGE CONTRACTOR TO SUPPLY SHOP DRAWINGS TO CONSTRUCTION MANAGER AND TO THE GENERAL CONTRACTOR AS NEEDED. GENERAL CONTRACTOR TO NOTIFY CONSTRUCTION MANAGER IMMEDIATELY IF SHOP DRAWINGS OR INSTALLATION IS IN DISCREPANCY WITH ARCHITECTURAL DRAWINGS.
- G. GENERAL CONTRACTOR TO CLEAN, PATCH AND REPAIR EXISTING EXTERIOR AS REQUIRED.

LEGEND - EXT. ELEV.

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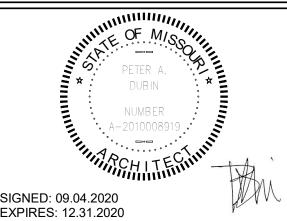
NOR LIABILITY TO THE OTHER (EXCEPT STATED ABOVE) UNTIL A WRITTEN AGREEMENT IS FULLY EXECUTED BY BOTH PARTIES.





Engineering Consultant

Fax (314) 373-3514



STORE #: 63039 PROJECT #:

CHECKED BY: **Revision Schedule**

Rev Date By D	Description

BUILDING EXTERIOR ELEVATIONS

SHEET NUMBER:

BID/P

0

20

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0 0

BUILDO COFFEE RT. 291

88084-001 ISSUE DATE: 09-04-2020
SR. DESIGN MANAGER: K. GORIN-SLONSKI
PRODUCTION DESIGNER: A.MAUSER

SCALE: AS SHOWN

A201

NORTH ELEVATION

Scale: 1/4" = 1'-0"

DESIGN ID	COUNT	DESCRIPTION	FURN. BY	INST. BY	COMMENTS
SIGNAGE -	DISK		•	•	
13182	1	SIGN - DISK SF ILLUMINATED FLUSH MOUNTED EVOLVED - 71IN 1805MM	SB	GC/ HILTON	LL TO PROVIDE BLOCKING AND CONDUIT AS REQUIRED
13184	1	SIGN - DISK SF ILLUMINATED FLUSH MOUNTED EVOLVED - 60IN 1525MM	SB	GC/ HILTON	LL TO PROVIDE BLOCKING AND CONDUIT AS REQUIRED
SIGNAGE - I	DRIVE THR	Ü	•	•	
14091	1	SIGN - DT DIRECTIONAL EXIT SIGN ILLUMINATED ARROW SERIES - 46IN 1170MM	SB	GC	GC TO COORDINATE WITH SBUX VENDOR. LL TO PROVIDE, FOOTING, ANCHOR BOLT AND CONDUIT
14106	1	SIGN - DT CLEARANCE BAR ARROW SERIES FREESTANDING	SB	GC	GC TO COORDINATE WITH SBUX VENDOR. LL TO PROVIDE, FOOTING AND ANCHOR BOLT
SIGNAGE -	OTHER		•	•	
19388	3	SIGN - 10 MINUTE PARKING	SB/LL	GC	FOOTING AND POST BY LL, SIGN BY VENDOR (TUBE ART). GC TO INSTALL.
SIGNAGE - I	PYLON DIS	K		•	
X0044	1	MONUMENT SIGN	SB	GC/ LL	LL TO PROVIDE BASE SIGN, FOOTING, ANCHOR BOLTS AND CONDUITS. SIGN PANELS BY SBUX VENDOR
SIGNAGE - V	WORDMAR	K			
X18498	1	SIGN - WORDMARK STARBUCKS FLUSH MOUNTED - 20IN 510MM	SB	GC/ HILTON	WORDMARK COLOR GREEN: LL TO PROVID CONDUIT AND BLOCKING AS REQUIRED

- 1. LL TO PROVIDE POWER FOR PATIO STRING LIGHTS.
- 2. LL TO PROVIDE J-BOX FOR BUILDING SIGNAGE. COORDINATE LOCATION WITH SIGNAGE VENDOR SHOP DRAWINGS.
- 3. LL TO PROVIDE SIGNAGE DISCONNECT ON INSIDE FACE OF WALL.
- 4. LL TO PROVIDE 3/4" MARINE GRADE PLYWOOD BLOCKING FOR EXTERIOR SIGNAGE. EXTEND BLOCKING 8" (205MM) MIN. BEYOND EDGE OF SIGNAGE.
- 5. LL TO PROVIDE POWER FOR PATIO FANS.
- 6. NEW SCONCES PER LL PER LL CRITERIA PACKAGE. LL SCONCES TO MATCH STARBUCKS SPEC.
- 7. OUTLINE OF ROOF BEYOND.
- 8. DRIVE-THRU WINDOW AND AIR CURTAIN TO BE PROVIDED AND INSTALLED BY LL PER SBUX SPECIFICATIONS.
- 9. STEEL CANOPY. LL TO PROVIDE RECESSED CAN LIGHTING AT ALL CANOPIES, SEE ELECTRICAL DRAWINGS.
- 10. PLANTER BOXES AND PLANTS BY LL.

GENERAL NOTES

- A. GENERAL CONTRACTOR TO COORDINATE AND SCHEDULE SIGNAGE INSTALLATION WITH THE SIGNAGE CONTRACTOR PROVIDING A MINIMUM SCHEDULING NOTICE OF 4 WEEKS AND 1 WEEK PRIOR TO SCHEDULED DATE OF INSTALLATION. CONSTRUCTION MANAGER TO PROVIDE GENERAL CONTRACTOR WITH SIGNAGE CONTRACTOR CONTACT INFORMATION.
- B. GENERAL CONTRACTOR SHALL COORDINATE WITH ELECTRICAL CONTRACTOR TO FURNISH AND INSTALL ELECTRICAL CIRCUITS INCLUDING ALL CONDUIT, WIRE, CONNECTIONS AND BREAKER AT PANEL BOARD NECESSARY TO SERVE SIGNAGE.
- C. GENERAL CONTRACTOR TO PROVIDE FIRE TREATED WOOD STUD BLOCKING OR EQUIVALENT TO SUPPORT SIGNAGE.
- D. SIGNAGE CONTRACTOR SHALL VERIFY SIZE AND LOCATION OF ANY AND ALL ALLOWABLE MONUMENT OR POLE SIGNAGE AND PROVIDE SHOP DRAWING(S) PRIOR TO FABRICATION TO THE STARBUCKS DESIGNER FOR APPROVAL.
- E. SIGNAGE CONTRACTOR TO INSTALL SIGNAGE IN COMPLIANCE WITH LOCAL CODES AND OBTAIN PERMIT.
- F. SIGNAGE CONTRACTOR TO SUPPLY SHOP DRAWINGS TO CONSTRUCTION MANAGER AND TO THE GENERAL CONTRACTOR AS NEEDED. GENERAL CONTRACTOR TO NOTIFY CONSTRUCTION MANAGER IMMEDIATELY IF SHOP DRAWINGS OR INSTALLATION IS IN DISCREPANCY WITH ARCHITECTURAL DRAWINGS.
- G. GENERAL CONTRACTOR TO CLEAN, PATCH AND REPAIR EXISTING EXTERIOR AS REQUIRED.




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Engineering Consultant

Fax (314) 373-3514



7 STE. 64082 PROJECT NAME:
BUILDOUT
COFFEE
RT. 291 &15

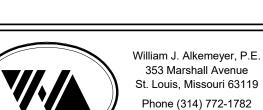STORE #: 63039 PROJECT #: 88084-001 ISSUE DATE: 09-04-2020 SR. DESIGN MANAGER: K. GORIN-SLONSKI PRODUCTION DESIGNER: A.MAUSER


Revision Schedule

BUILDING EXTERIOR ELEVATIONS SCALE: AS SHOWN

SHEET NUMBER:

CHECKED BY:

A202

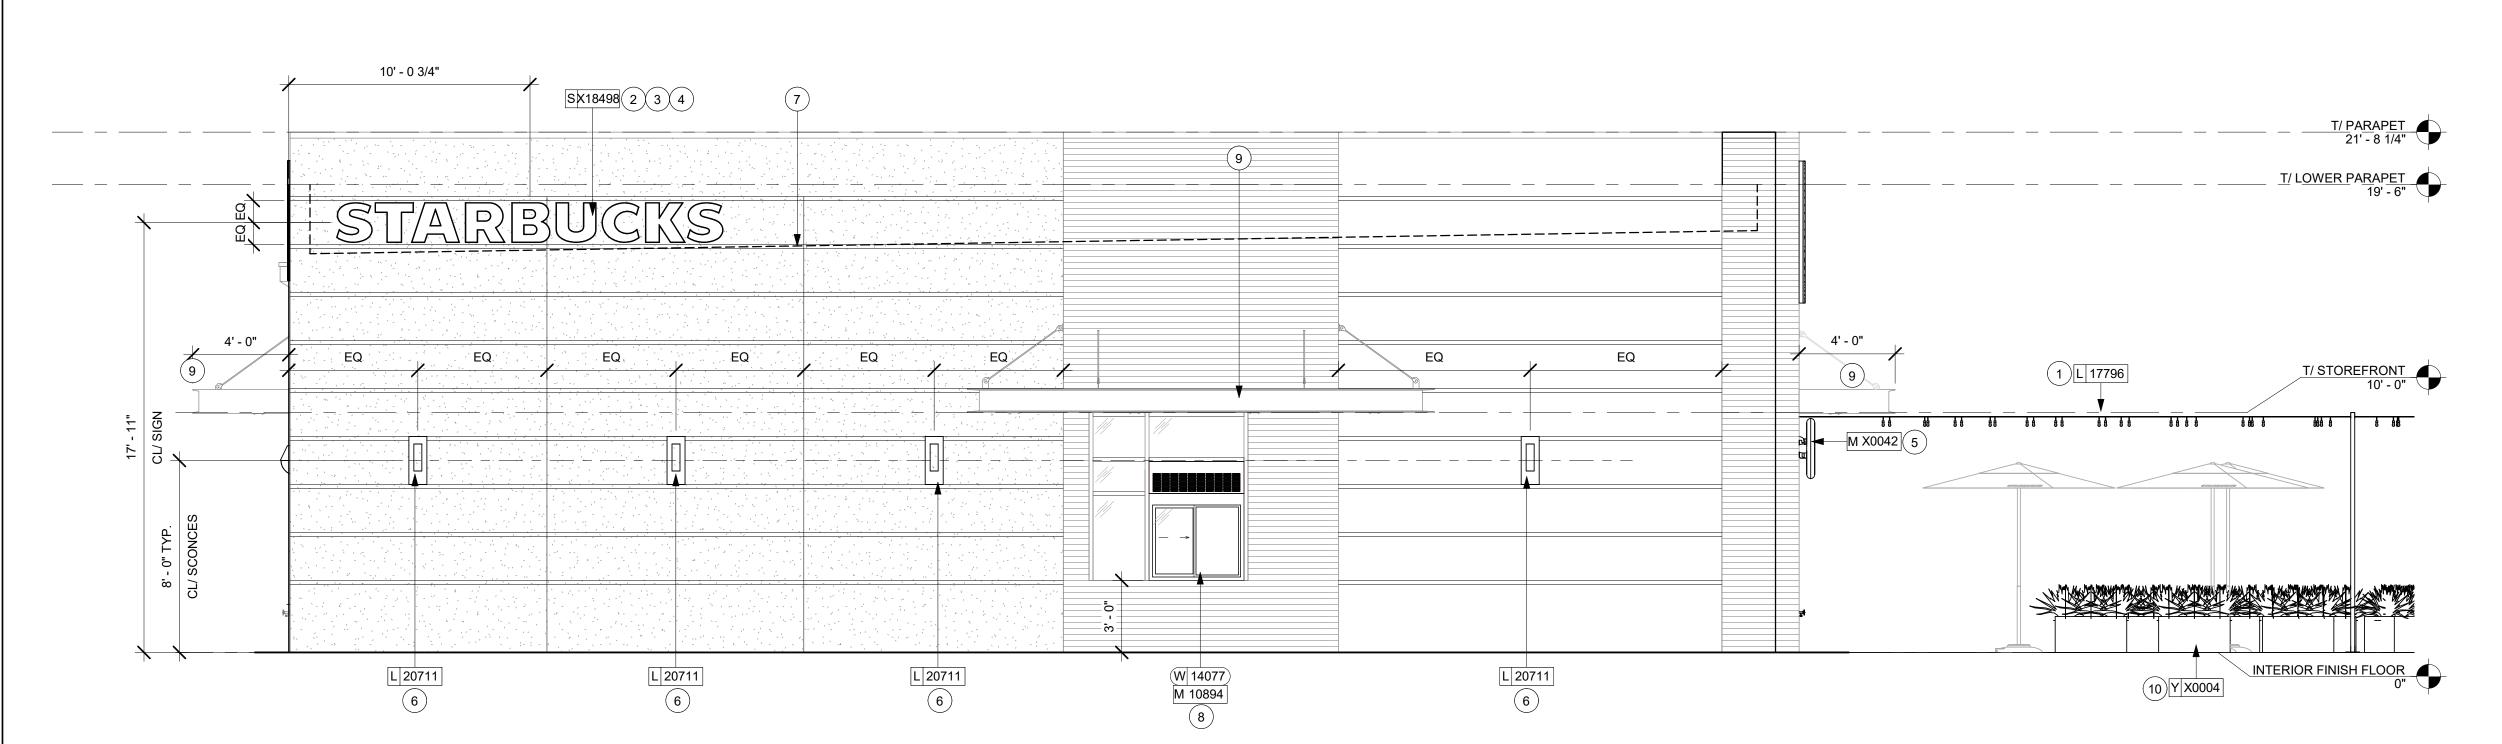

1 EAST ELEVATION

Scale: 1/4" = 1'-0"

DESIGN ID	COUNT	DESCRIPTION	FURN. BY	INST. BY	COMMENTS
SIGNAGE - I	DISK		1		
13182	1	SIGN - DISK SF ILLUMINATED FLUSH MOUNTED EVOLVED - 71IN 1805MM	SB	GC/ HILTON	LL TO PROVIDE BLOCKING AND CONDUIT AS REQUIRED
13184	1	SIGN - DISK SF ILLUMINATED FLUSH MOUNTED EVOLVED - 60IN 1525MM	SB	GC/ HILTON	LL TO PROVIDE BLOCKING AND CONDUIT AS REQUIRED
SIGNAGE - I	DRIVE THR	Ú			
14091	1	SIGN - DT DIRECTIONAL EXIT SIGN ILLUMINATED ARROW SERIES - 46IN 1170MM	SB	GC	GC TO COORDINATE WITH SBUX VENDOR. LL TO PROVIDE, FOOTING, ANCHOR BOLT AND CONDUIT
14106	1	SIGN - DT CLEARANCE BAR ARROW SERIES FREESTANDING	SB	GC	GC TO COORDINATE WITH SBUX VENDOR. LL TO PROVIDE, FOOTING AND ANCHOR BOLT
SIGNAGE - (OTHER			•	
19388	3	SIGN - 10 MINUTE PARKING	SB/LL	GC	FOOTING AND POST BY LL, SIGN BY VENDOR (TUBE ART). GC TO INSTALL.
SIGNAGE - F	PYLON DISI	<			
X0044	1	MONUMENT SIGN	SB	GC/ LL	LL TO PROVIDE BASE SIGN, FOOTING, ANCHOR BOLTS AND CONDUITS. SIGN PANELS BY SBUX VENDOR
SIGNAGE - \	WORDMARI	K	•	•	
X18498	1	SIGN - WORDMARK STARBUCKS FLUSH MOUNTED - 20IN 510MM	SB	GC/ HILTON	WORDMARK COLOR GREEN: LL TO PROVID CONDUIT AND BLOCKING AS REQUIRED

DESIGN ID	COUNT	DESCRIPTION	FURN. BY	INST. BY	COMMENTS
EXTERIOR I	/IENU				
14116	1	MENU BOARD - DT DIGITAL ORDER SCREEN - FLAT BLACK MT0028	SB		SUPPLIER: IT EQUIPMENT VENDOR (ZONES) SCREEN INSTALLER: REGIONAL SIGNAGE VENDOR. ELECTRICAL: GC CONNECTS DOS WHIPS & STUB-UPS TO DCB.
14119	1	MENU BOARD - DT 5 PANEL FREESTANDING - 108X65IN 2745X1650MM - FLAT BLACK MT0028	SB	SB/GC	SUPPLIER: DT SIGNAGE VENDOR (DSA). INSTALLER: REGIONAL SIGNAGE VENDOR. LL TO PROVIDE FOOTING, CONDUIT AND ANCHOR BOLTS
14120	1	MENU BOARD - DT PRE MENU FREESTANDING - 36X65IN 915X1650MM - FLAT BLACK MT0028	SB	SB/GC	SUPPLIER: DT SIGNAGE VENDOR (DSA). INSTALLER: REGIONAL SIGNAGE VENDOR. LL TO PROVIDE FOOTING, CONDUIT AND ANCHOR BOLTS
15700	1	MENU BOARD - DT DIGITAL ORDER SCREEN CONTROL BOX	SB	SB/GC	SUPPLIER: IT EQUIPMENT VENDOR (ZONES) INSTALLER: REGIONAL SIGNAGE VENDOR. ELECTRICAL CONNECTION: GC. LL TO PROVIDE FOOTING, CONDUIT AND ANCHOR BOLTS
OTHER					
14103	7	BOLLARD NONILLUMINATED SQUARE - FLAT BLACK MT0028	LL	LL	DSA PHOTOTECH. SEE DTL.
14163	1	DT ORDER POINT CANOPY FREESTANDING - FLAT BLACK MT0028	SB	SB/GC	SUPPLIER: DT SIGNAGE VENDOR (DSA). INSTALLER: REGIONAL SIGNAGE VENDOR. LL TO PROVIDE FOOTING, CONDUIT AND ANCHOR BOLTS
18818	2	LIGHT POLE - 10FT 300CM - FLAT BLACK MT0028	SB	GC	GC TO PROVIDE AIRLINE CABLE AND HOOKS AS NEEDED FOR LIGHT INSTALLATION.
18820	2	LIGHT POLE BASE PLATE - FLAT BLACK MT0028	SB	GC	
X0007	2	VEHICLE DETECTOR LOOP	SB	GC	SUPPLIER: DT AUDIO VENDOR (HME). INSTALLER: GC. LL TO PROVIDE CONDUIT
X0014	2	BIKE RACK - OLYMPIA	LL	LL	FORMS & SURFACES: OLYMPIA BIKE RACK. WWW.FORMS-SURFACES.COM; INSTALL PER MANUFACTURER'S RECOMMENDATIONS.FINISH: STANDARD BLACK TEXTURE.
PLANTER		•	•	•	
X0004	11	CONCRETE PLANTER BOX	LL	LL	CONCRETE PLANTERS WITH IRRIGATION BY LANDLORD. LL TO PROVIDE SPEC TO CM FOR APPROVAL.LL TO PROVIDE LANDSCAPING.COORDINATE WITH OPERATIONS PRIOR TO INSTALLATION.
UMBRELLA			•		•
12147	3	UMBRELLA - BASE 95LB 43KG - FLAT BLACK MT0028	SB	GC	
20073	3	UMBRELLA - WITHOUT VALANCE - 6FT 183CM - GREEN CANVAS WITH WORDMARK F0056	SB	GC	

RESPONSIBILITY LEGEND

- GC GENERAL CONTRACTOR LL LANDLORD SB STARBUCKS

A601



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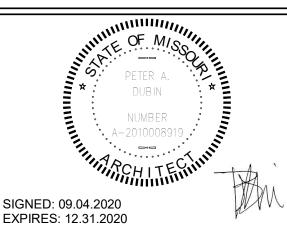
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EXPIRES: 12.31.2020

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BID/PERMIT

155 ОЕ PROJECT NAME:
BUILDOUT OF
COFFEE
RT. 291 &150

PROJECT ADDRESS:
155 SW M-150 HWY STE. 1
LEES SUMMIT, MO 64082
JACKSON COUNTY

STORE #: 63039 PROJECT #: 88084-001

Revision Schedule

ISSUE DATE: 09-04-2020
SR. DESIGN MANAGER: K. GORIN-SLONSKI
PRODUCTION DESIGNER: A.MAUSER
CHECKED BY: NORR

Rev	Date	Ву	Description


SHEET TITLE:
SCHEDULES

SCALE: AS SHOWN

SHEET NUMBER:

				DOOR S	SCHEDULE - "D"			
DESIGN ID	MARK	DESCRIPTION	WIDTH	HEIGHT	HARDWARE SET	FURN BY	INST BY	COMMENTS
Exterior			•					
X0001	96	DOOR - SINGLE SERVICE - 36IN	3' - 0"	7' - 0"	12	LL	LL	SEE INTERIOR ELEVATIONS FOR FINISHES. LL GC TO COORDINATE AND PAINT PER TENANT'S DRAWINGS.
X0002	97	DOOR - SINGLE SERVICE - 42IN	3' - 6"	7' - 0"	42	LL	LL	SEE INTERIOR ELEVATIONS FOR FINISHES. LL GC TO COORDINATE AND PAINT PER TENANT'S DRAWINGS.
10205	98	DOOR - STOREFRONT METAL FRAME SINGLE - TYPE B	3' - 0"	7' - 0"	2-A	LL	LL	
3				•				
Interior								
10190	80	DOOR - SINGLE FLUSH - 36IN	3' - 0"	7' - 0"	6	SB	GC	FINISH: PL0027 FRAME: SW7748
10190	91	DOOR - SINGLE FLUSH - 36IN	3' - 0"	7' - 0"	6	SB	GC	FINISH: PL0027 FRAME: SW7748


DOOR LEGEND

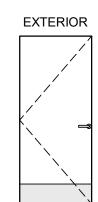



METAL FRAME

SINGLE (TYPE B)

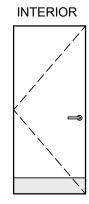

SINGLE SERVICE

SINGLE FLUSH

	DOOR HARDWARE SET I	NO. 2-A - For new single aluminum secondary entr	y/exit door (50 or	more occupancy)
No.	Item	Description	Manufacturer	Finish
3	Hanging Devices	TH2314/MPB91	McKinney	630
1	Securing Devices	CD35A-NL-OP Panic Device	Von Duprin	628/630
2	Securing Devices	C607 7-Pin Core Combinated "A" Keyway	Falcon Lock	626
1	Securing Devices	curing Devices KB609-2 Cut Control Key "A" Keyway		
9	Securing Devices	KB632-2 Cut User Key "A" Keyway	Falcon Lock	
1	Securing Devices	C953 7-Pin Rim Cylinder Housing	Falcon Lock	626
1	Securing Devices	C987 7-Pin Mortise Cylinder Housing w/AR Cam	Falcon Lock	626
1	Securing Devices	A08794-003 Adjustable Ring, Mortise Cyl. 516-13/32	Falcon Lock	626
1	Operating Trim	108 Door Pull Handle	Rockwood	630
1	Closing Devices	8916 Door Closer 8916 AF89P	Dorma	689
1	Stops and Holders	473 Door Stop w/ Hook	Rockwood	626
1	Threshold	325 Half Saddle Threshold	National Guard	
1	Sign	Vinyl Sign: "THIS DOOR MUST REMAIN UNLOCKED WHEN BUILDING IS OCCUPIED"	Seton	

No.	Item	Description	Manufacturer	Finish
3	Hanging Devices	TH2314/MPB91 Hinge MacPro Bearing 4.5 x 4.5	McKinney	630
1	Securing Devices	C607 7-Pin Core Combinated "A" Keyway	Falcon Lock	626
1	Securing Deices	I/O 2000L-03IC Auto Locking Door Alarm, IC: No CTR Includes Mortise Cylinder	Sur-Lock	
1	Closing Devices	8916 Door Closer 8916 AF89P	Dorma	689
1	Protective Trim Units	K1050 B4E Kickplate 8" x 34"	Rockwood	630
1	Accessories	137NA Weather Strip 17" 36" x 84"	National Guard	А
1	Accessories	Door Sweep 18062CNB36	Pemko	Α
1	Miscellaneous Items	DS/1000 Door Scope	Security	Silver
1	Miscellaneous Items	MCV309NWHGL Door Bell	Nutone	As Selected

No.	ltem	Description	Manufacturer	Finish
3	Hanging Devices	TH2314/MPB91 Hinge MacPro Bearing 4.5 x 4.5	McKinney	630
1	Securing Devices C607 7-Pin Core Combinated "A" Keyway		Falcon Lock	626
1	Securing Devices I/O 2000L-03IC Auto Locking Door Alarm, Includes Mortise Cylinder - PANIC HARDV		Sur-Lock	
1	Closing Devices	Closing Devices 8916 Door Closer 8916 AF89P		689
1	Protective Trim Units	K1050 B4E Kickplate 10" x 40"	Rockwood 630	
1	Accessories	137NA Weather Strip 20' 42" x 84"	137NA Weather Strip 20' 42" x 84" National Guard	
1	Accessories	Door Sweep 18062CNB36	Pemko	А
1	Miscellaneous Items	DS / 1000 Door Scope	Security Products	Silver
1	Miscellaneous Items	MCV309NWHGL Door Bell	Nutone	As Selected

STOREFRONT SCHEDULE						
DESIGN ID	COUNT	DESCRIPTION	FURN. BY	INST. BY	COMMENTS	
WINDOW						
14077	1	WINDOW - DT NO TRANSOM - 48X60IN 1205X1510MM - STANDARD GLASS	LL		READY ACCESS WINDOW 275 PASS THRU. CONTACT: ANNA ELLIS, ANNA@READY-ACCESS.COM. FINISH TO MATCH LL STOREFRONT.	

No.	Item	Description	Manufacturer	Finish
3	Hanging Items	TA2714/MPB79 Hinge MacPro Bearing 4.5 x 4.5	McKinney	626
1	Securing Devices	PB5425LN Lock, Shallow Coin Turn, Privacy PB5425LN-693-497 1-3/4	Yale Lock	626
1	Closing Devices	8916 Door Closer 8916 AF89P	Dorma	689
2	Protective Trim Units	K1050 B4E Kickplate 8" x 34" Each Side 32D	Rockwood	630
3	Accessories	GJ64 Rubber Silencer	Glynn Johnson	Gray
1	Stops and Holders	473 Door Stop w/ Hook	Rockwood	626

GENERAL NOTES

- A. STARBUCKS VENDOR TO PROVIDE DOOR HARDWARE COMPONENTS. GC TO INSTALL.
- B. SEE SHEET A101 FOR TAGGED LOCATION OF EXTERIOR DOORS AND WINDOWS.
- C. EGRESS SHALL NOT PASS THROUGH KITCHENS, STORAGE ROOMS, CLOSETS OR SIMILAR SPACES. (1014.2)
- D. PANIC AND FIRE EXIT HARDWARE, WHERE INSTALLED ON DOORS IN THIS BUILDING SHALL SATISFY THE FOLLOWING (1008.1.10):
- a) THE ACTUATION PORTION OF THE RELEASING DEVICE SHALL EXTEND AT LEAST ONE-HALF OF THE DOOR LEAF WIDTH.
- b) THE MAXIMUM UNLATCHING FORCE DOES NOT EXCEED 15 POUNDS (6.8 KG).
- c) PIVOTED OR BALANCED DOORS SHALL BE OF THE PUSH-PAD TYPE WHERE PANIC HARDWARE IS REQUIRED AND THE PAD SHALL NOT EXTEND ACROSS MORE THAN ONE-HALF OF THE DOOR WIDTH, MEASURED FROM THE LATCH SIDE.
- d) PANIC HARDWARE LISTED IN ACCORDANCE WITH UL 305.
- e) FIRE EXIT HARDWARE LISTED IN ACCORDANCE WITH UL 10C AND UL 305.



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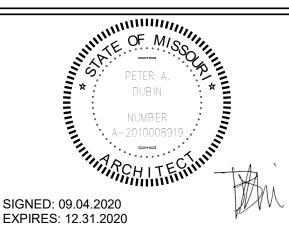
STARBUCKS TEMPLATE VERSION i2020-01-31





Phone (314) 772-1782 Fax (314) 373-3514

Engineering Consultant



EXPIRES: 12.31.2020

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PROJECT NAME:
BUILDOUT
COFFEE
RT. 291 &15

STORE #: 63039 PROJECT #: 88084-001


ISSUE DATE: 09-04-2020
SR. DESIGN MANAGER: K. GORIN-SLONSKI
PRODUCTION DESIGNER: A.MAUSER
CHECKED BY: NORR

Revision Schedule

WINDOW AND DOOR SCHEDULES & DETAILS SCALE: AS SHOWN

SHEET NUMBER:

A602

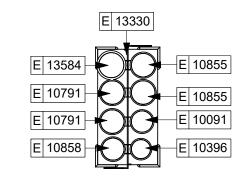

ENLARGED CUP CADDY

KEYED NOTES

FLOOR BASKETS.

- 1. INSTALL EXTERIOR FURNITURE THROUGHOUT AS SHOWN.
- 2. INSTALL CAFE FURNITURE THROUGHOUT AS SHOWN.
- 3. COMMUNITY BOARD. SEE INTERIOR FINISH ELEVATIONS.
- 4. CONDIMENT CART. SEE INTERIOR FINISH ELEVATIONS.
- 5. PLACE MERCHANDISE FIXTURES AND RETAIL FLOOR BASKETS PER PLAN. STORE OPERATORS TO ORDER RETAIL
- 6. MERCHANDISE DISPLAY. SEE DETAILS X/I50X FOR MORE INFORMATION. ALIGN FRONT OF MERCH. BAYS WITH STOREFRONT DOOR FRAME. CENTER MERCH, BAYS WITH CENTERLINE OF WALL BEHIND.
- 7. DO NOT BLOCK FOOD CASE INTAKE/EXHAUST.
- 8. SAFE LOCATED AT POS CABINET. SEE ELECTRICAL FOR ADDITIONAL INFORMATION.
- 9. HAND SINK W/ INTEGRAL SPLASH GUARD.
- 10. INSTALL CORNER GUARD AS INDICATED. SEE INTERIOR FINISH ELEVATIONS.
- 11. REFER TO ENLARGED RESTROOM PLANS AND ELEVATIONS (SHEET I401) FOR FIXTURE LOCATIONS AND MOUNTING
- 12. LOCATION OF SWITCH GEAR AND THERMOSTAT CONTROLS.
- 13. SECURE LOCKERS TO WALL.
- 14. VENDOR TO INSTALL WATER FILTRATION SYSTEM PER MANUFACTURER'S REQUIREMENTS. GC TO PROVIDE PLUMBING AND ELECTRICAL REQUIREMENTS.
- 15. WATER HEATER LOCATED ABOVE. SEE PLUMBING DRAWINGS.
- 16. MANAGERS DESK. SEE MANAGER'S DESK/EQUIPMENT RACK ELECTRICAL DETAIL FOR ADDITIONAL INFORMATION.
- 17. INSTALL PRINTER ON CABINET SHELF BELOW.

GENERAL NOTES

- A. GENERAL CONTRACTOR TO SCHEDULE WITH LOCAL REFRIGERATION CONTRACTOR TO CONDUCT INITIAL FOOD CASE START-UP AND TESTING. FOR LIST OF APPROVED START UP CONTRACTORS, CONTACT PROJECT CONSTRUCTION REPRESENTATIVE.
- B. THE SITE IS SERVED BY THE MUNICIPAL WATER AND SEWER SYSTEM UNLESS OTHERWISE NOTED.
- C. ALL FOOD STORAGE SHALL BE 6" (150mm) A.F.F.
- D. ALL WOOD SURFACES (DOORS, TRIM, SHELVES, CABINETS) SHALL BE SEALED.
- E. ALL EQUIPMENT AND INSTALLATION WILL MEET NATIONAL SANITATION FOUNDATION STANDARDS OR EQUIVALENT.
- F. ALL EQUIPMENT AND CABINETRY WILL BE FLUSH MOUNTED TO COUNTERS, WALLS OR FLOORS, OR BE RAISED TO ALLOW FOR CLEANING.
- G. CONFIRM ALL NECESSARY EQUIPMENT CLEARANCES PER PRODUCT CUT SHEET (E.G. ICE MACHINE).
- H. FOR LOCATION OF COUNTERTOP EQUIPMENT, REFER TO CASEWORK ELECTRICAL DETAILS.
- I. EQUIPMENT UNITS SHALL CONTAIN NO EXPOSED THREADS, EMBELLISHMENTS OR OVERHANGING EDGES THAT SERVE AS PLACES FOR ACCUMULATION OF DUST, DIRT AND DEBRIS.
- J. WARMING OVEN(S) SHOWN FOR PERMITTING PURPOSES. INSTALLATION AT STORE OPENING TO BE VERIFIED BY STARBUCKS CONSTRUCTION REPRESENTATIVE.
- K. EACH HAND WASHING SINK WILL HAVE A SINGLE SERVICE TOWEL AND SOAP DISPENSER, AND ALL HAND SINKS TO HAVE A COMBINATION FAUCET OR PREMIXING FAUCET.
- L. FOR PLUMBING FIXTURES, REFER TO THE PLUMBING DESIGN PLAN. FOR DATA DEVICE SCHEDULE, REFER TO THE ELECTRICAL DESIGN PLAN.
- M. SEE ELEVATIONS FOR DISTRIBUTION OF CUP DISPENSERS.
- N. PROVIDE FIRE EXTINGUISHERS AS NOTED ON THE APPROVED PLANS FROM THE LOCAL JURISDICTION.



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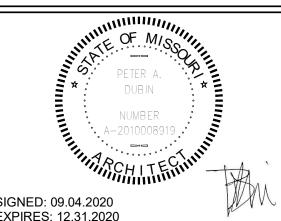
STARBUCKS TEMPLATE VERSION i2020-01-31





353 Marshall Avenue St. Louis, Missouri 63119 Phone (314) 772-1782 Fax (314) 373-3514

Engineering Consultant



SIGNED: 09.04.2020 EXPIRES: 12.31.2020

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STORE #:

ISSUE DATE

CHECKED BY:

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PROJECT NAME:
BUILDOUT
COFFEE
RT. 291 & 63039 PROJECT #: 88084-001 SR. DESIGN MANAGER: K. GORIN-SLONSKI

Revision Schedule


FF & E PLAN

PRODUCTION DESIGNER: A.MAUSER

SCALE: AS SHOWN

1101

SHEET NUMBER:

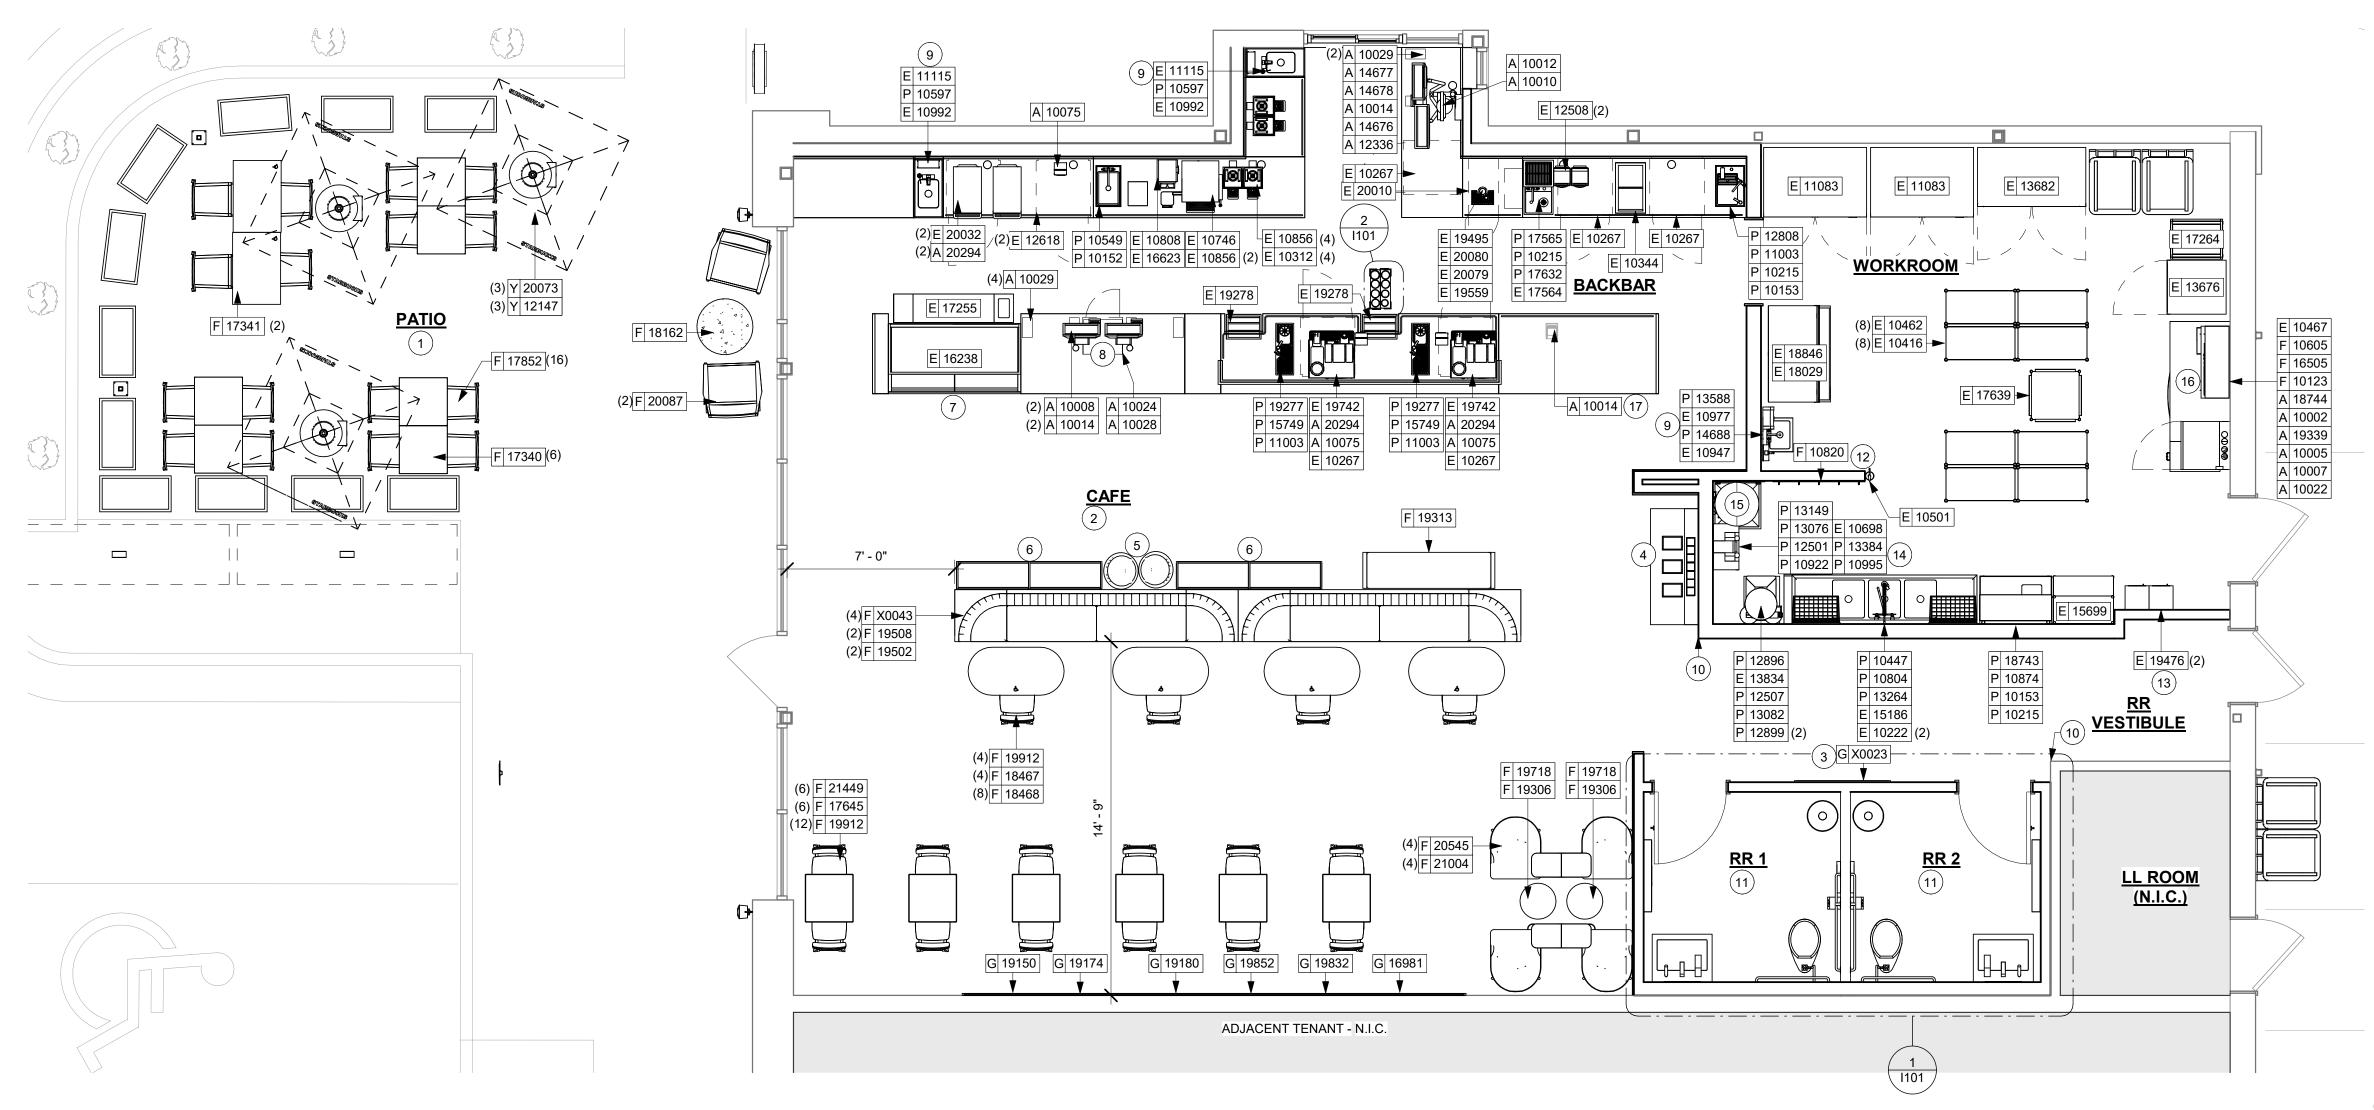

Z

FF AND E PLAN Scale: 1/4" = 1'-0"

ADJACENT TENANT - N.I.C.

LIMITED OPERATIONS FF&E

Scale: 1/4" = 1'-0"

SHOWN FOR REFERENCE ONLY

KEYED NOTES

1. FURNITURE STORAGE AREA




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STARBUCKS TEMPLATE VERSION i2020-01-31





Engineering Consultant

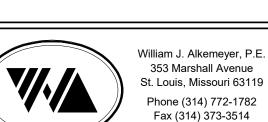

2020

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PROJECT NAME:
BUILDOUT
COFFEE
RT. 291 &15

STORE #: PROJECT #:

88084-001 ISSUE DATE: 09-04-2020
SR. DESIGN MANAGER: K. GORIN-SLONSKI
PRODUCTION DESIGNER: A.MAUSER
CHECKED BY: NORR

LIMITED OPERATIONS FF&E

SHEET NUMBER:

SCALE: AS SHOWN

I101.1

C X0013

C 20050 C 18122 C 21759

C 20062 C X0025 C 21191 C 21189

C X0041 C X0040

C X0018

3 1 C 20131

C X0001

7' - 0"

C 18122

C 17575

3' - 8"

C X0001

C X0008 ₩ ►

C 17740

4' - 0 1/2"

BACKBAR

C 20064 C 20067 C 20065 C 20063

C 20066

C 21193 C 11155 (2)

C 19281

C 17747 **→**

C 17809

C X0015

C X0046

|C|21192 | C|11142 | C|21192 | C|19281 | C|21193 |

C 19711 C 17741 C 17745 C 17740 C 17741 (2 \ 3)

C 18871 C 18872

C 17741

C 17832 C 17830 C 17744 C 17831

C X0021

21' - 0"

C 17574

C 17741

3' - 6 3/4"

C 17741 C 17741 C 17809

C X0003 C X0005 C X0047

7' - 0"

CASEWORK PLAN

Scale: 1/4" = 1'-0"

KEYED NOTES SAMPLES FOR DESIGNER APPROVAL PRIOR TO FABRICATION.

- 1. DO NOT CAULK TRASH RINGS TO COUNTERTOPS.
- 2. INSTALL CASEWORK, COUNTERTOPS, SHELVES, CUBBIES, FINISHES, TRIM AND TABLE TOPS THROUGHOUT. REFERENCE FINISH SCHEDULE AND MANUFACTURER'S SPECIFICATIONS FOR ADDITIONAL INFORMATION.
- 3. ALL COUNTERTOPS UTILIZED FOR CUSTOMER TRANSACTIONS, INCLUDING BAR, CONDIMENT AND SALES COUNTERTOPS SHALL BE INSTALLED AT 2'-10" (860 MM) MAXIMUM A.F.F.
- 4. FLOOR DRAIN BELOW. CASEWORK MANUFACTURER TO COORDINATE DESIGN TO INSURE THIS AREA IS READILY ACCESSIBLE FOR CLEANING AND FREE OF COUNTERTOP

GENERAL NOTES

- **NOTE: CASEWORK VENDOR TO PROVIDE SHOP DRAWINGS & A. GENERAL CONTRACTOR TO NOTIFY CONSTRUCTION MANAGER IMMEDIATELY IF A DISCREPANCY EXISTS BETWEEN CASEWORK SHOP DRAWINGS, EXITING SITE CONDITIONS, ARCHITECTURAL DRAWINGS OR BUILT FIXTURES. ALL DIMENSIONS SHALL BE FIELD VERIFIED BY GC PRIOR TO SHOP DRAWINGS PRODUCTION.
 - . STARBUCKS CONSTRUCTION MANAGER TO COORDINATE AND SCHEDULE CASEWORK DELIVERY DATE. GENERAL CONTRACTOR TO CONFIRM CASEWORK DELIVERY DATE WITH CASEWORK MANUFACTURER AT FOUR (4) WEEKS PRIOR AND THEN ONE (1) WEEK PRIOR TO SCHEDULED DATE OF DELIVERY.
 - C. STARBUCKS CONTRACTS DIRECTLY WITH CASEWORK VENDOR TO SUPPLY CASEWORK LISTED IN THE CASEWORK SCHEDULE, UNLESS OTHERWISE NOTED.
 - D. CASEWORK VENDOR TO PROVIDE COMPLETE SHOP DRAWINGS AND INSTALLATION PACKAGE TO GENERAL CONTRACTOR TO FACILITATE PROPER INSTALLATION.
 - E. ALL CASEWORK BOX BASE / TOE KICKS SHALL BE SET AND LEVELED USING 1/4" (6 MM) NON-ABSORBENT PLASTIC SHIMS PROVIDED BY CASEWORK VENDOR.
 - F. SEE INTERIOR FINISH ELEVATIONS AND SCHEDULES FOR LOCATION AND TAGGING OF WALL TREATMENTS BY CV
 - G. SEE REFLECTED CEILING PLAN FOR CASEWORK SOFFIT LOCATIONS.
 - H. REFERENCE PLUMBING AND ELECTRICAL PLANS FOR PLACEMENT OF ELECTRICAL, DATA AND PLUMBING ON FRONT AND BACKLINE OF BAR.

I. PROVIDE ACCENT LIGHTING AT FRONT EDGE OF BAR. SEE INTERIOR ELEVATIONS AND ELECTRICAL FOR ADDITIONAL INFORMATION.

J. CASEWORK VENDOR TO ENGINEER PROPER COUNTERTOP SUPPORT AT ESPRESSO BAR AND OTHER WORKSTATIONS PER STARBUCKS MINIMUM PERFORMANCE REQUIREMENTS.

LEGEND

INDICATES STAINLESS STEEL (SST) COUNTERTOP

INDICATES SOLID SURFACE (SS) COUNTERTOP



INDICATES WOOD CLADDING FINISH: WD0073 MAD200-V

---- INDICATES WOOD CLADDING FINISH: WD0073 MAD100-V



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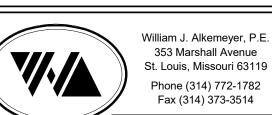
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TO CHANGE AT ANYTIME) AND DO NOT REFLECT ACTUAL SITE CONDITIONS. NEITHER PARTY SHALL HAVE ANY OBLIGATION





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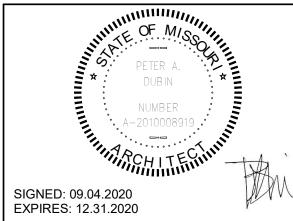
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Engineering Consultant



PROJECT NAM BUILDO COFFEE RT. 291

STORE #: PROJECT #: ISSUE DATE: 09-04-2020
SR. DESIGN MANAGER: K. GORIN-SLONSKI
PRODUCTION DESIGNER: A.MAUSER

CASEWORK PLAN SCALE: AS SHOWN

SHEET NUMBER:

CHECKED BY:

I102

**NOTE: CASEWORK VENDOR TO PROVIDE SHOP DRAWINGS & A. GENERAL CONTRACTOR TO NOTIFY CONSTRUCTION SAMPLES FOR DESIGNER APPROVAL PRIOR TO FABRICATION.

GENERAL NOTES

- MANAGER IMMEDIATELY IF A DISCREPANCY EXISTS BETWEEN CASEWORK SHOP DRAWINGS, EXITING SITE CONDITIONS, ARCHITECTURAL DRAWINGS OR BUILT FIXTURES. ALL DIMENSIONS SHALL BE FIELD VERIFIED BY GC PRIOR TO SHOP DRAWINGS PRODUCTION.
- B. STARBUCKS CONSTRUCTION MANAGER TO COORDINATE AND SCHEDULE CASEWORK DELIVERY DATE. GENERAL CONTRACTOR TO CONFIRM CASEWORK DELIVERY DATE WITH CASEWORK MANUFACTURER AT FOUR (4) WEEKS PRIOR AND THEN ONE (1) WEEK PRIOR TO SCHEDULED DATE OF DELIVERY.
- C. STARBUCKS CONTRACTS DIRECTLY WITH CASEWORK VENDOR TO SUPPLY CASEWORK LISTED IN THE CASEWORK SCHEDULE, UNLESS OTHERWISE NOTED.
- D. CASEWORK VENDOR TO PROVIDE COMPLETE SHOP DRAWINGS AND INSTALLATION PACKAGE TO GENERAL CONTRACTOR TO FACILITATE PROPER INSTALLATION.
- E. ALL CASEWORK BOX BASE / TOE KICKS SHALL BE SET AND LEVELED USING 1/4" (6 MM) NON-ABSORBENT PLASTIC SHIMS PROVIDED BY CASEWORK VENDOR.
- F. SEE INTERIOR FINISH ELEVATIONS AND SCHEDULES FOR LOCATION AND TAGGING OF WALL TREATMENTS BY CV AND OTHERS.
- G. SEE REFLECTED CEILING PLAN FOR CASEWORK SOFFIT LOCATIONS.
- H. REFERENCE PLUMBING AND ELECTRICAL PLANS FOR PLACEMENT OF ELECTRICAL, DATA AND PLUMBING ON FRONT AND BACKLINE OF BAR.
- I. PROVIDE ACCENT LIGHTING AT FRONT EDGE OF BAR. SEE INTERIOR ELEVATIONS AND ELECTRICAL FOR ADDITIONAL INFORMATION.
- J. CASEWORK VENDOR TO ENGINEER PROPER COUNTERTOP SUPPORT AT ESPRESSO BAR AND OTHER WORKSTATIONS PER STARBUCKS MINIMUM PERFORMANCE REQUIREMENTS.

LEGEND

INDICATES STAINLESS STEEL (SST) COUNTERTOP

INDICATES SOLID SURFACE (SS) COUNTERTOP

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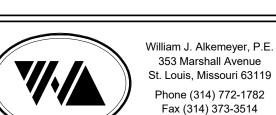
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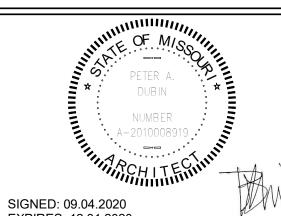
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Engineering Consultant



EXPIRES: 12.31.2020

BUILDOUT
COFFEE
RT. 291 &15


STORE #: 63039 PROJECT #: 88084-001 ISSUE DATE: 09-04-2020 SR. DESIGN MANAGER: K. GORIN-SLONSKI PRODUCTION DESIGNER: A.MAUSER


CHECKED BY: **Revision Schedule**

CASEWORK PLAN

SCALE: AS SHOWN SHEET NUMBER:

1102.1

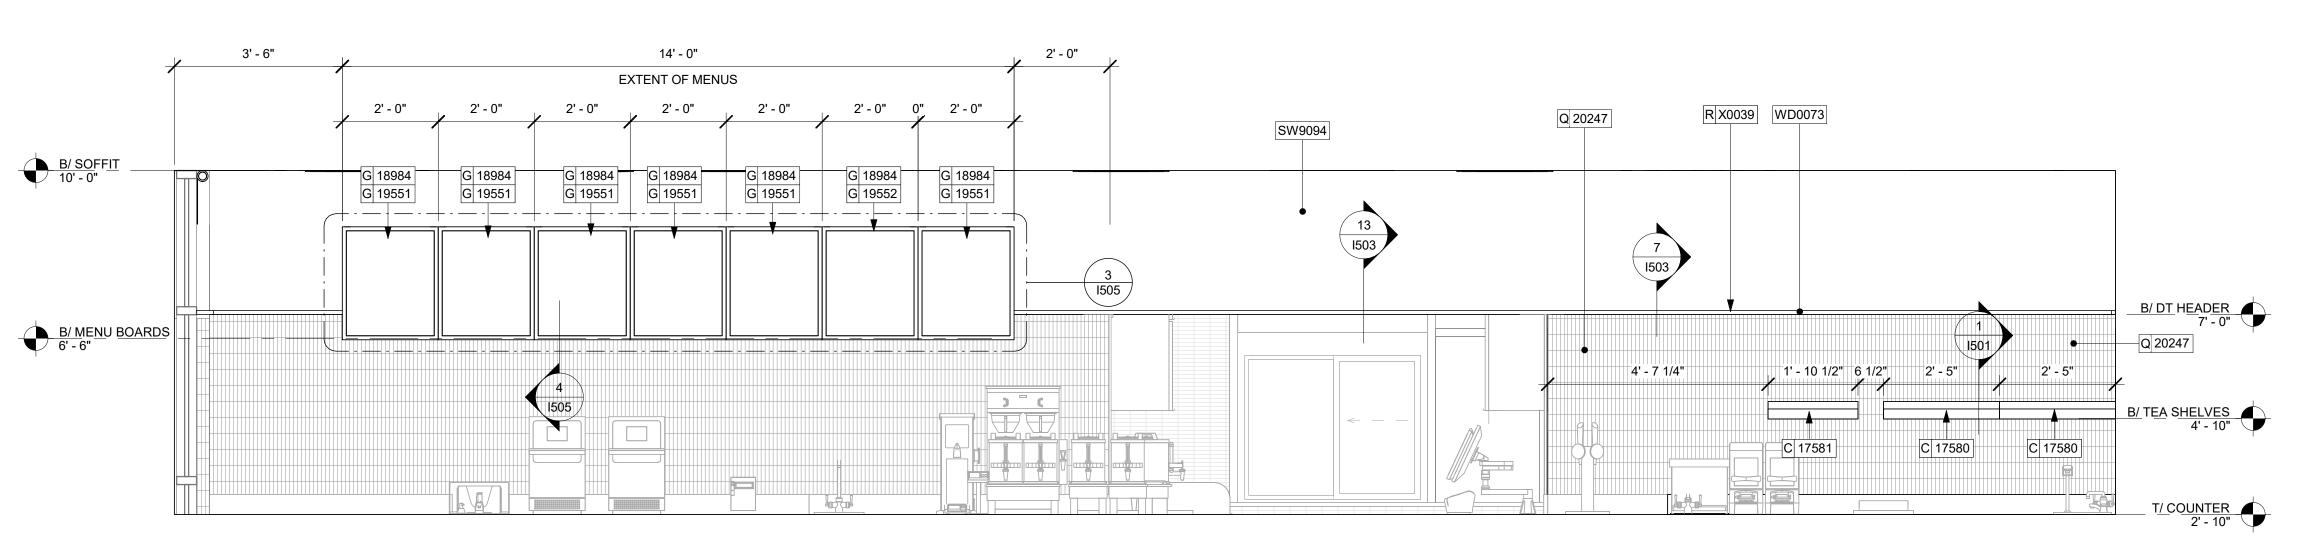


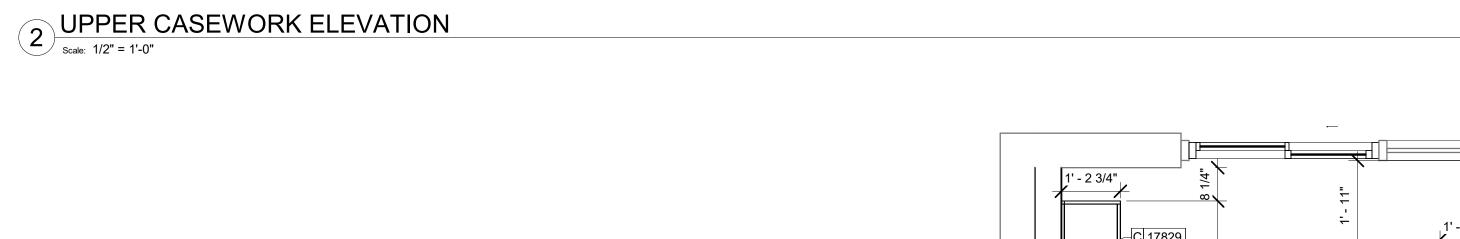

CX0017 & C 17829 3 (1502.1) C X0006 G 18984 G 19551 G 18984 G 19551 G 18984 G 19551 G 18984 G 19552 G 18984 G 19551 G 18984 G 19551 G 18984 G 19551 C 17580 C 17580 C 17581 (1102.1) 4' - 7 1/4" 1' - 10 1/2"

1 UPPER CASEWORK PLAN

Scale: 1/2" = 1'-0"

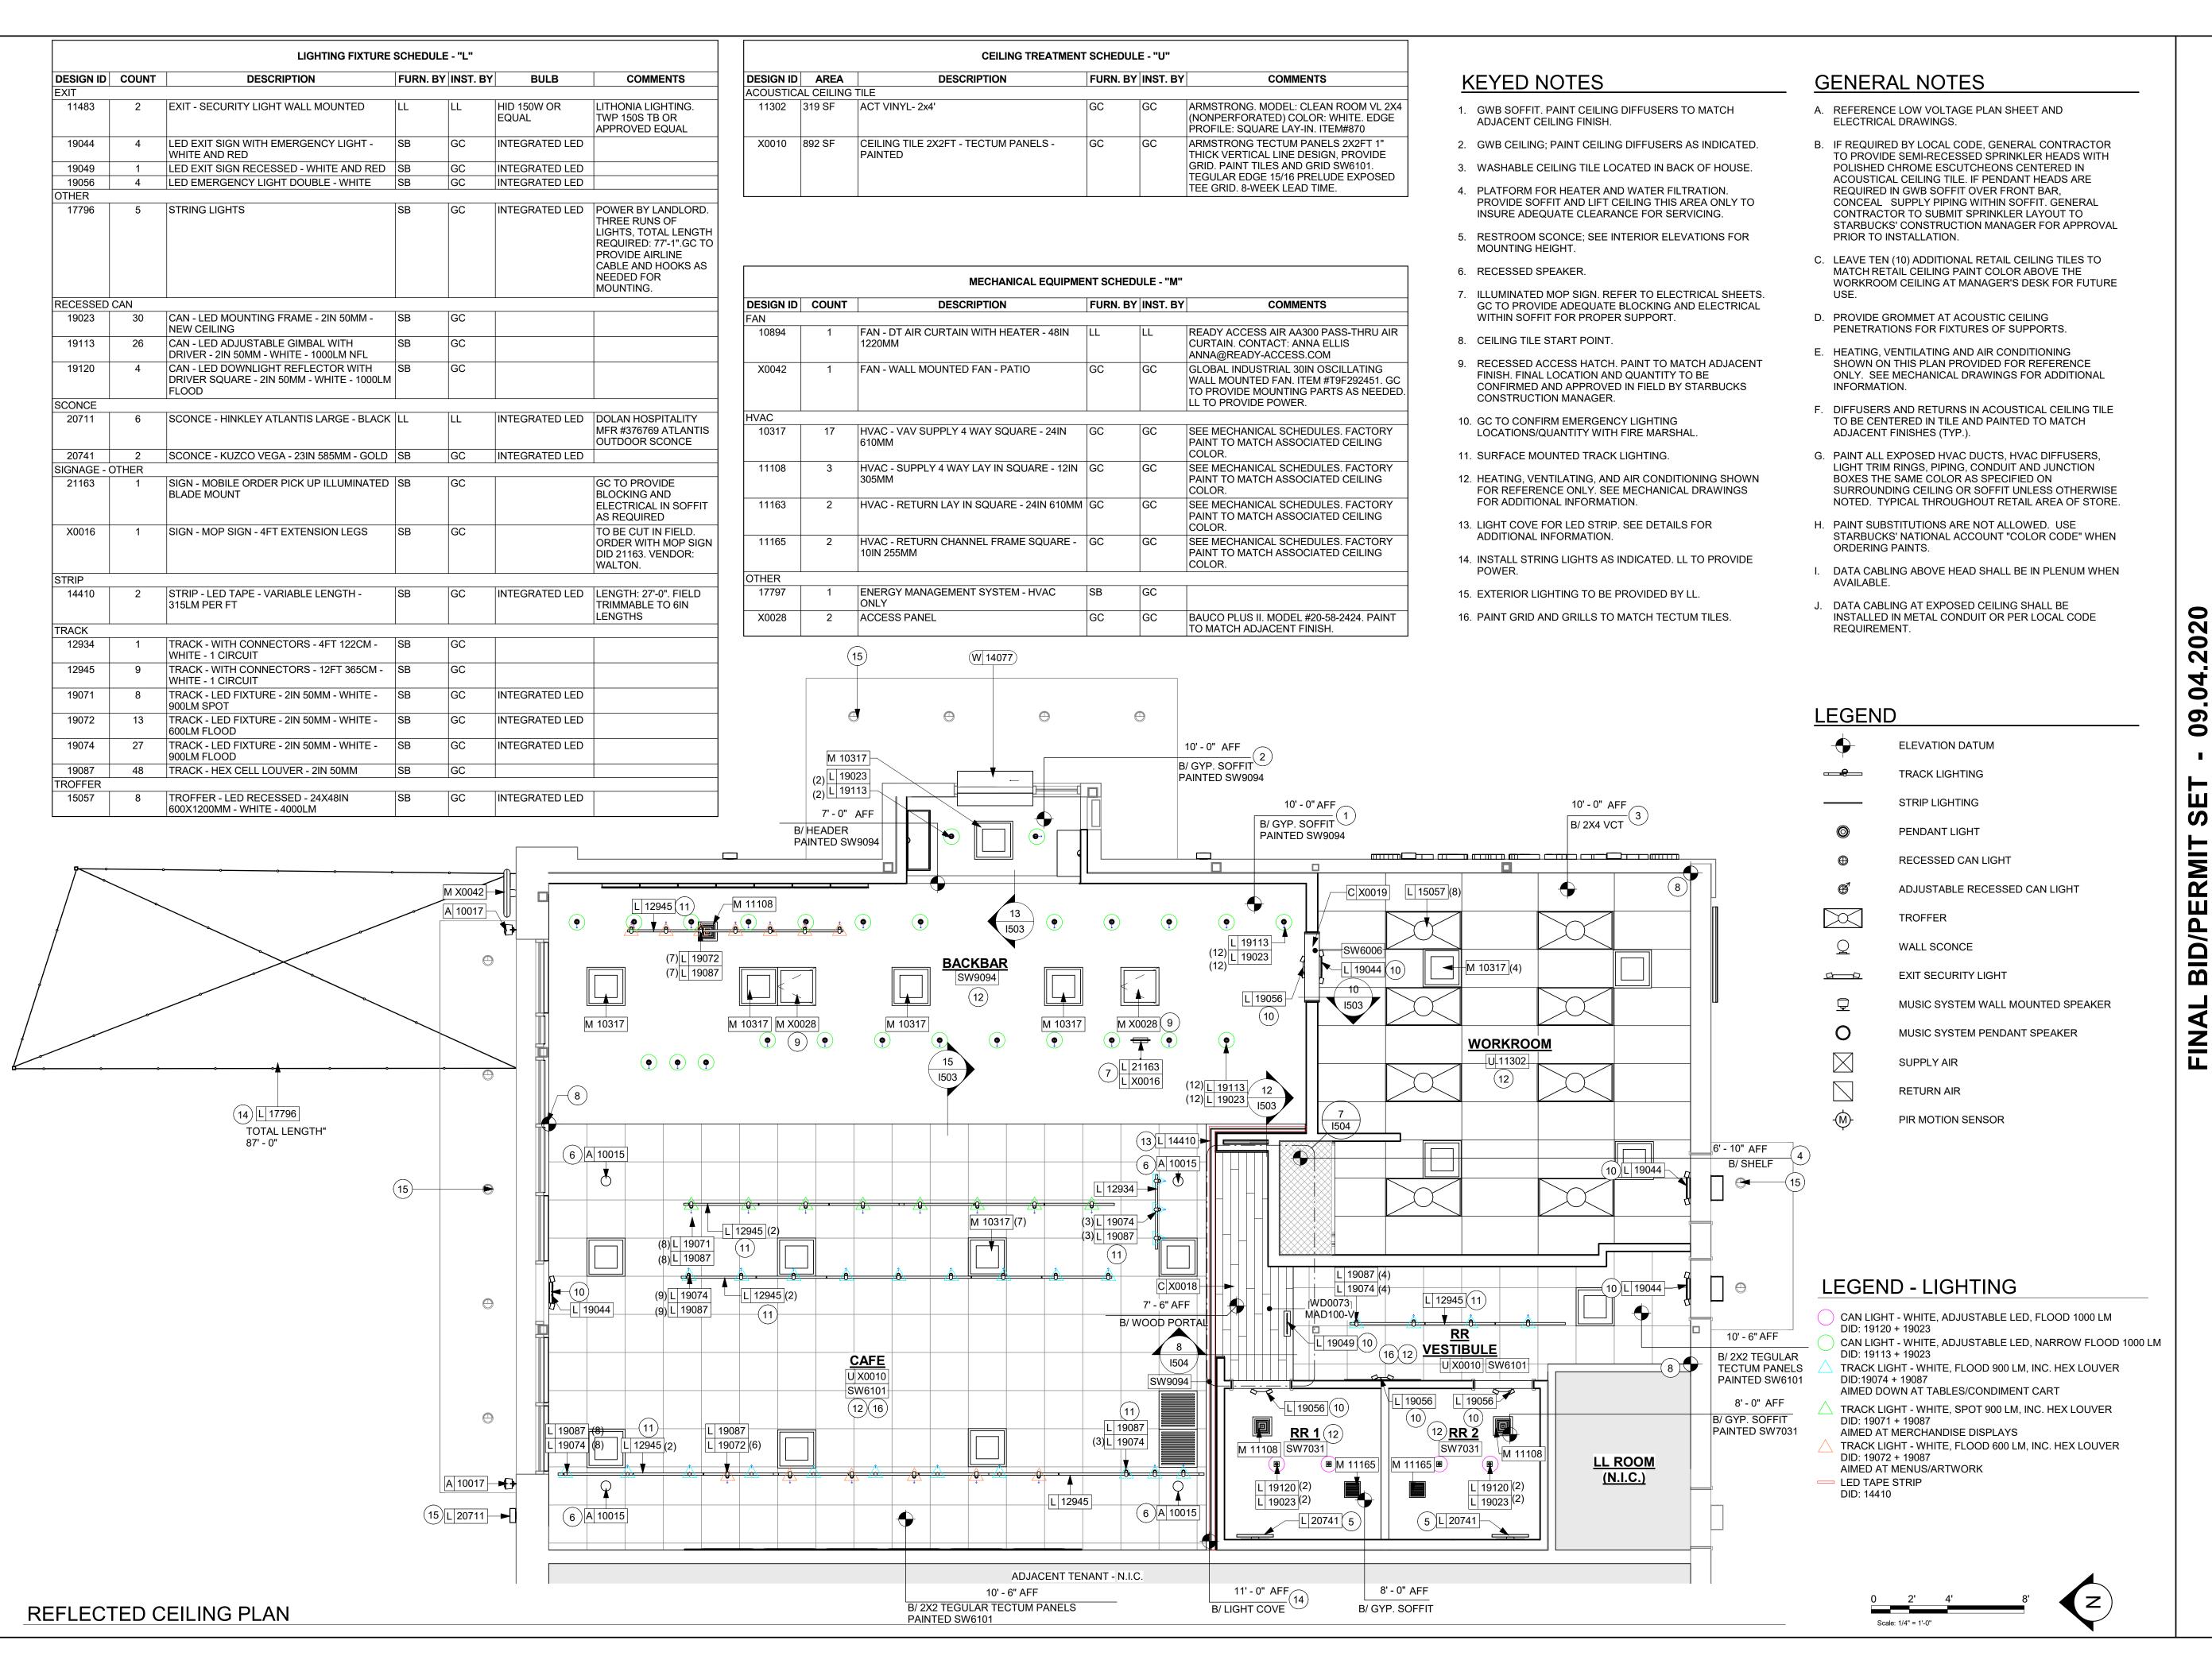

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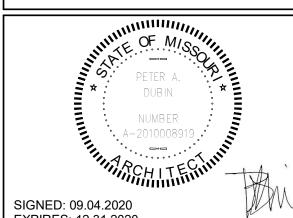


STARBUCKS TEMPLATE VERSION i2020-01-31



William J. Alkemeyer, P.E 353 Marshall Avenue St. Louis, Missouri 63119 Phone (314) 772-1782 Fax (314) 373-3514

Engineering Consultant



EXPIRES: 12.31.2020

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STORE #: 63039 PROJECT #: 88084-001

ISSUE DATE 09-04-2020 SR. DESIGN MANAGER: K. GORIN-SLONSKI PRODUCTION DESIGNER: A.MAUSER CHECKED BY: NORR

Revision Schedule

Rev Date Description SHEET TITLE:

REFLECTED CEILING PLAN SCALE: AS SHOWN

SHEET NUMBER:

I103

- 1. CENTER SCONCE ABOVE SINK BELOW.
- 2. CENTER LIGHT ABOVE TABLE BELOW.
- 3. CENTER EM SIGN/LIGHT ABOVE DOOR.
- 4. ALIGN HEADER WITH SIDE OF DOOR FRAME. SEE INTERIOR ELEVATIONS.




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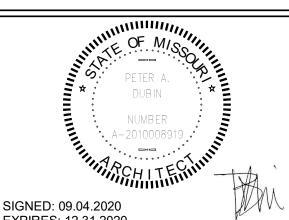
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STARBUCKS TEMPLATE VERSION i2020-01-31





Engineering Consultant

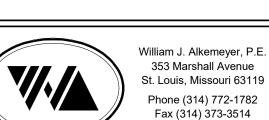

EXPIRES: 12.31.2020

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BUILDOI COFFEE RT. 291

STORE #: 63039 PROJECT #: 88084-001 ISSUE DATE: 09-04-2020 SR. DESIGN MANAGER: K. GORIN-SLONSKI PRODUCTION DESIGNER: A.MAUSER CHECKED BY: NORR

Revision Schedule

Rev Date By Description

DIMENSIONED RCP W/ UNDERLAY SCALE: AS SHOWN

SHEET NUMBER:

I103.1

LEGEND - LIGHTING

CAN LIGHT - WHITE, ADJUSTABLE LED, FLOOD 1000 LM

CAN LIGHT - WHITE, ADJUSTABLE LED, NARROW FLOOD 1000 LM DID: 19113 + 19023

TRACK LIGHT - WHITE, FLOOD 900 LM, INC. HEX LOUVER

DID:19074 + 19087 AIMED DOWN AT TABLES/CONDIMENT CART

TRACK LIGHT - WHITE, SPOT 900 LM, INC. HEX LOUVER DID: 19071 + 19087

AIMED AT MERCHANDISE DISPLAYS

TRACK LIGHT - WHITE, FLOOD 600 LM, INC. HEX LOUVER DID: 19072 + 19087

AIMED AT MENUS/ARTWORK

LED TAPE STRIP

	FLOOR TREATMENT SCHEDULE - "T"						
DESIGN ID	AREA	DESCRIPTION	FURN. BY	INST. BY	COMMENTS		
PLASTIC			-	•			
19795	844 SF	POLYVINYL FLOOR TILE - ECO-GRIP - PEWTER	GC	GC	MANUFACTURER: ALLIED ECO-GRIP. PEWTER		
TILE	•		•	•			
20255	1287 SF	TILE - VENICE VILLA - GRAPHITE - 24X24IN 600X600MM	SB	GC	GROUT: MAPEI - 47 CHARCOAL, OR EQUAL		
WALK OFF	MAT		•				
19288	21 SF	WALK OFF MAT - HELIX Z1 - BLACK - 12X9IN 305X230MM	SB	GC	ORDER WITH METAL FRAME FROM VENDOR		

WALL BASE SCHEDULE - "B"						
DESIGN ID	LENGTH	DESCRIPTION	FURN. BY	INST. BY	COMMENTS	
METAL BASE						
X0020	57' - 5 1/4"	METAL BASE - SCHULTER DILEX-AHK COVE	GC	GC	FINISH: SATIN NICKEL. SCHLUTER DILEX-AHK COVE	
TILE BASE			•			
19795	182' - 11 1/2"	POLYVINYL FLOOR TILE - ECOGRIP - PEWTER	GC	GC	MANUFACTURER: ALLIED ECO-GRIP. PEWTER	
20215	144' - 0 1/2"	TILE BASE - FORMULA - UNION BLACK - 6X12IN 150X300MM	SB	GC	GROUT: MAPEI - 47 CHARCOAL, OR EQUAL	

- 1. TILE START POINT WHERE INDICATED.
- 2. MOP SINK WHERE INDICATED. SEE PLUMBING PLANS FOR MORE INFORMATION.
- 3. FLOOR SINK/DRAIN LOCATION. SEE BUILDING FLOOR PENETRATION PLAN ON SHEET A102 AND PLUMBING FOR ADDITIONAL INFORMATION.
- 4. ELECTRICAL STUB-UP LOCATION. SEE BUILDING FLOOR PENETRATION PLAN ON SHEET A102 AND ELECTRICAL FOR ADDITIONAL INFORMATION.
- 5. RECESSED WALK-OFF MAT AT ENTRY, SEE INTERIOR DETAIL SHEETS FOR TRANSITION.
- 6. ELECTRICAL FLOOR OUTLET FOR BANQUETTE. REFER TO ELECTRICAL SHEETS AND CUTSHEETS FOR MORE INFORMATION.

GENERAL NOTES

- A. WORKROOM TO BE FINISHED PER LOCAL CODE REQUIREMENTS.
- B. FLOORS, WALLS AND CEILING FINISHES IN FOOD PREPARATION AREAS SHALL BE SMOOTH, NON-TOXIC, NON-ABSORBENT, DURABLE AND EASILY CLEANABLE. PAINT SHALL BE WASHABLE; SEMI-GLOSS OR HIGH-GLOSS FINISH.
- C. STARBUCKS TO SUPPLY FLOORING AND BASE FOR FRONT AND BACK OF HOUSE AS NOTED IN SCHEDULES. GENERAL CONTRACTOR TO INSTALL. GENERAL CONTRACTOR TO SUPPLY WORKROOM TILE AND BASE AND INSTALL. GENERAL CONTRACTOR TO SUPPLY AND INSTALL MORTAR, ADHESIVE, AND GROUT, GENERAL CONTRACTOR TO INSPECT ALL TILES AND REJECT DAMAGED OR SUBSTANDARD TILES PRIOR TO INSTALLATION.
- D. ALIGN TILE TRANSITIONS ON WHOLE TILES AS SHOWN.
- E. ALL FLOOR AND WALL JUNCTIONS IN STORAGE AND FOOD PREPARATION AREAS SHALL HAVE A 6" COVED




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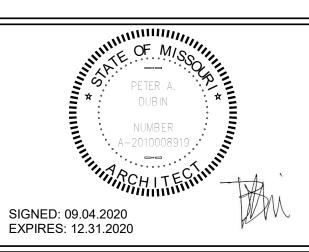
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STARBUCKS TEMPLATE VERSION i2020-01-31





Engineering Consultant

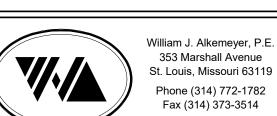

FLOOR FINISH LEGEND

TILE BASE - UNION BLACK 6IN X 12IN DID:20215 GROUT: MAPEI 47 - — POLYVINYL BASE - ECOGRIP - PEWTER

— - — SCHLUTER COVE BASE DID: X0020

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BUILDO COFFEE RT. 291


STORE #: 63039 PROJECT #: 88084-001 SR. DESIGN MANAGER: K. GORIN-SLONSKI PRODUCTION DESIGNER: A.MAUSER CHECKED BY: NORR

FLOOR FINISH PLAN

SCALE: AS SHOWN


SHEET NUMBER:


I104

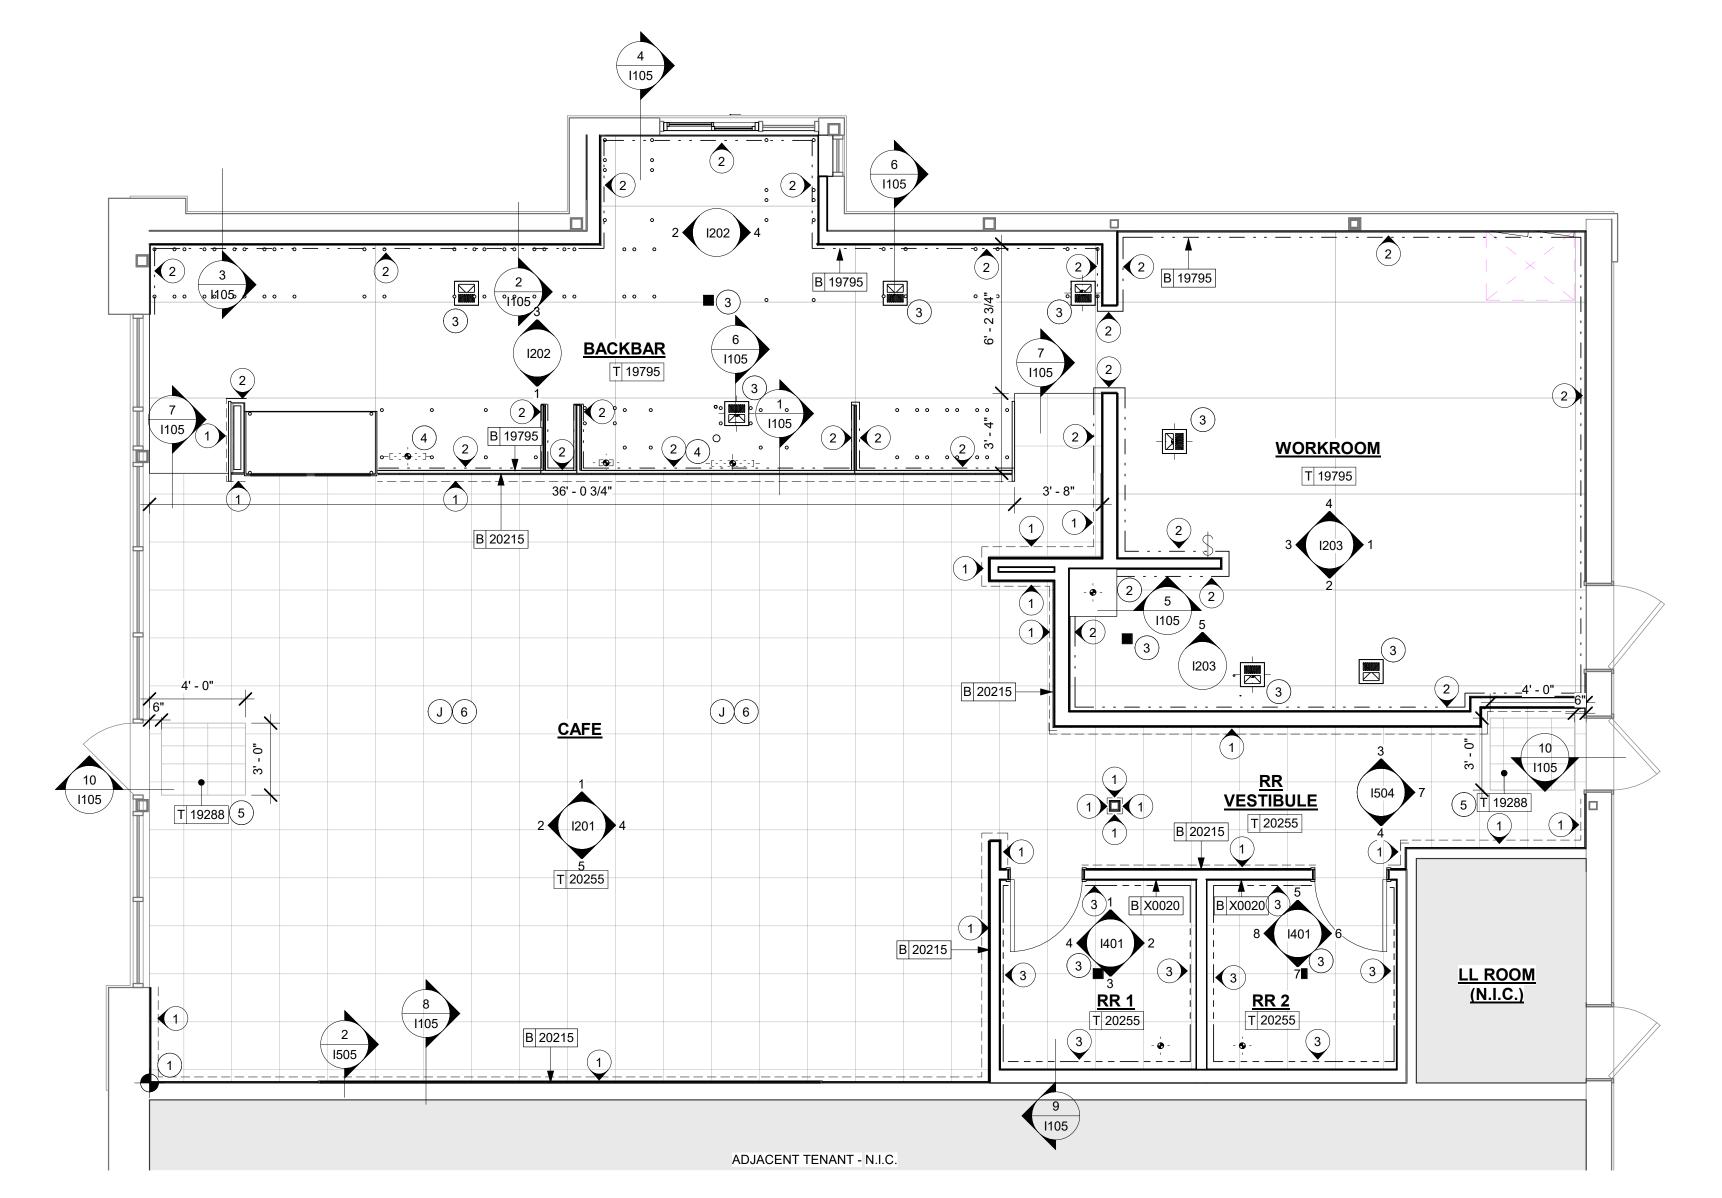

FLOOR FINISH PLAN

Scale: 1/4" = 1'-0"

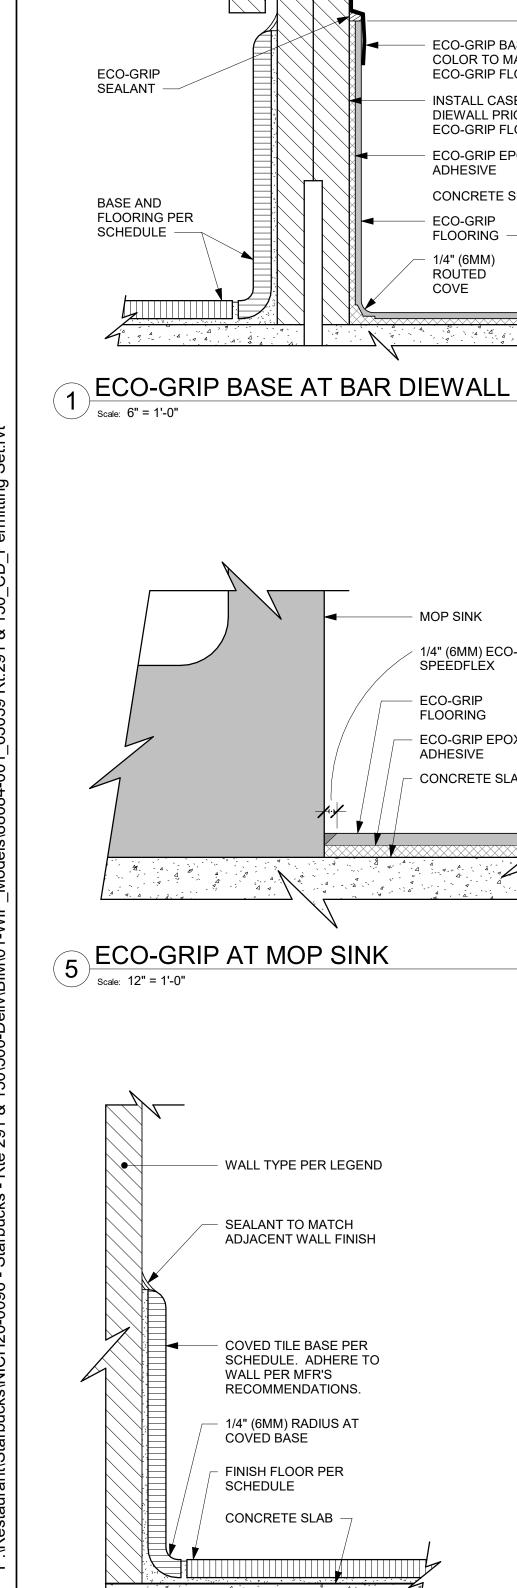

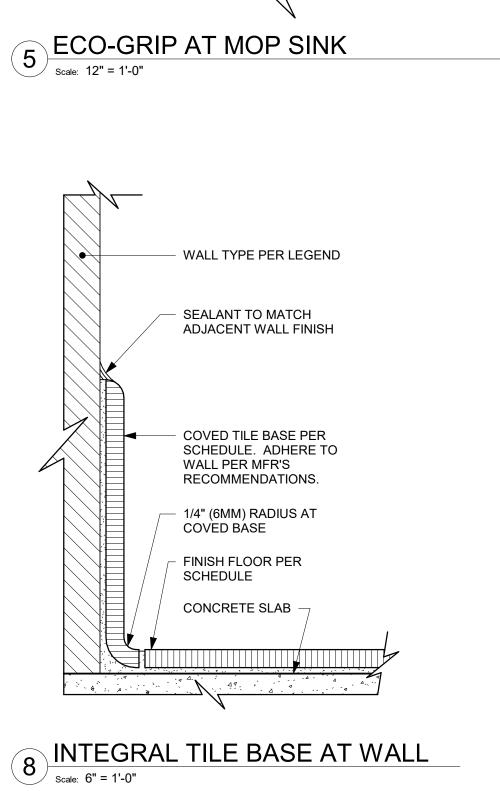

BAR

BAR DIEWALL

STAINLESS STAPLE

STEEL FASTENER

ECO-GRIP BASE CAP.

ECO-GRIP FLOORING

INSTALL CASEWORK DIEWALL PRIOR TO

ECO-GRIP FLOORING

ECO-GRIP EPOXY

CONCRETE SLAB

ADHESIVE

ECO-GRIP

FLOORING

1/4" (6MM)

4 4 4

ROUTED

COVE

MOP SINK

SPEEDFLEX

ECO-GRIP

FLOORING

 ECO-GRIP EPOXY ADHESIVE

CONCRETE SLAB

1/4" (6MM) ECO-GRIP

COLOR TO MATCH

OR POWDER COATED

CAFE

BAR FINISH

ECO-GRIP

SEALANT


BASE AND


SCHEDULE


Scale: 6" = 1'-0"

FLOORING PER


PANEL

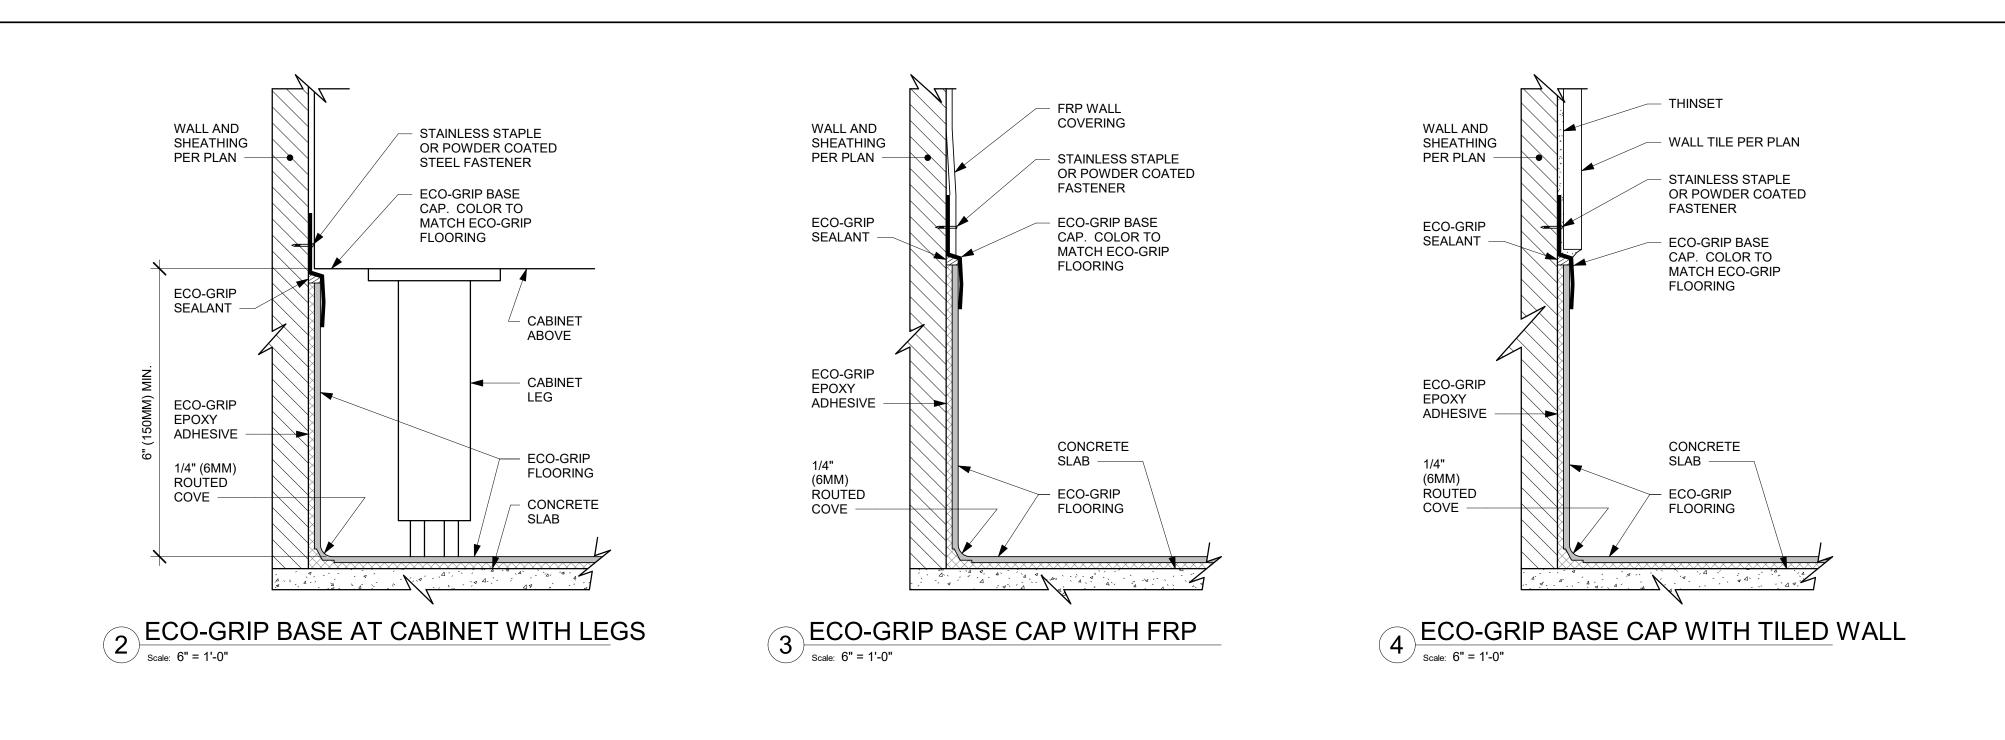


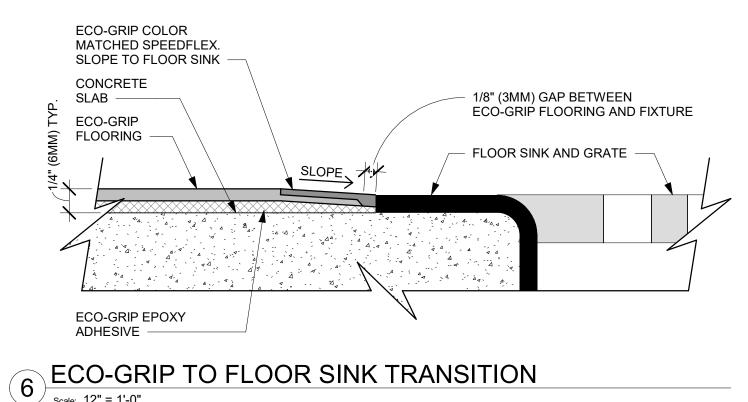

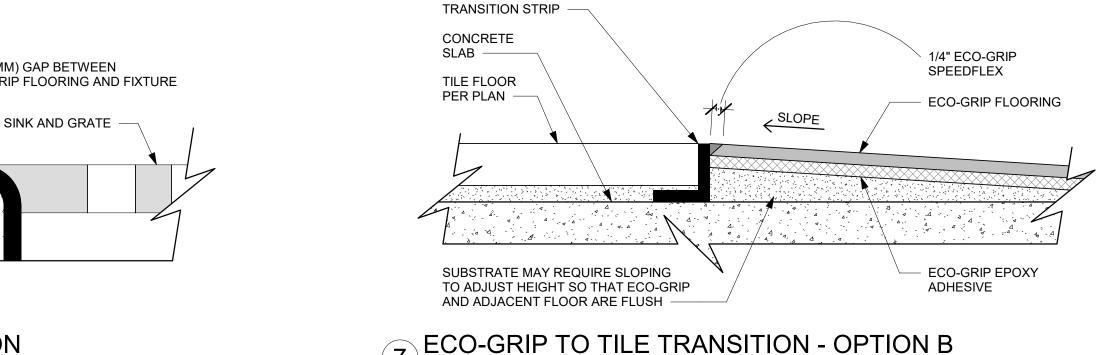

SCHLUTER

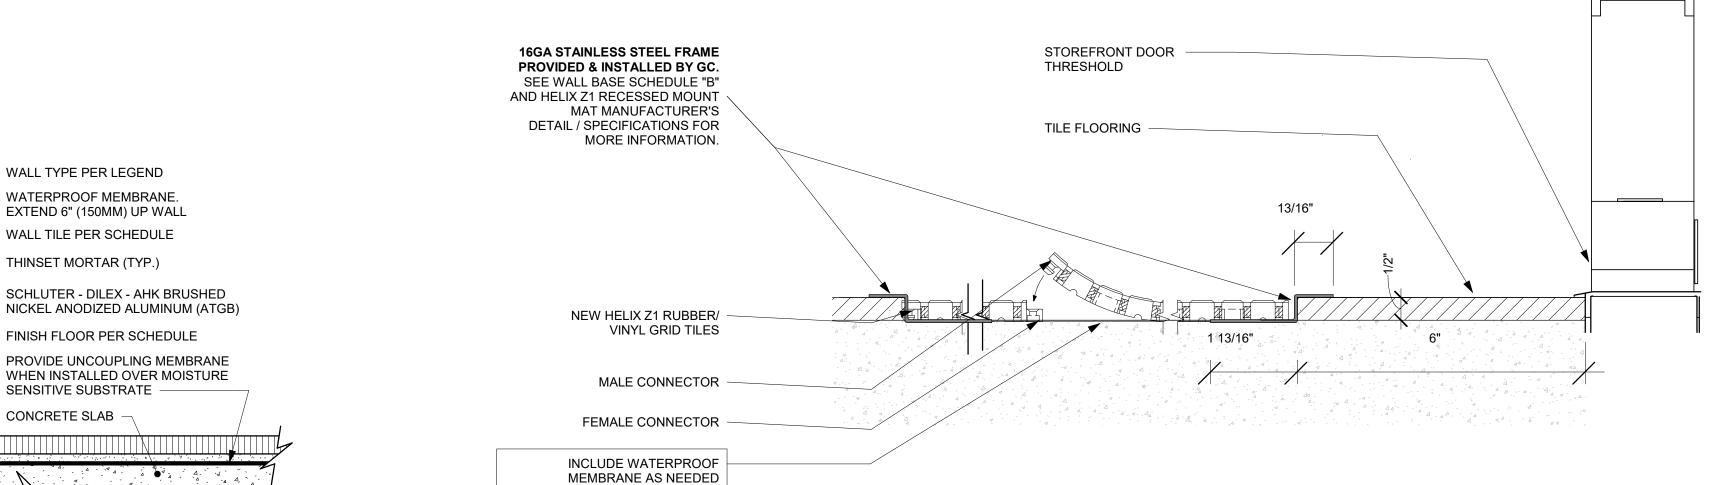

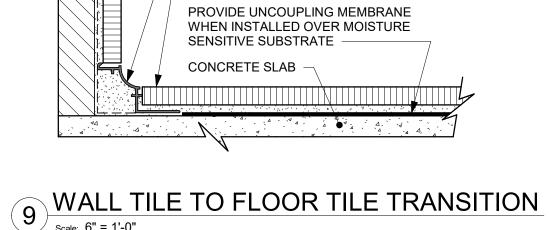

Scale: 6" = 1'-0"

WALL TYPE PER LEGEND WATERPROOF MEMBRANE.

EXTEND 6" (150MM) UP WALL

WALL TILE PER SCHEDULE

FINISH FLOOR PER SCHEDULE

THINSET MORTAR (TYP.)

TRANSITION - TILE FLOOR TO HELIX Z1 RECESSED TILES

| Scale: 6" = 1'-0"

0 0 N 0 60 S **BID/PER** FINAL

SIGNED: 09.04.2020 EXPIRES: 12.31.2020

3 / STE. 64082 $\overline{}$ BUIL COF

STORE #:

ISSUE DATE:

PROJECT #:

SCALE: AS SHOWN

SHEET NUMBER:

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NORR

Engineering Consultant

William J. Alkemeyer, P.E 353 Marshall Avenue

St. Louis, Missouri 63119 Phone (314) 772-1782

Fax (314) 373-3514

PRODUCTION DESIGNER: A.MAUSER CHECKED BY: NORR **Revision Schedule** Rev Date Description SHEET TITLE: FINISH DETAILS


SR. DESIGN MANAGER: K. GORIN-SLONSKI

63039

88084-001

09-04-2020

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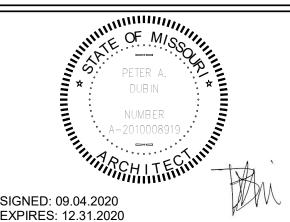
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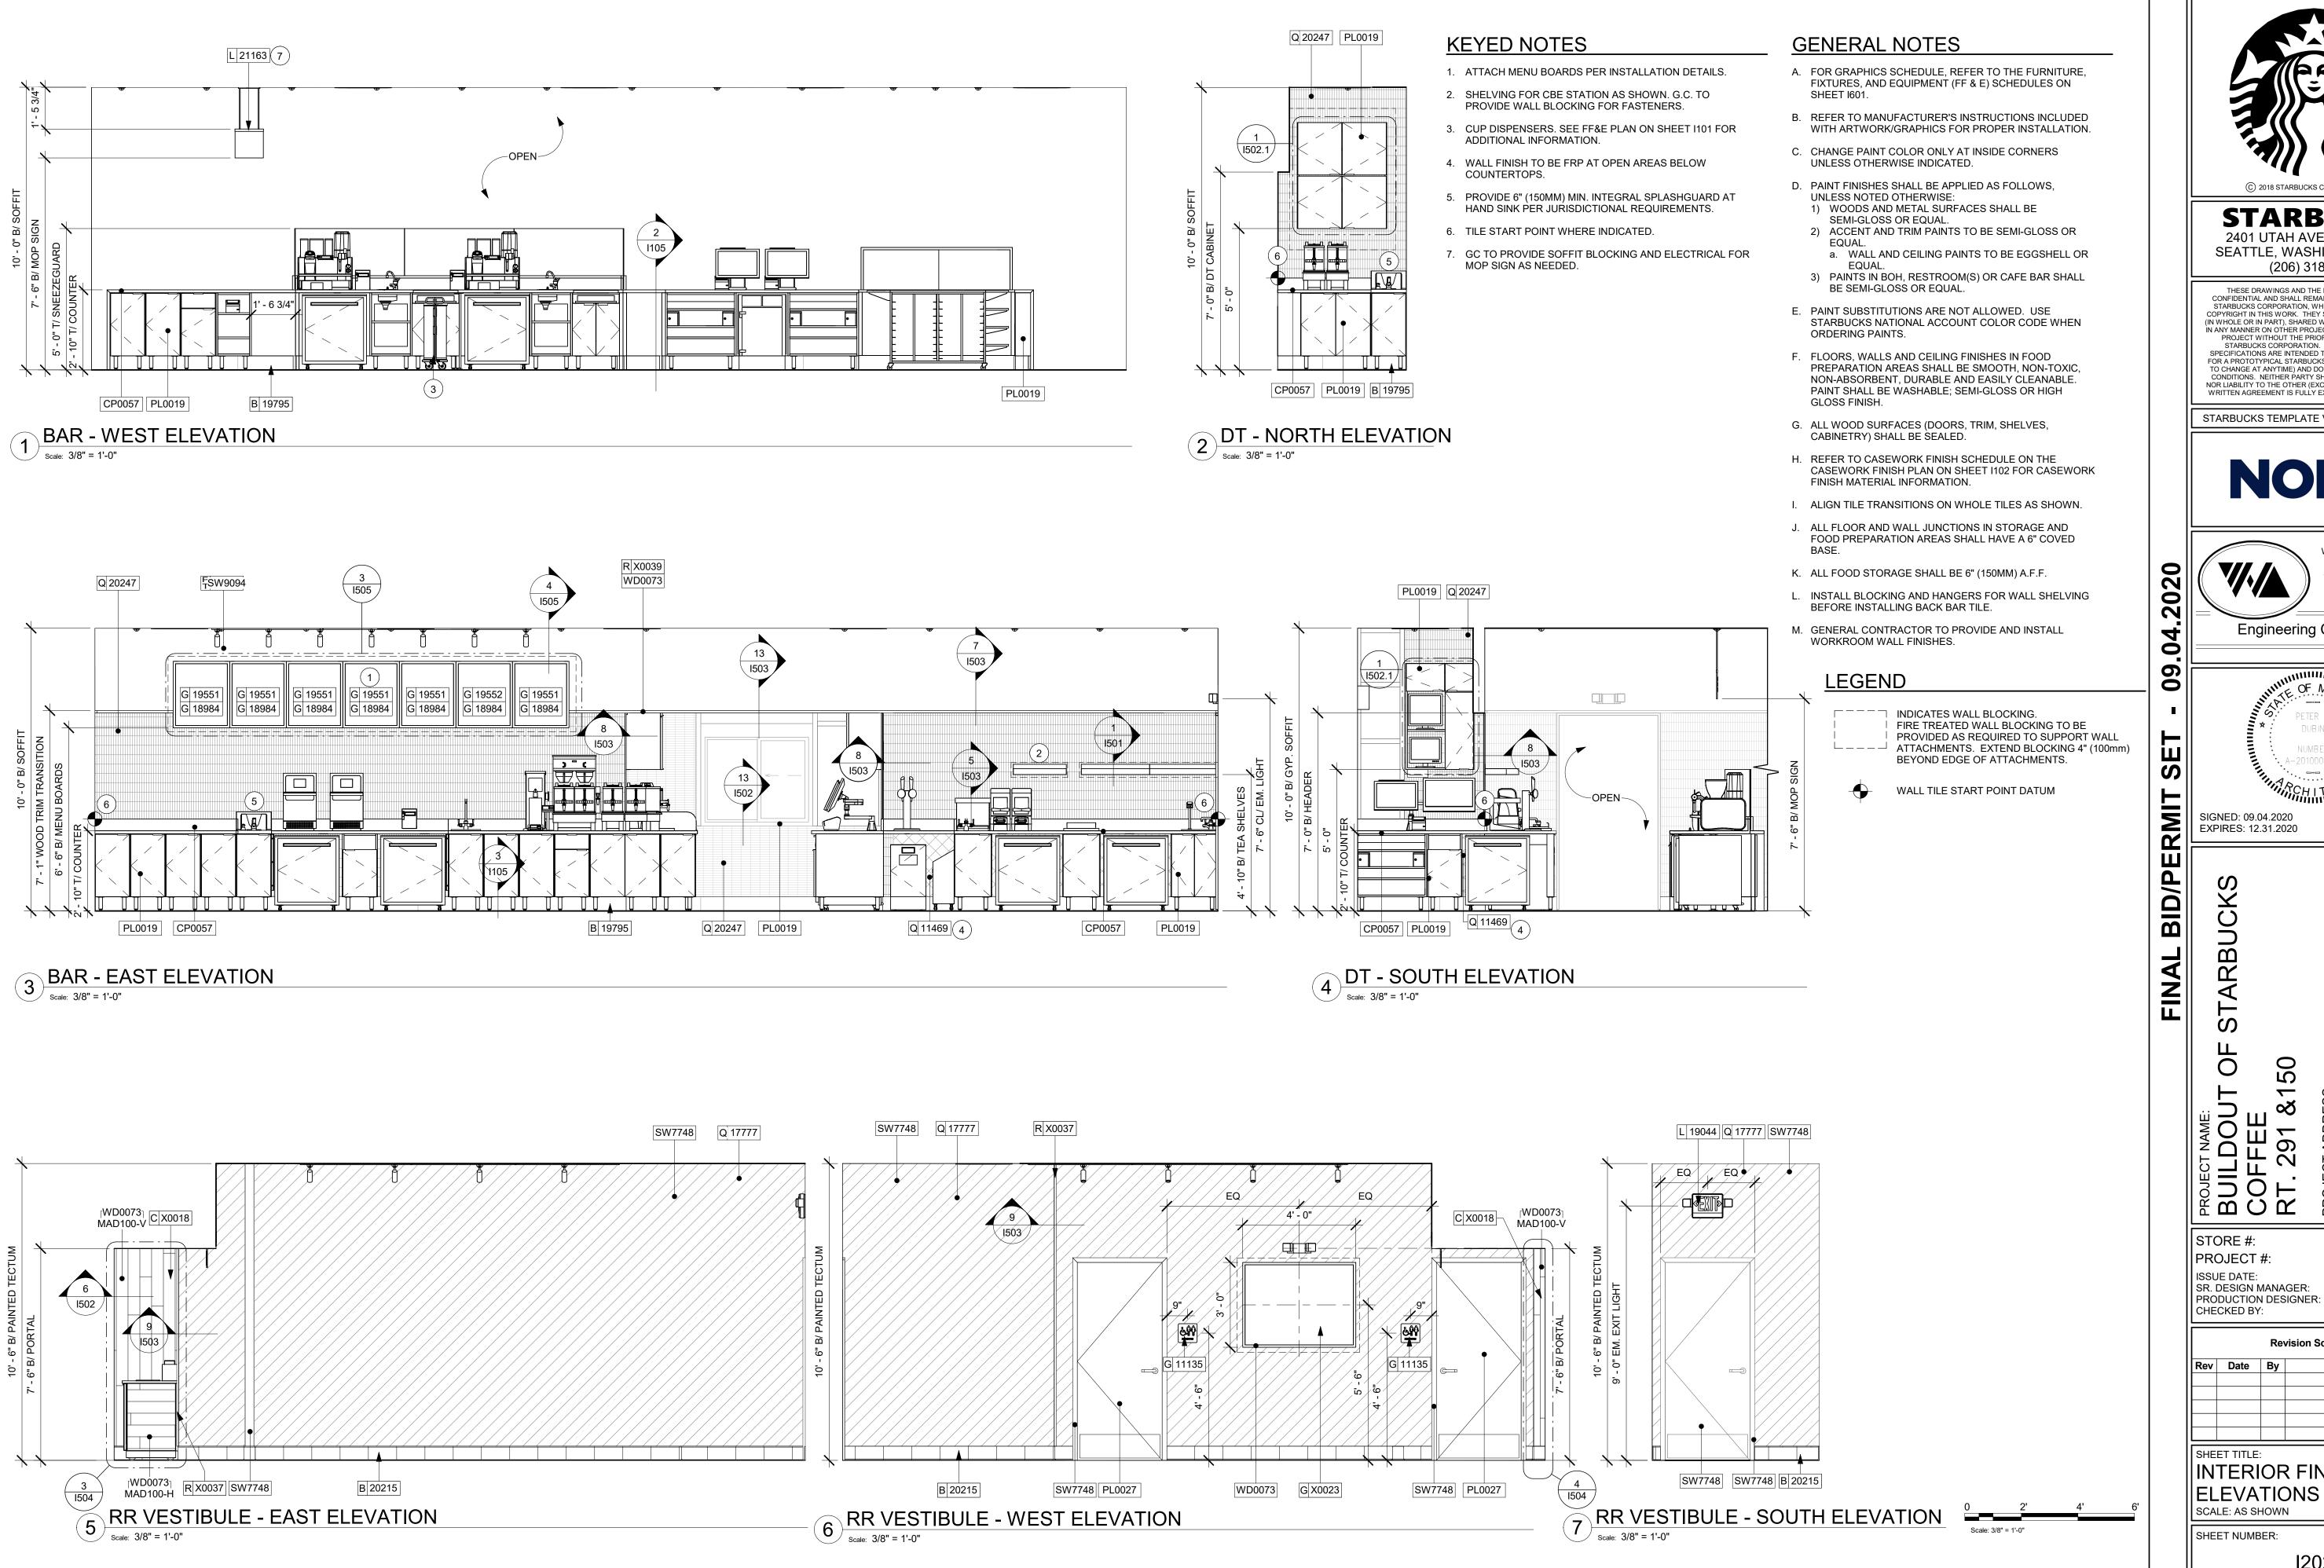
BUILDOUT
COFFEE
RT. 291 &1 STORE #:

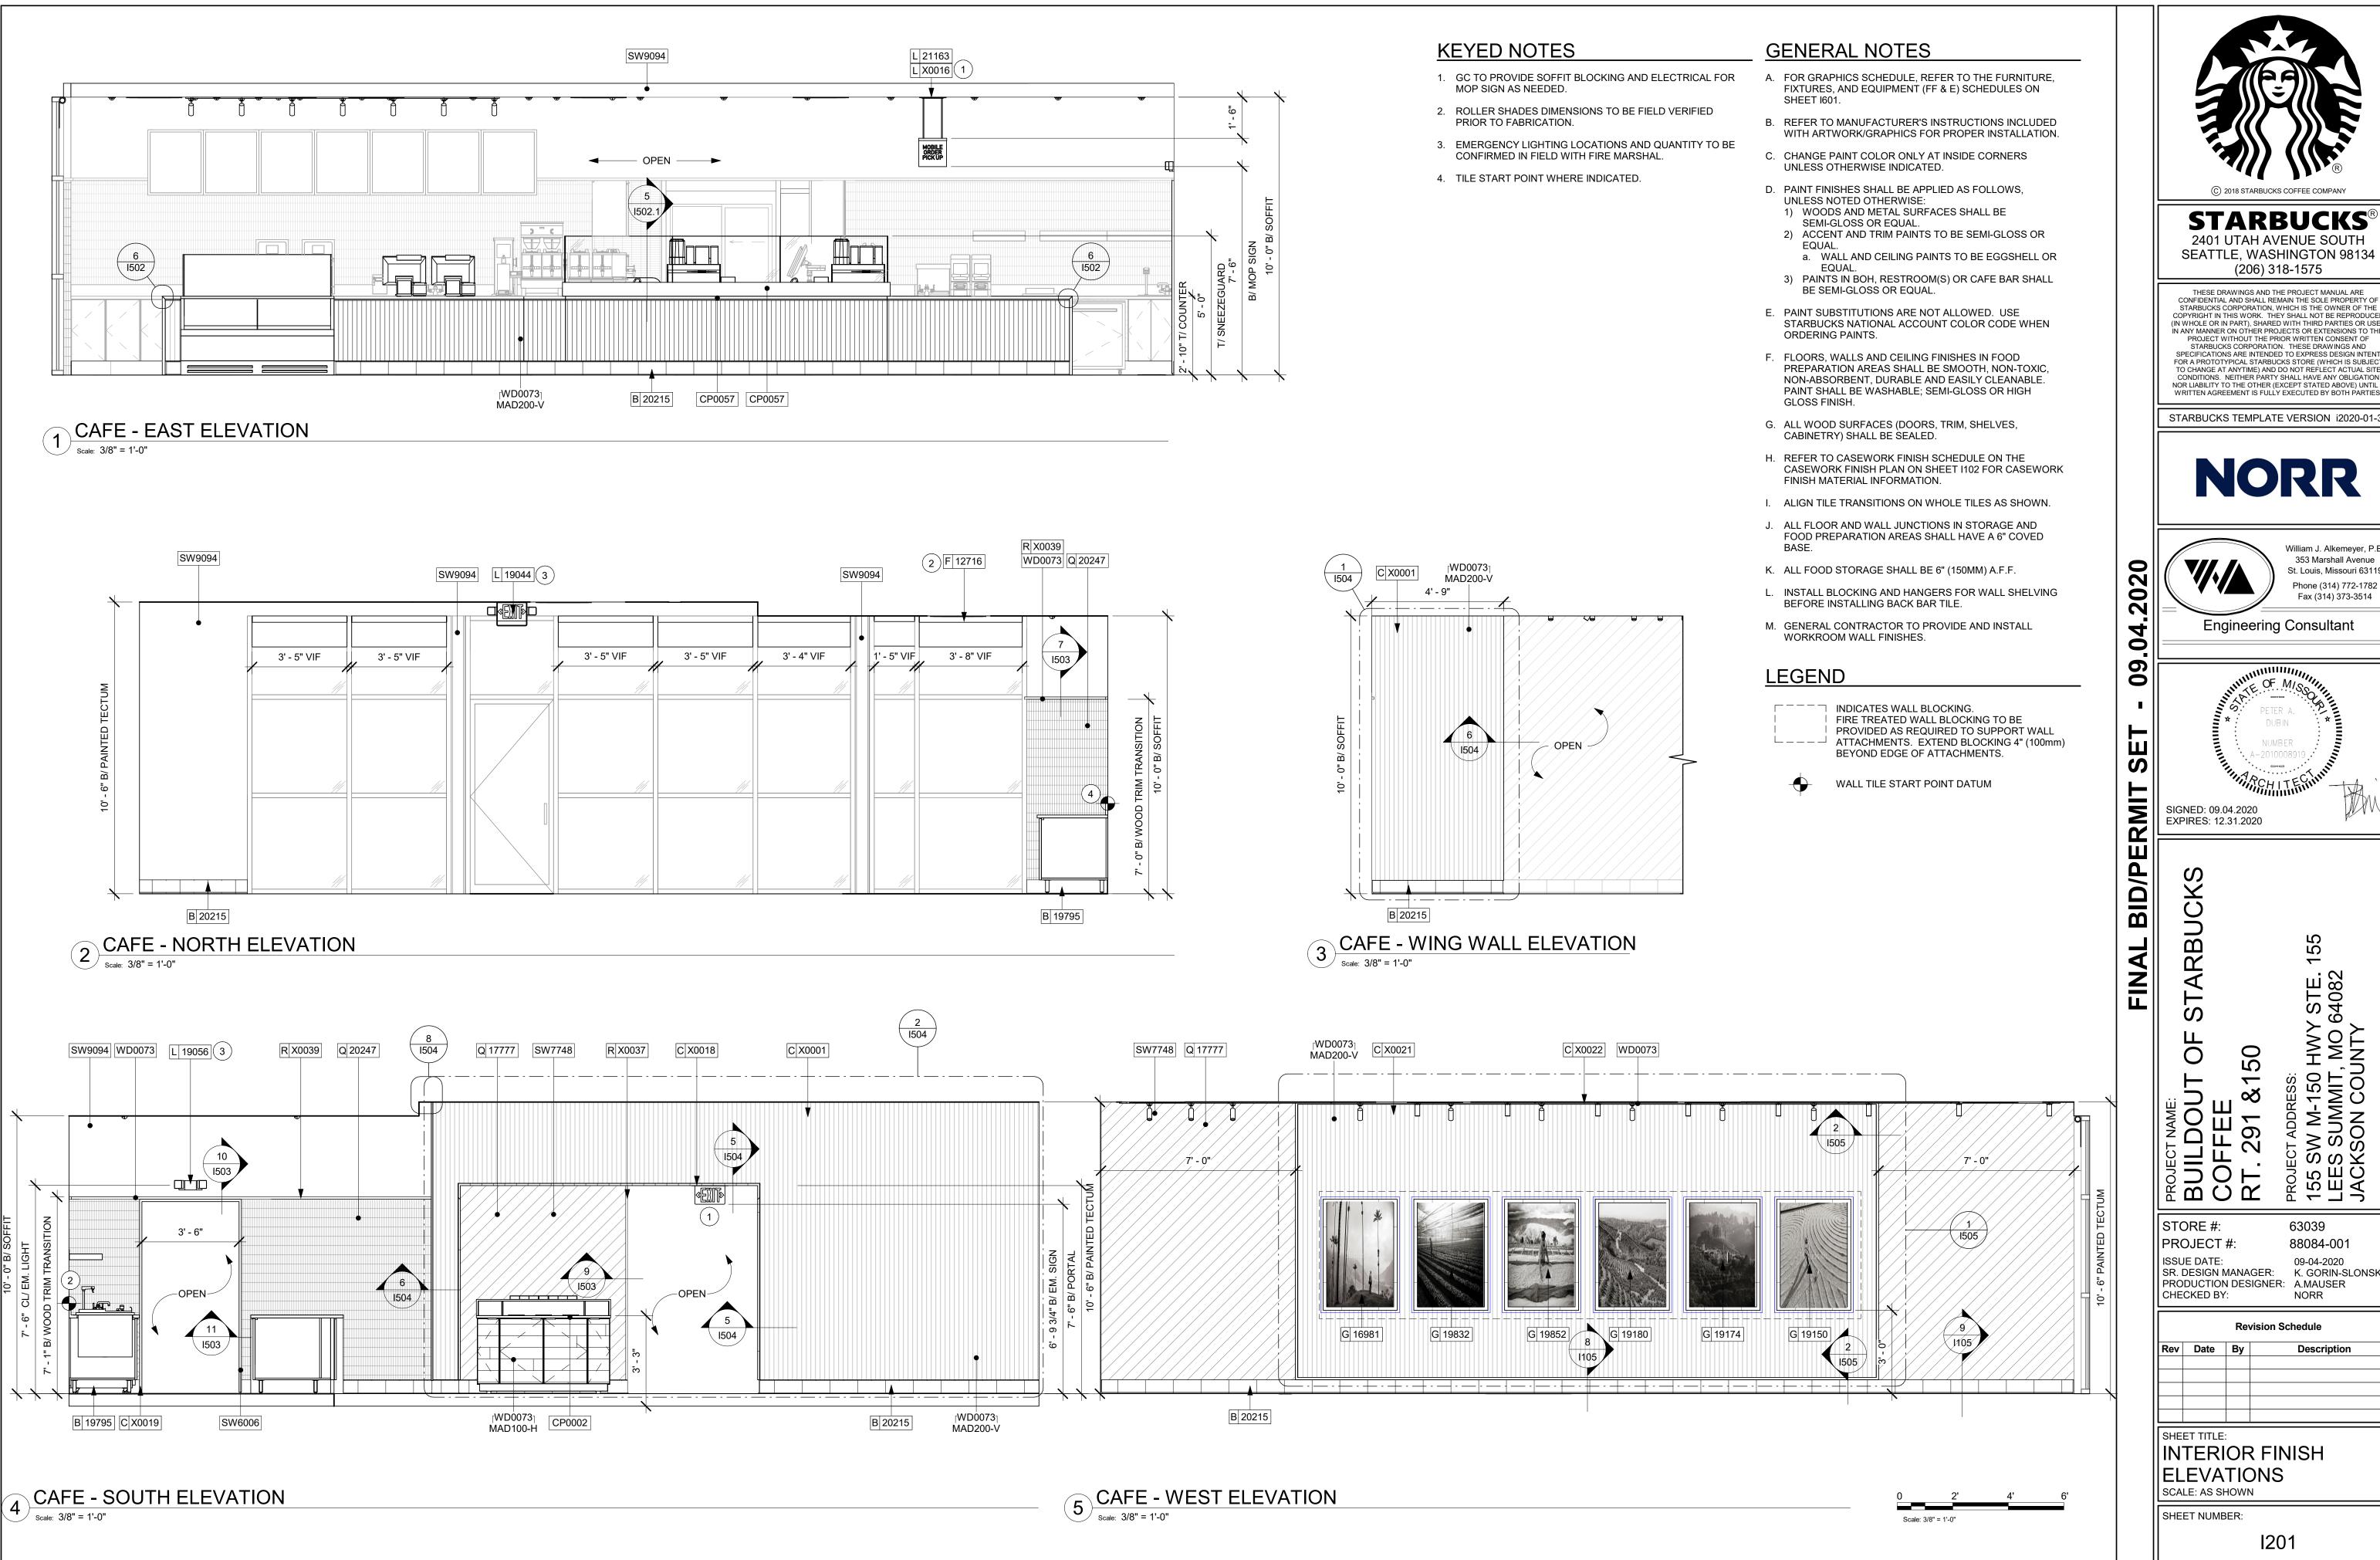63039 PROJECT #: 88084-001 ISSUE DATE: 09-04-2020 SR. DESIGN MANAGER: K. GORIN-SLONSKI PRODUCTION DESIGNER: A.MAUSER

INTERIOR FINISH ELEVATIONS

SHEET NUMBER:

1201



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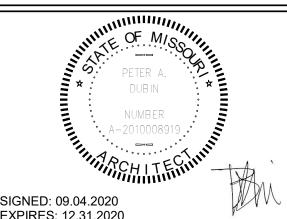
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EXPIRES: 12.31.2020

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291

63039 88084-001 PROJECT #: ISSUE DATE: 09-04-2020 SR. DESIGN MANAGER: K. GORIN-SLONSKI PRODUCTION DESIGNER: A.MAUSER

Revision Schedule

INTERIOR FINISH


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1202


1 WORKROOM - SOUTH ELEVATION

| Scale: 3/8" = 1'-0"



WORKROOM - WEST ELEVATION

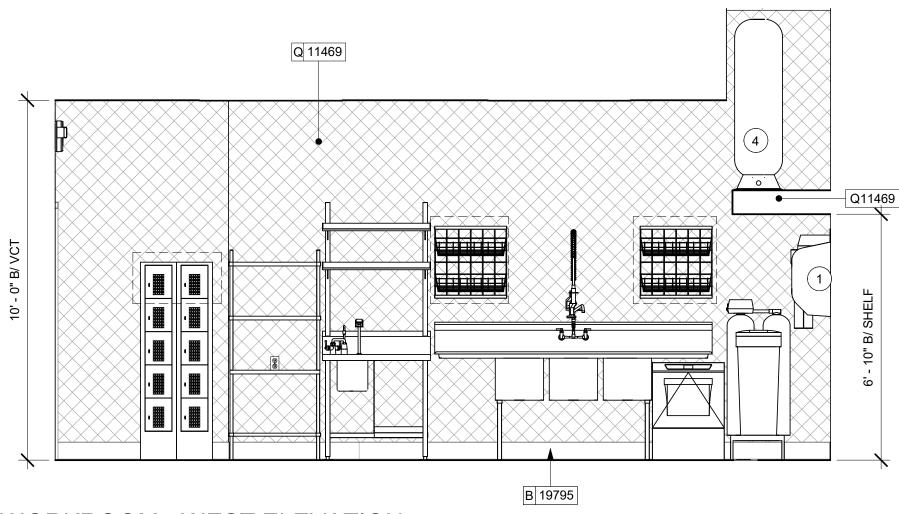Scale: 3/8" = 1'-0"

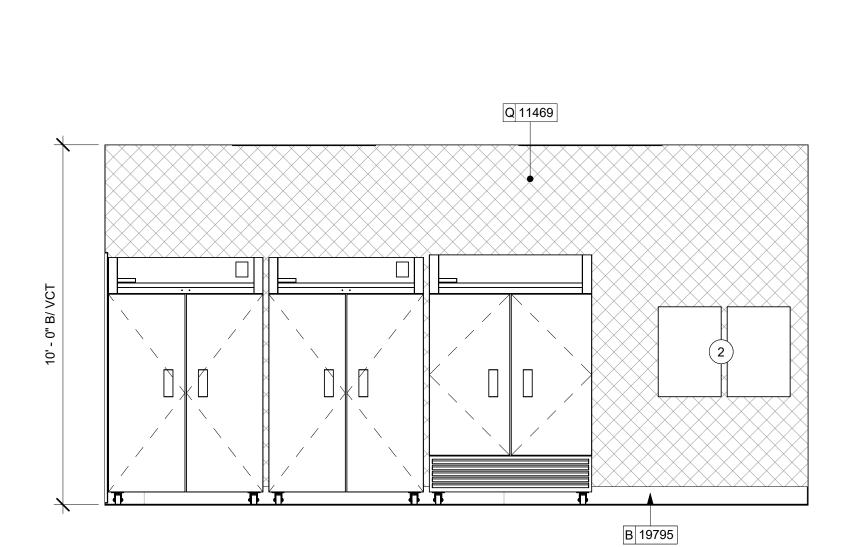

WORKROOM - EAST ELEVATION

Scale: 3/8" = 1'-0"

KEYED NOTES

- 1. WATER FILTRATION EQUIPMENT (SEE PLUMBING DRAWINGS).
- 2. ELECTRICAL PANELS BY LL (SEE ELECTRICAL DRAWINGS FOR ADDITIONAL INFORMATION).
- 3. MANAGER'S DESK (SEE ENLARGED DETAILS).
- 4. WATER HEATER ABOVE (SEE PLUMBING DRAWINGS).
- 5. WALL MOUNT HAND SINK WITH SOAP AND PAPER TOWEL DISPENSER. G.C. TO PROVIDE BLOCKING FOR FASTENERS.
- 6. ICE MACHINE (SEE PLUMBING AND ELECTRICAL DRAWINGS FOR ADDITIONAL INFORMATION).
- 7. MOP SINK. FULL HEIGHT FRP AT ENCLOSURE (SEE PLUMBING PLANS FOR MORE INFORMATION).

- A. FOR GRAPHICS SCHEDULE, REFER TO THE FURNITURE, FIXTURES, AND EQUIPMENT (FF & E) SCHEDULES ON SHEET I601.
- B. REFER TO MANUFACTURER'S INSTRUCTIONS INCLUDED
- a. WALL AND CEILING PAINTS TO BE EGGSHELL OR
- 3) PAINTS IN BOH, RESTROOM(S) OR CAFE BAR SHALL BE SEMI-GLOSS OR EQUAL.
- ORDERING PAINTS.
- H. REFER TO CASEWORK FINISH SCHEDULE ON THE CASEWORK FINISH PLAN ON SHEET I102 FOR CASEWORK
- I. ALIGN TILE TRANSITIONS ON WHOLE TILES AS SHOWN.
- K. ALL FOOD STORAGE SHALL BE 6" (150MM) A.F.F.
- L. INSTALL BLOCKING AND HANGERS FOR WALL SHELVING
- M. GENERAL CONTRACTOR TO PROVIDE AND INSTALL

FIRE TREATED WALL BLOCKING TO BE BEYOND EDGE OF ATTACHMENTS.



WALL TILE START POINT DATUM

GENERAL NOTES

WITH ARTWORK/GRAPHICS FOR PROPER INSTALLATION.

C. CHANGE PAINT COLOR ONLY AT INSIDE CORNERS UNLESS OTHERWISE INDICATED.

D. PAINT FINISHES SHALL BE APPLIED AS FOLLOWS, **UNLESS NOTED OTHERWISE:** 1) WOODS AND METAL SURFACES SHALL BE

SEMI-GLOSS OR EQUAL. 2) ACCENT AND TRIM PAINTS TO BE SEMI-GLOSS OR

E. PAINT SUBSTITUTIONS ARE NOT ALLOWED. USE STARBUCKS NATIONAL ACCOUNT COLOR CODE WHEN

F. FLOORS, WALLS AND CEILING FINISHES IN FOOD PREPARATION AREAS SHALL BE SMOOTH, NON-TOXIC, NON-ABSORBENT, DURABLE AND EASILY CLEANABLE. PAINT SHALL BE WASHABLE; SEMI-GLOSS OR HIGH GLOSS FINISH.

G. ALL WOOD SURFACES (DOORS, TRIM, SHELVES, CABINETRY) SHALL BE SEALED.

FINISH MATERIAL INFORMATION.

J. ALL FLOOR AND WALL JUNCTIONS IN STORAGE AND FOOD PREPARATION AREAS SHALL HAVE A 6" COVED

BEFORE INSTALLING BACK BAR TILE.

WORKROOM WALL FINISHES.

LEGEND

INDICATES WALL BLOCKING. PROVIDED AS REQUIRED TO SUPPORT WALL └──── ATTACHMENTS. EXTEND BLOCKING 4" (100mm)



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Engineering Consultant



BUILDO COFFEE RT. 291


STORE #: PROJECT #: 88084-001 ISSUE DATE: 09-04-2020 SR. DESIGN MANAGER: K. GORIN-SLONSKI PRODUCTION DESIGNER: A.MAUSER

INTERIOR FINISH ELEVATIONS SCALE: AS SHOWN

SHEET NUMBER:

CHECKED BY:

1203

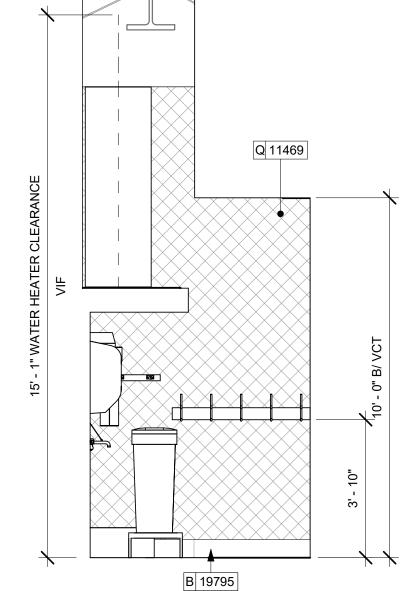

5 WORKROOM UTILITY - NORTH ELEVATION

Scale: 3/8" = 1'-0"

P 13384

WORKROOM - NORTH ELEVATION


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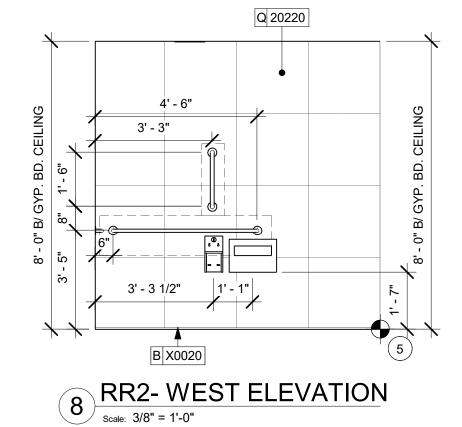
P 12507




B X0020

7 RR2- SOUTH ELEVATION

Scale: 3/8" = 1'-0"

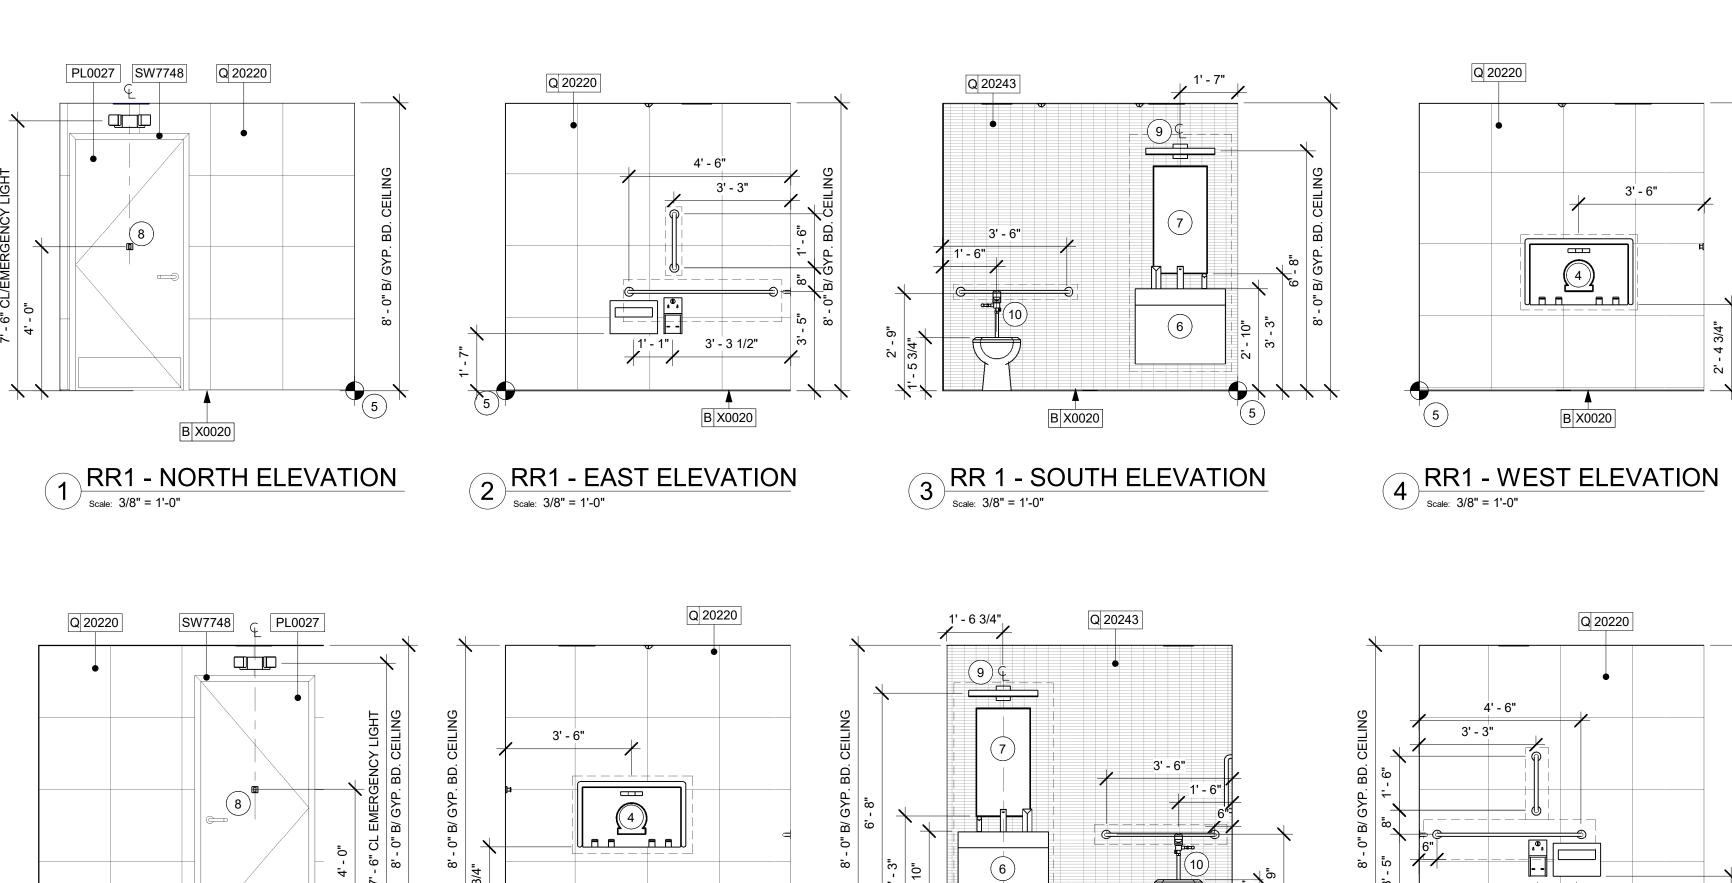

B X0020

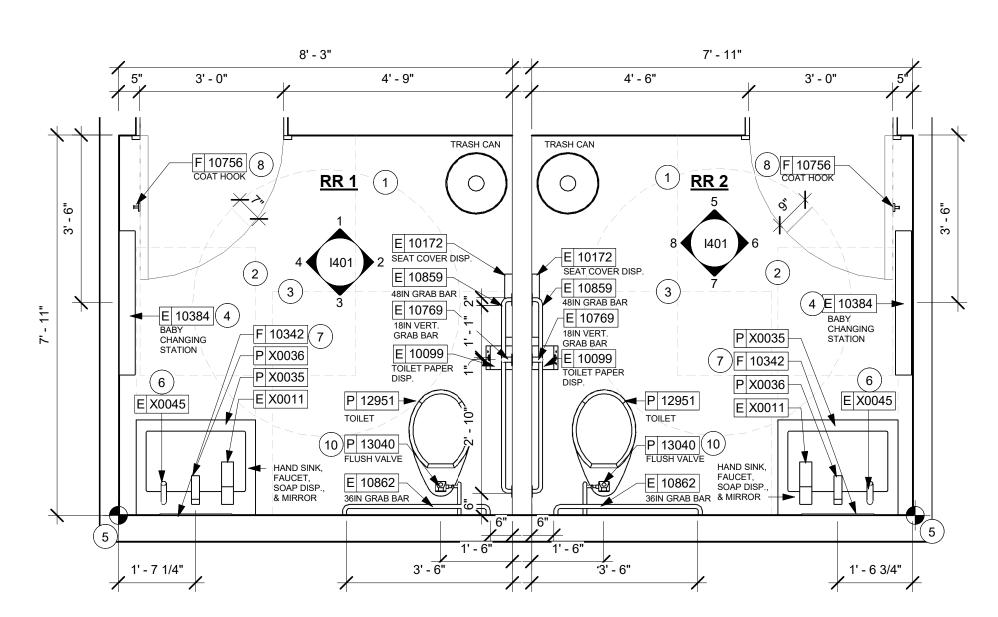

B X0020

RR2 - EAST ELEVATION

Scale: 3/8" = 1'-0"

ENLARGED RESTROOM PLAN

Scale: 1/2" = 1'-0"

B X0020

Scale: 3/8" = 1'-0"



KEYED NOTES

- 1. 67" ADA TURNING RADIUS.
- 2. 30" X 52" CLEAR FLOOR SPACE.
- 3. WATER CLOSET CLEAR FLOOR SPACE.
- 4. BABY CHANGING FIXTURE. GENERAL CONTRACTOR TO PROVIDE BLOCKING PER MANUFACTURER'S
- RECOMMENDATION.
- 5. TILE START POINT WHERE INDICATED. ALIGN BASE TILE GROUT WITH WALL TILE GROUT. ALIGN LARGE FORMAT TILE TO MINIMIZE TILE CUTTING IN FIELD.
- 6. WALL MOUNTED LAVATORY INSTALLED WITH INSULATED BOOT AT EXPOSED PIPES.
- 7. CENTER MIRROR OVER LAVATORY. MOUNT AT 40" (1015MM) MAX. TO BOTTOM EDGE OF REFLECTIVE SURFACE.
- 8. COAT HOOK. MOUNT AT CENTERLINE OF DOOR, MAX 4'-0"
- 9. CENTER SCONCE LIGHTING OVER MIRROR (SEE ELECTRICAL).

3' - 0"

DIAPER CHANGING STATION SIDE ELEVATION

10. INSTALL FLUSH VALVE AT OPEN SIDE OF TOILETS AS INDICATED ON ADA DETAILS SHEET.

GENERAL NOTES

- A. GENERAL CONTRACTOR TO VERIFY ALL DIMENSIONS AND NOTIFY STARBUCKS CONSTRUCTION MANAGER OF ANY DISCREPANCIES PRIOR TO CONSTRUCTION.
- B. ALL DIMENSIONS ARE TO BE TAKEN FROM A DESIGNATED DATUM POINT.
- C. DIMENSIONS ARE TO FACE OF FINISHED SURFACE UNLESS OTHERWISE NOTED.
- D. DIAPER CHANGING STATION IS TO BE INSTALLED PER MANUFACTURER'S INSTRUCTIONS. UNIT IS TO BE FASTENED TO STRUCTURE AT ALL SIX CHASSIS ATTACHMENT POINTS.
- E. LOCATE DIAPER CHANGING STATION AS SHOWN TO ALLOW NECESSARY CLEARANCE FOR OPERATION OF ALL RESTROOM FIXTURES. LOCATION SHALL NOT IMPEDE ACCESS, EGRESS, OR DOOR SWING.
- F. ALL RESTROOM ACCESSORY MOUNTING HEIGHTS AND CLEARANCES SHALL COMPLY WITH THE ACCESSIBILITY REQUIREMENTS OF THE LOCAL JURISDICTION.



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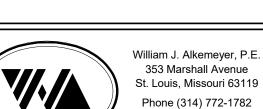
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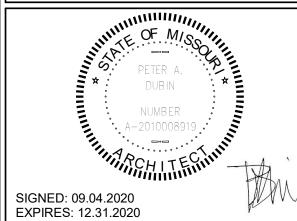
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STORE #: 63039 PROJECT #: 88084-001 ISSUE DATE: SR. DESIGN MANAGER: K. GORIN-SLONSKI

PRODUCTION DESIGNER: A.MAUSER

Revision Schedule

RESTROOM PLAN &

ELEVATIONS SCALE: AS SHOWN SHEET NUMBER:

CHECKED BY:

1401

3' - 3 1/2" 1' - 6" TOILET FRONT ELEVATION TOILET SIDE ELEVATION \ \\ \-HAND SINK SIDE ELEVATION HAND SINK FRONT ELEVATION COAT HOOK ELEVATION

MOUNTING HEIGHTS FOR RESTROOM ACCESSORIES Scale: 3/8" = 1'-0"

DIAPER CHANGING STATION FRONT ELEVATION

Scale: 3/8" = 1'-0"



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WRITTEN AGREEMENT IS FULLY EXECUTED BY BOTH PARTIES.



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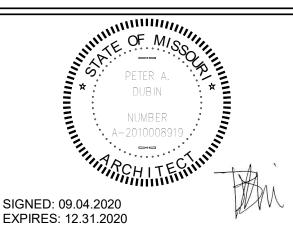
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/ STE. 64082

PROJECT NAME:
BUILDOUT
COFFEE
RT. 291 &1 STORE #: 63039 PROJECT #:

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88084-001 ISSUE DATE: SR. DESIGN MANAGER: K. GORIN-SLONSKI PRODUCTION DESIGNER: A.MAUSER CHECKED BY: NORR


Revision Schedule


ENLARGED BAR PLANS

SCALE: AS SHOWN

SHEET NUMBER:


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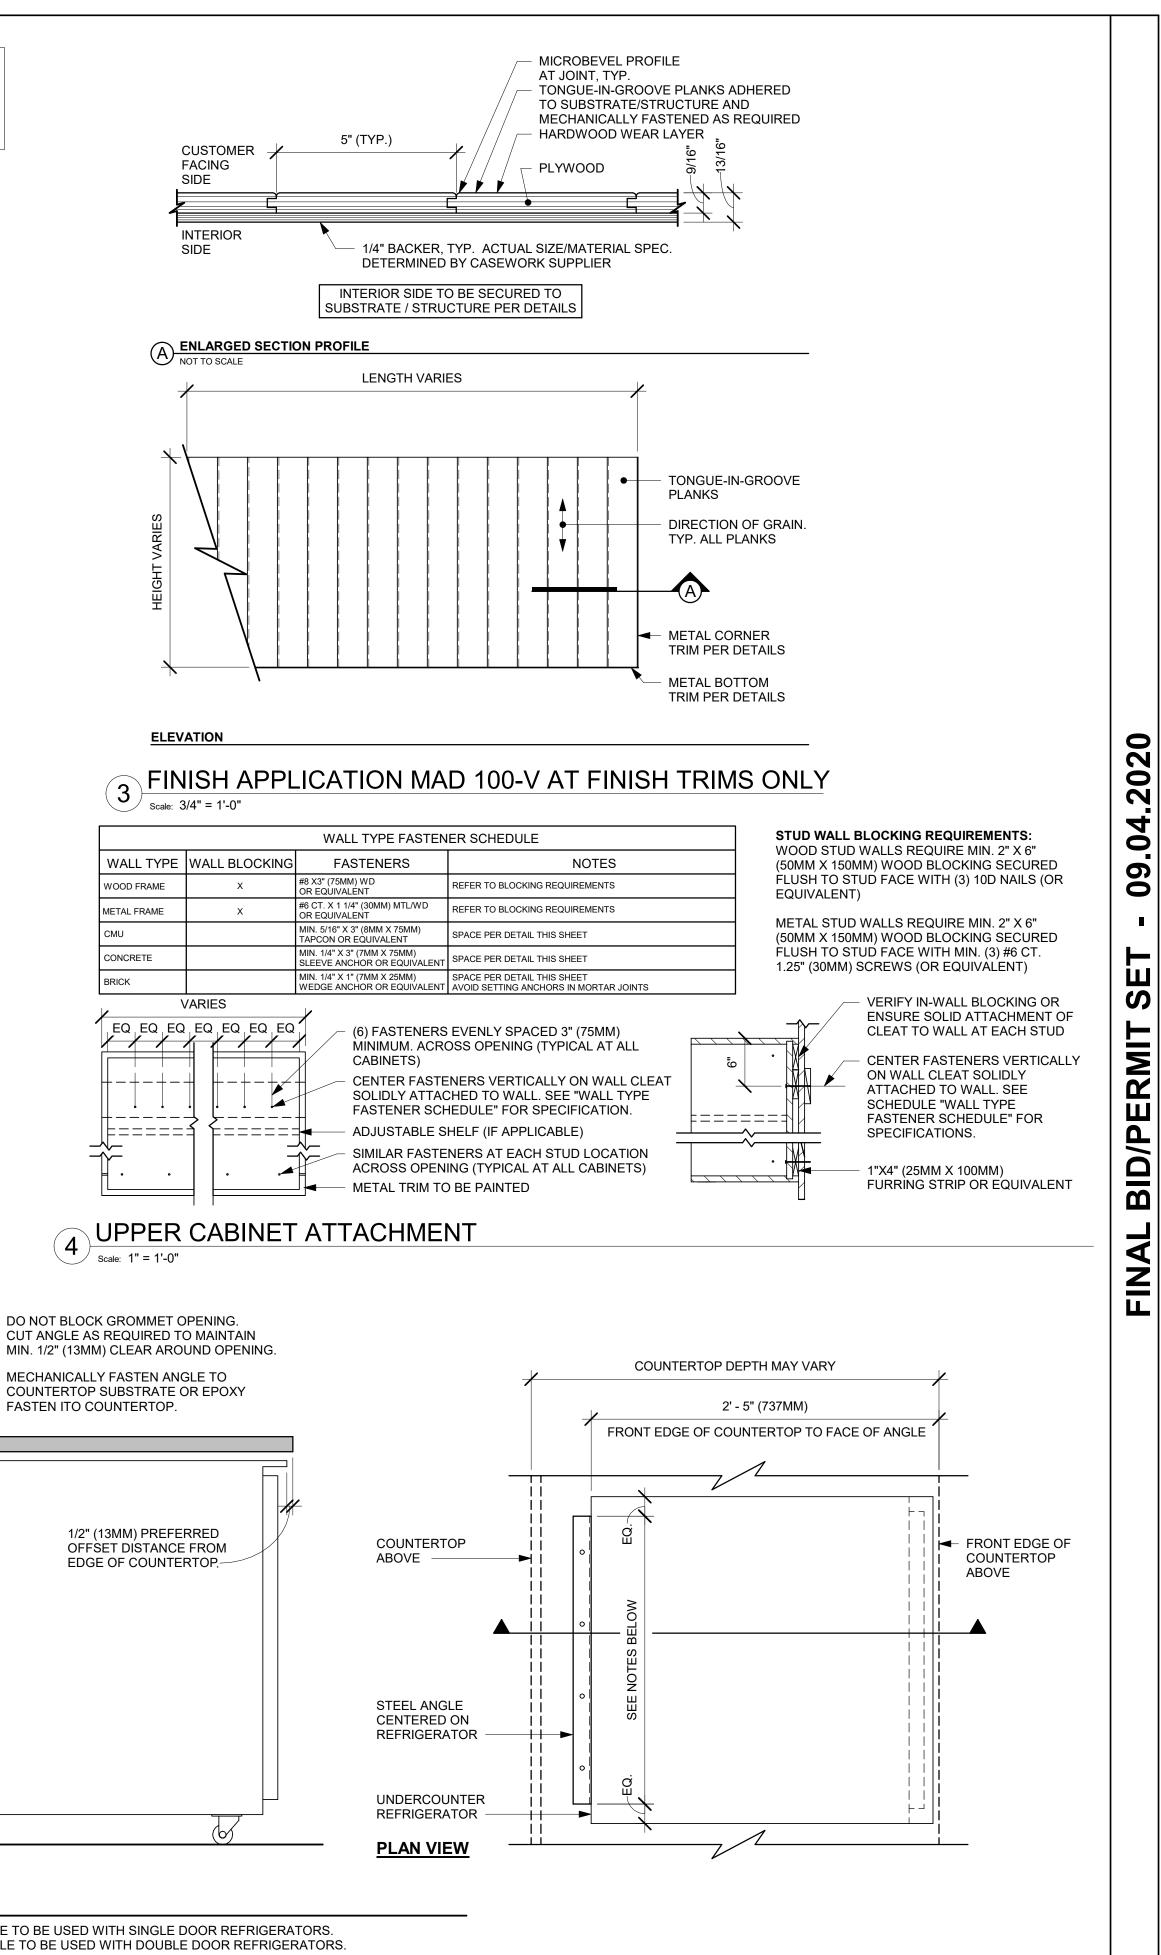


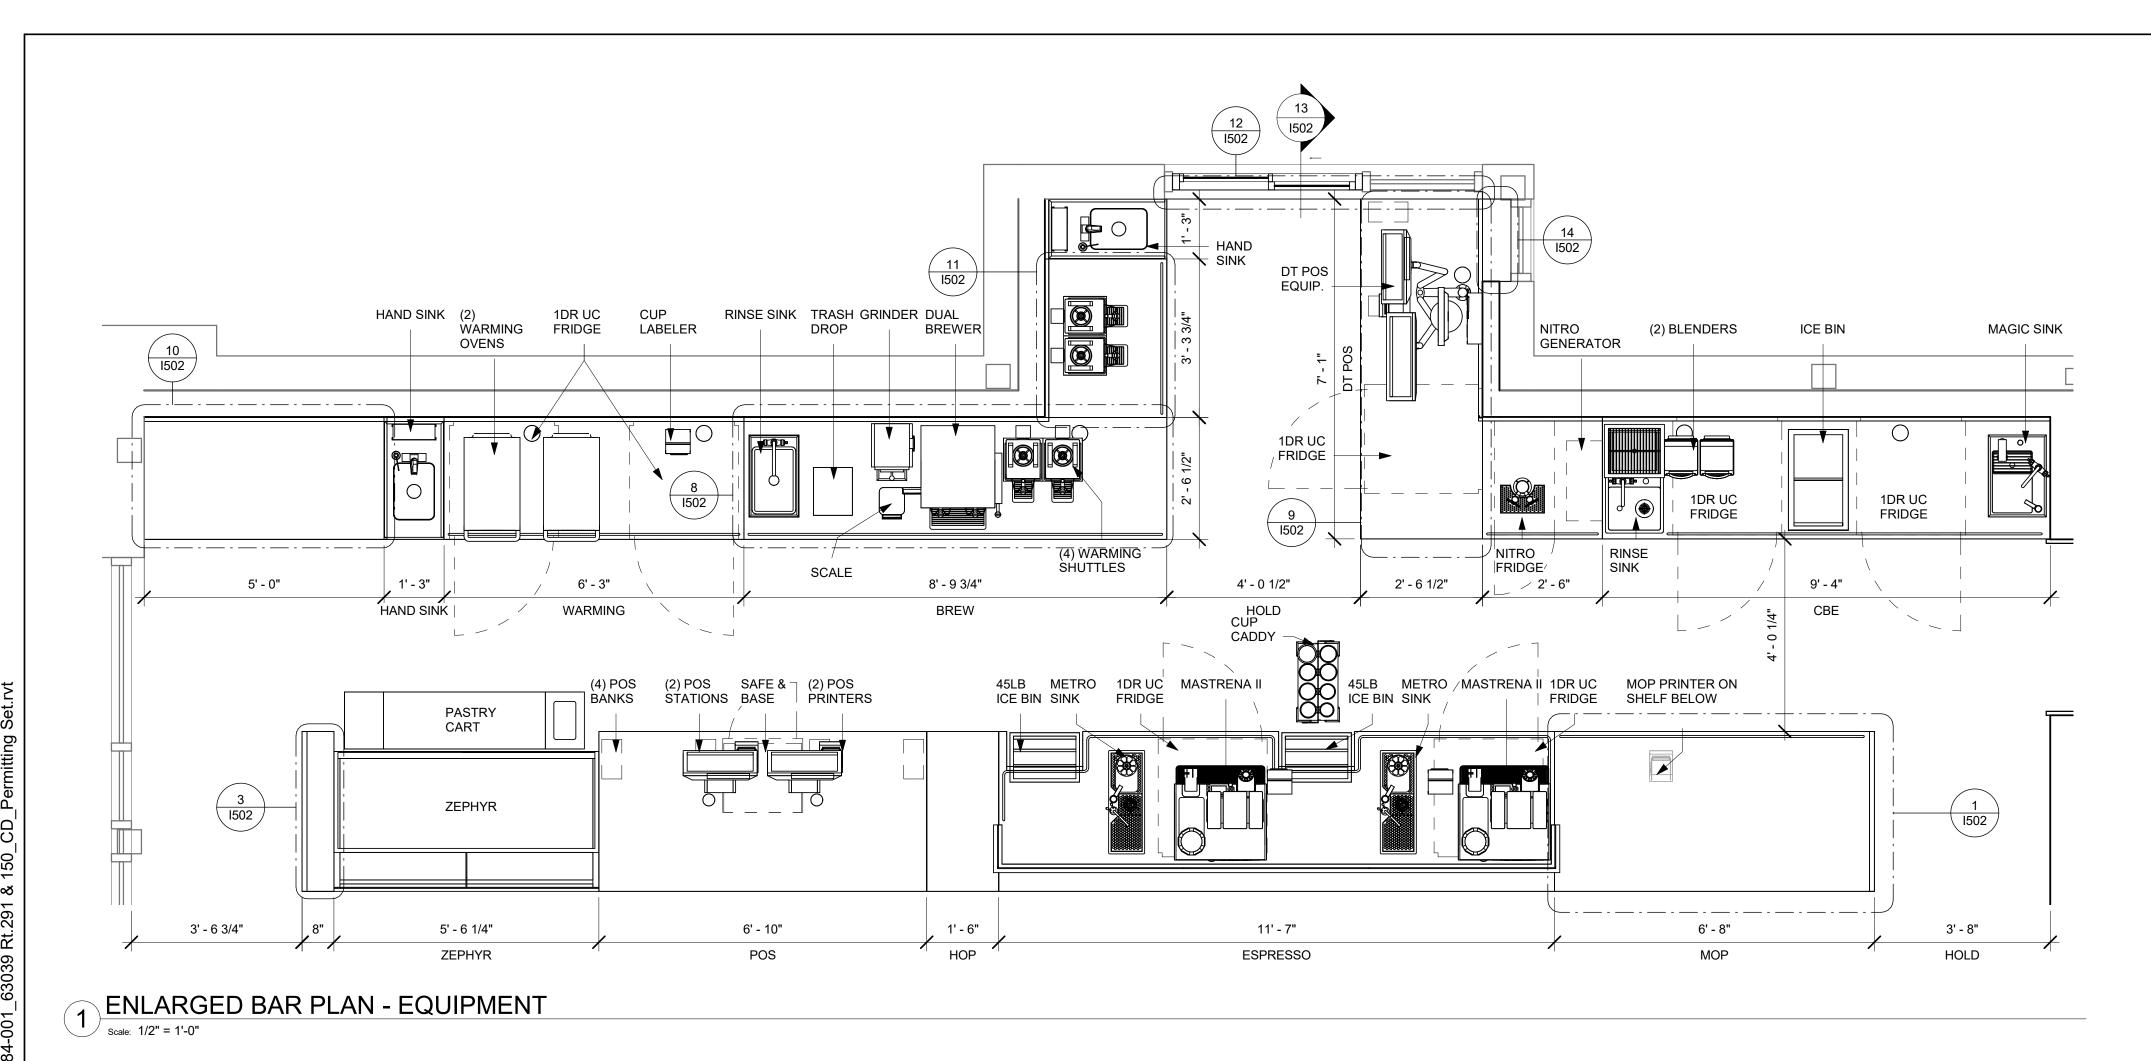


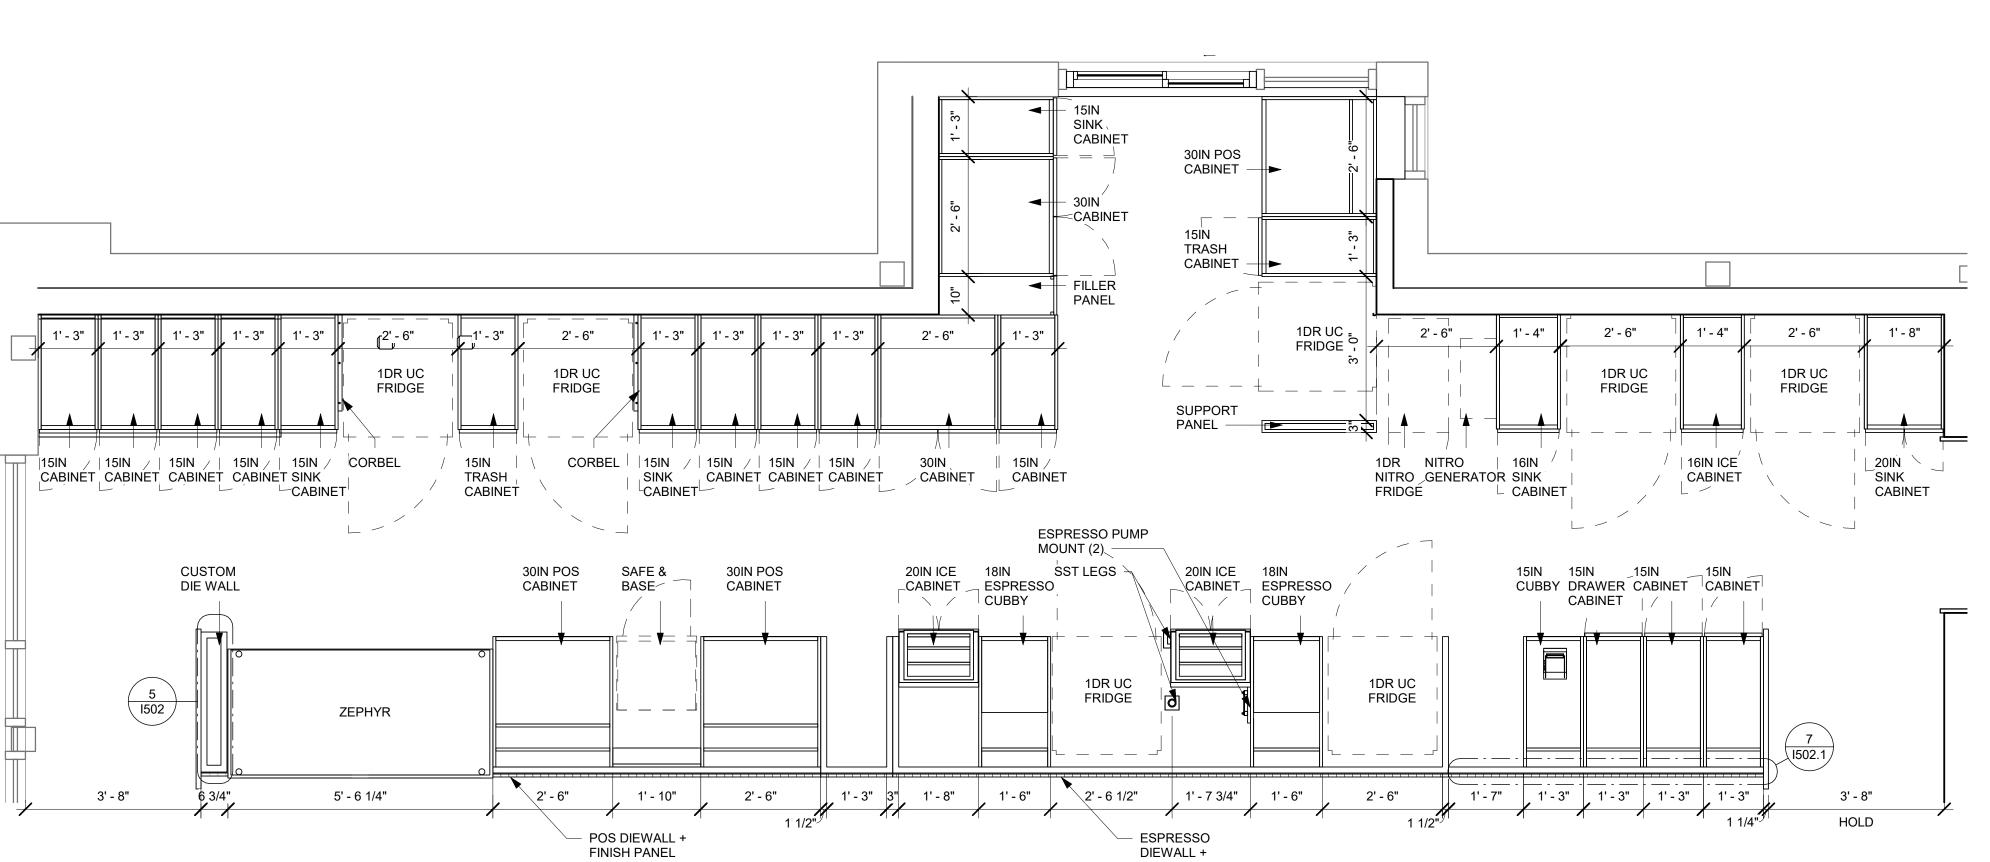
2 ENLARGED BAR PLAN - CASEWORK Scale: 1/2" = 1'-0"

FINISH PANEL



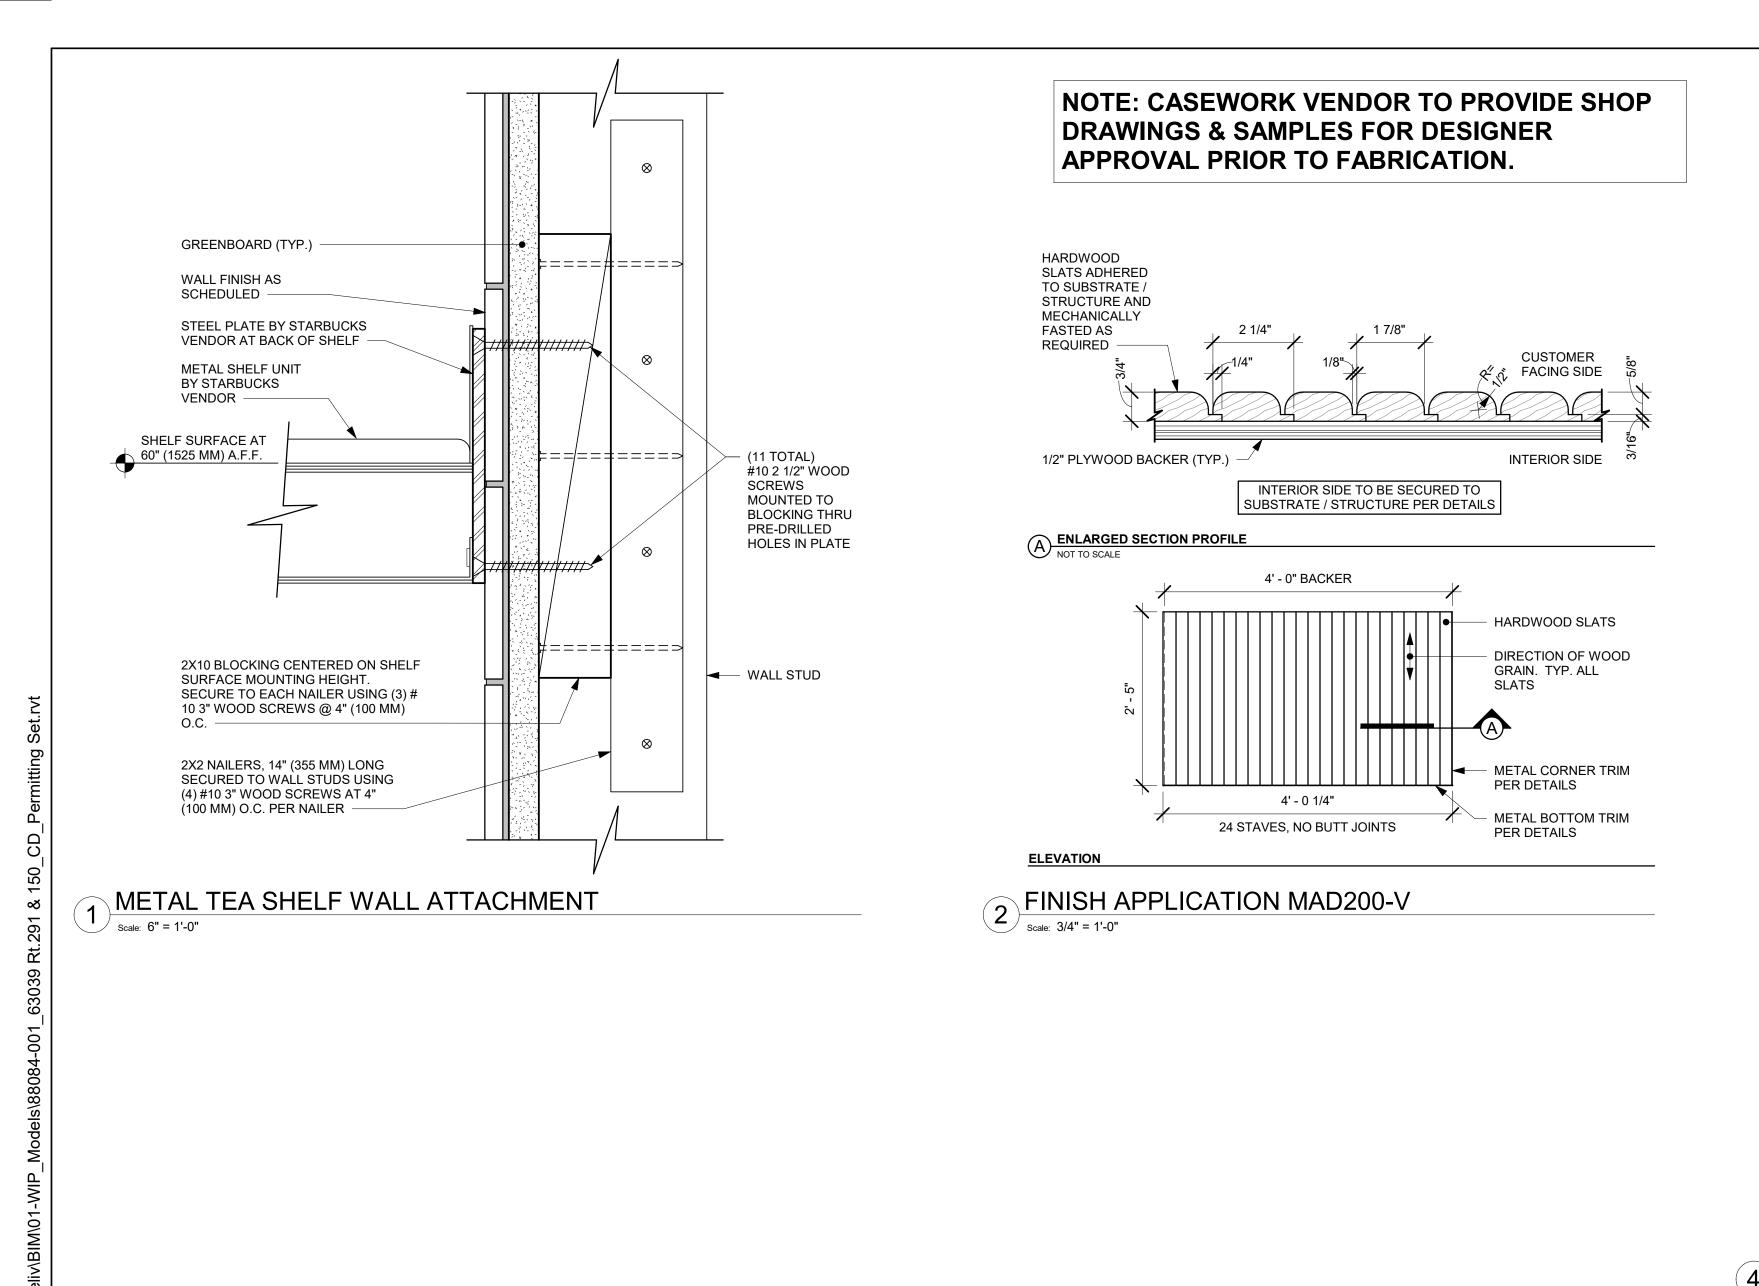

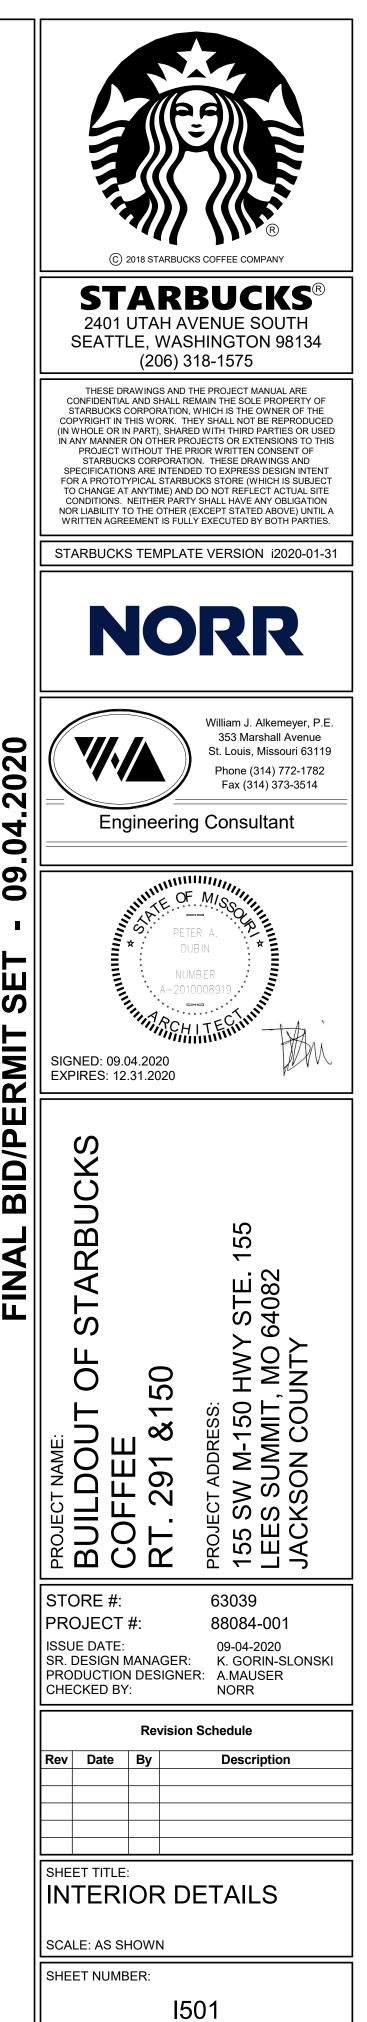

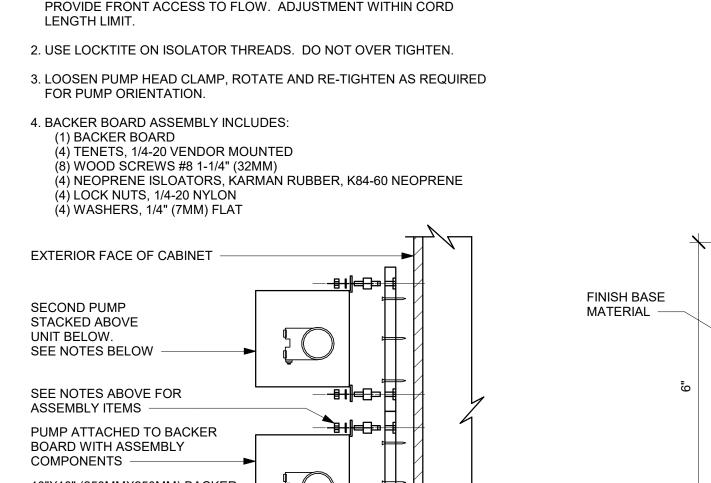

1. LOCATE PUMP WITHIN CORD LENGTH LIMIT. ORIENT WITH PUMP HEAD LEFT, RIGHT AND AT BOTTOM. LOOSEN PUMP HEAD CLAMP, ROTATE AND RE-TIGHTEN AS REQUIRED PER ORIENTATION TO

BOARD. ATTACH TO DIÉ WALL


WITH SILICONE ADHESIVE AND


WOOD SCREWS. SILICONE

PERIMETER.

CABINET LEG


FINISHED FLOOR

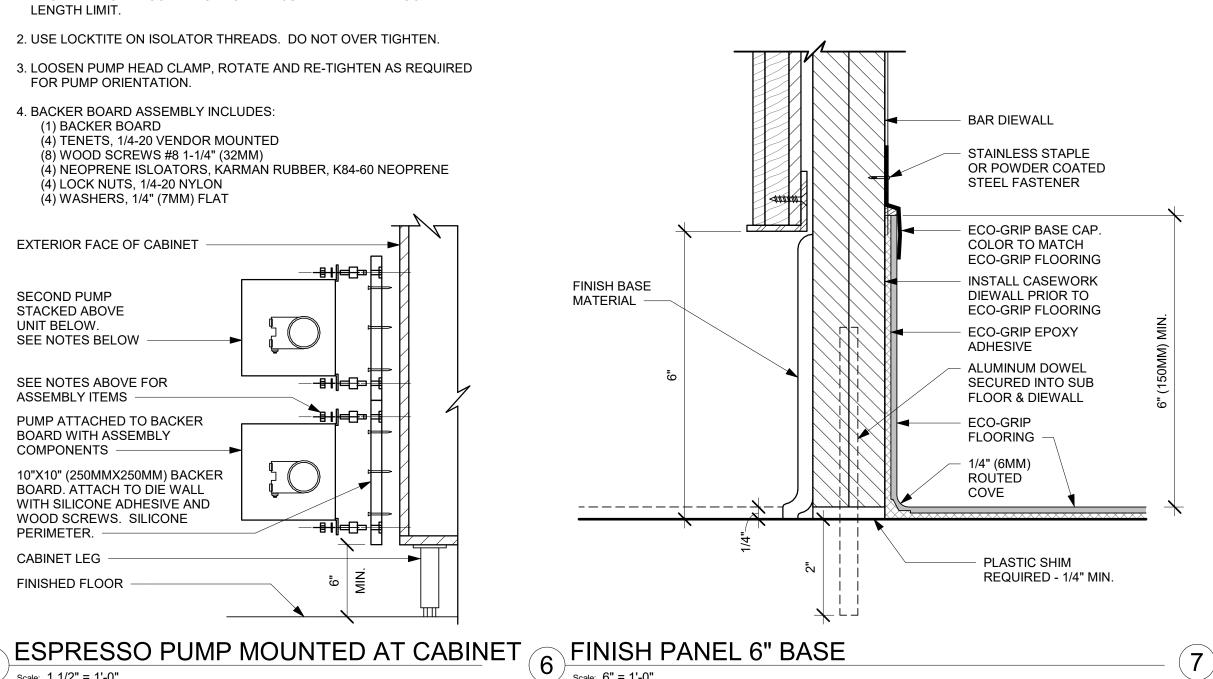


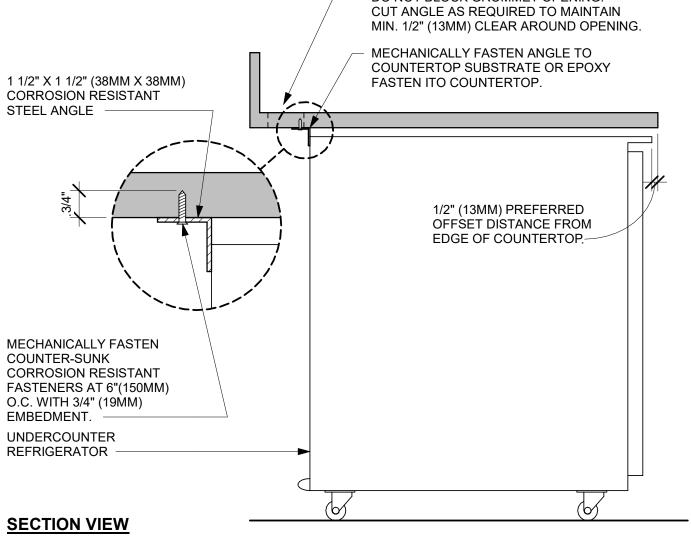

1. 24" (610MM) 1 1/2" X 1 1/2" (38MM X 38MM) STEEL ANGLE TO BE USED WITH SINGLE DOOR REFRIGERATORS 2. 48" (1220MM) 1 1/2" X 1 1/2" (38MM X 38MM) STEEL ANGLE TO BE USED WITH DOUBLE DOOR REFRIGERATORS.

UNDERCOUNTER REFRIGERATOR STOP INSTALLATION

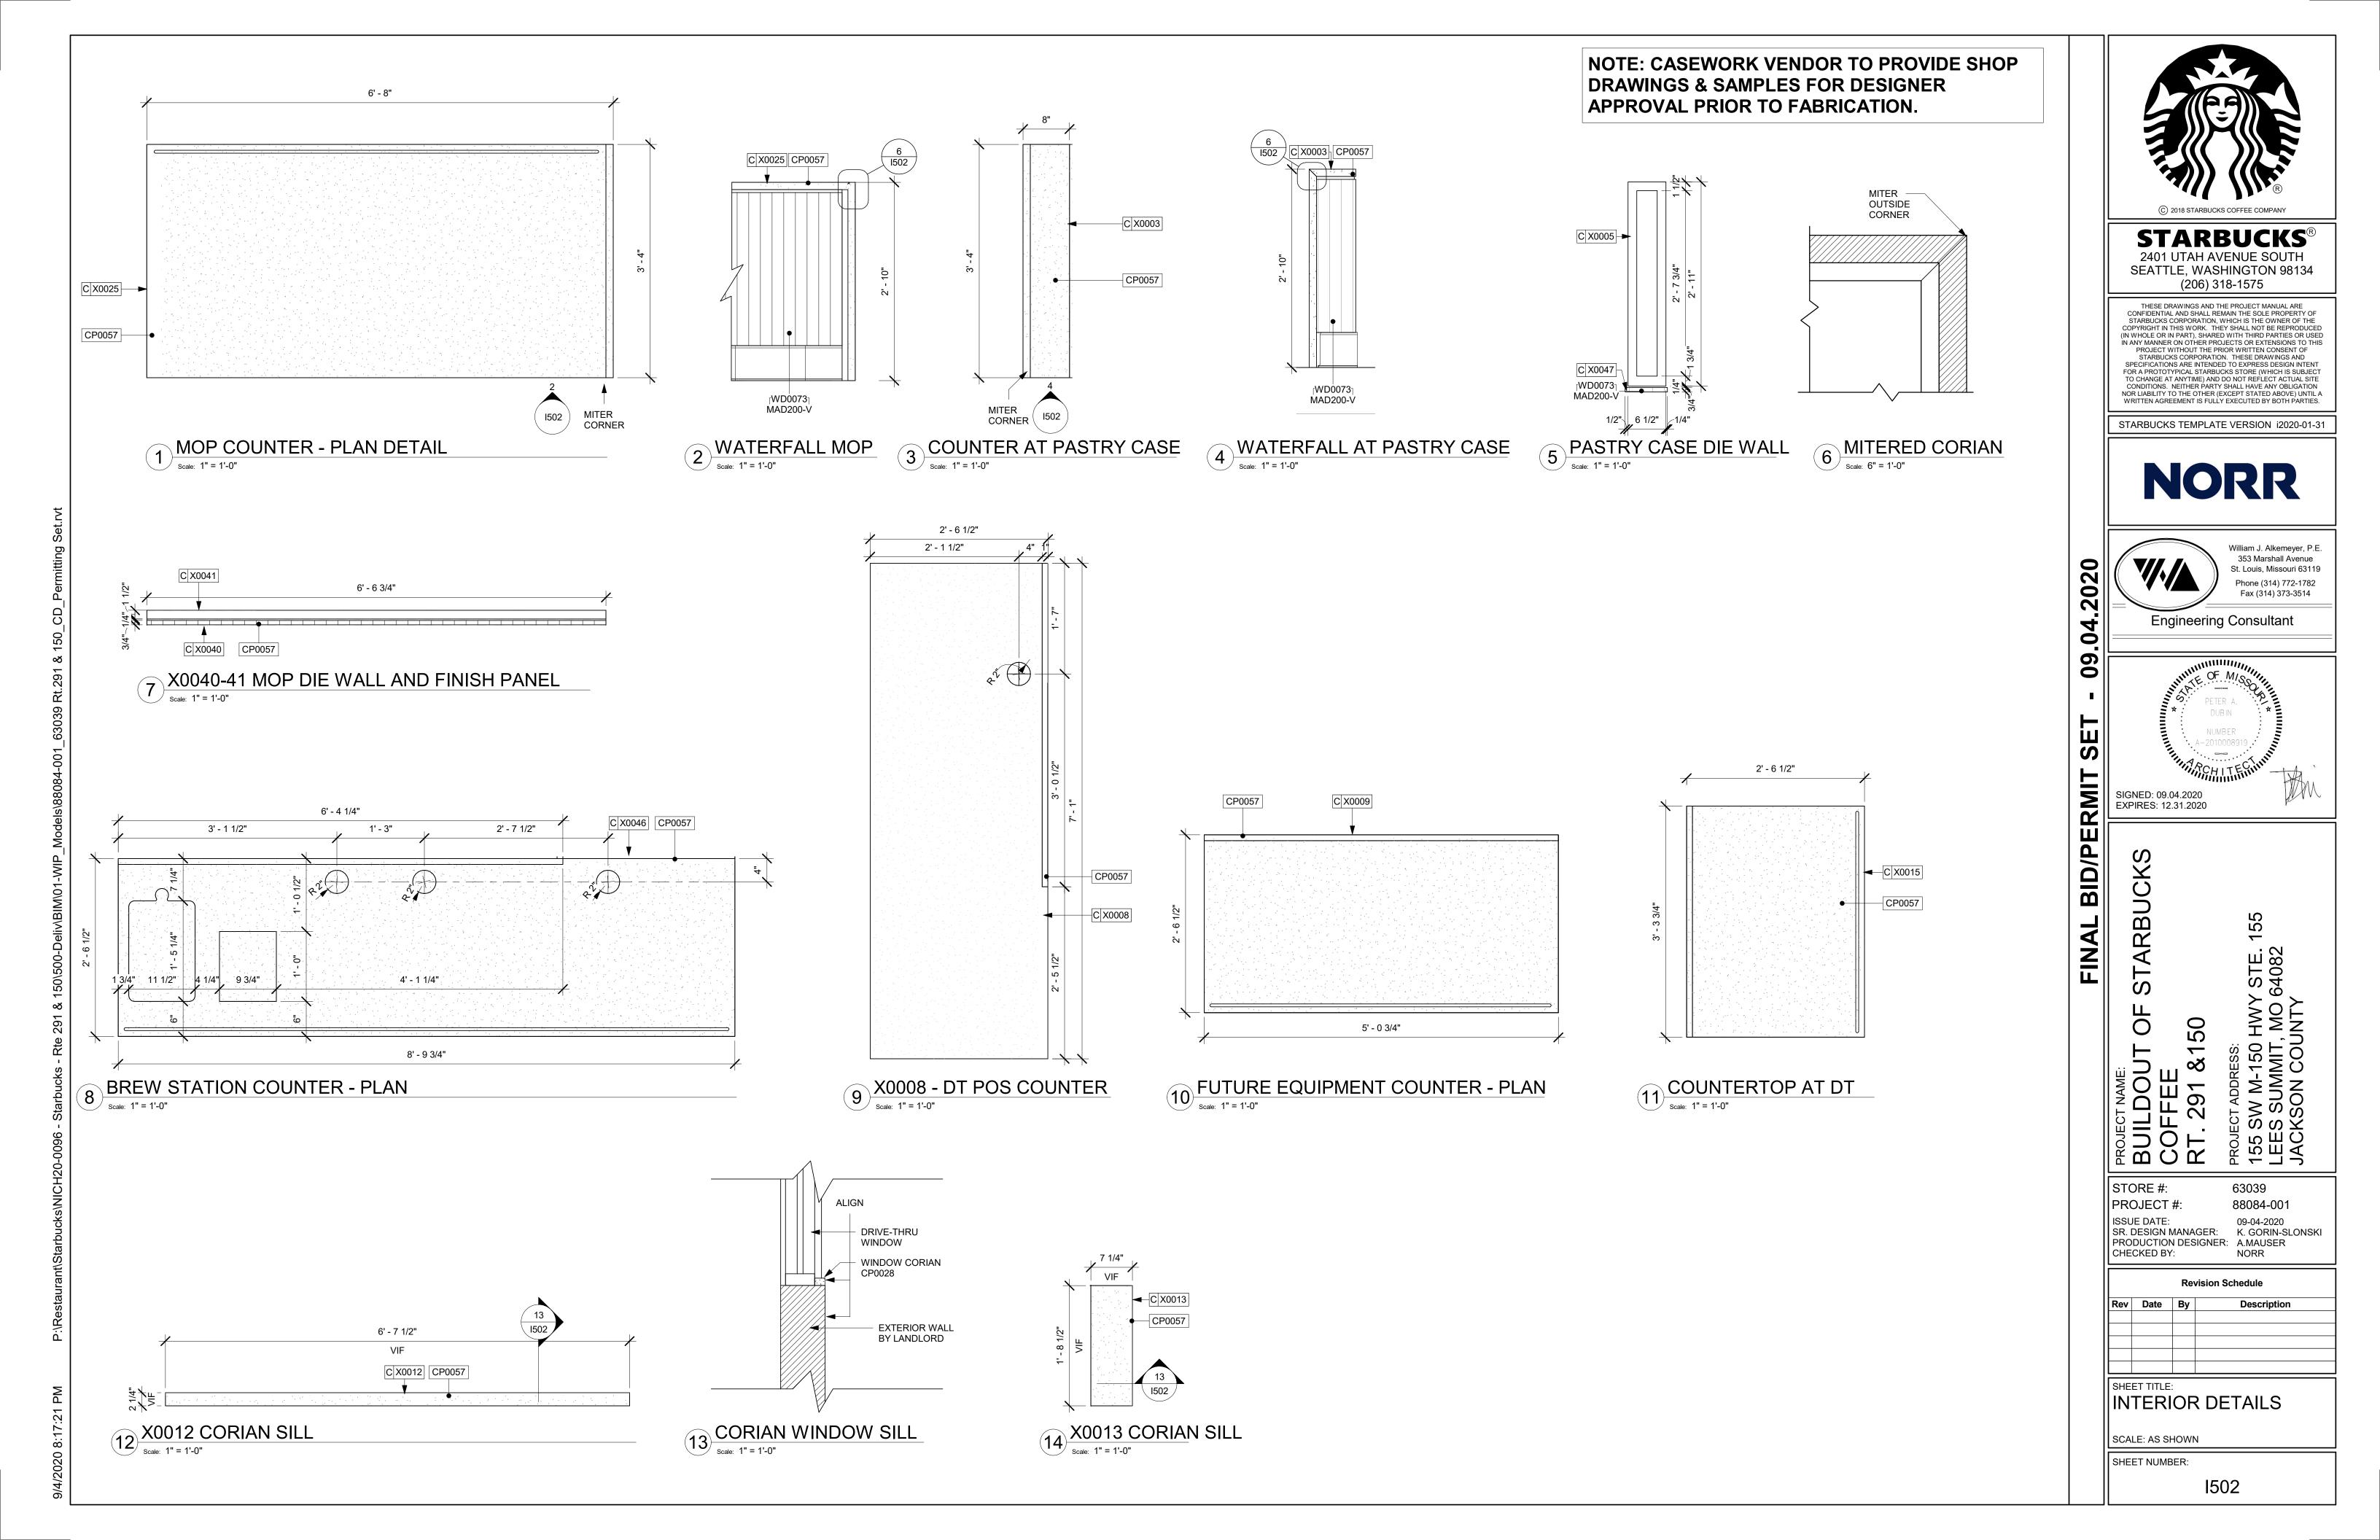

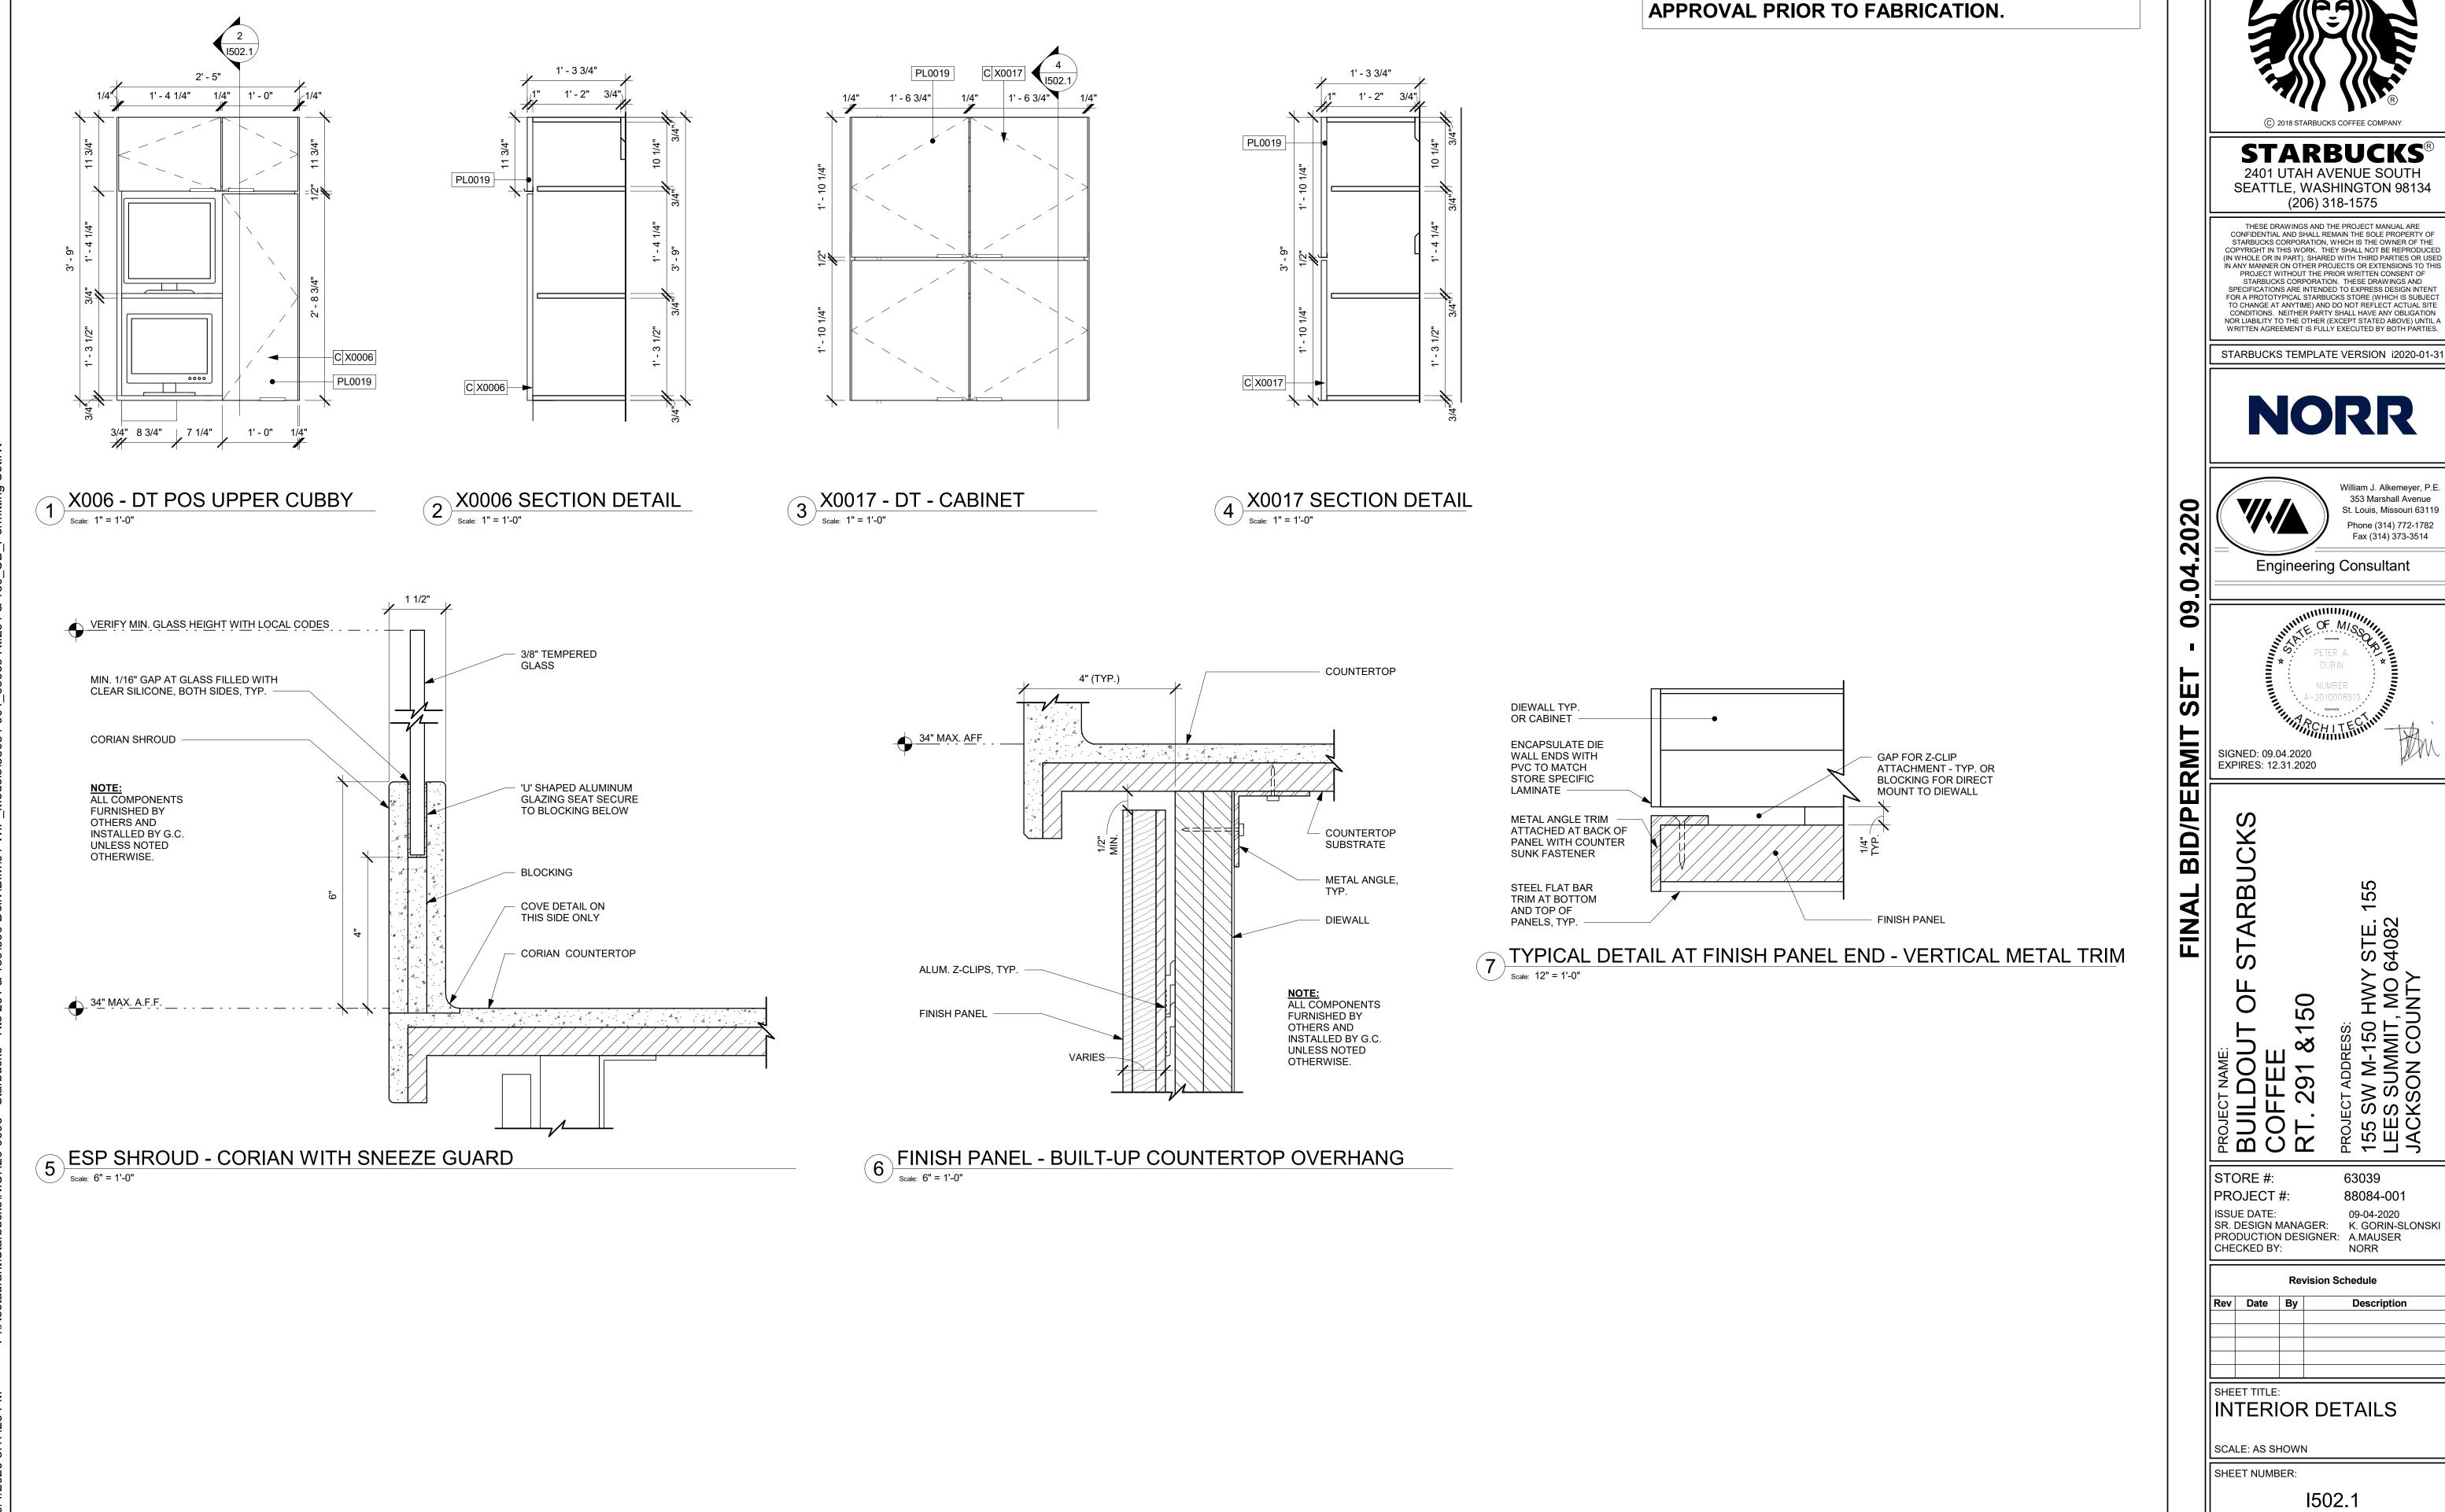



NOTE: CASEWORK VENDOR TO PROVIDE SHOP


DRAWINGS & SAMPLES FOR DESIGNER






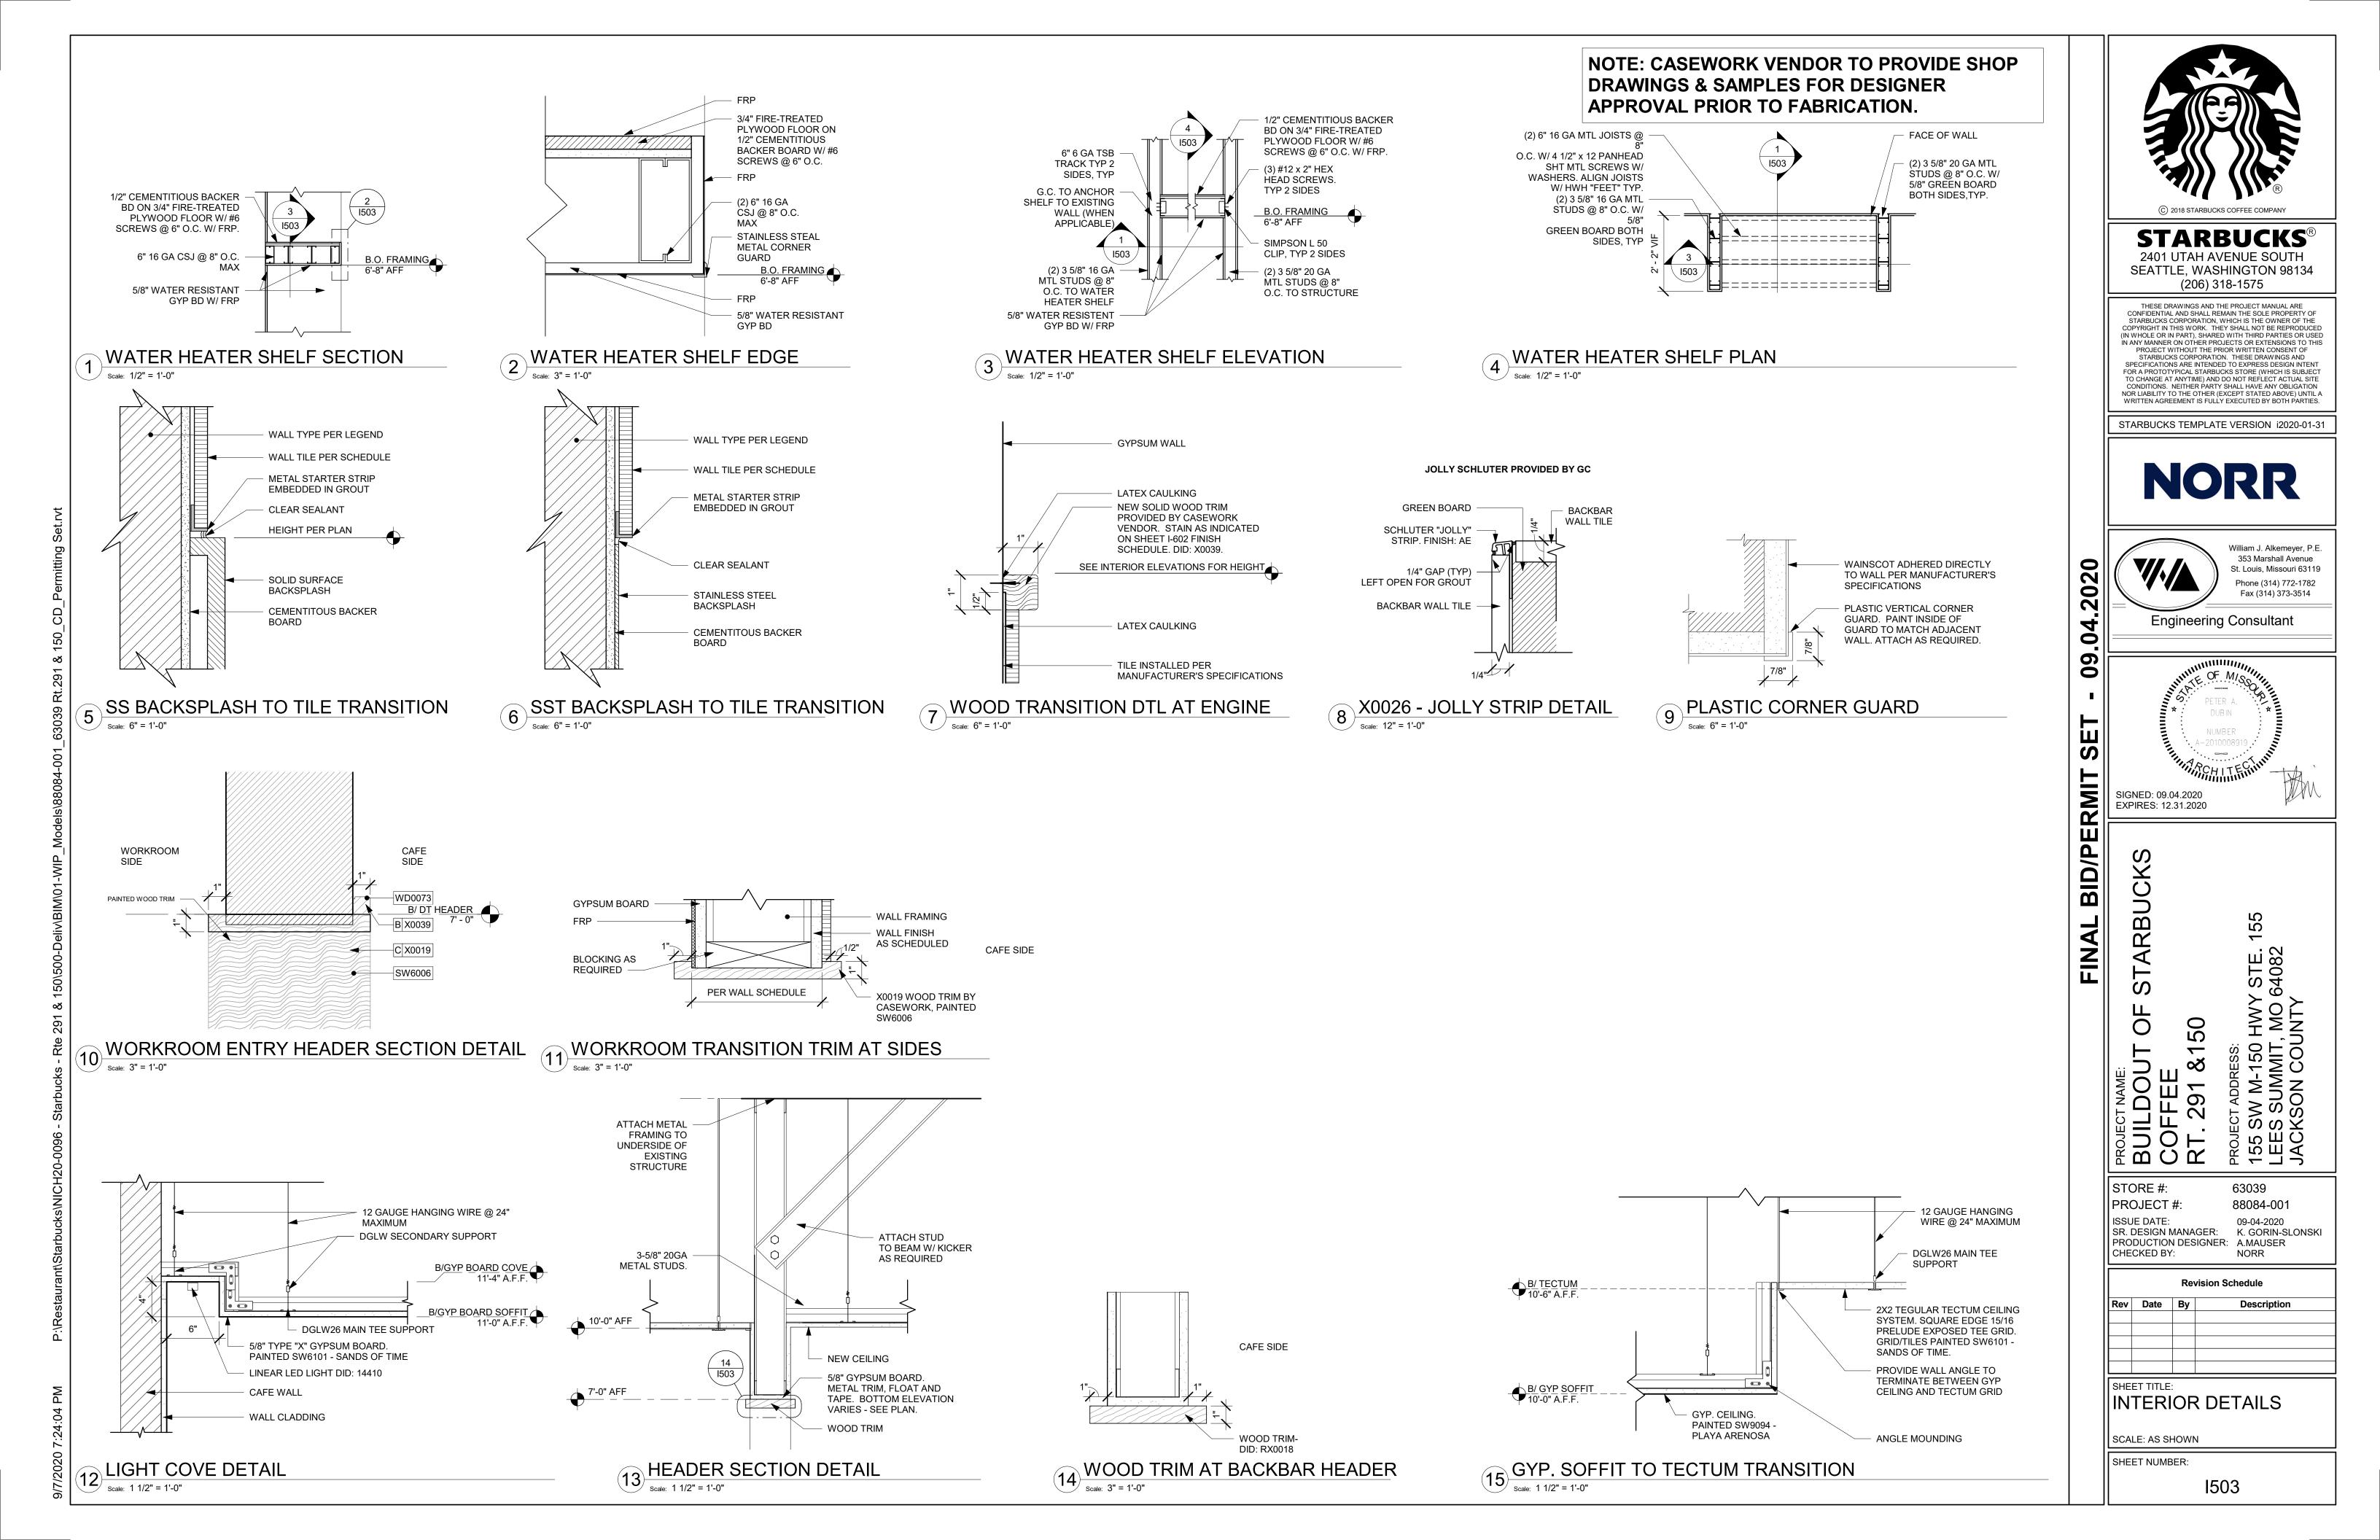

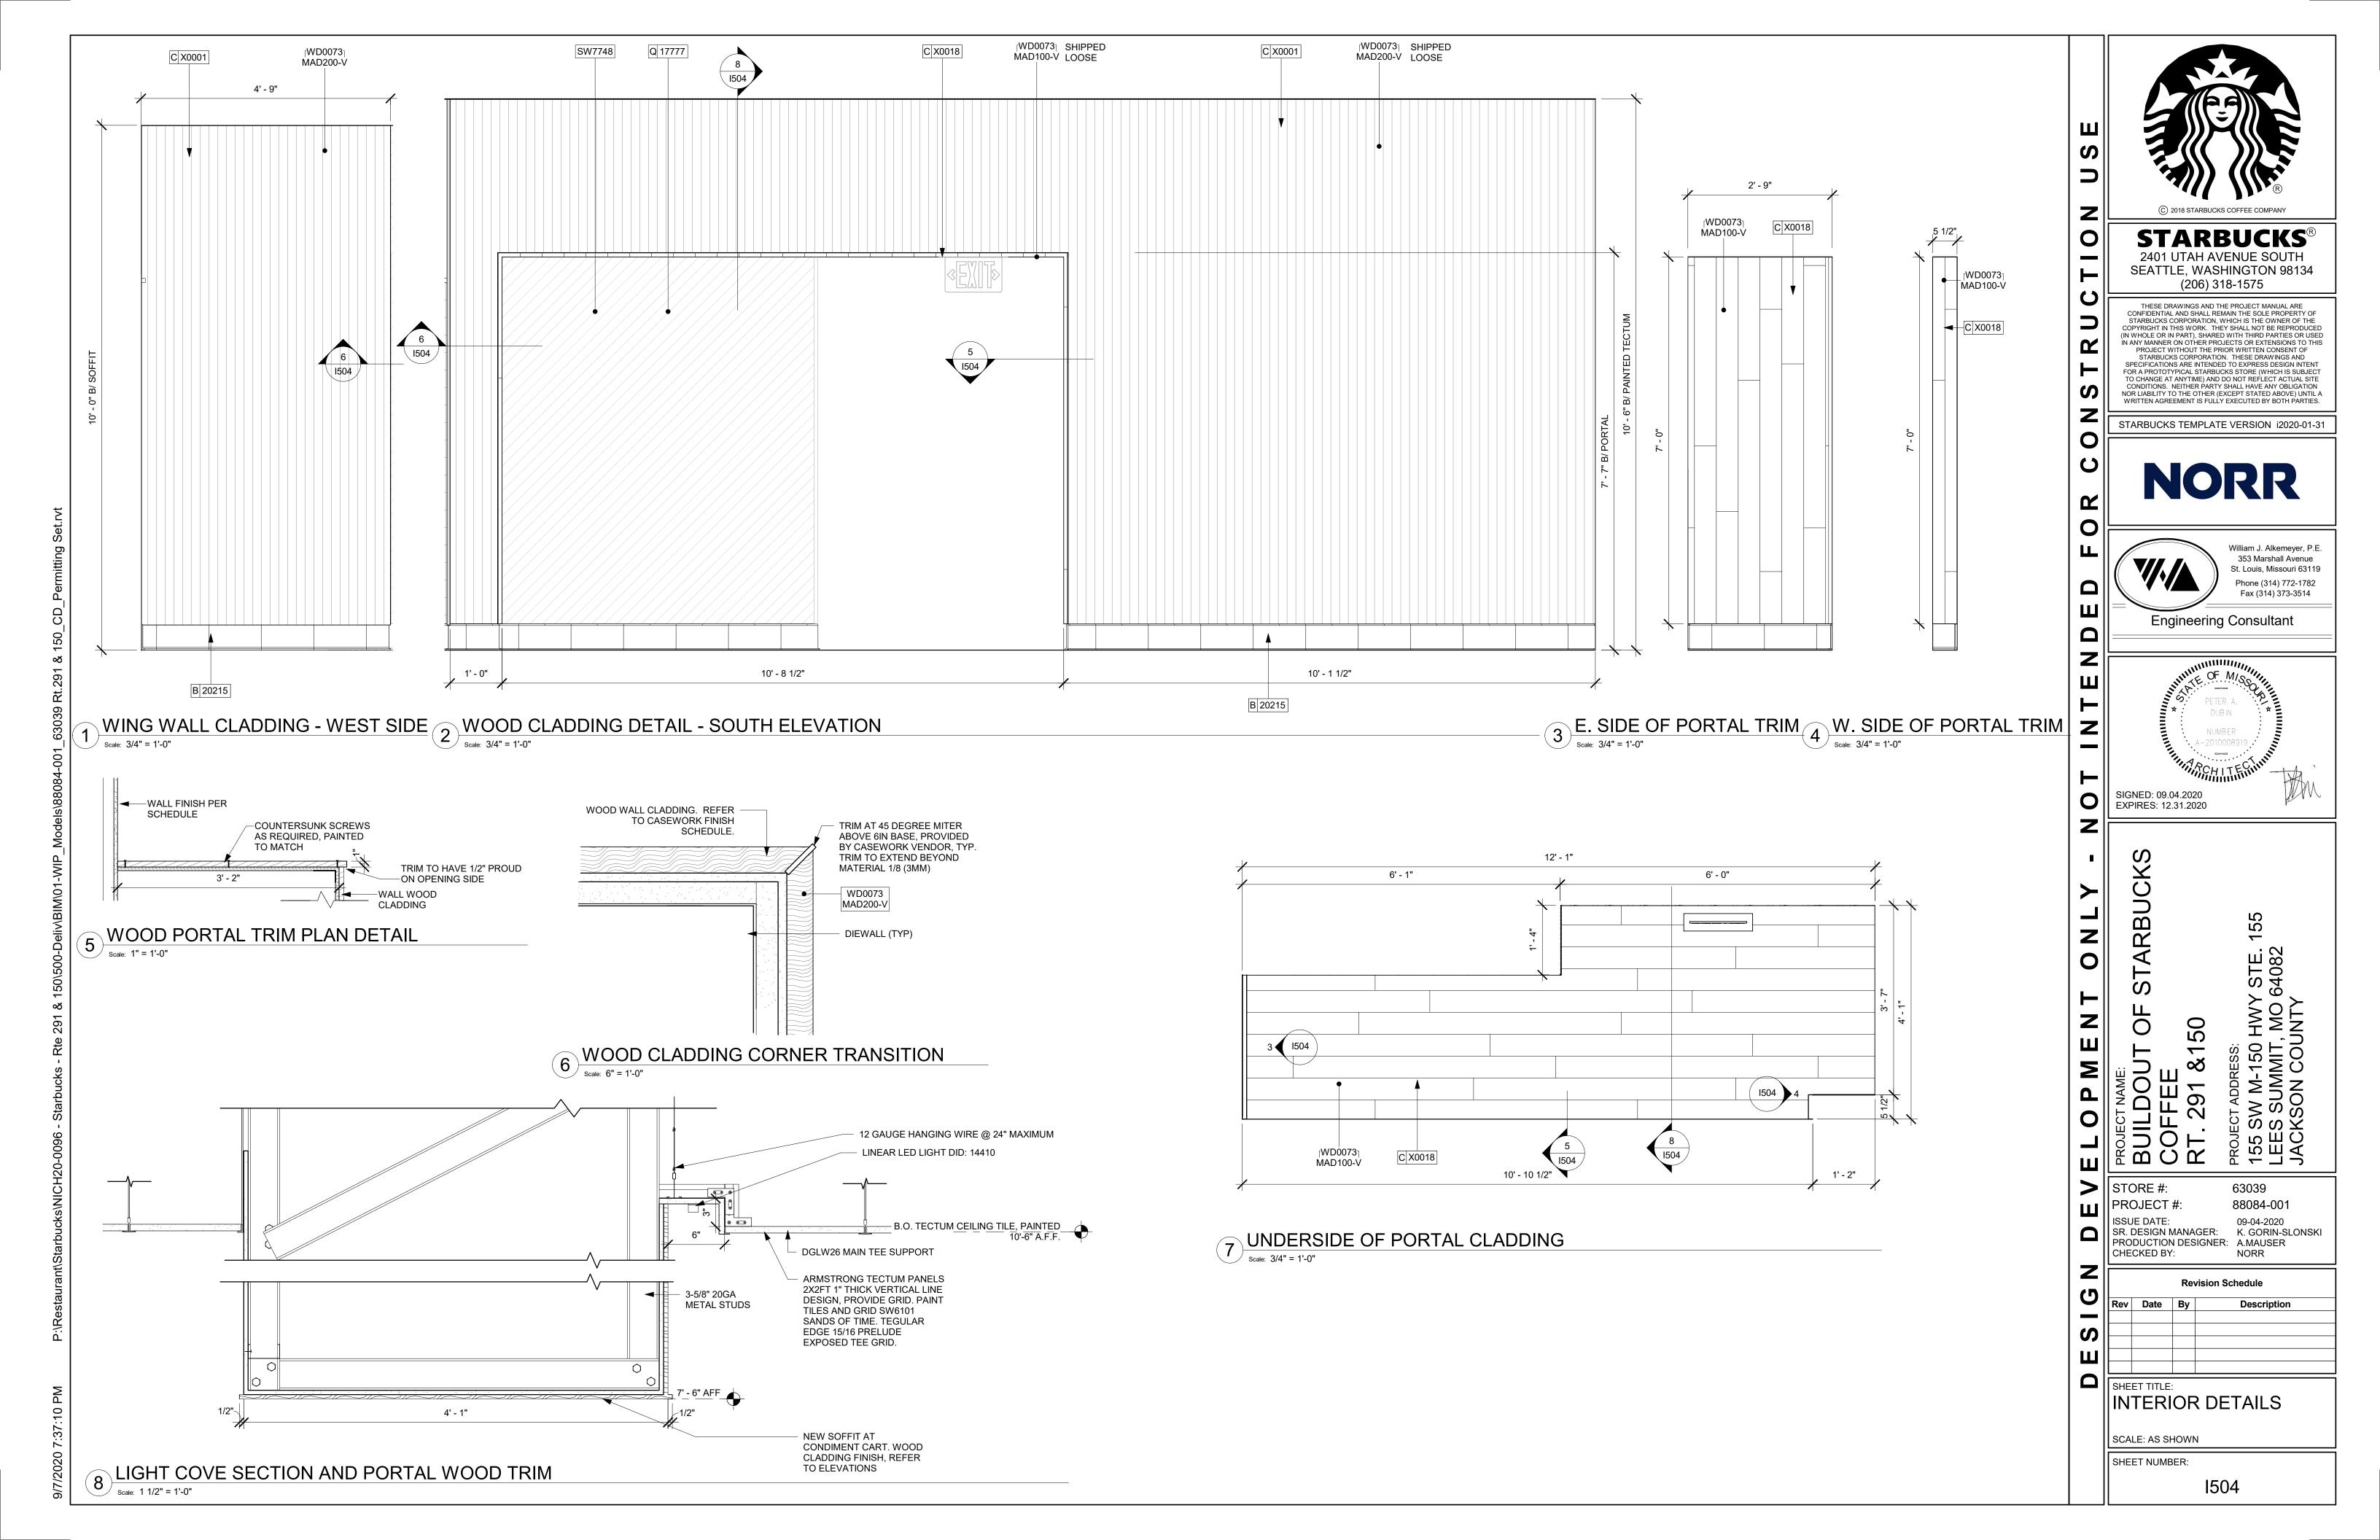


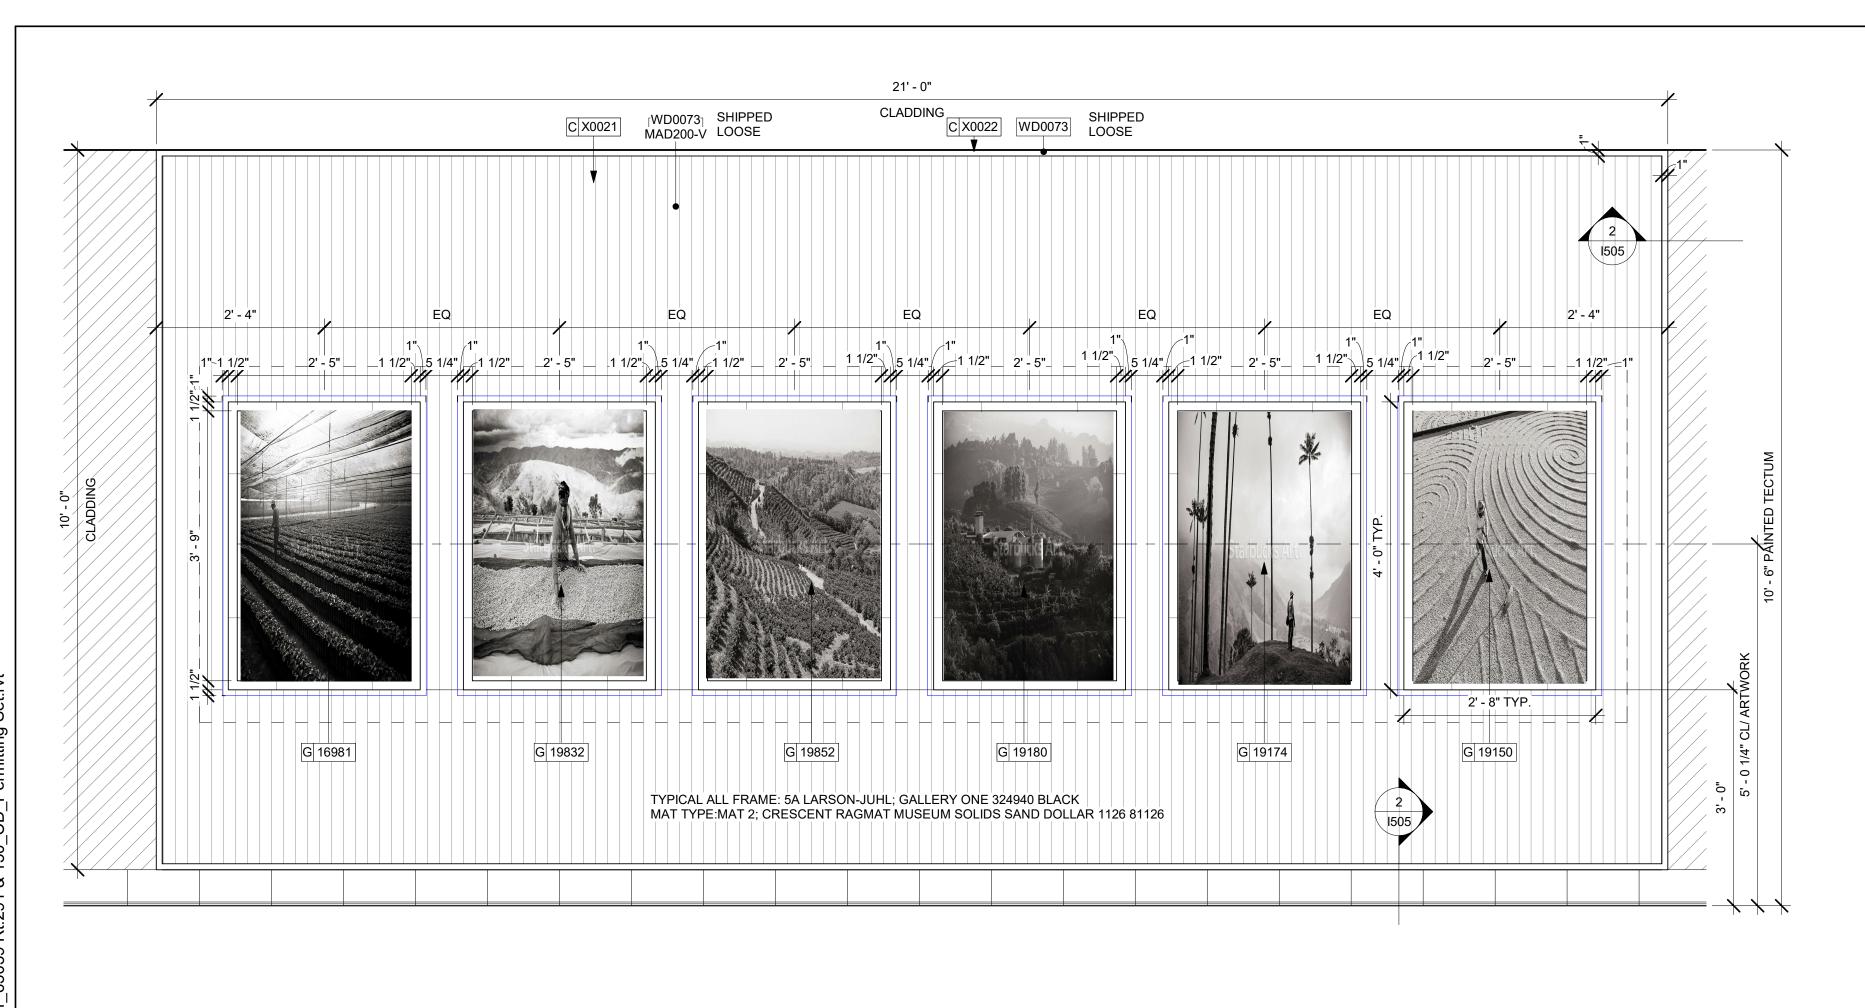


ARTWORK ELEVATION Scale: 3/4" = 1'-0"

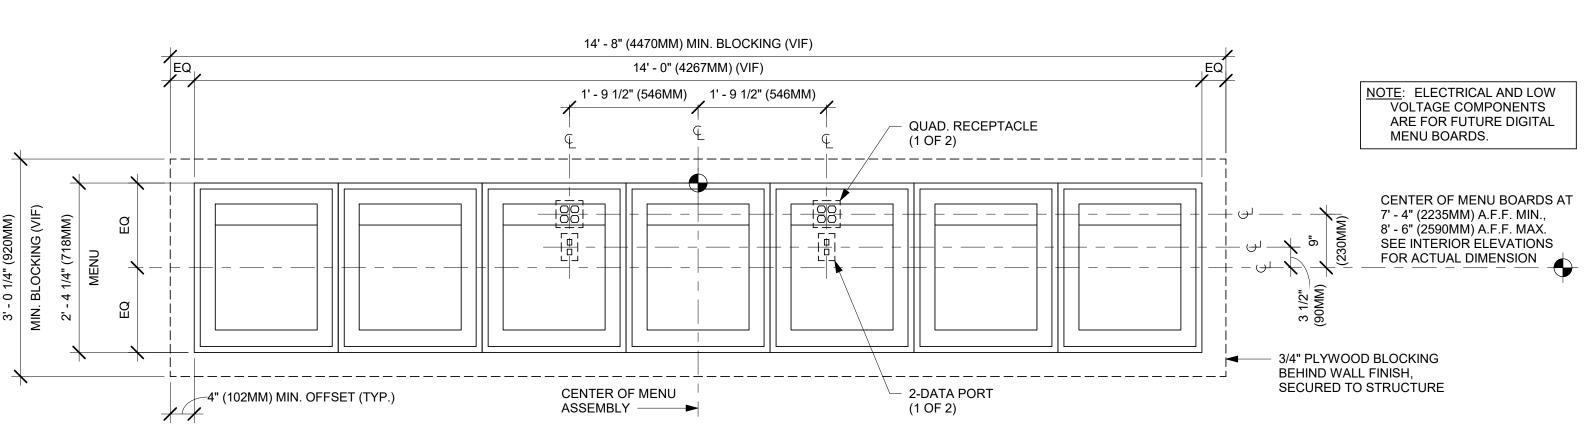


INFRASTRUCTURE FOR FUTURE DIGITAL MENU BOARDS Scale: 3/4" = 1'-0"

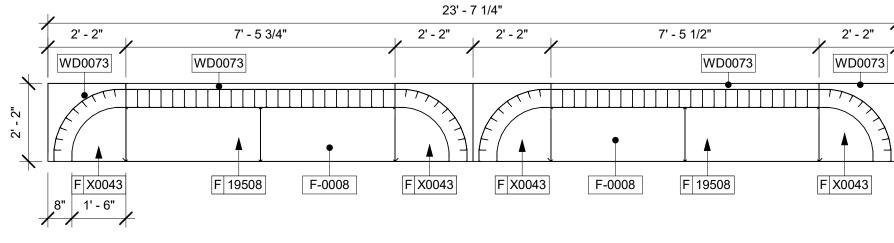

BANQUETTE DETAIL Scale: 3/8" = 1'-0"

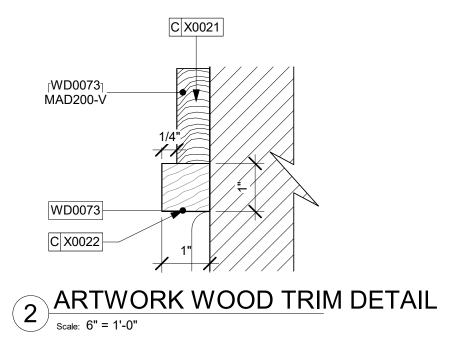

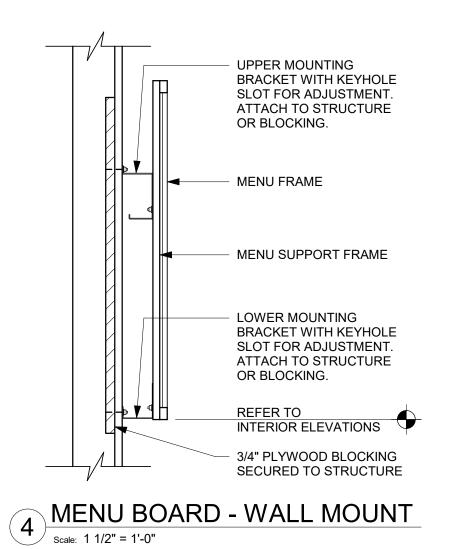



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Engineering Consultant

SIGNED: 09.04.2020 EXPIRES: 12.31.2020

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PROJECT NAME:
BUILDOUT
COFFEE
RT. 291 &15

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/ STE. 64082

STORE #: 63039 PROJECT #: 88084-001

ISSUE DATE: 09-04-2020 SR. DESIGN MANAGER: K. GORIN-SLONSKI PRODUCTION DESIGNER: A.MAUSER CHECKED BY: NORR

Revision Schedule

Rev Date By Description SHEET TITLE:

INTERIOR DETAILS SCALE: AS SHOWN

SHEET NUMBER:

1505

DESIGN ID	COUNT	DESCRIPTION	FURN. BY	INST RY	COMMENTS
BANQUETTE		BEOOKII HOR	· • · · · · · · · · · · · · · · · · ·	1	
19502	2	BANQUETTE - CLOSTER BASE - WHITE OAK WD0073	SB	GC	LENGTH: 23'- 7 3/4". BANQUETTE TO BE TOP SET. DO NOT FIX TO FLOOR. SEE DETAIL.
19508	2	BANQUETTE - CLOSTER CUSHION VERTICAL STITCH - CARAMEL BROWN NATURAL F0008	SB	GC	LENGTH: 23'-7 3/4". BANQUETTE TO BE TOP SET. DO NOT FIX TO FLOOR. SEE DETAIL.
X0043	4	BANQUETTE - CLOSTER INSIDE CORNER CURVED - WHITE OAK AND CARAMEL BROWN NATURAL WD0073 F0008	SB	GC	BANQUETTE TO BE TOP SET. DO NOT FIX TO FLOOR. SEE DETAIL.
BENCH					<u> </u>
19313	1	BENCH - BANK - 66IN 1675MM - CARAMEL BROWN NATURAL F0008	SB	GC	
CHAIR			•		
17852	16	CHAIR - CAFE PYRAMID - BLACK AND BROWN ROPE MT0028 F0194	SB	GC	
19912	16	CHAIR - CAFE ANNA UPHOLSTERED - WHITE OAK AND CARAMEL BROWN NATURAL WD0073 F0008	SB	GC	
20087	2	CHAIR - LOUNGE PYRAMID - BLACK AND BROWN ROPE MT0028 F0194	SB	GC	
21004	4	CHAIR - LOUNGE KIMBERLY - DEEP GREEN NATURAL F0230	SB	GC	
DESK		-			
10123	1	DESK - MANAGERS WORKSTATION - 60X30X30IN 1525X760X760MM	SB	GC	
10605	1	DESK - MANAGERS WORKSTATION KEYBOARD TRAY	SB	GC	
16505	1	DESK - MANAGERS WORKSTATION SHELVES - 36IN 915MM	SB	GC	
MIRROR			•	'	
10342	2	MIRROR - RESTROOM - 18X36IN 455X915MM	SB	GC	
OTHER		_			
10756	2	COAT HOOK 1 PRONG SQUARE - 2IN 50MM - SST	SB	GC	
10820	1	COAT HOOK STRIP - 46IN 1170MM	SB	GC	
TABLE					
17340	6	TABLE - CAFE METAL PEDESTAL BASE SQUARE - 24IN 610MM - BLACK MT0028	SB	GC	
17341	2	TABLE - ACCESSIBLE METAL WITH TAPERED LEGS - 36X24IN 915X610MM - BLACK MT0028	SB	GC	
17645	6	TABLE - TOP SQUARE - 24IN 610MM - WHITE OAK WD0073	SB	GC	
18162	1	TABLE - OCCASIONAL CONCRETE ROUND - 28IN 710MM - BEIGE CHARCOAL OMBRE CT0001 CT0002	SB	GC	
18467	4	TABLE - TOP ACCESSIBLE OBLONG - 24X48IN 610X1220MM - WHITE OAK WD0073	SB	GC	
18468	8	TABLE - BASE CAFE T LEG - HOT ROLLED STEEL MT0011	SB	GC	
19306	2	TABLE - TOP ROUND - 18IN 455MM - WHITE OAK WD0073	SB	GC	
19718	2	TABLE - BASE OCCASIONAL SIDE ESSENTIAL - FLAT BLACK MT0028	SB	GC	
20545	4	TABLE - OCCASIONAL COCKTAIL STUDY - FLAT BLACK MT0028	SB	GC	
21449	6	TABLE - BASE CAFE HEIGHT BOTTLE - FLAT BLACK MT0028	SB	GC	
WINDOW TR	REATMENT				
12716	7	ROLLER SHADE - CHARCOAL TRANSLUCENT F0049 - 5PC OPEN	SB	GC	

DESIGN ID	COUNT	DESCRIPTION	FURN. BY	INCT DV	COMMENTS
EXTERIOR N		DESCRIPTION	FURN. DI	INSI. DI	COMMENTS
14116	1	MENU BOARD - DT DIGITAL ORDER SCREEN - FLAT BLACK MT0028	SB	SB/GC	SUPPLIER: IT EQUIPMENT VENDOR (ZONES). SCREEN INSTALLER: REGIONAL SIGNAGE VENDOR. ELECTRICAL: GC CONNECTS DOS WHIPS & STUB-UPS TO DCB.
14119	1	MENU BOARD - DT 5 PANEL FREESTANDING - 108X65IN 2745X1650MM - FLAT BLACK MT0028	SB	SB/GC	SUPPLIER: DT SIGNAGE VENDOR (DSA). INSTALLER: REGIONAL SIGNAGE VENDOR. LL TO PROVIDE FOOTING, CONDUIT AND ANCHOR BOLTS
14120	1	MENU BOARD - DT PRE MENU FREESTANDING - 36X65IN 915X1650MM - FLAT BLACK MT0028	SB	SB/GC	SUPPLIER: DT SIGNAGE VENDOR (DSA). INSTALLER: REGIONAL SIGNAGE VENDOR. LL TO PROVIDE FOOTING, CONDUIT AND ANCHOR BOLTS
15700	1	MENU BOARD - DT DIGITAL ORDER SCREEN CONTROL BOX	SB	SB/GC	SUPPLIER: IT EQUIPMENT VENDOR (ZONES). INSTALLER: REGIONAL SIGNAGE VENDOR. ELECTRICAL CONNECTION: GC. LL TO PROVIDE FOOTING, CONDUIT AND ANCHOR BOLTS
OTHER					
14103	7	BOLLARD NONILLUMINATED SQUARE - FLAT BLACK MT0028	LL	LL	DSA PHOTOTECH. SEE DTL.
14163	1	DT ORDER POINT CANOPY FREESTANDING - FLAT BLACK MT0028	SB	SB/GC	SUPPLIER: DT SIGNAGE VENDOR (DSA). INSTALLER: REGIONAL SIGNAGE VENDOR. LL TO PROVIDE FOOTING, CONDUIT AND ANCHOR BOLTS
18818	2	LIGHT POLE - 10FT 300CM - FLAT BLACK MT0028	SB	GC	GC TO PROVIDE AIRLINE CABLE AND HOOKS AS NEEDED FOR LIGHT INSTALLATION.
18820	2	LIGHT POLE BASE PLATE - FLAT BLACK MT0028	SB	GC	
X0007	2	VEHICLE DETECTOR LOOP	SB	GC	SUPPLIER: DT AUDIO VENDOR (HME). INSTALLER: GC. LL TO PROVIDE CONDUIT
X0014	2	BIKE RACK - OLYMPIA	LL	LL	FORMS & SURFACES: OLYMPIA BIKE RACK. WWW.FORMS-SURFACES.COM; INSTALL PER MANUFACTURER'S RECOMMENDATIONS.FINISH: STANDARD BLACK TEXTURE.
PLANTER					
X0004	11	CONCRETE PLANTER BOX	LL	LL	CONCRETE PLANTERS WITH IRRIGATION BY LANDLORD. LL TO PROVIDE SPEC TO CM FOR APPROVAL.LL TO PROVIDE LANDSCAPING.COORDINATE WITH OPERATIONS PRIOR TO INSTALLATION.
UMBRELLA	<u> </u>				
12147	3	UMBRELLA - BASE 95LB 43KG - FLAT BLACK MT0028	SB	GC	
20073	3	UMBRELLA - WITHOUT VALANCE - 6FT 183CM - GREEN CANVAS WITH WORDMARK F0056	SB	GC	

		SPECIALTY EQUIPMEN			
DESIGN ID COOLING	COUNT	DESCRIPTION	FURN. BY	INST. BY	COMMENTS
10267	5	FRIDGE UNDERCOUNTER 1 DOOR - 27IN 685MM	SB	GC	
11083	2	FRIDGE REACH IN 2 DOOR - 51X35IN 1295X890MM	SB	GC	
12618	2	FRIDGE UNDERCOUNTER 1 DOOR WITH SHELF - 27IN 685MM	SB	GC	
13676	1	FREEZER REACH IN 1 DOOR RH - 27IN 685MM	SB	GC	
13682	1	FREEZER REACH IN 2 DOOR - 54IN 1370MM	SB	GC	
20010	1	FRIDGE NITRO 2 TAP JT NITCOM LH	SB	GC	KIT INCLUDES UNDERCOUNTER FRIDGE, FONT, TRAY, AND TUBING
EQUIPMENT 10312	4	BREWER SOFT HEAT WARMING STAND SINGLE	SB	GC	
10746	1	BREWER DUAL SOFT HEAT	SB	GC	GC TO COORDINATE WITH SBUX VENDOR.
10808	1	GRINDER DITTING KR1203	SB	GC	GC TO COORDINATE WITH SBUX VENDOR.
10856	6	BREWER SERVER SOFT HEAT	SB	GC	
12508 15186	2 1	BLENDER QUIET MODEL ON COUNTER DISHWASHER HOT LOW STEAM	SB SB	GC GC	
16623	1	SCALE DIGITAL WITH ADJUSTABLE DISPLAY	SB	GC	
17564	1	MOUNT SMALL BLENDER PITCHER RINSER WITH SENSOR	SB	GC	
19559	1	NITROGEN GENERATOR ELEMENT	SB	GC	GC TO COORDINATE INSTALLATION & CONNECTIONS WITH SBUX VENDOR
19742	2	ESPRESSO MACHINE MASTRENA II	SB	GC	GC TO COORDINATE WITH SBUX VENDOR.
20032	2	OVEN EIKON E2S - BLACK	SB	GC	
FOOD CASE 16238	<u> </u>	FOOD CASE - ZEPHYR - 66IN 1675MM	SB	GC	
ICE	·				
10344	1	ICE - BIN DROP IN 90LB 40KG	SB SB	GC GC	
18029 18846	<u>1</u> 1	ICE - BIN B110 ICE - MACHINE CIM1446HR SERIES REMOTE	SB	GC	
		COOLED			
19278 OTHER	2	ICE - BIN DROP IN 45LB 20KG HORIZONTAL	SB	GC	
10091	1	CUP DISPENSER TALL HOT VERTICAL	SB	GC	
10099	2	RESTROOM TOILET PAPER HOLDER	SB	GC	
10172	2	RESTROOM SEAT COVER DISPENSER	SB	GC	
10384	2	DIAPER CHANGING STATION HORIZONTAL	SB	GC	
10396	1	CUP DISPENSER SHORT HOT VERTICAL	SB	GC	
10467	1	FILE CABINET 2 DRAWER	SB	GC	
10501	1	FIRE EXTINGUISHER	GC	GC	LOCALLY SOURCED.
10769	2	RESTROOM GRAB BAR VERTICAL - 18IN 455MM	SB	GC	
10791	2	CUP DISPENSER GRANDE VENTI COLD VERTICAL	SB	GC	
10855	2	CUP DISPENSER GRANDE VENTI HOT VERTICAL	SB	GC	
10858	1	CUP DISPENSER TALL COLD VERTICAL	SB	GC	
10859	2	RESTROOM GRAB BAR - 48IN 1220MM	SB	GC	
10862	2	RESTROOM GRAB BAR - 36IN 915MM	SB	GC	
10947 10977	1 1	SOAP DISPENSER WALL MOUNTED PAPER TOWEL DISPENSER FULL SIZE -	SB SB	GC GC	
10992	2	TRANSLUCENT GRAY PAPER TOWEL DISPENSER HALF SIZE -	SB	GC	
10992		TRANSLUCENT GRAY	ЗВ	GC	
11115	2	SOAP DISPENSER SINK MOUNTED	SB	GC	
13330	1	MOBILE CUP DISPENSER CADDY	SB SB	GC	
13584 19495	<u> </u>	CUP DISPENSER TRENTA COLD VERTICAL NITRO 2 TAP HANDLE AND BADGE KIT	SB	GC GC	19495 RETIRED; ORDER FOUR SKU #'S: 011095591, 011095592, 011095587,
20070		NITEO 2 TAD BADOE MOUNT BAOKBAD III	SB	CC	011095588.
20079 20080	<u>1</u> 1	NITRO 2 TAP BADGE MOUNT BACKBAR LH NITRO 2 TAP BADGE MOUNT BACKBAR RH	SB	GC GC	
X0011	2	HAND DRYER - INTEGRATED	GC	GC	XLERATOR SYNC HAND DYER. AUTOMATIC SENSOR OPERATED. SURFACE MOUNTED. CONTACT: D 13 GROUP. 245 WEST CENTRA STREET, NATICK, MA 01760. PH: 617-307-1140. WWW.D13GROUP.COM EMAIL
X0045	2	SOAP DISPENSER - STERN	GC	GC	KRIZZO@D13GROUP.COM STERN. GREEN/CHROME SOAP DISPENSEF PART #07100008. PART OF D 13 INTEGRATED SINK SYSTEM. CONTACT: D 13 GROUP. 245 WEST CENTRAL STREET, NATICK, MA 01760. PH: 617-307-1140. WWW.D13GROUP.COM EMAIL:
					KRIZZO@D13GROUP.COM
STORAGE 10222	2	WIRE SHELL COID AT SIMIL	SB	GC	I
10222	8	WIRE SHELF GRID AT SINK WORKROOM SHELVING - 36IN 915MM	SB	GC GC	
10416	 8	WORKROOM SHELVING - 30IN 9 TSIMINI WORKROOM SHELVING POSTS	SB	GC	
10698	1	MOP RACK WITH 3 HOLDERS	SB	GC	
13834	1	BASE - 24X18IN 610X455MM	SB	GC	
15699	1	PARTNER WORK CENTER	SB	GC	
17255 17264	1	PASTRY TRAY CART - 60IN 1525MM ROLLING PASTRY TRAY THAW RACK - 20X26IN 510X660MM	SB SB	GC GC	
17639	1	WORKROOM CART - 24IN 610MM	SB	GC	
19476	2	5 COMP LOCKER - 12IN 305MM	SB	GC	

MECHANICAL EQUIPMENT SCHEDULE - "M"							
DESIGN ID	COUNT	DESCRIPTION	FURN. BY	INST. BY	COMMENTS		
FAN			•				
10894	1	FAN - DT AIR CURTAIN WITH HEATER - 48IN 1220MM	LL	LL	READY ACCESS AIR AA300 PASS-THRU AIR CURTAIN. CONTACT: ANNA ELLIS ANNA@READY-ACCESS.COM		
X0042	1	FAN - WALL MOUNTED FAN - PATIO	GC	GC	GLOBAL INDUSTRIAL 30IN OSCILLATING WALL MOUNTED FAN. ITEM #T9F292451. GC TO PROVIDE MOUNTING PARTS AS NEEDED LL TO PROVIDE POWER.		
HVAC							
10317	17	HVAC - VAV SUPPLY 4 WAY SQUARE - 24IN 610MM	GC	GC	SEE MECHANICAL SCHEDULES. FACTORY PAINT TO MATCH ASSOCIATED CEILING COLOR.		
11108	3	HVAC - SUPPLY 4 WAY LAY IN SQUARE - 12IN 305MM	GC	GC	SEE MECHANICAL SCHEDULES. FACTORY PAINT TO MATCH ASSOCIATED CEILING COLOR.		
11163	2	HVAC - RETURN LAY IN SQUARE - 24IN 610MM	GC	GC	SEE MECHANICAL SCHEDULES. FACTORY PAINT TO MATCH ASSOCIATED CEILING COLOR.		
11165	2	HVAC - RETURN CHANNEL FRAME SQUARE - 10IN 255MM	GC	GC	SEE MECHANICAL SCHEDULES. FACTORY PAINT TO MATCH ASSOCIATED CEILING COLOR.		
OTHER							
17797	1	ENERGY MANAGEMENT SYSTEM - HVAC ONLY	SB	GC			
X0028	2	ACCESS PANEL	GC	GC	BAUCO PLUS II. MODEL #20-58-2424. PAINT TO MATCH ADJACENT FINISH.		

DESIGN ID	COUNT	DESCRIPTION	FURN. BY	INST. BY	COMMENTS
AUDIO VISU	AL	1	l .		
10005	1	MUSIC SYSTEM	SB	SB	GC TO INSTALL AND TEST SYSTEM.
10010	1	DT ORDER MONITOR	SB	SB	
10012	1	DT COMMUNICATION SYSTEM	SB	SB	
10015	4	SPEAKER RECESSED - WHITE	SB	SB	
10017	2	SPEAKER SURFACE MOUNTED - BLACK	SB	SB	
12336	1	DT TIMER SYSTEM	SB	SB	
14676	1	DT POS MONITOR ARM DOUBLE SURFACE MOUNTED	SB	GC	
19339	1	AMPLIFIER - 40W	SB	SB	GC TO INSTALL AND TEST SYSTEM.
DATA					
10002	1	COMPUTER MANAGER WORKSTATION	SB	SB	
10007	1	PRINTER MANAGER WORKSTATION	SB	SB	
18744	1	EQUIPMENT RACK WITH LOCK - 24IN 610MM	SB	SB	
20294	4	IOT MODULE	SB	SB	
POINT OF S	ALE			•	
10008	2	POS - REGISTER WITH COMPACT CASH DRAWER	SB	SB	GC TO COORDINATE WITH SBUX VEND
10014	4	POS PRINTER	SB	SB	GC TO COORDINATE WITH SBUX VEND
10022	1	MONEY COUNTER	SB	SB	GC TO COORDINATE WITH SBUX VEND
10029	6	POS BANK	SB	GC	
10075	3	CUP LABELER	SB	SB	GC TO COORDINATE WITH SBUX VEND
14677	1	POS - DT TENDERING REGISTER	SB	SB	PART OF RETAIL IT EQUIPMENT PACKA
14678	1	POS - DT EXPEDITOR	SB	SB	PART OF RETAIL IT EQUIPMENT PACKA
SECURITY				•	
10024	1	SAFE LH - 20X18X26IN 510X455X660MM	SB	GC	GC TO COORDINATE WITH SBUX VEND STORE MANAGER TO PROGRAM WITH VENDOR PROVIDED MANUAL.
10028	1	SAFE BASE	SB	GC	GC TO COORDINATE WITH SBUX VENDOSTORE MANAGER TO PROGRAM WITH VENDOR PROVIDED MANUAL.

		PLUMBING FIXTURE			
DESIGN ID DRAIN	COUNT	DESCRIPTION	FURN. BY	INST. BY	COMMENTS
10294	7	DRAIN - FLOOR SINK SQUARE - 12IN 305MM	SB	GC	ZURN MODEL #FD2375-NH3.
10594	4	DRAIN - FLOOR SINK SQUARE - 5IN 125MM	GC	GC	JAY R. SMITH MODEL #2005Y (B) OR EQ
10726	7	DRAIN - GRATE HALF SQUARE - 12IN 305MM	SB	GC	ZURN MODEL #FD2375-NH3-H.
FAUCET	'	DIVIN GIVILLIAE GOOME 1211 GOOMW	OB	100	ZOTAT MODEL #1 DZOTO TATIOTI.
10152	1	FAUCET - DOUBLE LABORATORY WITH BENT	SB	GC	
10102	•	RISER SPOUT			
10153	2	FAUCET - WATER TOWER - 12IN 305MM	SB	GC	
10215	3	FAUCET - DOUBLE LABORATORY WITH SWING		GC	
		SPOUT			
10447	1	FAUCET - PRE RINSE SPRAYER WALL	SB	GC	
		MOUNTED			
10597	2	FAUCET - SINGLE HANDLE	SB	GC	
10804	1	FAUCET - PRE RINSE SWING SPOUT	SB	GC	
10874	1	FAUCET - HOT WATER SYSTEM GOOSENECK	SB	GC	
10922	1	FAUCET - MOP SINK WALL MOUNTED	SB	GC	
11003	3	FAUCET - METERED	SB	GC	
13588	1	FAUCET - HAND SINK WALL MOUNTED	SB	GC	
15749	2	FAUCET - HOT AND COLD WATER SYSTEM	SB	GC	
X0036	2	FAUCET - STERN	GC	GC	STERN. CONDOR 1010. PART #07100009
					CHROME. PART OF D 13 INTEGRATED S SYSTEM. CONTACT: D 13 GROUP. 245 V CENTRAL STREET, NATICK, MA 01760. F 617-307-1140. WWW.D13GROUP.COM E KRIZZO@D13GROUP.COM
FILTER			1	1	
12501	1	FILTER - RO SYSTEM 600GPD	SB	GC	CONFIGURATION 3. GC TO COORDINAT
			-		WITH SBUX VENDOR.
12507	1	FILTER - RO SYSTEM 40GAL STORAGE TANK	SB	GC	CONFIGURATION 3. GC TO COORDINAT
10000		EII TED. DDINE TANK	0.0	00	WITH SBUX VENDOR.
12896	1	FILTER - BRINE TANK	SB	GC	CONFIGURATION 3. GC TO COORDINAT WITH SBUX VENDOR.
12899	2	FILTER - POLY GLASS VESSEL	SB	GC	CONFIGURATION 3. GC TO COORDINAT
12099	2	FILTER - POLT GLASS VESSEL	SD	GC	WITH SBUX VENDOR.
13076	1	FILTER - PREFILTRATION SYSTEM	SB	GC	CONFIGURATION 3. GC TO COORDINAT
13070	·	TIETEK-TIKETIETIKATION STSTEW	OD		WITH SBUX VENDOR.
13082	1	FILTER - WATER SOFTENER TWIN	SB	GC	CONFIGURATION 3. GC TO COORDINAT
	•				WITH SBUX VENDOR.
13149	1	FILTER - PRESSURE GAUGE	SB	GC	CONFIGURATION 3. GC TO COORDINAT
					WITH SBUX VENDOR.
OTHER				_	
13384	1	WATER HEATER TANK GAS	GC	GC	AO SMITH POLARIS HIGH EFFICIENCY MODEL #BSS 130, 165 GPH RECOVERY @90 DEGREE RISE. SET WATER HEATE TO 140 DEG MAX ENERGY FACTOR = 0
SINK		I	T	T = -	
10549	1	SINK - RINSE DROP IN SST - 12X20IN	SB	GC	
		305X510MM			
10995	1	SINK - MOP - 24X24IN 610X610MM	SB	GC	
12808	1	SINK - UTENSIL RINSE WITH GRATE SST - RH - 14X20IN 355X510MM	SR	GC	
12064	4		CD.	GC	
13264	1	SINK - 3 COMP WORK SST - 93IN 2350MM	SB	GC	
14688	1	SINK - HAND WITH SIDE SPLASH WALL MOUNTED SST	SB	GC	
17565	1	SINK - RINSE WITH DRAINBOARD - 15X27IN	SB	GC	
17 300	ı	380X685MM	100		
17632	1	SINK - STACKED DRAINBOARD - 15IN 380MM	SB	GC	
18743	1	SINK - WATER FILLING STATION - 36X24IN	SB	GC	
.07 70	į	915X610MM			
19277	2	SINK - COUNTERTOP RINSER WITH DRAIN TROUGH - 26X9IN 660X235MM	SB	GC	
X0035	2	SINK - D13	GC	GC	D 13 INTEGRATED SINK SYSTEM. 30IN
					XLERATORSYNC SYSTEM WITH A SING BASIN SINK WITH A PIVOT DRAIN COVE GLACIER WHITE CORIAN COUNTER TO AND ENCLOSURE PANELS. BASIN COLD DIS WHITE. ORDER WITH LOCKING SL DOOR & SECURITY PANEL. CONTACT: I GROUP. 245 WEST CENTRAL STREET, NATICK, MA 01760. PH: 617-307-1140. WWW.D13GROUP.COM EMAIL: KRIZZO@D13GROUP.COM
			I	1	
TOU ET				1	
TOILET	2	TOILET - TANKI ESS EFFICIENT SINICI E EL LISU	GC	GC	SLOAN MODEL ST-2020 1 20 /1 20 CDEV
TOILET 12951 13040	2 2	TOILET - TANKLESS EFFICIENT SINGLE FLUSH TOILET - FLUSH VALVE AUTOMATIC	GC GC	GC GC	SLOAN MODEL ST-2020-1.28 (1.28 GPF) CROWN MODEL 8111-1.28 FLUSHOMET

RESPONSIBILITY LEGEND

GC GENERAL CONTRACTOR LL LANDLORD SB STARBUCKS



STARBUCKS®

2401 UTAH AVENUE SOUTH SEATTLE, WASHINGTON 98134 (206) 318-1575

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STARBUCKS TEMPLATE VERSION i2020-01-31





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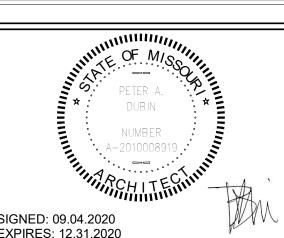
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BID/PER

353 Marshall Avenue St. Louis, Missouri 63119 Phone (314) 772-1782 Fax (314) 373-3514

Engineering Consultant



SIGNED: 09.04.2020 EXPIRES: 12.31.2020

PROJECT ADDRESS:
155 SW M-150 HWY STE. 1
LEES SUMMIT, MO 64082
JACKSON COUNTY PROJECT NAME:
BUILDOUT OF
COFFEE
RT. 291 &150

STORE #: 63039 PROJECT #: 88084-001

ISSUE DATE: 09-04-2020
SR. DESIGN MANAGER: K. GORIN-SLONSKI
PRODUCTION DESIGNER: A.MAUSER
CHECKED BY: NORR

Rev Date By Description SHEET TITLE:

SCHEDULES

SCALE: AS SHOWN

SHEET NUMBER:

1601

PAINT SCHEDULE - "PT"									
DESIGN ID	DESCRIPTION	LRV	FURN. BY	INST. BY	COMMENTS				
SW6006	SW6006 BLACK BEAN, OR EQUIVALENT	4	GC	GC	TRIM AT ENTRY TO WORKROOM				
SW6101	SW6101 SANDS OF TIME, OR EQUIVALENT	39	GC	GC	PAINTED TECTUM PANELS AND GRIDS				
SW7031	SW7031 MEGA GREIGE, OR EQUIVALENT	37	GC	GC	RESTROOM CEILINGS.				
SW7748	SW7748 GREEN EARTH, OR EQUIVALENT	31	GC	GC	PAINTED WALL COVERING IN CAFE AND RESTROOM VESTIBULE.				
SW9094	SW9094 PLAYA ARENOSA, OR EQUIVALENT	60	GC	GC	NORTH CAFE WALL AND BACK BAR SOFFIT				

DESIGN ID	AREA	DESCRIPTION	FURN. BY	INST. BY	COMMENTS
PLASTIC			•		
11469	1035 SF	FRP - WHITE	GC	GC	FULL HEIGHT FRP AT WORKROOM. MANUFACTURER: PARKLAND PLASTICS. CONTACT BRENDON EASH. PHONE (547) 312-1290. EMAIL: BRENDON.EASH@PARKLANDPLASTICS.CO M. PRODUCT PLAST-TEX NRP-HC. COLOR: WHITE.
TILE					
20220	361 SF	TILE - LUNAR - TITANIUM - 24X24IN 600X600MM	SB	GC	GROUT: MAPEI - 111 SILVER GREY, OR EQUAL
20243	141 SF	TILE - COLOR STUDIO - WHITE - BRICK MOSAIC - HORIZONTAL STACK - 12X12IN 300X300MM SHEET	SB	GC	GROUT: MAPEI - 111 SILVER GREY, OR EQUAL
20247	418 SF	TILE - COLOR STUDIO - NIGHT - BRICK MOSAIC - VERTICAL STACK - 12X12IN 300X300MM SHEET	SB	GC	GROUT: MAPEI - 47 CHARCOAL, OR EQUAL
WALL COVE	RING		•	•	
17777	825 SF	WALL TEXTURE - TEXTURGLAS - TG11 SMALL HERRINGBONE	SB	GC	TO BE PAINTED SW7748

	WALL TREATMENT (LENGTH) SCHEDULE- "R"								
DESIGN ID	LENGTH	DESCRIPTION	FURN. BY	INST. BY	COMMENTS				
TRANSITIO	TRANSITION								
X0037	21' - 0"	CLEAR PLASTIC CORNER GUARD - 0.75IN 20MM	GC	GC	GC TO INSTALL FULL HEIGHT. PAINT INSIDE FACE TO MATCH ADJACENT WALL COLOR.				
WOOD TRIM	WOOD TRIM								
X0039	56' - 0 1/4"	WOOD TRIM TRANSITION AT BACK BAR TILE - NOMINAL 1"X1" - WHITE OAK WD0073	SB	GC	MOUNTED PER INTERIOR ELEVATIONS. SERVES AS TRANSITION FOR BACKBAR TILE.BY CASEWORK VENDOR.				

WALL BASE SCHEDULE - "B"						
DESIGN ID	LENGTH	DESCRIPTION	FURN. BY	INST. BY	COMMENTS	
METAL BAS	SE					
X0020	57' - 5 1/4"	METAL BASE - SCHULTER DILEX-AHK COVE	GC	GC	FINISH: SATIN NICKEL. SCHLUTER DILEX-AHK COVE	
TILE BASE	•		•			
19795	182' - 11 1/2"	POLYVINYL FLOOR TILE - ECOGRIP - PEWTER	GC	GC	MANUFACTURER: ALLIED ECO-GRIP. PEWTER	
20215	144' - 0 1/2"	TILE BASE - FORMULA - UNION BLACK - 6X12IN 150X300MM	SB	GC	GROUT: MAPEI - 47 CHARCOAL, OR EQUAL	

FLOOR TREATMENT SCHEDULE - "T"							
DESIGN ID	AREA	DESCRIPTION	FURN. BY	INST. BY	COMMENTS		
PLASTIC	•	•	•				
19795	844 SF	POLYVINYL FLOOR TILE - ECO-GRIP - PEWTER	GC	GC	MANUFACTURER: ALLIED ECO-GRIP. PEWTER		
TILE	•	•	•				
20255	1287 SF	TILE - VENICE VILLA - GRAPHITE - 24X24IN 600X600MM	SB	GC	GROUT: MAPEI - 47 CHARCOAL, OR EQUAL		
WALK OFF	MAT		•				
19288	21 SF	WALK OFF MAT - HELIX Z1 - BLACK - 12X9IN 305X230MM	SB	GC	ORDER WITH METAL FRAME FROM VENDOR		

DESIGN ID	COUNT	DESCRIPTION	FURN. BY	INST. BY	COMMENTS
GRAPHICS -			· Ortan Bi		O MINIER TO
16981		ART - MICHAEL HANSON - COLOMBIA 15 - BW	SB	GC	VENDOR: COLORCHROME. ART DID: 16981. ART SIZE: 2'-6"W X 4'0"H.FRAME DID: 324940 BLACK. MAT 2: 1-1/2" BORDER, CRESCENT RAGMAT MUSEUM SOLIDS, SAND DOLLAR 1126 81126.
19150	1	ART - CREATIVE STUDIO - COSTA RICA 7 - BW	SB	GC	VENDOR: COLORCHROME. ART DID: 19150. ART SIZE: 2'-6"W X 4'0"H.FRAME DID: 32494 BLACK. MAT 2: 1-1/2" BORDER, CRESCENT RAGMAT MUSEUM SOLIDS, SAND DOLLAR 1126 81126.
19174		ART - CREATIVE STUDIO - HACIENDA ALSACIA 2 - BW	SB	GC	VENDOR: COLORCHROME. ART DID: 19174 ART SIZE: 2'-6"W X 4'0"H.FRAME DID: 32494 BLACK. MAT 2: 1-1/2" BORDER, CRESCENT RAGMAT MUSEUM SOLIDS, SAND DOLLAR 1126 81126.
19180		ART - CREATIVE STUDIO - HACIENDA ALSACIA 5 - BW	SB	GC	VENDOR: COLORCHROME. ART DID: 19180 ART SIZE: 2'-6"W X 4'0"H.FRAME DID: 32494 BLACK. MAT 2: 1-1/2" BORDER, CRESCENT RAGMAT MUSEUM SOLIDS, SAND DOLLAR 1126 81126.
19832	1	ART - JOSHUA TRUJILLO - CHIAPAS 5 - BW	SB	GC	VENDOR: COLORCHROME. ART DID: 19832 ART SIZE: 2'-6"W X 4'0"H.FRAME DID: 32494 BLACK. MAT 2: 1-1/2" BORDER, CRESCENT RAGMAT MUSEUM SOLIDS, SAND DOLLAR 1126 81126.
19852	1	ART - JOSHUA TRUJILLO - RWANDA 1 - BW	SB	GC	VENDOR: COLORCHROME. ART DID: 19852 ART SIZE: 2'-6"W X 4'0"H.FRAME DID: 32494 BLACK. MAT 2: 1-1/2" BORDER, CRESCENT RAGMAT MUSEUM SOLIDS, SAND DOLLAR 1126 81126.
GRAPHICS -	INTERIOR	MENU			
18984		MENU BOARD - UNIVERSAL WALL MOUNT BRACKET	SB	GC	
19551	6	MENU BOARD - FRONT INSERT PANEL WITH SQUARE FRAME - WHITE OAK WD0073	SB	GC	
19552	1	MENU BOARD - DAILY OFFERING CHALKBOARD WITH SQUARE FRAME - WHITE OAK WD0073	SB	GC	
GRAPHICS -	OTHER				
11135	2	RESTROOM SIGN UNISEX ACCESSIBLE	SB	GC	
X0023	1	COMMUNITY BOARD MAGNETIC WHITE OAK WD0073 - 48X36IN	SB	GC	3'X4' WD0073 FRAME COMMUNITY BOARD. VENDOR: COLORCHROME

	CASEWORK FINISH SCHEDULE		
LOCATION	DESCRIPTION	FINISH CODE	COMMENTS
COMPOSITE - BRUSHED DARK GREY		•	
COUNTERTOPS - ESPRESSO	COMPOSITE - BRUSHED DARK GREY	CP0057	
COUNTERTOPS - BACKBAR	COMPOSITE - BRUSHED DARK GREY	CP0057	
COUNTERTOPS - SHROUD	COMPOSITE - BRUSHED DARK GREY	CP0057	
COUNTERTOPS - FRONTBAR	COMPOSITE - BRUSHED DARK GREY	CP0057	
COMPOSITE - WHITE WITH VEINING	1		
COUNTERTOPS - CONDIMENT CART	COMPOSITE - WHITE WITH VEINING	CP0002	
METAL - FLAT BLACK POWDERCOAT			
CABINETS - DOOR PULL	METAL - FLAT BLACK POWDERCOAT	MT0028	
CABINETS - UNDERCOUNTER ICE BIN	METAL - FLAT BLACK POWDERCOAT	MT0028	
METAL - STAINLESS STEEL - BRUSHED			
CABINETS - CABINET LEG	METAL - STAINLESS STEEL - BRUSHED	#4 BRUSHED 16G	
COUNTERTOPS - HAND SINK	METAL - STAINLESS STEEL - BRUSHED	#4 BRUSHED 16G	
CABINETS - UNDERCOUNTER ICE BIN	METAL - STAINLESS STEEL - BRUSHED	#4 BRUSHED 16G	
PLAM - MOTTLED BLACK			
CABINETS - UNDERCOUNTER	PLAM - MOTTLED BLACK	PL0019	
CABINETS - DT POS CUBBY	PLAM - MOTTLED BLACK	PL0019	
CABINETS - DT CUBBY	PLAM - MOTTLED BLACK	PL0019	
WOOD - WHITE OAK			
1" WOOD TRIM AROUND ARTWORK	WOOD - WHITE OAK	WD0073	
BACK BAR WOOD TRIM	WOOD - WHITE OAK	WD0073	
1" WOOD TRIM AT WORKROOM ENTRY	WOOD - WHITE OAK	WD0073	PAINTED SW6006
WOOD - WHITE OAK - MULTI-DEPTH PLANK - VEF	RTICAL		
1" WOOD PANELS AT UNDERSIDE OF SOFFIT PORTAL	WOOD - WHITE OAK - MULTI-DEPTH PLANK - VERTICAL	WD0073 MAD100	TO SHIP LOOSE, SEE DETAILS FOR QUANTITY
WOOD - WHITE OAK - PLANK - HORIZONTAL			
CABINETS - CONDIMENT CART	WOOD - WHITE OAK - PLANK - HORIZONTAL	WD0073 MAD100-H	
WOOD - WHITE OAK - REVEAL SLAT - VERTICAL			
FINISH PANELS - FRONT BAR	WOOD - WHITE OAK - REVEAL SLAT - VERTICAL	WD0073 MAD200-V	
CAFE WALL CLADDING	WOOD - WHITE OAK - REVEAL SLAT - VERTICAL	WD0073 MAD200-V	TO SHIP LOOSE, SEE DETAILS FOR QUANTITY

DESIGN ID	COUNT	DESCRIPTION	FURN. BY	INST RV	BULB	COMMENTS
EXIT	000111	DEGOMI HON	I OIXIV. DI	III III	BOLD	OOMMENTO
11483	2	EXIT - SECURITY LIGHT WALL MOUNTED	LL	LL	HID 150W OR EQUAL	LITHONIA LIGHTING. TWP 150S TB OR APPROVED EQUAL
19044	4	LED EXIT SIGN WITH EMERGENCY LIGHT - WHITE AND RED	SB	GC	INTEGRATED LED	
19049	1	LED EXIT SIGN RECESSED - WHITE AND RED	SB	GC	INTEGRATED LED	
19056	4	LED EMERGENCY LIGHT DOUBLE - WHITE	SB	GC	INTEGRATED LED	
OTHER						
17796	5	STRING LIGHTS	SB	GC	INTEGRATED LED	POWER BY LANDLORD. THREE RUNS OF LIGHTS, TOTAL LENGTH REQUIRED: 77'-1".GC TO PROVIDE AIRLINE CABLE AND HOOKS AS NEEDED FOR MOUNTING.
RECESSED	CAN		'	'		•
19023	30	CAN - LED MOUNTING FRAME - 2IN 50MM - NEW CEILING	SB	GC		
19113	26	CAN - LED ADJUSTABLE GIMBAL WITH DRIVER - 2IN 50MM - WHITE - 1000LM NFL	SB	GC		
19120	4	CAN - LED DOWNLIGHT REFLECTOR WITH DRIVER SQUARE - 2IN 50MM - WHITE - 1000LM FLOOD	SB	GC		
SCONCE		,	_			
20711	6	SCONCE - HINKLEY ATLANTIS LARGE - BLACK	LL	LL	INTEGRATED LED	DOLAN HOSPITALITY MFR #376769 ATLANTIS OUTDOOR SCONCE
20741	2	SCONCE - KUZCO VEGA - 23IN 585MM - GOLD	SB	GC	INTEGRATED LED	
SIGNAGE - C	THER					
21163	1	SIGN - MOBILE ORDER PICK UP ILLUMINATED BLADE MOUNT	SB	GC		GC TO PROVIDE BLOCKING AND ELECTRICAL IN SOFFIT AS REQUIRED
X0016	1	1 SIGN - MOP SIGN - 4FT EXTENSION LEGS		GC		TO BE CUT IN FIELD. ORDER WITH MOP SIGN DID 21163. VENDOR: WALTON.
STRIP						
14410	2	STRIP - LED TAPE - VARIABLE LENGTH - 315LM PER FT	SB	GC	INTEGRATED LED	LENGTH: 27'-0". FIELD TRIMMABLE TO 6IN LENGTHS
TRACK		T	T	T = -		
12934	1	TRACK - WITH CONNECTORS - 4FT 122CM - WHITE - 1 CIRCUIT	SB	GC		
12945	9	TRACK - WITH CONNECTORS - 12FT 365CM - WHITE - 1 CIRCUIT	SB	GC	NITEODATES : ES	
19071	8	TRACK - LED FIXTURE - 2IN 50MM - WHITE - 900LM SPOT	SB	GC	INTEGRATED LED	
19072	13	TRACK - LED FIXTURE - 2IN 50MM - WHITE - 600LM FLOOD	SB	GC	INTEGRATED LED	
19074	27	TRACK - LED FIXTURE - 2IN 50MM - WHITE - 900LM FLOOD	SB	GC	INTEGRATED LED	
19087	48	TRACK - HEX CELL LOUVER - 2IN 50MM	SB	GC		
TROFFER 15057	8	TROFFER - LED RECESSED - 24X48IN	SB	GC	INTEGRATED LED	

DESIGN ID	COUNT	DESCRIPTION	FURN. BY	INST. BY	COMMENTS	FINISH
CABINET 17573	1	CABINET - BACKBAR COUNTER SUPPORT	SB	GC		PL0019
		PANEL - 3IN 75MM				
17574	3	CABINET - BACKBAR SINK OR ICE - 15IN 380MM	SB	GC		PL0019
17575	1	CABINET - BACKBAR SINK OR ICE - 20IN 510MM	SB	GC		PL0019
17580	2	CABINET - CBE TEA SHELF - 29IN 735MM -	SB	GC	NOT PROVIDED BY	MT0028
17581	1	FLAT BLACK MT0028 CABINET - CBE DRY INCLUSION SHELF - 23IN 585MM - FLAT BLACK MT0028	SB	GC	CASEWORK VENDOR. NOT PROVIDED BY CASEWORK VENDOR.	MT0028
17740	2	CABINET - BACKBAR - 30IN 760MM	SB	GC	CAOLWOIN VENDOIN.	PL0019
17741	7	CABINET - BACKBAR 15IN 380MM	SB	GC		PL0019
17743	1	CABINET - DT POS - 30IN 760MM	SB	GC		PL0019
17744	1	CABINET - FRONTBAR POS BRIDGE - 22IN 560MM	SB	GC		PL0019
17745	1	CABINET - BACKBAR DRAWER - 15IN 380MM	SB	GC		PL0019
17747 18060	2	CABINET - BACKBAR TRASH - 15IN 380MM CABINET - FRONTBAR POS CUBBY - 15IN	SB SB	GC GC		PL0019 PL0019
	· 	380MM				
18122	2	CABINET - BACKBAR SINK OR ICE - 16IN 405MM	SB	GC		PL0019
19281	2	CABINET - ESPRESSO ICE BIN STAINLESS - 20IN 510MM	SB	GC		PL0019
21189	2	CABINET - FRONTBAR - 15IN 380MM	SB	GC		SST
21191	1	CABINET - FRONTBAR DRAWER - 15IN 380MM	SB	GC		PL0019
21192	2	CABINET - FRONTBAR POS - 30IN 760MM	SB SB	GC		PL0019
21193	2	CABINET - ESPRESSO CUBBY WITH OPEN BACK - 18IN 455MM	SB	GC		PL0019
X0006	1	CABINET - DT POS UPPER CUBBY W DOORS	SB	GC	SEE DETAILS	PL0019
X0017 CAFE	1	CABINET - DT UPPER CUBBY W DOORS	SB	GC	SEE DETAILS	PL0027
20131	1	CONDIMENT CART THREE DROP - WHITE OAK	SB	GC	NOT PROVIDED BY	WD0073
20383	2	AND WHITE WD0073 CP0002 FREESTANDING INLINE 2 UNIT SHORT - 72IN	SB	GC	CASEWORK VENDOR. NOT PROVIDED BY	CP0002 WD0073
		1830MM - WHITE OAK WD0073			CASEWORK VENDOR.	**D0013
COUNTERTO 17809	OP 2	COUNTERTOP - HAND SINK WITH LOW	SB	GC		SST
17009	2	SPLASH STAINLESS - 15IN 380MM	SB	GC		331
17830	1	COUNTERTOP - POS - 82IN 2085MM	SB	GC		CP0057
18871	1	COUNTERTOP - FRONTBAR - 18IN 455MM	SB	GC		CP0057
19711 20050	<u> </u>	COUNTERTOP - WARMING - RF - 75IN 1905MM COUNTERTOP - BACKBAR NITRO - LH - 30IN	SB SB	GC GC		CP0057 CP0057
20000		760MM				01 0007
20062	1	COUNTERTOP - ESPRESSO METRO - LF - 139IN 3530MM	SB	GC		CP0057
20063	1	COUNTERTOP - FRONTBAR CAP - 139IN	SB	GC		CP0057
2.1==2		3530MM				
21759	1	COUNTERTOP - CBE WITH RINSE SINK - LF - 112IN 2845MM	SB	GC		CP0057
X0003	1	COUNTERTOP - AT PASTRY CASE - 8 1/2"	SB	GC	SEE DETAILS	CP0057
X0008	1	WIDTH COUNTERTOP - DT POS - LF	SB	GC	SEE DETAILS	CP0057
X0009	1	COUNTERTOP - FUTURE EQUIPMENT	SB	GC	SEE DETAILS	CP0057
X0015	1	COUNTERTOP - AT DT	SB	GC	SEE DETAILS	CP0057
X0025	1	COUNTERTOP - FRONTBAR MOP PLANAR - LF	SB	GC	SEE DETAILS	CP0057
X0046	1	COUNTERTOP - BREW WITH TRASH DROP - RF	SB	GC	SEE DETAILS	CP0057
DIEWALL			1			1
17831 18872	<u>1</u> 1	DIEWALL - POS - 82IN 2085MM DIEWALL - HANDOFF INLINE - 18IN 455MM	SB SB	GC GC		N/A N/A
20064	<u>'</u> 1	DIEWALL - ESPRESSO - 139IN 3530MM	SB	GC		N/A
X0041	1	MOP DIEWALL - 78 3/4"	SB	GC	SEE DETAILS	N/A
X0047	1	DIEWALL - AT PASTRY CASE	SB	GC	SEE DETAILS	PL0019
FIT KIT 17894	1	FIT KIT - CABINET FILLER PANEL	SB	GC	LENGTH: 9 3/4"	PL0019
OTHER	•	THE STORY OF THE PERSON OF THE	102	100		1. 200.0
11142	2	CORBEL SUPPORT - 24IN 610MM	SB	GC		SST
11155	2	ESPRESSO MACHINE PUMP MOUNT - 10X10IN 255X255MM	SB	GC		PL0019
17829	2	FRENCH CLEAT - VARIABLE LENGTH	SB	GC	2;3'-2" AND 2'-5"	PL0019
18145	1	COUNTERTOP SUPPORT LEG	SB	GC		SST
20066	1	SHROUD - 139IN 3530MM	SB SB	GC GC		CP0057 GLASS
20067 20633	<u>1</u> 1	SNEEZE GUARD - 139IN 3530MM COUNTERTOP SUPPORT LEG SLIM	SB	GC		SST
X0001	1	WOOD CLADDING AT CONDIMENT CART AREA		GC	SEE DETAILS	WD0073
V0040	a	CODIANI SILLI AT DT MINIDOM	QD.	CC	SEE DETAIL	MAD200
X0012 X0013	<u>1</u> 1	CORIAN SILL AT DT WINDOW CORIAN WINDOW SILL AT SIDE WINDOW	SB SB	GC GC	SEE DETAIL SEE DETAIL	CP0057 CP0057
X0018	1	CLADDING AT CONDIMENT CART PORTAL	SB	GC	SEE DETAILS	WD0073 MAD
X0019	1	OPENING SIDES 1" PAINTED WOOD TRIM AT WORKROOM	SB	GC	SEE DETAIL	100 V WD0073
V00 19	I	ENTRY	OD	30	OLL DETAIL	PAINTED
X0021	1	WOOD CLADDING AT ARTWORK WALL	SB	GC	SEE DETAIL	SW6006 WD0073
						MAD200
X0022	1	1" WOOD TRIM AROUND ARTWORK WALL	SB	GC	SEE DETAILS	WD0073
PANEL 17832	1	PANEL - 82IN 2085MM	SB	GC		WD0073 MAE
						200 V
	1	PANEL - 18IN 455MM	SB	GC		WD0073 MAD200
18873		PANEL - 139IN 3530MM	SB	GC		WD0073 MAD
18873 20065	1	171122 100111 0000111111		1	i .	1200 17
20065	•		QB	GC	SEE DETAILS	200 V
	1	PANEL - END CAP - RF	SB	GC	SEE DETAILS	WD0073 MAD200

CASEWORK SCHEDULE - "C"

GC GENERAL CONTRACTOR LL LANDLORD SB STARBUCKS

Revision Schedule

63039

88084-001

PROJECT ADDRESS:
155 SW M-150 HWY STE. 1
LEES SUMMIT, MO 64082
JACKSON COUNTY

ISSUE DATE: 09-04-2020
SR. DESIGN MANAGER: K. GORIN-SLONSKI
PRODUCTION DESIGNER: A.MAUSER
CHECKED BY: NORR

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STARBUCKS® 2401 UTAH AVENUE SOUTH SEATTLE, WASHINGTON 98134 (206) 318-1575

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STARBUCKS TEMPLATE VERSION i2020-01-31

NORR

Engineering Consultant

2020

09.04.

SE

BID/PERMIT

SIGNED: 09.04.2020 EXPIRES: 12.31.2020

BUILDOUT OF COFFEE RT. 291 &150

STORE #:

PROJECT #:

William J. Alkemeyer, P.E. 353 Marshall Avenue

St. Louis, Missouri 63119 Phone (314) 772-1782 Fax (314) 373-3514

SHEET TITLE: SCHEDULES

SCALE: AS SHOWN

SHEET NUMBER:

1602

RESPONSIBILITY LEGEND

	CEILING TREATMENT SCHEDULE - "U"						
DESIGN ID	AREA	DESCRIPTION	FURN. BY	INST. BY	COMMENTS		
ACOUSTICA	L CEILING	TILE	•				
11302	319 SF	ACT VINYL- 2x4'	GC		ARMSTRONG. MODEL: CLEAN ROOM VL 2X4 (NONPERFORATED) COLOR: WHITE. EDGE PROFILE: SQUARE LAY-IN. ITEM#870		
X0010	892 SF	CEILING TILE 2X2FT - TECTUM PANELS - PAINTED	GC	GC	ARMSTRONG TECTUM PANELS 2X2FT 1" THICK VERTICAL LINE DESIGN, PROVIDE GRID. PAINT TILES AND GRID SW6101. TEGULAR EDGE 15/16 PRELUDE EXPOSED TEE GRID. 8-WEEK LEAD TIME.		

DESIGN ID	COUNT	DESCRIPTION	FURN. BY	INICT DV	COMMENTS
SIGNAGE - D		DESCRIPTION	FURN. B1	INST. DT	COMMENTS
13182	1	SIGN - DISK SF ILLUMINATED FLUSH MOUNTED EVOLVED - 71IN 1805MM	SB	GC/ HILTON	LL TO PROVIDE BLOCKING AND CONDUIT AS REQUIRED
13184	1	SIGN - DISK SF ILLUMINATED FLUSH MOUNTED EVOLVED - 60IN 1525MM	SB	GC/ HILTON	LL TO PROVIDE BLOCKING AND CONDUIT AS REQUIRED
SIGNAGE - E	DRIVE THR	Ú		•	
14091	1	SIGN - DT DIRECTIONAL EXIT SIGN ILLUMINATED ARROW SERIES - 46IN 1170MM	SB	GC	GC TO COORDINATE WITH SBUX VENDOR. LL TO PROVIDE, FOOTING, ANCHOR BOLT AND CONDUIT
14106	1	SIGN - DT CLEARANCE BAR ARROW SERIES FREESTANDING	SB	GC	GC TO COORDINATE WITH SBUX VENDOR. LL TO PROVIDE, FOOTING AND ANCHOR BOLT
SIGNAGE - C	OTHER		-1	•	
19388	3	SIGN - 10 MINUTE PARKING	SB/LL	GC	FOOTING AND POST BY LL, SIGN BY VENDOR (TUBE ART). GC TO INSTALL.
SIGNAGE - F	PYLON DIS	K		•	
X0044	1	MONUMENT SIGN	SB	GC/ LL	LL TO PROVIDE BASE SIGN, FOOTING, ANCHOR BOLTS AND CONDUITS. SIGN PANELS BY SBUX VENDOR
SIGNAGE - V	VORDMAR	K			
X18498	1	SIGN - WORDMARK STARBUCKS FLUSH MOUNTED - 20IN 510MM	SB	GC/ HILTON	WORDMARK COLOR GREEN: LL TO PROVIDE CONDUIT AND BLOCKING AS REQUIRED

		STOREFRONT	SCHEDULE		
DESIGN ID	COUNT	DESCRIPTION	FURN. BY	INST. BY	COMMENTS
WINDOW					
14077	1	WINDOW - DT NO TRANSOM - 48X60IN 1205X1510MM - STANDARD GLASS	LL		READY ACCESS WINDOW 275 PASS THRU. CONTACT: ANNA ELLIS, ANNA@READY-ACCESS.COM. FINISH TO MATCH LL STOREFRONT.

RESPONSIBILITY LEGEND

GC GENERAL CONTRACTOR LL LANDLORD SB STARBUCKS

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STARBUCKS TEMPLATE VERSION i2020-01-31





Fax (314) 373-3514

Engineering Consultant



2020

09.04.

SE

BID/PERMIT

155

PROJECT ADDRESS:
155 SW M-150 HWY STE. 1
LEES SUMMIT, MO 64082
JACKSON COUNTY BUILDOUT OF COFFEE RT. 291 &150

STORE #: 63039 PROJECT #: 88084-001

ISSUE DATE: 09-04-2020
SR. DESIGN MANAGER: K. GORIN-SLONSKI
PRODUCTION DESIGNER: A.MAUSER
CHECKED BY: NORR

Revision	Schedul	(


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SHEET TITLE: SCHEDULES


SCALE: AS SHOWN

SHEET NUMBER:


1603

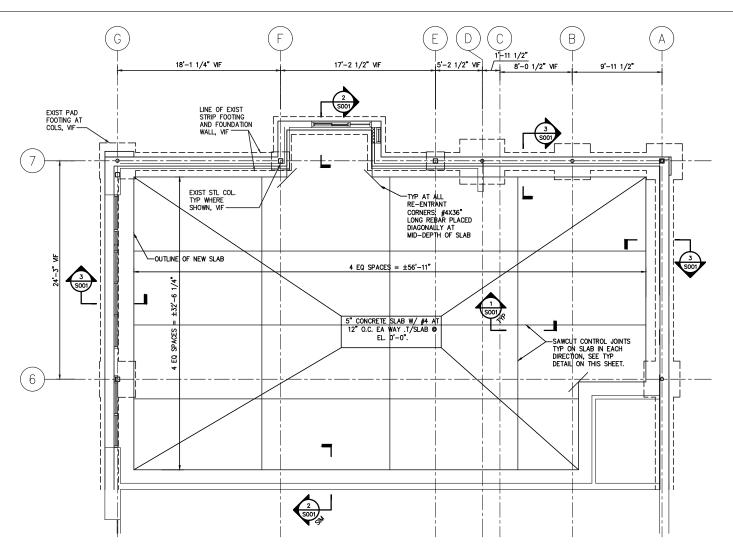


PARTIAL EXISTING FOUNDATION PLAN

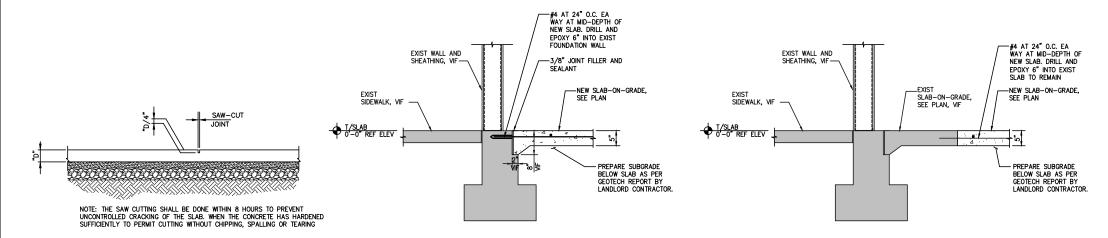

TYP. CONTROL JOINT 3/4" = 1'-0"

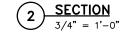

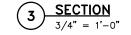

GENERAL STRUCTURAL NOTES

- GOVERNING CODE: 2015 INTERNATIONAL BUILDING CODE.
- LOADS:
 - A. FLOOR LIVE LOAD 100 PSF
- FIELD VERIFY ALL DIMENSIONS PRIOR TO FINAL DETAILING AND FABRICATION. IF ANY EXIST. CONDITION IS NOT AS SHOWN, CONTACT A/E BEFORE PROCEEDING WITH WORK.
- EXISTING STRUCTURE IS ASSUMED TO BE IN GOOD CONDITION. NOTIFY STRUCTURAL ENGINEER IF ANY STRUCTURAL MEMBERS ARE FOUND TO BE DAMAGED IN ANY WAY BEFORE PROCEEDING WITH ANY WORK ON
- CONTRACTOR SHALL SUPPORT, BRACE AND SECURE EXISTING STRUCTURE AS REQUIRED TO INSTALL NEW WORK. CONTRACTOR IS SOLELY RESPONSIBLE FOR THE SAFETY OF THE EXISTING BUILDING DURING CONSTRUCTION
- SPECIAL INSPECTIONS SERVICES SHALL BE PROVIDED BY A QUALIFIED AGENCY ON ALL ITEMS REQUIRED BY THE LOCAL BUILDING CODE.
- EXISTING STRUCTURAL INFORMATION HAS BEEN TAKEN FROM STRUCTURAL DRAWINGS AND HAS NOT BEEN VERIFIED IN FIELD. VERIFY ALL EXISTING CONDITIONS THAT AFFECT NEW CONSTRUCTION IN FIELD PRIOR TO BID.

CONSTRUCTION AND SAFETY

- ERECTOR SHALL PROVIDE TEMPORARY BRACING FOR THE ENTIRE STRUCTURE UNTIL PERMANENT BRACING IS INSTALLED AND FUNCTIONING AS THE DESIGNED UNIT.
- THE ENGINEER OF RECORD SHALL NOT BE RESPONSIBLE FOR THE MEANS, METHODS, TECHNIQUES, SEQUENCES, OR PROCEDURES OF CONSTRUCTION SELECTED BY THE CONTRACTOR.
- THE ERECTOR SHALL BE SOLELY AND COMPLETELY RESPONSIBLE FOR THE CONDITIONS OF THE JOB SITE INCLUDING SAFETY OF ALL PERSONS AND PROPERTY.

FOUNDATIONS

- THE FOUNDATION DESIGN OF THIS BUILDING ADDITION WAS BASED ON THE FOLLOWING CRITERIA:
- A. MINIMUM ALLOWABLE SOIL BEARING CAPACITY = 2000 PSF(ASSUMED)
- EXISTING SLAB—ON—GRADE SHALL BE SAWCUT AND REMOVED WITHOUT DISTURBING UNDERLYING BASE COURSE. NEW SLAB SHALL ONLY BE POURED AFTER VERIFYING A MINIMUM 4" THICK COMPACTED GRANULAR BASE ANDS VAPOR BARRIER AS NOTED ON PLANS AND

CONCRETE CONSTRUCTION

- CAST-IN-PLACE CONCRETE WORK SHALL CONFORM TO THE LATEST EDITIONS OF:
 - A. AMERICAN CONCRETE INSTITUTE CODES AND STANDARDS, INCLUDING BUT NOT LIMITED TO, ACI 301 (AS MODIFIED IN THE PROJECT MANUAL), ACI 305.1, ACI 315, ACI 318 AND
- B. CONCRETE REINFORCING STEEL INSTITUTE (CRSI) "MANUAL OF STANDARD PRACTICE".
- CONCRETE SHALL HAVE THE FOLLOWING MINIMUM COMPRESSIVE STRENGTH OF 4000 PSI AT 28 DAYS: (SUBMIT CONCRETE MIXES FOR APPROVAL IN ACCORDANCE WITH ACI301 BEFORE PLACING
- ALL REINFORCING STEEL SHALL BE NEW DOMESTIC DEFORMED BILLET STEEL CONFORMING TO ASTM A-615, A-616, A-617
- WELDED WIRE FABRIC SHALL CONFORM TO ASTM A-185 DELIVERED IN FLAT SHEETS.
- CONTRACTOR SHALL REVIEW ALL DRAWINGS FOR SIZE AND LOCATION OF EMBEDDED ITEMS, SLEEVES, SLAB DEPRESSIONS, OPENINGS, ETC. REQUIRED BY OTHER TRADES. RECONCILE THEIR EXACT SIZES AND LOCATIONS BEFORE PROCEEDING WITH THE WORK. ALL ITEMS SHALL BE FURNISHED AND INSTALLED PRIOR TO PLACEMENT OF CONCRETE. SECURE THE APPROVAL OF THE STRUCTURAL ENGINEER PRIOR TO PLACING OPENINGS NOT SHOWN ON THE STRUCTURAL DRAWINGS.
- COMPLY WITH ARCHITECTURAL DRAWINGS FOR LOCATION AND EXTENT OF SPECIAL FINISHES OR TREATMENTS TO EXPOSED CONCRETE.
- PROVIDE #4x3'-0" AT MID DEPTH PERPENDICULAR TO ANY DISCONTINUOUS CONTROL JOINTS.



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Rubix Consultants, LLC 2216 W. Leland Ave, #1 Chicago, IL 60625 (312) 602 5411



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88084-001 ISSUE DATE: 08-26 SR. DESIGN MANAGER: PRODUCTION DESIGNER: MB 08-26-2020

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FOUNDATION PLAN & DETAILS

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WP

WATER HEATER

WEATHER PROOF

ABBREVIATIONS ABOVE FINISHED FLOOR **AUTHORITIES HAVING JURISDICTION** APPROX **APPROXIMATE** BLDG BUILDING CKT CIRCUIT CLG CEILING STARBUCKS CONSTRUCTION MANAGER CONST CONSTRUCTION CW COLD WATER CXA COMMISSIONING AGENT DEG DEGREES LIGHTS WITHIN DAYLIGHT ZONE DM STARBUCKS DESIGN MANAGER DN DOWN DTL DETAIL DWG(S) DRAWING(S) EΑ EC **ELECTRICAL CONTRACTOR** ECP **EQUIPMENT CONTROL PAC EXHAUST GRILLE ELECTRICAL** FΜ **EMERGENCY EMS ENERGY MANAGEMENT SYSTEM EXIST EXISTING** EXT **EXTERIOR** F&I FURNISH & INSTALL FOIC FURNISHED BY OWNER, INSTALLED BY CONTRACTOR FURNISHED BY OWNER, **INSTALLED BY OWNER** FLR FLOOR FT FOOT/FEET GC **GENERAL CONTRACTOR GFCI GROUND FAULT CIRCUIT INTERRUPTER** GND GROUND HR HOUR HEATING, VENTILATION, AIR CONDITIONING HVAC **HOT WATER** LCP LIGHTING CONTROL PANEL LANDLORD LS LIGHT SENSOR PHOTOCELL LV LOW VOLTAGE MAX MAXIMUM MC MECHANICAL CONTRACTOR MDP MAIN DISTRIBUTION PANEL **MECH** MECHANICAL MECHANICAL, ELECTRICAL, AND PLUMBING MFG MANUFACTURER MIN MINIMUM **NIGHTLIGHT** NTS NOT TO SCALE OCP OVERCURRENT PROTECTION REF REFERENCE REQ('D) REQUIRE(D) REVISION SQUARE FEET SHEET SPECS SPECIFICATION(S) STAINLESS STEEL TELEPHONE **TEMP TEMPORARY** TYP TYPICAL UNDER COUNTER UNLESS NOTED OTHERWISE UNO

ELECTRICAL OVARDOL LECEND

ELE	CTRICAL SYME	BOL L	EGEND
J	JUNCTON BOX	ϕ	RECEPTACLE: DUPLEX
\$	SWITCH	ϕ	RECEPTACLE: DUPLEX - ISOLATED GROUND WITH INTEGRAL SURGE PROTECTION
\$3	THREE-WAY SWITCH	\Rightarrow	RECEPTACLE: QUAD
\$.	MOTION (OCCUPANCY) SENSOR SWITCH		RECEPTACLE: QUAD - ISOLATED GROUND WITH INTEGRAL SURGE PROTECTION
S	SWITCHBACK	ф	RECEPTACLE: HIGH VOLTAGE
\blacksquare	TELEPHONE		RECEPTACLE: FLOOR DUPLEX
\bigcirc	THERMOSTAT	(RECEPTACLE: CEILING DUPLEX
<u>S</u>	SPEAKER	₹	GROUNDING ELECTRODE CONNECTION
ф	DIMMER SWITCH	NL	NIGHTLIGHTING 24HR/DAY
\bigcirc	RECEPTACLE: DATA	PE	PHOTOELECTRIC CELL
-/ ///	RACEWAY CONCEALED IN CEILING OR WALL. HASH MARKS INDICATE NUMBER OF WIRES.		WIFI ACCESS POINT
	#12 AWG WIRE UNLESS	(co)	CARBON MONOXIDE

FIRE ALARM SYSTEM NOTES

OTHERWISE NOTED.

GROUND IF NO HASH

MARKS SHOWN. LONG

HASH MARK DENOTES

GROUND WIRE NOT

TWO WIRES PLUS

NEUTRAL

SHOWN.

IF STARBUCKS IS REQUIRED TO PROVIDE A FIRE ALARM AND/OR FIRE ALARM MONITORING AND/OR PHONE LINES FOR A FIRE ALARM. AS SPECIFIED IN THE LEASE AGREEMENT, THE CONTRACTOR IS TO NOTIFY GNOC IMMEDIATELY THAT FIRE ALARM LINES ARE NEEDED. STARBUCKS PREFERRED FIRE ALARM SERVICE PROVIDER, STANLEY, IS TO BE CONTACTED BY THE CONSTRUCTION MANAGER TO INSTALL FIRE ALARM PANEL AND/OR MONITORING SERVICE AS REQUIRED.

DETECTOR

CARBON MONOXIDE (CO) DETECTOR NOTES

COORDINATE INSTALLATION OF CARBON MONOXIDE (CO) DETECTOR DEVICE(S) AND LOW VOLTAGE WIRING WITH STARBUCKS SECURITY VENDOR FOR NEW STORES. RELOCATIONS AND MAJOR RENOVATIONS. VENDOR TO FURNISH AND INSTALL DEVICE(S) IN BOH AND FOH (AS APPLICABLE PER STARBUCKS STANDARDS). GC TO PROVIDE ROUGH-IN FOR SENSORS.

CONTROLS AND OPERATION

THE GENERAL CONTRACTOR SHALL COORDINATE INSTALLATION OF INTERMATIC TIMECLOCK, INSTALLATION OF LIGHTING CONTACTOR AND COMMISSIONING WITH ELECTRICAL CONTRACTOR PRIOR TO THE LAST WEEK OF CONSTRUCTION.

FURNISH AND INSTALL RACEWAYS WITH PULL STRINGS AND JUNCTION BOXES FOR THERMOSTAT(S) AND SENSOR(S).

SET RESTROOM OCCUPANCY SENSOR TO 5 MINUTE 'ON' DURATION IN SINGLE OCCUPANT RESTROOM AND TO 5 MINUTE 'ON' DURATION IN MULTI-OCCUPANT RESTROOM UNLESS JURISDICTION REQUIREMENTS STATE OTHERWISE.

COORDINATE WITH DRAWINGS AND MANUFACTUERE FOR DEVICE LOCATIONS.

THE GENERAL CONTRACTOR IS TO COMPLETE FINAL CONNECTION AFTER DATA RACK AND NETWORK INSTALLATION.

SYSTEM COMMISSIONING

CONTRACTOR RESPONSIBILITIES FOR BUILDING COMMISSIONING

CONTRACTOR SHALL PROVIDE SUPPORT AND WORK AS SPECIFIED. NEEDED AND REQUIRED TO CONDUCT AND FACILITATE STARBUCKS STAFF BUILDING COMMISSIONING EFFORTS. THIS WORK WILL BE COMPRISED OF THREE DISTINCT EFFORTS:

- 1) SUPPORT STARBUCKS COMMISSIONING AGENT (CXA) DURING INSTALLATION VERIFICATION AND CORRECT DISCLOSED DEFICIENCIES;
- 2) PERFORM TESTING, ADJUSTING, BALANCING AND SYSTEM STARTUP AND SUPPORT FUNCTIONAL PERFORMANCE TESTING BY STARBUCKS CXA:
- 3) CORRECT DEFICIENCIES DISCLOSED BY FUNCTIONAL PERFORMANCE TESTING AND SUBMIT REPORTS. CONTRACTOR SHALL PERFORM AND PROVIDE THE FOLLOWING:
- A. SYSTEMS SUBJECT TO COMMISSIONING MAY INCLUDE, BUT ARE NOT LIMITED TO DOMESTIC HOT WATER GENERATION, HVAC SYSTEMS, ROOFTOP UNITS, EXHAUST FANS, HVAC CONTROLS, LIGHTING CONTROLS, AIR CURTAINS, BUILT-IN REFRIGERATION EQUIPMENT, AND RENEWABLE ENERGY SYSTEMS.
- B. CONTRACTOR SHALL INCLUDE COMMISSIONING ACTIVITIES IN PROJECT SCHEDULE AND SHOW INTERVALS FOR PERFORMANCE OF WORK FOR WHICH CONTRACTOR IS RESPONSIBLE AND INTERVALS FOR WORK PERFORMED BY STARBUCKS CXA. CONTRACTOR SHALL SHOW RESOURCES FOR PERFORMING ALL WORK RELATED TO COMMISSIONING ACTIVITIES ON A LINE ITEM IN THE SCHEDULE OF VALUES.
- C. CONTRACTOR SHALL INSTALL EQUIPMENT IN ACCORDANCE WITH THE MANUFACTURER'S REQUIREMENTS AND ALL CONTRACT DOCUMENTS. ENSURE THAT ALL EQUIPMENT IS INSTALLED TOTALLY COMPLETE, AND ACCESSIBLE TO STARBUCKS CXA FOR INSTALLATION VERIFICATION AND FUNCTIONAL PERFORMANCE TESTING PRIOR TO THE SCHEDULED START OF INSTALLATION VERIFICATION.
- D. INSTALLATION VERIFICATION SHALL BE PERFORMED BY STARBUCKS CXA. CONTRACTOR SHALL SUPPORT STARBUCKS CXA INSTALLATION VERIFICATION EFFORTS AS NECESSARY. PROVIDE ALL ACCESS AND EQUIPMENT NECESSARY FOR STARBUCKS STAFF TO VERIFY THAT THE EQUIPMENT IS INSTALLED CORRECTLY.
- CONTRACTOR SHALL BE READILY AVAILABLE DURING INSTALLATION VERIFICATION TO CORRECT ANY DEFICIENCIES OR DEFECTS DISCLOSED BY THE INSTALLATION VERIFICATION PROCESS. CORRECTIONS SHALL BE MADE IN A TIMELY MANNER WITHOUT DISRUPTION OF THE CONSTRUCTION SCHEDULE.
- F. ALL HVAC, EXHAUST FAN, AND AIR CURTAIN EQUIPMENT SHALL BE TESTED, ADJUSTED AND BALANCED BY THE CONTRACTOR'S TESTING, ADJUSTING AND BALANCE AGENT(SEE TESTING, ADJUSTING AND BALANCING) AFTER THE SYSTEM IS VERIFIED TO BE COMPLETE AND CORRECT BY STARBUCKS CXA, IN ACCORDANCE WITH THE REQUIREMENTS OF THESE DOCUMENTS. ALL HVAC CONTROL SYSTEMS SHALL BE TESTED TO ENSURE THAT CONTROL DEVICES, COMPONENTS, EQUIPMENT AND SYSTEMS ARE CALIBRATED, ADJUSTED AND OPERATE IN ACCORDANCE WITH THESE PLANS AND PROJECT MANUAL. SEQUENCES OF OPERATION SHALL BE TESTED TO ENSURE THAT THEY OPERATE IN ACCORDANCE WITH THE CONTRACT REQUIREMENTS. DELIVERABLES: PRELIMINARY, WRITTEN TESTING AND AIR BALANCE REPORT CONFORMING TO THE REQUIREMENTS SPECIFIED HEREIN, DOCUMENTING THE INFORMATION SPECIFIED, ETC. TO THE STARBUCKS CXA IMMEDIATELY UPON COMPLETION OF THE WORK.
- G. CONTRACTOR SHALL INFORM STARBUCKS CXA WHEN EQUIPMENT IS READY FOR FUNCTIONAL PERFORMANC TESTING. ALL EQUIPMENT SHALL BE READY FOR FUNCTIONAL PERFORMANCE TESTING PRIOR TO STARTING TESTING. CONTRACTOR SHALL OPERATE EQUIPMENT FOR STARBUCKS CXA AND VERIFY BY DEMONSTRATION THE CORRECT OPERATION OF EQUIPMENT, RESPONSE OF SENSORS, AND PROPER EXECUTION OF HVAC CONTROL AND LIGHTING SEQUENCES; INCLUDING BUT NOT LIMITED TO, AIR MOVEMENT, TEMPERATURE, SOUND, AND CONTROL RESPONSE. PROVIDE ANY SECURITY ACCESS, HARDWARE, SOFTWARE, OR OTHER SUPPORT AS NEEDED FOR THE STARBUCKS CXA TO EFFICIENTLY WITNESS AND DOCUMENT ALL EQUIPMENT TESTING. STARBUCKS CXA WILL RECORD THE EQUIPMENT OPERATION AND RESPONSE TO TESTING SEQUENCES AND PREPARE A LIST OF ANY DEFICIENCIES DISCLOSED BY THE FUNCTIONAL PERFORMANCE TESTS FOR CORRECTION BY THE CONTRACTOR. EQUIPMENT INCLUDES, BUT IS NOT LIMITED TO, AIR HANDLING UNITS, ROOFTOP AND SPLIT TYPE, CONDENSING UNITS, EXHAUST FANS, LIGHTING CONTROLS, ETC. DELIVERABLES: PROVIDE COMPLETED COPIES OF ALL START UP REPORTS, FILLED OUT ON THE MANUFACTURER'S FORMS, TO THE STARBUCKS CXA.
- H. CONTRACTOR IS RESPONSIBLE FOR CORRECTING ANY ISSUES OR DEFICIENCIES DISCLOSED DURING THE FUNCTIONAL PERFORMANCE TESTING PROCESS. CORRECTIONS SHOULD BE MADE IN A TIMELY MANNER WITHOUT DISRUPTION TO THE SYSTEM AND CONSTRUCTION SCHEDULE.
- CONTRACTOR SHALL BE READILY AVAILABLE FOR ANY RE-TESTING OF EQUIPMENT DEEMED NECESSARY BY STARBUCKS CXA DURING INSTALLATION VERIFICATION AND FUNCTIONAL PERFORMANCE TESTING. CONTRACTOR IS RESPONSIBLE FOR CORRECTING ANY ISSUES OR DEFICIENCIES FOUND IN THE SYSTEM DURING ANY AND ALL RE-TESTING. CORRECTIONS SHOULD BE MADE IN A TIMELY MANNER WITHOUT DISRUPTION TO THE SYSTEM AND CONSTRUCTION SCHEDULE, DELIVERABLES: FINAL BALANCE REPORT, DEFICIENCIES LIST NOTING CORRECTIVE ACTIONS PERFORMED BY CONTRACTOR IN RESPONSE TO INSTALLATION VERIFICATION AND FUNCTIONAL PERFORMANCE TEST RESULTS.
- J. CONSTRUCTION AND POST CONSTRUCTION TESTING: ADDITIONAL TESTING MAY BE REQUIRED AND OTHER PROCESSES THAT MAY OCCUR OUT OF SEQUENCE WITH COMMISSIONING SERVICE. CONTRACTOR SHALL CONDUCT. DOCUMENT, SUPPORT AND SCHEDULE THIS TESTING AS DIRECTED BY STARBUCKS CXA.

SECURITY SYSTEM NOTES

STARBUCKS CONTRACTS DIRECTLY WITH SECURITY VENDOR TO SUPPLY AND INSTALL THE SECURITY SYSTEM. CONTRACTOR TO SCHEDULE INSTALLATION OF SECURITY SYSTEM FOR FOUR (4) TIMES:

- MEET TO PLAN SECURITY CABLE PULL WITH SECURITY CABLE INSTALLER PRIOR TO DRYWALL INSTALLATION.
- 2. SECURITY CABLE INSTALLER PULLS SECURITY CABLES, MOUNTS PANEL. KEYPAD AND SENSORS.
- 3. SECURITY EQUIPMENT INSTALL OF CAMERA, NVR AND MONITOR.
- 4. SECURITY MONITORING COMPANY TO BRING SYSTEM ONLINE AND

SECURITY VENDOR REQUIRES A MINIMUM TWO (2) WEEKS LEAD TIME FOR EACH INSTALLATION. SECURITY VENDOR WILL COORDINATE REGIONAL INSTALLERS. ALL ADDITIONAL EXPENSES INCURRED DUE TO THE CONTRACTOR'S FAILURE TO SCHEDULE ACCORDINGLY WILL BE THE RESPONSIBILITY OF THE CONTRACTOR

TELEPHONE SYSTEM NOTES

TRAIN PARTNERS AFTER POS INSTALL.

IF ADDITIONAL TELEPHONE LINES ARE REQUIRED BEYOND THE STANDARD SINGLE LINE (SUCH AS FOR A FIRE ALARM) THE GENERAL CONTRACTOR SHALL CONTACT THE STARBUCKS CONSTRUCTION MANAGER PRIOR TO BEGINNING CONSTRUCTION TO ORDER THE ADDITIONAL TELEPHONE LINE(S). REPORT ANY TELEPHONE INSTALLATION ISSUES IMMEDIATELY TO THE STARBUCKS CONSTRUCTION MANAGER.

CONFIRM PRIOR TO BEGINNING CONSTRUCTION THAT THERE ARE EXISTING, WORKING TELCO FACILITIES TO THE BUILDING OR THAT LANDLORD HAS FURNISHED AND INSTALLED ONE (1) 2" (51MM) MIN. (ENTRANCE) CONDUIT INCLUDING PULL STRING FROM TELCO STREET FEED LINE TO THE BUILDING AS IDENTIFIED BY THE PHONE COMPANY. NOTIFY STARBUCKS CONSTRUCTION MANAGER IMMEDIATELY IF FACILITIES OR CONDUIT AND PULL STRING ARE NOT INSTALLED.

GENERAL CONTRACTOR IS TO ENSURE THAT THERE IS A 2" (51MM) MIN. CONDUIT WITH PULL STRING FROM THE DATA RACK TO THE DEMARC (TELCO TO CUSTOMER HAND OFF EQUIPMENT) WHEN THE DEMARC IS MORE THAN 10' FROM THE DATA RACK. DISTANCES LESS THAN 10' WILL NOT REQUIRE CONDUIT.

PROVIDE A 3-POSITION GROUND LUG, GROUNDED WITH #6 AWG GROUND WIRE, IF REQUIRED BY TELEPHONE COMPANY.

ALL TELEPHONE/NETWORK CABLING IS THE SCOPE OF WORK OF THE TELEPHONE/NETWORK CABLING VENDOR.

POS \ DATA LINE NOTES

STARBUCKS CONTRACTS DIRECTLY WITH THE DATA CABLING VENDOR TO SUPPLY AND INSTALL CATEGORY 5e (CAT5e) LAN CABLE AND CONNECTORS FOR THE POINT OF SALE (POS) SYSTEMS. CONTRACTOR TO SCHEDULE INSTALLATION OF DATA CABLING WITH DATA CABLING VENDOR. DATA CABLING VENDOR REQUIRES A LEAD TIME FOR INSTALLATION. DATA CABLING VENDOR WILL COORDINATE REGIONAL INSTALLERS.

AT THE START OF CONSTRUCTION, STARBUCKS CONSTRUCTION MANAGER SCHEDULES DELIVERY OF CASH REGISTER/MANAGER'S WORKSTATION EQUIPMENT AND INSTALLATION BY A POS INSTALL TECHNICIAN FOR ONE (1) MONTH PRIOR TO STORE OPEN. CONTRACTOR TO VERIFY DELIVERY SCHEDULE TWO (2) WEEKS PRIOR TO DELIVERY AND INSTALLATION DATE. EQUIPMENT IS SHIPPED DIRECTLY TO THE STORE. CONTRACTOR TO ACCEPT POS EQUIPMENT DELIVERY. DO NOT REFUSE DELIVERY.

DATA CABLING TECHNICIAN TO PROVIDE ALL CAT5e LAN CABLING AND CONNECTORS FROM ALL DESIGNED AND FUTURE CASH REGISTER LOCATIONS, MANAGER'S WORKSTATION, ALL OTHER NETWORKED EQUIPMENT (CUP LABELERS, CLOVER, BUMP BAR, ETC...) AND WIRELESS ACCESS POINT TO THE DATA RACK AREA. CONTRACTOR IS TO HAVE CONDUIT WITH PULL STRING IN PLACE FOR ALL CABLE RUNS PRIOR TO CABLE INSTALL DATE.

STARBUCKS NEW STORE GROUP IS RESPONSIBLE FOR COORDINATING STARBUCKS POS SYSTEMS DELIVERY AND INSTALLATION WITH THE POS VENDOR. THIS GROUP MAY BE CONTACTED AT: NEWSTORES@STARBUCKS.COM.

COMMUNICATION SYSTEM NOTES

CONFIRM PRIOR TO BEGINNING CONSTRUCTION THAT THE LANDLORD HAS FURNISHED AND INSTALLED ONE (1) ADDITIONAL 2" (51MM) (ENTRANCE) CONDUIT INCLUDING PULL STRING (FOR A TOTAL OF TWO (2)) FROM THE STREET FEED TO THE BUILDING AS IDENTIFIED BY THE INTERNET SERVICE PROVIDER.

WIRELESS NETWORK NOTES

CABLING FOR INTERNET SERVICE SHALL BE FURNISHED AND INSTALLED BY THE VENDOR FOR FIBER OR BROADBAND CONNECTIONS. T1 AND ETHERNET EXTENSION CABLING IS PROVIDED BY THE STARBUCKS (TELEPHONE/ NETWORK) CABLING VENDOR. COORDINATE WITH STARBUCKS.

MUSIC SYSTEM NOTES

MOUNT OWNER FURNISHED SPEAKERS WHERE SHOWN ON INTERIOR REFLECTED CEILING PLANS AND IN COORDINATION WITH ALL PLANS, DETAILS AND MANUFACTURER'S INSTALLATION REQUIREMENTS. INSTALL AND CONNECT OWNER FURNISHED WIRING SYSTEM BETWEEN ALL SPEAKERS AND THE OWNER PROVIDED MUSIC SYSTEM. SET WATTAGE TAP ON EACH SPEAKER'S ROTARY SWITCH PER TAP SETTINGS NOTED ON PLANS.

GENERAL ELECTRICAL NOTES

- 1. THE ELECTRICAL CONTRACTOR SHALL COORDINATE ELECTRICAL WORK WITH OTHER TRADES. THE ARCHITECTURAL DRAWINGS SHALL TAKE PRECEDENCE OVER ALL OTHER DRAWINGS. DO NOT SCALE DISTANCES OFF THE ELECTRICAL DRAWINGS; USE ACTUAL BUILDING DIMENSIONS. OVERALL CASEWORK COMPONENT DIMENSIONING ON ELECTRICAL DETAILS ARE SHOWN FOR REFERENCE AND COORDINATION ONLY. SEE PROJECT MANUAL
- 2. ALL ELECTRICAL SYSTEMS SHALL BE TESTED FOR PROPER OPERATION. BALANCE ALL BRANCH CIRCUIT LOADS BETWEEN THE PHASES OF THE SYSTEM WITHIN 10% OF THE HIGHEST PHASE LOAD IN EACH PANEL BOARD.
- 3. THE ELECTRICAL CONTRACTOR SHALL BE RESPONSIBLE FOR DE-ENERGIZING CIRCUITS IN DEMOLITION AREAS TO INSURE A SAFE CONDITION. ELECTRICAL DEVICES AND ASSOCIATED WIRING LOCATED WITHIN THE DEMOLITION AREA THAT WILL NO LONGER BE USED SHALL BE REMOVED AND PROPERLY DISPOSED OF AT CONTRACTORS EXPENSE UNLESS OTHERWISE NOTED.
- 4. THE ELECTRICAL CONTRACTOR SHALL SCHEDULE ALL ELECTRICAL SYSTEM OUTAGES WITH THE GENERAL CONTRACTOR AND LANDLORD AT LEAST 24 HOURS IN ADVANCE. UNLESS APPROVED OTHERWISE ALL OUTAGES SHALL OCCUR BETWEEN 11:00PM AND
- 5. ELECTRICAL CONTRACTOR SHALL FURNISH AND INSTALL ALL NECESSARY CONDUIT AND J-BOXES TO SUPPORT A COMPLETE SECURITY, PHONE, POS AND DATA SYSTEMS. SEE MANAGER WORKSTATION AND BAR POINT OF SALE (POS) POWER/TELECOM/SECURITY DIAGRAM. COORDINATE ALL DEVICE LOCATIONS AND MOUNTING HEIGHTS WITH SECURITY VENDOR PRIOR TO ROUGH-IN. PROVIDE END-TO-END PULL STRINGS IN ALL CONDUITS. LABEL EACH END OF THE PULL STRING WITH CONDUIT SYSTEM ("SECURITY") AND DESTINATION ("CAFÉ", "FRONT BAR", ETC.). PROVIDE INSULATED BUSHINGS ON ALL STUBBED-UP AND EXPOSED CONDUIT ENDS.
- 6. ELECTRICAL CONTRACTOR SHALL COORDINATE WITH THE GENERAL CONTRACTOR TO PATCH AND REPAIR ALL EXISTING WALLS, FLOORS, CEILINGS OR OTHER SURFACES IDENTIFIED TO REMAIN THAT MAY BECOME DAMAGED DURING THE COURSE OF
- 7. EXPOSED/SURFACE MOUNTED CONDUITS SHALL ONLY BE ALLOWED WHERE NECESSARY IN EXPOSED CEILING AREAS. IF CONDUITS NEED TO BE SURFACE MOUNTED TO WALLS, COORDINATE WITH STARBUCKS CONSTRUCTION MANAGER FOR APPROVAL.
- 8. VERIFY LOCATION OF ALL OUTLETS AND SWITCHES WITH ARCHITECTURAL DRAWINGS, INTERIOR DETAILS, FINISH SCHEDULES, GENERAL CONTRACTOR, EQUIPMENT VENDORS, STARBUCKS AND EXISTING SITE CONDITIONS. VERIFY FINAL DOOR HINGE LOCATION PRIOR TO SWITCH INSTALLATION AND ADJUST SWITCH LOCATION IF NEEDED. DO NOT MOUNT RECEPTACLES/SWITCHES IN LOCATIONS THAT WOULD CONFLICT WITH MIRRORS, SEAMS OF WALLS, WAINSCOTS, TILE TRANSITIONS, ETC...

GENERAL NOTES

THE INTENT OF THE DRAWINGS AND PROJECT MANUAL IS TO PROVIDE A COMPLETE AND FULLY OPERATIONAL ELECTRICAL SYSTEM. THE ELECTRICAL CONTRACTOR SHALL FURNISH AND INSTALL ALL LABOR, MATERIAL, AND EQUIPMENT NECESSARY TO COMPLETE THE ELECTRICAL WORK.

THE ELECTRICAL CONTRACTOR SHALL THOROUGHLY EXAMINE ALL AREAS WHERE EQUIPMENT, CONDUIT, AND WIRING WILL BE INSTALLED AND WILL REPORT ANY CONDITION THAT, IN HIS OPINION, PREVENTS THE PROPER INSTALLATION OF THE ELECTRICAL WORK.

EQUIPMENT AND MATERIALS SHALL CONFORM WITH APPROPRIATE PROVISIONS OF CSA, ULC, NEC, ASTM, UL, ETL, NEMA, ANSI, AS APPLICABLE TO EACH INDIVIDUAL UNIT OR ASSEMBLY.

ALL WORK SHALL BE PERFORMED IN STRICT ACCORDANCE WITH ALL APPLICABLE PROVINCIAL AND LOCAL CODES AND ORDINANCES. IN CASE OF CONFLICT BETWEEN THE DRAWINGS AND SPECIFICATIONS AND THE CODES, THE HIGHEST STANDARD SHALL APPLY. ELECTRICAL CONTRACTOR SHALL SATISFY CODE REQUIREMENTS AS A MINIMUM STANDARD WITHOUT ANY EXTRA COST TO STARBUCKS.

THE ELECTRICAL CONTRACTOR SHALL PROCURE AND PAY FOR ALL PERMITS, FEES, AND INSPECTIONS NECESSARY TO COMPLETE THE ELECTRICAL WORK.

THE ELECTRICAL CONTRACTOR SHALL UNCONDITIONALLY WARRANT ALL WORK TO BE FREE OF DEFECTS IN MATERIAL AND WORKMANSHIP FOR A PERIOD OF ONE (1) YEAR FROM THE DATE OF FINAL ACCEPTANCE BY STARBUCKS AND WILL REPAIR OR REPLACE ANY DEFECTIVE WORK PROMPTLY AND WITHOUT CHARGE AND RESTORE ANY OTHER EXISTING WORK DAMAGED IN THE COURSE OF REPAIRING DEFECTIVE MATERIALS AND WORKMANSHIP.

LANDLORD REQUIREMENTS

PRIOR TO BID: THE CONTRACTOR SHALL COORDINATE WITH LANDLORD / BUILDING OWNER FOR ANY CONSTRUCTION REQUIREMENTS. IF LANDLORD / BUILDING OWNER DOES HAVE REQUIREMENTS, CONTRACTOR SHALL BECOME COMPLETELY FAMILIAR WITH REQUIREMENTS AND ADHERE TO THEM. WHERE LANDLORD / BUILDING OWNER REQUIREMENTS ARE MORE STRINGENT THAN SHOWN IN THESE PLANS (IN THE OPINION OF THE ENGINEER). LANDLORD / BUILDING OWNER REQUIREMENTS SHALL

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THESE DRAWINGS AND THE PROJECT MANUAL ARE CONFIDENTIAL AND SHALL REMAIN THE SOLE PROPERTY O STARBUCKS CORPORATION, WHICH IS THE OWNER OF THE COPYRIGHT IN THIS WORK. THEY SHALL NOT BE REPRODUCE (IN WHOLE OR IN PART), SHARED WITH THIRD PARTIES OR USED IN ANY MANNER ON OTHER PROJECTS OR EXTENSIONS TO THIS PROJECT WITHOUT THE PRIOR WRITTEN CONSENT OF STARBUCKS CORPORATION. THESE DRAWINGS AND SPECIFICATIONS ARE INTENDED TO EXPRESS DESIGN INTENT FOR A PROTOTYPICAL STARBUCKS STORE (WHICH IS SUBJEC TO CHANGE AT ANYTIME) AND DO NOT REFLECT ACTUAL SITE CONDITIONS. NEITHER PARTY SHALL HAVE ANY OBLIGATION

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NOR LIABILITY TO THE OTHER (EXCEPT STATED ABOVE) UNTIL A

WRITTEN AGREEMENT IS FULLY EXECUTED BY BOTH PARTIES





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ELECTRICAL NOTES

SCALE: AS SHOWN SHEET NUMBER:

E001

ELECTRICAL SITE PLAN GENERAL NOTES

- A. PROVIDE A COMPLETE & OPERATING SYSTEM. ALL ITEMS ARE NOT NECESSARILY SHOWN.
- B. CONTRACTOR IS RESPONSIBLE FOR SITE INVESTIGATION PRIOR TO START OF WORK TO REVEAL THE
- C. REVIEW ALL CIVIL DRAWINGS AND COORDINATE EXISTING CONDUIT ROUTES WITH LANDLORD PRIOR TO PLACING BID AND/OR COMMENCING WORK.
- D. SEE ARCHITECTURAL SHEETS FOR FURTHER SIGNAGE INFORMATION AND EXACT LOCATIONS.
- E. EXTERIOR SITE LIGHTING TO BE ON A PHOTO-ELECTRICAL CELL. LIGHTING REQUIREMENTS:
- 1. MINIMUM LIGHT LEVELS OF 1.5 FOOT CANDLES AT 30" AFF IN PATIO AREAS.
- 2. MINIMUM LIGHT LEVELS OF 1.5 FOOT CANDLES AT PAVED AREAS.
- 3. NO DARK AREAS ON SITE, INCLUDING TRASH ENCLOSURE.
- 4. LED LIGHTING PREFERRED.
- F. LANDLORD PROVIDED AND INSTALLED CONDUITS SHALL HAVE OPENINGS PROTECTED AND PULLWIRES LABELED SO VENDORS WILL KNOW WHICH CONDUITS TO USE.
- G. FURNISH AND INSTALL APPROPRIATE HAND HOLES WHERE NEEDED AND PER CODE TO INSTALL
- H. INCREASE SIZE OF CONDUCTORS INDICATED IF NEEDED TO ACCOUNT FOR VOLTAGE DROP.

ELECTRICAL SITE PLAN KEYED NOTES

- ES01 MONUMENT / DRIVE THRU DIRECTIONAL SIGNAGE: LANDLORD TO PROVIDE 1" CONDUIT WITH PULLSTRING AND TENANT E.C. TO PROVIDE WIRING AND MAKE FINAL CONNECTION AS REQUIRED. SEE ARCHITECTURAL PLANS FOR DETAILS. COORDINATE ROUTING OF LANDLORD PROVIDED
- ES02 LANDLORD TO PROVIDE TWO (2) 1" CONDUITS BELOW GRADE FROM DIGITAL ORDER SCREEN CONTROL BOX TO DRIVE-THRU WINDOW AREA AND TENANT E.C. TO PROVIDE WIRING AND MAKE FINAL CONNECTIONS. VERIFY ALL REQUIREMENTS WITH EQUIPMENT MANUFACTURER PRIOR TO COMMENCING WORK. COORDINATE ROUTING OF LANDLORD PROVIDED CONDUITS IN FIELD.
- ES03 LANDLORD TO PROVIDE ONE (1) SPARE 1" CONDUIT BELOW GRADE THROUGH FOUNDATION WALL OF BUILDING. CAPPED AND TERMINATED ABOVE INTERIOR CEILING FOR FUTURE USE AT THE REAR OF SPACE. VERIFY LOCATIONS FOR STUB UP WITH STARBUCKS REPRESENTATIVE PRIOR TO
- ES04 LANDLORD TO PROVIDE ONE (1) 1" CONDUIT BELOW GRADE WITH PULLSTRING FROM DRIVE-THRU EQUIPMENT TO ELECTRICAL PANELS AND TENANT E.C. TO PROVIDE WIRING AND MAKE FINAL CONNECTION AS REQUIRED. VERIFY ALL REQUIREMENTS WITH EQUIPMENT MANUFACTURER PRIOR TO COMMENCING WORK. COORDINATE ROUTING OF CONDUIT IN FIELD. COORDINATE WITH OWNER AND STARBUCKS REPRESENTATIVE PRIOR TO COMMENCING WORK.
- ES05 LANDLORD TO PROVIDE ONE (1) 1" CONDUIT WITH PULLSTRING FOR EACH OF TWO DETECTOR LOOP SETS (ONE AT THE SPEAKER POST AND THE OTHER AT THE DRIVE THRU WINDOW) AND TENANT E.C. TO PROVIDE WIRING AND MAKE FINAL CONNECTIONS.
- ES06 LANDLORD TO PROVIDE 1" CONDUIT BELOW GRADE WITH PULLSTRING FROM PRE-MENU BOARD TO BUILDING FOR FUTURE USE.
- ES07 LANDLORD TO PROVIDE ONE (1) 1" CONDUIT WITH PULL STRING FROM TO ELECTRICAL PANEL TO DRIVE-THRU DOS CONTROL BOX. PROVIDE FINAL CONNECTION TO DOS CONTROL BOX AS REQUIRED. SEE DETAIL #2 ON THIS SHEET FOR MORE INFORMATION.
- ES08 PROVIDE ONE (1) 1" CONDUIT, WIRING, AND FINAL CONNECTION FOR POWER TO CANOPY LIGHTING. SEE ARCHITECTURAL SHEETS FOR CONDUIT STUB-UP DETAILS AND ADDITIONAL INFORMATION.
- ES09 LANDLORD TO PROVIDE AND INSTALL TWO (2) 2" CONDUITS: ONE (1) 2" CONDUIT FOR TELEPHONE FROM DEMARCATION POINT TO TENANT'S SPACE AND ONE (1) 2" CONDUIT FOR BROADBAND CABLING FROM DEMARCATION POINT TO TENANT'S SPACE. LANDLORD SHALL TERMINATE CONDUITS IN THE CEILING AREA ABOVE THE TENANT'S MANAGER'S DESK LOCATION. COORDINATE TERMINATION POINT WITH ARCHITECTURAL PLANS PRIOR TO COMMENCING WORK.
- ES10 LANDLORD TO PROVIDE AND INSTALL EXTERIOR WEATHERPROOF RECEPTACLE. LANDLORD TO VERIFY EXACT HEIGHT WITH GC IN FIELD PRIOR TO INSTALLATION.
- ES11 LANDLORD TO PROVIDE AND INSTALL WEATHERPROOF GFCI DUPLEX RECEPTACLE FOR WALL MOUNTED FAN. VERIFY EXACT HEIGHT WITH GC IN FIELD PRIOR TO INSTALLATION. FANS TO BE SWITCHED TO RUN INDEPENDENTLY FROM PATIO LIGHTING. VERIFY WITH OWNER AND GC PRIOR TO INSTALLATION OF FAN SWITCH FOR EXACT LOCATION.
- ES12 LANDLORD TO PROVIDE AND INSTALL WALL MOUNTED WEATHERPROOF GFCI DUPLEX RECEPTACLE FOR PATIO LIGHTING. VERIFY EXACT HEIGHT WITH GC IN FIELD PRIOR TO INSTALLATION. PATIO LIGHTING FIXTURES SHALL BE CONTROLLED VIA ASTRONOMICAL TIME CLOCK WITH EXTERIOR LIGHTING.



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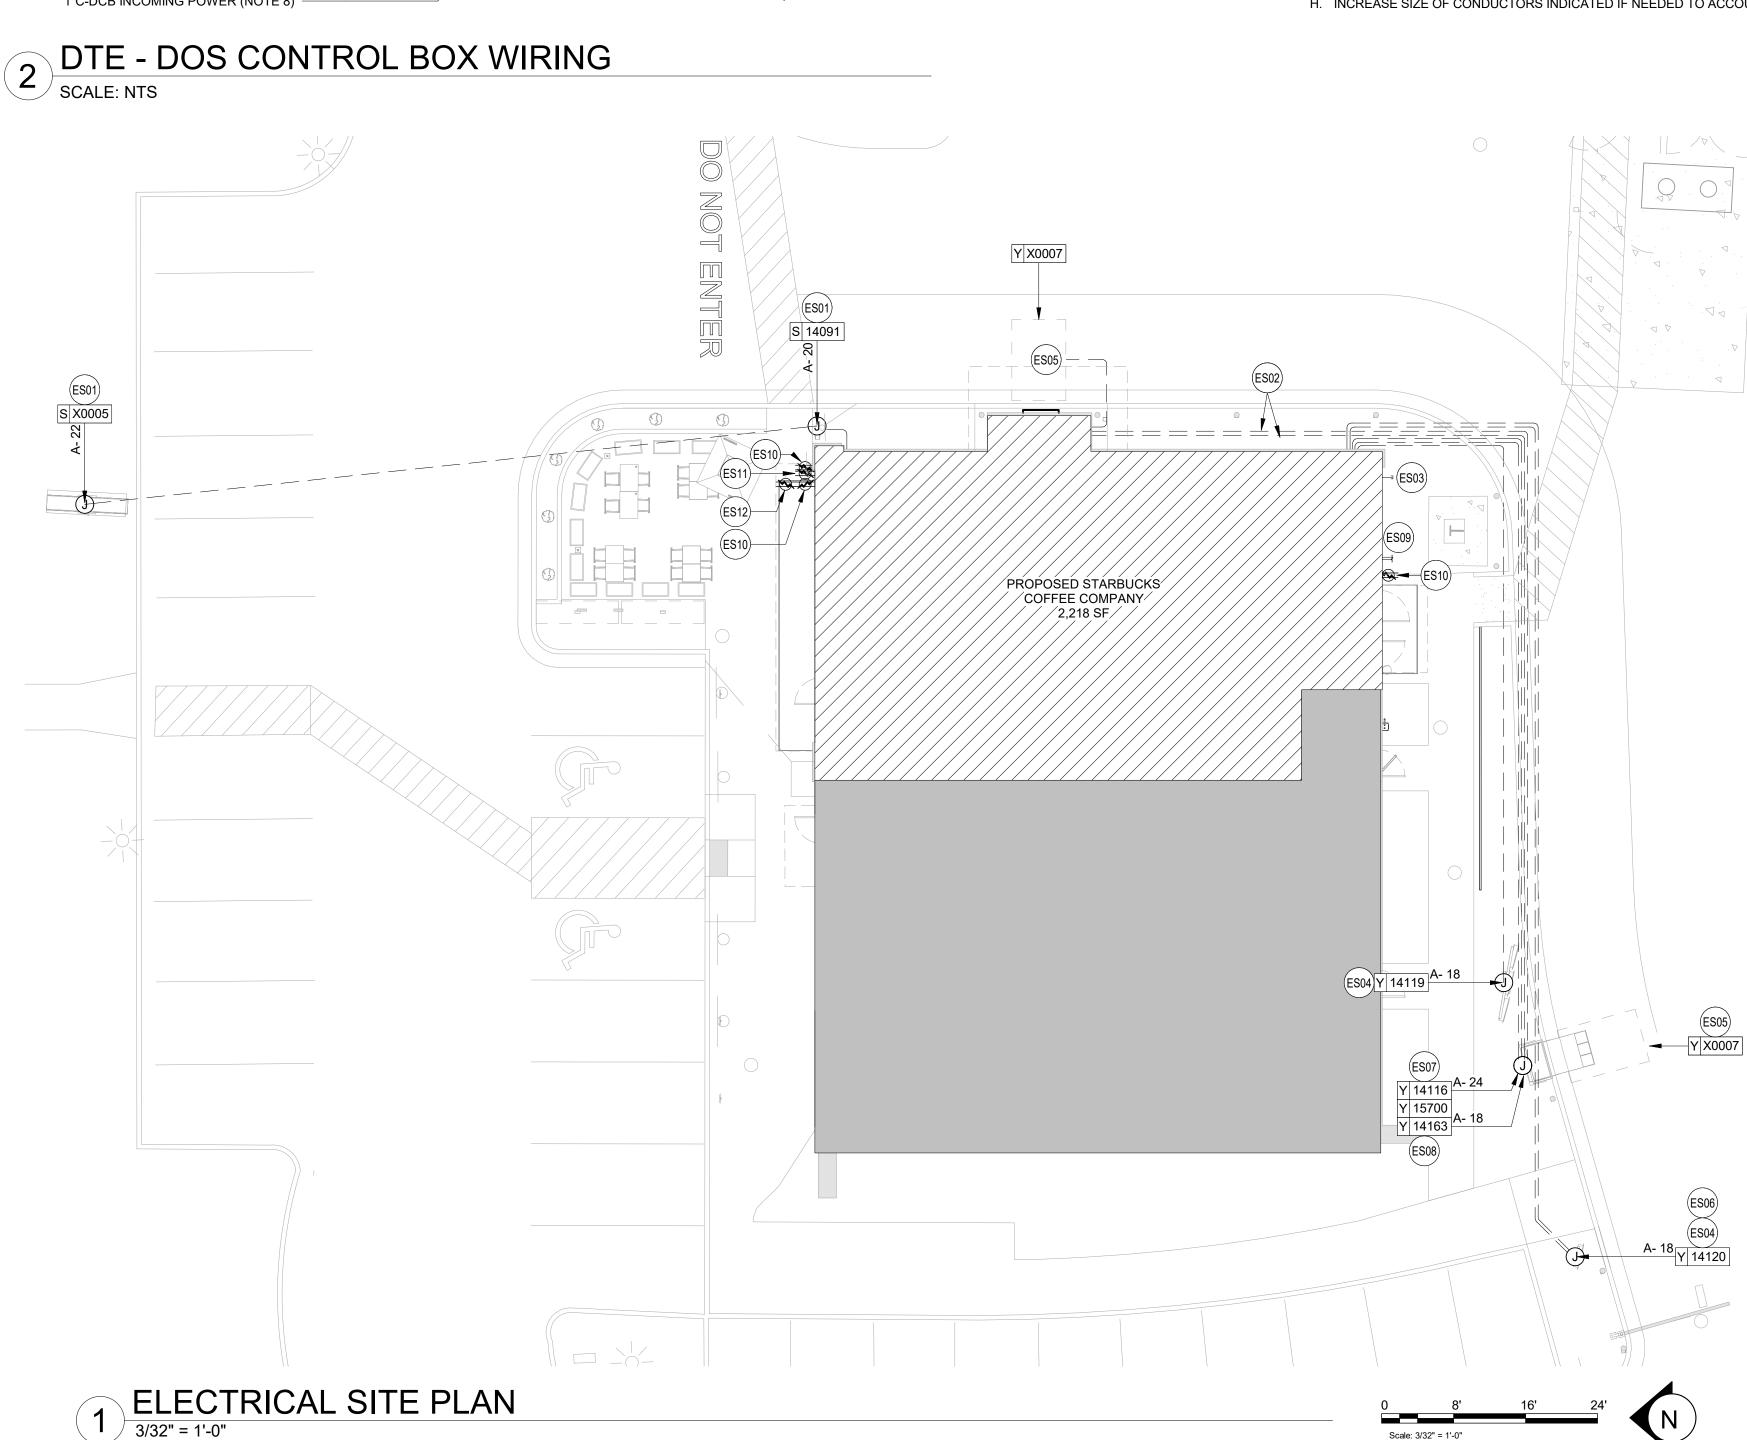
STORE #: PROJECT #: ISSUE DATE: SR. DESIGN MANAGER: K. GORIN-SLONSK PRODUCTION DESIGNER: A.MAUSER CHECKED BY:

ELECTRICAL SITE PLAN

SCALE: AS SHOWN

SHEET NUMBER:

E003



LEGEND:

DOS WHIP

CONDUIT BY EC

ELECTRICAL STUB UP DETAIL - POS

SCALE: NTS ALL CONDUIT STUB UPS-TO BE WITHIN THIS BOUNDARY 1" DATA TO MANAGER'S DESK--1" POWER CONDUIT TO ELECTRICAL (FUTURE) PANEL (FUTURE) 3/4" DATA TO MANAGER'S DESK (CUP -1" POWER CONDUIT TO ELECTRICAL LABELER/PRINTER) PANEL (U/C REFRIG./INSTA-HOT) 3/4" ISOLATED GROUND POWER CONDUIT -3/4" POWER CONDUIT TO ELECTRICAL TO ELECTRICAL PANEL (CUP PANEL (ESPRESSO MACHINE) LABELER/PRINTER) -3/4" POWER CONDUIT TO ELECTRICAL

PANEL (ESPRESSO MACHINE)

ELECTRICAL STUB UP DETAIL - ESPRESSO

3' - 10" (E17)(E16) COND. ON ROOF 1 E103 13' - 2" E20 P 13082 B- 31 2' - 4" 3" POWER PLAN

POWER PLAN GENERAL NOTES

- A. REFER TO ARCHITECTURAL DETAIL SHEETS FOR EXACT LOCATIONS AND MOUNTING HEIGHTS OF ELECTRICAL DEVICES.
- B. THE ELECTRICAL CONTRACTOR IS RESPONSIBLE FOR CONFIRMING ALL VOLTAGE **REQUIREMENTS**
- C. ELECTRICAL CONTRACTOR SHALL COORDINATE WITH PLUMBING AND HEATING, VENTILATING, AND AIR CONDITIONING (HVAC) CONTRACTORS FOR ANY ADDITIONAL EQUIPMENT NEEDING POWER.
- D. ALL FUTURE EQUIPMENT NEEDED HEREIN SHALL BE PROVIDED WITH AN APPROPRIATE RECEPTACLE AND FULLY WIRED. EVEN IF NOT SPECIFICALLY INDICATED.
- E. GROUND FAULT CIRCUIT INTERRUPTER (GFCI) BREAKERS (NOT RECEPTACLES) SHALL BE UTILIZED WHERE REQUIRED BY CODE AND AT ANY FLOOR BOXES. PROVIDÉ DEDICATED NEUTRAL WIRE FOR ALL THESE CIRCUITS.
- F. EQUIPMENT REQUIRES CONNECTION TO THE BUILDING ELECTRICAL SYSTEM. FURNISH AND INSTALL ALL NECESSARY CONDUIT, WIRE, CONNECTIONS, RECEPTACLES AND OVERCURRENT PROTECTION NECESSARY TO ENSURE THE EQUIPMENT FUNCTIONS PROPERLY AND COMPLIES WITH ALL APPLICABLE LOCAL AND NATIONAL CODES. COORDINATE EQUIPMENT REQUIREMENTS WITH MANUFACTURER CUT SHEET PRIOR TO
- G. ALL BACK BAR AND FRONT BAR J-BOXES AND OUTLETS SHALL BE SURFACE MOUNTED. PROVIDE CONDUITS AS NEEDED AND ONE (1) ADDITIONAL SPARE CONDUIT BETWEEN ALL J-BOXES FOR FUTURE ELECTRICAL REQUIREMENTS. ALL J-BOXES SHALL BE POSITIONED TO AVOID OBSTRUCTION OF ANY EQUIPMENT SUCH AS REFRIGERATORS
- H. REFERENCE LANDLORD WORK LETTER FOR DIVISION OF ELECTRICAL SCOPE OF WORK AND COORDINATE WITH STARBUCKS CONSTRUCTION MANAGER.
- I. ALL UNDERSLAB WORK BY STARBUCKS CONTRACTOR.
- J. REFER TO CALLOUT DETAILS INDICATED ON SHEET FOR ADDITIONAL INFORMATION.

POWER PLAN KEYED NOTES

- E01 PROVIDE ELECTRICAL CONNECTION TO WATER HEATER. CONFIRM ELECTRICAL REQUIREMENTS PRIOR TO ROUGH-IN.
- E02 PROVIDE ROUGH-IN AND FINAL CONNECTION TO RESTROOM EXHAUST FAN. FAN TO BE CONTROLLED BY TIMECLOCK, CONNECT TO TIMECLOCK AS REQUIRED. SEE TIMECLOCK DETAIL ON SHEET E102 FOR MORE INFORMATION.
- E03 REFRIGERATOR AND/OR FREEZER: PROVIDE RECEPTACLE AS SHOWN AT 84" AFF. DETAIL 5 ON SHEET E501 FOR MORE INFORMATION.
- E04 ICE MACHINE: PROVIDE ROUGH-IN AND FINAL CONNECTION. PROVIDE CONNECTION TO REMOTE CONDENSER LOCATED ON ROOF. FURNISH AND INSTALL ALL NECESSARY CONDUIT, WIRE CONNECTIONS AND BREAKERS TO SUPPORT ICE MACHINE AND REMOTE CONDENSER LOCATED ON ROOF.
- E05 WAREWASHER: PROVIDE AND INSTALL NEMA 14-50R RECEPTACLE TO SUPPORT WAREWASHER. VERIFY ALL REQUIREMENTS WITH EQUIPMENT SUPPLIER PRIOR TO COMMENCING WORK INCLUDING, BUT NOT LIMITED TOO, PROVISION OF POWER CORD ACCESSORY KIT WITH NEMA 14-50P PLUG.
- E06 PROVIDE POWER TO BANQUETTE. ROUGH-IN LOCATIONS SHOWN FOR REFERENCE ONLY. COORDINATE LOCATION AND REQUIREMENTS WITH DETAIL INDICATED AND FURNITURE MANUFACTURER PRIOR TO COMMENCING WORK.
- E07 PROVIDE RECEPTACLE AT 18" A.F.F. IN SEATING AREAS. VERIFY LOCATION WITH OWNER PRIOR TO COMMENCING WORK.
- E08 STUB UP POWER, DATA, AND PHONE CONDUITS 6" AFF IN THIS LOCATION. ROUTE POWER CONDUCTORS IN FLEXIBLE METAL CONDUIT TIGHT TO WALL FROM RECEPTACLES TO NEARBY RIGID STUB-UP AND BACK TO SERVING POWER PANEL ROUTE DATA AND PHONE CONDUITS UNDERFLOOR BACK TO DATA RACK NEAR MANAGERS WORKSTATION. LABEL DATA AND PHONE CONDUITS "FOR DATA CABLING", PROVIDE INSULATED BUSHINGS, AND PROVIDE PULL STRING FROM END TO END. LABEL SECURITY CONDUIT "FOR SECURITY" AND PROVIDE PULL STRING FROM END TO END. SEE DETAIL INDICATED FOR MORE INFORMATION.
- E09 MANAGER'S DESK: FURNISH AND INSTALL ALL NECESSARY POWER AND DATA ROUGH-INS FOR MANAGER'S DESK EQUIPMENT. ALL RECEPTACLES TO BE ISOLATED-GROUNDING TYPE RECEPTACLES WITH SURGE PROTECTION. SEE MANAGER'S DESK ELEVATIONS AND MANAGER'S DESK PLAN VIEW DETAILS INDICATED FOR EXACT ROUGH-IN TYPES, QUANTITIES, LOCATIONS, DIMENSIONS, AND
- E10 HAND DRYER/SOAP DISPENSER/FAUCET: FURNISH AND INSTALL CIRCUIT AND ROUGH-IN AT 14-13/16" A.F.F. ON GFI CIRCUIT BREAKER SIZED PER CODE TO SUPPORT INTEGRATED SINK EQUIPMENT. VERIFY EXACT ROUGH-IN LOCATION WITH MANUFACTURER AND EQUIPMENT PROVIDED PRIOR TO COMMENCING WORK.
- E11 FURNISH AND INSTALL WALL MOUNTED SHOW WINDOW RECEPTACLE. RECEPTACLES ARE TO BE PLACED WITHIN 18" OF WINDOW. COORDINATE EXACT RECEPTACLE AND COVER PLATE COLOR WITH OWNER PRIOR TO COMMENCING WORK.
- E12 PROVIDE SERVICE RECEPTACLE AT ELECTRICAL PANELS. VERIFY HEIGHT WITH OWNER PRIOR TO COMMENCING WORK.
- E13 PROVIDE ROUGH-IN AND FINAL CONNECTION TO HOT WATER RETURN PUMP. SEE PLUMBING SHEETS FOR MORE INFORMATION. VERIFY ALL REQUIREMENTS WITH EQUIPMENT MANUFACTURER PRIOR TO COMMENCING WORK. COORDINATE ALL WORK WITH PLUMBING CONTRACTOR IN FIELD.
- E14 LANDLORD TO PROVIDE ROUGH-IN AND FINAL CONNECTION TO NEW RTU. RTU-MOUNTED DISCONNECT AND SERVICE RECEPTACLE TO BE FACTORY INSTALLED AND CIRCUITED BY LANDLORD. SHOWN FOR REFERENCE ONLY.
- E15 PROVIDE ROUGH-IN AND FINAL CONNECTION FOR BOOSTER PUMP AS REQUIRED. VERIFY REQUIREMENTS WITH LANDLORD AND PLUMBING CONTRACTOR PRIOR TO
- E16 EXISTING EXTERIOR WEATHER PROOF RECEPTACLE PROVIDED AND INSTALLED BY LANDLORD TO REMAIN AND BE REUSED. SHOWN FOR REFERENCE ONLY.
- E17 LANDLORD TO PROVIDE AND INSTALL WALL MOUNTED WEATHERPROOF GFCI DUPLEX RECEPTACLE FOR PATIO LIGHTING. VERIFY EXACT HEIGHT WITH GC IN FIELD PRIOR TO INSTALLATION. PATIO LIGHTING FIXTURES SHALL BE CONTROLLED VIA ASTRONOMICAL TIME CLOCK WITH EXTERIOR LIGHTING. SEE CONTACTOR DETAIL ON SHEET E102 FOR MORE INFORMATION.
- E18 LANDLORD TO PROVIDE AND INSTALL WEATHERPROOF GFCI DUPLEX RECEPTACLE FOR WALL MOUNTED FAN. VERIFY EXACT HEIGHT WITH GC IN FIELD PRIOR TO INSTALLATION. FANS TO BE SWITCHED TO RUN INDEPENDENTLY FROM PATIO LIGHTING. VERIFY WITH OWNER AND GC PRIOR TO INSTALLATION OF FAN SWITCH FOR EXACT LOCATION. SEE SWITCH BANK DETAIL ON SHEET E102 FOR MORE
- E19 PROVIDE QUADPLEX RECEPTACLE AT 6'-6" AFF FOR WATER FILRATION SYSTEM.
- E20 PROVIDE DUPLEX RECEPTACLE AT 4'-6" AFF FOR WATER FILRATION SYSTEM.

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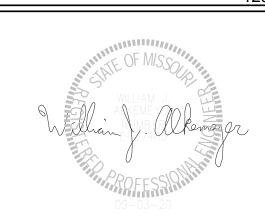
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STORE #: 63039 PROJECT #: **ISSUE DATE** SR. DESIGN MANAGER: K. GORIN-SLONSKI

88084-001 PRODUCTION DESIGNER: A.MAUSER JAK/BMS/CJS

Revision Schedule


POWER PLAN

SCALE: AS SHOWN

CHECKED BY:

SHEET NUMBER:

E101

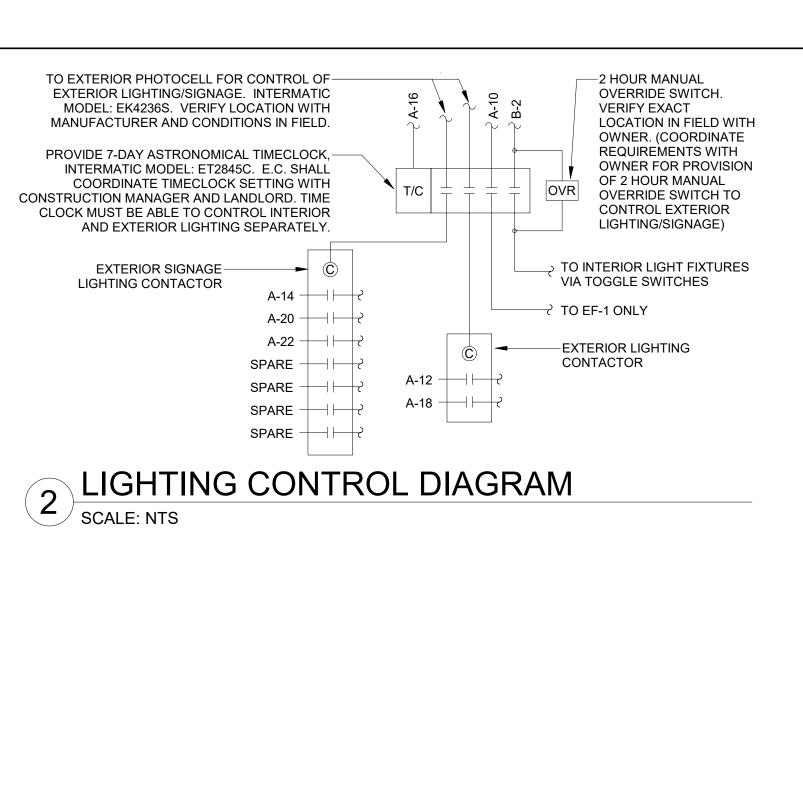

LIGHTING PLAN

1/4" = 1'-0"

EGRESS LIGHTING GENERAL NOTES

- A. EXIT SIGNS SHALL BE INTERNALLY ILLUMINATED, LISTED AND LABELED IN ACCORDANCE WITH UL 924 AND INSTALLED IN ACCORDANCE WITH THE MANUFACTURER'S INSTRUCTIONS.
- B. ANYTIME A BUILDING OR A PORTION OF A BUILDING IS OCCUPIED, THE MEANS OF EGRESS SERVING THE OCCUPIED PORTION SHALL BE ILLUMINATED AT AN INTENSITY OF NOT LESS THAN 1 FOOT CANDLE (11 LUX) AT THE WALKING SURFACE LEVEL.
- C. C.THE POWER SUPPLY FOR MEANS OF EGRESS ILLUMINATION SHALL BE PROVIDED BY THE PREMISE'S ELECTRICAL SUPPLY, IN THE EVENT OF POWER SUPPLY FAILURE, ILLUMINATION SHALL BE AUTOMATICALLY PROVIDED FROM AN EMERGENCY SYSTEM FOR THE FOLLOWING AREAS.
- 1) AISLES AND UNENCLOSED EGRESS STAIRWAYS IN ROOMS AND SPACES THAT REQUIRE TWO OR
- 2) CORRIDORS, INTERIOR EXIT STAIRWAYS & RAMPS AND EXIT PASSAGEWAYS IN BUILDINGS REQUIRED TO HAVE TWO OR MORE EXITS.
- 3) EXTERIOR EGRESS COMPONENTS AT OTHER THAN THE LEVEL OF EXIT DISCHARGE UNTIL EXIT DISCHARGE IS ACCOMPLISHED FOR BUILDINGS REQUIRED TO HAVE TWO OR MORE EXITS.
- 4) INTERIOR EXIT DISCHARGE ELEMENTS, AS REQUIRED BY CODE IN BUILDINGS REQUIRED TO HAVE TWO OR MORE EXITS.
- 5) EXTERIOR LANDINGS, AS REQUIRED BY CODE, EXIT DISCHARGE DOORWAYS IN BUILDING REQUIRED
- D. THE EMERGENCY POWER SYSTEM SHALL ALSO BE CONNECTED TO AN EMERGENCY ELECTRICAL SYSTEM WHICH IS TO PROVIDE CONTINUED ILLUMINATION FOR A DURATION OF NOT LESS THAN 1 1/2 HOUR IN CASE OF PRIMARY POWER LOSS. CONTINUED ILLUMINATION IS TO BE PROVIDED FROM STORAGE BATTERIES, UNIT EQUIPMENT OR AN ON-SITE GENERATOR AND THE INSTALLATION OF THE EMERGENCY POWER SYSTEM SHALL BE INSTALLED IN ACCORDANCE WITH THE MANUFACTURER'S
- E. EMERGENCY LIGHTING FACILITIES SHALL BE ARRANGED TO PROVIDE INITIAL ILLUMINATION THAT IS AT LEAST AN AVERAGE OF 1 FOOT CANDLE (11 LUX) AND A MINIMUM AT ANY POINT OF 0.1 FOOT CANDLE (1 LUX) MEASURED ALONG THE PATH OF EGRESS AT FLOOR LEVEL. A MAXIMUM TO MINIMUM ILLUMINATION UNIFORMITY RATION OF 40:1 SHALL NOT BE EXCEEDED.

(L04)(L06)

(L04) L06

LIGHTING PLAN GENERAL NOTES

- A. REFER TO ARCHITECTURAL PLANS FOR DIMENSIONED FIXTURE LOCATIONS.
- B. ALL FIXTURES IN WORK ROOM, BACK AND FRONT LINE, ABOVE CONDIMENT CART, AND ANY OTHER AREAS WHERE EXPOSED FOOD, CLEAN EQUIPMENT OR UTENSILS, OR UNWRAPPED SINGLE SERVICE ITEMS WILL BE EXPOSED, SHALL HAVE SHATTERPROOF LAMPS IF THE FIXTURE IS NOT LENSED. ARCHITECT OF RECORD TO INCLUDE APPROPRIATE LAMPS / FIXTURES ON DRAWINGS AND SCHEDULES, AND COMPLY WITH ANY ADDITIONAL JURISDICTIONAL LIGHTING REQUIREMENT.
- C. PROVIDE GROMMET AT ALL CEILING PENETRATIONS FOR FIXTURES/SUPPORTS
- D. CENTER EMERGENCY/EXIT LIGHTS ABOVE DOORS, UNLESS OTHERWISE NOTED.
- E. ADJUST FOCUS OF ALL TRACK AND RECESSED DIRECTIONAL LIGHTING TO FULLY ILLUMINATE ALL ARTWORK, MENU BOARDS, AND MERCHANDISE BAYS.
- F. IF PENDANT CYLINDERS CAN SUSPENDED LENGTH EXCEEDS 48" (1220MM) FROM CEILING, REPLACE WITH SURFACE MOUNTED CYLINDER CANS AND SUSPEND WITH GENERAL CONTRACTOR SUPPLIED CONDUIT AND J-BOX TO DIMENSIONED HEIGHT.
- G. CONTRACTOR SHALL FURNISH AS-BUILTS DRAWINGS FOR ELECTRICAL POWER SYSTEMS WITHIN 30 DAYS OF SYSTEM ACCEPTANCE.
- H. CONTRACTOR TO FURNISH OPERATIONS AND MAINTENANCE INSTRUCTIONS FOR SYSTEMS AND EQUIPMENT TO THE BUILDING OWNER OR DESIGNATED REPRESENTATIVE
- I. CONTRACTOR TO VERIFY LIGHTING SYSTEMS HAVE BEEN TESTED TO ENSURE PROPER CALIBRATION, ADJUSTMENT, PROGRAMING, AND OPERATION.
- J. ALL EMERGENCY LIGHTING TO BE CIRCUITED TO LOCAL LIGHTING CIRCUIT AHEAD OF ANY SWITCHING OR TIMECLOCK CONTROLS UNLESS NOTED OTHERWISE.
- K. ALL EXIT SIGNS TO BE ON DEDICATED CIRCUIT INDICATED ON PLAN.

LIGHTING PLAN KEYED NOTES

- L01 PROVIDE QUADPLEX RECEPTACLES AND DUAL DATA CONNECTIONS BEHIND MENUBOARD, DATA LINES SHALL RUN FROM MENUBOARD PORT TO DATA RACK AT MANAGER'S DESK. REFER TO DETAIL INDICATED FOR ADDITIONAL INFORMATION. FIELD VERIFY EXACT MOUNTING HEIGHT AND LOCATION WITH GENERAL CONTRACTOR PRIOR TO COMMENCING WORK.
- INTERIOR LIGHTING FIXTURES SHALL BE CONTROLLED VIA SWITCH BANK AND ASTRONOMICAL TIME CLOCK. SEE DETAILS 2 & 3 ON THIS SHEET FOR MORE INFORMATION. VERIFY EXACT LOCATION WITH OWNER PRIOR TO COMMENCING WORK. TIME CLOCK SHALL BE LOCATED ADJACENT TO ELECTRICAL PANELS. FURNISH AND INSTALL ALL CONDUIT, WIRE, CONNECTIONS AND TIME CLOCK MODULES NECESSARY TO INSURE A FUNCTIONAL TIME CLOCK SYSTEM.
- LOCATION OF SWITCH BANK SHOWN FOR REFERENCE ONLY. COORDINATE EXACT LOCATION FOR SWITCH BANK WITH GENERAL CONTRACTOR PRIOR TO COMMENCING
- CIRCUIT SERVING EXTERIOR SIGNAGE/LIGHTING SHALL BE CONTROLLED BY ASTRONOMICAL TIME CLOCK, PHOTOCELL AND LIGHTING CONTACTOR. TIME CLOCK SHALL BE LOCATED ADJACENT TO ELECTRICAL PANELS. VERIFY LOCATION OF PHOTOCELL WITH MANUFACTURER. FURNISH AND INSTALL ALL CONDUIT, WIRE. CONNECTIONS AND TIME CLOCK MODULES NECESSARY TO INSURE A FUNCTIONAL TIME CLOCK SYSTEM IF LANDLORD PROVIDED SYSTEM IS NOT ADEQUATE. SEE DETAIL 2 ON THIS SHEET FOR MORE INFORMATION.
- E.C. SHALL PROVIDE ROUGH-IN AND FINAL CONNECTION TO STOREFRONT SIGN. FIELD VERIFY EXACT MOUNTING HEIGHT AND LOCATION WITH OWNER PRIOR TO COMMENCING WORK AND/OR PLACING BID. PROVIDE ALL CONNECTIONS AND EQUIPMENT NECESSARY TO MEET ALL LOCAL CODES AND SIGNAGE REQUIREMENTS. VERIFY WITH SIGN VENDOR AND LOCAL AUTHORITY HAVING JURISDICTION PRIOR TO COMMENCING WORK. REUSE EXISTING CONDUIT AND PENETRATIONS PROVIDED BY LANDLORD WHERE POSSIBLE. VERIFY WITH CONDITIONS IN FIELD.
- LANDLORD TO PROVIDE, CIRCUIT AND INSTALL EXTERIOR LIGHT FIXTURE. VERIFY ANY ADDITIONAL WORK REQUIRED INCLUDING CONNECTION TO STARBUCKS TIMECLOCK SYSTEM.
- PROVIDE AND INSTALL EXTERIOR EGRESS LIGHTING IF NOT EXISTING BY LANDLORD. REUSE EXISTING EGRESS LIGHTING PROVIDED BY LANDLORD AND CONNECT TO NEW EXIT/EMERGENCY LIGHT IF COMPATIBLE, PROVIDE NEW IF NECESSARY. VERIFY WITH CONDITIONS IN FIELD PRIOR TO COMMENCING WORK.
- PROVIDE AND INSTALL ALL EQUIPMENT NECESSARY FOR LED TAPE LIGHTING IN SOFFIT INCLUDING, BUT NOT LIMITED TOO, LED DRIVER AND ADDITIONAL CONNECTIONS. LIGHTING SHALL BE CONTROLLED VIA SWITCH BANK AND ASTRONOMICAL TIME CLOCK. SEE DETAILS 2 & 3 ON THIS SHEET FOR MORE INFORMATION.
- L10 PATIO STRING LIGHTING TO BE POWERED BY WALL MOUNTED RECEPTACLE PROVIDED AND INSTALLED BY LANDLORD. LIGHTING TO BE CONTROLLED BY ASTRONOMICAL TIME CLOCK, PHOTOCELL AND LIGHTING CONTACTOR. SEE DETAIL 2 ON THIS SHEET FOR MORE INFORMATION.
- PROVIDE ROUGH-IN AND FINAL CONNECTION TO MOP SIGN. VERIFY EXACT ROUGH-IN AND CONTROL REQUIREMENTS WITH OWNER AND EQUIPMENT PROVIDED IN FIELD.



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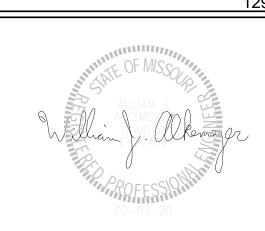
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PROJECT NAM BUILDO COFFEI RT. 291

STORE #: 63039

PROJECT #: 88084-001 **ISSUE DATE** SR. DESIGN MANAGER: K. GORIN-SLONSKI PRODUCTION DESIGNER: A.MAUSER CHECKED BY: JAK/BMS/CJS

Revision Schedule

LIGHTING PLAN

SCALE: AS SHOWN SHEET NUMBER:

E102

MANUFACTURER LIGHTING SWITCHBANK DETAIL
SCALE: NTS

dsw "b"

ACCENT

LIGHTING

CKT B-2

M.O.P.

SIGN

dsw "c"

CKT B-2

RETAIL

LIGHTING

dsw "g"

CKT A-13

PATIO

FANS

BACKBAR


LIGHTING

dsw "h"

CKT B-2

GENERAL

LIGHTING

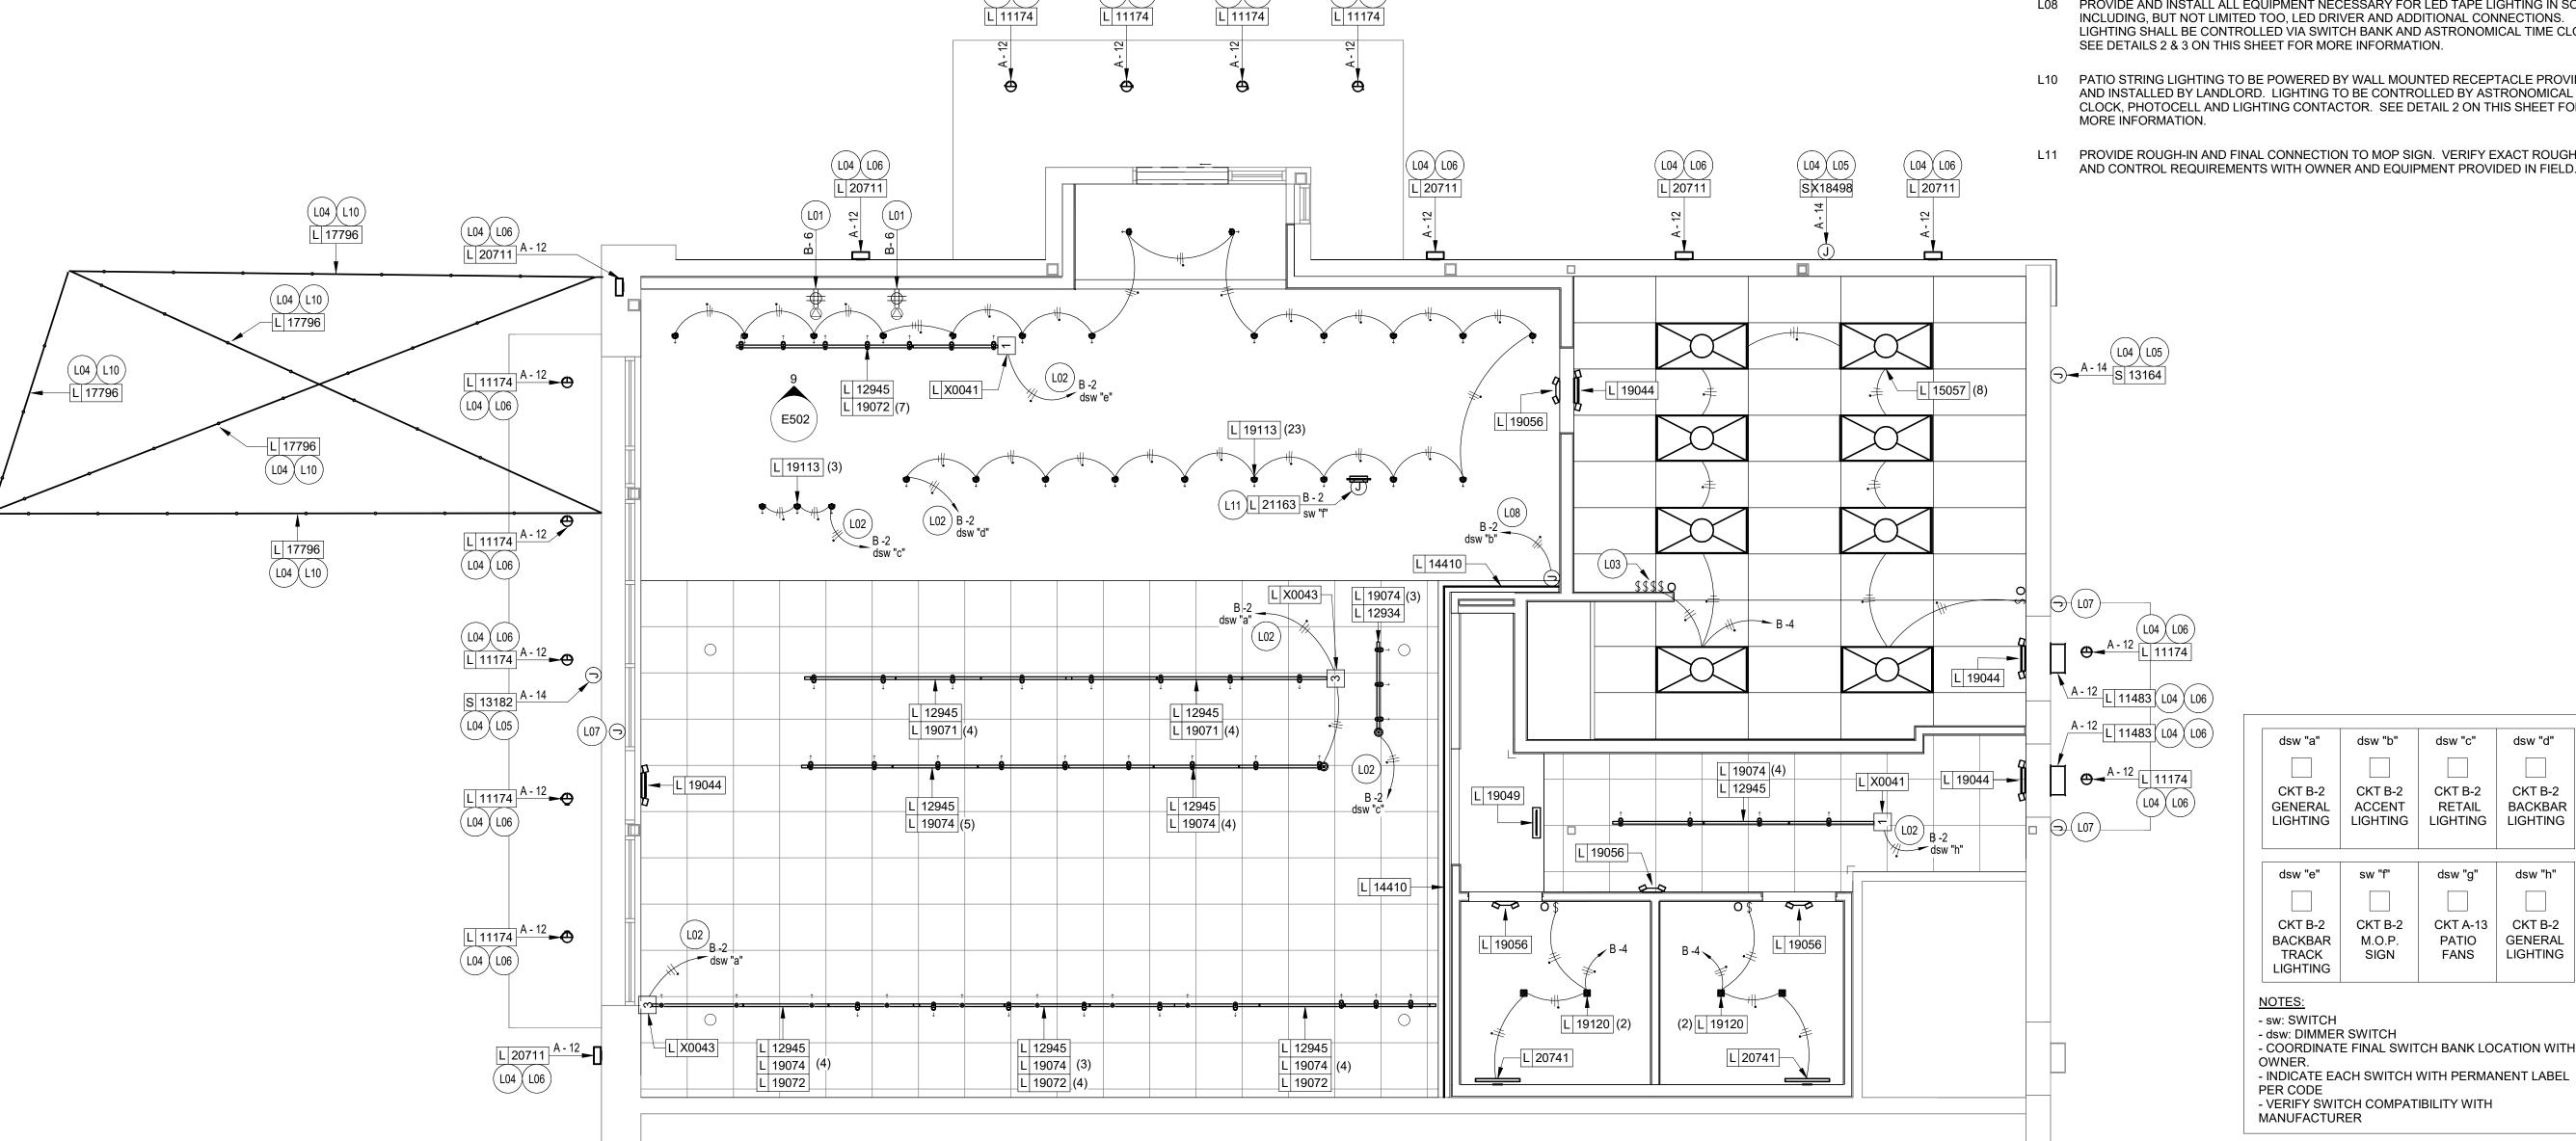

ENLARGED ELECTRICAL GENERAL NOTES

- A. REFER TO ELECTRICAL DETAIL SHEETS FOR EXACT LOCATIONS AND MOUNTING HEIGHTS OF ELECTRICAL DEVICES.
- B. THE ELECTRICAL CONTRACTOR IS RESPONSIBLE FOR CONFIRMING ALL VOLTAGE REQUIREMENTS ON ALL EQUIPMENT AND PROVIDING BUCK-BOOST TRANSFORMERS AS MAY BE NEEDED PER MANUFACTURER'S RECOMMENDATIONS OR FOR CODE. ALL ARE NOT NECESSARILY INDICATED.
- C. ELECTRICAL CONTRACTOR SHALL COORDINATE WITH PLUMBING AND HEATING, VENTILATING, AND AIR CONDITIONING (HVAC) CONTRACTORS FOR ANY ADDITIONAL EQUIPMENT NEEDING POWER.
- D. ANY EQUIPMENT NOTED AS 'FUTURE' SHALL BE PROVIDED WITH APPROPRIATE RECEPTACLES AND WIRING TO ENABLE FUTURE OPERATION.
- E. GROUND FAULT CIRCUIT INTERRUPTER (GFCI) BREAKERS (NOT RECEPTACLES) SHALL BE UTILIZED WHERE REQUIRED BY CODE AND AT ANY FLOOR BOXES. PROVIDE DEDICATED NEUTRAL WIRE FOR ALL THESE CIRCUITS.
- F. EQUIPMENT REQUIRES CONNECTION TO THE BUILDING ELECTRICAL SYSTEM. FURNISH AND INSTALL ALL NECESSARY CONDUIT, WIRE, CONNECTIONS, RECEPTACLES AND OVERCURRENT PROTECTION NECESSARY TO ENSURE THE EQUIPMENT FUNCTIONS PROPERLY AND COMPLIES WITH ALL APPLICABLE LOCAL AND NATIONAL CODES. COORDINATE EQUIPMENT REQUIREMENTS WITH MANUFACTURER CUT SHEET PRIOR TO ROUGH-IN.
- G. ALL BACK BAR AND FRONT BAR J-BOXES AND OUTLETS SHALL BE SURFACE MOUNTED. PROVIDE CONDUITS AS NEEDED AND ONE (1) ADDITIONAL SPARE CONDUIT BETWEEN ALL J-BOXES FOR FUTURE ELECTRICAL REQUIREMENTS. ALL J-BOXES SHALL BE POSITIONED TO AVOID OBSTRUCTION OF ANY EQUIPMENT SUCH AS REFRIGERATORS AND DISHWASHERS.
- H. REFERENCE LANDLORD WORK LETTER FOR DIVISION OF ELECTRICAL SCOPE OF WORK AND COORDINATE WITH STARBUCKS CONSTRUCTION MANAGER.
- I. ALL DATA OUTLETS TO BE ROUTED BACK TO DATA RACK AT MANAGER'S DESK WITH 3/4" UNLESS NOTED OTHERWISE.
- J. DIMENSION TO BOXED TOGETHER ROUGH-INS IN CASWORK INDICATING CENTERLINE OF ROUGH-IN GROUP.

ENLARGED ELECTRICAL KEYED NOTES

- EL01 PROVIDE ROUGH-IN(S) @ 26" AFF. CIRCUIT RECEPTACLE AS INDICATED. ROUTE DATA BACK TO DATA RACK AT MANAGERS DESK.
- EL02 DRIVE-THRU EQUIPMENT: FURNISH AND INSTALL ALL NECESSARY POWER AND DATA ROUGH-INS FOR DRIVE-THRU EQUIPMENT. ALL RECEPTACLES FOR DRIVE-THRU EQUIPMENT TO BE ISOLATED-GROUNDING TYPE RECEPTACLE WITH SURGE PROTECTION. SEE DRIVE-THRU ELEVATION AND DRIVE-THRU PLAN VIEW DETAILS INDICATED FOR EXACT ROUGH-IN TYPES, QUANTITIES, LOCATIONS, DIMENSIONS, AND CIRCUITING.
- EL03 ESPRESSO MACHINES: FURNISH AND INSTALL HEAVY DUTY RECEPTACLE AT 26" AFF. FURNISH AND INSTALL HEAVY DUTY ANGLED PLUG. PROVIDE ANY ADDITIONAL CONDUIT, WIRE, PRIMARY AND SECONDARY PROTECTION, AND CONNECTIONS NECESSARY TO INSURE A FUNCTIONAL SYSTEM. VERIFY EXACT ROUGH-IN AND OVERCURRENT PROTECTION REQUIREMENTS WITH MANUFACTURER PRIOR TO COMMENCING WORK.
- EL04 POS PRINTER: FURNISH AND INSTALL QUADPLEX ISOLATED-GROUNDING TYPE RECEPTACLE WITH SURGE PROTECTION AT 26" AFF. FURNISH AND INSTALL DATA OUTLET AT 26" AFF.
- EL05 SAFE: FURNISH AND INSTALL QUADPLEX ISOLATED-GROUNDING TYPE RECEPTACLE WITH SURGE PROTECTION AT 18" AFF.
- EL06 POS: FURNISH AND INSTALL DUPLEX ISOLATED-GROUNDING TYPE RECEPTACLE WITH SURGE PROTECTION AT 18" AFF. FURNISH AND INSTALL (1) DATA OUTLET AND AT 18"
- EL07 FURNISH AND INSTALL NEMA 6-30P RECEPTACLE AT 26" AFF TO SUPPORT WARMING OVENS. PROVIDE DATA CONNECTION FOR OWNER PROVIDED IOT MODULE AS REQUIRED FOR FOR WARMING OVEN. WORK SHALL INCLUDE ROUGH-IN AND CONDUIT WITH CAT5 CABLE FROM EQUIPMENT TO DATA RACK. COORDINATE LOCATION AND CONNECTION REQUIREMENTS WITH STARBUCKS PROJECT MANAGER IN FIELD.
- EL08 FURNISH AND INSTALL NEMA 6-50R RECEPTACLES AT 26" AFF TO SUPPORT DUAL BREWER. FURNISH AND INSTALL POWER CORD WITH NEMA 6-50P PLUG. COORDINATE EXACT INSTALLATION REQUIREMENTS WITH MANUFACTURER AND LOCATION AND CONNECTION REQUIREMENTS WITH STARBUCKS PROJECT MANAGER IN FIELD.
- EL09 D/T WINDOW CONTROL: LANDLORD TO PROVIDE ROUGH-IN AT WINDOW HEADER HEIGHT. PROVIDE FINAL CONNECTION AS REQUIRED. VERIFY EXACT SCOPE OF WORK WITH LANDLORD AND CONDITIONS IN FIELD PRIOR TO COMMENCING WORK.
- EL10 PROVIDE ROUGH-IN AT 26" AFF FOR FUTURE USE. CIRCUIT RECEPTACLE AS INDICATED. ROUTE DATA BACK TO DATA RACK AT MANAGERS DESK.
- EL11 D/T AIR CURTAIN: LANDLORD TO PROVIDE DEDICATED CONDUIT TO POWER PANEL AND ALL NECESSARY WIRE AND CONNECTIONS FOR A FUNCTIONAL AIR CURTAIN SYSTEM. COORDINATE WITH MANUFACTURER'S REQUIREMENTS PRIOR TO ROUGH-IN.
- EL12 INSTALL OWNER PROVIDED IOT MODULE FOR ESPRESSO MACHINE AND MAKE FINAL CONNECTIONS AS REQUIRED.



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CONDITIONS. NEITHER PARTY SHALL HAVE ANY OBLIGATION

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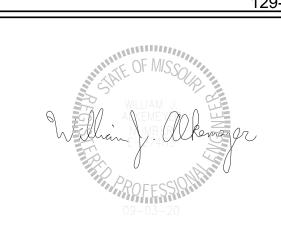
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Engineering Consultant

129-20



OF STARBUCKS

PROJECT NAME:
BUILDOUT OF
COFFEE

RT. 291 &150
PROJECT ADDRESS:
155 SW M-150 HW
LEES SUMMIT, MC

/ STE. 64082

STORE #: 63039
PROJECT #: 88084-001
ISSUE DATE: 09-04-2020
SR. DESIGN MANAGER: K. GORIN-SLONSKI

SR. DESIGN MANAGER: K. GORIN-SLC
PRODUCTION DESIGNER: A.MAUSER
CHECKED BY: JAK/BMS/CJS

Revision Schedule


Rev Date By Description

SHEET TITLE:
ENLARGED ELECTRICAL

PLACEMENT PLAN
SCALE: AS SHOWN


SHEET NUMBER:

E103

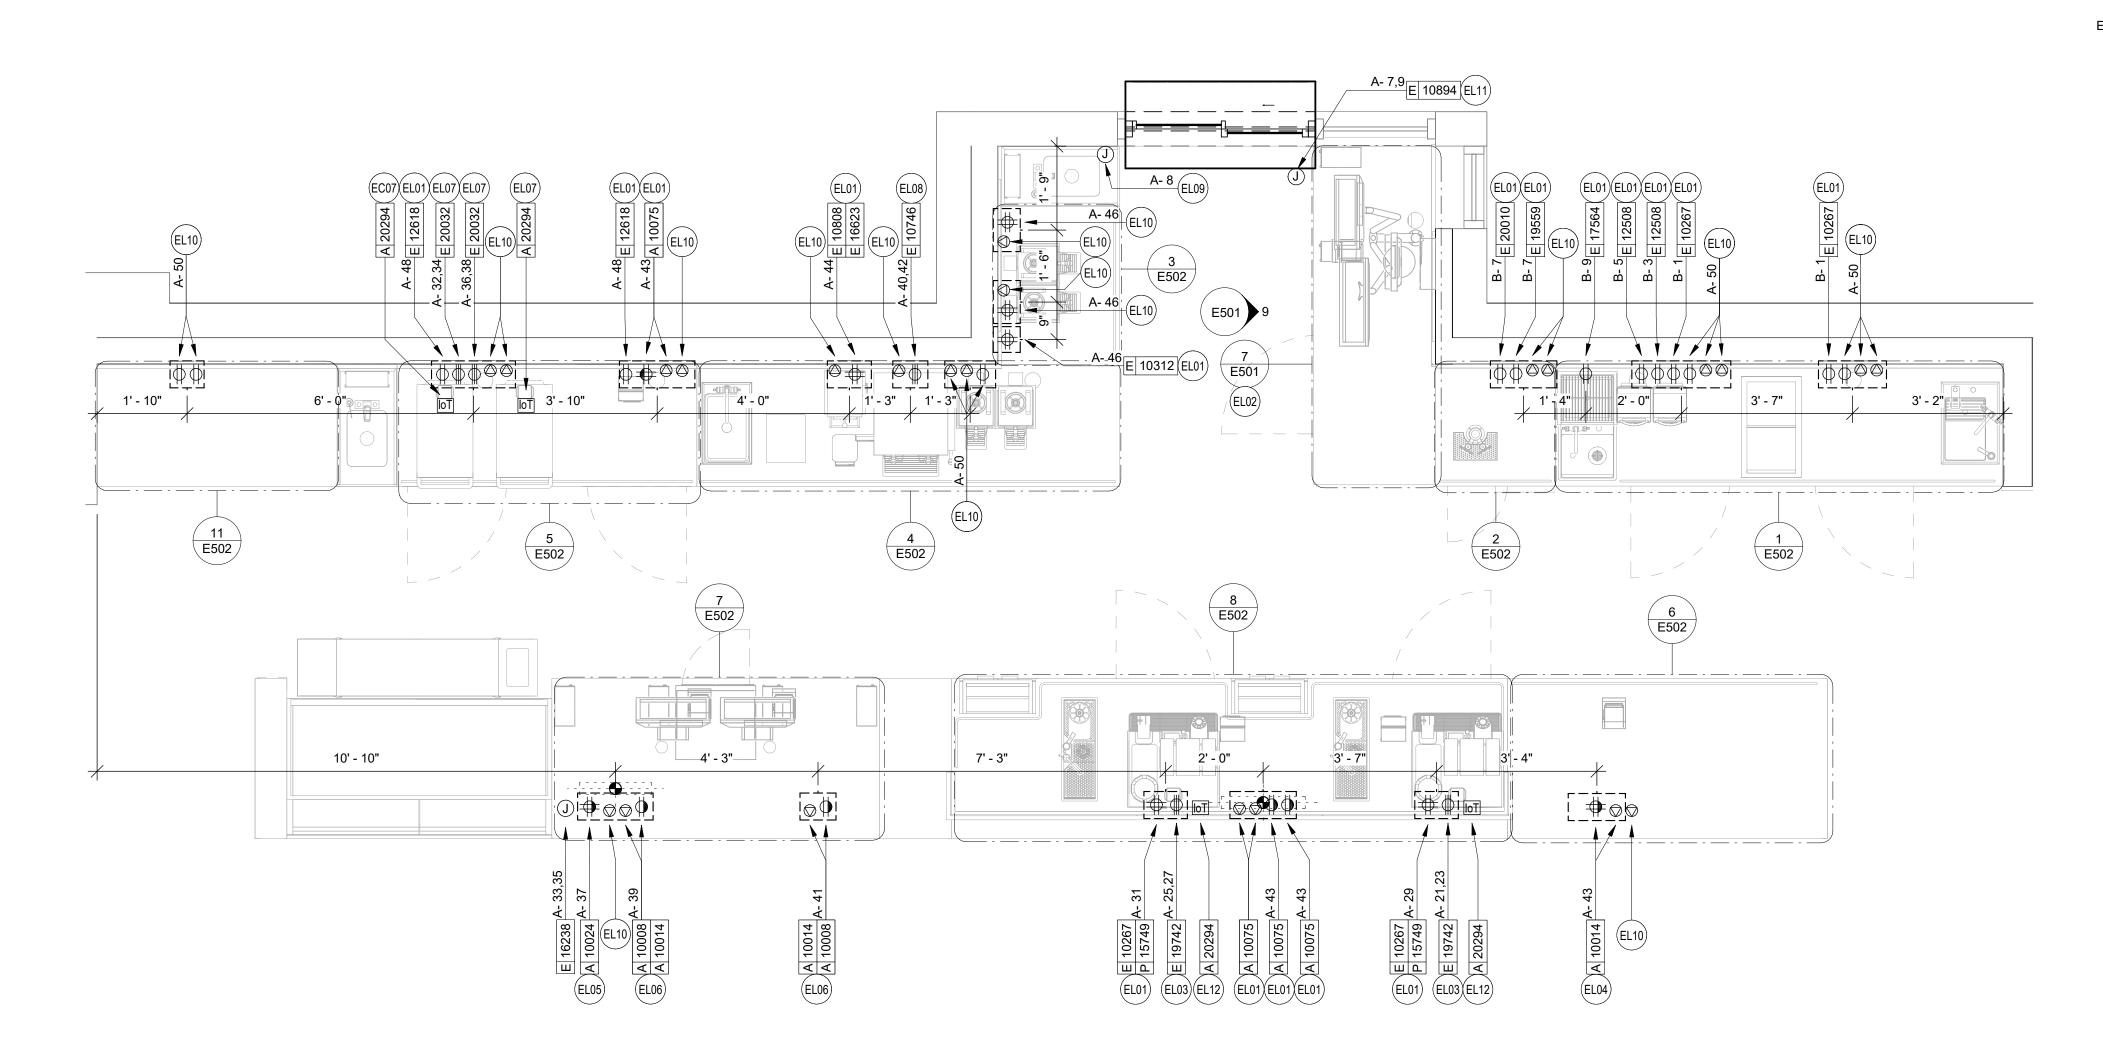

1 ENLARGED PLACEMENT PLAN

1/2" = 1'-0"

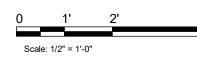



ELECTRICAL STUB UP DETAIL - POS

ALL CONDUIT STUB UPS-TO BE WITHIN THIS **BOUNDARY** 1" DATA TO MANAGER'S DESK--1" POWER CONDUIT TO ELECTRICAL PANEL (FUTURE) (FUTURE) 3/4" DATA TO MANAGER'S DESK (CUP 1" POWER CONDUIT TO ELECTRICAL LABELER/PRINTER) PANEL (U/C REFRIG./INSTA-HOT) 3/4" ISOLATED GROUND POWER CONDUIT -3/4" POWER CONDUIT TO ELECTRICAL TO ELECTRICAL PANEL (CUP PANEL (ESPRESSO MACHINE) LABELER/PRINTER) -3/4" POWER CONDUIT TO ELECTRICAL

PANEL (ESPRESSO MACHINE)

ELECTRICAL STUB UP DETAIL - ESPRESSO

DATA PLAN KEYED NOTES

- D01 CEILING MOUNTED WIRELESS ACCESS POINT (WAP). PROVIDE ROUGH-IN FOR WAP AND CAT6 CABLE FROM EQUIPMENT RACK PATCH PANEL AT MANAGERS DESK TO WAP LOCATION. PROVIDE ROUGH-IN FOR WAP OVER POS COUNTER CENTERED BETWEEN CASH REGISTERS AND OVER MANAGERS DESK. STARBUCKS VENDOR TO
- D02 PROVIDE DRIVE THRU SECURITY CAMERA ON EXTERIOR OF BUILDING ONLY AS REQUIRED. VERIFY EXACT REQUIREMENTS WITH OWNER AND/OR OWNERS REPRESENTATIVE PRIOR TO COMMENCING WORK.
- D03 PROVIDE ROUGH-IN AND FINAL CONNECTION TO AUDIO SPEAKER. WALL MOUNTED SPEAKER WATTAGE SETTING TO BE 5 VOLT. CEILING MOUNTED PENDANT SPEAKER WATTAGE SETTING TO BE 7.5 VOLT. COORDINATE EXACT LOCATION AND REQUIREMENTS, INCLUDING FINAL WATTAGE SETTING, WITH CONSTRUCTION MANAGER PRIOR TO COMMENCING WORK.
- D04 STUB UP POWER, DATA, AND PHONE CONDUITS 6" AFF IN THIS LOCATION. ROUTE POWER CONDUCTORS IN FLEXIBLE METAL CONDUIT TIGHT TO WALL FROM RECEPTACLES TO NEARBY RIGID STUB-UP AND BACK TO SERVING POWER PANEL. ROUTE DATA AND PHONE CONDUITS UNDERFLOOR BACK TO DATA RACK NEAR MANAGERS WORKSTATION. LABEL DATA AND PHONE CONDUITS "FOR DATA CABLING". PROVIDE INSULATED BUSHINGS, AND PROVIDE PULL STRING FROM END TO END. LABEL SECURITY CONDUIT "FOR SECURITY" AND PROVIDE PULL STRING FROM END TO END. SEE SHEET E102 FOR MORE INFORMATION.
- D05 MANAGER'S DESK: FURNISH AND INSTALL ALL NECESSARY POWER AND DATA ROUGH-INS FOR MANAGER'S DESK EQUIPMENT. ALL RECEPTACLES TO BE ISOLATED-GROUNDING TYPE RECEPTACLES WITH SURGE PROTECTION. SEE MANAGER'S DESK ELEVATIONS AND MANAGER'S DESK PLAN VIEW DETAILS INDICATED FOR EXACT ROUGH-IN TYPES, QUANTITIES, LOCATIONS, DIMENSIONS, AND CIRCUITING.
- D06 INSTALL CARBON MONOXIDE DETECTOR IN REAR OF SPACE AT LEAST 10 FEET FROM WATER HEATER PER STARBUCKS DESIGN STANDARDS. CARBON MONOXIDE DETECTOR SHALL BE #US 260 CO-SAFEAIR DETECTOR CONNECTED TO SECURITY CONTROL PANEL. VERIFY MOUNTING HEIGHT WITH EQUIPMENT SUPPLIER AND G.C. IN FIELD.
- DO7 DOOR POSITION SWITCH. LOCATE ONE AT EACH EXTERIOR DOOR LEAF.
- D08 ALARM KEY PAD. LOCATED WITHIN 10'-0" OF EMPLOYEE ENTRANCE. MOUNT AT 42" AFF.
- D09 PIR MOTION DETECTOR REQUIRED PER STORE AT FOLLOWING LOCATIONS: (1) BEHIND BAR NEAR POS, (1) CENTRALLY LOCATED IN CAFE, (1) AT MANAGER'S WORKSTATION, (1) CENTRALLY LOCATED IN BOH. VERIFY FINAL LOCATIONS PRIOR TO COMMENCING WORK.
- D10 SECURITY CAMERA. CEILING MOUNT TYPICAL. IN OPEN CEILING CONDITION LOCATE BOTTOM OF CAMERA AT SAME HEIGHT AS STORE LIGHTING.
- DRIVE THRU SECURITY CAMERA. LOCATE 6'-0" TO 8'-0" FROM WINDOW WITH CLEAR VIEW OF CUSTOMER AND DT

- A. REFER TO SHEET E104 FOR EXACT LOCATIONS AND MOUNTING HEIGHTS OF DATA DEVICES IN BAR AREA. REFER TO DETAILS ON SHEETS E501 AND 502 FOR ADDITIONAL INFORMATION.
- B. THE ELECTRICAL CONTRACTOR IS RESPONSIBLE FOR CONFIRMING ALL VOLTAGE REQUIREMENTS ON ALL EQUIPMENT AND PROVIDING BUCK-BOOST TRANSFORMERS AS MAY BE NEEDED FOR CODE. ALL ARE NOT NECESSARILY INDICATED.
- C. ANY EQUIPMENT NOTED AS 'FUTURE' SHALL BE PROVIDED WITH APPROPRIATE RECEPTACLES AND WIRING TO
- D. REFERENCE LANDLORD WORK LETTER FOR DIVISION OF ELECTRICAL SCOPE OF WORK AND COORDINATE WITH STARBUCKS CONSTRUCTION MANAGER.
- E. DATA CABLING LOCATED ABOVE HEAD SHALL BE PLENUM.

DATA PLAN GENERAL NOTES

- F. DATA CABLING LOCATED UNDERGROUND SHALL BE RATED FOR BELOW GROUND USE.
- G. DATA CABLING AT EXPOSED CEILING SHALL BE INSTALLED IN METAL CONDUIT OR PER LOCAL CODE REQUIREMENT.

2. MUSIC SYSTEM

- H. THE GENERAL CONTRACTOR SHALL INSTALL SPEAKERS AND WIRING PER VENDOR'S DRAWING
- I. SPEAKER PLACEMENT: LOCATE (1) PER 250 SF OF CAFE SPACE 14'-0" MIN. TO 18'-0" MAX. O.C.
- J. SPEAKER PAINTING: SPEAKER GRILLS CAN BE PAINTED. ALL GRILL HOLES TO REMAIN OPEN. NOTE: GRILL HOLES SHALL REMAIN OPEN.
- K. THE GENERAL CONTRACTOR SHALL INSTALL THE MUSIC SYSTEM, CONNECT WIRING AND TEST.

- L. ENTRY CAMERA: CAPTURE ENTIRE DOORWAY AND CUSTOMER TOP OF HEAD TO KNEES. PROVIDE (1) CAMERA AT EACH POINT OF ENTRY
- M. POS CAMERA: PRIMARY OBJECTIVE IS CUSTOMER. SECONDARY IS POS. IDEAL PLACEMENT IS TO CAPTURE BOTH.
- N. SAFE CAMERA: POSITION TO VIEW FROM HANDLE SIDE OF DOOR. POS CAMERA CAN BE USED WHEN SAFE IS LOCATED BELOW TERMINALS.
- O. DRIVE THRU CAMERA: PRIMARY OBJECTIVE IS CUSTOMER. SECONDARY IS POS. IDEAL PLACEMENT IS TO CAPTURE
- P. BOH CAMERA: CAPTURES CASH HANDLING AREA.
- Q. CARBON MONOXIDE: PROVIDE (1) MINIMUM CARBON MONOXIDE (CO) DETECTOR LOCATED IN THE BACK OF HOUSE. PROVIDE SECOND DETECTOR IN CAFE IF SPACE INCLUDES A FIREPLACE.

4. LOW VOLTAGE CABLING

- R. GENERAL CONTRACTOR TO PROVIDE PATHWAYS FOR ALL DATA AND LOW VOLTAGE CABLING DEVICES. CONDUITS CONTAINING MULTIPLE CABLES SHALL BE UPSIZED FOR FUTURE CAPACITY, 1" [25MM] TYPICAL.
- S. PROVIDE LABELED, END-TO-END PULL STRINGS RATED TO 25 LBS IN ALL CONDUITS.
- T. CONDUIT BEND RADIUS SHALL BE A MINIMUM OF 5x THE INTERNAL CONDUIT DIAMETER.
- U. TERMINATE CONDUITS THAT EXTEND THROUGH SLAB A MINIMUM OF 3" [75MM] AFF.
- V. FLEX CONDUIT IS GENERALLY UNACCEPTABLE FOR USE AS A COMMUNICATIONS CONDUIT EXCEPT AT SEISMIC
- W. ALL SUB-SLAB CONDUITS SHALL BE INSTALLED IN A MANNER THAT PREVENTS WATER INFILTRATION OF THE CONDUIT. IT IS THE GENERAL CONTRACTOR'S RESPONSIBILITY TO ENSURE RAIN WATER OR CONSTRUCTION WATER IS PREVENTED FROM ENTERING AND/OR REMOVED FROM CONDUIT PRIOR TO PLACEMENT OF CABLES.
- X. ALL PULL BOXES SHALL BE SIZED AND INSTALLED PER ANSI/TIA/EIA-569-A. PULL BOXES FOR UNDERGROUND CONDUITS ARE NOT PERMITTED UNLESS OTHERWISE NOTED.

5. BROADBAND CABLE

Y. MAIN POINT OF ENTRY: GENERAL C TO PROVIDE2" [50MM] MINIMUM CONDUIT PATH FROM THE BUILDING'S MAIN POINT OF ENTRY (MPOE) TO THE CEILING AT THE MANAGER'S WORKSTATION. THE INTERNET SERVICE PROVIDER (ISP) WILL DESIGNATE THE START AND END LOCATIONS OF THE CONDUIT AND ANY BACKBOARD, GROUNDING, AND POWER REQUIREMENTS.



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TO CHANGE AT ANYTIME) AND DO NOT REFLECT ACTUAL SITE CONDITIONS. NEITHER PARTY SHALL HAVE ANY OBLIGATION



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Phone (314) 772-1782 Fax (314) 373-3514

Engineering Consultant

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STORE #: PROJECT #: 88084-001 **ISSUE DATE** 09-04-2020 SR. DESIGN MANAGER: K. GORIN-SLONSKI PRODUCTION DESIGNER: A.MAUSER CHECKED BY:


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DATA DEVICE PLAN


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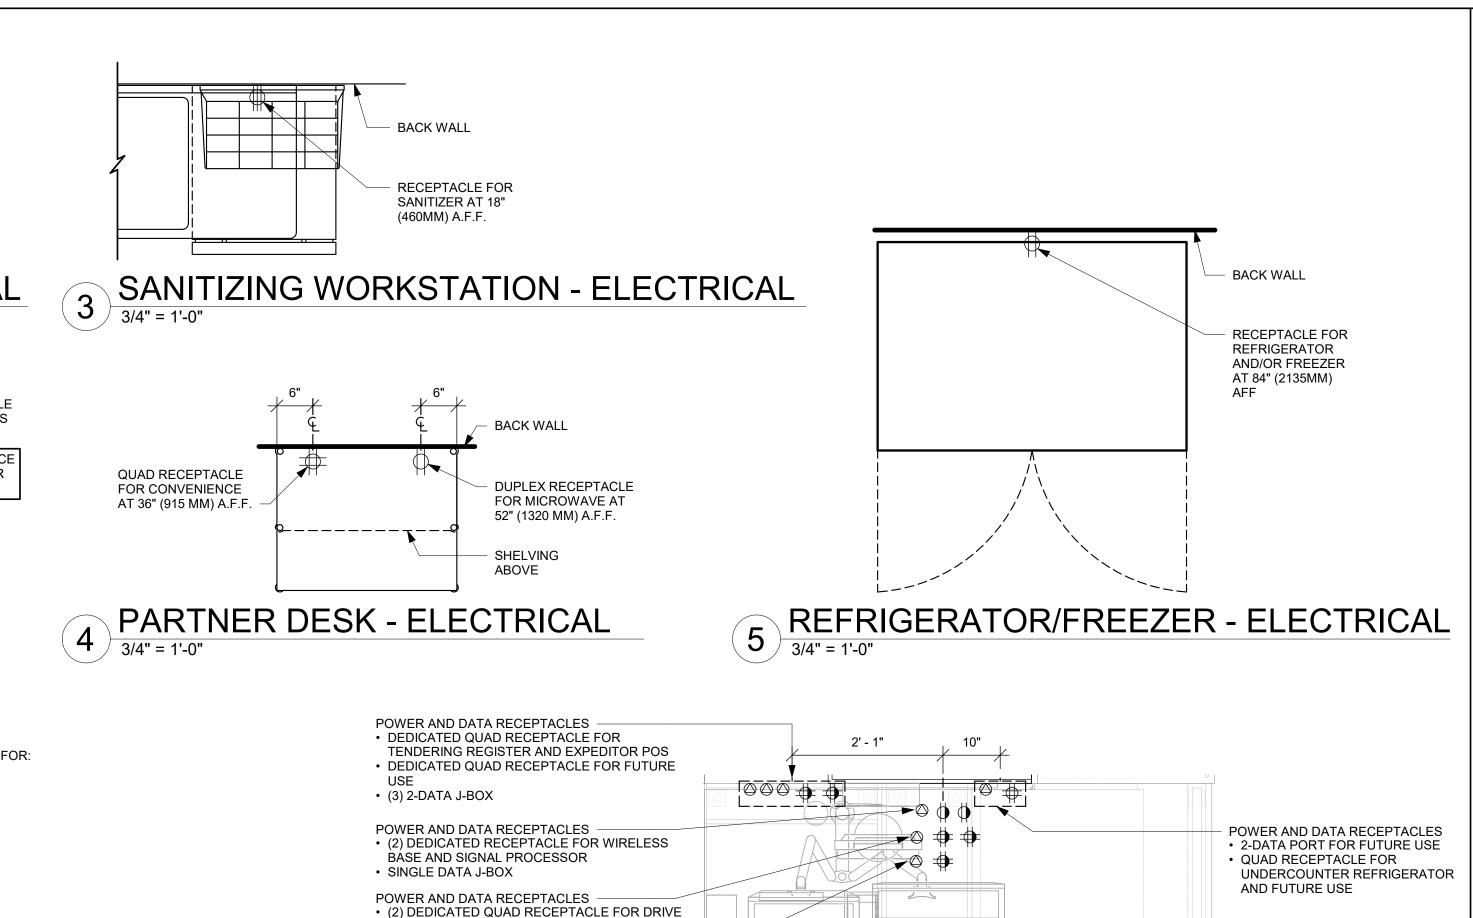
SHEET NUMBER:

E104



DATA DEVICE PLAN 1) 1/4" = 1'-0"

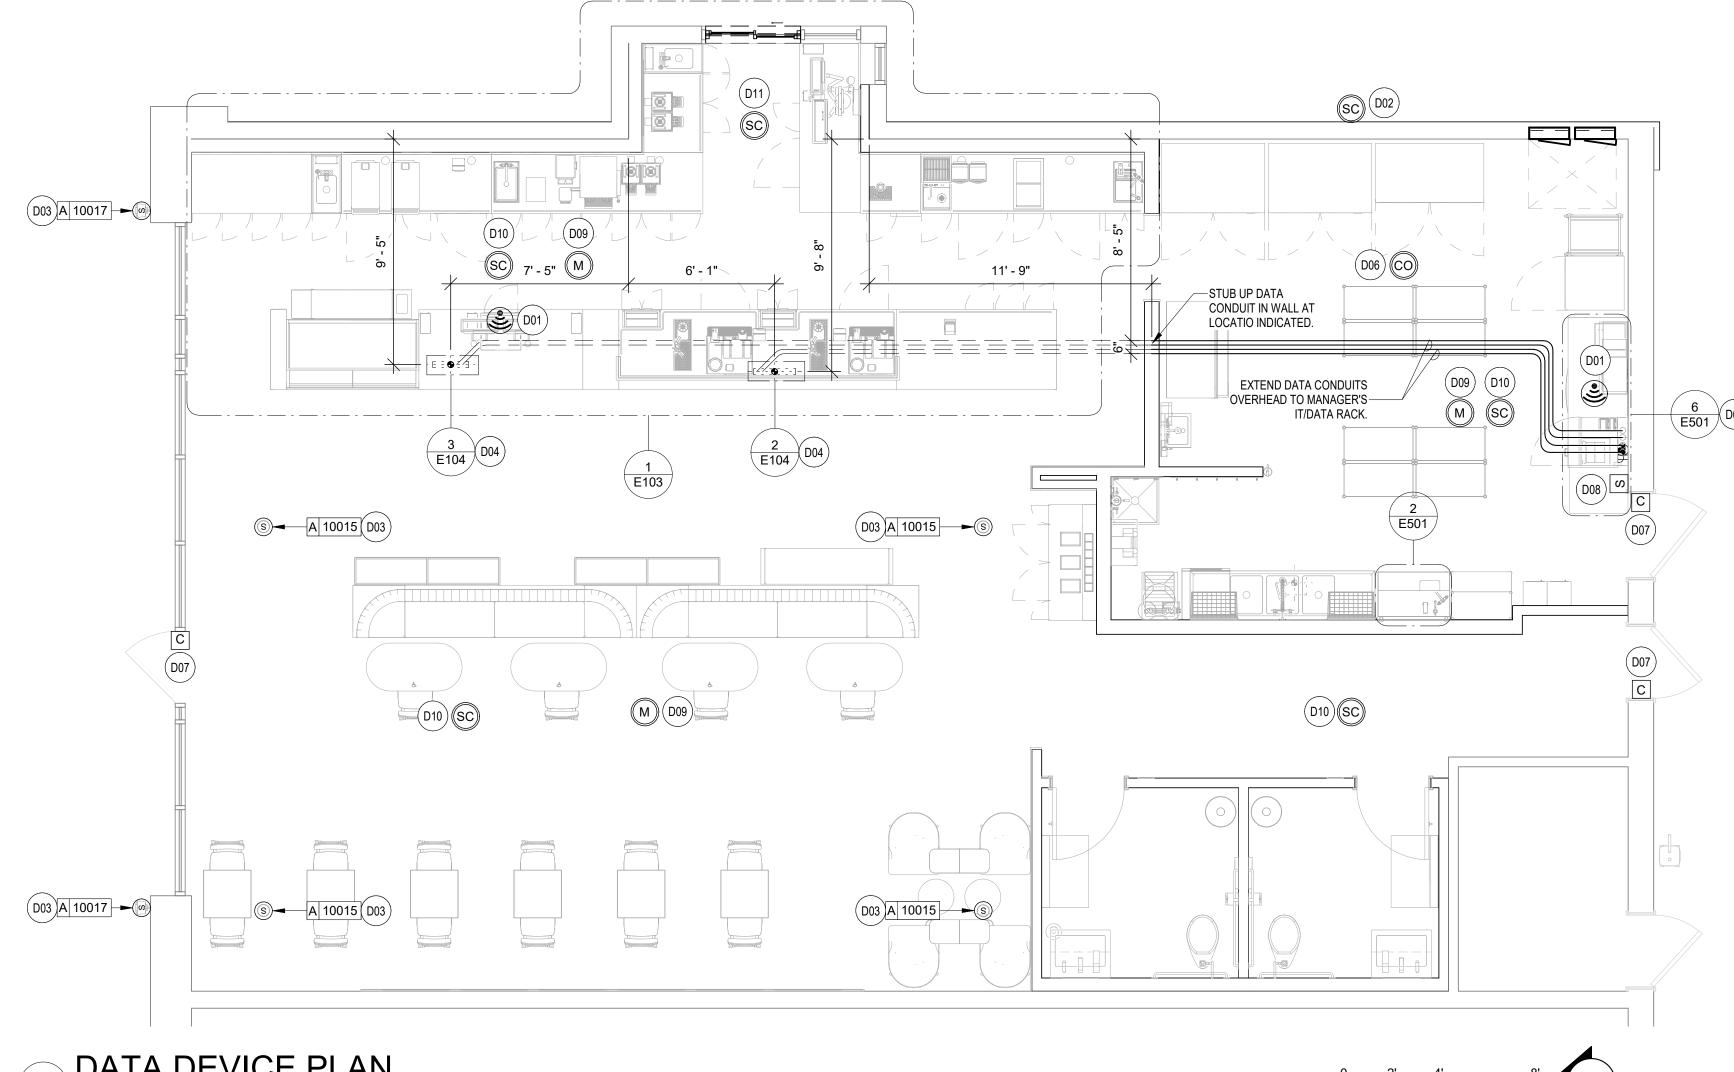

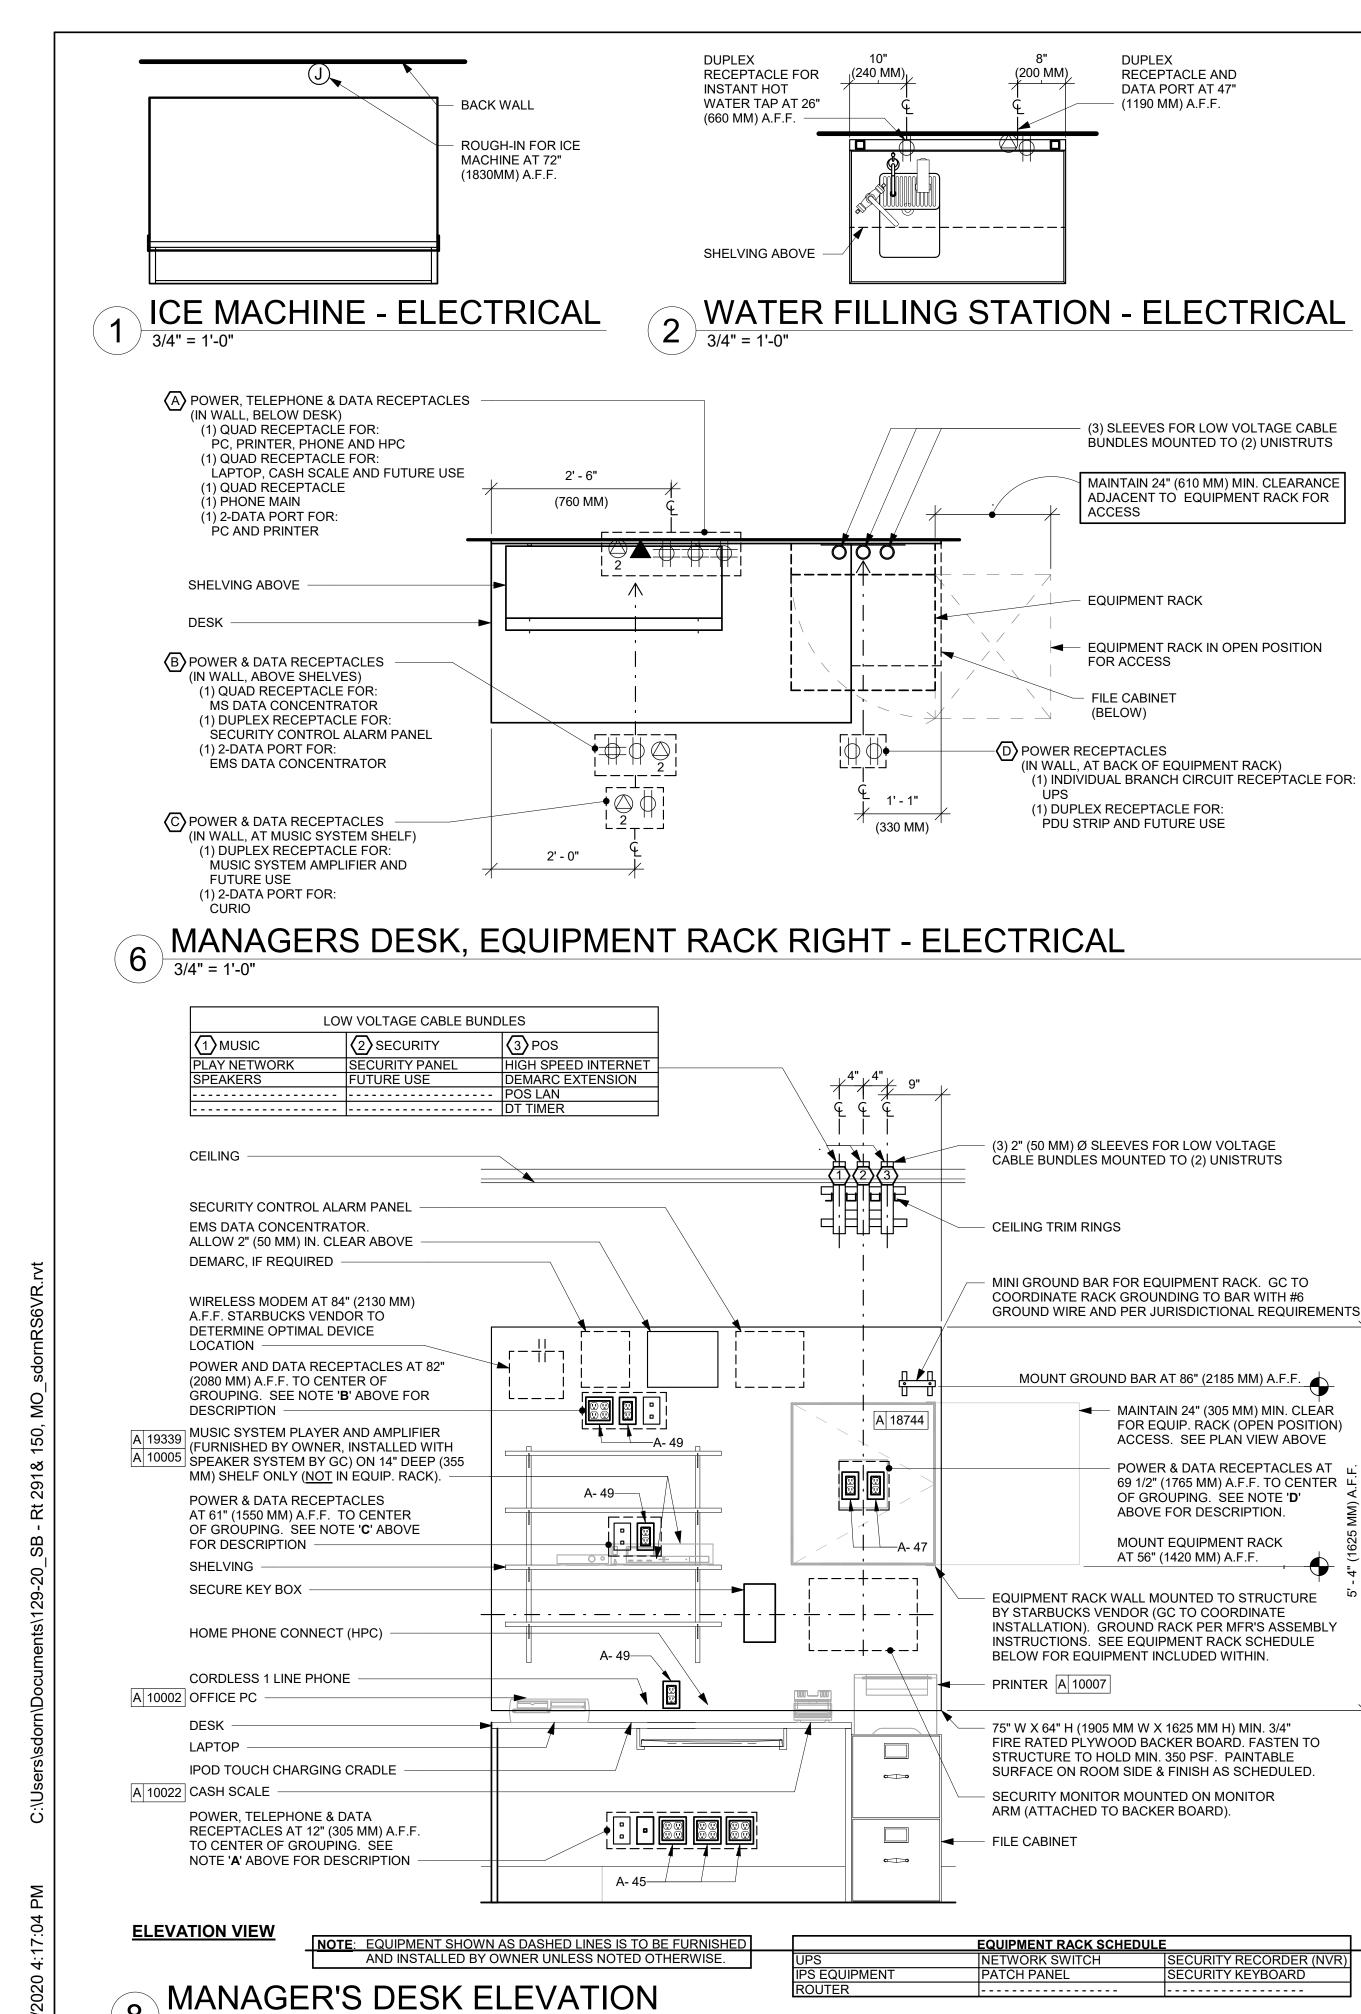

THRU TIMER MONITOR AND CONTROL UNIT


DEDICATED QUAD RECEPTACLE FOR DRIVE

THRU ORDER MONITOR AND BUMP BAR

POWER AND DATA RECEPTACLES

2-DATA J-BOX

SINGLE DATA J-BOX

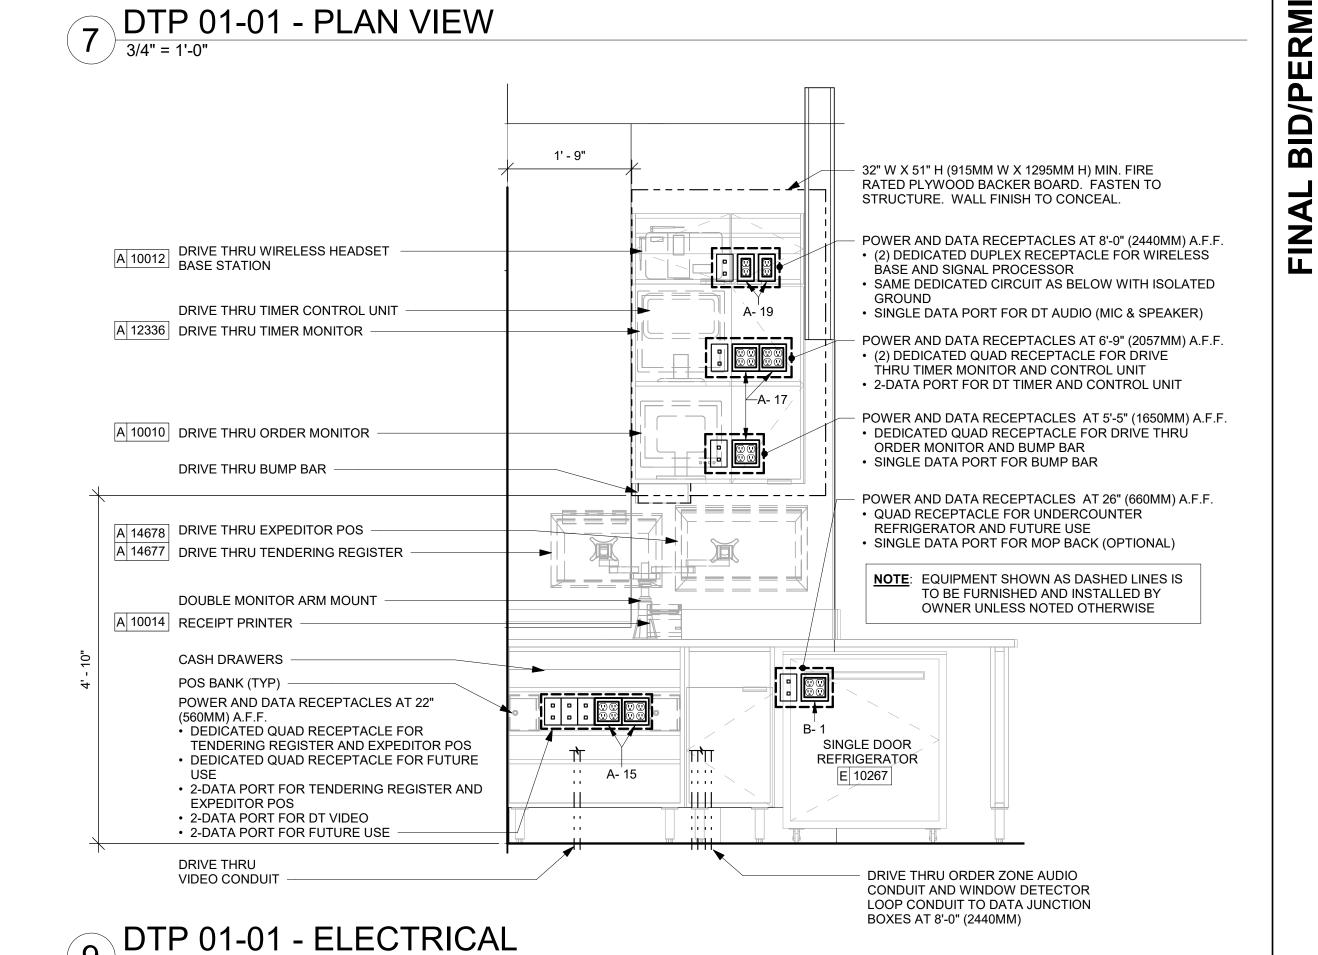



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55 SVEES E M C M 63039 PROJECT #: 88084-001 09-04-2020 SR. DESIGN MANAGER: K. GORIN-SLONSKI PRODUCTION DESIGNER: A.MAUSER

CHECKED BY: Revision Schedule Description

SCALE: AS SHOWN

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STORE #:

ISSUE DATE

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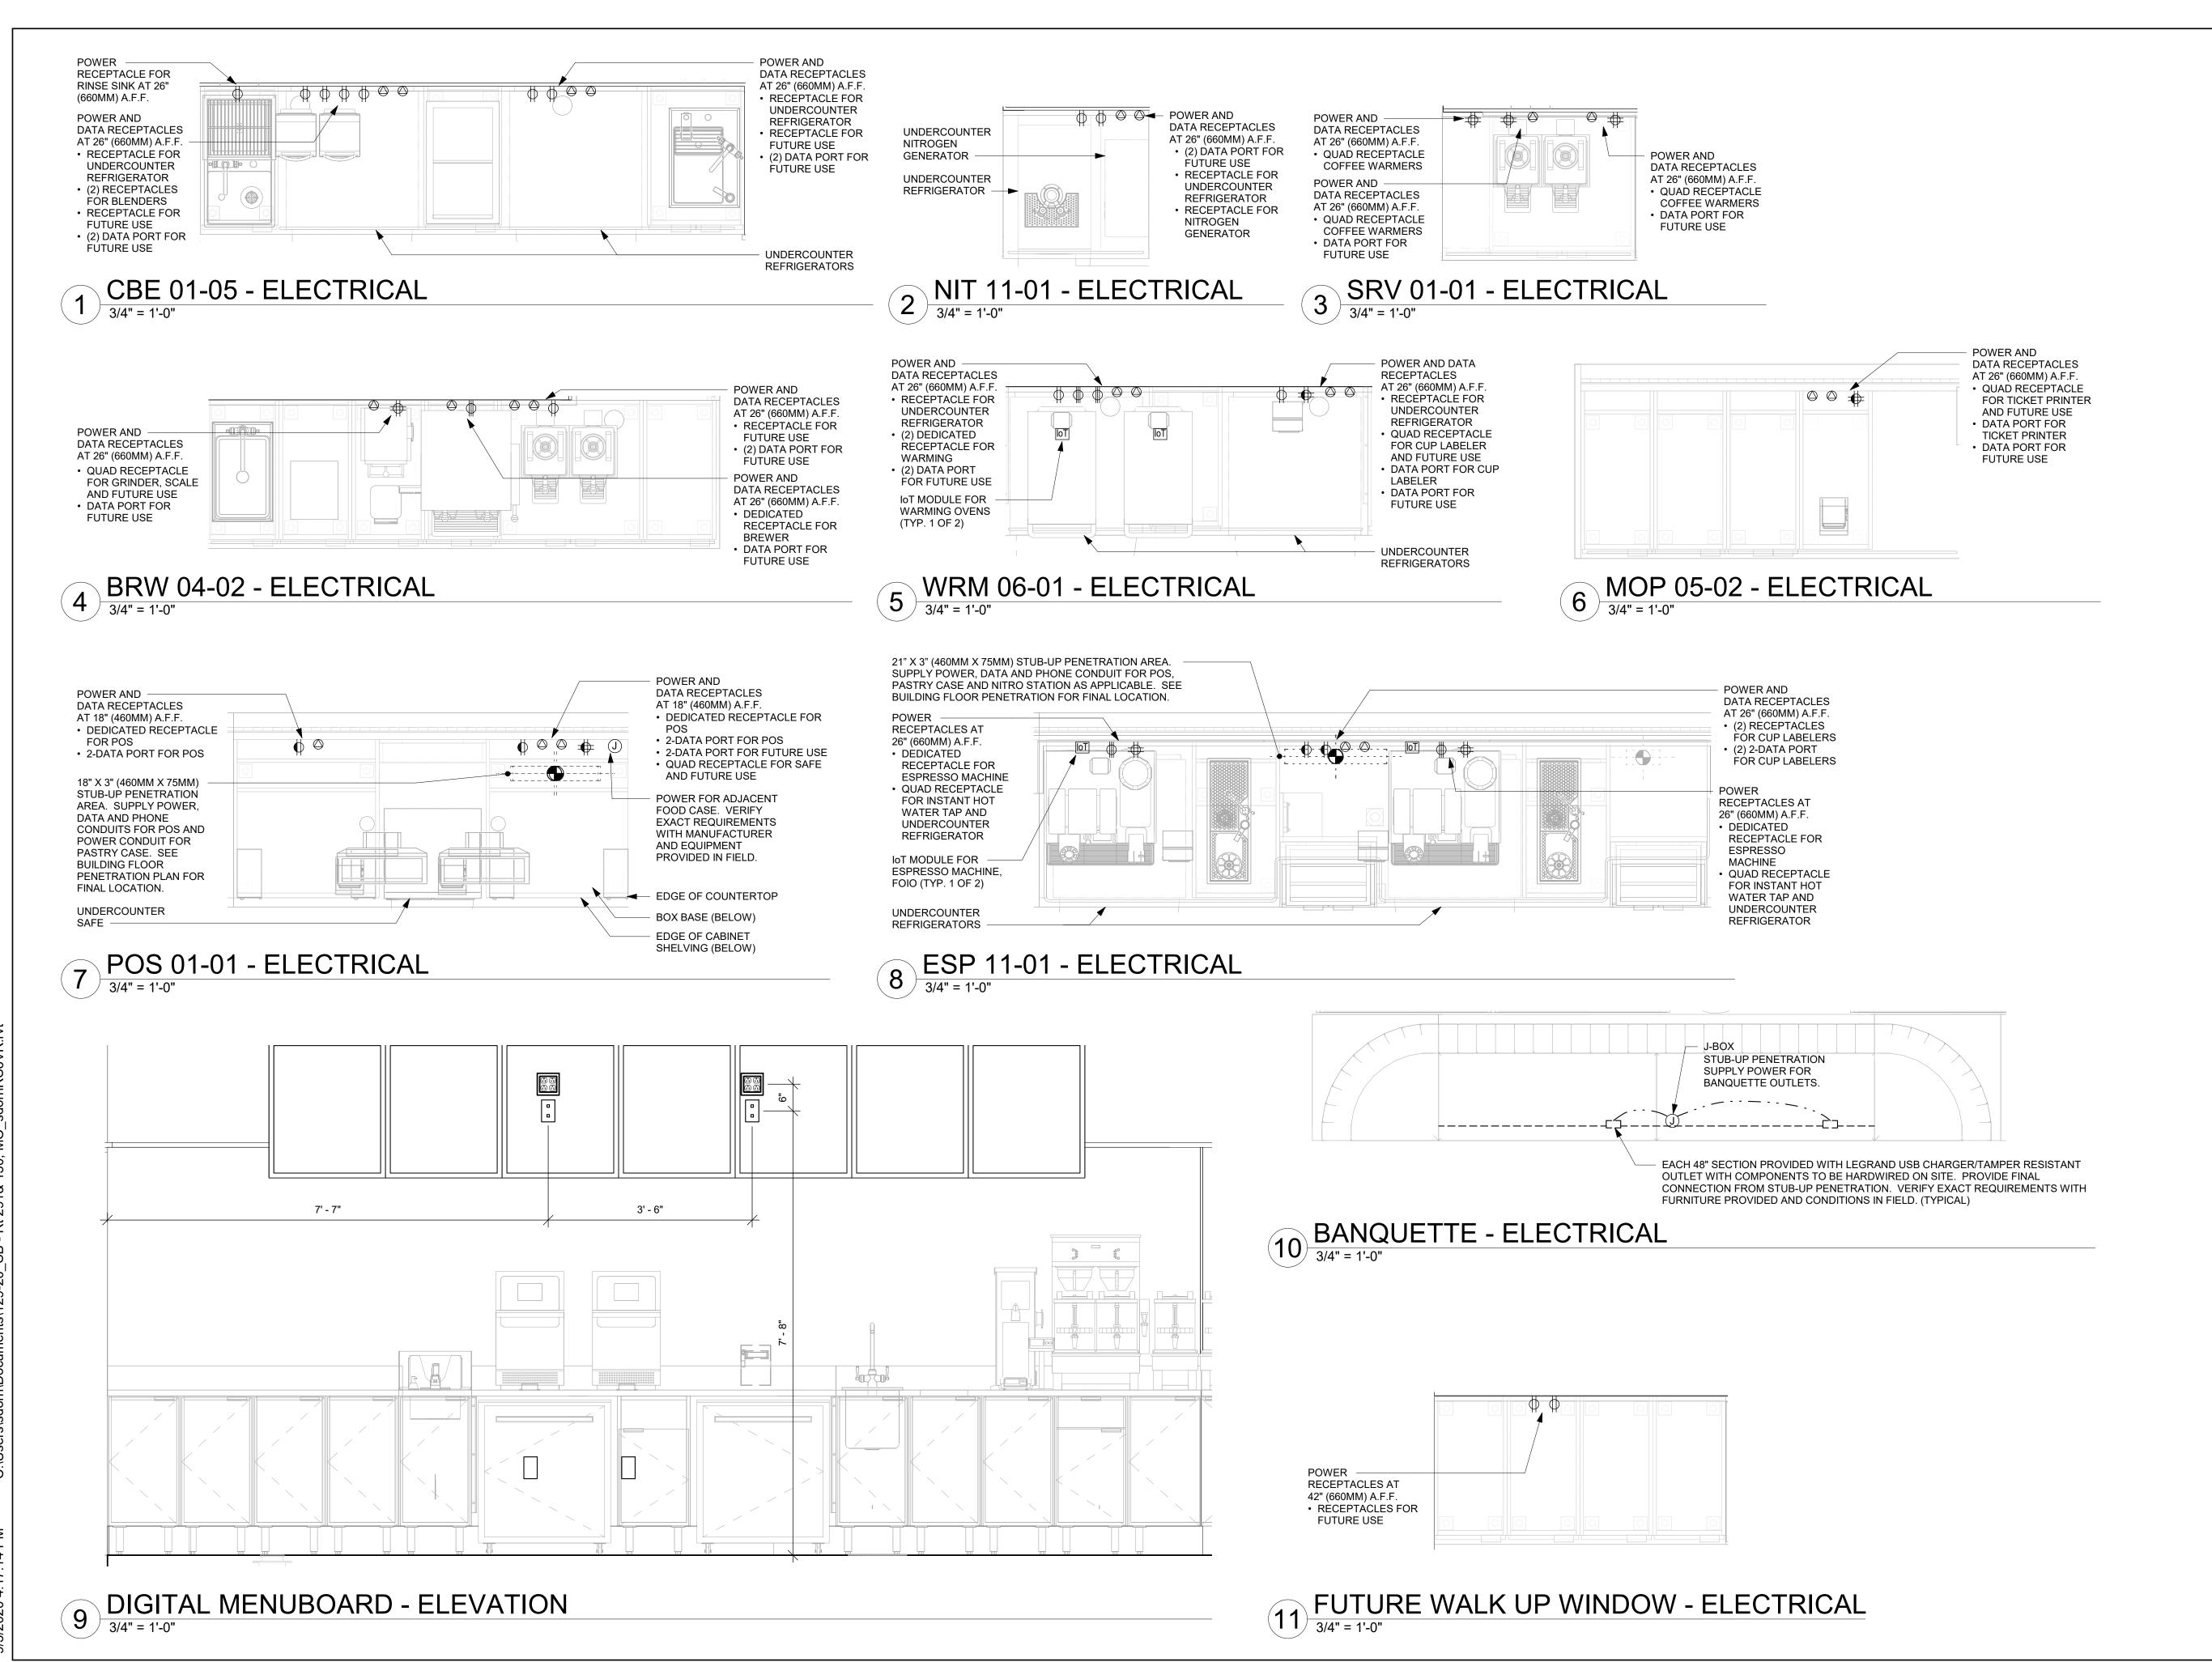
■ EDGE OF COUNTERTOP

JAK/BMS/CJS

ELECTRICAL DETAILS

SHEET NUMBER:

E501



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ECT ADDRESS:
SW M-150 HWY STE. 15
S SUMMIT, MO 64082
KSON COUNTY

PROJECT NAME:

BUILDOUT

COFFEE

RT. 291 & 1

PROJECT ADDRESS:

155 SW M-150

STORE #: 63039
PROJECT #: 88084-001
ISSUE DATE: 09-04-2020
SR. DESIGN MANAGER: K. GORIN-SLONSKI PRODUCTION DESIGNER: A.MAUSER CHECKED BY: JAK/BMS/CJS

Revision Schedu

Rev Date By Description

ELECTRICAL DETAILS

SCALE: AS SHOWN

SHEET NUMBER:

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	СКТ	Schedule Circuit Notes	Trip	Poles		A	ı	В		С	Poles	Trip	Schedule Circuit Notes	СКТ	
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E	9	D/T HEATED AIR CURTAIN	40 A	2			3328 VA	528 VA			1	20 A	EF-1	10	E
E	11	RTU / CONVENIENCE RECEPTACLES	20 A	1					900 VA	766 VA	1	20 A	EXTERIOR LIGHTING	12	E
E	13	PATIO FANS	20 A	1	180 VA	817 VA					1	20 A	BUILDING SIGNAGE	14	
(15	DT EQUIPMENT	20 A	1			720 VA	120 VA			1	20 A	TIMECLOCK	16	
C	17	DT EQUIPMENT	20 A	1					1080 VA	360 VA	1	20 A	DT MENU/PRE-MENUBOARD/CANOPY LTG	18	
C	19	DT EQUIPMENT	20 A	1	360 VA	100 VA					1	20 A	DT DIRECTIONAL SIGN	20	
	21	ESPRESSO MACHINE	40 A	2			2901 VA	500 VA			1	20 A	PYLON/MONUMENT SIGN	22	
Ĺ	23	EGI REGGO WAGINAL	407						2901 VA	1020 VA	1	20 A	DT ORDER SCREEN/CONTROL BOX	24	
	25	ESPRESSO MACHINE	40 A	2	2901 VA						1	20 A	SPARE	26	G
Ĺ	27	EGI REGGO WAGINAL	40 /				2901 VA	0 VA			1	20 A	SPARE	28	G
C	29	U.C. REFRIG./INSTA-HOT TAP	20 A	1					1836 VA	0 VA	1	20 A	SPARE	30	G
C	31	U.C. REFRIG./INSTA-HOT TAP	20 A	1	1836 VA	2995 VA					2	30 A	TURBO CHEF	32	G
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	37	SAFE	20 A	1	360 VA	2995 VA					_			38	Ļ
(39	POS REGISTER	20 A	1			229 VA	4170 VA			2	50 A	DIGITAL BREWER	40	۔ ا
C	41	POS REGISTER	20 A	1					229 VA	4170 VA		0071		42	Ľ
C	43	CUP LABELERS/POS PRINTER	20 A	1	960 VA	1660 VA					1	20 A	DIGITAL SCALE/COFFEE GRINDER	44	G
C	45	MANAGER'S DESK EQUIPMENT	20 A	1			1080 VA	1080 VA			1	20 A	COFFEE WARMERS/FUTURE	46	G
C	47	MANAGER'S DESK EQUIPMENT	20 A	1					360 VA	960 VA	1	20 A	U.C. REFRIGERATORS	48	G
C		MANAGER'S DESK EQUIPMENT	20 A	1	900 VA	900 VA					1	20 A	CONV. RECEPTACLES	50	G
C		SPARE	20 A	1			0 VA	0 VA			1	20 A	SPARE	52	G
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	57	SURGE PROTECTION	40 A	3			0 VA	0 VA						58	

Legend:

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G = GFI - FURNISH AND INSTALL GFI BREAKERS AND DEDICATED NEUTRALS FOR THESE CIRCUITS TO PREVENT FALSE TRIPPING. EQUIPMENT AIC RATINGS SHALL EXCEED THE AVAILABLE FAULT CURRENT. CONTRACTOR SHALL VERIFY AVAILABLE FAULT CURRENT WITH UTILITY PRIOR TO CONSTRUCTION. SYSTEM SHALL BE SERIES RATED IF NECESSARY TO LIMIT SHORT CIRCUIT CURRENT TO BELOW 22,000 AIC (FOR GFI BREAKERS). COORDINATE WITH LANDLORD. E = EXISTING BY LANDLORD

43293 VA

Load Classification	Connected Load	Demand Factor	Estimated Demand	Panel	Totals
HVAC	34753 VA	100.00%	34753 VA		
Kitchen Equipment - Non-Dwelling Unit	63831 VA	65.00%	41490 VA	Total Conn. Load:	128117 VA
Lighting - General	2029 VA	125.00%	2537 VA	Total Est. Demand:	99894 VA
Other	586 VA	100.00%	586 VA	Total Conn.:	356 A
Power - General	2700 VA	100.00%	2700 VA	Total Est. Demand:	277 A
Receptacle	23258 VA	71.50%	16629 VA		
Lighting	959 VA	125.00%	1199 VA		

		MECHANICAL E	QUIPMENT S	SCHEDULE	- "M"
DESIGN ID	COUNT	DESCRIPTION	FURN. BY	INST. BY	COMMENTS
FAN					
10894	1	FAN - DT AIR CURTAIN WITH HEATER - 48IN 1220MM	LL	LL	READY ACCESS AIR AA300 PASS-THRU AIR CURTAIN. CONTACT: ANNA ELLIS ANNA@READY-ACCESS.COM
X0003	1	FAN - WALL MOUNTED FAN - PATIO	GC	GC	GLOBAL INDUSTRIAL 30IN OSCILLATING WALL MOUNTED FAN. ITEM #T9F292451. GC TO PROVIDE MOUNTING PARTS AS NEEDED. LL TO PROVIDE POWER.
HVAC				•	
10317	17	HVAC - VAV SUPPLY 4 WAY SQUARE - 24IN 610MM	GC	GC	SEE MECHANICAL SCHEDULES. FACTORY PAINT TO MATCH ASSOCIATED CEILING COLOR.
11108	3	HVAC - SUPPLY 4 WAY LAY IN SQUARE - 12IN 305MM	GC	GC	SEE MECHANICAL SCHEDULES. FACTORY PAINT TO MATCH ASSOCIATED CEILING COLOR.
11163	2	HVAC - RETURN LAY IN SQUARE - 24IN 610MM	GC	GC	SEE MECHANICAL SCHEDULES. FACTORY PAINT TO MATCH ASSOCIATED CEILING COLOR.
11165	2	HVAC - RETURN CHANNEL FRAME SQUARE - 10IN 255MM	GC	GC	SEE MECHANICAL SCHEDULES. FACTORY PAINT TO MATCH ASSOCIATED CEILING COLOR.
OTHER				•	
17797	1	ENERGY MANAGEMENT SYSTEM - HVAC ONLY	SB	GC	
X0028	2	ACCESS PANEL	GC	GC	BAUCO PLUS II. MODEL #20-58-2424

Total Load: 45155 VA

Panel: B

60

59 --

Legend:

Mounting: Recessed Volts: 120/208 Wye Enclosure: Type 1 AIC Rating: 200k

Phases: 3 Wires: 4 Responsibility: LANDLORD

	СКТ	Schedule Circuit Notes	Trip	Poles	<i>A</i>	\	E	3	(Poles	Trip	Schedule Circuit Notes	СКТ	
G	1	U.C. REFRIGERATORS	20 A	1	1440 VA	1811 VA					1	20 A	CAFE/BACKBAR LIGHTING	2	G
G	3	BLENDER	20 A	1			1200 VA	360 VA			1	20 A	WORK/RESTROOM LIGHTING	4	G
G	5	BLENDER	20 A	1					1200 VA	720 VA	1	20 A	DIGITAL MENUBOARDS	6	G
G	7	NITRO GENERATOR/U.C. REFRIGERATOR	20 A	1	1020 VA	0 VA					1	20 A	SPARE	8	G
G	9	PITCHER RINSER	20 A	1			120 VA	0 VA			1	20 A	SPARE	10	G
	11	ICE MACHINE	20.4	2					1799 VA	0 VA	1	20 A	SPARE	12	G
Ī	13	TICE MACHINE	30 A	2	1799 VA	1080 VA					1	20 A	CONV. RECEPTACLES	14	G
G	15	WAREWASHER	40 A	2			3172 VA	1260 VA			1	20 A	CONV. RECEPTACLES	16	G
G	17	WAREWASHER	40 A						3172 VA	540 VA	1	20 A	SHOW WINDOW RECEPTACLES	18	G
G	19	REACH-IN REFRIGERATORS	20 A	1	1344 VA	720 VA					1	20 A	BANQUETTE RECEPTACLES	20	G
G	21	REACH-IN FREEZER	20 A	1			1152 VA	0 VA			1	20 A	SPARE	22	G
G	23	REACH-IN FREEZER	20 A	1					864 VA	0 VA	1	20 A	SPARE	24	G
G	25	INSTA-HOT TAP	20 A	1	1301 VA	0 VA					1	20 A	SPARE	26	G
G	27	PARTNERS DESK RECEPTACLES	20 A	1			1560 VA	0 VA			1	20 A	SPARE	28	G
G	29	WATER HEATER	20 A	1					600 VA	0 VA	1	20 A	SPARE	30	G
G	31	WATER FILTRATION SYSTEM	20 A	1	900 VA	0 VA					1	20 A	SPARE	32	G
G	33	BOOSTER/RECIRCULATION PUMP	20 A	1			360 VA	0 VA			1	20 A	SPARE	34	G
G	35	CONV. RECEPTACLES	20 A	1					360 VA	0 VA	1	20 A	SPARE	36	G
G	37	HAND DRYER	20 A	1	1440 VA	0 VA					1	20 A	SPARE	38	G
G	39	HAND DRYER	20 A	1			1440 VA	0 VA			1	20 A	SPARE	40	G
G	41	SOAP DISPENSERS/FAUCET SENSORS	20 A	1					720 VA	0 VA				42	
	43				0 VA	0 VA								44	
	45						0 VA	0 VA						46	
	47								0 VA	0 VA				48	
	49				0 VA	0 VA								50	
	51						0 VA	0 VA						52	
	53								0 VA	0 VA				54	П
	55				0 VA	0 VA								56	
	57						0 VA	0 VA						58	

Total Amps:	108 A

Total Load: 12855 VA

G = GFI - FURNISH AND INSTALL GFI BREAKERS AND DEDICATED NEUTRALS FOR THESE CIRCUITS TO PREVENT FALSE TRIPPING. EQUIPMENT AIC RATINGS SHALL EXCEED THE AVAILABLE FAULT CURRENT. CONTRACTOR SHALL VERIFY AVAILABLE FAULT CURRENT WITH UTILITY PRIOR TO CONSTRUCTION. SYSTEM SHALL BE SERIES RATED IF NECESSARY TO LIMIT SHORT CIRCUIT CURRENT TO BELOW 22,000 AIC (FOR GFI BREAKERS). COORDINATE WITH LANDLORD.

10624 VA

89 A

0 VA 0 VA

9975 VA

83 A

LANDLORD HOUSE

PANEL

100A

DISC.

SWITCH

(BY LL)

(BY LL)

C/T &

METER

_3@[3-1/2"C-400 MCM

400A

DISC.

SWITCH

(BY LL)

(BY LL)

`C/T &

METER

WIREWAY (BY LL)

#3/0 G

BY LL)

Load Classification	Connected Load	Demand Factor	Estimated Demand	Panel	Totals
Kitchen Equipment - Non-Dwelling Unit	17543 VA	65.00%	11403 VA		
Lighting - General	1212 VA	125.00%	1515 VA	Total Conn. Load:	33454 VA
Receptacle	13740 VA	86.39%	11870 VA	Total Est. Demand:	25987 VA
Lighting	959 VA	125.00%	1199 VA	Total Conn.:	93 A
				Total Est. Demand:	72 A

	WIRE SIZING	G SCHEDUL	E
BREAKER	WIRE SIZE	GROUND	CONDUIT
20A-1P	(2) #12	#12	3/4"
20A-2P	(3) #12	#12	3/4"
20A-3P	(4) #12	#12	3/4"
30A-1P	(2) #10	#10	3/4"
30A-2P	(3) #10	#10	3/4"
30A-3P	(4) #10	#10	3/4"
40A-2P	(3) #8	#10	3/4"
40A-3P	(4) #8	#10	1"
50A-2P	(3) #6	#10	1"
50A-3P	(4) #6	#10	1"
60A-2P	(3) #4	#10	1"
60A-3P	(4) #4	#10	1-1/4"
70A-3P	(4) #4	#8	1-1/4"
80A-3P	(4) #3	#8	1-1/4"
90A-3P	(4) #2	#8	1-1/4"
100A-3P	(4) #2	#8	1-1/4"
125A-3P	(4) #1	#6	1-1/2"
150A-3P	(4) #1/o	#6	2"

200A-3P (4) #3/o | #6 2"

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—CONTRACTOR TO PROVIDE AND INSTALL SURGE

PANEL A

ASCO SURGE 1

PROTECTOR

MODEL: 430 (BY CONTRACTOR)

PANELBOARD AND CONNECT USING THE SHORTEST RUN OF FEEDERS POSSIBLE.

(BY LANDLORD) | (BY LANDLORD)

_2@[2-1/2"C-4#3/0, 1#1/0(G) & 1#1/0(IG)]

(BY LANDLORD)

PANEL B

-LANDLORD TO

PROVIDE FEED THRU-

LUG KIT AS REQUIRED.

BY CONTRACTOR

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Engineering Consultant

Fax (314) 373-3514

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STORE #: PROJECT #: ISSUE DATE:

88084-001 09-04-2020 SR. DESIGN MANAGER: K. GORIN-SLONSKI PRODUCTION DESIGNER: A.MAUSER CHECKED BY: JAK/BMS/CJS

Revision Schedule

Rev Date By Description

SCALE: AS SHOWN

E601

PANEL SCHEDULES

SHEET NUMBER:

(BY LANDLORD) ONE-LINE DIAGRAM

UTILITY COMPANY TRANSFORMER (BY UTILITY COMPANY)

> ONE-LINE NOTES:
> LANDLORD TO PROVIDE NEW 400A, 120/208V-3PH ELECTRICAL SERVICE TO SPACE INCLUDING INSTALLATION OF ANY REQUIRED CT'S AND METERING AND DISCONNECT CONTROL OF THE CONTROL OF T IN SPACE. LANDLORD SHALL ALSO PROVIDE, INSTALL AND CONNECT ELECTRICAL SERVICE TO, TWO (2) 400 AMP RATED ELECTRICAL PANELS WITH FEED-THRU LUG KIT.

ADJACENT

TENANT

400A

DISC.

SWITCH

(BY LL)

(BY LL)

C/T &

METER

MCB Rating: 400A MLO Mains Type: CU

Mains Rating: 400 A

WIRE AND CONDUIT SIZES SHOWN ARE FOR COPPER CONDUCTORS WITH 75°C RATED INSULATION. LANDLORD CONTRACTOR TO PROVIDE PROPERLY SIZED CONDUIT & WIRE TO COMPENSATE FOR ALUMINUM FEEDERS OR VOLTAGE DROP AS REQUIRED.

CONTRACTOR IS RESPONSIBLE FOR, BUT NOT LIMITED TO, ALL WORK DOWNSTREAM OF LANDLORD PROVIDED ELECTRICAL PANEL.

ALL WORK SHALL BE IN ACCORDANCE WITH UTILITY COMPANY REQUIREMENTS AND LOCAL CODE. CONTRACTOR BID SHALL INCLUDE ALL WORK NECESSARY FOR A FULLY OPERATIONAL SYSTEM.

LANDLORD SHALL CONTACT THE ELECTRIC UTILITY CO. TO VERIFY ALL DETAILS OF NEW SERVICE IF EXISTING BUILDING ELECTRICAL SERVICE IS NOT ADEQUATE AND IS RESPONSIBLE FOR ANY FEES.

CONTRACTOR IS RESPONSIBLE FOR A COMPLETE AND OPERATIONAL SYSTEM IN COMPLIANCE WITH NEC AND ALL STATE AND LOCAL CODES.

	PLUMBING FIXTURE SCI	HEDULE - "P"				LIGHTING	G FIXTURE SC	HEDULE - "L"			SPECIALTY EQUIPMENT SCH	IEDULE - "E"		
DESIGN ID COUN	T DESCRIPTION I	FURN. BY INST. B	COMMENTS	DESIGN ID	COUNT	DESCRIPTION FURN	N. BY INST. B	Y BULB	COMMENTS	DESIGN ID COU	NT DESCRIPTION FURN.	BY INST. BY	Y COMMENTS	
10294 7	DRAIN - FLOOR SINK SQUARE - 12IN 305MM	SB GC	ZURN MODEL #FD2375-NH3.	X0041		1A (120W), 120V CURRENT LIMITING SB	GC			COOLING 10267 5	FRIDGE UNDERCOUNTER 1 DOOR - 27IN SB	GC		
10594 4	DRAIN - FLOOR SINK SQUARE - 5IN 125MM	GC GC	JAY R. SMITH MODEL #2005Y (B) OR EQUAL	X0043		DEVICE, WH 3A (360W), 120V CURRENT LIMITING SB	GC			11083 2	685MM FRIDGE REACH IN 2 DOOR - 51X35IN SB	GC		
10726 7	DRAIN - GRATE HALF SQUARE - 12IN 305MM	SB GC	ZURN MODEL #FD2375-NH3-H.	EXIT		DEVICE, WH					1295X890MM			
FAUCET 10152 1	FAUCET - DOUBLE LABORATORY WITH BENT S	SB GC		11483		EXIT - SECURITY LIGHT WALL LL	LL	HID 150W OR EQUAL	LITHONIA LIGHTING. TWP 150S TB OR	12618 2	FRIDGE UNDERCOUNTER 1 DOOR WITH SB SHELF - 27IN 685MM			
10153 2	RISER SPOUT FAUCET - WATER TOWER - 12IN 305MM S	SB GC		19044		MOUNTED LED EXIT SIGN WITH EMERGENCY SB	GC	INTEGRATED LED	APPROVED EQUAL	13676 1 13682 1	FREEZER REACH IN 1 DOOR RH - 27IN 685MM SB FREEZER REACH IN 2 DOOR - 54IN 1370MM SB	GC GC		
10215 3	FAUCET - DOUBLE LABORATORY WITH SWING S	SB GC				LIGHT - WHITE AND RED				20010 1	FRIDGE NITRO 2 TAP JT NITCOM LH SB	GC	KIT INCLUDES UNDERCOUNTER FRIDGE, FONT, TRAY, AND TUBING	
10447 1	SPOUT FAUCET - PRE RINSE SPRAYER WALL MOUNTED S	BB GC		19049		LED EXIT SIGN RECESSED - WHITE SB AND RED	GC	INTEGRATED LED		EQUIPMENT			FONT, TRAY, AND TUBING	
10597 2	FAUCET - SINGLE HANDLE S	SB GC		19056	4	LED EMERGENCY LIGHT DOUBLE - SB WHITE	GC	INTEGRATED LED		10312 4	BREWER SOFT HEAT WARMING STAND SB	GC		
10804 1 10874 1	FAUCET - PRE RINSE SWING SPOUT S FAUCET - HOT WATER SYSTEM GOOSENECK S	SB GC SB GC		OTHER			00	INITEODATED LED	INOTALL VIA LICOVO POWED DV	10746 1	BREWER DUAL SOFT HEAT SB	GC	GC TO COORDINATE WITH SBUX VENDOR.	
10922 1	FAUCET - MOP SINK WALL MOUNTED S FAUCET - METERED S	SB GC		17796	5	STRING LIGHTS SB	GC	INTEGRATED LED	INSTALL VIA HOOKS. POWER BY LANDLORD. THREE RUNS OF LIGHTS,	10808 1 10856 6	GRINDER DITTING KR1203 SB BREWER SERVER SOFT HEAT SB	GC GC	GC TO COORDINATE WITH SBUX VENDOR.	
11003 3 13588 1	FAUCET - METERED S FAUCET - HAND SINK WALL MOUNTED S	BB GC							TOTAL LENGTH REQUIRED: 77'-1".GC TO PROVIDE AIRLINE CABLE AND HOOKS	12508 2	BLENDER QUIET MODEL ON COUNTER SB	GC		╠
15749 2 X0009 2	FAUCET - HOT AND COLD WATER SYSTEM S FAUCET - STERN G	SB GC	STERN. CONDOR 1010. PART #07100005.	RECESSED	CAN				AS NEEDED FOR MOUNTING.	15186 1 16623 1	DISHWASHER HOT LOW STEAM SB SCALE DIGITAL WITH ADJUSTABLE DISPLAY SB	GC GC		
70009 2	FAUCET - STERIN	GC GC	CHROME. PART OF DI13 INTEGRATED	11174		CAN - ADJUSTABLE RECESSED - 5IN				17564 1	MOUNT SMALL BLENDER PITCHER RINSER WITH SENSOR SB	GC		
			SINK SYSTEM. CONTACT: D 13 GROUP. 245 WEST CENTRAL STREET, NATICK, MA	19023	30	125MM - BLACK CAN - LED MOUNTING FRAME - 2IN SB	GC			19559 1	NITROGEN GENERATOR ELEMENT SB	GC	GC TO COORDINATE INSTALLATION &	
			01760. PH: 617-307-1140. WWW.D13GROUP.COM EMAIL:	19113		50MM - NEW CEILING CAN - LED ADJUSTABLE GIMBAL SB	GC			19742 2	ESPRESSO MACHINE MASTRENA II SB	GC	GC TO COORDINATE WITH SBUX VENDOR.	
FILTER			KRIZZO@D13GROUP.COM	19113		WITH DRIVER - 2IN 50MM - WHITE -	GC			20032 2	OVEN EIKON E2S - BLACK SB	GC		
12501 1	FILTER - RO SYSTEM 600GPD	SB GC	CONFIGURATION 3. GC TO COORDINATE	19120		CAN - LED DOWNLIGHT REFLECTOR SB	GC			FOOD CASE 16238 1	FOOD CASE - ZEPHYR - 66IN 1675MM SB	GC		I
12507 1	FILTER - RO SYSTEM 40GAL STORAGE TANK S	SB GC	WITH SBUX VENDOR. CONFIGURATION 3. GC TO COORDINATE			WITH DRIVER SQUARE - 2IN 50MM - WHITE - 1000LM FLOOD				ICE	LOS DINI DECONINACION ACIVO			
12896 1	FILTER - BRINE TANK S	SB GC	WITH SBUX VENDOR. CONFIGURATION 3. GC TO COORDINATE	SCONCE				INTEGRATER LER		10344 1 18029 1	ICE - BIN DROP IN 90LB 40KG SB ICE - BIN B110 SB	GC GC		
		GC	WITH SBUX VENDOR.	20711		SCONCE - HINKLEY ATLANTIS LARGE - BLACK	LL	INTEGRATED LED	DOLAN HOSPITALITY MFR #376769 ATLANTIS OUTDOOR SCONCE	18846 1	ICE - MACHINE CIM1446HR SERIES REMOTE SB COOLED	GC		
12899 2	FILTER - POLY GLASS VESSEL S	er GC	CONFIGURATION 3. GC TO COORDINATE WITH SBUX VENDOR.	20741	2	SCONCE - KUZCO VEGA - 23IN SB 585MM - GOLD	GC	INTEGRATED LED		19278 2	ICE - BIN DROP IN 45LB 20KG HORIZONTAL SB	GC		
13076 1	FILTER - PREFILTRATION SYSTEM S	GC GC	CONFIGURATION 3. GC TO COORDINATE WITH SBUX VENDOR.	SIGNAGE - C					00 TO DDO #DE DI 00 ****	OTHER 10091 1	CUP DISPENSER TALL HOT VERTICAL SB	GC		
13082 1	FILTER - WATER SOFTENER TWIN S	SB GC	CONFIGURATION 3. GC TO COORDINATE WITH SBUX VENDOR.	21163		SIGN - MOBILE ORDER PICK UP ILLUMINATED BLADE MOUNT	GC		GC TO PROVIDE BLOCKING AND ELECTRICAL IN SOFFIT AS REQUIRED	10099 2	RESTROOM TOILET PAPER HOLDER SB	GC		-
13149 1	FILTER - PRESSURE GAUGE S	SB GC	CONFIGURATION 3. GC TO COORDINATE	X0016	1	SIGN - MOP SIGN - 4FT EXTENSION SB LEGS	GC		TO BE CUT IN FIELD. ORDER WITH MOP SIGN DID 21163. VENDOR: WALTON.	10172 2 10384 2	RESTROOM SEAT COVER DISPENSER SB DIAPER CHANGING STATION HORIZONTAL SB	GC GC		
OTHER			WITH SBUX VENDOR.	STRIP						10396 1	CUP DISPENSER SHORT HOT VERTICAL SB	GC		
13384 1	WATER HEATER TANK GAS G	GC GC	AO SMITH POLARIS HIGH EFFICIENCY	14410		STRIP - LED TAPE - VARIABLE SB LENGTH - 315LM PER FT	GC	INTEGRATED LED	LENGTH: 27'-0". FIELD TRIMMABLE TO 6IN LENGTHS	10467 1 10501 1	FILE CABINET 2 DRAWER SB FIRE EXTINGUISHER GC	GC GC	LOCALLY SOURCED.	, \
			MODEL #BSS 130, 165 GPH RECOVERY @90 DEGREE RISE. SET WATER HEATER	TRACK	4	TRACK WITH CONNECTORS AFT CR	00			10769 2	RESTROOM GRAB BAR VERTICAL - 18IN SB	GC	7	<u> </u> =
SINK			TO 140 DEG MAX ENERGY FACTOR = 0.96	12934		TRACK - WITH CONNECTORS - 4FT 122CM - WHITE - 1 CIRCUIT	GC			10791 2	CUP DISPENSER GRANDE VENTI COLD SB	GC	4	• -
10549 1	SINK - RINSE DROP IN SST - 12X20IN 305X510MM S	SB GC		12945		TRACK - WITH CONNECTORS - 12FT SB 365CM - WHITE - 1 CIRCUIT	GC			10855 2	VERTICAL CUP DISPENSER GRANDE VENTI HOT SB	GC		=
10995 1 12808 1	SINK - MOP - 24X24IN 610X610MM SINK - UTENSIL RINSE WITH GRATE SST - RH - S	SB GC SB GC		19071		TRACK - LED FIXTURE - 2IN 50MM - SB WHITE - 900LM SPOT	GC	INTEGRATED LED		10858 1	VERTICAL CUP DISPENSER TALL COLD VERTICAL SB	GC		
	14X20IN 355X510MM SINK - 3 COMP WORK SST - 93IN 2350MM S	SB GC		19072		TRACK - LED FIXTURE - 2IN 50MM - SB	GC	INTEGRATED LED		10859 2	RESTROOM GRAB BAR - 48IN 1220MM SB	GC		<u> </u>
13264 1 14688 1	SINK - 3 COMP WORK 331 - 93IN 2330MM SINK - HAND WITH SIDE SPLASH WALL MOUNTED S			19074	27	WHITE - 600LM FLOOD TRACK - LED FIXTURE - 2IN 50MM - SB	GC	INTEGRATED LED		10862 2 10947 1	RESTROOM GRAB BAR - 36IN 915MM SB SOAP DISPENSER WALL MOUNTED SB	GC GC		
17565 1	SST SINK - RINSE WITH DRAINBOARD - 15X27IN S	SB GC		19087		WHITE - 900LM FLOOD TRACK - HEX CELL LOUVER - 2IN SB	GC			10977 1	PAPER TOWEL DISPENSER FULL SIZE - SB	GC		<u>•</u>
	380X685MM				40	50MM	GC			10992 2	TRANSLUCENT GRAY PAPER TOWEL DISPENSER HALF SIZE - SB	GC	S Market Control of the Control of t	!
17632 1 18743 1	SINK - STACKED DRAINBOARD - 15IN 380MM SINK - WATER FILLING STATION - 36X24IN S	SB GC SB GC		TROFFER 15057	8	TROFFER - LED RECESSED - SB	GC	INTEGRATED LED		11115 2	TRANSLUCENT GRAY SOAP DISPENSER SINK MOUNTED SB	GC		'
19277 2	915X610MM SINK - COUNTERTOP RINSER WITH DRAIN S	SB GC				24X48IN 600X1200MM - WHITE - 4000LM				13330 1	MOBILE CUP DISPENSER CADDY SB	GC		<u>.</u>
	TROUGH - 26X9IN 660X235MM	00				TOOLIVI				13584 1 19495 1	CUP DISPENSER TRENTA COLD VERTICAL SB NITRO 2 TAP HANDLE AND BADGE KIT SB	GC GC	19495 RETIRED; ORDER FOUR SKU #'S:	<u>.</u>
X0008 2	SINK - D13	GC GC	D 13 INTEGRATED SINK SYSTEM. 30IN XLERATORSYNC SYSTEM WITH A SINGLE			S	SITE SCHEDULI	Ē - "Y"					011095591, 011095592, 011095587, 011095588.	┇╎┝
			BASIN SINK WITH A PIVOT DRAIN COVER. GLACIER WHITE CORIAN COUNTER TOP	DESIGN ID EXTERIOR M		DESCRIPTION FURN.	. BY INST. BY	, l	COMMENTS	20079 1 20080 1	NITRO 2 TAP BADGE MOUNT BACKBAR LH SB NITRO 2 TAP BADGE MOUNT BACKBAR RH SB	GC GC		<i>I</i>
			AND ENCLOSURE PANELS. BASIN COLOR: D 13 WHITE. ORDER WITH LOCKING	14116	1	MENU BOARD - DT DIGITAL ORDER SB	SB/GC	SUPPLIER: IT EQUIPMEN	NT VENDOR (ZONES). SCREEN INSTALLER:	X0010 2	SOAP DISPENSER - STERN GC	GC	STERN. GREEN/CHROME SOAP DISPENSER. PART #07100008. PART OF DI13 INTEGRATED	<u>: </u>
			SLIDING DOOR & SECURITY PANEL. CONTACT: D 13 GROUP. 245 WEST			SCREEN - FLAT BLACK MT0028		WHIPS & STUB-UPS TO	NDOR. ELECTRICAL: GC CONNECTS DOS DCB.				SINK SYSTEM. CONTACT: DJ13 GROUP. 245 WEST CENTRAL STREET, NATICK, MA 01760.	<u> </u>
			CENTRAL STREET, NATICK, MA 01760. PH: 617-307-1140. WWW.D13GROUP.COM	14119		MENU BOARD - DT 5 PANEL SB FREESTANDING - 108X65IN	SB/GC		VENDOR (DSA). INSTALLER: REGIONAL O PROVIDE FOOTING, CONDUIT AND				PH: 617-307-1140. WWW.D13GROUP.COM EMAIL: KRIZZO@D13GROUP.COM)
TOUET			EMAIL: KRIZZO@D13GROUP.COM			2745X1650MM - FLAT BLACK MT0028		ANCHOR BOLTS	01.1.01.121.001.1.05, 001.1201.7.1.12	X0011 2	HAND DRYER - INTEGRATED GC	GC	XLERATOR SYNC HAND DYER. AUTOMATIC	. II
TOILET 12951 2	TOILET - TANKLESS EFFICIENT SINGLE FLUSH G	GC GC	SLOAN MODEL ST-2020-1.28 (1.28 GPF)	14120	1	MENU BOARD - DT PRE MENU SB	SB/GC		VENDOR (DSA). INSTALLER: REGIONAL				SENSOR OPERATED. SURFACE MOUNTED. CONTACT: D 13 GROUP. 245 WEST CENTRAL	<u> </u>
13040 2	TOILET - FLUSH VALVE AUTOMATIC EFFICIENT SINGLE FLUSH	GC GC	CROWN MODEL 8111-1.28 FLUSHOMETER (1.28 GPF)			FREESTANDING - 36X65IN 915X1650MM - FLAT BLACK MT0028		SIGNAGE VENDOR. LL T ANCHOR BOLTS	O PROVIDE FOOTING, CONDUIT AND				STREET, NATICK, MA 01760. PH: 617-307-1140. WWW.D13GROUP.COM EMAIL:	<u>.</u>
DESIGN ID COUN	0.11022120011	N. BY INST. BY	COMMENTS	15700		MENU BOARD - DT DIGITAL ORDER SB SCREEN CONTROL BOX	SB/GC		NT VENDOR (ZONES). INSTALLER: REGIONAL CTRICAL CONNECTION: GC. LL TO PROVIDE	STORAGE			KRIZZO@D13GROUP.COM	.
AUDIO VISUAL	MUSIC SYSTEM SB	SB GC	TO INSTALL AND TEST SYSTEM.	OTHER				FOOTING, CONDUIT AND		10222 2	WIRE SHELF GRID AT SINK SB	GC		
10005 1 10010 1	DT ORDER MONITOR SB	SB GC	TO INSTALL AND TEST STSTEM.	14103		BOLLARD NONILLUMINATED LL	LL	DSA PHOTOTECH. SEE I	DTL.	10416 8 10462 8	WORKROOM SHELVING - 36IN 915MM SB WORKROOM SHELVING POSTS SB	GC GC		
10012 1 10015 4	DT COMMUNICATION SYSTEM SB SPEAKER RECESSED - WHITE SB	SB SB		14163		SQUARE - FLAT BLACK MT0028 DT ORDER POINT CANOPY SB	SB/GC	SUPPLIER: DT SIGNAGE	VENDOR (DSA). INSTALLER: REGIONAL	10698 1	MOP RACK WITH 3 HOLDERS SB	GC		
10017 2	SPEAKER SURFACE MOUNTED - BLACK SB	SB				FREESTANDING - FLAT BLACK MT0028			O PROVIDE FOOTING, CONDUIT AND	13834 1 15699 1	BASE - 24X18IN 610X455MM SB PARTNER WORK CENTER SB	GC GC		
12336 1 14676 1	DT TIMER SYSTEM SB DT POS MONITOR ARM DOUBLE SURFACE SB	SB GC		18818		LIGHT POLE - 10FT 300CM - FLAT SB BLACK MT0028	GC	GC TO PROVIDE AIRLINI	E CABLE AND HOOKS AS NEEDED FOR LIGHT	17255 1	PASTRY TRAY CART - 60IN 1525MM SB	GC GC		<u>i</u>
	MOUNTED AMPLIFIER - 40W SB		TO INSTALL AND TEST SYSTEM.	18820	2	LIGHT POLE BASE PLATE - FLAT SB	GC	INSTALLATION.		17264 1	ROLLING PASTRY TRAY THAW RACK - SB 20X26IN 510X660MM			
19339 1 DATA			, IO INOTALL AND TEST STSTEM.	X0006		BLACK MT0028 BIKE RACK - OLYMPIA LL	LL	FORMS & SURFACES: O	LYMPIA BIKE RACK.	17639 1 19476 2	WORKROOM CART - 24IN 610MM SB 5 COMP LOCKER - 12IN 305MM SB	GC GC		[
10002 1 10007 1	COMPUTER MANAGER WORKSTATION SB PRINTER MANAGER WORKSTATION SB	SB SB		7.0000	-			WWW.FORMS-SURFACE	ES.COM; INSTALL PER MANUFACTURER'S NISH: STANDARD BLACK TEXTURE.	2				
18744 1	EQUIPMENT RACK WITH LOCK - 24IN 610MM SB	SB		X0007	2	VEHICLE DETECTOR LOOP SB	GC	SUPPLIER: DT AUDIO VE	ENDOR (HME). INSTALLER: GC. LL TO		EXTERIOR SIGNAGE SCHE			
20294 4 POINT OF SALE	IOT MODULE SB	SB		PLANTER				PROVIDE CONDUIT		DESIGN ID SIGNAGE - DISK	COUNT DESCRIPTION FURN. BY	INST. BY	COMMENTS	
10008 2	POS - REGISTER WITH COMPACT CASH SB	SB GC	TO COORDINATE WITH SBUX VENDOR.	X0004	11	CONCRETE PLANTER BOX LL	LL		WITH IRRIGATION BY LANDLORD. LL TO FOR APPROVAL.LL TO PROVIDE	13182	1 SIGN - DISK SF ILLUMINATED SB	GC/ HILTON	LL TO PROVIDE BLOCKING AND CONDUIT AS	
10014 4	DRAWER POS PRINTER SB		TO COORDINATE WITH SBUX VENDOR.						NATE WITH OPERATIONS PRIOR TO		FLUSH MOUNTED EVOLVED - 71IN 1805MM		REQUIRED	
10022 1	MONEY COUNTER SB POS BANK SB	SB GC	TO COORDINATE WITH SBUX VENDOR.	UMBRELLA				INSTALLATION.		13184	1 SIGN - DISK SF ILLUMINATED SB FLUSH MOUNTED EVOLVED -	GC/ HILTON	LL TO PROVIDE BLOCKING AND CONDUIT AS REQUIRED	SF
10029 6 10075 3	CUP LABELER SB	SB GC	TO COORDINATE WITH SBUX VENDOR.	12147		UMBRELLA - BASE 95LB 43KG - SB FLAT BLACK MT0028	GC			CICNIACE DON'T	60IN 1525MM			
14677 1 14678 1	POS - DT TENDERING REGISTER SB POS - DT EXPEDITOR SB		RT OF RETAIL IT EQUIPMENT PACKAGE. RT OF RETAIL IT EQUIPMENT PACKAGE.	20073	3	UMBRELLA - WITHOUT VALANCE - SB	GC			SIGNAGE - DRIVE 14091	1 SIGN - DT DIRECTIONAL EXIT SB	GC	GC TO COORDINATE WITH SBUX VENDOR. LL	
SECURITY						6FT 183CM - GREEN CANVAS WITH WORDMARK F0056					SIGN ILLUMINATED ARROW SERIES - 46IN 1170MM		TO PROVIDE, FOOTING, ANCHOR BOLT AND CONDUIT	
10024 1	SAFE LH - 20X18X26IN 510X455X660MM SB	ST	TO COORDINATE WITH SBUX VENDOR; ORE MANAGER TO PROGRAM WITH							14106	1 SIGN - DT CLEARANCE BAR ARROW SERIES FREESTANDING	GC	GC TO COORDINATE WITH SBUX VENDOR. LL TO PROVIDE, FOOTING AND ANCHOR BOLT	Re
10028 1	SAFE BASF		NDOR PROVIDED MANUAL. TO COORDINATE WITH SBUX VENDOR;							SIGNAGE - OTHER				
10020	S. 1. E. S. 10 E	ST	ORE MANAGER TO PROGRAM WITH NDOR PROVIDED MANUAL.							19388	3 SIGN - 10 MINUTE PARKING SB/LL	GC	FOOTING AND POST BY LL, SIGN BY VENDOR (TUBE ART). GC TO INSTALL.	
		VE	NOOK I NOVIDED WANDAL.							SIGNAGE - PYLON				
										X0005	1 MONUMENT SIGN SB	GC/ LL	LL TO PROVIDE BASE SIGN, FOOTING, ANCHOR BOLTS AND CONDUITS. SIGN	SI
RESPONS	SIBILITY LEGEND									SIGNAGE - WORDI	MARK		PANELS BY SBUX VENDOR	
	NERAL CONTRACTOR									X18498	1 SIGN - WORDMARK STARBUCKS SB FLUSH MOUNTED - 20IN 510MM	GC/ HILTON	WORDMARK COLOR GREEN: LL TO PROVIDE CONDUIT AND BLOCKING AS REQUIRED	
LL LAN	DLORD										1 ESSIT MISSIALED - ZONA STONVINI		JOHNSON AND BEOGRAMO AO NEQUINED	SH
SB STA	RBUCKS													SH

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STARBUCKS TEMPLATE VERSION i2020-01-31





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Engineering Consultant

129-20

OF PROJECT NAME:
BUILDOUT OF
COFFEE
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STORE #: PROJECT #:	63039 88084-001
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JAK/BMS/CJS **Revision Schedule**

Date	Ву	Description

SCHEDULES

SCALE: AS SHOWN SHEET NUMBER:

E602

ABBREVIATIONS MECHANICAL SYMBOL LEGEND

ABOVE FINISHED FLOOR **AUTHORITIES HAVING JURISDICTION** AHJ APPROX APPROXIMATE BLDG BUILDING CO2 **CARBON DIOXIDE CEILING DIFFUSER** CLG CEILING CONST CONSTRUCTION CXA COMMISSIONING AGENT DEG **DEGREES** DM DN STARBUCKS DESIGN MANAGER DOWN DTL **DETAIL** DRAWING(S)

DWG(S) EA EC EACH **ELECTRICAL CONTRACTOR** ECP **EQUIPMENT CONTROL PAC** EG **EXHAUST GRILLE**

ELEC **ELECTRICAL EMERGENCY** ΕM **ENERGY MANAGEMENT SYSTEM**

EXISTING EXIST EXT **EXTERIOR**

CD

FURNISH & INSTALL F&I FLR **FLOOR** FT FOOT/FEET

GAS PIPING GENERAL CONTRACTOR GC

HOUR HEATING, VENTILATION, AIR CONDITIONING HVAC

I.D. **INSIDE DIAMETER** IAQ INDOOR AIR QUALITY

LCP LIGHTING CONTROL PANEL LANDLORD

LOW VOLTAGE

MAX MAXIMUM MC

LV

REQ'D

TYP

MECHANICAL CONTRACTOR MECH **MECHANICAL** MEP MECHANICAL, ELECTRICAL AND PLUMBING MFG MANUFACTURER

MIN MINIMUM NTS NOT TO SCALE

O.D. **OUTSIDE DIMENSION** OSA OUTSIDE AIR REF REFERENCE

REQUIRED

REV REVISION RT ROOFTOP SF SQUARE FEET SHT SHEET

SPECS SPECIFICATION(S) SST STAINLESS STEEL **TEMP TEMPORARY**

TYPICAL

UNLESS NOTED OTHERWISE

WH WATER HEATER WATER SOURCE HEAT PUMP

TYPICAL SUPPLY DUCT UP/DN TYPICAL RETURN OR EXHAUST DUCT UP/DN TURNING VANES

EF-1 **EQUIPMENT DESIGNATION**

THERMOSTAT

TEMPERATURE SENSOR

AIRFLOW ARROW

INDICATES UNLINED 12" X 8" O.D. SHEETMETAL 12 X 8 1ST FIGURE = SIDE SHOWN 2ND FIGURE = SIDE NOT SHOWN

FLEXIBLE DUCT

M H001 DIFFUSER ITEM# XXX CFM DESIGN CFM (WHERE APPLICABLE) **NECK SIZE**

CEILING DIFFUSER

CEILING RETURN GRILLE

CEILING EXHAUST GRILLE

CONTROLS AND OPERATION NOTES

THE GENERAL CONTRACTOR SHALL FURNISH AND INSTALL THE FOLLOWING COMPONENTS:

THE MECHANICAL CONTRACTOR SHALL PROVIDE ALL CONTROL WIRING IN CONDUIT NECESSARY FOR THE COMPLETE AND PROPER OPERATING TEMPERATURE CONTROL SYSTEM INCLUDING ALL MODES OF OPERATION AND INTERLOCK.

RESTROOM EXHAUST FAN(S) TO BE OPERATED IN CONJUNCTION WITH STORE HOURS UNLESS OTHERWISE NOTED OR APPROVED OR AS REQUIRED BY JURISDICTION (COORDINATE WITH ELECTRICAL).

PERMANENT THERMOSTAT(S) AND REMOTE SENSOR(S) SHALL BE FURNISHED AND INSTALLED. ONE THERMOSTAT AND SENSOR IS PROVIDED FOR EACH UNIT. MOUNT THERMOSTAT(S) AND SENSOR(S) IN LOCATION & HEIGHT AS INDICATED ON DRAWINGS. MECHANICAL CONTRACTOR TO PROVIDE THERMOSTAT IDENTIFICATION LABELS PER SPECIFICATION REQUIREMENTS. REFER TO THERMOSTAT SETUP

THERMOSTAT SETUP INSTRUCTIONS

PROVIDE THE FOLLOWING SETUP AND PROGRAMMING:

INSTRUCTIONS BELOW FOR ADDITIONAL REQUIREMENTS.

1. CONFIGURE AS FOLLOWS: A. DEGREES "F" DISPLAY

B. 12 HOUR CLOCK C. CONTINUOUS FAN OPERATION IN OCCUPIED

D. DISABLE KEYBOARD PROGRAMMING

2. SET TIME AND DATE. SET TO DISPLAY CURRENT TEMPERATURE. 4. SET OCCUPIED START TIME AT 30 MIN. BEFORE OPENING. SET UNOCCUPIED START TIME AT 30 MIN. AFTER CLOSING. VERIFY HOURS WITH STORE MANAGER OR

CONSTRUCTION MANAGER. 5. SET POINTS SHALL BE AS FOLLOWS OR AS APPROPRIATE

FOR CLIMATE: A. OCCUPIED (5° F DEADBAND) (3° C DEADBAND) HEATING: 70° F (21° C)

II. COOLING: 75° F (24° C) B. UNOCCUPIED HEATING: 60° F (15° C)

B COOLING: -2° F (1° C)

II. COOLING: 78° F (25° C) 6. SET TWO (2) HOUR OCCUPIED OVERRIDE FUNCTION TO PROVIDE THE FOLLOWING SET POINT OVERRIDES: A. HEATING: $+2^{\circ} F (1^{\circ} C)$

SYSTEM COMMISSIONING

CONTRACTOR RESPONSIBILITIES FOR BUILDING COMMISSIONING

CONTRACTOR SHALL PROVIDE SUPPORT AND WORK AS SPECIFIED, NEEDED AND REQUIRED TO CONDUCT AND FACILITATE STARBUCKS STAFF BUILDING COMMISSIONING EFFORTS. THIS WORK WILL BE COMPRISED OF THREE DISTINCT EFFORTS:

SUPPORT STARBUCKS COMMISSIONING AGENT (CXA) DURING INSTALLATION VERIFICATION AND CORRECT DISCLOSED DEFICIENCIES.

PERFORM TESTING, ADJUSTING, BALANCING AND SYSTEM STARTUP AND SUPPORT FUNCTIONAL PERFORMANCE TESTING BY STARBUCKS CXA;

CORRECT DEFICIENCIES DISCLOSED BY FUNCTIONAL PERFORMANCE TESTING AND SUBMIT REPORTS.

CONTRACTOR SHALL PERFORM AND PROVIDE THE FOLLOWING:

A. SYSTEMS SUBJECT TO COMMISSIONING MAY INCLUDE, BUT ARE NOT LIMITED TO DOMESTIC HOT WATER GENERATION, HVAC SYSTEMS, ROOFTOP UNITS, EXHAUST FANS, HVAC CONTROLS, LIGHTING CONTROLS, AIR CURTAINS, BUILT-IN REFRIGERATION, EQUIPMENT AND RENEWABLE ENERGY SYSTEMS.

B. CONTRACTOR SHALL PROVIDE WRITTEN RESPONSES TO ALL CXA'S REVIEWS AND COMMENTS. RESPONSES SHALL BE PROVIDED IN A TIMELY MANNER.

C. CONTRACTOR SHALL INCLUDE COMMISSIONING ACTIVITIES IN PROJECT SCHEDULE AND SHOW INTERVALS FOR PERFORMANCE OF WORK FOR WHICH CONTRACTOR IS RESPONSIBLE AND INTERVALS FOR WORK PERFORMED BY STARBUCKS CXA. CONTRACTOR SHALL SHOW RESOURCES FOR PERFORMING ALL WORK RELATED TO COMMISSIONING ACTIVITIES ON A LINE ITEM IN THE SCHEDULE OF VALUES.

D. CONTRACTOR SHALL INSTALL EQUIPMENT IN ACCORDANCE WITH THE MANUFACTURER'S REQUIREMENTS AND ALL CONTRACT DOCUMENTS. ENSURE THAT ALL EQUIPMENT IS INSTALLED TOTALLY COMPLETE AND ACCESSIBLE TO STARBUCKS CXA FOR INSTALLATION VERIFICATION AND FUNCTIONAL PERFORMANCE TESTING PRIOR TO THE SCHEDULED START OF INSTALLATION VERIFICATION.

CONTRACTOR SHALL COMPLETE MANUFACTURER'S STARTUP PROCEDURES PRIOR TO COMMISSIONING COORDINATION WITH

F. CONTRACTOR SHALL BE READILY AVAILABLE DURING INSTALLATION VERIFICATION TO CORRECT ANY DEFICIENCIES OR DEFECTS IS CLOSED BY THE INSTALLATION VERIFICATION PROCESS. CORRECTIONS SHALL BE MADE IN A TIMELY MANNER WITHOUT DISRUPTION OF THE CONSTRUCTION SCHEDULE.

G. ALL HVAC EXHAUST FAN AND AIR CURTAIN EQUIPMENT SHALL BE TESTED, ADJUSTED AND BALANCED BY THE CONTRACTOR'S TESTING, ADJUSTING AND BALANCE AGENT (SEE TESTING ADJUSTING AND BALANCING) AFTER THE SYSTEM IS VERIFIED TO BE COMPLETE AND CORRECT BY STARBUCKS CXA, IN ACCORDANCE WITH THE REQUIREMENTS OF THESE DOCUMENTS. ALL HVAC CONTROL SYSTEMS SHALL BE TESTED TO ENSURE THAT CONTROL DEVICES, COMPONENTS, EQUIPMENT AND SYSTEMS ARE CALIBRATED, ADJUSTED AND OPERATE IN ACCORDANCE WITH THESE PLANS AND SPECIFICATIONS. SEQUENCES OF OPERATION SHALL BE TESTED TO ENSURE THAT THEY OPERATE IN ACCORDANCE WITH THE CONTRACT REQUIREMENTS. DELIVERABLES: PRELIMINARY, WRITTEN TESTING AND AIR BALANCE REPORT CONFORMING TO THE REQUIREMENTS SPECIFIED HEREIN, DOCUMENTING THE INFORMATION SPECIFIED, ETC... TO THE STARBUCKS CXA IMMEDIATELY UPON COMPLETION OF THE WORK.

H. PROVIDE A LIST OF ALL FACTORY AND FIELD SETTINGS THAT HAVE BEEN PROGRAMMED INTO THE EQUIPMENT (SUCH AS SETPOINTS, SCHEDULES, DIP SWITCH SETTINGS, CONDENSER AND EVAPORATOR OPERATING PRESSURE/TEMPERATURE.

CONTRACTOR SHALL INFORM STARBUCKS CXA WHEN EQUIPMENT IS READY FOR FUNCTIONAL PERFORMANCE TESTING. ALL EQUIPMENT SHALL BE READY FOR FUNCTIONAL PERFORMANCE TESTING PRIOR TO STARTING TESTING. THIS INCLUDES REHEARSING ALL FUNCTIONAL PERFORMANCE TESTS BEFORE DEMONSTRATING TO THE CXA. CONTRACTOR SHALL OPERATE EQUIPMENT FOR STARBUCKS CXA AND VERIFY BY DEMONSTRATING THE CORRECT OPERATION OF EQUIPMENT SENSOR CALIBRATION, RESPONSE OF ACTUATORS AND PROPER EXECUTION OF HVAC CONTROL AND LIGHTING SEQUENCES, INCLUDING BUT NOT LIMITED TO AIR MOVEMENT, TEMPERATURE, SOUND AND CONTROL RESPONSE. PROVIDE ANY SECURITY ACCESS. HARDWARE. SOFTWARE OR OTHER SUPPORT AS NEEDED FOR THE STARBUCKS CXA TO EFFICIENTLY WITNESS AND DOCUMENT ALL EQUIPMENT TESTING. STARBUCKS CXA WILL RECORD THE EQUIPMENT OPERATION AND RESPONSE TO TESTING SEQUENCES AND PREPARE A LIST OF ANY DEFICIENCIES DISCLOSED BY THE FUNCTIONAL PERFORMANCE TESTS FOR CORRECTION BY THE CONTRACTOR. EQUIPMENT INCLUDES, BUT IS NOT LIMITED TO, AIR HANDLING UNITS, ROOFTOP AND SPLIT TYPE, CONDENSING UNITS, EXHAUST FANS, LIGHTING CONTROLS, ETC... DELIVERABLES: PROVIDE COMPLETED COPIES OF ALL START UP REPORTS, FILLED OUT ON THE MANUFACTURER'S FORMS, TO THE STARBUCKS CXA.

J. CONTRACTOR IS RESPONSIBLE FOR CORRECTING ANY ISSUES OR DEFICIENCIES DISCLOSED DURING THE FUNCTIONAL PERFORMANCE TESTING PROCESS. CORRECTIONS SHOULD BE MADE IN A TIMELY MANNER WITHOUT DISRUPTION TO THE SYSTEM AND CONSTRUCTION SCHEDULE.

K. CONTRACTOR SHALL BE READILY AVAILABLE FOR ANY RE-TESTING OF EQUIPMENT DEEMED NECESSARY BY STARBUCKS CXA DURING INSTALLATION VERIFICATION AND FUNCTIONAL PERFORMANCE TESTING. CONTRACTOR IS RESPONSIBLE FOR CORRECTING ANY ISSUES OR DEFICIENCIES FOUND IN THE SYSTEM DURING ANY AND ALL RE-TESTING. CORRECTIONS SHOULD BE MADE IN A TIMELY MANNER WITHOUT DISRUPTION TO THE SYSTEM AND CONSTRUCTION SCHEDULE. DELIVERABLES: FINAL BALANCE REPORT, DEFICIENCIES LIST NOTING CORRECTIVE ACTIONS PERFORMED BY CONTRACTOR IN RESPONSE TO INSTALLATION VERIFICATION AND FUNCTIONAL PERFORMANCE TEST RESULTS.

CONSTRUCTION AND POST CONSTRUCTION TESTING: ADDITIONAL TESTING MAY BE REQUIRED BY LEED AND OTHER PROCESSES THAT MAY OCCUR OUT OF SEQUENCE WITH COMMISSIONING SERVICE. CONTRACTOR SHALL CONDUCT. DOCUMENT, SUPPORT AND SCHEDULE THIS TESTING AS DIRECTED BY STARBUCKS CXA.

SYSTEM COMMISSIONING (continued)

- M. CONTRACTOR SHALL PROVIDE A TRAINING PLAN FOR EACH TRADE (MECHANICAL, ELECTRICAL, PLUMBING, RENEWABLE SYSTEMS) FOR THE CXA'S APPROVAL. THE TRAINING PLAN SHALI OUTLINE ALL THE TOPICS THAT ARE TO BE COVERED ALONG WITH THE TIME DURATION FOR EACH TOPIC. IT SHALL ALSO INCLUDE THE INSTRUCTOR'S NAME, QUALIFICATIONS AND COMPANY LOGO.
- N. THE CONTRACTOR IS RESPONSIBLE FOR RECORDING ATTENDANCE FOR EACH TRAINING SESSION. COPIES OF THESE SHALL BE SUBMITTED TO THE CXA.
- O. CONTRACTOR SHALL SUBMIT O&M MANUALS FOR ALL PIECES OF EQUIPMENT AT LEAST 6 WEEKS IN ADVANCE OF THE TRAINING

HVAC EQUIPMENT AND MATERIALS

FILTERS
IF OPERATING HVAC DURING CONSTRUCTION, PROVIDE THREE (3) SETS OF 2" (51MM) MERV6 PLEATED DISPOSABLE FILTERS (OR HIGHER RATING IF REQUIRED BY LEED). USE ONE SET UNTIL COMPLETION OF CONSTRUCTION. INSTALL ONE SET AT COMPLETION OF CONSTRUCTION (PRIOR TO TAB) AND DELIVER ONE SET OF MERV13 FILTERS TO STARBUCKS LÁBELED TO DENOTE THEIR RESPECTIVE AIR HANDLING UNIT.

BRACING AND ANCHORING

ALL MECHANICAL EQUIPMENT, FIXED OR FLEXIBLY MOUNTED. SHALL BE BRACED OR ANCHORED TO COMPLY WITH LOCAL CODES.

DUCTWORK AND ACCESSORIES

SHEET METAL DUCTWORK
ASSEMBLE AND INSTALL DUCTWORK IN ACCORDANCE WITH RECOGNIZED INDUSTRY PRACTICE FOR ACHIEVING AIR TIGHT (5% LEAKAGE) AND NOISELESS (NO OBJECTIONABLE NOISE) SYSTEMS. NO VARIATION OF DUCT CONFIGURATION OR SIZES WILL BE PERMITTED EXCEPT BY PERMISSION FROM THE ENGINEER.

PROVIDE CONVENIENTLY LOCATED ACCESS DOORS OF AMPLE SIZE AND QUANTITY FOR SERVICING THE DAMPERS. PROVIDE MOTORIZED DAMPERS AT ALL INTAKE & EXHAUST BUILDING OPENINGS. COORDINATE WITH OTHER TRADES FOR ACCESS PANELS, POWER AND FIRE ALARM INTERFACES. SEE PROJECT MANUAL

ACOUSTICAL DUCT LINER
UNLESS OTHERWISE INDICATED ON THE PLANS, PROVIDE 1" (25MM) ACOUSTICAL DUCT LINER IN SUPPLY AND RETURN DUCTWORK WITHIN 10'-0" (305CM) OF THE DISCHARGE AND INTAKE OF AIR HANDLING UNITS. INCREASE DUCT SIZE INDICATED ON PLANS AS NEEDED TO ACCOMMODATE LINER. LINER TO BE PROVIDED AND FASTENED TO DUCT WITH MECHANICAL LINER FASTENERS IN ACCORDANCE WITH SMACNA AND PROJECT MANUAL

FLEXIBLE DUCT WORK SHALL ONLY BE INSTALLED AS SHOWN IN PLAN AND NOT ABOVE HARD LID CEILINGS. FLEXIBLE DUCTWORK SHALL NOT EXCEED 5'-0" (152CM) IN LENGTH AND TWO 45° ELBOWS. IT SHALL BE PULLED TAUT AND APPROPRIATELY FASTENED TO RIGID BRANCH DUCT & DIFFUSER. BENDS SHALL BE MINIMIZED AND WHERE NEEDED BE A FULL RADIUS BEND SUPPORT BANDS SHALL BE INSTALLED SO AS TO NOT CRIMP FLEX DUCT. FLEXIBLE DUCTWORK SHALL MEET REQUIREMENTS.

TESTING, ADJUSTING, BALANCING

INDEPENDENT AIR BALANCE CONTRACTOR OR QUALIFIED MECHANICAL CONTRACTOR SHALL BE QUALIFIED BY NEBB OR AABC STANDARDS. BALANCER SHALL ACCURATELY BALANCE THE SUPPLY, RETURN AND OUTSIDE AIR, EXHAUST FAN(S), HYDRONIC (WHERE APPLICABLE) AND EXHAUST FAN(S) SYSTEMS TO PROVIDE AIR AND WATER QUANTITIES WITHIN 10% PLUS MINUS OF THE VALUES INDICATED ON THE DRAWINGS AND IN THE SPECIFICATIONS UNLESS MANUFACTURER REQUIRES TIGHTER TOLERANCES. OPERATE AUTOMATIC CONTROLS SYSTEMS AND VERIFY SETPOINTS FOR THERMOSTATS, C02 SENSORS, DCV, EMS AND ECONOMIZER/OUTSIDE AIR DAMPER. SEE CONTROLS AND OPERATION NOTES AND HVAC SCHEDULES AND NOTES FOR DETAILS. IF DEFICIENCIES OR SITE CONDITIONS PREVENT COMPLETE AND PROPER BALANCING, DO NOT COMPLETE WORK AND SUBMIT A REQUEST FOR INFORMATION TO GET COMPLETE INFORMATION PRIOR TO COMPLETING WORK. SUBMIT THREE (3) COPIES OF THE BALANCE REPORT TO THE ENGINEER, CONSTRUCTION MANAGER AND COMMISSIONING AGENT FOR APPROVAL. THE BALANCE REPORT SHALL INCLUDE NEBB OR AABC CREDENTIALS, EQUIPMENT/INSTRUMENT LIST WIT THE MOST RECENT CALIBRATION DATE AND BALANCE REPORTS FOR ALL HVAC AND EXHAUST SYSTEMS. T&B REPORT SHOULD MATCH NEBB OR AABC STANDARD REPORTS INCLUDING UNIT TEST DATA WITH TEMPERATURES, PRESSURES AND STATIC PRESSURE PROFILES. INCLUDE A COPY OF THE BALANCE REPORT AS APPROVED BY THE ENGINEER WITH APPLICATION FOR FINAL CONTRACT PAYMENT.

IAQ MANAGEMENT PLAN

DURING CONSTRUCTION, CONTRACTOR SHALL COMPLY WITH CHAPTER 3 OF SMACNA'S IAQ GUIDELINES FOR OCCUPIED BUILDINGS UNDER CONSTRUCTION. CONTRACTOR SHALL PERFORM AND SUBMIT ALL INFORMATION AS REQUIRED. IF HVAC SYSTEM IS TO BE USED DURING CONSTRUCTION, INSTALL MERV 8 FILTERS AT EACH RETURN AIR GRILL AND COMPLY WITH SMACNA'S GUIDELINES.

ENERGY MANAGEMENT SYSTEM (EMS)

THE GENERAL CONTRACTOR SHALL INSTALL (OR DEMO AND REINSTALL FOR RENOVATIONS) THE VENSTAR SURVEYOR EMS SYSTEMS PRIOR TO THE LAST WEEK OF CONSTRUCTION. GENERAL CONTRACTOR TO PROVIDE ONE PERMANENT THERMOSTAT AND REMOTE SENSOR PER HVAC UNIT. LOCATE AND MOUNT THERMOSTAT(S) AND SENSOR(S) PER THE DRAWINGS. PROVIDE THERMOSTAT IDENTIFICATION LABELS PER SPECIFICATION REQUIREMENTS.

GENERAL CONTRACTOR TO PROGRAM, START-UP AND COMMISSION THE CONTROL SYSTEM. GENERAL CONTRACTOR IS TO COMPLETE FINAL CONNECTION AFTER DATA RACK AND NETWORK INSTALLATIONS. GENERAL CONTRACTOR VENDOR TO VERIFY SYSTEM OPERATION AND TROUBLESHOOT IF REQUIRED. GENERAL CONTRACTOR TO COMPLETE SURVEYOR'S STARBUCKS INSTALLATION SURVEY FORM AND PROVIDE TWO (2) COMPLETED COPIES OF THIS DOCUMENT TO THE CONSTRUCTION MANAGER AND COMMISSIONING AGENT PRIOR TO FINAL PAYMENT.

GENERAL MECHANICAL NOTES

- MECHANICAL CONTRACTOR SHALL COORDINATE WITH THE GENERAL CONTRACTOR TO PATCH AND REPAIR ALL EXISTING WALLS, FLOORS, CEILINGS OR OTHER SURFACES IDENTIFIED TO REMAIN THAT MAY BECOME DAMAGED DURING THE COURSE OF WORK
- 2. DRAWINGS ARE DIAGRAMMATIC AND INDICATE GENERAL INTENT OR ARRANGEMENT OF SYSTEM(S). FURNISH & INSTALL ALL COMPONENTS NEEDED WHETHER INDICATED OR NOT TO PROVIDE A COMPLETE AND OPERATING SYSTEM.
- CONTRACTOR TO VERIFY ALL DIMENSIONS, INCLUDING CLEARANCES REQUIRED BY OTHER TRADES, AND NOTIFY STARBUCKS CONSTRUCTION MANAGER OF ANY DISCREPANCIES PRIOR TO PROCEEDING WITH THE WORK. ALL DIMENSIONS ARE TO THE FACE OF THE FINISHED SURFACE UNLESS NOTED OTHERWISE ALL DIMENSIONS TO BE TAKEN FROM ACTUAL BUILDING DIMENSIONS.
- 4. THE MECHANICAL CONTRACTOR SHALL COORDINATE HVAC WORK WITH OTHER TRADES. THE ARCHITECTURAL DRAWINGS AND PROJECT MANUAL SHALL TAKE PRECEDENCE OVER ALL OTHER DRAWINGS. SEE ARCHITECTURAL DRAWINGS AND PROJECT MANUAL FOR DIMENSIONED DIFFUSER LOCATIONS AND MOUNTING HEIGHTS WHERE EXPOSED.
- 5. NEW DUCTWORK AND EQUIPMENT SHALL NOT BE INSTALLED WHERE IT OBSTRUCTS ANY EXISTING OR NEW AREAS THAT REQUIRE ACCESS.
- INSULATE DUCTWORK PER CODE AND SPEC. REQUIREMENTS. COORDINATE CLEARANCE REQUIREMENTS FOR ADDED INSULATION.
- 7. ALL IS NEW UNLESS NOTED OTHERWISE.

GENERAL NOTES

THE INTENT OF THE PROJECT MANUAL AND THE DRAWINGS IS TO PROVIDE A COMPLETE AND FULLY OPERATIONAL MECHANICAL SYSTEM. THE MECHANICAL CONTRACTOR SHALL FURNISH ALL LABOR, MATERIAL, AND EQUIPMENT NECESSARY TO COMPLETE THE MECHANICAL WORK.

THE MECHANICAL CONTRACTOR SHALL THOROUGHLY EXAMINE ALL AREAS WHERE EQUIPMENT. DUCTWORK. AND PIPING WILL BE INSTALLED AND WILL REPORT ANY CONDITION THAT, IN HIS OPINION, PREVENTS THE PROPER INSTALLATION OF THE MECHANICAL WORK.

WHERE PIPES AND DUCTS PENETRATE WALL, SEAL OPENINGS TO PREVENT AIR TRANSFER BETWEEN SPACES. USE FIRE RATED SEALANTS ON ALL FIRE SEPARATION PENETRATIONS, INCLUDING FLOORS. SEAL AROUND ALL PIPES AND DUCTS PENETRATING FIRE SEPARATIONS WITH NON-COMBUSTIBLE PACKING RETAINED BY METAL COLLARS. THE ASSEMBLY SHALL BE APPROVED BY STATE FIRE MARSHALL.

EQUIPMENT AND MATERIALS SHALL CONFORM WITH THE APPROPRIATE PROVISIONS OF CSA, ULC, ARL, ASME, ASTM, UL, NEMA, ANSI, SMACNA, ASHRAE, NFPA, AS APPLICABLE TO EACH INDIVIDUAL UNIT OR ASSEMBLY.

ALL WORK SHALL BE PERFORMED IN STRICT ACCORDANCE WITH ALL APPLICABLE PROVINCIAL AND LOCAL CODES AND ORDINANCES. IN CASE OF CONFLICT BETWEEN THE DRAWINGS AND PROJECT MANUAL AND THE CODES AND ORDINANCES. USE WHICHEVER IS MORE STRINGENT. THE MECHANICAL CONTRACTOR SHALL SATISFY CODE REQUIREMENTS AS A MINIMUM STANDARD WITHOUT ANY EXTRA COST TO STARBUCKS.

PERMITS AND FEES

THE MECHANICAL CONTRACTOR SHALL PROCURE AND PAY FOR ALL PERMITS, FEES, AND INSPECTIONS NECESSARY TO COMPLETE THE MECHANICAL WORK.

THE MECHANICAL CONTRACTOR SHALL UNCONDITIONALLY WARRANT ALL WORK TO BE FREE OF DEFECTS IN MATERIAL AND WORKMANSHIP FOR A PERIOD OF ONE (1) YEAR FROM THE DATE OF FINAL ACCEPTANCE BY STARBUCKS AND WILL REPAIR OR REPLACE ANY DEFECTIVE WORK PROMPTLY AND WITHOUT CHARGE AND RESTORE ANY OTHER EXISTING WORK DAMAGED IN THE COURSE OF REPAIRING DEFECTIVE MATERIALS AND WORKMANSHIP.

LANDLORD REQUIREMENTS

PRIOR TO BID: THE GENERAL CONTRACTOR SHALL COORDINATE WITH LANDLORD / BUILDING OWNER FOR ANY CONSTRUCTION REQUIREMENTS. IF LANDLORD / BUILDING OWNER DOES HAVE REQUIREMENTS, CONTRACTOR SHALL BECOME COMPLETELY FAMILIAR WITH REQUIREMENTS AND ADHERE TO THEM. WHERE LANDLORD / BUILDING OWNER REQUIREMENTS ARE MORE STRINGENT THAN SHOWN IN THESE PLANS (IN THE OPINION OF THE ENGINEER). LANDLORD / BUILDING OWNER REQUIREMENTS SHALL GOVERN.




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 $\mathbb{E} \mathbf{m} \mathbf{O} \mathbf{M}$ STORE #: 63039 PROJECT #: 88084-001 09-04-2020 SR. DESIGN MANAGER: K. GORIN-SLONSKI

PRODUCTION DESIGNER: A.MAUSER

Revision Schedule

Description

MECHANICAL NOTES

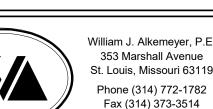SCALE: AS SHOWN

SHEET NUMBER:

NEW ELECTRIC COOLING/GAS HEATING ROOFTOP PACKAGED UNIT BY LANDLORD. VERIFY FINAL LOCATION AT JOBSITE.

HIGH EFFICIENCY, DOWN DISCHARGE CONFIGURATION.

MOUNT ON CURB WITH NEW ROOF OPENING.

PROVIDE WITH FACTORY INSTALLED UNIT MOUNTED DISCONNECT SWITCH. PROVIDE WITH FACTORY INSTALLED NON-POWERED CONVENIENCE SERVICE OUTLET (115V GFCI).

PROVIDE WITH FACTORY INSTALLED ENTHALPY TYPE ECONOMIZER.

PROVIDE SMOKE DETECTOR IN RETURN AIR DUCT TO SHUT DOWN UNIT UPON DETECTION.

PROGRAMMABLE THERMOSTAT WITH REMOTE SENSOR. SEE CONTROLS SPEC

PROVIDE WITH HAIL GUARDS

SERVICE

RESTROOMS / OVENS

10. PROVIDE WITH POWER EXHAUST


			EX	HAUS	T FAN	SCHE	DULE	(BY L.	.L.)			
	MAX.	PLAN	RPM	ESP (IN	DRIVE	SONES (MAX)		MOTOR		MANUFACTURER	MODEL	NOTES
CFM CFM			WG)		` ,	VOLTAGE	PHASE	HP				
	500	360	1405	0.31	DIRECT	6.2	115	1	1/10	GREENHECK	G-090-VG	1,2

NOTES: 1. PROVIDE WITH FACTORY ROOF CURB AND BACKDRAFT DAMPER 2 PROVIDE WITH SPEED CONTROLLER

2	THOUBL WITH OF ELD CONTROLLER	

	AIR TERMINAL SCHEDULE								
DIFFUSER ITEM#	COUNT	DESCRIPTION	MANUFACTURER	MODEL	AIR TERMINAL REMARKS				
H001	17	SQUARE SUPPLY - LAY-IN OR SURFACE - SEE PLAN	TITUS	TDC-A4	24x24				
H002	2	SQUARE SUPPLY - SURFACE	TITUS	TDC-G2	12x12				
H254	6	SQUARE RETURN - LAY-IN OR SURFACE	TITUS	350RL	24X24				
H255	3	SQUARE EXHAUST - SURFACE	TITUS	350 RL	12X12				

OUTSIDE AIR CALCULATIONS									
1. Summary Ventilation Sizing Method Design Condition Heating operation Occupant Diversity (D) Uncorrected Outdoor Air Intake (Vou) System Ventilation Efficiency (Ev) Outdoor Air Intake (Vot) 2. Space Ventilation Analysis									
2. opuse ventilation Analysis		Space Floor Area (ft²)	Area Outdoor Air Rate (CFM/ft²)	Time Averaged Occupancy (Occupants)	Rate	Air	Space Outdoor Air (CFM)	Breathing Zone Outdoor Air (CFM)	Space Ventilation Efficiency
Zone Name / Space Name	Mult.	(Az)		(Pz)	(Rp)	(Ez)	(Voz)	(Vbz)	(Evz)
Zone 1									
Backbar	1	434.0	0.18	2.0	7.50	0.8	116	93	1.059
Cafe	1	920.0	0.18	34.0	7.50	0.8	526	421	0.653
RR	1	132.0	0.00	0.0	0.00	0.8	0	0	1.122
Work Room	1	400.0	0.12	2.0	5.00	0.8	73	58	1.078
Corridor	1	138.0	0.06	0.0	0.00	0.8	10	8	0.951
Totals (incl. Space Multipliers)								580	0.653

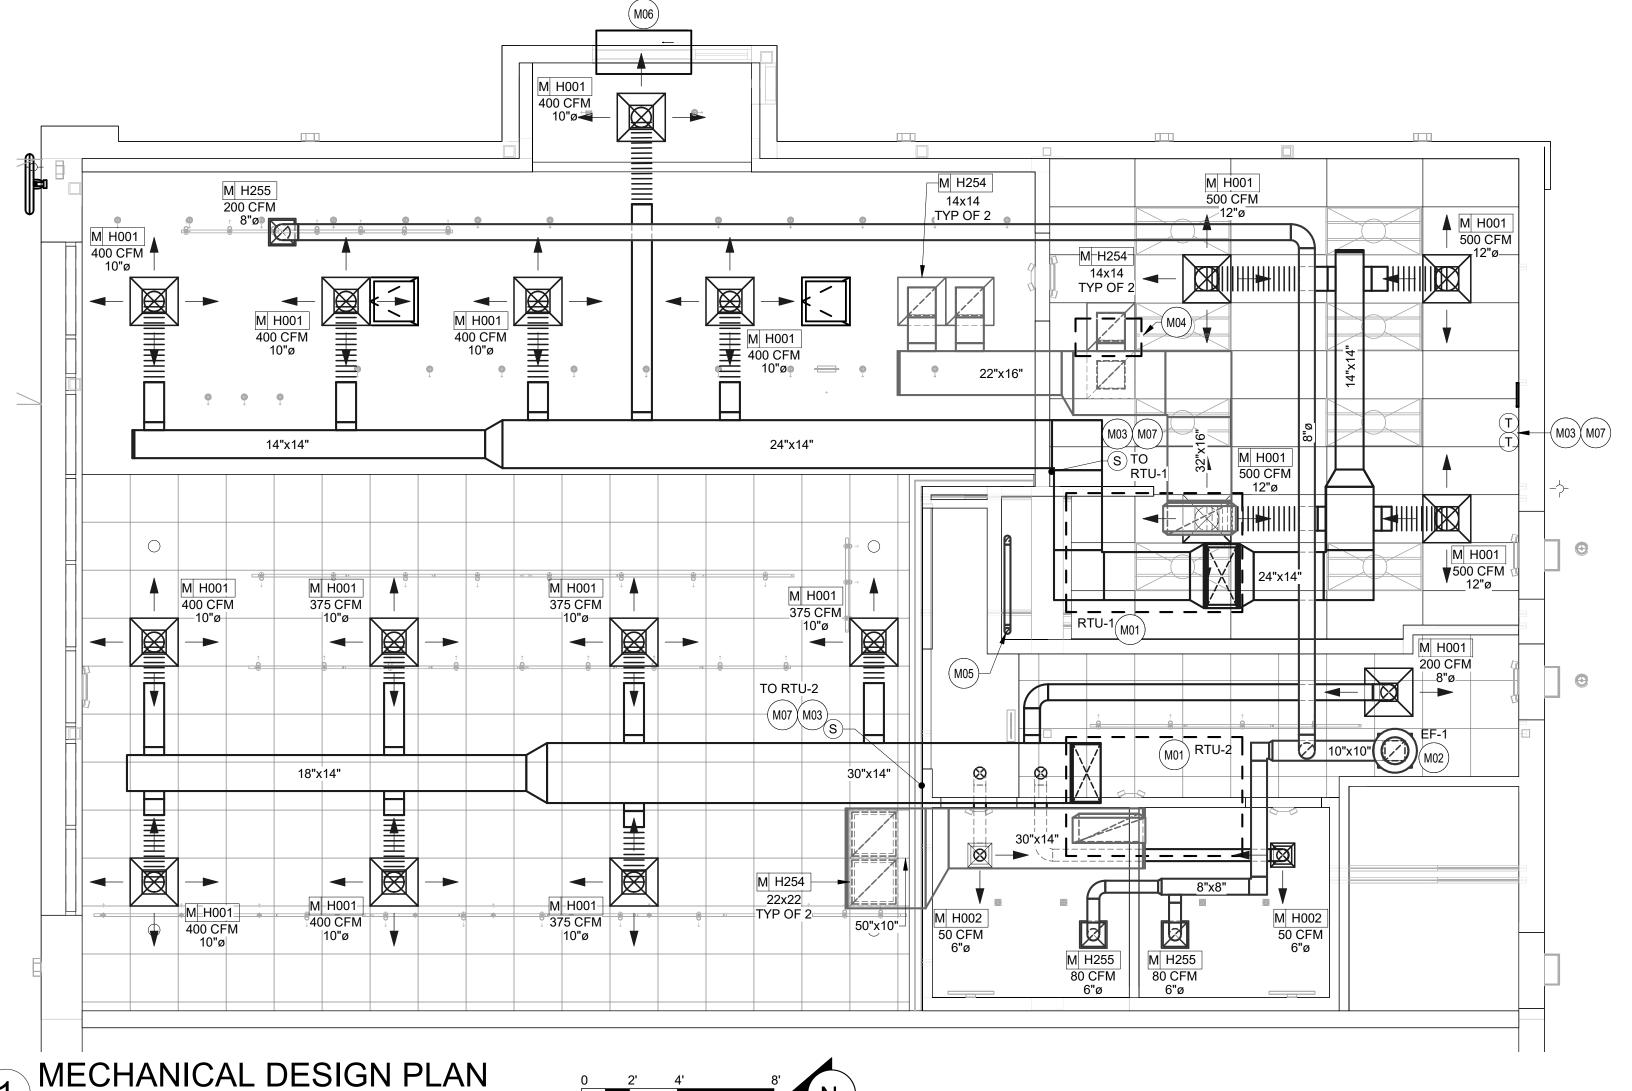

MECHANICAL GENERAL NOTES

- A. A.SEE MECHANICAL SPECIFICATIONS FOR FURTHER REQUIREMENTS.
- B. SEE ARCHITECTURAL SHEETS FOR PAINTING AND COLORS OF ALL EXPOSED DUCTWORK, DIFFUSERS AND GRILLES.
- C. C.SEE ARCHITECTURAL SHEETS FOR DIMENSIONED DIFFUSER AND EXPOSED DUCT LOCATIONS.
- D. D.DIFFUSERS AND RETURN GRILLES SHALL BE CENTERED IN CEILING TILE, UNLESS OTHERWISE NOTED.
- E. REFERENCE LANDLORD WORK LETTER FOR DIVISION OF MECHANICAL SCOPE OF WORK AND COORDINATE WITH STARBUCKS CONSTRUCTION
- F. THIS CONTRACTOR SHALL COORDINATE WITH ALL OTHER TRADES IN LOCATING DUCTWORK, PIPING AND EQUIPMENT TO AVOID ANY
- G. COORDINATE INSTALLATION OF NEW DUCT WITH STRUCTURE.
- H. CONTRACTOR TO INSTALL ALL WORK IN STRUCT COMPLIANCE WITH LOCAL CODES AND ORDINANCES.
- I. PROVIDE ADJUSTABLE VOLUME DAMPER AT ALL BRANCH DUCTWORK.
- J. PROVIDE TURNING VANES AT ALL RECTANGULAR ELBOWS (TYPICAL).
- K. MECHANICAL CONTRACTOR TO REPLACE FILTERS AFTER CONSTRUCTION IS COMPLETED.

MECHANICAL KEYED NOTES

- M01 ROOFTOP UNIT (RTU-1&2) PROVIDED AND INSTALLED BY LANDLORD, FINAL OUTDOOR AIR SETTING SHALL BE AS INDICATED IN SCHEDULE ON THIS SHEET. FACTORY INSTALLED SMOKE DETECTOR SHALL DE-ENERGIZE UNIT SUPPLY FAN AND ACTIVATE AUDIO/VISUAL INDICATOR IF SMOKE IS DETECTED IN RETURN AIR DUCT. PROVIDE PERMANENT ACCESS TO SMOKE DETECTOR. PROVIDE AND INSTALL REMOTE TEST SWITCH FOR ALARM THAT IS ACCESSIBLE WHILE STANDING ON THE FLOOR. COORDINATE WITH ELECTRICAL CONTRACTOR FOR POWER CONNECTIONS TO ALL MECHANICAL EQUIPMENT.
- M02 LANDLORD SHALL PROVIDE AND INSTALL NEW ROOF MOUNTED EXHAUST FAN WITH SPEED CONTROLLER (SEE SCHEDULE THIS SHEET) PER MANUFACTURER'S RECOMMENDATION. PROPERLY SEAL AROUND ALL ROOF PENETRATIONS. EXTEND EXHAUST DUCT FROM EACH GRILLE WITH BACKDRAFT DAMPER TO MAIN EXHAUST DUCT CONNECTING TO EF-1 ON ROOF. FAN SHALL BE 10' MINIMUM FROM ANY AIR INTAKE. VERIFY EXACT LOCATION IN THE FIELD. SEE CONTROLS AND OPERATION FOR FAN ON SHEET M001. BALANCE PER STARBUCKS DESIGN GUIDELINES.
- M03 LANDLORD SHALL PROVIDE AND INSTALL TEMPORARY THERMOSTAT AND WALL MOUNTED SENSOR FOR CONTROL OF RTUS. MOUNT THERMOSTATS AT 44" A.F.F. AT MANAGER'S DESK. COORDINATE EXACT LOCATION WITH OWNER. MOUNT SENSORS AT 60" A.F.F. COORDINATE LOCATIONS WITH OTHER ELEMENTS. VERIFY EXACT LOCATIONS IN FIELD. REFER TO LANDLORD WORK LETTER, MECHANICAL NOTES AND MECHANICAL SCHEDULE. MULTIPLE THERMOSTATS SHALL BE STACKED IN A VERTICAL CONFIGURATION WITH A MINIMUM 8" CLEARANCE BELOW EACH
- M04 REMOTE CONDENSING UNIT FOR ICE MACHINE ON ROOF. ROUTE REFRIGERATION PIPING DOWN TO MATCHING INDOOR UNIT AND PROVIDE ALL CONNECTIONS PER MANUFACTURER'S RECOMMENDATIONS.
- M05 DIRECT VENT CLOSED COMBUSTION AND FLUE PVC LINES FROM WATER HEATER UP THROUGH ROOF, TERMINATE WITH CONCENTRIC VENT KIT PER MANUFACTURER'S RECOMMENDATIONS. MAINTAIN 10' MINIMUM FROM OUTLET TO ANY AIR INTAKE. SEE DETAIL ON SHEET M501.
- M06 LANDLORD SHALL PROVIDE AND INSTALL 48" HEATED AIR CURTAIN OVER DRIVE THRU WINDOW. UNIT SHALL BE EQUAL TO READY ACCESS SERIES AA300, 208/240 V, 1 PH, 32 AMPS, 7.1 KW HEATER.
- M07 G.C. TO PROVIDE AND INSTALL VENSTAR THERMOSTATS AND REMOTE SENSORS TO REPLACE EXISTING CONTROLS PROVIDED BY LANDLORD AND HVAC CONTRACTOR. COORDINATE COMMISSIONING WITH VENSTAR PER STARBUCKS GUIDELINES. SEE EMS DETAILS ON SHEET M502.



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63039 PROJECT #: 88084-001 SR. DESIGN MANAGER: K. GORIN-SLONSKI PRODUCTION DESIGNER: A.MAUSER

Revision Schedule

DMC / NJD

MECHANICAL DESIGN PLAN SCALE: AS SHOWN


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STORE #:


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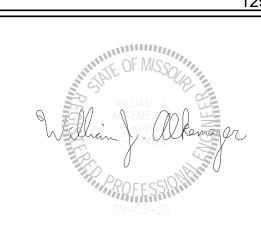
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Engineering Consultant

129-20



BUILDOUT COFFEE RT. 291 &

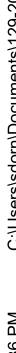STORE #: 63039 PROJECT #: 88084-001 ISSUE DATE: 09-04-2020 SR. DESIGN MANAGER: K. GORIN-SLONSKI PRODUCTION DESIGNER: A.MAUSER

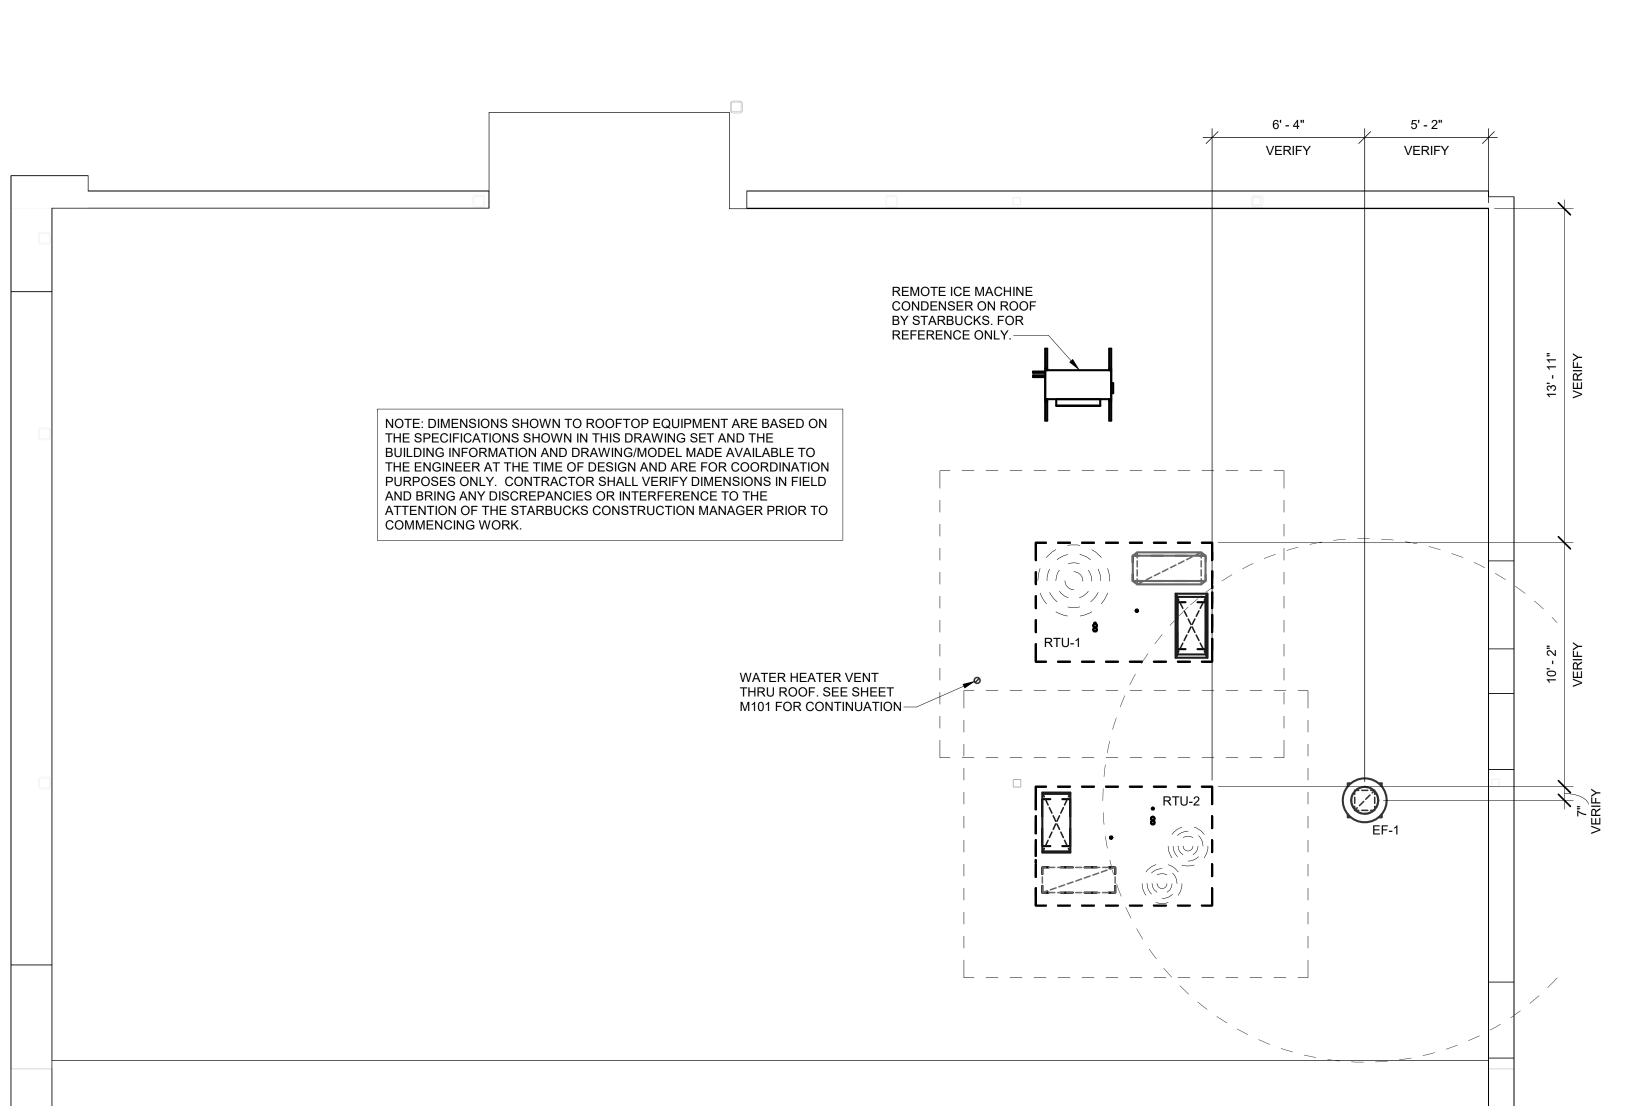CHECKED BY: DMC / NJD

Revision Schedule

MECHANICAL ROOF PLAN SCALE: AS SHOWN

SHEET NUMBER:

ROOF MOUNTED EXHAUST FAN DETAIL

SUPPORT ANGLE FOR DAMPER

1/4" SPONGE

ALL AROUND-

FRAMING ALL AROUND-

GRAVITY

DAMPER-

MOUNTED SUPPLY AIR FANS.

USE SAME CURB AND FLASHING ARRANGEMENT FOR ROOF

BACKDRAFT

FLASH AND

ROOF CURB-

COUNTERFLASH-

RUBBER

GASKET

ATTACHED TO

CURB-

-ROOF MOUNTED

ANCHOR

TO HOOD

CURB

EXHAUST DUCT SEE

SCHEDULES FOR

SIZE


SCREEN

EXHAUST FAN WITH BIRD

-CANT STRIP

-ROOFING

-INSULATION

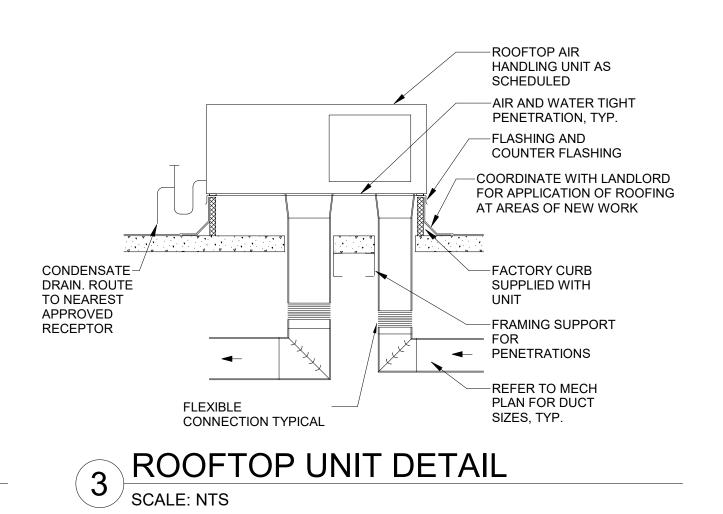


EQUAL WHERE NOTED ON MECHANICAL PLAN **EQUALIZING GRID** PERPEND TO STUB DUCT. -FLEX DUCT CLAMP FULL SIZE OF DIFFUSER CAP. HEIGHT FROM -FLEX DUCT. PULL DIFFUSER NECK TO STUB INSIDE LINER TAUT CNTRLN. FABRICATE FROM 22GA PERF SHT MTL (3/16" HOLES ON 1/4" CENTERS) -CLG DIFFUSER. FASTEN TO CAP PROVIDE SUPPORT FOR ` W/ SHT MTL SCREWS, MIN ONE DIFFUSER & CAP PER PER SIDE. SEAL JOINT AIR TIGHT CODE 2. EQUALIZING GRID REQ'D -TYP SUSP LAY-IN CEILING ON SUPPLY AIR DIFFUSERS ONLY.

LAY-IN DIFFUSER DETAIL


SCALE: NTS

HVAC LOAD SUMMARY **DESIGN HEATING** DESIGN COOLING COOLING DATA AT Aug 1400 HEATING DATA AT DES HTG COOLING OA DB / WB 96.4 °F / 74.9 °F HEATING OA DB / WB -1.0 °F / -2.5 °F Sensible Latent Sensible Latent ZONE LOADS Details (BTU/hr) (BTU/hr) Details (BTU/hr) (BTU/hr) 210 ft² 4225 210 ft² Window & Skylight Solar Loads Wall Transmission 962 ft² Roof Transmission 2024 ft² 2024 ft² Window Transmission 210 ft² 1968 210 ft² Skylight Transmission 0 ft² 0 ft² 82 ft² 1401 82 ft² Door Loads Floor Transmission 2024 ft² 2024 ft² Partitions Overhead Lighting 1619 W 5525 Task Lighting 0 W Electric Equipment 0 W 7211 6840 People Infiltration Miscellaneous 53953 7554 Safety Factor 0% / 0% 0% >> Total Zone Loads 82913 22646 14394 Zone Conditioning 14394 Plenum Wall Load Plenum Roof Load 0% Plenum Lighting Load 0% Return Fan Load 4761 CFM 4761 CFM Ventilation Load 900 CFM 900 CFM 19009 14251 66353 4761 CFM 4761 CFM Supply Fan Load Space Fan Coil Fans Duct Heat Gain / Loss 0% 0% >> Total System Loads 105169 28645 89563 Central Cooling Coil 105169 28656 Central Heating Coil 89563 >> Total Conditioning 105169 89563 Positive values are clg loads Positive values are htg loads

Negative values are htg loads

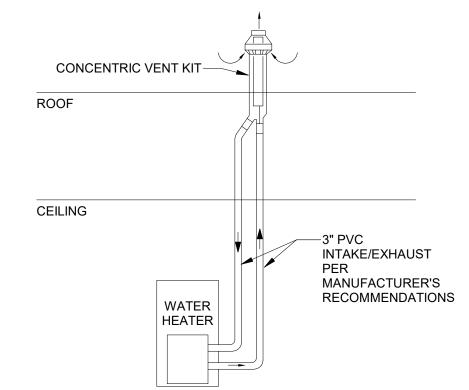

5 WATER HEATER VENT DETAIL

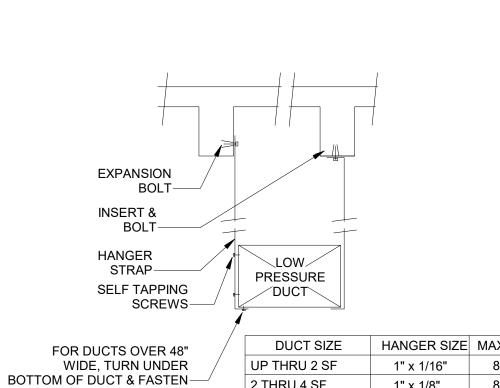

HANGER SIZE MAX SPACING 2 THRU 4 SF 1" x 1/8" 8'-0" 4 THRU 10 SF 6'-0" 1" x 1/8" OVER 10 SF 1" x 1/8" 4'-0"

Negative values are clg loads

DUCT HANGING DETAIL



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63039 PROJECT #: 88084-001 09-04-2020 K. GORIN-SLONSKI

ISSUE DATE SR. DESIGN MANAGER: PRODUCTION DESIGNER: A.MAUSER CHECKED BY: DMC / NJD **Revision Schedule**

Rev Date Description MECHANICAL DETAILS

SCALE: AS SHOWN

SHEET NUMBER:

STORE #:

M501

SCALE: NTS

SHOP FABRICATED SHT

SAME AS DIFFUSER NECK-

MTL CLG DIFFUSER


CAP NET INSIDE DIM.


-ROUND INSUL STUB DUCT

SAME SIZE AS FLEX DUCT

DAMPER TITUS AG-75 OR

OPPOSED BLADE

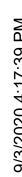


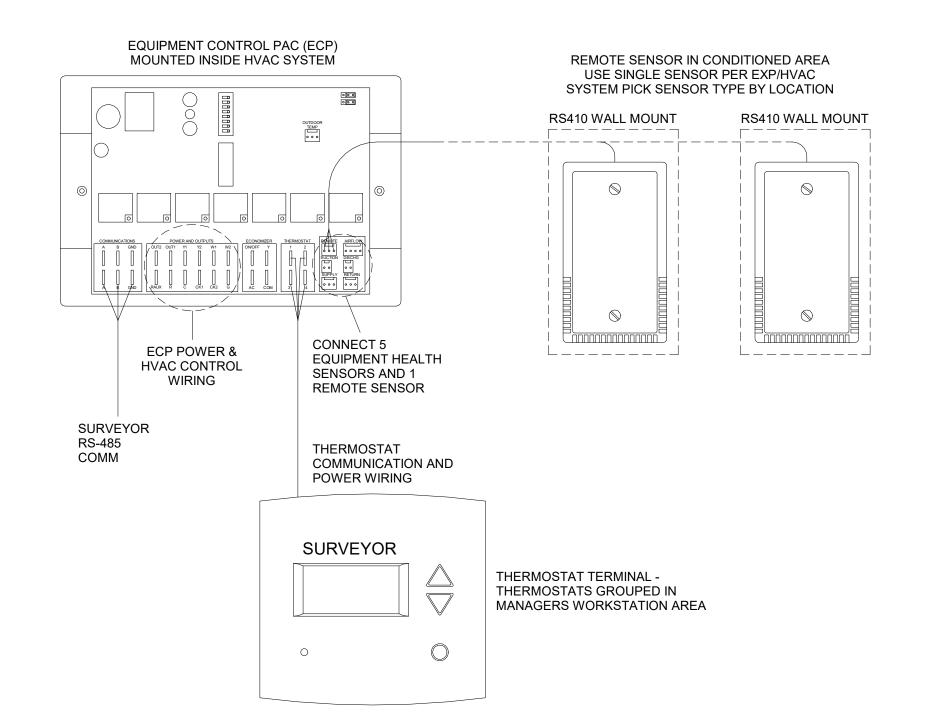

1. OUTDOOR TEMPERATURE SENSOR CONNECTED TO ONE ECP ONLY PER LOCATION. FACE NORTH WHEN POSSIBLE.

2. SEE GENERAL NOTES 7 AND 8 FOR REMOTE SENSOR MOUNTING LOCATION DETAILS.

Venstar EMS - No Lighting Control - HVAC Controls SCALE: NTS

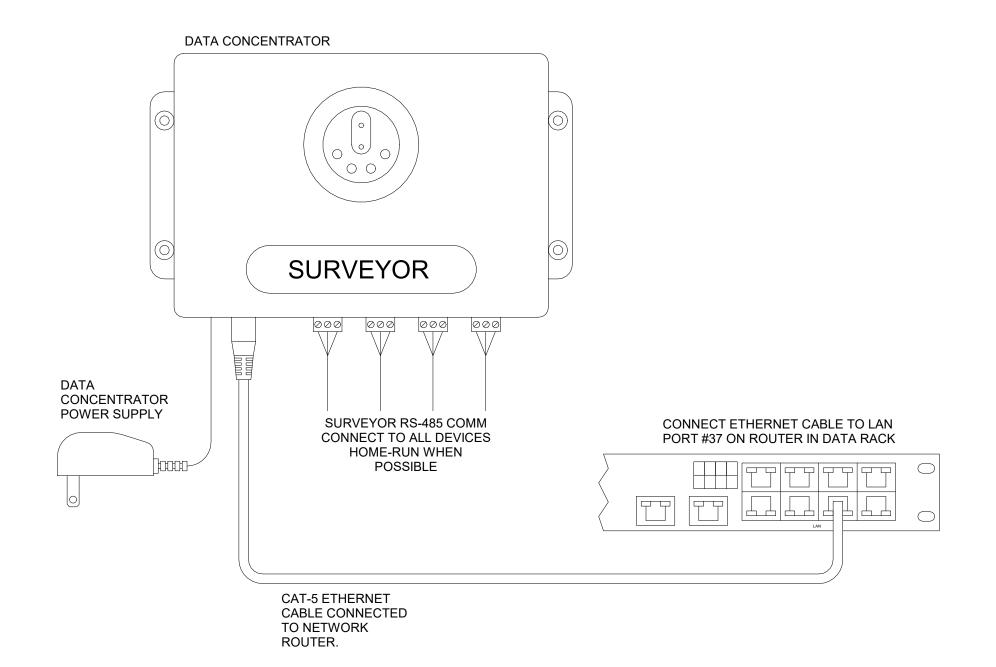


Venstar EMS - No Lighting Control - Data Concentrator

SCALE: NTS

GENERAL NOTES

- 1. SURVEYOR ENERGY MANAGEMENT SYSTEM HARDWARE IS SUPPLIED BY STARBUCKS.
- 2. DRAWING FOR GENERAL INFORMATION, DESIGN INTENT, AND COORDINATION ONLY.
- 3. LOCAL BUILDING CODES TAKE PRECEDENCE OVER THIS DOCUMENT.
- 4. NOT ALL WIRING IS SHOWN ON THIS DRAWING. FOR CLARITY, ONLY ONE EXAMPLE OF EACH TYPE OF DEVICE IS SHOWN.
- 5. REFER TO THE SURVEYOR INSTALLATION INSTRUCTIONS FOR EACH COMPONENT FOR DETAILED WIRING AND ADDITIONAL CRITICAL INFORMATION.
- 6. CAUTION! INSTALLATION REQUIRES THE REMOVAL OF SAFETY COVERS AND EXPOSE THE INSTALLER TO HIGH VOLTAGE AND ELECTRICAL HAZARDS. USE OF A LICENSED ELECTRICIAN IS REQUIRED. FOLLOW ALL APPROPRIATE SAFETY PRECAUTIONS. ADDITIONAL SAFETY INFORMATION IS IN THE SURVEYOR INSTALLATION MANUALS.
- 7. WALL MOUNTED REMOTE SENSOR IS MOUNTED ON WALL 4 TO 5 FT AFF. AVOID AREAS WITH DIRECT AIRFLOW FROM SUPPLY REGISTERS.
- 8. USE A DROP DOWN SENSOR IF A WALL MOUNT SENSOR CANNOT BE INSTALLED DUE TO SPACE CONSTRAINTS (SEE NOTE 7 FOR REQUIREMENTS). THE SENSOR CLIPS TO THE T-BAR GRID AND ADJUSTED SO THE BOTTOM OF THE SENSOR IS 8 TO 9 FT AFF. ALLOW 2 FT OF CLEARANCE FROM METRO SHELVING AND AVOID AREAS WITH DIRECT AIRFLOW FROM SUPPLY REGISTERS.
- 9. FOR SURVEYOR EMS TECHNICAL SUPPORT AND SYSTEM COMMISSIONING, CONTACT SURVEYOR TECHNICAL SUPPORT, (855) 647-7660, OPTION 1 OR EMAIL INSTALLSUPPORT@VENSTAR.COM. HOURS 6:00 AM TO 8:00 PM PACIFIC, MON-FRI.

	SURVEYOR EMS COMPONENTS								
VENSTAR PART	SBUX ITEM#	<u>DESCRIPTION</u>	<u>QUANTITY</u>						
DC400	011029485	DATA CONCENTRATOR	1						
OTS400	011029487	OUTDOOR TEMPERATURE SENSOR	1						
ECP400	011029489	EQUIPMENT CONTROL PAC	1 PER HVAC						
CT414	011029490	COMMUNICATING THERMOSTAT	1 PER HVAC						
SP400	011029491	SENSOR PAC	1 PER HVAC						
RS410	011029492	WALL MOUNT REMOTE SENSOR	1 PER HVAC						

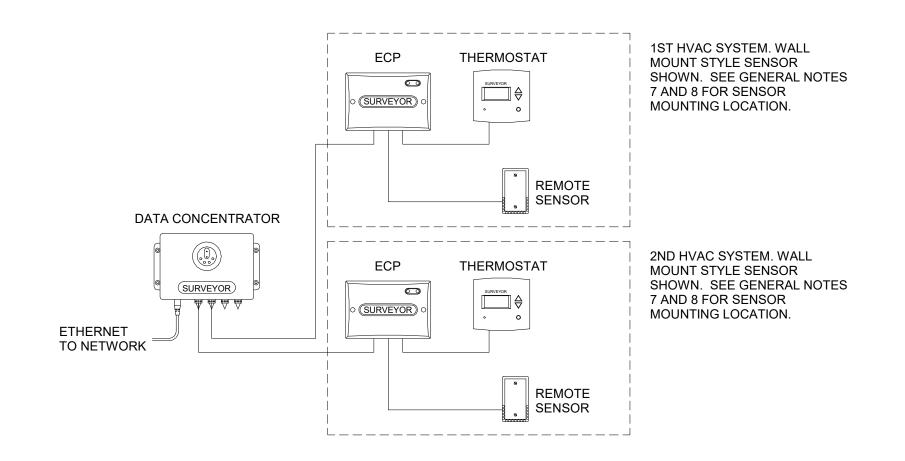

Venstar EMS - No Lighting Control - Basic Low Voltage Wire Runs



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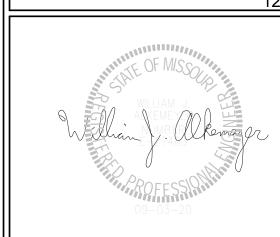
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STORE #: 63039 PROJECT #: 88084-001

ISSUE DATE: SR. DESIGN MANAGER: K. GORIN-SLONSKI PRODUCTION DESIGNER: A.MAUSER CHECKED BY: DMC / NJD

Revision Schedule					
Rev	Date	Ву	Description		

EMS DETAILS

SCALE: AS SHOWN

SHEET NUMBER:

CLG

EMER

EX

CO

ABBREVIATIONS

CONSTRUCTION CONST DOMESTIC COLD WATER CXA **COMMISSIONING AGENT** DEG **DEGREES** DN DOWN

EMERGENCY

EXISTING

CEILING

CLEANOUT

DTL DETAIL DWG(S) DRAWING(S) EΑ EC **ELECTRICAL CONTRACTOR** ELEC **ELECTRICAL**

EXT **EXTERIOR** FLOOR CLEANOUT FD FLOOR DRAIN F&I **FURNISH & INSTALL** FLR **FLOOR** FURNISHED BY OWNER. INSTALLED BY CONTRACTOR FURNISHED BY OWNER,

INSTALLED BY OWNER FEMALE PIPE THREAD FLOOR SINK FS FT FOOT/FEET **GENERAL CONTRACTOR**

GROUND FAULT CIRCUIT INTERRUPTER **GREASE INTERCEPTOR** GT **GREASE TRAP** GW **GREASE WASTE**

HR HOUR HS **HANDSINK** HEATING, VENTILATION, AND AIR HVAC CONDITIONING **HOT WATER**

HWS HOT WATER SUPPLY HWR HOT WATER RETURN **INSIDE DIAMETER**

LANDLORD

LV LOW VOLTAGE MAX MAXIMUM MC MECHANICAL CONTRACTOR

MDP MAIN DISTRIBUTION PANEL MECH MECHANICAL MEP MECHANICAL, ELECTRICAL, AND PLUMBING

MFG MANUFACTURER **MINIMUM** MS MOP SINK

OD **OUTSIDE DIAMETER** PC PLUMBING CONTRACTOR PREP SINK POINT OF CONNECTION

NIGHTLIGHT

NOT TO SCALE

NTS

REQ'D REQUIRED REV REVISION SHEET **SQUARE FEET** SOW

SCOPE OF WORK SPECS SPECIFICATION(S) SST STAINLESS STEEL TEL **TELEPHONE**

TEMP **TEMPORARY** TMV TEMPERATURE MIXING VALVE TW TEMPERED HOT WATER TYP TYPICAL

UC **UNDER COUNTER** UNO UNLESS NOTED OTHERWISE **VENT**

SANITARY WASTE WCO WALL CLEANOUT WH WATER HEATER WP WEATHER PROOF

YARD CLEANOUT (EXTERIOR)

PLUMBING SYMBOL LEGEND

—SAN. OR GW—	SAN. OR GW	SANITARY OR GREASE WASTE PIPING
V	V	VENT PIPING
CD	CD	CONDENSATE DRAIN PIPING
CW	CW	COLD WATER PIPING
——HW——	HW	HOT WATER PIPING
CWF	CWF	COLD WATER FILTERED PIPING
CWS	CWS	COLD WATER SOFTENED PIPING
TW	TW	TEMPERED WATER PIPING
G	G	GAS PIPING
M	BV	BALANCING VALVE
\bowtie	SOV	SHUT OFF VALVE
>,	НВ	HOSE BIBB
<u> </u>	WCO	WALL CLEANOUT
\oplus	FCO	FLOOR CLEANOUT
	FD	FLOOR DRAIN (SQUARE)
	FD	FLOOR DRAIN (ROUND)
0	HD	HUB DRAIN
0000000	FS	FLOOR SINK (SQUARE)
(III)	FS	FLOOR SINK (ROUND)
(WM	WATER METER
	GM	GAS METER
	BFP	BACKFLOW PREVENTER
	POC	CONNECT TO EXISTING

EXISTING PIPING SHOWN ON PLANS IN A LIGHTER SHADE

SYSTEM COMMISSIONING

CONTRACTOR RESPONSIBILITIES FOR BUILDING COMMISSIONING

CONTRACTOR SHALL PROVIDE SUPPORT AND WORK AS SPECIFIED. NEEDED AND REQUIRED TO CONDUCT AND FACILITATE STARBUCKS STAFF BUILDING COMMISSIONING EFFORTS. THIS WORK WILL BE COMPRISED OF THREE DISTINCT EFFORTS:

1) SUPPORT STARBUCKS COMMISSIONING AGENT (CXA) DURING INSTALLATION VERIFICATION AND CORRECT DISCLOSED

2) PERFORM TESTING, ADJUSTING, BALANCING AND SYSTEM STARTUP AND SUPPORT FUNCTIONAL PERFORMANCE TESTING BY STARBUCKS

3) CORRECT DEFICIENCIES DISCLOSED BY FUNCTIONAL PERFORMANCE TESTING AND SUBMIT REPORTS. CONTRACTOR SHALL PERFORM AND PROVIDE THE FOLLOWING:

A. SYSTEMS SUBJECT TO COMMISSIONING MAY INCLUDE, BUT ARE NOT LIMITED TO, DOMESTIC HOT WATER GENERATION.

B. CONTRACTOR SHALL INCLUDE COMMISSIONING ACTIVITIES IN PROJECT SCHEDULE AND SHOW INTERVALS FOR PERFORMANCE OF WORK FOR WHICH CONTRACTOR IS RESPONSIBLE AND INTERVALS FOR WORK PERFORMED BY STARBUCKS CXA. CONTRACTOR SHALL SHOW RESOURCES FOR PERFORMING ALL WORK RELATED TO COMMISSIONING ACTIVITIES ON A LINE ITEM IN THE SCHEDULE OF VALUES.

C. CONTRACTOR SHALL INSTALL EQUIPMENT IN ACCORDANCE WITH THE MANUFACTURER'S REQUIREMENTS AND ALL CONTRACT DOCUMENTS. ENSURE THAT ALL EQUIPMENT IS INSTALLED TOTALLY COMPLETE. AND ACCESSIBLE TO STARBUCKS CXA FOR INSTALLATION VERIFICATION AND FUNCTIONAL PERFORMANCE TESTING PRIOR TO THE SCHEDULED START OF INSTALLATION VERIFICATION.

D. INSTALLATION VERIFICATION SHALL BE PERFORMED BY STARBUCKS CXA. CONTRACTOR SHALL SUPPORT STARBUCKS CXA INSTALLATION VERIFICATION EFFORTS AS NECESSARY. PROVIDE ALL ACCESS AND EQUIPMENT NECESSARY FOR STARBUCKS STAFF TO VERIFY THAT THE EQUIPMENT IS INSTALLED CORRECTLY.

E. CONTRACTOR SHALL BE READILY AVAILABLE DURING INSTALLATION VERIFICATION TO CORRECT ANY DEFICIENCIES OR DEFECTS DISCLOSED BY THE INSTALLATION VERIFICATION PROCESS. CORRECTIONS SHALL BE MADE IN A TIMELY MANNER WITHOUT DISRUPTION OF THE CONSTRUCTION SCHEDULE.

F. ALL DOMESTIC WATER HEATING, RECIRCULATING, FILTER AND SOFTENING EQUIPMENT SHALL BE TESTED AND/OR ADJUSTED AND BALANCED BY THE CONTRACTOR'S TESTING, ADJUSTING AND BALANCE AGENT (SEE TESTING ADJUSTING AND BALANCING) OR THE MANUFACTURER'S CERTIFIED STARTUP REPRESENTATIVE AFTER THE SYSTEM IS VERIFIED TO BE COMPLETE AND CORRECT BY STARBUCKS CXA IN ACCORDANCE WITH THE REQUIREMENTS OF THESE DOCUMENTS. SEQUENCES OF OPERATION SHALL BE TESTED TO ENSURE THAT THEY OPERATE IN ACCORDANCE WITH THE CONTRACT REQUIREMENTS. DELIVERABLES: PRELIMINARY, WRITTEN FUNCTIONAL PERFORMANCE REPORT CONFORMING TO THE REQUIREMENTS SPECIFIED HEREIN, DOCUMENTING THE INFORMATION SPECIFIED, ETC. TO THE STARBUCKS CXA IMMEDIATELY UPON COMPLETION OF THE WORK.

G. CONTRACTOR SHALL INFORM STARBUCKS CXA WHEN EQUIPMENT IS READY FOR FUNCTIONAL PERFORMANCE TESTING. ALL EQUIPMENT SHALL BE READY FOR FUNCTIONAL PERFORMANCE TESTING PRIOR TO STARTING TESTING. CONTRACTOR SHALL OPERATE EQUIPMENT FOR STARBUCKS CXA AND VERIFY BY DEMONSTRATION THE CORRECT OPERATION OF EQUIPMENT, RESPONSE OF SENSORS, AND PROPER **EXECUTION OF HVAC CONTROL AND LIGHTING SEQUENCES:** INCLUDING BUT NOT LIMITED TO, AIR MOVEMENT, TEMPERATURE, SOUND, AND CONTROL RESPONSE. PROVIDE ANY SECURIT ACCESS, HARDWARE, SOFTWARE, OR OTHER SUPPORT AS NEEDED FOR THE STARBUCKS CXA TO EFFICIENTLY WITNESS AND DOCUMENT ALL EQUIPMENT TESTING. STARBUCKS CXA WILL RECORD THE EQUIPMENT OPERATION AND RESPONSE TO TESTING SEQUENCES AND PREPARE A LIST OF ANY DEFICIENCIES DISCLOSED BY THE FUNCTIONAL PERFORMANCE TESTS FOR CORRECTION BY THE CONTRACTOR. EQUIPMENT INCLUDES, BUT IS NOT LIMITED TO, AIR HANDLING UNITS. ROOFTOP AND SPLIT TYPE, CONDENSING UNITS, EXHAUST FANS, LIGHTING CONTROLS, ETC. DELIVERABLES: PROVIDE COMPLETED COPIES OF ALL START UP REPORTS, FILLED OUT ON THE MANUFACTURER'S FORMS, TO THE STARBUCKS CXA.

H. CONTRACTOR IS RESPONSIBLE FOR CORRECTING ANY ISSUES OR DEFICIENCIES DISCLOSED DURING THE FUNCTIONAL PERFORMANCE TESTING PROCESS. CORRECTIONS SHOULD BE MADE IN A TIMELY MANNER WITHOUT DISRUPTION TO THE SYSTEM AND CONSTRUCTION SCHEDULE.

I. CONTRACTOR SHALL BE READILY AVAILABLE FOR ANY RE-TESTING OF EQUIPMENT DEEMED NECESSARY BY STARBUCKS CXA DURING INSTALLATION VERIFICATION AND FUNCTIONAL PERFORMANCE TESTING. CONTRACTOR IS RESPONSIBLE FOR CORRECTING ANY ISSUES OR DEFICIENCIES FOUND IN THE SYSTEM DURING ANY AND ALL RE-TESTING. CORRECTIONS SHOULD BE MADE IN A TIMELY MANNER WITHOUT DISRUPTION TO THE SYSTEM AND CONSTRUCTION SCHEDULE. DELIVERABLES: FINAL BALANCE REPORT, DEFICIENCIES LIST NOTING CORRECTIVE ACTIONS PERFORMED BY CONTRACTOR IN RESPONSE TO INSTALLATION VERIFICATION AND FUNCTIONAL PERFORMANCE TEST RESULTS.

J. CONSTRUCTION AND POST CONSTRUCTION TESTING: ADDITIONAL TESTING MAY BE REQUIRED BY LEED AND OTHER PROCESSES THAT MAY OCCUR OUT OF SEQUENCE WITH COMMISSIONING SERVICE. CONTRACTOR SHALL CONDUCT, DOCUMENT, SUPPORT AND SCHEDULE THIS TESTING AS DIRECTED BY STARBUCKS CXA

VALVES

INSTALL VALVES FOR EACH FIXTURE AND ITEM OF EQUIPMENT. PROVIDE BRAIDED STAINLESS STEEL HOSE (UNLESS OTHERWISE NOTED) BETWEEN VALVE AND EQUIPMENT IN ACCORDANCE WITH MANUFACTURER'S SPECIFICATIONS. LOCATE SHUT-OFF VALVES ADJACENT TO EQUIPMENT FOR EASY ACCESS SUCH THAT VALVES CAN BE REACHED WITHOUT MOVING EQUIPMENT. SHUT OFF VALVES TO BE BALL TYPE. VALVES SHALL BE LISTED/APPROVED FOR USE PER AUTHORITIES HAVING JURISDICTION (AHJ) AND CODE REQUIREMENTS. PROVIDE VALVE IDENTIFICATION PER THE PROJECT MANUAL FOR MAIN WATER SERVICE SHUT-OFF AND ANY OTHER VALVES WHICH ARE NOT CLEARLY EVIDENT WHAT THEY SERVE.

PLUMBING FIXTURES

SIZE WATER HEATER PER STARBUCKS STANDARD AND PER AUTHORITIES HAVING JURISDICTION (AHJ), WHICHEVER IS MORE STRINGENT. PROVIDE INSTALLATION COMPLETE WITH FITTINGS AS SHOWN IN THE DRAWINGS. SET HOT WATER TEMPERATURE AT 140° F OR ADJUST AS REQUIRED BY AHJ. PROVIDE THERMOMETER ON HOT WATER PIPE LEAVING WATER HEATER.

STARBUCKS WATER FILTRATION VENDOR WILL PROVIDE FILTRATION SYSTEM. CONTRACTOR SHALL CONFIRM WITH STARBUCKS CONSTRUCTION MANAGER WHETHER VENDOR OR PLUMBING CONTRACTOR IS TO INSTALL FILTRATION SYSTEM. PROVIDE AND COORDINATE INSTALLATION COMPLETE WITH ALL PIPING, FITTINGS, AND EQUIPMENT AS INDICATED ON THE DRAWINGS.

THE PLUMBING CONTRACTOR SHALL MAKE ALL FINAL CONNECTIONS TO EQUIPMENT INCLUDING REQUIRED MATERIAL SUCH AS PIPING. VALVES. FILTERS, TRAPS, CHECKS VALVES, VACUUM BREAKERS, AND FLEXIBLE AND RIGID TUBING.

SCHEDULES

REFER TO SCHEDULES ON DRAWINGS FOR A DESCRIPTION OF LISTED ITEMS AND FURNISH ANY AND ALL PLUMBING FIXTURES LISTED AS "GC". ANY DISCREPANCIES ABOUT WHO IS TO PROVIDE PLUMBING FIXTURES IN THE SCHEDULE SHALL BE BROUGHT TO STARBUCKS ATTENTION FOR CLARIFICATION. INSTALL ALL FIXTURES LISTED REGARDLESS OF WHO SUPPLIES.

G.C. TO FURNISH AND INSTALL POWER CORD FOR DISHWASHER PER JURISDICTIONAL REQUIREMENTS. IF EQUIPMENT IS SPECIFIED AS <u>HOBART ADVANSYS,</u> THE UNIT IS TO BE PLUMBED WITH COLD, NON-FILTERED WATER. IF THE WATER FILTRATION SYSTEM IS A PENTAIR CONFIGURATION II OR III, THEN THE COLD, NON-FILTERED WATER MUST ALSO BE SOFTENED.

INSULATION

PROVIDE THERMAL INSULATION PER THE SPECIFICATIONS.

FURNISH AND INSTALL SPECIFIED NO SCALD SAFETY COVERS WITH INSULATED FOAM LINER AND TAMPER PROOF STRAP AT ALL EXPOSED ADA SINK P-TRAPS AND WATER SUPPLIES AND AS REQUIRED BY JURISDICTION

<u>CONDENSATE DRAINAGE PIPING</u>

THE PLUMBING CONTRACTOR SHALL PROVIDE CONDENSATE DRAINS FOR AIR HANDLING UNITS AND STARBUCKS EQUIPMENT (REFER TO COPPER TUBING WITH WROUGHT COPPER SWEAT FITTINGS JOINED WITH 50/50 SOLDER.

ALL PIPES SHALL BE TESTED BY AN APPROVED METHOD BEFORE THEY BACKFILLED OR CONCEALED. AFTER TESTING IS COMPLETE, THE

PLUMBING CONTRACTOR SHALL DISINFECT THE POTABLE WATER SYSTEM AS REQUIRED BY LOCAL AUTHORITY. TEST WATER PURITY ACCORDING TO LOCAL REQUIREMENTS AND SUBMIT CERTIFIED TEST RESULTS TO ENGINEER FOR REVIEW AND APPROVAL

CARBONATION

IF APPLICABLE TO PROJECT SCOPE FOR CBE STATION. STARBUCKS CARBONATION VENDOR WILL PROVIDE AND INSTALL EQUIPMENT, CO2 TANKS AND FITTINGS. STARBUCKS SHALL PROVIDE AND CONTRACTOR SHALL INSTALL CO2 TANK MOUNTING BRACKET, PROTECTIVE SHELVING UNIT AND CO2 GAS TUBING AS SHOWN ON DRAWINGS AND PER MANUFACTURER'S INSTRUCTIONS. MAXIMUM TUBING LENGTH INCLUDING COILED ENDS IS 100 FT (30 M) AND MAXIMUM BEND IS TO 3 INCH (75 MM) MINIMUM RADIUS. ROUTE CO2 TUBING PREFERABLY THROUGH WALL AND/OR CEILING CAVITIES, WITHOUT KINKS AND SO AS TO NOT TOUCH ANY HOT SURFACE (BALLAST, STEAM PIPE, ETC.) OR RUB AGAINST A SHARP EDGE THAT MAY ABRADE OR CUT TUBING. ALL HOLES MUST BE SEALED WITH A GROMMET OR ESCUTCHEON. TUBING IS TO BE SECURED TO APPROPRIATE PERMANENT SURFACES TO KEEP IT OFF THE FLOOR OR CABINET BOTTOMS AND AWAY FROM OTHER EQUIPMENT. LABEL BOTH ENDS OF TUBING AND REGULARLY AT TEN (10) FOOT INTERVALS ALONG ROUTE AS "CO2."

NITROGENATION

STARBUCKS NITROGENATION VENDOR WILL PROVIDE AND INSTALL EQUIPMENT AND FITTINGS IF APPLICABLE TO PROJECT SCOPE FOR NITRO STATION. GENERAL CONTRACTOR SHALL COORDINATE NITRO SYSTEM INSTALLATION WITH STARBUCKS VENDOR.

GENERAL PLUMBING NOTES

- 1. PLUMBING CONTRACTOR SHALL COORDINATE WITH THE GENERAL CONTRACTOR TO PATCH AND REPAIR ALL EXISTING WALLS, FLOORS, CEILINGS OR OTHER SURFACES IDENTIFIED TO REMAIN THAT MAY BECOME DAMAGED DURING THE COURSE OF WORK.
- 2. EXPOSED/SURFACE MOUNTED PIPING IS ONLY ALLOWED IN THE BAR AREA UNDER COUNTERTOPS, WHERE IT DOES NOT OBSTRUCT CABINETS/DEVICES AND WHERE APPROVED BY STARBUCKS CONSTRUCTION MANAGER. IF ROUTED THROUGH CABINETS, IT SHALL BE ROUTED TO MAXIMIZE STORAGE SPACE AND BE PROTECTED FROM DAMAGE.
- 3. DRAWINGS ARE DIAGRAMMATIC AND INDICATE GENERAL INTENT OR ARRANGEMENT OF SYSTEM(S). FURNISH AND INSTALL ALL COMPONENTS NEEDED WHETHER INDICATED OR NOT TO PROVIDE A COMPLETE AND OPERATING SYSTEM. OVERALL CASEWORK COMPONENT DIMENSIONING ON PLUMBING DETAILS ARE SHOWN FOR REFERENCE AND COORDINATION ONLY.
- 4. CONTRACTOR TO VERIFY ALL DIMENSIONS, INCLUDING CLEARANCES REQUIRED BY OTHER TRADES, AND NOTIFY STARBUCKS CONSTRUCTION MANAGER OF ANY DISCREPANCIES PRIOR TO PROCEEDING WITH THE WORK. ALL DIMENSIONS ARE TO THE FACE OF THE FINISHED SURFACE UNLESS NOTED OTHERWISE. ALL DIMENSIONS TO BE TAKEN FROM ACTUAL BUILDING DIMENSIONS
- THE PLUMBING CONTRACTOR SHALL COORDINATE PLUMBING WORK WITH OTHER TRADES. THE ARCHITECTURAL DRAWINGS AND SPECIFICATIONS SHALL TAKE PRECEDENCE OVER ALL OTHER DRAWINGS. SEE ARCHITECTURAL DRAWINGS FOR FIXTURES IN CASEWORK AND PLUMBING DETAILS. SEE THE PROJECT MANUAL FOR PLUMBING SPECIFICATION SECTIONS.
- 6. ALL PIPING AND/OR PLUMBING DEVICES SHALL BE SUPPORTED FROM STRUCTURE (NOT FROM HVAC DUCTS OR OTHER PIPES/CONDUITS).
- 7. WHEN BUNDLING SEVERAL INDIRECT WASTE LINES TO DRAIN INTO FLOOR SINK, A UNISTRUT IS REQUIRED FOR SECURING AND BRACING ALL LINES ABOVE THE DRAIN.
- 8. FURNISH AND INSTALL ALL NEEDED DRAIN LINES PER CODE (NOT ALL SHOWN). INSTALL DRAINS AT 2% SLOPE WHERE POSSIBLE WITHOUT DIPS OR SAGS. ALL INDIRECT DRAINS SHALL RUN SEPARATELY FROM EACH OTHER TO INDIRECT DRAIN RECEPTOR AND SHALL TERMINATE WITH AN AIR GAP PER CODE.
- 9. FURNISH AND INSTALL WALL CLEANOUTS AT ALL SINKS AND AS NEEDED PER CODE (NOT ALL SHOWN).
- 10. INSULATE ICE BIN DRAINAGE PIPES PER THE REQUIREMENTS IN THE PROJECT MANUAL.

GENERAL NOTES

THE INTENT OF THE PROJECT MANUAL AND THE DRAWINGS IS TO PROVIDE A COMPLETE AND FULLY OPERATIONAL PLUMBING SYSTEM. THE CONTRACTOR SHALL FURNISH ALL LABOR, MATERIAL, AND EQUIPMENT RELATED TO THE INSTALLATION OF THE PLUMBING WORK.

HE CONTRACTOR SHALL THOROUGHLY EXAMINE ALL AREAS WHERE FIXTURES, EQUIPMENT, AND PIPING WILL BE INSTALLED AND WILL REPORT ANY CONDITION THAT PREVENTS THE PROPER INSTALLATION OF THE PLUMBING WORK.

EQUIPMENT AND MATERIALS SHALL CONFORM WITH THE APPROPRIATE PROVISIONS OF LISTING STANDARD IN EFFECT AS APPLICABLE TO EACH INDIVIDUAL UNIT OR ASSEMBLY.

ALL WORK SHALL BE PERFORMED IN STRICT ACCORDANCE WITH ALL APPLICABLE PROVINCIAL AND LOCAL CODES AND ORDINANCES. IN CASE OF CONFLICT BETWEEN THE DRAWINGS AND SPECIFICATIONS AND THE CODES AND ORDINANCES. THE HIGHEST STANDARD SHALL APPLY. THE CONTRACTOR SHALL SATISFY CODE REQUIREMENTS AS A MINIMUM STANDARD WITHOUT ANY EXTRA COST TO STARBUCKS.

THE CONTRACTOR SHALL PROCURE AND PAY FOR ALL PERMITS. FEES. AND INSPECTIONS NECESSARY TO COMPLETE THE PLUMBING WORK.

HE CONTRACTOR SHALL UNCONDITIONALLY WARRANT ALL WORK TO BE FREE OF DEFECTS IN MATERIAL AND WORKMANSHIP FOR A PERIOD OF ONE (1) YEAR FROM THE DATE OF FINAL ACCEPTANCE BY STARBUCKS AND WILL REPAIR OR REPLACE ANY DEFECTIVE WORK PROMPTLY AND WITHOUT CHARGE AND RESTORE ANY OTHER EXISTING WORK DAMAGED IN THE COURSE OF REPAIRING DEFECTIVE MATERIALS AND WORKMANSHIP.

LANDLORD REQUIREMENTS

PRIOR TO BID: THE CONTRACTOR SHALL COORDINATE WITH LANDLORD / BUILDING OWNER FOR ANY CONSTRUCTION REQUIREMENTS. CONTRACTOR SHALL BECOME COMPLETELY FAMILIAR WITH REQUIREMENTS AND ADHERE TO THEM. WHERE LANDLORD / BUILDING OWNER REQUIREMENTS ARE MORE STRINGENT THAN SHOWN IN THESE PLANS. LANDLORD / BUILDING OWNER REQUIREMENTS SHALL GOVERN.



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STARBUCKS

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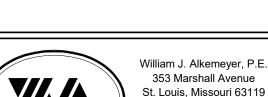
THESE DRAWINGS AND THE PROJECT MANUAL ARE CONFIDENTIAL AND SHALL REMAIN THE SOLE PROPERTY O STARBUCKS CORPORATION, WHICH IS THE OWNER OF THE COPYRIGHT IN THIS WORK. THEY SHALL NOT BE REPRODUCE (IN WHOLE OR IN PART), SHARED WITH THIRD PARTIES OR USED IN ANY MANNER ON OTHER PROJECTS OR EXTENSIONS TO THIS PROJECT WITHOUT THE PRIOR WRITTEN CONSENT OF STARBUCKS CORPORATION. THESE DRAWINGS AND SPECIFICATIONS ARE INTENDED TO EXPRESS DESIGN INTENT FOR A PROTOTYPICAL STARBUCKS STORE (WHICH IS SUBJEC TO CHANGE AT ANYTIME) AND DO NOT REFLECT ACTUAL SITE CONDITIONS. NEITHER PARTY SHALL HAVE ANY OBLIGATION

STARBUCKS TEMPLATE VERSION i2020-01-31

NOR LIABILITY TO THE OTHER (EXCEPT STATED ABOVE) UNTIL A

WRITTEN AGREEMENT IS FULLY EXECUTED BY BOTH PARTIES





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Engineering Consultant

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STORE #: 63039 PROJECT #: 88084-001 ISSUE DATE: 09-04-2020

PRODUCTION DESIGNER: A.MAUSER

Revision Schedule

CLL / SMD

SR. DESIGN MANAGER: K. GORIN-SLONSKI

Description

PLUMBING NOTES

SCALE: AS SHOWN

CHECKED BY:

SHEET NUMBER:

CROSS CONNECTI	ON CO	NTROL S	CHEDUL
FIXTURE	MAKE	MODEL	ASSE, ASME O
MOP SINK (FAUCET CONTAINS	WATTS &	9DM2-S	ASSE 1012
INTEGRAL BACKFLOW DEVICE)	INTEGRAL	-	ASSE 1001
DISHWASHER	WATTS	LF008PCQT	ASSE 1056
ICE MACHINE	AIR GAP	INTERNAL	ASME A112.1.2
COFFEE BREWER	WATTS	SD-3	ASSE 1022
ESPRESSO MACHINE	WATTS	SD-3	ASSE 1022
WATER FILTER SYSTEM	WATTS	LF009QT	ASSE 1013
CHEMICAL DISPENSER	WATTS	LF009 W/ AIR GAP	ASSE 1013
		FITTING 909AGA	
FREEZEPROOF HOSEBIBB	WATTS	LF8	ASSE 1011
HOSEBIBB FOR CHEM. DISP. @ MSB	WATTS	LF8	ASSE 1011
BLENDER PITCHER RINSER	WATTS	SD-3	ASSE 1022
3-COMPARTMENT SINK	AIR GAP	-	ASME A112.1.2
WORK SINK	AIR GAP	-	ASME A112.1.2
HAND SINKS	AIR GAP	-	ASME A112.1.2
DROP-IN SINKS	AIR GAP	-	ASME A112.1.2
LAVATORIES	AIR GAP	-	ASME A112.1.2
WATER CLOSETS (FLUSH VALVE)	WATTS	118A	ASSE 1001
WATER HEATER	WATTS	LFN36	ANSI Z21.22
BUILDING WATER SUPPLY	WATTS	LF009 M2-QT	ASSE 1013
(BY LANDLORD)		OR EQUAL	
ALL BRASS VALVES SHALL COMPLY V	WITH THE 201	14 EPA LEAD FREE	REQUIREMENT

10597 / 13588		•	400	_	4=
	HAND SINKS	3	100	5	15
10597	LAVATORIES	2	100	5	10
10152 / 10215	DROP-IN SINK	3	100	10	30
FUTURE EQ.	DROP-IN SINK	1	100	10	10
10922	MOP SINK BASIN	1	100	5	5
10447 / 10804	3 COMPARTMENT SIN	NK 1	100	50	50

130,000 BTUH WATER HEATER TO BE INSTALLED. SEE SPECIFICATION ON SHEET P601.

GAS LINE CALCULATION							
TAG	МВН	GAS LINE SIZE TO EQUIPMENT					
RTU-1	224	1-1/4"					
RTU-2	180	1"					
WH	130	1"					
TOTAL MBH =	534	TOTAL PIPE SIZE = 1-1/2"					

GAS PIPING IS SIZED PER TABLE 402.4(2) OF THE 2018 INTERNATIONAL FUEL & GAS CODE AND A DISTANCE OF 80' TO THE FURTHEST PIECE OF EQUIPMENT FROM THE METER.

PLUMBING SUPPLY GENERAL NOTES

- A. FURNISH AND INSTALL A COMPLETE AND OPERATING SYSTEM. ALL ITEMS ARE NOT NECESSARILY SHOWN.
- B. PLUMBING CONTRACTOR RESPONSIBLE FOR SITE INVESTIGATION PRIOR TO START OF WORK TO REVEAL FULL SCOPE OF WORK.
- C. ALL PLUMBING LINES TO BE ROUTED SUCH THAT THEY ARE NOT VISIBLE TO CUSTOMERS EXCEPT WHERE FIRST APPROVED BY STARBUCKS AT EXPOSED CEILING AREAS.
- D. REFER TO MANUFACTURER SPECIFICATIONS FOR LOCATION OF CONNECTIONS UNLESS OTHERWISE NOTED.
- E. COORDINATE WITH ELECTRICAL CONTRACTOR FOR POWER CONNECTION TO ALL PLUMBING EQUIPMENT.
- F. REFERENCE WORK LETTER FOR DIVISION OF PLUMBING SCOPE OF WORK AND COORDINATE WITH STARBUCKS CONSTRUCTION MANAGER
- G. DIMENSIONS ARE TO FINISH FACE UNLESS OTHERWISE NOTED.
- H. REFER TO DETAIL SHEETS FOR PLUMBING FITTINGS LOCATED IN CASEWORK.
- I. COLD WATER SUPPLY LINES INSIDE CASEWORK AND BAR AREA TO BE COVERED WITH (10MM) THICK SELF SEALING, SECTIONAL CLOSED-CELL FOAM INSULATION. REFER TO SPECIFICATIONS FOR HOT WATER SUPPLY LINE INSULATION REQUIREMENTS.
- J. INSULATE ALL PIPING INCLUDING PIPES AT BAR AND IN CASEWORK PER THE REQUIREMENTS LISTED IN THE PLUMBING PROJECT MANUAL.
- K. GENERAL CONTRACTOR SHALL CONTACT WATER FILTRATION SUPPLIER TO COORDINATE SOW AND SCHEDULE PRIOR TO INSTALLATION OF WATER FILTRATION SYSTEM.

PLUMBING SUPPLY KEYED NOTES

- 1" CSW & 3/4" HWR TO WATER HEATER & 1" HW FROM WATER HEATER. WATER HEATER AS SPECIFIED AND IN COMPLIANCE WITH APPLICABLE CODES AND ORDINANCES. DIMENSIONS OF THE HEATER SHALL ALLOW INSTALLATION ABOVE THE MOP SINK. REFER TO WATER HEATER DETAIL ON SHEET P501.
- 1/2" HW & CW TO FAUCET AT MOP SINK. CAULK AND SEAL BACK OF SINK TO WALL. PROVIDE TACO MODEL 5122 OR APPROVED ASSE 1070 EQUAL POINT OF USE THERMOSTATIC MIXING VALVE AT MOP SINK TO PROVIDE 120° WATER.
- 1" CW TO WATER FILTER AND 1" CSW & 3/4" CWF FROM WATER FILTER. PLUMBING CONTRACTOR TO FOLLOW MANUFACTURER'S INSTALLATION INSTRUCTIONS AND ACTIVATION PROCEDURES FOR FILTERS. VERIFY REQUIREMENTS PRIOR TO BID. SEE DETAIL ON SHEET P501.
- 3/4" HW & CW TO FAUCET AND SPRAY AT COMPARTMENT SINK, CAULK AND SEAL BACK OF SINK TO WALL. PROVIDE TACO MODEL 5123 OR APPROVED ASSE 1070 EQUAL POINT OF USE THERMOSTATIC MIXING VALVE AT COMPARTMENT SINK TO PROVIDE 120° WATER.
- 3/4" CSW TO DISHWASHER. INSTALL SHUT-OFF WITH 3/4" MALE HOSE-END FITTING @ 18" A.F.F. UNDER COMPARTMENT SINK. SHUT-OFF TO INCLUDE PRESSURE REDUCING VALVE, PRESSURE GAUGE (SET @ 20 PSI, +/- 5 PSI), LINE STRAINER, AND SHOCK ARRESTOR IN WALL. CONNECT SANITIZER TO CSW SUPPLY WITH 72" LONG BRAIDED STAINLESS STEEL HOSE. PROVIDE 3/8" TEE OFF OF COLD WATER LINE SERVING 3-COMPARTMENT SINK AND CONNECT TO DRAIN WATER TEMPERING KIT ACCESSORY ON DISHWASHER TO PROVIDE 140° MAX. WASTE WATER DISCHARGE TO DRAINAGE SYSTEM.
- 1/2" CWF TO ICE MACHINE. REDUCE TO 3/8" AT MACHINE. PW06
 - 1/2" HW & CW TO SINK. PROVIDE TACO MODEL 5122 OR APPROVED EQUAL POINT OF USE THERMOSTATIC MIXING VALVE AT EACH HAND SINK TO PROVIDE 110° TEMPERED WATER.
- 3/4" CWF TO SERVE COFFEE BREWER AND FUTURE AERO BREWER. INSTALL SHUT-OFFS IN CABINET @ 24" AFF. REDUCE TO 3/8" AT UNIT. PROVIDE ASSE 1022 BACKFLOW PREVENTER. PROVIDE CWF STUB FOR FUTURE AERO BREWER PER STARBUCKS GUIDELINES
- 1/2" CWF TO ESPRESSO MACHINE PUMP. SEE DETAIL PROVIDED ON SHEET P501. PW09 PROVIDE ASSE 1022 BACKFLOW PREVENTER.
- PW10 1/2" CW TO DIPPERWELL FAUCET. REDUCE TO 1/4" AT UNIT.
- PW11 1/2" CWF TO INSTAHOT TAP. REDUCE TO 1/4" AT UNIT.

PROVIDE 120° HOT WATER.

PW12 1/2" CWF TO WATER TOWER FAUCET LOCATED IN WATER STATION.

ROUTING IN FIELD WITH GC PRIOR TO INSTALLATION.

- 1" CW TO TOILET. PROVIDE WATER HAMMER ARRESTOR IN SUPPLY LINE. PW13
- 3/4" CWF, CW AND HW TO DROP DOWN IN WALL, ROUTE UNDERSLAB AND STUB UP IN CABINETRY FOR FRONT BAR AREA. CONNECT TO EQUIPMENT (2) 15749, (2) 19277, (2) 11003 AND (2) 19742. REFER TO NOTES 9, 10, 11, AND 20. VERIFY
- 1/2" HW & CW TO SINK. PROVIDE TACO MODEL 5122 OR APPROVED ASSE 1070 EQUAL POINT OF USE THERMOSTATIC MIXING VALVE AT EACH WORK SINK TO
- 1/2" CW SUPPLY TO PITCHER RINSER SINK. PROVIDE AN ASSE 1022 BACKFLOW PREVENTER AND ANY ADDITIONAL VALVES AS REQUIRED BY CODE AND MANUFACTURES INSTALLATION INSTRUCTIONS.
- MAKE CONNECTION TO 2" WATER LINE STUBBED INTO PREMISES BY LANDLORD. LANDLORD TO PROVIDE METER AND BACKFLOW PREVENTER IN LOCATION SHOWN. VERIFY THAT THE DOMESTIC WATER SERVICE IS ADEQUATE TO SUPPLY A MINIMUM OPERATING FLOW RATE OF 50 GALLONS PER MINUTE; AT A MINIMUM 50 PSIG AND A MAXIMUM OF 65 PSIG DYNAMIC PRESSURE AT ALL TIMES. IF FLOW RATE OR PRESSURE IS NOT SUFFICIENT, LANDLORD SHALL SIZE, FURNISH AND INSTALL A BOOSTER PUMP IN A LOCATION AGREED UPON WITH THE TENANT. ENTIRE INSTALLATION SHALL BE IN ACCORDANCE WITH LOCAL CODES. CONTRACTOR SHALL FIELD VERIFY REQUIREMENTS PRIOR TO BID. BID SHALL INCLUDE ALL WORK NECESSARY FOR A FULLY OPERATIONAL SYSTEM. SEE LANDLORD & CIVIL DRAWINGS FOR ADDITIONAL INFORMATION AND
- FREEZE PROOF HOSE BIBS BY LANDLORD. COORDINATE PROVISION OF HOSE BIBS WITH LANDLORD AND VERIFY REQUIREMENTS PRIOR TO COMMENCING WORK. HOSE BIB MUST BE CONNECTED TO 1/2" INSULATED, COPPER PIPE AND RUN WITHIN CONDITIONED SPACE. IT MUST BE EXPOSED AND VISIBLE FOR TENANT'S CONNECTION. VERIFY LOCATION WITH CONSTRUCTION MANAGER.
- PROVIDE A BACKFLOW PREVENTER FOR CHEMICAL DISPENSERS AT MOP SINK AND 3-COMPARTMENT SINK AS REQUIRED BY AHJ. VERIFY REQUIREMENTS PRIOR
- 1/2" CW SUPPLY FOR IN-COUNTER RINSER AT 20-1/2" AFF FOR BACK BAR PITCHER RINSER. FRONT BAR PITCHER RINSERS TO BE ROUTED FROM UNDER COUNTER WATER PIPING. SEE NOTE 14 FOR ADDITIONAL INFORMATION.
- INSTALL N/2-FUSION NITRO DISPENSING SYSTEM PER MANUFACTURER'S RECOMMENDATIONS. COORDINATE ROUTING, INSTALLATION AND RESPONSIBILITY WITH GENERAL CONTRACTOR AND STARBUCKS NITROGENATION VENDOR.
- PROVIDE 3/4" CWF AND 1/2" HW & CW DROP FOR WATER FILLING STATION.
- PW23 1/2" CW DOWN IN WALL TO ACCESSIBLE TRAP PRIMER FOR FLOOR DRAIN BY LANDLORD.

CONTINUATION.

- MAKE CONNECTION TO NATURAL GAS LINE STUB BY LANDLORD. LANDLORD TO PROVIDE METER AND ANY REQUIRED VALVING. VERIFY THAT SERVICE IS ADEQUATE TO SUPPLY 534 MBH. ALL WORK SHALL BE COMPLETED IN ACCORDANCE WITH LOCAL CODES. BID SHALL INCLUDE ALL WORK FOR A FULLY OPERATIONAL SYSTEM. ALL GAS PIPE SIZES SHOWN FOR LOW PRESSURE (LESS THAN 2 LBS.). VERIFY EXACT LOCATION, PRESSURE AND REQUIREMENTS ON SITE. SEE LANDLORD & CIVIL DRAWINGS FOR ADDITIONAL INFORMATION AND
- 1-1/4" GAS TO MECHANICAL RTU-1 ON ROOF WITH APPROVED SHUT-OFF VALVE & DIRT LEG BY LANDLORD.
- 1" GAS TO MECHANICAL RTU-1 ON ROOF WITH APPROVED SHUT-OFF VALVE & DIRT LEG BY LANDLORD.
- MAKE CONNECTION TO LANDLORD PROVIDED STUB AND EXTEND 1" GAS TO WATER HEATER WITH APPROVED SHUT-OFF VALVE & DIRT LEG.
 - 3/4" CW, CFW AND HW DOWN IN WALL FOR FUTURE EQUIPMENT CONNECTION. PROVIDE WITH SHUTOFF VALVE. FIELD VERIFY ROUTING OF PIPING PRIOR TO COMMECING WORK.



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Engineering Consultant

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STORE #: 63039 PROJECT #: 88084-001 ISSUE DATE: 09-04-2020 SR. DESIGN MANAGER: K. GORIN-SLONSKI


PRODUCTION DESIGNER: A.MAUSER CHECKED BY: CLL / SMD

> **Revision Schedule** Description

PLUMBING SUPPLY PLAN

SHEET NUMBER:

SCALE: AS SHOWN

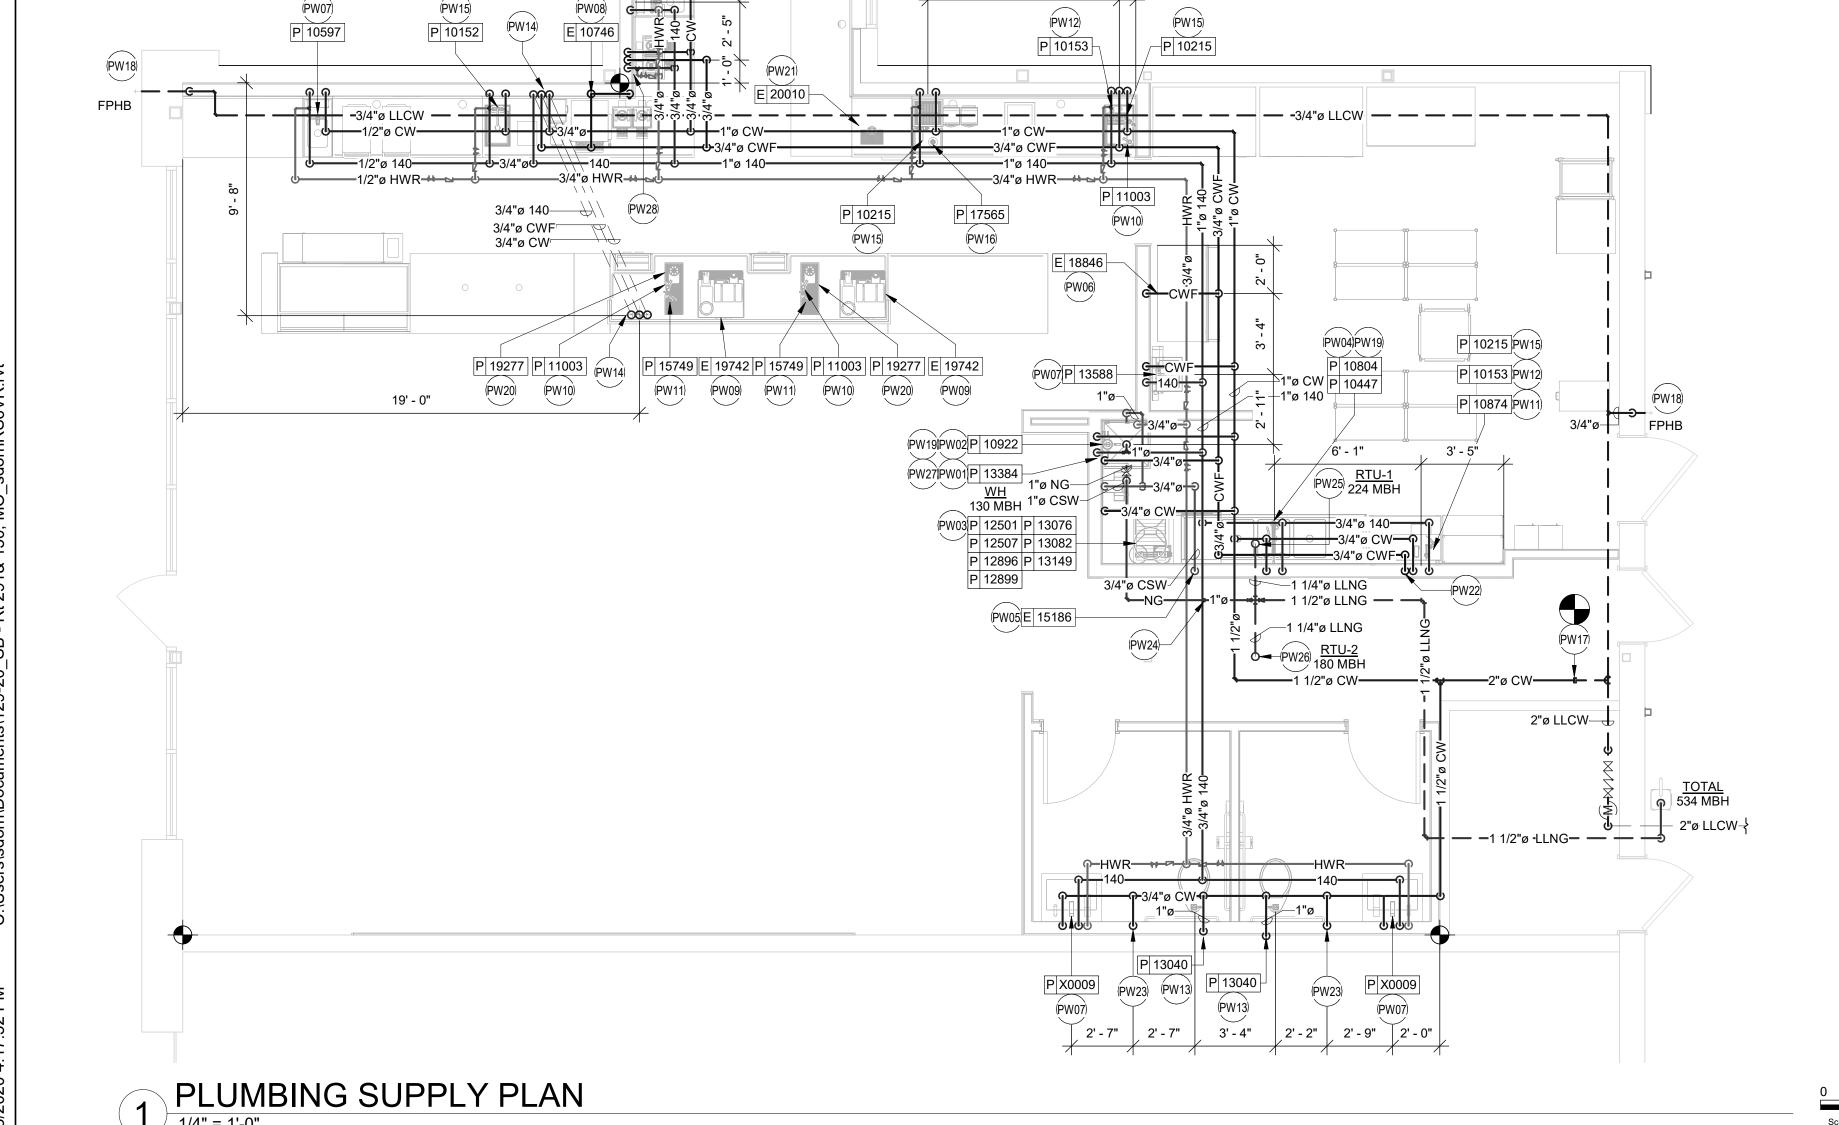

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GREASE INTERCEPTOR CALC.					
DESCRIPTION	QTY	F.U. EACH	TOTAL		
MOP SINK	1	3	3		
3" OUTLET FLOOR SINK	7	5	35		
3" OUTLET FLOOR DRAIN	2	5	10		
HAND SINK	3	1	3		
TOTAL D.F.U.			51		
51 D.F.U / 2 = 25.5 GPM					
25.5 GPM X 30 MINUTE RETENTION TIME =		765	GALLONS		

1,000 GALLON MINIMUM GREASE INTERCEPTOR REQUI CIVIL PLANS, LANDLORD IS TO INSTALL A 1,500 GALLON GREASE INTERCEPTOR.

OR CA	ALC.	DFU CALCU	JLA [°]	TION	
F.U. EACH	TOTAL	DESCRIPTION	QTY	F.U. EACH	TOTAL
3	3	WATER CLOSET	2	4	8
5	35	LAVATORY	2	1	2
5	10	MOP SINK	1	3	3
1	3	3" OUTLET FLOOR SINK	7	5	35
	51	3" OUTLET FLOOR DRAIN	4	5	20
	25.5 GPM	HAND SINK	3	1	3
765	GALLONS	TOTAL D.F.U.	'		71
UIRED. PER LA	NDLORD'S	71 D.F.U = 4" MINIMUM SANITARY SEWER			

7' - 10" 21' - 0" 7' - 7" C 17809 - C E 10344 P 17632 P 12808 C 17809 P 10549 ⊚FCO | (PS14)P 10594 □ 10294 E 18846 PS0. E 19278 (PS07) P 10726 P 10294 P 19277 P 10726 PS08 E 19742 PS09 P 14688 (PS10) P 10726 P 10294 P 10726 P 10294 P 12501 P 13076 P 12507 P 13082 P 12896 P 13149 P 12899 (2) P 10594 └GW 5' - 3" FCO LLGW - - -P|X0008||P|10594||P|12951| |P| 12951 | P| 10594 ||P| X0008

PLUMBING WASTE GENERAL NOTES

- A. ALL PLUMBING LINES TO BE ROUTED SUCH THAT THEY ARE NOT VISIBLE TO CUSTOMERS EXCEPT WHERE FIRST APPROVED BY STARBUCKS AT EXPOSED CEILING AREAS.
- B. REFER TO MANUFACTURER SPECIFICATIONS FOR LOCATION OF CONNECTIONS UNLESS OTHERWISE NOTED.
- C. COORDINATE WITH ELECTRICAL CONTRACTOR FOR POWER CONNECTION TO ALL PLUMBING EQUIPMENT.
- D. DIMENSIONS ARE TO FINISH FACE UNLESS OTHERWISE NOTED.
- E. REFER TO DETAIL SHEETS FOR PLUMBING FITTINGS LOCATED IN CASEWORK.
- F. WHEN BUNDLING SEVERAL INDIRECT WASTE LINES TO DRAIN INTO A FLOOR SINK, A UNISTRUT IS REQUIRED FOR SECURING AND BRACING ALL LINES ABOVE THE DRAIN.
- G. FURNISH & INSTALL ALL NEEDED INDIRECT DRAINS PER CODE (NOT ALL SHOWN). INSTALL DRAINS AT 2% SLOPE WHERE POSSIBLE WITHOUT DIPS OR SAGS. ALL INDIRECT DRAINS SHALL RUN SEPARATELY FROM EACH OTHER TO INDIRECT DRAIN RECEPTOR AND SHALL TERMINATE WITH AN AIR GAP
- H. FURNISH & INSTALL WALL CLEANOUTS AT ALL SINKS AND AS NEEDED AND PER CODE (NOT ALL SHOWN).
- I. INSULATE ICE BIN DRAINAGE PIPES PER THE REQUIREMENTS ON THE PLUMBING SPECIFICATION SHEET.

PLUMBING WASTE KEYED NOTES

- PS01 1" INDIRECT DRAIN FROM DRIP PAN AND 3/4" PRESSURE RELIEF FROM WATER HEATER TO MOP SINK. SEE DETAIL ON SHEET P501 FOR ADDITIONAL INFORMATION.
- PS02 3" WASTE FROM MOP SINK.
- PS03 2" INDIRECT DRAINS FROM THE 3-COMP SINK TO FLOOR SINK. FLOOR SINK UTILIZED FOR THE 3 COMP AND DISHWASHER TO BE ROUTED TO AN EXTERIOR GREASE INTERCEPTOR.
- PS04 1-1/2" INDIRECT DRAIN FROM DISHWASHER TO FUNNEL OVER FLOOR SINK (IF PERMITTED). 1-1/2" TRADE SIZE PIPE MINIMUM REDUCED TO 3/4" FPT
- PS05 (2) 3/4" INDIRECT DRAIN FROM ICE MACHINE AND BIN TO INDIRECT DRAIN AT FLOOR SINK.
- PS06 5/8" DRAIN HOSE FROM ESPRESSO MACHINE TO INDIRECT DRAIN RISER. SEE DETAIL ON SHEET P501.
- PS07 1" INDIRECT INSULATED DRAIN LINE FROM ICE BIN DROP TO FLOOR SINK.
- PS08 1" INDIRECT WASTE FROM DRAIN HOSE OF THE WARE RINSER TO FLOOR SINK AS REQUIRED.
- PS09 3" WASTE FROM FLOOR SINK. GENERAL CONTRACTOR MAY NEED TO MODIFY CABINET BASE TO ALLOW ACCESS TO FLOOR SINK.
- PS10 2" WASTE FROM SINK.
- PS11 4" WASTE FROM TOILET, CONTRACTOR TO VERIFY THAT A 1/4" SLOPE FROM TOILET WASTE CAN BE ACHIEVED WITH GENERAL CONTRACTOR BEFORE INSTALLING LOW FLUSH TOILET.
- PS12 MAKE NEW CONNECTION TO LANDLORD PROVIDED MINIMUM 4" SANITARY SEWER WASTE LINE TO THE PREMISES, DEDICATED TO THE TENANTS USE. THE INVERT ELEVATION AT THE FURTHEST POINT OF CONNECTION SHALL BE A MINIMUM DEPTH OF 27" BELOW FINISHED FLOOR AND MAINTAIN A MINIMUM SLOPE OF 1/4" PER LINEAL FOOT AND SHALL BE PER LOCAL CODE. SEE LANDLORD'S PLUMBING AND CIVIL DRAWINGS FOR CONTINUATION.
- PS13 1-1/2" INDIRECT DRAIN TO FLOOR SINK.
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- PS16 MAKE CONNECTION TO EXISTING 4" VENT THROUGH ROOF BY LANDLORD. A MINIMUM OF 10' CLEARANCE TO AIR INTAKES SHALL BE MAINTAINED. VERIFY EXACT LOCATION, SIZE AND REQUIREMENTS ON SITE. SEE LANDLORD DRAWINGS FOR ADDITIONAL INFORMATION AND CONTINUATION.
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BUIL COF STORE #: PROJECT #:

63039 88084-001 SR. DESIGN MANAGER: K. GORIN-SLONSKI PRODUCTION DESIGNER: A.MAUSER

CLL / SMD

PLUMBING WASTE & VENT PLAN

SCALE: AS SHOWN SHEET NUMBER:

ISSUE DATE

P102

CHECKED BY:






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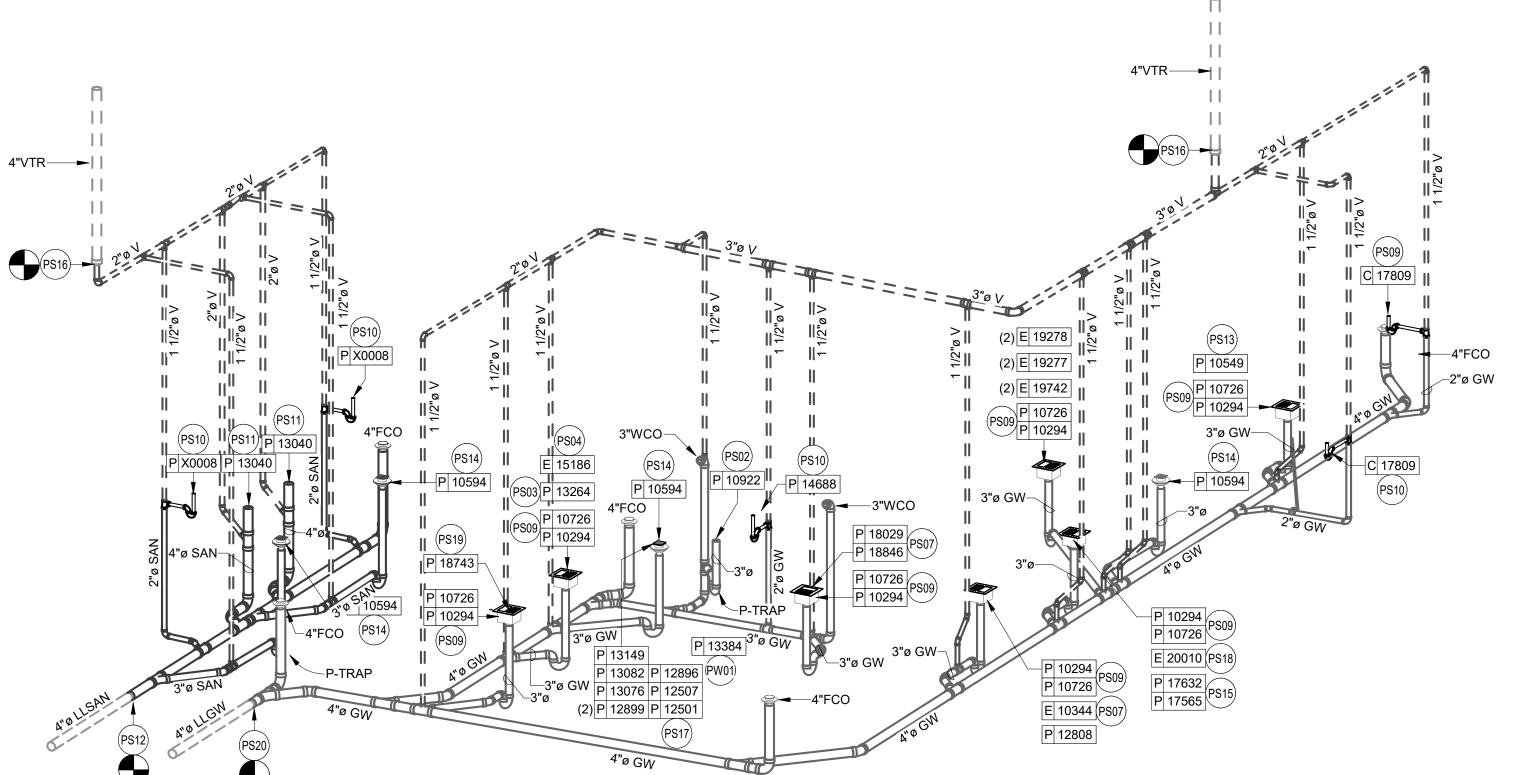
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BUILDOUT COFFEE RT. 291 &15

STORE #: PROJECT #: 88084-001 ISSUE DATE: 09-04-2020
SR. DESIGN MANAGER: K. GORIN-SLONSKI
PRODUCTION DESIGNER: A.MAUSER
CHECKED BY: CLL / SMD

ENLARGED PLUMBING PLACEMENT PLAN SCALE: AS SHOWN

SHEET NUMBER:

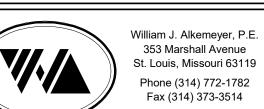

SANITARY ISOMETRIC DIAGRAM
SCALE: NTS

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- PS01 1" INDIRECT DRAIN FROM DRIP PAN AND 3/4" PRESSURE RELIEF FROM WATER HEATER TO MOP SINK. SEE DETAIL ON SHEET P501 FOR ADDITIONAL INFORMATION.
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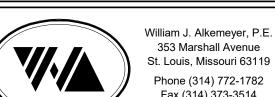
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WRITTEN AGREEMENT IS FULLY EXECUTED BY BOTH PARTIES.





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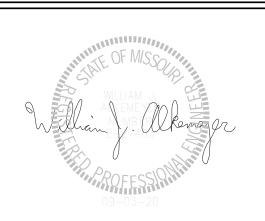
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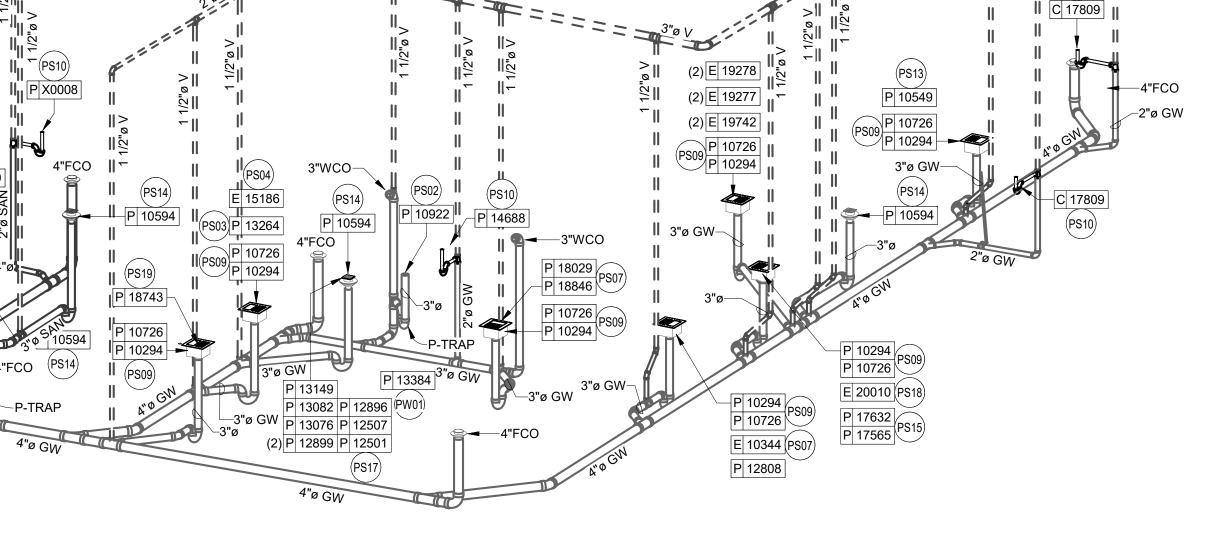
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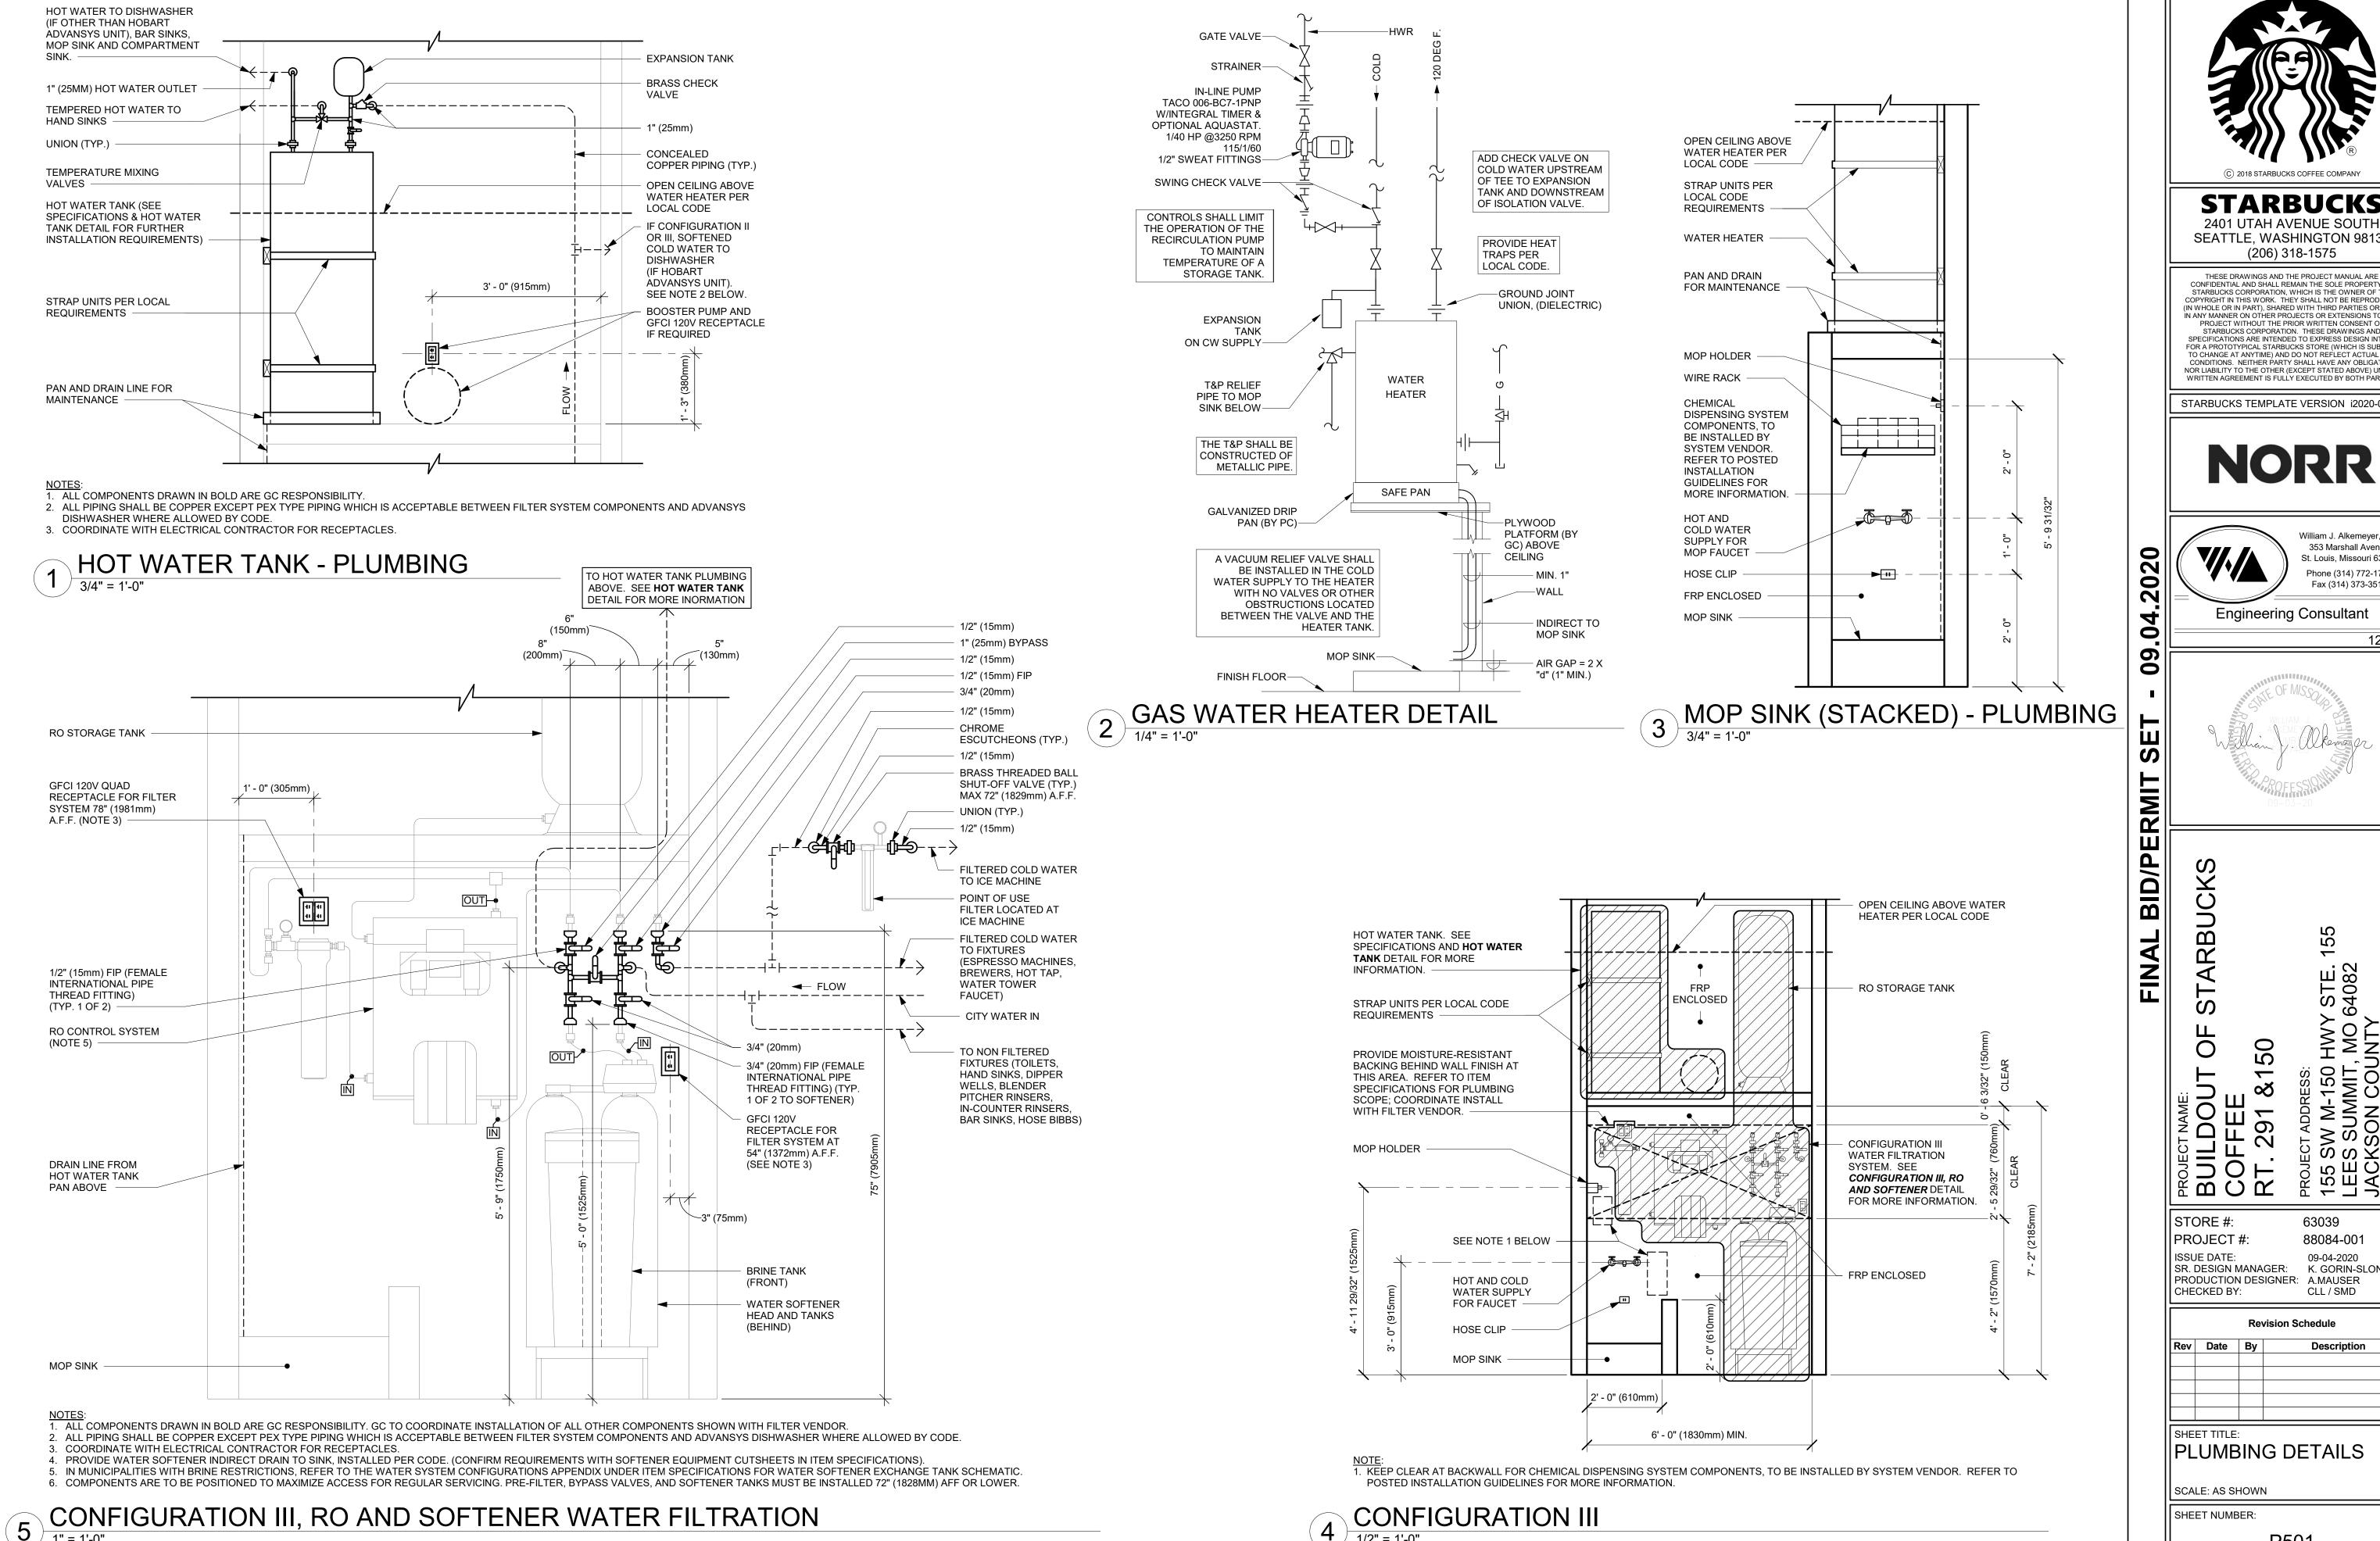
SR. DESIGN MANAGER: K. GORIN-SLONSKI PRODUCTION DESIGNER: A.MAUSER CHECKED BY: CLL / SMD

PLUMBING ISOMETRIC

DIAGRAM SCALE: AS SHOWN

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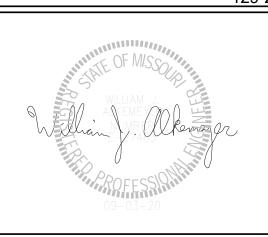
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63039 88084-001 SR. DESIGN MANAGER: K. GORIN-SLONSKI PRODUCTION DESIGNER: A.MAUSER CLL / SMD

Revision Schedule

DETAIL NOTES

1. THIS DETAIL IS SCHEMATIC ONLY. FOR THE LOCATION OF THE COMPONENTS SHOWN, EXTENT OF THE WORK REQUIRED, SEE THE

PLAN DRAWINGS. 2. ALL WATER HOSE SHALL BE THE MINIMUM LENGTH NEEDED AND SUPPORTED AS REQUIRED TO AVOID STRESSING

CONNECTIONS AND COILING EXCESSIVE ROUTE TO AVOID KINKING AND ALLOW SPACE FOR UNDER COUNTER REFRIGERATOR AND


3. ALL PIPING SHALL BE HELD TIGHT TO

ACCESS TO EQUIPMENT AND VALVES.


SLOPED WHERE REQUIRED AND ROUTED TO FLOW ACCESS TO EQUIPMENT AND VALVES.

4. ROUTE HORIZONTAL PIPING A MINIMUM OF 6" ABOVE FLOOR.

5. INSTALL PUMP AS SHOWN ON PLANS. COORDINATE LOCATION AND ELEVATION WITH OTHER TRADES. ORIENT PUMP AS REQUIRED TO ALLOW MAINTENANCE.

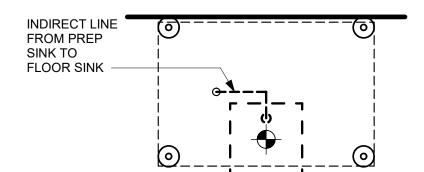

AT FLOOR LEVEL

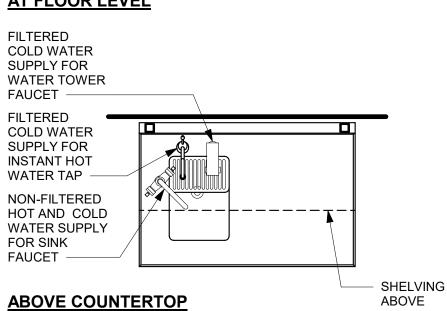


8" (200 MM) MIN. **BACK WALL CLEAR TO BACK** WALL FILTERED **COLD WATER** SUPPLY FOR ICE MACHINE **INDIRECT DRAIN** 6" (150 MM) MIN. LINE FROM ICE CLEAR MACHINE TO FLOOR DRAIN SEE PLUMBING PLAN FOR FINAL FLOOR DRAIN LOCATION AND TYPE


WATER FILLING STATION

3/4" = 1'-0"


ICE MACHINE

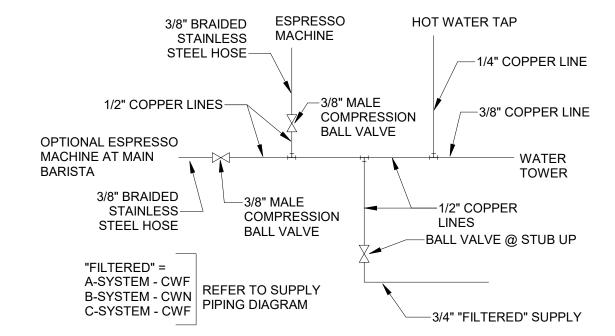


FRONTLINE FILTERED WATER MANIFOLD SCHEMATIC

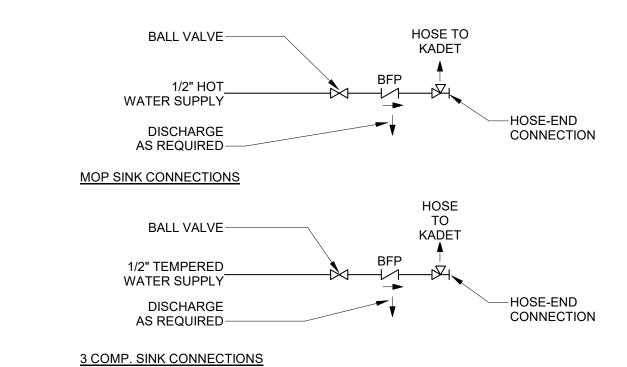

CHEMICAL SANITIZER CONNECTION SCHEMATICS

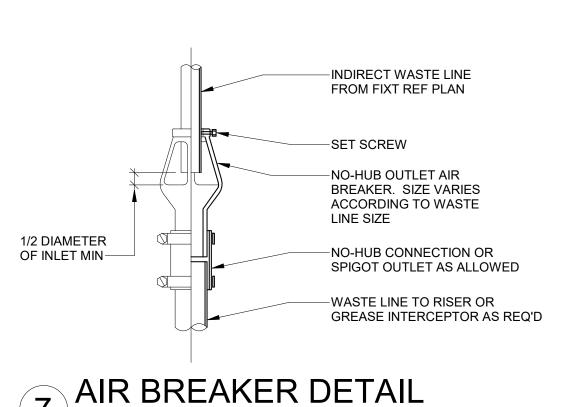

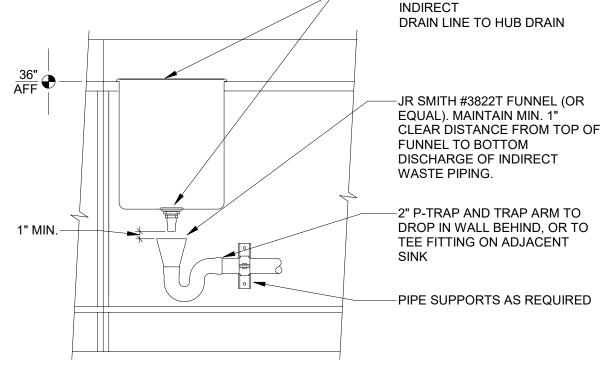

ICE BIN WITH 1-1/2"

ICE BIN HUB DRAIN DETAIL

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STORE #: PROJECT #: 88084-001 **ISSUE DATE** 09-04-2020 SR. DESIGN MANAGER: K. GORIN-SLONSKI PRODUCTION DESIGNER: A.MAUSER CHECKED BY:

CLL / SMD **Revision Schedule** Description


PLUMBING DETAILS

SCALE: AS SHOWN

SHEET NUMBER:

P502


MASTRENA GENERAL PIPING CONNECTION SCHEMATIC

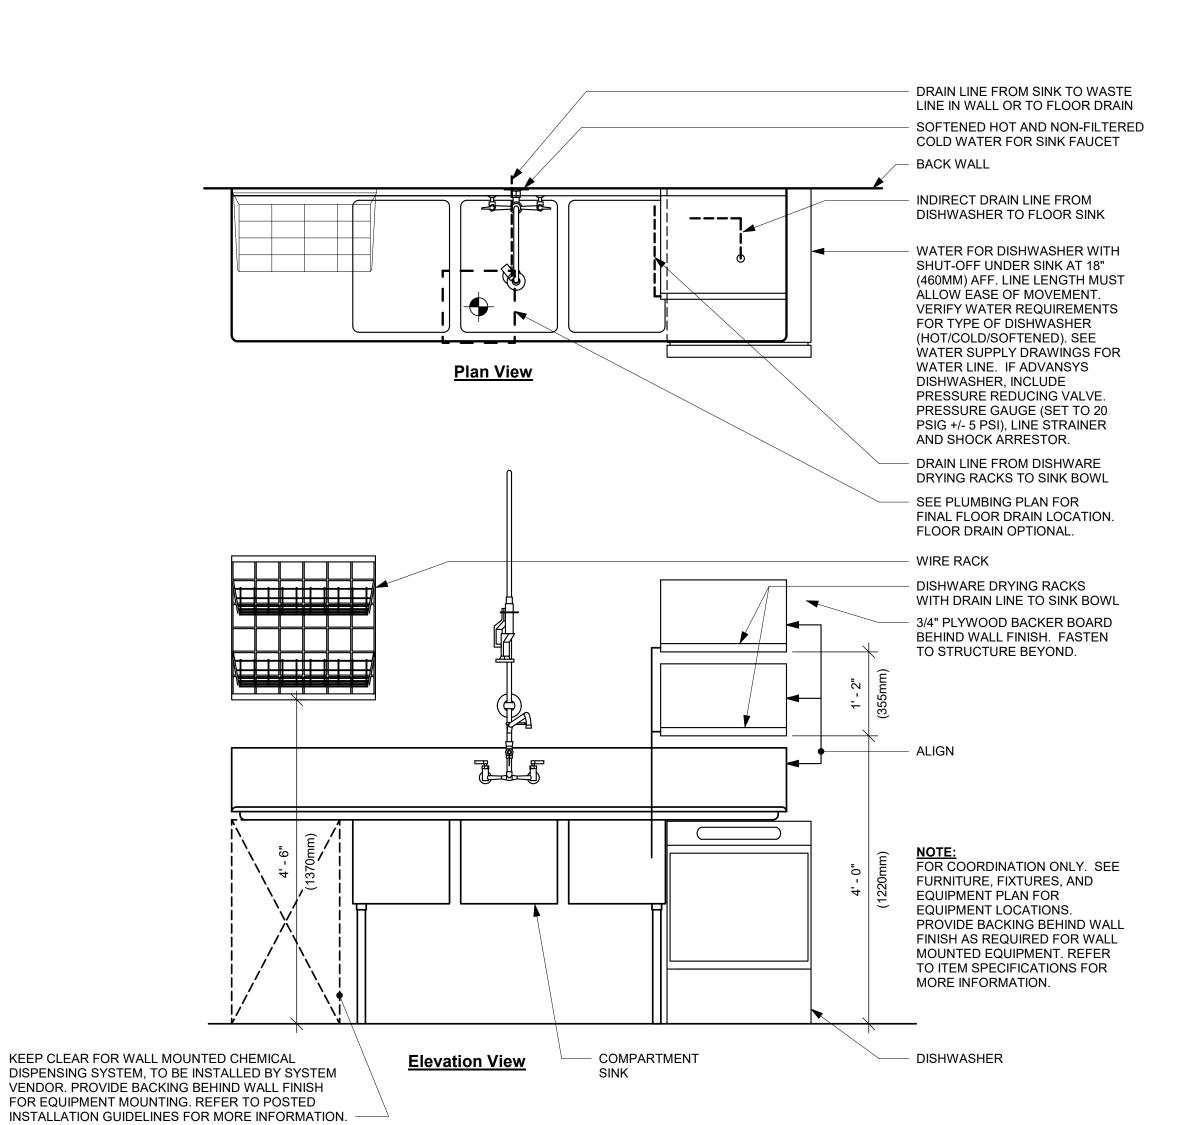


4 SANITIZING (GENERIC)

3/4" = 1'-0"



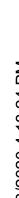

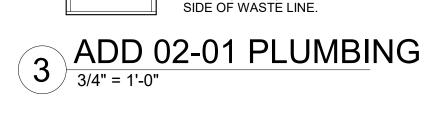

INDIRECT LINE FROM DRAINBOARD

HOT AND NON-FILTERED COLD

20 1/2" (520MM) A.F.F. SHUT-OFF

VALVES AT WALL AND 4" (100MM)

NON-FILTERED COLD WATER SUPPLY

CBE 01-05 PLUMBING

3/4" = 1'-0"

FOR BLENDER PITCHER RINSER

INDIRECT DRAIN LINE FROM ICE

WATER FOR SINK FAUCET AT


EITHER SIDE OF WASTE LINE


INDIRECT DRAIN LINE FROM


SINK TO FLOOR SINK

BIN TO FLOOR SINK -

TO FLOOR SINK

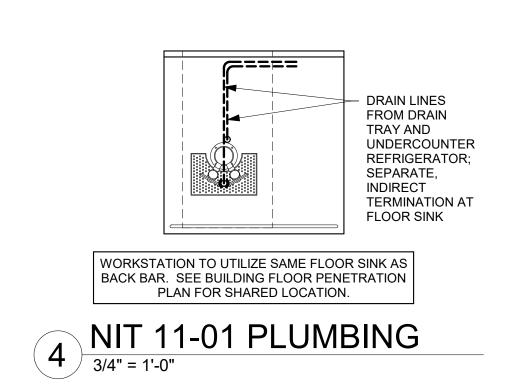


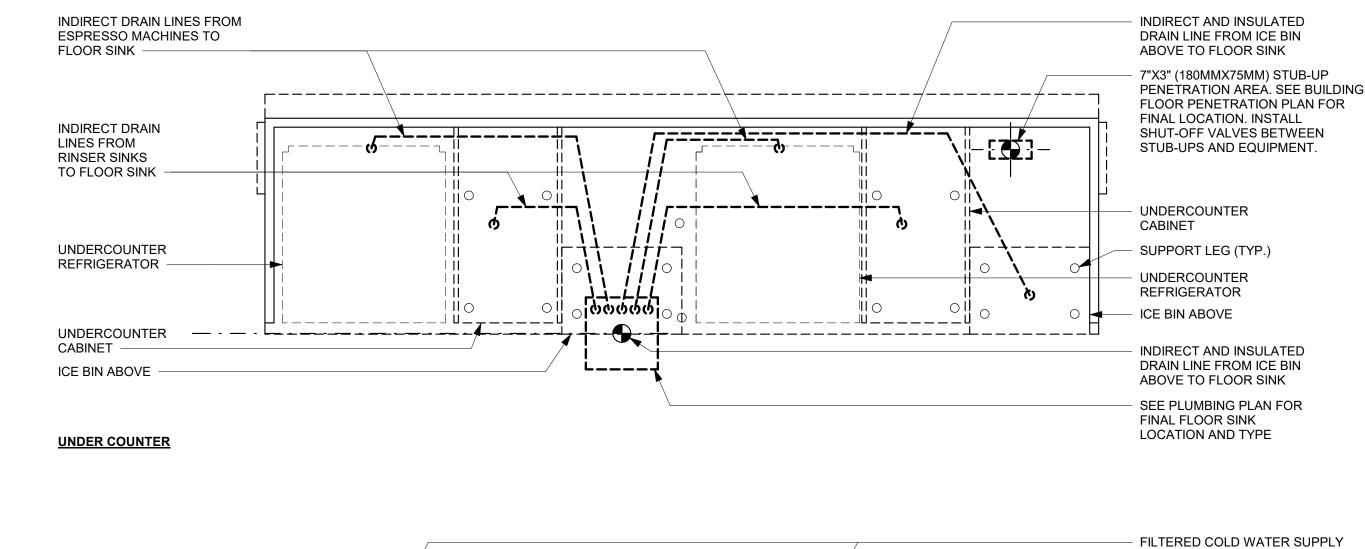

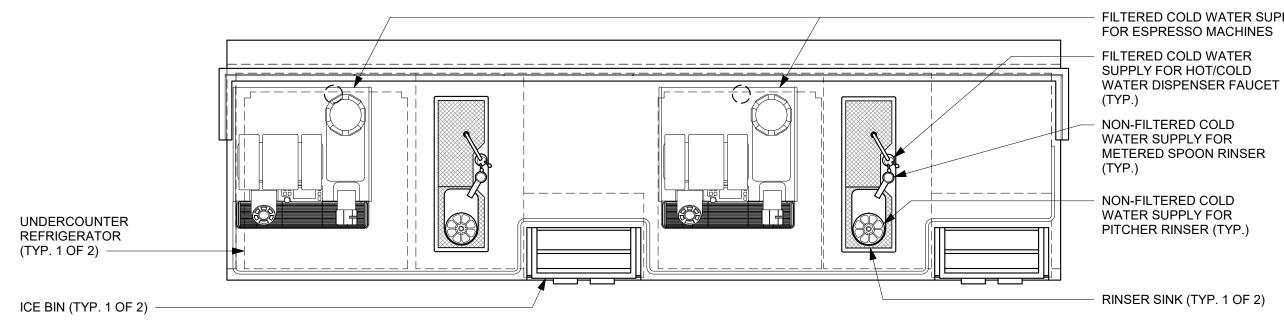

ABOVE COUNTER

2 ESP 11-01 PLUMBING 3/4" = 1'-0"

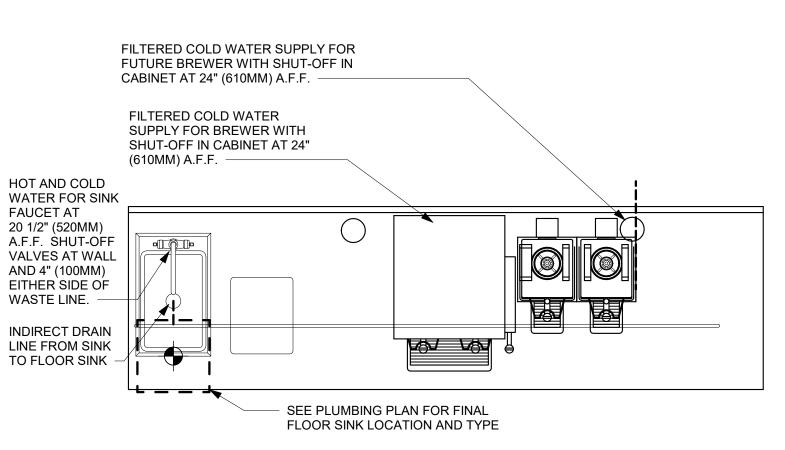





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NOR LIABILITY TO THE OTHER (EXCEPT STATED ABOVE) UNTIL A

WRITTEN AGREEMENT IS FULLY EXECUTED BY BOTH PARTIES.



William J. Alkemeyer, P.E. 353 Marshall Avenue St. Louis, Missouri 63119 Phone (314) 772-1782 Fax (314) 373-3514

Engineering Consultant

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STORE #:

129-20

60 J/PERI

— BUIL COFF

63039 PROJECT #: 88084-001

ISSUE DATE: SR. DESIGN MANAGER: K. GORIN-SLONSKI PRODUCTION DESIGNER: A.MAUSER CHECKED BY: CLL / SMD

Revision Schedule Description

PLUMBING DETAILS

SCALE: AS SHOWN

SHEET NUMBER:

P503

DIRECT DRAIN LINE FROM SINK. ROUGH-IN SINK WASTE STUB AT 15 1/2" (394MM) A.F.F. AND CENTERLINE OF SINK TEMPERED HOT AND COLD WATER FOR SINK FAUCET AT 20 1/2" (520MM) A.F.F. SHUT-OFF VALVES AT WALL AND 4" (102MM) EITHER

FILTERED COLD WATER

HOT AND NON-FILTERED COLD

20 1/2" (520MM) A.F.F. SHUT-OFF

VALVES AT WALL AND 4" (100MM)

WATER FOR SINK FAUCET AT

EITHER SIDE OF WASTE LINE

INDIRECT DRAIN LINE FROM

SEE PLUMBING PLAN FOR FINAL

FLOOR SINK LOCATION AND TYPE

SINK TO FLOOR SINK

NON-FILTERED COLD

WATER SUPPLY FOR

METERED SPOON

SUPPLY FOR WATER

TOWER FAUCET

		PLUMBING FIXTURE S	CHEDULE -	"P"	
DESIGN ID	COUNT	DESCRIPTION	FURN. BY	INST. BY	COMMENTS
10294	7	DRAIN - FLOOR SINK SQUARE - 12IN 305MM	SB	GC	ZURN MODEL #FD2375-NH3.
10594	4	DRAIN - FLOOR SINK SQUARE - 5IN 125MM	GC	GC	JAY R. SMITH MODEL #2005Y (B) OR
10594	4	DRAIN - FLOOR SINK SQUARE - SIN 125IVIVI	GC	GC	EQUAL
10726	7	DRAIN - GRATE HALF SQUARE - 12IN 305MM	SB	GC	ZURN MODEL #FD2375-NH3-H.
FAUCET					
10152	1	FAUCET - DOUBLE LABORATORY WITH BENT	SB	GC	
10153	2	RISER SPOUT FAUCET - WATER TOWER - 12IN 305MM	SB	GC	
10133	3	FAUCET - DOUBLE LABORATORY WITH SWING	SB	GC	
10210	Ū	SPOUT			
10447	1	FAUCET - PRE RINSE SPRAYER WALL MOUNTED	SB	GC	
10597	2	FAUCET - SINGLE HANDLE	SB	GC	
10804	1	FAUCET - PRE RINSE SWING SPOUT	SB	GC	
10874	1	FAUCET - HOT WATER SYSTEM GOOSENECK	SB	GC	
10922	1	FAUCET - MOP SINK WALL MOUNTED	SB	GC	
11003	3	FAUCET - METERED	SB	GC	
13588	1	FAUCET - HAND SINK WALL MOUNTED	SB	GC	
15749	2	FAUCET - HOT AND COLD WATER SYSTEM	SB	GC	
X0009	2	FAUCET - STERN	GC	GC	STERN. CONDOR 1010. PART #07100005. CHROME. PART OF D 13 INTEGRATED SINK SYSTEM. CONTACT: D 13 GROUP. 245 WEST CENTRAL STREET, NATICK, MA 01760. PH: 617-307-1140. WWW.D13GROUP.COM EMAIL: KRIZZO@D13GROUP.COM
FILTER					
12501	1	FILTER - RO SYSTEM 600GPD	SB	GC	CONFIGURATION 3. GC TO COORDINATE WITH SBUX VENDOR.
12507	1	FILTER - RO SYSTEM 40GAL STORAGE TANK	SB	GC	CONFIGURATION 3. GC TO COORDINATE WITH SBUX VENDOR.
12896	1	FILTER - BRINE TANK	SB	GC	CONFIGURATION 3. GC TO COORDINATE WITH SBUX VENDOR.
12899	2	FILTER - POLY GLASS VESSEL	SB	GC	CONFIGURATION 3. GC TO COORDINATE WITH SBUX VENDOR.
13076	1	FILTER - PREFILTRATION SYSTEM	SB	GC	CONFIGURATION 3. GC TO COORDINATE WITH SBUX VENDOR.
13082	1	FILTER - WATER SOFTENER TWIN	SB	GC	CONFIGURATION 3. GC TO COORDINATE WITH SBUX VENDOR.
13149	1	FILTER - PRESSURE GAUGE	SB	GC	CONFIGURATION 3. GC TO COORDINATE WITH SBUX VENDOR.
OTHER					
13384	1	WATER HEATER TANK GAS	GC	GC	AO SMITH POLARIS HIGH EFFICIENCY MODEL #BSS 130, 165 GPH RECOVERY @90 DEGREE RISE. SET WATER HEATER TO 140 DEG MAX ENERGY FACTOR = 0.96
SINK					
10549	1	SINK - RINSE DROP IN SST - 12X20IN 305X510MM	SB	GC	
10995	1	SINK - MOP - 24X24IN 610X610MM	SB	GC	
12808	1	SINK - UTENSIL RINSE WITH GRATE SST - RH - 14X20IN 355X510MM	SB	GC	
13264	1	SINK - 3 COMP WORK SST - 93IN 2350MM	SB	GC	
14688	<u>'</u> 1	SINK - HAND WITH SIDE SPLASH WALL MOUNTED		GC	
17565	1	SST SINK - RINSE WITH DRAINBOARD - 15X27IN	SB	GC	
17303	1	380X685MM			
17632	1	SINK - STACKED DRAINBOARD - 15IN 380MM	SB	GC	
18743	1	SINK - WATER FILLING STATION - 36X24IN 915X610MM	SB	GC	
19277	2	SINK - COUNTERTOP RINSER WITH DRAIN TROUGH - 26X9IN 660X235MM	SB	GC	
X0008	2	SINK - D13	GC	GC	D 13 INTEGRATED SINK SYSTEM. 30IN
					XLERATORSYNC SYSTEM WITH A SINGLE BASIN SINK WITH A PIVOT DRAIN COVER. GLACIER WHITE CORIAN COUNTER TOP AND ENCLOSURE PANELS. BASIN COLOR D 13 WHITE. ORDER WITH LOCKING SLIDING DOOR & SECURITY PANEL. CONTACT: D 13 GROUP. 245 WEST CENTRAL STREET, NATICK, MA 01760. PH 617-307-1140. WWW.D13GROUP.COM EMAIL: KRIZZO@D13GROUP.COM
TOILET					
12951	2	TOILET - TANKLESS EFFICIENT SINGLE FLUSH	GC	GC	SLOAN MODEL ST-2020-1.28 (1.28 GPF)
13040	2	TOILET - FLUSH VALVE AUTOMATIC EFFICIENT	GC	GC	CROWN MODEL 8111-1.28 FLUSHOMETER
		SINGLE FLUSH			(1.28 GPF)

RESPO	ONSIBILITY LEGEND
GC	GENERAL CONTRACTOR
LL	LANDLORD
SB	STARBUCKS

		SPECIALTY EQUIPM	ENT SCHED	JLE - "E"	
DESIGN ID	COUNT	DESCRIPTION	FURN. BY	INST. BY	COMMENTS
10267	5	FRIDGE UNDERCOUNTER 1 DOOR - 27IN 685MM	SB	GC	
11083	2	FRIDGE REACH IN 2 DOOR - 51X35IN 1295X890MM	SB	GC	
12618	2	FRIDGE UNDERCOUNTER 1 DOOR WITH SHELF - 27IN 685MM	SB	GC	
13676	1	FREEZER REACH IN 1 DOOR RH - 27IN 685MM		GC	
13682 20010	1	FREEZER REACH IN 2 DOOR - 54IN 1370MM FRIDGE NITRO 2 TAP JT NITCOM LH	SB SB	GC GC	KIT INCLUDES UNDERCOUNTER FRIDGE,
	· 	TRIBELIATING 2 174 OT INTOOM ET			FONT, TRAY, AND TUBING
EQUIPMENT 10312	4	BREWER SOFT HEAT WARMING STAND	SB	GC	
10746	1	SINGLE BREWER DUAL SOFT HEAT	SB	GC	GC TO COORDINATE WITH SBUX VENDOR.
10808	1	GRINDER DITTING KR1203	SB	GC	GC TO COORDINATE WITH SBUX VENDOR.
10856	6	BREWER SERVER SOFT HEAT	SB SB	GC GC	
12508 15186	2 1	BLENDER QUIET MODEL ON COUNTER DISHWASHER HOT LOW STEAM	SB	GC	
16623	1	SCALE DIGITAL WITH ADJUSTABLE DISPLAY	SB	GC	
17564	1	MOUNT SMALL BLENDER PITCHER RINSER WITH SENSOR	SB	GC	
19559	1	NITROGEN GENERATOR ELEMENT	SB	GC	GC TO COORDINATE INSTALLATION & CONNECTIONS WITH SBUX VENDOR
19742	2	ESPRESSO MACHINE MASTRENA II	SB	GC	GC TO COORDINATE WITH SBUX VENDOR.
20032	2	OVEN EIKON E2S - BLACK	SB	GC	
FOOD CASE 16238	1	FOOD CASE - ZEPHYR - 66IN 1675MM	SB	GC	
ICE	· · · · · · · · · · · · · · · · · · ·				1
10344 18029	1 1	ICE - BIN DROP IN 90LB 40KG ICE - BIN B110	SB SB	GC GC	
18029	1	ICE - MACHINE CIM1446HR SERIES REMOTE	SB	GC	
19278	2	COOLED ICE - BIN DROP IN 45LB 20KG HORIZONTAL	SB	GC	
OTHER					
10091 10099	1 2	CUP DISPENSER TALL HOT VERTICAL RESTROOM TOILET PAPER HOLDER	SB SB	GC GC	
10099	2	RESTROOM TOILET PAPER HOLDER RESTROOM SEAT COVER DISPENSER	SB	GC	
10384	2	DIAPER CHANGING STATION HORIZONTAL	SB	GC	
10396	1	CUP DISPENSER SHORT HOT VERTICAL	SB	GC	
10467	1	FILE CABINET 2 DRAWER	SB	GC	LOCALLY COURCER
10501 10769	2	FIRE EXTINGUISHER RESTROOM GRAB BAR VERTICAL - 18IN	GC SB	GC GC	LOCALLY SOURCED.
10791		455MM CUP DISPENSER GRANDE VENTI COLD	SB	GC	
		VERTICAL			
10855	2	CUP DISPENSER GRANDE VENTI HOT VERTICAL	SB	GC	
10858	1	CUP DISPENSER TALL COLD VERTICAL	SB	GC	
10859 10862	2 2	RESTROOM GRAB BAR - 48IN 1220MM RESTROOM GRAB BAR - 36IN 915MM	SB SB	GC GC	
10947	1	SOAP DISPENSER WALL MOUNTED	SB	GC	
10977	1	PAPER TOWEL DISPENSER FULL SIZE -	SB	GC	
10992	2	TRANSLUCENT GRAY PAPER TOWEL DISPENSER HALF SIZE -	SB	GC	
11115	2	TRANSLUCENT GRAY SOAP DISPENSER SINK MOUNTED	SB	GC	
13330	1	MOBILE CUP DISPENSER CADDY	SB	GC	
13584	1	CUP DISPENSER TRENTA COLD VERTICAL	SB	GC	
19495	1	NITRO 2 TAP HANDLE AND BADGE KIT	SB	GC	19495 RETIRED; ORDER FOUR SKU #'S: 011095591, 011095592, 011095587, 0110955
20079	1	NITRO 2 TAP BADGE MOUNT BACKBAR LH	SB	GC	
20080 X0010	2	NITRO 2 TAP BADGE MOUNT BACKBAR RH SOAP DISPENSER - STERN	SB GC	GC GC	STERN. GREEN/CHROME SOAP DISPENSE
7.00.0	_				PART #07100008. PART OF D 13 INTEGRAT SINK SYSTEM. CONTACT: D 13 GROUP. 24! WEST CENTRAL STREET, NATICK, MA 0176 PH: 617-307-1140. WWW.D13GROUP.COM EMAIL: KRIZZO@D13GROUP.COM
X0011	2	HAND DRYER - INTEGRATED	GC	GC	XLERATOR SYNC HAND DYER. AUTOMATIC SENSOR OPERATED. SURFACE MOUNTED CONTACT: D 13 GROUP. 245 WEST CENTR STREET, NATICK, MA 01760. PH: 617-307-1140. WWW.D13GROUP.COM EMA KRIZZO@D13GROUP.COM
STORAGE			la-	1	1
10222	2	WIRE SHELF GRID AT SINK	SB	GC	
10416 10462	8	WORKROOM SHELVING - 36IN 915MM WORKROOM SHELVING POSTS	SB SB	GC GC	
10462	<u>o</u> 1	MOP RACK WITH 3 HOLDERS	SB	GC	
13834	1	BASE - 24X18IN 610X455MM	SB	GC	
15699	1	PARTNER WORK CENTER	SB	GC	
17255 17264	<u>1</u> 1	PASTRY TRAY CART - 60IN 1525MM ROLLING PASTRY TRAY THAW RACK -	SB SB	GC GC	
		20X26IN 510X660MM			
17639 19476	1 2	WORKROOM CART - 24IN 610MM 5 COMP LOCKER - 12IN 305MM	SB SB	GC GC	

DESIGN ID	COUNT	DESCRIPTION	FURN. BY	INST. BY	COMMENTS
17573	1	CABINET - BACKBAR COUNTER SUPPORT PANEL	SB	GC	
17574	3	- 3IN 75MM CABINET - BACKBAR SINK OR ICE - 15IN 380MM	SB	GC	
17574	3 1	CABINET - BACKBAR SINK OR ICE - 15IN 38UMM CABINET - BACKBAR SINK OR ICE - 20IN 510MM	SB	GC	
17575	2	CABINET - CBE TEA SHELF - 29IN 735MM - FLAT	SB	GC	
17000	_	BLACK MT0028	CD		
17581	1	CABINET - CBE DRY INCLUSION SHELF - 23IN 585MM - FLAT BLACK MT0028	SB	GC	
17740	2	CABINET - BACKBAR - 30IN 760MM	SB	GC	
17741	7	CABINET - BACKBAR 15IN 380MM	SB	GC	
17743	1	CABINET - DT POS - 30IN 760MM	SB	GC	
17744	1	CABINET - FRONTBAR POS BRIDGE - 22IN 560MM	SB	GC	
17745	1	CABINET - BACKBAR DRAWER - 15IN 380MM	SB	GC	
17747	2	CABINET - BACKBAR TRASH - 15IN 380MM	SB	GC	
18060	1	CABINET - FRONTBAR POS CUBBY - 15IN 380MM	SB	GC	
18122	2	CABINET - BACKBAR SINK OR ICE - 16IN 405MM	SB	GC	
19281	2	CABINET - ESPRESSO ICE BIN STAINLESS - 20IN 510MM	SB	GC	
21189	2	CABINET - FRONTBAR - 15IN 380MM	SB	GC	
21191	1	CABINET - FRONTBAR DRAWER - 15IN 380MM	SB	GC	
21192	2	CABINET - FRONTBAR POS - 30IN 760MM	SB	GC GC	
21193	2	CABINET - ESPRESSO CUBBY WITH OPEN BACK - 18IN 455MM	SB	GC	
X0006	1	CABINET - DT POS UPPER CUBBY W DOORS	SB	GC	SEE DETAILS
X0017	1	CABINET - DT UPPER CUBBY W DOORS	SB	GC	SEE DETAILS
CAFE	4				
20131	1	CONDIMENT CART THREE DROP - WHITE OAK AND WHITE WD0073 CP0002	SB	GC	
20383	2	FREESTANDING INLINE 2 UNIT SHORT - 72IN 1830MM - WHITE OAK WD0073	SB	GC	
COUNTERTO	P				
17809	2	COUNTERTOP - HAND SINK WITH LOW SPLASH STAINLESS - 15IN 380MM	SB	GC	
17830	1	COUNTERTOP - POS - 82IN 2085MM	SB	GC	
18871	1	COUNTERTOP - FRONTBAR - 18IN 455MM	SB	GC	
19711	1	COUNTERTOP - WARMING - RF - 75IN 1905MM	SB	GC	
20050	1	COUNTERTOP - BACKBAR NITRO - LH - 30IN 760MM	SB	GC	
20062	1	COUNTERTOP - ESPRESSO METRO - LF - 139IN 3530MM	SB	GC	
20063	1	COUNTERTOP - FRONTBAR CAP - 139IN 3530MM	SB	GC	
21759	1	COUNTERTOP - CBE WITH RINSE SINK - LF - 112IN 2845MM	SB	GC	
X0003	1	COUNTERTOP - AT PASTRY CASE - 8 1/2" WIDTH	SB	GC	SEE DETAILS
X0008	1	COUNTERTOP - DT POS - LF	SB	GC	SEE DETAILS
X0009	1	COUNTERTOP - FUTURE EQUIPMENT	SB	GC	SEE DETAILS
X0015	1	COUNTERTOP - AT DT	SB	GC	SEE DETAILS
X0023	1	COUNTERTOP - BREW WITH TRASH DROP - RF	SB	GC	SEE DETAILS
X0025	1	COUNTERTOP - FRONTBAR MOP PLANAR - LF	SB	GC	SEE DETAILS
DIEWALL		I	T		
17831	1	DIEWALL - POS - 82IN 2085MM	SB	GC	
18859	1	DIEWALL - 78 3/4"	SB	GC	
18872	1	DIEWALL - HANDOFF INLINE - 18IN 455MM	SB	GC	
20064	1	DIEWALL - ESPRESSO - 139IN 3530MM	SB	GC	SEE DETAILS
X0021 FIT KIT	1	DIEWALL - END CAP - RF	SB	GC	SEE DETAILS
17894	1	FIT KIT - CABINET FILLER PANEL	SB	GC	LENGTH: 9 3/4"
OTHER					
11142	2	CORBEL SUPPORT - 24IN 610MM	SB	GC	
11155	2	ESPRESSO MACHINE PUMP MOUNT - 10X10IN	SB	GC	
17000		255X255MM	CD	00	0.21.011.011.01.511
17829	2	FRENCH CLEAT - VARIABLE LENGTH	SB	GC	2;3'-2" AND 2'-5"
18145	1	COUNTERTOP SUPPORT LEG	SB	GC	
20066	1	SHROUD - 139IN 3530MM	SB SB	GC GC	
20067	1	SNEEZE GUARD - 139IN 3530MM COUNTERTOP SUPPORT LEG SLIM	SB	GC	
X0001	1	WOOD CLADDING AT PORTAL	SB	GC	SEE DETAILS
X0001 X0001	1	WOOD CLADDING AT FORTAL WOOD PANEL NEAR FRONT BAR	SB	GC	SEE SEITHEO
X0001 X0012	1	CORIAN SILL AT DT WINDOW	SB	GC	SEE DETAIL
X0012 X0013	 1	CORIAN WINDOW SILL	SB	GC	SEE DETAIL
X0018	1	CLADDING AT PORTAL	SB	GC	SEE DETAILS
X0019	1	1" WOOD TRIM AT WORKROOM ENTRY	SB	GC	SEE DETAIL
X0021	1	WOOD CLADDING ALONG DEMISING WALL	SB	GC	SEE DETAIL
X0022	1	1" WOOD TRIM ALONG DEMISING WALL	SB	GC	SEE DETAILS
PANEL		•	1		
17832	1	PANEL - 82IN 2085MM	SB	GC	
18860	1	PANEL - MOP	SB	GC	
18873	1	PANEL - 18IN 455MM	SB	GC	
	1	PANEL - 139IN 3530MM	SB	GC	
20065 X0005	<u>'</u>	1711VLL 10011V 00001VIIVI	SB	GC	SEE DETAILS




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St. Louis, Missouri 63119 Phone (314) 772-1782 Fax (314) 373-3514

Engineering Consultant


2020

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129-20

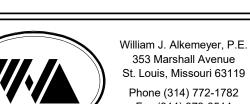

QF PROJECT NAME:
BUILDOUT OF
COFFEE
RT. 291 &150

STORE #: 63039 PROJECT #:

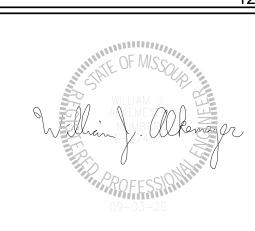88084-001 ISSUE DATE: 09-04-2020
SR. DESIGN MANAGER: K. GORIN-SLONSKI
PRODUCTION DESIGNER: A.MAUSER
CHECKED BY: CLL / SMD

Revision Schedule

PLUMBING SCHEDULES

SCALE: AS SHOWN

SHEET NUMBER: