




GENERAL GROUNDING NOTES

- A. FULL SIZE GROUND MEANS THAT GROUND CONNECTOR SIZE SHALL BE AS SHOWN ON SERVICE EQUIPMENT ON THE POWER RISER DIAGRAM.
- B. AFTER GROUNDING SYSTEM IS INSTALLED, GROUND RESISTANCE SHALL BE MEASURED, TO ASSURE THAT GROUND VALUE OF 15 OHM MAXIMUM RESISTANCE IS ACHIEVED. IF NOT, ADDITIONAL GROUNDING SHALL BE PROVIDED TO MEET THE SPECIFIC VALUE.
- C. ALL CONNECTIONS TO GROUND RODS SHALL BE EXOTHERMIC WELD CONNECTIONS
- D. WHERE LOCATED OUTSIDE OF BUILDING, TOP OF GROUND ROD SHALL BE 12" (MINIMUM) BELOW GRADE. PROVIDE NON-METALIC INSPECTION WELL WITH REMOVABLE COVER.
- E. GROUND CONNECTOR SHALL BE LOCATED WITHIN OR NEAR BOTTOM OF CONCRETE FOUNDATION OR FOOTING THAT IS IN DIRECT CONTACT WITH THE EARTH, AND SHALL CONSIST OF AT LEAST 20 FEET OF ONE OR MORE STEEL REINFORCING BARS OR RODS OF NOT LESS THAN 1/2 INCH DIAMETER OR OF AT LEAST 20 FEET OF BARE COPPER CONDUCTOR.
- F. SEE THE RISER DIAGRAM DETAIL 1/E301 FOR THE SIZE OF THE MAIN BONDING JUMPER AND BARE COPPER GROUNDING ELECTRODE CONDUCTORS.
- G. NOT ALL GROUNDING OPTIONS MAY APPLY. CONTRACTOR TO VERIFY AVAILABLE GROUNDING METHODS.

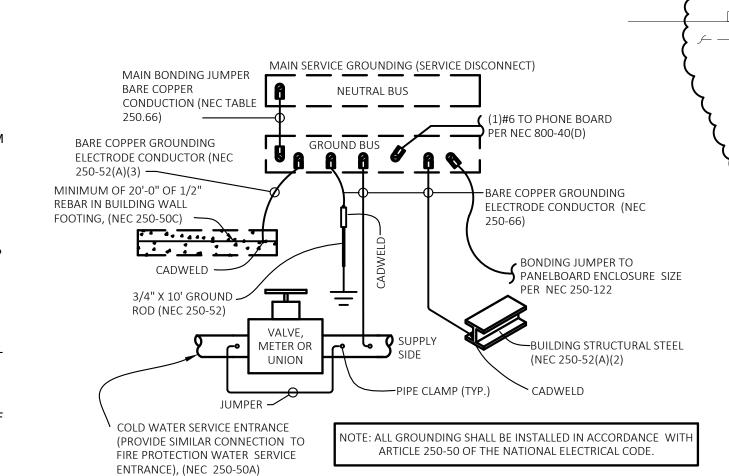

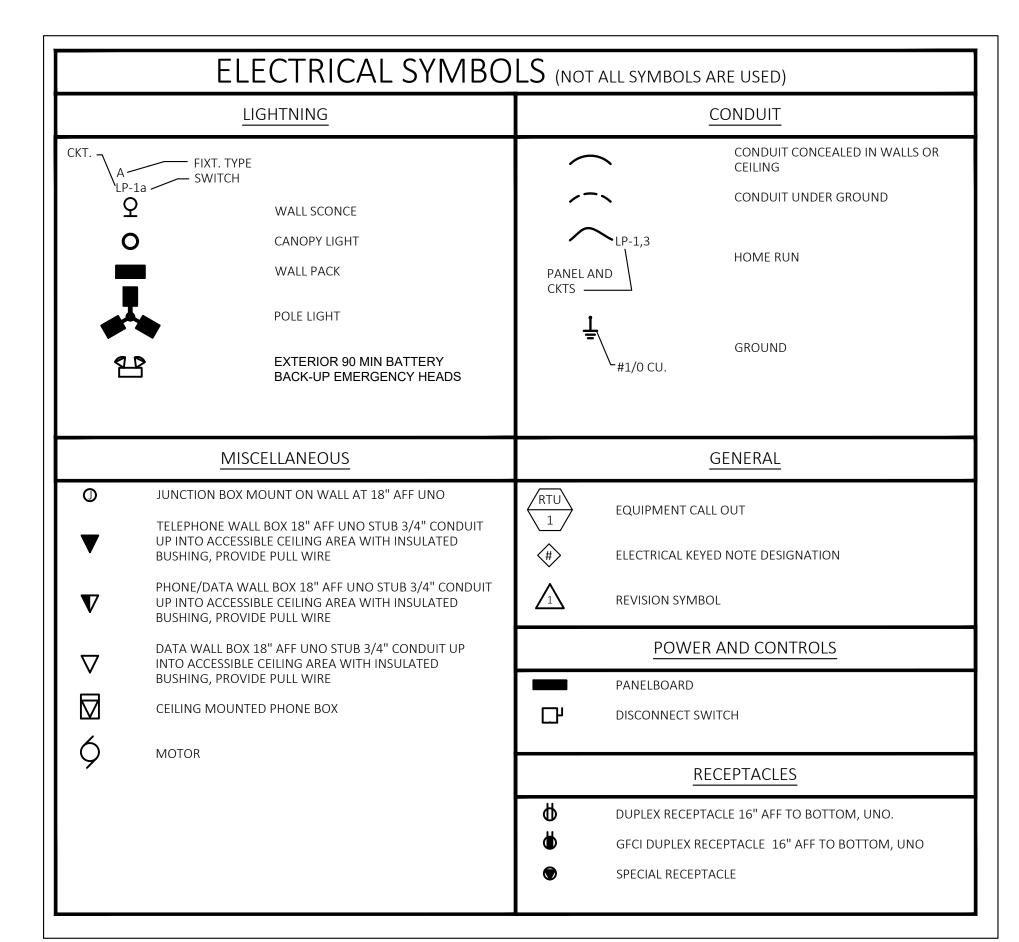



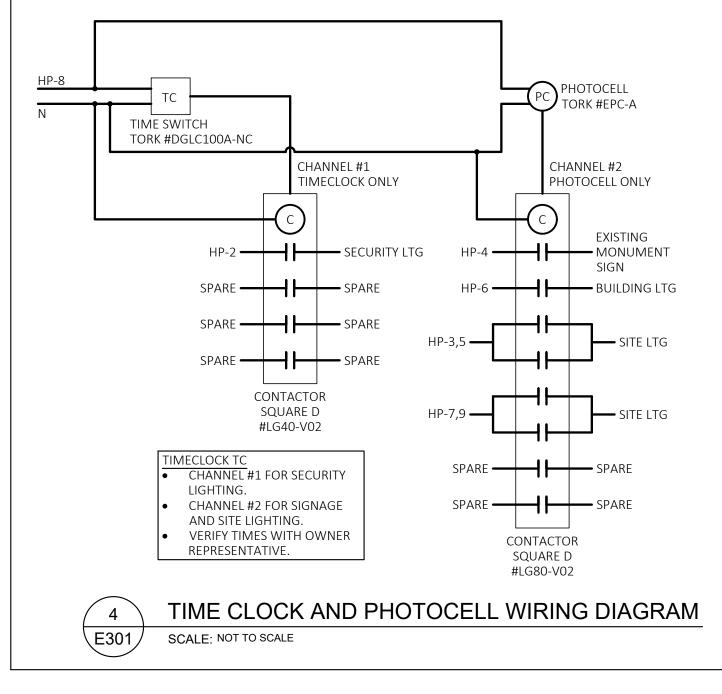

NEUTRAL AND GROUND—

TO DETAIL 3/E101

TO BE BONDED. REFER

1000A SERVICE FEEDER

(4)#400CU, 3.5"C ———

UTILITY TRANSFORMER

EXISTING TO REMAIN

PRIMARY FEEDER

PROVIDE 3 SETS OF

UTILITY TRANSFORMER

EXISTING TO REMAIN

PLAN MARK	MANUFACTURER	CATALOG NO.	** NO. WATTAGE & LAMPS	REMARKS AND MOUNTING HEIGHT TO BOTTOM OF LIGHT FIXTURE	WATTS PER FIXTURE	FIXTUR QUANTI]
А	LITHONIA	DSX0 LED-P6-40K-BLC-208-RPA DDB	LED FURNISHED WITH FIXTURE	13" W x 26" L x 7" H HEAD MOUNTED ON A EXISTING 28' TALL ROUND POLE, 70 CRI, 4000K, 13090 LUMENS, WET LOCATION LISTED. COORDINATE POLE DRILL HOLES WITH THE EXISTING POLES	134	7
В	LITHONIA	DSXW1 LED-20C-530-30K-T2M- MVOLT-DDBXD	LED FURNISHED WITH FIXTURE	14" W x 7" H x 10" D WALL PACK, 70CRI, 3000K, 3887 LUMENS, SURFACE MOUNTED 8'-0" AFF TO BOTTOM OF FIXTURE UNLESS	36	3
C	HINKLEY LIGHTING, INC.	1649SK-LED	LED FURNISHED WITH FIXTURE	9" W x 24" H x 4" D WALL SCONCE, 70CRI, 2700K, 900 LUMENS, SURFACE MOUNTED 8'-0" AFF TO BOTTOM OF FIXTURE UNLESS OTHERWISE NOTED.	11	6
D	PORTFOLIO	LD6B-15-D010-EU6B-1020-80-30-6LB- W-1-MB	LED FURNISHED WITH FIXTURE	7"W x 6" H DOWN LIGHT MOUNTED WITHIN THE CANOPY 10'-0" AFF UNLESS NOTED OTHERWISE	11	12
F	LITHONIA	TWP-150S-TB-LPI	HIGH PRESSURE SODIUM	17" W x 16" H x 8" D WALL PACK, 16,000 LUMENS, SURFACE MOUNTED 8'-0" AFF TO BOTTOM OF FIXTURE UNLESS OTHERWISE NOTED.	150	2
G	LITHONIA	HEAD: DSX0 LED-P6-40K-T5W-208- RPADDB POLE: RTS-25-6-5-9B-T20-DM28AS- DDBXD	LED FURNISHED WITH FIXTURE	13" W x 26" L x 7" H HEAD MOUNTED ON A EXISTING 28' TALL ROUND POLE, 70 CRI, 4000K, 166704 LUMENS, WET LOCATION LISTED. COORDINATE POLE DRILL HOLES WITH THE EXISTING POLES	134	HEADS: POLE: 1
x	LITHONIA	AFF-OEL-DDBTXD-UVOLT-LTP-SDRT- WT-CW	LED FURNISHED WITH FIXTURE	7" W x 10" H x 4" D EXTERIOR EMERGENCY LIGHT, SURFACE MOUNT WITH BOTTOM OF FIXTURE AT 8'-0" AFF, LITHIUM ION PHOSPHATE BATTERY, OUTPUTS FOR 90 MINUTES AFTER LOSS OF POWER, LISTED FOR COLD WEATHER AND WET LOCATION	12	4

PROVIDE (4)#3CU,

E301

ROOM | STARBUCKS

TIMECLOCK

REFER TO

FOR MORE

DETAIL 4/E301

INFORMATION

PANEL

SBA

- 400A FEEDER

OF (4)#3/0CU,

#3CU G, 2.5"C

ONE-LINE

SCALE: NOT TO SCALE

PROVIDE 2 SETS

FUTURE

MEDICAL

– 400A FEEDER

2.5"C

PROVIDE 2 SETS OF

(4)#3/0CU, #3CU G,

PANEL

FM

STARBUCKS | OFFICE

– 400A FEEDER

PROVIDE 2

(4)#3/0CU,

#3CU G, 2.5"C

SETS OF

PANEL

FUTURE

MEDICAL | BUILDING

OFFICE EXTERIOR

#8CU G, 1.25"C

UTILITY

PANEL

ALL EXTERIOR EQUIPMENT

IS TO BE NEMA-3R RATED.

COORDINATE ALL UTILITY

LOCATIONS WITH

PRIOR TO BID

RESPECTIVE COMPANY

\ E301

— 1000A FEEDER

— SERVICE GROUND

PROVIDE #3/0CU G. SEE DETAIL

888-471-5275

TELEPHONE:

3/E301 FOR INFORMATION

PROVIDE 3 SETS OF

(4)#400CU, #2/0CU G, 3.5"C

JTILITY CONTACT INFORMATION

KANSAS CITY POWER AND LIGHT COMPANY

EXTERIOR UTILITY ROOM

NOTE:
PRIOR TO THE INSTALLATION OF ALL EXIT SIGNS AND EMERGENCY LIGHTS, THE ELECTRICAL CONTRACTOR SHALL VERIFY WITH THE GC AND
FIRE DEPARTMENT INSPECTOR THE FINAL APPROVED LOCATIONS.

B. LIGHT FIXTURE QUANTITIES ARE APPROXIMATE CONTRACTOR IS RESPONSIBLE FOR VERIFYING FIXTURE COUNT

	E	QUIPME	NT SC	HEDU	JLE			FILE:	320488 LOAD.xlsm	
1 '	PLAN MARK	EQUIPMENT SERVED	LOAD	VOLT/ PHASE	FED BY	DISC BY	MCA	MOCPD	FEEDER	REMARKS
ı	RTU 1	ROOF TOP UNIT	19.45KVA	208/3	SBA	EC	54.0A	60A	(3)#4,#8G 1"C	
i	RTU 2	ROOF TOP UNIT	15.20KVA	208/3	SBA	EC (42.2A	50A	(3)#6,#8G 3/4"C	}
	FF 1	FLY FAN	0.77KVA	120/1	SBA	EC	6.4A	20A	1/2"C W/ PULL STRINGS	MARS #STD248-1U-OB
ı	DAC 1	DRIVE-THRU AIR CURTAIN	7.07KVA	208/1	SBA	EC	34.0A	40A	(2)#8,#10G 3/4"C	AA300-275 PASS-THRU AIR CURTAIN
	DW 1	DRIVE-THRU	0.96KVA	120/1	SBA	EC	8.0A	15A	(2)#12,#12G 1/2"C	275 SERIES WINDOW
2	EF 1	EXHAUST FAN	0.12KVA	120/1	SBA	EC	1.0A	20A	(2)#12,#12G 1/2"C	}

			ABBREVIATIONS		
		(<u>NOTE:</u> NO	OT ALL ABBREVIATIONS ARE USED)		
FF	ABOVE FINISHED FLOOR	DIM	DIMMER	IG	ISOLATED GROUND
L	ALUMINUM	DISC SW	DISCONNECT SWITCH	JB	JUNCTION BOX
MP	AMPERE	DP	DOUBLE POLE	MCB	MAIN CIRCUIT BREAKER
TS	AUTO-TRANSFER-SWITCH	DT	DOUBLE THROW	MDP	MAIN DISTRIBUTION PANEL
FG	BELOW FINSHED GRADE	DPP	DISTRIBUTION POWER PANEL	MLO	MAIN LUG ONLY
LDG	BUILDING	EC	EMPTY CONDUIT	MTD HT	MOUNTING HEIGHT
В	CIRCUIT BREAKER	EF	EXHAUST FAN	NF	NON FUSED
KT	CIRCUIT	EM	EMERGENCY	NIC	NOT IN CONTRACT
LG	CEILING	EWC	ELECTRIC WATER COOLER	RTU	ROOF TOP UNIT
OND OR "C"	CONDUIT	EXIST'G	EXISTING	SW	SWITCH
ONN	CONNECT	FL	FLOOR	UG	UNDER GROUND
ONT	CONTRACTOR	FLUOR	FLUORESCENT	UNO	UNLESS NOTED OTHERWISE
U	COPPER	GFCI	GROUND FAULT CURRENT INTERUPTER	WP	WEATHER-PROOF
/Τ	CURRENT TRANSFORMER	GND OR (G)	GROUND	XFMR	TRANSFORMER

12 Sunnen Drive, Suite 100, St. Louis, MO 63143 T: 314.821.1100

MIDLAND

Starbucks & Medical Office 155 S.W. MO-150 HWY LEE'S SUMMIT, MO 64802


 No. Description
 Date Owner Review
 05/12/20

 Owner Revision 2
 06/04/20

 1 Owner Revision 3
 07/20/20

 2 Owner Revision 6

CASCO DIVERSIFIED CORPERATION PROFESSIONAL ENGINEERING CERTIFICATE OF AUTHORITY #000613 EXP. 12/31/21

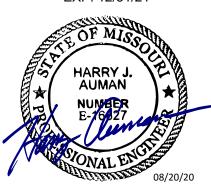

HARRY J. AUMAN LIC. #E16827 EXP. 12/31/20

Drawn By/Checked By:EAV/DAWProject Number320488

Permit Date

ELECTRICAL ONE-LINE AND DETAILS

06-17-20