

# **Revision Number 1**

07/07/2020 Date:

Project: 87799-001

Katie Slonski, Chitra Patel, Stephenie Rychlik, Matt Isch, Kristen Sylwestrzak, Edurne To:

Vega, Pierina Benevenuto, Katie Getz, Erika Aultman

Alissa Hahn

# MO - NW Pryor Rd. & Chipman - REVISION 1

Documents for the referenced project are hereby being amended per this revision (Revision No. 1, per Design Direction). Changes are noted in the text below. The summary of changes includes, but is not limited to the following:

**Sheet G000** Sheet added to display scope of revisions, per Revision 1.

**Sheet G001** Sheet G000 was added to index.

**Sheet G002** Added and tagged key note 10, per Fire Department Comments.

**Sheet A201** Updated key note 1, per Fire Department Comments.

Added and tagged occupancy sign in elevation #1, per Fire Department Comments. **Sheet I101** Added and tagged occupancy sign in FF&E Plan, per Fire Department Comments. **Sheet I202** Added and tagged occupancy sign in elevation #3, per Fire Department Comments. **Sheet I601** Added occupancy signs to graphics & artwork schedule, per Fire Department Comments.

# **END OF REVISION NO. 1**

Prepared By: Alissa Hahn

Designer NORR

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**RELEASE FOR** CONSTRUCTION **AS NOTED ON PLANS REVIEW** DEVELOPMENT SERVICES LEE'S SUMMIT, MISSOURI 07/13/2020

SUE S **REVISION** 

2020

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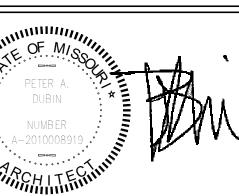
STARBUCKS TEMPLATE VERSION i2020-01-31

# NORR



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**Engineering Consultants** Mechanical - Electrical - Plumbing



ISSUED DATE: 06/16/2020 EXPIRATION DATE: 12/31/2020

**ら**る TARBUCKS
YOR RD & ST/ PR/ E'S N N - LEI PROJECT NAME:
BUILDOUT
COFFEE CHIPMAN

STORE #: 62012 87799-001

PROJECT #: ISSUE DATE: SR. DESIGN MANAGER: K. GORIN SLONSKI PRODUCTION DESIGNER: A. HAHN CHECKED BY: NORR

Rev Date By Description 7/7/2020 AH PERMIT COMMENTS

REVISIONS

SCALE: AS SHOWN SHEET NUMBER:

# **ABBREVIATIONS**

AIR CONDITIONING ACT ACOUSTICAL CEILING TILE ADJ ADJUSTABLE ABOVE FINISHED FLOOR AMP AMPERE

BOH BACK OF HOUSE

ARCH ARCHITECT

CAB CABINET CL CENTER LINE CEILING STARBUCKS CM

CONSTRUCTION MANAGER CENTER

CX COMMISSIONING CXA COMMISSIONING AGENT

DEG DEGREE DET DETAIL DIA DIAMETER DIM DIMENSION DM STARBUCKS

**DESIGN MANAGER** DOWN EΑ EACH **ELEVATION** 

EL EQ EQUAL EXIST EXISTING EXT EXTERIOR

FF&E FURNITURE. FIXTURE, AND EQUIPMENT FLR FLOOR FOH FRONT OF HOUSE

FOIC FURNISHED BY OWNER, **INSTALLED BY CONTRACTOR** FOIO FURNISHED BY OWNER **INSTALLED BY OWNER** 

FOOT/FEET GROUND GENERAL CONTRACTOR GWB GYPSUM WALLBOARD

HOLLOW CORE HDW HARDWARE HOLLOW METAL HORIZ HORIZONTAL HR HOUR HEIGHT

HVAC HEATING, VENTILATING AND AIR CONDITIONING

I.D. INSIDE DIAMETER

LEED LEADERSHIP IN ENERGY AND ENVIRONMENTAL DESIGN

LANDLORD LOW VOLTAGE

MAX MAXIMUM "MECHANICAL, ELECTRICAL

AND PLUMBING" MFR MANUFACTURER MINIMUM

NOT IN CONTRACT NIGHT LIGHT NTS NOT TO SCALE

OC ON CENTER

PLC PLACE

RADIUS REF REFERENCE REQ'D REQUIRED REV REVISION

RND ROUND **STARBUCKS** SC SOLID CORE SQUARE FEET

SHEET SIM SIMILAR SPEC SPECIFICATION SQ SQUARE

TEMP TEMPORARY TYP TYPICAL

UNDER COUNTER UNO UNLESS NOTED OTHERWISE

VIF VERIFY IN FIELD

# RESPONSIBILITY **LEGEND**

GC GENERAL CONTRACTOR LL LANDLORD

SB STARBUCKS

# ARCHITECTURAL SYMBOL LEGEND


DETAIL

CALL-OUT

PXXX-ES

PAINT

TAG

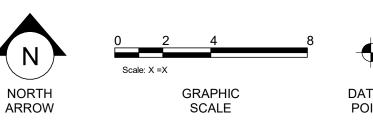

(xx)


SHEET

NOTE

CALLOUT

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**DESIGN ID** 

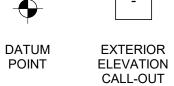

XXXX AFF


ABOVE FINISH

FLOOR

**HEIGHT TAG** 

DOOR

TAG

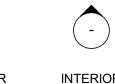





CLOUD

REVISION

FINISH FACE TO FINISH FACE DIMENSION


DXXXXXXXX (WXXXXX) WINDOW TAG

# **AERIAL MAP**


REVISION

**SECTION** 

CALL-OUT

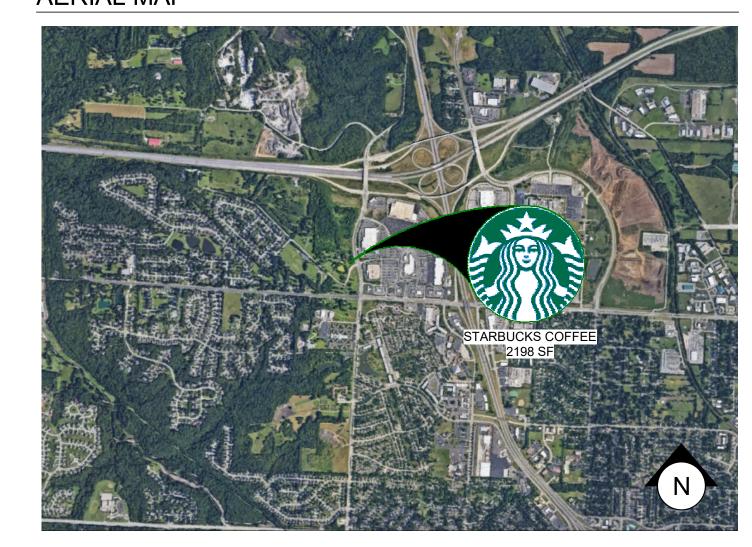

# **KEY SITE PLAN**

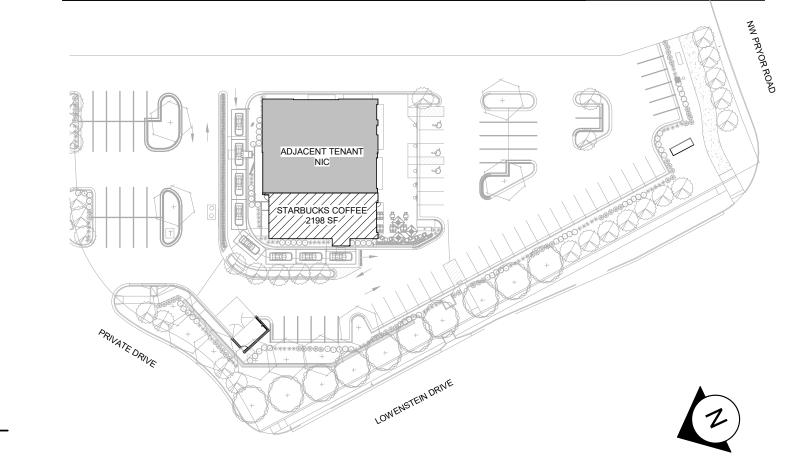

# PROJECT CONTACTS

SENIOR DESIGN KATIE GORIN SLONSKI MANAGER: STARBUCKS COFFEE COMPANY 111 N CANAL ST, SUITE 450 CHICAGO, IL 60606 (312) 380-3688 PHONE KGORIN@STARBUCKS.COM

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OF RECORD: 353 MARSHALL AVENUE, SUITE 100 ST. LOUIS, MO 63119 (314) 772-1782 PHONE (314) 772-0109 FAX BSWEENEY@ALKEMEYER.COM

# **SCOPE OF WORK**

MEP CONSULTANT WILLIAM ALKEMEYER

INTERIOR BUILDOUT OF A NEW STARBUCKS COFFEE DRIVE-THRU.

# SITE INFORMATION

CODE AUTHORITIES:	CITY OF KANSAS CITY JACKSON COUNY HEALTH
BUILDING CODE:	2018 INTERNATIONAL BUILDING CODE
PLUMBING CODE:	2018 INTERNATIONAL PLUMBING CODE
MECHANICAL CODE:	2018 INTERNATIONAL MECHANICAL CODE
ELECTRICAL CODE:	2017 NATIONAL ELECTRICAL CODE
ENERGY CODE:	2018 INTERNATIONAL FUEL GAS CODE
FIRE CODE:	2018 INTERNATIONAL FIRE CODE
HEALTH CODE:	MISSOURI STATE FOOD CODE
ACCESSIBILITY CODE:	ICC/ANSI A117.1-2017, ACCESSIBLE AND USABLE BUILDINGS AND FACILITIES
ZONING:	

PMXI - PLANNED MIX USED DISTRICT ZONE: PROPOSED USE: RETAIL SALES AND SERVICES

SIGNAGE & FIRE ALARM **DEFERRED SUBMITTALS:** 

# **BUILDING INFORMATION**

OCCUPANCY TYPE:	A-2
BUILDING AREA:	6,911 SF
TENANT AREA:	2,198 SF
FIRE SPRINKLER:	NO
CONSTRUCTION TYPE:	V-B

# **GENERAL NOTES**

- 1. THE DRAWINGS AND PROJECT MANUAL TOGETHER CONSTITUTE THE CONTRACT DOCUMENTS FOR CONSTRUCTION. ALL GENERAL REQUIREMENTS ARE TO BE MET AND ALL MATERIALS. FINISHES AND SYSTEMS ARE TO BE INSTALLED AND PERFORM PER SPECIFICATIONS UNLESS OTHERWISE NOTED.
- 2. GENERAL CONTRACTOR SHALL VISIT THE SITE, REVIEW THE BUILDING SHELL DRAWINGS AS SUBMITTED BY THE LANDLORD OR STARBUCKS AND BECOME THOROUGHLY FAMILIAR WITH THE SITE CONDITIONS PRIOR TO CONSTRUCTION.
- 3. GENERAL CONTRACTOR SHALL CONSULT WITH STARBUCKS CONSTRUCTION MANAGER TO RESOLVE ANY CHANGES, OMISSIONS
- 4. ALL WORK SHALL BE PERFORMED IN STRICT COMPLIANCE WITH LOCAL, COUNTY, STATE AND FEDERAL CODES AND ORDINANCES.
- 5. GENERAL CONTRACTOR SHALL VERIFY THE LOCATION OF ALL UTILITIES.

OR PLAN DISCREPANCIES PRIOR TO CONSTRUCTION.

- 6. GENERAL CONTRACTOR TO VERIFY ALL DIMENSIONS, INCLUDING CLEARANCES REQUIRED BY OTHER TRADES AND NOTIFY STARBUCKS CONSTRUCTION MANAGER OF ANY DISCREPANCIES PRIOR TO PROCEEDING WITH THE WORK. ALL DIMENSIONS ARE TO THE FACE OF THE FINISHED SURFACE UNLESS NOTED OTHERWISE. ALL DIMENSIONS TO BE TAKEN FROM DESIGNATED DATUM POINT. DO NOT SCALE DRAWINGS.
- 7. GENERAL CONTRACTOR SHALL PATCH AND REPAIR ALL EXISTING WALLS, FLOORS, CEILINGS, OR OTHER SURFACES IDENTIFIED TO REMAIN THAT MAY BECOME DAMAGED DURING THE COURSE OF THE
- 8. THE GENERAL CONTRACTOR IS RESPONSIBLE FOR OBTAINING PERMITS FOR FIRE PROTECTION, PLUMBING, MECHANICAL, AND ELECTRICAL SYSTEMS PRIOR TO INSTALLATION OF SUCH SYSTEMS
- 9. GENERAL CONTRACTOR SHALL RETAIN ONE SET OF PERMIT PLANS ON-SITE TO DOCUMENT ALL CHANGES MADE DURING CONSTRUCTION. THE RECORD DRAWINGS SHALL BE ISSUED TO THE OWNER AT PROJECT CLOSE-OUT AS DESCRIBED IN THE GENERAL REQUIREMENTS OF THE PROJECT MANUAL.
- 10. GENERAL CONTRACTOR IS RESPONSIBLE FOR COORDINATING DELIVERY OF MATERIALS FROM STARBUCKS CONTRACTED THIRD PARTY LOGISTICS DISTRIBUTION SERVICES AND VENDOR DIRECT SHIPMENTS. SEE THE PROJECT MANUAL FOR ADDITIONAL INFORMATION.
- 11. RESPONSIBILITY FOR SUPPLY AND DELIVERY OF MATERIALS AND EQUIPMENT IS IDENTIFIED IN THE DRAWING SCHEDULE SHEETS UNDER THE COLUMN LABELED "RESPONSIBILITY".
- 12. FOR THE PURPOSE OF THE DOCUMENTS, TO "INSTALL", SHALL MEAN TO PROVIDE ALL FASTENERS, MISCELLANEOUS HARDWARE, BLOCKING, ELECTRICAL CONNECTIONS, PLUMBING CONNECTIONS AND OTHER ITEMS REQUIRED FOR A COMPLETE AND OPERATIONAL INSTALLATION, UNLESS OTHERWISE NOTED.

13. ALL ITEM SUBSTITUTIONS MUST BE APPROVED BY THE STARBUCKS

CONSTRUCTION MANAGER.

# **INDEX OF SHEETS**

SHEET	SHEET TITLE	BID SET	PERMIT SET	REVISION 1	REVISION 2	REVISION 3	REVISION 4	
LEGEND:	X - SHEET ISSUED R - SHEET ISSUED FOR REFERENCE AND COORDINATION ONLY SEE TITLEBLOCK FOR REVISION ISSUE DATE(S)							

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$\langle \lambda \rangle$							
1	G000	REVISIONS			X		
•		CENTRAL INFORMATION CONTRACTOR					
				^			
	G002	LIFE SAFETY ACCESSIBILITY PLAN	Х	Χ	Х		
	G003	FOOD SERVICE PLAN	Х	Х	Х		
	G004	ADA DETAILS 2017	Х	Χ	Х		
	G005	3D VIEWS	Х	Χ	Х		
	G006	RENDERINGS	Х	Χ	Х		

ARCHITE	CTURAL				
A001	ARCHITECTURAL SITE PLAN	Х	Χ	Х	
A002	ARCHITECTURAL SITE DETAILS	X	Χ	Х	
A003	ARCHITECTURAL SITE DETAILS	Х	Χ	Х	
A004	ARCHITECTURAL SITE DETAILS	X	Χ	Х	
A005	ARCHITECTURAL SITE DETAILS	X	Χ	Х	
A006	ARCHITECTURAL SITE DETAILS	Х	Χ	Х	
A101	BUILDING FLOOR PLAN	X	Χ	Х	
A102	BUILDING FLOOR PENETRATION PLAN	Х	Χ	Х	
A103	BUILDING ROOF PLAN	X	Χ	Х	
A201	BUILDING EXTERIOR ELEVATIONS	Х	Χ	Х	
A202	BUILDING EXTERIOR ELEVATIONS	X	Χ	Х	
A301	BUILDING SECTIONS	Х	Χ	Х	
A401	ENLARGED PLANS & ELEVATIONS	Х	Χ	Х	
A501	BUILDING DETAILS	Х	Χ	Х	
A601	SCHEDULES	Х	Χ	Х	
A602	WINDOW AND DOOR SCHEDULES & DETAILS	X	Х	Х	

INTERIOR	S				
I101	FF & E PLAN	X	Х	Х	
I101.1	LIMITED OPERATIONS FURNITURE LAYOUT	X	Х	Х	
I102	CASEWORK PLAN	X	Х	Х	
I103	REFLECTED CEILING PLAN	X	Х	X	
I103.1	DIMENSIONED RCP W/ UNDERLAY	X	Х	X	
I104	FLOOR FINISH PLAN	X	Х	X	
I105	FINISH DETAILS	X	Х	X	
1201	INTERIOR FINISH ELEVATIONS	X	Х	X	
1202	INTERIOR FINISH ELEVATIONS	X	Х	X	
1203	INTERIOR FINISH ELEVATIONS	X	Х	X	
I401	RESTROOM PLAN & ELEVATIONS	X	Х	X	
1402	ENLARGED BAR PLANS	X	Х	X	
1501	INTERIOR DETAILS	X	Х	X	
1502	INTERIOR DETAILS	X	Х	X	
1503	INTERIOR DETAILS	X	Х	Х	
1504	INTERIOR DETAILS	X	Х	X	
1505	INTERIOR DETAILS	X	Х	Х	
1601	SCHEDULES	X	Х	X	
1602	SCHEDULES	X	Χ	Х	
1603	SCHEDULES	Х	Х	Х	

E001	ELECTRICAL NOTES	X	X	X	
E002	ENERGY CALCULATIONS	X	Х	Х	
E003	ELECTRICAL SITE PLAN	X	Х	Х	
E101	POWER PLAN	X	Х	Х	
E102	LIGHTING PLAN	X	Х	Х	
E103	ENLARGED ELECTRICAL PLACEMENT PLAN	X	Х	Х	
E104	DATA DEVICE PLAN	X	Х	Х	
E501	ELECTRICAL DETAILS	X	Х	Х	
E502	ELECTRICAL DETAILS	X	Х	Х	
E601	ELECTRICAL PANEL SCHEDULES	X	Х	Х	
E602	SCHEDULES	Х	Х	Х	

M001	MECHANICAL NOTES	X	Х	X	
M101	MECHANICAL DESIGN PLAN	X	Х	Х	
M102	MECHANICAL ROOF PLAN	X	Х	Х	
M501	MECHANICAL DETAILS	X	Х	Х	
M502	EMS DETAILS	X	Х	Х	

P000	PLUMBING COORDINATION PLAN	X	X	X
P001	PLUMBING NOTES	X	Х	X
P101	PLUMBING SUPPLY PLAN	X	Х	Х
P102	PLUMBING WASTE & VENT PLAN	X	Х	X
P103	ENLARGED PLUMBING PLACEMENT PLAN	X	Х	Х
P104	SANITARY ISOMETRIC DIAGRAM	X	Х	X
P501	PLUMBING DETAILS	X	Х	X
P502	PLUMBING DETAILS	X	Х	Х
P503	PLUMBING DETAILS	X	Х	Х
P601	PLUMBING SCHEDULES	X	Х	X

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STARBUCKS TEMPLATE VERSION i2020-01-31

CONDITIONS. NEITHER PARTY SHALL HAVE ANY OBLIGATION

NOR LIABILITY TO THE OTHER (EXCEPT STATED ABOVE) UNTIL A

WRITTEN AGREEMENT IS FULLY EXECUTED BY BOTH PARTIES





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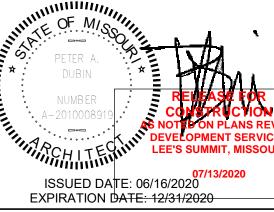
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Engineering Consultants Mechanical - Electrical - Plumbing



**の** & YOR, DR. S

STORE #: 62012 PROJECT #: 87799-001 ISSUE DATE: SR. DESIGN MANAGER: K. GORIN SLONSKI PRODUCTION DESIGNER: A. HAHN

E M O O

CHECKED BY:

**Revision Schedule** 

Rev Date By Description 7/7/2020 AH PERMIT COMMENTS

GENERAL INFORMATION

SCALE: AS SHOWN

SHEET NUMBER:

OUTDOOR SEATING						
DESCRIPTION	NUMBER OF ITEMS	TOTAL SEATS				
TABLE TOP, ROUND	3	6				
TABLE TOP, SQUARE	8	16				
ADA TABLES	2	4				
	TOTAL ACCESSIBLE SEATS	2				
	TOTAL	26				

EGRESS CALCULATION	
EXIT WIDTH REQUIRED - 73 OCC X 0.20	= 14.6 IN.
EXIT WIDTH PROVIDED	= 78 IN.
EXITS	= 36 IN. PRIMARY ENTRY, 42 IN. SECONDARY ENTRY
# EXITS REQUIRED	= 2
# EXITS PROVIDED	= 2
MAXIMUM ALLOWABLE TRAVEL DISTANCE	= 200'-0"
MAXIMUM TRAVEL DISTANCE PROVIDED	= 85'-4"
MINIMUM EXIT SEPARATION	= 75'-6" (MAXIMUM DIAGONAL) / 2 = 37'-9" IN.
EXIT SEPARATION PROVIDED	= 71'-0"

<b>PLUMBIN</b>	PLUMBING FIXTURE CALCULATION										
2018 INTERNA	ATIONAL PLUMB	ING CODE									
OCCUPANCY	MALE	FEMALE	TOTAL	72 (INT. OCC.) + 26 (DATIO) = 00							
	50 OCC	50 OCC	99 OCC	73 (INT. OCC.) + 26 (PATIO) = 99							
	WATERCLOSETS			URINALS	LAVAT	ORIES	WATER FOUNTAIN				
FIXTURES		1 PER 75		N/A	1 PEI	R 200	N/A				
FIXTURES	REQUIRED:	1 M	1 F	N/A	1 M	1 F	N/A				
	PROVIDED:	1 M	1 F	N/A	1 M	1 F	N/A				
	•		•	,	•	•					

LIFE SAFETY PLAN

Scale: 1/4" = 1'-0"

## 44 OCC CAFE: 660 SF / 15 9 OCC STANDING: 45 SF / 5 BAR: 395 SF / 200 2 OCC WORKROOM: 440 SF/ 300 2 OCC LINEAR SEATING: 300 IN / 18 16 OCC TOTAL OCC LOAD: **73 OCC**

**OCCUPANCY** 

# **LEGEND**

<b>←</b> X'-X" (XXMM) <b>→</b>	TRAVEL DISTANCE
	BARRIER FREE PATH OF TRAVEL (MIN 3'-0" - NO PINCH POINT)
2-9	EMERGENCY LIGHT

**EXIT SIGN** FIRE EXTINGUISHER ADA ACCESSIBLE SEATING

ADJACENT TENANT

NIC

30" X 52" CLEAR AREA

# HEALTH DEPT. PLAN NOTES

- A. GENERAL CONTRACTOR TO SCHEDULE WITH REFRIGERATION CONTRACTOR TO CONDUCT INITIAL FOOD CASE START-UP AND TESTING. FOR APPROVED CONTRACTOR, CONTACT THE VENDOR.
- B. THE SPACE IS SERVED BY THE MUNICIPAL WATER AND SEWER SYSTEM UNLESS OTHERWISE NOTED.
- C. ALL EQUIPMENT AND INSTALLATION WILL MEET NATIONAL SANITATION FOUNDATION STANDARDS OR

EQUIVALENT.

- D. EQUIPMENT UNITS SHALL CONTAIN NO EXPOSED THREADS, EMBELLISHMENTS OR OVERHANGING EDGES THAT SERVE AS PLACES FOR ACCUMULATION OF DUST, DIRT AND DEBRIS
- E. WARMING OVEN(S) SHOWN FOR PERMITTING PURPOSES. INSTALLATION AT STORE OPENING TO BE VERIFIED BY STARBUCKS CONSTRUCTION REPRESENTATIVE.
- F. EACH HAND WASHING WILL HAVE A SINGLE SERVICE TOWEL AND SOAP DISPENSER AND ALL HAND SINKS TO HAVE A COMBINATION FAUCET OR PREMIXING FAUCET.
- G. REFERENCE INTERIOR SCHEDULE SHEETS (1600 SERIES) FOR ADDITIONAL INFORMATION.
- H. PROVIDE SNEEZE GUARDS WHERE REQUIRED BY JURISDICTION.
- ALL FOOD STORAGE AND DISPLAY SHELVING SHALL BE A MINIMUM 6" (150MM) ABOVE FINISH FLOOR.

# **KEYED NOTES**

- 1. THRESHOLDS TO BE BARRIER FREE COMPLIANT PER ALL APPLICABLE CODES.
- 2. BARRIER-FREE PATH OF TRAVEL.
- 3. 30" X 52" CLEAR FOR WHEELCHAIR ACCESS.
- 4. 67" DIAMETER MINIMUM TURN RADIUS FOR WHEELCHAIR ACCESS.
- 5. 32" MINIMUM CLEAR AT RESTROOM DOOR.
- 6. POS TRANSACTION PLANE. CONDIMENT CART TOP AND HAND-OFF PLANE ARE 34 INCHES ABOVE THE FINISHED FLOOR FOR WHEELCHAIR ACCESSIBILITY.
- 7. PROVIDE BARRIER-FREE SIGNAGE AT ACCESSIBLE RESTROOMS PER ALL APPLICABLE CODES.
- 8. PROVIDE TACTILE "EXIT" SIGNAGE.
- 9. PROVIDE INTERNATIONAL SYMBOL OF ACCESSIBILITY SIGN WHERE
- REQUIRED BY APPLICABLE LAWS OR CODES. 10. GC TO PROVIDE AN APPROVED OCCUPANCY SIGN AS REQUIRED BY LOCAL CODE.

# HEALTH DEPT. FINISH SCHEDULE

FLOOR: POLYVINYL FLOORING

WALL: WALL TILE, BACKSPLASH, WITH POLYVINYL BASE

CEILING: PAINTED GYPSUM CEILING

FLOOR:

TILE FLOORING WALL: WALL TILE AND WOOD PANELING WITH COVED TILE BASE

AND WALL COVERING WITH COVED BASE CEILING: TECTUM CEILING TILES AND PAINTED GYPSUM CEILING

POLYVINYL FLOORING FRP WITH POLYVINYL BASE WALL: CEILING: VINYL CEILING TILE

RESTROOM

TILE FLOORING WALL TILE, COVED TILE BASE CEILING: GYPSUM CEILING, PAINTED

# **MEANS OF EGRESS NOTES**

- A. EVERY ROOM OR SPACE THAT IS ASSEMBLY OCCUPANCY SHALL HAVE THE OCCUPANT LOAD OF THE ROOM OR SPACE POSTED IN A CONSPICUOUS PLACE, NEAR THE MAIN EXIT ACCESS DOORWAY. POSTED SIGNS SHALL BE OF AN APPROVED LEGIBLE PERMANENT DESIGN AND SHALL BE MAINTAINED BY THE OWNER AUTHORIZED AGENT. (1004.3)
- B. EGRESS SHALL NOT PASS THROUGH KITCHENS, STORAGE ROOMS, CLOSETS OR SIMILAR SPACES. (1014.2)
- C. PANIC AND FIRE EXIT HARDWARE. WHERE INSTALLED ON DOORS IN THIS BUILDING SHALL SATISFY THE FOLLOWING (1008.1.10):
- 1) THE ACTUATION PORTION OF THE RELEASING DEVICE SHALL
- EXTEND AT LEAST ONE-HALF OF THE DOOR LEAF WIDTH.
- 2) THE MAXIMUM UNLATCHING FORCE DOES NOT EXCEED 15 POUNDS (6.8 KG).
- 3) PIVOTED OR BALANCED DOORS SHALL BE OF THE PUSH-PAD TYPE WHERE PANIC HARDWARE IS REQUIRED AND THE PAD SHALL NOT EXTEND ACROSS MORE THAN ONE-HALF OF THE
- DOOR WIDTH, MEASURED FROM THE LATCH SIDE. 4) PANIC HARDWARE LISTED IN ACCORDANCE WITH UL 305.
- 5) FIRE EXIT HARDWARE LISTED IN ACCORDANCE WITH UL 10C AND UL 305.
- STRUCTURAL ELEMENTS, FIXTURES OR FURNISHINGS SHALL NOT PROJECT HORIZONTALLY FROM EITHER SIDE MORE THAN 4 INCHES (100 MM) OVER ANY WALKING SURFACE BETWEEN 27 INCHES (685 MM) AND 80 INCHES (2030 MM) ABOVE THE WALKING SURFACE. EXCEPTION: HANDRAILS SERVING STAIRS AND RAMPS ARE PERMITTED TO PROTRUDE 4 1/2 INCHES (115 MM) FROM THE WALL. (1003.3.3)
- E. THE PATH OF EGRESS TRAVEL EXITS AND WITHIN EXITS IN THIS BUILDING SHALL BE IDENTIFIED BY EXIT SIGNS CONFORMING TO THE REQUIREMENTS OF SECTION 1011 AND AS NOTED BELOW:
- 1) EXIT SIGNS SHALL BE READILY VISIBLE FROM ANY DIRECTION OF EGRESS TRAVEL.
- 2) EXIT SIGNS SHALL BE LOCATED AS NECESSARY TO CLEARLY INDICATE THE DIRECTION OF EGRESS TRAVEL.
- 3) NO POINT IN A CORRIDOR SHALL BE MORE THAN 100 FT (30.5 M) OR THE LISTED VIEWING DISTANCE FOR THE SIGN, WHICHEVER IS LESS, FROM THE NEAREST VISIBLE EXIT SIGN.
- F. WHERE KEY OPERATED LOCKING DEVICES ARE USED, POST A SIGN ON OR ADJACENT TO THE REQUIRED MAIN EXIT DOOR WITH 1 INCH (25 MM) LETTERING STATING THAT "THIS DOOR TO REMAIN UNLOCKED WHEN BUILDING IS OCCUPIED". (1008.1.9.3)
- G. EGRESS DOORS OR GATES SHALL BE OPENABLE FROM THE EGRESS SIDE WITHOUT THE USE OF A KEY, SPECIAL KNOWLEDGE OR EFFORT. DOOR HANDLES, PULLS, LATCHES, LOCKS AND OTHER OPERATING DEVICES SHALL BE INSTALLED 34 INCHES (860 MM) TO 48 INCHES (1220 MM) ABOVE FINISHED FLOOR. MANUALLY OPERATED FLUSH BOLTS OR SURFACE BOLTS ARE NOT PERMITTED. THE UNLATCHING OF ANY DOOR OR LEAF SHALL NOT



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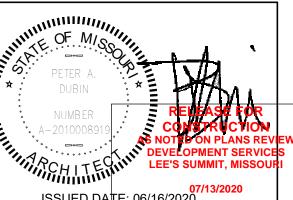
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Engineering Consultants Mechanical - Electrical - Plumbing



ISSUED DATE: 06/16/2020

EXPIRATION DATE: 12/31/2020

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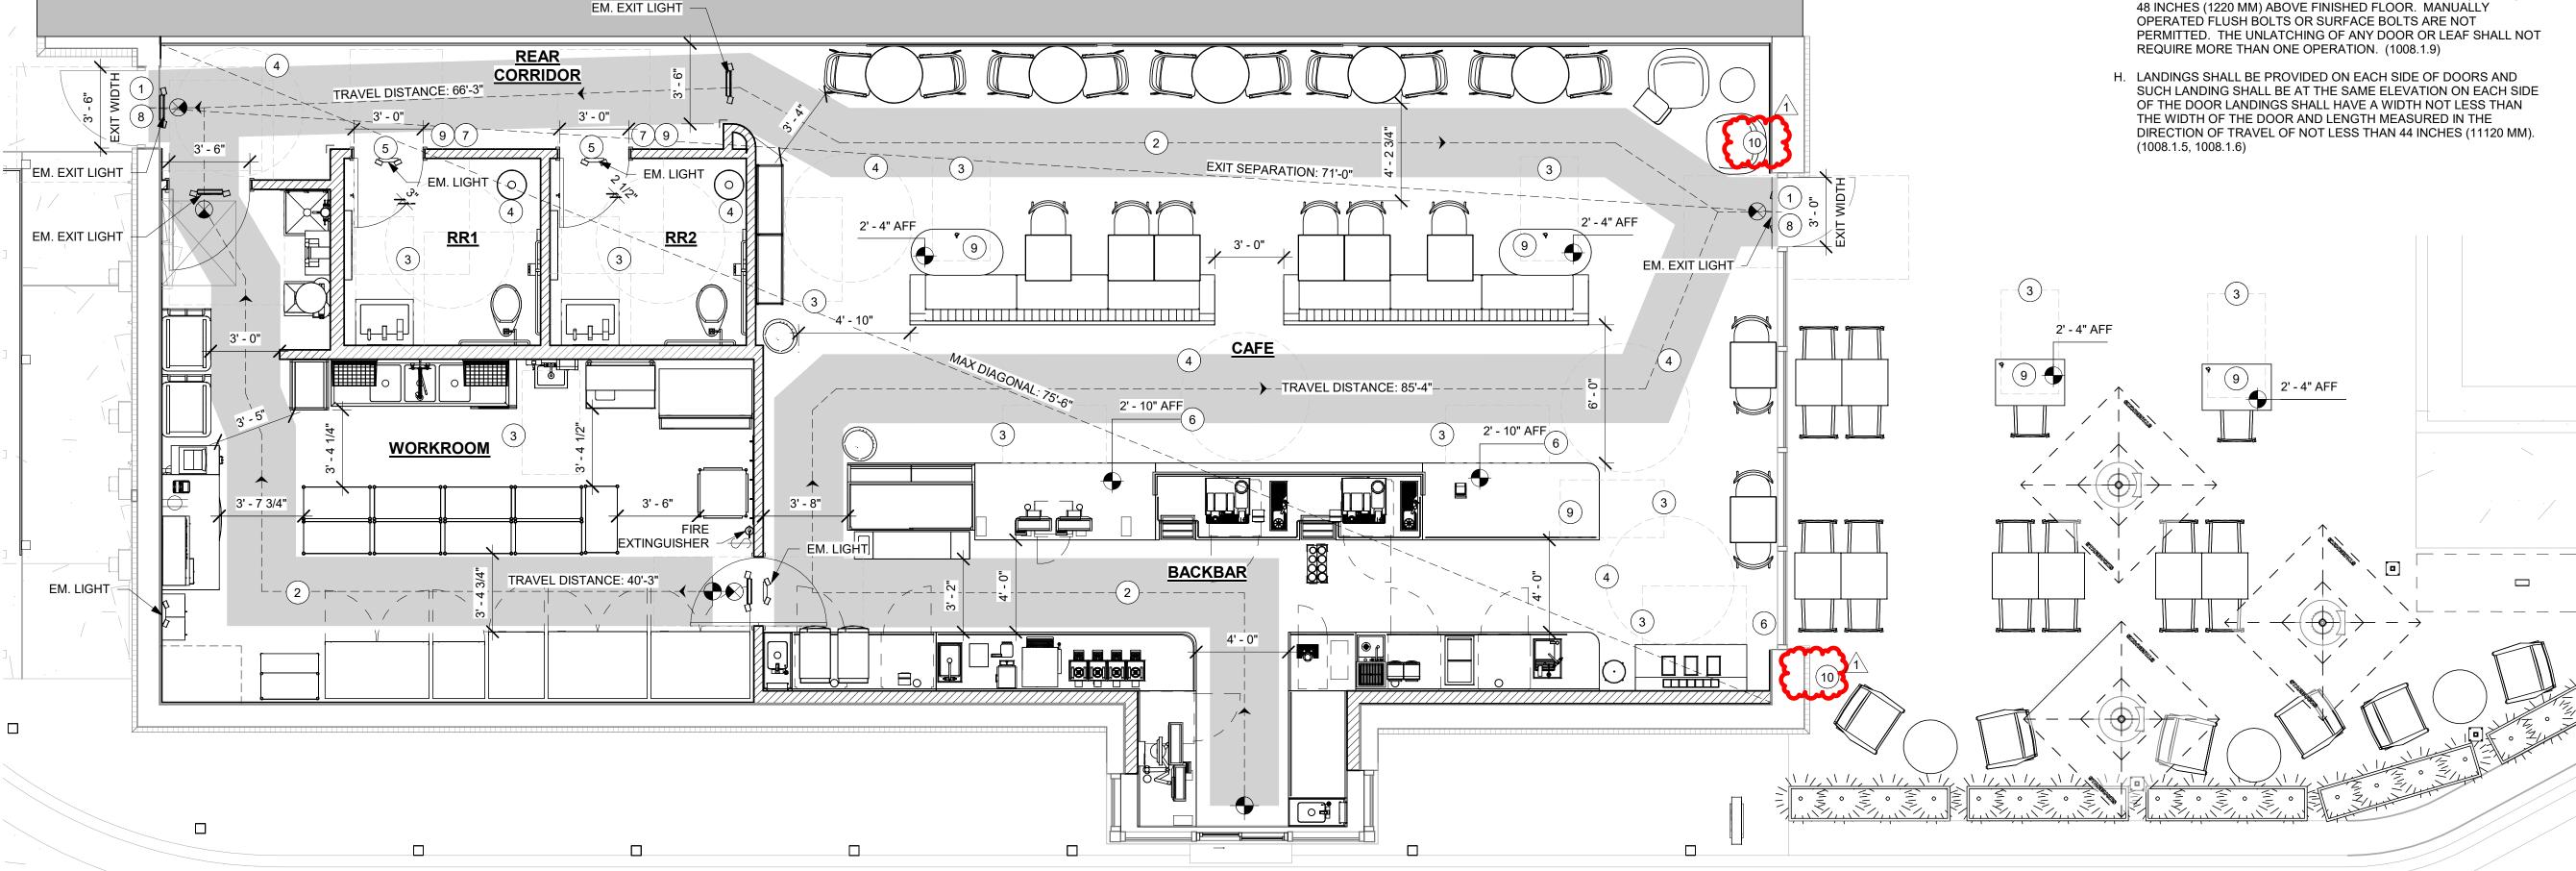
STORE #: 62012 PROJECT #: 87799-001 ISSUE DATE: SR. DESIGN MANAGER: K. GORIN SLONSK PRODUCTION DESIGNER: A. HAHN


**Revision Schedule** 

LIFE SAFETY ACCESSIBILITY PLAN SCALE: AS SHOWN

SHEET NUMBER:

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ISSUED DATE: 06/16/2020

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Description

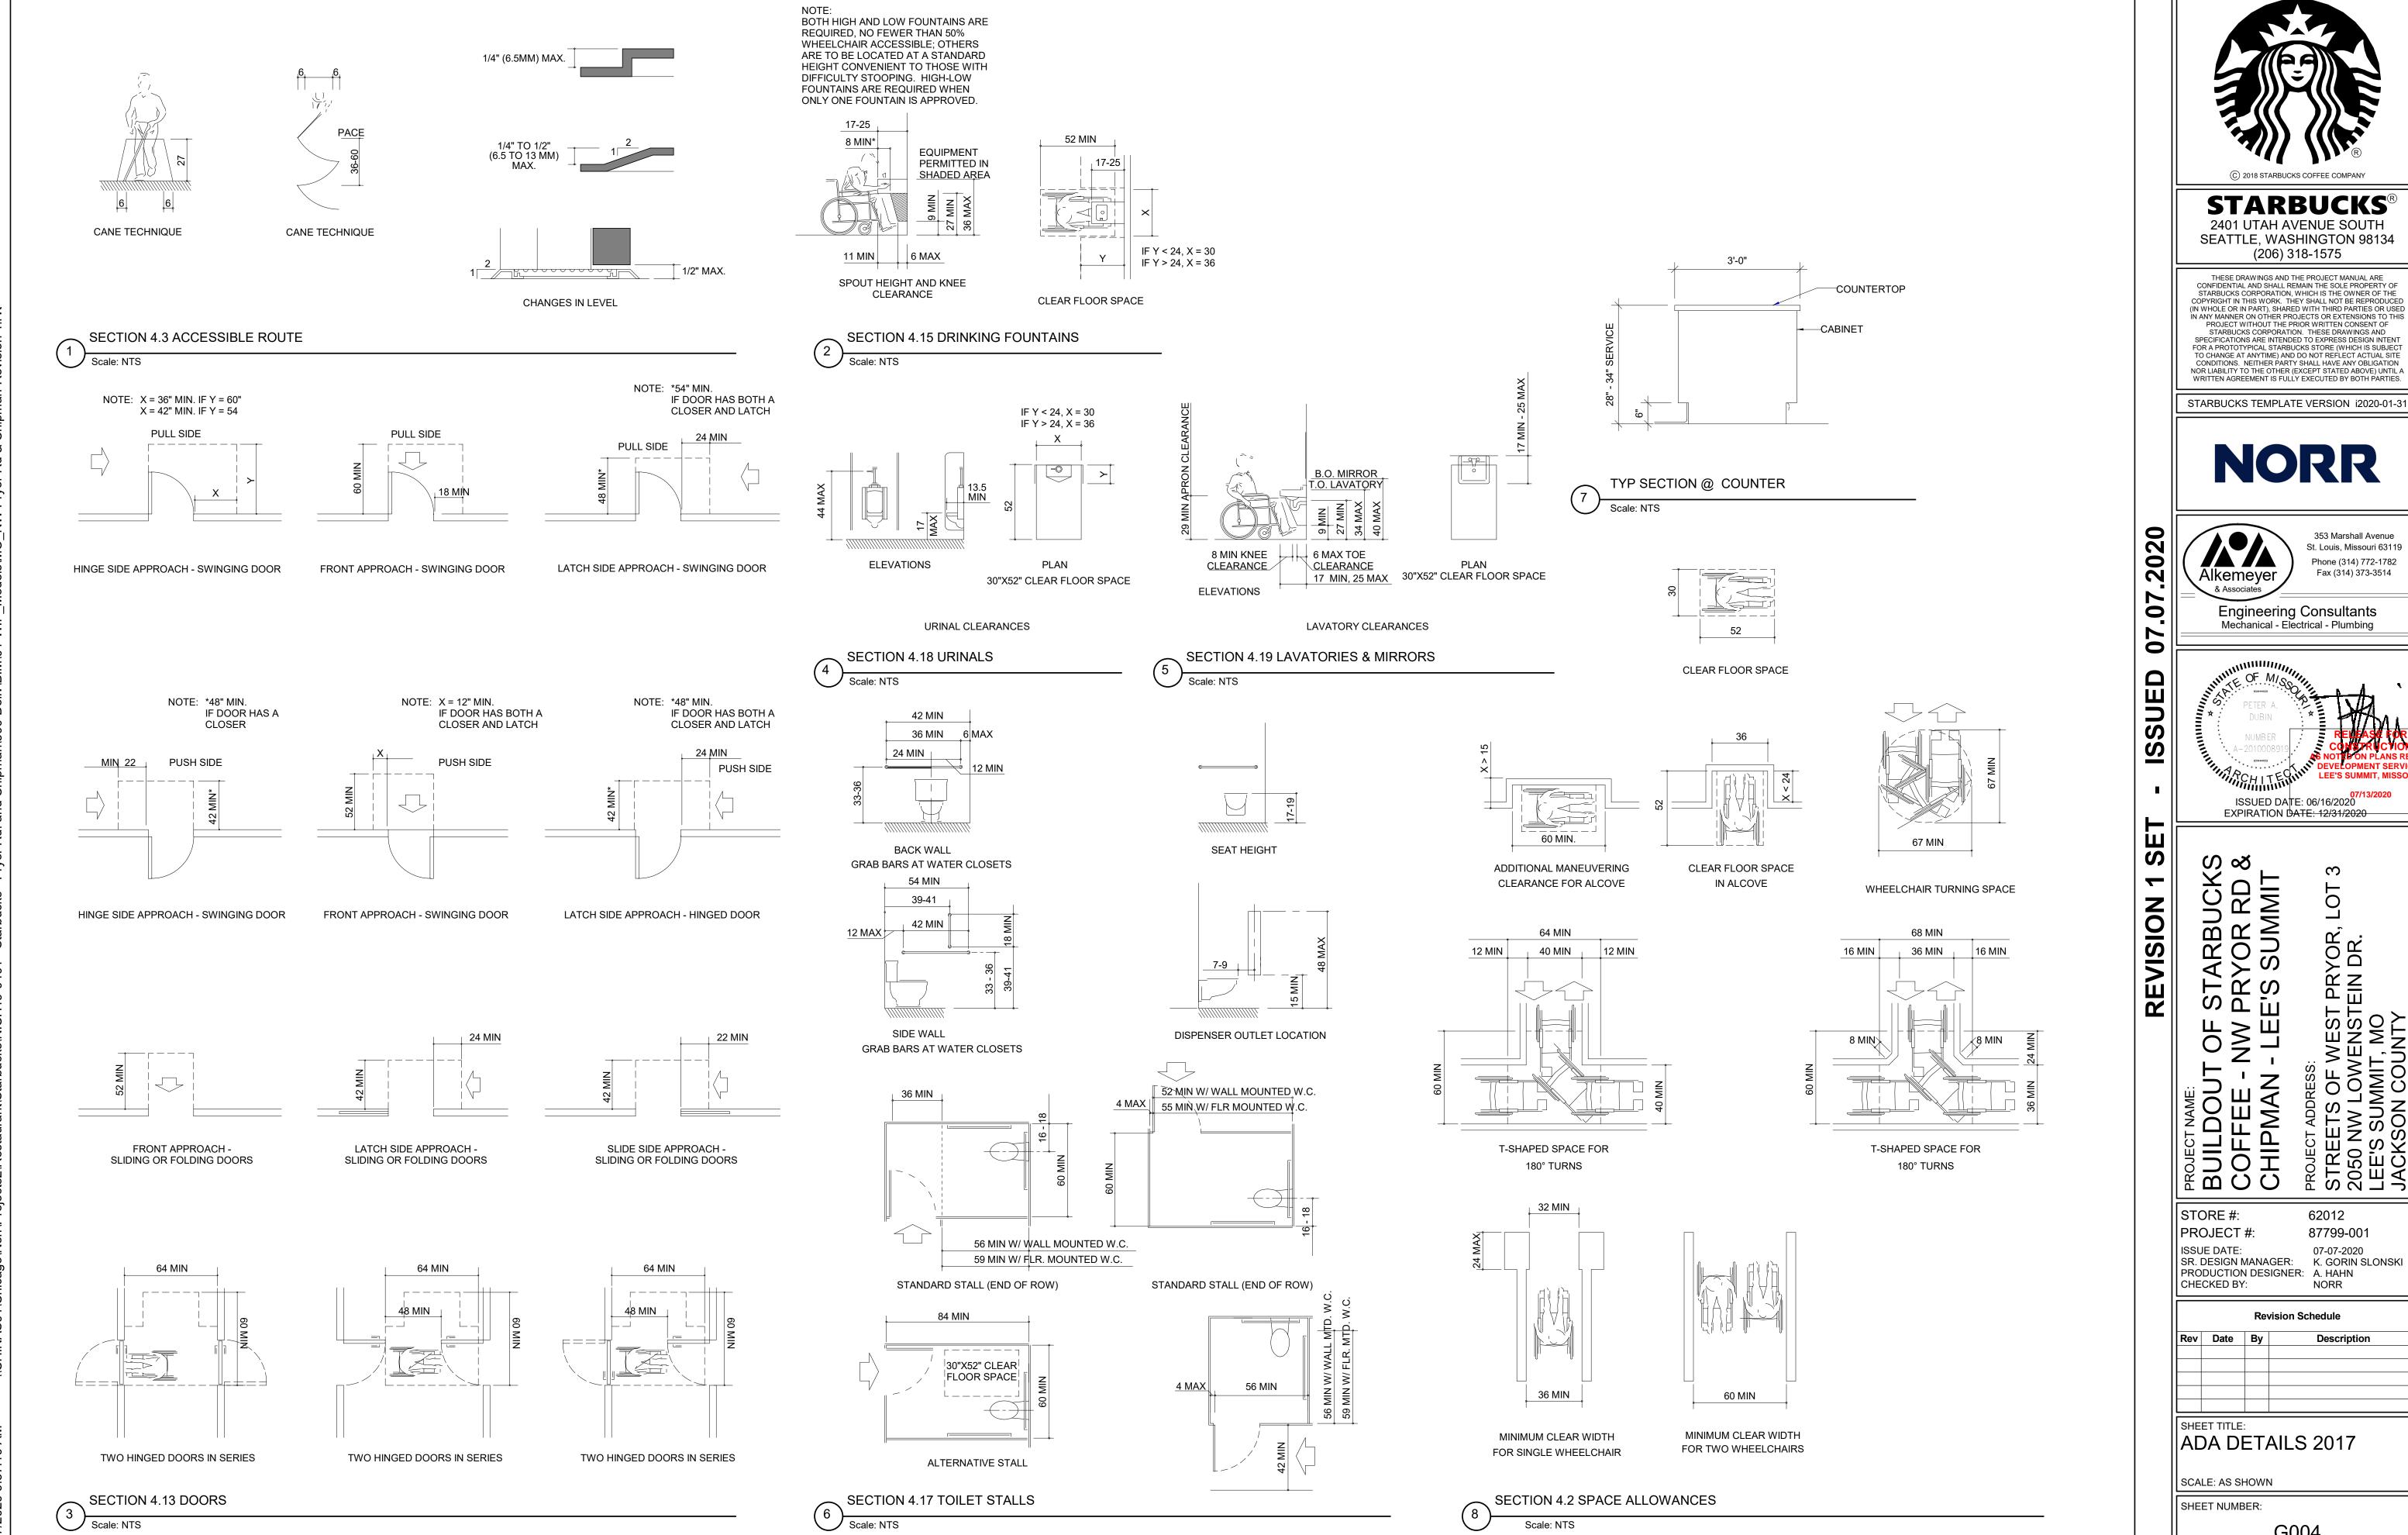
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CAFE VIEW FROM NORTHWEST



CAFE VIEW FROM EAST



CAFE VIEW FROM SOUTHEAST

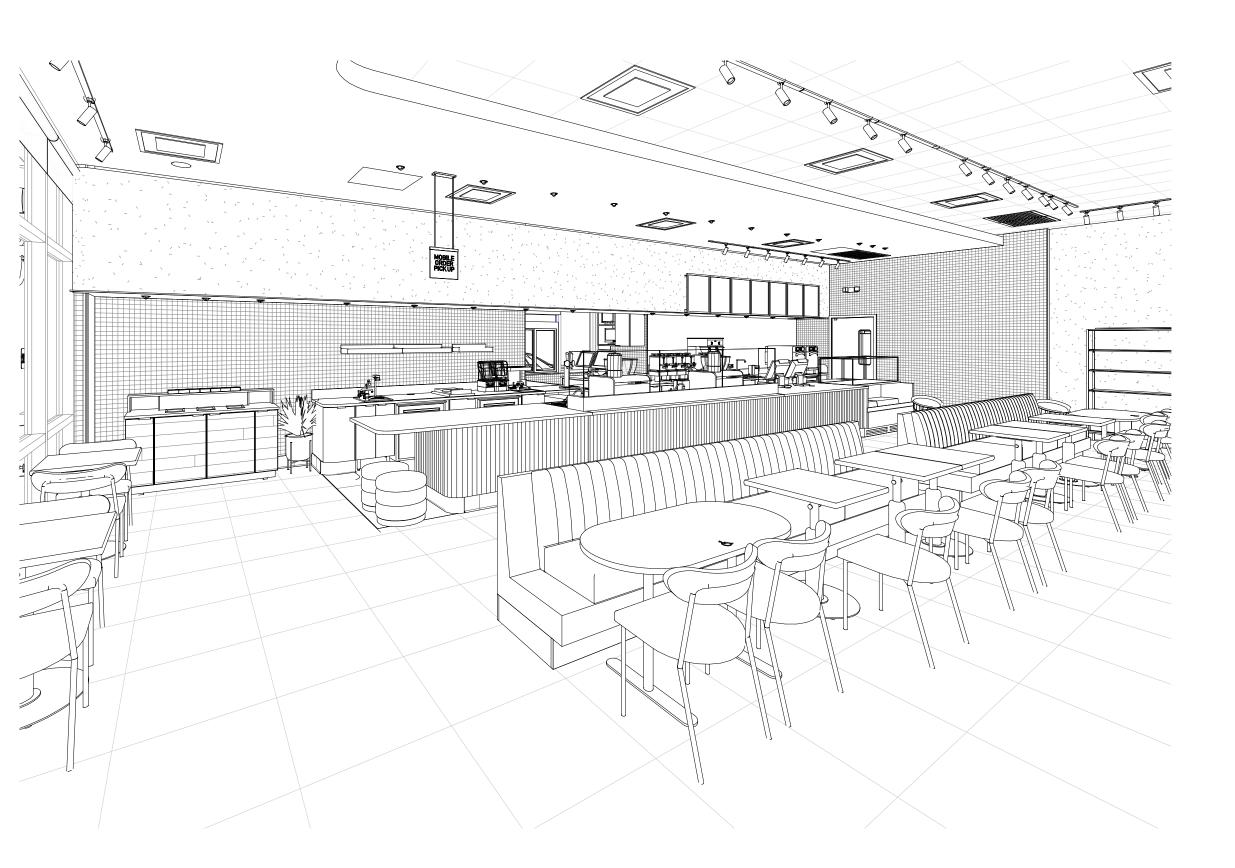

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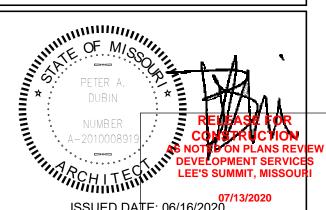
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SHEET TITLE:
3D VIEWS

SCALE: AS SHOWN

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CAFE VIEW FROM SOUTHWEST



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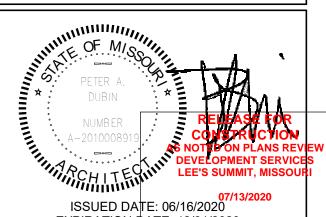


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SR. DESIGN MANAGER: K. GORIN SLONSKI
PRODUCTION DESIGNER: A. HAHN
CHECKED BY: NORR

SHEET TITLE:
RENDERINGS

SCALE: AS SHOWN

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Y 20075 (3)

Y 12147 (3)

B. LANDSCAPING TO BE PROVIDED PER ZONING CODE AND SUSTAINABILITY REQUIREMENTS.

C. DRIVE-THRU EQUIPMENT INCLUDING VEHICLE DETECTION LOOP, WIRELESS COMMUNICATION AND MONITORS SHALL BE COORDINATED BY STARBUCKS CONSTRUCTION MANAGER. REFER TO ELECTRICAL DRAWINGS FOR ADDITIONAL REQUIREMENTS.

D. PROVIDE 6" (150MM) THICK CONCRETE PAVING THE LENGTH OF THE DRIVE-THRU LANE, EXTENT TO INCLUDE DRIVE-THRU ENTRY POINT THROUGH WINDOW STANDING PAD.

E. GENERAL CONTRACTOR TO APPLY CONCRETE SEALER TO ALL EXTERIOR CONCRETE PATIO AND WALKWAY SURFACES.

F. GENERAL CONTRACTOR TO VERIFY ALL EXISTING ELEVATIONS AND BUILDING CONDITIONS IN FIELD PRIOR TO START OF CONSTRUCTION.

G. PROVIDE DETECTABLE WARNING (IF APPLCABLE PER LOCAL CODE) AT TRANSITION FROM SIDEWALK TO DRIVE AISLE.

H. ACCESSIBLE PARKING SPACES AND ACCESS AISLES SHALL HAVE SURFACE SLOPE NOT TO EXCEED 2% IN ALL DIRECTIONS.

REFER TO ELECTRICAL DRAWINGS FOR SITE RELATED ELECTRICAL WORK.

J. SCRAPE AND REPAINT ALL EXISTING PAINTED SITE FEATURES, INCLUDING, BUT NOT LIMITED TO CURBS, BOLLARDS, RAILINGS AND SITE LIGHTING BASES.

K. SEE SHEET A002 FOR ARCHITECTURAL SITE DETAILS.

# **KEYED NOTES**

- 1. DRIVE-THRU WINDOW, HAND-OFF SHELF, AND AIR CURTAIN
- 2. 5-PANEL MENU BOARD. LL TO PROVIDE AND INSTALL CONDUIT, FOOTING, AND ANCHOR BOLTS PER LLWL.
- 3. DIGITAL ORDER SCREEN AND CANOPY. REFER TO DOS CONTROL BOX FOR MORE INFORMATION. LL TO PROVIDE AND INSTALL CONDUIT, FOOTING, AND ANCHOR BOLTS PER
- 4. PRE-MENU BOARD. LL TO PROVIDE AND INSTALL CONDUIT, FOOTING AND ANCHOR BOLTS PER LLWL.
- 5. FREESTANDING CLEARANCE BAR. LL TO PROVIDE AND INSTALL FOOTING AND ANCHOR BOLTS PER LLWL.
- 6. SHARED TRASH ENCLOSURE BY LL.
- BUILDING ENTRANCE.
- 8. 42" REAR EXIT DOOR BY LL.
- 9. ADA PARKING, STRIPING, CURB CUTS AND SIGNAGE BY LL.
- 10. "DO NOT ENTER" PAVEMENT MARKING BY LL.
- 11. PROPERTY LINE
- 12. LL TO PROVIDE KEYED, FROST-FREE RECESSED HOSE BIB PER LLWL. SEE EXTERIOR ELEVATIONS FOR MORE INFORMATION
- 13. GREASE INTERCEPTOR BY LL. CAPACITY: 1500 GALLONS PER LL DRAWINGS.
- 14. PATIO SEATING AREA BY LL. LL TO PROVIDE IRRIGATED PLANTERS, PLANTS, AND LANDSCAPED AREA AS INDICATED. ELECTRICAL FOR FANS/ STRING LIGHTS TO BE PROVIDED BY LL PER LL CRITERIA PACKAGE STANDARDS.
- 15. LL TO PROVIDE 6" THICK CONCRETE DRIVE-THRU LANE WHICH SHALL EXTEND FROM 12FT FROM THE CENTERLINE OF THE ORDER SCREEN TO 12FT BEYOND THE CENTERLINE OF THE DRIVE-THRU WINDOW.
- 16. BIKE RACK PROVIDED BY LL. SPECIFICATION PER SBUX.
- 17. MONUMENT SIGN BY LL. SBUX TO PROVIDE PANEL FACES ONLY. BASE SIGN, FOOTING, ANCHOR BOLTS, AND CONDUIT TO BE PROVIDED BY LL.
- 18. LL TO PROVIDE COVERED EXTERIOR ELECTRICAL OUTLETS PER LLWL. SEE EXTERIOR ELEVATIONS AND ELECTRICAL SHEETS FOR MORE INFORMATION.
- 19. ILLUMINATED DRIVE THRU 'EXIT ONLY/ THANK YOU' SIGN. LL TO PROVIDE AND INSTALL CONDUIT, FOOTING AND ANCHOR **BOLT CONNECTIONS PER LLWL.**
- 20. "MOBILE ORDER PAY PARKING ONLY" SIGN BY LL.
- 21. KEYED, FROST-FREE RECESSED HOSE BIB TO BE INSTALLED IN TRASH ENCLOSURE PER LLWL.
- 22. DRIVE-THRU LANE TO BE 1'-0" AWAY FROM BUMPOUT PER LL CRITERIA PACKAGE REQUIREMENTS.
- 23. EMPLOYEE EGRESS PATH AND CURB CUTS TO TRASH ENCLOSURE BY LL PER LLWL.
- 24. INDICATES BUILDING CANOPY ABOVE. TO BE PROVIDED BY LL. LL TO PROVIDE BLOCKING, AS NECESSARY, AND RECESSED CAN LIGHTS PER LLWL. BUILDING CANOPY TO EXTEND A MINIMUM OF 4'-0" FROM EXTERIOR WALL PER LLWL REQUIREMENTS.
- 25. INSTALL VEHICLE DETECTOR LOOP @ CENTERLINE FOR ORDER POINT & DRIVE THRU WINDOW. REFER TO SITE DETAILS FOR MORE INFORMATION. LL TO PROVIDE ELECTRICAL.
- 26. WALL MOUNTED FAN. LL TO PROVIDE ELECTRICAL
- 27. PROVIDE PROTECTIVE BOLLARDS ON BOTH SIDES OF EXTERIOR UTILITY SERVICES ADJACENT TO VEHICULAR TRAFFIC. EXAMPLES INCLUDE FIRE STAND PIPE, GAS, AND ELECTRICAL METERS, SITE TRANSFORMERS, ETC.
- 28. STARBUCKS SIGNAGE VENDOR TO COORDINATE APPROVALS AND PERMITS FOR EXTERIOR SIGNAGE SEPARATELY AS REQUIRED.
- 29. LANDSCAPE BUFFER AREA AT PATIO BY LL. LL TO PROVIDE IRRIGATION AND PLANTS PER LLWL.
- 30. LL TO PROVIDE AND INSTALL 5IN SQUARE, NON ILLUMINATED BOLLARDS AS INDICATED PER LLWL. REFER TO SITE DETAILS FOR MORE INFORMATION.
- 31. LL TO PROVIDE UTILITY SCREEN PER LLWL REQUIREMENTS.
- 32. GAS METER LOCATION PER LL DRAWINGS.
- 33. ELECTRICAL METER LOCATION PER LL DRAWINGS.
- 34. EXTERIOR ROOF LADDER PER LL DRAWINGS.
- 35. GC TO REMOVE EXISTING DT SHELF.





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62012 PROJECT #: 87799-001 SR. DESIGN MANAGER: K. GORIN SLONSKI PRODUCTION DESIGNER: A. HAHN

CHECKED BY: NORR **Revision Schedule** 

STORE #:

ISSUE DATE:

ARCHITECTURAL SITE PLAN

SHEET NUMBER:

SCALE: AS SHOWN

A001

ARCHITECTURAL SITE PLAN - FOR REFERENCE ONLY Scale: 1" = 20'-0"

(30) Y 14103

Y 14120

(25)Y X0001

3 Y 14163

Y 14116

Y 15700

(30) Y 14103

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Y X0009 (20) Y X0004 (5) (14) NOTE: SITE PLAN PREPARED IN REFERENCE TO THE LANDLORD

CIVIL PLAN DATED: 04/24/20. NOTE: ALL SIGNAGE UNDER SEPARATE PERMIT, SHOWN FOR COORDINATION PURPOSES ONLY.

**LEGEND** 

\* \* \* \* \* \* LANDSCAPE AREA


EXTENTS OF CONCRETE PAD BY LANDLORD GC

Y 14103

Y X0001


12' - 0"

6" CONCRETE PAD BY LL

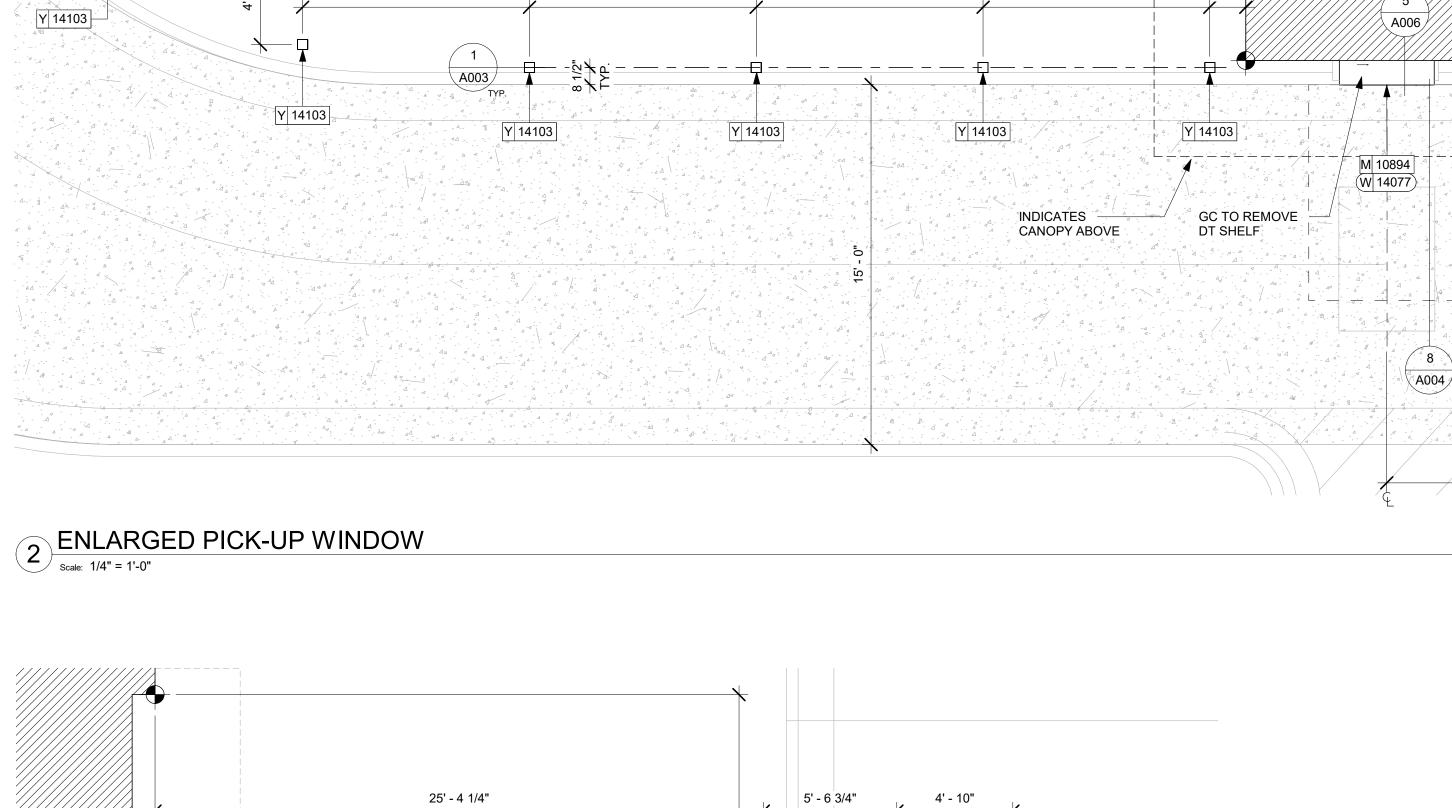

9' - 5"

9' - 5"

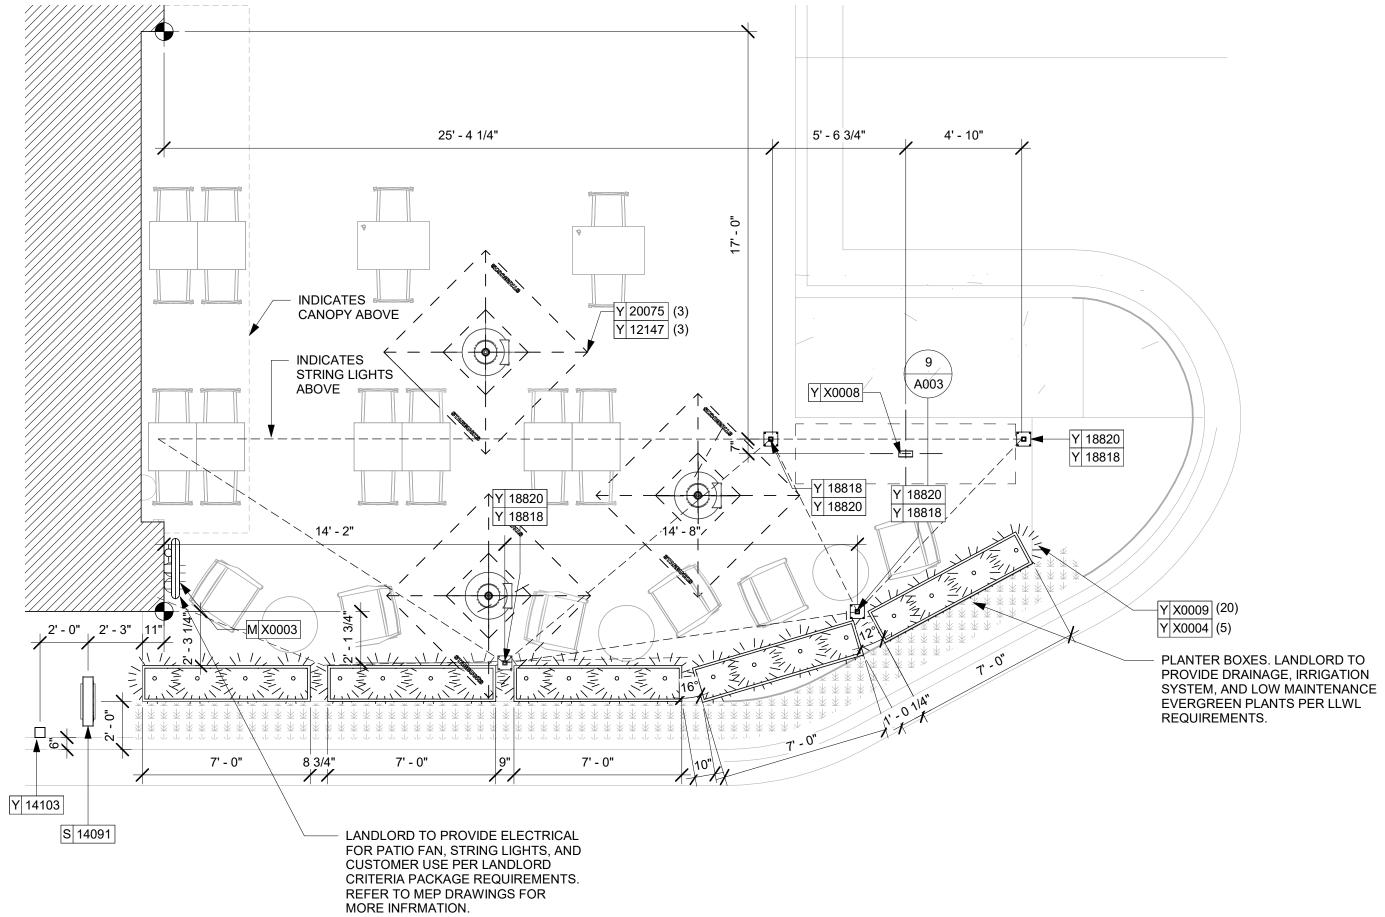

ENLARGED ORDER POINT Scale: 1/4" = 1'-0"

**ENLARGED PATIO** Scale: 1/4" = 1'-0"



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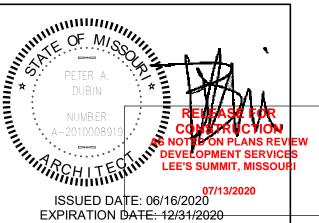
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62012 87799-001 ISSUE DATE: 07-07-2020 SR. DESIGN MANAGER: K. GORIN SLONSKI PRODUCTION DESIGNER: A. HAHN

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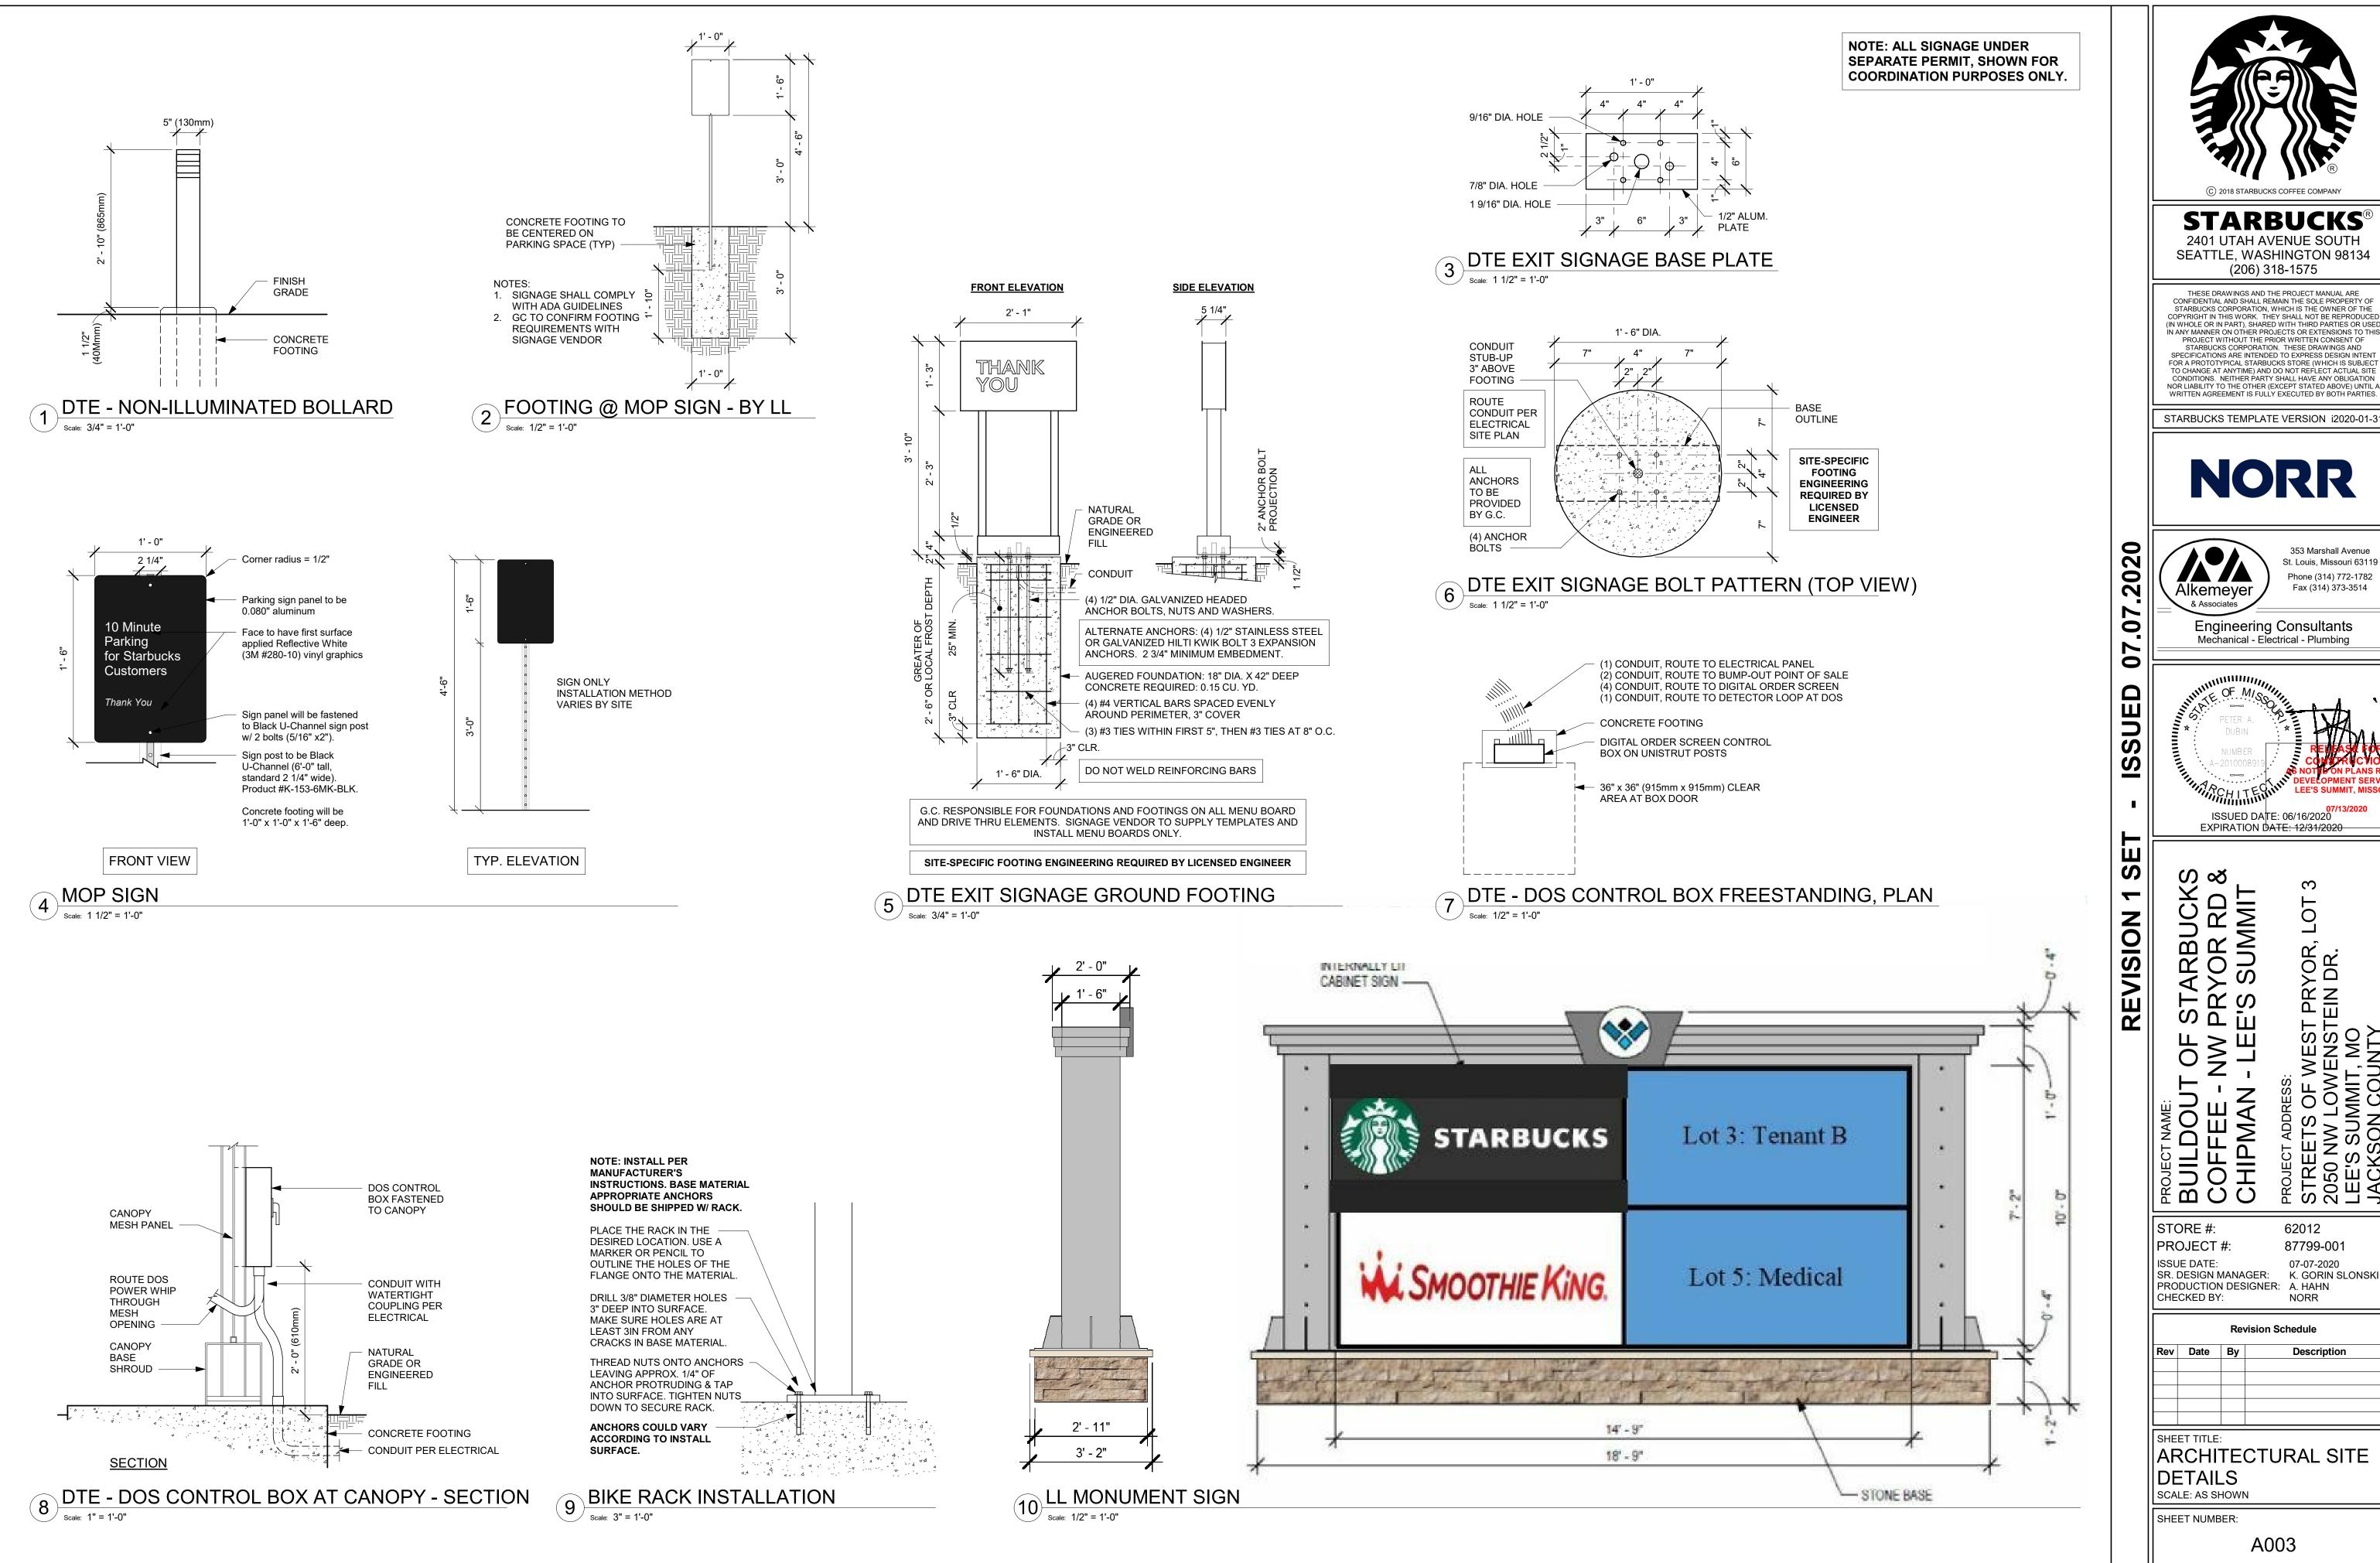
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Rev	Date	Ву	Description

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A002



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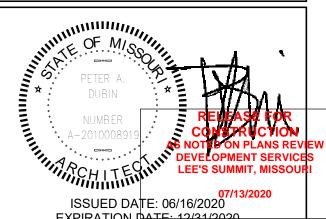
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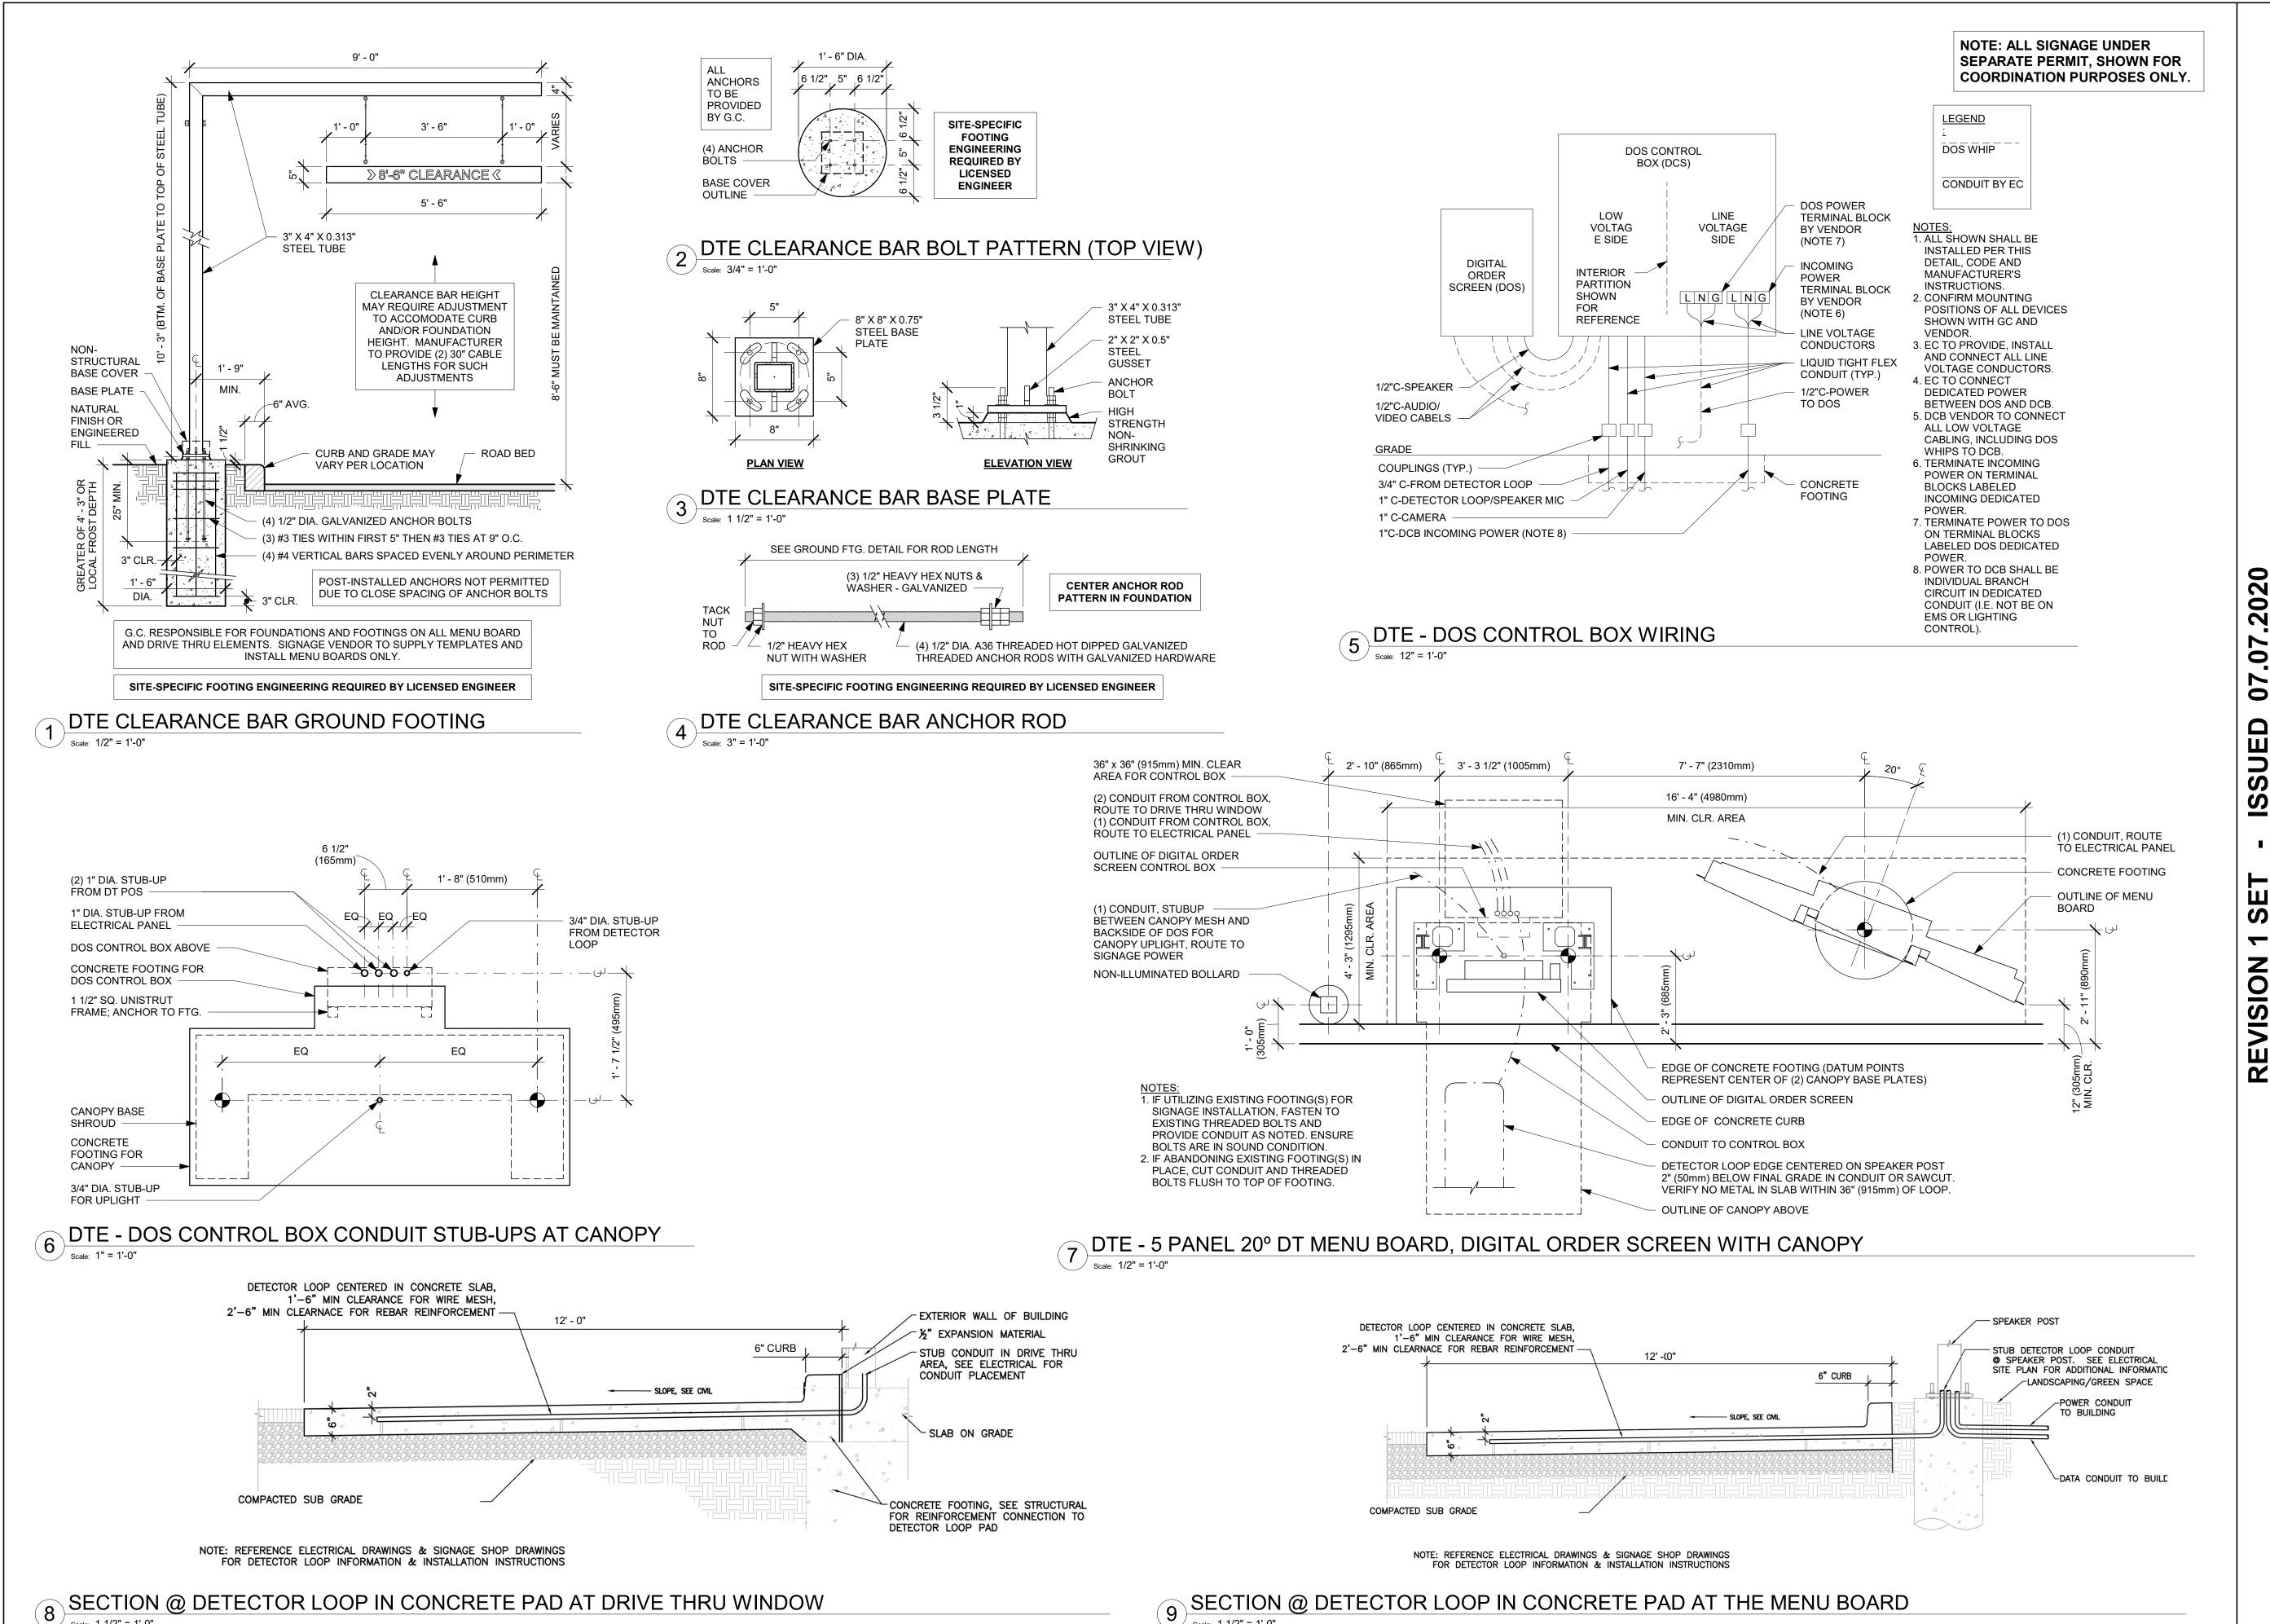
62012 87799-001 07-07-2020

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**Revision Schedule** 

Description

ARCHITECTURAL SITE



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STORE #:

62012 87799-001 07-07-2020

PROJECT #: **ISSUE DATE** SR. DESIGN MANAGER: K. GORIN SLONSKI PRODUCTION DESIGNER: A. HAHN CHECKED BY: NORR

**Revision Schedule** 

Description


ARCHITECTURAL SITE DETAILS

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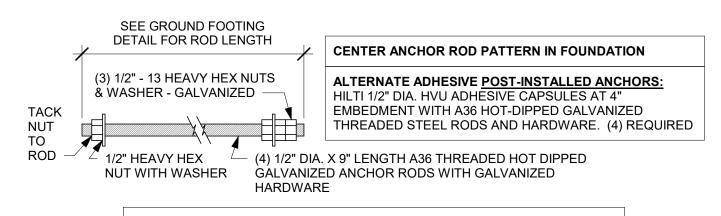
SCALE: AS SHOWN

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9 SECTION @ DETECTOR LOOP IN CONCRETE PAD AT THE MENU BOARD




DTE 5-PANEL MENU BOARD BOLT PATTERN (TOP VIEW)

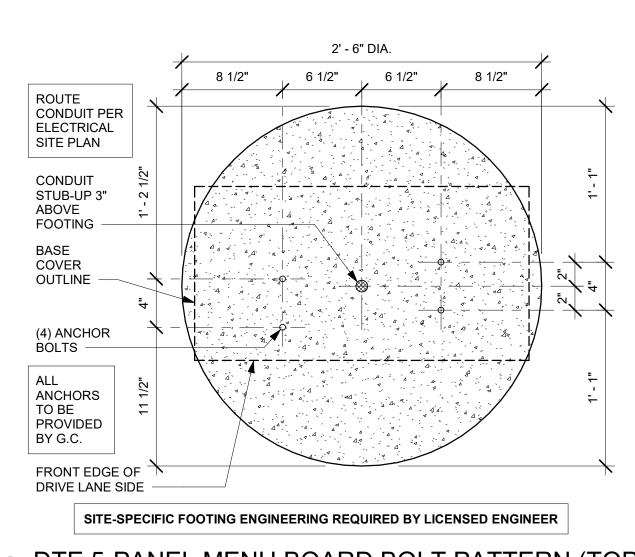


SITE-SPECIFIC FOOTING ENGINEERING REQUIRED BY LICENSED ENGINEER


5 DTE PRE-MENU ANCHOR ROD

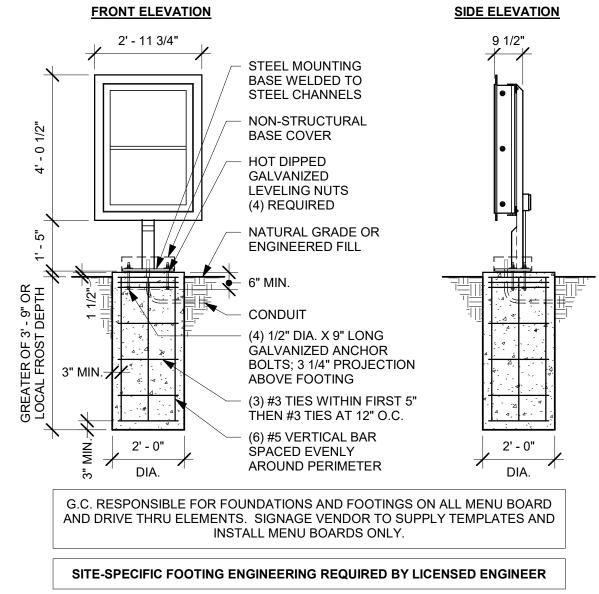


DTE PRE-MENU GROUND FOOTING

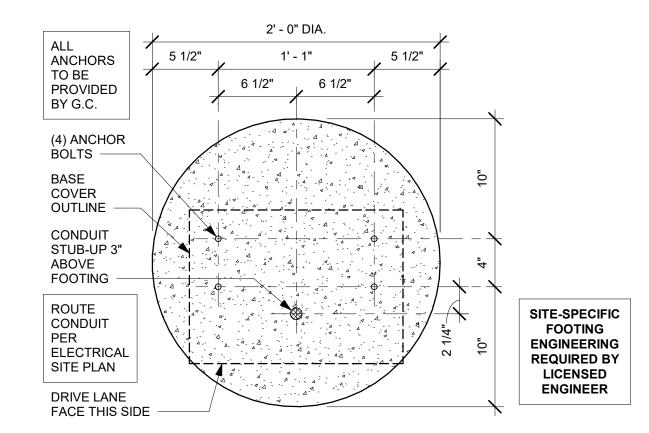


DTE PRE-MENU BOLT PATTERN (TOP VIEW)

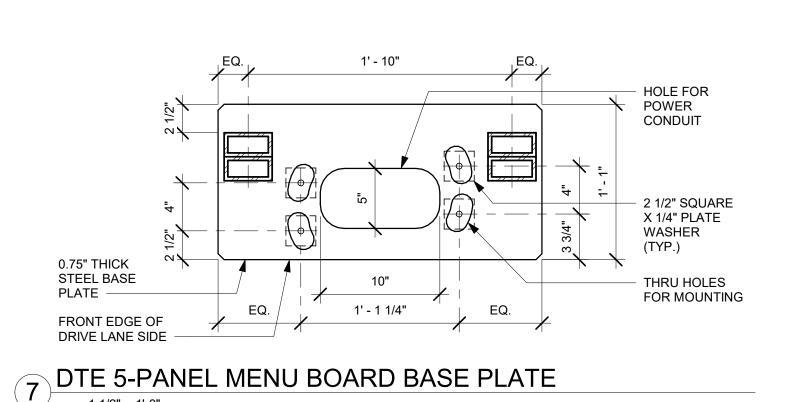


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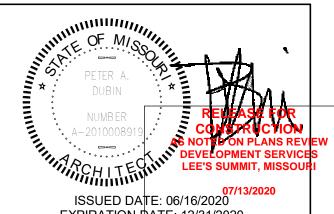
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62012 PROJECT #: 87799-001 07-07-2020 SR. DESIGN MANAGER: K. GORIN SLONSKI PRODUCTION DESIGNER: A. HAHN
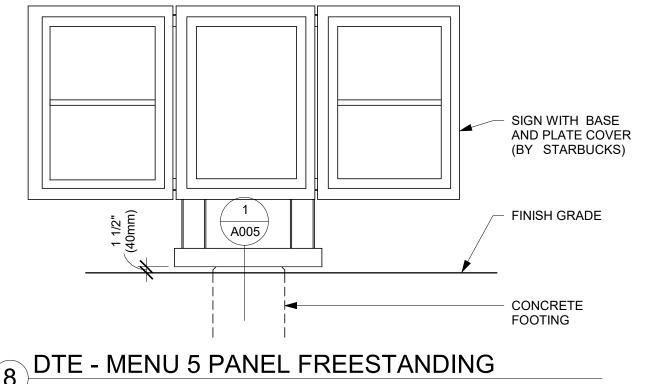
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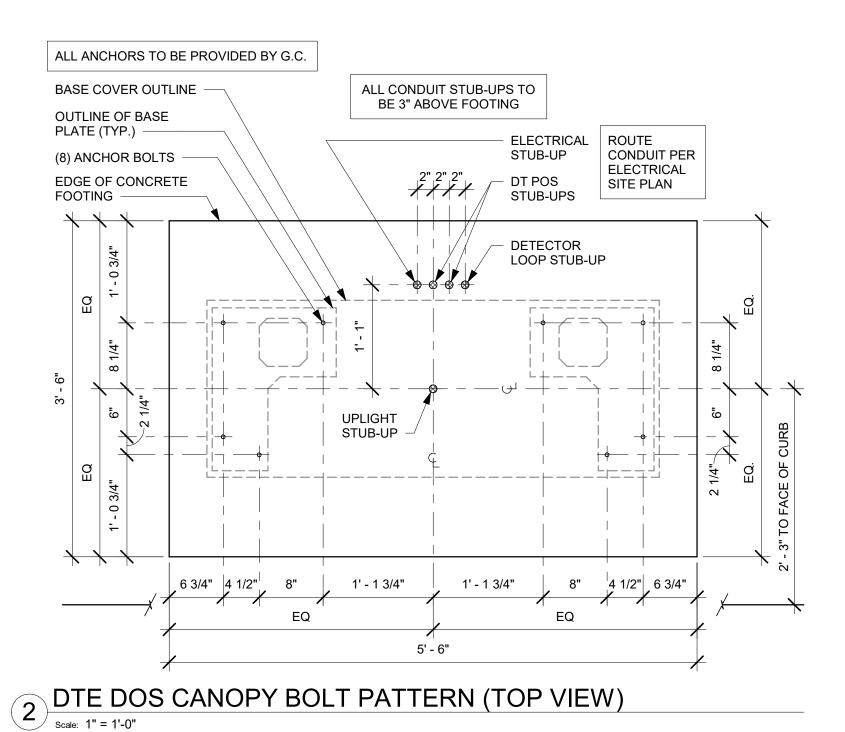
ARCHITECTURAL SITE DETAILS SCALE: AS SHOWN

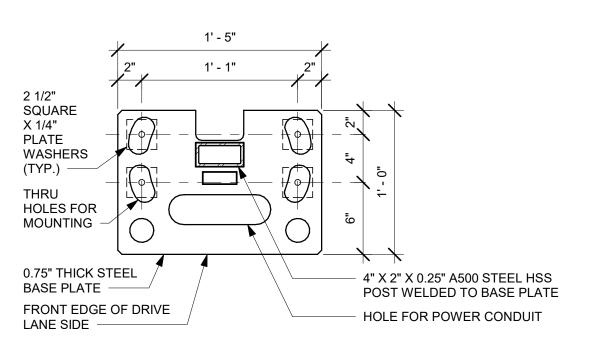
SHEET NUMBER:

A005

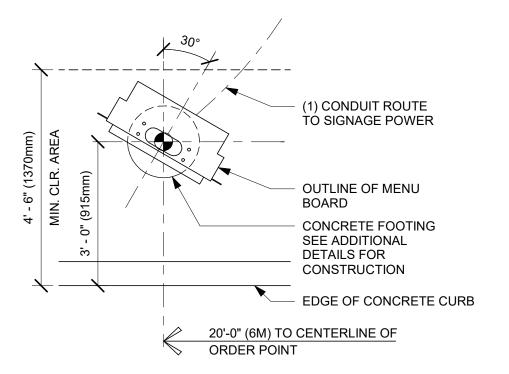9 DTE PRE-MENU BASE PLATE

10 DTE - PRE-MENU 30 DEG




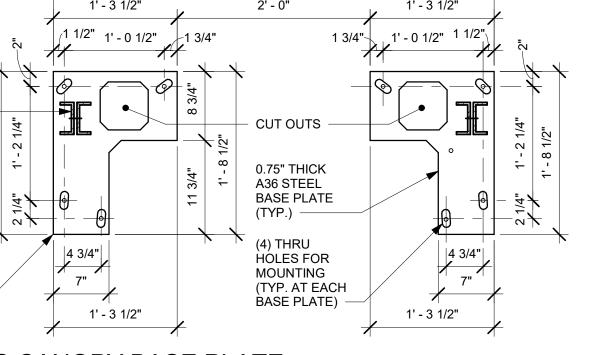




FRONT


EDGE OF DRIVE LANE

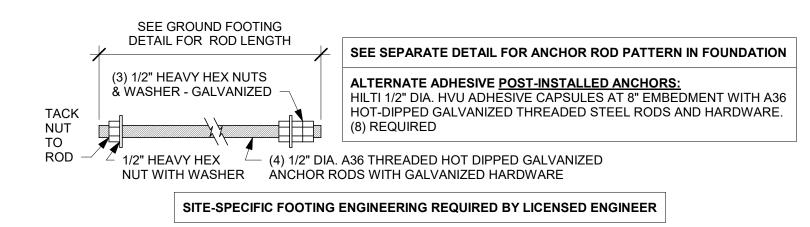


# DTE DOS CANOPY ANCHOR ROD

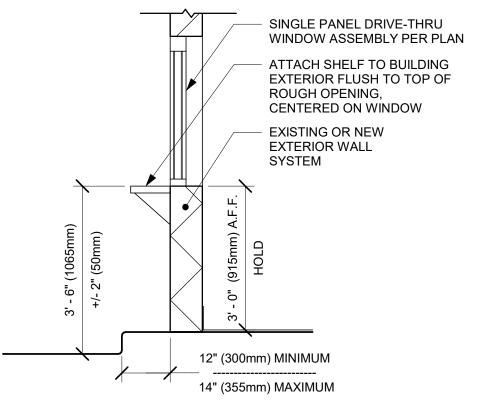





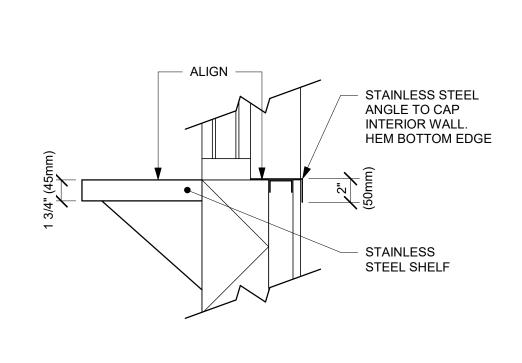



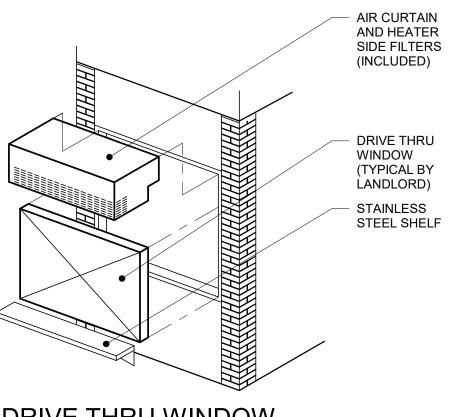

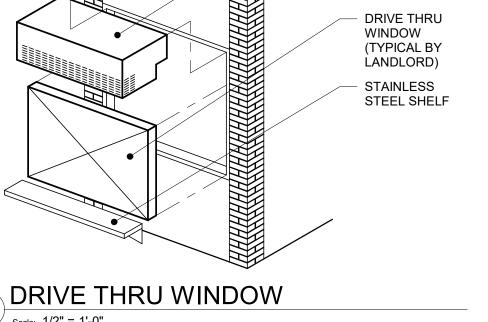

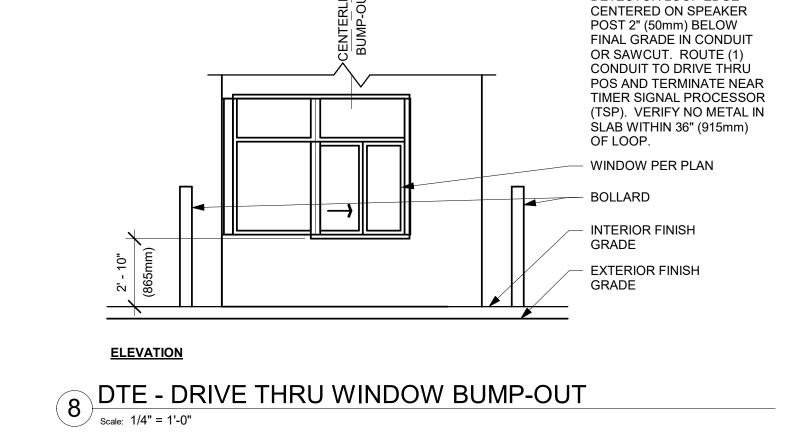

9'-1" (2770mm) MIN.

10'-1" (3075mm) MAX. CLR.

BOLLARD

1' - 6" (460mm)

<u>PLAN</u>

NOTE: ALL SIGNAGE UNDER SEPARATE PERMIT, SHOWN FOR COORDINATION PURPOSES ONLY.



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CONCRETE INFILL AT

BOLLARD

WINDOW BUMP-OUT

CONCRETE CURB WINDOW PER PLAN


SIDE WINDOW PER PLAN

DETECTOR LOOP EDGE

S F

353 Marshall Avenue St. Louis, Missouri 63119 Phone (314) 772-1782 Fax (314) 373-3514

**Engineering Consultants** Mechanical - Electrical - Plumbing

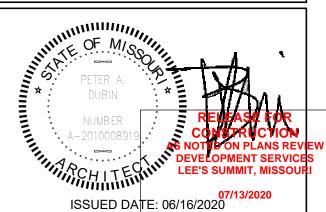

ISSUED DATE: 06/16/2020

EXPIRATION DATE: 12/31/2020 

ARBUCK YOR RD SUMMIT LOT YOR, DR. BUILDOUT
COFFEE CHIPMAN

STORE #: 62012 PROJECT #: 87799-001 ISSUE DATE: 07-07-2020 SR. DESIGN MANAGER: K. GORIN SLONSKI PRODUCTION DESIGNER: A. HAHN CHECKED BY: NORR

**Revision Schedule** 

Description

ARCHITECTURAL SITE DETAILS SCALE: AS SHOWN

SHEET NUMBER:

A006

12

D 21147 88 3 3/4" 3' - 6"

FLOOR PLAN

Scale: 1/4" = 1'-0"

D X0031 85


7' - 3 3/4"

|5' - 1 1/4"

	INTERIOR NEW WALL SCHEDULE						
TAG	DESCRIPTION	INSULATION	NOTES				
2-F-N	3 5/8" 20 GA STUD FURRING WALL	NONE	FULL HT. WALL. SEE PLAN FOR WALL SHEATHING.				
2-T-N	3 5/8" 20 GA STUD FURRING @ 16" O.C.	NONE	TERMINATE 6" ABOVE CEILING. PROVIDE 45 DEGREE METAL STUD BRACING AT 48" O.C. FROM STUD WALL TO STRUCTURE ABOVE. SEE PLAN FOR WALL SHEATHING.				
3-T-A	3 5/8" 20 GA STUDS @ 16" O.C.	ACOUSTIC	TERMINATE 6" ABOVE CEILING. PROVIDE 45 DEGREE METAL STUD BRACING AT 48" O.C. FROM STUD WALL TO STRUCTURE ABOVE. SEE PLAN FOR WALL SHEATHING.				
3-T-N	3 5/8" 20 GA STUDS @ 16" O.C.	NONE	TERMINATE 6" ABOVE CEILING. PROVIDE 45 DEGREE METAL STUD BRACING AT 48" O.C. FROM STUD WALL TO STRUCTURE ABOVE. SEE PLAN FOR WALL SHEATHING.				
4-T-A	6" 20 GA STUDS @ 16" O.C.	ACOUSTIC	TERMINATE 6" ABOVE CEILING. PROVIDE 45 DEGREE METAL STUD BRACING AT 48" O.C. FROM STUD WALL TO STRUCTURE ABOVE. SEE PLAN FOR WALL SHEATHING.				
5-T-N	6" 20 GA STUDS @ 16" O.C. FURRING WALL	NONE	TERMINATE 6" ABOVE CEILING. PROVIDE 45 DEGREE METAL STUD BRACING AT 48" O.C. FROM STUD WALL TO				

1' - 0 1/4"

3' - 6"

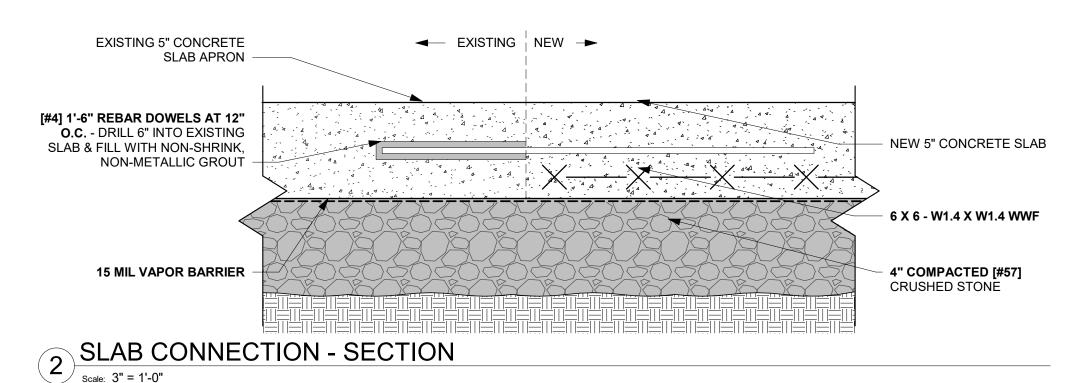

25' - 10"

-CORRIDOR

5' - 11 1/4"

20' - 6 3/4"

25' - 8 1/4"

**WORKROOM** 

3' - 0"

3' - 0"

STRUCTURE ABOVE. SEE PLAN FOR WALL SHEATHING.

# WALL BLOCKING KEY

ADJACENT TENANT

4' - 1 1/4" 1' - 4 3/4" A101 أم

\_\_\_\_3-T-N

D 10086 82

SYMBOL	ITEM	WEIGHT	HEIGHT A.F.F.	APPROX. WIDTH	
A	WORKROOM HAND SINK	128 LBS (58 KG)	36" TO 40" (915MM TO 1015MM)	30" (760MM) BEHIND SINK	
B	SHELVES ABOVE COMPARTMENT SINK	200 LBS (91 KG)	48" TO 76" (1220MM TO 1930MM)	96" (2440MM) CENTERED ABOVE COMPARTMENT SINK	
⟨c⟩	ARTWORK	200 LBS	COORDINATE WITH I	NTERIOR ELEVATIONS	
D	SHELVES AT MANAGER'S DESK	300 LBS (136 KG)	32" TO 96" (810MM TO 2440MM)	48" (1220MM) 3/4 (19MM) ACX PLYWOOD, CENTERED ON SHELVES	
E	EQUIPMENT RACK AT MANAGER'S DESK	300 LBS (136 KG)	44" TO 96" (1120MM TO 2440MM)	28" (710MM) 3/4 (19MM) ACX PLYWOOD, CENTERED ON RACK	
F	MERCHANDISE DISPLAY	100 LBS	70" TO 96"	WIDTH OF FIXTURE + 8" EITHER SIDE	
G	RESTROOM GRAB BARS	200 LBS (91 KG)	30" TO 36" (760MM TO 915MM)	60" (1525MM) AROUND WATER CLOSET	
H	RESTROOM HAND SINK	200 LBS COMMERCIAL INSTALLATION REQUIRES CONCEALE (91 KG) ARM CARRIER. REFER TO MFR'S SPECIFICATION			
	DT UPPER CABINET	BLOCKING SPECIFICATION FOR FRENCH CLEATING SYSTEM REFER TO DETAILS.			
J	DIAPER CHANGING STATION	250 LBS (113 KG)	40 1/2" TO 46 1/2"   32" (810MM) BEHIND STATI (1030MM TO 1180MM)		
⟨ <b>K</b> ⟩	UPPER CBE SHELVING	BLOCKING SPECIFICATION FOR CBE METAL SHELVES. REFER TO VENDOR'S SPECIFICATION AND DETAILS.			
⟨L⟩	WATER FILTRATION SYSTEM	TBD BY VENDOR	COORDINATE LOCATION AND EXTENT WITH PE		
⟨M⟩	ALL ARTWORK, FIXTURES, ACCESSORIES AND CASEWORK FABRICATIONS NOT OTHERWISE NOTED	TBD BY VENDOR (VARIES)	GC TO PROVIDE WALL BLOCKING AS REQUIRE ALL ITEMS FOR A COMPLETE AND SECUR INSTALLATION. EXTEND BLOCKING 8" (205 BEYOND ON EACH SIDE OF EACH ITEM.		
N	MENU BOARDS (ON SOFFIT)	480 LBS	EXTEND 4" ABOVE AND BELOW EXTENTS OF MENU	EXTENT OF MENUS, EXTEND 4" ON EITHER SIDE . REFER TO BLOCKING DETAIL.	

CAFE

**BACKBAR** 

ALIGN

9' - 1"

5-T-N 7

4 ALIGN

16' - 3"

69' - 11 1/2" (12)

# **KEYED NOTES**

- 1. LL PROVIDED ELECTRICAL PANEL LOCATIONS. MAINTAIN MINIMUM CLEARANCE AS REQUIRED BY CODE.
- 2. INSTALL NEW CONCRETE SLAB OVER VAPOR BARRIER OVER EXISTING COMPACTED FILL.
- 3. GC TO INSTALL NEW INTERIOR DOORS AS INDICATED. SEE SHEET A602 FOR DOOR AND HARDWARE TYPE.
- 4. ALIGN FACE OF FINISHED WALL.
- 5. SHELF FOR WATER HEATER ABOVE. REFER TO INTERIOR ELEVATION FOR HEIGHT AND DETAILS FOR CONSTRUCTION OF PLATFORM AND SUPPORTING ASSEMBLY.
- 6. EXTERIOR DOORS AND HARDWARE BY LL. PER STARBUCKS SPECIFICATION.
- 7. FUR OUT INTERIOR FACE OF WALL.

D 10205 89

2 A101

- 8. INDICATES SOFFIT ABOVE.
- 9. EDGE OF EXISTING PERIMETER SLAB INSTALLED BY LL. GC TO CLEAN AND SCARIFY, APPLY EPOXY BONDING AGENT AT EDGE PRIOR TO INSTALLATION OF NEW CONCRETE. INSTALL INTERIOR CONCRETE SLAB AS SPECIFIED IN LL STRUCTURE DRAWINGS DATED 04/24/2020.
- 10. LL TO PROVIDE GYPSUM BOARD WALL THROUGHOUT AS INDICATED.
- 11. GC TO FIELD VERIFY INCOMING WATER SERVICE EQUIPMENT AND CLEARANCES.
- 12. GC TO VERIFY OVERALL DIMENSIONS OF SPACE PRIOR TO LAYING OUT WALLS. CONTACT ARCHITECT IMMEDIATELY IF DISCREPANCIES OCCUR.

# **GENERAL NOTES**

- A. GENERAL CONTRACTOR TO VERIFY ALL DIMENSIONS AND NOTIFY STARBUCKS CONSTRUCTION MANAGER OF ANY DISCREPANCIES PRIOR TO CONSTRUCTION. ALL DIMENSIONS TO BE TAKEN FROM DESIGNATED DATUM POINT.
- B. GENERAL CONTRACTOR TO PROVIDE FIRE TREATED WOOD STUD BLOCKING, OR EQUIVALENT TO SUPPORT ANY WALL ATTACHMENT AND/OR SIGNAGE.
- C. IF EXISTING EXTERIOR ENTRANCE THRESHOLD EXCEEDS MINIMUM BARRIER FREE PROVISION OF THE CODE, REMOVE AND REPLACE WITH ACCESSIBLE THRESHOLD. RAISED THRESHOLDS AND FLOOR LEVEL CHANGES AT ACCESSIBLE DOORWAYS TO BE BEVELED WITH A SLOPE NO GREATER THAN 1:12.
- D. ALL DIMENSIONS ARE TO FINISHED FACE UNLESS SHOWN OR NOTED OTHERWISE.
- E.. INSTALL MOISTURE RESISTANT GREEN BOARD ON BACKBAR WALL PER PROJECT MANUAL.
- F. ALL DOORS SHALL BE 32" (815MM) MINIMUM CLEAR OPENING WHEN OPENED TO 90 DEGREE POSITION UNLESS OTHERWISE NOTED.
- G. SEE SHEET A601 FOR EXTERIOR DOOR AND WINDOW SCHEDULES.
- H. STARBUCKS VENDOR TO PROVIDE DOOR HARDWARE COMPONENTS AND GC TO INSTALL.
- I. VERIFY ALL EXISTING DOORS, HARDWARE AND FRAMES
- MEET STARBUCKS AND/OR CODE REQUIREMENTS.
- J. PROVIDE FIRE EXTINGUISHERS AS NOTED ON THE APPROVED PLANS FROM THE CITY.
- K. REFER TO SHEET I104 FOR FLOOR FINISHES.

# **GENERAL LEGEND**

NEW FULL HEIGHT WALL NEW PARTIAL HEIGHT WALL **EXISTING WALL** 

WALL BLOCKING CALL-OUT

WALL SHEATHING CALL-OUT


EXISTING 2H FIRE RATED DEMISING WALL

X-X-X WALL TAG

D XXXXXX XX DOOR TAG

# WALL SHEATHING KEY

WALL SHLATHING ILL					
SYMBOL	DESCRIPTION				
<b>A</b>	INDICATES SHEATHING TRANSITION				
(A)	5/8" GYP. WALL BOARD (TERMINATE AT 6" (150MM) ABOVE CEILING)				
В	5/8" MOISTURE RESISTANT GYPSUM BOARD (TERMINATE 6" ABOVE CEILING)				
<b>c</b>	5/8" CEMENTITIOUS BACKER BOARD (TERMINATE AT 6" (150MM) ABOVE CEILING)				

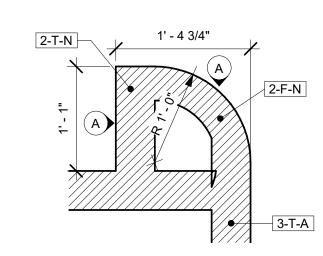

1 CORRIDOR WALL DETAIL

| Scale: 1" = 1'-0"

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**Engineering Consultants** Mechanical - Electrical - Plumbing



EXPIRATION DATE: 12/31/2020 

PRYOR, EIN DR.

STORE #: 62012 PROJECT #: 87799-001 ISSUE DATE: 07-07-2020
SR. DESIGN MANAGER: K. GORIN SLONSKI
PRODUCTION DESIGNER: A. HAHN

**BUILDING FLOOR PLAN** 

CHECKED BY:

BUILDOU COFFEE CHIPMAN

SCALE: AS SHOWN

SHEET NUMBER:

A101



FLOOR PENETRATION PLAN

Scale: 1/4" = 1'-0"

# **KEYED NOTES**

\*\*GC TO VERIFY IF EXISTING STUB-UPS ARE IN WORKING CONDITION & MAY BE REUSED. GC TO CONNECT NEW SPECIALTY EQUIPMENT TO EXISTING STUB-UPS WHERE POSSIBLE. ADD ADDITIONAL STUB-UPS/ROUGH-INS AS REQUIRED.

- 1. (3) 1/2" CONDUIT FOR PHONE, DATA, AND POWER FROM POS TO BE ROUTED TO CENTERLINE OF IT RACK AT MANAGERS DESK AS INDICATED. (1) 3/4" CONDUIT FOR DATA AT MANAGER'S DESK. STUB UPS TO BE WITHIN NEW PARTITION WALL. SEE MANAGER'S DESK DETAIL FOR MORE INFORMATION.
- 2. LOCATION OF INCOMING WATER SERVICE BY LL.
- 3. ELECTRICAL STUB-UP LOCATION. SEE ELECTRICAL SHEETS FOR MORE INFORMATION.
- 4. PLUMBING STUB-UP LOCATION. SEE PLUMBING SHEETS FOR MORE INFORMATION.
- 5. FLOOR SINK LOCATION. SEE PLUMBING SHEETS FOR MORE INFORMATION.
- 6. FLOOR DRAIN LOCATION. SEE PLUMBING SHEETS FOR MORE INFORMATION.
- 7. FLOOR ELECTRICAL J-BOX. SEE ELECTRICAL SHEETS FOR MORE INFORMATION. COORDINATE WITH BANQUETTE SPECIFICATIONS.
- 8. GC TO PROVIDE POWER & DATA FOR FUTURE DIGITAL MENU BOARDS PER STARBUCKS STANDARD REQUIREMENTS. REFER TO INTERIOR ELEVATIONS & DETAILS FOR MORE INFORMATION.
- 9. ELECTRICAL PANEL LOCATION BY LL.
- 10. NEW ELECTRICAL WALL OUTLET TO BE INSTALLED AS INDICATED. SEE INTERIOR ELEVATIONS AND ELECTRICAL SHEETS FOR MORE INFORMATION.
- 11. NEW SINK CONNECTION. REFER TO PLUMBING SHEETS FOR MORE INFO.
- 12. NEW WASTELINE PENETRATION AS INDICATED. REFER TO
- 13. DATUM FOR BACKBAR.
- 14. DATUM FOR WORKROOM AND RESTROOMS.
- 15. DATUM FOR CAFE.
- 16. SWITCHING LOCATION. SEE ELECTRICAL SHEETS.

PLUMBING SHEETS FOR MORE INFORMATION.

- 17. EXTERIOR COVERED GFCI ELECTRICAL OUTLET BY LL.
- 18. QUAD RECEPTACLE BEHIND CONDIMENT CART FOR FUTURE FLEXIBILITY

# **GENERAL NOTES**

- A. ALL STUB-UP DIMENSIONS ARE RELATIVE TO FINISHED WALL LOCATIONS (SHOWN AS OUTLINES ON THIS PLAN). REFER TO FLOOR PLAN FOR WALL PLACEMENT.
- B. FLOOR SINK: REFER TO CUT SHEETS FOR COMPONENT SPECIFICATIONS AND CUTOUT REQUIREMENTS.
- C. WASTE LINE PENETRATIONS: REFER TO PLUMBING PLANS FOR INDIVIDUAL LINE LOCATIONS.
- D. STUB-UP PENETRATIONS: REFER TO ELECTRICAL AND PLUMBING PLANS FOR INDIVIDUAL STUB-UP LOCATIONS.
- E. TOILET FLOOR PENETRATION: REFER TO CUT SHEETS FOR STUB-UP LOCATION RELATIVE TO FINISHED WALL.
- F. PENETRATION TO BE LOCATED ON CENTERLINE OF

WALL OR AS REQUIRED PER CONDITIONS.

- G. TRENCHING OUTLINE FOR GUIDELINE USE ONLY. GENERAL CONTRACTOR TO COORDINATE WITH SPECIFIC TRADES AND SITE CONDITIONS TO DETERMINE ACTUAL LAYOUT.
- H. REFER TO SHEET I104 FOR FLOOR FINISHES.

# LEGEND

**EXISTING WALL** CONCRETE LEAVE-OUT

DATUM POINT **NEW FLOOR SINK** 

NEW FLOOR DRAIN

FLOOR PENETRATION

PLUMBING PENETRATION AREA

ELECTRICAL PENETRATION AREA

NEW FLOOR DUPLEX

NEW WALL DUPLEX RECEPTACLE NEW QUADPLEX RECEPTACLE

NEW DATA RECEPTACLE

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Engineering Consultants Mechanical - Electrical - Plumbing



EXPIRATION DATE: 12/31/2020

/EST PRYOR, I ENSTEIN DR. MO

BUILDOUT
COFFEE CHIPMAN 62012 PROJECT #: 87799-001 ISSUE DATE: 07-07-2020 SR. DESIGN MANAGER: K. GORIN SLONSKI PRODUCTION DESIGNER: A. HAHN


CHECKED BY: **Revision Schedule** 


BUILDING FLOOR PENETRATION PLAN SCALE: AS SHOWN

SHEET NUMBER:

STORE #:

A102

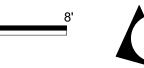

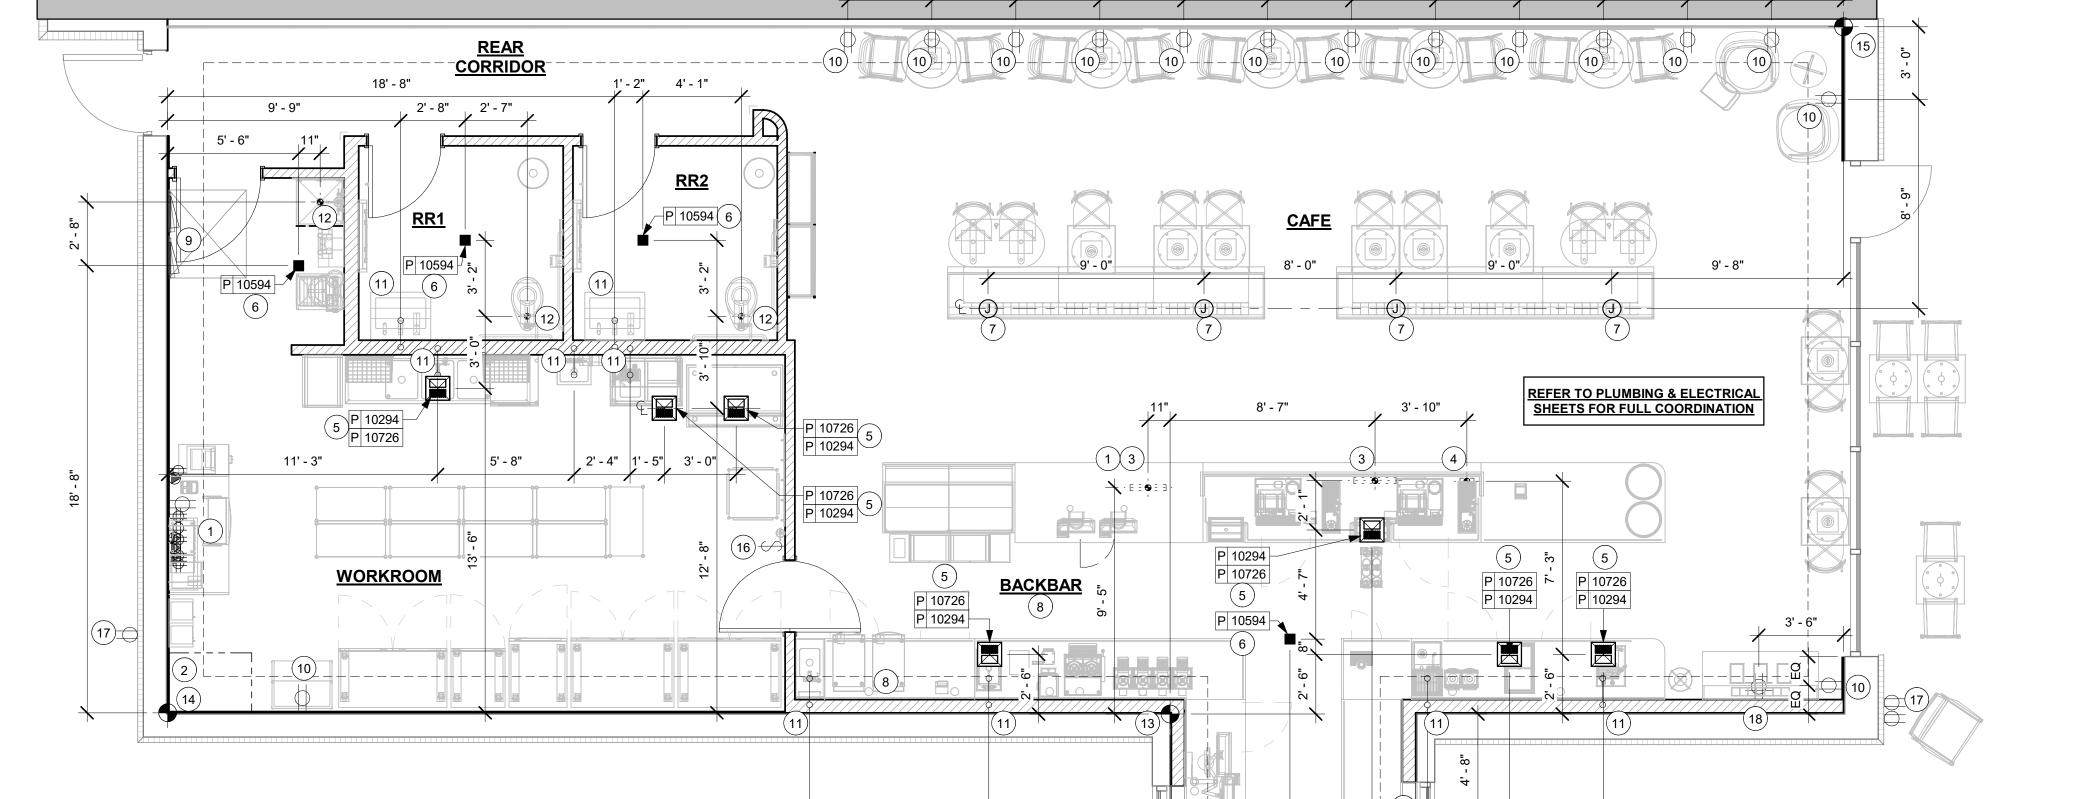

7' - 7"

7' - 6"

2' - 4"

3' - 5"

ADJACENT TENANT

NOTE: ALL SIGNAGE UNDER SEPARATE PERMIT, SHOWN FOR COORDINATION PURPOSES ONLY.

# **KEYED NOTES**

PROVIDE 4" (75MM) HIGH, WITH A MINIMUM STROKE WIDTH OF 0.5", BLACK ACRYLIC STORE ADDRESS ON GLAZING OR PER LOCAL JURISDICTIONAL CODE REQUIREMENTS.

LL TO PROVIDE J-BOX W/ PULL STRING FOR FUTURE BUILDING SIGNAGE.

- 3. GC TO PROVIDE SIGNAGE DISCONNECT.
- 4. 3/4" MARINE GRADE PLYWOOD BLOCKING FOR EXTERIOR SIGNAGE. EXTEND OF BLOCKING 8" (205MM) MIN. BEYOND EDGE OF SIGNAGE.
- 5. DRIVE-THRU WINDOW, AIR CURTAIN, AND HAND OFF SHELF TO BE PROVIDED AND INSTALLED BY LL PER SBUX SPECIFICATIONS. LL TO VERIFY OPENING DIRECTION.
- 6. INDICATES EXTENT OF STARBUCKS LEASE.
- NEW BUILDING CANOPY BY LL. LL TO PROVIDE IN WALL BLOCKING AS NECESSARY AND RECESSED CAN LIGHTS PER LLWL. BUILDING CANOPY TO EXTEND A MINIMUM OF 4'-0" FROM EXTERIOR WALL PER LLWL.
- 8. OUTLINE OF ROOF BEYOND.
- 9. LL TO PROVIDE GFI EXTERIOR PATIO OUTLET FOR CUSTOMER USE.
- 10. LL TO PROVIDE KEYED, FROST-FREE RECESSED PATIO HOSE BIB PER LLWL REQUIREMENTS.
- 11. NEW SCONCES BY LL PER SBUX SPECIFICATIONS.
- 12. LL TO PROVIDE POWER FOR PATIO STRING LIGHTS AND WALL MOUNTED FAN.
- 13. PATIO FAN. LL TO PROVIDE ELECTRICAL POWER.
- 14. UTILITY SCREEN BY LL PER LLWL REQUIREMENTS.
- 15. PATIO STRING LIGHTS POWER BY LL.
- 16. PATIO PLANTERS & LANDSCAPING BY LL.
- 17. EXTERIOR SPEAKER BY TENANT.

18. OCCUPANCY LOAD TO BE POSTED AT THE STORE ENTRY AS SHOWN, PER JURISDICTIONAL REQUIREMENT.

# **GENERAL NOTES**

- GENERAL CONTRACTOR TO COORDINATE AND SCHEDULE SIGNAGE INSTALLATION WITH THE SIGNAGE CONTRACTOR PROVIDING A MINIMUM SCHEDULING NOTICE OF 4 WEEKS AND 1 WEEK PRIOR TO SCHEDULED DATE OF INSTALLATION. CONSTRUCTION MANAGER TO PROVIDE GENERAL CONTRACTOR WITH SIGNAGE CONTRACTOR CONTACT INFORMATION.
- B. GENERAL CONTRACTOR SHALL COORDINATE WITH ELECTRICAL CONTRACTOR TO FURNISH AND INSTALL ELECTRICAL CIRCUITS INCLUDING ALL CONDUIT, WIRE, CONNECTIONS AND BREAKER AT PANEL BOARD NECESSARY TO SERVE SIGNAGE.
- C. GENERAL CONTRACTOR TO PROVIDE FIRE TREATED WOOD STUD BLOCKING OR EQUIVALENT TO SUPPORT
- D. SIGNAGE CONTRACTOR SHALL VERIFY SIZE AND LOCATION OF ANY AND ALL ALLOWABLE MONUMENT OR POLE SIGNAGE AND PROVIDE SHOP DRAWING(S) PRIOR TO FABRICATION TO THE STARBUCKS DESIGNER FOR APPROVAL.
- E. SIGNAGE CONTRACTOR TO INSTALL SIGNAGE IN COMPLIANCE WITH LOCAL CODES AND OBTAIN PERMIT.
- F. SIGNAGE CONTRACTOR TO SUPPLY SHOP DRAWINGS TO CONSTRUCTION MANAGER AND TO THE GENERAL CONTRACTOR AS NEEDED. GENERAL CONTRACTOR TO NOTIFY CONSTRUCTION MANAGER IMMEDIATELY IF SHOP DRAWINGS OR INSTALLATION IS IN DISCREPANCY WITH ARCHITECTURAL DRAWINGS.
- G. GENERAL CONTRACTOR TO CLEAN, PATCH AND REPAIR EXISTING EXTERIOR AS REQUIRED.

DUPLEX

LEGEND - EXT. ELEV.

HOSE BIB

ISSUED DATE: 06/16/2020 EXPIRATION DATE: 12/31/2020

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STARBUCKS TEMPLATE VERSION i2020-01-31

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REVISION

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BUILDOU COFFEE CHIPMAI STORE #: 62012 PROJECT #: 87799-001 ISSUE DATE: 07-07-2020 SR. DESIGN MANAGER: K. GORIN SLONSKI PRODUCTION DESIGNER: A. HAHN

**Revision Schedule** 

NORR

7/7/2020 AH PERMIT COMMENTS

BUILDING EXTERIOR ELEVATIONS

SCALE: AS SHOWN SHEET NUMBER:

CHECKED BY:


A201

EXTERIOR WORDMARK DETAIL

STARBUCKS

INTERIOR WHITE FAUX

NEON WORDMARK

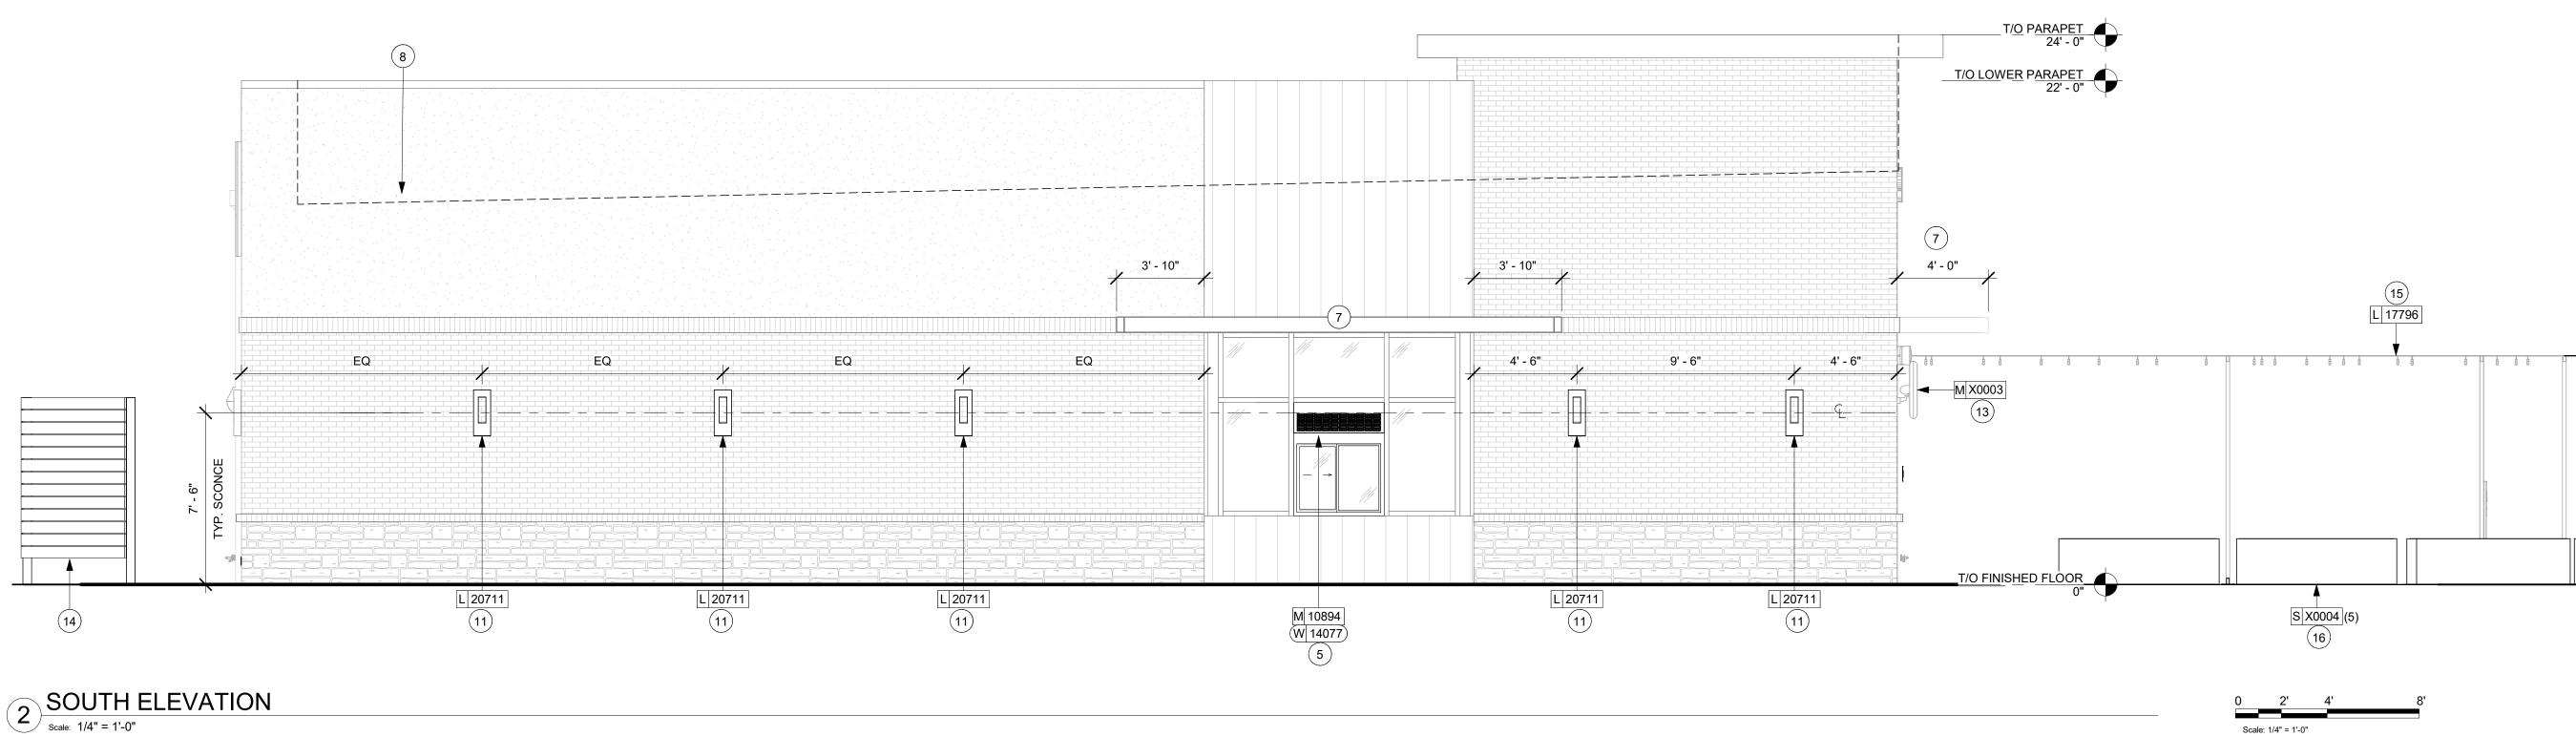

EQ

2 3 4 S 13164

12 L 20711 1

14

8

L 11483

EQ

T<u>/O LOWER PARAPET</u> 22' - 0"

B<u>/O</u> C<u>ANOPY</u> 11' - 0"

T/O FINISHED FLOOR

4' - 0"

7

WEST ELEVATION

scale: 1/4" = 1'-0"

NOTE: ALL SIGNAGE UNDER SEPARATE PERMIT, SHOWN FOR COORDINATION PURPOSES ONLY.

# GENERAL NOTES

- A. GENERAL CONTRACTOR TO COORDINATE AND SCHEDULE SIGNAGE INSTALLATION WITH THE SIGNAGE CONTRACTOR PROVIDING A MINIMUM SCHEDULING NOTICE OF 4 WEEKS AND 1 WEEK PRIOR TO SCHEDULED DATE OF INSTALLATION. CONSTRUCTION MANAGER TO PROVIDE GENERAL CONTRACTOR WITH SIGNAGE CONTRACTOR CONTACT INFORMATION.
- B. GENERAL CONTRACTOR SHALL COORDINATE WITH ELECTRICAL CONTRACTOR TO FURNISH AND INSTALL ELECTRICAL CIRCUITS INCLUDING ALL CONDUIT, WIRE, CONNECTIONS AND BREAKER AT PANEL BOARD NECESSARY TO SERVE SIGNAGE.
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- D. SIGNAGE CONTRACTOR SHALL VERIFY SIZE AND LOCATION OF ANY AND ALL ALLOWABLE MONUMENT OR POLE SIGNAGE AND PROVIDE SHOP DRAWING(S) PRIOR TO FABRICATION TO THE STARBUCKS DESIGNER FOR APPROVAL.
- E. SIGNAGE CONTRACTOR TO INSTALL SIGNAGE IN COMPLIANCE WITH LOCAL CODES AND OBTAIN PERMIT.
- F. SIGNAGE CONTRACTOR TO SUPPLY SHOP DRAWINGS TO CONSTRUCTION MANAGER AND TO THE GENERAL CONTRACTOR AS NEEDED. GENERAL CONTRACTOR TO NOTIFY CONSTRUCTION MANAGER IMMEDIATELY IF SHOP DRAWINGS OR INSTALLATION IS IN DISCREPANCY WITH ARCHITECTURAL DRAWINGS.
- G. GENERAL CONTRACTOR TO CLEAN, PATCH AND REPAIR EXISTING EXTERIOR AS REQUIRED.

# **KEYED NOTES**

- 1. NEW SCONCES BY LL PER SBUX SPECIFICATIONS.
- 2. LL TO PROVIDE J-BOX W/ PULL STRING FOR FUTURE BUILDING SIGNAGE.
- 3. LL TO PROVIDE SIGNAGE DISCONNECT.
- 4. 3/4" MARINE GRADE PLYWOOD BLOCKING FOR EXTERIOR SIGNAGE. EXTEND OF BLOCKING 8" (205MM) MIN. BEYOND EDGE OF SIGNAGE.
- 5. DRIVE-THRU WINDOW, AIR CURTAIN, AND HAND OFF SHELF TO BE PROVIDED AND INSTALLED BY LL PER SBUX SPECIFICATIONS. LL TO VERIFY OPENING DIRECTION.
- 6. INDICATES EXTENT OF STARBUCKS LEASE.
- 7. NEW BUILDING CANOPY BY LL. LL TO PROVIDE IN WALL BLOCKING, AS NECESSARY, AND RECESSED CAN LIGHTS PER LLWL. BUILDING CANOPY TO EXTEND A MINIMUM OF 4'-0" FROM EXTERIOR WALL PER LLWL.
- 8. OUTLINE OF ROOF BEYOND.
- LL TO PROVIDE GFI EXTERIOR OUTLET PER LLWL REQUIREMENTS.
- 10. LL TO PROVIDE KEYED, FROST-FREE RECESSED HOSE BIB PER LLWL REQUIREMENTS.
- 11. SECURITY LIGHT BY LL.
- 12. ROOF SCUPPER AND OVERFLOW BY LL
- 13. ELECTRICAL METERS BY LL PER LL DRAWINGS
- 14. UTILITY SCREEN BY LL PER LLWL REQIREMENTS.

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Engineering Consultants
Mechanical - Electrical - Plumbing



ISSUED DATE: 06/16/2020 EXPIRATION DATE: 12/31/2020

STARBUCKS
PRYOR RD &
E'S SUMMIT
TEIN DR.

ADDRESS:
ETS OF WEST PRYOR, I
IW LOWENSTEIN DR.
SUMMIT, MO
ON COUNTY

BUILDOUT

COFFEE 
COFFEE

PROJECT #: 87799-001

ISSUE DATE: 07-07-2020
SR. DESIGN MANAGER: K. GORIN SLONSKI
PRODUCTION DESIGNER: A. HAHN
CHECKED BY: NORR

Revision Schedu

Rev Date By Description

SHEET TITLE:
BUILDING EXTERIOR
ELEVATIONS
SCALE: AS SHOWN

SHEET NUMBER:

A202

0 2' 4'
Scale: 1/4" = 1'-0"

DESIGN ID	COUNT	DESCRIPTION	FURN. BY	INST. BY	COMMENTS
SIGNAGE - [	DISK		1	1	
13164	1	SIGN - DISK SF ILLUMINATED FLUSH MOUNTED EVOLVED - 60IN 1525MM	SB		LL TO PROVIDE BLOCKING AND CONDUIT AS REQUIRED
SIGNAGE - I	DRIVE THR	Ü	'	'	
14091	1	SIGN - DT DIRECTIONAL EXIT SIGN ILLUMINATED ARROW SERIES - 46IN 1170MM	SB	GC/LL	LL TO FURNISH AND INSTALL CONCRETE FOOTINGS, ANCHOR BOLTS, AND ELECTRICAL CONDUIT PER LLWL. GC TO COORDINATE WITH SBUX VENDOR
14106	1	SIGN - DT CLEARANCE BAR ARROW SERIES FREESTANDING	SB	GC/LL	LL TO FURNISH AND INSTALL CONCRETE FOOTINGS AND ANCHOR BOLTS PER LLWL GC TO COORDINATE WITH SBUX VENDOR
SIGNAGE -	OTHER		<u>'</u>		
19388	2	SIGN - 10 MINUTE PARKING	SB	LL/ HILTON	FOOTING & POST BY LL. SIGN BY SBUX SIGNAGE VENDOR
X0002	1	MONUMENT SIGN PANELS	SB/ HILTON	1	BASE SIGN FOOTING AND ELECTRICAL BY LL. PANELS BY SIGNAGE VENDOR. LL TO COORDINATE WITH SIGNAGE VENDOR
SIGNAGE - V	NORDMAR	K			
X0007	1	SIGN - FAUX NEON GREEN WORDMARK STARBUCKS WITH WHITE INTERIOR & SURROUND. FLUSH MOUNTED - 18IN 455MM	SB	LL/ HILTON	FAUX NEON GREEN WORDMARK. LL TO PROVIDE CONDUIT AND BLOCKING AS REQUIRED.

		SITE SCHED	ULE - "Y"		
DESIGN ID	COUNT	DESCRIPTION	FURN. BY	INST. BY	COMMENTS
EXTERIOR N	ЛENU		•	•	
14116	1	MENU BOARD - DT DIGITAL ORDER SCREEN - FLAT BLACK MT0028	SB	SB/GC	SUPPLIER: IT EQUIPMENT VENDOR (ZONES) SCREEN INSTALLER: REGIONAL SIGNAGE VENDOR. ELECTRICAL: GC CONNECTS DOS WHIPS & STUB-UPS TO DCB.
14119	1	MENU BOARD - DT 5 PANEL FREESTANDING - 108X65IN 2745X1650MM - FLAT BLACK MT0028	SB	SB	SUPPLIER: DT SIGNAGE VENDOR (DSA). INSTALLER: REGIONAL SIGNAGE VENDOR. LL TO PROVIDE CONDUIT, FOOTING, AND ANCHOR BOLTS PER LLWL.
14120	1	MENU BOARD - DT PRE MENU FREESTANDING - 36X65IN 915X1650MM - FLAT BLACK MT0028	SB	SB	PROVIDED AND INSTALLED BY SIGNAGE VENDOR. LANDLORD GC TO PROVIDE FOOTING & ELECTRICAL AS SPECIFIED PER LLWL.
15700	1	MENU BOARD - DT DIGITAL ORDER SCREEN CONTROL BOX		SB/GC	SUPPLIER: IT EQUIPMENT VENDOR (ZONES) INSTALLER: REGIONAL SIGNAGE VENDOR. ELECTRICAL CONNECTION: GC. LL TO PROVIDE FOOTING, CONDUIT, AND ANCHOR BOLTS PER LLWL.
OTHER			•	•	
14103	11	BOLLARD NONILLUMINATED SQUARE - FLAT BLACK MT0028	LL	LL	SUPPLIER/INSTALLER: LL. DSA PHOTOTECH SEE DETAILS.
14163 1 DT ORDER POINT CANOPY FREESTANDING - FLAT BLACK MT0028		SB	SB	SUPPLIER: DT SIGNAGE VENDOR (DSA). INSTALLER: REGIONAL SIGNAGE VENDOR. LL TO PROVIDE AND INSTALL CONDUIT, FOOTING, AND ANCHOR BOLTS PER LLWL.	
18818	4	LIGHT POLE - 10FT 300CM - FLAT BLACK MT0028	LL	LL	
18820	4 LIGHT POLE BASE PLATE - FLAT BLACK MT0028		LL	LL	
X0001			SB	GC/LL	SUPPLIER: DT AUDIO VENDOR (HME). INSTALLER:GC. LL TO PROVIDE CONDUIT PER LLWL.
X0004	X0004 5 PLANTER BOXES - 84X36X18IN		LL	LL	LL TO PROVIDE DRAINAGE AND AUTOMATED IRRIGATION PER LLWL REQUIREMENTS. LL TO PROVIDE SPEC TO DESIGNER FOR APPROVAL.
X0008 1 BIKE RACK - OLYMPIA		LL	LL	FORMS & SURFACES: OLYMPIA BIKE RACK. WWW.FORMS-SURFACES.COM; INSTALL PER MANUFACTURER'S RECOMMENDATIONS.	
X0009	20	NATIVE PLANTS FOR PLANTER BOXES	LL	LL	LANDSCAPING SELECTION AND QTY VERIFICATION BY LANDLORD. PROVIDE DRAUGHT-RESISTANT, NATIVE PLANTS WITH MINIMUM MAINTENANCE REQUIREMENTS.
UMBRELLA			'	•	
12147	3	UMBRELLA - BASE 95LB 43KG - FLAT BLACK MT0028	SB	GC	
20075	3	UMBRELLA - WITHOUT VALANCE - 6FT 183CM - BLACK CANVAS WITH WORDMARK F0061	SB	GC	

# RESPONSIBILITY LEGEND

GC GENERAL CONTRACTOR LL LANDLORD SB STARBUCKS



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T OF STARBUCKS - NW PRYOR RD & I - LEE'S SUMMIT LOT

WEST PRYOR, L WENSTEIN DR. IT, MO JUNTY

PROJECT NAME:

BUILDOUT

COFFEE - N

CHIPMAN -STORE #: 62012 PROJECT #: 87799-001

ISSUE DATE: 07-07-2020
SR. DESIGN MANAGER: K. GORIN SLONSKI
PRODUCTION DESIGNER: A. HAHN
CHECKED BY: NORR

Rev	vision	Schedu
Bv		Des

SCHEDULES

SCALE: AS SHOWN

SHEET NUMBER:

A601

DOOR SCHEDULE - "D"								
DESIGN ID	MARK	DESCRIPTION	WIDTH	HEIGHT	HARDWARE SET	FURN BY	INST BY	COMMENTS
Exterior								
21147	88	DOOR - SINGLE SERVICE - 42IN 1070MM	3' - 6"	7' - 0"	42	LL	LL	LL TO INSTALL AND PROVIDE TENANT SPECIFIED DOOR HARDWARE ON EXTERIOR DOORS AS INDICATED. FINISH: SW7748
10205	89	DOOR - STOREFRONT METAL FRAME SINGLE - TYPE B	3' - 0"	8' - 0"	2-A	LL	LL	LL TO INSTALL AND PROVIDE TENANT SPECIFIED DOOR HARDWARE ON EXTERIOR DOORS AS INDICATED
2 Interior								
10190	83	DOOR - SINGLE FLUSH - 36IN	3' - 0"	7' - 0"	6	SB	GC	FINISH: PL0027 FRAME FINISH: SW7748
10190	84	DOOR - SINGLE FLUSH - 36IN	3' - 0"	7' - 0"	6	SB	GC	FINISH: PL0027 FRAME FINISH: SW7748
X0031	85	DOOR - SINGLE FLUSH - 42IN	3' - 6"	7' - 0"	15	SB	GC	FINISH: PL0027 FRAME FINISH: SW7748
10086	82	DOOR - SINGLE IMPACT DOUBLE ACTING - 36IN 915MM	3' - 0"	7' - 0"	11	SB	GC	PROVIDED BY LOCKNET. ELIASON SCP-8 DOOR. FINISH: PL0027 FRAME FINISH: SW7030
4	-				1	1		


# DOOR LEGEND

# **EXTERIOR**

SINGLE

SERVICE




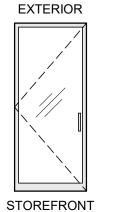


METAL FRAME

SINGLE

(TYPE B)

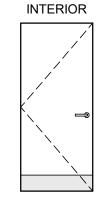

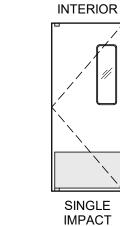

DOUBLE

ACTING

SINGLE FLUSH

	WINDOW SCHEDULE - "W"						
DESIGN ID	COUNT	DESCRIPTION	FURN. BY	INST. BY	COMMENTS		
WINDOW							
14077	1	WINDOW - DT WITH OPEN TRANSOM - 48X60IN 1205X1510MM - ALUMINUM	LL	LL	275 SERIES SINGLE PANEL SLIDER W/ MOER. LL TO VERIFY OPENING DIRECTION. USE IN CONJUNCTION WITH AA300-275 PASS THRU AIR CURTAIN SYSTEM. CONTACT: ANNA ELLIS, ANNA@READY-ACCESS.COM		

No.	Item	Description	Manufacturer	Finish
3	Hanging Devices	TH2314/MPB91	McKinney	630
1	Securing Devices	CD35A-NL-OP Panic Device	Von Duprin	628/630
2	Securing Devices	C607 7-Pin Core Combinated "A" Keyway	Falcon Lock	626
1	Securing Devices	KB609-2 Cut Control Key "A" Keyway	Falcon Lock	
9	Securing Devices	KB632-2 Cut User Key "A" Keyway	Falcon Lock	
1	Securing Devices	C953 7-Pin Rim Cylinder Housing	Falcon Lock	626
1	Securing Devices	C987 7-Pin Mortise Cylinder Housing w/AR Cam	Falcon Lock	626
1	Securing Devices	A08794-003 Adjustable Ring, Mortise Cyl. 516-13/32	Falcon Lock	626
1	Operating Trim	108 Door Pull Handle	Rockwood	630
1	Closing Devices	8916 Door Closer 8916 AF89P	Dorma	689
1	Stops and Holders	473 Door Stop w/ Hook	Rockwood	626
1	Threshold	325 Half Saddle Threshold	National Guard	
1	Sign	Vinyl Sign: "THIS DOOR MUST REMAIN UNLOCKED WHEN BUILDING IS OCCUPIED"	Seton	

No.	Item	Description	Manufacturer	Finish
3	Hanging Items	TA2714/MPB79 Hinge MacPro Bearing 4.5 x 4.5	McKinney	626
1	Securing Devices	PB5425LN Lock, Shallow Coin Turn, Privacy PB5425LN-693-497 1-3/4	Yale Lock	626
1	Closing Devices	8916 Door Closer 8916 AF89P	Dorma	689
2	Protective Trim Units	K1050 B4E Kickplate 8" x 34" Each Side 32D	Rockwood	630
3	Accessories	GJ64 Rubber Silencer	Glynn Johnson	Gray
1	Stops and Holders	473 Door Stop w/ Hook	Rockwood	626

	DOOR HARDWARE SET NO. 11 - For workroom door at backbar							
No.	No. Item Description Manufacturer Finish							
1	Traffic Door Package	SCP8 36" x 84"	Eliason	PL0027				
1	тапіс Door Package	SCP8 36 X 84"	Eliason	PL0027				

No.	Item	Description	Manufacturer	Finish
3	Hanging Devices	TH2314/MPB91 Hinge MacPro Bearing 4.5 x 4.5	McKinney	630
1	Securing Devices	C607 7-Pin Core Combinated "A" Keyway	Falcon Lock	626
1	Securing Devices	I/O 2000L-03IC Auto Locking Door Alarm, IC; No CTR Includes Mortise Cylinder	Sur-Lock	
1	Closing Devices	8916 Door Closer 8916 AF89P	Dorma	689
1	Protective Trim Units	K1050 B4E Kickplate 10" x 40"	Rockwood	630
1	Accessories	137NA Weather Strip 20' 42" x 84"	National Guard	А
1	Accessories	Door Sweep 18062CNB36	Pemko	А
1	Miscellaneous Items	DS / 1000 Door Scope	Security Products	Silver
1	Miscellaneous Items	MCV309NWHGL Door Bell	Nutone	As Selected

No.	Item	Description	Manufacturer	Finish
3	Hanging Devices	TA2714/MPB79	McKinney	626
1	Securing Devices	B-PB5405LNIC Lever Storeroom LC B-PB5405LN-693-497 1-3/4	Yale Lock	626
1	Securing Deices	C607 7-Pin Core Combinated "A" Keyway	Falcon Lock	626
1	Closing Devices	8916 Door Closer 8916 AF89P AL	Dorma	689
1	Protective Trim Units	K1050 B4E Kickplate 10" x 2" LDW	Rockwood	630
1	Accessories	137NA Weather Strip 17' 36" x 84"	National Guard	А
1	Stops and Holders	473 Door Stop w/ Hook	Rockwood	626

# **GENERAL NOTES**

- A. STARBUCKS VENDOR TO PROVIDE DOOR HARDWARE COMPONENTS. GC TO INSTALL.
- B. SEE SHEET A101 FOR TAGGED LOCATION OF EXTERIOR DOORS AND WINDOWS.
- C. EGRESS SHALL NOT PASS THROUGH KITCHENS, STORAGE ROOMS, CLOSETS OR SIMILAR SPACES. (1014.2)
- D. PANIC AND FIRE EXIT HARDWARE, WHERE INSTALLED ON DOORS IN THIS BUILDING SHALL SATISFY THE FOLLOWING (1008.1.10):
- a) THE ACTUATION PORTION OF THE RELEASING DEVICE SHALL EXTEND AT LEAST ONE-HALF OF THE DOOR LEAF WIDTH.
- b) THE MAXIMUM UNLATCHING FORCE DOES NOT EXCEED 15 POUNDS (6.8 KG).
- c) PIVOTED OR BALANCED DOORS SHALL BE OF THE PUSH-PAD TYPE WHERE PANIC HARDWARE IS REQUIRED AND THE PAD SHALL NOT EXTEND ACROSS MORE THAN ONE-HALF OF THE DOOR WIDTH, MEASURED FROM THE LATCH SIDE.
- d) PANIC HARDWARE LISTED IN ACCORDANCE WITH UL 305.
- e) FIRE EXIT HARDWARE LISTED IN ACCORDANCE WITH UL 10C AND UL 305.



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Engineering Consultants Mechanical - Electrical - Plumbing



EXPIRATION DATE: 12/31/2020

**⊘** ⊗ T OF STARBUCKS
- NW PRYOR RD 8
- LEE'S SUMMIT LOT VEST PRYOR, I ENSTEIN DR. MO NTY

BUILDOUT COFFEE - NCHIPMAN -62012 87799-001

PROJECT #: ISSUE DATE: 07-07-2020
SR. DESIGN MANAGER: K. GORIN SLONSKI
PRODUCTION DESIGNER: A. HAHN
CHECKED BY: NORR

Rev D	ate By	Description

STORE #:

WINDOW AND DOOR SCHEDULES & DETAILS SCALE: AS SHOWN

SHEET NUMBER:

A602

FURNITURE, FIXTURES, AND EQUIPMENT PLAN

Scale: 1/4" = 1'-0"

E 10172

E 10859

E 10099

E 10769

E 10396

E 10091

E 10855

E 10855

ENLARGED CUP CADDY

E 10858

E 10791

# **KEYED NOTES**

- 1. INSTALL EXTERIOR FURNITURE THROUGHOUT AS SHOWN.
- 2. INSTALL CAFE FURNITURE THROUGHOUT AS SHOWN.
- 3. CONDIMENT CART. SEE INTERIOR FINISH ELEVATIONS.
- 4. PLACE MERCHANDISE FIXTURES AND RETAIL FLOOR BASKETS PER PLAN. STORE OPERATORS TO ORDER RETAIL FLOOR BASKETS.
- 5. MERCHANDISE DISPLAY. SEE DETAILS FOR MORE INFORMATION. CENTER MERCH. BAYS WITH CENTERLINE OF WALL BEHIND.
- 6. DO NOT BLOCK FOOD CASE INTAKE/EXHAUST.
- 7. SAFE LOCATED AT POS CABINET, SEE ELECTRICAL FOR ADDITIONAL INFORMATION.
- 8. HAND SINK W/ INTEGRAL SPLASH GUARD.
- 9. MANAGERS DESK. SEE MANAGER'S DESK/EQUIPMENT RACK ELECTRICAL DETAIL FOR ADDITIONAL INFORMATION.
- 10. REFER TO ENLARGED RESTROOM PLANS AND ELEVATIONS (SHEET I401) FOR FIXTURE LOCATIONS AND MOUNTING HEIGHTS.
- 11. LOCATION OF SWITCH GEAR AND THERMOSTAT CONTROLS.
- 12. SECURE LOCKERS TO WALL.
- 13. VENDOR TO INSTALL WATER FILTRATION SYSTEM PER MANUFACTURER'S REQUIREMENTS. GC TO PROVIDE PLUMBING AND ELECTRICAL REQUIREMENTS.
- 14. WATER HEATER LOCATED ABOVE. SEE PLUMBING
- 15. OCCUPANCY PLACARD AT STORE ENTRY PER JURISDICTIONAL COMMENTS.

# **GENERAL NOTES**

- A. GENERAL CONTRACTOR TO SCHEDULE WITH LOCAL REFRIGERATION CONTRACTOR TO CONDUCT INITIAL FOOD CASE START-UP AND TESTING. FOR LIST OF APPROVED START UP CONTRACTORS, CONTACT PROJECT CONSTRUCTION REPRESENTATIVE.
- B. THE SITE IS SERVED BY THE MUNICIPAL WATER AND SEWER SYSTEM UNLESS OTHERWISE NOTED.
- C. ALL FOOD STORAGE SHALL BE 6" (150mm) A.F.F.
- D. ALL WOOD SURFACES (DOORS, TRIM, SHELVES, CABINETS) SHALL BE SEALED.
- E. ALL EQUIPMENT AND INSTALLATION WILL MEET NATIONAL SANITATION FOUNDATION STANDARDS OR EQUIVALENT.
- F. ALL EQUIPMENT AND CABINETRY WILL BE FLUSH MOUNTED TO COUNTERS, WALLS OR FLOORS, OR BE RAISED TO ALLOW FOR CLEANING.
- G. CONFIRM ALL NECESSARY EQUIPMENT CLEARANCES PER PRODUCT CUT SHEET (E.G. ICE MACHINE).
- H. FOR LOCATION OF COUNTERTOP EQUIPMENT, REFER TO CASEWORK ELECTRICAL DETAILS.
- I. EQUIPMENT UNITS SHALL CONTAIN NO EXPOSED THREADS, EMBELLISHMENTS OR OVERHANGING EDGES THAT SERVE AS PLACES FOR ACCUMULATION OF DUST, DIRT AND DEBRIS.
- J. WARMING OVEN(S) SHOWN FOR PERMITTING PURPOSES. INSTALLATION AT STORE OPENING TO BE VERIFIED BY STARBUCKS CONSTRUCTION REPRESENTATIVE.
- K. EACH HAND WASHING SINK WILL HAVE A SINGLE SERVICE TOWEL AND SOAP DISPENSER, AND ALL HAND SINKS TO HAVE A COMBINATION FAUCET OR PREMIXING FAUCET.
- L. FOR PLUMBING FIXTURES. REFER TO THE PLUMBING DESIGN PLAN. FOR DATA DEVICE SCHEDULE, REFER TO THE ELECTRICAL DESIGN PLAN.
- M. SEE ELEVATIONS FOR DISTRIBUTION OF CUP DISPENSERS.
- N. PROVIDE FIRE EXTINGUISHERS AS NOTED ON THE APPROVED PLANS FROM THE LOCAL JURISDICTION.



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**Engineering Consultants** Mechanical - Electrical - Plumbing



EXPIRATION DATE: 12/31/2020

LOT VEST PRYOR, I ENSTEIN DR. MO

BUILDOUT
COFFEE CHIPMAN STORE #: 62012 PROJECT #: 87799-001 ISSUE DATE: 07-07-2020 SR. DESIGN MANAGER: K. GORIN SLONSKI PRODUCTION DESIGNER: A. HAHN

**Revision Schedule** 

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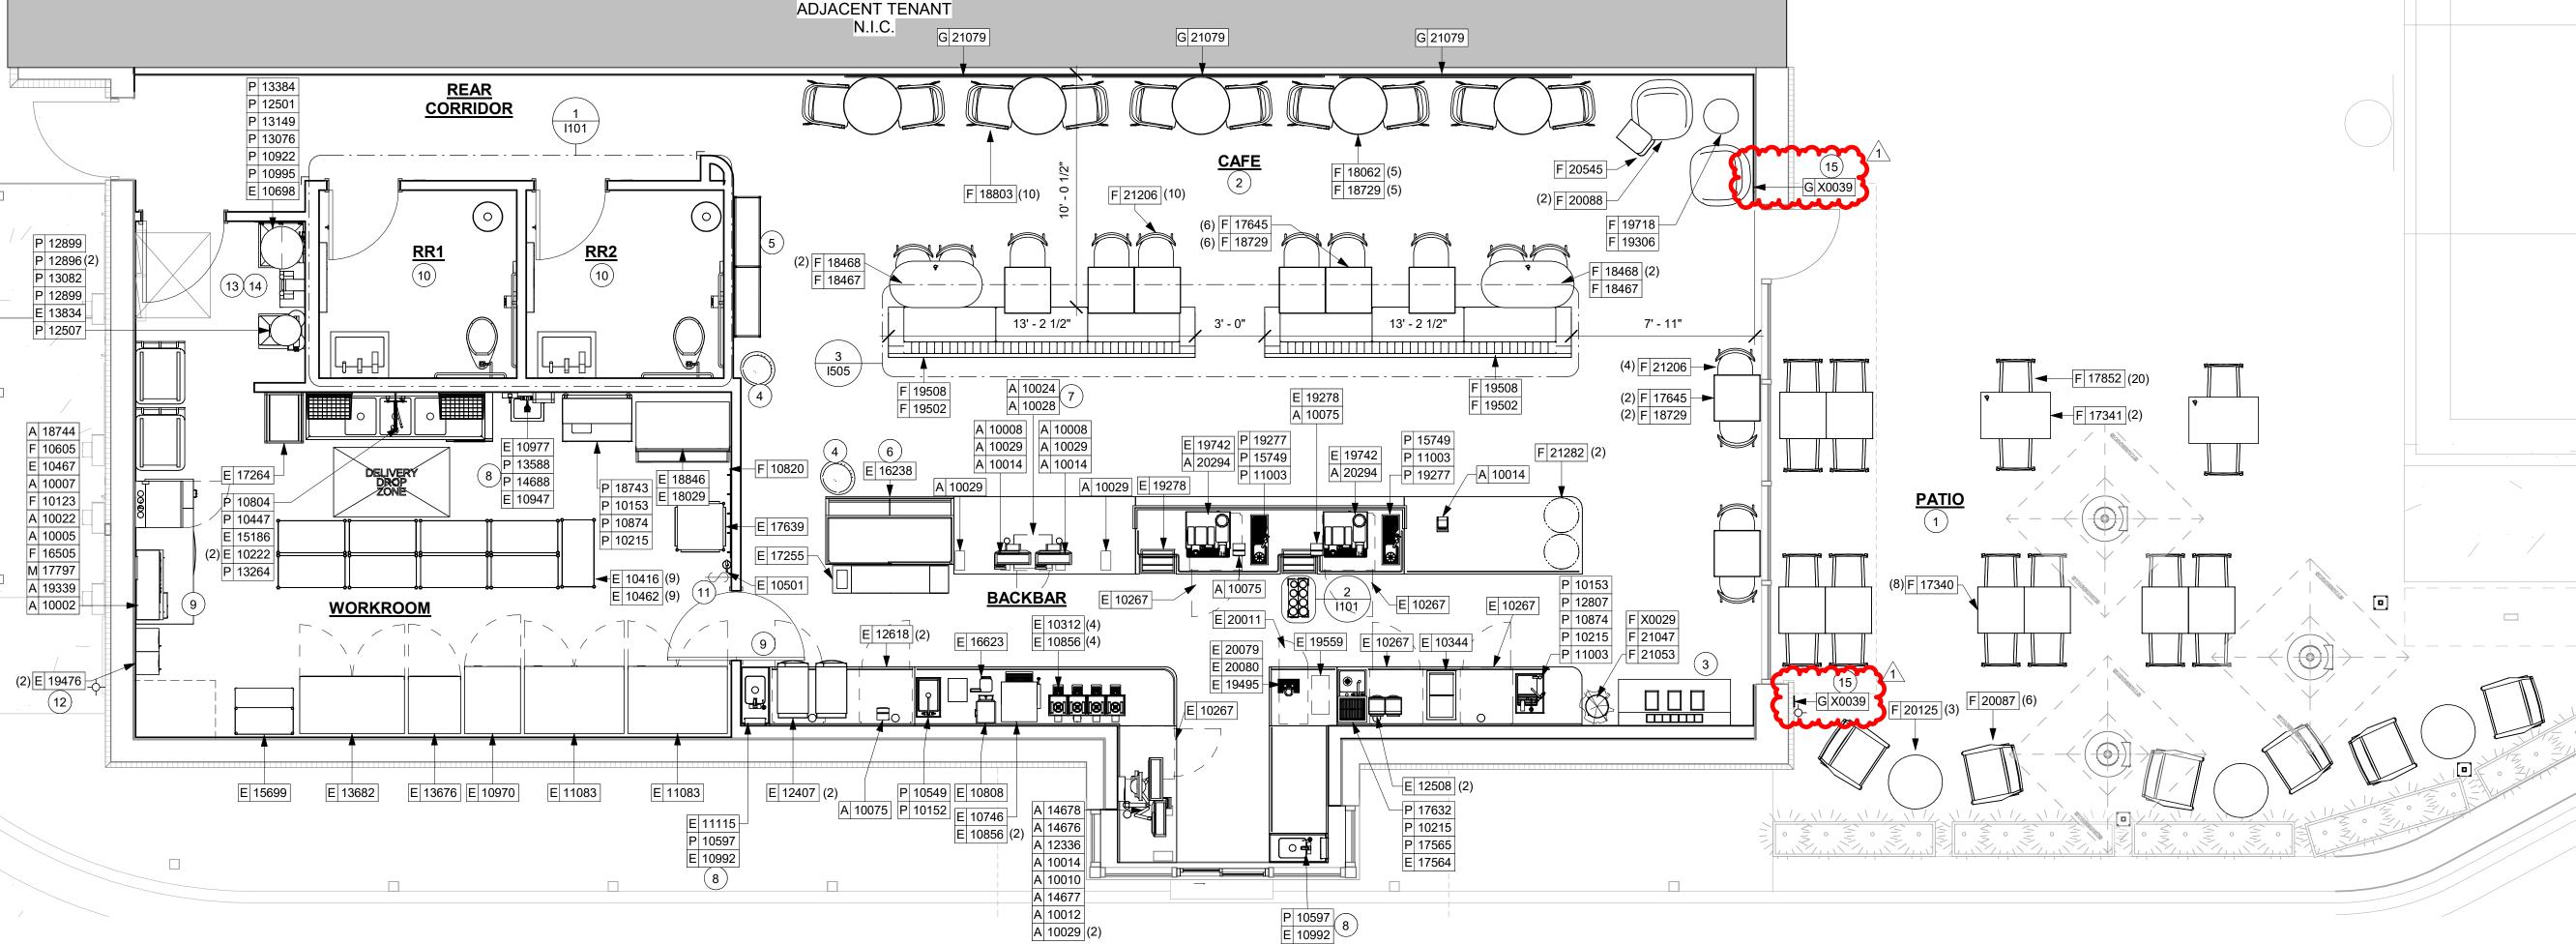
Rev Date By

FF & E PLAN

SCALE: AS SHOWN SHEET NUMBER:

CHECKED BY:


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**KEYED NOTES** 

1. FUNITURE STORAGE AREA



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2020


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Engineering Consultants
Mechanical - Electrical - Plumbing

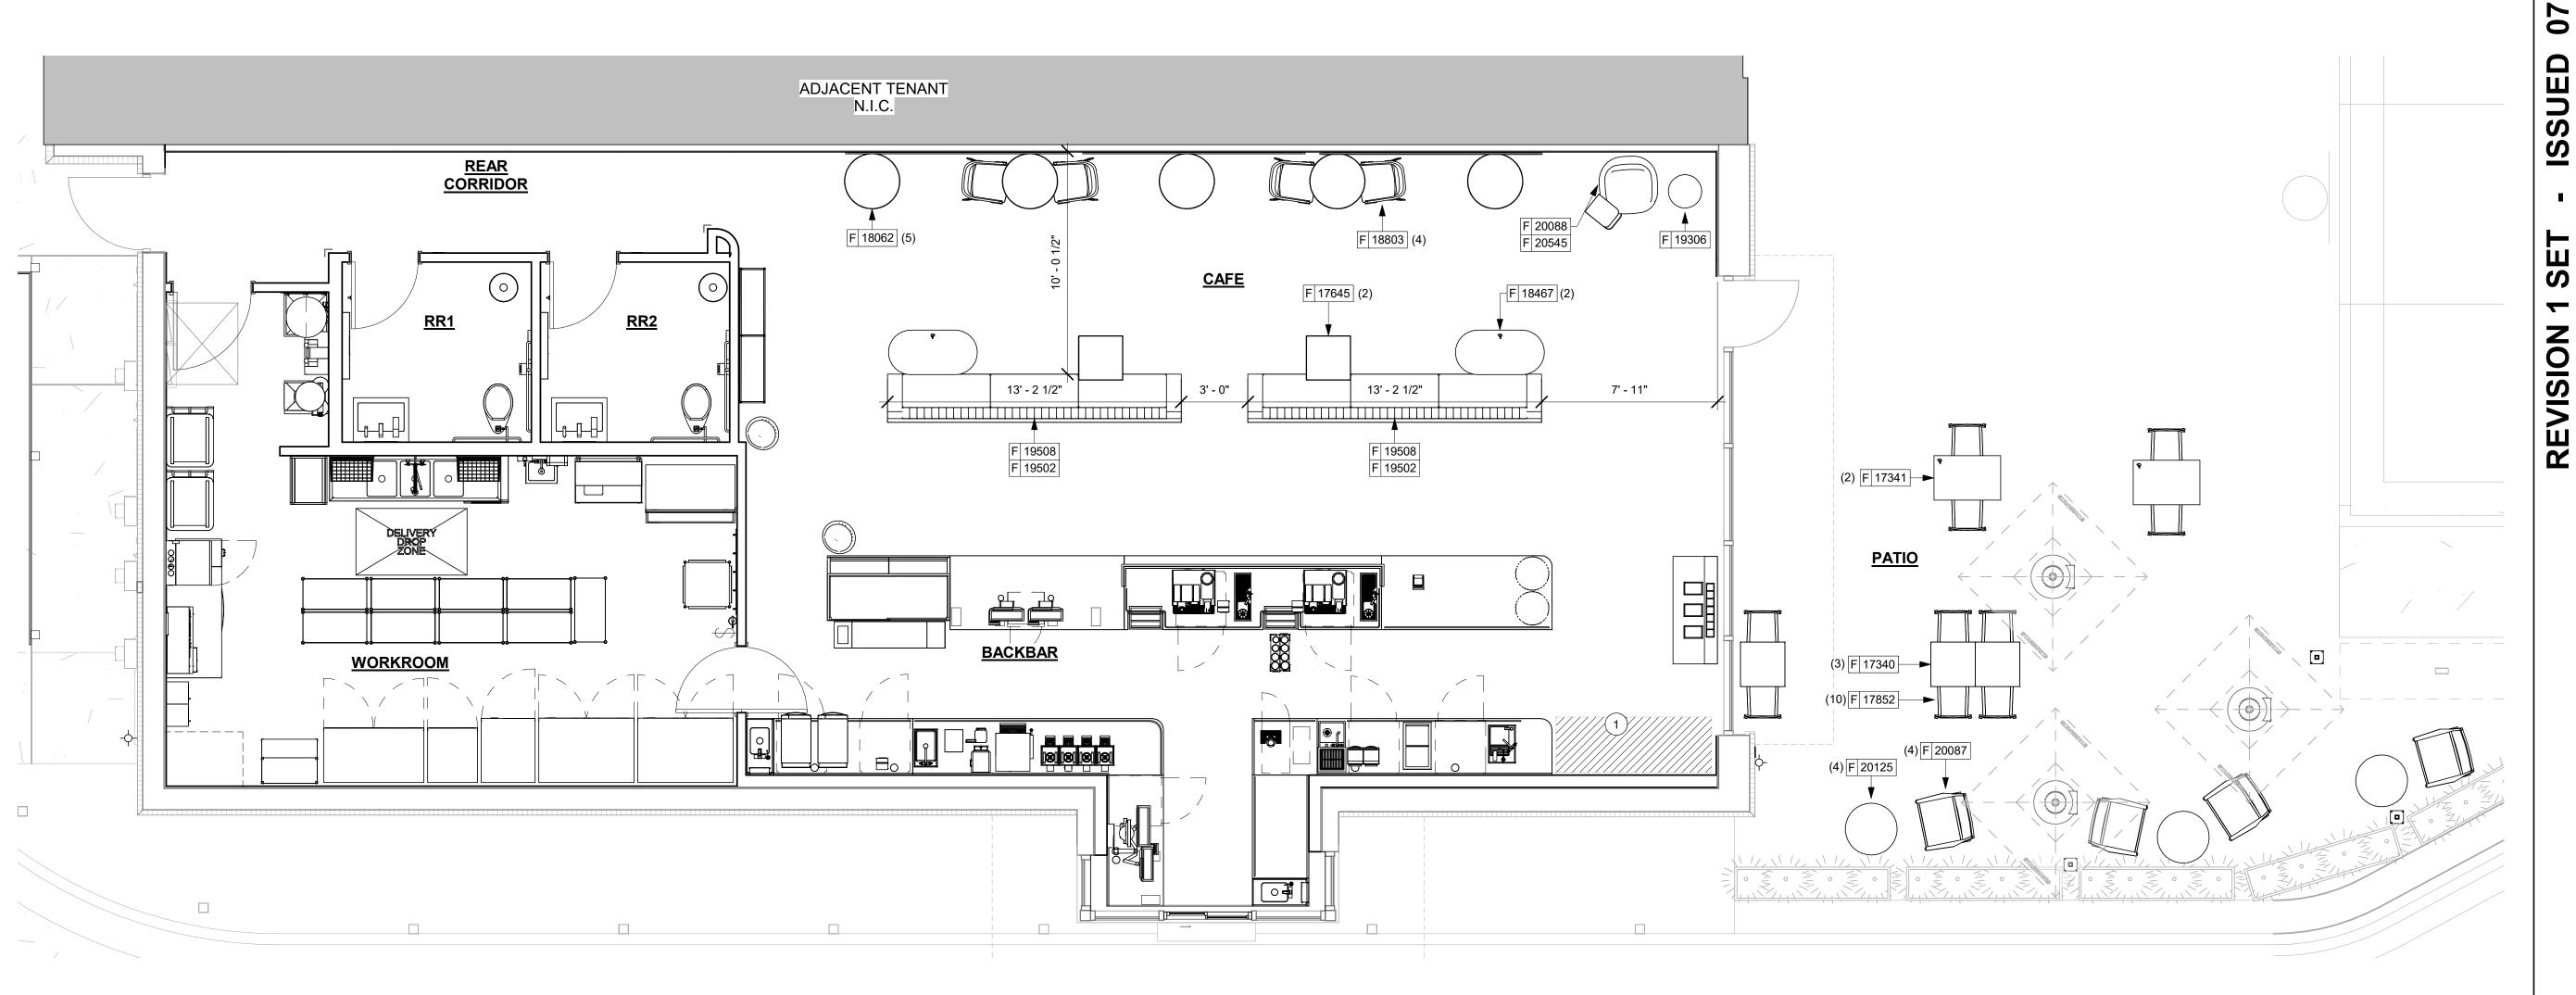353 Marshall Avenue

Phone (314) 772-1782

Fax (314) 373-3514

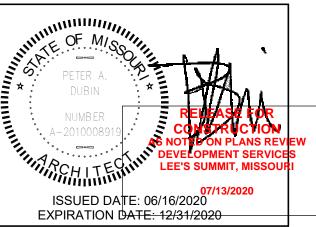

/EST PRYOR, I ENSTEIN DR. MO NTY BUILDOUT
COFFEE CHIPMAN

STORE #: 62012 PROJECT #: ISSUE DATE: 07-07-2020
SR. DESIGN MANAGER: K. GORIN SLONSKI
PRODUCTION DESIGNER: A. HAHN
CHECKED BY: NORR

LIMITED OPERATIONS FURNITURE LAYOUT SCALE: AS SHOWN

1101.1

LIMITED OPERATIONS FF AND E PLAN Scale: 1/4" = 1'-0"

# **KEYED NOTES**

\*\*MATERIAL AREAS AND TAKE-OFFS ARE ACTUAL AREA, NOT ORDERING QUANTITY. SUPPLIER MUST ACCOUNT FOR OVERAGE, PATTERN REPEAT, ACCESSORY PIECES, ETC.

\*\*NOTE: CASEWORK VENDOR TO PROVIDE SHOP DRAWINGS & SAMPLES FOR DESIGNER APPROVAL PRIOR TO FABRICATION.

- 1. DO NOT CAULK TRASH RINGS TO COUNTERTOPS.
- 2. INSTALL CASEWORK, COUNTERTOPS, SHELVES, CUBBIES, FINISHES, TRIM AND TABLE TOPS THROUGHOUT. REFERENCE FINISH SCHEDULE AND MANUFACTURER'S SPECIFICATIONS FOR ADDITIONAL INFORMATION.
- 3. ALL COUNTERTOPS UTILIZED FOR CUSTOMER TRANSACTIONS, INCLUDING BAR, CONDIMENT AND SALES COUNTERTOPS SHALL BE INSTALLED AT 2'-10" (860 MM) MAXIMUM A.F.F.
- 4. FLOOR SINK BELOW. CASEWORK MANUFACTURER TO INSURE THIS AREA IS READILY ACCESSIBLE FOR CLEANING AND FREE OF COUNTERTOP SUPPORT.
- 5. WALL FINISH BEHIND EXPOSED CABINETRY AND BELOW UNDERSIDE OF COUNTERTOP SUBSTRATE TO BE FRP.
- 6. CASEWORK VENDOR TO ENGINEER PROPER COUNTEROTP SUPPORT AT ESPRESSO BAR AND OTHER WORKSTATIONS PER STARBUCKS MINIMUM PERFORMANCE REQUIREMENTS.
- 7. INDICATES SOFFIT EDGE.
- 8. INSTALL CORNER GUARD AS INDICATED. SEE INTERIOR FINISH ELEVATIONS.

# **GENERAL NOTES**

- A. GENERAL CONTRACTOR TO NOTIFY CONSTRUCTION MANAGER IMMEDIATELY IF A DISCREPANCY EXISTS BETWEEN CASEWORK SHOP DRAWINGS, EXITING SITE CONDITIONS, ARCHITECTURAL DRAWINGS OR BUILT FIXTURES. ALL DIMENSIONS SHALL BE FIELD VERIFIED BY GC PRIOR TO SHOP DRAWINGS PRODUCTION.
- B. STARBUCKS CONSTRUCTION MANAGER TO COORDINATE AND SCHEDULE CASEWORK DELIVERY DATE. GENERAL CONTRACTOR TO CONFIRM CASEWORK DELIVERY DATE WITH CASEWORK MANUFACTURER AT FOUR (4) WEEKS PRIOR AND THEN ONE (1) WEEK PRIOR TO SCHEDULED DATE OF DELIVERY.
- C. STARBUCKS CONTRACTS DIRECTLY WITH CASEWORK VENDOR TO SUPPLY CASEWORK LISTED IN THE CASEWORK SCHEDULE, UNLESS OTHERWISE NOTED.
- D. CASEWORK VENDOR TO PROVIDE COMPLETE SHOP DRAWINGS AND INSTALLATION PACKAGE TO GENERAL CONTRACTOR TO FACILITATE PROPER INSTALLATION.
- E. ALL CASEWORK BOX BASE / TOE KICKS SHALL BE SET AND LEVELED USING 1/4" (6 MM) NON-ABSORBENT PLASTIC SHIMS PROVIDED BY CASEWORK VENDOR.
- F. SEE INTERIOR FINISH ELEVATIONS AND SCHEDULES FOR LOCATION AND TAGGING OF WALL TREATMENTS BY CV AND OTHERS.
- G. SEE REFLECTED CEILING PLAN FOR CASEWORK SOFFIT LOCATIONS.
- H. REFERENCE PLUMBING AND ELECTRICAL PLANS FOR PLACEMENT OF ELECTRICAL, DATA AND PLUMBING ON FRONT AND BACKLINE OF BAR.
- I. PROVIDE ACCENT LIGHTING AT FRONT EDGE OF BAR. SEE INTERIOR ELEVATIONS AND ELECTRICAL FOR ADDITIONAL INFORMATION.
- CASEWORK VENDOR TO ENGINEER PROPER COUNTERTOP SUPPORT AT ESPRESSO BAR AND OTHER WORKSTATIONS PER STARBUCKS MINIMUM PERFORMANCE REQUIREMENTS.



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ISSUED DATE: 06/16/2020 EXPIRATION DATE: 12/31/2020

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PRYOR, EIN DR. ST, PR, E'S

BUILDOU COFFEE CHIPMAN 62012 87799-001

PROJECT #: ISSUE DATE: SR. DESIGN MANAGER: K. GORIN SLONSKI PRODUCTION DESIGNER: A. HAHN CHECKED BY:


Revision Schedule

CASEWORK PLAN

SCALE: AS SHOWN

STORE #:

SHEET NUMBER: I102

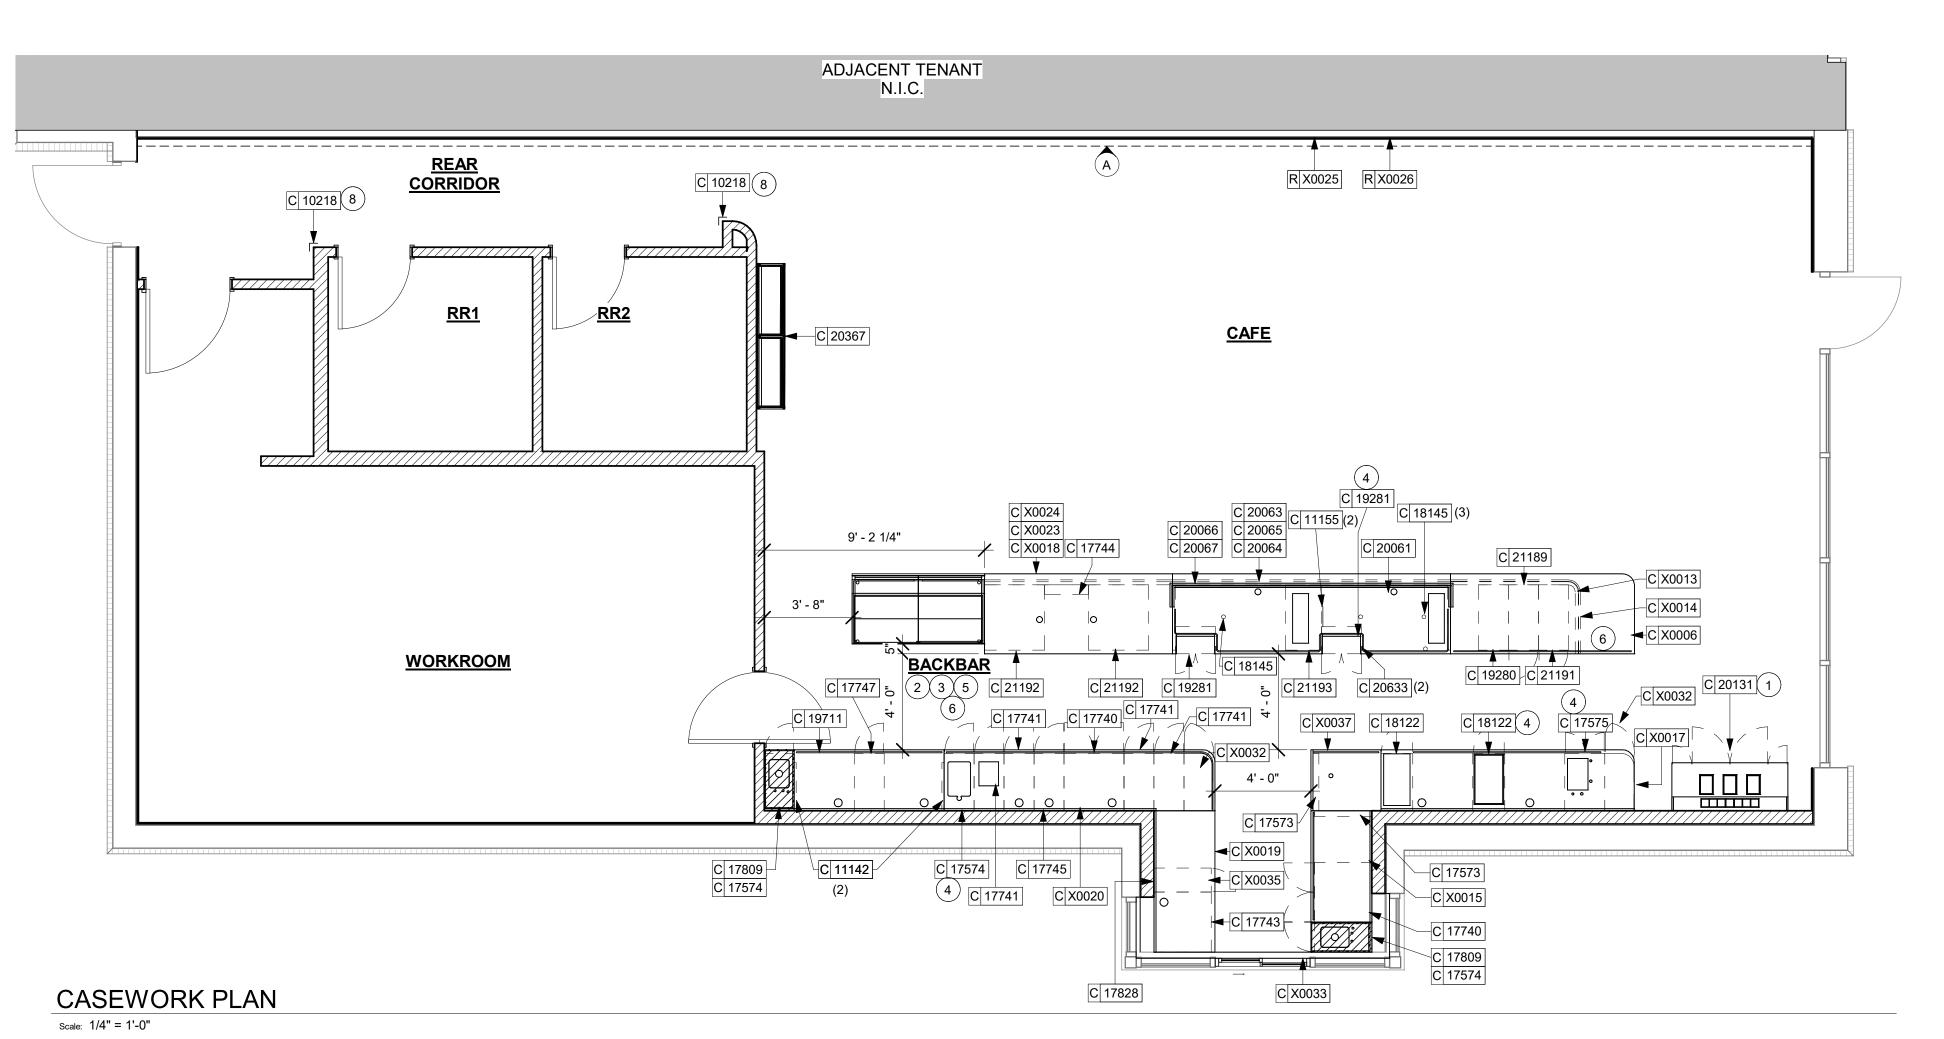

LEGEND


INDICATES STAINLESS STEEL (SST) COUNTERTOP

INDICATES SOLID SURFACE (SS) COUNTERTOP

DATUM POINT

EXTENT OF WOOD CLADDING

C 12345 CASEWORK TAG

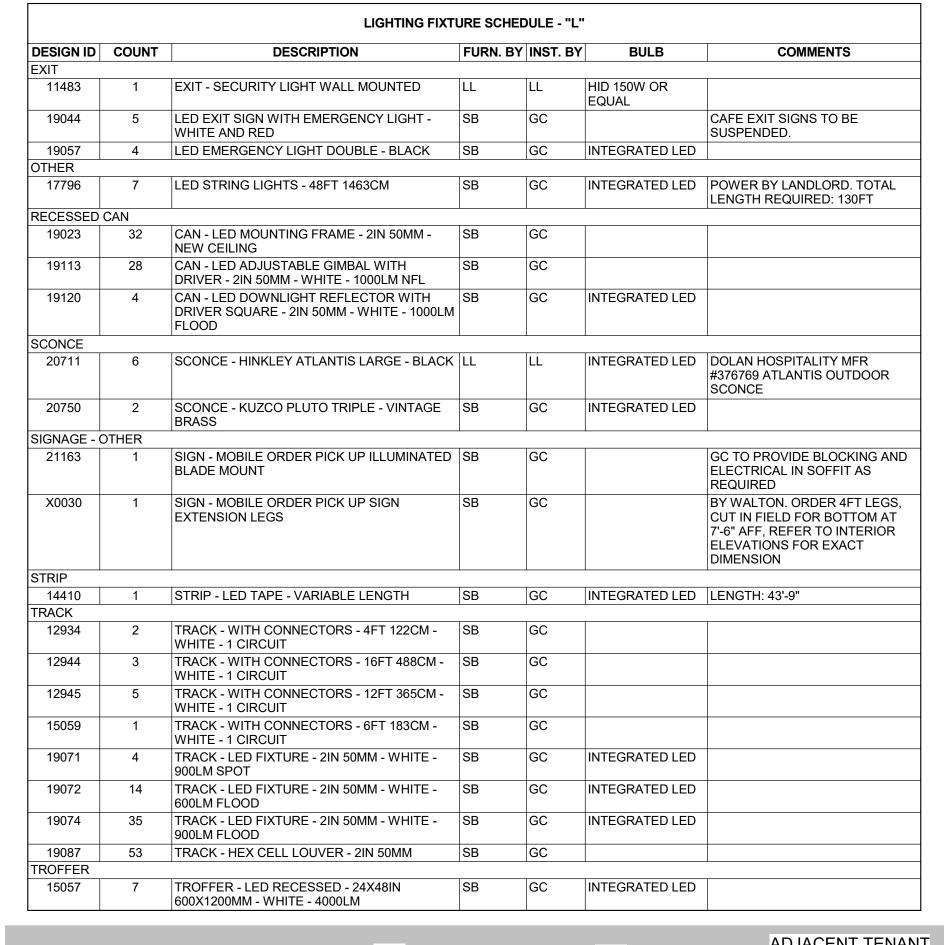

Scale: 1/4" = 1'-0"

**LEGEND - LIGHTING LEGEND** CAN - LED ADJUSTABLE GIMBAL WITH DRIVER - 2IN 50MM - WHITE -1000LM NFL DID: 19113 & 19023 CAN - LED DOWNLIGHT REFLECTOR WITH DRIVER -2IN 50MM - WHITE - 1000LM FLOOD DID: 19120 & 19023 TRACK - LED FIXTURE - 2IN 50MM - WHITE - 900LM FLOOD HEX LOUVER DID: 19087 AIM AT SEATING TRACK - LED FIXTURE - 2IN 50MM - WHITE - 900LM SPOT DID: 19071 HEX LOUVER DID: 19087

AIM AT MERCHANDISE/CONDIMENT CART TRACK - LED FIXTURE - 2IN 50MM - WHITE - 600LM FLOOD DID: 19072 HEX LOUVER DID: 19087 AIM AT MENU BOARDS & ARTWORK

STRIP - LED TAPE - VARIABLE LENGTH; DID: 14410

# **KEYED NOTES**

**ELEVATION DATUM** 

TRACK LIGHTING

TROFFER

WALL SCONCE

**EXIT SECURITY LIGHT** 

SECURITY CAMERA

SUPPLY AIR

**RETURN AIR** 

MUSIC SYSTEM SPEAKER

WIFI ACCESS POINT (WAP)

RECESSED CAN LIGHT

ADJUSTABLE RECESSED CAN LIGHT

- 1. GWB SOFFIT WITH SMOOTH FINISH (PAINT AS SCHEDULED).
- 2. GWB CEILING. PAINT CEILING DIFFUSERS AS INDICATED.
- 3. WASHABLE CEILING TILE LOCATED IN BACK OF HOUSE
- AND ABOVE CAFE BAR (IF APPLICABLE). 4. PLATFORM FOR HEATER AND WATER FILTRATION. PROVIDE SOFFIT AND LIFT CEILING THIS AREA ONLY TO
- 5. EXTERIOR RECESSED LIGHTING BY LL.
- 6. HEATING, VENTILATING AND AIR CONDITIONING FOR REFERENCE ONLY. SEE MECHANICAL DRAWINGS FOR ADDITIONAL INFORMATION. EXPOSED PARTS TO BE PAINTED TO MATCH ADJACENT COLOR.

INSURE ADEQUATE CLEARANCE FOR SERVICING.

- 7. SURFACE MOUNTED TRACK LIGHTING.
- 8. RECESSED ACCESS HATCH. PAINT TO MATCH ADJACENT FINISH. FINAL LOCATION TO BE CONFIRMED AND APPROVED IN FIELD BY STARBUCKS CONSTRUCTION MANAGER.
- 9. RESTROOM SCONCE. SEE INTERIOR ELEVATIONS FOR MOUNTING HEIGHT.
- 10. RECESSED SPEAKER.
- 11. ILLUMINATED MOP SIGN. REFER TO ELECTRICAL SHEETS. GC TO PROVIDE ADEQUATE BLOCKING WITHIN SOFFIT FOR PROPER SUPPORT
- 12. CAFE CEILING TILE START POINT.
- 13. WORKROOM CEILING TILE START POINT.
- 14. INSTALL STRING LIGHTS AS INDICATED. POWER BY LL.
- 15. GC TO CONFIRM EMERGENCY LIGHTING LOCATIONS/QUANTITY WITH FIRE MARSHAL.
- 16. INDICATES EDGE OF CEILING TILE, SEE DETAIL

# **GENERAL NOTES**

- A. IF REQUIRED BY LOCAL CODE, GENERAL CONTRACTOR TO PROVIDE SEMI-RECESSED SPRINKLER HEADS WITH POLISHED CHROME ESCUTCHEONS CENTERED IN ACOUSTICAL CEILING TILE. IF PENDANT HEADS ARE REQUIRED IN GWB SOFFIT OVER FRONTBAR, CONCEAL SUPPLY PIPING WITHIN SOFFIT. GENERAL CONTRACTOR TO SUBMIT SPRINKLER LAYOUT TO STARBUCKS' CONSTRUCTION MANAGER FOR APPROVAL PRIOR TO INSTALLATION.
- B. LEAVE TEN (10) ADDITIONAL RETAIL CEILING TILES TO MATCH RETAIL CEILING PAINT COLOR ABOVE THE WORKROOM CEILING AT MANAGER'S DESK FOR FUTURE
- C. PROVIDE GROMMET AT ACOUSTIC CEILING PENETRATIONS FOR FIXTURES OF SUPPORTS.
- D. HEATING, VENTILATING AND AIR CONDITIONING SHOWN ON THIS PLAN PROVIDED FOR REFERENCE ONLY. SEE MECHANICAL DRAWINGS FOR ADDITIONAL INFORMATION.
- E. DIFFUSERS AND RETURNS IN ACOUSTICAL CEILING TILE TO BE CENTERED IN TILE AND PAINTED TO MATCH ADJACENT FINISHES (TYP.).
- F. PAINT ALL EXPOSED HVAC DUCTS, HVAC DIFFUSERS. LIGHT TRIM RINGS, PIPING, CONDUIT AND JUNCTION BOXES THE SAME COLOR AS SPECIFIED ON SURROUNDING CEILING OR SOFFIT UNLESS OTHERWISE NOTED. TYPICAL THROUGHOUT RETAIL AREA OF STORE.
- G. PAINT SUBSTITUTIONS ARE NOT ALLOWED. USE STARBUCKS' NATIONAL ACCOUNT "COLOR CODE" WHEN ORDERING PAINTS.



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ISSUED DATE: 06/16/2020

EXPIRATION DATE: 12/31/2020 3 SUMMIT LOT /EST PRYOR, I ENSTEIN DR. MO NTY ST, PR, E'S

BUILDOUT
COFFEE CHIPMAN STORE #: 62012 PROJECT #: 87799-001 ISSUE DATE: SR. DESIGN MANAGER: K. GORIN SLONSKI PRODUCTION DESIGNER: A. HAHN


CHECKED BY: NORR **Revision Schedule** 

SHEET TITLE: REFLECTED CEILING PLAN

SHEET NUMBER:

SCALE: AS SHOWN

**I**103

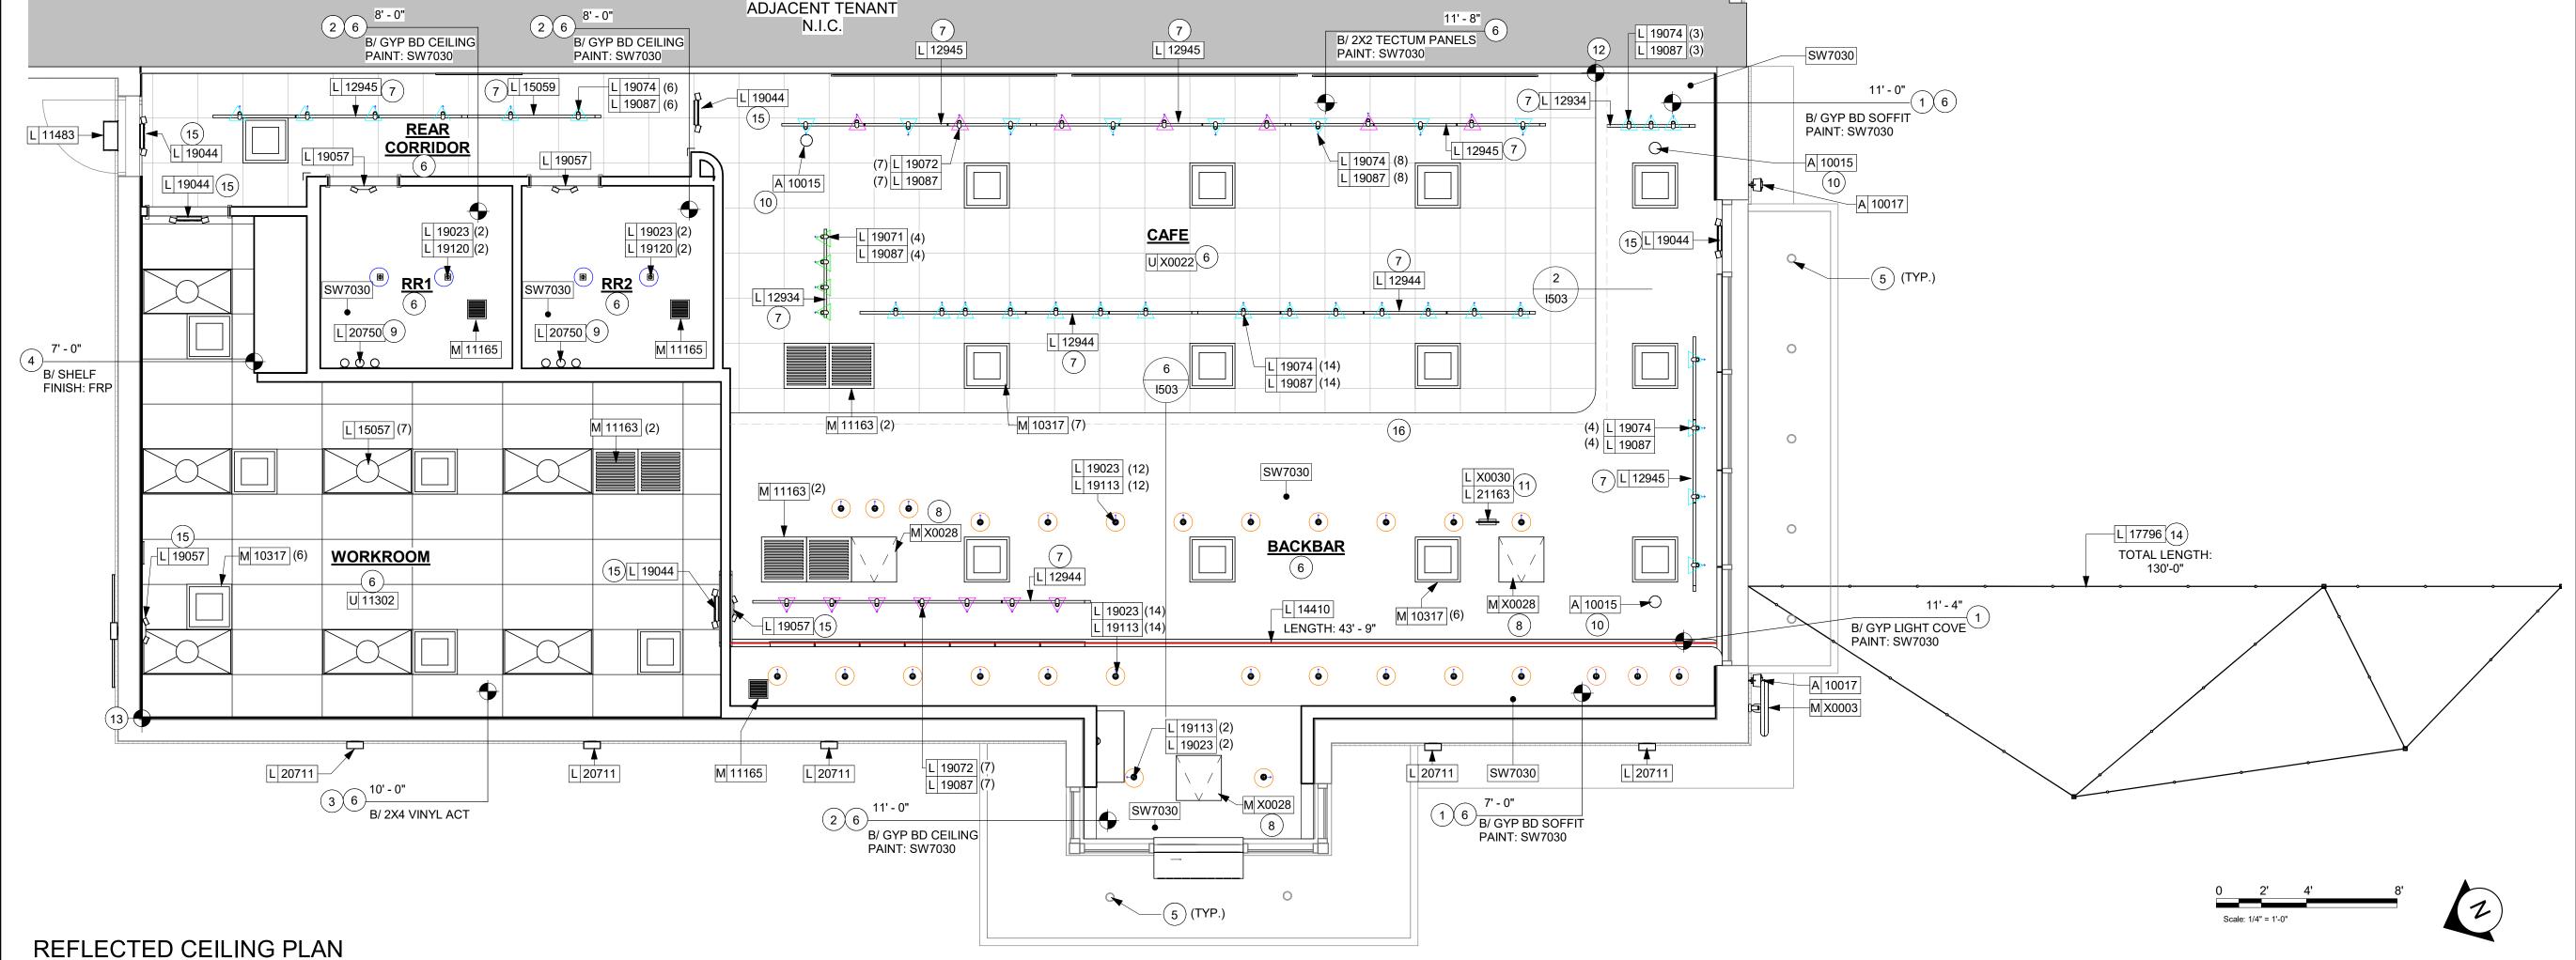

# LEGEND - LIGHTING

- CAN LED ADJUSTABLE GIMBAL WITH DRIVER - 2IN 50MM - WHITE -1000LM NFL DID: 19113 & 19023
- CAN LED DOWNLIGHT REFLECTOR WITH DRIVER -2IN 50MM - WHITE - 1000LM FLOOD DID: 19120 & 19023
- TRACK LED FIXTURE 2IN 50MM WHITE 900LM FLOOD HEX LOUVER DID: 19087 AIM AT SEATING
- DID: 19071 HEX LOUVER DID: 19087 AIM AT MERCHANDISE/CONDIMENT CART



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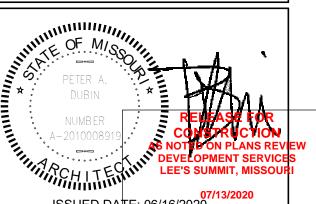
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/EST PRYOR, I ENSTEIN DR. MO NTY

BUILDOUT
COFFEE CHIPMAN STORE #: 62012 PROJECT #: 87799-001

ISSUE DATE: 07-07-2020
SR. DESIGN MANAGER: K. GORIN SLONSKI
PRODUCTION DESIGNER: A. HAHN
CHECKED BY: NORR

Rev	vision	Schedul

DIMENSIONED RCP W/ UNDERLAY SCALE: AS SHOWN

SHEET NUMBER:

I103.1

Scale: 1/4" = 1'-0"

FLOOR TREATMENT SCHEDULE - "T"						
DESIGN ID	AREA	DESCRIPTION	FURN. BY	INST. BY	COMMENTS	
PLASTIC	•					
19795	819 SF	POLYVINYL FLOOR TILE - ECO-GRIP - PEWTER	GC	GC	MANUFACTURER: ALLIED ECO-GRIP. PEWTER	
TILE	•					
20266	1149 SF	TILE - FRENCH CLAY - BRONZAGE - 24X24IN 600X600MM	SB	GC	GROUT: MAPEI - 09 GRAY, OR EQUAL	
WALK OFF	MAT		•			
19288	26 SF	WALK OFF MAT - HELIX Z1 - BLACK - 12X9IN 305X230MM	SB	GC	ANODIZED METAL FRAME TO BE INCLUDED IN ORDER, FROM MANUFACTURER	


WALL BASE SCHEDULE - "B"						
DESIGN ID	LENGTH	DESCRIPTION	FURN. BY	INST. BY	COMMENTS	
TILE BASE	•		•	'		
18740	150' - 0 1/2"	TILE BASE - PLAZA NOVA - BLACK SHADOW - 6X12IN 150X300MM	SB	GC	GROUT: MAPEI - 47 CHARCOAL, OR EQUAL	
19795	188' - 2 1/4"	POLYVINYL FLOOR TILE - ECOGRIP - PEWTER	GC	GC	MANUFACTURER: ALLIED ECO-GRIP. PEWTER	
20196	59' - 10"	TILE BASE - FORMULA - EQUATION GREY - 6X12IN 150X300MM	SB	GC	GROUT: MAPEI - 09 GRAY	

# **KEYED NOTES**

- 1. TILE START POINT WHERE INDICATED.
- 2. MOP SINK WHERE INDICATED. SEE PLUMBING PLANS FOR MORE INFORMATION.
- 3. FLOOR SINK/FLOOR DRAIN LOCATION. SEE BUILDING FLOOR PENETRATION PLAN ON SHEET A102 AND PLUMBING FOR ADDITIONAL INFORMATION.
- ELECTRICAL STUB UP. SEE BUILDING FLOOR PENETRATION PLAN ON SHEET A102 AND ELECTRICAL FOR ADDITIONAL INFORMATION.
- 5. RECESSED WALK-OFF MAT AT ENTRY. SEE INTERIOR DETAIL SHEETS FOR TRANSITION.
- 6. PLUMBING STUB UP. SEE BUILDING FLOOR PENETRATION PLAN ON SHEET A102 AND PLUMBING SHEETS FOR ADDITIONAL INFORMATION.
- 7. INDICATES FLOOR J-BOX FOR FURNITURE. VERIFY LOCATION WITH FF&E PLAN.

# **GENERAL NOTES**

- A. WORKROOM TO BE FINISHED PER LOCAL CODE REQUIREMENTS.
- B. FLOORS, WALLS AND CEILING FINISHES IN FOOD PREPARATION AREAS SHALL BE SMOOTH, NON-TOXIC, NON-ABSORBENT, DURABLE AND EASILY CLEANABLE. PAINT SHALL BE WASHABLE; SEMI-GLOSS OR HIGH-GLOSS FINISH.
- C. STARBUCKS TO SUPPLY FLOORING AND BASE FOR FRONT AND BACK OF HOUSE AS NOTED IN SCHEDULES. GENERAL CONTRACTOR TO INSTALL. GENERAL CONTRACTOR TO SUPPLY WORKROOM TILE AND BASE AND INSTALL. GENERAL CONTRACTOR TO SUPPLY AND INSTALL MORTAR, ADHESIVE, AND GROUT, GENERAL CONTRACTOR TO INSPECT ALL TILES AND REJECT DAMAGED OR SUBSTANDARD TILES PRIOR TO INSTALLATION.
- D. ALIGN TILE TRANSITIONS ON WHOLE TILES AS SHOWN.
- E. ALL FLOOR AND WALL JUNCTIONS IN STORAGE AND FOOD PREPARATION AREAS SHALL HAVE A 6" COVED

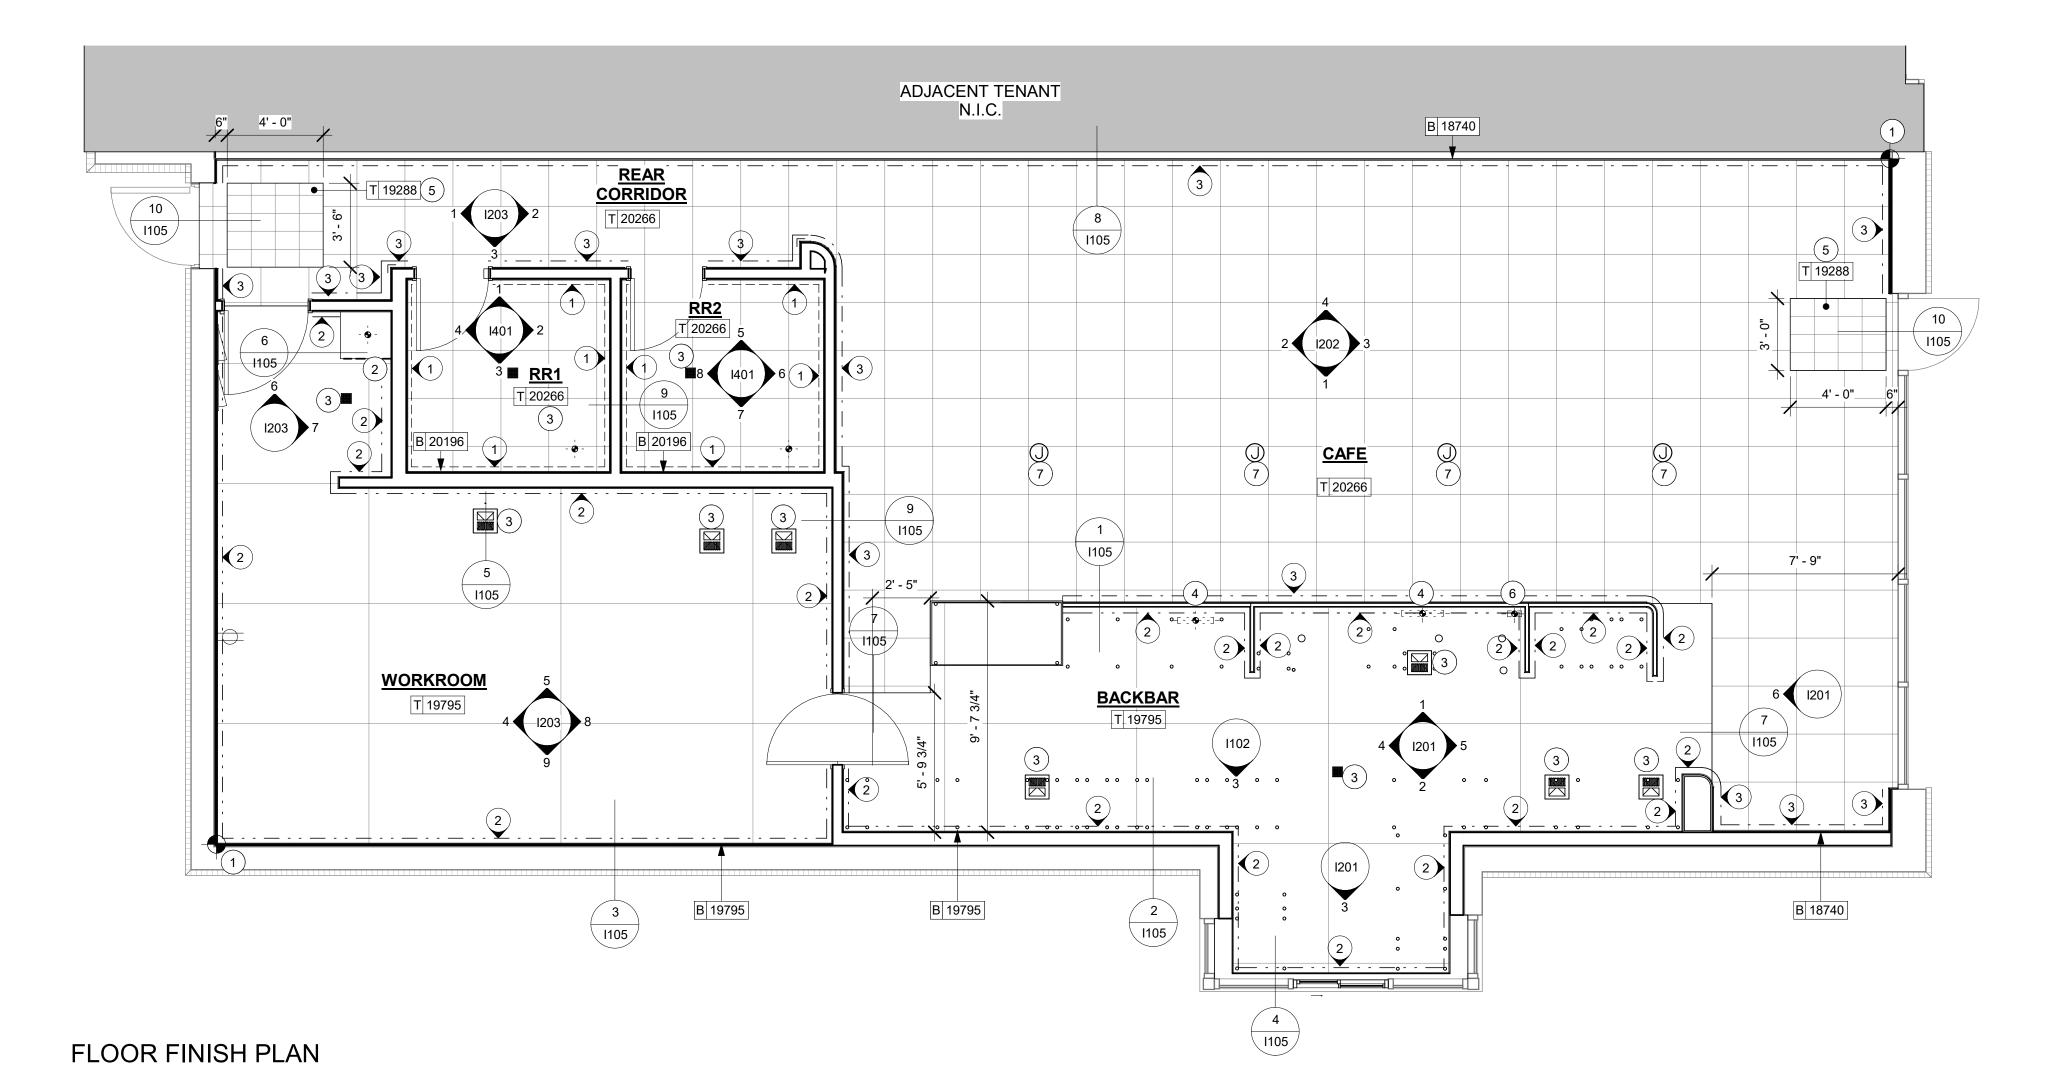







---- TILE BASE - FORMULA - EQUATION GRAY - 6IN X 12IN

DID: 20196 POLYVINYL BASE - ECOGRIP - PEWTER DID: 19795

TILE BASE - PLAZA NOVA - BLACK SHADOW - 6IN X 12IN DID: 18740



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EXPIRATION DATE: 12/31/2020

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BUILDOUT
COFFEE CHIPMAN

STORE #: 62012 PROJECT #: 87799-001 ISSUE DATE: 07-07-2020 SR. DESIGN MANAGER: K. GORIN SLONSKI PRODUCTION DESIGNER: A. HAHN CHECKED BY: NORR

Revision Schedule						
Date	Ву	Description				
	Date					


FLOOR FINISH PLAN

SCALE: AS SHOWN

SHEET NUMBER:

**I**104



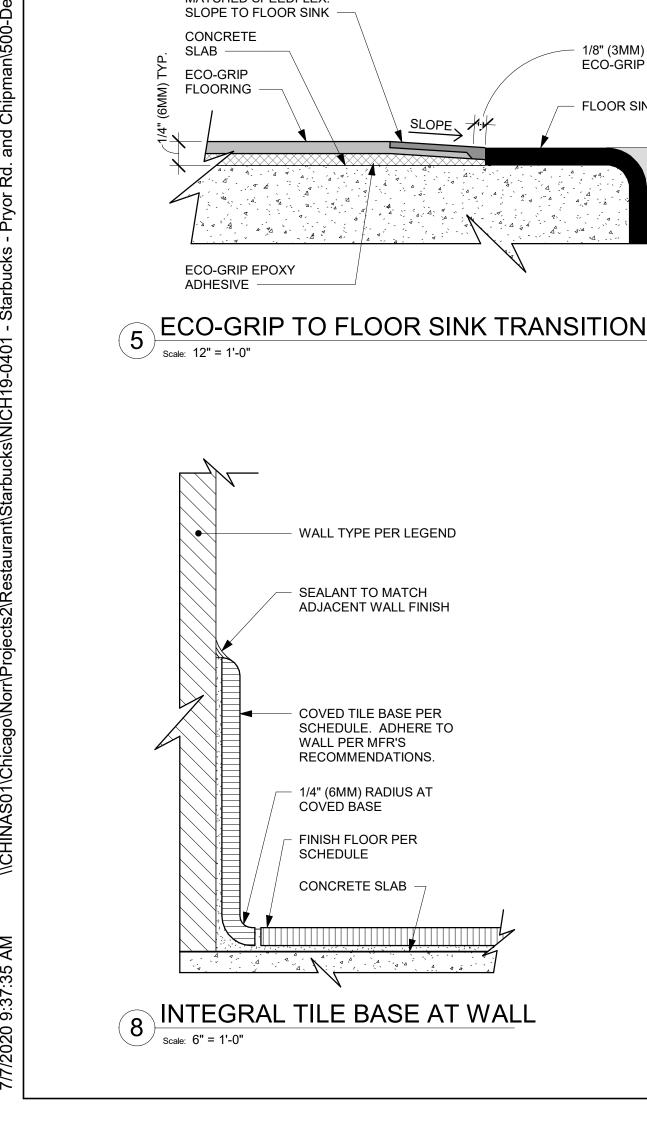

WALL TYPE PER LEGEND

SEALANT TO MATCH

ADJACENT WALL FINISH

COVED TILE BASE PER

RECOMMENDATIONS.

1/4" (6MM) RADIUS AT

FINISH FLOOR PER


CONCRETE SLAB

WALL PER MFR'S

COVED BASE

SCHEDULE


SCHEDULE. ADHERE TO

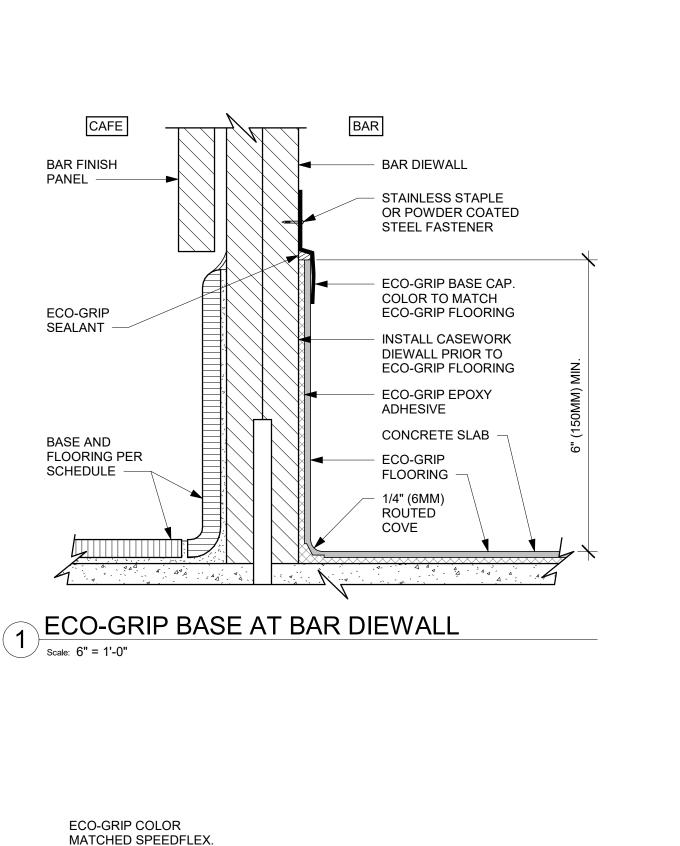



1/8" (3MM) GAP BETWEEN

FLOOR SINK AND GRATE

ECO-GRIP FLOORING AND FIXTURE

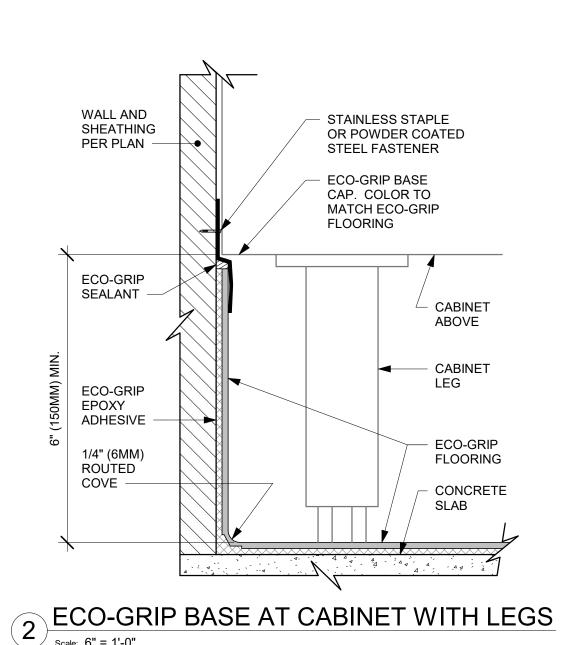


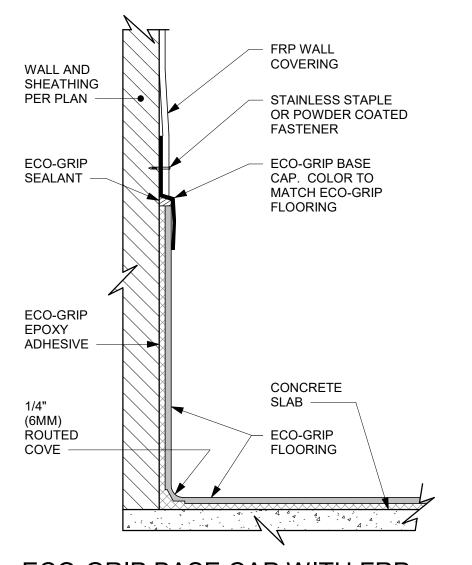


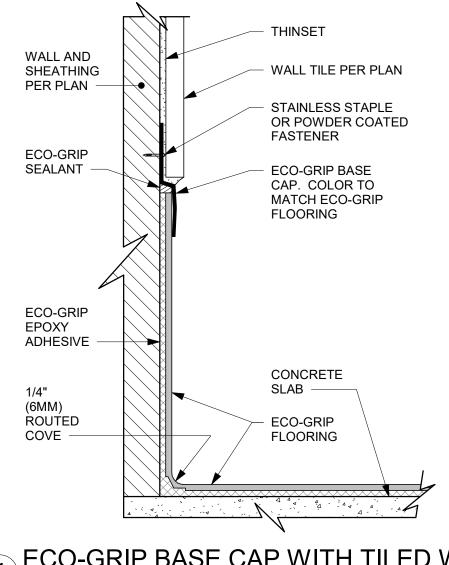



ECO-GRIP BASE CAP WITH FRP

ECO-GRIP BASE CAP WITH TILED WALL

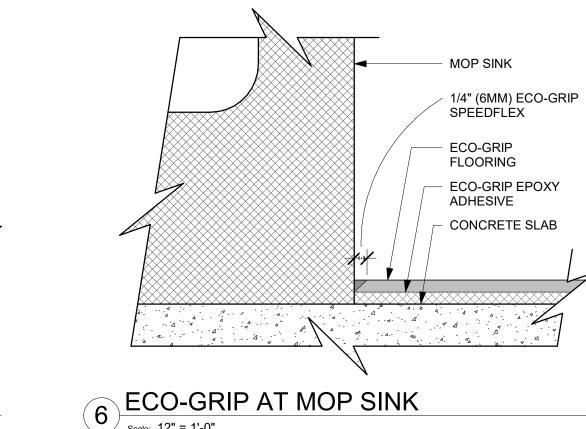

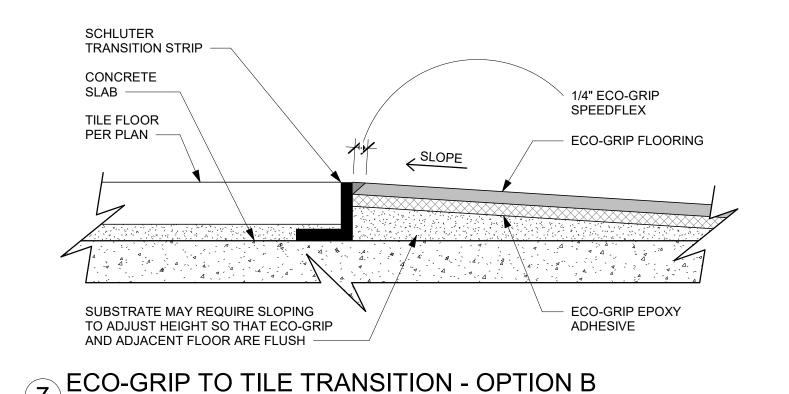


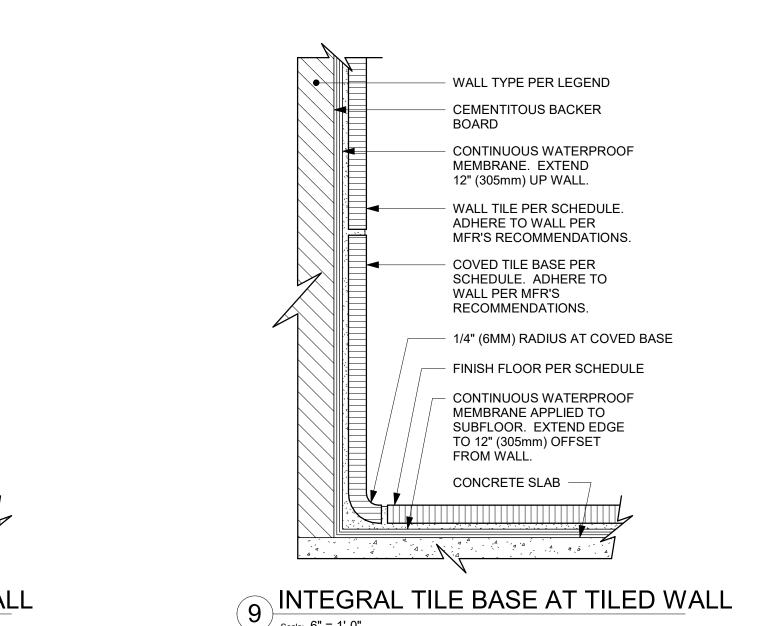

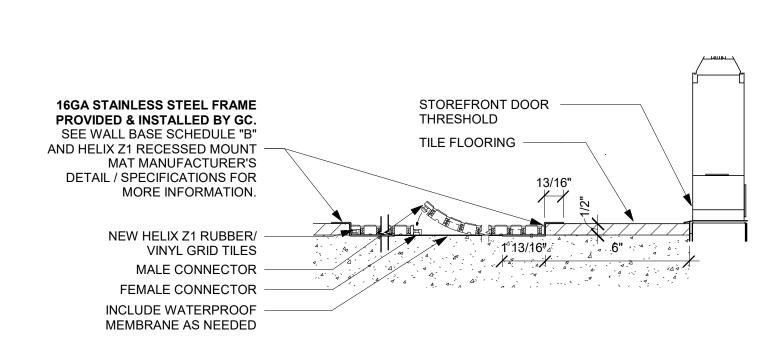



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LOT YOR, DR.

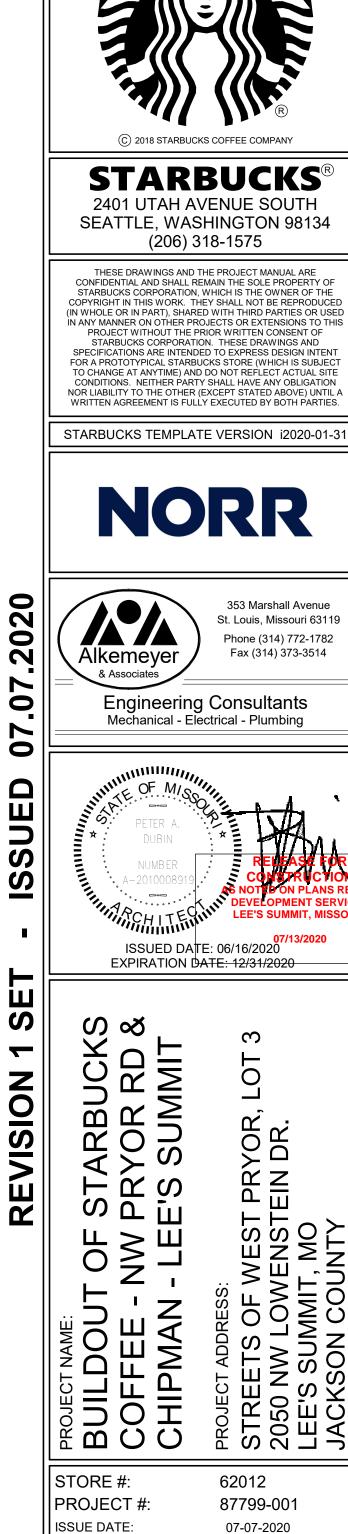STORE #:	62012
PROJECT #:	87799-001
ISSUE DATE: SR. DESIGN MANAGER: PRODUCTION DESIGNER: CHECKED BY:	07-07-2020 K. GORIN SLONSKI A. HAHN NORR

Rev	Date	Ву	Description
SHE	ET TITLE	:	
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SCALE: AS SHOWN SHEET NUMBER:

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ISSUED DATE: 06/16/2020 EXPIRATION DATE: 12/31/2020

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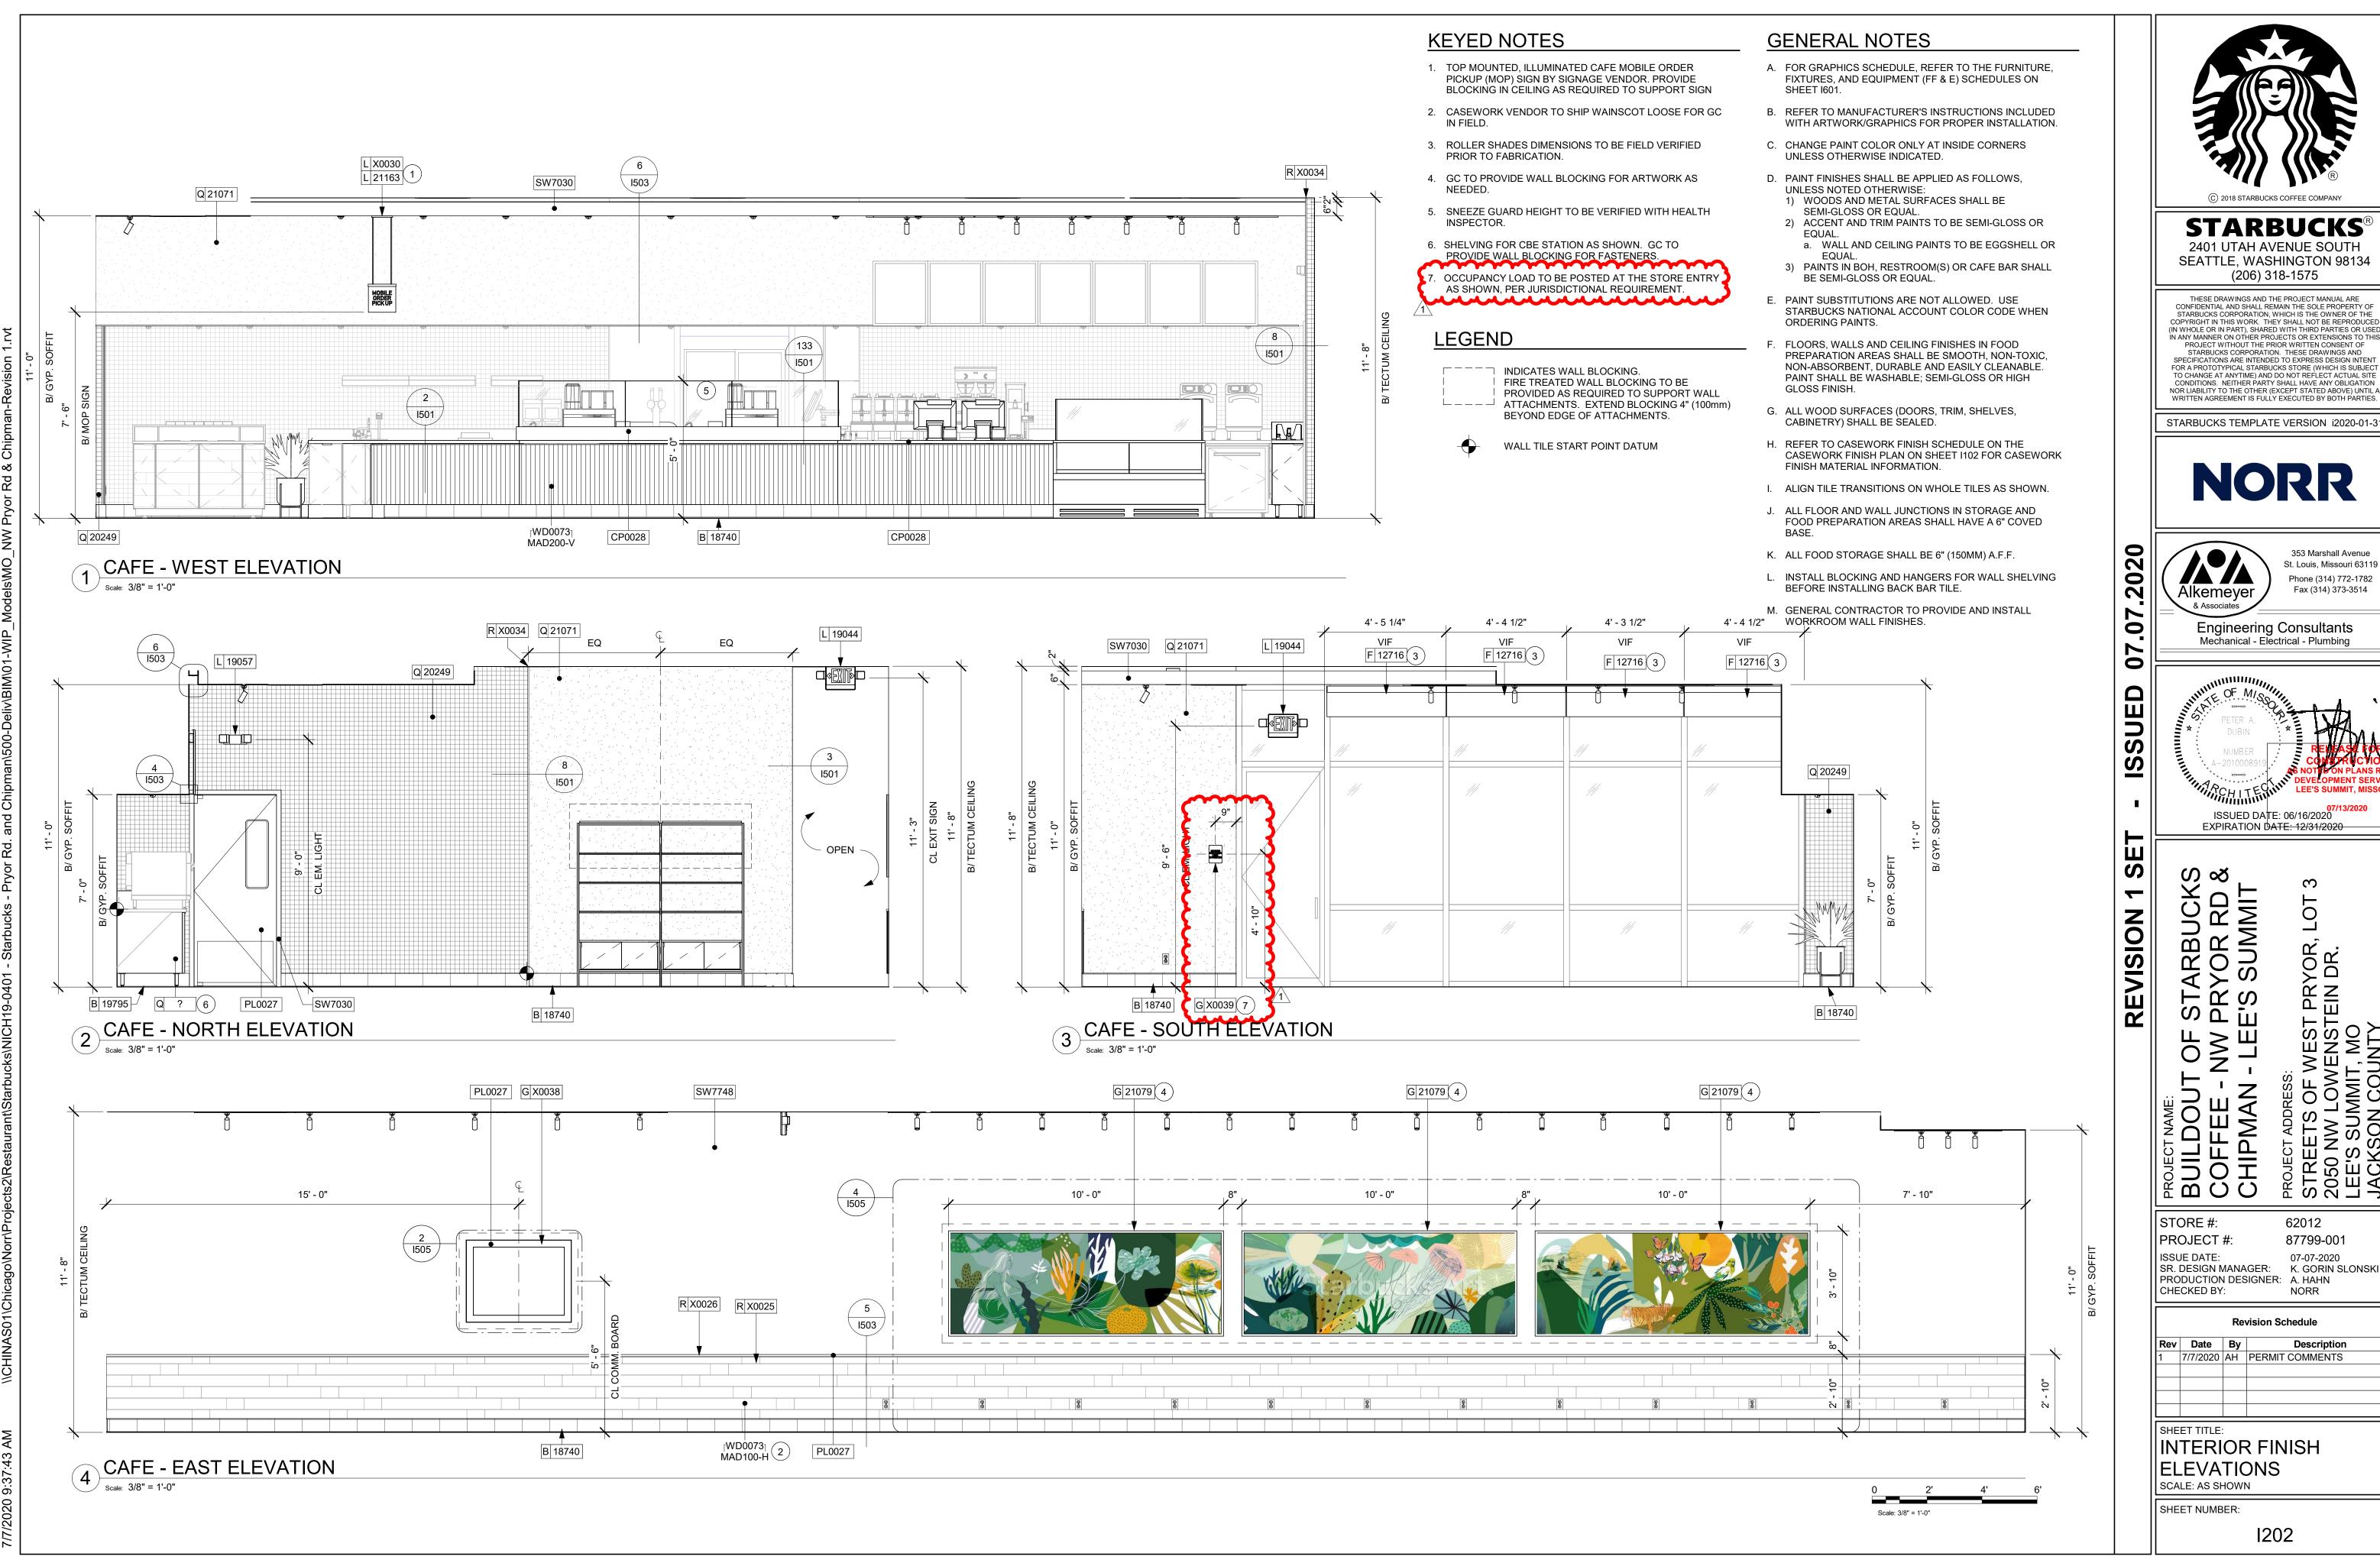
BUILDOU COFFEE CHIPMAN STORE #: 62012 87799-001 PROJECT #:

ISSUE DATE: 07-07-2020
SR. DESIGN MANAGER: K. GORIN SLONSKI
PRODUCTION DESIGNER: A. HAHN CHECKED BY:

INTERIOR FINISH ELEVATIONS SCALE: AS SHOWN

SHEET NUMBER:

1201



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Engineering Consultants Mechanical - Electrical - Plumbing




ISSUED DATE: 06/16/2020 EXPIRATION DATE: 12/31/2020

PRYOR, EIN DR.

62012 87799-001

ISSUE DATE: 07-07-2020 SR. DESIGN MANAGER: K. GORIN SLONSKI PRODUCTION DESIGNER: A. HAHN

**Revision Schedule** 

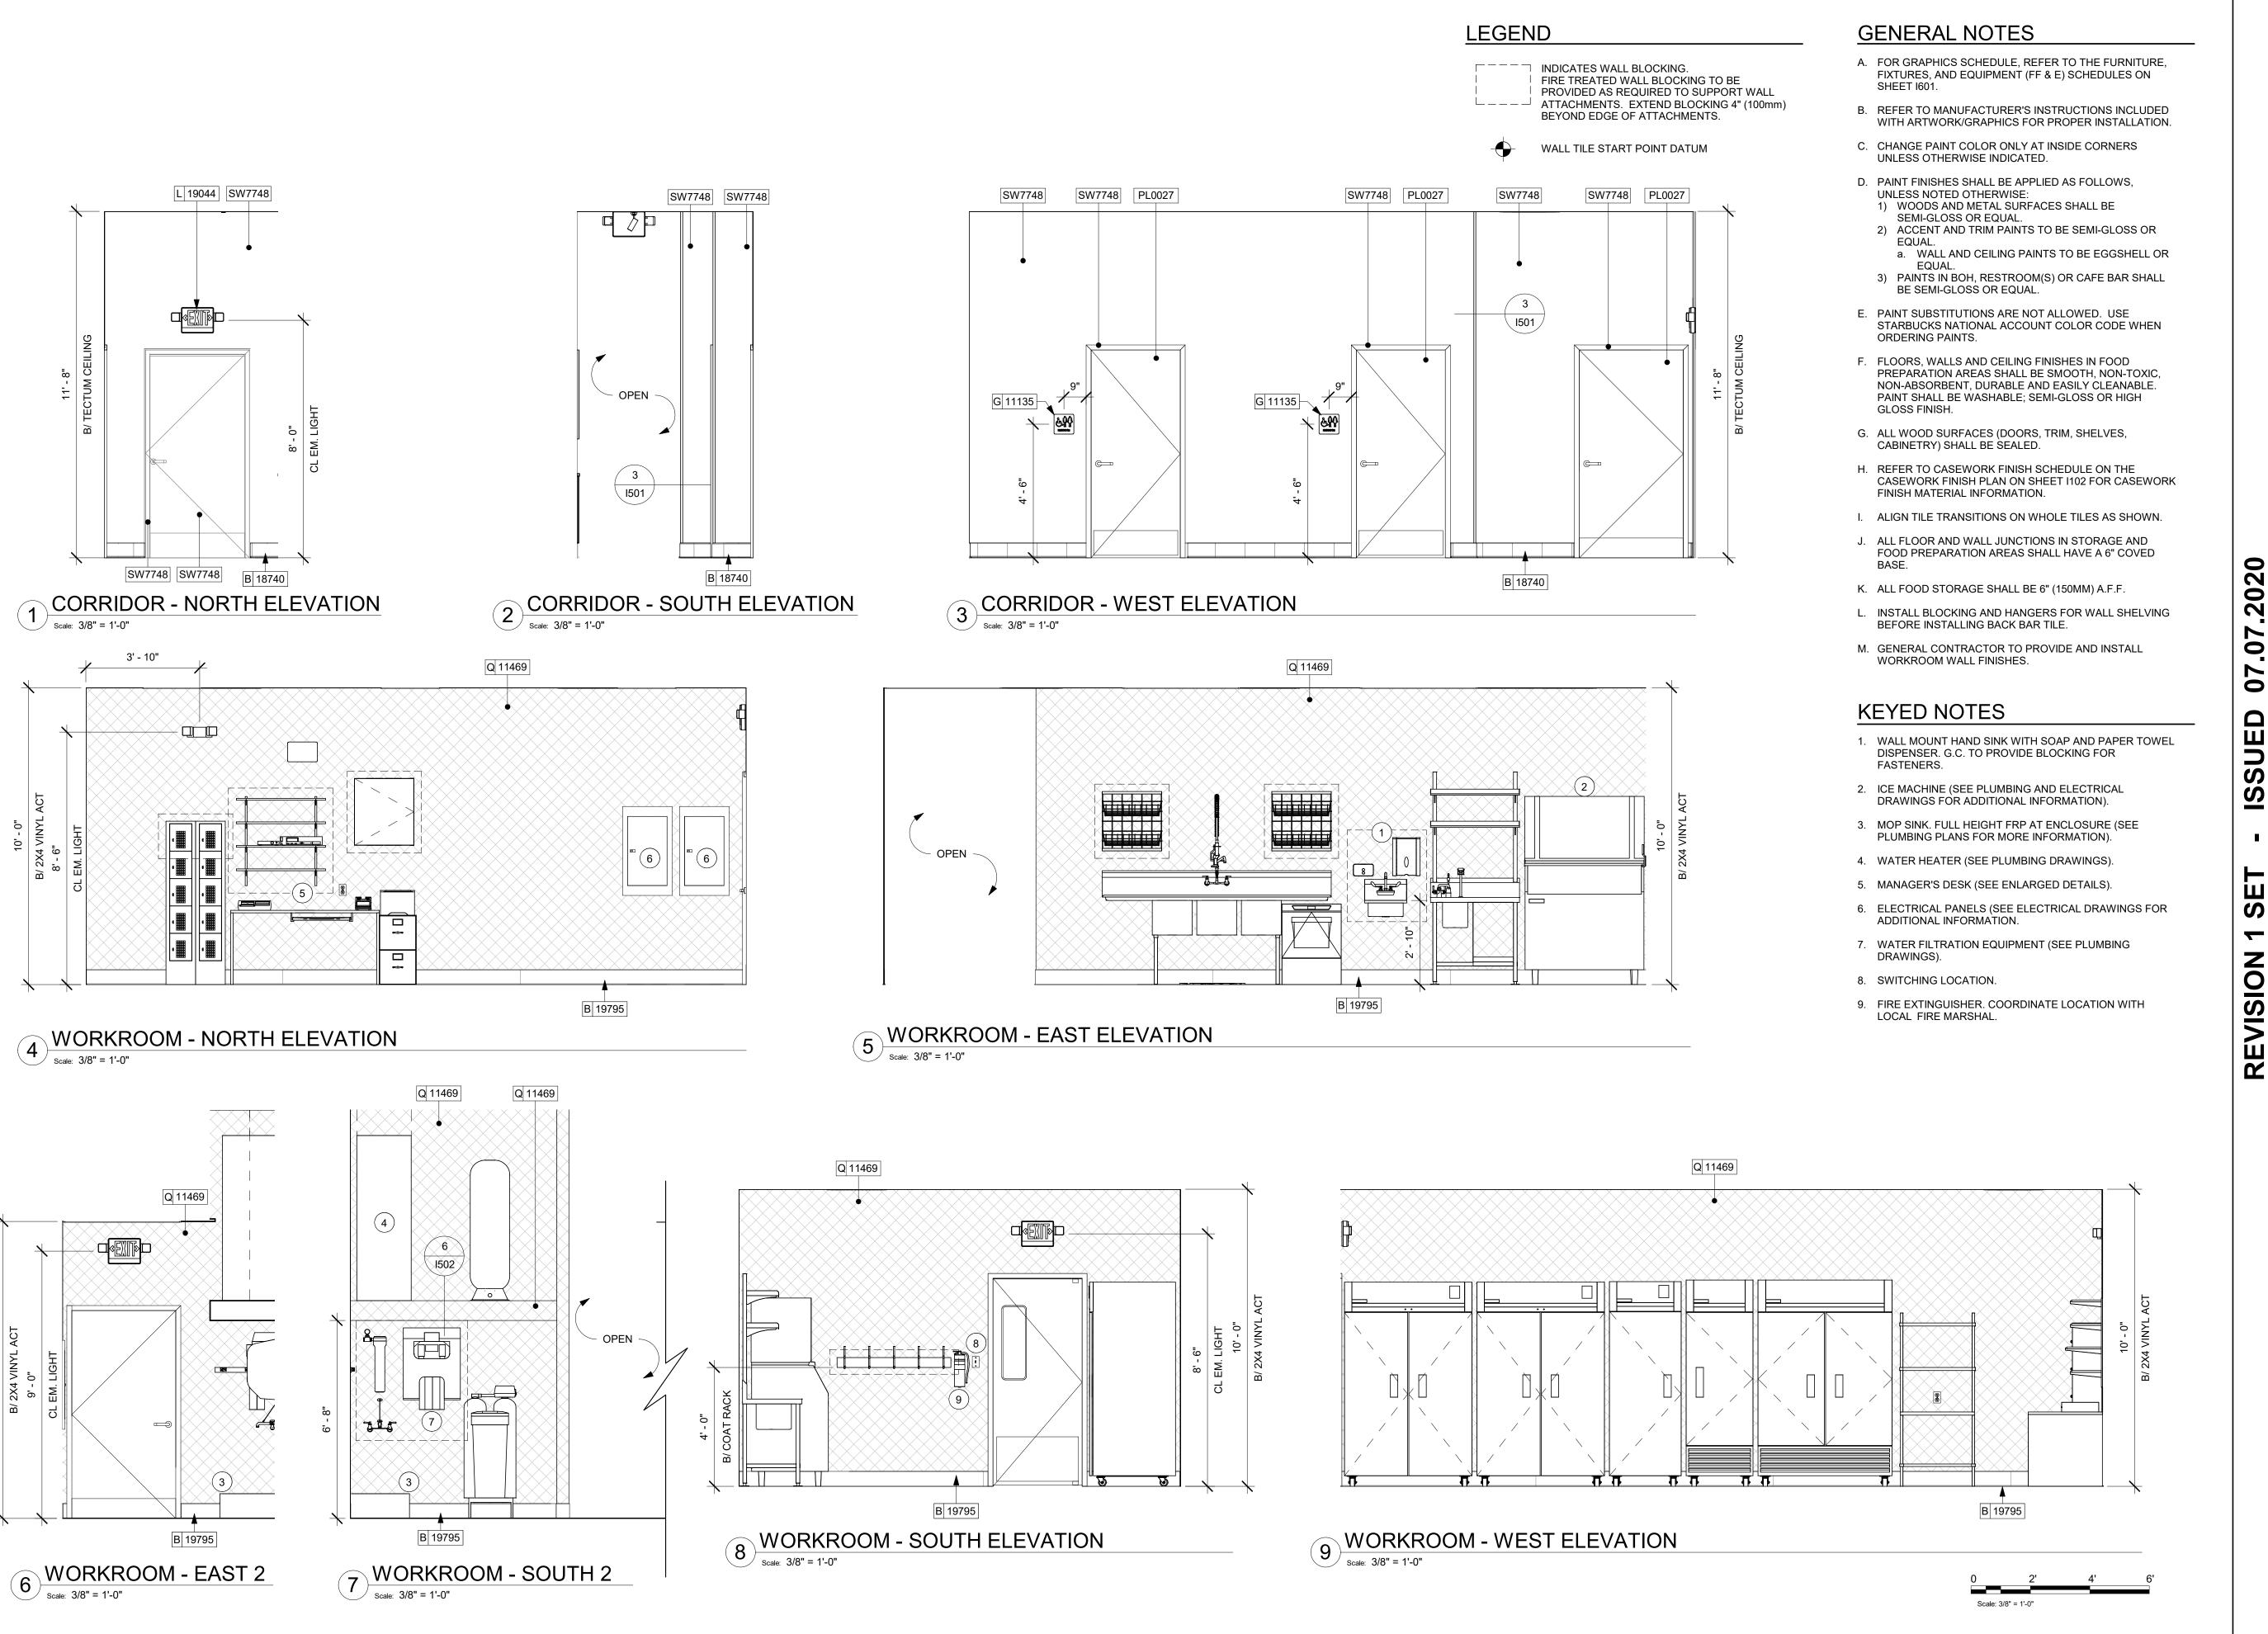

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ISSUED DATE: 06/16/2020

LOT

VEST PRYOR, I ENSTEIN DR. MO

EXPIRATION DATE: 12/31/2020

TARBUCK YOR RD SUMMIT REVISION ST, PR, E'S BUILDOUT
COFFEE CHIPMAN

STORE #: 62012 87799-001 PROJECT #: ISSUE DATE: 07-07-2020 SR. DESIGN MANAGER: K. GORIN SLONSKI PRODUCTION DESIGNER: A. HAHN CHECKED BY: NORR


**Revision Schedule** 

SHEET TITLE:

INTERIOR FINISH ELEVATIONS SCALE: AS SHOWN

SHEET NUMBER:

1203

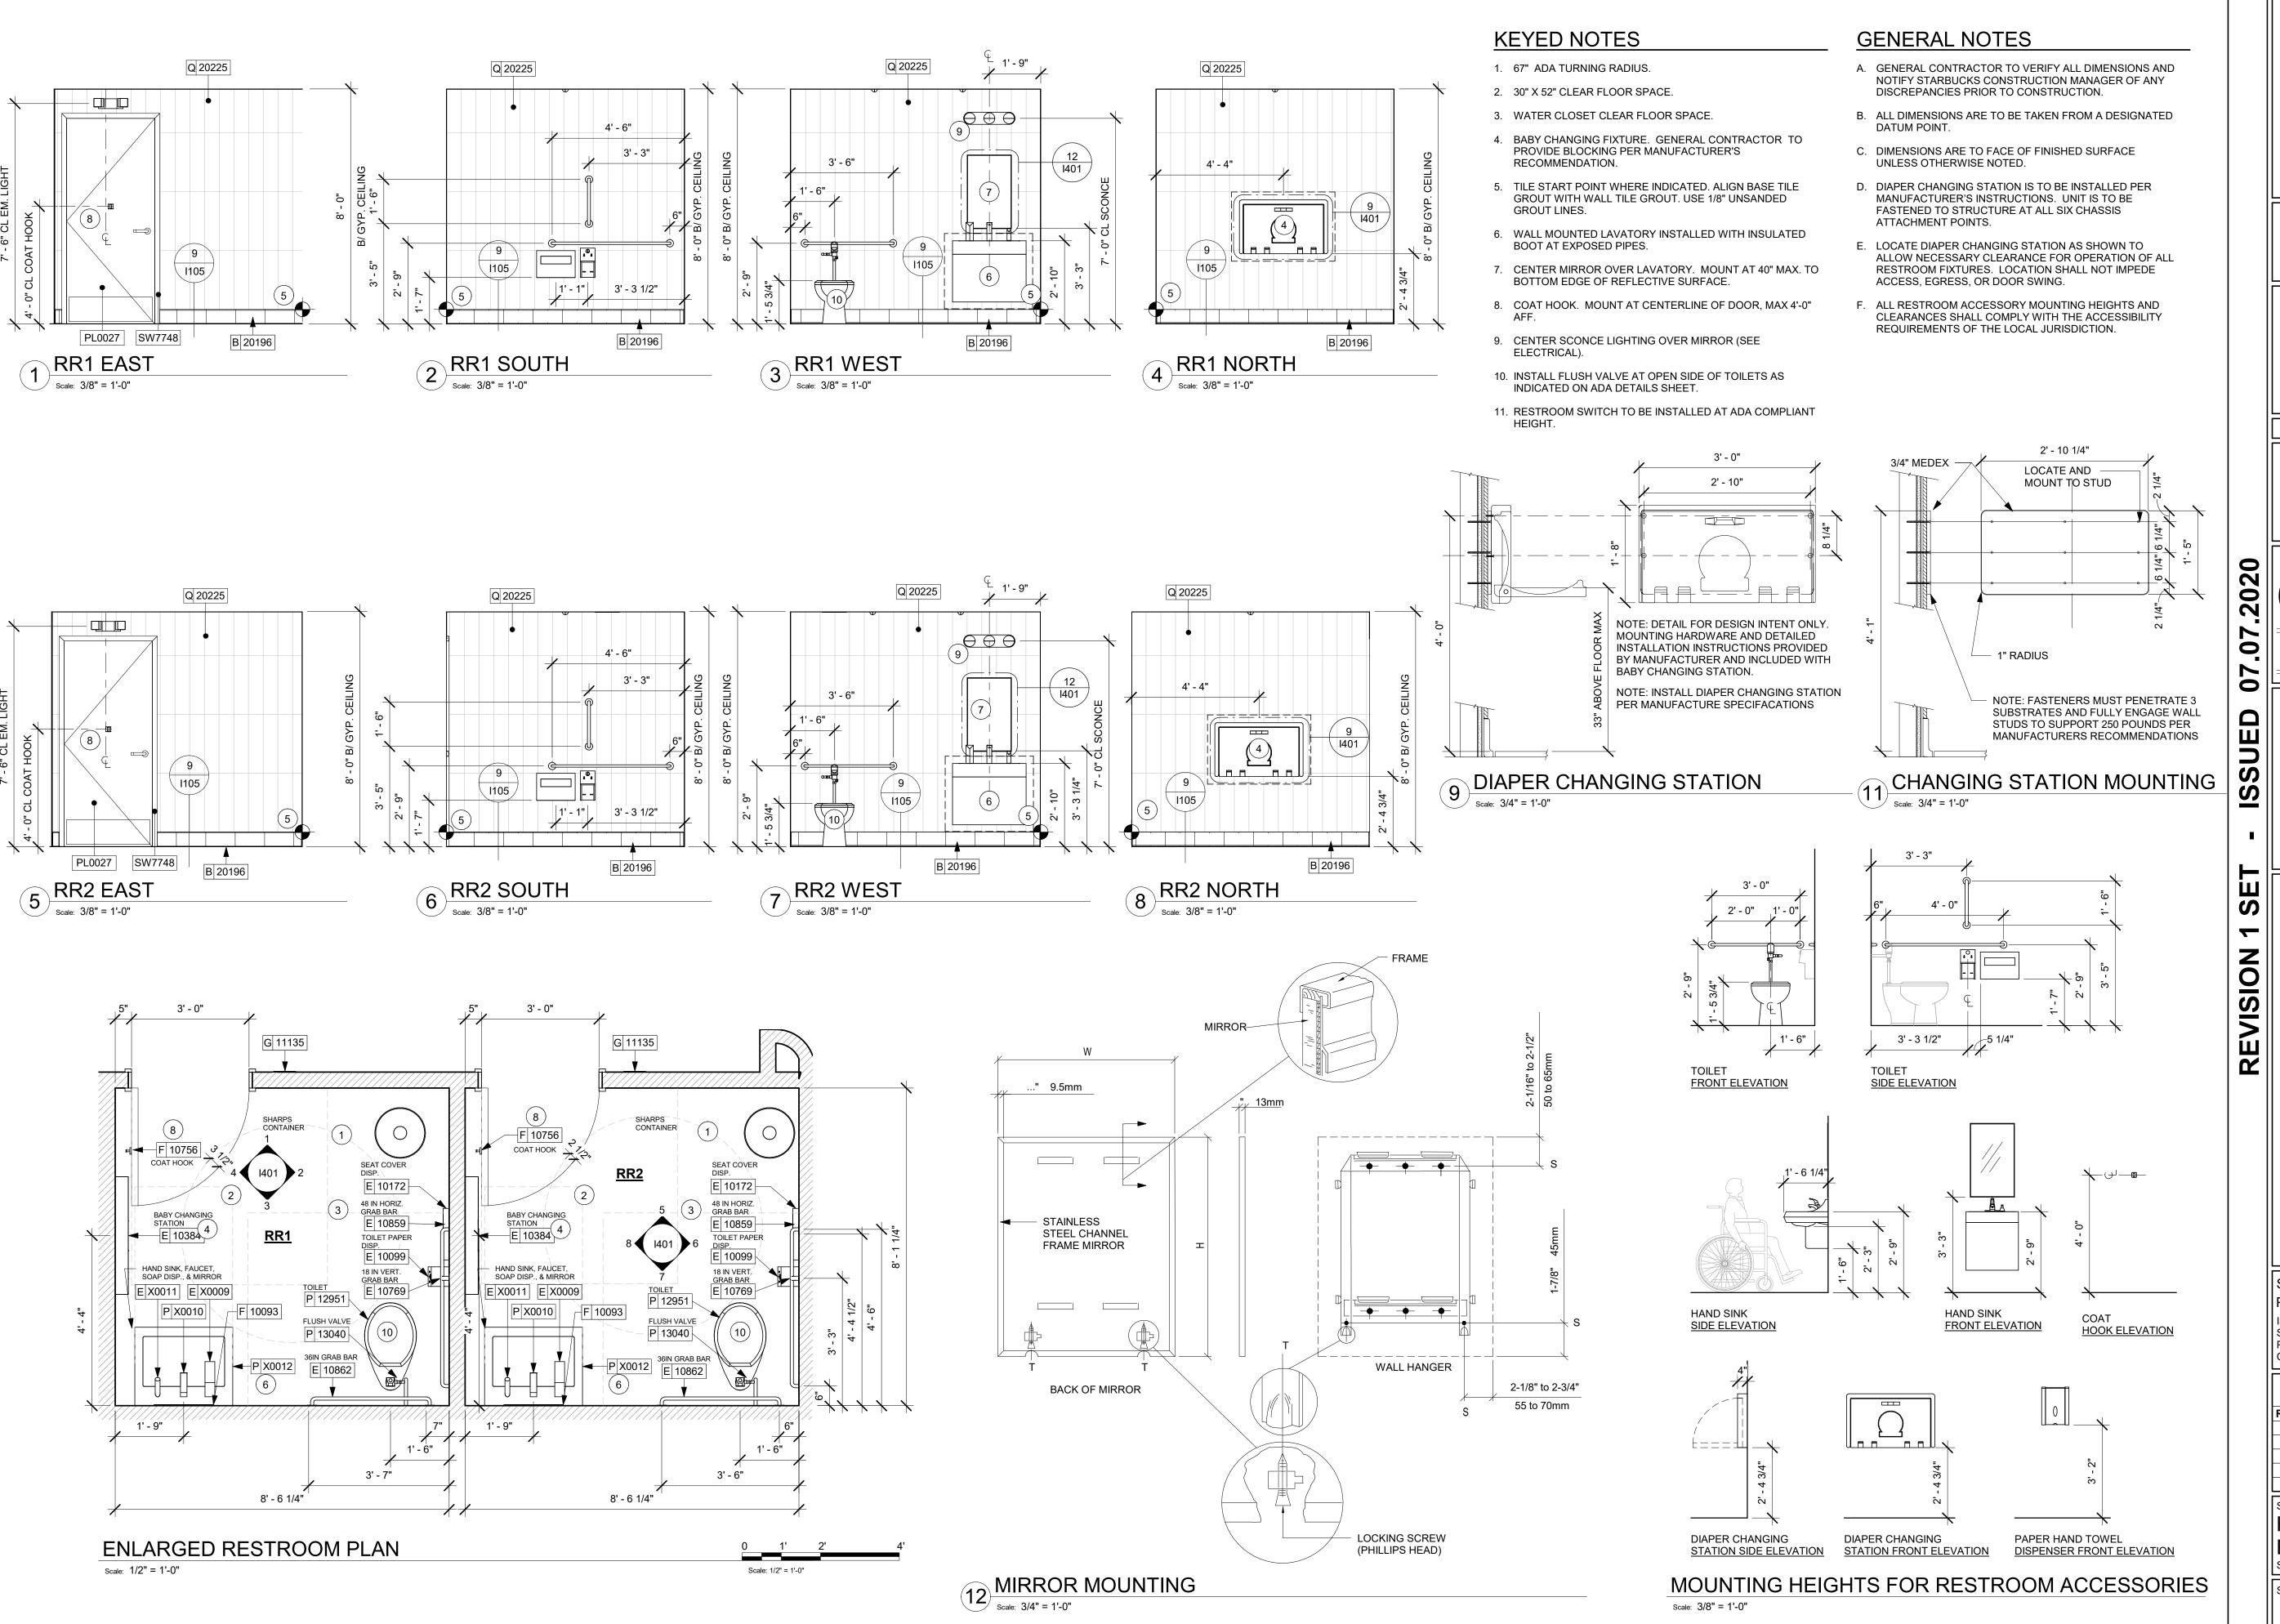

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**Engineering Consultants** Mechanical - Electrical - Plumbing



ISSUED DATE: 06/16/2020

EXPIRATION DATE: 12/31/2020

PRYOR, EIN DR.

BUILI COFF CHIP STORE #: 62012 PROJECT #: 87799-001 ISSUE DATE: SR. DESIGN MANAGER: K. GORIN SLONSKI

PRODUCTION DESIGNER: A. HAHN CHECKED BY: NORR

**Revision Schedule** SHEET TITLE: RESTROOM PLAN &

ELEVATIONS SCALE: AS SHOWN

SHEET NUMBER:

1401

Scale: 1/2" = 1'-0"

NOTE: CASEWORK VENDOR TO PROVIDE SHOP DRAWINGS FOR SBUX REVIEW PRIOR TO FABRICATION

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REVISION

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ST, PR, E'S

BUILDOUT
COFFEE CHIPMAN

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ISSUED DATE: 06/16/2020

EXPIRATION DATE: 12/31/2020

VEST PRYOR, I ENSTEIN DR. , MO INTY


STORE #: 62012 PROJECT #: 87799-001 ISSUE DATE: 07-07-2020 SR. DESIGN MANAGER: K. GORIN SLONSKI


PRODUCTION DESIGNER: A. HAHN CHECKED BY:

ENLARGED BAR PLANS

SCALE: AS SHOWN

SHEET NUMBER: I402

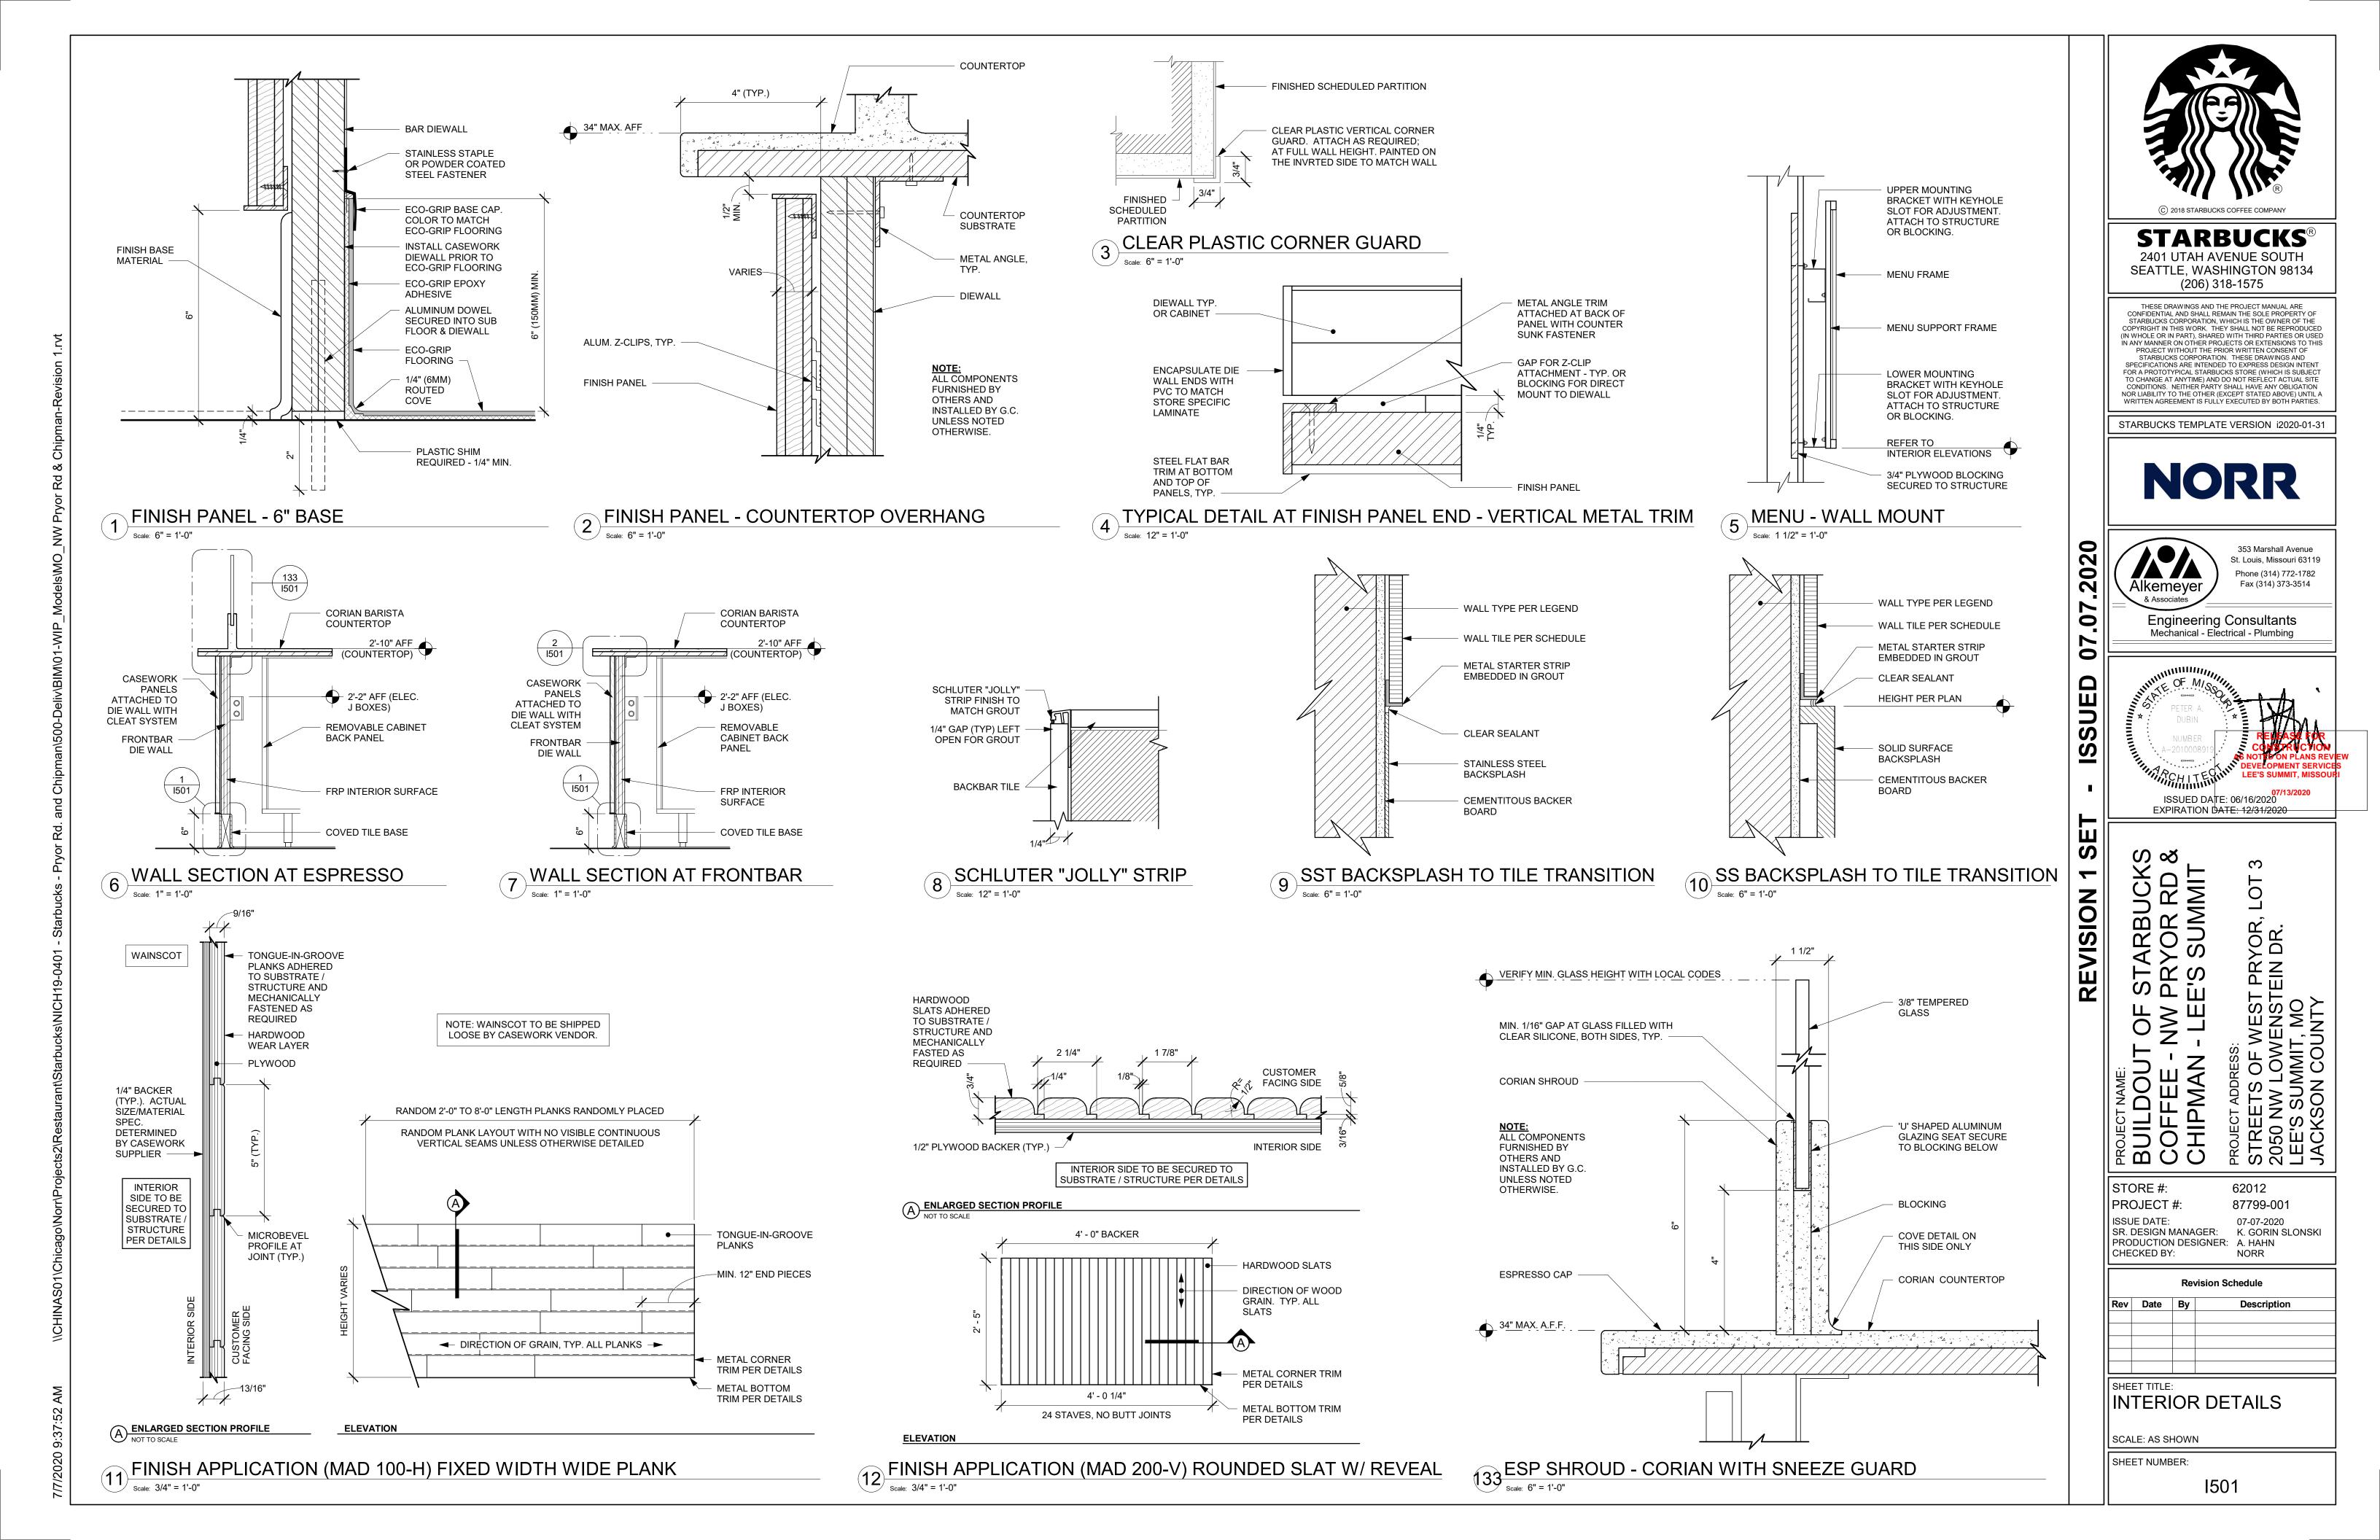

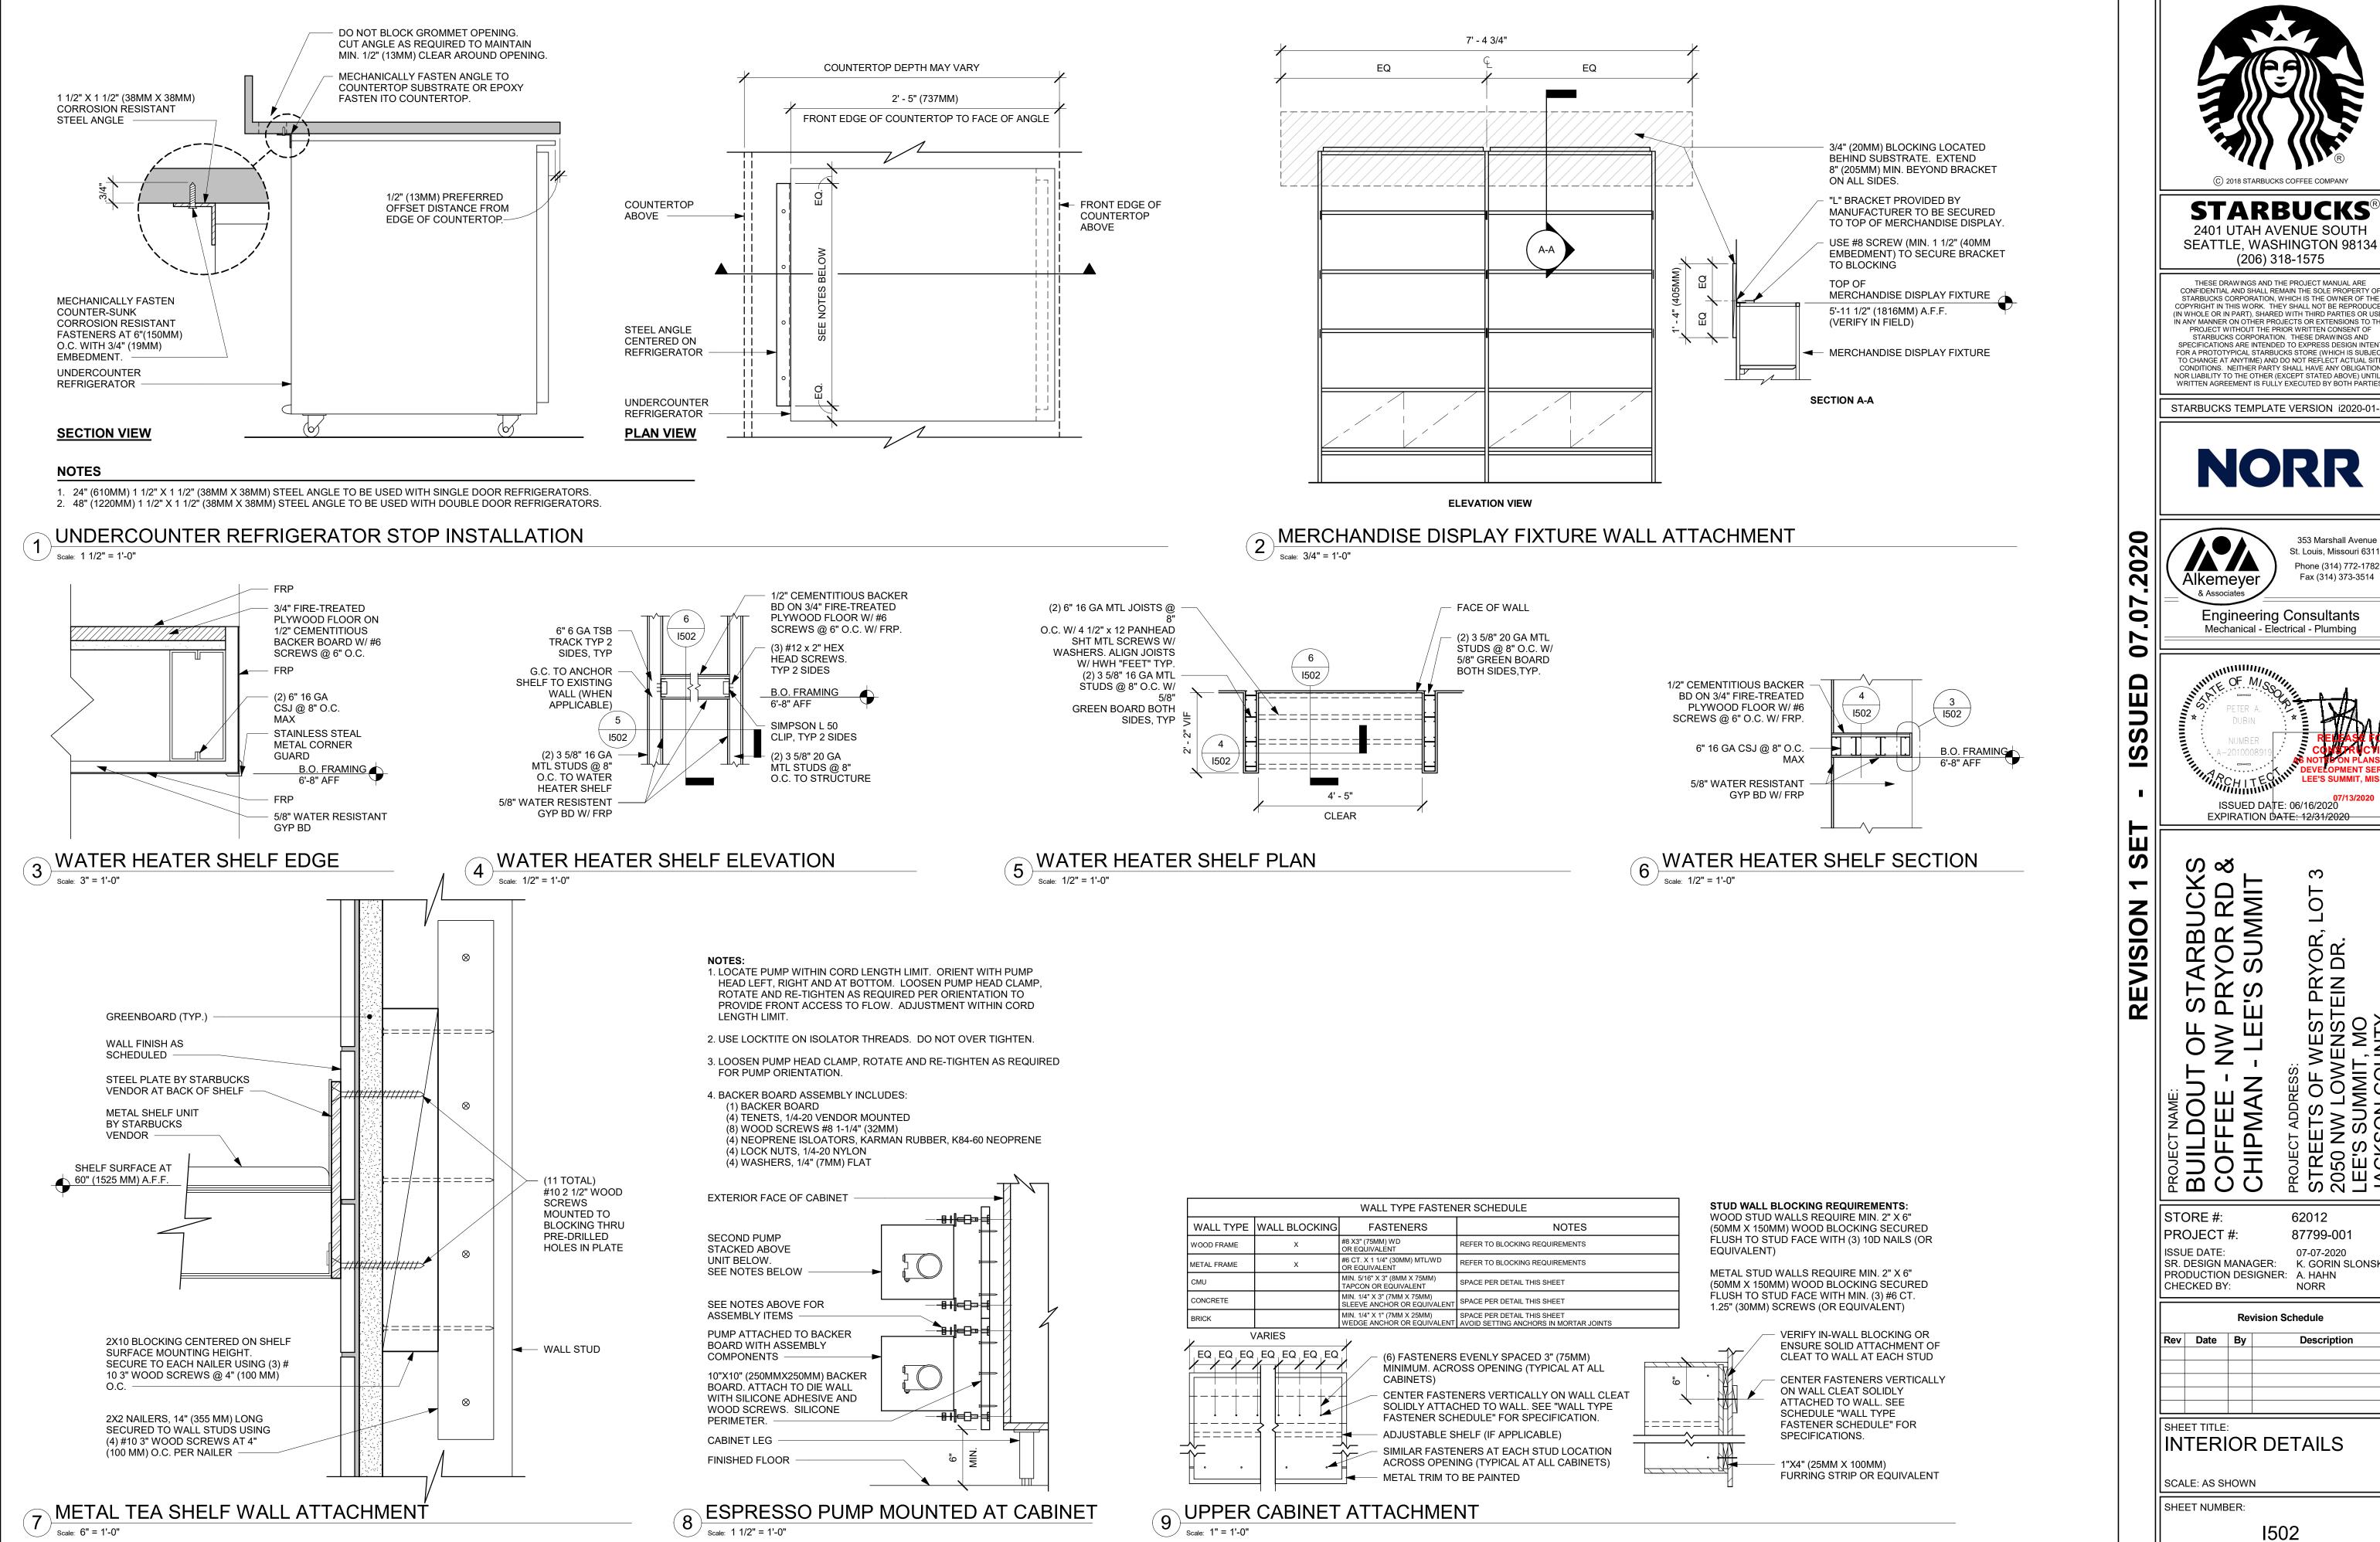

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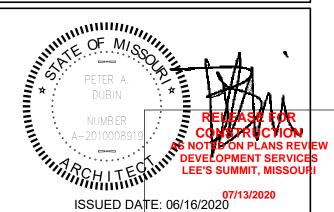
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YOR. DR.


62012 87799-001

07-07-2020 SR. DESIGN MANAGER: K. GORIN SLONSKI PRODUCTION DESIGNER: A. HAHN NORR

**Revision Schedule** 

Description

1502

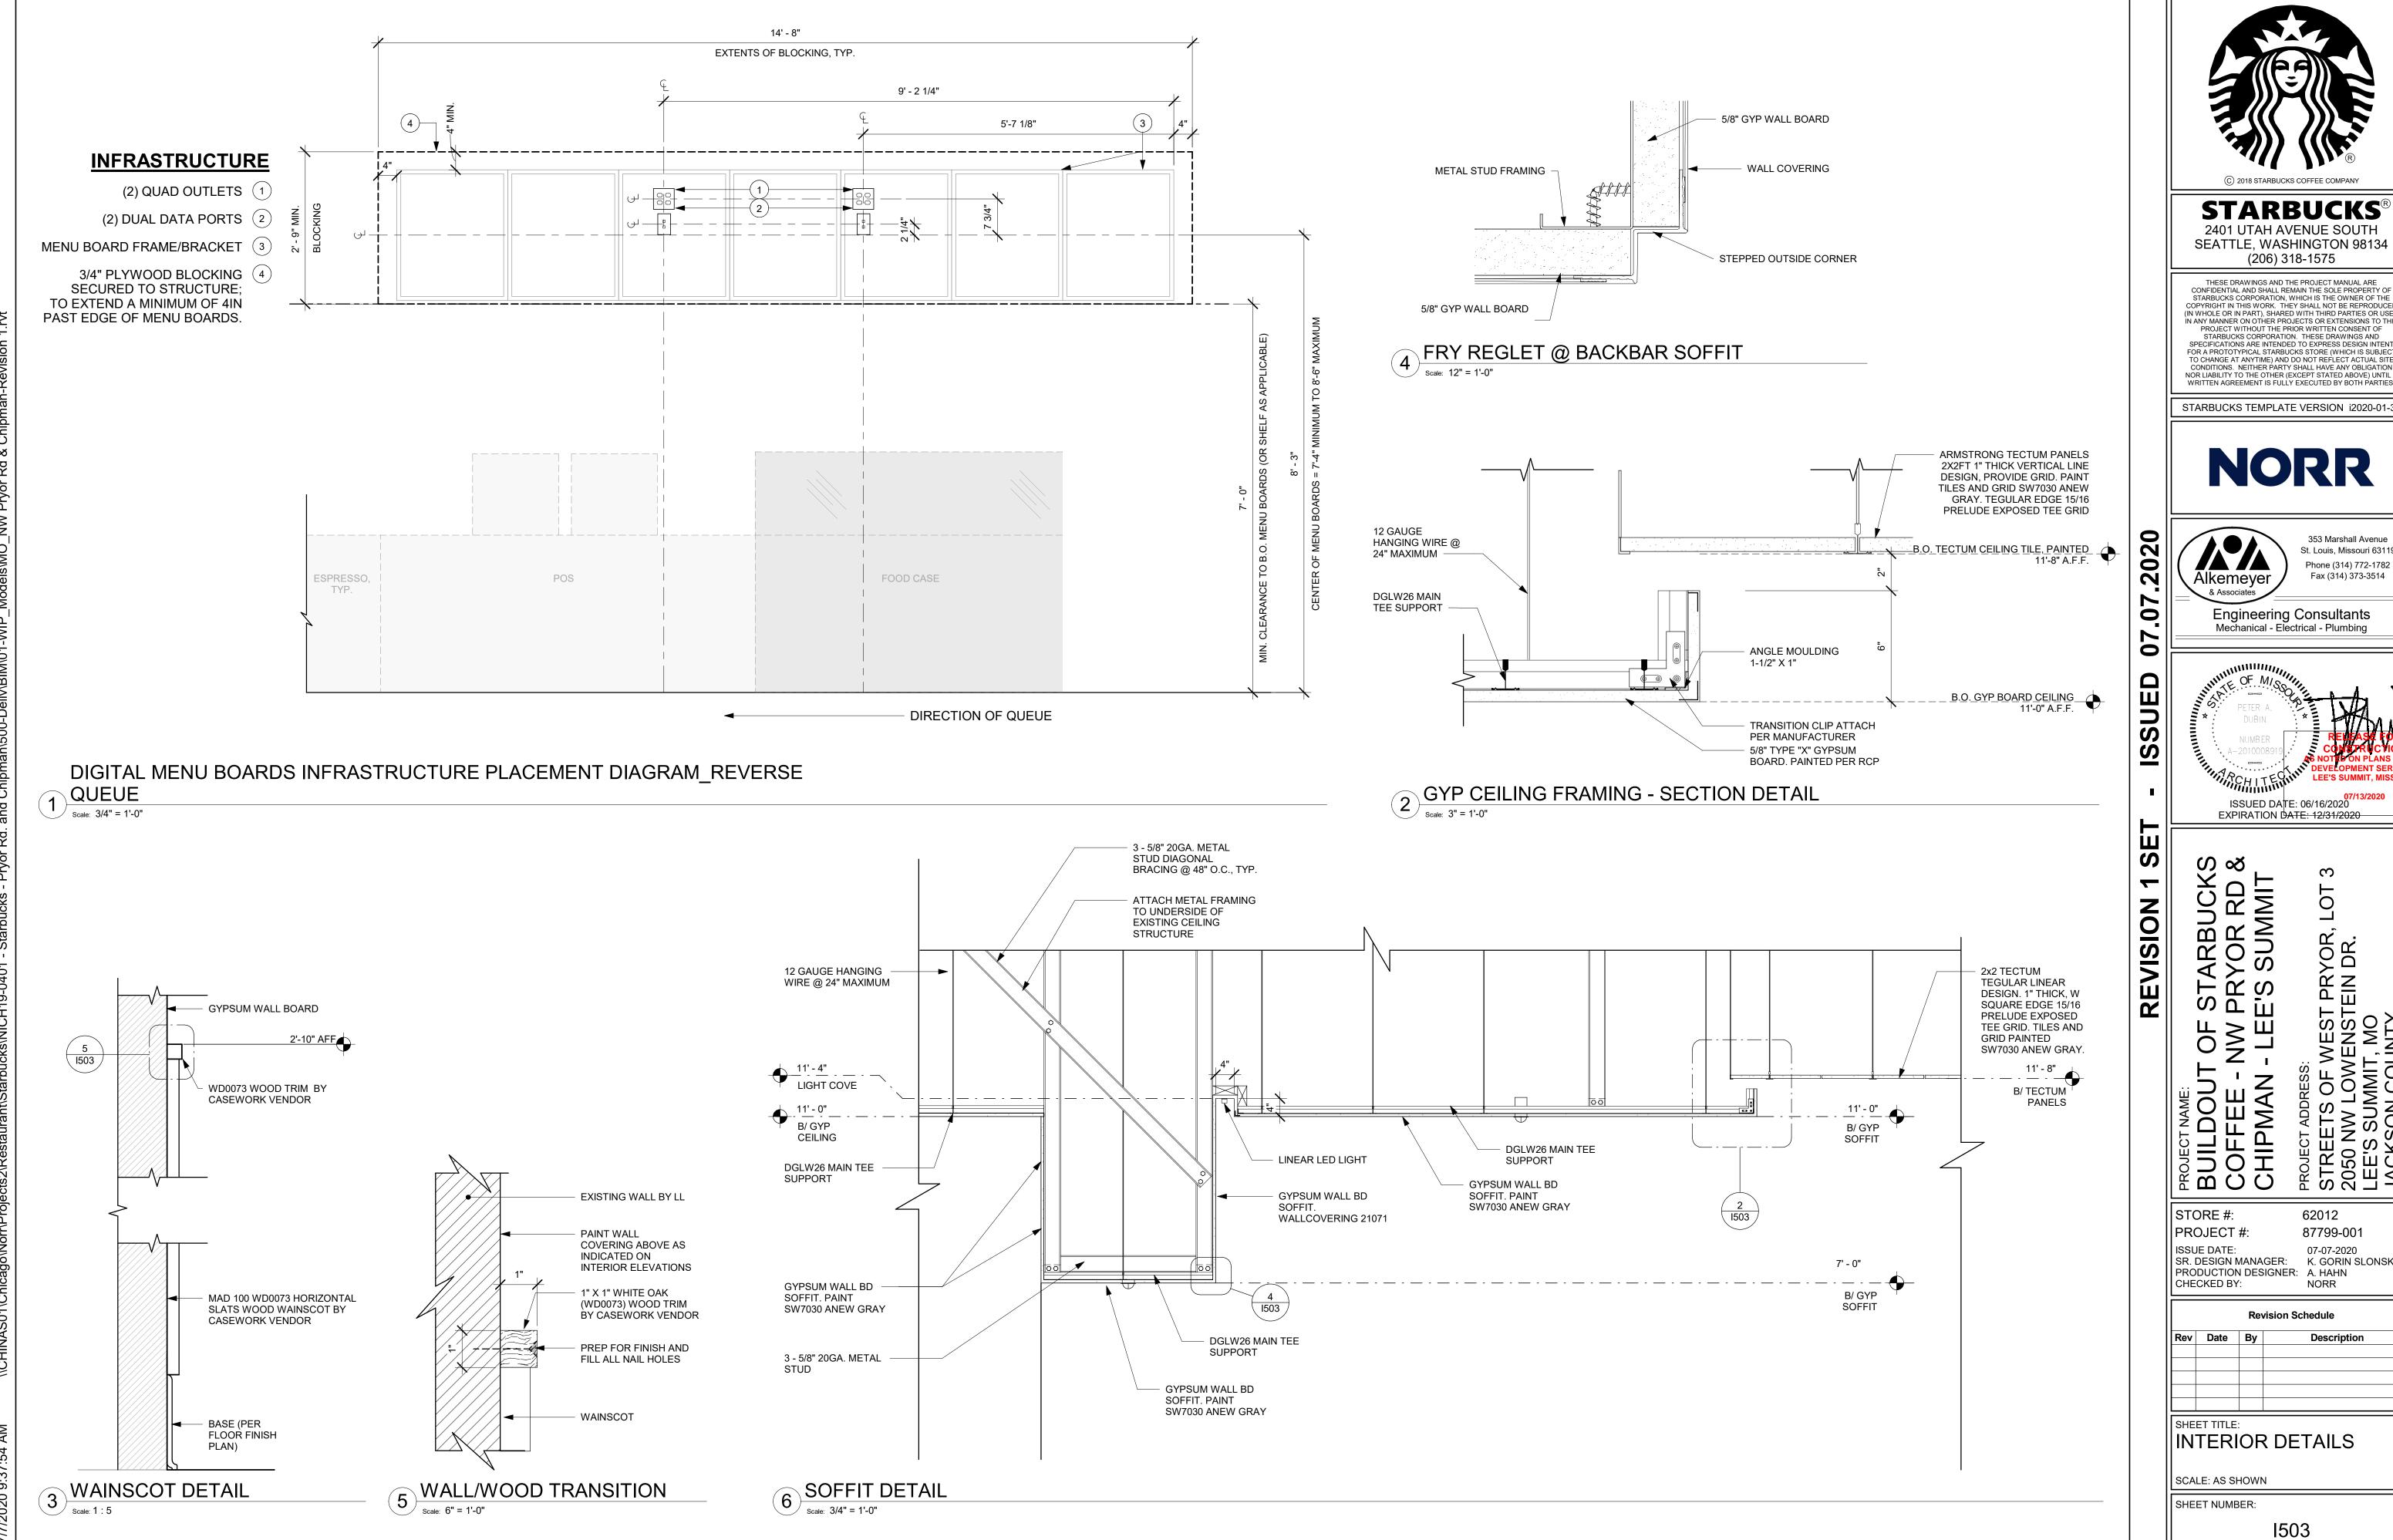

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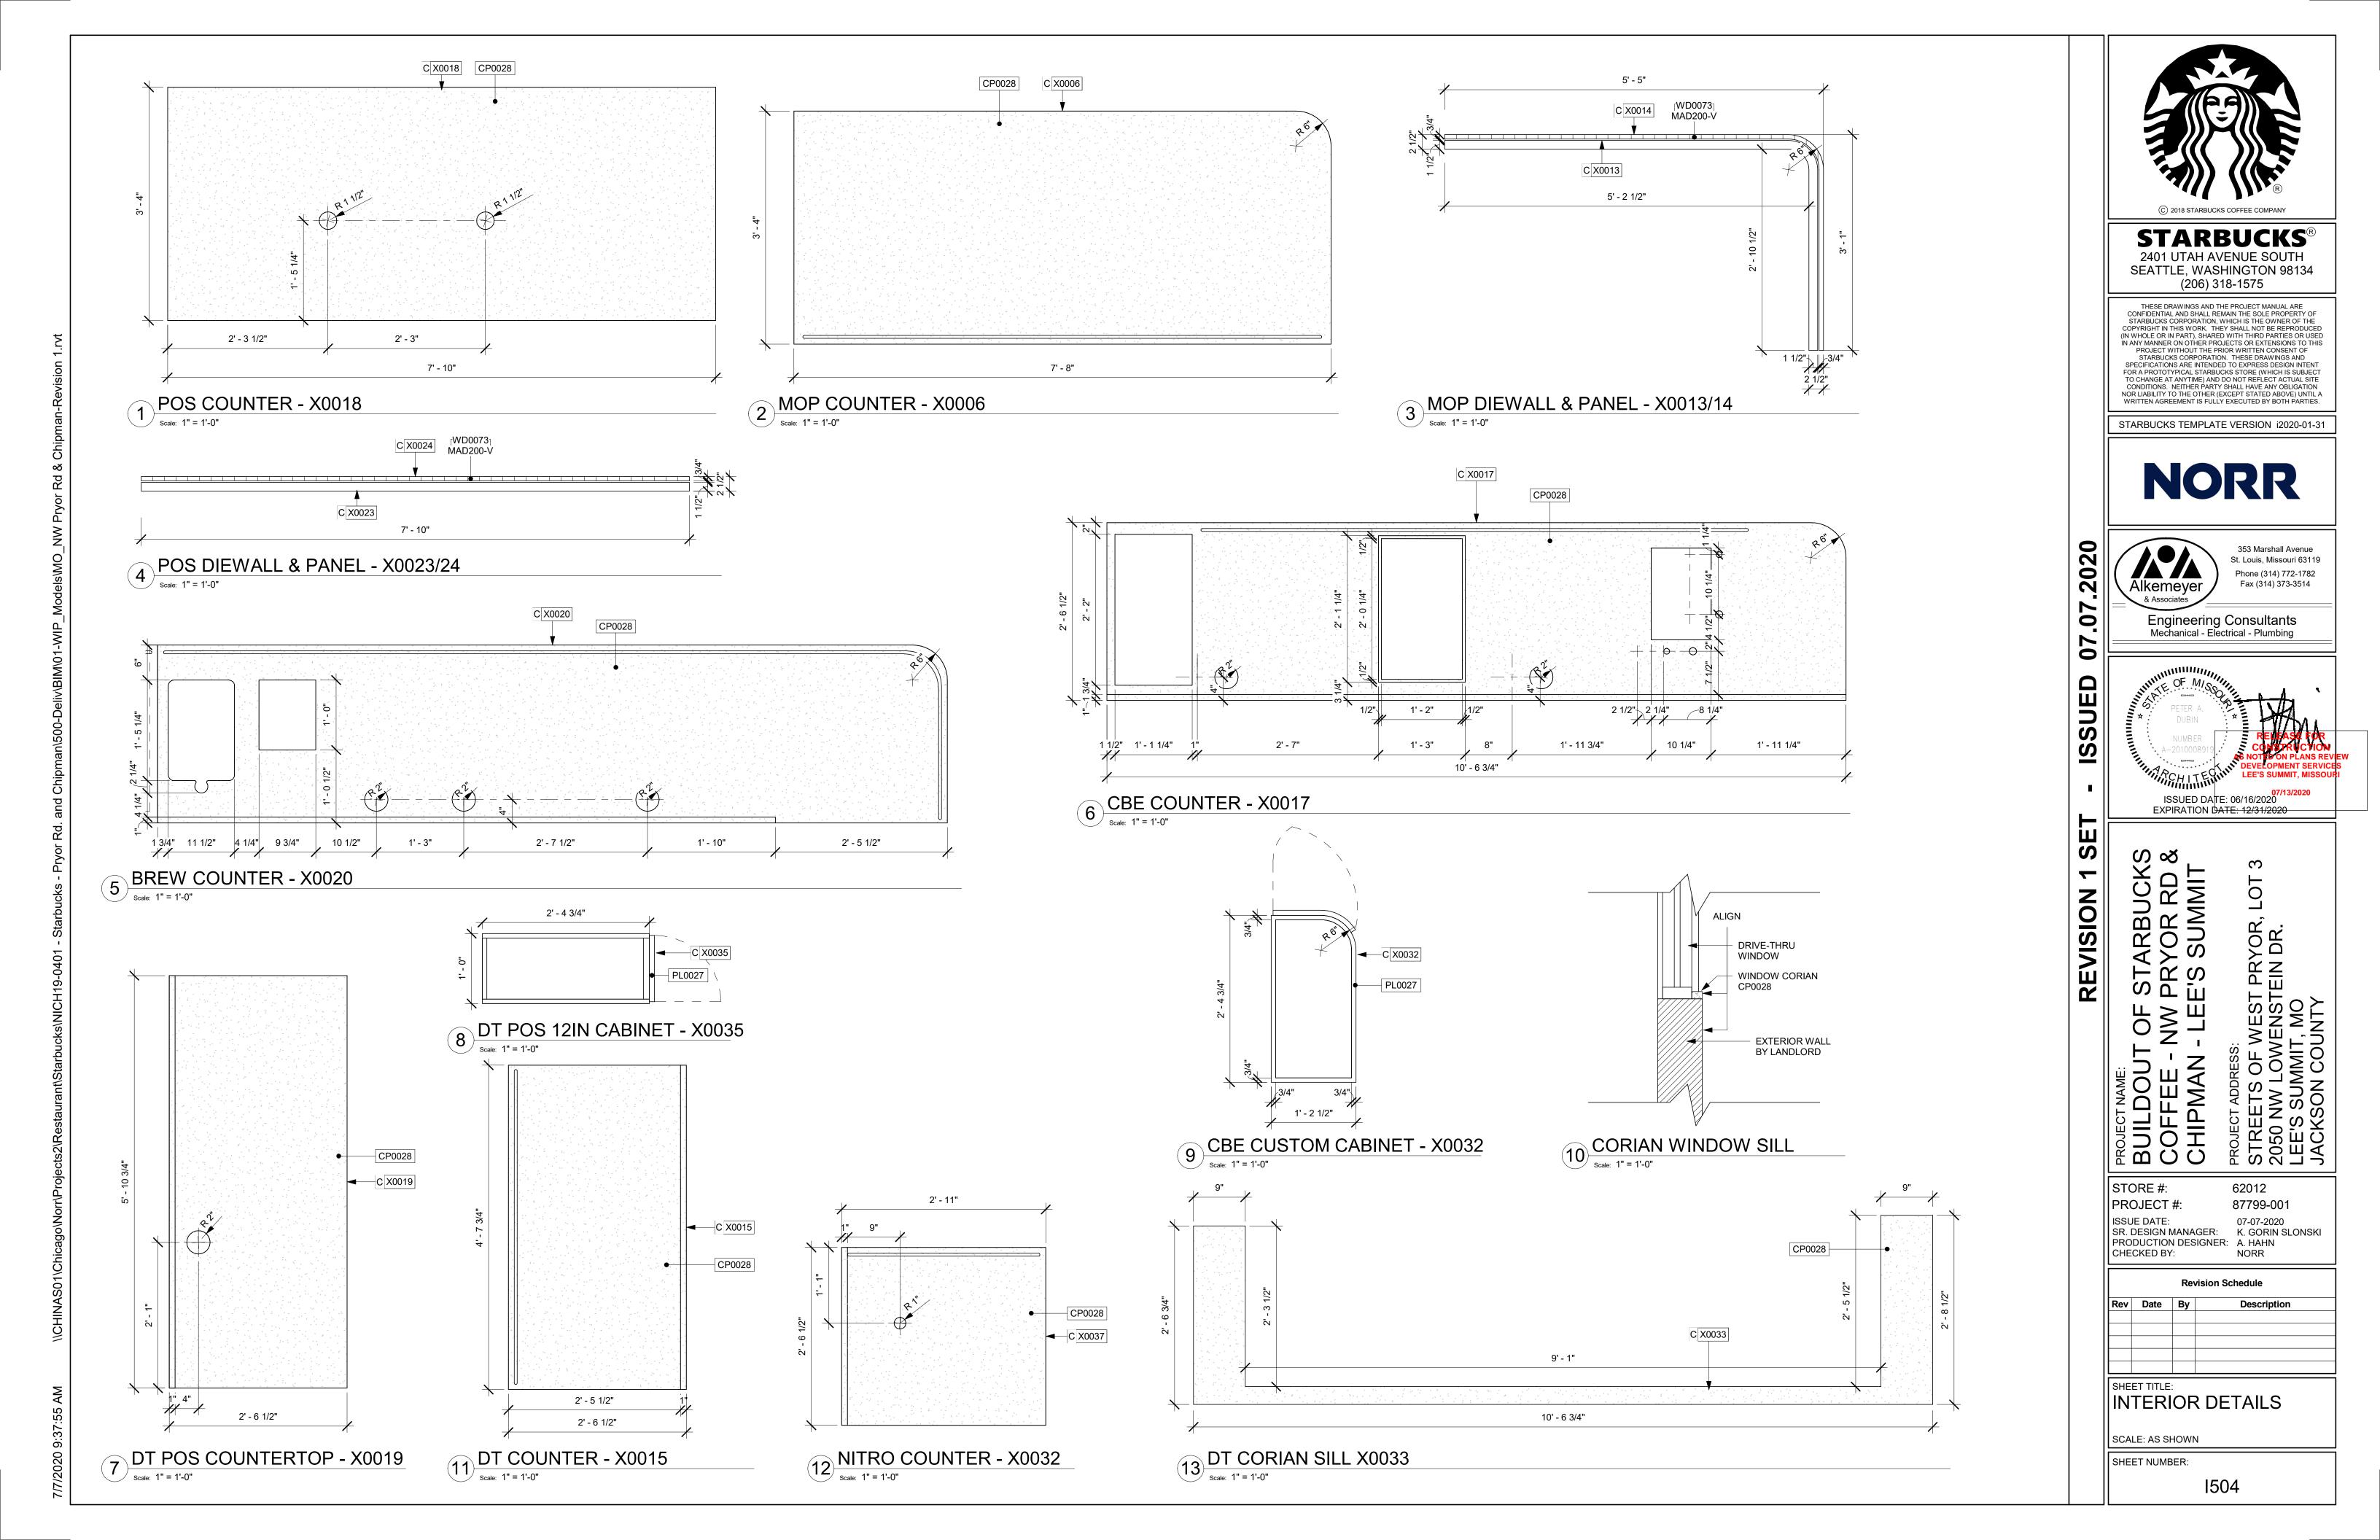



ISSUED DATE: 06/16/2020 EXPIRATION DATE: 12/31/2020


PRYOR, EIN DR.

62012 87799-001 07-07-2020 SR. DESIGN MANAGER: K. GORIN SLONSKI

**Revision Schedule** 



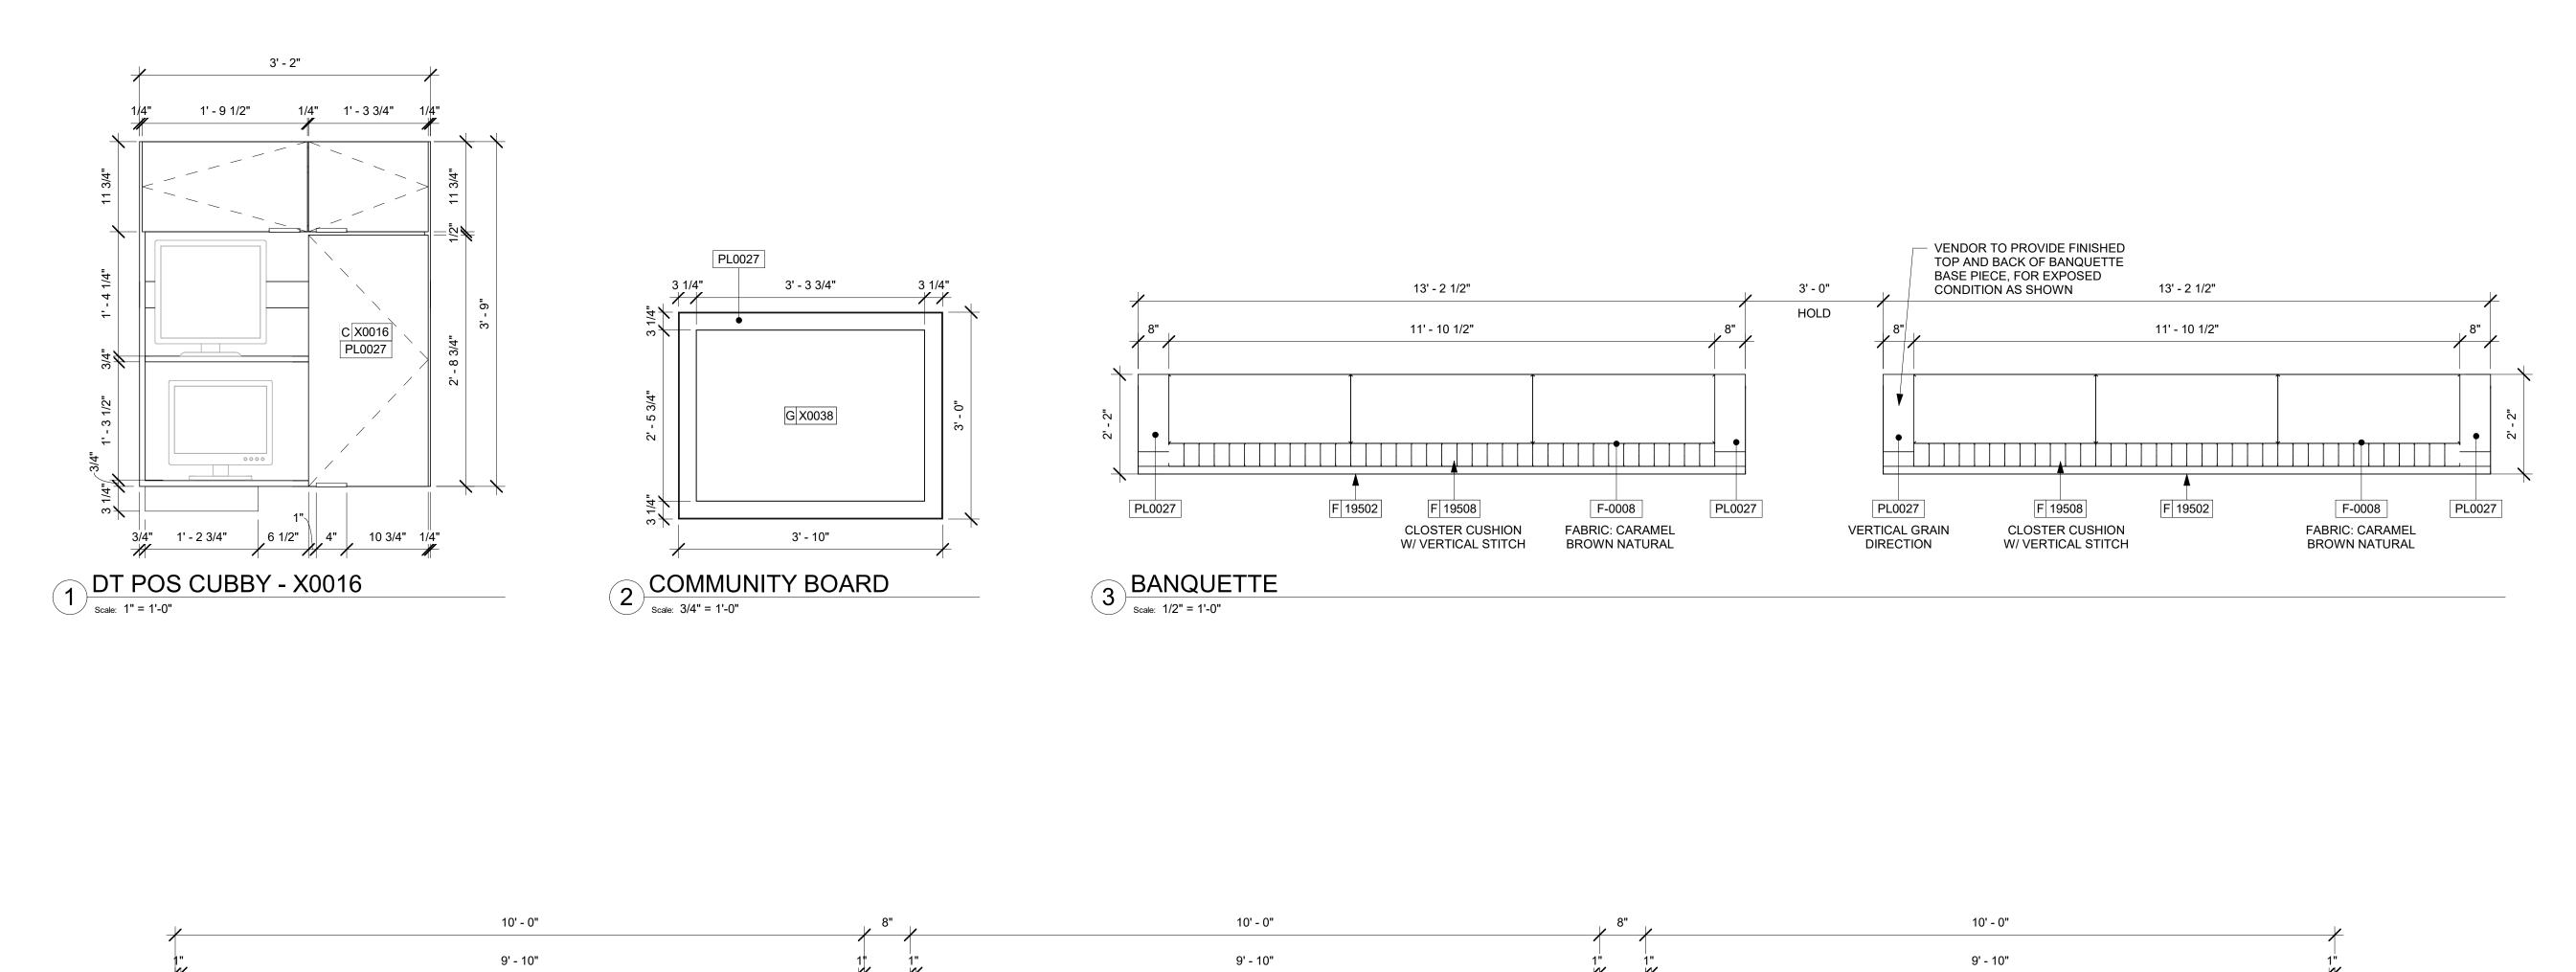

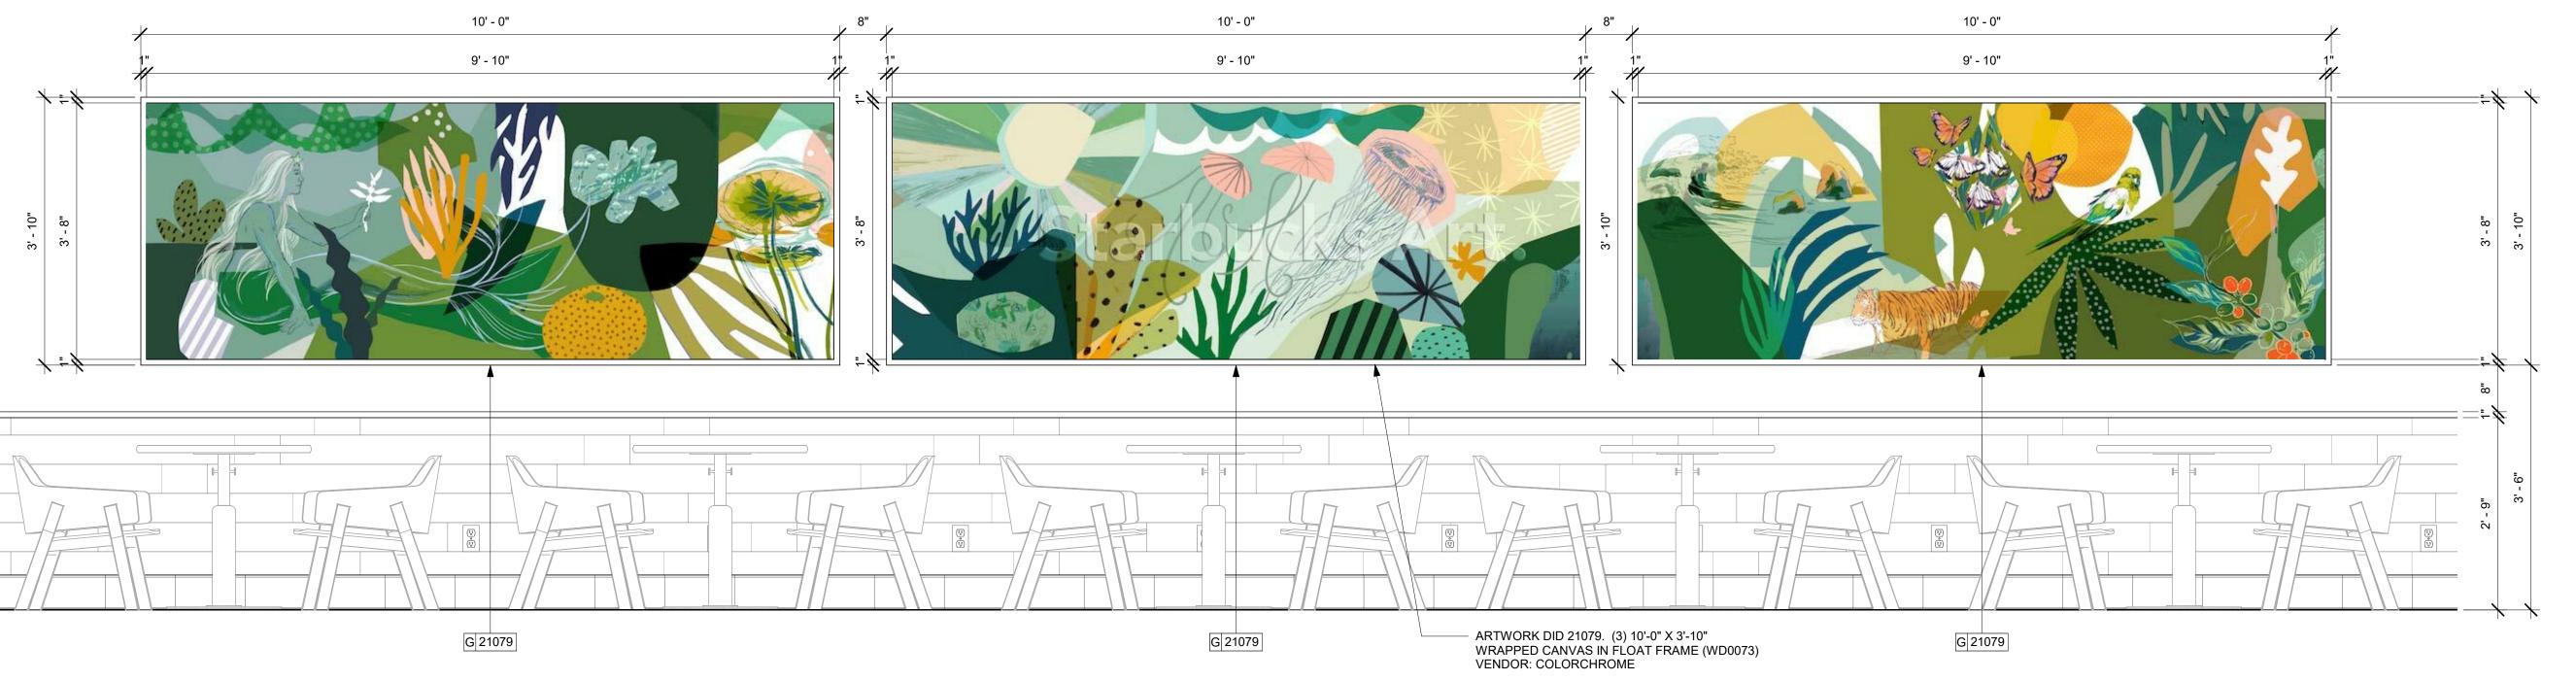

4 ARTWORK DETAIL

scale: 3/4" = 1'-0"

REVISION 1 SET - ISSUED

2020

07.07

BUILDOUT OF STARBUCKS
COFFEE - NW PRYOR RD &
CHIPMAN - LEE'S SUMMIT

CHIPMAN - LI
PROJECT ADDRESS:
STREETS OF WE
2050 NW LOWEN

62012

87799-001

PRYOR, I

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ISSUE DATE: 07-07-2020
SR. DESIGN MANAGER: K. GORIN SLONSKI
PRODUCTION DESIGNER: A. HAHN
CHECKED BY: NORR

Revision Schedule						
Rev	Date	Ву	Description			

SHEET TITLE:
INTERIOR DETAILS

SCALE: AS SHOWN

STORE #:

PROJECT #:

SHEET NUMBER:

1505

		FURNITURE SCH	HEDULE - "F	-"	
DESIGN ID	COUNT	DESCRIPTION	FURN. BY	INST. BY	COMMENTS
BANQUETTE					
19502	2	BANQUETTE - CLOSTER BASE - WHITE OAK WD0073	SB	GC	PROVIDE 8" SEAT SIDES FINISHED AND BACK FINISHED PER DETAIL. (2) TOTAL LENGTH: 13'-2 1/2", REFER TO DETAIL
19508	2	BANQUETTE - CLOSTER CUSHION VERTICAL STITCH - CARAMEL BROWN NATURAL F0008	SB	GC	(2) LENGTH: 13' - 2 1/2" VIF, REFER TO DETAIL
CHAIR		Taura	10-		
17852	20	CHAIR - CAFE ANGLED BACK WITH WOVEN SEAT - BLACK AND BROWN ROPE MT0028 F0194	SB	GC	
18803	10	CHAIR - LOUNGE CLUTCH - WHITE OAK AND CHARCOAL GREY NATURAL WD0073 F0188	SB	GC	
20087	6	CHAIR - LOUNGE PYRAMID - BLACK AND BROWN ROPE MT0028 F0194	SB	GC	
20088	2	CHAIR - LOUNGE CLAUDIA - COAL WOOL F0221	SB	GC	
21206	14	CHAIR - CAFE NOMI UPHOLSTERED - CHARCOAL GREY NATURAL F0188	SB	GC	
DESK					
10123	1	DESK - MANAGERS WORKSTATION - 60X30X30IN 1525X760X760MM	SB	GC	
10605	1	DESK - MANAGERS WORKSTATION KEYBOARD TRAY	SB	GC	
16505	1	DESK - MANAGERS WORKSTATION SHELVES - 36IN 915MM	SB	GC	
MIRROR			•		
10093	2	MIRROR - RESTROOM - 18X30IN 455X760MM	SB	GC	
OTHER					
10756	2	COAT HOOK 1 PRONG SQUARE - 2IN 50MM - SST	SB	GC	
10820	1	COAT HOOK STRIP - 46IN 1170MM	SB	GC	
OTTOMAN			•		
21282	2	OTTOMAN - STOUT - WHITE OAK AND CARAMEL BROWN NATURAL WD0073 F0008	SB	GC	
PLANTER		T	1		
21047	1	PLANTER - DUO LARGE - FLAT BLACK MT0028		GC	
21053	1	PLANTER - DUO STAND - FLAT BLACK MT0028		GC	
X0029	1	PLANTS - INDOOR	GC	GC	GC TO ORDER & INSTALL PLANT. ARECA PALM DYPSIS LUTESCENS (LOW MAINTENANCE).
TABLE		1	1		
17340	8	TABLE - CAFE METAL PEDESTAL BASE SQUARE - 24IN 610MM - BLACK MT0028	SB	GC	
17341	2	TABLE - ACCESSIBLE METAL WITH TAPERED LEGS - 36X24IN 915X610MM - BLACK MT0028	SB	GC	
17645	8	TABLE - TOP SQUARE - 24IN 610MM - WHITE OAK WD0073	SB	GC	
18062	5	TABLE - TOP ROUND - 30IN 760MM - WHITE OAK WD0073	SB	GC	
18467	2	TABLE - TOP ACCESSIBLE OBLONG - 24X48IN 610X1220MM - WHITE OAK WD0073	SB	GC	
18468	4	TABLE - BASE CAFE T LEG - HOT ROLLED STEEL MT0011	SB	GC	
18729	13	TABLE - BASE CAFE HEIGHT APOLLO - HOT ROLLED STEEL MT0011	SB	GC	
19306	1	TABLE - TOP ROUND - 18IN 455MM - WHITE OAK WD0073	SB	GC	
19718	1	TABLE - BASE OCCASIONAL SIDE ESSENTIAL - FLAT BLACK MT0028	SB	GC	
20125	3	TABLE - OCCASIONAL COFFEE CAMERON - OYSTER WHITE MT0045	SB	GC	
20545	1	TABLE - OCCASIONAL COCKTAIL STUDY - FLAT BLACK MT0028	SB	GC	
WINDOW TR	REATMENT				
12716	4	ROLLER SHADE - CHARCOAL TRANSLUCENT F0049 - 5PC OPEN	SB	GC	VERIFY DIMENSIONS IN FIELD

		MECHANICAL EQUIPME	NT SCHED	ULE - "M"	
DESIGN ID	COUNT	DESCRIPTION	FURN. BY	INST. BY	COMMENTS
FAN					
10894	1	FAN - DT AIR CURTAIN WITH HEATER - 48IN 1220MM	LL	LL	INCLUDED AS PART OF DT WINDOW PACKAGE. READY ACCESS AA300-275 PASS THRU AIR CURTAIN SYSTEM. CONTACT: ANNA ELLIS, ANNA@READY-ACCESS.COM
X0003	1	FAN - WALL MOUNTED FAN - PATIO	GC	GC	GLOBAL INDUSTRIAL 30IN OSCILLATING WALL MOUNTED FAN. ITEM #T9F292451. GC TO PROVIDE MOUNTING PARTS AS NEEDED. LL TO PROVIDE ELECTRICAL POWER.
HVAC					
10317	19	HVAC - VAV SUPPLY 4 WAY SQUARE - 24IN 610MM	GC	GC	SEE MECHANICAL SCHEDULES. PAINT TO MATCH ASSOCIATED CEILING COLOR.
11163	6	HVAC - RETURN LAY IN SQUARE - 24IN 610MM	GC	GC	SEE MECHANICAL SCHEDULES. PAINT TO MATCH ASSOCIATED CEILING COLOR.
11165	3	HVAC - RETURN CHANNEL FRAME SQUARE - 10IN 255MM	GC	GC	SEE MECHANICAL SCHEDULES. PAINT TO MATCH ASSOCIATED CEILING COLOR.
OTHER			•	•	
17797	1	ENERGY MANAGEMENT SYSTEM - HVAC ONLY	SB	GC	
X0028	3	ACCESS PANELS	GC	GC	BAUCO PLUSS III SINGLE LEAF CEILING ACCESS PANEL. TOUCH LATCH. CONCEALED HARDWARE. CONTACT: 250.592.0033 / INFO@ACCESSPANELSOLUTIONS.COM FINSH TO MATCH HOST CEILING

		SPECIALTY EQUIPMEN	II SCHED	JLL - L	
DESIGN ID	COUNT	DESCRIPTION	FURN. B	Y INST. BY	COMMENTS
COOLING			1	1	
10267	5	FRIDGE UNDERCOUNTER 1 DOOR - 27IN	SB	GC	
		685MM			
10970	1	FRIDGE REACH IN 1 DOOR LH - 29IN 735MM	SB	GC	
11083	2	FRIDGE REACH IN 2 DOOR - 51X35IN	SB	GC	
		1295X890MM			
12618	2	FRIDGE UNDERCOUNTER 1 DOOR WITH	SB	GC	
12010	_	SHELF - 27IN 685MM	OB		
13676	1	FREEZER REACH IN 1 DOOR RH - 27IN 685MM	SB	GC	
13682	<u>'</u> 1		SB	GC	
		FREEZER REACH IN 2 DOOR - 54IN 1370MM			
20011	1	FRIDGE NITRO 2 TAP JT NITCOM RH	SB	GC	KIT INCLUDES UNDERCOUNTER FRIDGE
					FONT, TRAY, AND TUBING
EQUIPMENT					
10312	4	BREWER SOFT HEAT WARMING STAND	SB	GC	
		SINGLE			
10746	1	BREWER DUAL SOFT HEAT	SB	GC	GC TO COORDINATE WITH SBUX VENDO
10808	1	GRINDER DITTING KR1203	SB	GC	GC TO COORDINATE WITH SBUX VENDO
10856	6	BREWER SERVER SOFT HEAT	SB	GC	
12407	2	OVEN TURBOCHEF NEXT GENERATION	SB	GC	
12508	2	BLENDER QUIET MODEL ON COUNTER	SB	GC	
					TO BE STORED IN BACK OF HOUSE LINE
12508	1	BLENDER QUIET MODEL ON COUNTER - BACK-UP	SB	GC	TO BE STORED IN BACK OF HOUSE UNLINEEDED
					NEEDED
15186	1	DISHWASHER HOT LOW STEAM	SB	GC	
16623	1	SCALE DIGITAL WITH ADJUSTABLE DISPLAY	SB	GC	
		MOUNT SMALL			
17564	1	BLENDER PITCHER RINSER WITH SENSOR	SB	GC	
19559	1	NITROGEN GENERATOR ELEMENT	SB	GC	GC TO COORDINATE INSTALLATION &
					CONNECTIONS WITH SBUX VENDOR
19742	2	ESPRESSO MACHINE MASTRENA II	SB	GC	GC TO COORDINATE WITH SBUX VENDO
FOOD CASE			1	100	155.5 555.15WILL WITH OBOX VENDO
	1	FOOD CASE - ZEPHYR - 66IN 1675MM	SB	GC	
16238	Т	FUUD GASE - ZEPTYK - 00IN 10/5MM	SD	JGC	
ICE			1	1-	
10344	1	ICE - BIN DROP IN 90LB 40KG	SB	GC	
18029	1	ICE - BIN B110	SB	GC	
18846	1	ICE - MACHINE CIM1446HR SERIES REMOTE	SB	GC	
		COOLED			
19278	2	ICE - BIN DROP IN 45LB 20KG HORIZONTAL	SB	GC	
OTHER					
	1	CUR DISPENSED TALL HOT VERTICAL	SB	GC	1
10091		CUP DISPENSER TALL HOT VERTICAL			
10099	2	RESTROOM TOILET PAPER HOLDER	SB	GC	
10172	2	RESTROOM SEAT COVER DISPENSER	SB	GC	
10384	2	DIAPER CHANGING STATION HORIZONTAL	SB	GC	
10396	1	CUP DISPENSER SHORT HOT VERTICAL	SB	GC	
10467	1	FILE CABINET 2 DRAWER	SB	GC	
10501	<u>·</u> 1	FIRE EXTINGUISHER	GC	GC	LOCALLY SOURCED
	·				LOCALLY SOUNCED
10769	2	RESTROOM GRAB BAR VERTICAL - 18IN 455MM	SB	GC	
10701			0.0		
10791	2	CUP DISPENSER GRANDE VENTI COLD	SB	GC	
		VERTICAL			
10855	2	CUP DISPENSER GRANDE VENTI HOT	SB	GC	
		VERTICAL			
10858	1	CUP DISPENSER TALL COLD VERTICAL	SB	GC	
10859	2	RESTROOM GRAB BAR - 48IN 1220MM	SB	GC	
10862	2	RESTROOM GRAB BAR - 36IN 915MM	SB	GC	
10947	1	SOAP DISPENSER WALL MOUNTED	SB	GC	
10947	<u>'</u> 1	PAPER TOWEL DISPENSER FULL SIZE -	SB	GC	
10811	ı	TRANSLUCENT GRAY	OD	190	
10003	2		SB	GC	
10992	2	PAPER TOWEL DISPENSER HALF SIZE - TRANSLUCENT GRAY	SD	GC	
4444			CD		
11115	2	SOAP DISPENSER SINK MOUNTED	SB	GC	
13330	1	MOBILE CUP DISPENSER CADDY	SB	GC	
13584	1	CUP DISPENSER TRENTA COLD VERTICAL	SB	GC	
19495	1	NITRO 2 TAP HANDLE AND BADGE KIT	SB	GC	
20079	1	NITRO 2 TAP BADGE MOUNT BACKBAR LH	SB	GC	
20080	<u>·</u> 1	NITRO 2 TAP BADGE MOUNT BACKBAR RH	SB	GC	
	•				VI EDATOD CVNC HAND DVED ALITOMA
X0009	2	HAND DRYER - INTEGRATED	GC	GC	XLERATOR SYNC HAND DYER. AUTOMA SENSOR OPERATED. SURFACE MOUNTI
					CONTACT: D 13 GROUP. 245 WEST CEN
					STREET, NATICK, MA 01760. PH:
					617-307-1140. WWW.D13GROUP.COM EN
					KRIZZO@D13GROUP.COM
X0011	2	SOAP DISPENSER - STERN	GC	GC	STERN. GREEN/CHROME SOAP DISPENS
					PART #07100008. PART OF D 13
					INTEGRATED SINK SYSTEM. CONTACT:
					GROUP. 245 WEST CENTRAL STREET,
					NATICK, MA 01760. PH: 617-307-1140.
					WWW.D13GROUP.COM
STORAGE					
10222	2	WIRE SHELF GRID AT SINK	SB	GC	
10416	9	WORKROOM SHELVING - 36IN 915MM	SB	GC	
10462	9	WORKROOM SHELVING POSTS	SB	GC	
10698	1	MOP RACK WITH 3 HOLDERS	SB	GC	
13834	1	BASE - 24X18IN 610X455MM	SB	GC	
15699	1	PARTNER WORK CENTER	SB	GC	
17255	1	PASTRY TRAY CART - 60IN 1525MM	SB	GC	
17264	1	ROLLING PASTRY TRAY THAW RACK -	SB	GC	
., 204	'	20X26IN 510X660MM			
17639	1	WORKROOM CART - 24IN 610MM	SB	GC	
					<u> </u>
19476	2	5 COMP LOCKER - 12IN 305MM	SB	GC	

DESIGN ID	COUNT	DESCRIPTION	FURN. BY	INST. BY	COMMENTS
GRAPHICS -	ARTWORK	, L			
21079	3	ART - ASHLEY MARY AND ALLEGRA LOCKSTADT - SIREN SCENE - GREENS	SB	GC	(3) PIECES, 10'-0" X 3'-10". WRAPPED CANVAS IN FLOAT FRAME. FINISH WD0073. VENDOR COLORCHROME
GRAPHICS -	INTERIOR	MENU			
18984	7	MENU BOARD - UNIVERSAL WALL MOUNT BRACKET	SB	GC	
19551	6	MENU BOARD - FRONT INSERT PANEL WITH SQUARE FRAME - WHITE OAK WD0073	SB	GC	
19552	1	MENU BOARD - DAILY OFFERING CHALKBOARD WITH SQUARE FRAME - WHITE OAK WD0073	SB	GC	
GRAPHICS -	OTHER		•	•	
11135	2	RESTROOM SIGN UNISEX ACCESSIBLE	SB	GC	
X0038	1	COMMUNITY BOARD MAGNETIC WHITE OAK	SB	GC	VENDOR: COLORCHROME
		WE BOTO ABOOK IN WOOD FINIT		• •	
X0039	2	OCCUPANCY PLACARD	GC	GC	PROVIDE PER LOCAL REQUIREMENTS. CAFE OCCUPANCY 73, PATIO OCCUPANCY 26.

		DATA DEVICE SC	HEDULE - "	A"	
DESIGN ID	COUNT	DESCRIPTION	FURN. BY	INST. BY	COMMENTS
AUDIO VISU	AL		!	•	
10005	1	MUSIC SYSTEM	SB	SB	GC TO INSTALL AND TEST SYSTEM
10010	1	DT ORDER MONITOR	SB	SB	
10012	1	DT COMMUNICATION SYSTEM	SB	SB	
10015	3	SPEAKER RECESSED - WHITE	SB	GC	
10017	2	SPEAKER SURFACE MOUNTED - BLACK	SB	GC	
12336	1	DT TIMER SYSTEM	SB	SB	
14676	1	DT POS MONITOR ARM DOUBLE SURFACE MOUNTED	SB	GC	
19339	1	AMPLIFIER - 40W	SB	SB	GC TO INSTALL AND TEST SYSTEM
DATA					
10002	1	COMPUTER MANAGER WORKSTATION	SB	SB	
10007	1	PRINTER MANAGER WORKSTATION	SB	SB	
18744	1	EQUIPMENT RACK WITH LOCK - 24IN 610MM	SB	SB	
20294	2	IOT MODULE	SB	SB	
POINT OF S	ALE				
10008	2	POS - REGISTER WITH COMPACT CASH DRAWER	SB	SB	GC TO COORDINATE WITH SBUX VENDO
10014	4	POS PRINTER	SB	SB	GC TO COORDINATE WITH SBUX VENDO
10022	1	MONEY COUNTER	SB	SB	GC TO COORDINATE WITH SBUX VENDO
10029	6	POS BANK	SB	GC	
10075	3	CUP LABELER	SB	SB	GC TO COORDINATE WITH SBUX VENDO
14677	1	POS - DT TENDERING REGISTER	SB	SB	PART OF RETAIL IT EQUIPMENT PACKA
14678	1	POS - DT EXPEDITOR	SB	SB	PART OF RETAIL IT EQUIPMENT PACKA
SECURITY	<u> </u>				
10024	1	SAFE LH - 20X18X26IN 510X455X660MM	SB	GC	GC TO COORDINATE WITH SBUX VENDO STORE MANAGER TO PROGRAM WITH VENDOR PROVIDED MANUAL.
10028	1	SAFE BASE	SB	GC	GC TO COORDINATE WITH SBUX VENDO STORE MANAGER TO PROGRAM WITH VENDOR PROVIDED MANUAL.
		PLUMBING FIXTURE	SCHEDULE	- "P"	
DESIGN ID	COUNT	DESCRIPTION	FURN. BY	INST. BY	COMMENTS
DRAIN					
10294	7	DRAIN - FLOOR SINK SQUARE - 12IN 305MM	SB	GC	ZURN MODEL #FD2375-NH3.
10594	4	DRAIN - FLOOR SINK SQUARE - 5IN 125MM	GC	GC	JAY R. SMITH MODEL #2005Y (B) OR EQ
10726	7	DRAIN - GRATE HALF SQUARE - 12IN 305MM	SB	GC	ZURN MODEL #FD2375-NH2.
FAUCET					
10152	1	FAUCET - DOUBLE LABORATORY WITH BENT RISER SPOUT	SB	GC	
10153	2	FAUCET - WATER TOWER - 12IN 305MM	SB	GC	
10215	3	FAUCET - DOUBLE LABORATORY WITH SWING SPOUT	SB	GC	
10447	1	FAUCET - PRE RINSE SPRAYER WALL MOUNTED	SB	GC	
10597	2	FAUCET - SINGLE HANDLE	SB	GC	
10804	1	FAUCET - PRE RINSE SWING SPOUT	SB	GC	
10874	2	FAUCET - HOT WATER DISPENSER GOOSENECK	SB	GC	
	1	FAUCET - MOP SINK WALL MOUNTED	SB	GC	
10922		FAUCET - METERED	SB	GC	
10922 11003	3	FAUCET - WIETERED			
	3 1	FAUCET - METERED FAUCET - HAND SINK WALL MOUNTED	SB	GC	
11003				GC GC	

	1	SAFE BASE	28	GC	STORE MANAGER TO PROGRAM WITH VENDOR PROVIDED MANUAL.
		PLUMBING FIXTURE	SCHEDULE	E - "P"	
DESIGN ID	COUNT	DESCRIPTION	FURN. BY	INST. BY	COMMENTS
DRAIN		,			
10294	7	DRAIN - FLOOR SINK SQUARE - 12IN 305MM	SB	GC	ZURN MODEL #FD2375-NH3.
10594	4	DRAIN - FLOOR SINK SQUARE - 5IN 125MM	GC	GC	JAY R. SMITH MODEL #2005Y (B) OR EQ
10726	7	DRAIN - GRATE HALF SQUARE - 12IN 305MM	SB	GC	ZURN MODEL #FD2375-NH2.
FAUCET					
10152	1	FAUCET - DOUBLE LABORATORY WITH BENT	SB	GC	
10102	•	RISER SPOUT			
10153	2	FAUCET - WATER TOWER - 12IN 305MM	SB	GC	
10135	3	FAUCET - DOUBLE LABORATORY WITH SWING		GC	
10215	3	SPOUT	SD	GC	
10447	1	FAUCET - PRE RINSE SPRAYER WALL	SB	GC	
10447	ı	MOUNTED	SD	GC	
10597	2	FAUCET - SINGLE HANDLE	SB	GC	
				GC	
10804	1	FAUCET - PRE RINSE SWING SPOUT	SB		
10874	2	FAUCET - HOT WATER DISPENSER	SB	GC	
		GOOSENECK			
10922	1	FAUCET - MOP SINK WALL MOUNTED	SB	GC	
11003	3	FAUCET - METERED	SB	GC	
13588	1	FAUCET - HAND SINK WALL MOUNTED	SB	GC	
15749	2	FAUCET - HOT AND COLD WATER SYSTEM	SB	GC	
X0010	2	FAUCET - STERN	GC	GC	STERN. CONDOR 1010. PART #07100005
		TAGGET - GTERRY	GO		CHROME. PART OF D 13 INTEGRATED S SYSTEM. CONTACT: D 13 GROUP. 245 W CENTRAL STREET, NATICK, MA 01760. F 617-307-1140. WWW.D13GROUP.COM
FILTER					
12501	1	FILTER - RO SYSTEM 600GPD	SB	SB	CONFIGURATION [III]. GC TO COORDINA
					WITH SBUX VENDOR.
12507	1	FILTER - RO SYSTEM 40GAL STORAGE TANK	SB	SB	CONFIGURATION [III]. GC TO COORDINA
					WITH SBUX VENDOR.
12896	1	FILTER - BRINE TANK	SB	SB	CONFIGURATION [III]. GC TO COORDINA
					WITH SBUX VENDOR.
12899	2	FILTER - POLY GLASS VESSEL	SB	SB	CONFIGURATION [III]. GC TO COORDINA
					WITH SBUX VENDOR.
13076	1	FILTER - PREFILTRATION SYSTEM	SB	SB	CONFIGURATION [III]. GC TO COORDINA
					WITH SBUX VENDOR.
13082	1	FILTER - WATER SOFTENER TWIN	SB	SB	CONFIGURATION [III]. GC TO COORDINA
					WITH SBUX VENDOR.
13149	1	FILTER - PRESSURE GAUGE	SB	SB	CONFIGURATION [III]. GC TO COORDINA
					WITH SBUX VENDOR.
OTHER			1	1	
13384	1	WATER HEATER TANK GAS	GC	GC	AO SMITH CYCLONE XI MODEL #BTX-10 129 GPH RECOVERY @90 DEGREE RISE SET WATER HEATER TO 140 DEG MAX. ENERGY FACTOR = 0.96
SINK					
10549	1	SINK - RINSE DROP IN SST - 12X20IN	SB	GC	
		305X510MM			
10995	1	SINK - MOP - 24X24IN 610X610MM	SB	GC	
12807	1	SINK - UTENSIL RINSE WITH GRATE SST - LH -	SB	GC	
		14X20IN 355X510MM	[		
		1 17420114 000740 10141141			
13264	1	SINK - 3 COMP WORK SST - 93IN 2350MM	SB	GC	
13264 14688	1		SB SB	GC GC	
		SINK - 3 COMP WORK SST - 93IN 2350MM			
		SINK - 3 COMP WORK SST - 93IN 2350MM SINK - HAND WITH SIDE SPLASH WALL			
14688	1	SINK - 3 COMP WORK SST - 93IN 2350MM SINK - HAND WITH SIDE SPLASH WALL MOUNTED SST	SB	GC	
14688	1	SINK - 3 COMP WORK SST - 93IN 2350MM SINK - HAND WITH SIDE SPLASH WALL MOUNTED SST SINK - RINSE WITH DRAINBOARD - 15X27IN	SB	GC	
14688 17565 17632	1 1 1	SINK - 3 COMP WORK SST - 93IN 2350MM SINK - HAND WITH SIDE SPLASH WALL MOUNTED SST SINK - RINSE WITH DRAINBOARD - 15X27IN 380X685MM SINK - STACKED DRAINBOARD - 15IN 380MM	SB SB SB	GC GC GC	
14688 17565	1	SINK - 3 COMP WORK SST - 93IN 2350MM SINK - HAND WITH SIDE SPLASH WALL MOUNTED SST SINK - RINSE WITH DRAINBOARD - 15X27IN 380X685MM	SB SB	GC GC	
14688 17565 17632 18743	1 1 1 1	SINK - 3 COMP WORK SST - 93IN 2350MM SINK - HAND WITH SIDE SPLASH WALL MOUNTED SST SINK - RINSE WITH DRAINBOARD - 15X27IN 380X685MM SINK - STACKED DRAINBOARD - 15IN 380MM SINK - WATER FILLING STATION - 36X24IN 915X610MM	SB SB SB SB	GC GC GC	
14688 17565 17632	1 1 1	SINK - 3 COMP WORK SST - 93IN 2350MM SINK - HAND WITH SIDE SPLASH WALL MOUNTED SST SINK - RINSE WITH DRAINBOARD - 15X27IN 380X685MM SINK - STACKED DRAINBOARD - 15IN 380MM SINK - WATER FILLING STATION - 36X24IN	SB SB SB	GC GC GC	
14688 17565 17632 18743 19277	1 1 1 1 2	SINK - 3 COMP WORK SST - 93IN 2350MM SINK - HAND WITH SIDE SPLASH WALL MOUNTED SST SINK - RINSE WITH DRAINBOARD - 15X27IN 380X685MM SINK - STACKED DRAINBOARD - 15IN 380MM SINK - WATER FILLING STATION - 36X24IN 915X610MM SINK - COUNTERTOP RINSER WITH DRAIN TROUGH - 26X9IN 660X235MM	SB SB SB SB SB	GC GC GC GC	DI13 INTEGRATED SINK SYSTEM 30IN
14688 17565 17632 18743	1 1 1 1	SINK - 3 COMP WORK SST - 93IN 2350MM SINK - HAND WITH SIDE SPLASH WALL MOUNTED SST SINK - RINSE WITH DRAINBOARD - 15X27IN 380X685MM SINK - STACKED DRAINBOARD - 15IN 380MM SINK - WATER FILLING STATION - 36X24IN 915X610MM SINK - COUNTERTOP RINSER WITH DRAIN	SB SB SB SB	GC GC GC	D 13 INTEGRATED SINK SYSTEM. 30IN XLERATORSYNC SYSTEM WITH A SINGI BASIN SINK WITH A PIVOT DRAIN COVE GLACIER WHITE CORIAN COUNTER TOR AND ENCLOSURE PANELS. BASIN COLO D 13 WHITE. ORDER WITH LOCKING SLI DOOR & SECURITY PANEL. CONTACT: E GROUP. 245 WEST CENTRAL STREET, NATICK, MA 01760. PH: 617-307-1140. WWW.D13GROUP.COM
14688 17565 17632 18743 19277 X0012	1 1 1 1 2	SINK - 3 COMP WORK SST - 93IN 2350MM SINK - HAND WITH SIDE SPLASH WALL MOUNTED SST SINK - RINSE WITH DRAINBOARD - 15X27IN 380X685MM SINK - STACKED DRAINBOARD - 15IN 380MM SINK - WATER FILLING STATION - 36X24IN 915X610MM SINK - COUNTERTOP RINSER WITH DRAIN TROUGH - 26X9IN 660X235MM	SB SB SB SB SB	GC GC GC GC	XLERATORSYNC SYSTEM WITH A SING BASIN SINK WITH A PIVOT DRAIN COVE GLACIER WHITE CORIAN COUNTER TO! AND ENCLOSURE PANELS. BASIN COLO D 13 WHITE. ORDER WITH LOCKING SLI DOOR & SECURITY PANEL. CONTACT: I GROUP. 245 WEST CENTRAL STREET, NATICK, MA 01760. PH: 617-307-1140.
14688  17565  17632 18743  19277  X0012	1 1 1 1 2 2	SINK - 3 COMP WORK SST - 93IN 2350MM SINK - HAND WITH SIDE SPLASH WALL MOUNTED SST  SINK - RINSE WITH DRAINBOARD - 15X27IN 380X685MM SINK - STACKED DRAINBOARD - 15IN 380MM SINK - WATER FILLING STATION - 36X24IN 915X610MM SINK - COUNTERTOP RINSER WITH DRAIN TROUGH - 26X9IN 660X235MM SINK - D13	SB SB SB SB GC	GC GC GC GC GC	XLERATORSYNC SYSTEM WITH A SING BASIN SINK WITH A PIVOT DRAIN COVE GLACIER WHITE CORIAN COUNTER TOI AND ENCLOSURE PANELS. BASIN COLO D 13 WHITE. ORDER WITH LOCKING SLI DOOR & SECURITY PANEL. CONTACT: I GROUP. 245 WEST CENTRAL STREET, NATICK, MA 01760. PH: 617-307-1140. WWW.D13GROUP.COM
14688 17565 17632 18743 19277 X0012	1 1 1 1 2	SINK - 3 COMP WORK SST - 93IN 2350MM SINK - HAND WITH SIDE SPLASH WALL MOUNTED SST SINK - RINSE WITH DRAINBOARD - 15X27IN 380X685MM SINK - STACKED DRAINBOARD - 15IN 380MM SINK - WATER FILLING STATION - 36X24IN 915X610MM SINK - COUNTERTOP RINSER WITH DRAIN TROUGH - 26X9IN 660X235MM	SB SB SB SB GC	GC GC GC GC	XLERATORSYNC SYSTEM WITH A SING BASIN SINK WITH A PIVOT DRAIN COVE GLACIER WHITE CORIAN COUNTER TOI AND ENCLOSURE PANELS. BASIN COLO D 13 WHITE. ORDER WITH LOCKING SLI DOOR & SECURITY PANEL. CONTACT: [GROUP. 245 WEST CENTRAL STREET, NATICK, MA 01760. PH: 617-307-1140.

# RESPONSIBILITY LEGEND

GC GENERAL CONTRACTOR LL LANDLORD SB STARBUCKS

SHEET NUMBER:



**STARBUCKS**®

2401 UTAH AVENUE SOUTH SEATTLE, WASHINGTON 98134 (206) 318-1575

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STARBUCKS TEMPLATE VERSION i2020-01-31





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REVISION

353 Marshall Avenue St. Louis, Missouri 63119 Phone (314) 772-1782 Fax (314) 373-3514

Engineering Consultants
Mechanical - Electrical - Plumbing



ISSUED DATE: 06/16/2020 EXPIRATION DATE: 12/31/2020

T OF STARBUCKS - NW PRYOR RD & | - LEE'S SUMMIT LOT WEST PRYOR, I WENSTEIN DR. IT, MO JUNTY

BUILDOUT COFFEE - NCHIPMAN -STORE #: 62012 87799-001

PROJECT #: ISSUE DATE: 07-07-2020
SR. DESIGN MANAGER: K. GORIN SLONSKI
PRODUCTION DESIGNER: A. HAHN
CHECKED BY: NORR

**Revision Schedule** 

Rev	Date	Ву	Description
1	7/7/2020	AH	PERMIT COMMENTS

SHEET TITLE:
SCHEDULES

SCALE: AS SHOWN

1601

	EXTERIOR SIGNAGE SCHEDULE - "S"								
DESIGN ID	COUNT	DESCRIPTION	FURN. BY	INST. BY	COMMENTS				
SIGNAGE -	DISK		1	•					
13164	1	SIGN - DISK SF ILLUMINATED FLUSH MOUNTED EVOLVED - 60IN 1525MM	SB	LL/ HILTON	LL TO PROVIDE BLOCKING AND CONDUIT AS REQUIRED				
SIGNAGE -	DRIVE THR	Ú	•						
14091	1	SIGN - DT DIRECTIONAL EXIT SIGN ILLUMINATED ARROW SERIES - 46IN 1170MM	SB	GC/LL	LL TO FURNISH AND INSTALL CONCRETE FOOTINGS, ANCHOR BOLTS, AND ELECTRICAL CONDUIT PER LLWL. GC TO COORDINATE WITH SBUX VENDOR				
14106	1	SIGN - DT CLEARANCE BAR ARROW SERIES FREESTANDING	SB	GC/LL	LL TO FURNISH AND INSTALL CONCRETE FOOTINGS AND ANCHOR BOLTS PER LLWL. GC TO COORDINATE WITH SBUX VENDOR				
SIGNAGE -	OTHER		'	1					
19388	2	SIGN - 10 MINUTE PARKING	SB	LL/ HILTON	FOOTING & POST BY LL. SIGN BY SBUX SIGNAGE VENDOR				
X0002	1	MONUMENT SIGN PANELS	SB/ HILTON	HILTON/ LL	BASE SIGN FOOTING AND ELECTRICAL BY LL. PANELS BY SIGNAGE VENDOR. LL TO COORDINATE WITH SIGNAGE VENDOR				
SIGNAGE -	WORDMARI	K							
X0007	1	SIGN - FAUX NEON GREEN WORDMARK STARBUCKS WITH WHITE INTERIOR & SURROUND. FLUSH MOUNTED - 18IN 455MM	SB	LL/ HILTON	FAUX NEON GREEN WORDMARK. LL TO PROVIDE CONDUIT AND BLOCKING AS REQUIRED.				

	FLOOR TREATMENT SCHEDULE - "T"									
DESIGN ID	AREA	DESCRIPTION	FURN. BY	INST. BY	COMMENTS					
PLASTIC	•			•						
19795	819 SF	POLYVINYL FLOOR TILE - ECO-GRIP - PEWTER	GC	GC	MANUFACTURER: ALLIED ECO-GRIP. PEWTER					
TILE	•			•						
20266	1149 SF	TILE - FRENCH CLAY - BRONZAGE - 24X24IN 600X600MM	SB	GC	GROUT: MAPEI - 09 GRAY, OR EQUAL					
WALK OFF	MAT			•						
19288	26 SF	WALK OFF MAT - HELIX Z1 - BLACK - 12X9IN 305X230MM	SB	GC	ANODIZED METAL FRAME TO BE INCLUDED IN ORDER, FROM MANUFACTURER					

	WALL BASE SCHEDULE - "B"								
DESIGN ID	LENGTH	DESCRIPTION	FURN. BY	INST. BY	COMMENTS				
TILE BASE				•					
18740	150' - 0 1/2"	TILE BASE - PLAZA NOVA - BLACK SHADOW - 6X12IN 150X300MM	SB	GC	GROUT: MAPEI - 47 CHARCOAL, OR EQUAL				
19795	188' - 2 1/4"	POLYVINYL FLOOR TILE - ECOGRIP - PEWTER	GC	GC	MANUFACTURER: ALLIED ECO-GRIP. PEWTER				
20196	59' - 10"	TILE BASE - FORMULA - EQUATION GREY - 6X12IN 150X300MM	SB	GC	GROUT: MAPEI - 09 GRAY				

	WINDOW SCHEDULE - "W"									
DESIGN ID	COUNT	DESCRIPTION	FURN. BY	INST. BY	COMMENTS					
WINDOW										
14077	1	WINDOW - DT WITH OPEN TRANSOM - 48X60IN 1205X1510MM - ALUMINUM	LL		275 SERIES SINGLE PANEL SLIDER W/ MOER. LL TO VERIFY OPENING DIRECTION. USE IN CONJUNCTION WITH AA300-275 PASS THRU AIR CURTAIN SYSTEM. CONTACT: ANNA ELLIS, ANNA@READY-ACCESS.COM					

CASEWORK FINISH SCHEDULE								
ENGINE ZONE	MATERIAL DESCRIPTION	FINISH CODE	COMMENTS					
COMPOSITE - LINEN								
COUNTERTOPS - BACKBAR	COMPOSITE - LINEN	CP0028						
COUNTERTOPS - ESPRESSO	COMPOSITE - LINEN	CP0028						
COUNTERTOPS - FRONTBAR	COMPOSITE - LINEN	CP0028						
COUNTERTOPS - SHROUD	COMPOSITE - LINEN	CP0028						
METAL - FLAT BLACK POWDER	COAT							
CABINETS - DOOR PULL	METAL - FLAT BLACK POWDERCOAT	MT0028						
CABINETS - UNDERCOUNTER ICE BIN	METAL - FLAT BLACK POWDERCOAT	MT0028						
METAL - STAINLESS STEEL - BI	RUSHED	'	•					
CABINETS - CABINET LEG	METAL - STAINLESS STEEL - BRUSHED	#4 BRUSHED 16GA						
CABINETS - UNDERCOUNTER ICE BIN	METAL - STAINLESS STEEL - BRUSHED	#4 BRUSHED 16GA						
COUNTERTOPS - HAND SINK	METAL - STAINLESS STEEL - BRUSHED	#4 BRUSHED 16GA						
PLAM - GOLDEN BLONDE GRAI	N							
CABINETS - DT POS CUBBY	PLAM - GOLDEN BLONDE GRAIN	PL0027						
CABINETS - UNDERCOUNTER	PLAM - GOLDEN BLONDE GRAIN	PL0027						
WOOD - WHITE OAK - ROUNDE	D SLAT - VERTICAL							
FINISH PANELS - FRONTBAR	WOOD - WHITE OAK - ROUNDED SLAT - VERTICAL	WD0073 MAD200-V						
WOOD - WHITE OAK - FIXED W	IDTH WIDE PLANK - HORIZONTAL		•					
WAINSCOT	WOOD - WHITE OAK - FIXED WIDTH WIDE PLANK - HORIZONTAL	WD0073 MAD100-H	PLANKS TO BE SHIPPED LOOSE, GC TO INSTALL IN FIELD.					

	PAINT SCHEDULE - "PT"										
DESIGN ID	DESCRIPTION	LRV	FURN. BY	INST. BY	COMMENTS						
SW7030	SW7030 ANEW GRAY, OR EQUIVALENT	47	GC		SW USE PRIMER CP-1; NCS - S 2002-Y50R; AKZO NOBEL - 40YY 51/084						
SW7748	SW7748 GREEN EARTH, OR EQUIVALENT	31	GC	GC							

	WALL TREATMENT (AREA) SCHEDULE - "Q"								
DESIGN ID	AREA	DESCRIPTION	FURN. BY	INST. BY	COMMENTS				
PLASTIC	•		•						
11469	1026 SF	FRP - WHITE	GC	GC	MANUFACTURER: PARKLAND PLASTICS. CONTACT BRENDON EASH. PHONE (547) 312-1290. EMAIL: BRENDON.EACH@PARKLANDPLASTICS.CO M PRODUCT PLAST-TEX NRP-HC. COLOR: WHITE.				
TILE	•								
20225	624 SF	TILE - I COCCI - CALCE - 6X24IN 150X600MM	SB	GC	GROUT: MAPEI - 09 GREY. UNSANDED GROUT LINES TO BE 1/8".				
20249	393 SF	TILE - COLOR STUDIO - SAGE - SQUARE MOSAIC - 12X12IN 300X300MM SHEET	SB	GC	GROUT: MAPEI - 09 GREY, OR EQUAL				
WALL COVE	ERING								
21071	173 SF	VINYL WALL COVERING - ORIGAMI - SAGE	SB	GC					

WALL TREATMENT (LENGTH) SCHEDULE- "R"							
DESIGN ID	LENGTH	DESCRIPTION	FURN. BY	INST. BY	COMMENTS		
CHAIR RAIL	_			•			
X0026	69' - 9 3/4"	WOOD TRIM - 1X1IN - WHITE OAK WD0073	SB	GC	MOUNTED AT 2'-9" AFF		
OTHER							
X0034	24' - 2"	SCHLUTER JOLLY AE	GC	GC	FINISH TO MATCH TILE COLOR.		
X0036	43' - 9"	STEPPED OUTSIDE CORNER FRY REGLET	GC	GC	FINISH TO MATCH PAINT COLOR.		
WAINSCOT		•		•	•		
X0025	69' - 9 1/4"	WAINSCOT - WD0073 MAD 100-H	SB	GC	MOUNTED TO 2'-9" AFF. CASEWORK VENDOR TO SHIP LOOSE.		

	CEILING TREATMENT SCHEDULE - "U"								
DESIGN ID	AREA	DESCRIPTION	FURN. BY	INST. BY	COMMENTS				
X0022	735 SF	CEILING TILE - 2X2FT - TECTUM PANELS - PAINTED	GC	GC	ARMSTRONG TECTUM PANELS 2X2FT 1" THICK VERTICAL LINE DESIGN, PROVIDE GRID. PAINT TILES AND GRID SW7030 ANEW GRAY. TEGULAR EDGE 15/16 PRELUDE EXPOSED TEE GRID. 6-WEEK LEAD TIME.				
OTHER			•						
11302	412 SF	VCT - WHITE - 2X4FT 61X122CM	GC	GC	ARMSTRONG MODE: CLEAN ROOM VL 2X4 (NONPERFORATED). COLOR: WHITE. EDGE PROFILE: SQUARE LAY-IN, ITEM #870				

DESIGN ID	COUNT	DESCRIPTION	FURN. B	Y INST. BY	COMMENTS	FINISH
CABINET		CARINET DACKDAD COUNTED CUIDDORT DANIEL CIN	CD.	00		
17573	2	CABINET - BACKBAR COUNTER SUPPORT PANEL - 3IN 75MM	SB	GC		
17574	3	CABINET - BACKBAR SINK OR ICE - 15IN 380MM	SB	GC		PL0027
17575	1	CABINET - BACKBAR SINK OR ICE - 20IN 510MM	SB	GC		PL0027
17580	2	CABINET - CBE TEA SHELF - 29IN 735MM - FLAT BLACK MT0028	SB	GC	NOT PROVIDED BY CASEWORK VENDOR	MT0028
17581	1	CABINET - CBE DRY INCLUSION SHELF - 23IN 585MM - FLAT BLACK MT0028	SB	GC	NOT PROVIDED BY CASEWORK VENDOR	MT0028
17740	2	CABINET - BACKBAR - 30IN 760MM	SB	GC	ONOLWONK VENDOR	PL0027
17741	4	CABINET - BACKBAR 15IN 380MM	SB	GC		PL0027
17743	<u>'</u> 1	CABINET - DT POS - 30IN 760MM	SB	GC		PL0027
17744	<u>·</u> 1	CABINET - FRONTBAR POS BRIDGE - 22IN 560MM	SB	GC		PL0027
17745	<u>·</u> 1	CABINET - BACKBAR DRAWER - 15IN 380MM	SB	GC		PL0027
17747	1	CABINET - BACKBAR TRASH - 15IN 380MM	SB	GC		PL0027
18122	2	CABINET - BACKBAR SINK OR ICE - 16IN 405MM	SB	GC		PL0027
19280	1	CABINET - ESPRESSO CUBBY WITH OPEN BACK - 15IN 380MM	SB	GC		PL0027
19281	2	CABINET - ESPRESSO ICE BIN STAINLESS - 20IN 510MM	SB	GC		PL0027
21189	1	CABINET - FRONTBAR - 15IN 380MM	SB	GC		PL0027
21191	1	CABINET - FRONTBAR DRAWER - 15IN 380MM	SB	GC		PL0027
21192	2	CABINET - FRONTBAR POS - 30IN 760MM	SB	GC		PL0027
21193	1	CABINET - ESPRESSO CUBBY WITH OPEN BACK - 18IN 455MM	SB	GC		PL0027
X0016	1	CABINET - DT POS UPPER CUBBY W DOORS	SB		SEE DETAILS	PL0027
X0032	2	CABINET - BACKBAR COUNTER CUSTOM CABINET	SB	GC	SEE DETAILS, CURVED	PL0027
V0005		CADINET 40IN 2058484	CD.	00	DOOR SEE DETAILS	DI 0007
X0035	1	CABINET - 12IN 305MM	SB	GC	SEE DETAILS	PL0027
20131	1	CONDIMENT CART THREE DROP - WHITE OAK AND WHITE WD0073 CP0002	SB	GC	NOT PROVIDED BY CASEWORK VENDOR	WD0073 CP0002
20367	1	WALL BAY 2 UNIT - 72IN 1830MM - WHITE OAK WD0073	SB	GC	NOT PROVIDED BY	WD0073
COUNTERT	OP				CASEWORK VENDOR	
17809	2	COUNTERTOP - HAND SINK WITH LOW SPLASH STAINLESS - 15IN 380MM	SB	GC		SST
17828	1	COUNTERTOP - BACKSPLASH - VARIABLE LENGTH	SB	GC	LENGTH:5'-10 3/4". SEE DETAILS FOR ADDITIONAL INFORMATION	CP0028
19711	1	COUNTERTOP - WARMING - RF - 75IN 1905MM	SB	GC		CP0028
20061	1	COUNTERTOP - ESPRESSO METRO - RF - 139IN 3530MM	SB	GC		CP0028
20063	1	COUNTERTOP - FRONTBAR CAP - 139IN 3530MM	SB	GC		CP0028
X0006	1	COUNTERTOP - FRONTBAR MOP PLANAR - 30IN 760MM	SB	GC	SEE DETAILS	CP0028
X0015	1	COUNTERTOP - AT DT	SB	GC	SEE DETAILS	CP0028
X0017	1	COUNTERTOP - CBE - w/ MAGIC SINK- RF - 112IN 2845MM	SB	GC	SIMILAR TO 17577. PROVIDE OPENING FOR MAGIC SINK INSTEAD OF RINSE TRAY & WATER FILLER.	CP0028
X0018	1	COUNTERTOP - POS	SB	GC	SEE DETAILS	CP0028
X0019	1	COUNTERTOP - DT POS - LF - VARIABLE LENGTH	SB	GC	LENGTH: 6' - 7 153/256" SEE DETAILS FOR ADDITIONAL INFORMATION	CP0028
X0020	1	COUNTERTOP - BREW WITH TRASH DROP - LF	SB	GC	SEE DETAILS	CP0028
X0020 X0033	1	CORIAN SILL @ DT WINDOW	SB	GC	1" SILL, SEE DETAILS	CP0028
X0033 X0037	1	COUNTERTOP - BACKBAR NITRO - RH	SB	GC	SIMILAR TO 20051, W/O BACKSPLASH & WATERFALL	CP0028
) DIEWALL		1			EDGE	<u> </u>
20064	1	DIEWALL - ESPRESSO - 139IN 3530MM	SB	GC		N/A
X0013	1	DIEWALL	SB	GC	SEE DETAILS	N/A
X0023 OTHER	1	DIEWALL - POS	SB	GC	SEE DETAILS	N/A
10218	2	CORNER GUARD - 0.75IN 20MM - CLEAR PLASTIC	SB	GC	GC TO INSTALL FULL HEIGHT. PAINT INSIDE FACE TO MATCH ADJACENT WALL COLOR.	
11142	2	CORBEL SUPPORT - 24IN 610MM	SB	GC		SST
11155	2	ESPRESSO MACHINE PUMP MOUNT - 10X10IN 255X255MM	SB	GC		SST
17829	1	FRENCH CLEAT - VARIABLE LENGTH	SB	GC	OVERALL LENGTH 3' - 2"	PL0027
18145	4	COUNTERTOP SUPPORT LEG	SB	GC	=======================================	SST
20066	1	SHROUD - 139IN 3530MM	SB	GC		CP0028
20067	1	SNEEZE GUARD - 139IN 3530MM	SB	GC		GLASS
20633	2	COUNTERTOP SUPPORT LEG SLIM	SB	GC		SST
X0026	1	WOOD TRIM - WD0073	SB	GC	1X1IN. WD0073 WOOD TRIM. SEE WALL TREATMENT LENGTH SCHEDULE.	WD0073
PANEL		DANIEL 120IN 2520MM	CD.			M/D0070
20065	1	PANEL - 139IN 3530MM	SB	GC		WD0073 MAD200-\
X0014	1	PANEL	SB	GC	SEE DETAILS	WD0073 MAD200-\
X0024	1	PANEL	SB	GC	SEE DETAILS	WD0073 MAD200-\
X0025	1	WAINSCOT	SB	GC	SEE WALL TREATMENT	WD0073

#### RESPONSIBILITY LEGEND

- GC GENERAL CONTRACTOR LL LANDLORD SB STARBUCKS

ISSUE DATE: 07-07-2020
SR. DESIGN MANAGER: K. GORIN SLONSKI
PRODUCTION DESIGNER: A. HAHN
CHECKED BY: NORR

**Revision Schedule** 

**STARBUCKS**®

2401 UTAH AVENUE SOUTH SEATTLE, WASHINGTON 98134 (206) 318-1575

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STARBUCKS TEMPLATE VERSION i2020-01-31

NORR

Engineering Consultants
Mechanical - Electrical - Plumbing

ISSUED DATE: 06/16/2020 EXPIRATION DATE: 12/31/2020

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WEST PRYOR, I WENSTEIN DR. IT, MO JUNTY

Alkemeyer

T OF STARBUCKS - NW PRYOR RD & I - LEE'S SUMMIT

BUILDOUT COFFEE - NCHIPMAN -

STORE #:

PROJECT #:

353 Marshall Avenue St. Louis, Missouri 63119 Phone (314) 772-1782 Fax (314) 373-3514

2020

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**REVISION** 

SHEET TITLE: SCHEDULES

SCALE: AS SHOWN

SHEET NUMBER:

62012

87799-001

1602

		SITE SCHEDU	JLE - "Y"		
DESIGN ID	COUNT	DESCRIPTION	FURN. BY	INST. BY	COMMENTS
EXTERIOR N	/IENU				
14116	1	MENU BOARD - DT DIGITAL ORDER SCREEN - FLAT BLACK MT0028	SB	SB/GC	SUPPLIER: IT EQUIPMENT VENDOR (ZONES). SCREEN INSTALLER: REGIONAL SIGNAGE VENDOR. ELECTRICAL: GC CONNECTS DOS WHIPS & STUB-UPS TO DCB.
14119	1	MENU BOARD - DT 5 PANEL FREESTANDING - 108X65IN 2745X1650MM - FLAT BLACK MT0028	SB	SB	SUPPLIER: DT SIGNAGE VENDOR (DSA). INSTALLER: REGIONAL SIGNAGE VENDOR. LL TO PROVIDE CONDUIT, FOOTING, AND ANCHOR BOLTS PER LLWL.
14120	1	MENU BOARD - DT PRE MENU FREESTANDING - 36X65IN 915X1650MM - FLAT BLACK MT0028	SB	SB	PROVIDED AND INSTALLED BY SIGNAGE VENDOR. LANDLORD GC TO PROVIDE FOOTING & ELECTRICAL AS SPECIFIED PER LLWL.
15700	1	MENU BOARD - DT DIGITAL ORDER SCREEN CONTROL BOX	SB	SB/GC	SUPPLIER: IT EQUIPMENT VENDOR (ZONES). INSTALLER: REGIONAL SIGNAGE VENDOR. ELECTRICAL CONNECTION: GC. LL TO PROVIDE FOOTING, CONDUIT, AND ANCHOR BOLTS PER LLWL.
OTHER					
14103	11	BOLLARD NONILLUMINATED SQUARE - FLAT BLACK MT0028	LL	LL	SUPPLIER/INSTALLER: LL. DSA PHOTOTECH. SEE DETAILS.
14163	1	DT ORDER POINT CANOPY FREESTANDING - FLAT BLACK MT0028	SB	SB	SUPPLIER: DT SIGNAGE VENDOR (DSA). INSTALLER: REGIONAL SIGNAGE VENDOR. LL TO PROVIDE AND INSTALL CONDUIT, FOOTING, AND ANCHOR BOLTS PER LLWL.
18818	4	LIGHT POLE - 10FT 300CM - FLAT BLACK MT0028	LL	LL	
18820	4	LIGHT POLE BASE PLATE - FLAT BLACK MT0028	LL	LL	
X0001	2	VEHICLE DETECTOR LOOP	SB	GC/LL	SUPPLIER: DT AUDIO VENDOR (HME). INSTALLER:GC. LL TO PROVIDE CONDUIT PER LLWL.
X0004	5	PLANTER BOXES - 84X36X18IN	LL	LL	LL TO PROVIDE DRAINAGE AND AUTOMATED IRRIGATION PER LLWL REQUIREMENTS. LL TO PROVIDE SPEC TO DESIGNER FOR APPROVAL.
X0008	1	BIKE RACK - OLYMPIA	LL	LL	FORMS & SURFACES: OLYMPIA BIKE RACK. WWW.FORMS-SURFACES.COM; INSTALL PER MANUFACTURER'S RECOMMENDATIONS.
X0009	20	NATIVE PLANTS FOR PLANTER BOXES	LL	LL	LANDSCAPING SELECTION AND QTY VERIFICATION BY LANDLORD. PROVIDE DRAUGHT-RESISTANT, NATIVE PLANTS WITH MINIMUM MAINTENANCE REQUIREMENTS.
UMBRELLA					
12147	3	UMBRELLA - BASE 95LB 43KG - FLAT BLACK MT0028	SB	GC	
20075	3	UMBRELLA - WITHOUT VALANCE - 6FT 183CM - BLACK CANVAS WITH WORDMARK F0061	SB	GC	

DESIGN ID	COUNT	DESCRIPTION	FURN. BY	INST. BY	BULB	COMMENTS
EXIT			1	1		2 2 1111121 11 2
11483	1	EXIT - SECURITY LIGHT WALL MOUNTED	LL	LL	HID 150W OR EQUAL	
19044	5	LED EXIT SIGN WITH EMERGENCY LIGHT - WHITE AND RED	SB	GC		CAFE EXIT SIGNS TO BE SUSPENDED.
19057	4	LED EMERGENCY LIGHT DOUBLE - BLACK	SB	GC	INTEGRATED LED	
OTHER			•	1		
17796	7	LED STRING LIGHTS - 48FT 1463CM	SB	GC	INTEGRATED LED	POWER BY LANDLORD. TOTAL LENGTH REQUIRED: 130FT
RECESSED	CAN					
19023	32	CAN - LED MOUNTING FRAME - 2IN 50MM - NEW CEILING	SB	GC		
19113	28	CAN - LED ADJUSTABLE GIMBAL WITH DRIVER - 2IN 50MM - WHITE - 1000LM NFL	SB	GC		
19120	4	CAN - LED DOWNLIGHT REFLECTOR WITH DRIVER SQUARE - 2IN 50MM - WHITE - 1000LM FLOOD	SB	GC	INTEGRATED LED	
SCONCE						1
20711	6	SCONCE - HINKLEY ATLANTIS LARGE - BLACK	LL	LL	INTEGRATED LED	DOLAN HOSPITALITY MFR #376769 ATLANTIS OUTDOOR SCONCE
20750	2	SCONCE - KUZCO PLUTO TRIPLE - VINTAGE BRASS	SB	GC	INTEGRATED LED	
SIGNAGE - (	OTHER	1				1
21163	1	SIGN - MOBILE ORDER PICK UP ILLUMINATED BLADE MOUNT	SB	GC		GC TO PROVIDE BLOCKING AND ELECTRICAL IN SOFFIT AS REQUIRED
X0030	1	SIGN - MOBILE ORDER PICK UP SIGN EXTENSION LEGS	SB	GC		BY WALTON. ORDER 4FT LEGS, CUT IN FIELD FOR BOTTOM AT 7'-6" AFF, REFER TO INTERIOR ELEVATIONS FOR EXACT DIMENSION
STRIP		1			I .	1
14410	1	STRIP - LED TAPE - VARIABLE LENGTH	SB	GC	INTEGRATED LED	LENGTH: 43'-9"
TRACK			•	1	,	
12934	2	TRACK - WITH CONNECTORS - 4FT 122CM - WHITE - 1 CIRCUIT	SB	GC		
12944	3	TRACK - WITH CONNECTORS - 16FT 488CM - WHITE - 1 CIRCUIT	SB	GC		
12945	5	TRACK - WITH CONNECTORS - 12FT 365CM - WHITE - 1 CIRCUIT	SB	GC		
15059	1	TRACK - WITH CONNECTORS - 6FT 183CM - WHITE - 1 CIRCUIT	SB	GC		
19071	4	TRACK - LED FIXTURE - 2IN 50MM - WHITE - 900LM SPOT	SB	GC	INTEGRATED LED	
19072	14	TRACK - LED FIXTURE - 2IN 50MM - WHITE - 600LM FLOOD	SB	GC	INTEGRATED LED	
19074	35	TRACK - LED FIXTURE - 2IN 50MM - WHITE - 900LM FLOOD	SB	GC	INTEGRATED LED	
19087	53	TRACK - HEX CELL LOUVER - 2IN 50MM	SB	GC		
TROFFER						
15057	7	TROFFER - LED RECESSED - 24X48IN 600X1200MM - WHITE - 4000LM	SB	GC	INTEGRATED LED	

#### RESPONSIBILITY LEGEND

GC GENERAL CONTRACTOR LL LANDLORD SB STARBUCKS



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**REVISION** 

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62012 87799-001

PROJECT #:

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SR. DESIGN MANAGER: K. GORIN SLONSKI
PRODUCTION DESIGNER: A. HAHN
CHECKED BY: NORR

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SCHEDULES

SCALE: AS SHOWN

SHEET NUMBER:

STORE #:

1603

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ABBR	EVIATIONS
AFF AHJ APPROX	ABOVE FINISHED FLOOR AUTHORITIES HAVING JURISDICTION APPROXIMATE
BLDG	BUILDING
CKT CLG CM CONST CW CXA	CIRCUIT CEILING STARBUCKS CONSTRUCTION MANAGER CONSTRUCTION COLD WATER COMMISSIONING AGENT
DEG DL DM DN DTL DWG(S)	DEGREES LIGHTS WITHIN DAYLIGHT ZONE STARBUCKS DESIGN MANAGER DOWN DETAIL DRAWING(S)
EA EC ECP EG ELEC EM EMS EXIST EXT	EACH ELECTRICAL CONTRACTOR EQUIPMENT CONTROL PAC EXHAUST GRILLE ELECTRICAL EMERGENCY ENERGY MANAGEMENT SYSTEM EXISTING EXTERIOR
F&I FOIC	FURNISH & INSTALL FURNISHED BY OWNER,
FOIO	INSTALLED BY CONTRACTOR FURNISHED BY OWNER,
FLR FT	INSTALLED BY OWNER FLOOR FOOT/FEET
GC GFCI GND	GENERAL CONTRACTOR GROUND FAULT CIRCUIT INTERRUPTER GROUND
HR HVAC HW	HOUR HEATING, VENTILATION, AIR CONDITIONING HOT WATER
LCP LL LS LV	LIGHTING CONTROL PANEL LANDLORD LIGHT SENSOR PHOTOCELL LOW VOLTAGE
MAX MC MDP MECH MEP MFG MIN	MAXIMUM MECHANICAL CONTRACTOR MAIN DISTRIBUTION PANEL MECHANICAL MECHANICAL, ELECTRICAL, AND PLUMBING MANUFACTURER MINIMUM
NL NTS	NIGHTLIGHT NOT TO SCALE
OCP	OVERCURRENT PROTECTION
REF REQ('D) REV	REFERENCE REQUIRE(D) REVISION
SF SHT SPECS SST	SQUARE FEET SHEET SPECIFICATION(S) STAINLESS STEEL
TEL TEMP TYP	TELEPHONE TEMPORARY TYPICAL
UC UNO	UNDER COUNTER UNLESS NOTED OTHERWISE
WH	WATER HEATER

WATER HEATER

**WEATHER PROOF** 

#### **ELECTRICAL SYMBOL LEGEND**

	CTRICAL STIVIL		LOLIND
(J)	JUNCTON BOX	$\phi$	RECEPTACLE: DUPLEX
\$	SWITCH	$\phi$	RECEPTACLE: DUPLEX - ISOLATED GROUND WITH INTEGRAL SURGE PROTECTION
$\S_3$	THREE-WAY SWITCH	<b>+</b>	RECEPTACLE: QUAD
\$.	MOTION (OCCUPANCY) SENSOR SWITCH	<b>+</b>	RECEPTACLE: QUAD - ISOLATED GROUND WITH INTEGRAL SURGE PROTECTION
S	SWITCHBACK	$\bigoplus$	RECEPTACLE: HIGH VOLTAGE
$\blacksquare$	TELEPHONE		RECEPTACLE: FLOOR DUPLEX
	THERMOSTAT		RECEPTACLE: CEILING DUPLEX
S	SPEAKER	₹	GROUNDING ELECTRODE CONNECTION
ф	DIMMER SWITCH	NL	NIGHTLIGHTING 24HR/DAY
	RECEPTACLE: DATA	PE	PHOTOELECTRIC CELL
<del>-////</del>	RACEWAY CONCEALED IN CEILING OR WALL. HASH MARKS INDICATE	<b></b>	WIFI ACCESS POINT
	NUMBER OF WIRES. #12 AWG WIRE UNLESS OTHERWISE NOTED. TWO WIRES PLUS GROUND IF NO HASH MARKS SHOWN. LONG HASH MARK DENOTES NEUTRAL. GROUND WIRE NOT SHOWN.	CO	CARBON MONOXIDE DETECTOR

#### FIRE ALARM SYSTEM NOTES

IF STARBUCKS IS REQUIRED TO PROVIDE A FIRE ALARM AND/OR FIRE ALARM MONITORING AND/OR PHONE LINES FOR A FIRE ALARM, AS SPECIFIED IN THE LEASE AGREEMENT, THE CONTRACTOR IS TO NOTIFY GNOC IMMEDIATELY THAT FIRE ALARM LINES ARE NEEDED. STARBUCKS PREFERRED FIRE ALARM SERVICE PROVIDER, STANLEY, IS TO BE CONTACTED BY THE CONSTRUCTION MANAGER TO INSTALL FIRE ALARM PANEL AND/OR MONITORING SERVICE AS REQUIRED.

#### CARBON MONOXIDE (CO) DETECTOR NOTES

COORDINATE INSTALLATION OF CARBON MONOXIDE (CO) DETECTOR DEVICE(S) AND LOW VOLTAGE WIRING WITH STARBUCKS SECURITY VENDOR FOR NEW STORES, RELOCATIONS AND MAJOR RENOVATIONS. VENDOR TO FURNISH AND INSTALL DEVICE(S) IN BOH AND FOH (AS APPLICABLE PER STARBUCKS STANDARDS). GC TO PROVIDE ROUGH-IN FOR SENSORS.

#### **CONTROLS AND OPERATION**

THE GENERAL CONTRACTOR SHALL COORDINATE INSTALLATION OF INTERMATIC TIMECLOCK, INSTALLATION OF LIGHTING CONTACTOR AND COMMISSIONING WITH ELECTRICAL CONTRACTOR PRIOR TO THE LAST WEEK OF CONSTRUCTION.

FURNISH AND INSTALL RACEWAYS WITH PULL STRINGS AND JUNCTION BOXES FOR THERMOSTAT(S) AND SENSOR(S).

SET RESTROOM OCCUPANCY SENSOR TO 5 MINUTE 'ON' DURATION IN SINGLE OCCUPANT RESTROOM AND TO 5 MINUTE 'ON' DURATION IN MULTI-OCCUPANT RESTROOM UNLESS JURISDICTION REQUIREMENTS STATE OTHERWISE.

COORDINATE WITH DRAWINGS AND MANUFACTUERE FOR DEVICE LOCATIONS.

THE GENERAL CONTRACTOR IS TO COMPLETE FINAL CONNECTION AFTER DATA RACK AND NETWORK INSTALLATION.

#### SYSTEM COMMISSIONING

#### CONTRACTOR RESPONSIBILITIES FOR BUILDING COMMISSIONING

CONTRACTOR SHALL PROVIDE SUPPORT AND WORK AS SPECIFIED. NEEDED AND REQUIRED TO CONDUCT AND FACILITATE STARBUCKS STAFF BUILDING COMMISSIONING EFFORTS. THIS WORK WILL BE COMPRISED OF THREE DISTINCT EFFORTS:

- 1) SUPPORT STARBUCKS COMMISSIONING AGENT (CXA) DURING INSTALLATION VERIFICATION AND CORRECT DISCLOSED DEFICIENCIES;
- 2) PERFORM TESTING, ADJUSTING, BALANCING AND SYSTEM STARTUP AND SUPPORT FUNCTIONAL PERFORMANCE TESTING BY STARBUCKS CXA:
- 3) CORRECT DEFICIENCIES DISCLOSED BY FUNCTIONAL PERFORMANCE TESTING AND SUBMIT REPORTS. CONTRACTOR SHALL PERFORM AND PROVIDE THE FOLLOWING:
- A. SYSTEMS SUBJECT TO COMMISSIONING MAY INCLUDE, BUT ARE NOT LIMITED TO DOMESTIC HOT WATER GENERATION, HVAC SYSTEMS, ROOFTOP UNITS, EXHAUST FANS, HVAC CONTROLS, LIGHTING CONTROLS, AIR CURTAINS, BUILT-IN REFRIGERATION EQUIPMENT, AND RENEWABLE ENERGY SYSTEMS.
- B. CONTRACTOR SHALL INCLUDE COMMISSIONING ACTIVITIES IN PROJECT SCHEDULE AND SHOW INTERVALS FOR PERFORMANCE OF WORK FOR WHICH CONTRACTOR IS RESPONSIBLE AND INTERVALS FOR WORK PERFORMED BY STARBUCKS CXA. CONTRACTOR SHALL SHOW RESOURCES FOR PERFORMING ALL WORK RELATED TO COMMISSIONING ACTIVITIES ON A LINE ITEM IN THE SCHEDULE OF VALUES.
- C. CONTRACTOR SHALL INSTALL EQUIPMENT IN ACCORDANCE WITH THE MANUFACTURER'S REQUIREMENTS AND ALL CONTRACT DOCUMENTS. ENSURE THAT ALL EQUIPMENT IS INSTALLED TOTALLY COMPLETE, AND ACCESSIBLE TO STARBUCKS CXA FOR INSTALLATION VERIFICATION AND FUNCTIONAL PERFORMANCE TESTING PRIOR TO THE SCHEDULED START OF INSTALLATION VERIFICATION.
- D. INSTALLATION VERIFICATION SHALL BE PERFORMED BY STARBUCKS CXA. CONTRACTOR SHALL SUPPORT STARBUCKS CXA INSTALLATION VERIFICATION EFFORTS AS NECESSARY. PROVIDE ALL ACCESS AND EQUIPMENT NECESSARY FOR STARBUCKS STAFF TO VERIFY THAT THE EQUIPMENT IS INSTALLED CORRECTLY.
- CONTRACTOR SHALL BE READILY AVAILABLE DURING INSTALLATION VERIFICATION TO CORRECT ANY DEFICIENCIES OR DEFECTS DISCLOSED BY THE INSTALLATION VERIFICATION PROCESS. CORRECTIONS SHALL BE MADE IN A TIMELY MANNER WITHOUT DISRUPTION OF THE CONSTRUCTION SCHEDULE.
- F. ALL HVAC, EXHAUST FAN, AND AIR CURTAIN EQUIPMENT SHALL BE TESTED, ADJUSTED AND BALANCED BY THE CONTRACTOR'S TESTING, ADJUSTING AND BALANCE AGENT( SEE TESTING, ADJUSTING AND BALANCING) AFTER THE SYSTEM IS VERIFIED TO BE COMPLETE AND CORRECT BY STARBUCKS CXA, IN ACCORDANCE WITH THE REQUIREMENTS OF THESE DOCUMENTS. ALL HVAC CONTROL SYSTEMS SHALL BE TESTED TO ENSURE THAT CONTROL DEVICES, COMPONENTS, EQUIPMENT AND SYSTEMS ARE CALIBRATED, ADJUSTED AND OPERATE IN ACCORDANCE WITH THESE PLANS AND PROJECT MANUAL. SEQUENCES OF OPERATION SHALL BE TESTED TO ENSURE THAT THEY OPERATE IN ACCORDANCE WITH THE CONTRACT REQUIREMENTS. DELIVERABLES: PRELIMINARY, WRITTEN TESTING AND AIR BALANCE REPORT CONFORMING TO THE REQUIREMENTS SPECIFIED HEREIN, DOCUMENTING THE INFORMATION SPECIFIED, ETC. TO THE STARBUCKS CXA IMMEDIATELY UPON COMPLETION OF THE WORK.
- G. CONTRACTOR SHALL INFORM STARBUCKS CXA WHEN EQUIPMENT IS READY FOR FUNCTIONAL PERFORMANC TESTING. ALL EQUIPMENT SHALL BE READY FOR FUNCTIONAL PERFORMANCE TESTING PRIOR TO STARTING TESTING. CONTRACTOR SHALL OPERATE EQUIPMENT FOR STARBUCKS CXA AND VERIFY BY DEMONSTRATION THE CORRECT OPERATION OF EQUIPMENT, RESPONSE OF SENSORS, AND PROPER **EXECUTION OF HVAC CONTROL AND LIGHTING SEQUENCES:** INCLUDING BUT NOT LIMITED TO, AIR MOVEMENT, TEMPERATURE, SOUND, AND CONTROL RESPONSE. PROVIDE ANY SECURITY ACCESS, HARDWARE, SOFTWARE, OR OTHER SUPPORT AS NEEDED FOR THE STARBUCKS CXA TO EFFICIENTLY WITNESS AND DOCUMENT ALL EQUIPMENT TESTING. STARBUCKS CXA WILL RECORD THE EQUIPMENT OPERATION AND RESPONSE TO TESTING SEQUENCES AND PREPARE A LIST OF ANY DEFICIENCIES DISCLOSED BY THE FUNCTIONAL PERFORMANCE TESTS FOR CORRECTION BY THE CONTRACTOR. EQUIPMENT INCLUDES, BUT IS NOT LIMITED TO, AIR HANDLING UNITS, ROOFTOP AND SPLIT TYPE, CONDENSING UNITS, EXHAUST FANS, LIGHTING CONTROLS, ETC. DELIVERABLES: PROVIDE COMPLETED COPIES OF ALL START UP REPORTS, FILLED OUT ON THE MANUFACTURER'S FORMS, TO THE STARBUCKS CXA.
- H. CONTRACTOR IS RESPONSIBLE FOR CORRECTING ANY ISSUES OR DEFICIENCIES DISCLOSED DURING THE FUNCTIONAL PERFORMANCE TESTING PROCESS. CORRECTIONS SHOULD BE MADE IN A TIMELY MANNER WITHOUT DISRUPTION TO THE SYSTEM AND CONSTRUCTION SCHEDULE.
- CONTRACTOR SHALL BE READILY AVAILABLE FOR ANY RE-TESTING OF EQUIPMENT DEEMED NECESSARY BY STARBUCKS CXA DURING INSTALLATION VERIFICATION AND FUNCTIONAL PERFORMANCE TESTING. CONTRACTOR IS RESPONSIBLE FOR CORRECTING ANY ISSUES OR DEFICIENCIES FOUND IN THE SYSTEM DURING ANY AND ALL RE-TESTING. CORRECTIONS SHOULD BE MADE IN A TIMELY MANNER WITHOUT DISRUPTION TO THE SYSTEM AND CONSTRUCTION SCHEDULE, DELIVERABLES: FINAL BALANCE REPORT, DEFICIENCIES LIST NOTING CORRECTIVE ACTIONS PERFORMED BY CONTRACTOR IN RESPONSE TO INSTALLATION VERIFICATION AND FUNCTIONAL PERFORMANCE TEST RESULTS.
- J. CONSTRUCTION AND POST CONSTRUCTION TESTING: ADDITIONAL TESTING MAY BE REQUIRED AND OTHER PROCESSES THAT MAY OCCUR OUT OF SEQUENCE WITH COMMISSIONING SERVICE. CONTRACTOR SHALL CONDUCT. DOCUMENT, SUPPORT AND SCHEDULE THIS TESTING AS DIRECTED BY STARBUCKS CXA.

#### SECURITY SYSTEM NOTES

PANEL. KEYPAD AND SENSORS.

TRAIN PARTNERS AFTER POS INSTALL.

STARBUCKS CONTRACTS DIRECTLY WITH SECURITY VENDOR TO SUPPLY AND INSTALL THE SECURITY SYSTEM. CONTRACTOR TO SCHEDULE INSTALLATION OF SECURITY SYSTEM FOR FOUR (4) TIMES;

- . MEET TO PLAN SECURITY CABLE PULL WITH SECURITY CABLE INSTALLER PRIOR TO DRYWALL INSTALLATION.
- 2. SECURITY CABLE INSTALLER PULLS SECURITY CABLES, MOUNTS
- 3. SECURITY EQUIPMENT INSTALL OF CAMERA, NVR AND MONITOR.
- 4. SECURITY MONITORING COMPANY TO BRING SYSTEM ONLINE AND

SECURITY VENDOR REQUIRES A MINIMUM TWO (2) WEEKS LEAD TIME FOR EACH INSTALLATION. SECURITY VENDOR WILL COORDINATE REGIONAL INSTALLERS. ALL ADDITIONAL EXPENSES INCURRED DUE TO THE CONTRACTOR'S FAILURE TO SCHEDULE ACCORDINGLY WILL BE THE RESPONSIBILITY OF THE CONTRACTOR

#### TELEPHONE SYSTEM NOTES

IF ADDITIONAL TELEPHONE LINES ARE REQUIRED BEYOND THE STANDARD SINGLE LINE (SUCH AS FOR A FIRE ALARM) THE GENERAL CONTRACTOR SHALL CONTACT THE STARBUCKS CONSTRUCTION MANAGER PRIOR TO BEGINNING CONSTRUCTION TO ORDER THE ADDITIONAL TELEPHONE LINE(S). REPORT ANY TELEPHONE INSTALLATION ISSUES IMMEDIATELY TO THE STARBUCKS CONSTRUCTION MANAGER

CONFIRM PRIOR TO BEGINNING CONSTRUCTION THAT THERE ARE EXISTING. WORKING TELCO FACILITIES TO THE BUILDING OR THAT LANDLORD HAS FURNISHED AND INSTALLED ONE (1) 2" (51MM) MIN. (ENTRANCE) CONDUIT INCLUDING PULL STRING FROM TELCO STREET FEED LINE TO THE BUILDING AS IDENTIFIED BY THE PHONE COMPANY. NOTIFY STARBUCKS CONSTRUCTION MANAGER IMMEDIATELY IF FACILITIES OR CONDUIT AND PULL STRING ARE NOT INSTALLED.

GENERAL CONTRACTOR IS TO ENSURE THAT THERE IS A 2" (51MM) MIN. CONDUIT WITH PULL STRING FROM THE DATA RACK TO THE DEMARC (TELCO TO CUSTOMER HAND OFF EQUIPMENT) WHEN THE DEMARC IS MORE THAN 10' FROM THE DATA RACK. DISTANCES LESS THAN 10' WILL NOT REQUIRE CONDUIT.

PROVIDE A 3-POSITION GROUND LUG, GROUNDED WITH #6 AWG GROUND WIRE, IF REQUIRED BY TELEPHONE COMPANY.

ALL TELEPHONE/NETWORK CABLING IS THE SCOPE OF WORK OF THE TELEPHONE/NETWORK CABLING VENDOR.

#### POS \ DATA LINE NOTES

STARBUCKS CONTRACTS DIRECTLY WITH THE DATA CABLING VENDOR TO SUPPLY AND INSTALL CATEGORY 5e (CAT5e) LAN CABLE AND CONNECTORS FOR THE POINT OF SALE (POS) SYSTEMS. CONTRACTOR TO SCHEDULE INSTALLATION OF DATA CABLING WITH DATA CABLING VENDOR. DATA CABLING VENDOR REQUIRES A LEAD TIME FOR INSTALLATION. DATA CABLING VENDOR WILL COORDINATE REGIONAL INSTALLERS.

AT THE START OF CONSTRUCTION, STARBUCKS CONSTRUCTION MANAGER SCHEDULES DELIVERY OF CASH REGISTER/MANAGER'S WORKSTATION EQUIPMENT AND INSTALLATION BY A POS INSTALL TECHNICIAN FOR ONE (1) MONTH PRIOR TO STORE OPEN. CONTRACTOR TO VERIFY DELIVERY SCHEDULE TWO (2) WEEKS PRIOR TO DELIVERY AND INSTALLATION DATE. EQUIPMENT IS SHIPPED DIRECTLY TO THE STORE. CONTRACTOR TO ACCEPT POS EQUIPMENT DELIVERY. DO NOT REFUSE DELIVERY.

DATA CABLING TECHNICIAN TO PROVIDE ALL CAT5e LAN CABLING AND CONNECTORS FROM ALL DESIGNED AND FUTURE CASH REGISTER LOCATIONS, MANAGER'S WORKSTATION, ALL OTHER NETWORKED EQUIPMENT (CUP LABELERS, CLOVER, BUMP BAR, ETC...) AND WIRELESS ACCESS POINT TO THE DATA RACK AREA. CONTRACTOR IS TO HAVE CONDUIT WITH PULL STRING IN PLACE FOR ALL CABLE RUNS PRIOR TO CABLE INSTALL DATE.

STARBUCKS NEW STORE GROUP IS RESPONSIBLE FOR COORDINATING STARBUCKS POS SYSTEMS DELIVERY AND INSTALLATION WITH THE POS VENDOR. THIS GROUP MAY BE CONTACTED AT: NEWSTORES@STARBUCKS.COM.

#### **COMMUNICATION SYSTEM NOTES**

CONFIRM PRIOR TO BEGINNING CONSTRUCTION THAT THE LANDLORD HAS FURNISHED AND INSTALLED ONE (1) ADDITIONAL 2" (51MM) (ENTRANCE) CONDUIT INCLUDING PULL STRING (FOR A TOTAL OF TWO (2)) FROM THE STREET FEED TO THE BUILDING AS IDENTIFIED BY THE INTERNET SERVICE PROVIDER.

#### WIRELESS NETWORK NOTES

CABLING FOR INTERNET SERVICE SHALL BE FURNISHED AND INSTALLED BY THE VENDOR FOR FIBER OR BROADBAND CONNECTIONS. T1 AND ETHERNET EXTENSION CABLING IS PROVIDED BY THE STARBUCKS (TELEPHONE/ NETWORK) CABLING VENDOR. COORDINATE WITH STARBUCKS.

#### MUSIC SYSTEM NOTES

MOUNT OWNER FURNISHED SPEAKERS WHERE SHOWN ON INTERIOR REFLECTED CEILING PLANS AND IN COORDINATION WITH ALL PLANS, DETAILS AND MANUFACTURER'S INSTALLATION REQUIREMENTS. INSTALL AND CONNECT OWNER FURNISHED WIRING SYSTEM BETWEEN ALL SPEAKERS AND THE OWNER PROVIDED MUSIC SYSTEM. SET WATTAGE TAP ON EACH SPEAKER'S ROTARY SWITCH PER TAP SETTINGS NOTED ON PLANS.

#### GENERAL ELECTRICAL NOTES

- 1. THE ELECTRICAL CONTRACTOR SHALL COORDINATE ELECTRICAL WORK WITH OTHER TRADES. THE ARCHITECTURAL DRAWINGS SHALL TAKE PRECEDENCE OVER ALL OTHER DRAWINGS. DO NOT SCALE DISTANCES OFF THE ELECTRICAL DRAWINGS; USE ACTUAL BUILDING DIMENSIONS. OVERALL CASEWORK COMPONENT DIMENSIONING ON ELECTRICAL DETAILS ARE SHOWN FOR REFERENCE AND COORDINATION ONLY. SEE PROJECT MANUAL
- 2. ALL ELECTRICAL SYSTEMS SHALL BE TESTED FOR PROPER OPERATION. BALANCE ALL BRANCH CIRCUIT LOADS BETWEEN THE PHASES OF THE SYSTEM WITHIN 10% OF THE HIGHEST PHASE LOAD IN EACH PANEL BOARD.
- 3. THE ELECTRICAL CONTRACTOR SHALL BE RESPONSIBLE FOR DE-ENERGIZING CIRCUITS IN DEMOLITION AREAS TO INSURE A SAFE CONDITION. ELECTRICAL DEVICES AND ASSOCIATED WIRING LOCATED WITHIN THE DEMOLITION AREA THAT WILL NO LONGER BE USED SHALL BE REMOVED AND PROPERLY DISPOSED OF AT CONTRACTORS EXPENSE UNLESS OTHERWISE NOTED.
- 4. THE ELECTRICAL CONTRACTOR SHALL SCHEDULE ALL ELECTRICAL SYSTEM OUTAGES WITH THE GENERAL CONTRACTOR AND LANDLORD AT LEAST 24 HOURS IN ADVANCE. UNLESS APPROVED OTHERWISE ALL OUTAGES SHALL OCCUR BETWEEN 11:00PM AND
- 5. ELECTRICAL CONTRACTOR SHALL FURNISH AND INSTALL ALL NECESSARY CONDUIT AND J-BOXES TO SUPPORT A COMPLETE SECURITY, PHONE, POS AND DATA SYSTEMS. SEE MANAGER WORKSTATION AND BAR POINT OF SALE (POS) POWER/TELECOM/SECURITY DIAGRAM. COORDINATE ALL DEVICE LOCATIONS AND MOUNTING HEIGHTS WITH SECURITY VENDOR PRIOR TO ROUGH-IN. PROVIDE END-TO-END PULL STRINGS IN ALL CONDUITS. LABEL EACH END OF THE PULL STRING WITH CONDUIT SYSTEM ("SECURITY") AND DESTINATION ("CAFÉ", "FRONT BAR", ETC.). PROVIDE INSULATED BUSHINGS ON ALL STUBBED-UP AND EXPOSED CONDUIT ENDS.
- 6. ELECTRICAL CONTRACTOR SHALL COORDINATE WITH THE GENERAL CONTRACTOR TO PATCH AND REPAIR ALL EXISTING WALLS, FLOORS, CEILINGS OR OTHER SURFACES IDENTIFIED TO REMAIN THAT MAY BECOME DAMAGED DURING THE COURSE OF
- 7. EXPOSED/SURFACE MOUNTED CONDUITS SHALL ONLY BE ALLOWED WHERE NECESSARY IN EXPOSED CEILING AREAS. IF CONDUITS NEED TO BE SURFACE MOUNTED TO WALLS, COORDINATE WITH STARBUCKS CONSTRUCTION MANAGER FOR APPROVAL.
- 8. VERIFY LOCATION OF ALL OUTLETS AND SWITCHES WITH ARCHITECTURAL DRAWINGS, INTERIOR DETAILS, FINISH SCHEDULES, GENERAL CONTRACTOR, EQUIPMENT VENDORS, STARBUCKS AND EXISTING SITE CONDITIONS. VERIFY FINAL DOOR HINGE LOCATION PRIOR TO SWITCH INSTALLATION AND ADJUST SWITCH LOCATION IF NEEDED. DO NOT MOUNT RECEPTACLES/SWITCHES IN LOCATIONS THAT WOULD CONFLICT WITH MIRRORS, SEAMS OF WALLS, WAINSCOTS, TILE TRANSITIONS, ETC...

#### **GENERAL NOTES**

THE INTENT OF THE DRAWINGS AND PROJECT MANUAL IS TO PROVIDE A COMPLETE AND FULLY OPERATIONAL ELECTRICAL SYSTEM. THE ELECTRICAL CONTRACTOR SHALL FURNISH AND INSTALL ALL LABOR, MATERIAL, AND EQUIPMENT NECESSARY TO COMPLETE THE ELECTRICAL WORK.

THE ELECTRICAL CONTRACTOR SHALL THOROUGHLY EXAMINE ALL AREAS WHERE EQUIPMENT, CONDUIT, AND WIRING WILL BE INSTALLED AND WILL REPORT ANY CONDITION THAT, IN HIS OPINION, PREVENTS THE PROPER INSTALLATION OF THE ELECTRICAL WORK.

**EQUIPMENT** AND MATERIALS SHALL CONFORM WITH APPROPRIATE PROVISIONS OF CSA, ULC, NEC, ASTM, UL, ETL, NEMA, ANSI, AS APPLICABLE TO EACH INDIVIDUAL UNIT OR ASSEMBLY.

ALL WORK SHALL BE PERFORMED IN STRICT ACCORDANCE WITH ALL APPLICABLE PROVINCIAL AND LOCAL CODES AND ORDINANCES. IN CASE OF CONFLICT BETWEEN THE DRAWINGS AND SPECIFICATIONS AND THE CODES, THE HIGHEST STANDARD SHALL APPLY. ELECTRICAL CONTRACTOR SHALL SATISFY CODE REQUIREMENTS AS A MINIMUM STANDARD WITHOUT ANY EXTRA COST TO STARBUCKS.

PERMITS AND FEES

THE ELECTRICAL CONTRACTOR SHALL PROCURE AND PAY FOR ALL PERMITS, FEES, AND INSPECTIONS NECESSARY TO COMPLETE THE ELECTRICAL WORK.

THE ELECTRICAL CONTRACTOR SHALL UNCONDITIONALLY WARRANT ALL WORK TO BE FREE OF DEFECTS IN MATERIAL AND WORKMANSHIP FOR A PERIOD OF ONE (1) YEAR FROM THE DATE OF FINAL ACCEPTANCE BY STARBUCKS AND WILL REPAIR OR REPLACE ANY DEFECTIVE WORK PROMPTLY AND WITHOUT CHARGE AND RESTORE ANY OTHER EXISTING WORK DAMAGED IN THE COURSE OF REPAIRING DEFECTIVE MATERIALS AND WORKMANSHIP.

#### LANDLORD REQUIREMENTS

PRIOR TO BID: THE CONTRACTOR SHALL COORDINATE WITH LANDLORD / BUILDING OWNER FOR ANY CONSTRUCTION REQUIREMENTS. IF LANDLORD / BUILDING OWNER DOES HAVE REQUIREMENTS, CONTRACTOR SHALL BECOME COMPLETELY FAMILIAR WITH REQUIREMENTS AND ADHERE TO THEM. WHERE LANDLORD / BUILDING OWNER REQUIREMENTS ARE MORE STRINGENT THAN SHOWN IN THESE PLANS (IN THE OPINION OF THE ENGINEER). LANDLORD / BUILDING OWNER REQUIREMENTS SHALL

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#### **STARBUCKS**

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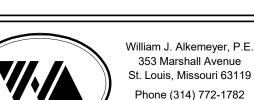
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WRITTEN AGREEMENT IS FULLY EXECUTED BY BOTH PARTIES





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**Engineering Consultant** 

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 $\Xi$   $\square$   $\square$   $\square$ 62012 PROJECT #:

87799-001 07-07-2020 SR. DESIGN MANAGER: K. GORIN SLONSKI PRODUCTION DESIGNER: A. HAHN

NJD/BMS

**Revision Schedule** 

Rev	Date	Ву	Description

ELECTRICAL NOTES

SCALE: AS SHOWN SHEET NUMBER:

#### COMcheck Software Version 4.1.2.1

#### **Interior Lighting Compliance Certificate**

Project Information

2018 IECC Energy Code: Project Title: Starbucks Coffee Company Project Type: New Construction

Construction Site: Designer/Contractor:

Additional Efficiency Package(s)

Reduced interior lighting power. Requirements are implicitly enforced within interior lighting allowance calculations.

Allowed Interior Lighting Power

Α	В	C	D
Area Category	Floor Area (ft2)	Allowed Watts / ft2	Allowed Watts (B X C)
1-Dining: Bar Lounge/Leisure	2220	0.81	1798
		Total Allowed Watts	= 1798

#### Proposed Interior Lighting Power

A Fixture ID : Description / Lamp / Wattage Per Lamp / Ballast	B Lamps/ Fixture	C # of Fixtures	D Fixture Watt.	(C X D)
1-Dining: Bar Lounge/Leisure				
15057: 15057: Other:	1	7	36	252
LED 2: 20057: Other:	3	2	16	33
LED 3: 19113: Other:	1	25	11	280
LED 3 copy 1: 19120: Other:	1	4	12	46
Track lighting 1: Wattage based on 122 feet of track	0	O	976	976
		Total Propos	sed Watts =	1587

#### nterior Lighting PASSES: Design 12% better than code

Interior Lighting Compliance Statement

Compliance Statement: The proposed interior lighting design represented in this document is consistent with the building plans, specifications, and other calculations submitted with this permit application. The proposed interior lighting systems have been designed to meet the 2018 IECC requirements in COMcheck Version 4.1.2.1 and to comply with any applicable mandatory requirements listed in the Inspection Checklist.

SEE TITLE BLOCK FOR SEAL, SIGNATURE, AND DATE Name - Title

Project Title: Starbucks Coffee Company 

Section # & Req.ID	Final Inspection	Complies?	Comments/Assumptions
C303.3, C408.2.5. 2 [FI17] <sup>3</sup>	Furnished O&M instructions for systems and equipment to the building owner or designated representative.	□Complies □Does Not □Not Observable □Not Applicable	Requirement will be met.
C405.4.1 [FI18] <sup>1</sup>	Interior installed lamp and fixture lighting power is consistent with what is shown on the approved lighting plans, demonstrating proposed watts are less than or equal to allowed watts.	Complies Does Not Not Observable Not Applicable	See the Interior Lighting fixture schedule for values.
C408.1.1 [FI57] <sup>1</sup>	Building operations and maintenance documents will be provided to the owner. Documents will cover manufacturers' information, specifications, programming procedures and means of illustrating to owner how building, equipment and systems are intended to be installed, maintained, and operated.	Complies Does Not Not Observable Not Applicable	Requirement will be met.
C408.2.5. 1 [FI16] <sup>3</sup>	Furnished as-built drawings for electric power systems within 90 days of system acceptance.	Complies Does Not Not Observable Not Applicable	Requirement will be met.
C408.3 [FI33] <sup>1</sup>	Lighting systems have been tested to ensure proper calibration, adjustment, programming, and operation.	□Complies □Does Not □Not Observable □Not Applicable	Requirement will be met.

Additional Comments/Assumptions:

1 High Impact (Tier 1) 2 Medium Impact (Tier 2) 3 Low Impact (Tier 3)

Project Title: Starbucks Coffee Company Report date: 05/21/20 Data filename: F:\2020\100-20 SB - NORR\120-20 SB - Pryor Rd & Chipman, MO\DOCS\120-20 COMCheck.cck Page 5 of 6 COMcheck Software Version 4.1.2.1 **Inspection Checklist** Energy Code: 2018 IECC

Requirements: 100.0% were addressed directly in the COMcheck software Text in the "Comments/Assumptions" column is provided by the user in the COMcheck Requirements screen. For each requirement, the user certifies that a code requirement will be met and how that is documented, or that an exception is being claimed. Where compliance is itemized in a separate table, a reference to that table is provided.

# & Req.ID

C405.2.2. Spaces required to have light-

C405.2.1, Occupancy sensors installed in

[EL18]1 rooms, copy/print rooms,

C405.2.1. classrooms/lecture/training rooms,

reduction controls have a manual

control that allows the occupant to

a reasonably uniform illumination pattern >= 50 percent.

conference/meeting/multipurpose

open plan office areas, restrooms, storage rooms, locker rooms,

Reference section language C405.2.1.2 for control function in

for open plan office spaces.

warehouse storage areas, and other spaces <= 300 sqft that are enclosed by floor-to-ceiling height partitions.

warehouses and section C405.2.1.3

by 50% or more when the areas are unoccupied. The occupant sensors

control lighting in each aisleway

independently and do not control

controlled by the sensor.

lighting beyond the aisleway being

open plan office areas: Occupant

be controlled separately in control zones with floor areas <= 600 sq.ft.

within the space, 2) automatically turn off general lighting in all control zones

within 20 minutes after all occupants have left the space, 3) are configured so that general lighting power in each control zone is reduced by >= 80% of

the full zone general lighting power within 20 minutes of all occupants

configured such that any daylight

for the same area is detected.

leaving that control zone, and 4) are

responsive control will activate space general lighting or control zone general lighting only when occupancy

2405.2.2, Each area not served by occupancy Complies

C405.2.2. sensors (per C405.2.1) have time-switch controls and functions detailed 1, switch controls and functions detailed C405.2.2. in sections C405.2.2.1 and C405.2.2.2. Not Observable Not Applicable

2405.2.1. Occupant sensor control function in Complies

C405.2.1. Occupancy sensors control function in Complies

warehouses: In warehouses, the Does Not

lighting in aisleways and open areas is controlled with occupant sensors that automatically reduce lighting power

sensor controls in open office spaces 

Not Observable

reduce the connected lighting load in

Rough-In Electrical Inspection Complies?

lounges/breakrooms, enclosed offices, Not Applicable

□Complies

□Not Observable

☐Not Applicable

□Not Observable

Does Not

Complies

Does Not

Does Not

Section # & Req.ID	Plan Review	Complies?	Comments/Assumptions
C103.2 [PR4] <sup>1</sup>	Plans, specifications, and/or calculations provide all information with which compliance can be determined for the interior lighting and electrical systems and equipment and document where exceptions to the standard are claimed. Information provided should include interior lighting power calculations, wattage of bulbs and ballasts, transformers and control devices.	□Complies □Does Not □Not Observable □Not Applicable	Requirement will be met.
C406 [PR9] <sup>1</sup>	Plans, specifications, and/or calculations provide all information with which compliance can be determined for the additional energy efficiency package options.	□Complies □Does Not □Not Observable □Not Applicable	Requirement will be met.

Additional Comments/Assumptions:

1 High Impact (Tier 1) 2 Medium Impact (Tier 2) 3 Low Impact (Tier 3)

Project Title: Starbucks Coffee Company Data filename: F:\2020\100-20 SB - NORR\120-20 SB - Pryor Rd & Chipman, MO\DOCS\120-20 COMCheck.cck Page 2 of 6

1 High Impact (Tier 1) 2 Medium Impact (Tier 2) 3 Low Impact (Tier 3) Project Title: Starbucks Coffee Company Data filename: F:\2020\100-20 SB - NORR\120-20 SB - Pryor Rd & Chipman, MO\DOCS\120-20 COMCheck.cck Page 3 of 6

Comments/Assumptions

Requirement will be met.

# & Req.ID	Rough-In Electrical Inspection	Complies?	Comments/Assumptions
C405.2.3, C405.2.3. 1,	Daylight zones provided with individual controls that control the lights independent of general area lighting. See code section C405.2.3 Daylight-responsive controls for applicable spaces, C405.2.3.1 Daylight responsive control function and section C405.2.3.2 Sidelit zone.	Complies Does Not Not Observable Not Applicable	<b>Exception:</b> Sidelit zones on first floor in Group A-2 and M occupancies.
C405.2.4 [EL26] <sup>1</sup>	Separate lighting control devices for specific uses installed per approved lighting plans.	□Complies □Does Not □Not Observable □Not Applicable	Requirement will be met.
C405.2.4 [EL27] <sup>1</sup>	Additional interior lighting power allowed for special functions per the approved lighting plans and is automatically controlled and separated from general lighting.	□Complies □Does Not □Not Observable □Not Applicable	Requirement will be met.
C405.3 [EL6] <sup>1</sup>	Exit signs do not exceed 5 watts per face.	Complies Does Not Not Observable Not Applicable	Requirement will be met.
C405.6 [EL26] <sup>2</sup>	Low-voltage dry-type distribution electric transformers meet the minimum efficiency requirements of Table C405.6.	Complies Does Not Not Observable Not Applicable	Exception: Requirement does not apply.
C405.7 [EL27] <sup>2</sup>	Electric motors meet the minimum efficiency requirements of Tables C405.7(1) through C405.7(4). Efficiency verified through certification under an approved certification program or the equipment efficiency ratings shall be provided by motor manufacturer (where certification programs do not exist).	Complies Does Not Not Observable Not Applicable	Exception: Requirement does not apply.
C405.8.2, C405.8.2. 1 [EL28] <sup>2</sup>	Escalators and moving walks comply with ASME A17.1/CSA B44 and have automatic controls configured to reduce speed to the minimum permitted speed in accordance with ASME A17.1/CSA B44 or applicable local code when not conveying passengers.	Complies Does Not Not Observable Not Applicable	Exception: Requirement does not apply.
C405.9 [EL29] <sup>2</sup>	Total voltage drop across the combination of feeders and branch circuits <= 5%.	Complies Does Not Not Observable Not Applicable	Requirement will be met.

1 High Impact (Tier 1) 2 Medium Impact (Tier 2) 3 Low Impact (Tier 3)

Project Title: Starbucks Coffee Company Data filename: F:\2020\100-20 SB - NORR\120-20 SB - Pryor Rd & Chipman, MO\DOCS\120-20 COMCheck.cck Page 4 of 6

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WRITTEN AGREEMENT IS FULLY EXECUTED BY BOTH PARTIES



William J. Alkemeyer, P.E. 353 Marshall Avenue St. Louis, Missouri 63119 Phone (314) 772-1782 Fax (314) 373-3514

**Engineering Consultant** 

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62012 PROJECT #: 87799-001 SR. DESIGN MANAGER: K. GORIN SLONSKI PRODUCTION DESIGNER: A. HAHN CHECKED BY: NJD/BMS

**Revision Schedule** 


Description

**ENERGY CALCULATIONS** 

SCALE: AS SHOWN

SHEET NUMBER: E002

Project Title: Starbucks Coffee Company Report date: 05/21/20 Data filename: F:\2020\100-20 SB - NORR\120-20 SB - Pryor Rd & Chipman, MO\DOCS\120-20 COMCheck.cck Page 6 of 6

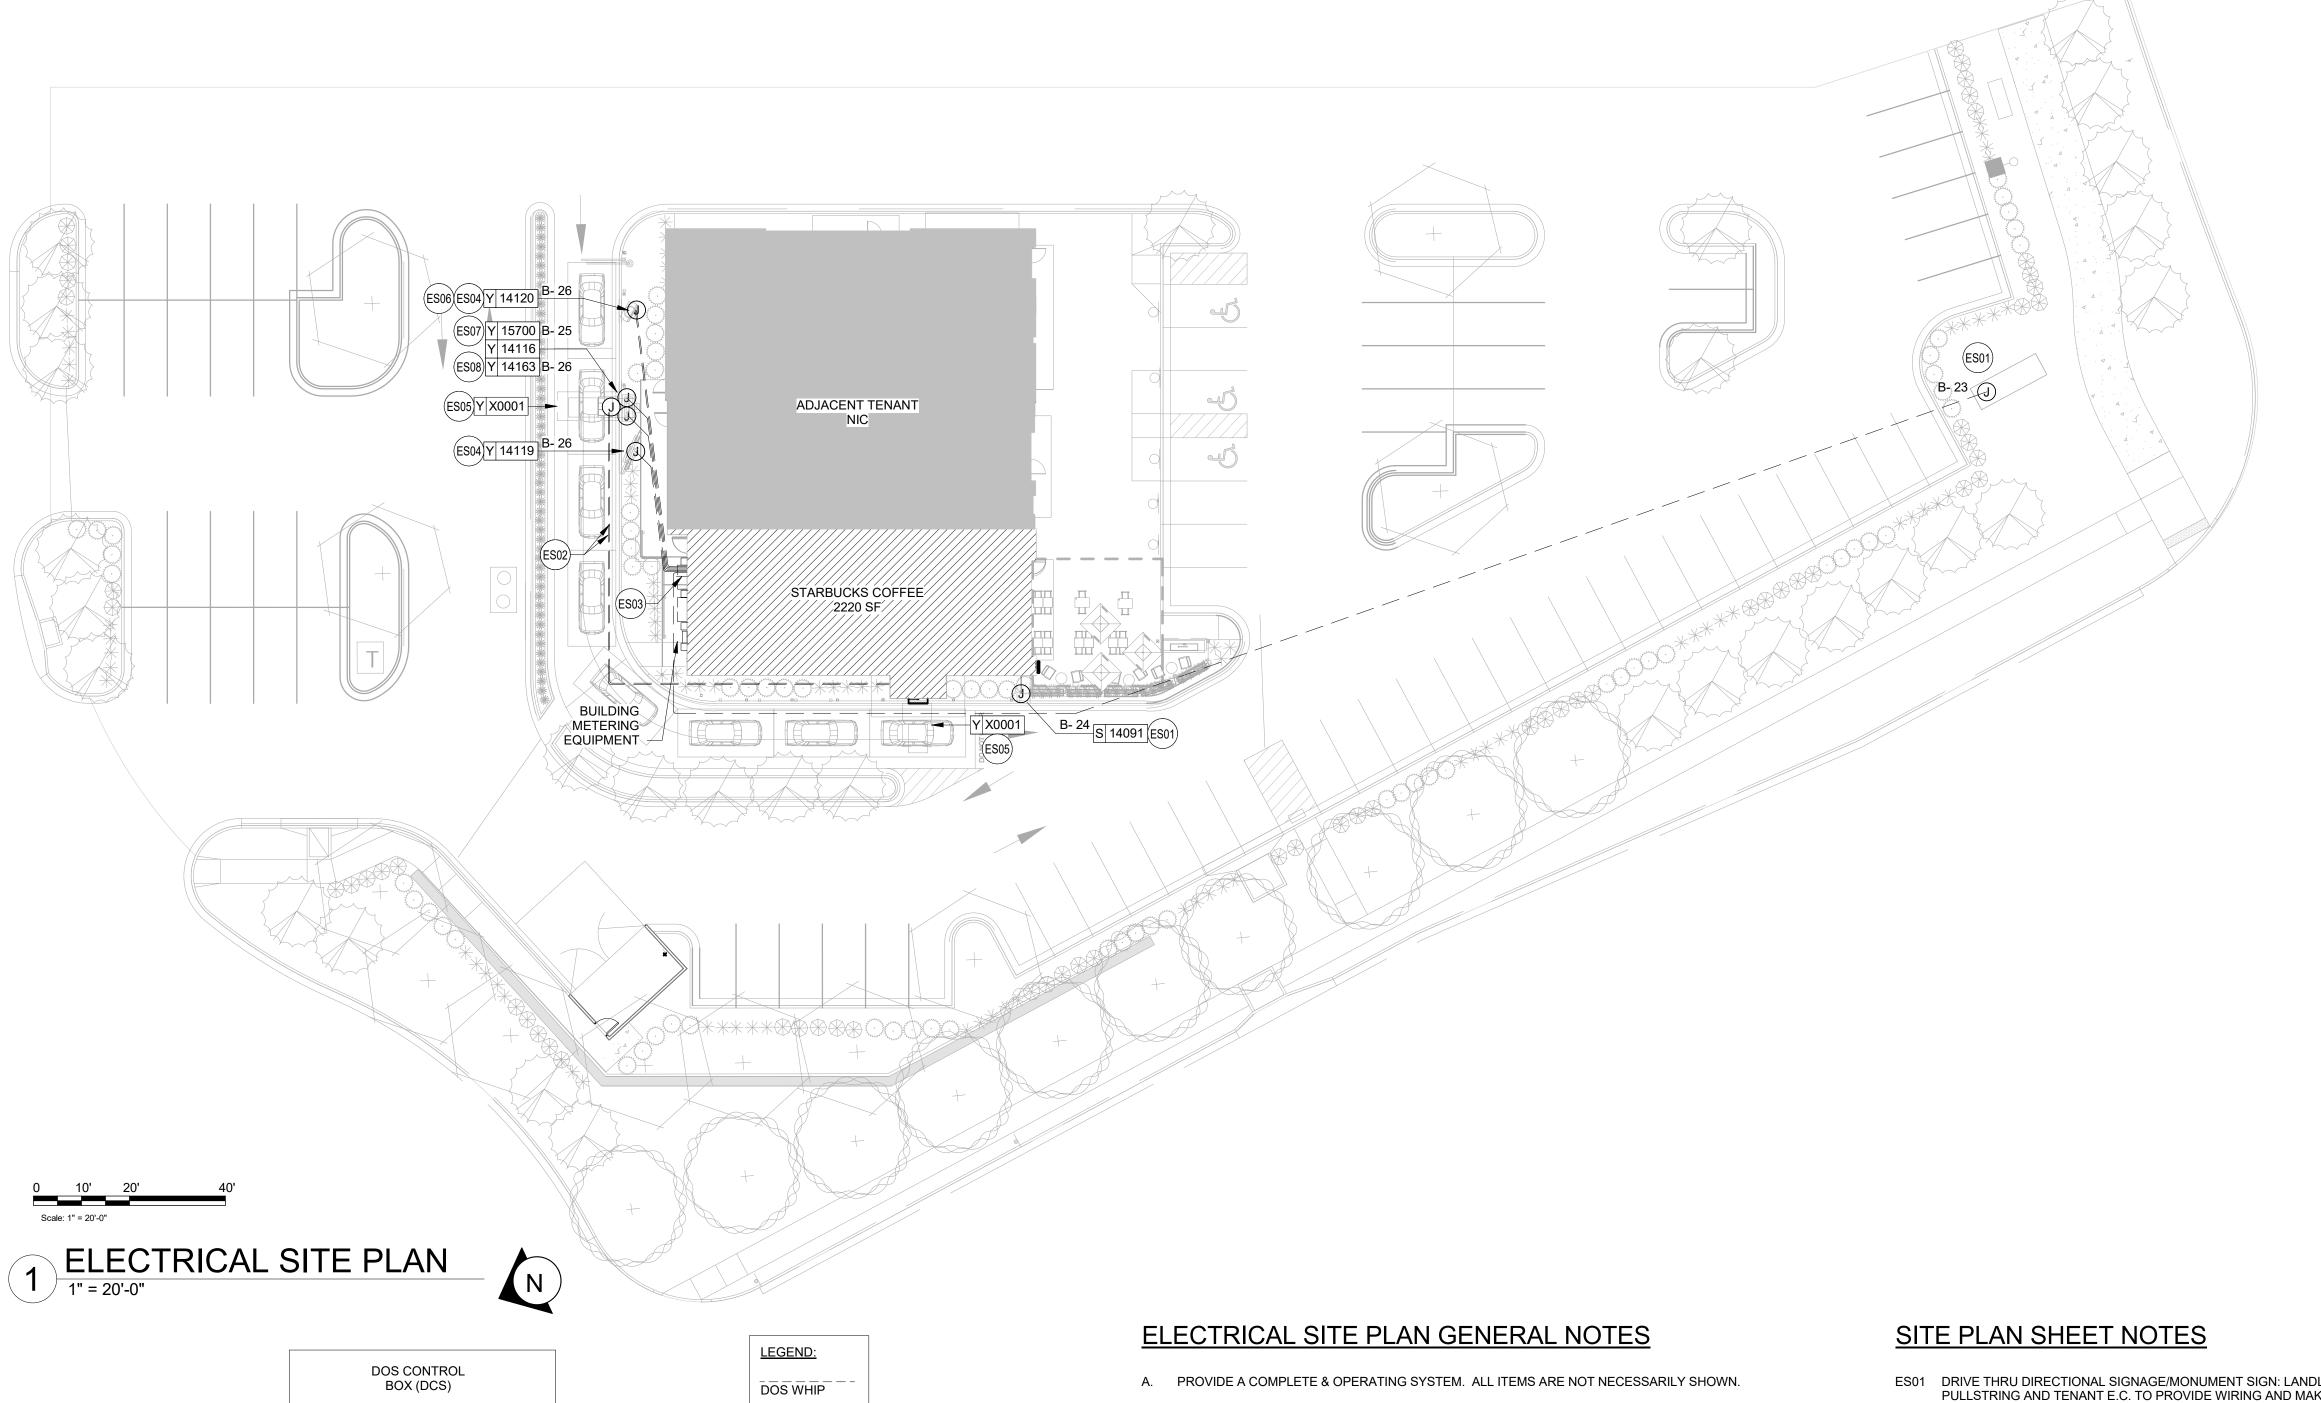

- TO PLACING BID AND/OR COMMENCING WORK.
- D. SEE ARCHITECTURAL SHEETS FOR FURTHER SIGNAGE INFORMATION AND EXACT LOCATIONS.

- 3. NO DARK AREAS ON SITE, INCLUDING TRASH ENCLOSURE.
- 4. LED LIGHTING PREFERRED. 6. TERMINATE INCOMING POWER ON TERMINAL BLOCKS

CONDUIT BY EC

SHOWN WITH GC AND VENDOR.

- LIQUID TIGHT FLEX 4. EC TO CONNECT DEDICATED POWER BETWEEN DOS

INCLUDING DOS WHIPS TO DCB.

LABELED DOS DEDICATED POWER.

LABELED INCOMING DEDICATED POWER.

VOLTAGE CONDUCTORS.

AND DCB.

1. ALL SHOWN SHALL BE INSTALLED PER THIS DETAIL,

2. CONFIRM MOUNTING POSITIONS OF ALL DEVICES

3. EC TO PROVIDE, INSTALL AND CONNECT ALL LINE

5. DCB VENDOR TO CONNECT ALL LOW VOLTAGE CABLING,

7. TERMINATE POWER TO DOS ON TERMINAL BLOCKS

8. POWER TO DCB SHALL BE INDIVIDUAL BRANCH CIRCUIT

IN DEDICATED CONDUIT (I.E. NOT BE ON EMS OR LIGHTING

CODE AND MANUFACTURER'S INSTRUCTIONS.

DOS POWER

BY VENDOR

(NOTE 7)

INCOMING

BY VENDOR

LINE VOLTAGE

CONDUCTORS

CONDUIT (TYP.)

1/2"C-POWER

TO DOS

CONCRETE

FOOTING

POWER

(NOTE 6)

TERMINAL BLOCK

TERMINAL BLOCK

- F. LANDLORD PROVIDED AND INSTALLED CONDUITS SHALL HAVE OPENINGS PROTECTED AND PULLWIRES LABELED SO VENDORS WILL KNOW WHICH CONDUITS TO USE.
- G. FURNISH AND INSTALL APPROPRIATE HAND HOLES WHERE NEEDED AND PER CODE TO INSTALL
- H. INCREASE SIZE OF CONDUCTORS INDICATED IF NEEDED TO ACCOUNT FOR VOLTAGE DROP.

- ES01 DRIVE THRU DIRECTIONAL SIGNAGE/MONUMENT SIGN: LANDLORD TO PROVIDE 1" CONDUIT WITH PULLSTRING AND TENANT E.C. TO PROVIDE WIRING AND MAKE FINAL CONNECTION AS REQUIRED. SEE ARCHITECTURAL PLANS FOR DETAILS. COORDINATE ROUTING OF LANDLORD PROVIDED
- ES02 LANDLORD TO PROVIDE TWO (2) 1" CONDUITS BELOW GRADE FROM DIGITAL ORDER SCREEN CONTROL BOX TO DRIVE-THRU WINDOW AREA AND TENANT E.C. TO PROVIDE WIRING AND MAKE FINAL CONNECTIONS. VERIFY ALL REQUIREMENTS WITH EQUIPMENT MANUFACTURER PRIOR TO COMMENCING WORK. COORDINATE ROUTING OF LANDLORD PROVIDED CONDUITS IN FIELD.
- ES03 LANDLORD TO PROVIDE ONE (1) SPARE 1" CONDUIT BELOW GRADE THROUGH FOUNDATION WALL OF BUILDING, CAPPED AND TERMINATED ABOVE INTERIOR CEILING FOR FUTURE USE AT THE REAR OF SPACE. VERIFY LOCATIONS FOR STUB UP WITH STARBUCKS REPRESENTATIVE PRIOR TO COMMENCING WORK.
- ES04 LANDLORD TO PROVIDE ONE (1) 1" CONDUIT BELOW GRADE WITH PULLSTRING FROM DRIVE-THRU EQUIPMENT TO ELECTRICAL PANELS AND TENANT E.C. TO PROVIDE WIRING AND MAKE FINAL CONNECTION AS REQUIRED. VERIFY ALL REQUIREMENTS WITH EQUIPMENT MANUFACTURER PRIOR TO COMMENCING WORK. COORDINATE ROUTING OF CONDUIT IN FIELD. COORDINATE WITH OWNER AND STARBUCKS REPRESENTATIVE PRIOR TO COMMENCING WORK.
- ES05 LANDLORD TO PROVIDE ONE (1) 1" CONDUIT WITH PULLSTRING FOR EACH OF TWO DETECTOR LOOP SETS (ONE AT THE SPEAKER POST AND THE OTHER AT THE DRIVE THRU WINDOW) AND TENANT E.C. TO PROVIDE WIRING AND MAKE FINAL CONNECTIONS.
- ES06 LANDLORD TO PROVIDE 1" CONDUIT BELOW GRADE WITH PULLSTRING FROM PRE-MENU BOARD TO BUILDING FOR FUTURE USE.
- ES07 LANDLORD TO PROVIDE ONE (1) 1" CONDUIT WITH PULL STRING FROM TO ELECTRICAL PANEL TO DRIVE-THRU DOS CONTROL BOX. PROVIDE FINAL CONNECTION TO DOS CONTROL BOX AS REQUIRED. SEE DETAIL #2 ON THIS SHEET FOR MORE INFORMATION.
- ES08 PROVIDE ONE (1) 1" CONDUIT, WIRING, AND FINAL CONNECTION FOR POWER TO CANOPY LIGHTING. SEE ARCHITECTURAL SHEETS FOR CONDUIT STUB-UP DETAILS AND ADDITIONAL INFORMATION.



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62012 87799-001 07-07-2020 SR. DESIGN MANAGER: K. GORIN SLONSKI

PRODUCTION DESIGNER: A. HAHN NJD/BMS

> **Revision Schedule** Description

ELECTRICAL SITE PLAN

SCALE: AS SHOWN

STORE #:

ISSUE DATE:

CHECKED BY:

PROJECT #:

SHEET NUMBER: E003

DTE - DOS CONTROL BOX WIRING scale: NTS

LOW

**VOLTAG** 

E SIDE

INTERIOR

PARTITION

REFERENCE

SHOWN

VOLTAGE

SIDE

DIGITAL

ORDER

SCREEN (DOS)

1/2"C-

SPEAKER

1/2"C-AUDIO/

VIDEO CABELS

COUPLINGS (TYP.)

1" C-CAMERA

3/4" C-FROM DETECTOR LOOP

1" C-DETECTOR LOOP/SPEAKER MIC -

1"C-DCB INCOMING POWER (NOTE 8)

B. CONTRACTOR IS RESPONSIBLE FOR SITE INVESTIGATION PRIOR TO START OF WORK TO REVEAL THE FULL SCOPE OF WORK.

C. REVIEW ALL CIVIL DRAWINGS AND COORDINATE EXISTING CONDUIT ROUTES WITH LANDLORD PRIOR

E. EXTERIOR SITE LIGHTING TO BE ON A PHOTO-ELECTRICAL CELL. LIGHTING REQUIREMENTS:

1. MINIMUM LIGHT LEVELS OF 1.5 FOOT CANDLES AT 30" AFF IN PATIO AREAS.

2. MINIMUM LIGHT LEVELS OF 1.5 FOOT CANDLES AT PAVED AREAS.

#### ELECTRICAL STUB UP DETAIL - POS

TO ELECTRICAL PANEL (CUP

LABELER/PRINTER)

ALL CONDUIT STUB UPS TO BE WITHIN THIS BOUNDARY 1" DATA TO MANAGER'S DESK 1" POWER CONDUIT TO ELECTRICAL (FUTURE) PANEL (FUTURE) 3/4" DATA TO MANAGER'S DESK (CUP 1" POWER CONDUIT TO ELECTRICAL LABELER/PRINTER) PANEL (U/C REFRIG./INSTA-HOT) 3/4" ISOLATED GROUND POWER CONDUIT 3/4" POWER CONDUIT TO ELECTRICAL

#### ELECTRICAL STUB UP DETAIL - ESPRESSO

PANEL (ESPRESSO MACHINE)

PANEL (ESPRESSO MACHINE)

3/4" POWER CONDUIT TO ELECTRICAL

SCALE: NTS

#### **ELECTRICAL DESIGN NOTES**

- A. REFER TO ARCHITECTURAL DETAIL SHEETS FOR EXACT LOCATIONS AND MOUNTING HEIGHTS OF ELECTRICAL DEVICES.
- THE ELECTRICAL CONTRACTOR IS RESPONSIBLE FOR CONFIRMING ALL VOLTAGE REQUIREMENTS
- ELECTRICAL CONTRACTOR SHALL COORDINATE WITH PLUMBING AND HEATING, VENTILATING, AND AIR CONDITIONING (HVAC) CONTRACTORS FOR ANY ADDITIONAL EQUIPMENT NEEDING POWER.
- D. ALL FUTURE EQUIPMENT NEEDED HEREIN SHALL BE PROVIDED WITH AN APPROPRIATE RECEPTACLE AND FULLY WIRED. EVEN IF NOT SPECIFICALLY INDICATED.
- GROUND FAULT CIRCUIT INTERRUPTER (GFCI) BREAKERS (NOT RECEPTACLES) SHALL BE UTILIZED WHERE RÉQUIRED BY CODE AND AT ANY FLOOR BOXES. PROVIDE DEDICATED NEUTRAL WIRE FOR ALL THESE CIRCUITS.
- EQUIPMENT REQUIRES CONNECTION TO THE BUILDING ELECTRICAL SYSTEM. FURNISH AND INSTALL ALL NECESSARY CONDUIT, WIRE, CONNECTIONS, RECEPTACLES AND OVERCURRENT PROTECTION NECESSARY TO ENSURE THE EQUIPMENT FUNCTIONS PROPERLY AND COMPLIES WITH ALL APPLICABLE LOCAL AND NATIONAL CODES. COORDINATE EQUIPMENT REQUIREMENTS WITH MANUFACTURER CUT SHEET PRIOR TO ROUGH-IN.
- ALL BACK BAR AND FRONT BAR J-BOXES AND OUTLETS SHALL BE SURFACE MOUNTED. PROVIDE CONDUITS AS NEEDED AND ONE (1) ADDITIONAL SPARE CONDUIT BETWEEN ALL J-BOXES FOR FUTURE ELECTRICAL REQUIREMENTS. ALL J-BOXES SHALL BE POSITIONED TO AVOID OBSTRUCTION OF ANY EQUIPMENT SUCH AS REFRIGERATORS AND DISHWASHERS.
- REFERENCE LANDLORD WORK LETTER FOR DIVISION OF ELECTRICAL SCOPE OF WORK AND COORDINATE WITH STARBUCKS CONSTRUCTION MANAGER.
- I. ALL UNDERSLAB WORK BY STARBUCKS CONTRACTOR.
- REFER TO CALLOUTS DETAILS INDICATED ON SHEET FOR ADDITIONAL INFORMATION.

#### EF-1 A- 1 E02 9' - 6 1/2" (E11) (E06) B- 19 🖰 E103 -ROUTE CONDUIT UNDERSLAB TO ELECTRICAL PANELS (E04) 🛱 (E09) B- 19 🔂 E16 A- 14 3' - 6" 3' - 7" 1 POWER PLAN 1/4" = 1'-0"

#### **POWER PLAN SHEET NOTES**

- E01 PROVIDE ELECTRICAL CONNECTION TO WATER HEATER. CONFIRM ELECTRICAL REQUIREMENTS PRIOR TO ROUGH-IN.
- E02 LANDLORD TO PROVIDE ROUGH-IN AND FINAL CONNECTION TO RESTROOM EXHAUST FAN. FAN TO BE CONTROLLED BY TIMECLOCK. CONNECT TO TIMECLOCK AS REQUIRED. SEE TIMECLOCK DETAIL ON SHEET E102 FOR MORE INFORMATION.
- E03 REFRIGERATOR AND/OR FREEZER: PROVIDE RECEPTACLE AS SHOWN AT 84" AFF. DETAIL 5 ON SHEET E501 FOR MORE INFORMATION.
- E04 ICE MACHINE: PROVIDE ROUGH-IN AND FINAL CONNECTION. PROVIDE CONNECTION TO REMOTE CONDENSER LOCATED ON ROOF. FURNISH AND INSTALL ALL NECESSARY CONDUIT, WIRE CONNECTIONS AND BREAKERS TO SUPPORT ICE MACHINE AND REMOTE CONDENSER LOCATED ON ROOF.
- E05 WAREWASHER: PROVIDE AND INSTALL NEMA 14-50R RECEPTACLE TO SUPPORT WAREWASHER. VERIFY ALL REQUIREMENTS WITH EQUIPMENT SUPPLIER PRIOR TO COMMENCING WORK INCLUDING, BUT NOT LIMITED TOO, PROVISION OF POWER CORD ACCESSORY KIT WITH NEMA 14-50P PLUG.
- E06 PROVIDE 1" CONDUIT WITH POWER TO BANQUETTE FOR POWER TO BANQUETTE MOUNTED RECEPTACLES. VERIFY EXACT ROUGH-IN AND CONNECTION REQUIREMENTS WITH FURNITURE MANUFACTURER PRIOR TO COMMENCING WORK. COORDINATE LOCATION OF FLOOR PENETRATION AND ROUTING OF 1" CONDUIT PRIOR TO COMMENCING WORK.
- E07 PROVIDE RECEPTACLE AT 18" A.F.F. IN SEATING AREAS.
- E08 STUB UP POWER, DATA, AND PHONE CONDUITS 6" AFF IN THIS LOCATION. ROUTE POWER CONDUCTORS IN FLEXIBLE METAL CONDUIT TIGHT TO WALL FROM RECEPTACLES TO NEARBY RIGID STUB-UP AND BACK TO SERVING POWER PANEL. ROUTE DATA AND PHONE CONDUITS UNDERFLOOR BACK TO DATA RACK NEAR MANAGERS WORKSTATION. LABEL DATA AND PHONE CONDUITS "FOR DATA CABLING". PROVIDE INSULATED BUSHINGS, AND PROVIDE PULL STRING FROM END TO END. LABEL SECURITY CONDUIT "FOR SECURITY" AND PROVIDE PULL STRING FROM END TO END. SEE DETAIL INDICATED FOR MORE INFORMATION.
- E09 MANAGER'S DESK: FURNISH AND INSTALL ALL NECESSARY POWER AND DATA ROUGH-INS FOR MANAGER'S DESK FOUIPMENT. ALL RECEPTACIES TO BE ISOLATED-GROUNDING TYPE RECEPTACLES WITH SURGE PROTECTION. SEE MANAGER'S DESK ELEVATIONS AND MANAGER'S DESK PLAN VIEW DETAILS INDICATED FOR EXACT ROUGH-IN TYPES, QUANTITIES, LOCATIONS, DIMENSIONS, AND
- E10 HAND DRYER/SOAP DISPENSER/FAUCET: FURNISH AND INSTALL CIRCUIT AND ROUGH-IN AT 14-13/16" A.F.F. ON GFI CIRCUIT BREAKER SIZED PER CODE TO SUPPORT INTEGRATED SINK EQUIPMENT. VERIFY EXACT ROUGH-IN LOCATION WITH MANUFACTURE AND EQUIPMENT PROVIDED PRIOR TO COMMENCING WORK.
- E11 FURNISH AND INSTALL CEILING MOUNTED SHOW WINDOW RECEPTACLE. RECEPTACLES ARE TO BE PLACED WITHIN 18" OF WINDOW. COORDINATE EXACT RECEPTACLE AND COVER PLATE COLOR WITH OWNER PRIOR TO COMMENCING WORK.
- E12 PROVIDE SERVICE RECEPTACLE AT ELECTRICAL PANELS. VERIFY HEIGHT WITH OWNER PRIOR TO COMMENCING WORK.
- E13 PROVIDE ROUGH-IN AND FINAL CONNECTION TO HOT WATER RETURN PUMP. SEE PLUMBING SHEETS FOR MORE INFORMATION. VERIFY ALL REQUIREMENTS WITH EQUIPMENT MANUFACTURER PRIOR TO COMMENCING WORK. COORDINATE ALL WORK WITH PLUMBING CONTRACTOR IN FIELD.
- E14 LANDLORD TO PROVIDE ROUGH-IN AND FINAL CONNECTION TO NEW RTU. RTU-MOUNTED DISCONNECT AND SERVICE RECEPTACLE TO BE FACTORY INSTALLED AND CIRCUITED BY LANDLORD. SHOWN FOR REFERENCE ONLY.
- E15 PROVIDE ROUGH-IN AND FINAL CONNECTION FOR BOOSTER PUMP AS REQUIRED. VERIFY REQUIREMENTS WITH LANDLORD AND PLUMBING CONTRACTOR PRIOR TO COMMENCING WORK.
- E16 EXISTING EXTERIOR WEATHER PROOF RECEPTACLE PROVIDED AND INSTALLED BY LANDLORD TO REMAIN AND BE REUSED. SHOWN FOR REFERENCE ONLY.
- LANDLORD TO PROVIDE AND INSTALL WEATHERPROOF GFCI DUPLEX RECEPTACLE FOR WALL MOUNTED FAN. VERIFY EXACT HEIGHT WITH GC IN FIELD PRIOR TO INSTALLATION. FANS TO BE SWITCHED TO RUN INDEPENDENTLY FROM PATIO LIGHTING. VERIFY WITH OWNER AND GC PRIOR TO INSTALLATION OF FAN SWITCH FOR
- E18 LANDLORD TO PROVIDE AND INSTALL WALL MOUNTED WEATHERPROOF GFCI DUPLEX RECEPTACLE FOR PATIO LIGHTING. VERIFY EXACT HEIGHT WITH GC IN FIELD PRIOR TO INSTALLATION. PATIO LIGHTING FIXTURES SHALL BE CONTROLLED VIA ASTRONOMICAL TIME CLOCK WITH EXTERIOR LIGHTING. SEE CONTACTOR DETAIL ON SHEET E102 FOR MORE INFORMATION.



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PRODUCTION DESIGNER: A. HAHN NJD/BMS Revision Schedule

POWER PLAN

SCALE: AS SHOWN


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# 2 LIGHTING CONTROL DIAGRAM SCALE: NTS

dsw "b" dsw "c" CKT B-2 CKT B-2 CKT B-2 RETAIL GENERAL BACKBAR LIGHTING LIGHTING LIGHTING sw "e" dsw "f" CKT B-2 CKT B-2 CKT B-2 BACKBAR MOP SIGN LED TAPE TRACK LIGHTING LIGHTING - sw: SWITCH - dsw: DIMMER SWITCH - COORDINATE FINAL SWITCH BANK LOCATION WITH OWNER. - INDICATE EACH SWITCH WITH PERMANENT LABEL PER CODE - VERIFY SWITCH COMPATIBILITY WITH MANUFACTURER

#### IGHTING SWITCHBANK DETAIL

#### **EGRESS LIGHTING NOTES**

- A. EXIT SIGNS SHALL BE INTERNALLY ILLUMINATED, LISTED AND LABELED IN ACCORDANCE WITH UL 924 AND INSTALLED IN ACCORDANCE WITH THE MANUFACTURER'S INSTRUCTIONS.
- B. ANYTIME A BUILDING OR A PORTION OF A BUILDING IS OCCUPIED, THE MEANS OF EGRESS SERVING THE OCCUPIED PORTION SHALL BE ILLUMINATED AT AN INTENSITY OF NOT LESS THAN 1 FOOT CANDLE (11 LUX) AT THE WALKING SURFACE LEVEL.
- C. THE POWER SUPPLY FOR MEANS OF EGRESS ILLUMINATION SHALL BE PROVIDED BY THE PREMISE'S ELECTRICAL SUPPLY, IN THE EVENT OF POWER SUPPLY FAILURE, ILLUMINATION SHALL BE AUTOMATICALLY PROVIDED FROM AN EMERGENCY SYSTEM FOR THE FOLLOWING AREAS.
  - 1) AISLES AND UNENCLOSED EGRESS STAIRWAYS IN ROOMS AND SPACES THAT REQUIRE TWO OR MORE MEANS OF EGRESS.
  - 2) CORRIDORS, INTERIOR EXIT STAIRWAYS & RAMPS AND EXIT PASSAGEWAYS IN BUILDINGS REQUIRED TO HAVE TWO OR MORE EXITS.
  - 3) EXTERIOR EGRESS COMPONENTS AT OTHER THAN THE LEVEL OF EXIT DISCHARGE UNTIL EXIT DISCHARGE IS ACCOMPLISHED FOR BUILDINGS REQUIRED TO HAVE TWO OR MORE EXITS.
  - 4) INTERIOR EXIT DISCHARGE ELEMENTS, AS REQUIRED BY CODE IN BUILDINGS REQUIRED TO HAVE TWO OR MORE EXITS.
  - 5) EXTERIOR LANDINGS, AS REQUIRED BY CODE, EXIT DISCHARGE DOORWAYS IN BUILDING REQUIRED TO HAVE TWO OR MORE EXITS.
- D. THE EMERGENCY POWER SYSTEM SHALL ALSO BE CONNECTED TO AN EMERGENCY ELECTRICAL SYSTEM WHICH IS TO PROVIDE CONTINUED ILLUMINATION FOR A DURATION OF NOT LESS THAN 1 1/2 HOUR IN CASE OF PRIMARY POWER LOSS. CONTINUED ILLUMINATION IS TO BE PROVIDED FROM STORAGE BATTERIES, UNIT EQUIPMENT OR AN ON-SITE GENERATOR AND THE INSTALLATION OF THE EMERGENCY POWER SYSTEM SHALL BE INSTALLED IN ACCORDANCE WITH THE MANUFACTURER'S INSTRUCTIONS.

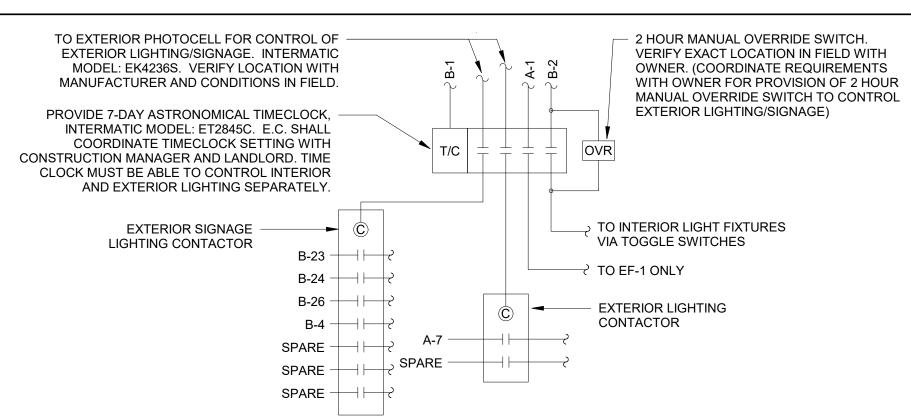EMERGENCY LIGHTING FACILITIES SHALL BE ARRANGED TO PROVIDE INITIAL ILLUMINATION THAT IS AT LEAST AN AVERAGE OF 1 FOOT CANDLE (11 LUX) AND A MINIMUM AT ANY POINT OF 0.1 FOOT CANDLE (1 LUX) MEASURED ALONG THE PATH OF EGRESS AT FLOOR LEVEL. A MAXIMUM TO MINIMUM ILLUMINATION UNIFORMITY RATION OF 40:1 SHALL NOT BE EXCEEDED.

#### LIGHTING DESIGN PLAN NOTES

- REFER TO ARCHITECTURAL PLANS FOR DIMENSIONED FIXTURE LOCATIONS.
- ALL FIXTURES IN WORK ROOM, BACK AND FRONT LINE, ABOVE CONDIMENT CART, AND ANY OTHER AREAS WHERE EXPOSED FOOD, CLEAN EQUIPMENT OR UTENSILS, OR UNWRAPPED SINGLE SERVICE ITEMS WILL BE EXPOSED, SHALL HAVE SHATTERPROOF LAMPS IF THE FIXTURE IS NOT LENSED. ARCHITECT OF RECORD TO INCLUDE APPROPRIATE LAMPS / FIXTURES ON DRAWINGS AND SCHEDULES, AND COMPLY WITH ANY ADDITIONAL JURISDICTIONAL LIGHTING REQUIREMENT.
- PROVIDE GROMMET AT ALL CEILING PENETRATIONS FOR FIXTURES/SUPPORTS.
- D. CENTER EMERGENCY/EXIT LIGHTS ABOVE DOORS, UNLESS OTHERWISE NOTED.
- ADJUST FOCUS OF ALL TRACK AND RECESSED DIRECTIONAL LIGHTING TO FULLY ILLUMINATE ALL ARTWORK, MENU BOARDS, AND MERCHANDISE BAYS.
  - IF PENDANT CYLINDERS CAN SUSPENDED LENGTH EXCEEDS 48" (1220MM) FROM CEILING, REPLACE WITH SURFACE MOUNTED CYLINDER CANS AND SUSPEND WITH GENERAL CONTRACTOR SUPPLIED CONDUIT AND J-BOX TO DIMENSIONED HEIGHT.
- CONTRACTOR SHALL FURNISH AS-BUILTS DRAWINGS FOR ELECTRICAL POWER SYSTEMS WITHIN 30 DAYS OF SYSTEM ACCEPTANCE.
- CONTRACTOR TO FURNISH OPERATIONS AND MAINTENANCE INSTRUCTIONS FOR SYSTEMS AND EQUIPMENT TO THE BUILDING OWNER OR DESIGNATED REPRESENTATIVE UPON COMPLETION.
- CONTRACTOR TO VERIFY LIGHTING SYSTEMS HAVE BEEN TESTED TO ENSURE PROPER CALIBRATION, ADJUSTMENT, PROGRAMING, AND OPERATION.
- J. ALL EMERGENCY LIGHTING TO BE CIRCUITED TO LOCAL LIGHTING CIRCUIT AHEAD OF ANY SWITCHING OR TIMECLOCK CONTROLS UNLESS NOTED OTHERWISE.
- K. ALL EXIT SIGNS TO BE ON DEDICATED CIRCUIT INDICATED ON

#### **LIGHTING PLAN SHEET NOTES**

- PROVIDE QUADPLEX RECEPTACLES AND DUAL DATA CONNECTIONS L01 BEHIND MENUBOARD, DATA LINES SHALL RUN FROM MENUBOARD PORT TO DATA RACK AT MANAGER'S DESK. QUANTITY AND LOCATIONS OF ROUGH-INS SHOWN FOR REFERENCE ONLY. FIELD VERIFY EXACT MOUNTING HEIGHT AND LOCATION WITH GENERAL CONTRACTOR PRIOR TO COMMENCING WORK.
- INTERIOR LIGHTING FIXTURES SHALL BE CONTROLLED VIA SWITCH BANK AND ASTRONOMICAL TIME CLOCK. SEE DETAILS 2 & 3 ON THIS SHEET FOR MORE INFORMATION. VERIFY EXACT LOCATION WITH OWNER PRIOR TO COMMENCING WORK. TIME CLOCK SHALL BE LOCATED ADJACENT TO ELECTRICAL PANELS. FURNISH AND INSTALL ALL CONDUIT, WIRE, CONNECTIONS AND TIME CLOCK MODULES NECESSARY TO INSURE A FUNCTIONAL TIME CLOCK SYSTEM.
- LOCATION OF SWITCH BANK SHOWN FOR REFERENCE ONLY. COORDINATE EXACT LOCATION FOR SWITCH BANK WITH GENERAL CONTRACTOR PRIOR TO COMMENCING WORK.
- CIRCUIT SERVING EXTERIOR SIGNAGE SHALL BE CONTROLLED BY L04 ASTRONOMICAL TIME CLOCK. PHOTOCELL AND LIGHTING CONTACTOR TIME CLOCK SHALL BE LOCATED ADJACENT TO ELECTRICAL PANELS. VERIFY LOCATION OF PHOTOCELL WITH MANUFACTURER. FURNISH AND INSTALL ALL CONDUIT, WIRE, CONNECTIONS AND TIME CLOCK MODULES NECESSARY TO INSURE A FUNCTIONAL TIME CLOCK SYSTEM IF LANDLORD PROVIDED SYSTEM IS NOT ADEQUATE. SEE DETAIL 2 ON THIS SHEET FOR MORE INFORMATION.
- E.C. SHALL PROVIDE ROUGH-IN AND FINAL CONNECTION TO STOREFRONT SIGN. FIELD VERIFY EXACT MOUNTING HEIGHT AND LOCATION WITH OWNER PRIOR TO COMMENCING WORK AND/OR PLACING BID. PROVIDE ALL CONNECTIONS AND EQUIPMENT NECESSARY TO MEET ALL LOCAL CODES AND SIGNAGE REQUIREMENTS. VERIFY WITH SIGN VENDOR AND LOCAL AUTHORITY HAVING JURISDICTION PRIOR TO COMMENCING WORK. REUSE EXISTING CONDUIT AND PENETRATIONS PROVIDED BY LANDLORD WHERE POSSIBLE. VERIFY WITH CONDITIONS IN FIELD.
- LANDLORD TO PROVIDE, CIRCUIT, INSTALL, AND CONTROLL EXTERIOR LIGHT FIXTURE. SHOWN FOR REFERENCE ONLY.
- PROVIDE AND INSTALL EXTERIOR EGRESS LIGHTING IF NOT EXISTING BY LANDLORD. REUSE EXISTING EGRESS LIGHTING PROVIDED BY LANDLORD AND CONNECT TO NEW EXIT/EMERGENCY LIGHT IF COMPATIBLE, PROVIDE NEW IF NECESSARY. VERIFY WITH CONDITIONS IN FIELD PRIOR TO COMMENCING WORK.
- PATIO STRING LIGHTING TO BE POWERED BY WALL MOUNTED RECEPTACLE PROVIDED AND INSTALLED BY LANDLORD. LIGHTING TO BE CONTROLLED BY ASTRONOMICAL TIME CLOCK, PHOTOCELL AND LIGHTING CONTACTOR. SEE DETAIL 2 ON THIS SHEET FOR MORE INFORMATION.
- PROVIDE ROUGH-IN AND FINAL CONNECTION TO MOP SIGN. VERIFY EXACT ROUGH-IN AND CONTROL REQUIREMENTS WITH OWNER AND EQUIPMENT PROVIDED IN FIELD.
- PROVIDE AND INSTALL ALL EQUIPMENT NECESSARY FOR LED TAPE LIGHTING AT BAR INCLUDING, BUT NOT LIMITED TOO, LED DRIVER(S) AND ADDITIONAL CONNECTIONS. VERIFY EXACT QUANTITY AND LOCATION OF LED DRIVERS AND ADDITIONAL EQUIPMENT. LIGHTING SHALL BE CONTROLLED VIA SWITCH BANK AND ASTRONOMICAL TIME CLOCK. SEE DETAILS 2 & 3 ON THIS SHEET FOR MORE INFORMATION.



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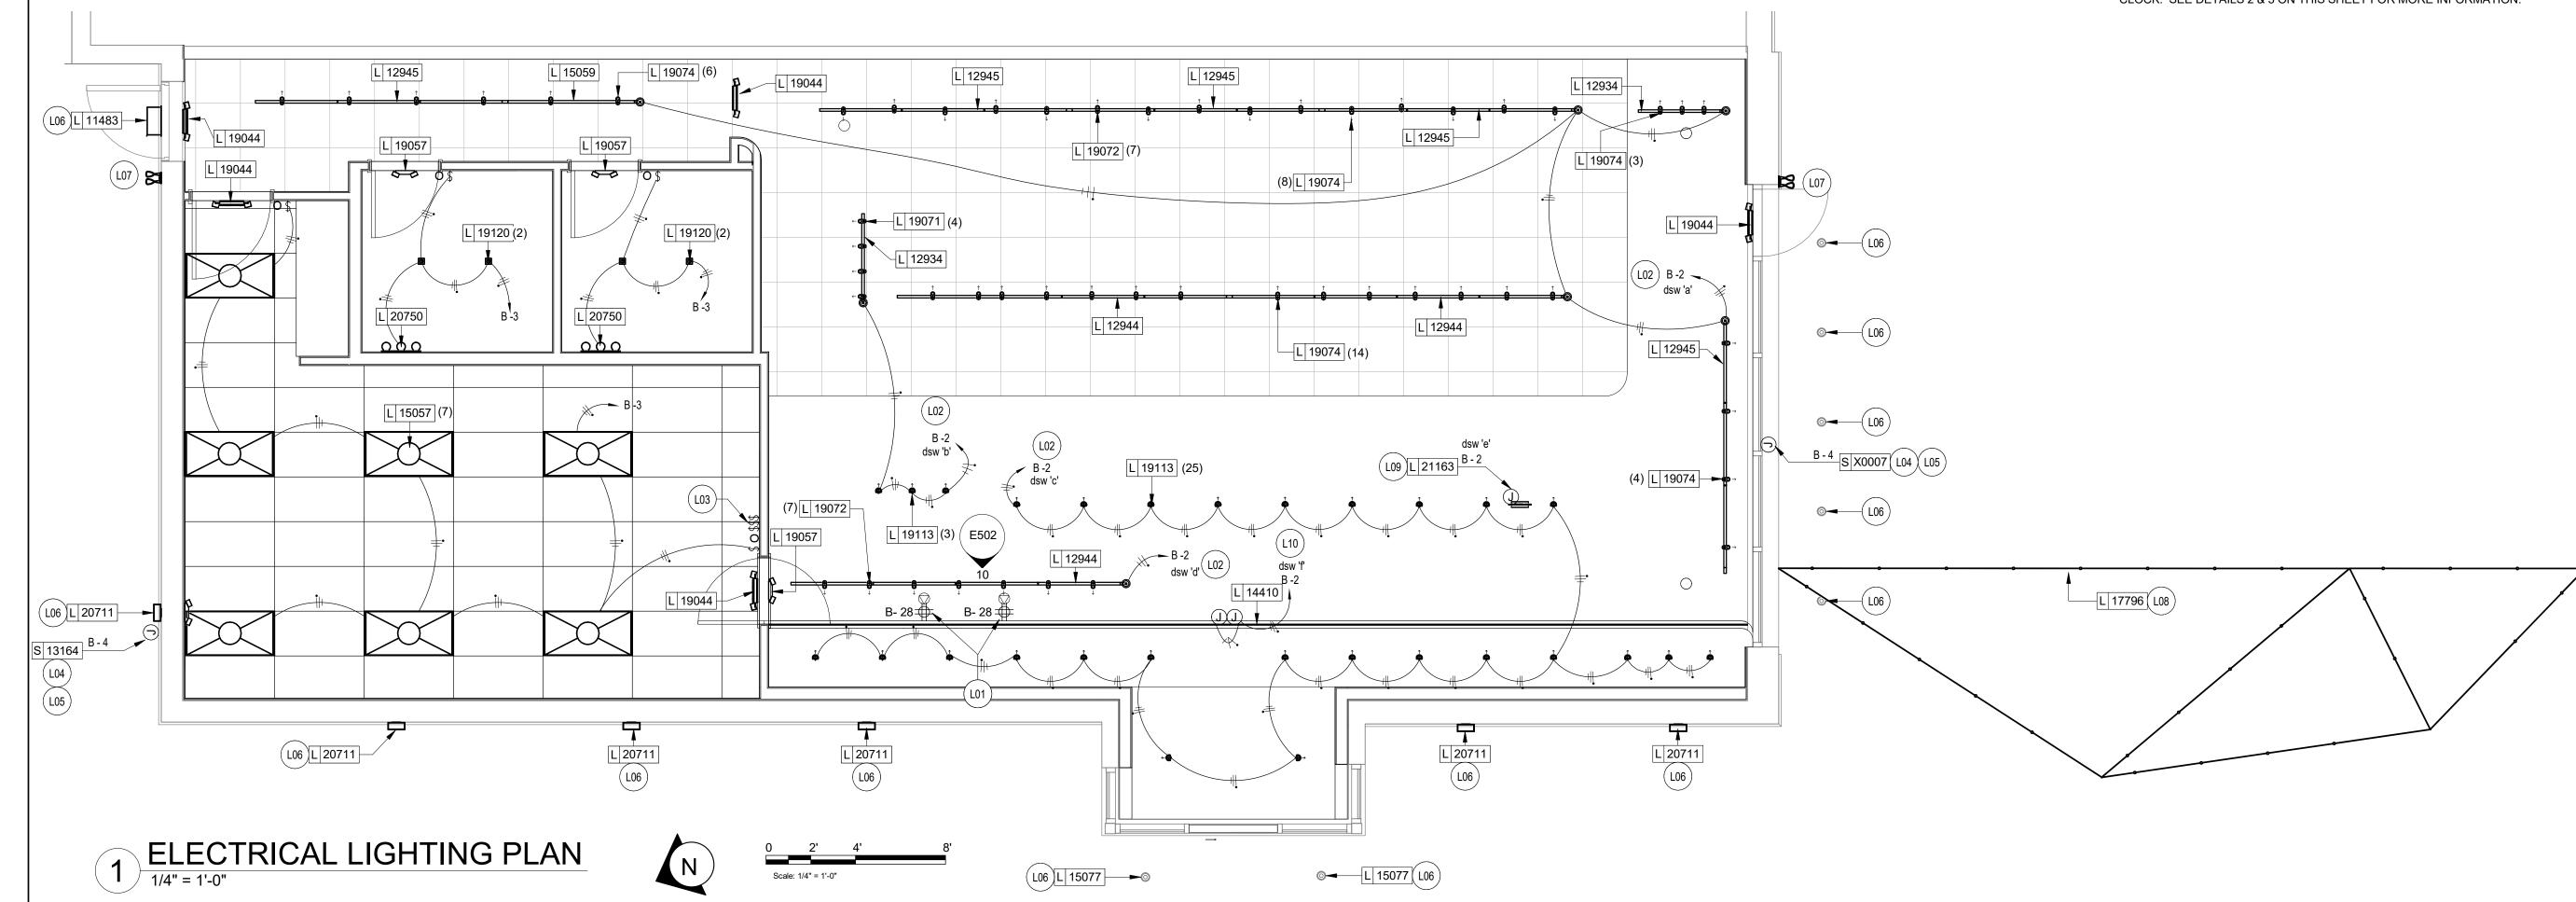


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62012 87799-001 SR. DESIGN MANAGER: K. GORIN SLONSKI PRODUCTION DESIGNER: A. HAHN

ELECTRICAL LIGHTING PLAN

SCALE: AS SHOWN SHEET NUMBER:



#### ENLARGED ELECTRICAL GENERAL NOTES

- REFER TO ELECTRICAL DETAIL SHEETS FOR EXACT LOCATIONS AND MOUNTING HEIGHTS OF ELECTRICAL DEVICES.
- THE ELECTRICAL CONTRACTOR IS RESPONSIBLE FOR CONFIRMING ALL VOLTAGE REQUIREMENTS ON ALL EQUIPMENT AND PROVIDING BUCK-BOOST TRANSFORMERS AS MAY BE NEEDED PER MANUFACTURER'S RECOMMENDATIONS OR FOR CODE. ALL ARE NOT NECESSARILY INDICATED.
- ELECTRICAL CONTRACTOR SHALL COORDINATE WITH PLUMBING AND HEATING. VENTILATING, AND AIR CONDITIONING (HVAC) CONTRACTORS FOR ANY ADDITIONAL EQUIPMENT NEEDING POWER.
- ANY EQUIPMENT NOTED AS 'FUTURE' SHALL BE PROVIDED WITH APPROPRIATE RECEPTACLES AND WIRING TO ENABLE FUTURE OPERATION.
- GROUND FAULT CIRCUIT INTERRUPTER (GFCI) BREAKERS (NOT RECEPTACLES) SHALL BE UTILIZED WHERE REQUIRED BY CODE AND AT ANY FLOOR BOXES. PROVIDE DEDICATED NEUTRAL WIRE FOR ALL THESE CIRCUITS.
- EQUIPMENT REQUIRES CONNECTION TO THE BUILDING ELECTRICAL SYSTEM. FURNISH AND INSTALL ALL NECESSARY CONDUIT, WIRE, CONNECTIONS, RECEPTACLES AND OVERCURRENT PROTECTION NECESSARY TO ENSURE THE EQUIPMENT FUNCTIONS PROPERLY AND COMPLIES WITH ALL APPLICABLE LOCAL AND NATIONAL CODES. COORDINATE EQUIPMENT REQUIREMENTS WITH MANUFACTURER CUT SHEET PRIOR TO ROUGH-IN.
- ALL BACK BAR AND FRONT BAR J-BOXES AND OUTLETS SHALL BE SURFACE MOUNTED. PROVIDE CONDUITS AS NEEDED AND ONE (1) ADDITIONAL SPARE CONDUIT BETWEEN ALL J-BOXES FOR FUTURE ELECTRICAL REQUIREMENTS. ALL J-BOXES SHALL BE POSITIONED TO AVOID OBSTRUCTION OF ANY EQUIPMENT SUCH AS REFRIGERATORS AND DISHWASHERS.
- REFERENCE LANDLORD WORK LETTER FOR DIVISION OF ELECTRICAL SCOPE OF WORK AND COORDINATE WITH STARBUCKS CONSTRUCTION MANAGER.
- ALL DATA OUTLETS TO BE ROUTED BACK TO DATA RACK AT MANAGER'S DESK WITH 3/4" UNLESS NOTED OTHERWISE.
- DIMENSION TO BOXED TOGETHER ROUGH-INS IN CASWORK INDICATING CENTERLINE OF ROUGH-IN GROUP.

#### **ENLARGED ELECTRICAL SHEET NOTES**

- EL01 PROVIDE ROUGH-IN(S) @ 26" AFF. CIRCUIT RECEPTACLE AS INDICATED. ROUTE DATA BACK TO DATA RACK AT MANAGERS DESK.
- EL02 DRIVE-THRU EQUIPMENT: FURNISH AND INSTALL ALL NECESSARY POWER AND DATA ROUGH-INS FOR DRIVE-THRU EQUIPMENT. ALL RECEPTACLES FOR DRIVE-THRU EQUIPMENT TO BE ISOLATED-GROUNDING TYPE RECEPTACLE WITH SURGE PROTECTION. SEE DRIVE-THRU ELEVATION AND DRIVE-THRU PLAN VIEW DETAILS INDICATED FOR EXACT ROUGH-IN TYPES, QUANTITIES, LOCATIONS, DIMENSIONS, AND CIRCUITING.
- EL03 ESPRESSO MACHINES: FURNISH AND INSTALL HEAVY DUTY RECEPTACLE AT 26" AFF. FURNISH AND INSTALL HEAVY DUTY ANGLED PLUG. PROVIDE ANY ADDITIONAL CONDUIT, WIRE, PRIMARY AND SECONDARY PROTECTION, AND CONNECTIONS NECESSARY TO INSURE A FUNCTIONAL SYSTEM. VERIFY EXACT ROUGH-IN AND OVERCURRENT PROTECTION REQUIREMENTS WITH MANUFACTURER PRIOR TO COMMENCING WORK.
- EL04 POS PRINTER: FURNISH AND INSTALL QUADPLEX ISOLATED-GROUNDING TYPE RECEPTACLE WITH SURGE PROTECTION AT 26" AFF. FURNISH AND INSTALL DATA OUTLET AT 26" AFF.
- EL05 SAFE: FURNISH AND INSTALL QUADPLEX ISOLATED-GROUNDING TYPE RECEPTACLE WITH SURGE PROTECTION AT 18" AFF.
- EL06 POS: FURNISH AND INSTALL DUPLEX ISOLATED-GROUNDING TYPE RECEPTACLE WITH SURGE PROTECTION AT 18" AFF. FURNISH AND INSTALL (1) DATA OUTLET AND AT 18"
- EL07 FURNISH AND INSTALL NEMA 6-30R RECEPTACLE AT 26" AFF TO SUPPORT WARMING OVENS, PROVIDE DATA CONNECTION AS REQUIRED FOR WARMING OVEN, WORK SHALL INCLUDE ROUGH-IN AND CONDUIT WITH CAT5 CABLE FROM EQUIPMENT TO DATA RACK. COORDINATE LOCATION AND CONNECTION REQUIREMENTS WITH STARBUCKS PROJECT MANAGER IN FIELD.
- EL08 FURNISH AND INSTALL NEMA 6-50R RECEPTACLES AT 26" AFF TO SUPPORT DUAL BREWER. FURNISH AND INSTALL POWER CORD WITH NEMA 6-50P PLUG. COORDINATE EXACT INSTALLATION REQUIREMENTS WITH MANUFACTURER AND LOCATION AND CONNECTION REQUIREMENTS WITH STARBUCKS PROJECT MANAGER IN FIELD.
- EL09 D/T WINDOW CONTROL: LANDLORD TO PROVIDE ROUGH-IN AT WINDOW HEADER HEIGHT. PROVIDE FINAL CONNECTION AS REQUIRED. VERIFY EXACT SCOPE OF WORK WITH LANDLORD AND CONDITIONS IN FIELD PRIOR TO COMMENCING WORK.
- EL10 PROVIDE ROUGH-IN AT 26" AFF FOR FUTURE USE. CIRCUIT RECEPTACLE AS INDICATED. ROUTE DATA BACK TO DATA RACK AT MANAGERS DESK.
- EL11 D/T AIR CURTAIN: LANDLORD TO PROVIDE DEDICATED CONDUIT TO POWER PANEL AND ALL NECESSARY WIRE AND CONNECTIONS FOR A FUNCTIONAL AIR CURTAIN SYSTEM. COORDINATE WITH MANUFACTURER'S REQUIREMENTS PRIOR TO ROUGH-IN.
- EL12 INSTALL OWNER PROVIDED IOT MODULE FOR ESPRESSO MACHINE AND MAKE FINAL CONNECTIONS AS REQUIRED.



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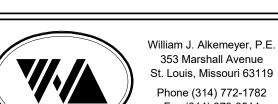
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PROJECT #: **ISSUE DATE** SR. DESIGN MANAGER: K. GORIN SLONSKI PRODUCTION DESIGNER: A. HAHN CHECKED BY: NJD/BMS


ENLARGED ELECTRICAL PLACEMENT PLAN


SCALE: AS SHOWN


STORE #:

SHEET NUMBER: E103

1 ENLARGED ELECTRICAL PLACEMENT PLAN \_\_\_\_

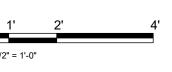

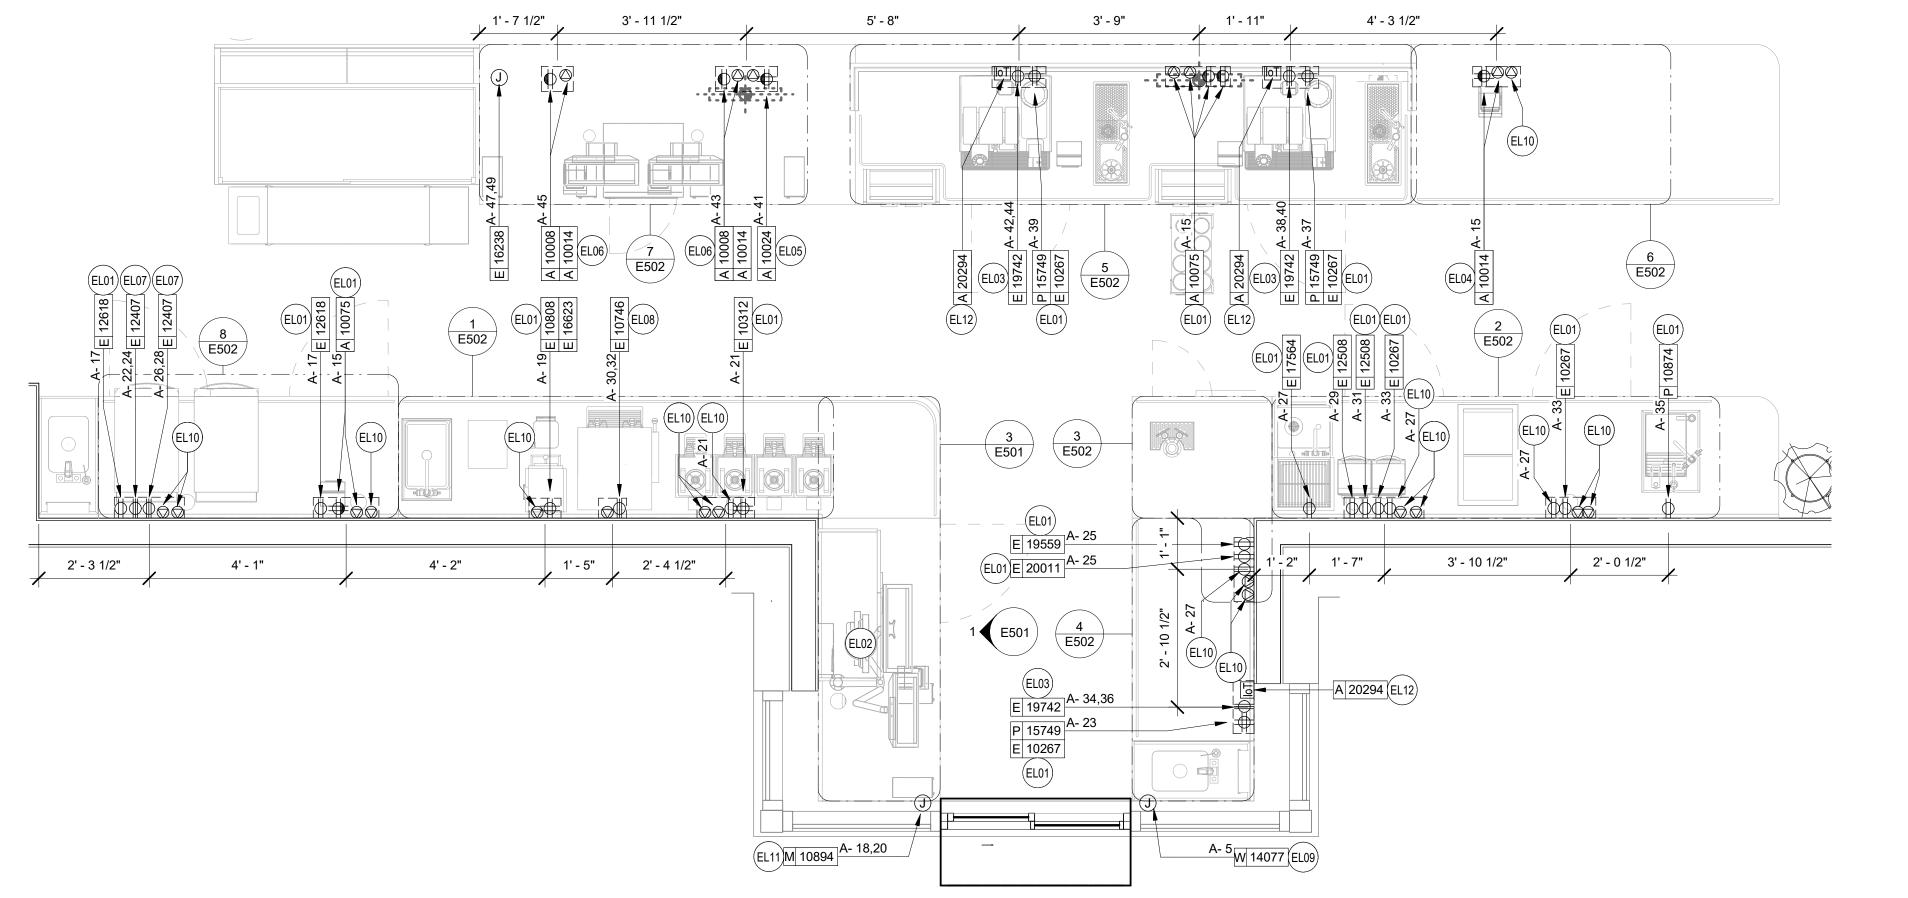

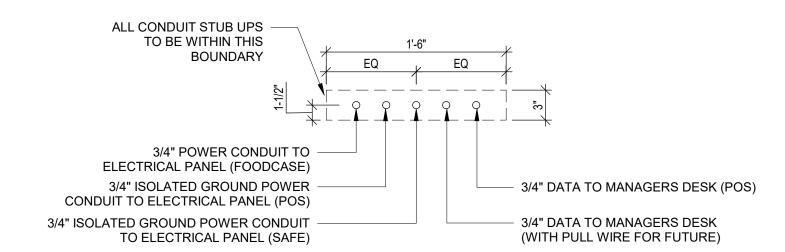

#### ELECTRICAL STUB UP DETAIL - POS

SCALE: NTS ALL CONDUIT STUB UPS TO BE WITHIN THIS **BOUNDARY** 1" DATA TO MANAGER'S DESK 1" POWER CONDUIT TO ELECTRICAL (FUTURE) PANEL (FUTURE) 3/4" DATA TO MANAGER'S DESK (CUP 1" POWER CONDUIT TO ELECTRICAL LABELER/PRINTER) PANEL (U/C REFRIG./INSTA-HOT) 3/4" ISOLATED GROUND POWER CONDUIT 3/4" POWER CONDUIT TO ELECTRICAL TO ELECTRICAL PANEL (CUP PANEL (ESPRESSO MACHINE) LABELER/PRINTER) 3/4" POWER CONDUIT TO ELECTRICAL PANEL (ESPRESSO MACHINE)

#### ELECTRICAL STUB UP DETAIL - ESPRESSO

#### DATA PLAN SHEET NOTES

- D01 CEILING MOUNTED WIRELESS ACCESS POINT (WAP). PROVIDE ROUGH-IN FOR WAP AND CAT6 CABLE FROM EQUIPMENT RACK PATCH PANEL AT MANAGERS DESK TO WAP LOCATION. PROVIDE ROUGH-IN FOR WAP OVER POS COUNTER CENTERED BETWEEN CASH REGISTERS AND OVER MANAGERS DESK. STARBUCKS VENDOR TO INSTALL WAP DEVICE.
- D02 PROVIDE DRIVE THRU SECURITY CAMERA ON EXTERIOR OF BUILDING ONLY AS REQUIRED. VERIFY EXACT REQUIREMENTS WITH OWNER AND/OR OWNERS REPRESENTATIVE PRIOR TO COMMENCING WORK.
- D03 PROVIDE ROUGH-IN AND FINAL CONNECTION TO AUDIO SPEAKER. WALL MOUNTED SPEAKER WATTAGE SETTING TO BE 5 VOLT. CEILING MOUNTED PENDANT SPEAKER WATTAGE SETTING TO BE 7.5 VOLT. COORDINATE EXACT LOCATION AND REQUIREMENTS, INCLUDING FINAL WATTAGE SETTING, WITH CONSTRUCTION MANAGER PRIOR TO COMMENCING WORK.
- D04 STUB UP POWER, DATA, AND PHONE CONDUITS 6" AFF IN THIS LOCATION. ROUTE POWER CONDUCTORS IN FLEXIBLE METAL CONDUIT TIGHT TO WALL FROM RECEPTACLES TO NEARBY RIGID STUB-UP AND BACK TO SERVING POWER PANEL ROUTE DATA AND PHONE CONDUITS UNDERFLOOR BACK TO DATA RACK NEAR MANAGERS WORKSTATION. LABEL DATA AND PHONE CONDUITS "FOR DATA CABLING". PROVIDE INSULATED BUSHINGS, AND PROVIDE PULL STRING FROM END TO END. LABEL SECURITY CONDUIT "FOR SECURITY" AND PROVIDE PULL STRING FROM END TO END. SEE SHEET E102 FOR MORE INFORMATION.
- D05 MANAGER'S DESK: FURNISH AND INSTALL ALL NECESSARY POWER AND DATA ROUGH-INS FOR MANAGER'S DESK EQUIPMENT. ALL RECEPTACLES TO BE ISOLATED-GROUNDING TYPE RECEPTACLES WITH SURGE PROTECTION. SEE MANAGER'S DESK ELEVATIONS AND MANAGER'S DESK PLAN VIEW DETAILS INDICATED FOR EXACT ROUGH-IN TYPES, QUANTITIES, LOCATIONS, DIMENSIONS, AND CIRCUITING.
- D06 INSTALL CARBON MONOXIDE DETECTOR IN REAR OF SPACE AT LEAST 10 FEET FROM WATER HEATER PER STARBUCKS DESIGN STANDARDS. CARBON MONOXIDE DETECTOR SHALL BE #US 260 CO-SAFEAIR DETECTOR CONNECTED TO SECURITY CONTROL PANEL. VERIFY MOUNTING HEIGHT WITH EQUIPMENT SUPPLIER AND G.C. IN
- D07 DOOR POSITION SWITCH. LOCATE ONE AT EACH EXTERIOR DOOR LEAF.
- D08 ALARM KEY PAD. LOCATED WITHIN 10'-0" OF EMPLOYEE ENTRANCE. MOUNT AT 42"
- D09 PIR MOTION DETECTOR REQUIRED PER STORE AT FOLLOWING LOCATIONS: (1) BEHIND BAR NEAR POS, (1) CENTRALLY LOCATED IN CAFE, (1) AT MANAGER'S WORKSTATION, (1) CENTRALLY LOCATED IN BOH. VERIFY FINAL LOCATIONS PRIOR TO COMMENCING
- D10 SECURITY CAMERA. CEILING MOUNT TYPICAL. IN OPEN CEILING CONDITION LOCATE BOTTOM OF CAMERA AT SAME HEIGHT AS STORE LIGHTING.
- D11 DRIVE THRU SECURITY CAMERA. LOCATE 6'-0" TO 8'-0" FROM WINDOW WITH CLEAR VIEW OF CUSTOMER AND DT POS.

#### D03 A 10015 S A 10017 (D03) A 10015 D03 M D09 (D08) -STUB UP DATA CONDUIT IN WALL AT LOCATIO INDICATED (D03) A 10015 (D09) (M) E501 **EXTEND DATA CONDUITS** OVERHEAD TO MANAGER'S IT/DATA RACK.— A 10017 (D03) E501 DATA DEVICE PLAN

#### DATA GENERAL NOTES

- A. REFER TO SHEET E104 FOR EXACT LOCATIONS AND MOUNTING HEIGHTS OF DATA DEVICES IN BAR AREA. REFER TO DETAILS ON SHEETS E501 AND 502 FOR ADDITIONAL INFORMATION.
- B. THE ELECTRICAL CONTRACTOR IS RESPONSIBLE FOR CONFIRMING ALL VOLTAGE REQUIREMENTS ON ALL EQUIPMENT AND PROVIDING BUCK-BOOST TRANSFORMERS AS MAY BE NEEDED FOR CODE. ALL ARE NOT NECESSARILY INDICATED.
- C. ANY EQUIPMENT NOTED AS 'FUTURE' SHALL BE PROVIDED WITH APPROPRIATE RECEPTACLES AND WIRING TO ENABLE FUTURE OPERATION.
- D. REFERENCE LANDLORD WORK LETTER FOR DIVISION OF ELECTRICAL SCOPE OF WORK AND COORDINATE WITH STARBUCKS CONSTRUCTION
- E. DATA CABLING LOCATED ABOVE HEAD SHALL BE PLENUM.
- F. DATA CABLING LOCATED UNDERGROUND SHALL BE RATED FOR BELOW GROUND USE.
- G. DATA CABLING AT EXPOSED CEILING SHALL BE INSTALLED IN METAL CONDUIT OR PER LOCAL CODE REQUIREMENT.

#### 2. MUSIC SYSTEM

- H. GC SHALL INSTALL SPEAKERS AND WIRING PER DRAWING
- I. SPEAKER PLACEMENT: LOCATE (1) PER 250 SF OF CAFE SPACE @ 14'-0" MIN. TO 18'-0" MAX. O.C.
- J. SPEAKER PAINTING: SPEAKER GRILLS CAN BE PAINTED. NOTE: GRILL HOLES SHALL REMAIN OPEN.
- K. G.C. SHALL INSTALL MUSIC SYSTEM, CONNECT WIRING, AND TEST.

- L. ENTRY CAMERA: CAPTURE ENTIRE DOORWAY ANDCUSTOMER TOP OF HEAD TO KNEES. PROVIDE (1) CAMERA @ EACH ENTRY.
- M. POS CAMERA: PRIMARY OBJECTIVE IS CUSTOMER; SECONDARY IS TRANSACTION PLANE. CAPTURE MULTIPLE POS LOCATIONS.
- N. SAFE CAMERA: POSITION TO VIEW FROM HANDLE SIDE OF DOOR. POS CAMERA CAN BE USED WHEN SAFE IS LOCATED BELOW TERMINALS.
- O. DRIVE THRU CAMERA: PRIMARY OBJECTIVE IS CUSTOMER; SECONDARY IS POS. IDEAL PLACEMENT WOULD CAPTURE BOTH.
- P. BOH CAMERA: CAPTURES CASH HANDLING.
- Q. CARBON MONOXIDE: AT LEAST ONE CARBON MONOXIDE (CO) DETECTOR IS TO BE LOCATED IN THE BACK OF HOUSE. PROVIDE SECOND DETECTOR IN CAFE IF SPACE INCLUDES A FIREPLACE.

#### 4. LOW VOLTAGE CABLING

- R. GC TO PROVIDE PATHWAYS FOR ALL DATA AND LOWVOLTAGE CABLING DEVICES. CONDUITS CONTAINING MULTIPLE CABLES SHALL BE UP-SIZED FOR FUTURE CAPACITY, 1" [25MM] TYPICAL.
- S. PROVIDE LABELED, END-TO-END PULL STRINGS RATED TO 20 LBS IN ALL CONDUITS.
- T. CONDUIT BEND RADIUS SHALL BE A MIN. OF 6x THE INTERNAL CONDUIT
- U. TERMINATE CONDUITS THAT EXTEND THROUGH SLAB MIN. 3" [75MM]
- V. FLEX CONDUIT IS GENERALLY UNACCEPTABLE FOR USE AS A COMMUNICATIONS CONDUIT EXCEPT AT SEISMIC JOINTS.
- W. ALL SUB-SLAB CONDUITS SHALL BE INSTALLED IN A MATTER THAT PREVENTS WATER INFILTRATION OF THE CONDUIT. IT IS THE GC'S RESPONSIBILITY TO ENSURE RAIN WATER OR CONSTRUCTION WATER IS PREVENTED FROM ENTERING AND/OR REMOVED FROM CONDUIT PRIOR TO PLACEMENT OF CABLES.
- X. ALL PULL BOXES SHALL BE SIZED AND INSTALLED PER ANSI/TIA/EIA-569-A. PULL BOXES FOR UNDERGROUND CONDUITS ARE NOT PERMITTED UNLESS OTHERWISE NOTED.

#### 5. BROADBAND CABLE

Y. MAIN POINT OF ENTRY: GC TO PROVIDE MIN. 2" [50MM] CONDUIT PATH FROM THE BUILDING'S MAIN POINT OF ENTRY (MPOE) TO THE CEILING AT THE MANAGER'S WORKSTATION. THE INTERNET SERVICE PROVIDER (ISP) WILL DESIGNATE THE START AND END LOCATIONS OF THE CONDUIT, AND ANY BACKBOARD, GROUNDING, AND POWER REQUIREMENTS.



#### **STARBUCKS**

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NOR LIABILITY TO THE OTHER (EXCEPT STATED ABOVE) UNTIL A

WRITTEN AGREEMENT IS FULLY EXECUTED BY BOTH PARTIES





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**Engineering Consultant** 

07/06/20

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 $\mathcal{C}$ YOR, DR. F M S

BUILI COFF CHIP 62012 87799-001 SR. DESIGN MANAGER: K. GORIN SLONSKI


PRODUCTION DESIGNER: A. HAHN CHECKED BY: NJD/BMS


**Revision Schedule** 

DATA DEVICE PLAN

SCALE: AS SHOWN

SHEET NUMBER:

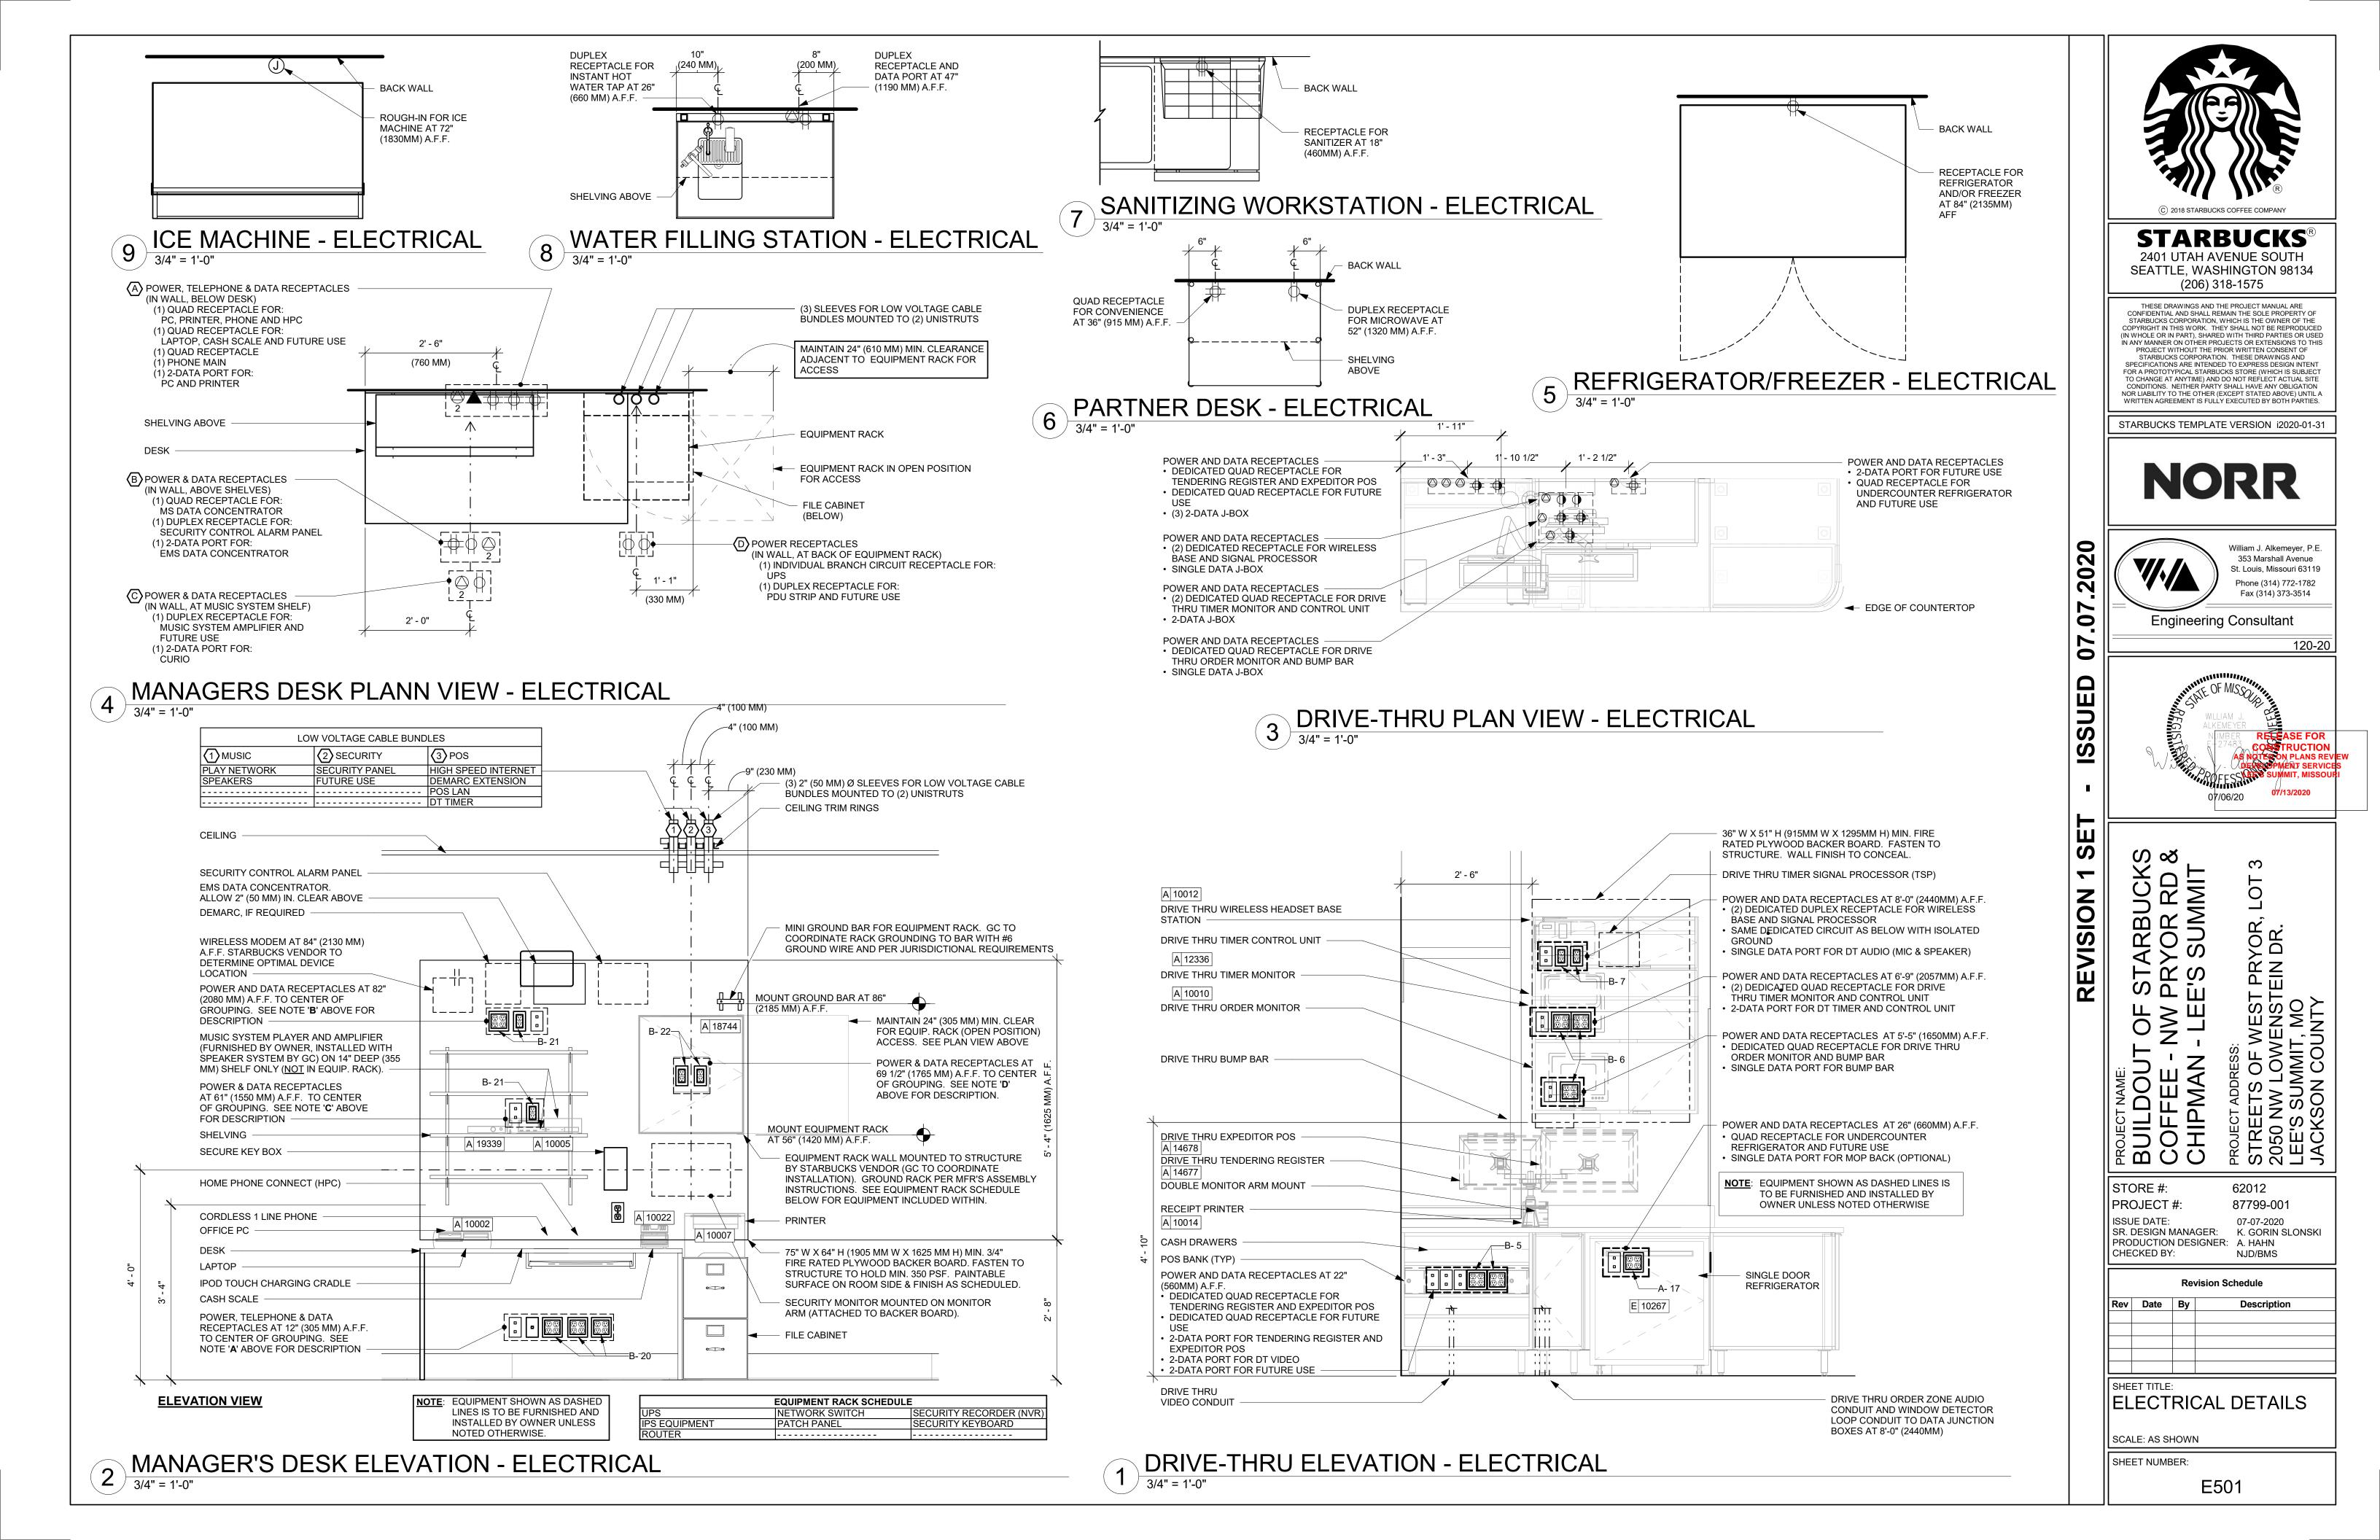

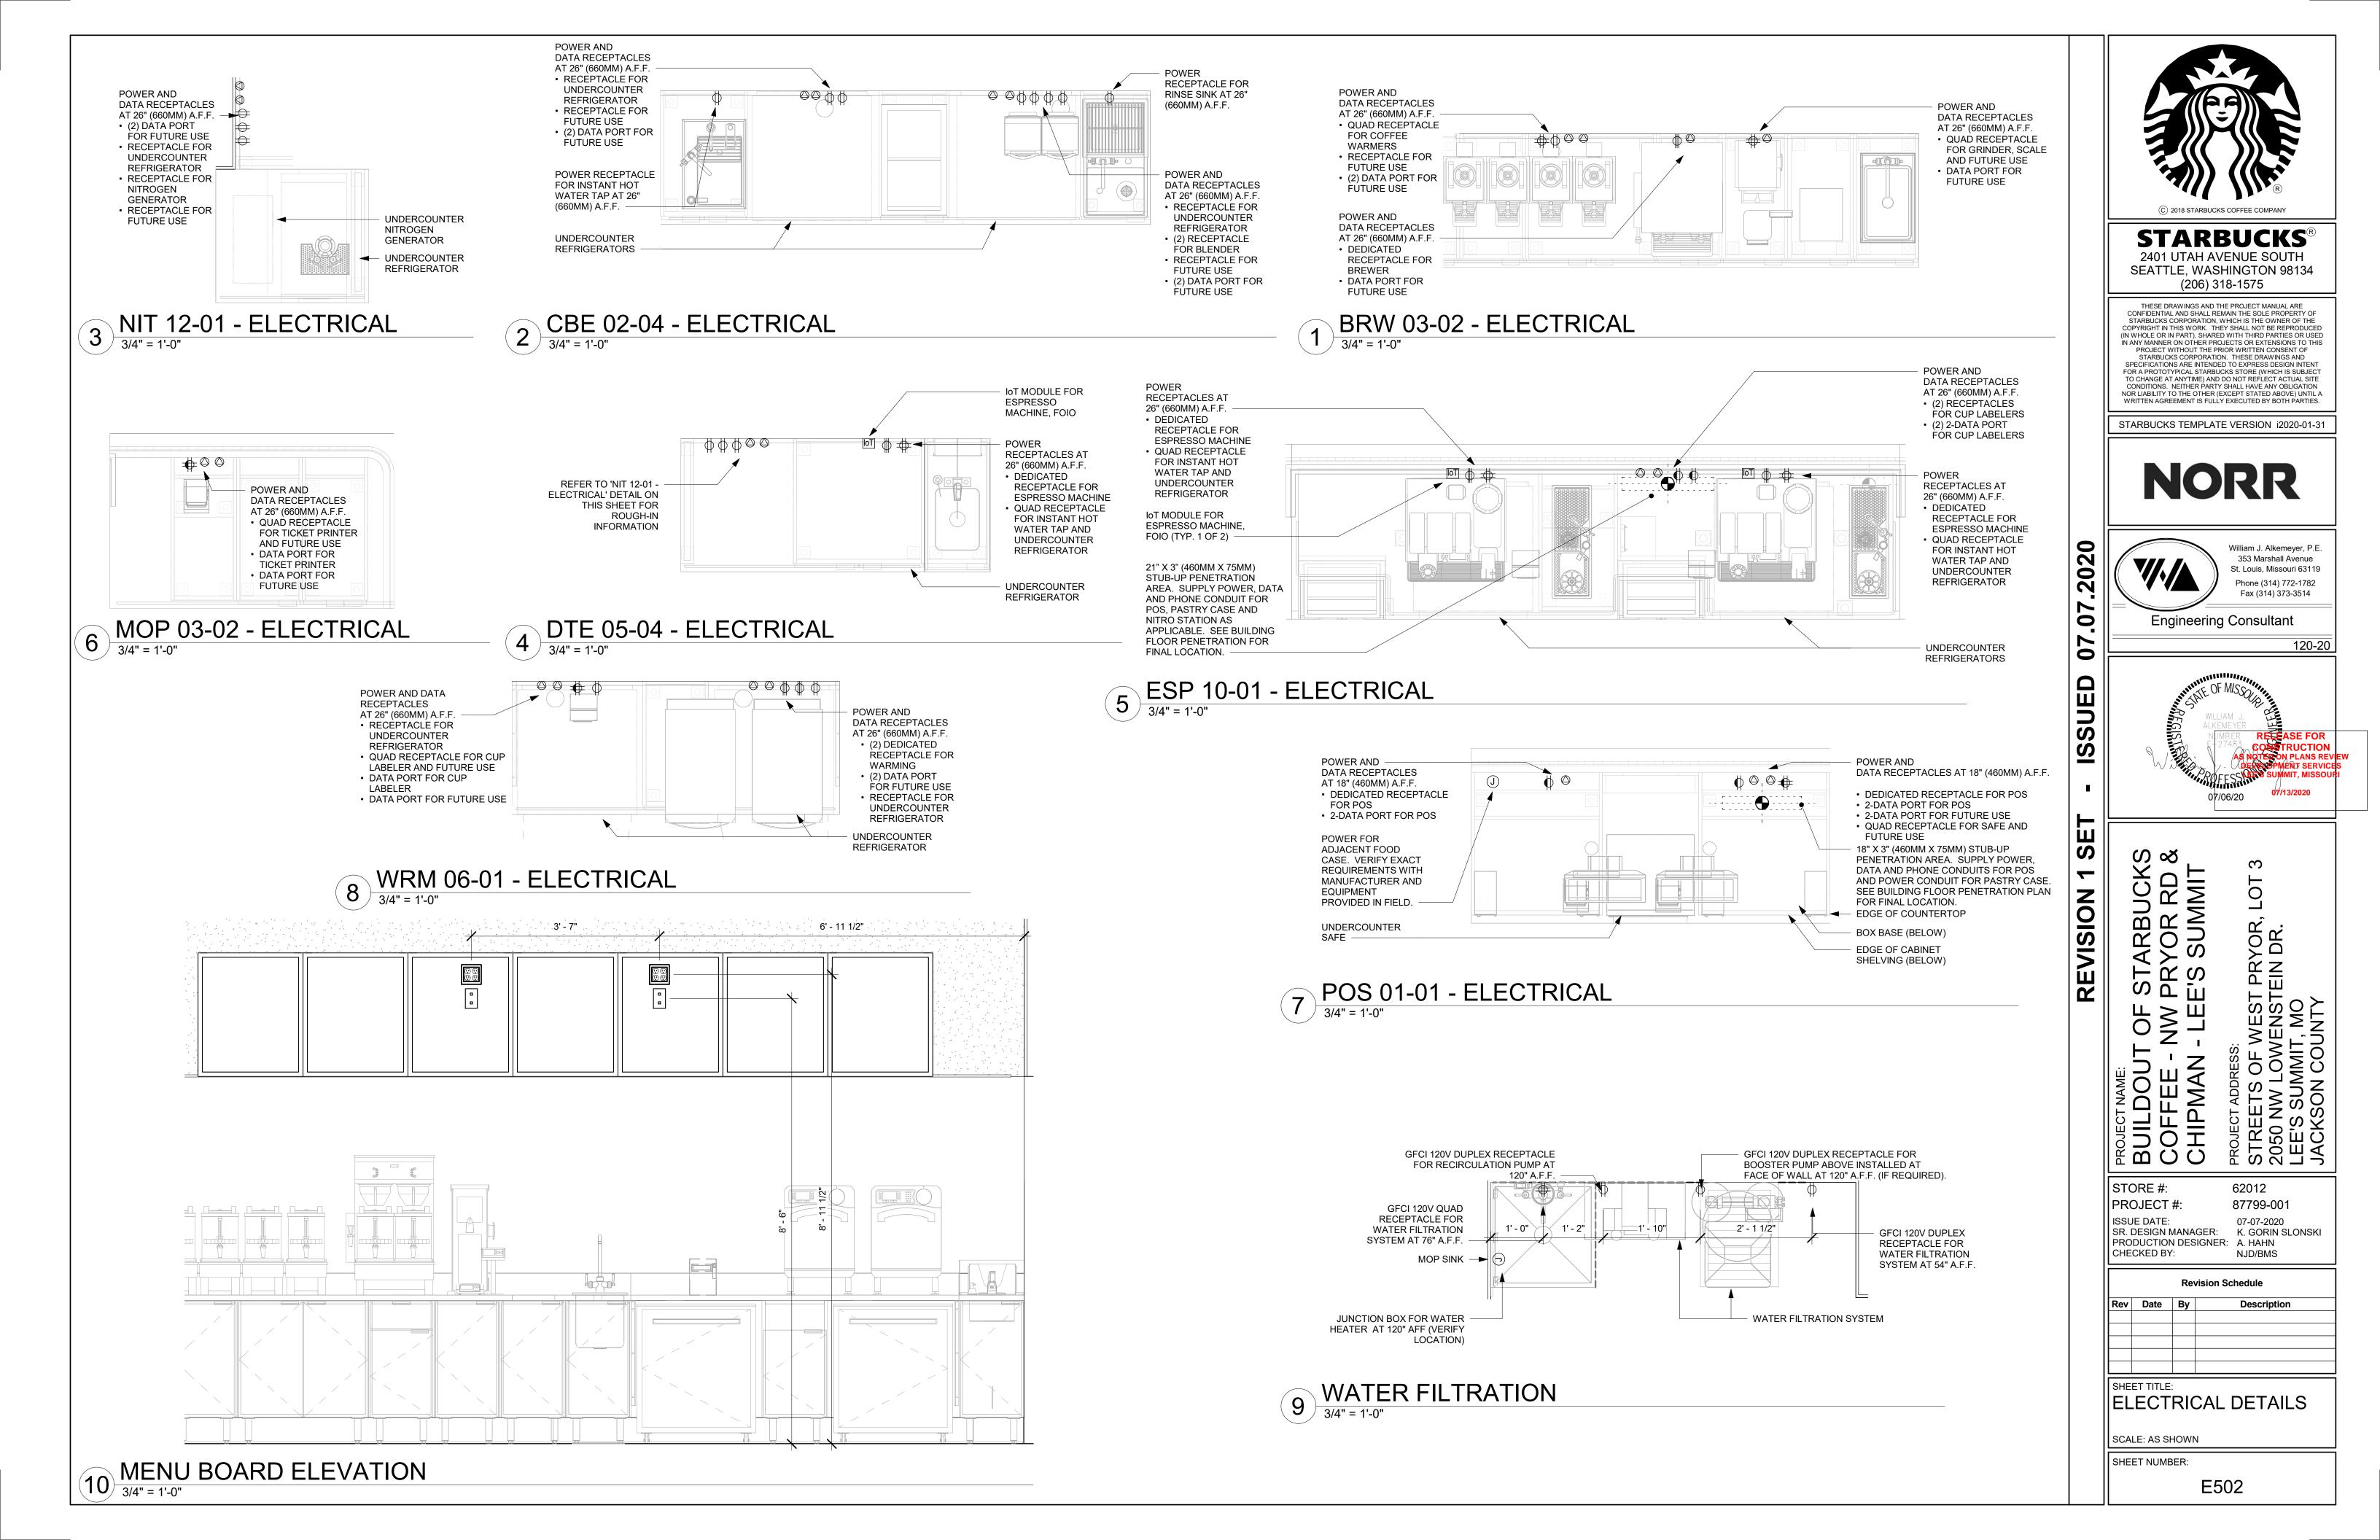

#### Panel: A

Mounting: Recessed Enclosure: Type 1 AIC Rating: By Landlord

#### Volts: 120/208 Wye Phases: 3 Wires: 4 Responsibility: Landlord

MCB Rating: 400A MLO Mains Type: CU Mains Rating: 400 A

СКТ		Schedule Circuit Notes	Trip	Poles		4	E	3		C	Poles	Trip	Schedule Circuit Notes	СКТ	
Е	1	EF-1	20 A	1	528 VA	5536 VA								2	
G	3	REACH-IN REFRIGERATOR	20 A	1			1344 VA	5536 VA			3	60 A	RTU-1	4	E
Е	5	DRIVE-THRU WINDOW	20 A	1					600 VA	5536 VA				6	1
Е	7	PATIO STRING LIGHTS	20 A	1	180 VA	5536 VA								8	
G	9	REACH-IN REFRIGERATOR/FREEZER	20 A	1			1164 VA	5536 VA			3	60 A	RTU-2	10	E
G	11	REACH-IN FREEZER	20 A	1					1152 VA	5536 VA				12	1
G	13	PARTNER DESK	20 A	1	1560 VA	1080 VA					1	20 A	RECEPTACLES: EXTERIOR	14	E
G	15	CUP LABELERS/PRINTER	20 A	1			960 VA	0 VA			1	20 A	SPARE	16	G
G	17	U.C. REFRIGERATOR (X3)	20 A	1					1440 VA	3328 VA	2	40 A	HEATED AIR CURTAIN	18	
G	19	GRINDER/SCALE	20 A	1	1660 VA	3328 VA					~	40 A	HEATED AIR CORTAIN	20	1
G	21	COFFEE WARMERS/FUTURE POWER	20 A	1			540 VA	2288 VA			2	30 A	TURBO CHEF	22	G
G	23	INSTA-HOT/U.C. FRIG	20 A	1					1836 VA	2288 VA		30 A	TORBO CHEF	24	] G
G	25	NITRO SYSTEM	20 A	1	990 VA	2288 VA					2	30 A	TURBO CHEF	26	G
G	27	FUTURE POWER/PITCHER RINSER	20 A	1			660 VA	2288 VA			~	30 A	TORBO CHEF	28	] G
G	29	BLENDER	20 A	1					1200 VA	4170 VA	2	50 A	DUEL BREWER	30	G
G	31	BLENDER	20 A	1	1200 VA	4170 VA						30 A	DOEL BREVVER	32	]
G	33	U.C. REFRIGERATOR (X2)	20 A	1			960 VA	2901 VA			2	40 A	ESPRESSO MACHINE	34	G
G	35	INSTA-HOT WATER TAP	20 A	1					1301 VA	2901 VA		40 A	ESPRESSO WACHINE	36	] [
G	37	INSTA-HOT/U.C. FRIG	20 A	1	1836 VA	2901 VA					_	40.4	ESPRESSO MACHINE	38	
G	39	INSTA-HOT/U.C. FRIG	20 A	1			1836 VA	2901 VA			2	40 A	ESPRESSO MACHINE	40	G
G	41	SAFE	20 A	1					360 VA	2901 VA	_	40.4	ECDDECCO MACUINE	42	
G	43	POS REGISTER	20 A	1	360 VA	2901 VA					2	40 A	ESPRESSO MACHINE	44	G
G	45	POS REGISTER	20 A	1			360 VA	1799 VA			_	20. 4	ICE MACHINE	46	
	47	F00D 040F	20. 4	0					708 VA	1799 VA	2	20 A	ICE MACHINE	48	1
	49	FOOD CASE	20 A	2	708 VA	3172 VA						50 A	CANUTIZINIO OTATIONI	50	
G	51	SPARE	20 A	1			0 VA	3172 VA			2	50 A	SANITIZING STATION	52	G
G	53	SPARE	20 A	1					0 VA	0 VA	1	20 A	SPARE	54	G
	55				0 VA	0 VA					1	20 A	SPARE	56	G
	57	SURGE PROTECTION	40 A	3			0 VA	0 VA			1	20 A	SPARE	58	G
	59								0 VA	0 VA	1	20 A	SPARE	60	G
			Tota	al Load:	4764	3 VA	4087	6 VA	4341	6 VA					-

E = E = EXISTING BY LANDLORD

G = GFI - FURNISH AND INSTALL GFI BREAKERS AND DEDICATED NEUTRALS FOR THESE CIRCUITS TO PREVENT FALSE TRIPPING. EQUIPMENT AIC RATINGS SHALL EXCEED THE AVAILABLE FAULT CURRENT. CONTRACTOR SHALL VERIFY AVAILABLE FAULT CURRENT WITH UTILITY PRIOR TO CONSTRUCTION. SYSTEM SHALL BE SERIES RATED IF NECESSARY TO LIMIT SHORT CIRCUIT CURRENT TO BELOW 22,000 AIC (FOR GFI BREAKERS). COORDINATE WITH LANDLORD.

341 A

365 A

Total Amps: 400 A

Load Classification	Connected Load	Demand Factor	Estimated Demand	Panel	Totals
HVAC	33745 VA	100.00%	33745 VA		
Kitchen Equipment - Non-Dwelling Unit	70210 VA	65.00%	45637 VA	Total Conn. Load:	131934 VA
Lighting - General	990 VA	125.00%	1238 VA	Total Est. Demand:	101280 VA
Power - General	2280 VA	100.00%	2280 VA	Total Conn.:	366 A
Receptacle	23340 VA	71.42%	16670 VA	Total Est. Demand:	281 A
Lighting	1369 VA	125.00%	1712 VA		

#### Panel: B

Mounting: Recessed Enclosure: Type 1 AIC Rating: By Landlord

#### Volts: 120/208 Wye Phases: 3 Wires: 4 Responsibility: Landlord

	СКТ	Schedule Circuit Notes	Trip	Poles		4	Е	3		С	Poles	Trip	Schedule Circuit Notes	СКТ	
3	1	TIME CLOCK	20 A	1	120 VA	1308 VA						20 A	CAFE LIGHTING	2	7
3	3	BOH/RR LIGHTING	20 A	1			331 VA	720 VA			1	20 A	EXTERIOR SIGNS	4	(
3	5	DRIVE-THRU EQUIPMENT	20 A	1					720 VA	1080 VA	1	20 A	DRIVE-THRU EQUIPMENT	6	(
3	7	DRIVE-THRU EQUIPMENT	20 A	1	360 VA	600 VA					1	20 A	WATER HEATER	8	(
3	9	WATER FILTER SYSTEM	20 A	1			1440 VA	360 VA			1	20 A	RECIRC/BOOSER PUMP	10	(
3	11	RESTROOM FAUCT/SOAP DISPENSERS	20 A	1					720 VA	1440 VA	1	20 A	RESTROOM HAND DRYER	12	(
3	13	RESTROOM HAND DRYER	20 A	1	1440 VA	1481 VA					1	20 A	WATER FILLING STATION	14	(
3	15	BANQUETTE POWER	20 A	1			720 VA	1080 VA			1	20 A	CAFE CONVENIENCE RECEPTACLES	16	(
3	17	CAFE CONVENIENCE RECEPTACLES	20 A	1					1260 VA	540 VA	1	20 A	CAFE CONVENIENCE RECEPTACLES	18	(
3	19	SHOW WINDOW RECEPTACLES	20 A	1	360 VA	1080 VA					1	20 A	MANAGERS DESK POWER	20	(
3	21	MANAGERS DESK POWER	20 A	1			720 VA	360 VA			1	20 A	MANAGERS DESK POWER	22	(
3	23	MONUMENT SIGN	20 A	1					500 VA	100 VA	1	20 A	DRIVE-THRU DIRECTIONAL SIGN	24	(
3	25	DOS CONTROL BOX	20 A	1	600 VA	360 VA					1	20 A	MENU/PRE-MENU/CANOPY LIGHT	26	(
3	27	PANEL SERVICE RECEPTACLE	20 A	1			180 VA	720 VA			1	20 A	FUTURE DIGITAL MENU BOARD	28	(
3	29	SPARE	20 A	1					0 VA	0 VA	1	20 A	SPARE	30	(
3	31	SPARE	20 A	1	0 VA	0 VA					1	20 A	SPARE	32	(
3	33	SPARE	20 A	1			0 VA	0 VA			1	20 A	SPARE	34	(
3	35	SPARE	20 A	1					0 VA	0 VA	1	20 A	SPARE	36	(
3	37	SPARE	20 A	1	0 VA	0 VA					1	20 A	SPARE	38	(
3	39	SPARE	20 A	1			0 VA	0 VA			1	20 A	SPARE	40	(
	41								0 VA	0 VA				42	T
	43				0 VA	0 VA								44	T
	45						0 VA	0 VA						46	T
	47								0 VA	0 VA				48	T
	49				0 VA	0 VA								50	T
	51						0 VA	0 VA						52	T
	53								0 VA	0 VA				54	T
	55				0 VA	0 VA								56	T
	57						0 VA	0 VA						58	
	59								0 VA	0 VA				60	
	ı		Tota	al Load:	7709	) VA	6631	1 VA	636	0 VA		I	1		
			Tota	I Amne:	65	Δ	56	: Δ	53	ЗΔ	1				

G = GFI - FURNISH AND INSTALL GFI BREAKERS AND DEDICATED NEUTRALS FOR THESE CIRCUITS TO PREVENT FALSE TRIPPING. EQUIPMENT AIC RATINGS SHALL EXCEED THE AVAILABLE FAULT CURRENT. CONTRACTOR SHALL VERIFY AVAILABLE FAULT CURRENT WITH UTILITY PRIOR TO CONSTRUCTION. SYSTEM SHALL BE SERIES RATED IF NECESSARY TO LIMIT SHORT CIRCUIT CURRENT TO BELOW 22,000 AIC (FOR GFI BREAKERS). COORDINATE WITH LANDLORD. E = EXISTING BY LANDLORD

56 A

Total Amps:


65 A

53 A

		Demand Factor	Estimated Demand	Panel Totals		
Kitchen Equipment - Non-Dwelling Unit	2141 VA	90.00%	1927 VA			
ighting - General	990 VA	125.00%	1238 VA	Total Conn. Load:	20700 VA	
Power - General	1680 VA	100.00%	1680 VA	Total Est. Demand:	18816 VA	
Receptacle	14520 VA	84.44%	12260 VA	Total Conn.:	57 A	
Lighting	1369 VA	125.00%	1712 VA	Total Est. Demand:	52 A	

	WIRE SIZING	G SCHEDUL	E
BREAKER	WIRE SIZE	GROUND	CONDUI
20A-1P	(2) #12	#12	3/4"
20A-2P	(3) #12	#12	3/4"
20A-3P	(4) #12	#12	3/4"
30A-1P	(2) #10	#10	3/4"
30A-2P	(3) #10	#10	3/4"
30A-3P	(4) #10	#10	3/4"
40A-2P	(3) #8	#10	3/4"
40A-3P	(4) #8	#10	1"
50A-2P	(3) #6	#10	1"
50A-3P	(4) #6	#10	1"
60A-2P	(3) #4	#10	1"
60A-3P	(4) #4	#10	1-1/4"
70A-3P	(4) #4	#8	1-1/4"
80A-3P	(4) #3	#8	1-1/4"
90A-3P	(4) #2	#8	1-1/4"
100A-3P	(4) #2	#8	1-1/4"
125A-3P	(4) #1	#6	1-1/2"
150A-3P	(4) #1/o	#6	2"

# 200A-3P (4) #3/o #6 2"

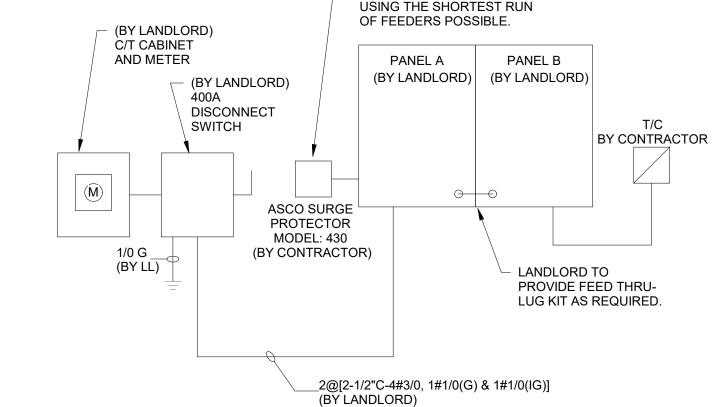

CONTRACTOR TO PROVIDE

PANELBOARD AND CONNECT

AND INSTALL SURGE PROTECTOR CLOSE TO

#### ONE-LINE DIAGRAM

MCB Rating: 400A MLO

Mains Type: CU

Mains Rating: 400 A

ONE-LINE NOTES: LANDLORD TO PROVIDE NEW 400A, 120/208V-3PH ELECTRICAL SERVICE TO SPACE INCLUDING INSTALLATION OF ANY REQUIRED CT'S AND METERING AND DISCONNECT IN SPACE. LANDLORD SHALL ALSO PROVIDE, INSTALL AND CONNECT ELECTRICAL SERVICE TO, TWO (2) 400 AMP RATED ELECTRICAL PANELS.

WIRE AND CONDUIT SIZES SHOWN ARE FOR COPPER CONDUCTORS WITH 75°C RATED INSULATION. LANDLORD CONTRACTOR TO PROVIDE PROPERLY SIZED CONDUIT & WIRE TO COMPENSATE FOR ALUMINUM FEEDERS OR VOLTAGE DROP AS REQUIRED.

CONTRACTOR IS RESPONSIBLE FOR, BUT NOT LIMITED TO, ALL WORK DOWNSTREAM OF LANDLORD PROVIDED ELECTRICAL PANELS.

ALL WORK SHALL BE IN ACCORDANCE WITH UTILITY COMPANY REQUIREMENTS AND LOCAL CODE. CONTRACTOR BID SHALL INCLUDE ALL WORK NECESSARY FOR A FULLY OPERATIONAL

LANDLORD SHALL CONTACT THE ELECTRIC UTILITY CO. TO VERIFY ALL DETAILS OF NEW SERVICE IF EXISTING BUILDING ELECTRICAL SERVICE IS NOT ADEQUATE AND IS RESPONSIBLE

CONTRACTOR IS RESPONSIBLE FOR A COMPLETE AND OPERATIONAL SYSTEM IN COMPLIANCE WITH NEC AND ALL STATE AND LOCAL CODES.



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STARBUCKS TEMPLATE VERSION i2020-01-31





353 Marshall Avenue St. Louis, Missouri 63119 Phone (314) 772-1782 Fax (314) 373-3514

**Engineering Consultant** 

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#### **⊘** ⊗ TARBUCK YOR RD SUMMIT YOR, DR. F K S S. P. N N - L E

OF WEST LOWENSTE MMIT, MO COUNTY

STORE #: 62012 PROJECT #: 87799-001

BUIL COFF

ISSUE DATE: 07-07-2020 SR. DESIGN MANAGER: K. GORIN SLONSKI PRODUCTION DESIGNER: A. HAHN CHECKED BY: NJD/BMS

**Revision Schedule** 

Rev Date By Description

SHEET TITLE: ELECTRICAL PANEL SCHEDULES

SHEET NUMBER:

SCALE: AS SHOWN

		SPECIALTY EQUIPME						
DESIGN ID	COUNT	DESCRIPTION	FURN.	BY INST. BY	COMMENTS	DESIGN ID	COUNT	T DE
COOLING 10267	5	FRIDGE UNDERCOUNTER 1 DOOR - 27IN	SB	GC		AUDIO VISUA	<u>AL</u> 1	MUSIC SYSTEM
10970	1	685MM FRIDGE REACH IN 1 DOOR LH - 29IN 735MM	SB	GC		10010	1	DT ORDER MONIT
11083	2	FRIDGE REACH IN 1 DOOR LH - 29IN 735IMIM	SB	GC		10012 10015	<u>1</u> 3	DT COMMUNICAT SPEAKER RECES
12618	2	1295X890MM FRIDGE UNDERCOUNTER 1 DOOR WITH	SB	GC		10017	2	SPEAKER SURFA
		SHELF - 27IN 685MM				12336 14676	<u>1</u> 1	DT TIMER SYSTEM DT POS MONITOR
13676 13682	1	FREEZER REACH IN 1 DOOR RH - 27IN 685MM FREEZER REACH IN 2 DOOR - 54IN 1370MM	SB SB	GC GC				MOUNTED
20011	1	FRIDGE NITRO 2 TAP JT NITCOM RH	SB	GC	KIT INCLUDES UNDERCOUNTER FRIDGE,	19339 DATA	1	AMPLIFIER - 40W
 EQUIPMENT					FONT, TRAY, AND TUBING	10002	1	COMPUTER MANA
10312	4	BREWER SOFT HEAT WARMING STAND	SB	GC		10007 18744	1 1	PRINTER MANAGI
10746	1	SINGLE BREWER DUAL SOFT HEAT	SB	GC	GC TO COORDINATE WITH SBUX VENDOR.	20294	2	IOT MODULE
10808	1	GRINDER DITTING KR1203	SB	GC	GC TO COORDINATE WITH SBUX VENDOR.	POINT OF SA	ALE 2	POS - REGISTER V
10856 12407	<u>6</u> 2	BREWER SERVER SOFT HEAT  OVEN TURBOCHEF NEXT GENERATION	SB SB	GC GC				DRAWER
12508	2	BLENDER QUIET MODEL ON COUNTER	SB	GC		10014 10022	<u>4</u> 1	POS PRINTER MONEY COUNTER
12508	1	BLENDER QUIET MODEL ON COUNTER - BACK-UP	SB	GC	TO BE STORED IN BACK OF HOUSE UNLESS NEEDED	10029	6	POS BANK
15186	1	DISHWASHER HOT LOW STEAM	SB	GC		10075 14677	3 1	CUP LABELER POS - DT TENDER
16623	1	SCALE DIGITAL WITH ADJUSTABLE DISPLAY MOUNT SMALL	SB	GC		14678	1	POS - DT EXPEDIT
17564	1	BLENDER PITCHER RINSER WITH SENSOR	SB	GC	CO TO COOPDINATE INICTALLATION 9	SECURITY 10024	1	SAFE LH - 20X18X
19559	1	NITROGEN GENERATOR ELEMENT	SB	GC	GC TO COORDINATE INSTALLATION & CONNECTIONS WITH SBUX VENDOR	10024	'	OAI L LIT - ZOXTOX
19742	2	ESPRESSO MACHINE MASTRENA II	SB	GC	GC TO COORDINATE WITH SBUX VENDOR.	10028	1	SAFE BASE
16238	1	FOOD CASE - ZEPHYR - 66IN 1675MM	SB	GC				
CE	,							
10344 18029	1	ICE - BIN DROP IN 90LB 40KG ICE - BIN B110	SB SB	GC GC				
18846	1	ICE - MACHINE CIM1446HR SERIES REMOTE	SB	GC		DESIGN ID	COUNT	<b>7</b>
19278	2	ICE - BIN DROP IN 45LB 20KG HORIZONTAL	SB	GC		DRAIN		
OTHER						10294 10594	7	DRAIN - FLOOR SI
10091 10099	2	CUP DISPENSER TALL HOT VERTICAL RESTROOM TOILET PAPER HOLDER	SB SB	GC GC	_	10726	7	DRAIN - GRATE H
10172	2	RESTROOM SEAT COVER DISPENSER	SB	GC		FAUCET		FAUCET - DOUBLE
10384 10396	2	DIAPER CHANGING STATION HORIZONTAL CUP DISPENSER SHORT HOT VERTICAL	SB SB	GC GC		10152	1	RISER SPOUT
10396	1	FILE CABINET 2 DRAWER	SB	GC		10153 10215	3	FAUCET - WATER
10501	1	FIRE EXTINGUISHER	GC	GC	LOCALLY SOURCED	10215	ა 	SPOUT
10769	2	RESTROOM GRAB BAR VERTICAL - 18IN 455MM	SB	GC		10447 10597	2	FAUCET - PRE RIN
10791	2	CUP DISPENSER GRANDE VENTI COLD VERTICAL	SB	GC		10804	1	FAUCET - PRE RIN
10855	2	CUP DISPENSER GRANDE VENTI HOT	SB	GC		10874	2	FAUCET - HOT WA
10858	1	VERTICAL  CUP DISPENSER TALL COLD VERTICAL	SB	GC		10922 11003	<u>1</u> 3	FAUCET - MOP SII
10859	2	RESTROOM GRAB BAR - 48IN 1220MM	SB	GC		13588	1	FAUCET - HAND S
10862	2	RESTROOM GRAB BAR - 36IN 915MM	SB	GC		15749 X0010	2	FAUCET - HOT AN
10947 10977	1	SOAP DISPENSER WALL MOUNTED PAPER TOWEL DISPENSER FULL SIZE -	SB SB	GC GC		7,0010	_	TAGGET GTERRY
		TRANSLUCENT GRAY						
10992	2	PAPER TOWEL DISPENSER HALF SIZE - TRANSLUCENT GRAY	SB	GC		FILTER		
11115 13330	2	SOAP DISPENSER SINK MOUNTED MOBILE CUP DISPENSER CADDY	SB SB	GC GC		12501	1	FILTER - RO SYST
13584	1	CUP DISPENSER TRENTA COLD VERTICAL	SB	GC		12507	1	FILTER - RO SYST
19495	1	NITRO 2 TAP HANDLE AND BADGE KIT	SB	GC				
20079	<u> </u>	NITRO 2 TAP BADGE MOUNT BACKBAR LH NITRO 2 TAP BADGE MOUNT BACKBAR RH	SB SB	GC GC		12896	1	FILTER - BRINE TA
X0009	2	HAND DRYER - INTEGRATED	GC	GC	XLERATOR SYNC HAND DYER. AUTOMATIC	12899	2	FILTER - POLY GL
					SENSOR OPERATED. SURFACE MOUNTED. CONTACT: D 13 GROUP. 245 WEST	13076	1	FILTER - PREFILTI
					CENTRAL STREET, NATICK, MA 01760. PH: 617-307-1140. WWW.D13GROUP.COM	12002		FILTED WATER
					EMAIL: KRIZZO@D13GROUP.COM	13082	1	FILTER - WATER S
X0011	2	SOAP DISPENSER - STERN	GC	GC	STERN. GREEN/CHROME SOAP DISPENSER. PART #07100008. PART OF	13149	1	FILTER - PRESSU
					D 13 INTEGRATED SINK SYSTEM. CONTACT: D 13 GROUP. 245 WEST	OTHER		
					CENTRAL STREET, NATICK, MA 01760. PH: 617-307-1140. WWW.D13GROUP.COM	13384	1	WATER HEATER T
STORAGE					017-307-1140. WWWW.D13GROUP.COM			
10222	2	WIRE SHELF GRID AT SINK	SB	GC		SINK		
10416 10462	9	WORKROOM SHELVING - 36IN 915MM WORKROOM SHELVING POSTS	SB SB	GC GC		10549	1	SINK - RINSE DRO
10698	1	MOP RACK WITH 3 HOLDERS	SB	GC		10995 12807	<u>1</u> 1	SINK - MOP - 24X2 SINK - UTENSIL R
13834 15699	1	BASE - 24X18IN 610X455MM PARTNER WORK CENTER	SB SB	GC GC				14X20IN 355X510N
17255	1	PASTRY TRAY CART - 60IN 1525MM	SB	GC		13264 14688	1 1	SINK - 3 COMP WO
17264	1	ROLLING PASTRY TRAY THAW RACK - 20X26IN 510X660MM	SB	GC				SST
17639	1	WORKROOM CART - 24IN 610MM	SB	GC		17565	1	SINK - RINSE WITI 380X685MM
19476	2	5 COMP LOCKER - 12IN 305MM	SB	GC		17632	1	SINK - STACKED I
						18743	1	SINK - WATER FIL 915X610MM
		EXTERIOR SIGNAG	E SCHEL			19277	2	SINK - COUNTERT TROUGH - 26X9IN
DESIGN II SIGNAGE - D		INT DESCRIPTION FUR	N. BY	INST. BY	COMMENTS	X0012	2	SINK - D13
13164	1			LL/ HILTON	LL TO PROVIDE BLOCKING AND CONDUIT			
		FLUSH MOUNTED EVOLVED - 60IN 1525MM			AS REQUIRED			
SIGNAGE - D								
14091	1	SIGN ILLUMINATED ARROW		GC/LL	LL TO FURNISH AND INSTALL CONCRETE FOOTINGS, ANCHOR BOLTS, AND			
		SERIES - 46IN 1170MM			ELECTRICAL CONDUIT PER LLWL. GC TO COORDINATE WITH SBUX VENDOR	TOILET		
14106	1	0.0 2.022		GC/LL	LL TO FURNISH AND INSTALL CONCRETE	12951	2	TOILET - TANKLES
		ARROW SERIES FREESTANDING			FOOTINGS AND ANCHOR BOLTS PER LLWL. GC TO COORDINATE WITH SBUX	13040	2	TOILET - FLUSH V SINGLE FLUSH
CIONACE O	THED				VENDOR			ON OLL 1 LOON
SIGNAGE - C 19388	THER 2	SIGN - 10 MINUTE PARKING SB		LL/ HILTON	FOOTING & POST BY LL. SIGN BY SBUX	RESPO	IP.NC	IBILITY LEC
YOOO			TON		SIGNAGE VENDOR	GC		ERAL CONTRACTOR
X0002	1	MONUMENT SIGN PANELS SB/ HIL	i ON	HILTON/ LL	BASE SIGN FOOTING AND ELECTRICAL BY LL. PANELS BY SIGNAGE VENDOR. LL TO	LL		DLORD
	/ODDNAAD	 K			COORDINATE WITH SIGNAGE VENDOR	SB	STAR	RBUCKS
SIGNAGE - M	MOKUWAR	- <u>-</u>						
SIGNAGE - V X0007	VORDMAR 1	SIGN - FAUX NEON GREEN WORDMARK STARBUCKS WITH		LL/ HILTON	FAUX NEON GREEN WORDMARK. LL TO PROVIDE CONDUIT AND BLOCKING AS			

DESIGN ID	COUNT	DESCRIPTION	FURN. BY	INST. BY	COMMENTS
AUDIO VISU	AL				
10005	1	MUSIC SYSTEM	SB	SB	GC TO INSTALL AND TEST SYSTEM
10010	1	DT ORDER MONITOR	SB	SB	
10012	1	DT COMMUNICATION SYSTEM	SB	SB	
10015	3	SPEAKER RECESSED - WHITE	SB	GC	
10017	2	SPEAKER SURFACE MOUNTED - BLACK	SB	GC	
12336	1	DT TIMER SYSTEM	SB	SB	
14676	1	DT POS MONITOR ARM DOUBLE SURFACE MOUNTED	SB	GC	
19339	1	AMPLIFIER - 40W	SB	SB	GC TO INSTALL AND TEST SYSTEM
DATA				1	
10002	1	COMPUTER MANAGER WORKSTATION	SB	SB	
10007	1	PRINTER MANAGER WORKSTATION	SB	SB	
18744	1	EQUIPMENT RACK WITH LOCK - 24IN 610MM	SB	SB	
20294	2	IOT MODULE	SB	SB	
POINT OF S	ALE			•	
10008	2	POS - REGISTER WITH COMPACT CASH DRAWER	SB	SB	GC TO COORDINATE WITH SBUX VENDOR.
10014	4	POS PRINTER	SB	SB	GC TO COORDINATE WITH SBUX VENDOR.
10022	1	MONEY COUNTER	SB	SB	GC TO COORDINATE WITH SBUX VENDOR
10029	6	POS BANK	SB	GC	
10075	3	CUP LABELER	SB	SB	GC TO COORDINATE WITH SBUX VENDOR.
14677	1	POS - DT TENDERING REGISTER	SB	SB	PART OF RETAIL IT EQUIPMENT PACKAGE.
14678	1	POS - DT EXPEDITOR	SB	SB	PART OF RETAIL IT EQUIPMENT PACKAGE.
SECURITY				•	
10024	1	SAFE LH - 20X18X26IN 510X455X660MM	SB	GC	GC TO COORDINATE WITH SBUX VENDOR; STORE MANAGER TO PROGRAM WITH VENDOR PROVIDE MANUAL.
10028	1	SAFE BASE	SB	GC	GC TO COORDINATE WITH SBUX VENDOR; STORE MANAGER TO PROGRAM WITH VENDOR PROVIDE MANUAL.

FURN. BY INST. BY

GC

GC

GC

COMMENTS

JAY R. SMITH MODEL #2005Y (B) OR EQUAL

ZURN MODEL #FD2375-NH3.

ZURN MODEL #FD2375-NH2.

DESCRIPTION

DRAIN - FLOOR SINK SQUARE - 12IN 305MM

DRAIN - FLOOR SINK SQUARE - 5IN 125MM

DRAIN - GRATE HALF SQUARE - 12IN 305MM

FAUCET - DOUBLE LABORATORY WITH BENT

FAUCET - DOUBLE LABORATORY WITH SWING

FAUCET - WATER TOWER - 12IN 305MM

		SPOUT			
10447	1	FAUCET - PRE RINSE SPRAYER WALL MOUNTED	SB	GC	
10597	2	FAUCET - SINGLE HANDLE	SB	GC	
10804	1	FAUCET - PRE RINSE SWING SPOUT	SB	GC	
10874	2	FAUCET - HOT WATER DISPENSER GOOSENECK	SB	GC	
10922	1	FAUCET - MOP SINK WALL MOUNTED	SB	GC	
11003	3	FAUCET - METERED	SB	GC	
13588	1	FAUCET - HAND SINK WALL MOUNTED	SB	GC	
15749	2	FAUCET - HOT AND COLD WATER SYSTEM	SB	GC	
X0010	2	FAUCET - STERN	GC	GC	STERN. CONDOR 1010. PART #07100005. CHROME. PART OF D 13 INTEGRATED SINK SYSTEM. CONTACT: D 13 GROUP. 245 WEST CENTRAL STREET, NATICK, MA 01760. PH: 617-307-1140. WWW.D13GROUP.COM
ILTER					
12501	1	FILTER - RO SYSTEM 600GPD	SB	SB	CONFIGURATION [III]. GC TO COORDINATE WITH SBUX VENDOR.
12507	1	FILTER - RO SYSTEM 40GAL STORAGE TANK	SB	SB	CONFIGURATION [III]. GC TO COORDINATE WITH SBUX VENDOR.
12896	1	FILTER - BRINE TANK	SB	SB	CONFIGURATION [III]. GC TO COORDINATE WITH SBUX VENDOR.
12899	2	FILTER - POLY GLASS VESSEL	SB	SB	CONFIGURATION [III]. GC TO COORDINATE WITH SBUX VENDOR.
13076	1	FILTER - PREFILTRATION SYSTEM	SB	SB	CONFIGURATION [III]. GC TO COORDINATE WITH SBUX VENDOR.
13082	1	FILTER - WATER SOFTENER TWIN	SB	SB	CONFIGURATION [III]. GC TO COORDINATE WITH SBUX VENDOR.
13149	1	FILTER - PRESSURE GAUGE	SB	SB	CONFIGURATION [III]. GC TO COORDINATE WITH SBUX VENDOR.
THER					
13384	1	WATER HEATER TANK GAS	GC	GC	AO SMITH CYCLONE XI MODEL #BTX-100, 129 GPH RECOVERY @90 DEGREE RISE. SET WATER HEATER TO 140 DEG MAX. ENERGY FACTOR = 0.96
SINK				l .	
10549	1	SINK - RINSE DROP IN SST - 12X20IN 305X510MM	SB	GC	
10995	1	SINK - MOP - 24X24IN 610X610MM	SB	GC	
12807	1	SINK - UTENSIL RINSE WITH GRATE SST - LH - 14X20IN 355X510MM	SB	GC	
13264	1	SINK - 3 COMP WORK SST - 93IN 2350MM	SB	GC	
14688	1	SINK - HAND WITH SIDE SPLASH WALL MOUNTED SST	SB	GC	
17565	1	SINK - RINSE WITH DRAINBOARD - 15X27IN 380X685MM	SB	GC	
17632	1	SINK - STACKED DRAINBOARD - 15IN 380MM	SB	GC	
18743	1	SINK - WATER FILLING STATION - 36X24IN 915X610MM	SB	GC	
19277	2	SINK - COUNTERTOP RINSER WITH DRAIN TROUGH - 26X9IN 660X235MM	SB	GC	
X0012	2	SINK - D13	GC	GC	D 13 INTEGRATED SINK SYSTEM. 30IN XLERATORSYNC SYSTEM WITH A SINGLE BASIN SINK WITH A PIVOT DRAIN COVER. GLACIER WHITE CONTENT TOP AND
					ENCLOSURE PANELS. BASIN COLOR: D 13 WHITE. ORDER WITH LOCKING SLIDING DOOR & SECURITY PANEL. CONTACT: D 13 GROUP. 245 WEST CENTRAL STREET, NATICK, MA 01760. PH: 617-307-1140. WWW.D13GROUP.CO
OILET					
	2	TOILET - TANKLESS EFFICIENT SINGLE FLUSH	GC	GC	SLOAN MODEL ST-2020-1.28 (1.28 GPF)
12951	2	TOILET - FLUSH VALVE AUTOMATIC EFFICIENT	GC	GC	CROWN MODEL 81-2020-1.28 (1.28 GPF)

DESIGN ID	COUNT	DESCRIPTION	FURN. BY	INST. BY	Y COMMENTS				
FAN									
10894	1	FAN - DT AIR CURTAIN WITH HEATER - 48IN 1220MM	LL	LL	INCLUDED AS PART OF DT WINDOW PACKAGE. READY ACCESS AA300-275 PASS THRU AIR CURTAIN SYSTEM. CONTACT: ANNA ELLIS, ANNA@READY-ACCESS.COM				
X0003	1	FAN - WALL MOUNTED FAN - PATIO	GC	GC	GLOBAL INDUSTRIAL 30IN OSCILLATING WALL MOUNTE FAN. ITEM #T9F292451. GC TO PROVIDE MOUNTING PAR AS NEEDED. LL TO PROVIDE ELECTRICAL POWER.				
OTHER			<u>'</u>						
17797	1	ENERGY MANAGEMENT SYSTEM - HVAC ONLY	SB	GC					
X0028	3	ACCESS PANELS	GC	GC	BAUCO PLUSS III SINGLE LEAF CEILING ACCESS PANEL TOUCH LATCH. CONCEALED HARDWARE. CONTACT: 250.592.0033 / INFO@ACCESSPANELSOLUTIONS.COM F TO MATCH HOST CEILING				

SITE SCHEDULE - "Y"

DESIGN ID	COUNT	DESCRIPTION	FURN. BY	INST. BY	COMMENTS
EXTERIOR N	MENU		•	•	
14116	1	MENU BOARD - DT DIGITAL ORDER SCREEN - FLAT BLACK MT0028		SB/GC	SUPPLIER: IT EQUIPMENT VENDOR (ZONES). SCREEN INSTALLER: REGIONAL SIGNAGE VENDOR. ELECTRICAL: GC CONNECTS DOS WHIPS & STUB-UPS TO DCB.
14119	14119 1 MENU BOARD - DT 5 PANEL FREESTANDING - 108X65IN 2745X1650MM - FLAT BLACK MT0028		SB	SB	SUPPLIER: DT SIGNAGE VENDOR (DSA). INSTALLER: REGIONAL SIGNAGE VENDOR. LL TO PROVIDE CONDUIT, FOOTING, AND ANCHOR BOLTS PER LLWL.
14120	1	MENU BOARD - DT PRE MENU FREESTANDING - 36X65IN 915X1650MM - FLAT BLACK MT0028	SB	SB	PROVIDED AND INSTALLED BY SIGNAGE VENDOR. LANDLORD GC TO PROVIDE FOOTING & ELECTRICAL AS SPECIFIED PER LLWL.
15700	1	MENU BOARD - DT DIGITAL ORDER SCREEN CONTROL BOX	SB	SB/GC	SUPPLIER: IT EQUIPMENT VENDOR (ZONES). INSTALLER: REGIONAL SIGNAGE VENDOR. ELECTRICAL CONNECTION: GC. LL TO PROVIDE FOOTING, CONDUIT, AND ANCHOR BOLTS PER LLWL.
OTHER				•	
14103	11	BOLLARD NONILLUMINATED SQUARE - FLAT BLACK MT0028	LL	LL	SUPPLIER/INSTALLER: LL. DSA PHOTOTECH. SEE DETAILS.
14163	1	DT ORDER POINT CANOPY FREESTANDING - FLAT BLACK MT0028	SB	SB	SUPPLIER: DT SIGNAGE VENDOR (DSA). INSTALLER: REGIONAL SIGNAGE VENDOR. LL TO PROVIDE AND INSTALL CONDUIT, FOOTING, AND ANCHOR BOLTS PER LLWL.
18818	4	LIGHT POLE - 10FT 300CM - FLAT BLACK MT0028	LL	LL	
18820	4	LIGHT POLE BASE PLATE - FLAT BLACK MT0028	LL	LL	
X0001	2	VEHICLE DETECTOR LOOP	SB	GC/LL	SUPPLIER: DT AUDIO VENDOR (HME). INSTALLER:GC. LL TO PROVIDE CONDUIT PER LLWL.
X0004	5	PLANTER BOXES - 84X36X18IN	LL	LL	LL TO PROVIDE DRAINAGE AND AUTOMATED IRRIGATION PER LLWL REQUIREMENTS. LL TO PROVIDE SPEC TO DESIGNER FOR APPROVAL.
X0008	1	BIKE RACK - OLYMPIA	LL	LL	FORMS & SURFACES: OLYMPIA BIKE RACK. WWW.FORMS-SURFACES.COM; INSTALL PER MANUFACTURER'S RECOMMENDATIONS.
X0009	20	NATIVE PLANTS FOR PLANTER BOXES	LL	LL	LANDSCAPING SELECTION AND QTY VERIFICATION BY LANDLORD. PROVIDE DRAUGHT-RESISTANT, NATIVE PLANTS WITH MINIMUM MAINTENANCE REQUIREMENTS.
UMBRELLA				1	
12147	3	UMBRELLA - BASE 95LB 43KG - FLAT BLACK MT0028	SB	GC	
20075	3	UMBRELLA - WITHOUT VALANCE - 6FT 183CM - BLACK CANVAS WITH WORDMARK F0061	SB	GC	

DESIGN ID	COUNT	DESCRIPTION	FURN. BY	INST. BY	BULB	COMMENTS
XIT			1	1	I	
11483	1	EXIT - SECURITY LIGHT WALL MOUNTED	LL	LL	HID 150W OR EQUAL	
19044	5	LED EXIT SIGN WITH EMERGENCY LIGHT - WHITE AND RED	SB	GC		CAFE EXIT SIGNS TO BE SUSPENDED.
19057	4	LED EMERGENCY LIGHT DOUBLE - BLACK	SB	GC	INTEGRATED LED	
THER						
17796	7	LED STRING LIGHTS - 48FT 1463CM	SB	GC	INTEGRATED LED	POWER BY LANDLORD. TOTAL LENGTH REQUIRED: 130FT
ECESSED	CAN					
19023	32	CAN - LED MOUNTING FRAME - 2IN 50MM - NEW CEILING	SB	GC		
19113	28	CAN - LED ADJUSTABLE GIMBAL WITH DRIVER - 2IN 50MM - WHITE - 1000LM NFL	SB	GC		
19120	4	CAN - LED DOWNLIGHT REFLECTOR WITH DRIVER SQUARE - 2IN 50MM - WHITE - 1000LM FLOOD	SB	GC	INTEGRATED LED	
CONCE				1	1	
20711	6	SCONCE - HINKLEY ATLANTIS LARGE - BLACK	LL	LL	INTEGRATED LED	DOLAN HOSPITALITY MFR #376769 ATLANTIS OUTDOOR SCONCE
20750	2	SCONCE - KUZCO PLUTO TRIPLE - VINTAGE BRASS	SB	GC	INTEGRATED LED	
SIGNAGE - C	OTHER			·		
21163	1	SIGN - MOBILE ORDER PICK UP ILLUMINATED BLADE MOUNT	SB	GC		GC TO PROVIDE BLOCKING AND ELECTRICAL IN SOFFIT AS REQUIRED
X0030	1	SIGN - MOBILE ORDER PICK UP SIGN EXTENSION LEGS	SB	GC		BY WALTON. ORDER 4FT LEGS, CUT IN FIELD FOR BOTTOM AT 7'-6" AFF, REFER TO INTERIOR ELEVATIONS FOR EXACT DIMENSION
STRIP						
14410	1	STRIP - LED TAPE - VARIABLE LENGTH	SB	GC	INTEGRATED LED	LENGTH: 43'-9"
RACK				•		
12934	2	TRACK - WITH CONNECTORS - 4FT 122CM - WHITE - 1 CIRCUIT	SB	GC		
12944	3	TRACK - WITH CONNECTORS - 16FT 488CM - WHITE - 1 CIRCUIT	SB	GC		
12945	5	TRACK - WITH CONNECTORS - 12FT 365CM - WHITE - 1 CIRCUIT	SB	GC		
15059	1	TRACK - WITH CONNECTORS - 6FT 183CM - WHITE - 1 CIRCUIT	SB	GC		
19071	4	TRACK - LED FIXTURE - 2IN 50MM - WHITE - 900LM SPOT	SB	GC	INTEGRATED LED	
19072	14	TRACK - LED FIXTURE - 2IN 50MM - WHITE - 600LM FLOOD	SB	GC	INTEGRATED LED	
19074	35	TRACK - LED FIXTURE - 2IN 50MM - WHITE - 900LM FLOOD	SB	GC	INTEGRATED LED	
19087	53	TRACK - HEX CELL LOUVER - 2IN 50MM	SB	GC		
roffer		1	I	1	1	
15057	7	TROFFER - LED RECESSED - 24X48IN 600X1200MM - WHITE - 4000LM	SB	GC	INTEGRATED LED	



**STARBUCKS**<sup>®</sup>

2401 UTAH AVENUE SOUTH SEATTLE, WASHINGTON 98134 (206) 318-1575

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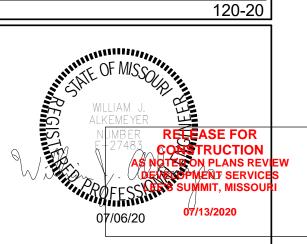
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**Engineering Consultant** 



## **⊘** ⊗ T OF STARBUCK - NW PRYOR RD | - LEE'S SUMMIT LOT VEST PRYOR, I ENSTEIN DR. MO NTY BUILDOUT COFFEE - NCHIPMAN -

STORE #: 62012 PROJECT #: 87799-001

ISSUE DATE: 07-07-2020
SR. DESIGN MANAGER: K. GORIN SLONSKI
PRODUCTION DESIGNER: A. HAHN
CHECKED BY: NJD/BMS

**Revision Schedule** Rev Date By Description

Rev	Date	Ву	Description
SHE	ET TITLE:		

E602

SCHEDULES SCALE: AS SHOWN

SHEET NUMBER:

**ABBREVIATIONS** ABOVE FINISHED FLOOR **AUTHORITIES HAVING JURISDICTION** AHJ APPROX APPROXIMATE BLDG BUILDING CO2 **CARBON DIOXIDE** CD **CEILING DIFFUSER** CLG CEILING CONST CONSTRUCTION CXA COMMISSIONING AGENT DEG **DEGREES** DM DN STARBUCKS DESIGN MANAGER DOWN DTL **DETAIL** DWG(S) DRAWING(S) EA EC EACH **ELECTRICAL CONTRACTOR** ECP **EQUIPMENT CONTROL PAC** EG **EXHAUST GRILLE** ELEC **ELECTRICAL EMERGENCY** ΕM **ENERGY MANAGEMENT SYSTEM EXISTING** EXIST EXT **EXTERIOR FURNISH & INSTALL** F&I FLR **FLOOR** FT FOOT/FEET **GAS PIPING** GENERAL CONTRACTOR GC HOUR HEATING, VENTILATION, AIR CONDITIONING HVAC I.D. **INSIDE DIAMETER** IAQ INDOOR AIR QUALITY LCP LIGHTING CONTROL PANEL LANDLORD LV LOW VOLTAGE MAX MAXIMUM MC MECHANICAL CONTRACTOR MECH **MECHANICAL** MEP MECHANICAL, ELECTRICAL AND PLUMBING MFG MANUFACTURER MIN MINIMUM NTS NOT TO SCALE O.D. **OUTSIDE DIMENSION** OSA OUTSIDE AIR REF REFERENCE REQ'D REQUIRED REV REVISION RT ROOFTOP SF SQUARE FEET SHT SHEET SPECS SPECIFICATION(S) SST STAINLESS STEEL

**TEMP** 

TYP

WH

**TEMPORARY** 

WATER HEATER

**UNLESS NOTED OTHERWISE** 

WATER SOURCE HEAT PUMP

**TYPICAL** 

#### MECHANICAL SYMBOL LEGEND

TYPICAL SUPPLY DUCT UP/DN TYPICAL RETURN OR EXHAUST DUCT UP/DN TURNING VANES

EF-1 **EQUIPMENT DESIGNATION** 

THERMOSTAT

TEMPERATURE SENSOR

AIRFLOW ARROW

INDICATES UNLINED 12" X 8" O.D. SHEETMETAL 12 X 8 1ST FIGURE = SIDE SHOWN 2ND FIGURE = SIDE NOT SHOWN **FLEXIBLE DUCT** 

M H001 DIFFUSER ITEM# XXX CFM DESIGN CFM (WHERE APPLICABLE) **NECK SIZE** 

**CEILING DIFFUSER** 

**CEILING RETURN GRILLE** 

**CEILING EXHAUST GRILLE** 

#### **CONTROLS AND OPERATION NOTES**

THE GENERAL CONTRACTOR SHALL FURNISH AND INSTALL THE FOLLOWING COMPONENTS:

THE MECHANICAL CONTRACTOR SHALL PROVIDE ALL CONTROL WIRING IN CONDUIT NECESSARY FOR THE COMPLETE AND PROPER OPERATING TEMPERATURE CONTROL SYSTEM INCLUDING ALL MODES OF OPERATION AND INTERLOCK.

RESTROOM EXHAUST FAN(S) TO BE OPERATED IN CONJUNCTION WITH STORE HOURS UNLESS OTHERWISE NOTED OR APPROVED OR AS REQUIRED BY JURISDICTION (COORDINATE WITH ELECTRICAL).

PERMANENT THERMOSTAT(S) AND REMOTE SENSOR(S) SHALL BE FURNISHED AND INSTALLED. ONE THERMOSTAT AND SENSOR IS PROVIDED FOR EACH UNIT. MOUNT THERMOSTAT(S) AND SENSOR(S) IN LOCATION & HEIGHT AS INDICATED ON DRAWINGS. MECHANICAL CONTRACTOR TO PROVIDE THERMOSTAT IDENTIFICATION LABELS PER SPECIFICATION REQUIREMENTS. REFER TO THERMOSTAT SETUP INSTRUCTIONS BELOW FOR ADDITIONAL REQUIREMENTS.

#### THERMOSTAT SETUP INSTRUCTIONS

- PROVIDE THE FOLLOWING SETUP AND PROGRAMMING:
  - 1. CONFIGURE AS FOLLOWS: A. DEGREES "F" DISPLAY
    - B. 12 HOUR CLOCK C. CONTINUOUS FAN OPERATION IN OCCUPIED

  - D. DISABLE KEYBOARD PROGRAMMING 2. SET TIME AND DATE.
  - SET TO DISPLAY CURRENT TEMPERATURE. 4. SET OCCUPIED START TIME AT 30 MIN. BEFORE OPENING. SET UNOCCUPIED START TIME AT 30 MIN. AFTER CLOSING. VERIFY HOURS WITH STORE MANAGER OR CONSTRUCTION MANAGER.
  - 5. SET POINTS SHALL BE AS FOLLOWS OR AS APPROPRIATE
  - FOR CLIMATE: A. OCCUPIED (5° F DEADBAND) (3° C DEADBAND) HEATING: 70° F (21° C)
  - II. COOLING: 75° F (24° C) B. UNOCCUPIED HEATING: 60° F (15° C)
  - II. COOLING: 78° F (25° C) 6. SET TWO (2) HOUR OCCUPIED OVÉRRIDE FUNCTION TO PROVIDE THE FOLLOWING SET POINT OVERRIDES:
    - A. HEATING:  $+2^{\circ}$  F (1 $^{\circ}$  C) B COOLING: -2° F (1° C)

#### SYSTEM COMMISSIONING

CONTRACTOR RESPONSIBILITIES FOR BUILDING COMMISSIONING

CONTRACTOR SHALL PROVIDE SUPPORT AND WORK AS SPECIFIED, NEEDED AND REQUIRED TO CONDUCT AND FACILITATE STARBUCKS STAFF BUILDING COMMISSIONING EFFORTS. THIS WORK WILL BE COMPRISED OF THREE DISTINCT EFFORTS:

SUPPORT STARBUCKS COMMISSIONING AGENT (CXA) DURING INSTALLATION VERIFICATION AND CORRECT DISCLOSED DEFICIENCIES.

PERFORM TESTING, ADJUSTING, BALANCING AND SYSTEM STARTUP AND SUPPORT FUNCTIONAL PERFORMANCE TESTING BY STARBUCKS CXA;

CORRECT DEFICIENCIES DISCLOSED BY FUNCTIONAL PERFORMANCE TESTING AND SUBMIT REPORTS.

CONTRACTOR SHALL PERFORM AND PROVIDE THE FOLLOWING:

- A. SYSTEMS SUBJECT TO COMMISSIONING MAY INCLUDE, BUT ARE NOT LIMITED TO DOMESTIC HOT WATER GENERATION, HVAC SYSTEMS, ROOFTOP UNITS, EXHAUST FANS, HVAC CONTROLS, LIGHTING CONTROLS, AIR CURTAINS, BUILT-IN REFRIGERATION, EQUIPMENT AND RENEWABLE ENERGY SYSTEMS.
- B. CONTRACTOR SHALL PROVIDE WRITTEN RESPONSES TO ALL CXA'S REVIEWS AND COMMENTS. RESPONSES SHALL BE PROVIDED IN A TIMELY MANNER.
- C. CONTRACTOR SHALL INCLUDE COMMISSIONING ACTIVITIES IN PROJECT SCHEDULE AND SHOW INTERVALS FOR PERFORMANCE OF WORK FOR WHICH CONTRACTOR IS RESPONSIBLE AND INTERVALS FOR WORK PERFORMED BY STARBUCKS CXA. CONTRACTOR SHALL SHOW RESOURCES FOR PERFORMING ALL WORK RELATED TO COMMISSIONING ACTIVITIES ON A LINE ITEM IN THE SCHEDULE OF VALUES.
- D. CONTRACTOR SHALL INSTALL EQUIPMENT IN ACCORDANCE WITH THE MANUFACTURER'S REQUIREMENTS AND ALL CONTRACT DOCUMENTS. ENSURE THAT ALL EQUIPMENT IS INSTALLED TOTALLY COMPLETE AND ACCESSIBLE TO STARBUCKS CXA FOR INSTALLATION VERIFICATION AND FUNCTIONAL PERFORMANCE TESTING PRIOR TO THE SCHEDULED START OF INSTALLATION VERIFICATION.
- CONTRACTOR SHALL COMPLETE MANUFACTURER'S STARTUP PROCEDURES PRIOR TO COMMISSIONING COORDINATION WITH
- F. CONTRACTOR SHALL BE READILY AVAILABLE DURING INSTALLATION VERIFICATION TO CORRECT ANY DEFICIENCIES OR DEFECTS IS CLOSED BY THE INSTALLATION VERIFICATION PROCESS. CORRECTIONS SHALL BE MADE IN A TIMELY MANNER WITHOUT DISRUPTION OF THE CONSTRUCTION SCHEDULE.
- G. ALL HVAC EXHAUST FAN AND AIR CURTAIN EQUIPMENT SHALL BE TESTED, ADJUSTED AND BALANCED BY THE CONTRACTOR'S TESTING, ADJUSTING AND BALANCE AGENT (SEE TESTING ADJUSTING AND BALANCING) AFTER THE SYSTEM IS VERIFIED TO BE COMPLETE AND CORRECT BY STARBUCKS CXA, IN ACCORDANCE WITH THE REQUIREMENTS OF THESE DOCUMENTS. ALL HVAC CONTROL SYSTEMS SHALL BE TESTED TO ENSURE THAT CONTROL DEVICES, COMPONENTS, EQUIPMENT AND SYSTEMS ARE CALIBRATED, ADJUSTED AND OPERATE IN ACCORDANCE WITH THESE PLANS AND SPECIFICATIONS. SEQUENCES OF OPERATION SHALL BE TESTED TO ENSURE THAT THEY OPERATE IN ACCORDANCE WITH THE CONTRACT REQUIREMENTS. DELIVERABLES: PRELIMINARY, WRITTEN TESTING AND AIR BALANCE REPORT CONFORMING TO THE REQUIREMENTS SPECIFIED HEREIN, DOCUMENTING THE INFORMATION SPECIFIED, ETC... TO THE STARBUCKS CXA IMMEDIATELY UPON COMPLETION OF THE WORK.
- H. PROVIDE A LIST OF ALL FACTORY AND FIELD SETTINGS THAT HAVE BEEN PROGRAMMED INTO THE EQUIPMENT (SUCH AS SETPOINTS, SCHEDULES, DIP SWITCH SETTINGS, CONDENSER AND EVAPORATOR OPERATING PRESSURE/TEMPERATURE.
- CONTRACTOR SHALL INFORM STARBUCKS CXA WHEN EQUIPMENT IS READY FOR FUNCTIONAL PERFORMANCE TESTING. ALL EQUIPMENT SHALL BE READY FOR FUNCTIONAL PERFORMANCE TESTING PRIOR TO STARTING TESTING. THIS INCLUDES REHEARSING ALL FUNCTIONAL PERFORMANCE TESTS BEFORE DEMONSTRATING TO THE CXA. CONTRACTOR SHALL OPERATE EQUIPMENT FOR STARBUCKS CXA AND VERIFY BY DEMONSTRATING THE CORRECT OPERATION OF EQUIPMENT SENSOR CALIBRATION, RESPONSE OF ACTUATORS AND PROPER EXECUTION OF HVAC CONTROL AND LIGHTING SEQUENCES, INCLUDING BUT NOT LIMITED TO AIR MOVEMENT, TEMPERATURE, SOUND AND CONTROL RESPONSE. PROVIDE ANY SECURITY ACCESS. HARDWARE. SOFTWARE OR OTHER SUPPORT AS NEEDED FOR THE STARBUCKS CXA TO EFFICIENTLY WITNESS AND DOCUMENT ALL EQUIPMENT TESTING. STARBUCKS CXA WILL RECORD THE EQUIPMENT OPERATION AND RESPONSE TO TESTING SEQUENCES AND PREPARE A LIST OF ANY DEFICIENCIES DISCLOSED BY THE FUNCTIONAL PERFORMANCE TESTS FOR CORRECTION BY THE CONTRACTOR. EQUIPMENT INCLUDES, BUT IS NOT LIMITED TO, AIR HANDLING UNITS, ROOFTOP AND SPLIT TYPE, CONDENSING UNITS, EXHAUST FANS, LIGHTING CONTROLS, ETC... DELIVERABLES: PROVIDE COMPLETED COPIES OF ALL START UP REPORTS, FILLED OUT ON THE MANUFACTURER'S FORMS, TO THE STARBUCKS CXA.
- J. CONTRACTOR IS RESPONSIBLE FOR CORRECTING ANY ISSUES OR DEFICIENCIES DISCLOSED DURING THE FUNCTIONAL PERFORMANCE TESTING PROCESS. CORRECTIONS SHOULD BE MADE IN A TIMELY MANNER WITHOUT DISRUPTION TO THE SYSTEM AND CONSTRUCTION SCHEDULE.
- K. CONTRACTOR SHALL BE READILY AVAILABLE FOR ANY RE-TESTING OF EQUIPMENT DEEMED NECESSARY BY STARBUCKS CXA DURING INSTALLATION VERIFICATION AND FUNCTIONAL PERFORMANCE TESTING. CONTRACTOR IS RESPONSIBLE FOR CORRECTING ANY ISSUES OR DEFICIENCIES FOUND IN THE SYSTEM DURING ANY AND ALL RE-TESTING. CORRECTIONS SHOULD BE MADE IN A TIMELY MANNER WITHOUT DISRUPTION TO THE SYSTEM AND CONSTRUCTION SCHEDULE. DELIVERABLES: FINAL BALANCE REPORT, DEFICIENCIES LIST NOTING CORRECTIVE ACTIONS PERFORMED BY CONTRACTOR IN RESPONSE TO INSTALLATION VERIFICATION AND FUNCTIONAL PERFORMANCE TEST RESULTS.
- CONSTRUCTION AND POST CONSTRUCTION TESTING: ADDITIONAL TESTING MAY BE REQUIRED BY LEED AND OTHER PROCESSES THAT MAY OCCUR OUT OF SEQUENCE WITH COMMISSIONING SERVICE. CONTRACTOR SHALL CONDUCT. DOCUMENT, SUPPORT AND SCHEDULE THIS TESTING AS DIRECTED BY STARBUCKS CXA.

#### SYSTEM COMMISSIONING (continued)

- M. CONTRACTOR SHALL PROVIDE A TRAINING PLAN FOR EACH TRADE (MECHANICAL, ELECTRICAL, PLUMBING, RENEWABLE SYSTEMS) FOR THE CXA'S APPROVAL. THE TRAINING PLAN SHALI OUTLINE ALL THE TOPICS THAT ARE TO BE COVERED ALONG WITH THE TIME DURATION FOR EACH TOPIC. IT SHALL ALSO INCLUDE THE INSTRUCTOR'S NAME, QUALIFICATIONS AND COMPANY LOGO
- N. THE CONTRACTOR IS RESPONSIBLE FOR RECORDING ATTENDANCE FOR EACH TRAINING SESSION. COPIES OF THESE SHALL BE SUBMITTED TO THE CXA.
- O. CONTRACTOR SHALL SUBMIT O&M MANUALS FOR ALL PIECES OF EQUIPMENT AT LEAST 6 WEEKS IN ADVANCE OF THE TRAINING

#### HVAC EQUIPMENT AND MATERIALS

FILTERS
IF OPERATING HVAC DURING CONSTRUCTION, PROVIDE THREE (3) SETS OF 2" (51MM) MERV6 PLEATED DISPOSABLE FILTERS (OR HIGHER RATING IF REQUIRED BY LEED). USE ONE SET UNTIL COMPLETION OF CONSTRUCTION. INSTALL ONE SET AT COMPLETION OF CONSTRUCTION (PRIOR TO TAB) AND DELIVER ONE SET OF MERV13 FILTERS TO STARBUCKS LABELED TO DENOTE THEIR RESPECTIVE AIR HANDLING UNIT.

BRACING AND ANCHORING

ALL MECHANICAL EQUIPMENT, FIXED OR FLEXIBLY MOUNTED. SHALL BE BRACED OR ANCHORED TO COMPLY WITH LOCAL CODES.

#### **DUCTWORK AND ACCESSORIES**

SHEET METAL DUCTWORK
ASSEMBLE AND INSTALL DUCTWORK IN ACCORDANCE WITH RECOGNIZED INDUSTRY PRACTICE FOR ACHIEVING AIR TIGHT (5% LEAKAGE) AND NOISELESS (NO OBJECTIONABLE NOISE) SYSTEMS. NO VARIATION OF DUCT CONFIGURATION OR SIZES WILL BE PERMITTED EXCEPT BY PERMISSION FROM THE ENGINEER.

PROVIDE CONVENIENTLY LOCATED ACCESS DOORS OF AMPLE SIZE AND QUANTITY FOR SERVICING THE DAMPERS. PROVIDE MOTORIZED DAMPERS AT ALL INTAKE & EXHAUST BUILDING OPENINGS. COORDINATE WITH OTHER TRADES FOR ACCESS PANELS, POWER AND FIRE ALARM INTERFACES. SEE PROJECT MANUAL

ACOUSTICAL DUCT LINER
UNLESS OTHERWISE INDICATED ON THE PLANS, PROVIDE 1" (25MM) ACOUSTICAL DUCT LINER IN SUPPLY AND RETURN DUCTWORK WITHIN 10'-0" (305CM) OF THE DISCHARGE AND INTAKE OF AIR HANDLING UNITS. INCREASE DUCT SIZE INDICATED ON PLANS AS NEEDED TO ACCOMMODATE LINER. LINER TO BE PROVIDED AND FASTENED TO DUCT WITH MECHANICAL LINER FASTENERS IN ACCORDANCE WITH SMACNA AND PROJECT MANUAL

FLEXIBLE DUCT WORK SHALL ONLY BE INSTALLED AS SHOWN IN PLAN AND NOT ABOVE HARD LID CEILINGS. FLEXIBLE DUCTWORK SHALL NOT EXCEED 5'-0" (152CM) IN LENGTH AND TWO 45° ELBOWS. IT SHALL BE PULLED TAUT AND APPROPRIATELY FASTENED TO RIGID BRANCH DUCT & DIFFUSER. BENDS SHALL BE MINIMIZED AND WHERE NEEDED BE A FULL RADIUS BEND SUPPORT BANDS SHALL BE INSTALLED SO AS TO NOT CRIMP FLEX DUCT. FLEXIBLE DUCTWORK SHALL MEET REQUIREMENTS.

#### TESTING, ADJUSTING, BALANCING

INDEPENDENT AIR BALANCE CONTRACTOR OR QUALIFIED MECHANICAL CONTRACTOR SHALL BE QUALIFIED BY NEBB OR AABC STANDARDS. BALANCER SHALL ACCURATELY BALANCE THE SUPPLY, RETURN AND OUTSIDE AIR, EXHAUST FAN(S), HYDRONIC (WHERE APPLICABLE) AND EXHAUST FAN(S) SYSTEMS TO PROVIDE AIR AND WATER QUANTITIES WITHIN 10% PLUS MINUS OF THE VALUES INDICATED ON THE DRAWINGS AND IN THE SPECIFICATIONS UNLESS MANUFACTURER REQUIRES TIGHTER TOLERANCES. OPERATE AUTOMATIC CONTROLS SYSTEMS AND VERIFY SETPOINTS FOR THERMOSTATS, C02 SENSORS, DCV, EMS AND ECONOMIZER/OUTSIDE AIR DAMPER. SEE CONTROLS AND OPERATION NOTES AND HVAC SCHEDULES AND NOTES FOR DETAILS. IF DEFICIENCIES OR SITE CONDITIONS PREVENT COMPLETE AND PROPER BALANCING, DO NOT COMPLETE WORK AND SUBMIT A REQUEST FOR INFORMATION TO GET COMPLETE INFORMATION PRIOR TO COMPLETING WORK. SUBMIT THREE (3) COPIES OF THE BALANCE REPORT TO THE ENGINEER, CONSTRUCTION MANAGER AND COMMISSIONING AGENT FOR APPROVAL. THE BALANCE REPORT SHALL INCLUDE NEBB OR AABC CREDENTIALS. EQUIPMENT/INSTRUMENT LIST WIT THE MOST RECENT CALIBRATION DATE AND BALANCE REPORTS FOR ALL HVAC AND EXHAUST SYSTEMS. T&B REPORT SHOULD MATCH NEBB OR AABC STANDARD REPORTS INCLUDING UNIT TEST DATA WITH TEMPERATURES, PRESSURES AND STATIC PRESSURE PROFILES. INCLUDE A COPY OF THE BALANCE REPORT AS APPROVED BY THE ENGINEER WITH APPLICATION FOR FINAL CONTRACT PAYMENT.

#### IAQ MANAGEMENT PLAN

DURING CONSTRUCTION, CONTRACTOR SHALL COMPLY WITH CHAPTER 3 OF SMACNA'S IAQ GUIDELINES FOR OCCUPIED BUILDINGS UNDER CONSTRUCTION. CONTRACTOR SHALL PERFORM AND SUBMIT ALL INFORMATION AS REQUIRED. IF HVAC SYSTEM IS TO BE USED DURING CONSTRUCTION, INSTALL MERV 8 FILTERS AT EACH RETURN AIR GRILL AND COMPLY WITH SMACNA'S GUIDELINES.

#### **ENERGY MANAGEMENT SYSTEM (EMS)**

THE GENERAL CONTRACTOR SHALL INSTALL (OR DEMO AND REINSTALL FOR RENOVATIONS) THE VENSTAR SURVEYOR EMS SYSTEMS PRIOR TO THE LAST WEEK OF CONSTRUCTION. GENERAL CONTRACTOR TO PROVIDE ONE PERMANENT THERMOSTAT AND REMOTE SENSOR PER HVAC UNIT. LOCATE AND MOUNT THERMOSTAT(S) AND SENSOR(S) PER THE DRAWINGS. PROVIDE THERMOSTAT IDENTIFICATION LABELS PER SPECIFICATION REQUIREMENTS.

GENERAL CONTRACTOR TO PROGRAM, START-UP AND COMMISSION THE CONTROL SYSTEM. GENERAL CONTRACTOR IS TO COMPLETE FINAL CONNECTION AFTER DATA RACK AND NETWORK INSTALLATIONS. GENERAL CONTRACTOR VENDOR TO VERIFY SYSTEM OPERATION AND TROUBLESHOOT IF REQUIRED. GENERAL CONTRACTOR TO COMPLETE SURVEYOR'S STARBUCKS INSTALLATION SURVEY FORM AND PROVIDE TWO (2) COMPLETED COPIES OF THIS DOCUMENT TO THE CONSTRUCTION MANAGER AND COMMISSIONING AGENT PRIOR TO FINAL PAYMENT.

#### GENERAL MECHANICAL NOTES

- MECHANICAL CONTRACTOR SHALL COORDINATE WITH THE GENERAL CONTRACTOR TO PATCH AND REPAIR ALL EXISTING WALLS, FLOORS, CEILINGS OR OTHER SURFACES IDENTIFIED TO REMAIN THAT MAY BECOME DAMAGED DURING THE COURSE OF WORK
- 2. DRAWINGS ARE DIAGRAMMATIC AND INDICATE GENERAL INTENT OR ARRANGEMENT OF SYSTEM(S). FURNISH & INSTALL ALL COMPONENTS NEEDED WHETHER INDICATED OR NOT TO PROVIDE A COMPLETE AND OPERATING SYSTEM.
- CONTRACTOR TO VERIFY ALL DIMENSIONS, INCLUDING CLEARANCES REQUIRED BY OTHER TRADES, AND NOTIFY STARBUCKS CONSTRUCTION MANAGER OF ANY DISCREPANCIES PRIOR TO PROCEEDING WITH THE WORK. ALL DIMENSIONS ARE TO THE FACE OF THE FINISHED SURFACE UNLESS NOTED OTHERWISE. ALL DIMENSIONS TO BE TAKEN FROM ACTUAL BUILDING DIMENSIONS.
- 4. THE MECHANICAL CONTRACTOR SHALL COORDINATE HVAC WORK WITH OTHER TRADES. THE ARCHITECTURAL DRAWINGS AND PROJECT MANUAL SHALL TAKE PRECEDENCE OVER ALL OTHER DRAWINGS. SEE ARCHITECTURAL DRAWINGS AND PROJECT MANUAL FOR DIMENSIONED DIFFUSER LOCATIONS AND MOUNTING HEIGHTS WHERE EXPOSED.
- 5. NEW DUCTWORK AND EQUIPMENT SHALL NOT BE INSTALLED WHERE IT OBSTRUCTS ANY EXISTING OR NEW AREAS THAT REQUIRE ACCESS.
- INSULATE DUCTWORK PER CODE AND SPEC. REQUIREMENTS. COORDINATE CLEARANCE REQUIREMENTS FOR ADDED INSULATION.
- 7. ALL IS NEW UNLESS NOTED OTHERWISE.

#### **GENERAL NOTES**

THE INTENT OF THE PROJECT MANUAL AND THE DRAWINGS IS TO PROVIDE A COMPLETE AND FULLY OPERATIONAL MECHANICAL SYSTEM. THE MECHANICAL CONTRACTOR SHALL FURNISH ALL LABOR, MATERIAL, AND EQUIPMENT NECESSARY TO COMPLETE THE MECHANICAL WORK.

THE MECHANICAL CONTRACTOR SHALL THOROUGHLY EXAMINE ALL AREAS WHERE EQUIPMENT. DUCTWORK. AND PIPING WILL BE INSTALLED AND WILL REPORT ANY CONDITION THAT, IN HIS OPINION, PREVENTS THE PROPER INSTALLATION OF THE MECHANICAL WORK.

WHERE PIPES AND DUCTS PENETRATE WALL, SEAL OPENINGS TO PREVENT AIR TRANSFER BETWEEN SPACES. USE FIRE RATED SEALANTS ON ALL FIRE SEPARATION PENETRATIONS, INCLUDING FLOORS. SEAL AROUND ALL PIPES AND DUCTS PENETRATING FIRE SEPARATIONS WITH NON-COMBUSTIBLE PACKING RETAINED BY METAL COLLARS. THE ASSEMBLY SHALL BE APPROVED BY STATE FIRE MARSHALL.

**EQUIPMENT AND MATERIALS SHALL CONFORM WITH THE APPROPRIATE** PROVISIONS OF CSA, ULC, ARL, ASME, ASTM, UL, NEMA, ANSI, SMACNA, ASHRAE, NFPA, AS APPLICABLE TO EACH INDIVIDUAL UNIT OR ASSEMBLY.

ALL WORK SHALL BE PERFORMED IN STRICT ACCORDANCE WITH ALL APPLICABLE PROVINCIAL AND LOCAL CODES AND ORDINANCES. IN CASE OF CONFLICT BETWEEN THE DRAWINGS AND PROJECT MANUAL AND THE CODES AND ORDINANCES. USE WHICHEVER IS MORE STRINGENT. THE MECHANICAL CONTRACTOR SHALL SATISFY CODE REQUIREMENTS AS A MINIMUM STANDARD WITHOUT ANY EXTRA COST TO STARBUCKS.

PERMITS AND FEES

THE MECHANICAL CONTRACTOR SHALL PROCURE AND PAY FOR ALL PERMITS, FEES, AND INSPECTIONS NECESSARY TO COMPLETE THE MECHANICAL WORK.

THE MECHANICAL CONTRACTOR SHALL UNCONDITIONALLY WARRANT ALL WORK TO BE FREE OF DEFECTS IN MATERIAL AND WORKMANSHIP FOR A PERIOD OF ONE (1) YEAR FROM THE DATE OF FINAL ACCEPTANCE BY STARBUCKS AND WILL REPAIR OR REPLACE ANY DEFECTIVE WORK PROMPTLY AND WITHOUT CHARGE AND RESTORE ANY OTHER EXISTING WORK DAMAGED IN THE COURSE OF REPAIRING DEFECTIVE MATERIALS AND WORKMANSHIP.

#### LANDLORD REQUIREMENTS

PRIOR TO BID: THE GENERAL CONTRACTOR SHALL COORDINATE WITH LANDLORD / BUILDING OWNER FOR ANY CONSTRUCTION REQUIREMENTS. IF LANDLORD / BUILDING OWNER DOES HAVE REQUIREMENTS, CONTRACTOR SHALL BECOME COMPLETELY FAMILIAR WITH REQUIREMENTS AND ADHERE TO THEM. WHERE LANDLORD / BUILDING OWNER REQUIREMENTS ARE MORE STRINGENT THAN SHOWN IN THESE PLANS (IN THE OPINION OF THE ENGINEER). LANDLORD / BUILDING OWNER REQUIREMENTS SHALL GOVERN.



**STARBUCKS** 

2401 UTAH AVENUE SOUTH SEATTLE, WASHINGTON 98134 (206) 318-1575


THESE DRAWINGS AND THE PROJECT MANUAL ARE CONFIDENTIAL AND SHALL REMAIN THE SOLE PROPERTY O STARBUCKS CORPORATION, WHICH IS THE OWNER OF THE COPYRIGHT IN THIS WORK. THEY SHALL NOT BE REPRODUCE (IN WHOLE OR IN PART), SHARED WITH THIRD PARTIES OR USED IN ANY MANNER ON OTHER PROJECTS OR EXTENSIONS TO THIS PROJECT WITHOUT THE PRIOR WRITTEN CONSENT OF STARBUCKS CORPORATION. THESE DRAWINGS AND SPECIFICATIONS ARE INTENDED TO EXPRESS DESIGN INTENT FOR A PROTOTYPICAL STARBUCKS STORE (WHICH IS SUBJEC TO CHANGE AT ANYTIME) AND DO NOT REFLECT ACTUAL SITE CONDITIONS. NEITHER PARTY SHALL HAVE ANY OBLIGATION

STARBUCKS TEMPLATE VERSION i2020-01-31

NOR LIABILITY TO THE OTHER (EXCEPT STATED ABOVE) UNTIL A

WRITTEN AGREEMENT IS FULLY EXECUTED BY BOTH PARTIES



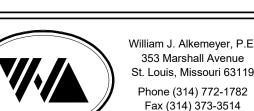

**Engineering Consultant** 

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62012 87799-001 07-07-2020 SR. DESIGN MANAGER: K. GORIN SLONSKI

> DMC **Revision Schedule**

PRODUCTION DESIGNER: A. HAHN

Description

MECHANICAL NOTES

SCALE: AS SHOWN

SHEET NUMBER:

#### ROOFTOP PACKAGED UNIT SCHEDULE (BY L.L.) **FAN SELECTION** COOLING CAP. HTG. CAP. WEIGHT EER | SEER | LOCATION | MARK **MANUFACTURER** NOTES **HEAT** SERVICE MOTOR (LBS) NOMINAL | TOTAL/SENS OUT & MODEL CFM O.A. E.S.P. RPM DB/WB (KW) Hz MCA MOCP (TON) (MBH) (MBH) (MBH) 4000 10 208 ROOF CAFE 1,2,3,4,5,6,7,8,9,10 1500 RTU-1 700 1.0 1465 80/67 113.97/94.06 250 200 60 46.1 3.8 12.4 YHC120F BACKBAR/ RTU-2 1,2,3,4,5,6,7,8,9,10 1500 4000 200 1.0 1465 80/67 10 113.97/94.06 250 200 208 60 46.1 **ROOF** 3.8 60 | 12.4 | YHC120F WORKROOM

NEW ELECTRIC COOLING/GAS HEATING ROOFTOP PACKAGED UNIT BY LANDLORD. VERIFY FINAL LOCATION AT JOBSITE.

HIGH EFFICIENCY, DOWN DISCHARGE CONFIGURATION. MOUNT ON CURB WITH NEW ROOF OPENING.

PROVIDE WITH FACTORY INSTALLED UNIT MOUNTED DISCONNECT SWITCH.

PROVIDE WITH FACTORY INSTALLED NON-POWERED CONVENIENCE SERVICE OUTLET (115V GFCI).

PROVIDE WITH FACTORY INSTALLED ENTHALPY TYPE ECONOMIZER. PROVIDE SMOKE DETECTOR IN RETURN AIR DUCT TO SHUT DOWN UNIT UPON DETECTION.

PROGRAMMABLE THERMOSTAT WITH REMOTE SENSOR. SEE CONTROLS SPEC

PROVIDE WITH HAIL GUARDS

10. PROVIDE WITH POWER EXHAUST


	EXHAUST FAN SCHEDULE (BY L.L.)												
MARK	SERVICE	MAX. CFM	PLAN CFM	RPM	ESP (IN WG)	DRIVE	SONES (MAX)	MOTOR			MANUFACTURER	MODEL	NOTES
		Crivi Criv	Citivi		( vvG)		1	VOLTAGE	PHASE	HP		1	
EF-1	RESTROOMS / OVENS	500	360	1405	0.31	DIRECT	6.2	115	1	1/10	GREENHECK	G-090-VG	1,2
EF-1	RESTROOMS / OVENS	500	360	1405	0.31	DIRECT	6.2	115	1	1/10	GREENHECK	G-090-VG	

NOTES: 1. PROVIDE WITH FACTORY ROOF CURB AND BACKDRAFT DAMPER

2. PROVIDE WITH SPEED CONTROLLER

	AIR TERMINAL SCHEDULE										
DIFFUSER ITEM#	COUNT	DESCRIPTION	MANUFACTURER	MODEL	AIR TERMINAL REMARKS						
H001	17	SQUARE SUPPLY - LAY-IN OR SURFACE - SEE PLAN	TITUS	TDC-A4	24x24						
H002	1	SQUARE SUPPLY - LAY-IN OR SURFACE - SEE PLAN	TITUS	TDC-A4	24x24						
H254	H254 6 SQUARE RETURN - LAY-IN OR SURFACE		TITUS	350RL	24X24						
H255	3	SQUARE EXHAUST - SURFACE	TITUS	350 RL	12X12						

0	OUTSIDE AIR CALCULATIONS												
1. Summary  Ventilation Sizing Method													
2. Space ventuation Analysis				Time	People		T	Breathing	1				
		Space Floor Area (ft²)	Area Outdoor Air Rate (CFM/ft²)	Averaged Occupancy (Occupants)	Outdoor Air Rate	Air	Space Outdoor Air (CFM)	Zone Outdoor Air (CFM)	Space Ventilation Efficiency				
Zone Name / Space Name	Mult.	(Az)	(Ra)	(Pz)			(Voz)	(Vbz)	(Evz)				
Zone 1													
Backbar	1	408.0	0.18	2.0	7.50	0.8	111	88	1.046				
Cafe	1	878.0	0.18	36.0	7.50	0.8	535	428	0.811				
RR	1	134.0	0.00	0.0	0.00	0.8	0	0	1.100				
Corridor	1	127.0	0.06	0.0	0.00	0.8	10	8	0.942				
Work Room	1	434.0	0.12	2.0	5.00	0.8	78	62	1.058				
Totals (incl. Space Multipliers)								586	0.811				

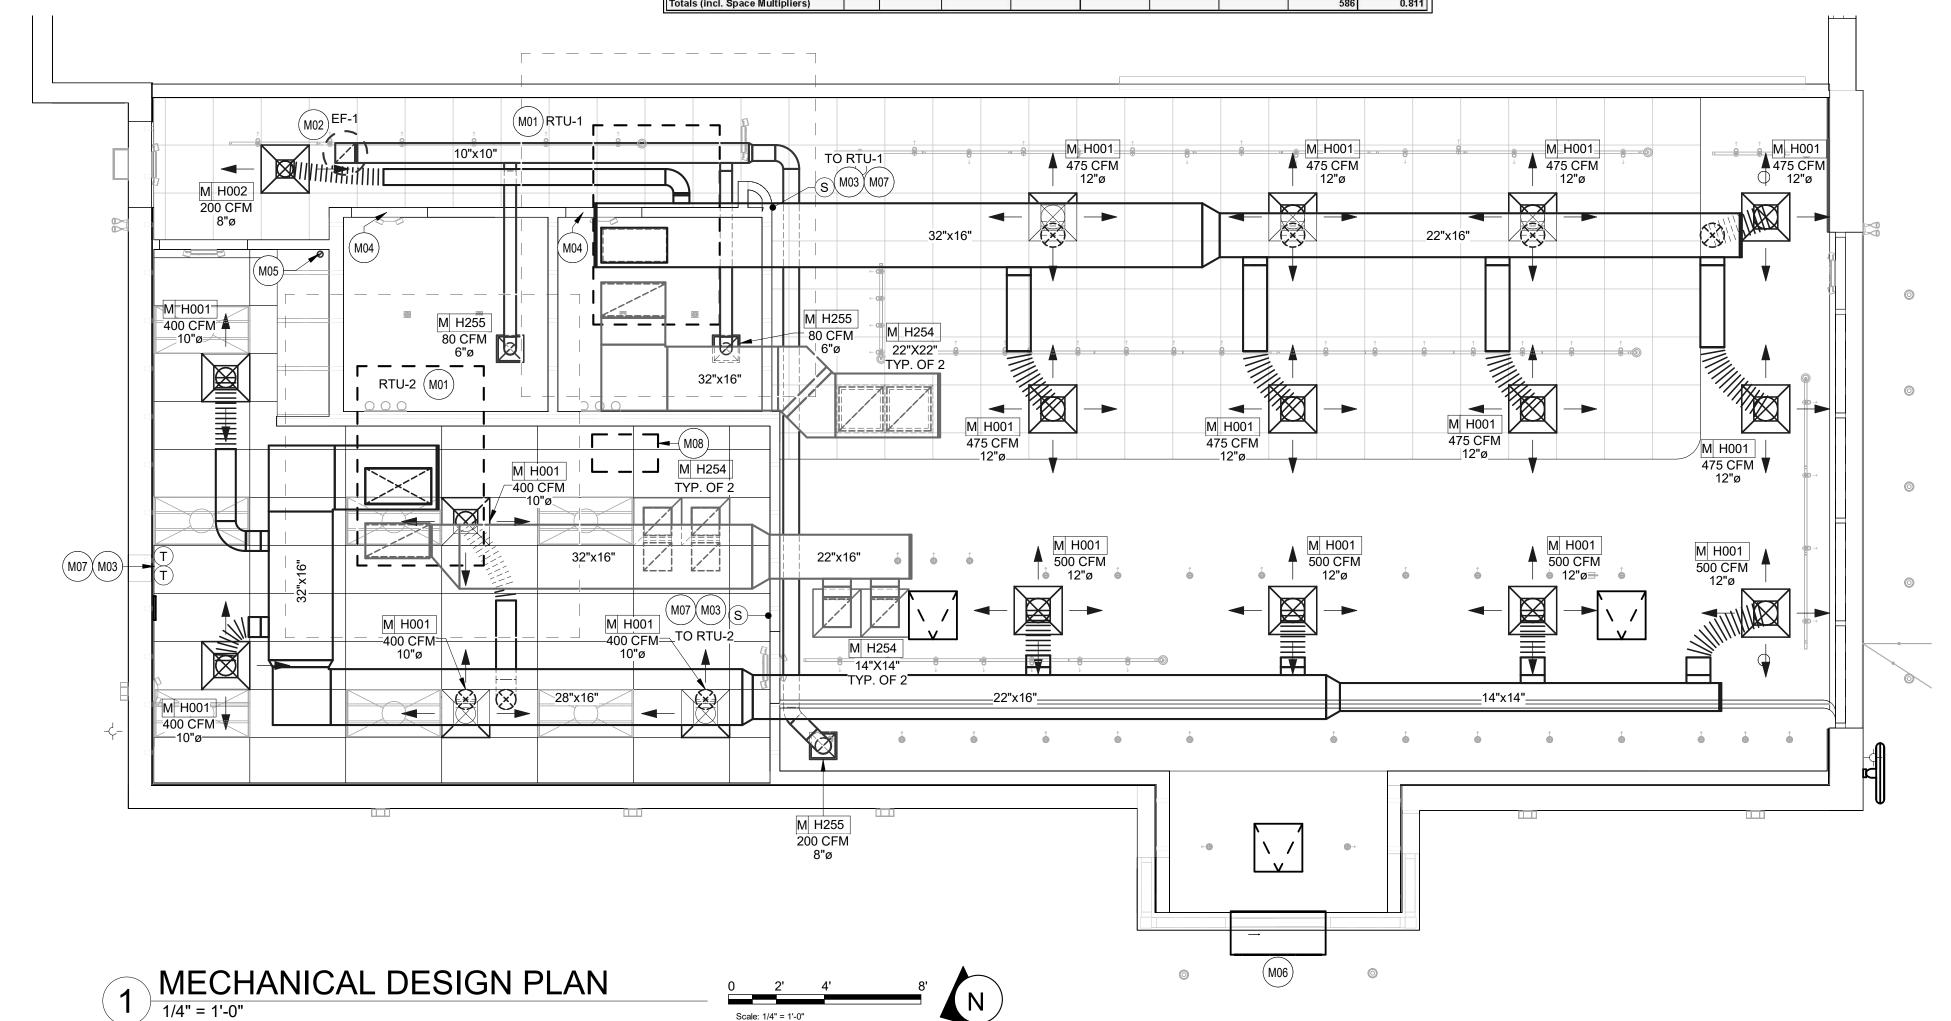

#### MECHANICALDESIGN PLAN NOTES

- SEE MECHANICAL SPECIFICATIONS FOR FURTHER
- SEE ARCHITECTURAL SHEETS FOR PAINTING AND COLORS OF ALL EXPOSED DUCTWORK, DIFFUSERS AND GRILLES.
- SEE ARCHITECTURAL SHEETS FOR DIMENSIONED DIFFUSER AND EXPOSED DUCT LOCATIONS.
- DIFFUSERS AND RETURN GRILLES SHALL BE CENTERED IN CEILING TILE, UNLESS OTHERWISE NOTED.
- REFERENCE LANDLORD WORK LETTER FOR DIVISION OF MECHANICAL SCOPE OF WORK AND COORDINATE WITH STARBUCKS CONSTRUCTION MANAGER.
- THIS CONTRACTOR SHALL COORDINATE WITH ALL OTHER TRADES IN LOCATING DUCTWORK, PIPING AND EQUIPMENT TO AVOID ANY INTERFERENCE.
- COORDINATE INSTALLATION OF NEW DUCT WITH
- CONTRACTOR TO INSTALL ALL WORK IN STRUCT COMPLIANCE WITH LOCAL CODES AND ORDINANCES.
- PROVIDE ADJUSTABLE VOLUME DAMPER AT ALL BRANCH
- PROVIDE TURNING VANES AT ALL RECTANGULAR ELBOWS
- MECHANICAL CONTRACTOR TO REPLACE FILTERS AFTER CONSTRUCTION IS COMPLETED.

#### MECHANICAL SHEET NOTES

- ROOFTOP UNIT (RTU-1&2) PROVIDED AND INSTALLED BY LANDLORD. FINAL OUTDOOR AIR SETTING SHALL BE AS INDICATED IN SCHEDULE ON THIS SHEET. FACTORY INSTALLED SMOKE DETECTOR SHALL DE-ENERGIZE UNIT SUPPLY FAN AND ACTIVATE AUDIO/VISUAL INDICATOR IF SMOKE IS DETECTED IN RETURN AIR DUCT. PROVIDE PERMANENT ACCESS TO SMOKE DETECTOR. PROVIDE AND INSTALL REMOTE TEST SWITCH FOR ALARM THAT IS ACCESSIBLE WHILE STANDING ON THE FLOOR. COORDINATE WITH ELECTRICAL CONTRACTOR FOR POWER CONNECTIONS TO ALL MECHANICAL EQUIPMENT.
- LANDLORD SHALL PROVIDE AND INSTALL NEW ROOF MOUNTED EXHAUST FAN WITH SPEED CONTROLLER (SEE SCHEDULE THIS SHEET) PER MANUFACTURER'S RECOMMENDATION. PROPERLY SEAL AROUND ALL ROOF PENETRATIONS. EXTEND EXHAUST DUCT FROM EACH GRILLE WITH BACKDRAFT DAMPER TO MAIN EXHAUST DUCT CONNECTING TO EF-1 ON ROOF. FAN SHALL BE 10' MINIMUM FROM ANY AIR INTAKE. VERIFY EXACT LOCATION IN THE FIELD. SEE CONTROLS AND OPERATION FOR FAN ON SHEET M001. BALANCE PER STARBUCKS DESIGN GUIDELINES.
- LANDLORD SHALL PROVIDE AND INSTALL TEMPORARY THERMOSTAT AND WALL MOUNTED SENSOR FOR CONTROL OF RTU-1. MOUNT THERMOSTATS AT 44" A.F.F. AT MANAGER'S DESK. COORDINATE EXACT LOCATION WITH OWNER. MOUNT SENSORS AT 60" A.F.F. COORDINATE LOCATIONS WITH OTHER ELEMENTS. VERIFY EXACT LOCATIONS IN FIELD. REFER TO LANDLORD WORK LETTER, MECHANICAL NOTES AND MECHANICAL SCHEDULE. MULTIPLE THERMOSTATS SHALL BE STACKED IN A VERTICAL CONFIGURATION WITH A MINIMUM 8" CLEARANCE BELOW EACH
- M04 UNDERCUT RESTROOM DOOR 1" TO PROVIDE MAKE UP AIR. IF LOCAL CODE DOES NOT ALLOW UNDERCUT, PROVIDE A DOOR LOUVER SIZED FOR 160 CFM AT A VELOCITY OF 300 FPM.
- M05 DIRECT VENT CLOSED COMBUSTION AND FLUE PVC LINES FROM WATER HEATER UP THROUGH ROOF, TERMINATE WITH CONCENTRIC VENT KIT PER MANUFACTURER'S RECOMMENDATIONS. MAINTAIN 10' MINIMUM FROM OUTLET TO ANY AIR INTAKE. SEE DETAIL ON SHEET M501.
- LANDLORD SHALL PROVIDE AND INSTALL 48" HEATED AIR CURTAIN OVER DRIVE THRU WINDOW. UNIT SHALL BE EQUAL TO READY ACCESS SERIES AA300, 208/240 V. 1 PH, 32 AMPS, 7.1 KW HEATER.
- G.C. TO PROVIDE AND INSTALL VENSTAR THERMOSTATS AND REMOTE SENSORS TO REPLACE EXISTING CONTROLS PROVIDED BY LANDLORD AND HVAC CONTRACTOR. COORDINATE COMMISSIONING WITH VENSTAR PER STARBUCKS GUIDELINES. SEE EMS DETAILS ON SHEET M502.
- REMOTE CONDENSING UNIT FOR ICE MACHINE MOUNTED ON ROOF. ROUTE REFRIGERATION PIPING DOWN TO MATCHING INDOOR UNIT AND MAKE ALL CONNECTIONS PER MANUFACTURER'S RECOMMENDATIONS.



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07/06/20

TARBUCK YOR RD SUMMIT S L

YOR, DR. BUILI COFF CHIP


STORE #: 62012 PROJECT #: 87799-001 ISSUE DATE: SR. DESIGN MANAGER: K. GORIN SLONSKI PRODUCTION DESIGNER: A. HAHN

**Revision Schedule** 

MECHANICAL DESIGN PLAN

SCALE: AS SHOWN SHEET NUMBER:

CHECKED BY:

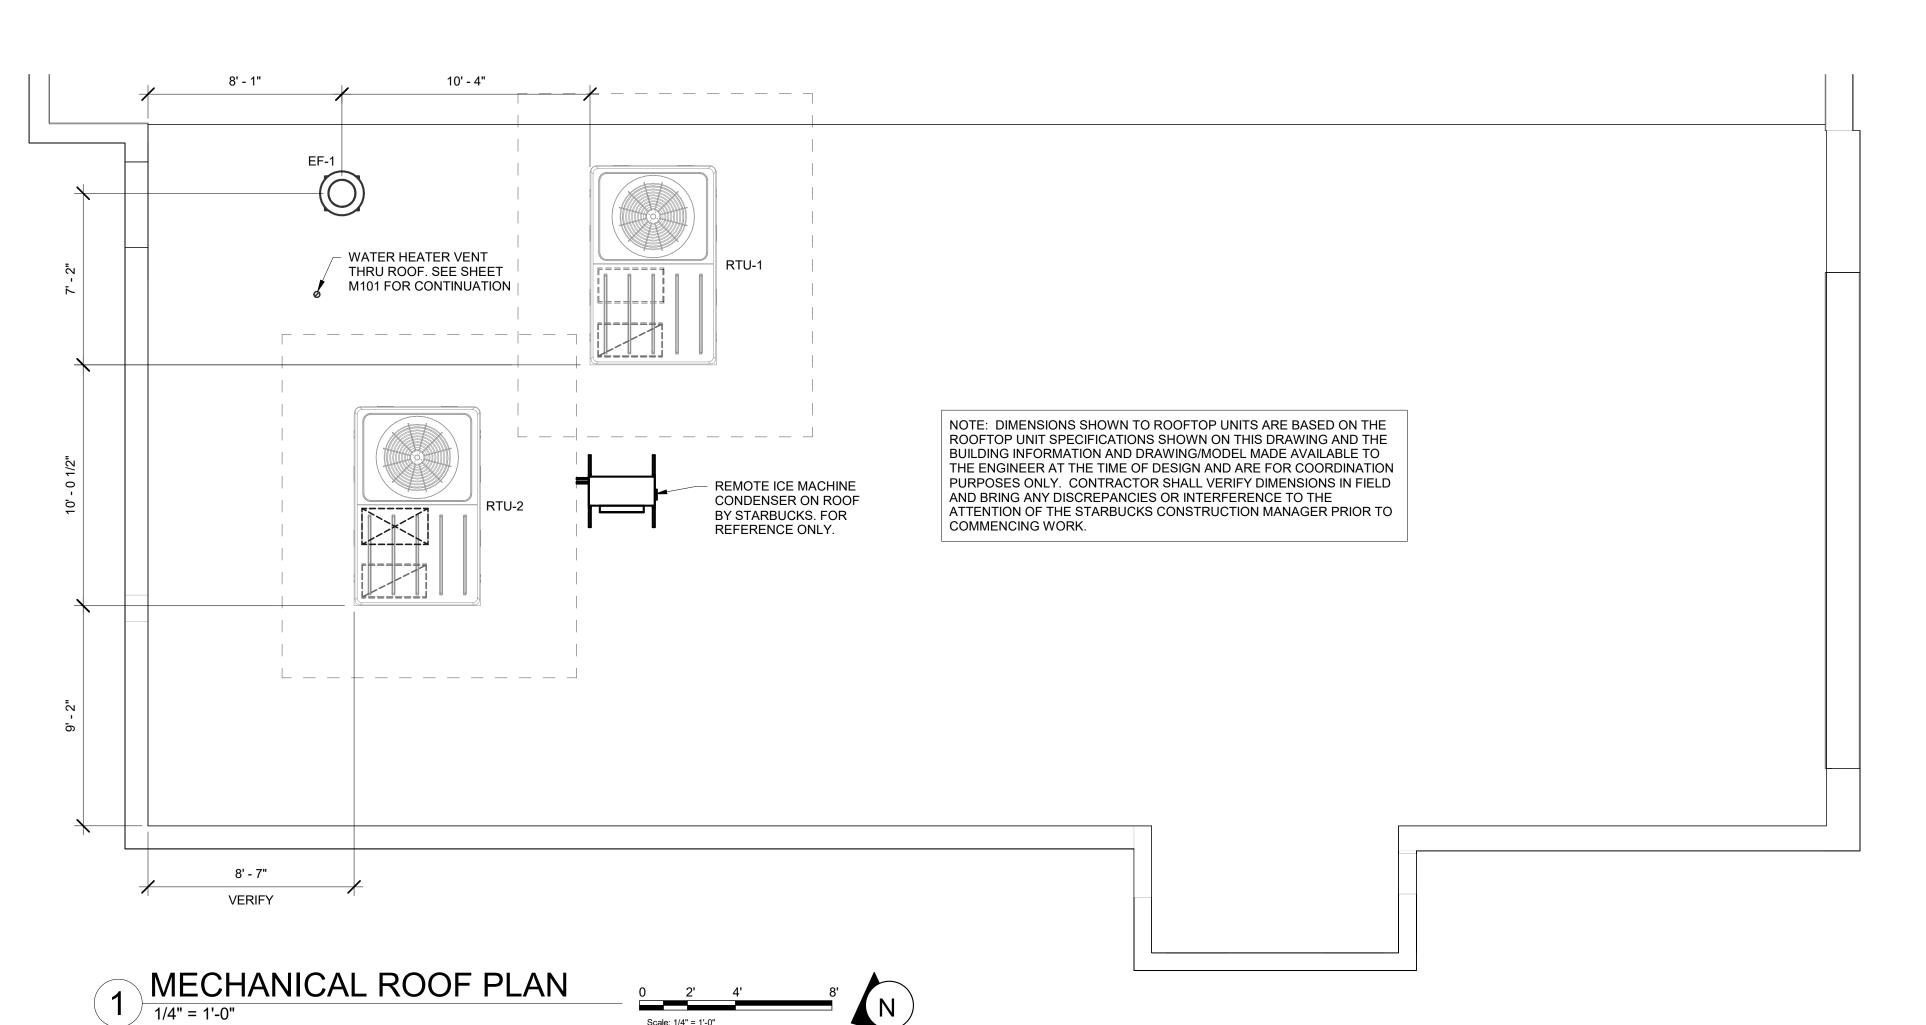




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**Engineering Consultant** 

2020

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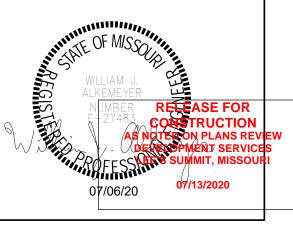
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# T OF STARBUCK NW PRYOR RD 8

VEST PRYOR, I ENSTEIN DR. MO NTY

PROJECT NAME:

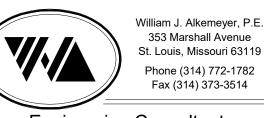BUILDOUT

COFFEE - N

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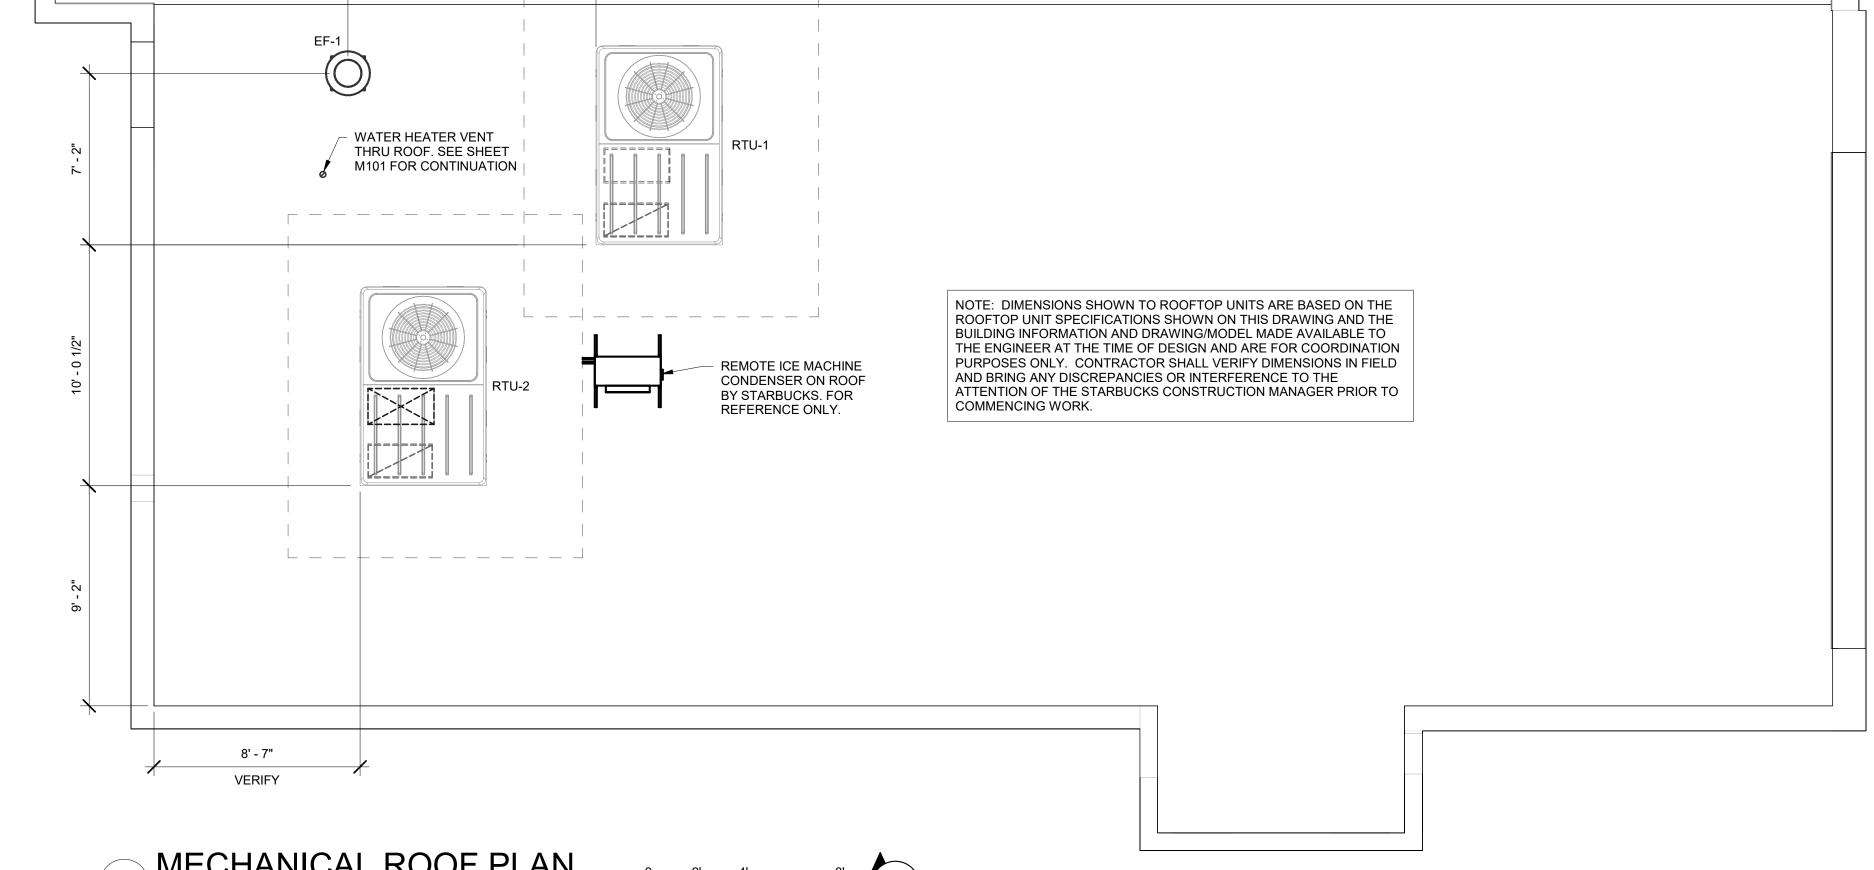
STORE #: PROJECT #:

ISSUE DATE: 07-07-2020 SR. DESIGN MANAGER: K. GORIN SLONSKI PRODUCTION DESIGNER: A. HAHN CHECKED BY: DMC


**Revision Schedule** 

MECHANICAL ROOF PLAN

SCALE: AS SHOWN SHEET NUMBER:



	DES	IGN COOLING		DES	IGN HEATING	
	COOLING DATA A	T Aug 1400		HEATING DATA A	T DES HTG	
	COOLING OA DB	WB 95.4 °F / 7	4.9 °F	HEATING OA DB /	WB -1.0 °F / -2.	5 °F
ZONE LOADS	Details	Sensible (BTU/hr)	Latent (BTU/hr)	Details	Sensible (BTU/hr)	Latent (BTU/hr)
Window & Skylight Solar Loads	310 ft <sup>2</sup>	14592	_	310 ft <sup>2</sup>	_	-
Wall Transmission	1017 ft <sup>2</sup>	1199	_	1017 ft <sup>2</sup>	3263	-
Roof Transmission	1981 ft²	7106	-	1981 ft²	6834	-
Window Transmission	310 ft <sup>2</sup>	2744	×-	310 ft <sup>2</sup>	11445	-
Skylight Transmission	0 ft²	0	X <del>-</del>	0 ft²	0	-
Door Loads	37 ft²	806	15	37 ft²	976	-
Floor Transmission	1981 ft²	0	1	1981 ft²	2613	=
Partitions	0 ft²	0	=	0 ft²	0	
Ceiling	0 ft²	0	(12)	0 ft²	0	-
Overhead Lighting	1585 W	5407	, <del>-</del>	0	0	-
Task Lighting	0 W	0	.=	0	0	-
Electric Equipment	0 W	0	_	0	0	
People	40	7562	7080	0	0	0
Infiltration	1-	0	0	-	0	0
Miscellaneous	;=	53953	7554	-	0	0
Safety Factor	10% / 10%	9337	1463	0%	0	0
>> Total Zone Loads		102705	16097	-	25132	0
Zone Conditioning	\frac{1}{2}	105595	16097	-	24998	0
Plenum Wall Load	0%	0	9	0	0	
Plenum Roof Load	0%	0	3	0	0	-
Plenum Lighting Load	0%	0	(1)	0	0	
Return Fan Load	5846 CFM	0	, <del>-</del>	5846 CFM	0	-
Ventilation Load	723 CFM	14481	12207	723 CFM	53205	0
Supply Fan Load	5846 CFM	0	-	5846 CFM	0	
Space Fan Coil Fans	3#	0	-	H	0	-
Duct Heat Gain / Loss	0%	0	-	0%	0	9
>> Total System Loads	-	120076	28305	-	78203	0
Central Cooling Coil		120076	28307		0	0
Central Heating Coil		0	4	=	78203	
>> Total Conditioning		120076	28307	-	78203	.0
Key:		values are clg lo			values are htg lo	

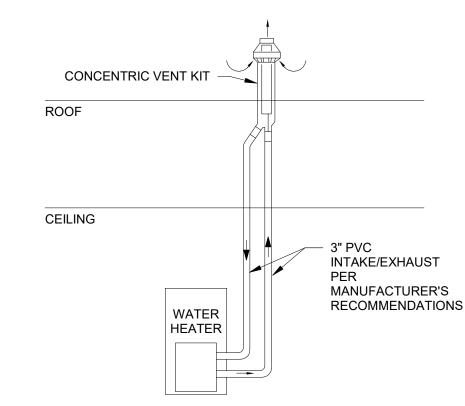

# 5 WATER HEATER VENT DETAIL SCALE: NTS

\LOW/

/ DUCT

PRESSURE

DUCT SIZE

HANGER SIZE MAX SPACING

8'-0"

6'-0"


4'-0"

1" x 1/16"

1" x 1/8"

1" x 1/8"

1" x 1/8"

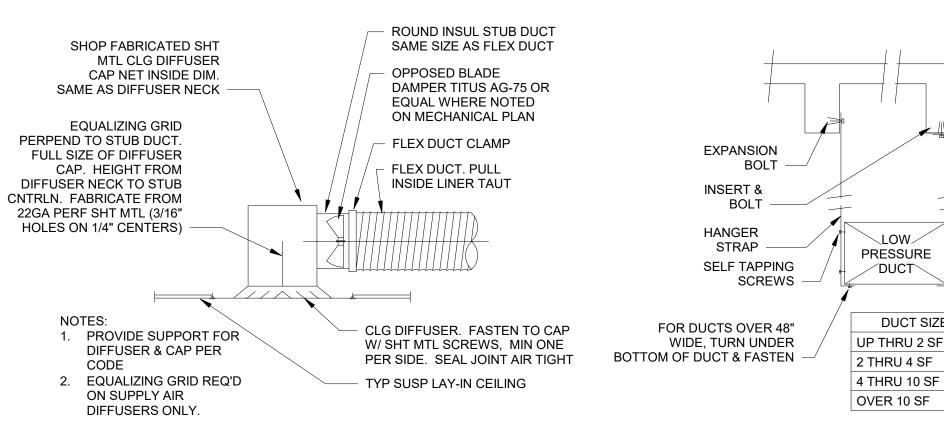

LAY-IN DIFFUSER DETAIL

DUCT HANGING DETAIL SCALE: NTS

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WRITTEN AGREEMENT IS FULLY EXECUTED BY BOTH PARTIES.





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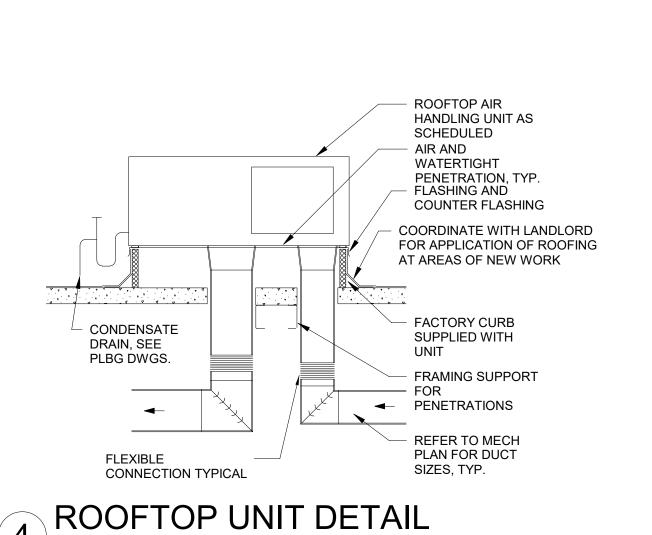
STORE #: 62012 PROJECT #: 87799-001 ISSUE DATE: SR. DESIGN MANAGER: K. GORIN SLONSKI PRODUCTION DESIGNER: A. HAHN CHECKED BY: DMC **Revision Schedule** 

Rev Date Description MECHANICAL DETAILS


SCALE: AS SHOWN

SHEET NUMBER:

M501



SCALE: NTS

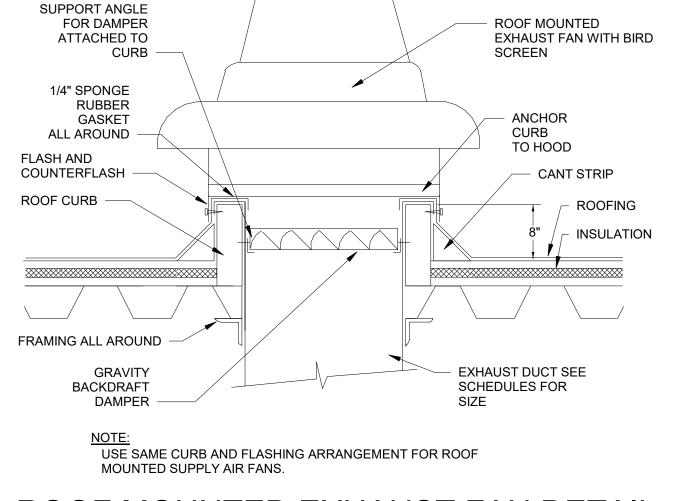


ROOF MOUNTED EXHAUST FAN DETAIL

SCALE: NTS

1. OUTDOOR TEMPERATURE SENSOR CONNECTED TO ONE ECP ONLY PER LOCATION. FACE NORTH WHEN POSSIBLE.

2. SEE GENERAL NOTES 7 AND 8 FOR REMOTE SENSOR MOUNTING LOCATION DETAILS.

#### Venstar EMS - No Lighting Control - HVAC Controls SCALE: NTS

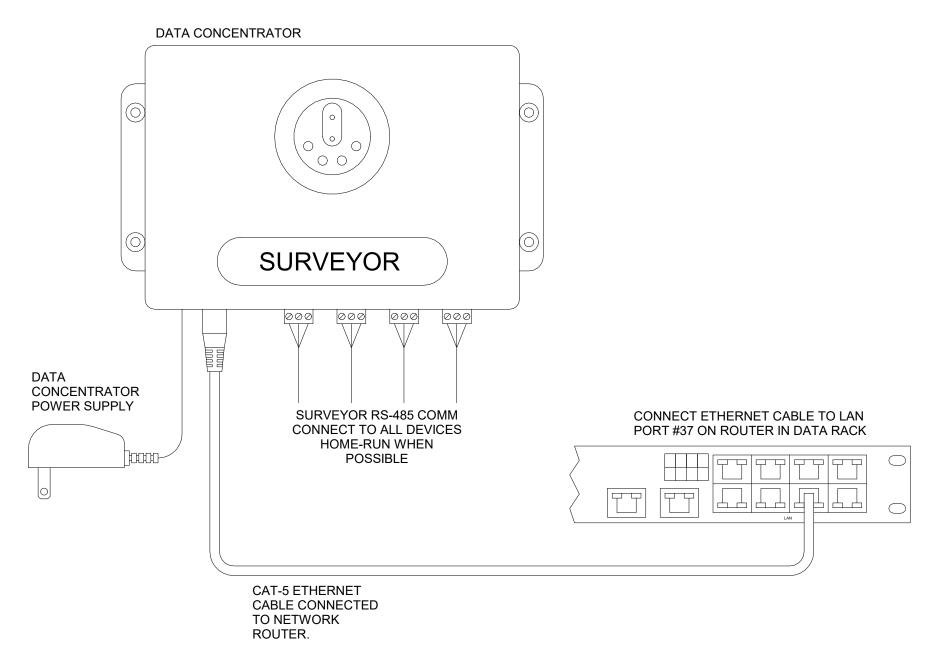


#### Venstar EMS - No Lighting Control - Data

2 Concentrator SCALE: NTS

#### **GENERAL NOTES**

- 1. SURVEYOR ENERGY MANAGEMENT SYSTEM HARDWARE IS SUPPLIED BY STARBUCKS.
- 2. DRAWING FOR GENERAL INFORMATION, DESIGN INTENT, AND COORDINATION ONLY.
- 3. LOCAL BUILDING CODES TAKE PRECEDENCE OVER THIS DOCUMENT.
- 4. NOT ALL WIRING IS SHOWN ON THIS DRAWING. FOR CLARITY, ONLY ONE EXAMPLE OF EACH TYPE OF DEVICE IS SHOWN.
- 5. REFER TO THE SURVEYOR INSTALLATION INSTRUCTIONS FOR EACH COMPONENT FOR DETAILED WIRING AND ADDITIONAL CRITICAL INFORMATION.
- 6. CAUTION! INSTALLATION REQUIRES THE REMOVAL OF SAFETY COVERS AND EXPOSE THE INSTALLER TO HIGH VOLTAGE AND ELECTRICAL HAZARDS. USE OF A LICENSED ELECTRICIAN IS REQUIRED. FOLLOW ALL APPROPRIATE SAFETY PRECAUTIONS. ADDITIONAL SAFETY INFORMATION IS IN THE SURVEYOR INSTALLATION MANUALS.
- 7. WALL MOUNTED REMOTE SENSOR IS MOUNTED ON WALL 4 TO 5 FT AFF. AVOID AREAS WITH DIRECT AIRFLOW FROM SUPPLY REGISTERS.
- 8. USE A DROP DOWN SENSOR IF A WALL MOUNT SENSOR CANNOT BE INSTALLED DUE TO SPACE CONSTRAINTS (SEE NOTE 7 FOR REQUIREMENTS). THE SENSOR CLIPS TO THE T-BAR GRID AND ADJUSTED SO THE BOTTOM OF THE SENSOR IS 8 TO 9 FT AFF. ALLOW 2 FT OF CLEARANCE FROM METRO SHELVING AND AVOID AREAS WITH DIRECT AIRFLOW FROM SUPPLY REGISTERS.
- 9. FOR SURVEYOR EMS TECHNICAL SUPPORT AND SYSTEM COMMISSIONING, CONTACT SURVEYOR TECHNICAL SUPPORT, (855) 647-7660, OPTION 1 OR EMAIL INSTALLSUPPORT@VENSTAR.COM. HOURS 6:00 AM TO 8:00 PM PACIFIC, MON-FRI.

SURVEYOR EMS COMPONENTS						
VENSTAR PART	SBUX ITEM#	<u>DESCRIPTION</u>	QUANTITY			
DC400	011029485	DATA CONCENTRATOR	1			
OTS400	011029487	OUTDOOR TEMPERATURE SENSOR	1			
ECP400	011029489	EQUIPMENT CONTROL PAC	1 PER HVAC			
CT414	011029490	COMMUNICATING THERMOSTAT	1 PER HVAC			
SP400	011029491	SENSOR PAC	1 PER HVAC			
RS410	011029492	WALL MOUNT REMOTE SENSOR	1 PER HVAC			

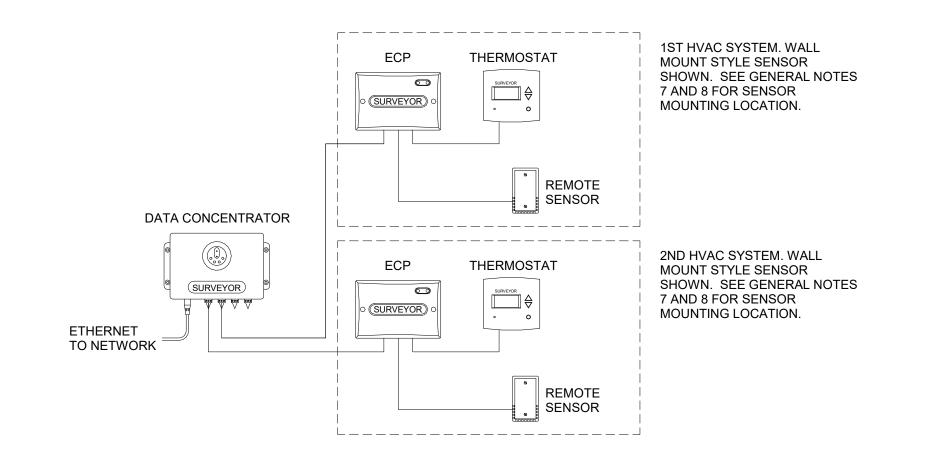

Venstar EMS - No Lighting Control - Basic Low Voltage Wire Runs

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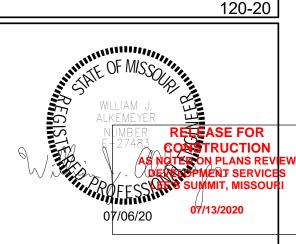
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BUILDOU COFFEE CHIPMAN

STORE #: 62012 87799-001 PROJECT #:

**ISSUE DATE** SR. DESIGN MANAGER: K. GORIN SLONSKI PRODUCTION DESIGNER: A. HAHN CHECKED BY:

EMS DETAILS

SCALE: AS SHOWN

SHEET NUMBER:

ABBR	REVIATIONS
	ABOVE FINISHED FLOOR AUTHORITIES HAVING JURISDICTION APPROXIMATE
BLDG	BUILDING
CLG CO CONST CW CXA	CEILING CLEANOUT CONSTRUCTION DOMESTIC COLD WATER COMMISSIONING AGENT
DEG DN DTL DWG(S)	DEGREES DOWN DETAIL DRAWING(S)
EA EC ELEC EMER EX EXT	EACH ELECTRICAL CONTRACTOR ELECTRICAL EMERGENCY EXISTING EXTERIOR
FCO FD F&I FLR FOIC FOIO FPT FS FT	FLOOR CLEANOUT FLOOR DRAIN FURNISH & INSTALL FLOOR FURNISHED BY OWNER, INSTALLED BY CONTRACTOR FURNISHED BY OWNER, INSTALLED BY OWNER, INSTALLED BY OWNER FEMALE PIPE THREAD FLOOR SINK FOOT/FEET
GC GFCI GI GT GW	GENERAL CONTRACTOR GROUND FAULT CIRCUIT INTERRUPTER GREASE INTERCEPTOR GREASE TRAP GREASE WASTE
HR HS HVAC HW HWS HWR	HOUR HANDSINK HEATING, VENTILATION, AND AIR CONDITIONING HOT WATER HOT WATER SUPPLY HOT WATER RETURN
ID	INSIDE DIAMETER
LL LV	LANDLORD LOW VOLTAGE
MAX MC MDP MECH MEP MFG MIN MS	MAXIMUM MECHANICAL CONTRACTOR MAIN DISTRIBUTION PANEL MECHANICAL MECHANICAL, ELECTRICAL, AND PLUMBING MANUFACTURER MINIMUM MOP SINK
NII	NICHTUCHT

**NIGHTLIGHT** 

PREP SINK

REQUIRED

REVISION

**SQUARE FEET** 

**TELEPHONE** 

**TEMPORARY** 

**TYPICAL** 

**VENT** 

YARD

**CLEANOUT** 

(EXTERIOR)

SCOPE OF WORK

SPECIFICATION(S)

STAINLESS STEEL

TEMPERATURE MIXING VALVE

**UNLESS NOTED OTHERWISE** 

TEMPERED HOT WATER

UNDER COUNTER

SANITARY WASTE

WALL CLEANOUT

WATER HEATER

WEATHER PROOF

SHEET

NOT TO SCALE

**OUTSIDE DIAMETER** 

PLUMBING CONTRACTOR

POINT OF CONNECTION

NTS

OD

PC

REQ'D

REV

SOW

SST

TEL

TEMP

TMV

TW

TYP

UC

UNO

WCO

WH

WP

YCO

SPECS

#### PLUMBING SYMBOL LEGEND

—SAN. OR GW—	SAN OP CW	SANITARY OR GREASE WASTE PIPING
V	V	VENT PIPING
CD	CD	CONDENSATE DRAIN PIPING
CW	CW	COLD WATER PIPING
HW	HW	HOT WATER PIPING
CWF	CWF	COLD WATER FILTERED PIPING
CWS	cws	COLD WATER SOFTENED PIPING
TW	TW	TEMPERED WATER PIPING
G	G	GAS PIPING
Ŵ	BV	BALANCING VALVE
$\bowtie$	SOV	SHUT OFF VALVE
>,	НВ	HOSE BIBB
—	WCO	WALL CLEANOUT
$\oplus$	FCO	FLOOR CLEANOUT
	FD	FLOOR DRAIN (SQUARE)
	FD	FLOOR DRAIN (ROUND)
0	HD	HUB DRAIN
00000000	FS	FLOOR SINK (SQUARE)
	FS	FLOOR SINK (ROUND)
$\mathbf{M}$	WM	WATER METER
	GM	GAS METER
	BFP	BACKFLOW PREVENTER
	POC	CONNECT TO EXISTING
EXISTING PIPING SH	OWN ON PLANS	IN A LIGHTER SHADE.

#### SYSTEM COMMISSIONING

#### CONTRACTOR RESPONSIBILITIES FOR BUILDING COMMISSIONING

CONTRACTOR SHALL PROVIDE SUPPORT AND WORK AS SPECIFIED. NEEDED AND REQUIRED TO CONDUCT AND FACILITATE STARBUCKS STAFF BUILDING COMMISSIONING EFFORTS. THIS WORK WILL BE COMPRISED OF THREE DISTINCT EFFORTS:

- 1) SUPPORT STARBUCKS COMMISSIONING AGENT (CXA) DURING INSTALLATION VERIFICATION AND CORRECT DISCLOSED
- 2) PERFORM TESTING, ADJUSTING, BALANCING AND SYSTEM STARTUP AND SUPPORT FUNCTIONAL PERFORMANCE TESTING BY STARBUCKS
- 3) CORRECT DEFICIENCIES DISCLOSED BY FUNCTIONAL PERFORMANCE TESTING AND SUBMIT REPORTS. CONTRACTOR SHALL PERFORM AND PROVIDE THE FOLLOWING:
- A. SYSTEMS SUBJECT TO COMMISSIONING MAY INCLUDE, BUT ARE NOT LIMITED TO, DOMESTIC HOT WATER GENERATION.
- B. CONTRACTOR SHALL INCLUDE COMMISSIONING ACTIVITIES IN PROJECT SCHEDULE AND SHOW INTERVALS FOR PERFORMANCE OF WORK FOR WHICH CONTRACTOR IS RESPONSIBLE AND INTERVALS FOR WORK PERFORMED BY STARBUCKS CXA. CONTRACTOR SHALL SHOW RESOURCES FOR PERFORMING ALL WORK RELATED TO COMMISSIONING ACTIVITIES ON A LINE ITEM IN THE SCHEDULE OF VALUES.
- C. CONTRACTOR SHALL INSTALL EQUIPMENT IN ACCORDANCE WITH THE MANUFACTURER'S REQUIREMENTS AND ALL CONTRACT DOCUMENTS. ENSURE THAT ALL EQUIPMENT IS INSTALLED TOTALLY COMPLETE, AND ACCESSIBLE TO STARBUCKS CXA FOR INSTALLATION VERIFICATION AND FUNCTIONAL PERFORMANCE TESTING PRIOR TO THE SCHEDULED START OF INSTALLATION VERIFICATION.
- D. INSTALLATION VERIFICATION SHALL BE PERFORMED BY STARBUCKS CXA. CONTRACTOR SHALL SUPPORT STARBUCKS CXA INSTALLATION VERIFICATION EFFORTS AS NECESSARY. PROVIDE ALL ACCESS AND EQUIPMENT NECESSARY FOR STARBUCKS STAFF TO VERIFY THAT THE EQUIPMENT IS INSTALLED CORRECTLY.
- E. CONTRACTOR SHALL BE READILY AVAILABLE DURING INSTALLATION VERIFICATION TO CORRECT ANY DEFICIENCIES OR DEFECTS DISCLOSED BY THE INSTALLATION VERIFICATION PROCESS. CORRECTIONS SHALL BE MADE IN A TIMELY MANNER WITHOUT DISRUPTION OF THE CONSTRUCTION SCHEDULE.
- F. ALL DOMESTIC WATER HEATING, RECIRCULATING, FILTER AND SOFTENING EQUIPMENT SHALL BE TESTED AND/OR ADJUSTED AND BALANCED BY THE CONTRACTOR'S TESTING, ADJUSTING AND BALANCE AGENT (SEE TESTING ADJUSTING AND BALANCING) OR THE MANUFACTURER'S CERTIFIED STARTUP REPRESENTATIVE AFTER THE SYSTEM IS VERIFIED TO BE COMPLETE AND CORRECT BY STARBUCKS CXA IN ACCORDANCE WITH THE REQUIREMENTS OF THESE DOCUMENTS. SEQUENCES OF OPERATION SHALL BE TESTED TO ENSURE THAT THEY OPERATE IN ACCORDANCE WITH THE CONTRACT REQUIREMENTS. DELIVERABLES: PRELIMINARY, WRITTEN FUNCTIONAL PERFORMANCE REPORT CONFORMING TO THE REQUIREMENTS SPECIFIED HEREIN, DOCUMENTING THE INFORMATION SPECIFIED, ETC. TO THE STARBUCKS CXA IMMEDIATELY UPON COMPLETION OF THE WORK.
- G. CONTRACTOR SHALL INFORM STARBUCKS CXA WHEN EQUIPMENT IS READY FOR FUNCTIONAL PERFORMANCE TESTING. ALL EQUIPMENT SHALL BE READY FOR FUNCTIONAL PERFORMANCE TESTING PRIOR TO STARTING TESTING. CONTRACTOR SHALL OPERATE EQUIPMENT FOR STARBUCKS CXA AND VERIFY BY DEMONSTRATION THE CORRECT OPERATION OF EQUIPMENT, RESPONSE OF SENSORS, AND PROPER **EXECUTION OF HVAC CONTROL AND LIGHTING SEQUENCES:** INCLUDING BUT NOT LIMITED TO. AIR MOVEMENT, TEMPERATURE. SOUND, AND CONTROL RESPONSE. PROVIDE ANY SECURIT ACCESS, HARDWARE, SOFTWARE, OR OTHER SUPPORT AS NEEDED FOR THE STARBUCKS CXA TO EFFICIENTLY WITNESS AND DOCUMENT ALL EQUIPMENT TESTING. STARBUCKS CXA WILL RECORD THE EQUIPMENT OPERATION AND RESPONSE TO TESTING SEQUENCES AND PREPARE A LIST OF ANY DEFICIENCIES DISCLOSED BY THE FUNCTIONAL PERFORMANCE TESTS FOR CORRECTION BY THE CONTRACTOR. EQUIPMENT INCLUDES, BUT IS NOT LIMITED TO, AIR HANDLING UNITS, ROOFTOP AND SPLIT TYPE, CONDENSING UNITS, EXHAUST FANS. LIGHTING CONTROLS, ETC. DELIVERABLES: PROVIDE COMPLETED COPIES OF ALL START UP REPORTS, FILLED OUT ON THE MANUFACTURER'S FORMS, TO THE STARBUCKS CXA.
- H. CONTRACTOR IS RESPONSIBLE FOR CORRECTING ANY ISSUES OR DEFICIENCIES DISCLOSED DURING THE FUNCTIONAL PERFORMANCE TESTING PROCESS. CORRECTIONS SHOULD BE MADE IN A TIMELY MANNER WITHOUT DISRUPTION TO THE SYSTEM AND CONSTRUCTION SCHEDULE.
- I. CONTRACTOR SHALL BE READILY AVAILABLE FOR ANY RE-TESTING OF EQUIPMENT DEEMED NECESSARY BY STARBUCKS CXA DURING INSTALLATION VERIFICATION AND FUNCTIONAL PERFORMANCE TESTING. CONTRACTOR IS RESPONSIBLE FOR CORRECTING ANY ISSUES OR DEFICIENCIES FOUND IN THE SYSTEM DURING ANY AND ALL RE-TESTING. CORRECTIONS SHOULD BE MADE IN A TIMELY MANNER WITHOUT DISRUPTION TO THE SYSTEM AND CONSTRUCTION SCHEDULE. DELIVERABLES: FINAL BALANCE REPORT, DEFICIENCIES LIST NOTING CORRECTIVE ACTIONS PERFORMED BY CONTRACTOR IN RESPONSE TO INSTALLATION VERIFICATION AND FUNCTIONAL PERFORMANCE TEST RESULTS.
- J. CONSTRUCTION AND POST CONSTRUCTION TESTING: ADDITIONAL TESTING MAY BE REQUIRED BY LEED AND OTHER PROCESSES THAT MAY OCCUR OUT OF SEQUENCE WITH COMMISSIONING SERVICE. CONTRACTOR SHALL CONDUCT, DOCUMENT, SUPPORT AND SCHEDULE THIS TESTING AS DIRECTED BY STARBUCKS CXA

#### **VALVES**

INSTALL VALVES FOR EACH FIXTURE AND ITEM OF EQUIPMENT. PROVIDE BRAIDED STAINLESS STEEL HOSE (UNLESS OTHERWISE NOTED) BETWEEN VALVE AND EQUIPMENT IN ACCORDANCE WITH MANUFACTURER'S SPECIFICATIONS. LOCATE SHUT-OFF VALVES ADJACENT TO EQUIPMENT FOR EASY ACCESS SUCH THAT VALVES CAN BE REACHED WITHOUT MOVING EQUIPMENT. SHUT OFF VALVES TO BE BALL TYPE. VALVES SHALL BE LISTED/APPROVED FOR USE PER AUTHORITIES HAVING JURISDICTION (AHJ) AND CODE REQUIREMENTS. PROVIDE VALVE IDENTIFICATION PER THE PROJECT MANUAL FOR MAIN WATER SERVICE SHUT-OFF AND ANY OTHER VALVES WHICH ARE NOT CLEARLY EVIDENT WHAT THEY SERVE.

#### PLUMBING FIXTURES

SIZE WATER HEATER PER STARBUCKS STANDARD AND PER AUTHORITIES HAVING JURISDICTION (AHJ), WHICHEVER IS MORE STRINGENT. PROVIDE INSTALLATION COMPLETE WITH FITTINGS AS SHOWN IN THE DRAWINGS. SET HOT WATER TEMPERATURE AT 140° F OR ADJUST AS REQUIRED BY AHJ. PROVIDE THERMOMETER ON HOT WATER PIPE LEAVING WATER HEATER.

STARBUCKS WATER FILTRATION VENDOR WILL PROVIDE FILTRATION SYSTEM. CONTRACTOR SHALL CONFIRM WITH STARBUCKS CONSTRUCTION MANAGER WHETHER VENDOR OR PLUMBING CONTRACTOR IS TO INSTALL FILTRATION SYSTEM. PROVIDE AND COORDINATE INSTALLATION COMPLETE WITH ALL PIPING, FITTINGS, AND EQUIPMENT AS INDICATED ON THE DRAWINGS.

THE PLUMBING CONTRACTOR SHALL MAKE ALL FINAL CONNECTIONS TO EQUIPMENT INCLUDING REQUIRED MATERIAL SUCH AS PIPING, VALVES, FILTERS, TRAPS, CHECKS VALVES, VACUUM BREAKERS, AND FLEXIBLE AND RIGID TUBING.

#### **SCHEDULES**

REFER TO SCHEDULES ON DRAWINGS FOR A DESCRIPTION OF LISTED ITEMS AND FURNISH ANY AND ALL PLUMBING FIXTURES LISTED AS "GC". ANY DISCREPANCIES ABOUT WHO IS TO PROVIDE PLUMBING FIXTURES IN THE SCHEDULE SHALL BE BROUGHT TO STARBUCKS ATTENTION FOR CLARIFICATION. INSTALL ALL FIXTURES LISTED REGARDLESS OF WHO SUPPLIES.

G.C. TO FURNISH AND INSTALL POWER CORD FOR DISHWASHER PER JURISDICTIONAL REQUIREMENTS. IF EQUIPMENT IS SPECIFIED AS <u>HOBART ADVANSYS,</u> THE UNIT IS TO BE PLUMBED WITH COLD, NON-FILTERED WATER. IF THE WATER FILTRATION SYSTEM IS A PENTAIR CONFIGURATION II OR III, THEN THE COLD, NON-FILTERED WATER MUST ALSO BE SOFTENED.

#### INSULATION

PROVIDE THERMAL INSULATION PER THE SPECIFICATIONS.

FURNISH AND INSTALL SPECIFIED NO SCALD SAFETY COVERS WITH INSULATED FOAM LINER AND TAMPER PROOF STRAP AT ALL EXPOSED ADA SINK P-TRAPS AND WATER SUPPLIES AND AS REQUIRED BY JURISDICTION

#### PIPING

#### <u>CONDENSATE DRAINAGE PIPING</u>

THE PLUMBING CONTRACTOR SHALL PROVIDE CONDENSATE DRAINS FOR AIR HANDLING UNITS AND STARBUCKS EQUIPMENT (REFER TO COPPER TUBING WITH WROUGHT COPPER SWEAT FITTINGS JOINED WITH 50/50 SOLDER.

ALL PIPES SHALL BE TESTED BY AN APPROVED METHOD BEFORE THEY BACKFILLED OR CONCEALED. AFTER TESTING IS COMPLETE, THE

PLUMBING CONTRACTOR SHALL DISINFECT THE POTABLE WATER SYSTEM AS REQUIRED BY LOCAL AUTHORITY. TEST WATER PURITY ACCORDING TO LOCAL REQUIREMENTS AND SUBMIT CERTIFIED TEST RESULTS TO ENGINEER FOR REVIEW AND APPROVAL

#### **CARBONATION**

IF APPLICABLE TO PROJECT SCOPE FOR CBE STATION, STARBUCKS CARBONATION VENDOR WILL PROVIDE AND INSTALL EQUIPMENT, CO2 TANKS AND FITTINGS. STARBUCKS SHALL PROVIDE AND CONTRACTOR SHALL INSTALL CO2 TANK MOUNTING BRACKET, PROTECTIVE SHELVING UNIT AND CO2 GAS TUBING AS SHOWN ON DRAWINGS AND PER MANUFACTURER'S INSTRUCTIONS. MAXIMUM TUBING LENGTH INCLUDING COILED ENDS IS 100 FT (30 M) AND MAXIMUM BEND IS TO 3 INCH (75 MM) MINIMUM RADIUS. ROUTE CO2 TUBING PREFERABLY THROUGH WALL AND/OR CEILING CAVITIES, WITHOUT KINKS AND SO AS TO NOT TOUCH ANY HOT SURFACE (BALLAST, STEAM PIPE, ETC.) OR RUB AGAINST A SHARP EDGE THAT MAY ABRADE OR CUT TUBING. ALL HOLES MUST BE SEALED WITH A GROMMET OR ESCUTCHEON. TUBING IS TO BE SECURED TO APPROPRIATE PERMANENT SURFACES TO KEEP IT OFF THE FLOOR OR CABINET BOTTOMS AND AWAY FROM OTHER EQUIPMENT. LABEL BOTH ENDS OF TUBING AND REGULARLY AT TEN (10) FOOT INTERVALS ALONG ROUTE AS "CO2."

#### **NITROGENATION**

STARBUCKS NITROGENATION VENDOR WILL PROVIDE AND INSTALL EQUIPMENT AND FITTINGS IF APPLICABLE TO PROJECT SCOPE FOR NITRO STATION. GENERAL CONTRACTOR SHALL COORDINATE NITRO SYSTEM INSTALLATION WITH STARBUCKS VENDOR.

#### **GENERAL PLUMBING NOTES**

- 1. PLUMBING CONTRACTOR SHALL COORDINATE WITH THE GENERAL CONTRACTOR TO PATCH AND REPAIR ALL EXISTING WALLS, FLOORS, CEILINGS OR OTHER SURFACES IDENTIFIED TO REMAIN THAT MAY BECOME DAMAGED DURING THE COURSE OF WORK.
- 2. EXPOSED/SURFACE MOUNTED PIPING IS ONLY ALLOWED IN THE BAR AREA UNDER COUNTERTOPS, WHERE IT DOES NOT OBSTRUCT CABINETS/DEVICES AND WHERE APPROVED BY STARBUCKS CONSTRUCTION MANAGER. IF ROUTED THROUGH CABINETS, IT SHALL BE ROUTED TO MAXIMIZE STORAGE SPACE AND BE PROTECTED FROM DAMAGE.
- 3. DRAWINGS ARE DIAGRAMMATIC AND INDICATE GENERAL INTENT OR ARRANGEMENT OF SYSTEM(S). FURNISH AND INSTALL ALL COMPONENTS NEEDED WHETHER INDICATED OR NOT TO PROVIDE A COMPLETE AND OPERATING SYSTEM. OVERALL CASEWORK COMPONENT DIMENSIONING ON PLUMBING DETAILS ARE SHOWN FOR REFERENCE AND COORDINATION ONLY.
- 4. CONTRACTOR TO VERIFY ALL DIMENSIONS, INCLUDING CLEARANCES REQUIRED BY OTHER TRADES, AND NOTIFY STARBUCKS CONSTRUCTION MANAGER OF ANY DISCREPANCIES PRIOR TO PROCEEDING WITH THE WORK. ALL DIMENSIONS ARE TO THE FACE OF THE FINISHED SURFACE UNLESS NOTED OTHERWISE. ALL DIMENSIONS TO BE TAKEN FROM ACTUAL BUILDING DIMENSIONS
- THE PLUMBING CONTRACTOR SHALL COORDINATE PLUMBING WORK WITH OTHER TRADES. THE ARCHITECTURAL DRAWINGS AND SPECIFICATIONS SHALL TAKE PRECEDENCE OVER ALL OTHER DRAWINGS. SEE ARCHITECTURAL DRAWINGS FOR FIXTURES IN CASEWORK AND PLUMBING DETAILS. SEE THE PROJECT MANUAL FOR PLUMBING SPECIFICATION SECTIONS.
- 6. ALL PIPING AND/OR PLUMBING DEVICES SHALL BE SUPPORTED FROM STRUCTURE (NOT FROM HVAC DUCTS OR OTHER PIPES/CONDUITS).
- 7. WHEN BUNDLING SEVERAL INDIRECT WASTE LINES TO DRAIN INTO FLOOR SINK, A UNISTRUT IS REQUIRED FOR SECURING AND BRACING ALL LINES ABOVE THE DRAIN.
- 8. FURNISH AND INSTALL ALL NEEDED DRAIN LINES PER CODE (NOT ALL SHOWN). INSTALL DRAINS AT 2% SLOPE WHERE POSSIBLE WITHOUT DIPS OR SAGS. ALL INDIRECT DRAINS SHALL RUN SEPARATELY FROM EACH OTHER TO INDIRECT DRAIN RECEPTOR AND SHALL TERMINATE WITH AN AIR GAP PER CODE.
- 9. FURNISH AND INSTALL WALL CLEANOUTS AT ALL SINKS AND AS NEEDED PER CODE (NOT ALL SHOWN).
- 10. INSULATE ICE BIN DRAINAGE PIPES PER THE REQUIREMENTS IN THE PROJECT MANUAL.

#### **GENERAL NOTES**

THE INTENT OF THE PROJECT MANUAL AND THE DRAWINGS IS TO PROVIDE A COMPLETE AND FULLY OPERATIONAL PLUMBING SYSTEM. THE CONTRACTOR SHALL FURNISH ALL LABOR, MATERIAL, AND EQUIPMENT RELATED TO THE INSTALLATION OF THE PLUMBING WORK.

HE CONTRACTOR SHALL THOROUGHLY EXAMINE ALL AREAS WHERE FIXTURES, EQUIPMENT, AND PIPING WILL BE INSTALLED AND WILL REPORT ANY CONDITION THAT PREVENTS THE PROPER INSTALLATION OF THE PLUMBING WORK.

EQUIPMENT AND MATERIALS SHALL CONFORM WITH THE APPROPRIATE PROVISIONS OF LISTING STANDARD IN EFFECT AS APPLICABLE TO EACH INDIVIDUAL UNIT OR ASSEMBLY.

ALL WORK SHALL BE PERFORMED IN STRICT ACCORDANCE WITH ALL APPLICABLE PROVINCIAL AND LOCAL CODES AND ORDINANCES. IN CASE OF CONFLICT BETWEEN THE DRAWINGS AND SPECIFICATIONS AND THE CODES AND ORDINANCES. THE HIGHEST STANDARD SHALL APPLY. THE CONTRACTOR SHALL SATISFY CODE REQUIREMENTS AS A MINIMUM STANDARD WITHOUT ANY EXTRA COST TO STARBUCKS.

THE CONTRACTOR SHALL PROCURE AND PAY FOR ALL PERMITS. FEES. AND INSPECTIONS NECESSARY TO COMPLETE THE PLUMBING WORK.

HE CONTRACTOR SHALL UNCONDITIONALLY WARRANT ALL WORK TO BE FREE OF DEFECTS IN MATERIAL AND WORKMANSHIP FOR A PERIOD OF ONE (1) YEAR FROM THE DATE OF FINAL ACCEPTANCE BY STARBUCKS AND WILL REPAIR OR REPLACE ANY DEFECTIVE WORK PROMPTLY AND WITHOUT CHARGE AND RESTORE ANY OTHER EXISTING WORK DAMAGED IN THE COURSE OF REPAIRING DEFECTIVE MATERIALS AND WORKMANSHIP.

#### LANDLORD REQUIREMENTS

PRIOR TO BID: THE CONTRACTOR SHALL COORDINATE WITH LANDLORD / BUILDING OWNER FOR ANY CONSTRUCTION REQUIREMENTS. CONTRACTOR SHALL BECOME COMPLETELY FAMILIAR WITH REQUIREMENTS AND ADHERE TO THEM. WHERE LANDLORD / BUILDING OWNER REQUIREMENTS ARE MORE STRINGENT THAN SHOWN IN THESE PLANS. LANDLORD / BUILDING OWNER REQUIREMENTS SHALL GOVERN.



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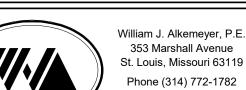
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NOR LIABILITY TO THE OTHER (EXCEPT STATED ABOVE) UNTIL A

WRITTEN AGREEMENT IS FULLY EXECUTED BY BOTH PARTIES





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62012 87799-001

ISSUE DATE: 07-07-2020 SR. DESIGN MANAGER: K. GORIN SLONSKI PRODUCTION DESIGNER: A. HAHN CHECKED BY: SMD / SWE

**Revision Schedule** 

Description

PLUMBING NOTES

SCALE: AS SHOWN

SHEET NUMBER:

CROSS CONNECTI	ON CO	NTROL SO	CHEDULE
FIXTURE	MAKE	MODEL	ASSE, ASME OR ANSI STANDARD
MOP SINK (FAUCET CONTAINS	WATTS &	9DM2-S	ASSE 1012
INTEGRAL BACKFLOW DEVICE)	INTEGRAL	-	ASSE 1001
DISHWASHER	WATTS	LF008PCQT	ASSE 1056
ICE MACHINE	AIR GAP	INTERNAL	ASME A112.1.2
COFFEE BREWER	WATTS	SD-3	ASSE 1022
ESPRESSO MACHINE	WATTS	SD-3	ASSE 1022
WATER FILTER SYSTEM	WATTS	LF009QT	ASSE 1013
CHEMICAL DISPENSER	WATTS	LF009 W/ AIR GAP	ASSE 1013
		FITTING 909AGA	
FREEZEPROOF HOSEBIBB	WATTS	LF8	ASSE 1011
HOSEBIBB FOR CHEM. DISP. @ MSB	WATTS	LF8	ASSE 1011
BLENDER PITCHER RINSER	WATTS	SD-3	ASSE 1022
3-COMPARTMENT SINK	AIR GAP	-	ASME A112.1.2
WORK SINK	AIR GAP	-	ASME A112.1.2
HAND SINKS	AIR GAP	-	ASME A112.1.2
DROP-IN SINKS	AIR GAP	-	ASME A112.1.2
LAVATORIES	AIR GAP	-	ASME A112.1.2
WATER CLOSETS (FLUSH VALVE)	WATTS	118A	ASSE 1001
WATER HEATER	WATTS	LFN36	ANSI Z21.22
BUILDING WATER SUPPLY	WATTS	LF009 M2-QT	ASSE 1013
(BY LANDLORD)		OR EQUAL	

ALL BRASS VALVES SHALL COMPLY WITH THE 2014 EPA LEAD FREE REQUIREMENTS.

#### GAS LINE CALCULCATION

		.07 (1101)
TAG	МВН	GAS LINE SIZE TO EQUIPMENT
RTU-1	250	1-1/4"
RTU-2	250	1-1/4"
WH	100	3/4"
TOTAL MBH =	600	TOTAL PIPE SIZE = 1-1/2"

GAS PIPING IS SIZED PER TABLE 402.4(2) OF THE 2015 INTERNATIONAL FUEL & GAS CODE AND A DISTANCE OF 100' TO THE FURTHEST PIECE OF EQUIPMENT FROM THE METER.

#### HOT WATER DEMAND REQUIREMENT COLUDNACNIT# NO OF FIXTURES TEMP PISE COURTED BY TOTAL COU

<u>EQUIPMENT#</u>	<u>FIXTURE</u>	NO. OF FIXTURES	TEMP. RISE	<u>GPH PER FIX.</u>	<u>TOTAL GPH</u>
10597 / 13588	HAND SINKS	3	100	5	15
10597	LAVATORIES	2	100	5	10
10152 / 10215	DROP-IN SINK	3	100	10	30
10922	MOP SINK BASIN	1	100	5	5
10447 / 10804	3 COMPARTMENT SI	NK 1	100	50	50
	110 GAL. X 100°F X 8	3.33 = 95,448 BTU	H REQUIRED		

100,000 BTUH WATER HEATER TO BE INSTALLED. SEE SPECIFICATION ON SHEET P601

#### PLUMBING SUPPLY NOTES

- FURNISH AND INSTALL A COMPLETE AND OPERATING SYSTEM. ALL ITEMS ARE NOT NECESSARILY SHOWN.
- PLUMBING CONTRACTOR RESPONSIBLE FOR SITE INVESTIGATION PRIOR TO START OF WORK TO REVEAL FULL SCOPE OF WORK.
- ALL PLUMBING LINES TO BE ROUTED SUCH THAT THEY ARE NOT VISIBLE TO CUSTOMERS EXCEPT WHERE FIRST APPROVED BY

STARBUCKS AT EXPOSED CEILING AREAS.

CONNECTION TO ALL PLUMBING EQUIPMENT.

MANAGER.

- REFER TO MANUFACTURER SPECIFICATIONS FOR LOCATION OF CONNECTIONS UNLESS OTHERWISE NOTED.
- COORRDINATE WITH ELECTRICAL CONTRACTOR FOR POWER
- REFERENCE WORK LETTER FOR DIVISION OF PLUMBING SCOPE OF WORK AND COORDINATE WITH STARBUCKS CONSTRUCTION
- DIMENSIONS ARE TO FINISH FACE UNLESS OTHERWISE NOTED.
- REFER TO DETAIL SHEETS FOR PLUMBING FITTINGS LOCATED IN
- COLD WATER SUPPLY LINES INSIDE CASEWORK AND BAR AREA TO BE COVERED WITH (10MM) THICK SELF SEALING, SECTIONAL CLOSED-CELL FOAM INSULATION, REFER TO SPECIFICATIONS FOR HOT WATER SUPPLY LINE INSULATION REQUIREMENTS.
- INSULATE ALL PIPING INCLUDING PIPES AT BAR AND IN CASEWORK PER THE REQUIREMENTS LISTED IN THE PLUMBING PROJECT MANUAL
- GENERAL CONTRACTOR SHALL CONTACT WATER FILTRATION SUPPLIER TO COORDINATE SCOPE OF WORK AND SCHEDULE PRIOR TO INSTALLATION OF WATER FILTRATION SYSTEM.

#### SUPPLY KEYED NOTES

- 1" CSW & 1/2" HWR TO WATER HEATER & 1" HW FROM WATER HEATER. WATER HEATER AS SPECIFIED AND IN COMPLIANCE WITH APPLICABLE CODES AND ORDINANCES. DIMENSIONS OF THE HEATER SHALL ALLOW INSTALLATION ABOVE THE MOP SINK. REFER TO WATER HEATER DETAIL
- 1/2" HW & CW TO FAUCET AT MOP SINK. CAULK AND SEAL BACK OF SINK PW02 TO WALL. PROVIDE TACO MODEL 5122 OR APPROVED ASSE 1070 EQUAL POINT OF USE THERMOSTATIC MIXING VALVE AT MOP SINK TO PROVIDE
- PW03 1" CW TO WATER FILTER AND 1" CSW & 3/4" CWF FROM WATER FILTER. PLUMBING CONTRACTOR TO FOLLOW MANUFACTURER'S INSTALLATION INSTRUCTIONS AND ACTIVATION PROCEDURES FOR FILTERS. VERIFY REQUIREMENTS PRIOR TO BID. SEE DETAIL ON SHEET P501.
  - 3/4" HW & CW TO FAUCET AND SPRAY AT COMPARTMENT SINK. CAULK AND SEAL BACK OF SINK TO WALL. PROVIDE TACO MODEL 5123 OR APPROVED ASSE 1070 EQUAL POINT OF USE THERMOSTATIC MIXING VALVE AT COMPARTMENT SINK TO PROVIDE 120° WATER.
  - 3/4" CSW TO DISHWASHER. INSTALL SHUT-OFF WITH 3/4" MALE HOSE-END FITTING @ 18" A.F.F. UNDER COMPARTMENT SINK. SHUT-OFF TO INCLUDE PRESSURE REDUCING VALVE, PRESSURE GAUGE (SET @ 20 PSI, +/- 5 PSI) LINE STRAINER, AND SHOCK ARRESTOR IN WALL. CONNECT SANITIZER TO CSW SUPPLY WITH 72" LONG BRAIDED STAINLESS STEEL HOSE. PROVIDE 3/8" TEE OFF OF COLD WATER LINE SERVING 3-COMPARTMENT SINK AND CONNECT TO DRAIN WATER TEMPERING KIT ACCESSORY ON DISHWASHER TO PROVIDE 140° MAX. WASTE WATER DISCHARGE TO DRAINAGE SYSTEM.
  - 1/2" CWF TO ICE MACHINE. REDUCE TO 3/8" AT MACHINE.
  - 1/2" HW & CW TO SINK. PROVIDE TACO MODEL 5122 OR APPROVED EQUAL POINT OF USE THERMOSTATIC MIXING VALVE AT EACH HAND SINK TO PROVIDE 110° TEMPERED WATER
  - 3/4" CWF TO SERVE COFFEE BREWER AND FUTURE AERO BREWER. INSTALL SHUT-OFFS IN CABINET @ 24" AFF. REDUCE TO 3/8" AT UNIT. PROVIDE ASSE 1022 BACKFLOW PREVENTER. PROVIDE CWF STUB FOR FUTURE AERO BREWER PER STARBUCKS GUIDELINES.
- 1/2" CWF TO ESPRESSO MACHINE PUMP. SEE DETAIL PROVIDED ON SHEET P501. PROVIDE ASSE 1022 BACKFLOW PREVENTER.
- 1/2" CWF TO INSTAHOT TAP. REDUCE TO 1/4" AT UNIT.

PW10

1/2" CWF TO WATER TOWER FAUCET LOCATED IN WATER STATION.

1/2" CW TO DIPPERWELL FAUCET. REDUCE TO 1/4" AT UNIT.

- 1" CW TO TOILET. PROVIDE WATER HAMMER ARRESTOR IN SUPPLY LINE. PW13
  - 3/4" CWF, CW AND HW TO DROP DOWN IN WALL AND ROUTE THROUGH CABINETRY FOR FRONT BAR AREA. CONNECT TO EQUIPMENT (2) 10153, (2) 10215, (2) 10874, (2) 11003 AND (2) 12694. REFER TO NOTES 9, 10, 11, 12, AND 15. VERIFY ROUTING IN FIELD WITH GC PRIOR TO INSTALLATION.
- 1/2" HW & CW TO SINK. PROVIDE TACO MODEL 5122 OR APPROVED ASSE 1070 EQUAL POINT OF USE THERMOSTATIC MIXING VALVE AT EACH WORK SINK TO PROVIDE 120° HOT WATER.
- 1/2" CW SUPPLY TO PITCHER RINSER SINK, PROVIDE AN ASSE 1022 BACKFLOW PREVENTER AND ANY ADDITIONAL VALVES AS REQUIRED BY CODE AND MANUFACTURES INSTALLATION INSTRUCTIONS.
  - MAKE CONNECTION TO 2" WATER LINE STUBBED INTO PREMISES BY LANDLORD. LANDLORD TO PROVIDE METER AND BACKFLOW PREVENTER IN LOCATION SHOWN. VERIFY THAT THE DOMESTIC WATER SERVICE IS ADEQUATE TO SUPPLY A MINIMUM OPERATING FLOW RATE OF 50 GALLONS PER MINUTE: AT A MINIMUM 50 PSIG AND A MAXIMUM OF 65 PSIG DYNAMIC PRESSURE AT ALL TIMES. IF FLOW RATE OR PRESSURE IS NOT SUFFICIENT, LANDLORD SHALL SIZE, FURNISH AND INSTALL A BOOSTER PUMP IN A LOCATION AGREED UPON WITH THE TENANT. ENTIRE INSTALLATION SHALL BE IN ACCORDANCE WITH LOCAL CODES. CONTRACTOR SHALL FIELD VERIFY REQUIREMENTS PRIOR TO BID. BID SHALL INCLUDE ALL WORK NECESSARY FOR A FULLY OPERATIONAL SYSTEM. SEE LANDLORD & CIVIL DRAWINGS FOR ADDITIONAL
- FREEZE PROOF HOSE BIBS BY LANDLORD. COORDINATE PROVISION OF HOSE BIBS WITH LANDLORD AND VERIFY REQUIREMENTS PRIOR TO COMMENCING WORK. HOSE BIB MUST BE CONNECTED TO 1/2" INSULATED, COPPER PIPE AND RUN WITHIN CONDITIONED SPACE. IT MUST BE EXPOSED AND VISIBLE FOR TENANT'S CONNECTION. VERIFY

INFORMATION AND CONTINUATION.

PROVIDE A BACKFLOW PREVENTER FOR CHEMICAL DISPENSERS AT MOP SINK AND 3-COMPARTMENT SINK AS REQUIRED BY AHJ. VERIFY REQUIREMENTS PRIOR TO COMMENCING WORK.

LOCATION WITH CONSTRUCTION MANAGER.

- 1/2" CW SUPPLY FOR IN-COUNTER RINSER AT 20-1/2" AFF FOR BACK BAR PITCHER RINSER. FRONT BAR PITCHER RINSERS TO BE ROUTED FROM UNDER COUNTER WATER PIPING. SEE NOTE 14 FOR ADDITIONAL
  - INSTALL N/2-FUSION NITRO DISPENSING SYSTEM PER MANUFACTURER'S RECOMMENDATIONS. COORDINATE ROUTING, INSTALLATION AND RESPONSIBILITY WITH GENERAL CONTRACTOR AND STARBUCKS NITROGENATION VENDOR.
- PROVIDE 3/4" CWF AND 1/2" HW & CW DROP FOR WATER FILLING STATION.
  - MAKE CONNECTION TO NATURAL GAS LINE STUB BY LANDLORD. LANDLORD TO PROVIDE METER AND ANY REQUIRED VALVING. VERIFY THAT SERVICE IS ADEQUATE TO SUPPLY 550 MBH. ALL WORK SHALL BE COMPLETED IN ACCORDANCE WITH LOCAL CODES. BID SHALL INCLUDE ALL WORK FOR A FULLY OPERATIONAL SYSTEM. ALL GAS PIPE SIZES SHOWN FOR LOW PRESSURE (LESS THAN 2 LBS.). VERIFY EXACT LOCATION, PRESSURE AND REQUIREMENTS ON SITE. SEE LANDLORD & CIVIL DRAWINGS FOR ADDITIONAL INFORMATION AND CONTINUATION.
  - 1-1/4" GAS TO MECHANICAL RTU-1 & 2 ON ROOF WITH APPROVED SHUT-OFF VALVE & DIRT LEG BY LANDLORD.
  - 3/4" GAS TO WATER HEATER WITH APPROVED SHUT-OFF VALVE & DIRT

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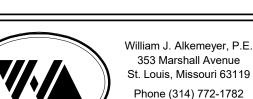
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STORE #: 62012 PROJECT #: 87799-001 07-07-2020

ISSUE DATE: SR. DESIGN MANAGER: K. GORIN SLONSKI PRODUCTION DESIGNER: A. HAHN CHECKED BY: SMD / SWE

**Revision Schedule** 

Rev Date Description

PLUMBING SUPPLY PLAN SCALE: AS SHOWN

SHEET NUMBER:

P101

ALL DOMESTIC WATER PIPING TO BE 1/2" UNLESS OTHERWISE INDICATED. 10922 PW02PW19 P X0010 P 13040 P 12501 — + 1 1/2"ø-LLNG - +1 1/4"ø LLNG - -P 12507 3/4"ø▶**----**1/2"ø-140**--**1/2"ø 🕶 🙀 ብ 1/2"ø-CW-P 12896 (PW03|P| 12899 --P 13040 PW13 P 13076 P 13082 P 13149 E 18029 PW06 1' - 9 1/2" P 11003 PW10 E 18846 PW11 P 15749 PW11P 15749 d--3/4"ø-SCW-P 19277 PW20 E 19742 PW14 E 19742 P 19277 PW20 P 10215 PW15 -1"ø-140--1"ø-140-<del>--</del>3/4"ø-HWR--3/4"ø-HWR---P 10153 PW12 <del>-</del>3/4"ø-FCW-><del>---</del>3/4"ø•FCW<del>-y---</del>**U** P 11003 PW10 P 10447 |E|15186||P|13588| P 10804 P 10874 PW11 -{PW05}|s|=--{PW07}|-(PW04(PW19) 3' - 2 1/2" | 2' - 6" | 2' - 4" 6' - 1" -3/4"ø-CW—€ -3/4"ø-140---1"ø---140--3/4"ø-HWR-<del>-</del>3/4"ø−HWR− -3/4"ø-HWR--3/4"ø-FCW-—3/4"ø-FCW--3/4"ø-FCW-(PW18) FCW-(PW21 E 20011 - --**C**-LLCW <del>-</del>3/4"ø− 2"ø LLCW CW-PW16 E 17564 (PW17) **2"**ø-LLCW − PW15 P 10215

P 10152 P 10597 E 10746 P 10215 P 11003 P 10153 | P 10874 | (PW15) (PW08) (PW11)

> 3' - 11" 7' - 5 1/2" 4' - 3"

PLUMBING SUPPLY PLAN

#### PLUMBING WASTE NOTES

- ALL PLUMBING LINES TO BE ROUTED SUCH THAT THEY ARE NOT VISIBLE TO CUSTOMERS EXCEPT WHERE FIRST APPROVED BY STARBUCKS AT EXPOSED CEILING AREAS.
- REFER TO MANUFACTURER SPECIFICATIONS FOR LOCATION OF CONNECTIONS UNLESS OTHERWISE NOTED.
- COORDINATE WITH ELECTRICAL CONTRACTOR FOR POWER CONNECTION TO ALL PLUMBING EQUIPMENT.
- DIMENSIONS ARE TO FINISH FACE UNLESS OTHERWISE NOTED.
- E. REFER TO DETAIL SHEETS FOR PLUMBING FITTINGS LOCATED IN CASEWORK.
- WHEN BUNDLING SEVERAL INDIRECT WASTE LINES TO DRAIN INTO A FLOOR SINK, A UNISTRUT IS REQUIRED FOR SECURING AND BRACING ALL LINES ABOVE THE DRAIN.
- FURNISH & INSTALL ALL NEEDED INDIRECT DRAINS PER CODE (NOT ALL SHOWN). INSTALL DRAINS AT 2% SLOPE WHERE POSSIBLE WITHOUT DIPS OR SAGS. ALL INDIRECT DRAINS SHALL RUN SEPARATELY FROM EACH OTHER TO INDIRECT DRAIN RECEPTOR AND SHALL TERMINATE WITH AN AIR GAP
- FURNISH & INSTALL WALL CLEANOUTS AT ALL SINKS AND AS NEEDED AND PER CODE (NOT ALL SHOWN).
- INSULATE ICE BIN DRAINAGE PIPES PER THE REQUIREMENTS ON THE PLUMBING SPECIFICATION SHEET.

#### SANITARY KEYED NOTES

- PS01 1" INDIRECT DRAIN FROM DRIP PAN AND 3/4" PRESSURE RELIEF FROM WATER HEATER TO FLOOR DRAIN. SEE DETAIL ON SHEET P501 FOR ADDITIONAL INFORMATION.
- PS02 3" WASTE FROM MOP SINK.
- PS03 2" INDIRECT DRAINS FROM THE 3-COMP SINK TO FLOOR SINK. FLOOR SINK UTILIZED FOR THE 3 COMP AND DISHWASHER TO BE ROUTED TO AN INTERIOR GREASE TRAP.
- 1-1/2" INDIRECT DRAIN FROM DISHWASHER TO FUNNEL OVER FLOOR SINK (IF PERMITTED). 1-1/2" TRADE SIZE PIPE MINIMUM REDUCED TO 3/4" FPT
- PS05 (2) 3/4" INDIRECT DRAIN FROM ICE MACHINE AND BIN TO INDIRECT DRAIN AT FLOOR SINK.
- PS06 5/8" DRAIN HOSE FROM ESPRESSO MACHINE TO INDIRECT DRAIN RISER.
- PS07 1" INDIRECT INSULATED DRAIN LINE FROM ICE BIN DROP TO FLOOR SINK.
- 1" INDIRECT WASTE FROM DRAIN HOSE OF THE WARE RINSER TO FLOOR SINK AS REQUIRED.
- 3" WASTE FROM FLOOR SINK. GENERAL CONTRACTOR MAY NEED TO MODIFY CABINET BASE TO ALLOW ACCESS TO FLOOR SINK.
- PS10 2" WASTE FROM SINK.

SEE DETAIL ON SHEET P501.

- 4" WASTE FROM TOILET, CONTRACTOR TO VERIFY THAT A 1/4" SLOPE FROM TOILET WASTE CAN BE ACHIEVED WITH GENERAL CONTRACTOR BEFORE INSTALLING LOW FLUSH TOILET.
- MAKE CONNECTION TO EXISTING 4" SANITARY SEWER BY LANDLORD IN THE PREMISES WITH A MINIMUM INVERT ELEVATION AT THE FURTHEST POINT OF CONNECTION TO BE 27". VERIFY EXACT LOCATION. INVERTS AND REQUIREMENTS ON SITE. SEE LANDLORD DRAWINGS FOR ADDITIONAL INFORMATION AND CONTINUATION.
- PS13 1-1/2" INDIRECT DRAIN TO FLOOR SINK.
- 3" WASTE FROM FLOOR DRAIN. PROVIDE TRAP PRIMERS FOR ALL FLOOR
- PS15 (2) 1-1/2" INDIRECT DRAINS FROM PITCHER RINSER SINK TO FLOOR SINK.
- MAKE CONNECTION TO EXISTING 4" VENT THROUGH ROOF BY LANDLORD. A MINIMUM OF 10' CLEARANCE TO AIR INTAKES SHALL BE MAINTAINED. VERIFY EXACT LOCATION, SIZE AND REQUIREMENTS ON SITE. SEE LANDLORD DRAWINGS FOR ADDITIONAL INFORMATION AND CONTINUATION.
- INDIRECT DRAIN FROM WATER EQUIPMENT TO NEAREST DRAIN RECEPTACLE. CONTRACTOR TO VERIFY EXACT REQUIREMENTS WITH EQUIPMENT SUPPLIER. SEE DETAIL ON SHEET P501.
- ROUTE INDIRECT WASTE FROM THE DRAIN TRAY AND 1/2" INDIRECT CONDENSATE WASTE FORM THE COLD BREW NITRO SYSTEM TO FLOOR SINK. INSTALL PER MANUFACTURER'S RECOMMENDATION. COORDINATE INSTALLATION AND RESPONSIBILITY WITH GENERAL CONTRACTOR AND STARBUCKS NITROGENATION VENDOR.
- 3" WASTE FROM EXISTING FLOOR DRAIN PROVIDED BY LANDLORD FOR WATER SERVICE BACKFLOW PREVENTER AS REQUIRED BY CODE. FIELD VERIFY EXACT LOCATION AND REQUIREMENTS.



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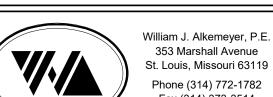
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Fax (314) 373-3514 **Engineering Consultant** 

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**の** & T OF STARBUCK NW PRYOR RD - LEE'S SUMMIT

VEST PRYOR, I ENSTEIN DR. MO

LOT

BUILDOUT
COFFEE CHIPMAN STORE #: 62012 PROJECT #:

87799-001 07-07-2020 K. GORIN SLONSKI SR. DESIGN MANAGER: PRODUCTION DESIGNER: A. HAHN

SMD / SWE

PLUMBING WASTE & VENT PLAN


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SCALE: AS SHOWN

ISSUE DATE:

CHECKED BY:


P102

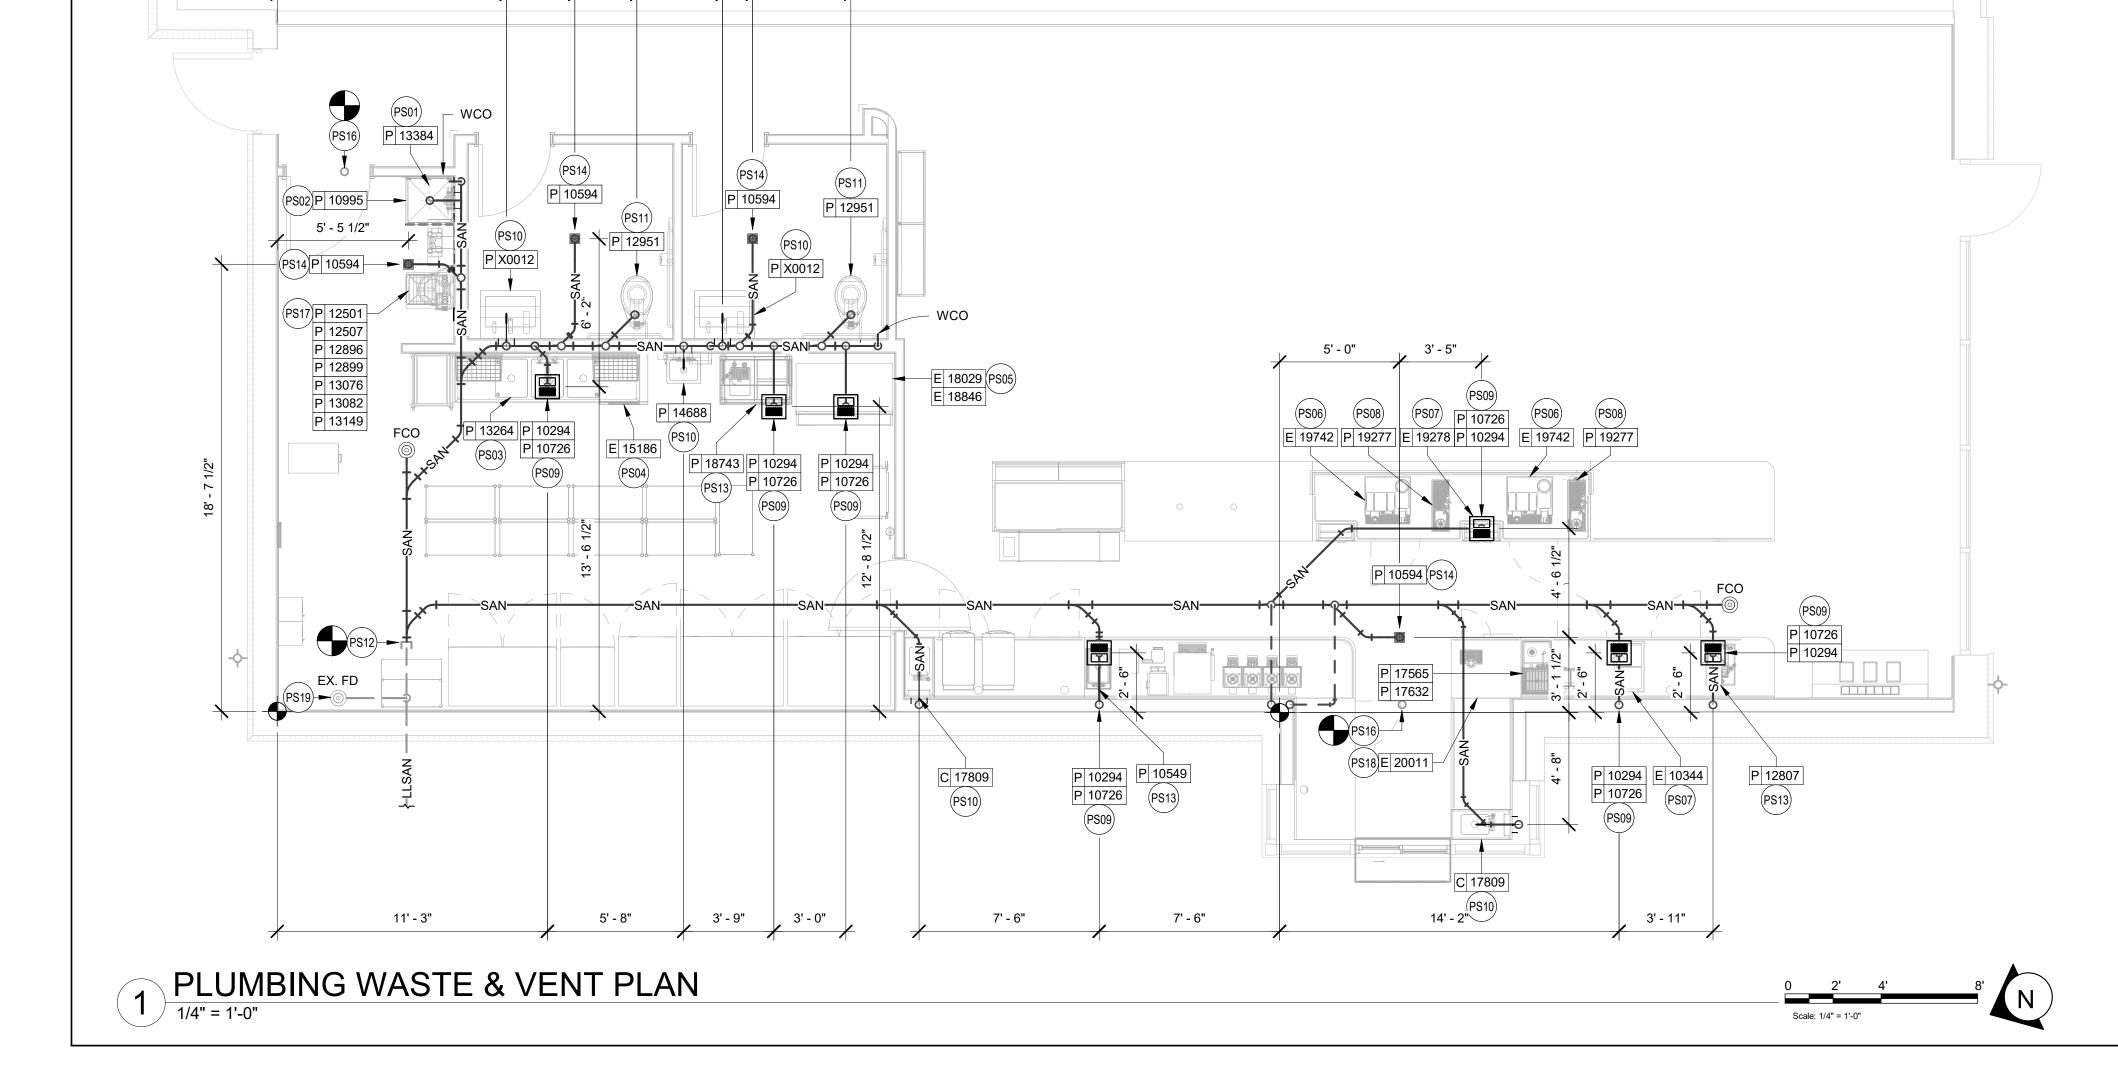

9' - 6 1/2"

3' - 7" 1' - 3", 4' - 1"

, 2' - 10 1/2", 2' - 7"

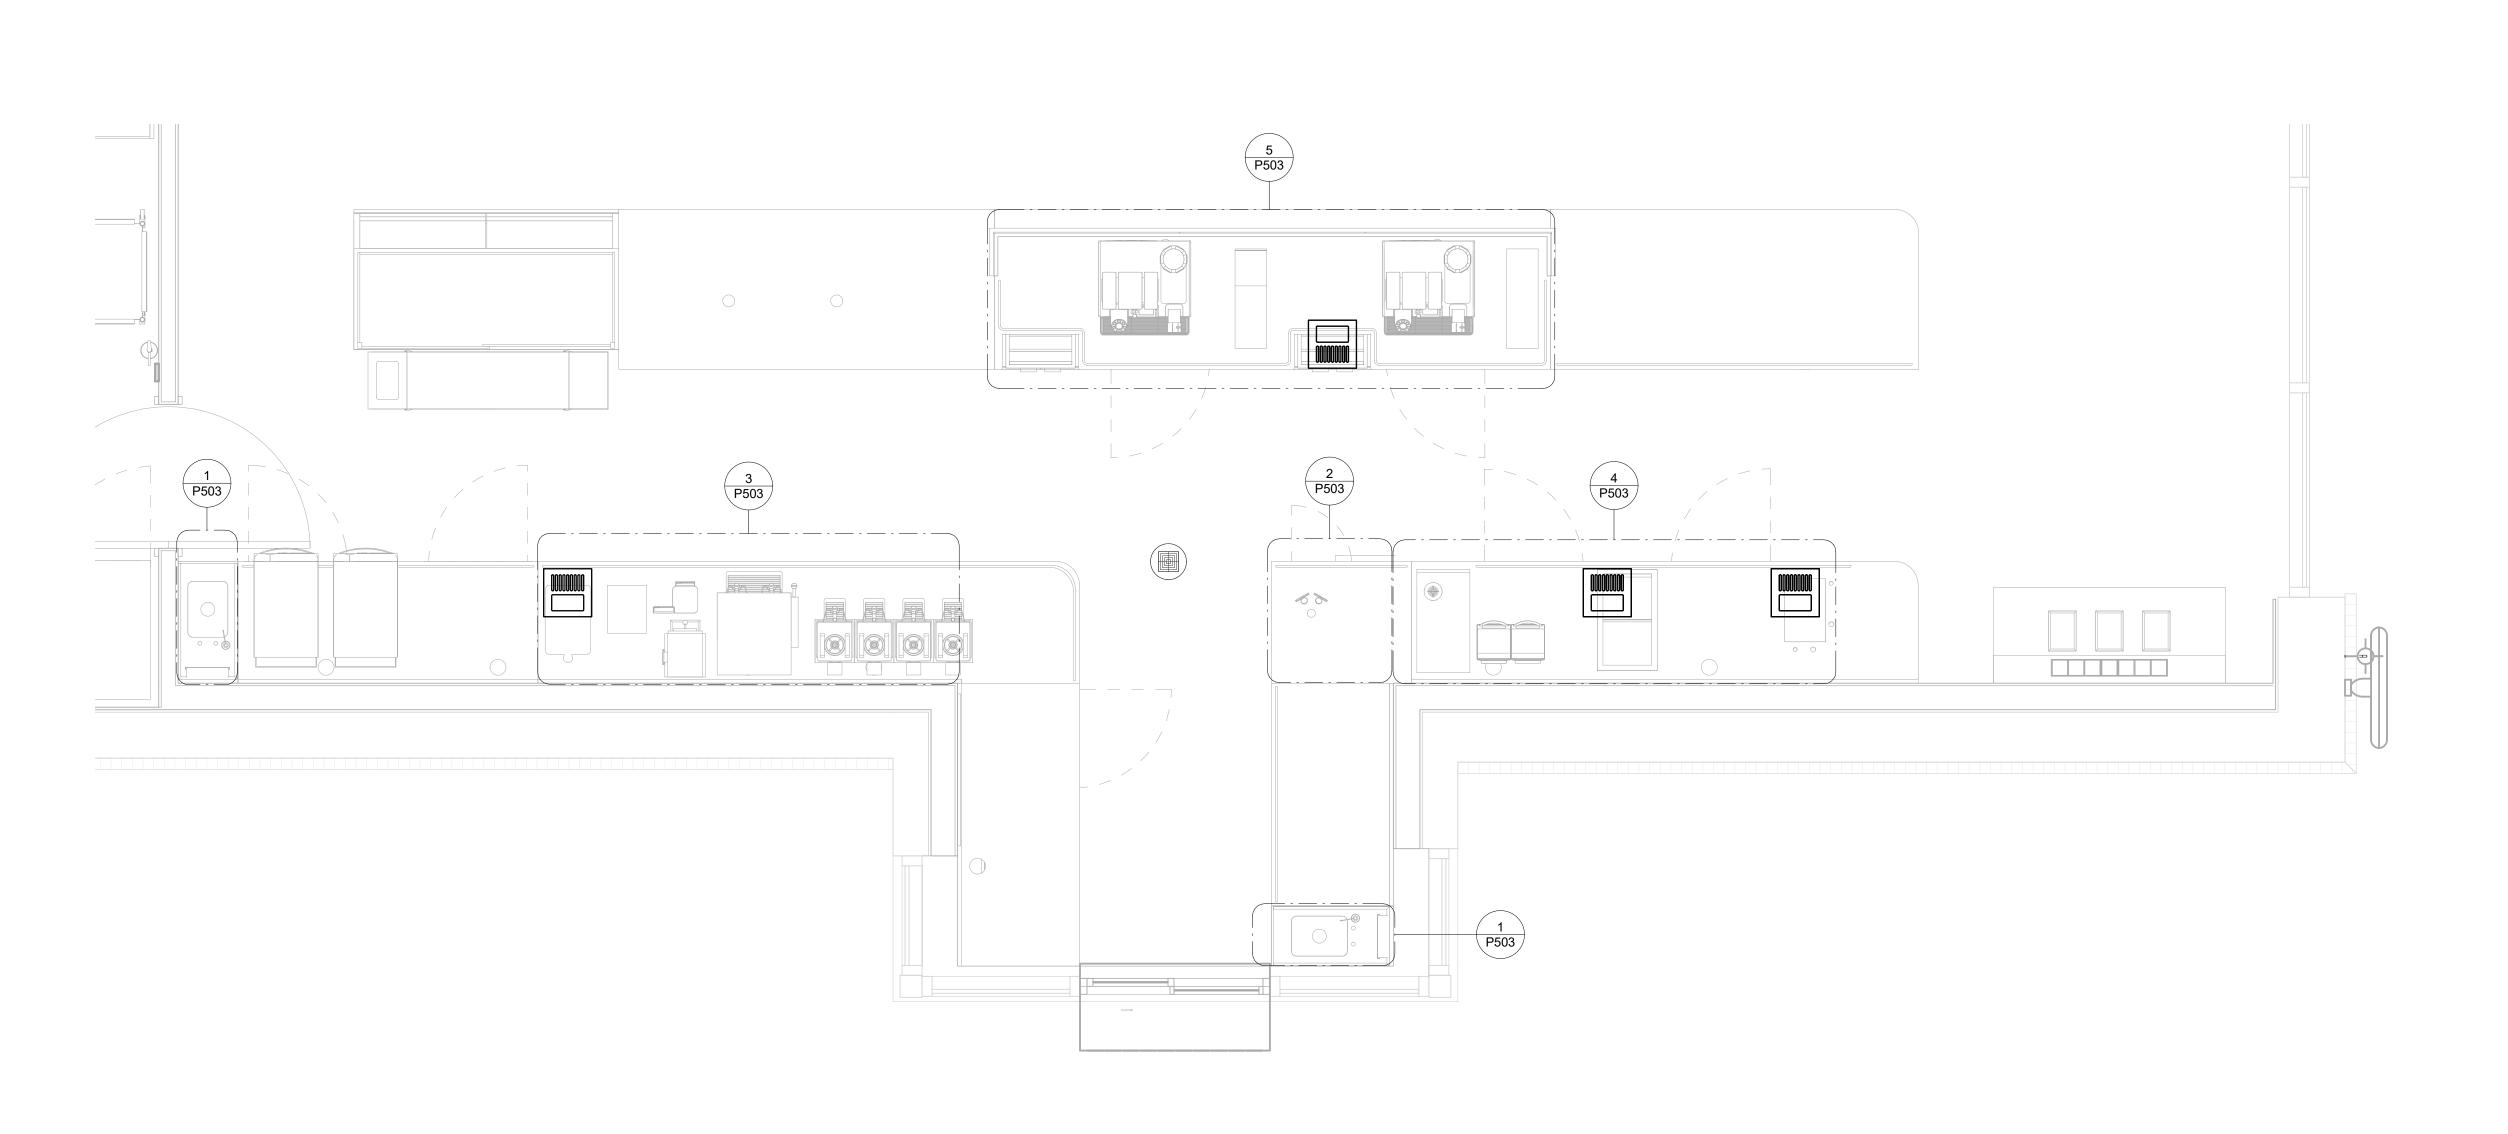



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William J. Alkemeyer, P.E. 353 Marshall Avenue St. Louis, Missouri 63119 Phone (314) 772-1782 Fax (314) 373-3514 **Engineering Consultant** 

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VEST PRYOR, LOT (ENSTEIN DR. MO

BUILDOUT
COFFEE - N
CHIPMAN -STORE #: 62012 87799-001 PROJECT #:

ISSUE DATE: 07-07-2020
SR. DESIGN MANAGER: K. GORIN SLONSKI
PRODUCTION DESIGNER: A. HAHN
CHECKED BY: SMD / SWE


ENLARGED PLUMBING PLACEMENT PLAN SCALE: AS SHOWN

SHEET NUMBER:

P103

1 ENLARGED PLUMBING DESIGN PLAN
1/2" = 1'-0"



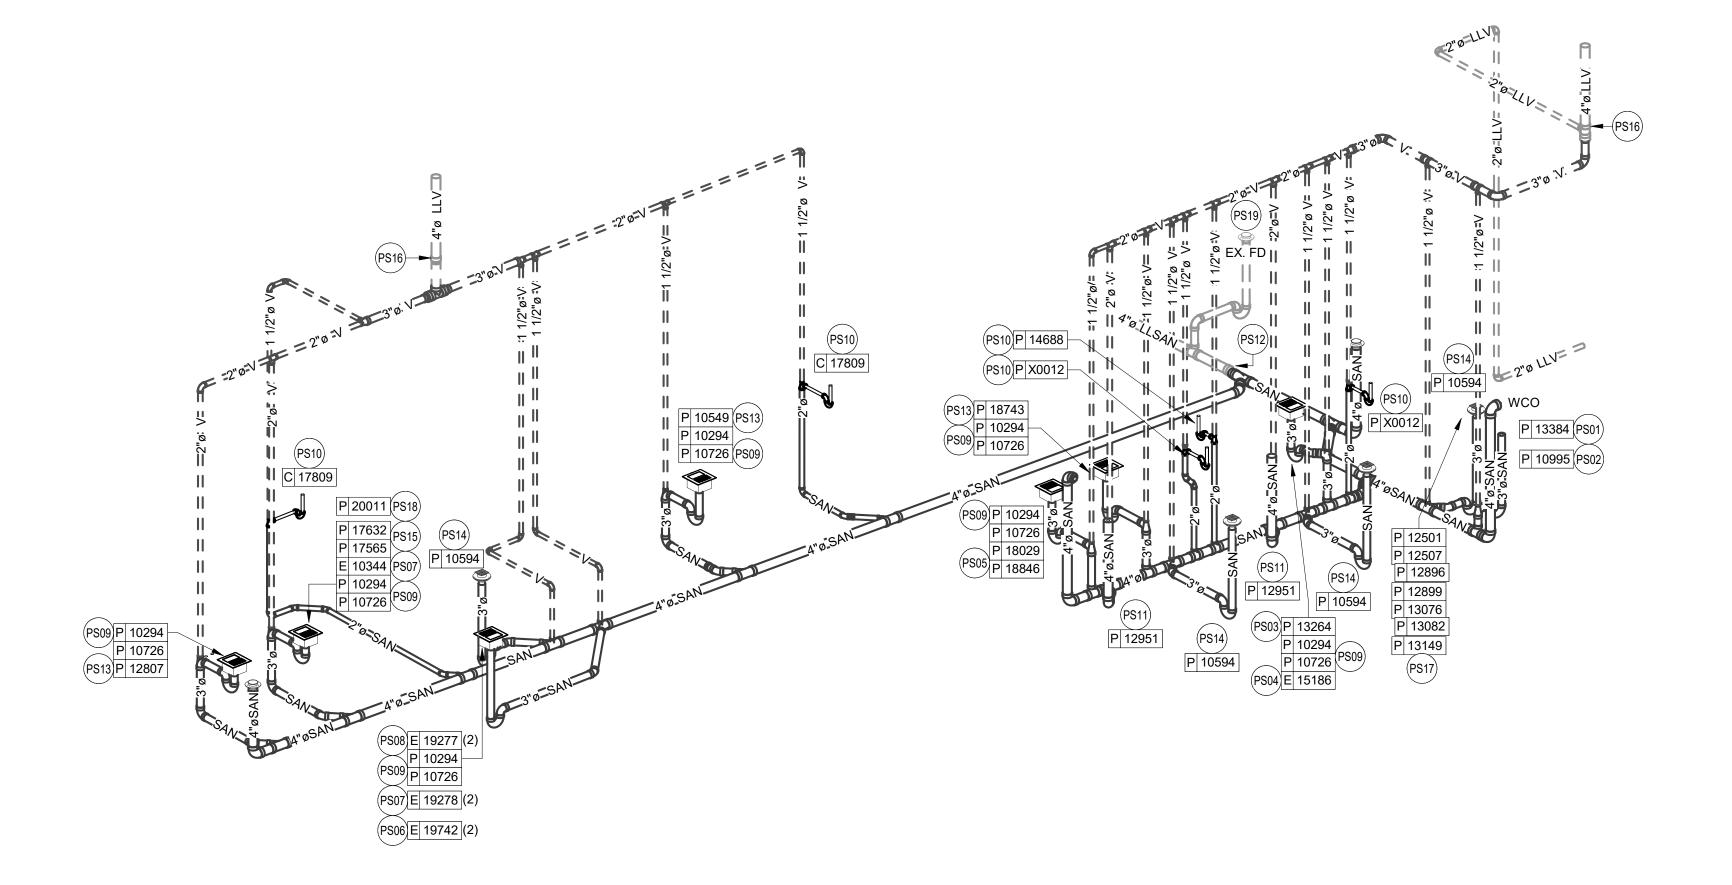

#### SANITARY ISOMETRIC DIAGRAM

#### SANITARY ISO KEYED NOTES

- PS01 1" INDIRECT DRAIN FROM DRIP PAN AND 3/4" PRESSURE RELIEF FROM WATER HEATER TO FLOOR DRAIN. SEE DETAIL ON SHEET P501 FOR ADDITIONAL INFORMATION.
- PS02 3" WASTE FROM MOP SINK.
- 2" INDIRECT DRAINS FROM THE 3-COMP SINK TO FLOOR SINK. FLOOR SINK UTILIZED FOR THE 3 COMP AND DISHWASHER TO BE ROUTED TO AN INTERIOR GREASE TRAP.
- 1-1/2" INDIRECT DRAIN FROM DISHWASHER TO FUNNEL OVER FLOOR SINK (IF PERMITTED). 1-1/2" TRADE SIZE PIPE MINIMUM REDUCED TO 3/4" FPT
- (2) 3/4" INDIRECT DRAIN FROM ICE MACHINE AND BIN TO INDIRECT DRAIN
- 5/8" DRAIN HOSE FROM ESPRESSO MACHINE TO INDIRECT DRAIN RISER. SEE DETAIL ON SHEET P501.
- PS07 1" INDIRECT INSULATED DRAIN LINE FROM ICE BIN DROP TO FLOOR SINK.
- 1" INDIRECT WASTE FROM DRAIN HOSE OF THE WARE RINSER TO FLOOR SINK AS REQUIRED.
- PS09 3" WASTE FROM FLOOR SINK. GENERAL CONTRACTOR MAY NEED TO MODIFY CABINET BASE TO ALLOW ACCESS TO FLOOR SINK.
- PS10 2" WASTE FROM SINK.
- PS11 4" WASTE FROM TOILET. CONTRACTOR TO VERIFY THAT A 1/4" SLOPE FROM TOILET WASTE CAN BE ACHIEVED WITH GENERAL CONTRACTOR BEFORE INSTALLING LOW FLUSH TOILET.
- PS12 MAKE CONNECTION TO EXISTING 4" SANITARY SEWER BY LANDLORD IN THE PREMISES WITH A MINIMUM INVERT ELEVATION AT THE FURTHEST POINT OF CONNECTION TO BE 27". VERIFY EXACT LOCATION, INVERTS AND REQUIREMENTS ON SITE. SEE LANDLORD DRAWINGS FOR ADDITIONAL INFORMATION AND CONTINUATION.
- PS13 1-1/2" INDIRECT DRAIN TO FLOOR SINK.
- 3" WASTE FROM FLOOR DRAIN. PROVIDE TRAP PRIMERS FOR ALL FLOOR
- (2) 1-1/2" INDIRECT DRAINS FROM PITCHER RINSER SINK TO FLOOR SINK.
- PS16 MAKE CONNECTION TO EXISTING 4" VENT THROUGH ROOF BY LANDLORD. A MINIMUM OF 10' CLEARANCE TO AIR INTAKES SHALL BE MAINTAINED. VERIFY EXACT LOCATION, SIZE AND REQUIREMENTS ON SITE. SEE LANDLORD DRAWINGS FOR ADDITIONAL INFORMATION AND CONTINUATION.
- INDIRECT DRAIN FROM WATER EQUIPMENT TO NEAREST DRAIN RECEPTACLE. CONTRACTOR TO VERIFY EXACT REQUIREMENTS WITH EQUIPMENT SUPPLIER. SEE DETAIL ON SHEET P501.
- ROUTE INDIRECT WASTE FROM THE DRAIN TRAY AND 1/2" INDIRECT CONDENSATE WASTE FORM THE COLD BREW NITRO SYSTEM TO FLOOR SINK, INSTALL PER MANUFACTURER'S RECOMMENDATION, COORDINATE INSTALLATION AND RESPONSIBILITY WITH GENERAL CONTRACTOR AND STARBUCKS NITROGENATION VENDOR.
- PS19 3" WASTE FROM EXISTING FLOOR DRAIN PROVIDED BY LANDLORD FOR WATER SERVICE BACKFLOW PREVENTER AS REQUIRED BY CODE. FIELD VERIFY EXACT LOCATION AND REQUIREMENTS.



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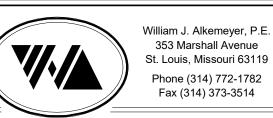
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**Engineering Consultant** 

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PRYOR, EIN DR. ST, PR, E'S BUILDOU COFFEE CHIPMAN


62012 87799-001

PROJECT #: 07-07-2020 K. GORIN SLONSKI ISSUE DATE: SR. DESIGN MANAGER: PRODUCTION DESIGNER: A. HAHN CHECKED BY: SMD / SWE

STORE #:

SANITARY ISOMETRIC DIAGRAM SCALE: AS SHOWN

SHEET NUMBER:

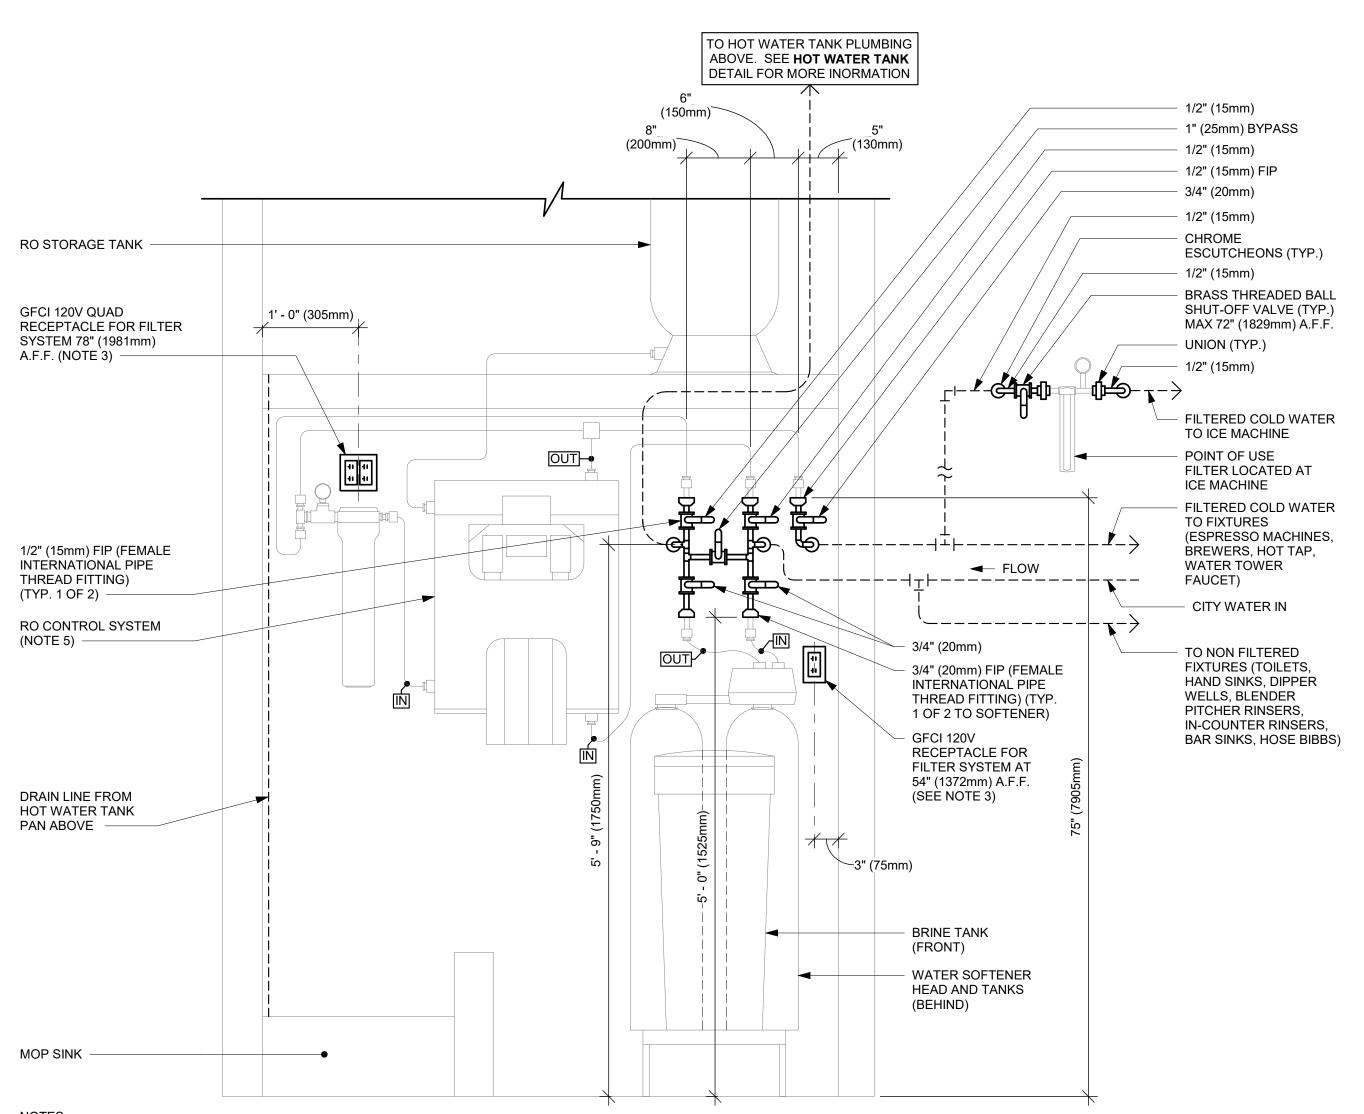


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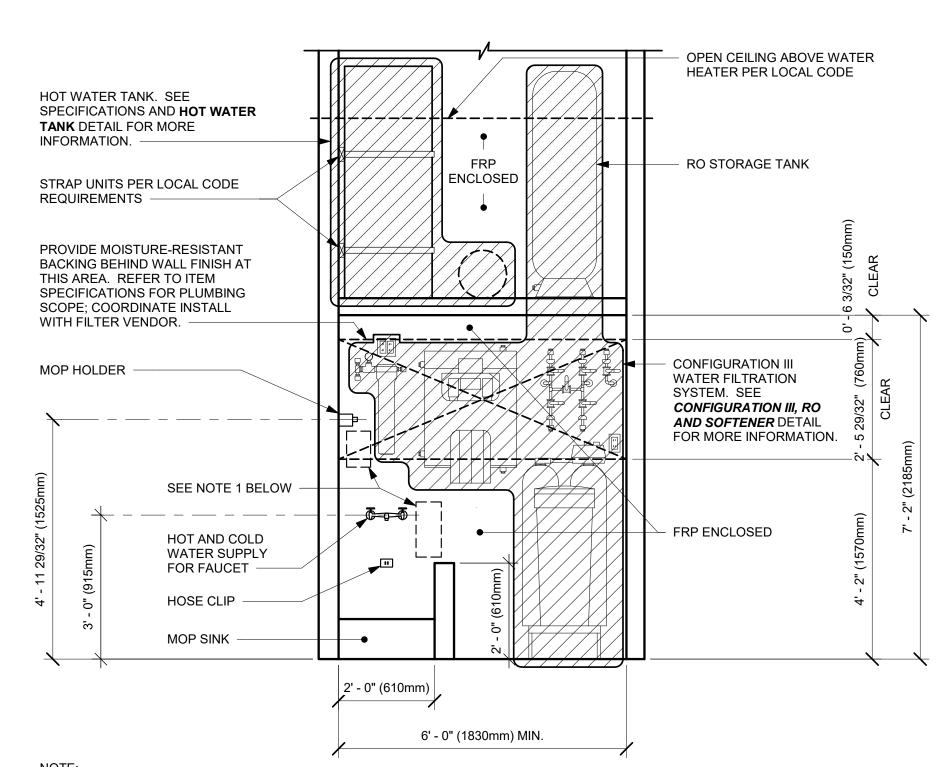
1. ALL COMPONENTS DRAWN IN BOLD ARE GC RESPONSIBILITY. GC TO COORDINATE INSTALLATION OF ALL OTHER COMPONENTS SHOWN WITH FILTER VENDOR.

- 2. ALL PIPING SHALL BE COPPER EXCEPT PEX TYPE PIPING WHICH IS ACCEPTABLE BETWEEN FILTER SYSTEM COMPONENTS AND ADVANSYS DISHWASHER WHERE ALLOWED BY CODE
- COORDINATE WITH ELECTRICAL CONTRACTOR FOR RECEPTACLES.
- PROVIDE WATER SOFTENER INDIRECT DRAIN TO SINK, INSTALLED PER CODE. (CONFIRM REQUIREMENTS WITH SOFTENER EQUIPMENT CUTSHEETS IN ITEM SPECIFICATIONS).
- 5. IN MUNICIPALITIES WITH BRINE RESTRICTIONS, REFER TO THE WATER SYSTEM CONFIGURATIONS APPENDIX UNDER ITEM SPECIFICATIONS FOR WATER SOFTENER EXCHANGE TANK SCHEMATIC. 6. COMPONENTS ARE TO BE POSITIONED TO MAXIMIZE ACCESS FOR REGULAR SERVICING. PRE-FILTER, BYPASS VALVES, AND SOFTENER TANKS MUST BE INSTALLED 72" (1828MM) AFF OR LOWER.

#### CONFIGURATION III, RO AND SOFTENER WATER FILTRATION

SCALE: NTS



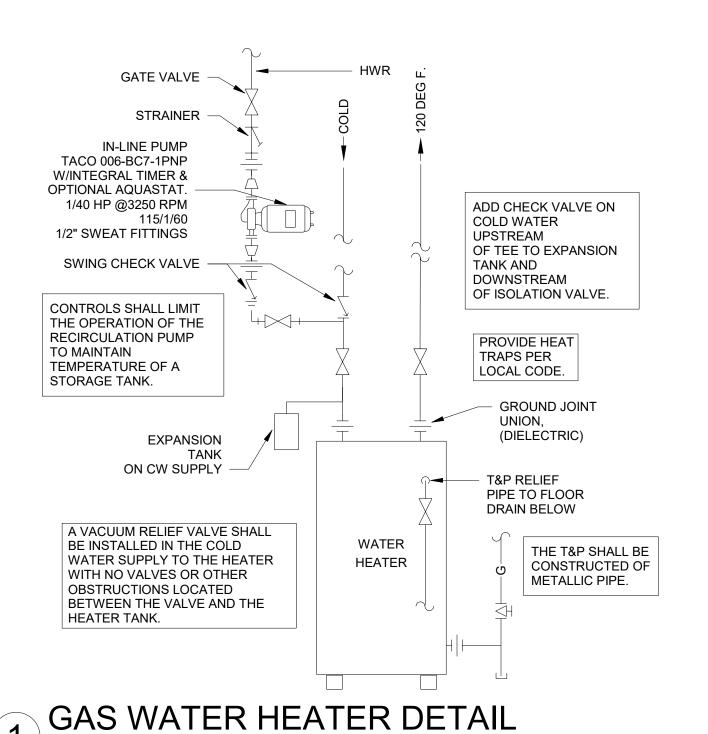

1. KEEP CLEAR AT BACKWALL FOR CHEMICAL DISPENSING SYSTEM COMPONENTS, TO BE INSTALLED BY SYSTEM VENDOR. REFER TO POSTED INSTALLATION GUIDELINES FOR MORE INFORMATION.





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Phone (314) 772-1782 Fax (314) 373-3514

**Engineering Consultant** 

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**⊘** ∞ ARBUCK YOR RD SUMMIT F R S S L BUIL COFF

STORE #: 62012 87799-001 PROJECT #: K. GORIN SLONSKI


**ISSUE DATE** SR. DESIGN MANAGER: PRODUCTION DESIGNER: A. HAHN CHECKED BY: SMD / SWE

**Revision Schedule** 

Rev	Date	Ву	Description

PLUMBING DETAILS

SCALE: AS SHOWN SHEET NUMBER:

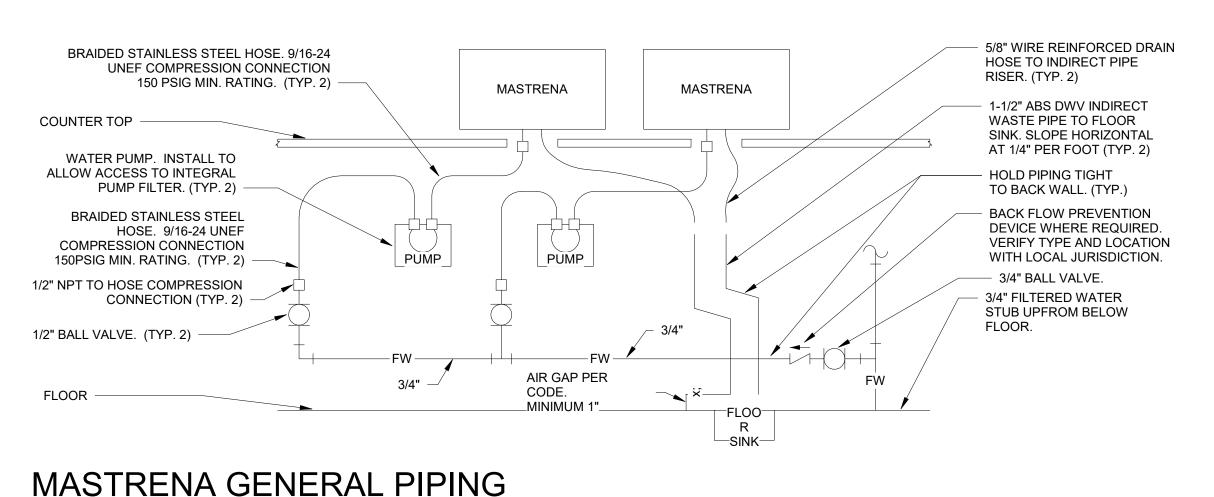

CONNECTION SCHEMATIC

SCALE: NTS

#### **DETAIL NOTES**

1. THIS DETAIL IS SCHEMATIC ONLY. FOR THE LOCATION OF THE COMPONENTS SHOWN. EXTENT OF THE WORK REQUIRED, SEE THE

2. ALL WATER HOSE SHALL BE THE MINIMUM LENGTH NEEDED AND SUPPORTED AS REQUIRED TO AVOID STRESSING CONNECTIONS AND COILING EXCESSIVE

PLAN DRAWINGS.


ROUTE TO AVOID KINKING AND ALLOW SPACE FOR UNDER COUNTER REFRIGERATOR AND ACCESS TO EQUIPMENT AND VALVES.

3. ALL PIPING SHALL BE HELD TIGHT TO


SLOPED WHERE REQUIRED AND ROUTED TO FLOW ACCESS TO EQUIPMENT AND VALVES.

4. ROUTE HORIZONTAL PIPING A MINIMUM OF 6" ABOVE FLOOR.

5. INSTALL PUMP AS SHOWN ON PLANS. COORDINATE LOCATION AND ELEVATION WITH OTHER TRADES. ORIENT PUMP AS REQUIRED TO ALLOW MAINTENANCE.

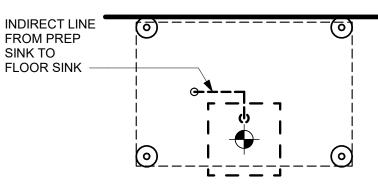


#### **AT FLOOR LEVEL**

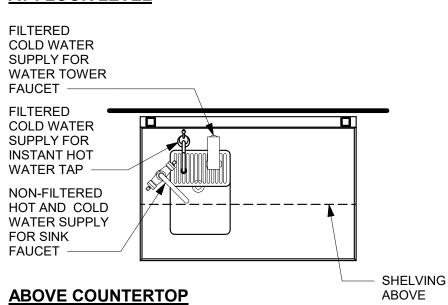



WATER FILLING STATION

3/4" = 1'-0"

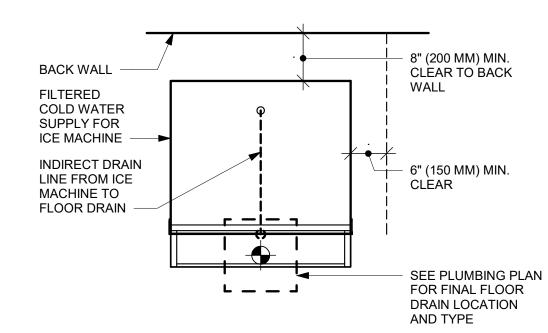


3 ICE MACHINE
3/4" = 1'-0"

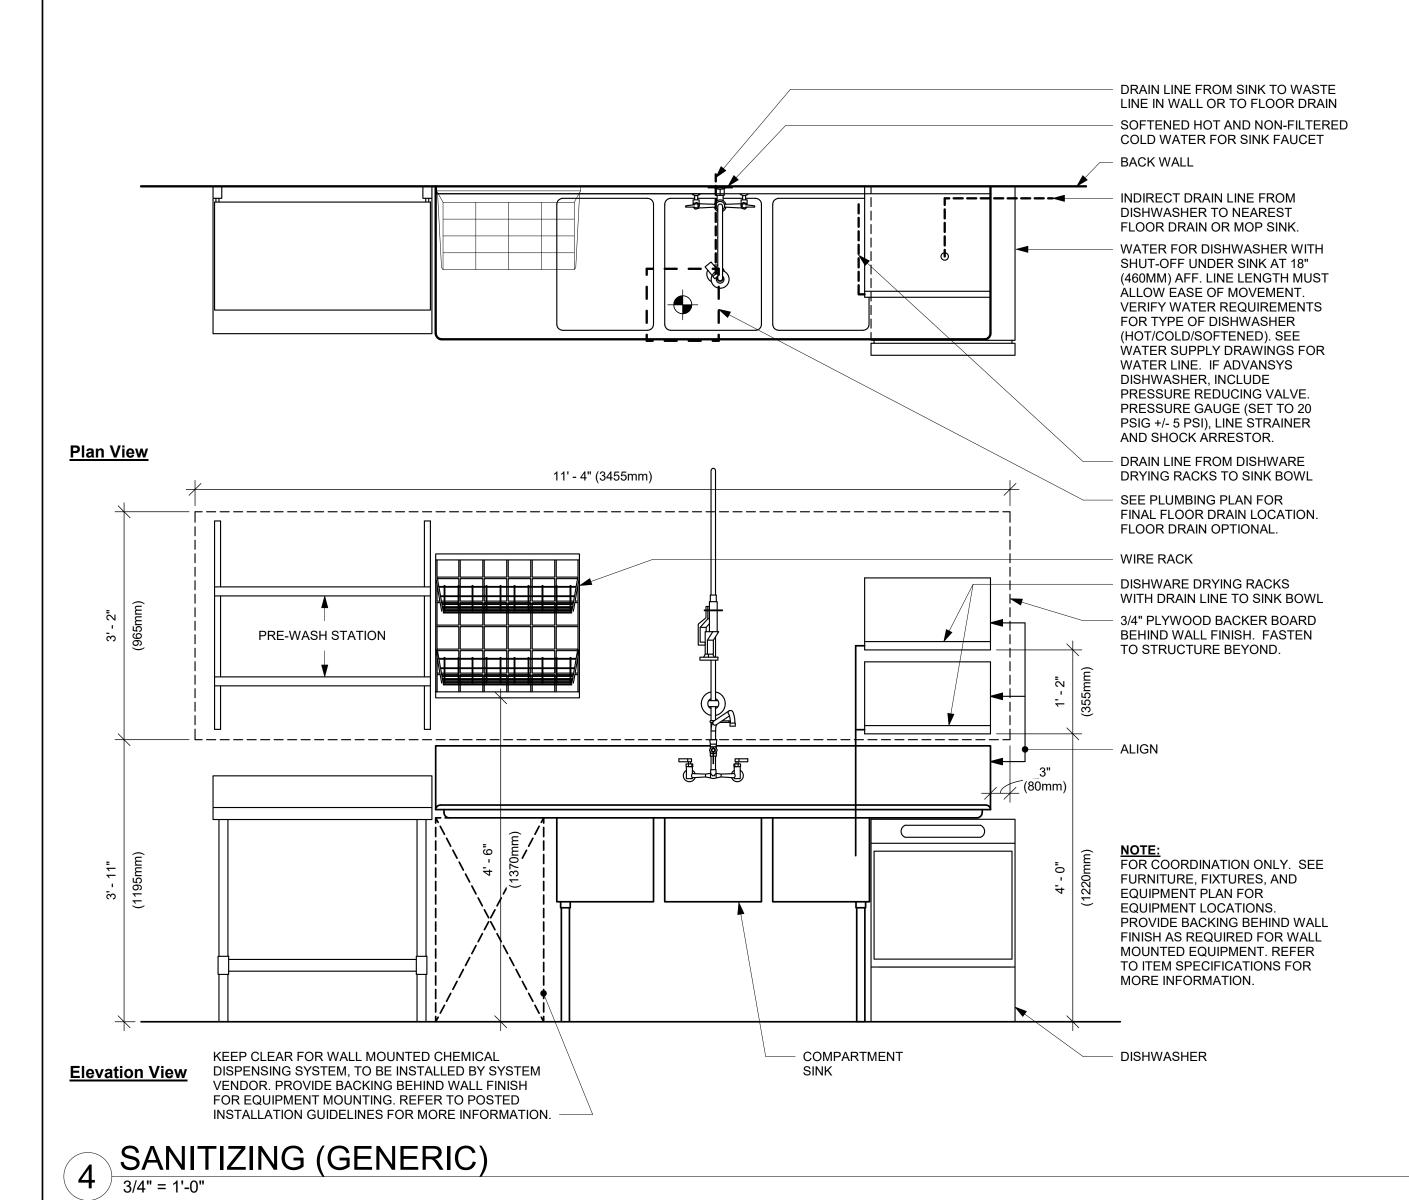


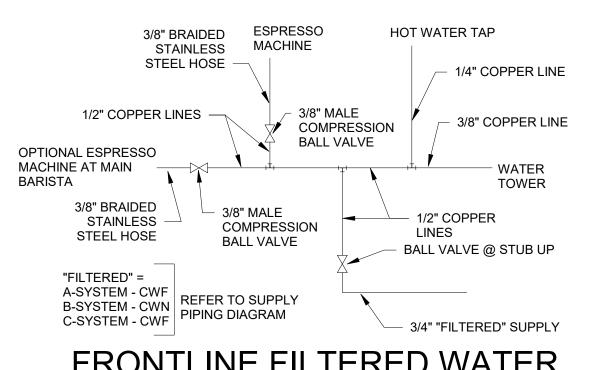


FRONTLINE FILTERED WATER MANIFOLD SCHEMATIC

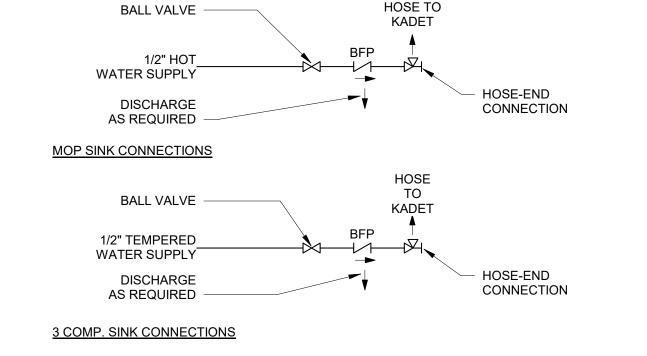

CHEMICAL SANITIZER CONNECTION SCHEMATICS

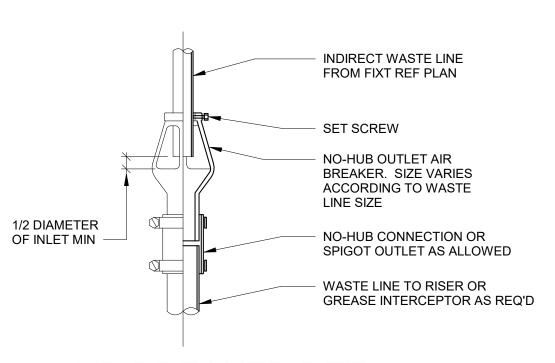



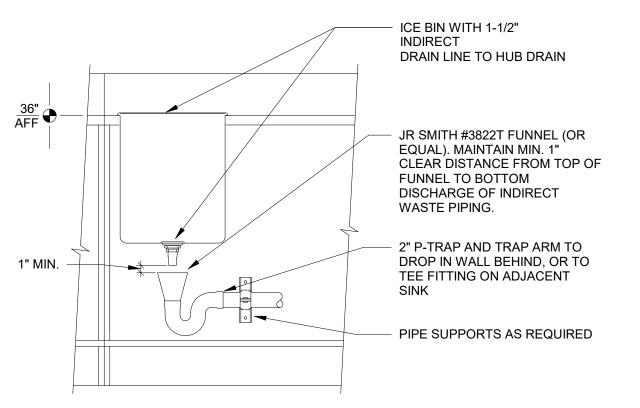

ICE BIN HUB DRAIN DETAIL




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07-07-2020

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		Rev	vision Sc	hedule
Rev	Date	Ву		Description
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PLUMBING DETAILS


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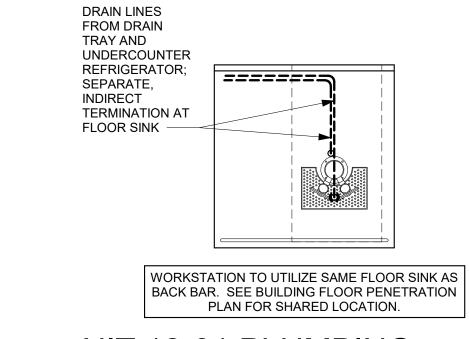
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STORE #:

ISSUE DATE


PROJECT #:

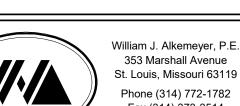




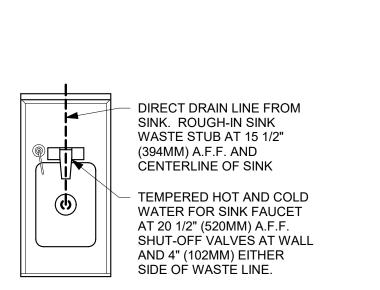




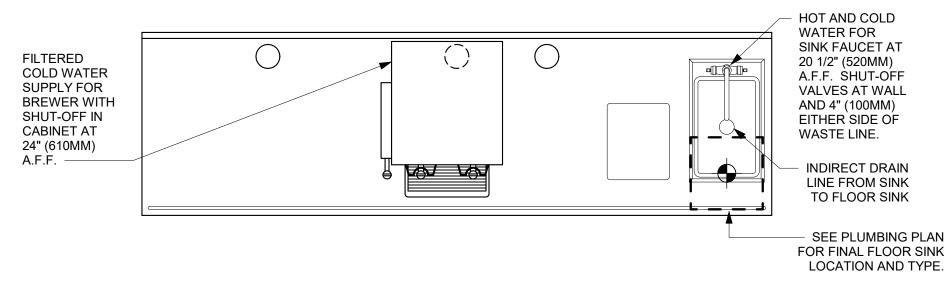



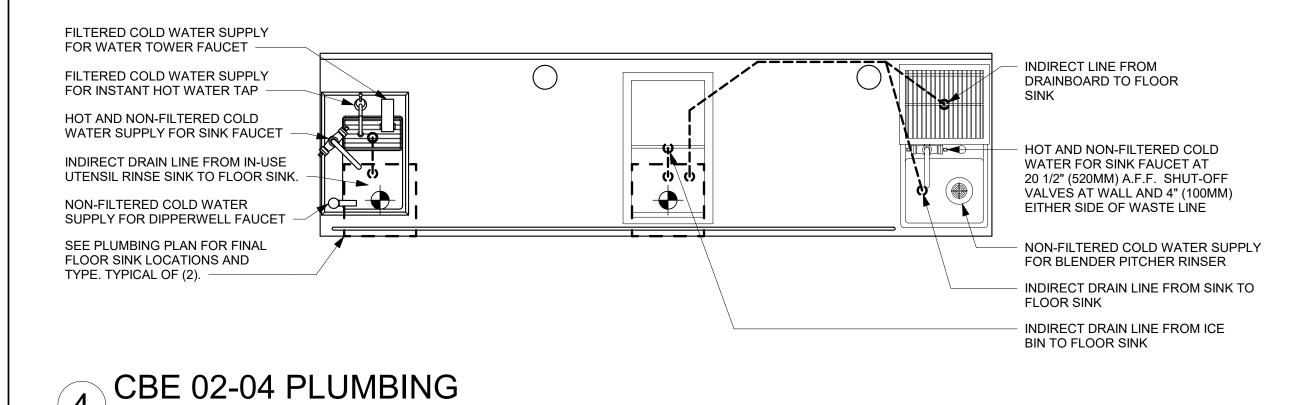

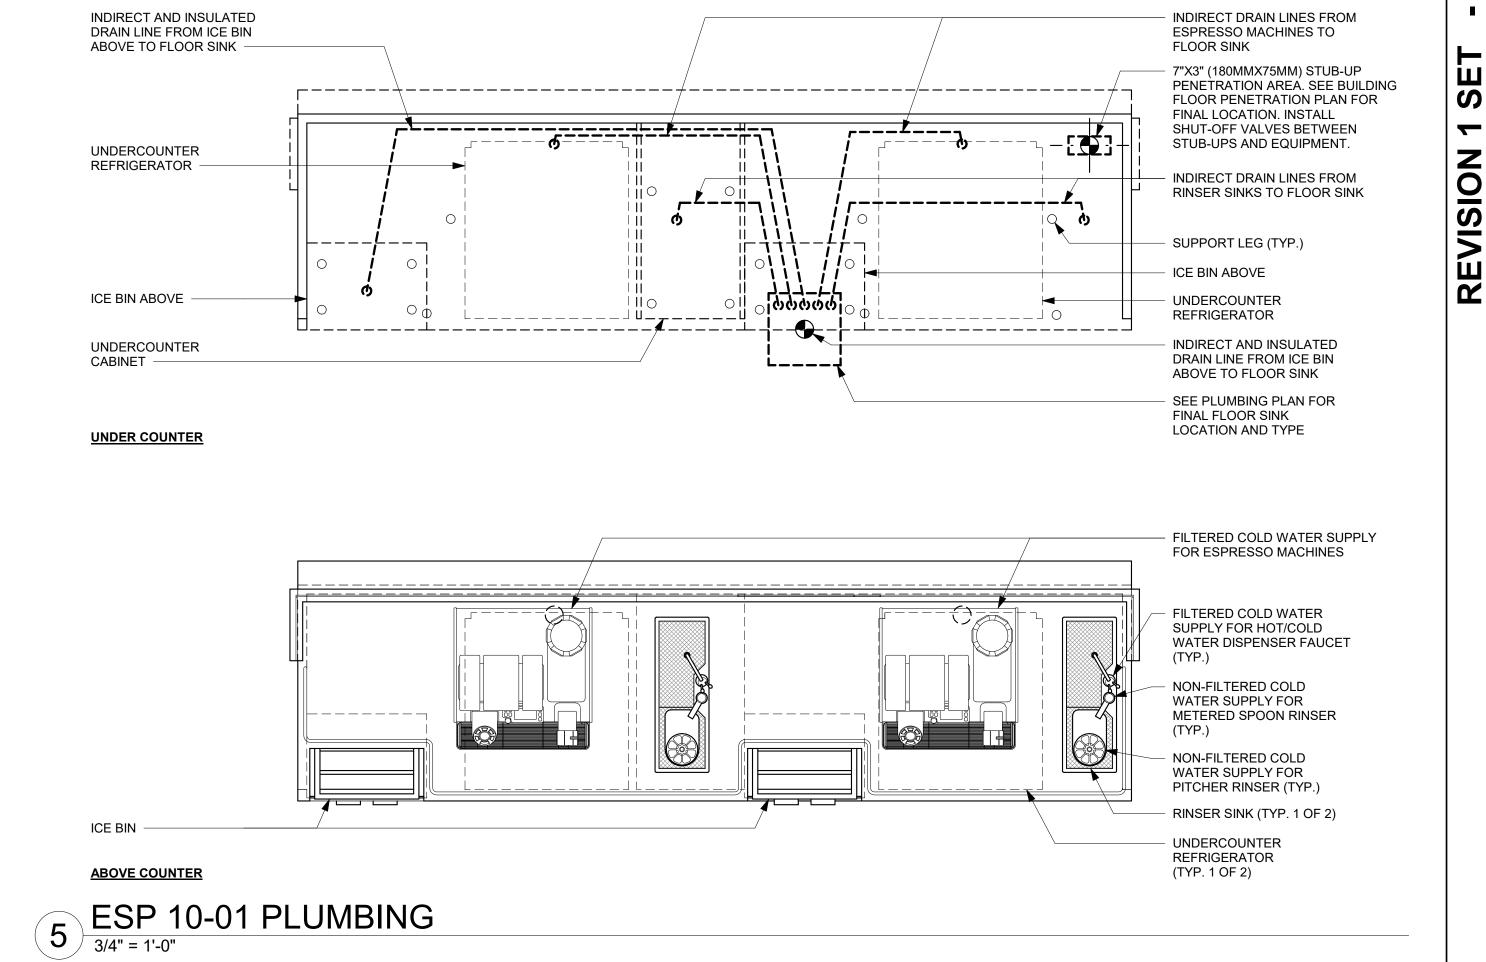




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**⊘** ∞ TARBUCK YOR RD SUMMIT F K S S P

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YOR, DR.

STORE #: 62012 87799-001 PROJECT #: ISSUE DATE: 07-07-2020 SR. DESIGN MANAGER: K. GORIN SLONSKI

PRODUCTION DESIGNER: A. HAHN CHECKED BY: SMD / SWE

> **Revision Schedule** Description

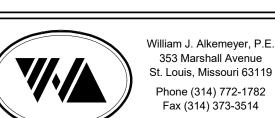PLUMBING DETAILS

SCALE: AS SHOWN

SHEET NUMBER:

		PLUMBING FIXTUR	L GOHLDOL	•	
DESIGN ID	COUNT	DESCRIPTION	FURN. BY	INST. BY	COMMENTS
DRAIN					
10294	7	DRAIN - FLOOR SINK SQUARE - 12IN 305MM	SB	GC	ZURN MODEL #FD2375-NH3.
10594	4	DRAIN - FLOOR SINK SQUARE - 5IN 125MM	GC	GC	JAY R. SMITH MODEL #2005Y (B) OR EQUAL
10726	7	DRAIN - GRATE HALF SQUARE - 12IN 305MM	SB	GC	ZURN MODEL #FD2375-NH2.
AUCET					
10152	1	FAUCET - DOUBLE LABORATORY WITH BENT	SB	GC	
10102		RISER SPOUT			
10153	2	FAUCET - WATER TOWER - 12IN 305MM	SB	GC	
10215	3	FAUCET - DOUBLE LABORATORY WITH SWING	SB	GC	
10210	Ü	SPOUT			
10447	1	FAUCET - PRE RINSE SPRAYER WALL MOUNTED	SB	GC	
10597	2	FAUCET - SINGLE HANDLE	SB	GC	
10804	1	FAUCET - PRE RINSE SWING SPOUT	SB	GC	
10874	2	FAUCET - HOT WATER DISPENSER GOOSENECK	SB	GC	
10922	1	FAUCET - MOP SINK WALL MOUNTED	SB	GC	
11003	3	FAUCET - METERED	SB	GC	
13588	1	FAUCET - HAND SINK WALL MOUNTED	SB	GC	
15749	2	FAUCET - HOT AND COLD WATER SYSTEM	SB	GC	
X0010	2	FAUCET - STERN	GC	GC	STERN. CONDOR 1010. PART #07100005. CHROME. PART OF D 13 INTEGRATED SINK SYSTEM. CONTACT: D 13 GROUP. 245 WEST CENTRAL STREET, NATICK, MA 01760. PH: 617-307-1140. WWW.D13GROUP.COM
FILTER					
12501	1	FILTER - RO SYSTEM 600GPD	SB	SB	CONFIGURATION [III]. GC TO COORDINATE WITH SBUX VENDOR.
12507	1	FILTER - RO SYSTEM 40GAL STORAGE TANK	SB	SB	CONFIGURATION [III]. GC TO COORDINATE WITH SBUX VENDOR.
12896	1	FILTER - BRINE TANK	SB	SB	CONFIGURATION [III]. GC TO COORDINATE WITH SBUX VENDOR.
12899	2	FILTER - POLY GLASS VESSEL	SB	SB	CONFIGURATION [III]. GC TO COORDINATE WITH SBUX VENDOR.
13076	1	FILTER - PREFILTRATION SYSTEM	SB	SB	CONFIGURATION [III]. GC TO COORDINATE WITH SBUX VENDOR.
13082	1	FILTER - WATER SOFTENER TWIN	SB	SB	CONFIGURATION [III]. GC TO COORDINATE WITH SBUX VENDOR.
13149	1	FILTER - PRESSURE GAUGE	SB	SB	CONFIGURATION [III]. GC TO COORDINATE WITH SBUX VENDOR.
OTHER					
13384	1	WATER HEATER TANK GAS	GC	GC	AO SMITH CYCLONE Xi MODEL #BTX-100, 129 GPH RECOVERY @90 DEGREE RISE. SET WATER HEATER TO 140 DEG MAX. ENERGY FACTOR = 0.96
SINK					
10549	1	SINK - RINSE DROP IN SST - 12X20IN 305X510MM	SB	GC	
10995	1	SINK - MOP - 24X24IN 610X610MM	SB	GC	
12807	1	SINK - UTENSIL RINSE WITH GRATE SST - LH - 14X20IN 355X510MM	SB	GC	
13264	1	SINK - 3 COMP WORK SST - 93IN 2350MM	SB	GC	
14688	1	SINK - HAND WITH SIDE SPLASH WALL MOUNTED SST	SB	GC	
17565	1	SINK - RINSE WITH DRAINBOARD - 15X27IN 380X685MM	SB	GC	
17632	1	SINK - STACKED DRAINBOARD - 15IN 380MM	SB	GC	
18743	1	SINK - WATER FILLING STATION - 36X24IN 915X610MM	SB	GC	
19277	2	SINK - COUNTERTOP RINSER WITH DRAIN TROUGH - 26X9IN 660X235MM	SB	GC	
X0012	2	SINK - D13	GC	GC	D 13 INTEGRATED SINK SYSTEM. 30IN XLERATORSYNC SYSTEM WITH A SINGLE BASIN SINK WITH A PIVOT DRAIN COVER. GLACIER WHITE CORIAN COUNTER TOP AND ENCLOSURE PANELS. BASIN COLOR: D 13 WHITE. ORDER WITH LOCKING SLIDING DOOR & SECURITY PANEL. CONTACT: D 13 GROUP.
					245 WEST CENTRAL STREET, NATICK, MA 01760. PH: 617-307-1140. WWW.D13GROUP.COM
					01760. PH: 617-307-1140. WWW.D13GROUP.COM
TOILET 12951 13040	2 2	TOILET - TANKLESS EFFICIENT SINGLE FLUSH TOILET - FLUSH VALVE AUTOMATIC EFFICIENT	GC GC	GC GC	

		SPECIALTY EQUIPME	NT SCHEDU	LE - "E"	
DESIGN ID	COUNT	DESCRIPTION	FURN. BY	INST. BY	COMMENTS
10267	5	FRIDGE UNDERCOUNTER 1 DOOR - 27IN	SB	GC	
10970	1	685MM FRIDGE REACH IN 1 DOOR LH - 29IN 735MM	SB	GC	
11083	2	FRIDGE REACH IN 2 DOOR - 51X35IN	SB	GC	
12618	2	1295X890MM FRIDGE UNDERCOUNTER 1 DOOR WITH	SB	GC	
40070		SHELF - 27IN 685MM	CD	00	
13676 13682	1 1	FREEZER REACH IN 1 DOOR RH - 27IN 685MM FREEZER REACH IN 2 DOOR - 54IN 1370MM	SB SB	GC GC	
20011	1	FRIDGE NITRO 2 TAP JT NITCOM RH	SB	GC	KIT INCLUDES UNDERCOUNTER FRIDGE.
					FONT, TRAY, AND TUBING
QUIPMENT		1	T = =	T	
10312	4	BREWER SOFT HEAT WARMING STAND SINGLE	SB	GC	
10746	1	BREWER DUAL SOFT HEAT	SB	GC	GC TO COORDINATE WITH SBUX VENDOR
10808	1	GRINDER DITTING KR1203	SB	GC	GC TO COORDINATE WITH SBUX VENDOR
10856	6	BREWER SERVER SOFT HEAT	SB	GC	
12407	2	OVEN TURBOCHEF NEXT GENERATION	SB	GC	
12508	2	BLENDER QUIET MODEL ON COUNTER	SB	GC	
12508	1	BLENDER QUIET MODEL ON COUNTER -	SB	GC	TO BE STORED IN BACK OF HOUSE UNLESS NEEDED
15186	1	BACK-UP DISHWASHER HOT LOW STEAM	SB	GC	OINLESS INEEDED
16623	1	SCALE DIGITAL WITH ADJUSTABLE DISPLAY	SB	GC	
.0020	1	MOUNT SMALL			
17564	1	BLENDER PITCHER RINSER WITH SENSOR	SB	GC	
19559	1	NITROGEN GENERATOR ELEMENT	SB	GC	GC TO COORDINATE INSTALLATION &
					CONNECTIONS WITH SBUX VENDOR
19742	2	ESPRESSO MACHINE MASTRENA II	SB	GC	GC TO COORDINATE WITH SBUX VENDOR
OOD CASE		EOOD CASE ZEDIND CON 4075444	CD.	00	I
16238   CE	1	FOOD CASE - ZEPHYR - 66IN 1675MM	SB	GC	
10344	1	ICE - BIN DROP IN 90LB 40KG	SB	GC	
18029	1	ICE - BIN B110	SB	GC	
18846	1	ICE - MACHINE CIM1446HR SERIES REMOTE	SB	GC	
		COOLED			
19278	2	ICE - BIN DROP IN 45LB 20KG HORIZONTAL	SB	GC	
THER					
10091	1	CUP DISPENSER TALL HOT VERTICAL	SB	GC	
10099	2	RESTROOM TOILET PAPER HOLDER	SB	GC	
10172	2	RESTROOM SEAT COVER DISPENSER	SB	GC	
10384 10396	2 1	DIAPER CHANGING STATION HORIZONTAL  CUP DISPENSER SHORT HOT VERTICAL	SB SB	GC GC	
10390	1	FILE CABINET 2 DRAWER	SB	GC	
10501	1	FIRE EXTINGUISHER	GC	GC	LOCALLY SOURCED
10769	2	RESTROOM GRAB BAR VERTICAL - 18IN 455MM	SB	GC	EGG, LET GGGHGES
10791	2	CUP DISPENSER GRANDE VENTI COLD	SB	GC	
10855	2	VERTICAL  CUP DISPENSER GRANDE VENTI HOT  VERTICAL	SB	GC	
10858	1	CUP DISPENSER TALL COLD VERTICAL	SB	GC	
10859	2	RESTROOM GRAB BAR - 48IN 1220MM	SB	GC	
10862	2	RESTROOM GRAB BAR - 36IN 915MM	SB	GC	
10947	1	SOAP DISPENSER WALL MOUNTED	SB	GC	
10977	1	PAPER TOWEL DISPENSER FULL SIZE -	SB	GC	
		TRANSLUCENT GRAY			
10992	2	PAPER TOWEL DISPENSER HALF SIZE -	SB	GC	
11145		TRANSLUCENT GRAY	CD.	00	
11115	<u>2</u> 1	SOAP DISPENSER SINK MOUNTED	SB SB	GC GC	
13330 13584	1 1	MOBILE CUP DISPENSER CADDY  CUP DISPENSER TRENTA COLD VERTICAL	SB	GC	
19495	1	NITRO 2 TAP HANDLE AND BADGE KIT	SB	GC	
20079	1	NITRO 2 TAP BADGE MOUNT BACKBAR LH	SB	GC	
20080	1	NITRO 2 TAP BADGE MOUNT BACKBAR RH	SB	GC	
X0009	2	HAND DRYER - INTEGRATED	GC	GC	XLERATOR SYNC HAND DYER. AUTOMAT SENSOR OPERATED. SURFACE MOUNTE CONTACT: D 13 GROUP. 245 WEST CENTRAL STREET, NATICK, MA 01760. PH 617-307-1140. WWW.D13GROUP.COM EMAIL: KRIZZO@D13GROUP.COM
X0011	2	SOAP DISPENSER - STERN	GC	GC	STERN. GREEN/CHROME SOAP DISPENSER. PART #07100008. PART OF D 13 INTEGRATED SINK SYSTEM. CONTACT: D 13 GROUP. 245 WEST CENTRAL STREET, NATICK, MA 01760. PH 617-307-1140. WWW.D13GROUP.COM
STORAGE					
10222	2	WIRE SHELF GRID AT SINK	SB	GC	
10416	9	WORKROOM SHELVING - 36IN 915MM	SB	GC	
10462	9	WORKROOM SHELVING POSTS	SB	GC	
10698	1	MOP RACK WITH 3 HOLDERS	SB	GC	
13834	1	BASE - 24X18IN 610X455MM	SB	GC GC	
15699 17255	<u>1</u> 1	PARTNER WORK CENTER PASTRY TRAY CART - 60IN 1525MM	SB SB	GC	
17255	1	ROLLING PASTRY TRAY THAW RACK -	SB	GC	
	•	20X26IN 510X660MM			
17639	1	WORKROOM CART - 24IN 610MM	SB	GC	
19476	2	5 COMP LOCKER - 12IN 305MM	SB	GC	

DESIGN ID	COUNT	DESCRIPTION	FURN. BY	INST. BY	COMMENTS
17573	2	CABINET - BACKBAR COUNTER SUPPORT PANEL - 3IN 75MM	SB	GC	
17574	3	CABINET - BACKBAR SINK OR ICE - 15IN 380MM	SB	GC	
17575	1	CABINET - BACKBAR SINK OR ICE - 20IN 510MM	SB	GC	
17580	2	CABINET - CBE TEA SHELF - 29IN 735MM - FLAT BLACK MT0028	SB	GC	NOT PROVIDED BY CASEWORK VENDOR
17581	1	CABINET - CBE DRY INCLUSION SHELF - 23IN 585MM - FLAT BLACK MT0028	SB	GC	NOT PROVIDED BY CASEWORK VENDOR
17740	2	CABINET - BACKBAR - 30IN 760MM	SB	GC	
17741	4	CABINET - BACKBAR 15IN 380MM	SB	GC	
17743	1	CABINET - DT POS - 30IN 760MM	SB	GC	
17744	1	CABINET - FRONTBAR POS BRIDGE - 22IN 560MM	SB	GC	
17745	1	CABINET - BACKBAR DRAWER - 15IN 380MM	SB	GC	
17747	1	CABINET - BACKBAR TRASH - 15IN 380MM	SB	GC	
18122 19280	2 1	CABINET - BACKBAR SINK OR ICE - 16IN 405MM CABINET - ESPRESSO CUBBY WITH OPEN BACK -	SB SB	GC GC	
19281	2	15IN 380MM  CABINET - ESPRESSO ICE BIN STAINLESS - 20IN	SB	GC	
04400	4	510MM	OD	00	
21189	1	CABINET - FRONTBAR - 15IN 380MM	SB	GC	
21191	1	CABINET - FRONTBAR DRAWER - 15IN 380MM	SB	GC	
21192	2	CABINET - FRONTBAR POS - 30IN 760MM	SB	GC	
21193	1	CABINET - ESPRESSO CUBBY WITH OPEN BACK - 18IN 455MM	SB	GC	CEE DETAIL C
X0016	1	CABINET - DT POS UPPER CUBBY W DOORS	SB	GC	SEE DETAILS CURVED DOOR
X0032	2	CABINET - BACKBAR COUNTER CUSTOM CABINET - 12IN 205MM	SB	GC	SEE DETAILS, CURVED DOOR
X0035 CAFE	1	CABINET - 12IN 305MM	SB	GC	SEE DETAILS
20131	1	CONDIMENT CART THREE DROP - WHITE OAK AND WHITE WD0073 CP0002	SB	GC	NOT PROVIDED BY CASEWORK VENDOR
20367	1	WALL BAY 2 UNIT - 72IN 1830MM - WHITE OAK WD0073	SB	GC	NOT PROVIDED BY CASEWORK VENDOR
COUNTERTO		COUNTEDTOD HAND ONLY WITH LOW OR AGU	100		I
17809	2	COUNTERTOP - HAND SINK WITH LOW SPLASH STAINLESS - 15IN 380MM	SB	GC	LENOTHE ACCUMENTS DETAILS
17828	1	COUNTERTOP - BACKSPLASH - VARIABLE LENGTH	SB	GC	LENGTH:5'-10 3/4". SEE DETAILS FOR ADDITIONAL INFORMATION
19711 20061	<u> </u>	COUNTERTOP - WARMING - RF - 75IN 1905MM COUNTERTOP - ESPRESSO METRO - RF - 139IN 3530MM	SB SB	GC GC	
20063	1	COUNTERTOP - FRONTBAR CAP - 139IN 3530MM	SB	GC	
X0006	1	COUNTERTOP - FRONTBAR MOP PLANAR - 30IN	SB	GC	SEE DETAILS
		760MM			
X0015	1	COUNTERTOP - AT DT	SB	GC	SEE DETAILS
X0017	1	COUNTERTOP - CBE - w/ MAGIC SINK- RF - 112IN 2845MM	SB	GC	SIMILAR TO 17577. PROVIDE OPENING FOR MAGIC SINK INSTEAD OF RINSE TRAY & WATEFILLER.
X0018	1	COUNTERTOP - POS	SB	GC	SEE DETAILS
X0019	1	COUNTERTOP - DT POS - LF - VARIABLE LENGTH	SB	GC	LENGTH: 6' - 7 153/256" SEE DETAILS FOR ADDITIONAL INFORMATION
X0020	1	COUNTERTOP - BREW WITH TRASH DROP - LF	SB	GC	SEE DETAILS
X0033 X0037	1	CORIAN SILL @ DT WINDOW COUNTERTOP - BACKBAR NITRO - RH	SB SB	GC GC	1" SILL, SEE DETAILS SIMILAR TO 20051, W/O
DIEWALL					BACKSPLASH & WATERFALL EDGE
20064	1	DIEWALL - ESPRESSO - 139IN 3530MM	SB	GC	
X0013	<u>'</u> 1	DIEWALL	SB	GC	SEE DETAILS
X0013 X0023	1	DIEWALL - POS	SB	GC	SEE DETAILS
	'			100	
)IHER	2	CORNER GUARD - 0.75IN 20MM - CLEAR PLASTIC	SB	GC	GC TO INSTALL FULL HEIGHT. PAINT INSIDE FACE TO MATCH ADJACENT WALL COLOR.
10218					
	2	CORBEL SUPPORT - 24IN 610MM	SB	GC	
10218	2 2	CORBEL SUPPORT - 24IN 610MM  ESPRESSO MACHINE PUMP MOUNT - 10X10IN 255X255MM	SB SB	GC GC	
10218 11142 11155 17829	2	ESPRESSO MACHINE PUMP MOUNT - 10X10IN 255X255MM FRENCH CLEAT - VARIABLE LENGTH	SB SB	GC GC	OVERALL LENGTH 3' - 2"
10218 11142 11155 17829 18145	2	ESPRESSO MACHINE PUMP MOUNT - 10X10IN 255X255MM FRENCH CLEAT - VARIABLE LENGTH COUNTERTOP SUPPORT LEG	SB SB SB	GC GC GC	OVERALL LENGTH 3' - 2"
10218 11142 11155 17829 18145 20066	2 1 4 1	ESPRESSO MACHINE PUMP MOUNT - 10X10IN 255X255MM FRENCH CLEAT - VARIABLE LENGTH COUNTERTOP SUPPORT LEG SHROUD - 139IN 3530MM	SB SB SB SB	GC GC GC	OVERALL LENGTH 3' - 2"
10218 11142 11155 17829 18145 20066 20067	2 1 4 1	ESPRESSO MACHINE PUMP MOUNT - 10X10IN 255X255MM FRENCH CLEAT - VARIABLE LENGTH COUNTERTOP SUPPORT LEG SHROUD - 139IN 3530MM SNEEZE GUARD - 139IN 3530MM	SB SB SB SB SB	GC GC GC GC	OVERALL LENGTH 3' - 2"
10218 11142 11155 17829 18145 20066	2 1 4 1	ESPRESSO MACHINE PUMP MOUNT - 10X10IN 255X255MM FRENCH CLEAT - VARIABLE LENGTH COUNTERTOP SUPPORT LEG SHROUD - 139IN 3530MM	SB SB SB SB	GC GC GC	1X1IN. WD0073 WOOD TRIM. SEE WALL TREATMENT LENGTH
10218 11142 11155 17829 18145 20066 20067 20633 X0026	1 4 1 1 2	ESPRESSO MACHINE PUMP MOUNT - 10X10IN 255X255MM  FRENCH CLEAT - VARIABLE LENGTH  COUNTERTOP SUPPORT LEG  SHROUD - 139IN 3530MM  SNEEZE GUARD - 139IN 3530MM  COUNTERTOP SUPPORT LEG SLIM	SB SB SB SB SB SB SB	GC GC GC GC GC	1X1IN. WD0073 WOOD TRIM. SEE
10218 11142 11155 17829 18145 20066 20067 20633 X0026	1 4 1 1 2	ESPRESSO MACHINE PUMP MOUNT - 10X10IN 255X255MM  FRENCH CLEAT - VARIABLE LENGTH  COUNTERTOP SUPPORT LEG  SHROUD - 139IN 3530MM  SNEEZE GUARD - 139IN 3530MM  COUNTERTOP SUPPORT LEG SLIM	SB SB SB SB SB SB SB	GC GC GC GC GC	1X1IN. WD0073 WOOD TRIM. SEE WALL TREATMENT LENGTH
10218 11142 11155 17829 18145 20066 20067 20633 X0026	1 4 1 1 2 1	ESPRESSO MACHINE PUMP MOUNT - 10X10IN 255X255MM  FRENCH CLEAT - VARIABLE LENGTH COUNTERTOP SUPPORT LEG SHROUD - 139IN 3530MM SNEEZE GUARD - 139IN 3530MM COUNTERTOP SUPPORT LEG SLIM WOOD TRIM - WD0073	SB SB SB SB SB SB SB SB	GC GC GC GC GC GC	1X1IN. WD0073 WOOD TRIM. SEE WALL TREATMENT LENGTH
11142 11155 17829 18145 20066 20067 20633 X0026	1 4 1 1 2 1	ESPRESSO MACHINE PUMP MOUNT - 10X10IN 255X255MM  FRENCH CLEAT - VARIABLE LENGTH  COUNTERTOP SUPPORT LEG  SHROUD - 139IN 3530MM  SNEEZE GUARD - 139IN 3530MM  COUNTERTOP SUPPORT LEG SLIM  WOOD TRIM - WD0073  PANEL - 139IN 3530MM	SB SB SB SB SB SB SB SB SB	GC GC GC GC GC GC	1X1IN. WD0073 WOOD TRIM. SEE WALL TREATMENT LENGTH SCHEDULE.

RES	PONSIBILITY LEGEND
GC	GENERAL CONTRACTOR
LL	LANDLORD
SB	STARBUCKS




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STARBUCKS TEMPLATE VERSION i2020-01-31





Phone (314) 772-1782 Fax (314) 373-3514

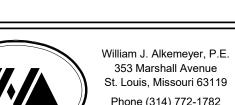**Engineering Consultant** 

2020


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REVISION

120-20



T OF STARBUCKS - NW PRYOR RD & I - LEE'S SUMMIT LOT BUILDOUT (COFFEE - NCHIPMAN -

STORE #: 62012 PROJECT #: 87799-001

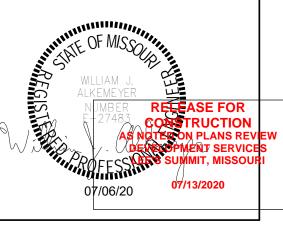ISSUE DATE: 07-07-2020
SR. DESIGN MANAGER: K. GORIN SLONSKI
PRODUCTION DESIGNER: A. HAHN CHECKED BY: SMD / SWE

Revision	Schedule

Rev	Date	Ву	Description

PLUMBING SCHEDULES

SCALE: AS SHOWN SHEET NUMBER: