ABBREVIATIONS

AIR CONDITIONING ACOUSTICAL CEILING TILE ADJ ADJUSTABLE ABOVE FINISHED FLOOR AMP AMPERE

BOH BACK OF HOUSE

ARCH ARCHITECT

CABINET CL CENTER LINE CEILING STARBUCKS CM

CONSTRUCTION MANAGER CENTER CX COMMISSIONING

CXA COMMISSIONING AGENT DEG DEGREE DET DETAIL

DIA DIAMETER DIM DIMENSION DM **STARBUCKS DESIGN MANAGER** DOWN

EΑ EACH **ELEVATION** EL EQ EQUAL EXIST EXISTING EXT EXTERIOR

FF&E FURNITURE, FIXTURE, AND EQUIPMENT FLR FLOOR

FOH FRONT OF HOUSE FOIC FURNISHED BY OWNER, **INSTALLED BY CONTRACTOR** FOIO FURNISHED BY OWNER **INSTALLED BY OWNER**

FOOT/FEET GROUND GENERAL CONTRACTOR

GWB GYPSUM WALLBOARD HOLLOW CORE HDW HARDWARE HOLLOW METAL HORIZ HORIZONTAL HR HOUR HT HEIGH

HEIGHT HVAC HEATING, VENTILATING AND AIR CONDITIONING

I.D. INSIDE DIAMETER

LEED LEADERSHIP IN ENERGY AND ENVIRONMENTAL DESIGN

LANDLORD LOW VOLTAGE

MAXIMUM "MECHANICAL, ELECTRICAL AND PLUMBING"

MFR MANUFACTURER MINIMUM NOT IN CONTRACT NIGHT LIGHT

OC ON CENTER

NTS NOT TO SCALE

PLC PLACE

RADIUS REF REFERENCE REQ'D REQUIRED REV REVISION RND ROUND

STARBUCKS SC SOLID CORE SQUARE FEET SHT SHEET SIM SIMILAR

SPEC SPECIFICATION SQ SQUARE TEMP TEMPORARY

TYP TYPICAL

UNDER COUNTER UNO UNLESS NOTED OTHERWISE


VIF VERIFY IN FIELD

RESPONSIBILITY LEGEND

GC GENERAL CONTRACTOR LL LANDLORD

SB STARBUCKS

ARCHITECTURAL SYMBOL LEGEND

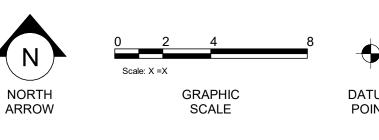

DETAIL

CALL-OUT

PXXX-ES

PAINT

TAG

(xx)


SHEET

NOTE

CALLOUT

XXXXX

DESIGN ID

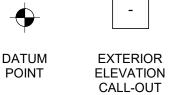

XXXX AFF


ABOVE FINISH

FLOOR

HEIGHT TAG

DOOR

TAG

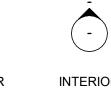





REVISION CLOUD

FINISH FACE TO FINISH FACE DIMENSION


DXXXXXXXX (WXXXXX) WINDOW TAG

AERIAL MAP


SECTION

CALL-OUT

REVISION

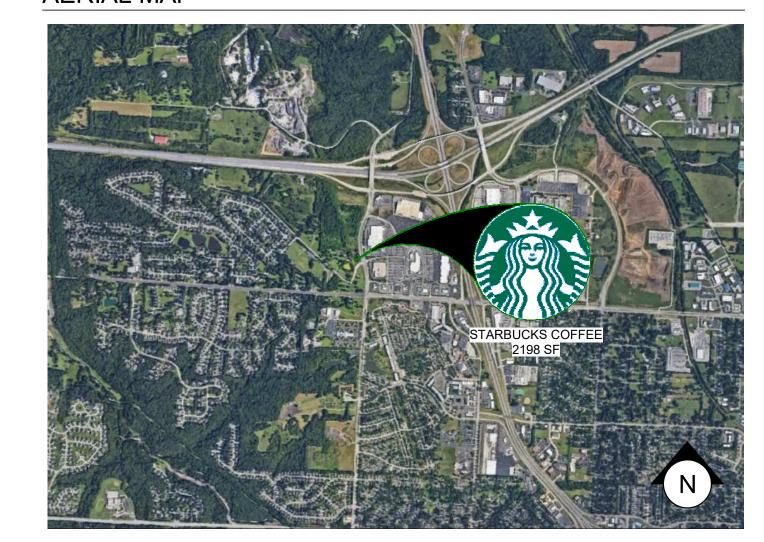

KEY SITE PLAN

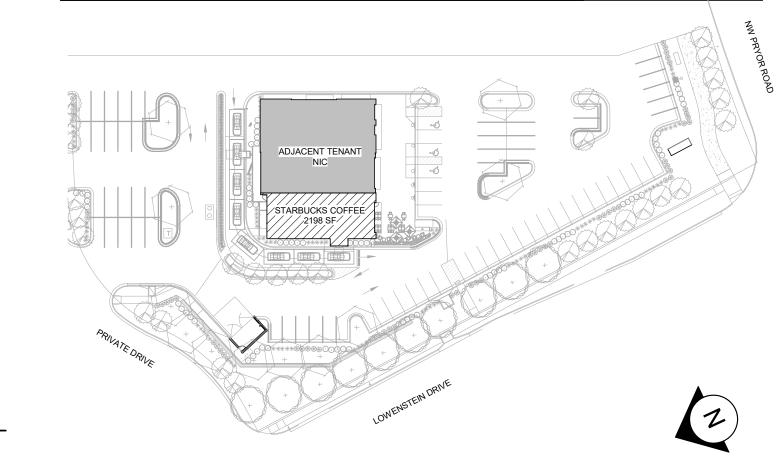

PROJECT CONTACTS

SENIOR DESIGN KATIE GORIN SLONSKI MANAGER: STARBUCKS COFFEE COMPANY 111 N CANAL ST, SUITE 450 CHICAGO, IL 60606 (312) 380-3688 PHONE KGORIN@STARBUCKS.COM

STORE DESIGNER: CHITRA PATEL STARBUCKS COFFEE COMPANY (312) 380-3731 PHONE CHPATEL@STARBUCKS.COM

CONSTRUCTION MATTISCH MANAGER: STARBUCKS COFFEE COMPANY (214) 674-3225 PHONE MISCH@STARBUCKS.COM

LANDLORD: IAN MUSSMAN DRAKE DEVELOPMENT, LLC 7200 W 132ND ST. SUITE 150 **OVERLAND PARK, KS 66213** (913) 662-2630 PHONE

ARCHITECT OF PETER DUBIN - NORR RECORD: 325 N. LASALLE STREET, SUITE 500 CHICAGO, IL 60654

(312) 424-2400 PHONE ÈDURNE.VEGA@NORR.COM ALISSA.HAHN@NORR.COM MEP CONSULTANT WILLIAM ALKEMEYER

OF RECORD: 353 MARSHALL AVENUE, SUITE 100

IAN@DRAKEKC.COM

ST. LOUIS, MO 63119 (314) 772-1782 PHONE (314) 772-0109 FAX BSWEENEY@ALKEMEYER.COM

SCOPE OF WORK

INTERIOR BUILDOUT OF A NEW STARBUCKS COFFEE DRIVE-THRU.

SITE INFORMATION

CODE AUTHORITIES:	CITY OF KANSAS CITY JACKSON COUNY HEALTH
BUILDING CODE:	2018 INTERNATIONAL BUILDING CODE
PLUMBING CODE:	2018 INTERNATIONAL PLUMBING CODE
MECHANICAL CODE:	2018 INTERNATIONAL MECHANICAL CODE
ELECTRICAL CODE:	2017 NATIONAL ELECTRICAL CODE
ENERGY CODE:	2018 INTERNATIONAL FUEL GAS CODE
FIRE CODE:	2018 INTERNATIONAL FIRE CODE
HEALTH CODE:	MISSOURI STATE FOOD CODE
ACCESSIBILITY CODE:	ICC/ANSI A117.1-2017, ACCESSIBLE AND USABLE BUILDINGS AND FACILITIES
ZONING:	

ZONE: PMXI - PLANNED MIX USED DISTRICT PROPOSED USE: RETAIL SALES AND SERVICES

DEFERRED SUBMITTALS: SIGNAGE & FIRE ALARM

BUILDING INFORMATION

OCCUPANCY TYPE: A-2 **BUILDING AREA:** 6,911 SF TENANT AREA: 2,198 SF FIRE SPRINKLER: NO **CONSTRUCTION TYPE:** V-B

GENERAL NOTES

- 1. THE DRAWINGS AND PROJECT MANUAL TOGETHER CONSTITUTE THE CONTRACT DOCUMENTS FOR CONSTRUCTION. ALL GENERAL REQUIREMENTS ARE TO BE MET AND ALL MATERIALS. FINISHES AND SYSTEMS ARE TO BE INSTALLED AND PERFORM PER SPECIFICATIONS UNLESS OTHERWISE NOTED.
- 2. GENERAL CONTRACTOR SHALL VISIT THE SITE, REVIEW THE BUILDING SHELL DRAWINGS AS SUBMITTED BY THE LANDLORD OR STARBUCKS AND BECOME THOROUGHLY FAMILIAR WITH THE SITE CONDITIONS PRIOR TO CONSTRUCTION.
- 3. GENERAL CONTRACTOR SHALL CONSULT WITH STARBUCKS CONSTRUCTION MANAGER TO RESOLVE ANY CHANGES, OMISSIONS OR PLAN DISCREPANCIES PRIOR TO CONSTRUCTION.
- 4. ALL WORK SHALL BE PERFORMED IN STRICT COMPLIANCE WITH LOCAL, COUNTY, STATE AND FEDERAL CODES AND ORDINANCES.
- 5. GENERAL CONTRACTOR SHALL VERIFY THE LOCATION OF ALL UTILITIES.
- 6. GENERAL CONTRACTOR TO VERIFY ALL DIMENSIONS, INCLUDING CLEARANCES REQUIRED BY OTHER TRADES AND NOTIFY STARBUCKS CONSTRUCTION MANAGER OF ANY DISCREPANCIES PRIOR TO PROCEEDING WITH THE WORK. ALL DIMENSIONS ARE TO THE FACE OF THE FINISHED SURFACE UNLESS NOTED OTHERWISE. ALL DIMENSIONS TO BE TAKEN FROM DESIGNATED DATUM POINT. DO NOT SCALE DRAWINGS.
- 7. GENERAL CONTRACTOR SHALL PATCH AND REPAIR ALL EXISTING WALLS, FLOORS, CEILINGS, OR OTHER SURFACES IDENTIFIED TO REMAIN THAT MAY BECOME DAMAGED DURING THE COURSE OF THE
- 8. THE GENERAL CONTRACTOR IS RESPONSIBLE FOR OBTAINING PERMITS FOR FIRE PROTECTION, PLUMBING, MECHANICAL, AND ELECTRICAL SYSTEMS PRIOR TO INSTALLATION OF SUCH SYSTEMS
- 9. GENERAL CONTRACTOR SHALL RETAIN ONE SET OF PERMIT PLANS ON-SITE TO DOCUMENT ALL CHANGES MADE DURING CONSTRUCTION. THE RECORD DRAWINGS SHALL BE ISSUED TO THE OWNER AT PROJECT CLOSE-OUT AS DESCRIBED IN THE GENERAL REQUIREMENTS OF THE PROJECT MANUAL.
- 10. GENERAL CONTRACTOR IS RESPONSIBLE FOR COORDINATING DELIVERY OF MATERIALS FROM STARBUCKS CONTRACTED THIRD PARTY LOGISTICS DISTRIBUTION SERVICES AND VENDOR DIRECT SHIPMENTS. SEE THE PROJECT MANUAL FOR ADDITIONAL INFORMATION.
- 11. RESPONSIBILITY FOR SUPPLY AND DELIVERY OF MATERIALS AND EQUIPMENT IS IDENTIFIED IN THE DRAWING SCHEDULE SHEETS UNDER THE COLUMN LABELED "RESPONSIBILITY".
- 12. FOR THE PURPOSE OF THE DOCUMENTS, TO "INSTALL", SHALL MEAN TO PROVIDE ALL FASTENERS, MISCELLANEOUS HARDWARE, BLOCKING, ELECTRICAL CONNECTIONS, PLUMBING CONNECTIONS AND OTHER ITEMS REQUIRED FOR A COMPLETE AND OPERATIONAL INSTALLATION, UNLESS OTHERWISE NOTED.

13. ALL ITEM SUBSTITUTIONS MUST BE APPROVED BY THE STARBUCKS

CONSTRUCTION MANAGER.

INDEX OF SHEETS

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G001	GENERAL INFORMATION	X	X	
G002	LIFE SAFETY ACCESSIBILITY PLAN	X	Х	
G003	FOOD SERVICE PLAN	X	Х	
G004	ADA DETAILS 2017	X	Х	
G005	3D VIEWS	X	Х	
G006	RENDERINGS	X	Х	

A001	ARCHITECTURAL SITE PLAN	X	X	
A002	ARCHITECTURAL SITE DETAILS	Х	Х	
A003	ARCHITECTURAL SITE DETAILS	Х	Х	
A004	ARCHITECTURAL SITE DETAILS	Х	Х	
A005	ARCHITECTURAL SITE DETAILS	X	Х	
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A101	BUILDING FLOOR PLAN	X	Х	
A102	BUILDING FLOOR PENETRATION PLAN	X	Х	
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A201	BUILDING EXTERIOR ELEVATIONS	X	Х	
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I101.1	LIMITED OPERATIONS FURNITURE LAYOUT	X	Х	
I102	CASEWORK PLAN	X	Х	
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1504	INTERIOR DETAILS	X	Х	
1505	INTERIOR DETAILS	X	Х	
I601	SCHEDULES	X	Х	
1602	SCHEDULES	X	Х	
1603	SCHEDULES	X	Х	

ELECTRICAL E001 ELECTRICAL NOTES | X | X | E002 ENERGY CALCULATIONS | X | X | E003 ELECTRICAL SITE PLAN | x | x | E101 POWER PLAN XX E102 LIGHTING PLAN E103 ENLARGED ELECTRICAL PLACEMENT PLAN | X | X | E104 DATA DEVICE PLAN | X | X | E501 ELECTRICAL DETAILS | X | X | E502 ELECTRICAL DETAILS XX E601 ELECTRICAL PANEL SCHEDULES XX

M001	MECHANICAL NOTES	X	X	
M101	MECHANICAL DESIGN PLAN	X	X	
M102	MECHANICAL ROOF PLAN	X	Х	
M501	MECHANICAL DETAILS	X	Х	
M502	EMS DETAILS	X	Х	

XX

PLUMBING

E602 SCHEDULES

P000	PLUMBING COORDINATION PLAN	X	Х		
P001	PLUMBING NOTES	X	Х		
P101	PLUMBING SUPPLY PLAN	X	Х		
P102	PLUMBING WASTE & VENT PLAN	X	Х		
P103	ENLARGED PLUMBING PLACEMENT PLAN	X	Х		
P104	SANITARY ISOMETRIC DIAGRAM	X	Х		
P501	PLUMBING DETAILS	X	Х		
P502	PLUMBING DETAILS	X	Х		
P503	PLUMBING DETAILS	X	Х		
P601	PLUMBING SCHEDULES	X	Х		

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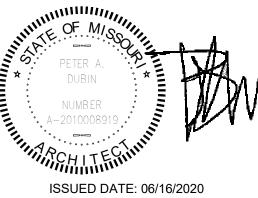




Alkemeyer

353 Marshall Avenue St. Louis, Missouri 63119 Phone (314) 772-1782 Fax (314) 373-3514

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EXPIRATION DATE: 12/31/2020

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FINAL

YOR, DR.

BUIL COFF 62012 PROJECT #: 87799-001 SR. DESIGN MANAGER: K. GORIN SLONSKI

NORR

Revision Schedule

PRODUCTION DESIGNER: A. HAHN

GENERAL INFORMATION

SCALE: AS SHOWN

G001

SHEET NUMBER:

OUTDOOR SEATING				
DESCRIPTION	NUMBER OF ITEMS	TOTAL SEATS		
TABLE TOP, ROUND	3	6		
TABLE TOP, SQUARE	8	16		
ADA TABLES	2	4		
	TOTAL ACCESSIBLE SEATS	2		
	TOTAL	26		

= 14.6 IN.
= 78 IN.
= 36 IN. PRIMARY ENTRY, 42 IN. SECONDARY ENTRY
= 2
= 2
= 200'-0"
= 85'-4"
= 75'-6" (MAXIMUM DIAGONAL) / 2 = 37'-9" IN.
= 71'-0"

URINALS

N/A

N/A

N/A

73 (INT. OCC.) + 26 (PATIO) = 99

1 F

1 F

WATER FOUNTAIN

N/A

N/A

N/A

LAVATORIES

1 PER 200

1 M

1 M

TOTAL

99 OCC

1 F

1 F

PLUMBING FIXTURE CALCULATION

FEMALE

50 OCC

WATERCLOSETS

1 PER 75

1 M

1 M

2018 INTERNATIONAL PLUMBING CODE

OCCUPANCY

FIXTURES

MALE

50 OCC

REQUIRED:

PROVIDED:

OCCUPANCY				
CAFE: 660 SF / 15	44 OCC			
STANDING: 45 SF / 5	9 OCC			
BAR: 395 SF / 200	2 OCC			
WORKROOM: 440 SF/ 300	2 OCC			
LINEAR SEATING: 300 IN / 18	16 OCC			
TOTAL OCC LOAD:	73 OCC			

LEGEND

<u> </u>	TRAVEL DISTANCE
	BARRIER FREE PATH OF TRAVEL (MIN 3'-0" - NO PINCH POINT)
29	EMERGENCY LIGHT

FIRE EXTINGUISHER

30" X 52" CLEAR AREA

ADA ACCESSIBLE SEATING

EXIT SIGN

EQUIVALENT. D. EQUIPMENT UNITS SHALL CONTAIN NO EXPOSED THREADS, EMBELLISHMENTS OR OVERHANGING EDGES THAT SERVE AS PLACES FOR ACCUMULATION OF DUST, DIRT AND DEBRIS

E. WARMING OVEN(S) SHOWN FOR PERMITTING PURPOSES. INSTALLATION AT STORE OPENING TO BE VERIFIED BY STARBUCKS CONSTRUCTION REPRESENTATIVE.

HEALTH DEPT. PLAN NOTES

REFRIGERATION CONTRACTOR TO CONDUCT INITIAL

FOOD CASE START-UP AND TESTING. FOR APPROVED

B. THE SPACE IS SERVED BY THE MUNICIPAL WATER AND

NATIONAL SANITATION FOUNDATION STANDARDS OR

SEWER SYSTEM UNLESS OTHERWISE NOTED.

C. ALL EQUIPMENT AND INSTALLATION WILL MEET

GENERAL CONTRACTOR TO SCHEDULE WITH

CONTRACTOR, CONTACT THE VENDOR.

F. EACH HAND WASHING WILL HAVE A SINGLE SERVICE TOWEL AND SOAP DISPENSER AND ALL HAND SINKS TO HAVE A COMBINATION FAUCET OR PREMIXING FAUCET.

G. REFERENCE INTERIOR SCHEDULE SHEETS (1600 SERIES) FOR ADDITIONAL INFORMATION.

H. PROVIDE SNEEZE GUARDS WHERE REQUIRED BY JURISDICTION.

ALL FOOD STORAGE AND DISPLAY SHELVING SHALL BE A MINIMUM 6" (150MM) ABOVE FINISH FLOOR.

KEYED NOTES

- 1. THRESHOLDS TO BE BARRIER FREE COMPLIANT PER ALL APPLICABLE CODES.
- 2. BARRIER-FREE PATH OF TRAVEL.
- 3. 30" X 52" CLEAR FOR WHEELCHAIR ACCESS.
- 4. 67" DIAMETER MINIMUM TURN RADIUS FOR WHEELCHAIR ACCESS.
- 5. 32" MINIMUM CLEAR AT RESTROOM DOOR.
- 6. POS TRANSACTION PLANE. CONDIMENT CART TOP AND HAND-OFF PLANE ARE 34 INCHES ABOVE THE FINISHED FLOOR FOR WHEELCHAIR ACCESSIBILITY.
- 7. PROVIDE BARRIER-FREE SIGNAGE AT ACCESSIBLE RESTROOMS PER ALL APPLICABLE CODES.
- 8. PROVIDE TACTILE "EXIT" SIGNAGE.
- 9. PROVIDE INTERNATIONAL SYMBOL OF ACCESSIBILITY SIGN WHERE REQUIRED BY APPLICABLE LAWS OR CODES.

HEALTH DEPT. FINISH SCHEDULE

<u>BAR</u> FLOOR: POLYVINYL FLOORING WALL TILE, BACKSPLASH, WITH POLYVINYL BASE WALL:

CEILING: PAINTED GYPSUM CEILING

TILE FLOORING WALL:

WALL TILE AND WOOD PANELING WITH COVED TILE BASE AND WALL COVERING WITH COVED BASE CEILING: TECTUM CEILING TILES AND PAINTED GYPSUM CEILING

FLOOR: POLYVINYL FLOORING FRP WITH POLYVINYL BASE CEILING: VINYL CEILING TILE

RESTROOM FLOOR: TILE FLOORING WALL TILE, COVED TILE BASE CEILING: GYPSUM CEILING, PAINTED

MEANS OF EGRESS NOTES

- A. EVERY ROOM OR SPACE THAT IS ASSEMBLY OCCUPANCY SHALL HAVE THE OCCUPANT LOAD OF THE ROOM OR SPACE POSTED IN A CONSPICUOUS PLACE, NEAR THE MAIN EXIT ACCESS DOORWAY. POSTED SIGNS SHALL BE OF AN APPROVED LEGIBLE PERMANENT DESIGN AND SHALL BE MAINTAINED BY THE OWNER AUTHORIZED AGENT. (1004.3)
- B. EGRESS SHALL NOT PASS THROUGH KITCHENS, STORAGE ROOMS, CLOSETS OR SIMILAR SPACES. (1014.2)
- C. PANIC AND FIRE EXIT HARDWARE, WHERE INSTALLED ON DOORS IN THIS BUILDING SHALL SATISFY THE FOLLOWING (1008.1.10):
- 1) THE ACTUATION PORTION OF THE RELEASING DEVICE SHALL EXTEND AT LEAST ONE-HALF OF THE DOOR LEAF WIDTH.
- 2) THE MAXIMUM UNLATCHING FORCE DOES NOT EXCEED 15
- POUNDS (6.8 KG). 3) PIVOTED OR BALANCED DOORS SHALL BE OF THE PUSH-PAD TYPE WHERE PANIC HARDWARE IS REQUIRED AND THE PAD

SHALL NOT EXTEND ACROSS MORE THAN ONE-HALF OF THE

- DOOR WIDTH, MEASURED FROM THE LATCH SIDE. 4) PANIC HARDWARE LISTED IN ACCORDANCE WITH UL 305.
- 5) FIRE EXIT HARDWARE LISTED IN ACCORDANCE WITH UL 10C AND UL 305.
- D. STRUCTURAL ELEMENTS, FIXTURES OR FURNISHINGS SHALL NOT PROJECT HORIZONTALLY FROM EITHER SIDE MORE THAN 4 INCHES (100 MM) OVER ANY WALKING SURFACE BETWEEN 27 INCHES (685 MM) AND 80 INCHES (2030 MM) ABOVE THE WALKING SURFACE. EXCEPTION: HANDRAILS SERVING STAIRS AND RAMPS ARE PERMITTED TO PROTRUDE 4 1/2 INCHES (115 MM) FROM THE WALL. (1003.3.3)
- THE PATH OF EGRESS TRAVEL EXITS AND WITHIN EXITS IN THIS BUILDING SHALL BE IDENTIFIED BY EXIT SIGNS CONFORMING TO THE REQUIREMENTS OF SECTION 1011 AND AS NOTED BELOW:
- 1) EXIT SIGNS SHALL BE READILY VISIBLE FROM ANY DIRECTION OF EGRESS TRAVEL.
- 2) EXIT SIGNS SHALL BE LOCATED AS NECESSARY TO CLEARLY INDICATE THE DIRECTION OF EGRESS TRAVEL.
- 3) NO POINT IN A CORRIDOR SHALL BE MORE THAN 100 FT (30.5 M) OR THE LISTED VIEWING DISTANCE FOR THE SIGN, WHICHEVER IS LESS, FROM THE NEAREST VISIBLE EXIT SIGN.
- F. WHERE KEY OPERATED LOCKING DEVICES ARE USED, POST A SIGN ON OR ADJACENT TO THE REQUIRED MAIN EXIT DOOR WITH 1 INCH (25 MM) LETTERING STATING THAT "THIS DOOR TO REMAIN UNLOCKED WHEN BUILDING IS OCCUPIED". (1008.1.9.3)
- G. EGRESS DOORS OR GATES SHALL BE OPENABLE FROM THE EGRESS SIDE WITHOUT THE USE OF A KEY, SPECIAL KNOWLEDGE OPERATING DEVICES SHALL BE INSTALLED 34 INCHES (860 MM) TO 48 INCHES (1220 MM) ABOVE FINISHED FLOOR. MANUALLY OPERATED FLUSH BOLTS OR SURFACE BOLTS ARE NOT PERMITTED. THE UNLATCHING OF ANY DOOR OR LEAF SHALL NOT



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ISSUED DATE: 06/16/2020

EXPIRATION DATE: 12/31/2020

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62012 PROJECT #: 87799-001 SR. DESIGN MANAGER: K. GORIN SLONSK PRODUCTION DESIGNER: A. HAHN CHECKED BY:

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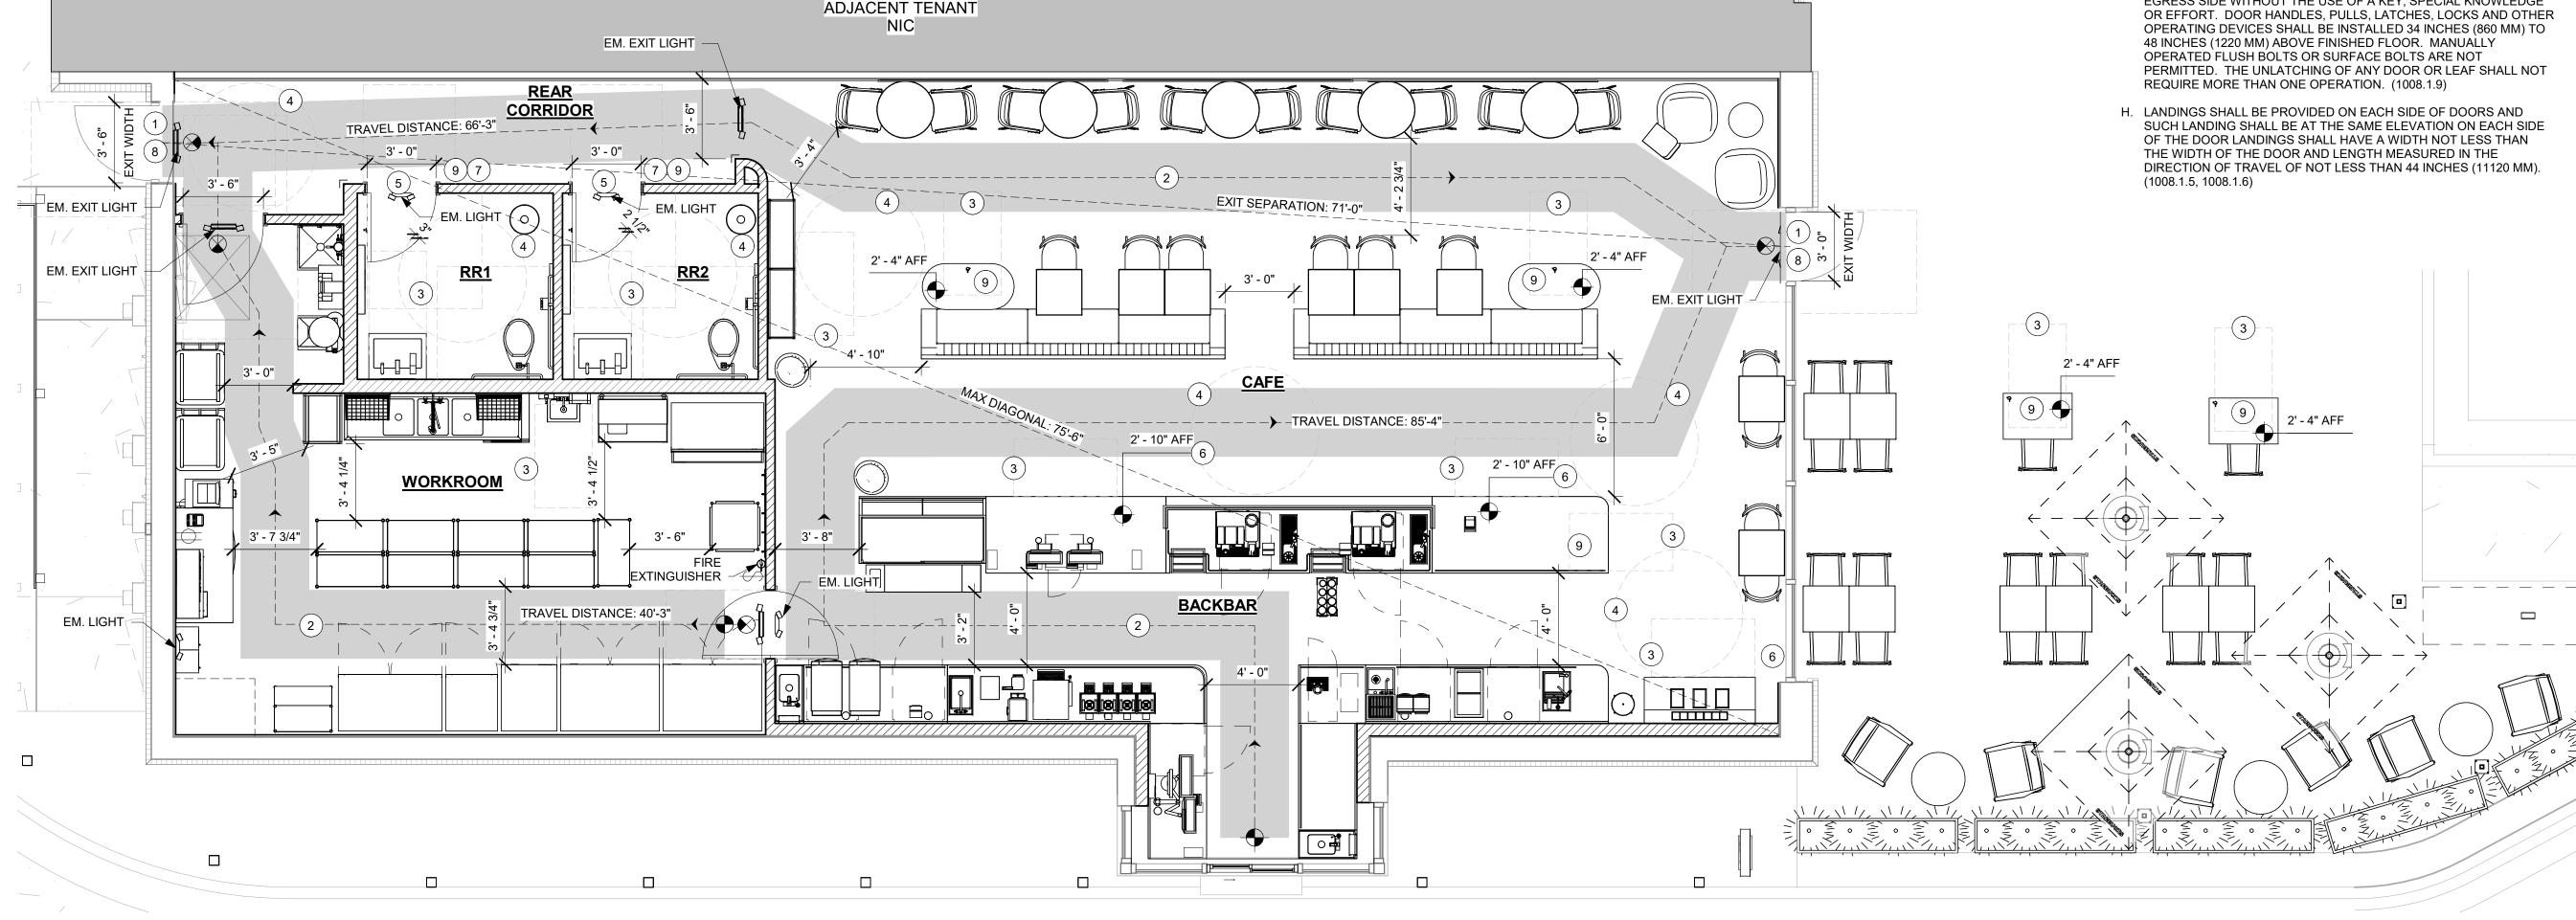
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ISSUE DATE:

LIFE SAFETY ACCESSIBILITY PLAN SCALE: AS SHOWN


SHEET NUMBER:

G002



LIFE SAFETY PLAN

Scale: 1/4" = 1'-0"

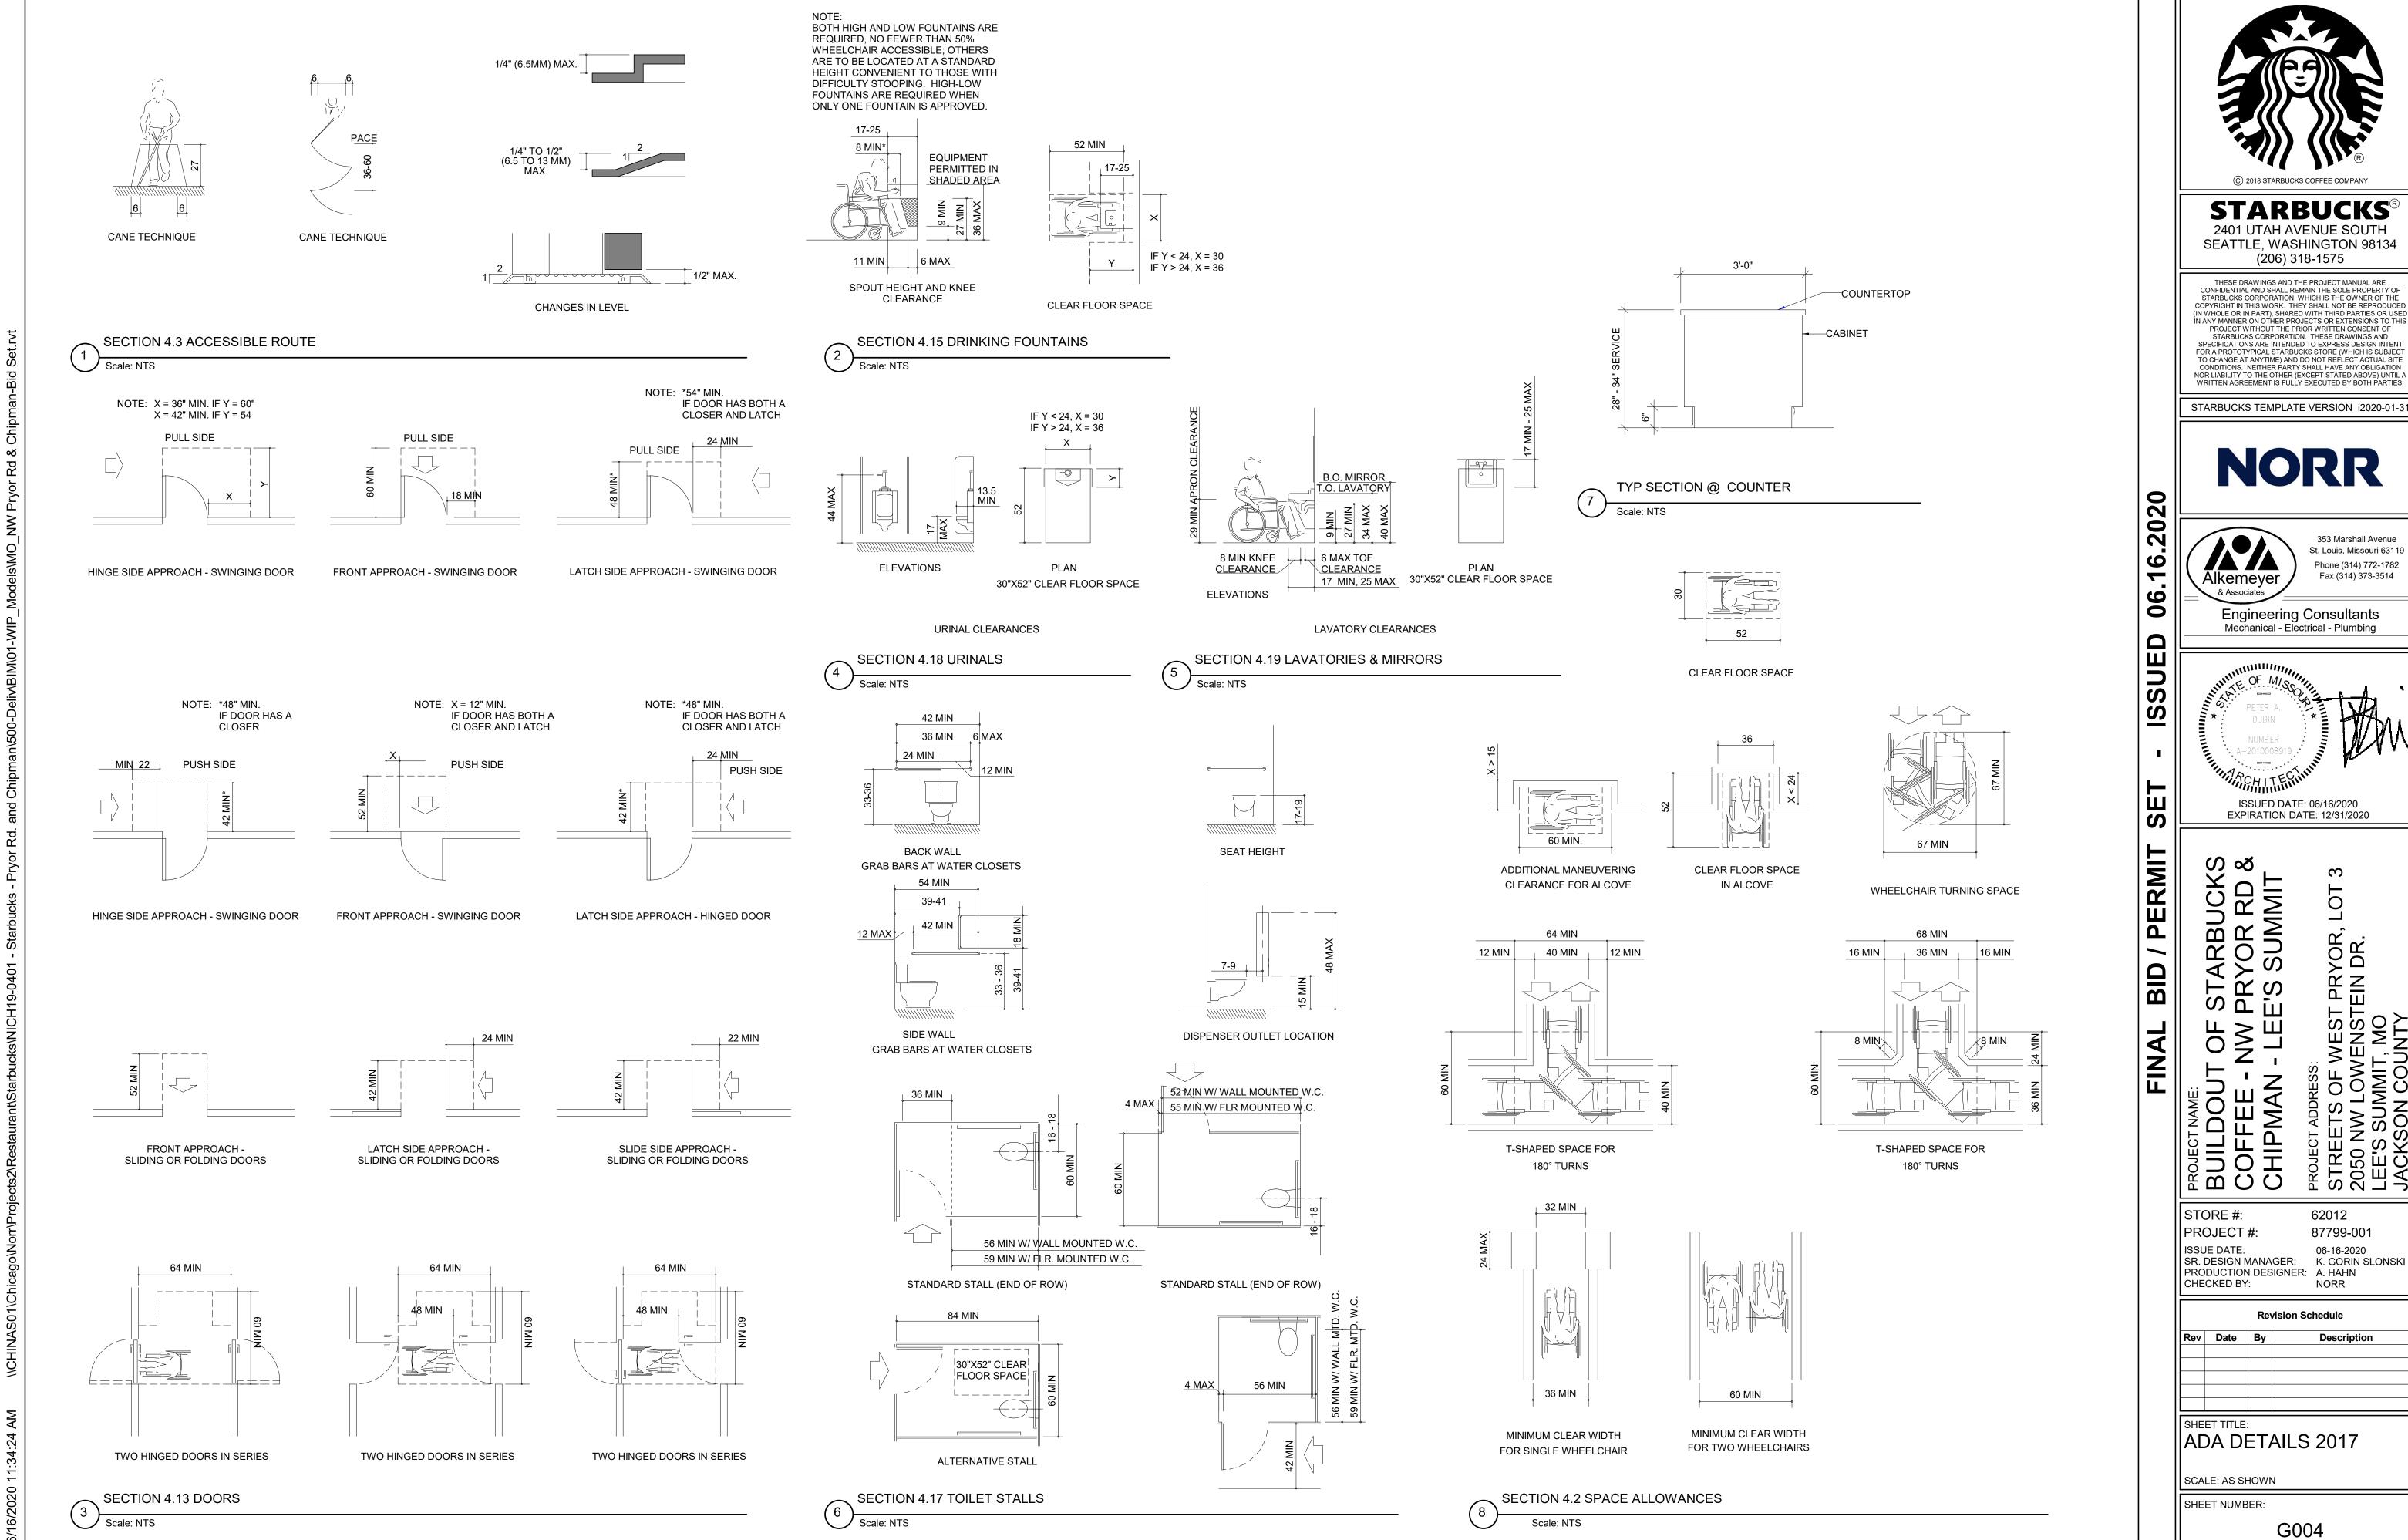

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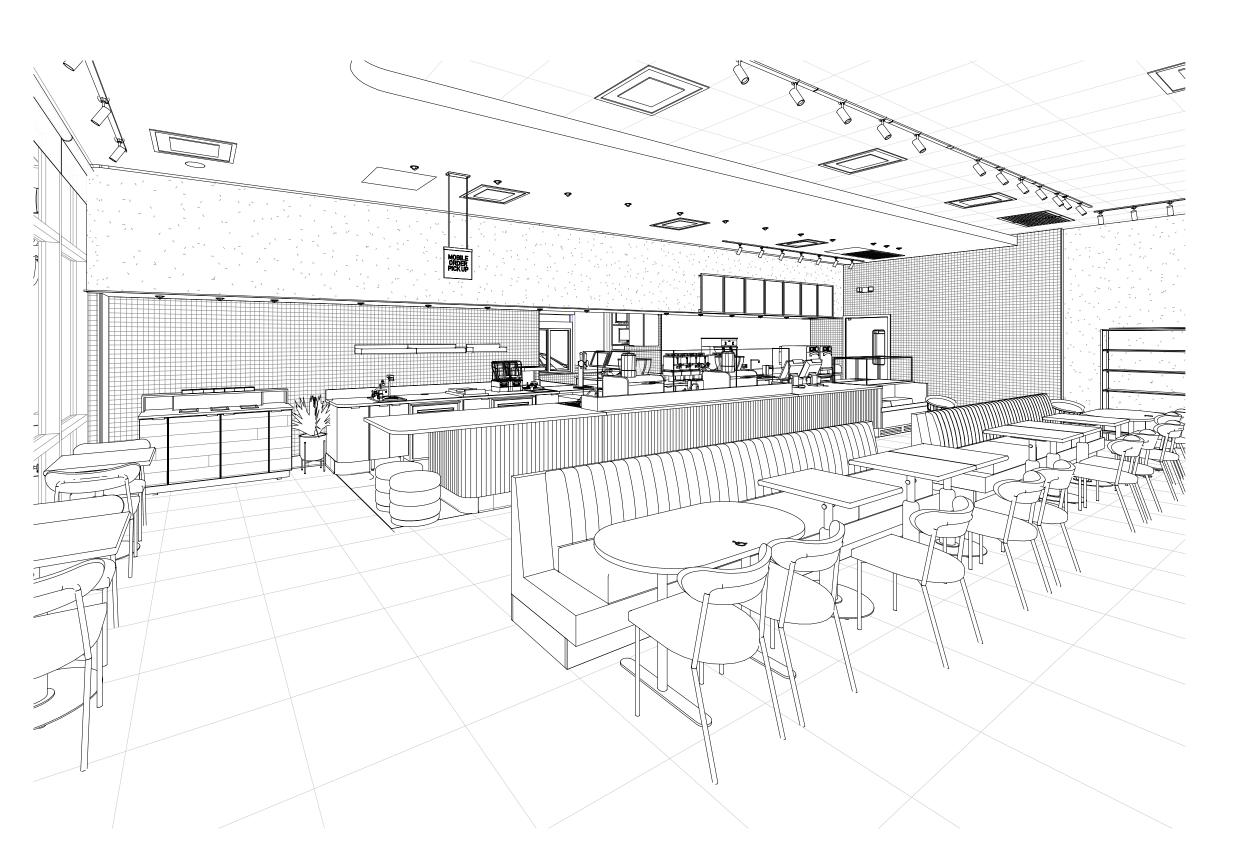
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CAFE VIEW FROM NORTHWEST



CAFE VIEW FROM EAST



CAFE VIEW FROM SOUTHEAST



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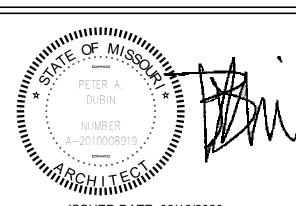
2020

06.16.

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Engineering Consultants
Mechanical - Electrical - Plumbing



ISSUED DATE: 06/16/2020 EXPIRATION DATE: 12/31/2020

ISSUE DATE: 06-16-2020
SR. DESIGN MANAGER: K. GORIN SLONSKI
PRODUCTION DESIGNER: A. HAHN
CHECKED BY: NORR

Revision Schedule							
е	Ву	Description					

SHEET TITLE:
3D VIEWS

STORE #: PROJECT #:

SCALE: AS SHOWN

G005



CAFE VIEW FROM SOUTHWEST



CAFE VIEW FROM EAST



CAFE VIEW FROM SOUTHEAST

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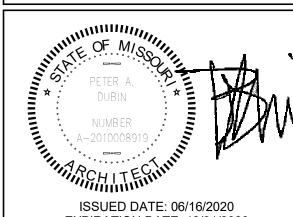
2020

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STORE #: PROJECT #: ISSUE DATE: 06-16-2020
SR. DESIGN MANAGER: K. GORIN SLONSKI
PRODUCTION DESIGNER: A. HAHN
CHECKED BY: NORR

SHEET TITLE:
RENDERINGS

SCALE: AS SHOWN

SHEET NUMBER:

G006

GENERAL NOTES

S 19388 (2)(20)

YX0008 (6)(16

Y X0009 (20)

Y X0004 (5) (14)

(4) Y 18820

S 14091 (19)

Y 20075 (3)

Y 12147 (3)

- A. REFER TO EXTERIOR ELEVATIONS ON SHEET A201 FOR BUILDING SIGNAGE LOCATION AND DESIGN ID. REFER TO ELECTRICAL PLANS FOR ELECTRICAL REQUIREMENTS.
- B. LANDSCAPING TO BE PROVIDED PER ZONING CODE AND SUSTAINABILITY REQUIREMENTS.
- C. DRIVE-THRU EQUIPMENT INCLUDING VEHICLE DETECTION LOOP, WIRELESS COMMUNICATION AND MONITORS SHALL BE COORDINATED BY STARBUCKS CONSTRUCTION MANAGER. REFER TO ELECTRICAL DRAWINGS FOR ADDITIONAL REQUIREMENTS.
- D. PROVIDE 6" (150MM) THICK CONCRETE PAVING THE LENGTH OF THE DRIVE-THRU LANE, EXTENT TO INCLUDE DRIVE-THRU ENTRY POINT THROUGH WINDOW STANDING PAD.
- E. GENERAL CONTRACTOR TO APPLY CONCRETE SEALER TO ALL EXTERIOR CONCRETE PATIO AND WALKWAY SURFACES.

- F. GENERAL CONTRACTOR TO VERIFY ALL EXISTING ELEVATIONS AND BUILDING CONDITIONS IN FIELD PRIOR TO START OF CONSTRUCTION.
- G. PROVIDE DETECTABLE WARNING (IF APPLCABLE PER LOCAL CODE) AT TRANSITION FROM SIDEWALK TO DRIVE AISLE.
- H. ACCESSIBLE PARKING SPACES AND ACCESS AISLES SHALL HAVE SURFACE SLOPE NOT TO EXCEED 2% IN ALL DIRECTIONS.
- REFER TO ELECTRICAL DRAWINGS FOR SITE RELATED ELECTRICAL WORK.
- J. SCRAPE AND REPAINT ALL EXISTING PAINTED SITE FEATURES, INCLUDING, BUT NOT LIMITED TO CURBS, BOLLARDS, RAILINGS AND SITE LIGHTING BASES.
- K. SEE SHEET A002 FOR ARCHITECTURAL SITE DETAILS.

KEYED NOTES

- 1. DRIVE-THRU WINDOW, HAND-OFF SHELF, AND AIR CURTAIN
- 2. 5-PANEL MENU BOARD. LL TO PROVIDE AND INSTALL CONDUIT, FOOTING, AND ANCHOR BOLTS PER LLWL.
- 3. DIGITAL ORDER SCREEN AND CANOPY. REFER TO DOS CONTROL BOX FOR MORE INFORMATION. LL TO PROVIDE AND INSTALL CONDUIT, FOOTING, AND ANCHOR BOLTS PER
- 4. PRE-MENU BOARD. LL TO PROVIDE AND INSTALL CONDUIT, FOOTING AND ANCHOR BOLTS PER LLWL.
- 5. FREESTANDING CLEARANCE BAR, LL TO PROVIDE AND INSTALL FOOTING AND ANCHOR BOLTS PER LLWL.
- 6. SHARED TRASH ENCLOSURE BY LL.
- BUILDING ENTRANCE.
- 8. 42" REAR EXIT DOOR BY LL.
- 9. ADA PARKING, STRIPING, CURB CUTS AND SIGNAGE BY LL.
- 10. "DO NOT ENTER" PAVEMENT MARKING BY LL.
- 11. PROPERTY LINE
- 12. LL TO PROVIDE KEYED, FROST-FREE RECESSED HOSE BIB PER LLWL. SEE EXTERIOR ELEVATIONS FOR MORE INFORMATION
- 13. GREASE INTERCEPTOR BY LL. CAPACITY: 1500 GALLONS PER LL DRAWINGS.
- 14. PATIO SEATING AREA BY LL. LL TO PROVIDE IRRIGATED PLANTERS, PLANTS, AND LANDSCAPED AREA AS INDICATED. ELECTRICAL FOR FANS/ STRING LIGHTS TO BE PROVIDED BY LL PER LL CRITERIA PACKAGE STANDARDS.
- 15. LL TO PROVIDE 6" THICK CONCRETE DRIVE-THRU LANE WHICH SHALL EXTEND FROM 12FT FROM THE CENTERLINE OF THE ORDER SCREEN TO 12FT BEYOND THE CENTERLINE OF THE DRIVE-THRU WINDOW.
- 16. BIKE RACK PROVIDED BY LL. SPECIFICATION PER SBUX.
- 17. MONUMENT SIGN BY LL. SBUX TO PROVIDE PANEL FACES ONLY. BASE SIGN, FOOTING, ANCHOR BOLTS, AND CONDUIT TO BE PROVIDED BY LL.
- 18. LL TO PROVIDE COVERED EXTERIOR ELECTRICAL OUTLETS PER LLWL. SEE EXTERIOR ELEVATIONS AND ELECTRICAL SHEETS FOR MORE INFORMATION.
- 19. ILLUMINATED DRIVE THRU 'EXIT ONLY/ THANK YOU' SIGN. LL TO PROVIDE AND INSTALL CONDUIT, FOOTING AND ANCHOR **BOLT CONNECTIONS PER LLWL.**
- 20. "MOBILE ORDER PAY PARKING ONLY" SIGN BY LL.
- 21. KEYED, FROST-FREE RECESSED HOSE BIB TO BE INSTALLED IN TRASH ENCLOSURE PER LLWL.
- 22. DRIVE-THRU LANE TO BE 1'-0" AWAY FROM BUMPOUT PER LL CRITERIA PACKAGE REQUIREMENTS.
- 23. EMPLOYEE EGRESS PATH AND CURB CUTS TO TRASH ENCLOSURE BY LL PER LLWL.
- 24. INDICATES BUILDING CANOPY ABOVE. TO BE PROVIDED BY LL. LL TO PROVIDE BLOCKING, AS NECESSARY, AND RECESSED CAN LIGHTS PER LLWL. BUILDING CANOPY TO EXTEND A MINIMUM OF 4'-0" FROM EXTERIOR WALL PER LLWL REQUIREMENTS.
- 25. INSTALL VEHICLE DETECTOR LOOP @ CENTERLINE FOR ORDER POINT & DRIVE THRU WINDOW. REFER TO SITE DETAILS FOR MORE INFORMATION. LL TO PROVIDE ELECTRICAL.
- 26. WALL MOUNTED FAN. LL TO PROVIDE ELECTRICAL
- 27. PROVIDE PROTECTIVE BOLLARDS ON BOTH SIDES OF EXTERIOR UTILITY SERVICES ADJACENT TO VEHICULAR TRAFFIC. EXAMPLES INCLUDE FIRE STAND PIPE, GAS, AND ELECTRICAL METERS, SITE TRANSFORMERS, ETC.
- 28. STARBUCKS SIGNAGE VENDOR TO COORDINATE APPROVALS AND PERMITS FOR EXTERIOR SIGNAGE SEPARATELY AS REQUIRED.
- 29. LANDSCAPE BUFFER AREA AT PATIO BY LL. LL TO PROVIDE IRRIGATION AND PLANTS PER LLWL.
- 30. LL TO PROVIDE AND INSTALL 5IN SQUARE, NON ILLUMINATED BOLLARDS AS INDICATED PER LLWL. REFER TO SITE DETAILS FOR MORE INFORMATION.
- 31. LL TO PROVIDE UTILITY SCREEN PER LLWL REQUIREMENTS.
- 32. GAS METER LOCATION PER LL DRAWINGS.
- 33. ELECTRICAL METER LOCATION PER LL DRAWINGS.
- 34. EXTERIOR ROOF LADDER PER LL DRAWINGS.
- 35. GC TO REMOVE EXISTING DT SHELF.





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STORE #: 62012 PROJECT #: 87799-001 ISSUE DATE: SR. DESIGN MANAGER: K. GORIN SLONSKI PRODUCTION DESIGNER: A. HAHN

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Description

ARCHITECTURAL SITE PLAN

SHEET NUMBER:

SCALE: AS SHOWN

CHECKED BY:

A001

ARCHITECTURAL SITE PLAN - FOR REFERENCE ONLY Scale: 1" = 20'-0"

(30) Y 14103

Y 14120

(25)Y X0001

3 Y 14163

Y 14116

Y 15700

(30) Y 14103

(2)Y 14119

(30) Y 14103 -

(7) Y 14103

ADJACENT TENANT

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(25)YX0001

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COORDINATION PURPOSES ONLY.


CIVIL PLAN DATED: 04/24/20.

* * * * * * LANDSCAPE AREA


EXTENTS OF CONCRETE PAD BY LANDLORD GC

NOTE: SITE PLAN PREPARED IN REFERENCE TO THE LANDLORD

NOTE: ALL SIGNAGE UNDER SEPARATE PERMIT, SHOWN FOR

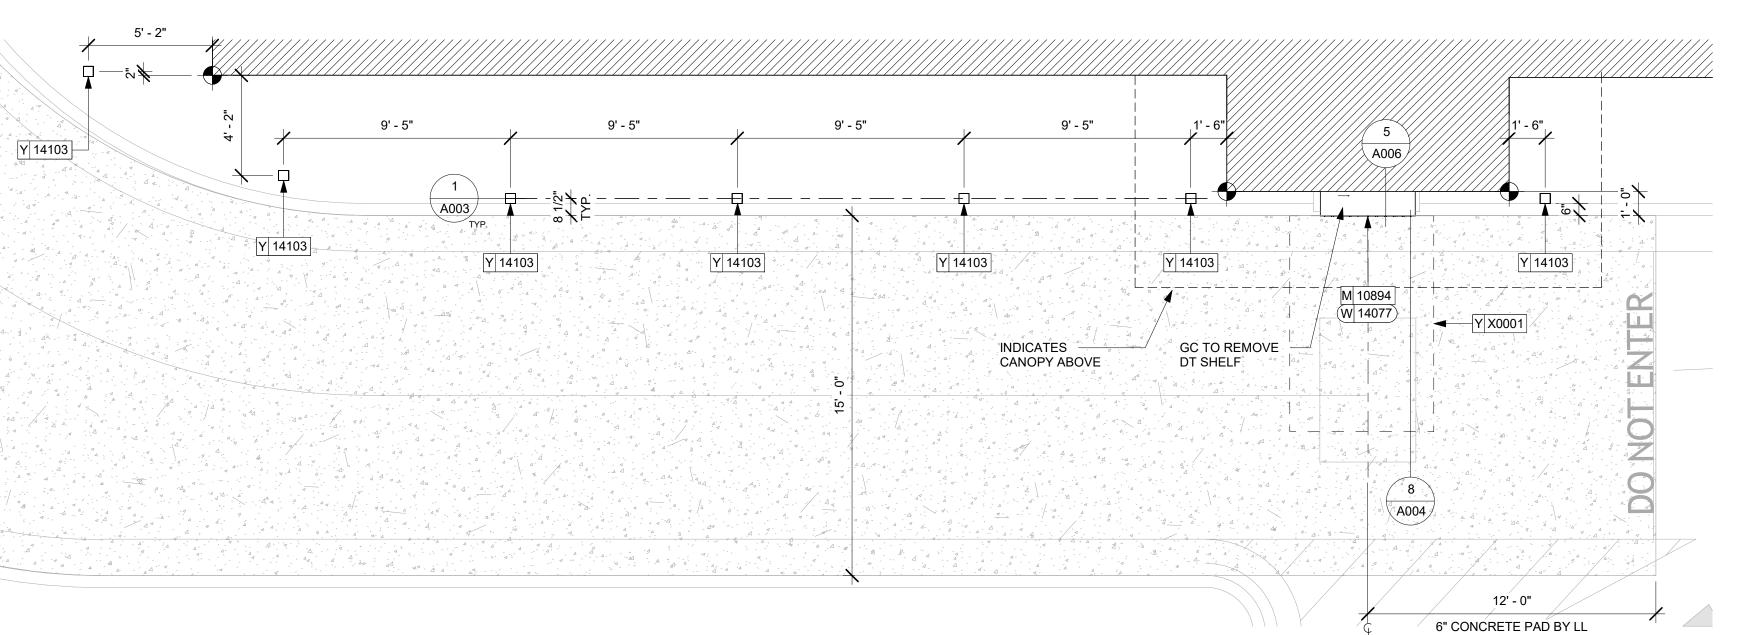

2 ENLARGED PICK-UP WINDOW

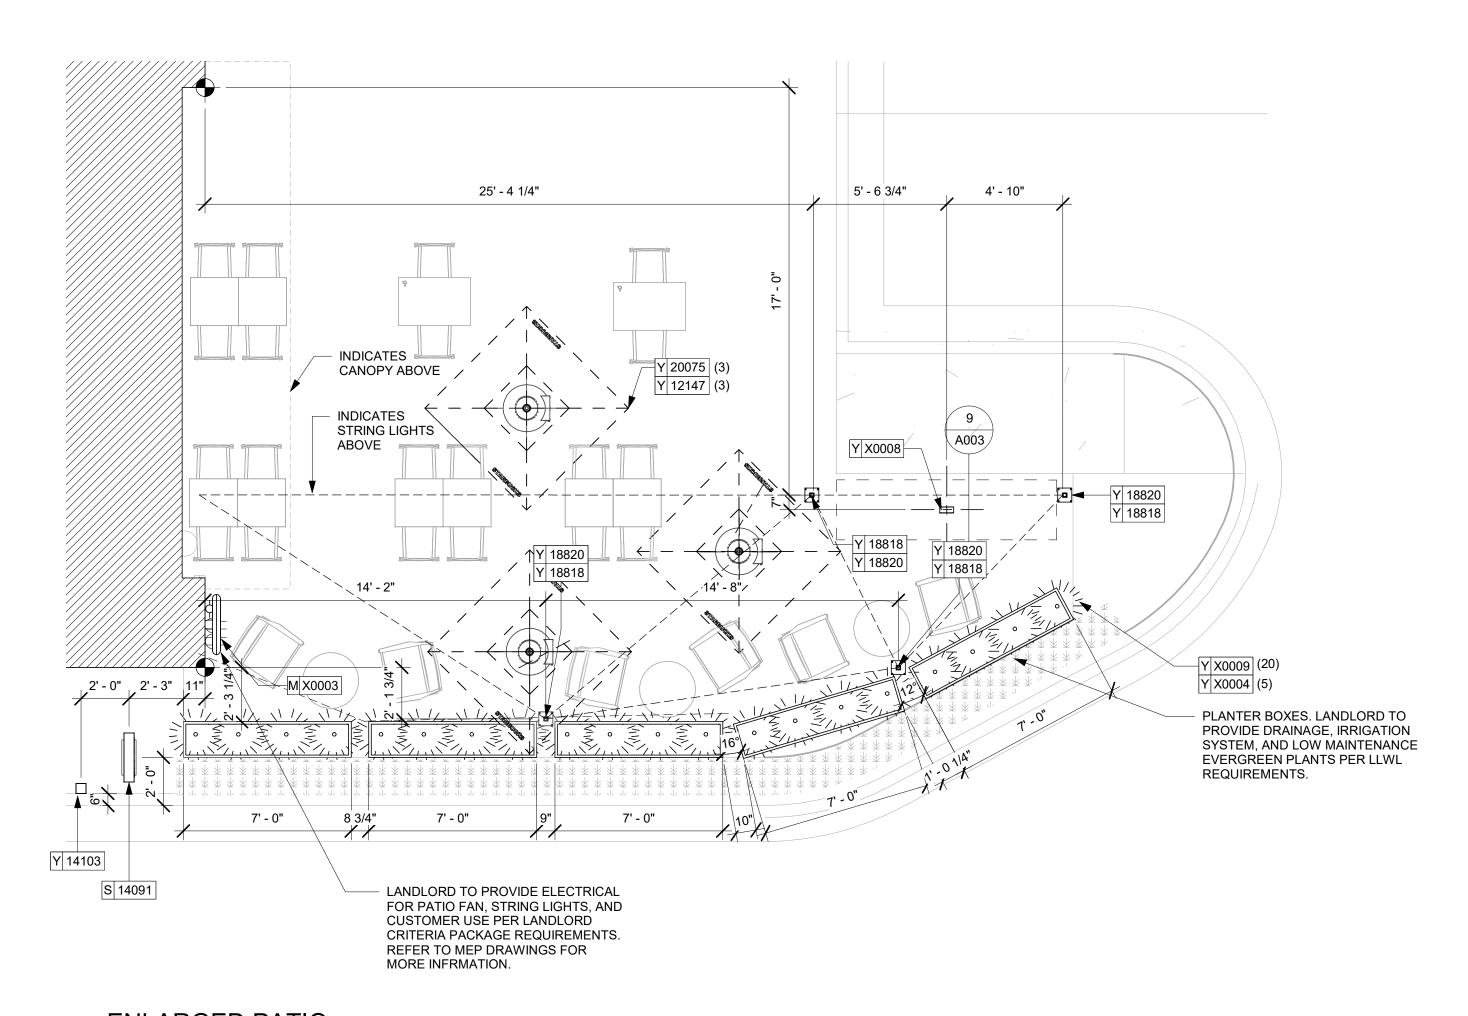



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PRYOR, EIN DR.

62012 87799-001 ISSUE DATE: 06-16-2020 SR. DESIGN MANAGER: K. GORIN SLONSKI PRODUCTION DESIGNER: A. HAHN NORR

Revision Schedule

Rev	Date	Ву	Description

ARCHITECTURAL SITE DETAILS SCALE: AS SHOWN

SHEET NUMBER:


BUILDOU COFFEE CHIPMAN

STORE #:

PROJECT #:

CHECKED BY:

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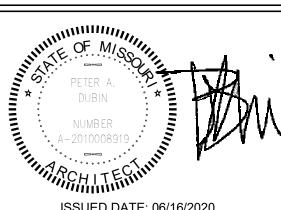
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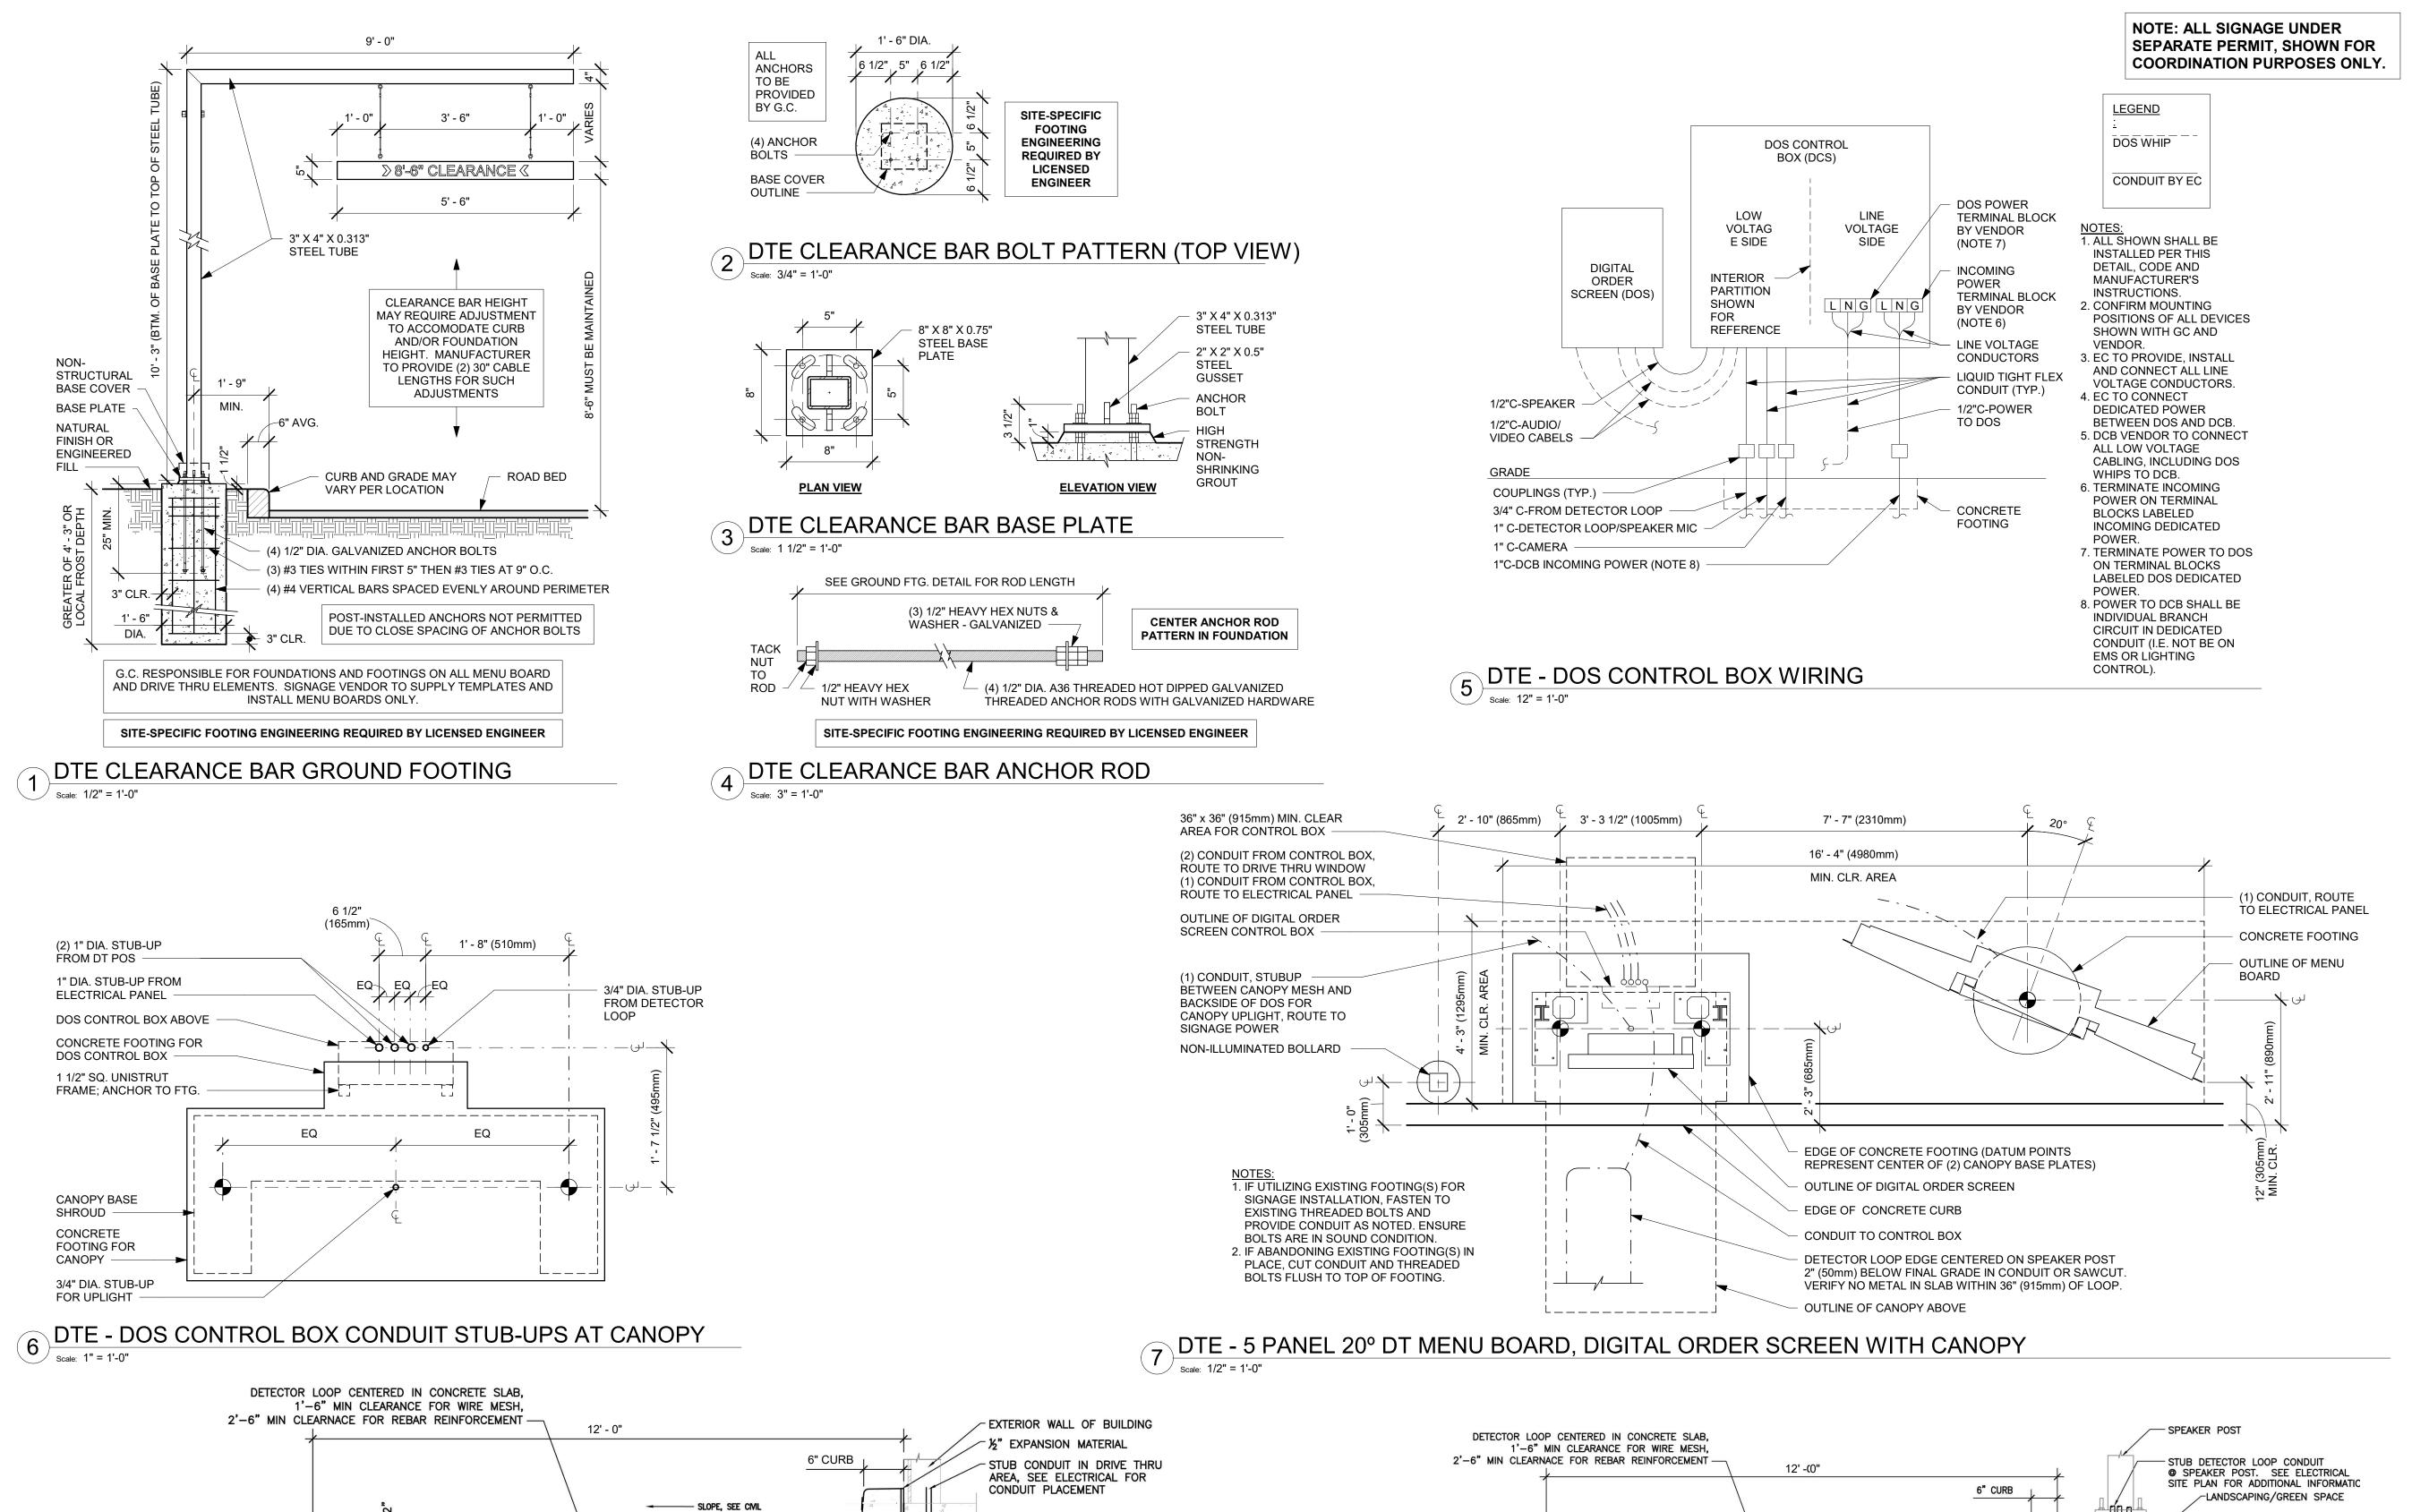
62012 87799-001

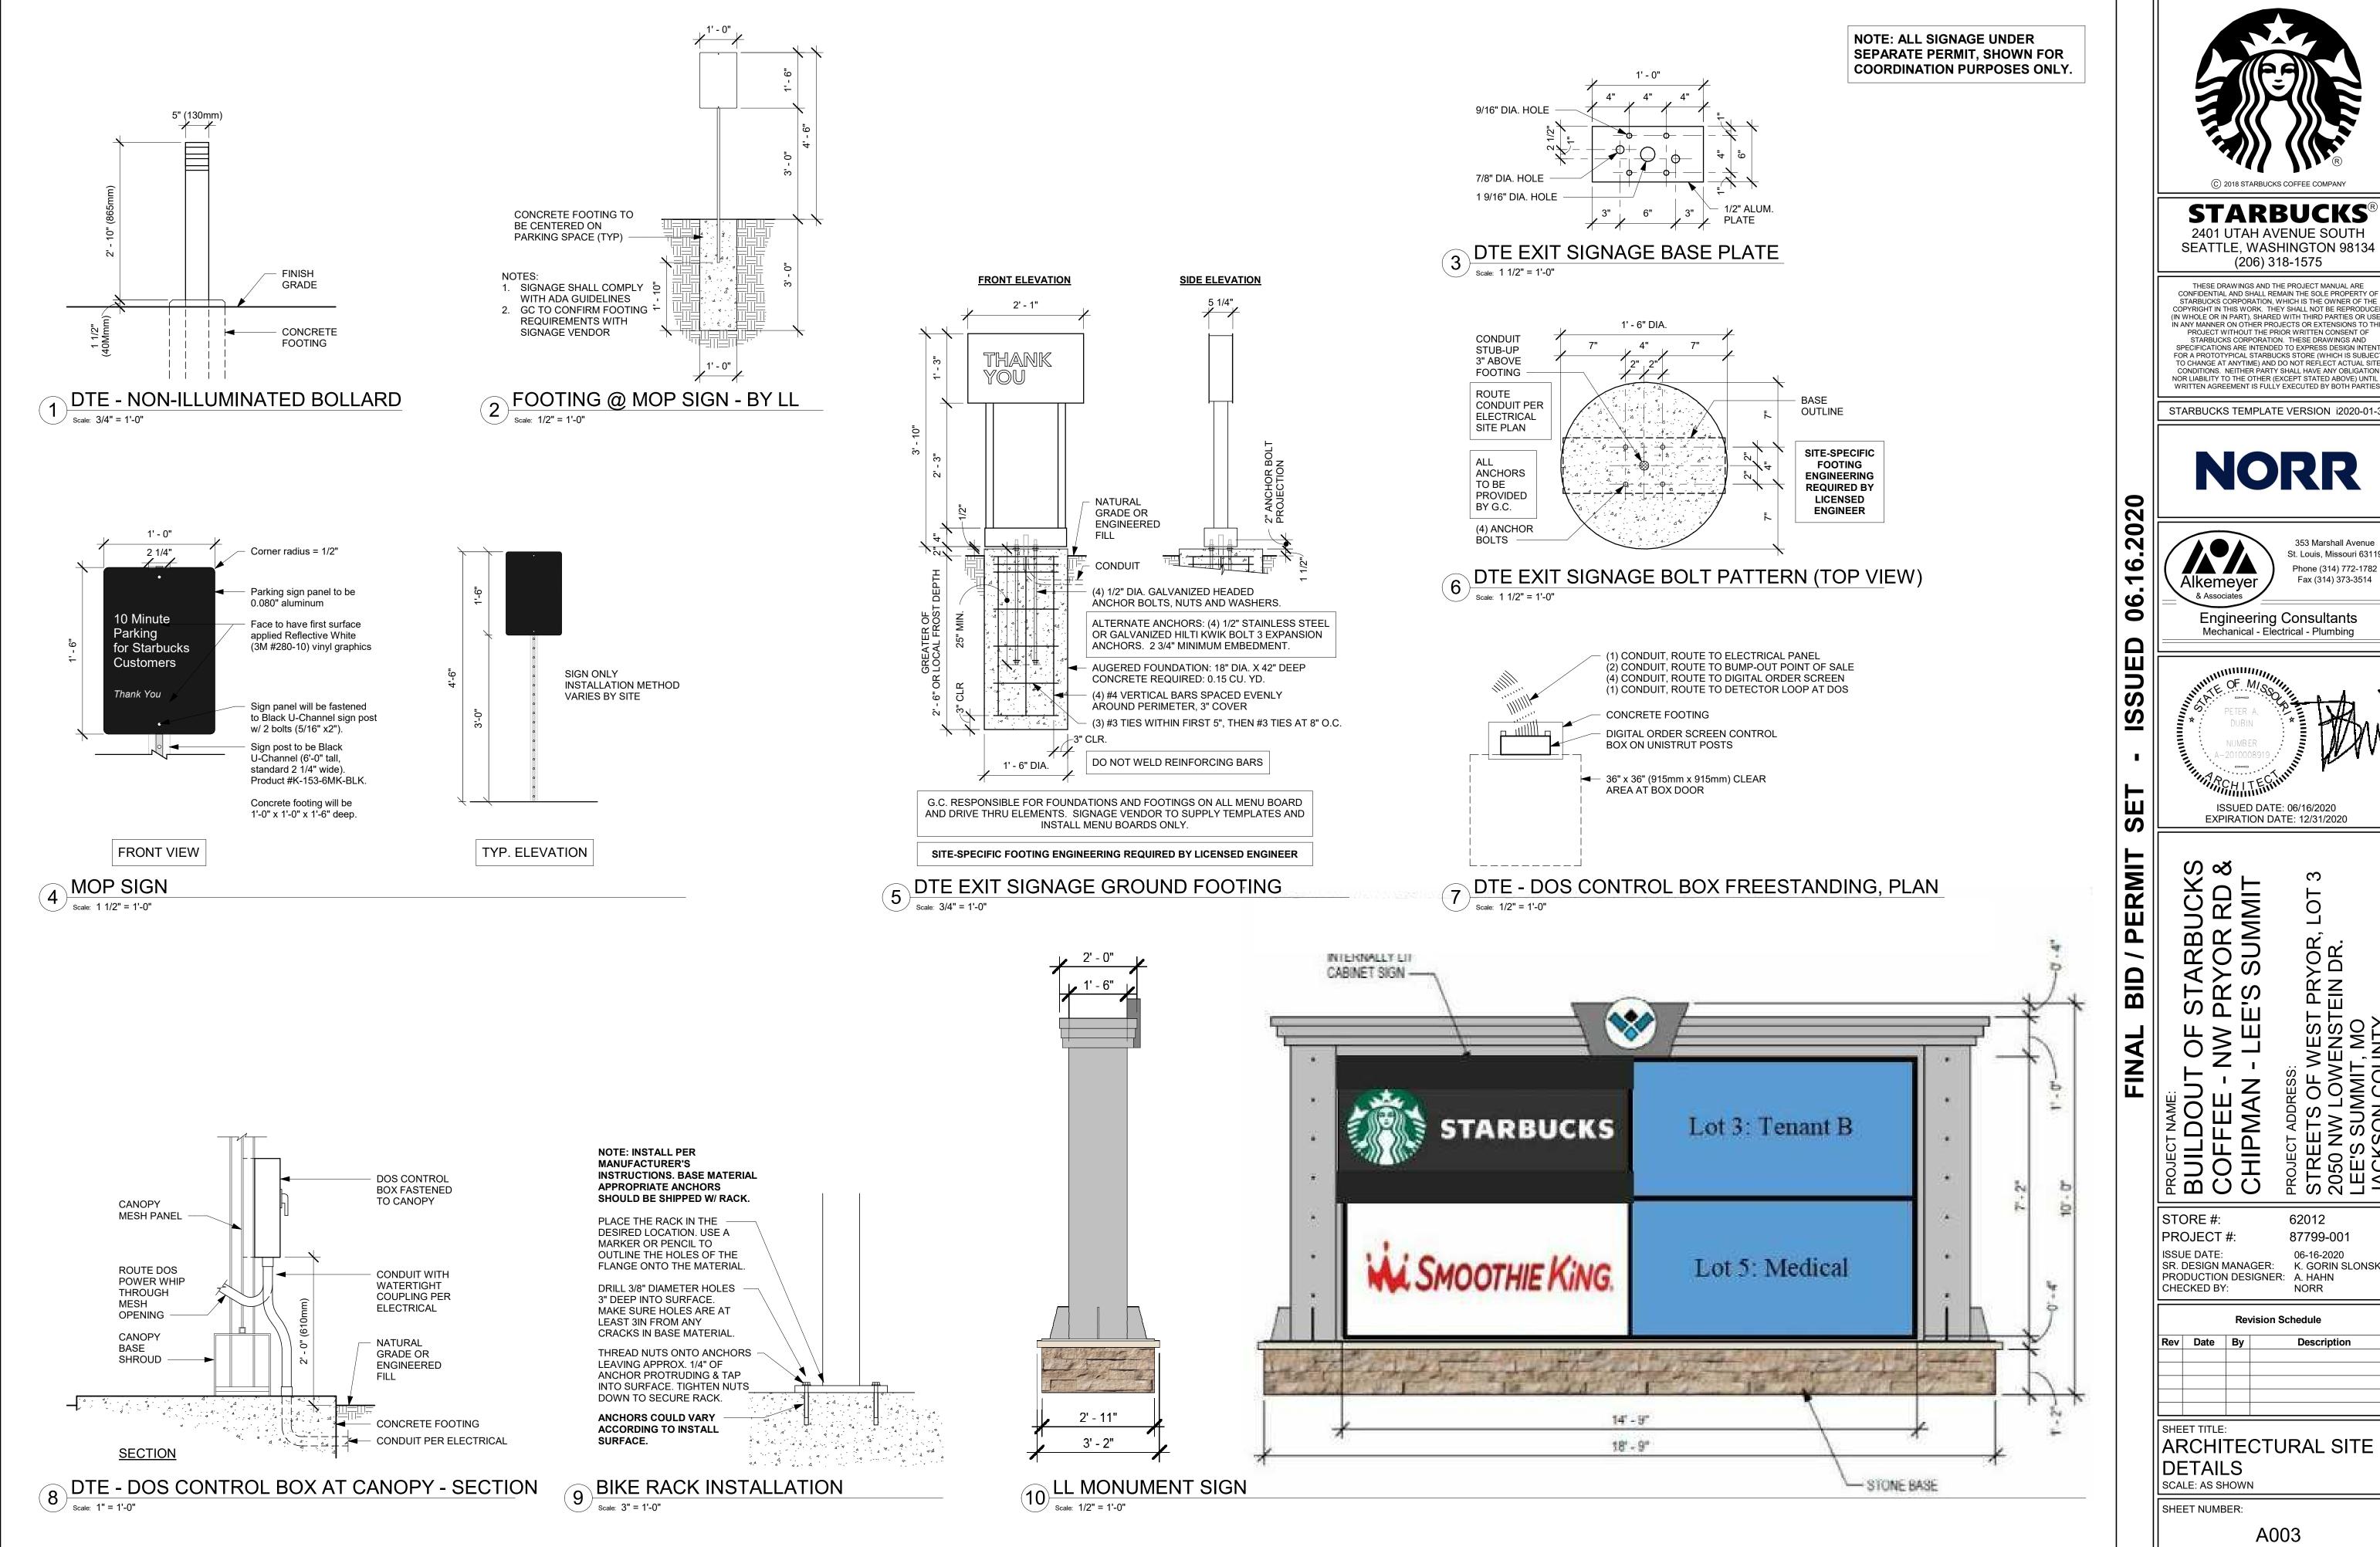06-16-2020 SR. DESIGN MANAGER: K. GORIN SLONSKI NORR

Revision Schedule

Description

ARCHITECTURAL SITE



STORE #: PROJECT #: **ISSUE DATE** SR. DESIGN MANAGER: K. GORIN SLONSKI PRODUCTION DESIGNER: A. HAHN CHECKED BY:

POWER CONDUIT TO BUILDING

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Revision Schedule

62012

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06-16-2020

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Description

ARCHITECTURAL SITE DETAILS

SHEET NUMBER:

SCALE: AS SHOWN

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8 SECTION @ DETECTOR LOOP IN CONCRETE PAD AT DRIVE THRU WINDOW

COMPACTED SUB GRADE

[/] Scale: 1 1/2" = 1'-0"

NOTE: REFERENCE ELECTRICAL DRAWINGS & SIGNAGE SHOP DRAWINGS

FOR DETECTOR LOOP INFORMATION & INSTALLATION INSTRUCTIONS

9 SECTION @ DETECTOR LOOP IN CONCRETE PAD AT THE MENU BOARD

NOTE: REFERENCE ELECTRICAL DRAWINGS & SIGNAGE SHOP DRAWINGS

FOR DETECTOR LOOP INFORMATION & INSTALLATION INSTRUCTIONS

SLOPE, SEE CM

DETECTOR LOOP PAD

SLAB ON GRADE

CONCRETE FOOTING, SEE STRUCTURAL


FOR REINFORCEMENT CONNECTION TO

COMPACTED SUB GRADE


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SIDE ELEVATION


2' - 0"



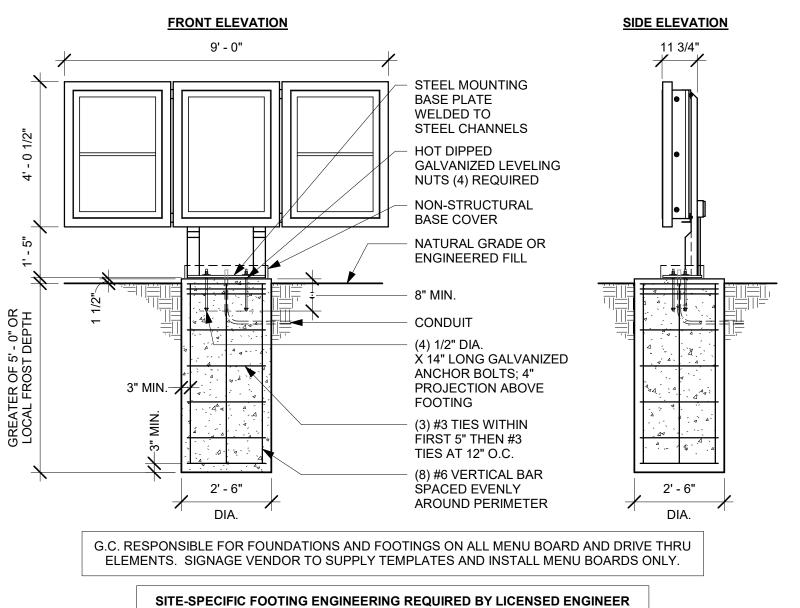


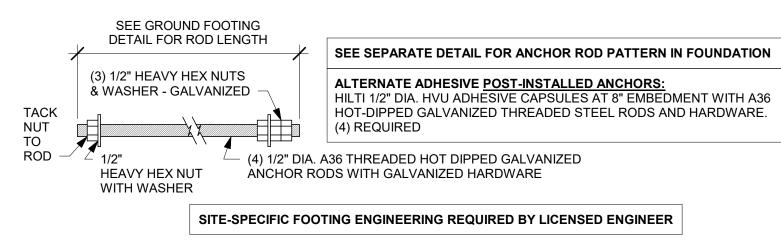

4 DTE 5-PANEL MENU BOARD ANCHOR ROD

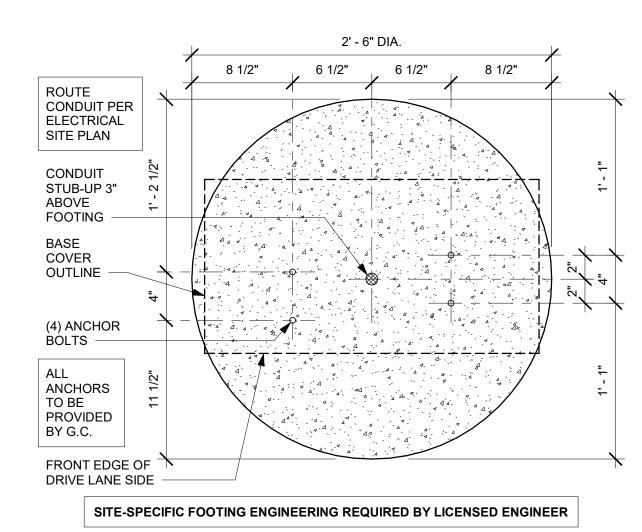


DTE 5-PANEL MENU BOARD BOLT PATTERN (TOP VIEW)

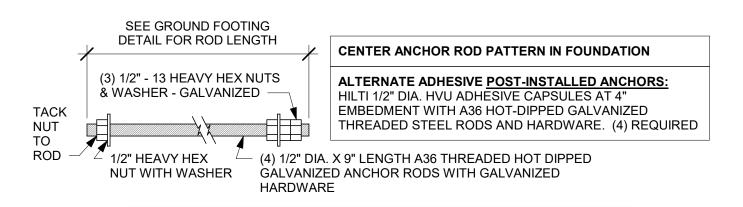

SITE-SPECIFIC FOOTING ENGINEERING REQUIRED BY LICENSED ENGINEER

5 DTE PRE-MENU ANCHOR ROD

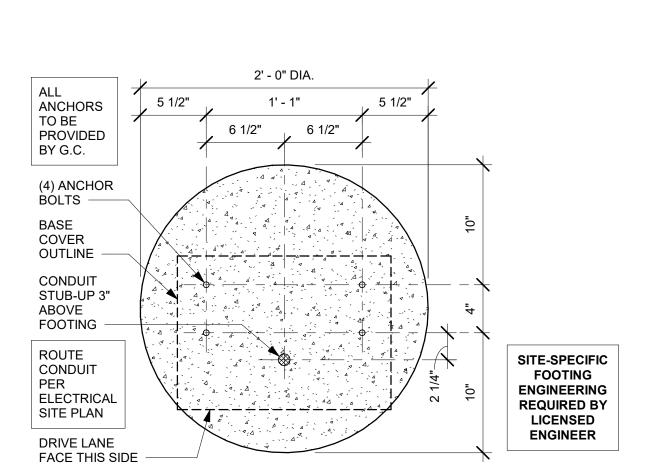

FRONT ELEVATION

2' - 0"

STEEL MOUNTING

BASE WELDED TO

STEEL CHANNELS

NON-STRUCTURAL BASE COVER

HOT DIPPED

GALVANIZED

LEVELING NUTS

NATURAL GRADE OR

(4) 1/2" DIA. X 9" LONG

ABOVE FOOTING

SPACED EVENLY

G.C. RESPONSIBLE FOR FOUNDATIONS AND FOOTINGS ON ALL MENU BOARD

AND DRIVE THRU ELEMENTS. SIGNAGE VENDOR TO SUPPLY TEMPLATES AND

INSTALL MENU BOARDS ONLY.

SITE-SPECIFIC FOOTING ENGINEERING REQUIRED BY LICENSED ENGINEER

DTE PRE-MENU GROUND FOOTING

AROUND PERIMETER

GALVANIZED ANCHOR

BOLTS; 3 1/4" PROJECTION

(3) #3 TIES WITHIN FIRST 5'


THEN #3 TIES AT 12" O.C.

ENGINEERED FILL


(4) REQUIRED


CONDUIT

DTE PRE-MENU BOLT PATTERN (TOP VIEW)

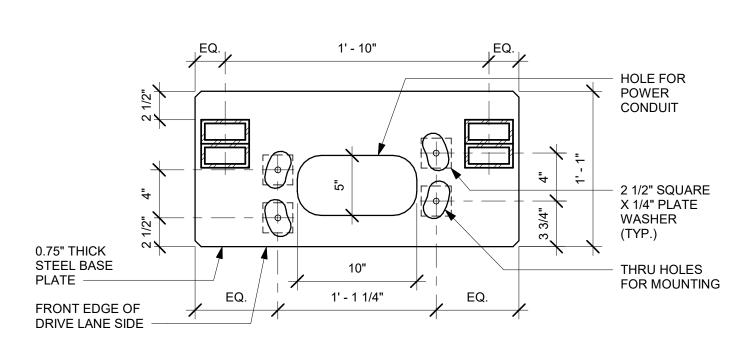


DTE 5-PANEL MENU BOARD BASE PLATE Scale: 1 1/2" = 1'-0"

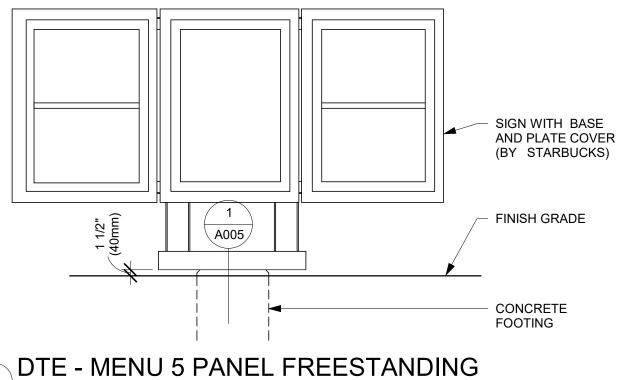

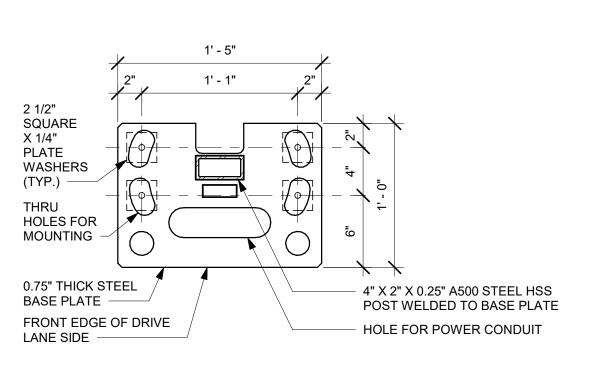

9 DTE PRE-MENU BASE PLATE

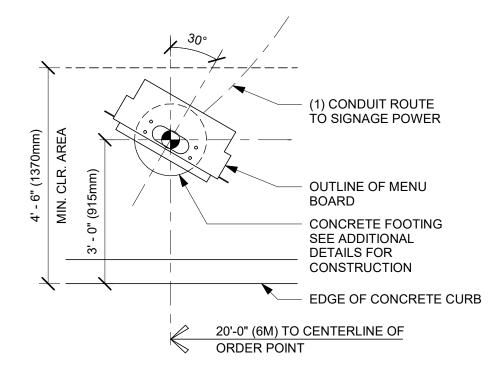

10 DTE - PRE-MENU 30 DEG

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ISSUED DATE: 06/16/2020 EXPIRATION DATE: 12/31/2020

ARBUCK YOR RD SUMMIT LOT PRYOR, EIN DR. $\Omega \square$

STORE #: 62012 PROJECT #: 87799-001 ISSUE DATE: 06-16-2020 SR. DESIGN MANAGER: K. GORIN SLONSKI PRODUCTION DESIGNER: A. HAHN CHECKED BY: NORR

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Revision Schedule						
Ву	Description					

ARCHITECTURAL SITE DETAILS

SHEET NUMBER:


SCALE: AS SHOWN

A005

ALL ANCHORS TO BE PROVIDED BY G.C. BASE COVER OUTLINE ALL CONDUIT STUB-UPS TO BE 3" ABOVE FOOTING OUTLINE OF BASE PLATE (TYP.) -**ELECTRICAL** CONDUIT PER STUB-UP (8) ANCHOR BOLTS ELECTRICAL **EDGE OF CONCRETE** DT POS SITE PLAN FOOTING -STUB-UPS DETECTOR LOOP STUB-UP **UPLIGHT** STUB-UP 8" 4 1/2" 6 3/4"

(2) C4 X 7.25 2' - 0" 1' - 3 1/2" 1' - 3 1/2" STEEL **CHANNELS** 1' - 0 1/2" 1 1/2" WELDED TO STEEL BASE PLATE BY MFR. (TYP. AT EACH BASE PLATE) 0.75" THICK A36 STEEL BASE PLATE (4) THRU 4 3/4" 4 3/4" FRONT **HÓLES FOR** EDGE OF DRIVE LANE MOUNTING (TYP. AT EACH BASE PLATE) -1' - 3 1/2" 1' - 3 1/2"

DTE DOS CANOPY BASE PLATE

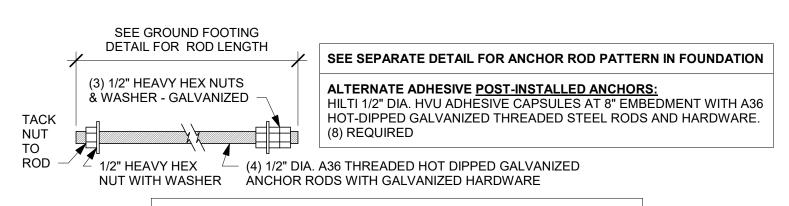



SITE-SPECIFIC FOOTING ENGINEERING REQUIRED BY LICENSED ENGINEER

2 DTE DOS CANOPY BOLT PATTERN (TOP VIEW)


Scale: 1" = 1'-0"

DTE DOS CANOPY ANCHOR ROD

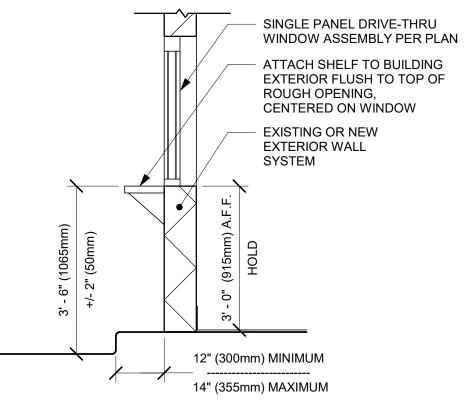


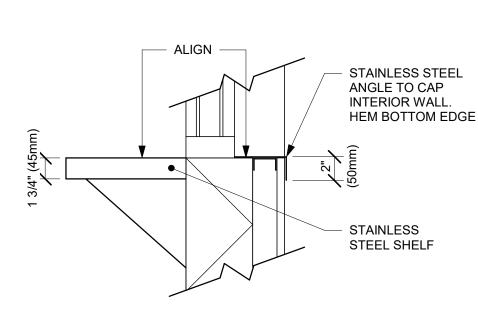



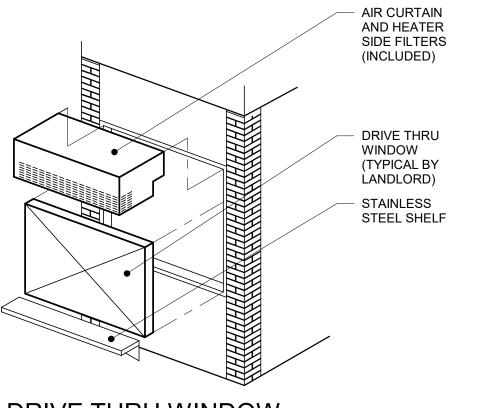



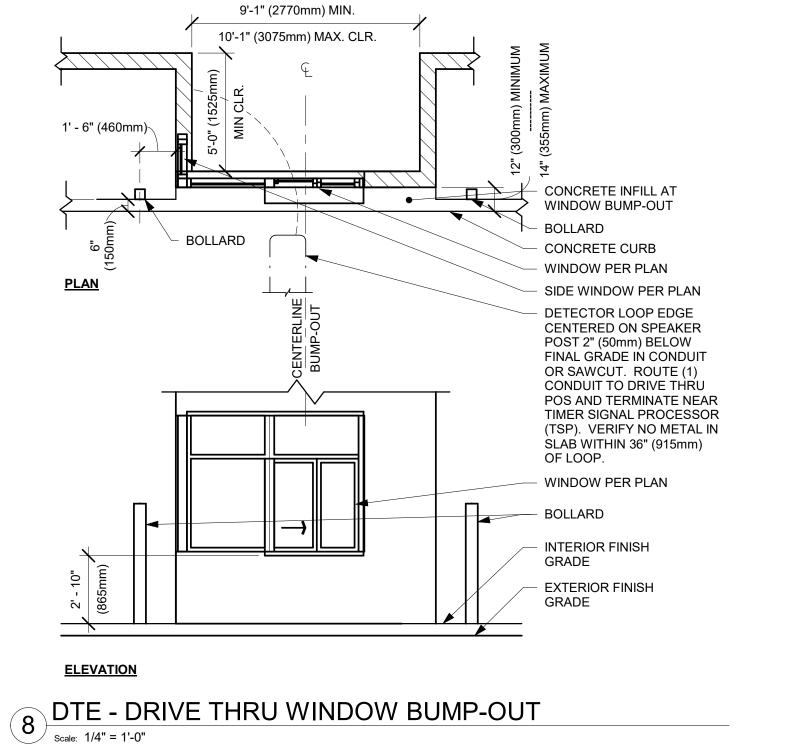



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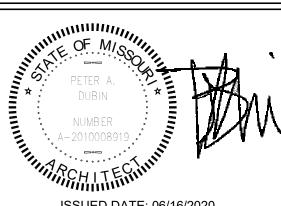
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Phone (314) 772-1782 Fax (314) 373-3514

Engineering Consultants Mechanical - Electrical - Plumbing



ISSUED DATE: 06/16/2020

EXPIRATION DATE: 12/31/2020

PRYOR, EIN DR. $S \subseteq \Pi$

STORE #: 62012 PROJECT #: 87799-001 ISSUE DATE: 06-16-2020 SR. DESIGN MANAGER: K. GORIN SLONSKI PRODUCTION DESIGNER: A. HAHN CHECKED BY: NORR

BUIL COFF CHIP

Revision Schedule

Rev	Date	Ву	Description

SHEET TITLE: ARCHITECTURAL SITE DETAILS SCALE: AS SHOWN

SHEET NUMBER:

A006

5 DRIVE THRU WINDOW

Scale: 1/2" = 1'-0"

12

D 21147 88 3 3/4" 3' - 6"

FLOOR PLAN

Scale: 1/4" = 1'-0"

D X0031 85


7' - 3 3/4"

|5' - 1 1/4"

	INTERIOR NEW WALL SCHEDULE								
TAG	DESCRIPTION	INSULATION	NOTES						
2-F-N	3 5/8" 20 GA STUD FURRING WALL	NONE	FULL HT. WALL. SEE PLAN FOR WALL SHEATHING.						
2-T-N	3 5/8" 20 GA STUD FURRING @ 16" O.C.	NONE	TERMINATE 6" ABOVE CEILING. PROVIDE 45 DEGREE METAL STUD BRACING AT 48" O.C. FROM STUD WALL TO STRUCTURE ABOVE. SEE PLAN FOR WALL SHEATHING.						
3-T-A	3 5/8" 20 GA STUDS @ 16" O.C.	ACOUSTIC	TERMINATE 6" ABOVE CEILING. PROVIDE 45 DEGREE METAL STUD BRACING AT 48" O.C. FROM STUD WALL TO STRUCTURE ABOVE. SEE PLAN FOR WALL SHEATHING.						
3-T-N	3 5/8" 20 GA STUDS @ 16" O.C.	NONE	TERMINATE 6" ABOVE CEILING. PROVIDE 45 DEGREE METAL STUD BRACING AT 48" O.C. FROM STUD WALL TO STRUCTURE ABOVE. SEE PLAN FOR WALL SHEATHING.						
4-T-A	6" 20 GA STUDS @ 16" O.C.	ACOUSTIC	TERMINATE 6" ABOVE CEILING. PROVIDE 45 DEGREE METAL STUD BRACING AT 48" O.C. FROM STUD WALL TO STRUCTURE ABOVE. SEE PLAN FOR WALL SHEATHING.						
5-T-N	6" 20 GA STUDS @ 16" O.C. FURRING WALL	NONE	TERMINATE 6" ABOVE CEILING. PROVIDE 45 DEGREE METAL STUD BRACING AT 48" O.C. FROM STUD WALL TO STRUCTURE ABOVE. SEE PLAN FOR WALL SHEATHING.						

1' - 0 1/4"

3' - 6"

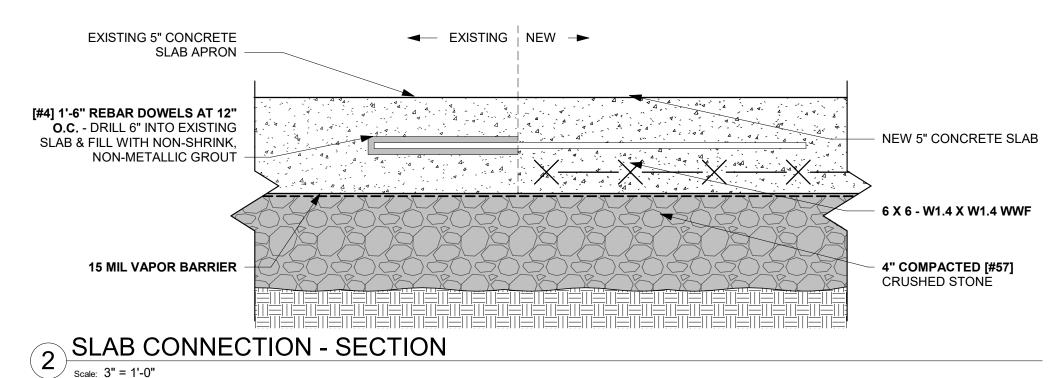

25' - 10"

-CORRIDOR

5' - 11 1/4"

20' - 6 3/4"

25' - 8 1/4"

WORKROOM

3' - 0"

3' - 0"

WALL BLOCKING KEY

ADJACENT TENANT

4' - 1 1/4" 1' - 4 3/4" A101 أم

3-T-N

D 10086 82

SYMBOL	ITEM	WEIGHT	HEIGHT A.F.F.	APPROX. WIDTH	
A	WORKROOM HAND SINK	128 LBS (58 KG)	36" TO 40" (915MM TO 1015MM)	30" (760MM) BEHIND SINK	
B	SHELVES ABOVE COMPARTMENT SINK	200 LBS (91 KG)	48" TO 76" (1220MM TO 1930MM)	96" (2440MM) CENTERED ABOVE COMPARTMENT SINK	
⟨c⟩	ARTWORK	200 LBS	COORDINATE WITH INTERIOR ELEVATIONS		
D	SHELVES AT MANAGER'S DESK	300 LBS (136 KG)	32" TO 96" (810MM TO 2440MM)	48" (1220MM) 3/4 (19MM) ACX PLYWOOD, CENTERED ON SHELVES	
E	EQUIPMENT RACK AT MANAGER'S DESK	300 LBS (136 KG)	44" TO 96" (1120MM TO 2440MM)	28" (710MM) 3/4 (19MM) ACX PLYWOOD, CENTERED ON RACK	
F	MERCHANDISE DISPLAY	100 LBS	70" TO 96"	WIDTH OF FIXTURE + 8" EITHER SIDE	
G	RESTROOM GRAB BARS	200 LBS (91 KG)	30" TO 36" (760MM TO 915MM)	60" (1525MM) AROUND WATER CLOSET	
H	RESTROOM HAND SINK	200 LBS (91 KG)	COMMERCIAL INSTALLATION REQUIRES CONCEALS ARM CARRIER. REFER TO MFR'S SPECIFICATION		
	DT UPPER CABINET	BLOCK	KING SPECIFICATION FOR FRENCH CLEATING SYSTEM REFER TO DETAILS.		
J	DIAPER CHANGING STATION	250 LBS (113 KG)	40 1/2" TO 46 1/2" (1030MM TO 1180MM)	32" (810MM) BEHIND STATION	
K	UPPER CBE SHELVING			FOR CBE METAL SHELVES. ECIFICATION AND DETAILS.	
<u>(L)</u>	WATER FILTRATION SYSTEM	TBD BY VENDOR			
⟨M⟩	ALL ARTWORK, FIXTURES, ACCESSORIES AND CASEWORK FABRICATIONS NOT OTHERWISE NOTED	TBD BY VENDOR (VARIES)			
⟨N⟩	MENU BOARDS (ON SOFFIT)	480 LBS	EXTEND 4" ABOVE AND BELOW EXTENTS OF MENU	EXTENT OF MENUS, EXTEND 4" ON EITHER SIDE . REFER TO BLOCKING DETAIL.	

CAFE

BACKBAR

ALIGN

9' - 1"

5-T-N 7

4 ALIGN

16' - 3"

69' - 11 1/2" (12)

KEYED NOTES

- 1. LL PROVIDED ELECTRICAL PANEL LOCATIONS. MAINTAIN MINIMUM CLEARANCE AS REQUIRED BY CODE.
- 2. INSTALL NEW CONCRETE SLAB OVER VAPOR BARRIER OVER EXISTING COMPACTED FILL.
- 3. GC TO INSTALL NEW INTERIOR DOORS AS INDICATED. SEE SHEET A602 FOR DOOR AND HARDWARE TYPE.
- 4. ALIGN FACE OF FINISHED WALL.
- 5. SHELF FOR WATER HEATER ABOVE. REFER TO INTERIOR ELEVATION FOR HEIGHT AND DETAILS FOR CONSTRUCTION OF PLATFORM AND SUPPORTING ASSEMBLY.
- 6. EXTERIOR DOORS AND HARDWARE BY LL. PER STARBUCKS SPECIFICATION.
- 7. FUR OUT INTERIOR FACE OF WALL.

D 10205 89

2 A101

- 8. INDICATES SOFFIT ABOVE.
- 9. EDGE OF EXISTING PERIMETER SLAB INSTALLED BY LL. GC TO CLEAN AND SCARIFY, APPLY EPOXY BONDING AGENT AT EDGE PRIOR TO INSTALLATION OF NEW CONCRETE. INSTALL INTERIOR CONCRETE SLAB AS SPECIFIED IN LL STRUCTURE DRAWINGS DATED 04/24/2020.
- 10. LL TO PROVIDE GYPSUM BOARD WALL THROUGHOUT AS INDICATED.
- 11. GC TO FIELD VERIFY INCOMING WATER SERVICE EQUIPMENT AND CLEARANCES.
- 12. GC TO VERIFY OVERALL DIMENSIONS OF SPACE PRIOR TO LAYING OUT WALLS. CONTACT ARCHITECT IMMEDIATELY IF DISCREPANCIES OCCUR.

GENERAL NOTES

- A. GENERAL CONTRACTOR TO VERIFY ALL DIMENSIONS AND NOTIFY STARBUCKS CONSTRUCTION MANAGER OF ANY DISCREPANCIES PRIOR TO CONSTRUCTION. ALL DIMENSIONS TO BE TAKEN FROM DESIGNATED DATUM POINT.
- B. GENERAL CONTRACTOR TO PROVIDE FIRE TREATED WOOD STUD BLOCKING, OR EQUIVALENT TO SUPPORT ANY WALL ATTACHMENT AND/OR SIGNAGE.
- C. IF EXISTING EXTERIOR ENTRANCE THRESHOLD EXCEEDS MINIMUM BARRIER FREE PROVISION OF THE CODE, REMOVE AND REPLACE WITH ACCESSIBLE THRESHOLD. RAISED THRESHOLDS AND FLOOR LEVEL CHANGES AT ACCESSIBLE DOORWAYS TO BE BEVELED WITH A SLOPE NO GREATER THAN 1:12.
- D. ALL DIMENSIONS ARE TO FINISHED FACE UNLESS SHOWN OR NOTED OTHERWISE.
- E.. INSTALL MOISTURE RESISTANT GREEN BOARD ON BACKBAR WALL PER PROJECT MANUAL.
- F. ALL DOORS SHALL BE 32" (815MM) MINIMUM CLEAR OPENING WHEN OPENED TO 90 DEGREE POSITION UNLESS OTHERWISE NOTED.
- G. SEE SHEET A601 FOR EXTERIOR DOOR AND WINDOW SCHEDULES.
- H. STARBUCKS VENDOR TO PROVIDE DOOR HARDWARE COMPONENTS AND GC TO INSTALL.
- I. VERIFY ALL EXISTING DOORS, HARDWARE AND FRAMES
- MEET STARBUCKS AND/OR CODE REQUIREMENTS.
- J. PROVIDE FIRE EXTINGUISHERS AS NOTED ON THE APPROVED PLANS FROM THE CITY.
- K. REFER TO SHEET I104 FOR FLOOR FINISHES.

GENERAL LEGEND

NEW FULL HEIGHT WALL NEW PARTIAL HEIGHT WALL **EXISTING WALL**

WALL BLOCKING CALL-OUT

WALL SHEATHING CALL-OUT

EXISTING 2H FIRE RATED DEMISING WALL

X-X-X WALL TAG D XXXXXX XX DOOR TAG

WALL SHEATHING KEY

WALL SHEATHING KET						
SYMBOL	DESCRIPTION					
A	INDICATES SHEATHING TRANSITION					
A	INDICATES SHEATHING					
В	GYPSUM BOARD (TERMINATE					
c	5/8" CEMENTITIOUS BACKER BOARD (TERMINATE AT 6" (150MM) ABOVE CEILING)					

3-T-A

CORRIDOR WALL DETAIL

| Scale: 1" = 1'-0"

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WRITTEN AGREEMENT IS FULLY EXECUTED BY BOTH PARTIES. STARBUCKS TEMPLATE VERSION i2020-01-31





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Engineering Consultants Mechanical - Electrical - Plumbing



ISSUED DATE: 06/16/2020 EXPIRATION DATE: 12/31/2020

PRYOR, EIN DR.

BUILDOUT
COFFEE CHIPMAN STORE #: 62012 PROJECT #: SR. DESIGN MANAGER: K. GORIN SLONSKI PRODUCTION DESIGNER: A. HAHN CHECKED BY: NORR

BUILDING FLOOR PLAN

SCALE: AS SHOWN

SHEET NUMBER:

A101

(2)

KEYED NOTES

**GC TO VERIFY IF EXISTING STUB-UPS ARE IN WORKING CONDITION & MAY BE REUSED. GC TO CONNECT NEW SPECIALTY EQUIPMENT TO EXISTING STUB-UPS WHERE POSSIBLE. ADD ADDITIONAL STUB-UPS/ROUGH-INS AS REQUIRED.

- 1. (3) 1/2" CONDUIT FOR PHONE, DATA, AND POWER FROM POS TO BE ROUTED TO CENTERLINE OF IT RACK AT MANAGERS DESK AS INDICATED. (1) 3/4" CONDUIT FOR DATA AT MANAGER'S DESK. STUB UPS TO BE WITHIN NEW PARTITION WALL. SEE MANAGER'S DESK DETAIL FOR MORE INFORMATION.
- 2. LOCATION OF INCOMING WATER SERVICE BY LL.
- 3. ELECTRICAL STUB-UP LOCATION. SEE ELECTRICAL SHEETS FOR MORE INFORMATION.
- 4. PLUMBING STUB-UP LOCATION. SEE PLUMBING SHEETS FOR MORE INFORMATION.
- 5. FLOOR SINK LOCATION. SEE PLUMBING SHEETS FOR MORE INFORMATION.
- 6. FLOOR DRAIN LOCATION. SEE PLUMBING SHEETS FOR MORE INFORMATION.
- 7. FLOOR ELECTRICAL J-BOX. SEE ELECTRICAL SHEETS FOR MORE INFORMATION. COORDINATE WITH BANQUETTE SPECIFICATIONS.
- 8. GC TO PROVIDE POWER & DATA FOR FUTURE DIGITAL MENU BOARDS PER STARBUCKS STANDARD REQUIREMENTS. REFER TO INTERIOR ELEVATIONS & DETAILS FOR MORE INFORMATION.
- 9. ELECTRICAL PANEL LOCATION BY LL.
- 10. NEW ELECTRICAL WALL OUTLET TO BE INSTALLED AS INDICATED. SEE INTERIOR ELEVATIONS AND ELECTRICAL SHEETS FOR MORE INFORMATION.
- 11. NEW SINK CONNECTION. REFER TO PLUMBING SHEETS FOR MORE INFO.
- 12. NEW WASTELINE PENETRATION AS INDICATED. REFER TO
- 13. DATUM FOR BACKBAR.
- 14. DATUM FOR WORKROOM AND RESTROOMS.

PLUMBING SHEETS FOR MORE INFORMATION.

- 15. DATUM FOR CAFE.
- 16. SWITCHING LOCATION. SEE ELECTRICAL SHEETS.
- 17. EXTERIOR COVERED GFCI ELECTRICAL OUTLET BY LL.
- 18. QUAD RECEPTACLE BEHIND CONDIMENT CART FOR FUTURE FLEXIBILITY

GENERAL NOTES

- A. ALL STUB-UP DIMENSIONS ARE RELATIVE TO FINISHED WALL LOCATIONS (SHOWN AS OUTLINES ON THIS PLAN). REFER TO FLOOR PLAN FOR WALL PLACEMENT.
- B. FLOOR SINK: REFER TO CUT SHEETS FOR COMPONENT SPECIFICATIONS AND CUTOUT REQUIREMENTS.
- C. WASTE LINE PENETRATIONS: REFER TO PLUMBING PLANS FOR INDIVIDUAL LINE LOCATIONS.
- D. STUB-UP PENETRATIONS: REFER TO ELECTRICAL AND PLUMBING PLANS FOR INDIVIDUAL STUB-UP LOCATIONS.
- E. TOILET FLOOR PENETRATION: REFER TO CUT SHEETS FOR STUB-UP LOCATION RELATIVE TO FINISHED WALL.
- F. PENETRATION TO BE LOCATED ON CENTERLINE OF

WALL OR AS REQUIRED PER CONDITIONS.

- G. TRENCHING OUTLINE FOR GUIDELINE USE ONLY. GENERAL CONTRACTOR TO COORDINATE WITH SPECIFIC TRADES AND SITE CONDITIONS TO DETERMINE ACTUAL LAYOUT.
- H. REFER TO SHEET I104 FOR FLOOR FINISHES.

LEGEND

EXISTING WALL CONCRETE LEAVE-OUT

DATUM POINT

NEW FLOOR SINK

NEW FLOOR DRAIN FLOOR PENETRATION

PLUMBING PENETRATION AREA

ELECTRICAL PENETRATION AREA

NEW FLOOR DUPLEX

NEW WALL DUPLEX RECEPTACLE

NEW QUADPLEX RECEPTACLE

NEW DATA RECEPTACLE

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Engineering Consultants Mechanical - Electrical - Plumbing



ISSUED DATE: 06/16/2020 EXPIRATION DATE: 12/31/2020

⊘ ∞ PROJECT NAME: BUILDOUT COFFEE CHIPMAN


VEST PRYOR, I ENSTEIN DR. MO

STORE #: 62012 PROJECT #: 87799-001 ISSUE DATE: 06-16-2020 SR. DESIGN MANAGER: K. GORIN SLONSKI PRODUCTION DESIGNER: A. HAHN CHECKED BY:

BUILDING FLOOR PENETRATION PLAN SCALE: AS SHOWN

SHEET NUMBER:

A102

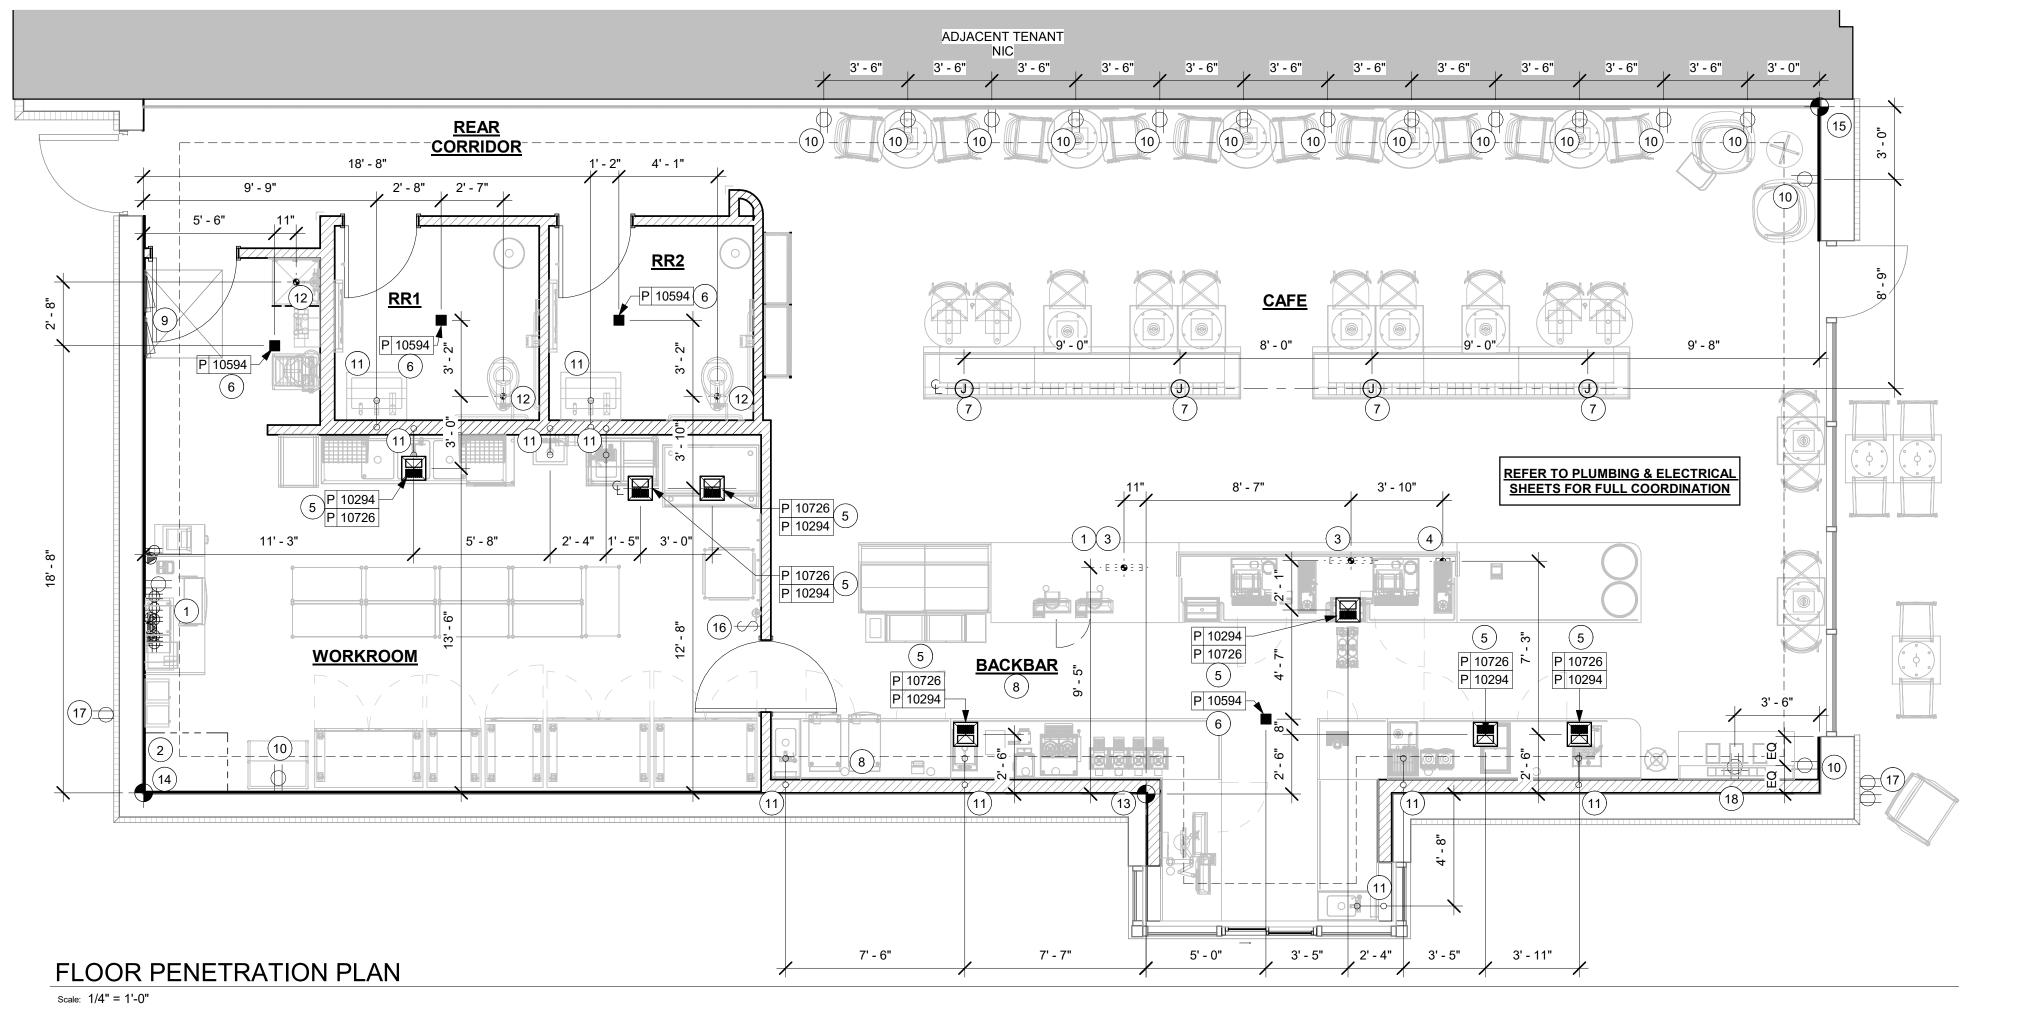

South Elevation

Scale: 1/4" = 1'-0"

NOTE: ALL SIGNAGE UNDER SEPARATE PERMIT, SHOWN FOR COORDINATION PURPOSES ONLY.

INTERIOR WHITE FAUX

NEON WORDMARK

STARBUCKS

EXTERIOR WORDMARK DETAIL

KEYED NOTES

- PROVIDE 3" (75MM) HIGH BLACK ACRYLIC STORE ADDRESS ON GLAZING OR PER LOCAL JURISDICTIONAL CODE REQUIREMENTS.
- 2. LL TO PROVIDE J-BOX W/ PULL STRING FOR FUTURE BUILDING SIGNAGE.
- 3. GC TO PROVIDE SIGNAGE DISCONNECT.
- 4. 3/4" MARINE GRADE PLYWOOD BLOCKING FOR EXTERIOR SIGNAGE. EXTEND OF BLOCKING 8" (205MM) MIN. BEYOND EDGE OF SIGNAGE.
- 5. DRIVE-THRU WINDOW, AIR CURTAIN, AND HAND OFF SHELF TO BE PROVIDED AND INSTALLED BY LL PER SBUX SPECIFICATIONS. LL TO VERIFY OPENING DIRECTION.
- 6. INDICATES EXTENT OF STARBUCKS LEASE.
- NEW BUILDING CANOPY BY LL. LL TO PROVIDE IN WALL BLOCKING AS NECESSARY AND RECESSED CAN LIGHTS PER LLWL. BUILDING CANOPY TO EXTEND A MINIMUM OF 4'-0" FROM EXTERIOR WALL PER LLWL.
- 8. OUTLINE OF ROOF BEYOND.
- 9. LL TO PROVIDE GFI EXTERIOR PATIO OUTLET FOR CUSTOMER USE.
- 10. LL TO PROVIDE KEYED, FROST-FREE RECESSED PATIO HOSE BIB PER LLWL REQUIREMENTS.
- 11. NEW SCONCES BY LL PER SBUX SPECIFICATIONS.
- 12. LL TO PROVIDE POWER FOR PATIO STRING LIGHTS AND WALL MOUNTED FAN.
- 13. PATIO FAN. LL TO PROVIDE ELECTRICAL POWER.
- 14. UTILITY SCREEN BY LL PER LLWL REQUIREMENTS.
- 15. PATIO STRING LIGHTS POWER BY LL.
- 16. PATIO PLANTERS & LANDSCAPING BY LL.
- 17. EXTERIOR SPEAKER BY TENANT

GENERAL NOTES

- A. GENERAL CONTRACTOR TO COORDINATE AND SCHEDULE SIGNAGE INSTALLATION WITH THE SIGNAGE CONTRACTOR PROVIDING A MINIMUM SCHEDULING NOTICE OF 4 WEEKS AND 1 WEEK PRIOR TO SCHEDULED DATE OF INSTALLATION. CONSTRUCTION MANAGER TO PROVIDE GENERAL CONTRACTOR WITH SIGNAGE CONTRACTOR CONTACT INFORMATION.
- B. GENERAL CONTRACTOR SHALL COORDINATE WITH ELECTRICAL CONTRACTOR TO FURNISH AND INSTALL ELECTRICAL CIRCUITS INCLUDING ALL CONDUIT, WIRE, CONNECTIONS AND BREAKER AT PANEL BOARD NECESSARY TO SERVE SIGNAGE.
- C. GENERAL CONTRACTOR TO PROVIDE FIRE TREATED WOOD STUD BLOCKING OR EQUIVALENT TO SUPPORT
- D. SIGNAGE CONTRACTOR SHALL VERIFY SIZE AND LOCATION OF ANY AND ALL ALLOWABLE MONUMENT OR POLE SIGNAGE AND PROVIDE SHOP DRAWING(S) PRIOR TO FABRICATION TO THE STARBUCKS DESIGNER FOR APPROVAL.
- E. SIGNAGE CONTRACTOR TO INSTALL SIGNAGE IN COMPLIANCE WITH LOCAL CODES AND OBTAIN PERMIT.
- F. SIGNAGE CONTRACTOR TO SUPPLY SHOP DRAWINGS TO CONSTRUCTION MANAGER AND TO THE GENERAL CONTRACTOR AS NEEDED. GENERAL CONTRACTOR TO NOTIFY CONSTRUCTION MANAGER IMMEDIATELY IF SHOP DRAWINGS OR INSTALLATION IS IN DISCREPANCY WITH ARCHITECTURAL DRAWINGS.
- G. GENERAL CONTRACTOR TO CLEAN, PATCH AND REPAIR EXISTING EXTERIOR AS REQUIRED.

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LEGEND - EXT. ELEV.

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STARBUCKS TEMPLATE VERSION i2020-01-31

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ISSUED DATE: 06/16/2020 EXPIRATION DATE: 12/31/2020

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BUILDOU COFFEE CHIPMAI STORE #: 62012 PROJECT #: 87799-001 ISSUE DATE: SR. DESIGN MANAGER: K. GORIN SLONSKI PRODUCTION DESIGNER: A. HAHN CHECKED BY: NORR

BUILDING EXTERIOR ELEVATIONS SCALE: AS SHOWN

SHEET NUMBER:

A201

EQ EQ 4' - 6" L 20711 L 20711 L 20711 L 20711

NOTE: ALL SIGNAGE UNDER SEPARATE PERMIT, SHOWN FOR COORDINATION PURPOSES ONLY.

A. GENERAL CONTRACTOR TO COORDINATE AND SCHEDULE

GENERAL NOTES

- SIGNAGE INSTALLATION WITH THE SIGNAGE CONTRACTOR PROVIDING A MINIMUM SCHEDULING NOTICE OF 4 WEEKS AND 1 WEEK PRIOR TO SCHEDULED DATE OF INSTALLATION. CONSTRUCTION MANAGER TO PROVIDE GENERAL CONTRACTOR WITH SIGNAGE CONTRACTOR CONTACT INFORMATION.
- B. GENERAL CONTRACTOR SHALL COORDINATE WITH ELECTRICAL CONTRACTOR TO FURNISH AND INSTALL ELECTRICAL CIRCUITS INCLUDING ALL CONDUIT, WIRE, CONNECTIONS AND BREAKER AT PANEL BOARD NECESSARY TO SERVE SIGNAGE.
- C. GENERAL CONTRACTOR TO PROVIDE FIRE TREATED WOOD STUD BLOCKING OR EQUIVALENT TO SUPPORT
- D. SIGNAGE CONTRACTOR SHALL VERIFY SIZE AND LOCATION OF ANY AND ALL ALLOWABLE MONUMENT OR POLE SIGNAGE AND PROVIDE SHOP DRAWING(S) PRIOR TO FABRICATION TO THE STARBUCKS DESIGNER FOR APPROVAL.
- E. SIGNAGE CONTRACTOR TO INSTALL SIGNAGE IN COMPLIANCE WITH LOCAL CODES AND OBTAIN PERMIT.
- F. SIGNAGE CONTRACTOR TO SUPPLY SHOP DRAWINGS TO CONSTRUCTION MANAGER AND TO THE GENERAL CONTRACTOR AS NEEDED. GENERAL CONTRACTOR TO NOTIFY CONSTRUCTION MANAGER IMMEDIATELY IF SHOP DRAWINGS OR INSTALLATION IS IN DISCREPANCY WITH ARCHITECTURAL DRAWINGS.
- G. GENERAL CONTRACTOR TO CLEAN, PATCH AND REPAIR EXISTING EXTERIOR AS REQUIRED.

KEYED NOTES

- 1. NEW SCONCES BY LL PER SBUX SPECIFICATIONS.
- 2. LL TO PROVIDE J-BOX W/ PULL STRING FOR FUTURE BUILDING SIGNAGE.
- 3. LL TO PROVIDE SIGNAGE DISCONNECT.
- 4. 3/4" MARINE GRADE PLYWOOD BLOCKING FOR EXTERIOR SIGNAGE. EXTEND OF BLOCKING 8" (205MM) MIN. BEYOND EDGE OF SIGNAGE.
- 5. DRIVE-THRU WINDOW, AIR CURTAIN, AND HAND OFF SHELF TO BE PROVIDED AND INSTALLED BY LL PER SBUX SPECIFICATIONS. LL TO VERIFY OPENING DIRECTION.
- 6. INDICATES EXTENT OF STARBUCKS LEASE.
- 7. NEW BUILDING CANOPY BY LL. LL TO PROVIDE IN WALL BLOCKING, AS NECESSARY, AND RECESSED CAN LIGHTS PER LLWL. BUILDING CANOPY TO EXTEND A MINIMUM OF 4'-0" FROM EXTERIOR WALL PER LLWL.
- 8. OUTLINE OF ROOF BEYOND.
- 9. LL TO PROVIDE GFI EXTERIOR OUTLET PER LLWL REQUIREMENTS.
- 10. LL TO PROVIDE KEYED, FROST-FREE RECESSED HOSE BIB PER LLWL REQUIREMENTS.
- 11. SECURITY LIGHT BY LL.
- 12. ROOF SCUPPER AND OVERFLOW BY LL
- 13. ELECTRICAL METERS BY LL PER LL DRAWINGS.
- 14. UTILITY SCREEN BY LL PER LLWL REQIREMENTS.

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Engineering Consultants Mechanical - Electrical - Plumbing



ISSUED DATE: 06/16/2020

EXPIRATION DATE: 12/31/2020 **⊘** ⊗

VEST PRYOR, I ENSTEIN DR. MO

BUILDOUT
COFFEE CHIPMAN 62012 87799-001

PROJECT #: SR. DESIGN MANAGER: K. GORIN SLONSKI PRODUCTION DESIGNER: A. HAHN CHECKED BY: NORR


BUILDING EXTERIOR ELEVATIONS

SHEET NUMBER:

SCALE: AS SHOWN

STORE #:

A202

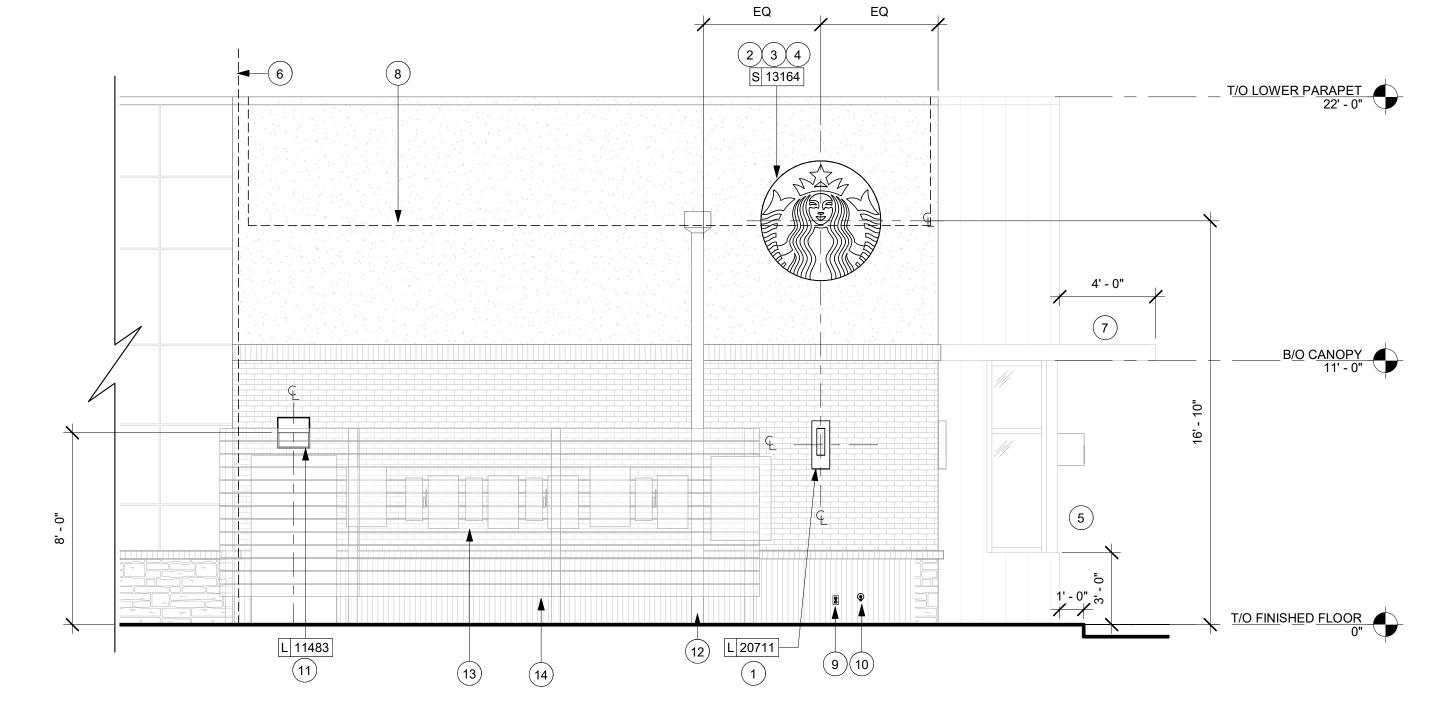

WEST ELEVATION 1 VVESIEI
Scale: 1/4" = 1'-0"

EXTERIOR SIGNAGE SCHEDULE - "S"							
DESIGN ID	COUNT	DESCRIPTION	FURN. BY	INST. BY	COMMENTS		
SIGNAGE - I	DISK			•			
13164	1	SIGN - DISK SF ILLUMINATED FLUSH MOUNTED EVOLVED - 60IN 1525MM	SB	LL/ HILTON	LL TO PROVIDE BLOCKING AND CONDUIT AS REQUIRED		
SIGNAGE - I	ORIVE THRU	j		•			
14091	1	SIGN - DT DIRECTIONAL EXIT SIGN ILLUMINATED ARROW SERIES - 46IN 1170MM	SB	GC/LL	LL TO FURNISH AND INSTALL CONCRETE FOOTINGS, ANCHOR BOLTS, AND ELECTRICAL CONDUIT PER LLWL. GC TO COORDINATE WITH SBUX VENDOR		
14106	1	SIGN - DT CLEARANCE BAR ARROW SERIES FREESTANDING	SB	GC/LL	LL TO FURNISH AND INSTALL CONCRETE FOOTINGS AND ANCHOR BOLTS PER LLWL. GC TO COORDINATE WITH SBUX VENDOR		
SIGNAGE - (OTHER		'	•			
19388	2	SIGN - 10 MINUTE PARKING	SB	LL/ HILTON	FOOTING & POST BY LL. SIGN BY SBUX SIGNAGE VENDOR		
X0002	1	MONUMENT SIGN PANELS	SB/ HILTON	HILTON/ LL	BASE SIGN FOOTING AND ELECTRICAL BY LL. PANELS BY SIGNAGE VENDOR. LL TO COORDINATE WITH SIGNAGE VENDOR		
SIGNAGE - V	NORDMAR	<	•				
X0007	1	SIGN - FAUX NEON GREEN WORDMARK STARBUCKS WITH WHITE INTERIOR & SURROUND. FLUSH MOUNTED - 18IN 455MM	SB	LL/ HILTON	FAUX NEON GREEN WORDMARK. LL TO PROVIDE CONDUIT AND BLOCKING AS REQUIRED.		

		SITE SCHED	ULE - "Y"		
DESIGN ID	COUNT	DESCRIPTION	FURN. BY	INST. BY	COMMENTS
EXTERIOR I	MENU	•			
14116	1	MENU BOARD - DT DIGITAL ORDER SCREEN - FLAT BLACK MT0028	SB	SB/GC	SUPPLIER: IT EQUIPMENT VENDOR (ZONE SCREEN INSTALLER: REGIONAL SIGNAGE VENDOR. ELECTRICAL: GC CONNECTS DC WHIPS & STUB-UPS TO DCB.
14119	1	MENU BOARD - DT 5 PANEL FREESTANDING - 108X65IN 2745X1650MM - FLAT BLACK MT0028	SB	SB	SUPPLIER: DT SIGNAGE VENDOR (DSA). INSTALLER: REGIONAL SIGNAGE VENDOR LL TO PROVIDE CONDUIT, FOOTING, AND ANCHOR BOLTS PER LLWL.
14120	1	MENU BOARD - DT PRE MENU FREESTANDING - 36X65IN 915X1650MM - FLAT BLACK MT0028	SB	SB	PROVIDED AND INSTALLED BY SIGNAGE VENDOR. LANDLORD GC TO PROVIDE FOOTING & ELECTRICAL AS SPECIFIED PELLWL.
15700 1 MENU BOARD - DT DIGITAL ORDER SCREEN CONTROL BOX		SB	SB/GC	SUPPLIER: IT EQUIPMENT VENDOR (ZONE: INSTALLER: REGIONAL SIGNAGE VENDOR ELECTRICAL CONNECTION: GC. LL TO PROVIDE FOOTING, CONDUIT, AND ANCHOBOLTS PER LLWL.	
OTHER					
14103	11	BOLLARD NONILLUMINATED SQUARE - FLAT BLACK MT0028	LL	LL	SUPPLIER/INSTALLER: LL. DSA PHOTOTEC SEE DETAILS.
14163 1 DT ORDER POINT CANOPY FREESTANDING - FLAT BLACK MT0028		SB	SB	SUPPLIER: DT SIGNAGE VENDOR (DSA). INSTALLER: REGIONAL SIGNAGE VENDOR. LL TO PROVIDE AND INSTALL CONDUIT, FOOTING, AND ANCHOR BOLTS PER LLWL.	
18818	4	LIGHT POLE - 10FT 300CM - FLAT BLACK MT0028	LL	LL	
18820	4	LIGHT POLE BASE PLATE - FLAT BLACK MT0028	LL	LL	
X0001 2 VEHICLE DETECTOR LOOP		SB	GC/LL	SUPPLIER: DT AUDIO VENDOR (HME). INSTALLER:GC. LL TO PROVIDE CONDUIT PER LLWL.	
X0004	5	PLANTER BOXES - 84X36X18IN	LL	LL	LL TO PROVIDE DRAINAGE AND AUTOMATED IRRIGATION PER LLWL REQUIREMENTS. LL TO PROVIDE SPEC TO DESIGNER FOR APPROVAL.
X0008	1	BIKE RACK - OLYMPIA	LL	LL	FORMS & SURFACES: OLYMPIA BIKE RACK WWW.FORMS-SURFACES.COM; INSTALL PER MANUFACTURER'S RECOMMENDATIONS.
X0009	20	NATIVE PLANTS FOR PLANTER BOXES	LL	LL	LANDSCAPING SELECTION AND QTY VERIFICATION BY LANDLORD. PROVIDE DRAUGHT-RESISTANT, NATIVE PLANTS WITH MINIMUM MAINTENANCE REQUIREMENTS.
UMBRELLA					
12147	3	UMBRELLA - BASE 95LB 43KG - FLAT BLACK MT0028	SB	GC	
20075	3	UMBRELLA - WITHOUT VALANCE - 6FT 183CM - BLACK CANVAS WITH WORDMARK F0061	SB	GC	

RESPONSIBILITY

GC GENERAL CONTRACTOR LL LANDLORD SB STARBUCKS



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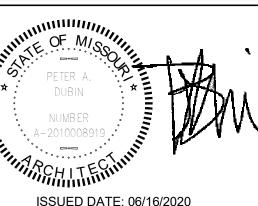
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LOT WEST PRYOR, L WENSTEIN DR. IT, MO JUNTY

PROJECT NAME:

BUILDOUT

COFFEE - N

CHIPMAN -STORE #: 62012 PROJECT #: 87799-001

ISSUE DATE: 06-16-2020
SR. DESIGN MANAGER: K. GORIN SLONSKI
PRODUCTION DESIGNER: A. HAHN
CHECKED BY: NORR

Rev	vision	Schedule
Rv		Doscr

Rev Date

SCHEDULES

SCALE: AS SHOWN

SHEET NUMBER:

A601

LEGEND


	DOOR SCHEDULE - "D"									
DESIGN ID	MARK	DESCRIPTION	WIDTH	HEIGHT	HARDWARE SET	FURN BY	INST BY	COMMENTS		
Exterior	Exterior									
21147	88	DOOR - SINGLE SERVICE - 42IN 1070MM	3' - 6"	7' - 0"	42	LL		LL TO INSTALL AND PROVIDE TENANT SPECIFIED DOOR HARDWARE ON EXTERIOR DOORS AS INDICATED. FINISH: SW7748		
10205	89	DOOR - STOREFRONT METAL FRAME SINGLE - TYPE B	3' - 0"	8' - 0"	2-A	LL		LL TO INSTALL AND PROVIDE TENANT SPECIFIED DOOR HARDWARE ON EXTERIOR DOORS AS INDICATED		
2 Interior	2 Interior									
10190	83	DOOR - SINGLE FLUSH - 36IN	3' - 0"	7' - 0"	6	SB	GC	FINISH: PL0027 FRAME FINISH: SW7748		
10190	84	DOOR - SINGLE FLUSH - 36IN	3' - 0"	7' - 0"	6	SB	GC	FINISH: PL0027 FRAME FINISH: SW7748		
X0031	85	DOOR - SINGLE FLUSH - 42IN	3' - 6"	7' - 0"	15	SB	GC	FINISH: PL0027 FRAME FINISH: SW7748		
10086	82	DOOR - SINGLE IMPACT DOUBLE ACTING - 36IN 915MM	3' - 0"	7' - 0"	11	SB	GC	PROVIDED BY LOCKNET. ELIASON SCP-8 DOOR. FINISH: PL0027 FRAME FINISH: SW7030		

DOOR LEGEND

EXTERIOR

SINGLE


SERVICE

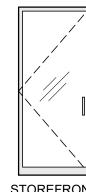


METAL FRAME

(TYPE B)

SINGLE

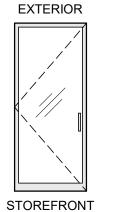

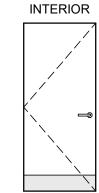

SINGLE FLUSH

WINDOW SCHEDULE - "W"							
DESIGN ID	COUNT	DESCRIPTION	FURN. BY	INST. BY	COMMENTS		
WINDOW							
14077	1	WINDOW - DT WITH OPEN TRANSOM - 48X60IN 1205X1510MM - ALUMINUM	LL	LL	275 SERIES SINGLE PANEL SLIDER W/ MOER. LL TO VERIFY OPENING DIRECTION. USE IN CONJUNCTION WITH AA300-275 PASS THRU AIR CURTAIN SYSTEM. CONTACT: ANNA ELLIS, ANNA@READY-ACCESS.COM		

INTERIOR

SINGLE

IMPACT

DOUBLE

ACTING

No.	Item	Description	Manufacturer	Finish
3	Hanging Devices	TH2314/MPB91	McKinney	630
1	Securing Devices	CD35A-NL-OP Panic Device	Von Duprin	628/630
2	Securing Devices C607 7-Pin Core Combinated "A" Keyway		Falcon Lock	626
1	Securing Devices	curing Devices KB609-2 Cut Control Key "A" Keyway Falcon		
9	Securing Devices	KB632-2 Cut User Key "A" Keyway	Falcon Lock	
1	Securing Devices	C953 7-Pin Rim Cylinder Housing	Falcon Lock	626
1	Securing Devices	C987 7-Pin Mortise Cylinder Housing w/AR Cam	Falcon Lock	626
1	Securing Devices	A08794-003 Adjustable Ring, Mortise Cyl. 516-13/32	Falcon Lock	626
1	Operating Trim	108 Door Pull Handle	Rockwood	630
1	Closing Devices	8916 Door Closer 8916 AF89P	Dorma	689
1	Stops and Holders	473 Door Stop w/ Hook	Rockwood	626
1	Threshold	325 Half Saddle Threshold	National Guard	
1	Sign	Vinyl Sign: "THIS DOOR MUST REMAIN UNLOCKED WHEN BUILDING IS OCCUPIED"	Seton	

No.	Item	Description	Manufacturer	Finish
3	Hanging Items	TA2714/MPB79 Hinge MacPro Bearing 4.5 x 4.5	McKinney	626
1	Securing Devices	PB5425LN Lock, Shallow Coin Turn, Privacy PB5425LN-693-497 1-3/4	Yale Lock	626
1	Closing Devices	8916 Door Closer 8916 AF89P	Dorma	689
2	Protective Trim Units	K1050 B4E Kickplate 8" x 34" Each Side 32D	Rockwood	630
3	Accessories	GJ64 Rubber Silencer	Glynn Johnson	Gray
1	Stops and Holders	473 Door Stop w/ Hook	Rockwood	626

No. Item Description Manufacturer		DOOR HARDWARE SET NO. 11 - For workroom door at backbar							
	No.	Item	Description	Manufacturer	Finish				
1 Traffic Door Package SCP8 36" x 84" Eliason PL0027	1	Traffic Door Package	SCP8 36" x 84"	Eliason	PL0027				

No.	ltem	Description	Manufacturer	Finish	
3	Hanging Devices	TH2314/MPB91 Hinge MacPro Bearing 4.5 x 4.5	McKinney	630	
1	Securing Devices	C607 7-Pin Core Combinated "A" Keyway	Falcon Lock	626	
1	Securing Devices	I/O 2000L-03IC Auto Locking Door Alarm, IC; No CTR Includes Mortise Cylinder	Sur-Lock		
1	Closing Devices	8916 Door Closer 8916 AF89P	Dorma	689	
1	Protective Trim Units	K1050 B4E Kickplate 10" x 40"	Rockwood	630	
1	Accessories	137NA Weather Strip 20' 42" x 84"	National Guard	А	
1	Accessories	Door Sweep 18062CNB36	Pemko	А	
1	Miscellaneous Items	DS / 1000 Door Scope	Security Products	Silver	
1	Miscellaneous Items	MCV309NWHGL Door Bell	Nutone	As Selected	

No.	Item	Description	Manufacturer	Finish
3	Hanging Devices	TA2714/MPB79	McKinney	626
1	Securing Devices	B-PB5405LNIC Lever Storeroom LC B-PB5405LN-693-497 1-3/4	Yale Lock	626
1	Securing Deices	C607 7-Pin Core Combinated "A" Keyway	Falcon Lock	626
1	Closing Devices	8916 Door Closer 8916 AF89P AL	Dorma	689
1	Protective Trim Units	K1050 B4E Kickplate 10" x 2" LDW	Rockwood	630
1	Accessories	137NA Weather Strip 17' 36" x 84"	National Guard	А
1	Stops and Holders	473 Door Stop w/ Hook	Rockwood	626

GENERAL NOTES

- A. STARBUCKS VENDOR TO PROVIDE DOOR HARDWARE COMPONENTS. GC TO INSTALL.
- B. SEE SHEET A101 FOR TAGGED LOCATION OF EXTERIOR DOORS AND WINDOWS.
- C. EGRESS SHALL NOT PASS THROUGH KITCHENS, STORAGE ROOMS, CLOSETS OR SIMILAR SPACES. (1014.2)
- D. PANIC AND FIRE EXIT HARDWARE, WHERE INSTALLED ON DOORS IN THIS BUILDING SHALL SATISFY THE FOLLOWING (1008.1.10):
- a) THE ACTUATION PORTION OF THE RELEASING DEVICE SHALL EXTEND AT LEAST ONE-HALF OF THE DOOR LEAF WIDTH.
- b) THE MAXIMUM UNLATCHING FORCE DOES NOT EXCEED 15 POUNDS (6.8 KG).
- c) PIVOTED OR BALANCED DOORS SHALL BE OF THE PUSH-PAD TYPE WHERE PANIC HARDWARE IS REQUIRED AND THE PAD SHALL NOT EXTEND ACROSS MORE THAN ONE-HALF OF THE DOOR WIDTH, MEASURED FROM THE LATCH SIDE.
- d) PANIC HARDWARE LISTED IN ACCORDANCE WITH UL 305.
- e) FIRE EXIT HARDWARE LISTED IN ACCORDANCE WITH UL 10C AND UL 305.



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WRITTEN AGREEMENT IS FULLY EXECUTED BY BOTH PARTIES.





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ISSUED DATE: 06/16/2020

EXPIRATION DATE: 12/31/2020 S ∞ T OF STARBUCKS
- NW PRYOR RD 8
I - LEE'S SUMMIT

LOT VEST PRYOR, I ENSTEIN DR. MO NTY PROJECT NAME:

BUILDOUT

COFFEE - N

CHIPMAN -


STORE #: 62012 PROJECT #: 87799-001

ISSUE DATE: 06-16-2020
SR. DESIGN MANAGER: K. GORIN SLONSKI
PRODUCTION DESIGNER: A. HAHN
CHECKED BY: NORR

WINDOW AND DOOR SCHEDULES & DETAILS SCALE: AS SHOWN

SHEET NUMBER:

A602

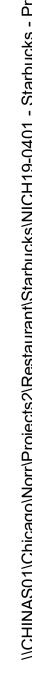


G 11135 վ**⊸** F|10756| E 10172 E 10172 <u>RR1</u> E 10859 E 10859 **⋖** E 10384 —E 10384 | E 10099 EX0011 EX0009 E 10099 → E X0011 E X0009 E 10769 E 10769 P X0010 F 10093 P 13040 P 13040 P 12951 -P X0012 P 12951 → →P X0012 E 10862 E 10862

ENLARGED RESTROOMS FF&E

FURNITURE, FIXTURES, AND EQUIPMENT PLAN

Scale: 1/2" = 1'-0"

Scale: 1/4" = 1'-0"

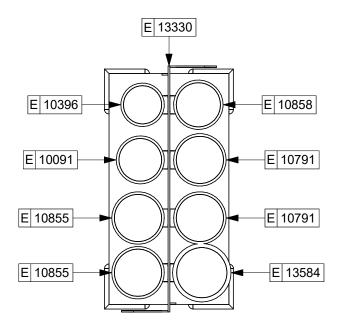

ENLARGED CUP CADDY

KEYED NOTES

- 1. INSTALL EXTERIOR FURNITURE THROUGHOUT AS SHOWN.
- 2. INSTALL CAFE FURNITURE THROUGHOUT AS SHOWN.
- 3. CONDIMENT CART. SEE INTERIOR FINISH ELEVATIONS.
- 4. PLACE MERCHANDISE FIXTURES AND RETAIL FLOOR BASKETS PER PLAN. STORE OPERATORS TO ORDER RETAIL FLOOR BASKETS.
- 5. MERCHANDISE DISPLAY. SEE DETAILS FOR MORE INFORMATION. CENTER MERCH. BAYS WITH CENTERLINE OF WALL BEHIND.
- 6. DO NOT BLOCK FOOD CASE INTAKE/EXHAUST.
- 7. SAFE LOCATED AT POS CABINET, SEE ELECTRICAL FOR ADDITIONAL INFORMATION.
- 8. HAND SINK W/ INTEGRAL SPLASH GUARD.
- 9. MANAGERS DESK. SEE MANAGER'S DESK/EQUIPMENT RACK ELECTRICAL DETAIL FOR ADDITIONAL INFORMATION.
- 10. REFER TO ENLARGED RESTROOM PLANS AND ELEVATIONS (SHEET I401) FOR FIXTURE LOCATIONS AND MOUNTING HEIGHTS.
- 11. LOCATION OF SWITCH GEAR AND THERMOSTAT CONTROLS.
- 12. SECURE LOCKERS TO WALL.
- 13. VENDOR TO INSTALL WATER FILTRATION SYSTEM PER MANUFACTURER'S REQUIREMENTS. GC TO PROVIDE PLUMBING AND ELECTRICAL REQUIREMENTS.
- 14. WATER HEATER LOCATED ABOVE. SEE PLUMBING DRAWINGS.

GENERAL NOTES

- A. GENERAL CONTRACTOR TO SCHEDULE WITH LOCAL REFRIGERATION CONTRACTOR TO CONDUCT INITIAL FOOD CASE START-UP AND TESTING. FOR LIST OF APPROVED START UP CONTRACTORS, CONTACT PROJECT CONSTRUCTION REPRESENTATIVE.
- B. THE SITE IS SERVED BY THE MUNICIPAL WATER AND SEWER SYSTEM UNLESS OTHERWISE NOTED.
- C. ALL FOOD STORAGE SHALL BE 6" (150mm) A.F.F.
- D. ALL WOOD SURFACES (DOORS, TRIM, SHELVES, CABINETS) SHALL BE SEALED.
- E. ALL EQUIPMENT AND INSTALLATION WILL MEET NATIONAL SANITATION FOUNDATION STANDARDS OR EQUIVALENT.
- F. ALL EQUIPMENT AND CABINETRY WILL BE FLUSH MOUNTED TO COUNTERS, WALLS OR FLOORS, OR BE RAISED TO ALLOW FOR CLEANING.
- G. CONFIRM ALL NECESSARY EQUIPMENT CLEARANCES PER PRODUCT CUT SHEET (E.G. ICE MACHINE).
- H. FOR LOCATION OF COUNTERTOP EQUIPMENT, REFER TO CASEWORK ELECTRICAL DETAILS.
- I. EQUIPMENT UNITS SHALL CONTAIN NO EXPOSED THREADS, EMBELLISHMENTS OR OVERHANGING EDGES THAT SERVE AS PLACES FOR ACCUMULATION OF DUST, DIRT AND DEBRIS.
- J. WARMING OVEN(S) SHOWN FOR PERMITTING PURPOSES. INSTALLATION AT STORE OPENING TO BE VERIFIED BY STARBUCKS CONSTRUCTION REPRESENTATIVE.
- K. EACH HAND WASHING SINK WILL HAVE A SINGLE SERVICE TOWEL AND SOAP DISPENSER, AND ALL HAND SINKS TO HAVE A COMBINATION FAUCET OR PREMIXING FAUCET.
- L. FOR PLUMBING FIXTURES. REFER TO THE PLUMBING DESIGN PLAN. FOR DATA DEVICE SCHEDULE, REFER TO THE ELECTRICAL DESIGN PLAN.
- M. SEE ELEVATIONS FOR DISTRIBUTION OF CUP DISPENSERS.



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STORE #: 62012 PROJECT #: 87799-001 ISSUE DATE: 06-16-2020 SR. DESIGN MANAGER: K. GORIN SLONSKI PRODUCTION DESIGNER: A. HAHN CHECKED BY:


BUILDOUT
COFFEE CHIPMAN

Revision Schedule

FF & E PLAN SCALE: AS SHOWN

SHEET NUMBER:


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KEYED NOTES

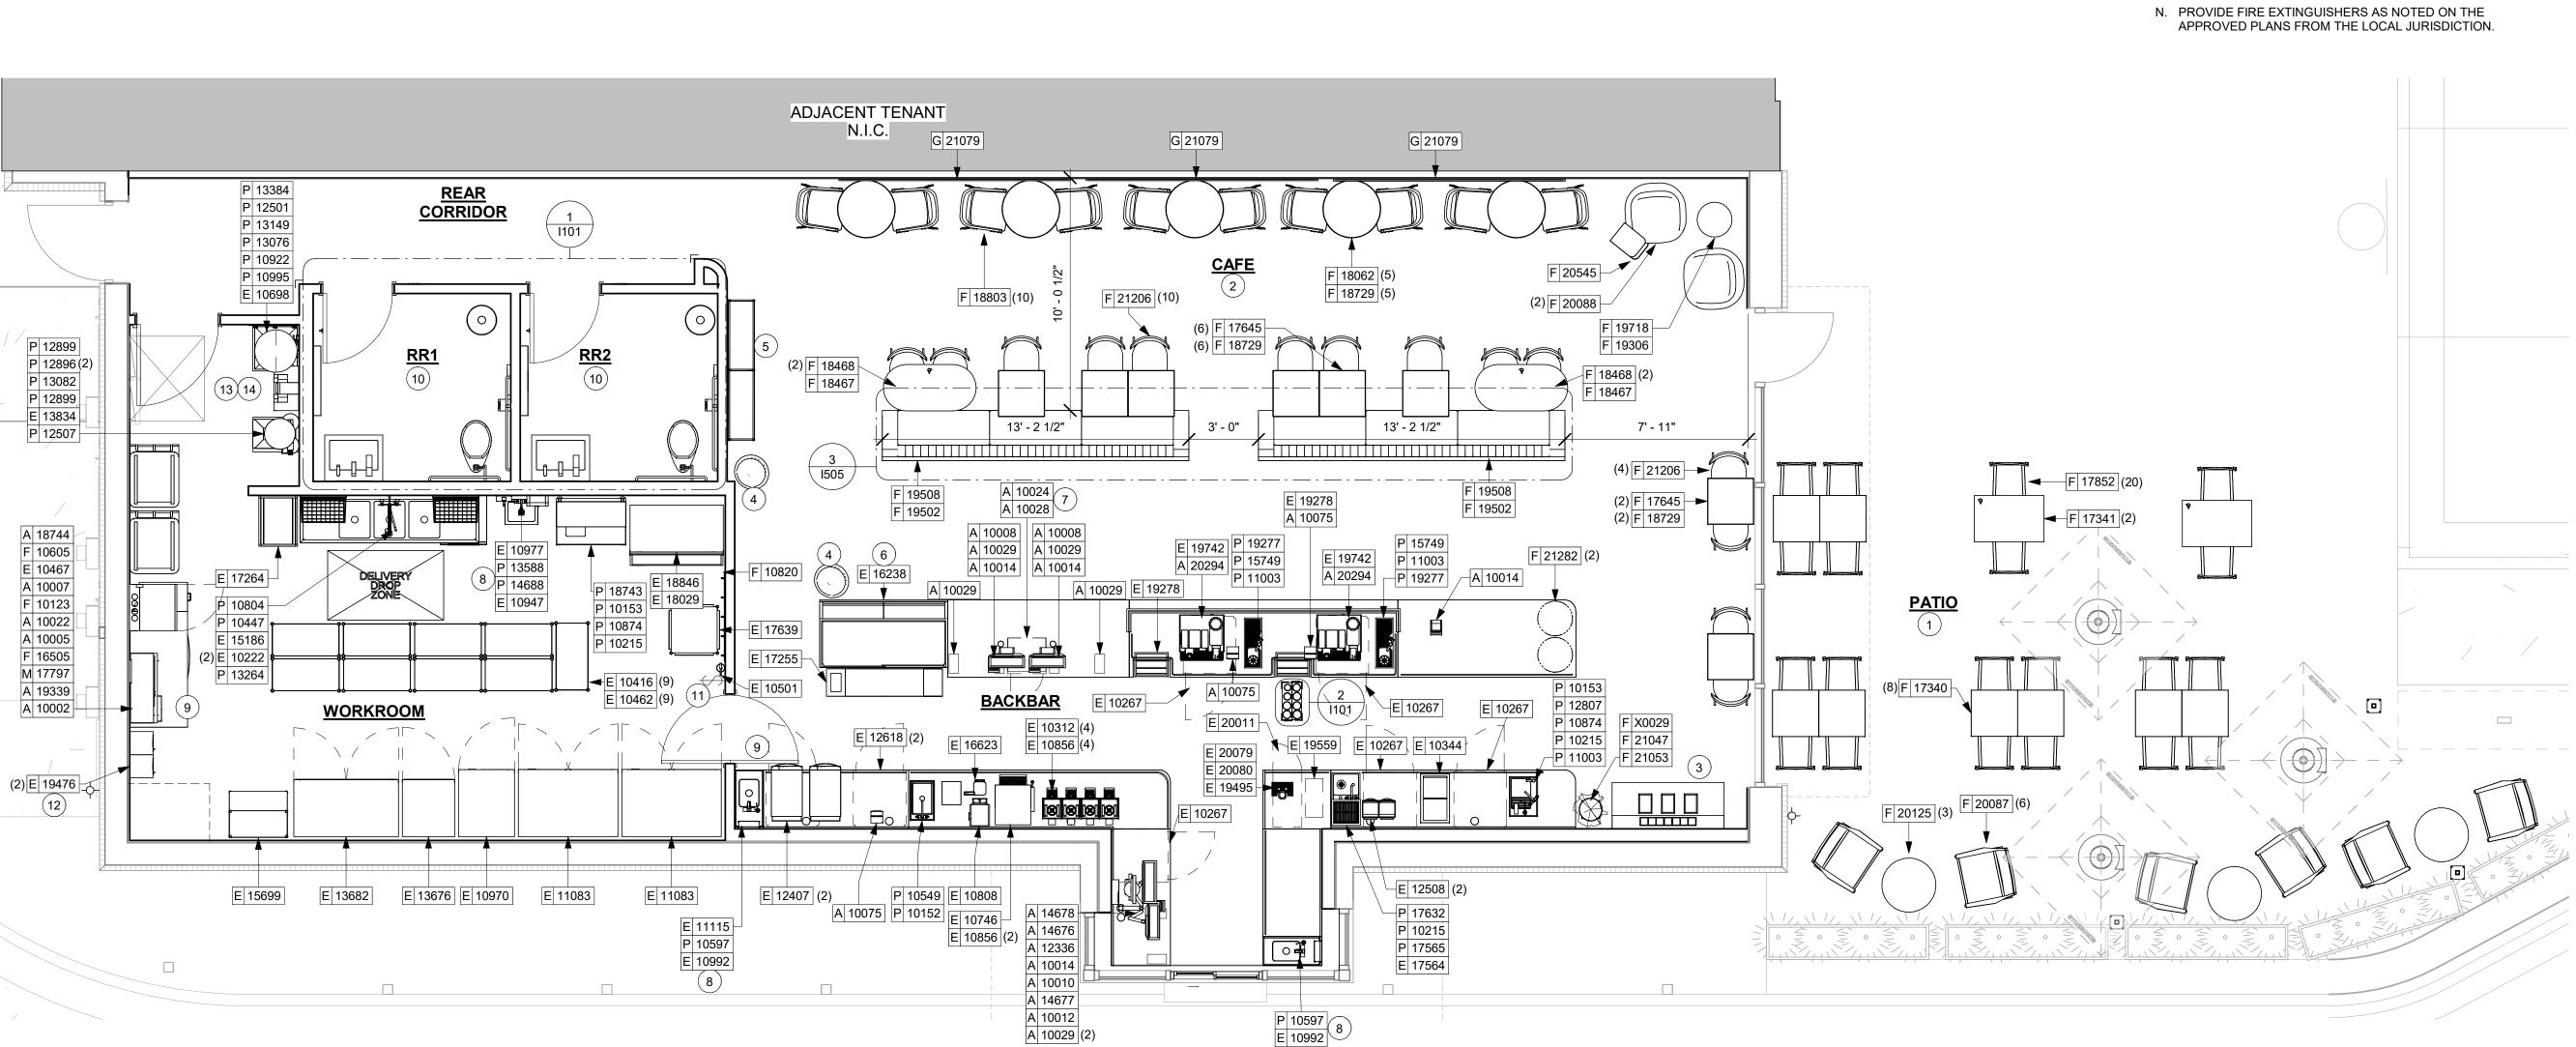1. FUNITURE STORAGE AREA



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BUILDOUT
COFFEE CHIPMAN STORE #: 62012 PROJECT #:

ISSUE DATE: 06-16-2020
SR. DESIGN MANAGER: K. GORIN SLONSKI
PRODUCTION DESIGNER: A. HAHN
CHECKED BY: NORR

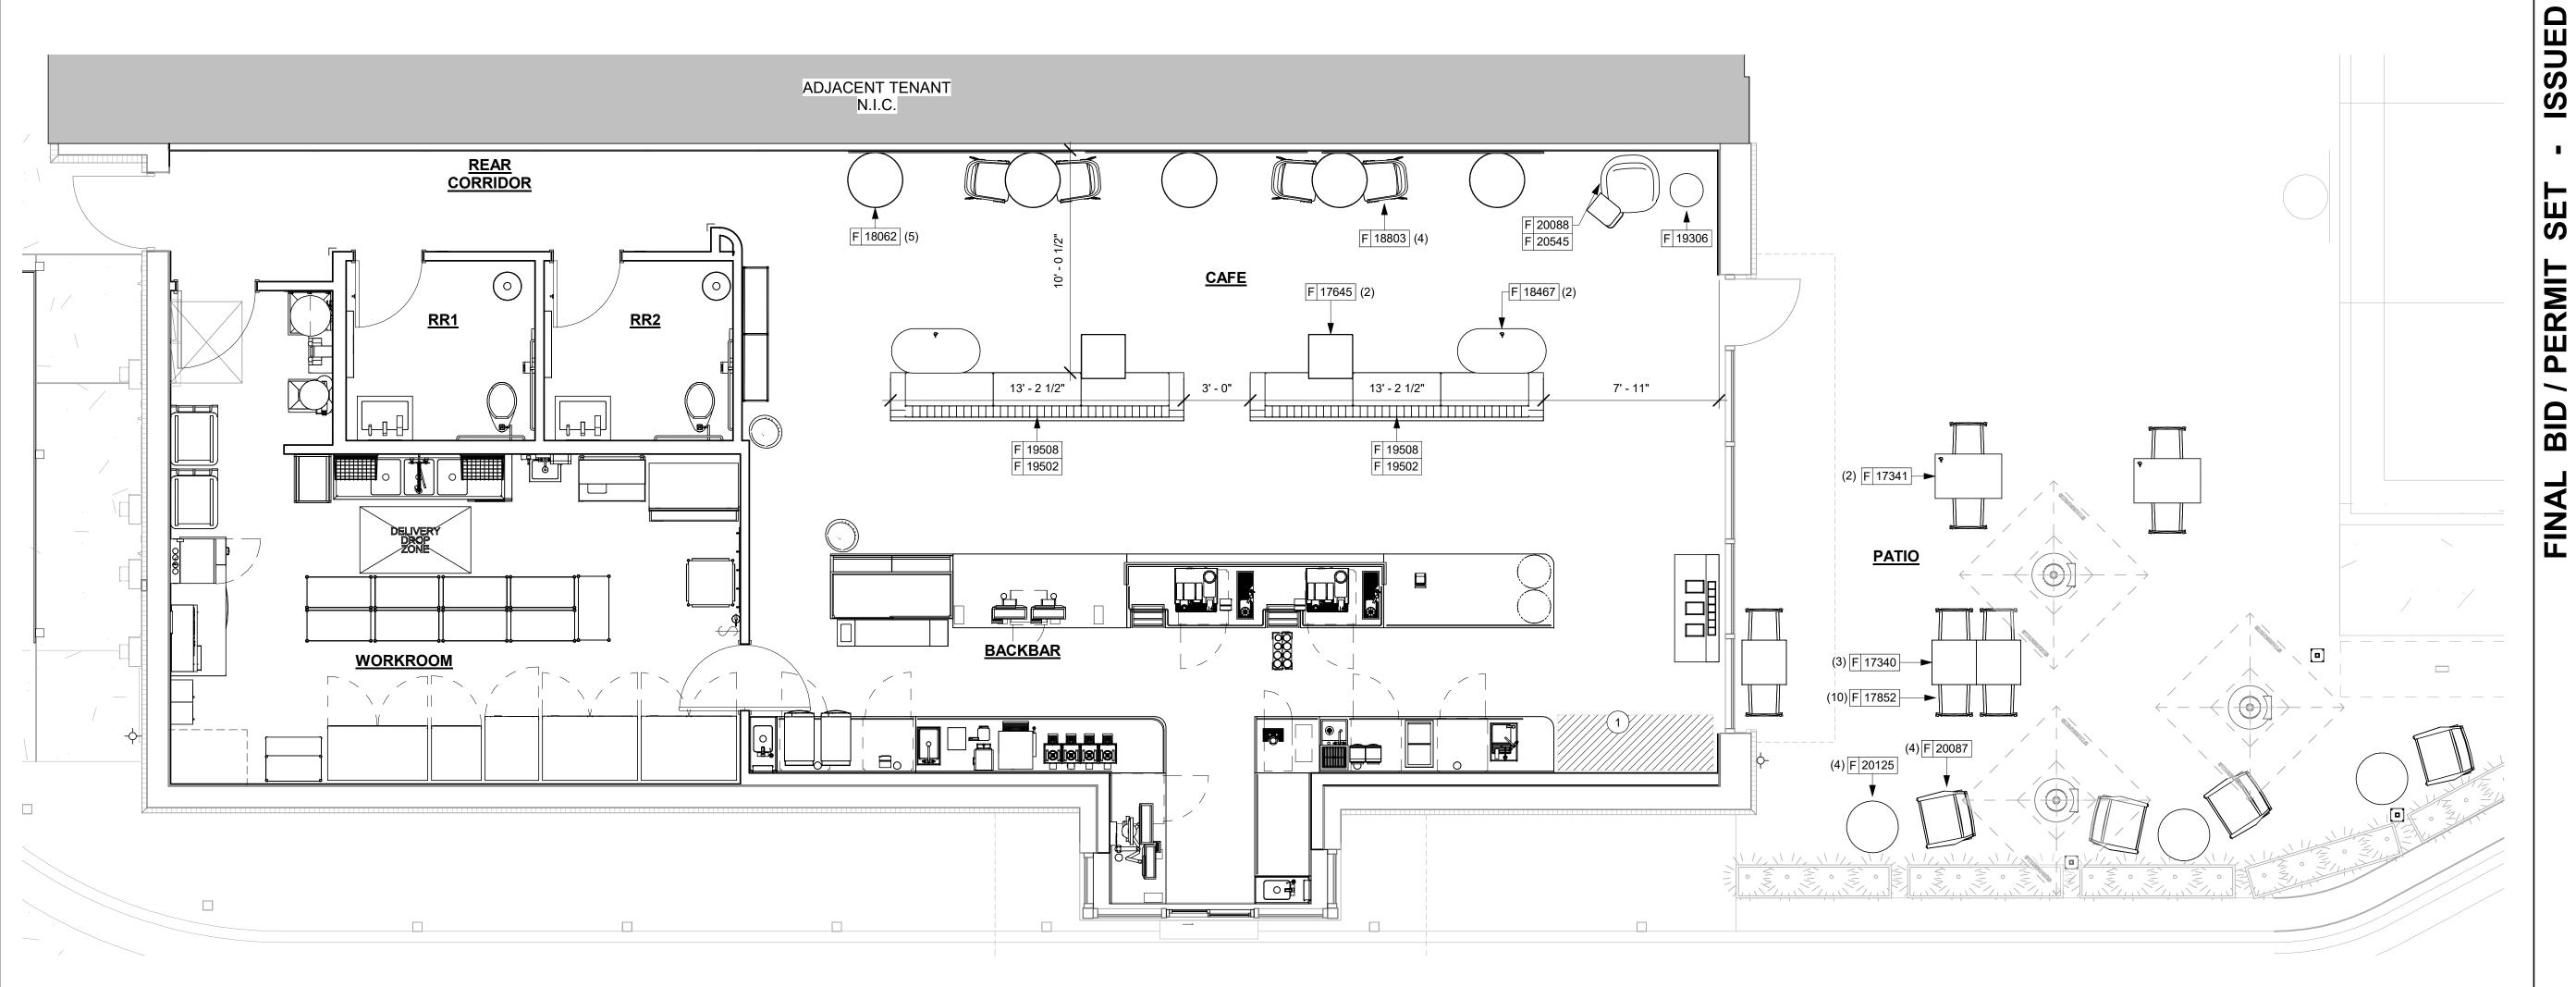LIMITED OPERATIONS FURNITURE LAYOUT SCALE: AS SHOWN

1101.1

LIMITED OPERATIONS FF AND E PLAN Scale: 1/4" = 1'-0"

C 17829

⊢C X0016

1' - 9"

Scale: 3/8" = 1'-0"

UPPER CASEWORK PLAN

CASEWORK PLAN

Scale: 1/4" = 1'-0"

14' - 0"

EXTENT OF MENUS

ADJACENT TENANT N.I.C. **REAR** C 10218 8 R X0025 R X0026 CORRIDOR C 10218 8 <u>CAFE</u> **-**C 20367 C 20066 C 20067 C 20064 C 20064 C 20064 C 20064 C X0024 C X0023 9' - 2 1/4" C X0018 C 17744 **WORKROOM** C 19280 C 21191 C 21192 C 19281 C 21193 C 20633 (2) C 18122 4 C 17575 C X0037 C 18122 C X0017 C 17573 **4**C X0019 C 17809 C 17574 C 11142 C 17574 C 17745 ⊢C|X0035 (4) C 17741 C X0020

C 17828

C X0033

KEYED NOTES

**MATERIAL AREAS AND TAKE-OFFS ARE ACTUAL AREA, NOT ORDERING QUANTITY. SUPPLIER MUST ACCOUNT FOR OVERAGE, PATTERN REPEAT, ACCESSORY PIECES, ETC.

**NOTE: CASEWORK VENDOR TO PROVIDE SHOP DRAWINGS & SAMPLES FOR DESIGNER APPROVAL PRIOR TO FABRICATION.

- 1. DO NOT CAULK TRASH RINGS TO COUNTERTOPS.
- 2. INSTALL CASEWORK, COUNTERTOPS, SHELVES, CUBBIES, FINISHES, TRIM AND TABLE TOPS THROUGHOUT. REFERENCE FINISH SCHEDULE AND MANUFACTURER'S SPECIFICATIONS FOR ADDITIONAL INFORMATION.
- 3. ALL COUNTERTOPS UTILIZED FOR CUSTOMER TRANSACTIONS, INCLUDING BAR, CONDIMENT AND SALES COUNTERTOPS SHALL BE INSTALLED AT 2'-10" (860 MM) MAXIMUM A.F.F.
- 4. FLOOR SINK BELOW. CASEWORK MANUFACTURER TO INSURE THIS AREA IS READILY ACCESSIBLE FOR CLEANING AND FREE OF COUNTERTOP SUPPORT.
- 5. WALL FINISH BEHIND EXPOSED CABINETRY AND BELOW UNDERSIDE OF COUNTERTOP SUBSTRATE TO BE FRP.
- 6. CASEWORK VENDOR TO ENGINEER PROPER COUNTEROTP SUPPORT AT ESPRESSO BAR AND OTHER WORKSTATIONS PER STARBUCKS MINIMUM PERFORMANCE REQUIREMENTS.
- 7. INDICATES SOFFIT EDGE.
- 8. INSTALL CORNER GUARD AS INDICATED. SEE INTERIOR FINISH ELEVATIONS.

GENERAL NOTES

- A. GENERAL CONTRACTOR TO NOTIFY CONSTRUCTION MANAGER IMMEDIATELY IF A DISCREPANCY EXISTS BETWEEN CASEWORK SHOP DRAWINGS, EXITING SITE CONDITIONS, ARCHITECTURAL DRAWINGS OR BUILT FIXTURES. ALL DIMENSIONS SHALL BE FIELD VERIFIED BY GC PRIOR TO SHOP DRAWINGS PRODUCTION.
- B. STARBUCKS CONSTRUCTION MANAGER TO COORDINATE AND SCHEDULE CASEWORK DELIVERY DATE. GENERAL CONTRACTOR TO CONFIRM CASEWORK DELIVERY DATE WITH CASEWORK MANUFACTURER AT FOUR (4) WEEKS PRIOR AND THEN ONE (1) WEEK PRIOR TO SCHEDULED DATE OF DELIVERY.
- C. STARBUCKS CONTRACTS DIRECTLY WITH CASEWORK VENDOR TO SUPPLY CASEWORK LISTED IN THE CASEWORK SCHEDULE, UNLESS OTHERWISE NOTED.
- D. CASEWORK VENDOR TO PROVIDE COMPLETE SHOP DRAWINGS AND INSTALLATION PACKAGE TO GENERAL CONTRACTOR TO FACILITATE PROPER INSTALLATION.
- E. ALL CASEWORK BOX BASE / TOE KICKS SHALL BE SET AND LEVELED USING 1/4" (6 MM) NON-ABSORBENT PLASTIC SHIMS PROVIDED BY CASEWORK VENDOR.
- F. SEE INTERIOR FINISH ELEVATIONS AND SCHEDULES FOR LOCATION AND TAGGING OF WALL TREATMENTS BY CV AND OTHERS.
- G. SEE REFLECTED CEILING PLAN FOR CASEWORK SOFFIT LOCATIONS.
- H. REFERENCE PLUMBING AND ELECTRICAL PLANS FOR PLACEMENT OF ELECTRICAL, DATA AND PLUMBING ON FRONT AND BACKLINE OF BAR.
- I. PROVIDE ACCENT LIGHTING AT FRONT EDGE OF BAR. SEE INTERIOR ELEVATIONS AND ELECTRICAL FOR ADDITIONAL INFORMATION.
- CASEWORK VENDOR TO ENGINEER PROPER COUNTERTOP SUPPORT AT ESPRESSO BAR AND OTHER WORKSTATIONS PER STARBUCKS MINIMUM PERFORMANCE REQUIREMENTS.



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ISSUED DATE: 06/16/2020 EXPIRATION DATE: 12/31/2020

PRYOR, EIN DR.

LEGEND



INDICATES STAINLESS STEEL (SST) COUNTERTOP

INDICATES SOLID SURFACE (SS) COUNTERTOP

DATUM POINT

C 12345 CASEWORK TAG

EXTENT OF WOOD CLADDING

PERI BID

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STORE #: 62012 PROJECT #: 87799-001

ISSUE DATE: SR. DESIGN MANAGER: K. GORIN SLONSKI PRODUCTION DESIGNER: A. HAHN CHECKED BY:

Revision Schedule

CASEWORK PLAN

SCALE: AS SHOWN SHEET NUMBER:

I102

LEGEND - LIGHTING

CAN - LED ADJUSTABLE GIMBAL WITH DRIVER - 2IN 50MM - WHITE -1000LM NFL DID: 19113 & 19023

CAN - LED DOWNLIGHT REFLECTOR WITH DRIVER -2IN 50MM - WHITE - 1000LM FLOOD DID: 19120 & 19023

TRACK - LED FIXTURE - 2IN 50MM - WHITE - 900LM FLOOD HEX LOUVER DID: 19087 AIM AT SEATING

TRACK - LED FIXTURE - 2IN 50MM - WHITE - 900LM SPOT DID: 19071 HEX LOUVER DID: 19087 AIM AT MERCHANDISE/CONDIMENT CART

TRACK - LED FIXTURE - 2IN 50MM - WHITE - 600LM FLOOD DID: 19072 HEX LOUVER DID: 19087 AIM AT MENU BOARDS & ARTWORK

STRIP - LED TAPE - VARIABLE LENGTH; DID: 14410

LEGEND

ELEVATION DATUM TRACK LIGHTING

RECESSED CAN LIGHT ADJUSTABLE RECESSED CAN LIGHT

TROFFER

WALL SCONCE

EXIT SECURITY LIGHT

MUSIC SYSTEM SPEAKER WIFI ACCESS POINT (WAP)

RETURN AIR

SECURITY CAMERA

SUPPLY AIR

KEYED NOTES

1. GWB SOFFIT WITH SMOOTH FINISH (PAINT AS SCHEDULED).

2. GWB CEILING. PAINT CEILING DIFFUSERS AS INDICATED.

3. WASHABLE CEILING TILE LOCATED IN BACK OF HOUSE

AND ABOVE CAFE BAR (IF APPLICABLE). 4. PLATFORM FOR HEATER AND WATER FILTRATION. PROVIDE SOFFIT AND LIFT CEILING THIS AREA ONLY TO INSURE ADEQUATE CLEARANCE FOR SERVICING.

5. EXTERIOR RECESSED LIGHTING BY LL.

6. HEATING, VENTILATING AND AIR CONDITIONING FOR REFERENCE ONLY. SEE MECHANICAL DRAWINGS FOR ADDITIONAL INFORMATION. EXPOSED PARTS TO BE PAINTED TO MATCH ADJACENT COLOR.

7. SURFACE MOUNTED TRACK LIGHTING.

8. RECESSED ACCESS HATCH. PAINT TO MATCH ADJACENT FINISH. FINAL LOCATION TO BE CONFIRMED AND APPROVED IN FIELD BY STARBUCKS CONSTRUCTION MANAGER.

9. RESTROOM SCONCE. SEE INTERIOR ELEVATIONS FOR MOUNTING HEIGHT.

10. RECESSED SPEAKER.

11. ILLUMINATED MOP SIGN. REFER TO ELECTRICAL SHEETS. GC TO PROVIDE ADEQUATE BLOCKING WITHIN SOFFIT FOR PROPER SUPPORT

12. CAFE CEILING TILE START POINT.

13. WORKROOM CEILING TILE START POINT.

14. INSTALL STRING LIGHTS AS INDICATED. POWER BY LL.

15. GC TO CONFIRM EMERGENCY LIGHTING LOCATIONS/QUANTITY WITH FIRE MARSHAL.

16. INDICATES EDGE OF CEILING TILE, SEE DETAIL

GENERAL NOTES

A. IF REQUIRED BY LOCAL CODE. GENERAL CONTRACTOR TO PROVIDE SEMI-RECESSED SPRINKLER HEADS WITH POLISHED CHROME ESCUTCHEONS CENTERED IN ACOUSTICAL CEILING TILE. IF PENDANT HEADS ARE REQUIRED IN GWB SOFFIT OVER FRONTBAR, CONCEAL SUPPLY PIPING WITHIN SOFFIT. GENERAL CONTRACTOR TO SUBMIT SPRINKLER LAYOUT TO STARBUCKS' CONSTRUCTION MANAGER FOR APPROVAL PRIOR TO INSTALLATION.

B. LEAVE TEN (10) ADDITIONAL RETAIL CEILING TILES TO MATCH RETAIL CEILING PAINT COLOR ABOVE THE WORKROOM CEILING AT MANAGER'S DESK FOR FUTURE

C. PROVIDE GROMMET AT ACOUSTIC CEILING PENETRATIONS FOR FIXTURES OF SUPPORTS.

D. HEATING, VENTILATING AND AIR CONDITIONING SHOWN ON THIS PLAN PROVIDED FOR REFERENCE ONLY. SEE MECHANICAL DRAWINGS FOR ADDITIONAL INFORMATION.

E. DIFFUSERS AND RETURNS IN ACOUSTICAL CEILING TILE TO BE CENTERED IN TILE AND PAINTED TO MATCH ADJACENT FINISHES (TYP.).

F. PAINT ALL EXPOSED HVAC DUCTS, HVAC DIFFUSERS. LIGHT TRIM RINGS, PIPING, CONDUIT AND JUNCTION BOXES THE SAME COLOR AS SPECIFIED ON SURROUNDING CEILING OR SOFFIT UNLESS OTHERWISE NOTED. TYPICAL THROUGHOUT RETAIL AREA OF STORE.

G. PAINT SUBSTITUTIONS ARE NOT ALLOWED. USE STARBUCKS' NATIONAL ACCOUNT "COLOR CODE" WHEN ORDERING PAINTS.

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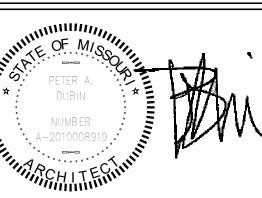
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ISSUED DATE: 06/16/2020 EXPIRATION DATE: 12/31/2020

3 ARBUCK YOR RD LOT SUMMI

VEST PRYOR, I ENSTEIN DR. MO

BUILDOUT
COFFEE CHIPMAN 62012 87799-001

ISSUE DATE: SR. DESIGN MANAGER: K. GORIN SLONSKI PRODUCTION DESIGNER: A. HAHN CHECKED BY: NORR

Revision Schedule


SHEET TITLE: REFLECTED CEILING PLAN

SCALE: AS SHOWN SHEET NUMBER:

STORE #:

PROJECT #:

I103

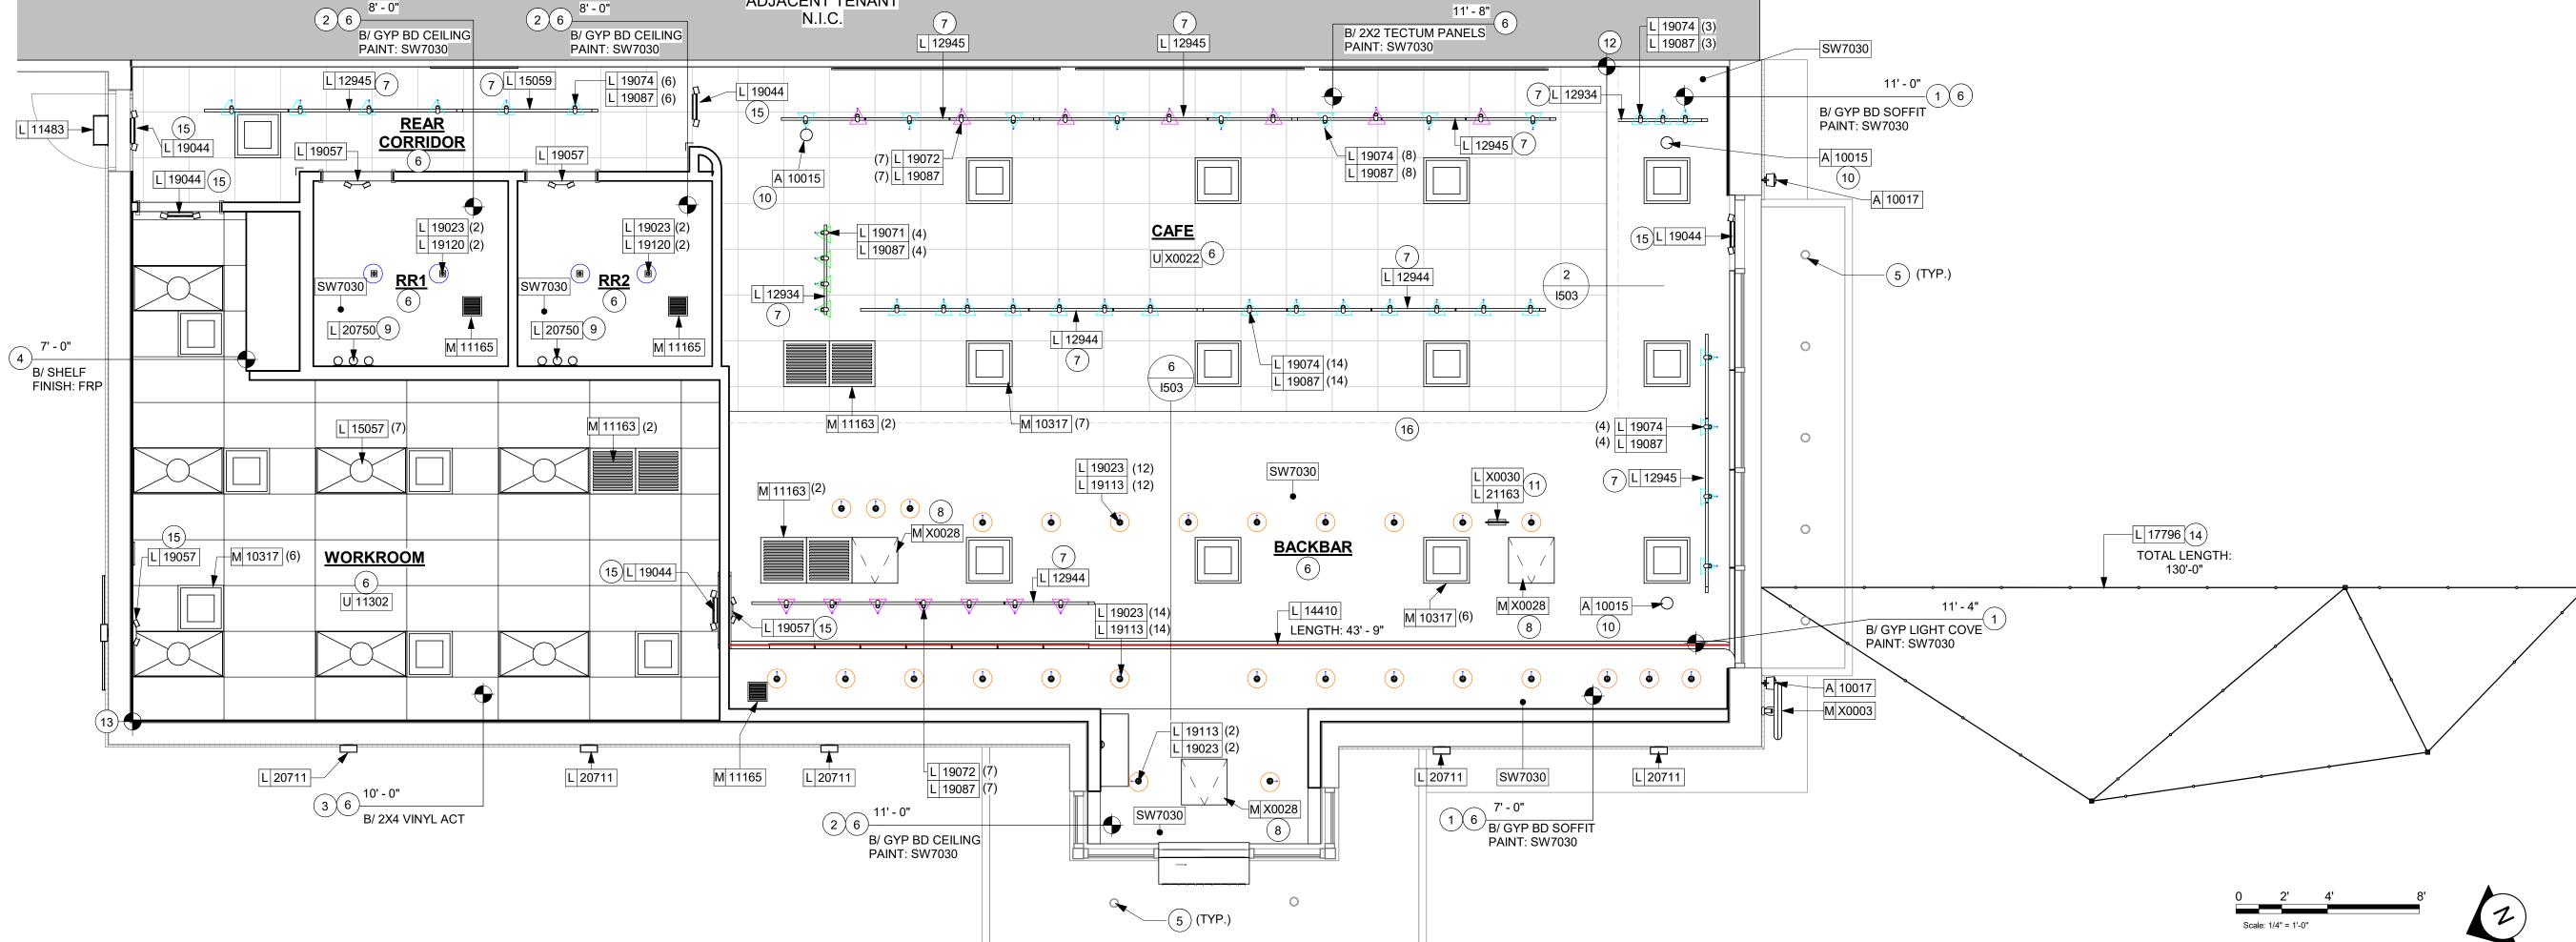

REFLECTED CEILING PLAN Scale: 1/4" = 1'-0"

LEGEND - LIGHTING

- CAN LED ADJUSTABLE GIMBAL WITH DRIVER - 2IN 50MM - WHITE -1000LM NFL DID: 19113 & 19023
- CAN LED DOWNLIGHT REFLECTOR WITH DRIVER -2IN 50MM - WHITE - 1000LM FLOOD DID: 19120 & 19023
- TRACK LED FIXTURE 2IN 50MM WHITE 900LM FLOOD HEX LOUVER DID: 19087 AIM AT SEATING
- DID: 19071 HEX LOUVER DID: 19087 AIM AT MERCHANDISE/CONDIMENT CART



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ISSUED DATE: 06/16/2020 EXPIRATION DATE: 12/31/2020

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STORE #: 62012 PROJECT #: 87799-001 ISSUE DATE: 06-16-2020 SR. DESIGN MANAGER: K. GORIN SLONSKI PRODUCTION DESIGNER: A. HAHN

Revision Schedule

DIMENSIONED RCP W/ UNDERLAY SCALE: AS SHOWN

SHEET NUMBER:

I103.1

FLOOR TREATMENT SCHEDULE - "T"							
DESIGN ID	AREA	DESCRIPTION	FURN. BY	INST. BY	COMMENTS		
PLASTIC			•				
19795	819 SF	POLYVINYL FLOOR TILE - ECO-GRIP - PEWTER	GC	GC	MANUFACTURER: ALLIED ECO-GRIP. PEWTER		
TILE				•			
20266	1149 SF	TILE - FRENCH CLAY - BRONZAGE - 24X24IN 600X600MM	SB	GC	GROUT: MAPEI - 09 GRAY, OR EQUAL		
WALK OFF	MAT		•				
19288	26 SF	WALK OFF MAT - HELIX Z1 - BLACK - 12X9IN 305X230MM	SB	GC	ANODIZED METAL FRAME TO BE INCLUDED IN ORDER, FROM MANUFACTURER		

WALL BASE SCHEDULE - "B"								
DESIGN ID LENGTH DESCRIPTION FURN. BY INST. BY COMMENTS								
TILE BASE								
18740	150' - 0 1/2"	TILE BASE - PLAZA NOVA - BLACK SHADOW - 6X12IN 150X300MM	SB	GC	GROUT: MAPEI - 47 CHARCOAL, OR EQUAL			
19795	188' - 2 1/4"	POLYVINYL FLOOR TILE - ECOGRIP - PEWTER	GC	GC	MANUFACTURER: ALLIED ECO-GRIP. PEWTER			
20196	59' - 10"	TILE BASE - FORMULA - EQUATION GREY - 6X12IN 150X300MM	SB	GC	GROUT: MAPEI - 09 GRAY			

KEYED NOTES

- 1. TILE START POINT WHERE INDICATED.
- 2. MOP SINK WHERE INDICATED. SEE PLUMBING PLANS FOR MORE INFORMATION.
- 3. FLOOR SINK/FLOOR DRAIN LOCATION. SEE BUILDING FLOOR PENETRATION PLAN ON SHEET A102 AND PLUMBING FOR ADDITIONAL INFORMATION.
- ELECTRICAL STUB UP. SEE BUILDING FLOOR PENETRATION PLAN ON SHEET A102 AND ELECTRICAL FOR ADDITIONAL INFORMATION.
- 5. RECESSED WALK-OFF MAT AT ENTRY. SEE INTERIOR DETAIL SHEETS FOR TRANSITION.
- 6. PLUMBING STUB UP. SEE BUILDING FLOOR PENETRATION PLAN ON SHEET A102 AND PLUMBING SHEETS FOR ADDITIONAL INFORMATION.
- 7. INDICATES FLOOR J-BOX FOR FURNITURE. VERIFY LOCATION WITH FF&E PLAN.

GENERAL NOTES

- A. WORKROOM TO BE FINISHED PER LOCAL CODE REQUIREMENTS.
- B. FLOORS, WALLS AND CEILING FINISHES IN FOOD PREPARATION AREAS SHALL BE SMOOTH, NON-TOXIC, NON-ABSORBENT, DURABLE AND EASILY CLEANABLE. PAINT SHALL BE WASHABLE; SEMI-GLOSS OR HIGH-GLOSS FINISH.
- C. STARBUCKS TO SUPPLY FLOORING AND BASE FOR FRONT AND BACK OF HOUSE AS NOTED IN SCHEDULES. GENERAL CONTRACTOR TO INSTALL. GENERAL CONTRACTOR TO SUPPLY WORKROOM TILE AND BASE AND INSTALL. GENERAL CONTRACTOR TO SUPPLY AND INSTALL MORTAR, ADHESIVE, AND GROUT, GENERAL CONTRACTOR TO INSPECT ALL TILES AND REJECT DAMAGED OR SUBSTANDARD TILES PRIOR TO INSTALLATION.
- D. ALIGN TILE TRANSITIONS ON WHOLE TILES AS SHOWN.
- E. ALL FLOOR AND WALL JUNCTIONS IN STORAGE AND FOOD PREPARATION AREAS SHALL HAVE A 6" COVED



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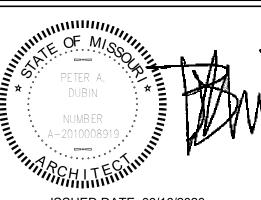
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EXPIRATION DATE: 12/31/2020

S &

DID: 20196 POLYVINYL BASE - ECOGRIP - PEWTER DID: 19795

FLOOR FINISH LEGEND

---- TILE BASE - FORMULA - EQUATION GRAY - 6IN X 12IN

TILE BASE - PLAZA NOVA - BLACK SHADOW - 6IN X 12IN DID: 18740

TARBUCKS
YOR RD 8 BUILDOUT
COFFEE CHIPMAN STORE #:

62012 87799-001

PROJECT #: ISSUE DATE: 06-16-2020 SR. DESIGN MANAGER: K. GORIN SLONSKI PRODUCTION DESIGNER: A. HAHN CHECKED BY:


Revision Schedule

FLOOR FINISH PLAN

SCALE: AS SHOWN

SHEET NUMBER:


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ISSUED DATE: 06/16/2020

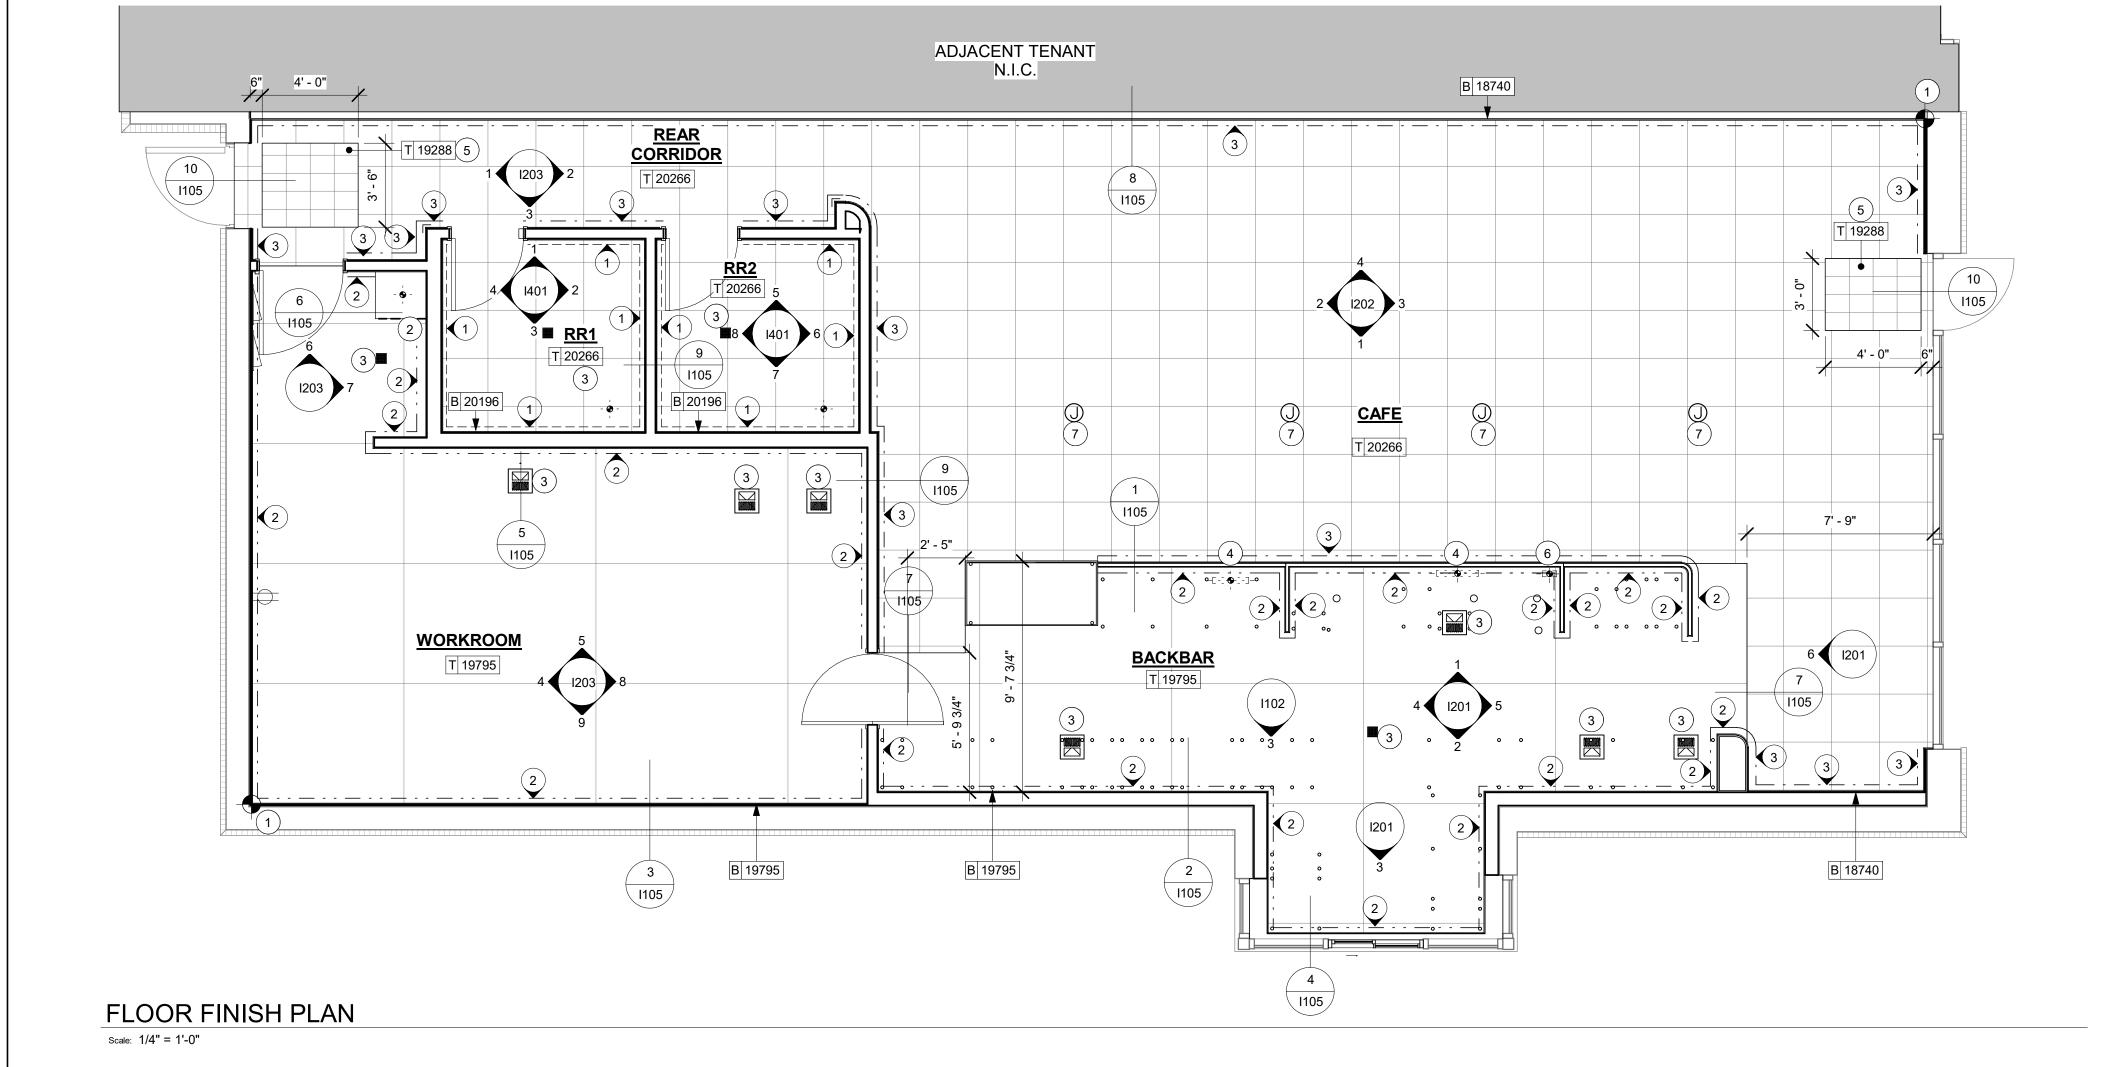EXPIRATION DATE: 12/31/2020

LOT YOR, DR.

62012 87799-001 06-16-2020 SR. DESIGN MANAGER: K. GORIN SLONSKI NORR

Revision Schedule						
Rev	Date	Ву	Description			
	ET TITLE:		ETAILS			

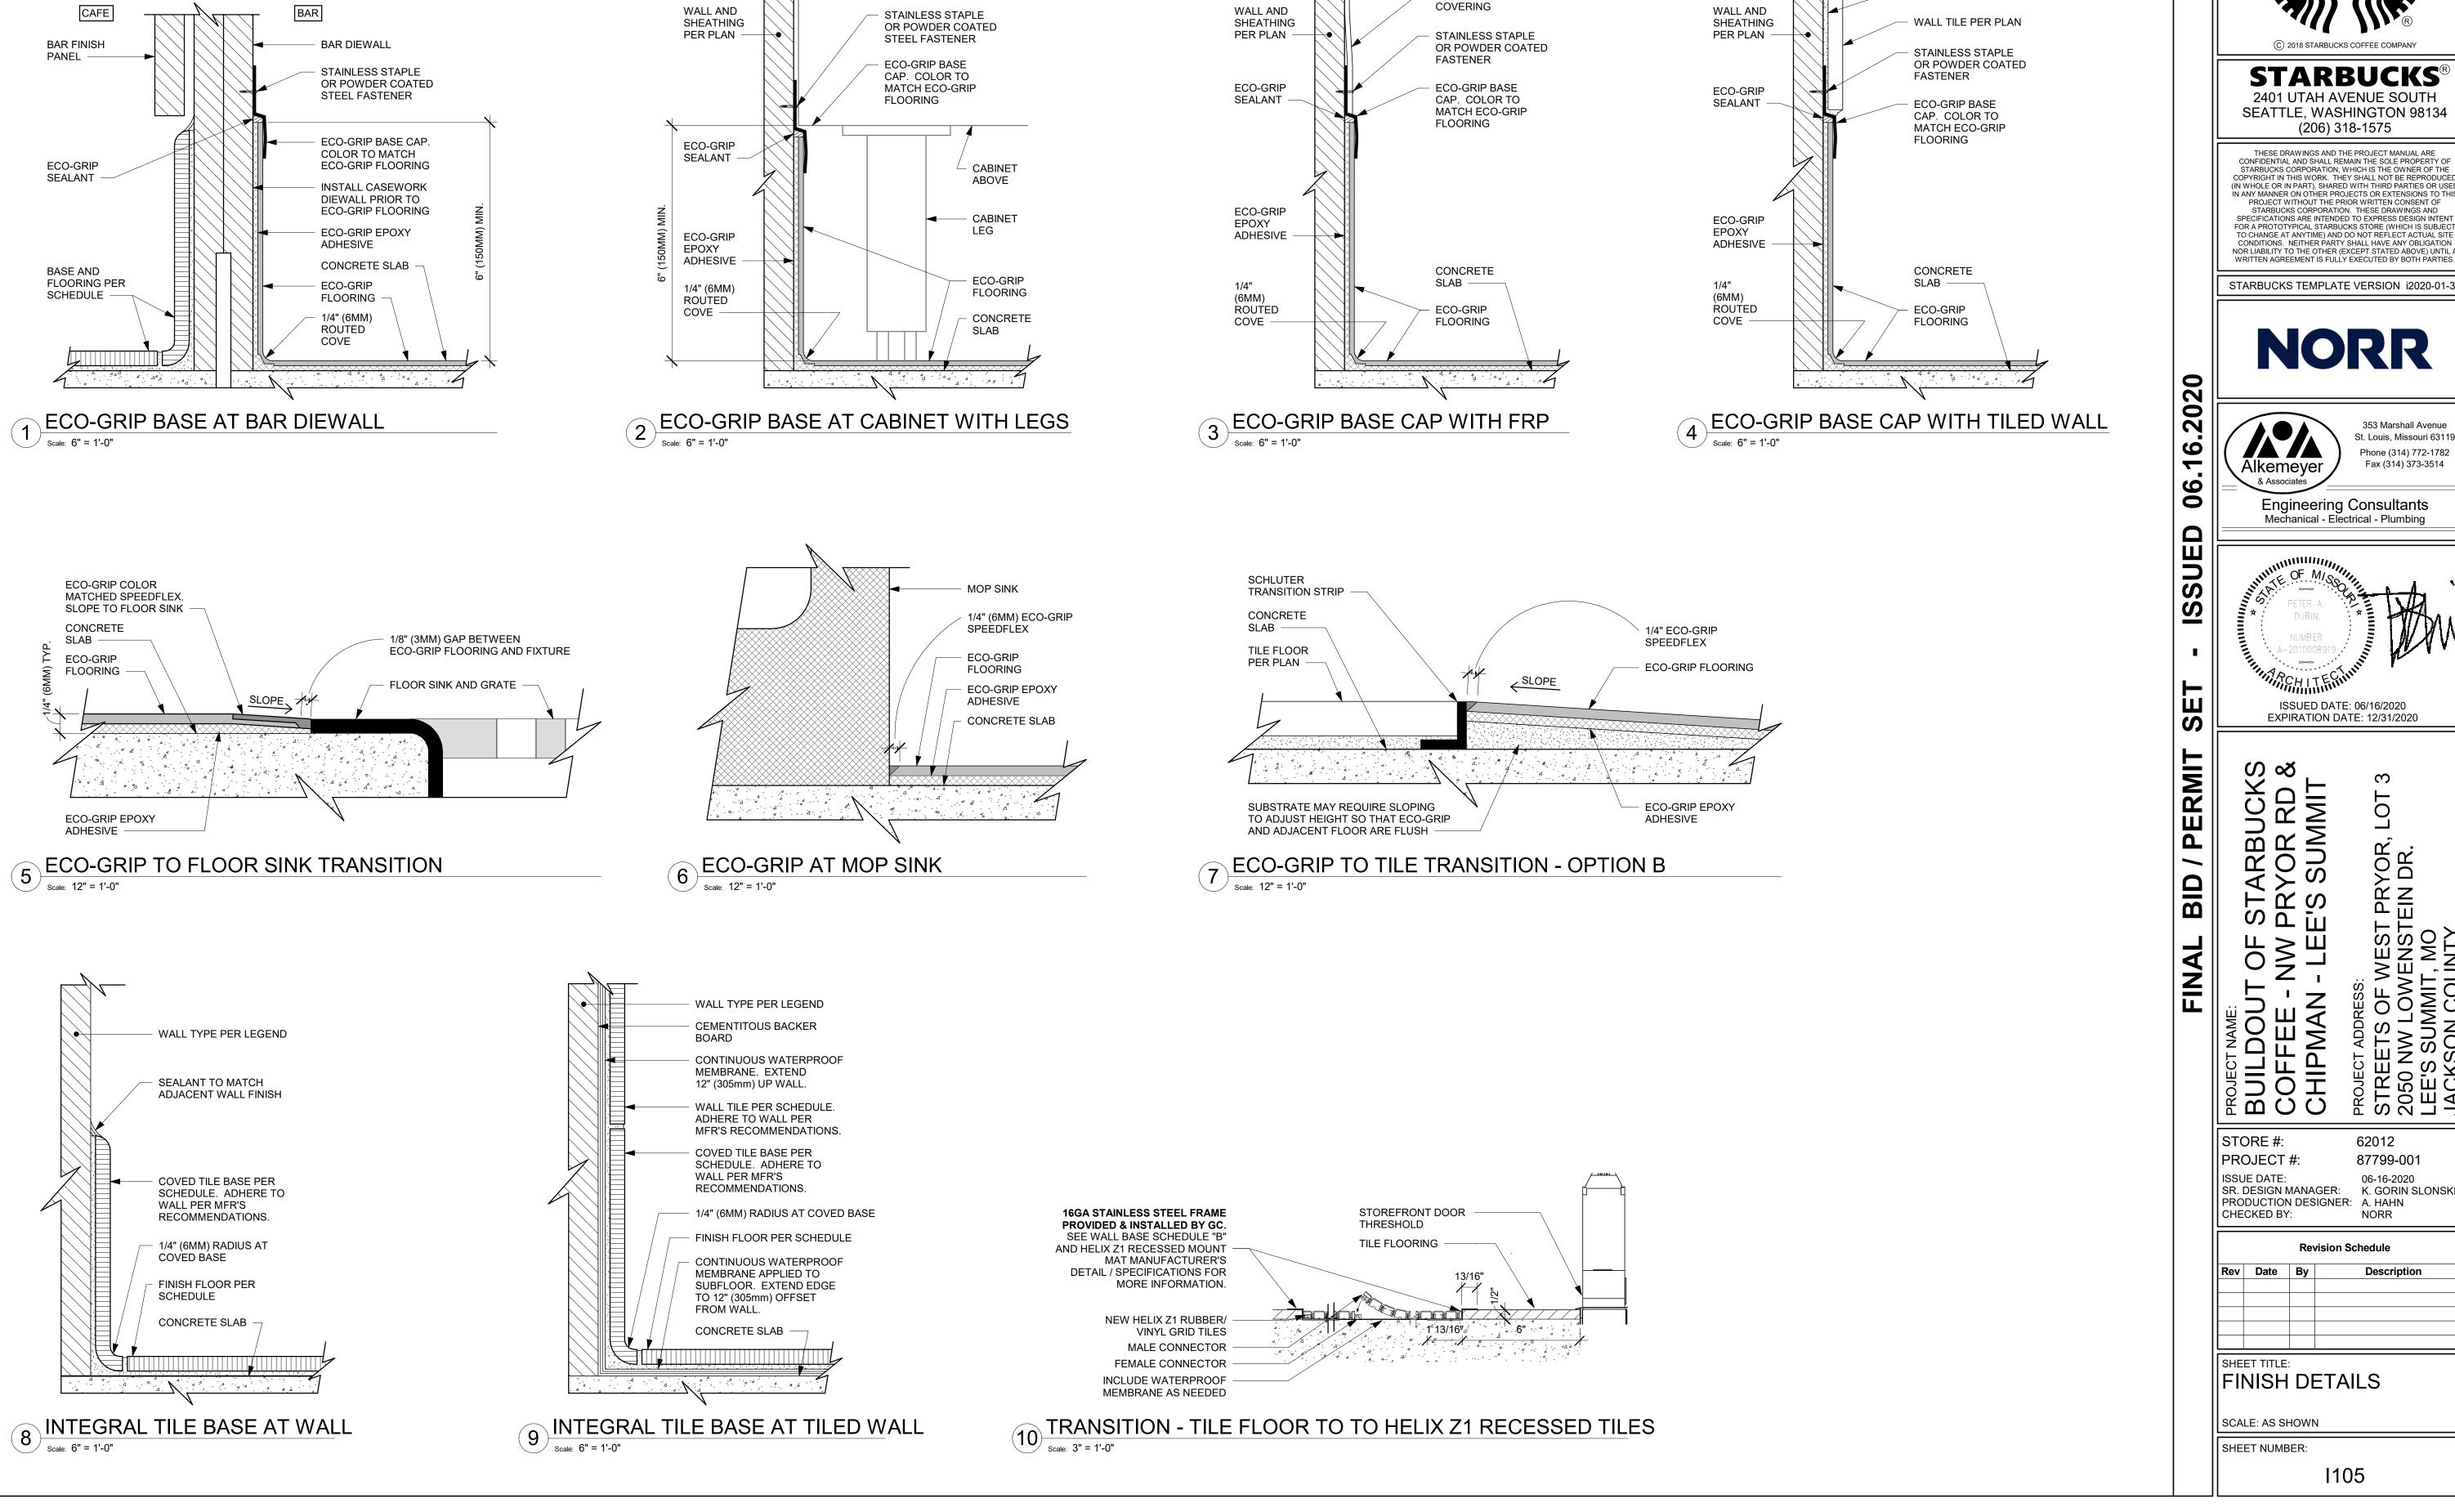KEYED NOTES

- 1. ATTACH MENU BOARDS PER INSTALLATION DETAILS.
- 2. SHELVING FOR CBE STATION AS SHOWN. G.C. TO PROVIDE WALL BLOCKING FOR FASTENERS.
- 3. TILE START POINT WHERE INDICATED.
- 4. WALL FINISH BEHIND EXPOSED CABINETRY AND BELOW UNDERSIDE OF COUNTERTOP SUBSTRATE TO BE WHITE
- 5. PROVIDE 6" (150MM) MIN. INTERGRAL SPLASHGUARD AT HAND SINK PER JURISDICTIONAL REQUIREMENTS.
- 6. TOP MOUNTED, ILLUMINATED CAFE MOBILE ORDER PICKUP (MOP) SIGN BY SIGNAGE VENDOR. PROVIDE BLOCKING IN CEILING AS REQUIRED TO SUPPORT SIGN.
- 7. SNEEZE GUARD HEIGHT TO BE VERIFIED WITH HEALTH
- 8. ROUNDED CORNERS. SEE REFLECTED CEILING PLAN FOR MORE INFORMATION.
- 9. INSTALL AIR CURTAIN AS REQUIRED PER JURISDICTION.

GENERAL NOTES

- A. FOR GRAPHICS SCHEDULE, REFER TO THE FURNITURE, FIXTURES, AND EQUIPMENT (FF & E) SCHEDULES ON SHEET 1601.
- B. REFER TO MANUFACTURER'S INSTRUCTIONS INCLUDED WITH ARTWORK/GRAPHICS FOR PROPER INSTALLATION.
- C. CHANGE PAINT COLOR ONLY AT INSIDE CORNERS
- D. PAINT FINISHES SHALL BE APPLIED AS FOLLOWS,
- UNLESS NOTED OTHERWISE: 1) WOODS AND METAL SURFACES SHALL BE SEMI-GLOSS OR EQUAL.

UNLESS OTHERWISE INDICATED.

- 2) ACCENT AND TRIM PAINTS TO BE SEMI-GLOSS OR a. WALL AND CEILING PAINTS TO BE EGGSHELL OR
- 3) PAINTS IN BOH, RESTROOM(S) OR CAFE BAR SHALL BE SEMI-GLOSS OR EQUAL.
- E. PAINT SUBSTITUTIONS ARE NOT ALLOWED. USE STARBUCKS NATIONAL ACCOUNT COLOR CODE WHEN ORDERING PAINTS.
- F. FLOORS, WALLS AND CEILING FINISHES IN FOOD PREPARATION AREAS SHALL BE SMOOTH, NON-TOXIC, NON-ABSORBENT, DURABLE AND EASILY CLEANABLE. PAINT SHALL BE WASHABLE; SEMI-GLOSS OR HIGH GLOSS FINISH.
- G. ALL WOOD SURFACES (DOORS, TRIM, SHELVES, CABINETRY) SHALL BE SEALED.
- H. REFER TO CASEWORK FINISH SCHEDULE ON THE CASEWORK FINISH PLAN ON SHEET I102 FOR CASEWORK FINISH MATERIAL INFORMATION.
- I. ALIGN TILE TRANSITIONS ON WHOLE TILES AS SHOWN.
- J. ALL FLOOR AND WALL JUNCTIONS IN STORAGE AND FOOD PREPARATION AREAS SHALL HAVE A 6" COVED
- K. ALL FOOD STORAGE SHALL BE 6" (150MM) A.F.F.
- L. INSTALL BLOCKING AND HANGERS FOR WALL SHELVING BEFORE INSTALLING BACK BAR TILE.
- M. GENERAL CONTRACTOR TO PROVIDE AND INSTALL WORKROOM WALL FINISHES.

LEGEND

INDICATES WALL BLOCKING. FIRE TREATED WALL BLOCKING TO BE PROVIDED AS REQUIRED TO SUPPORT WALL \square — — — ATTACHMENTS. EXTEND BLOCKING 4" (100mm) BEYOND EDGE OF ATTACHMENTS.



WALL TILE START POINT DATUM

10 C X0033 1504 B 19795 CP0028 Q 11469 Q 20249 (4) CP0028

PERI BID BUILDOUT
COFFEE CHIPMAN STORE #:

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62012 87799-001

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Mechanical - Electrical - Plumbing

ISSUED DATE: 06/16/2020 EXPIRATION DATE: 12/31/2020

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PROJECT #: ISSUE DATE: 06-16-2020 SR. DESIGN MANAGER: K. GORIN SLONSKI PRODUCTION DESIGNER: A. HAHN CHECKED BY:


INTERIOR FINISH ELEVATIONS SCALE: AS SHOWN


SHEET NUMBER:

1201

Q 20249 Q 11469 B 19795 CP0028 PL0027 CP0028 CP0028

BACKBAR - SOUTH ELEVATION

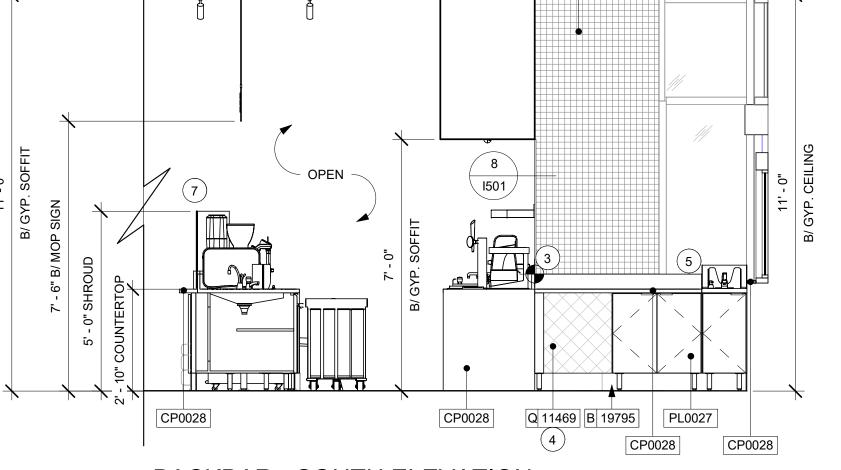

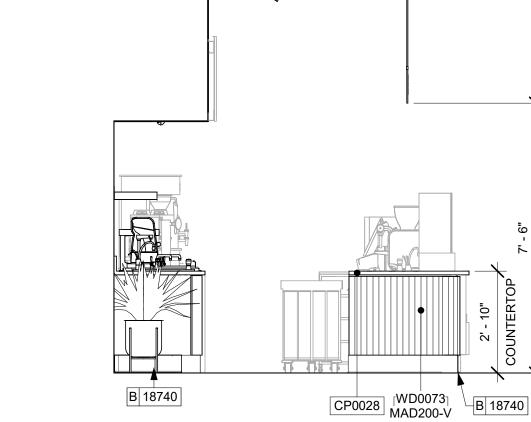

SIDEBAR

Scale: 3/8" = 1'-0"



1502 1501

CP0028

BACKBAR - WEST ELEVATION

MAD100-H

B 18740

CP0002

PL0027 Q 20249 Q 11469

B 19795

CP0028

BACKBAR - NORTH ELEVATION


PL0027

3 DT ELEVATION

Scale: 3/8" = 1'-0"

PL0027

Q 11469

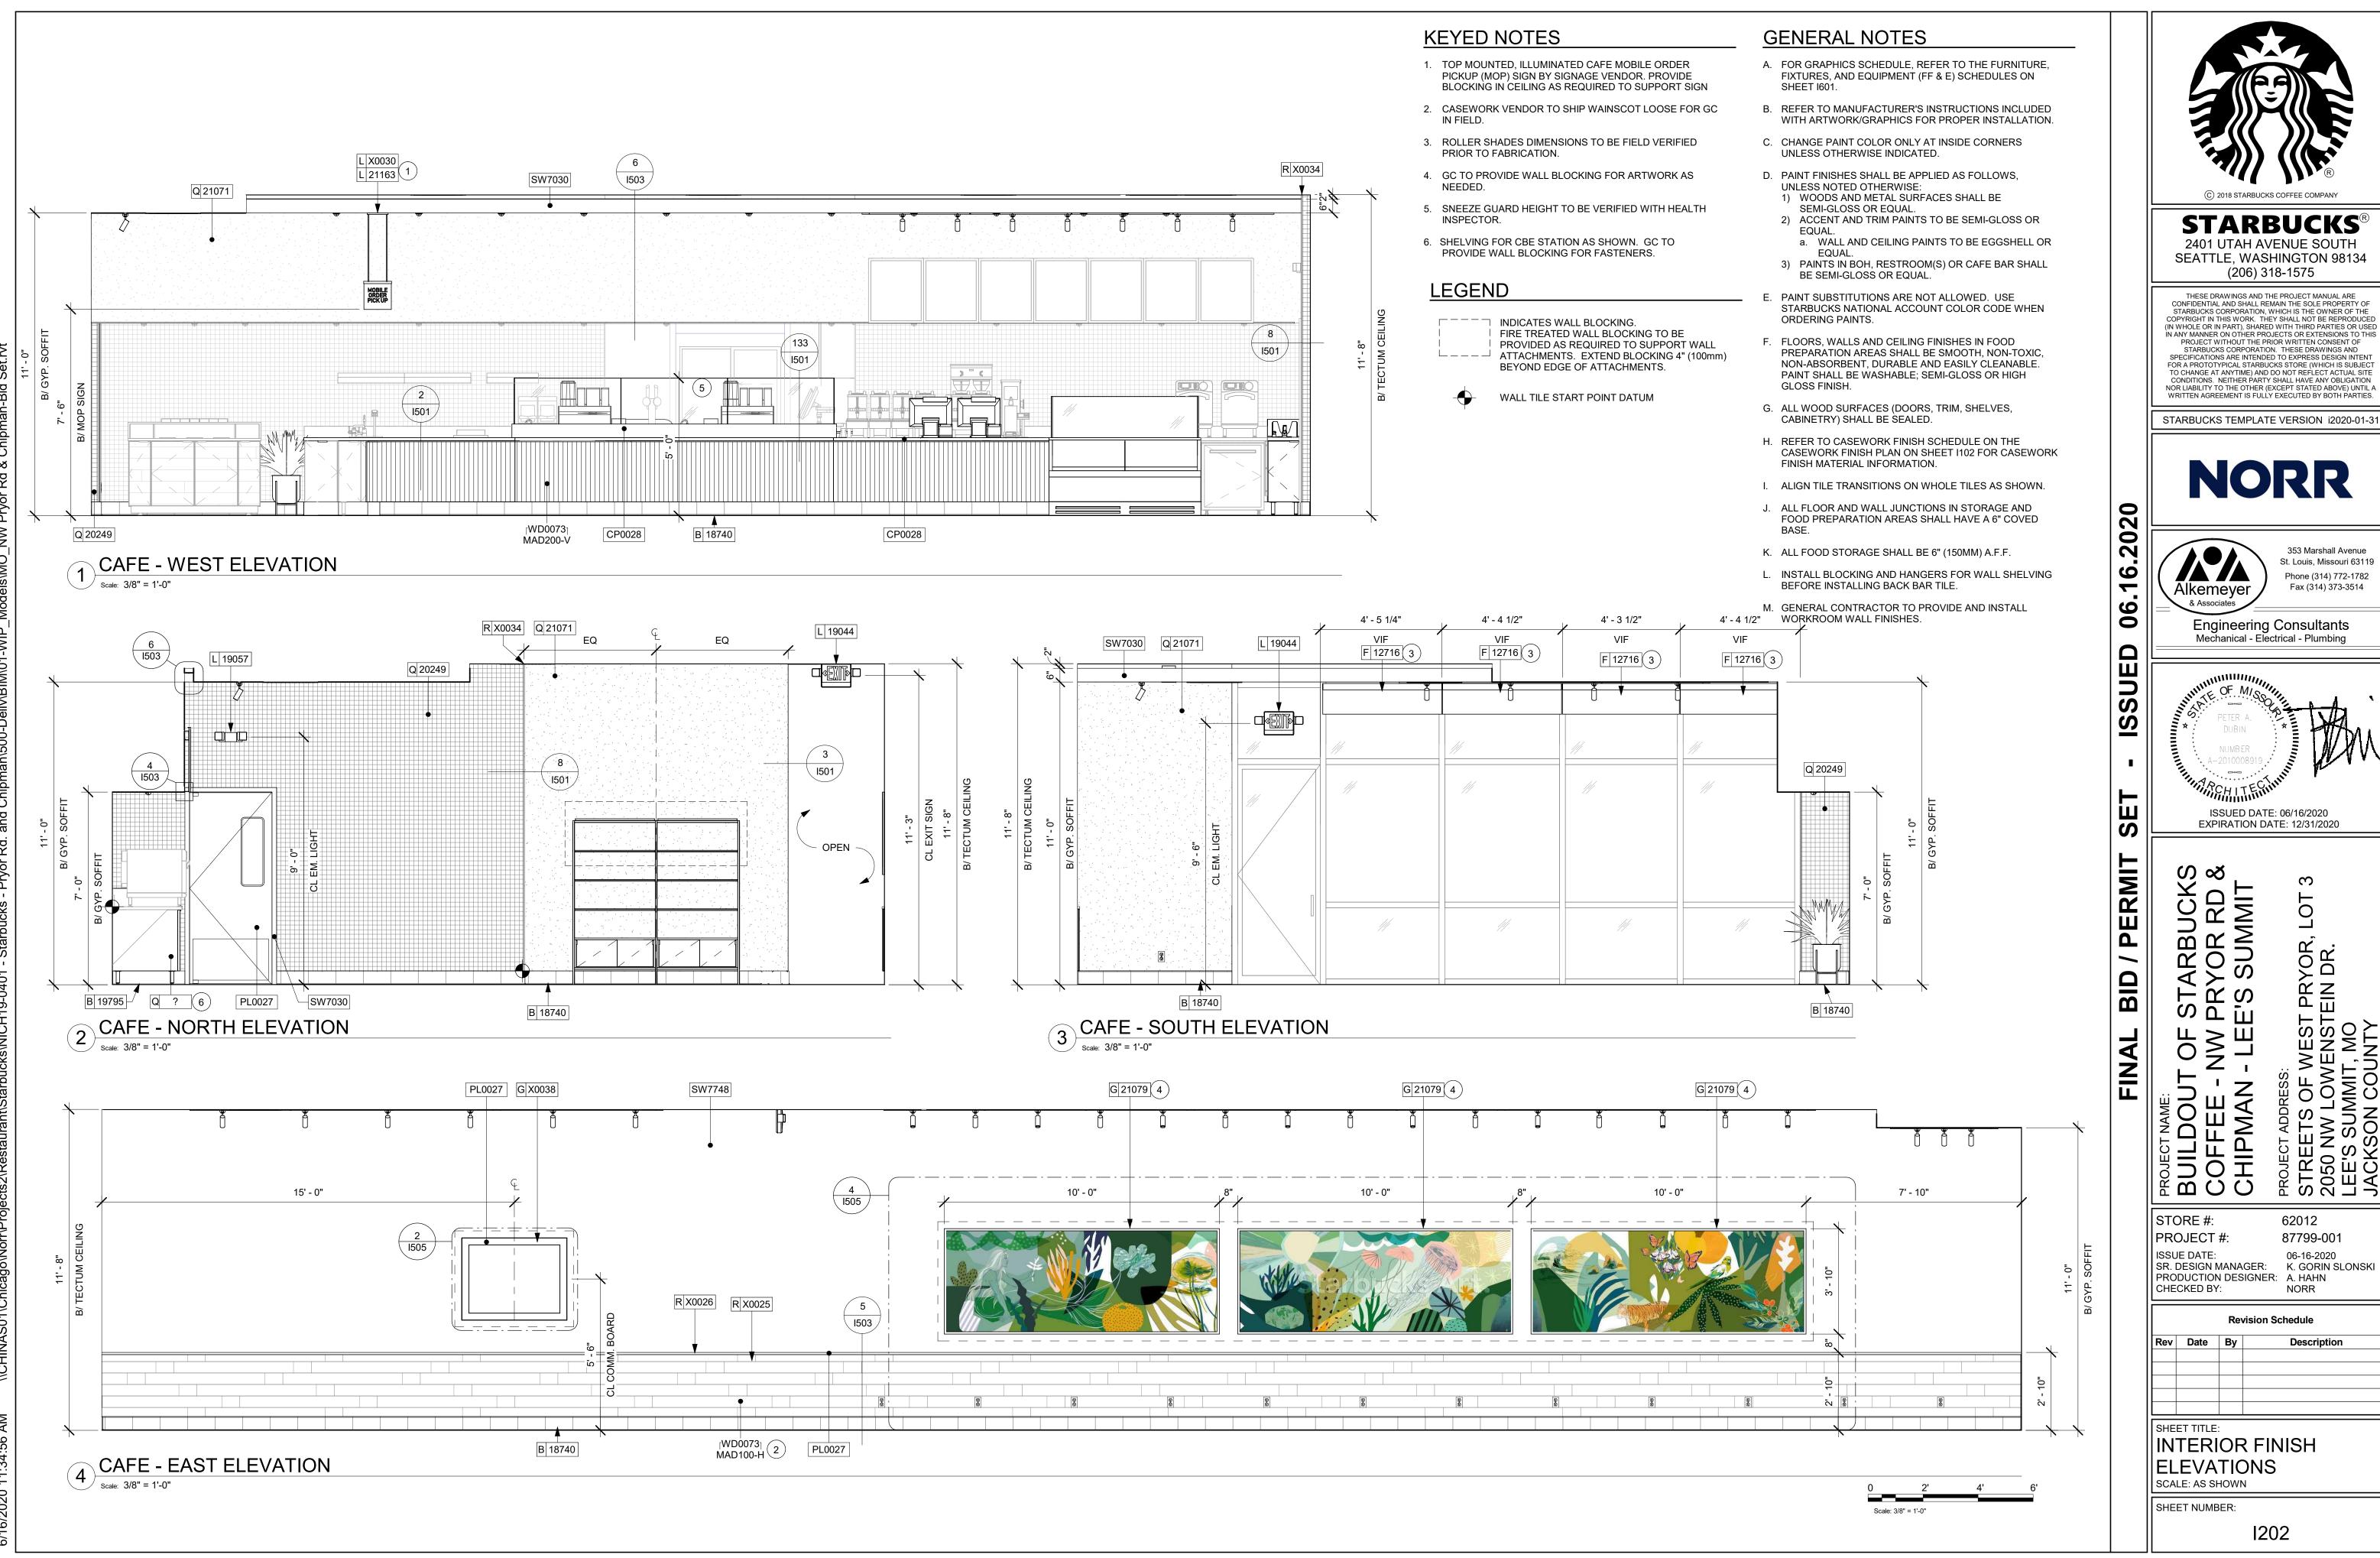

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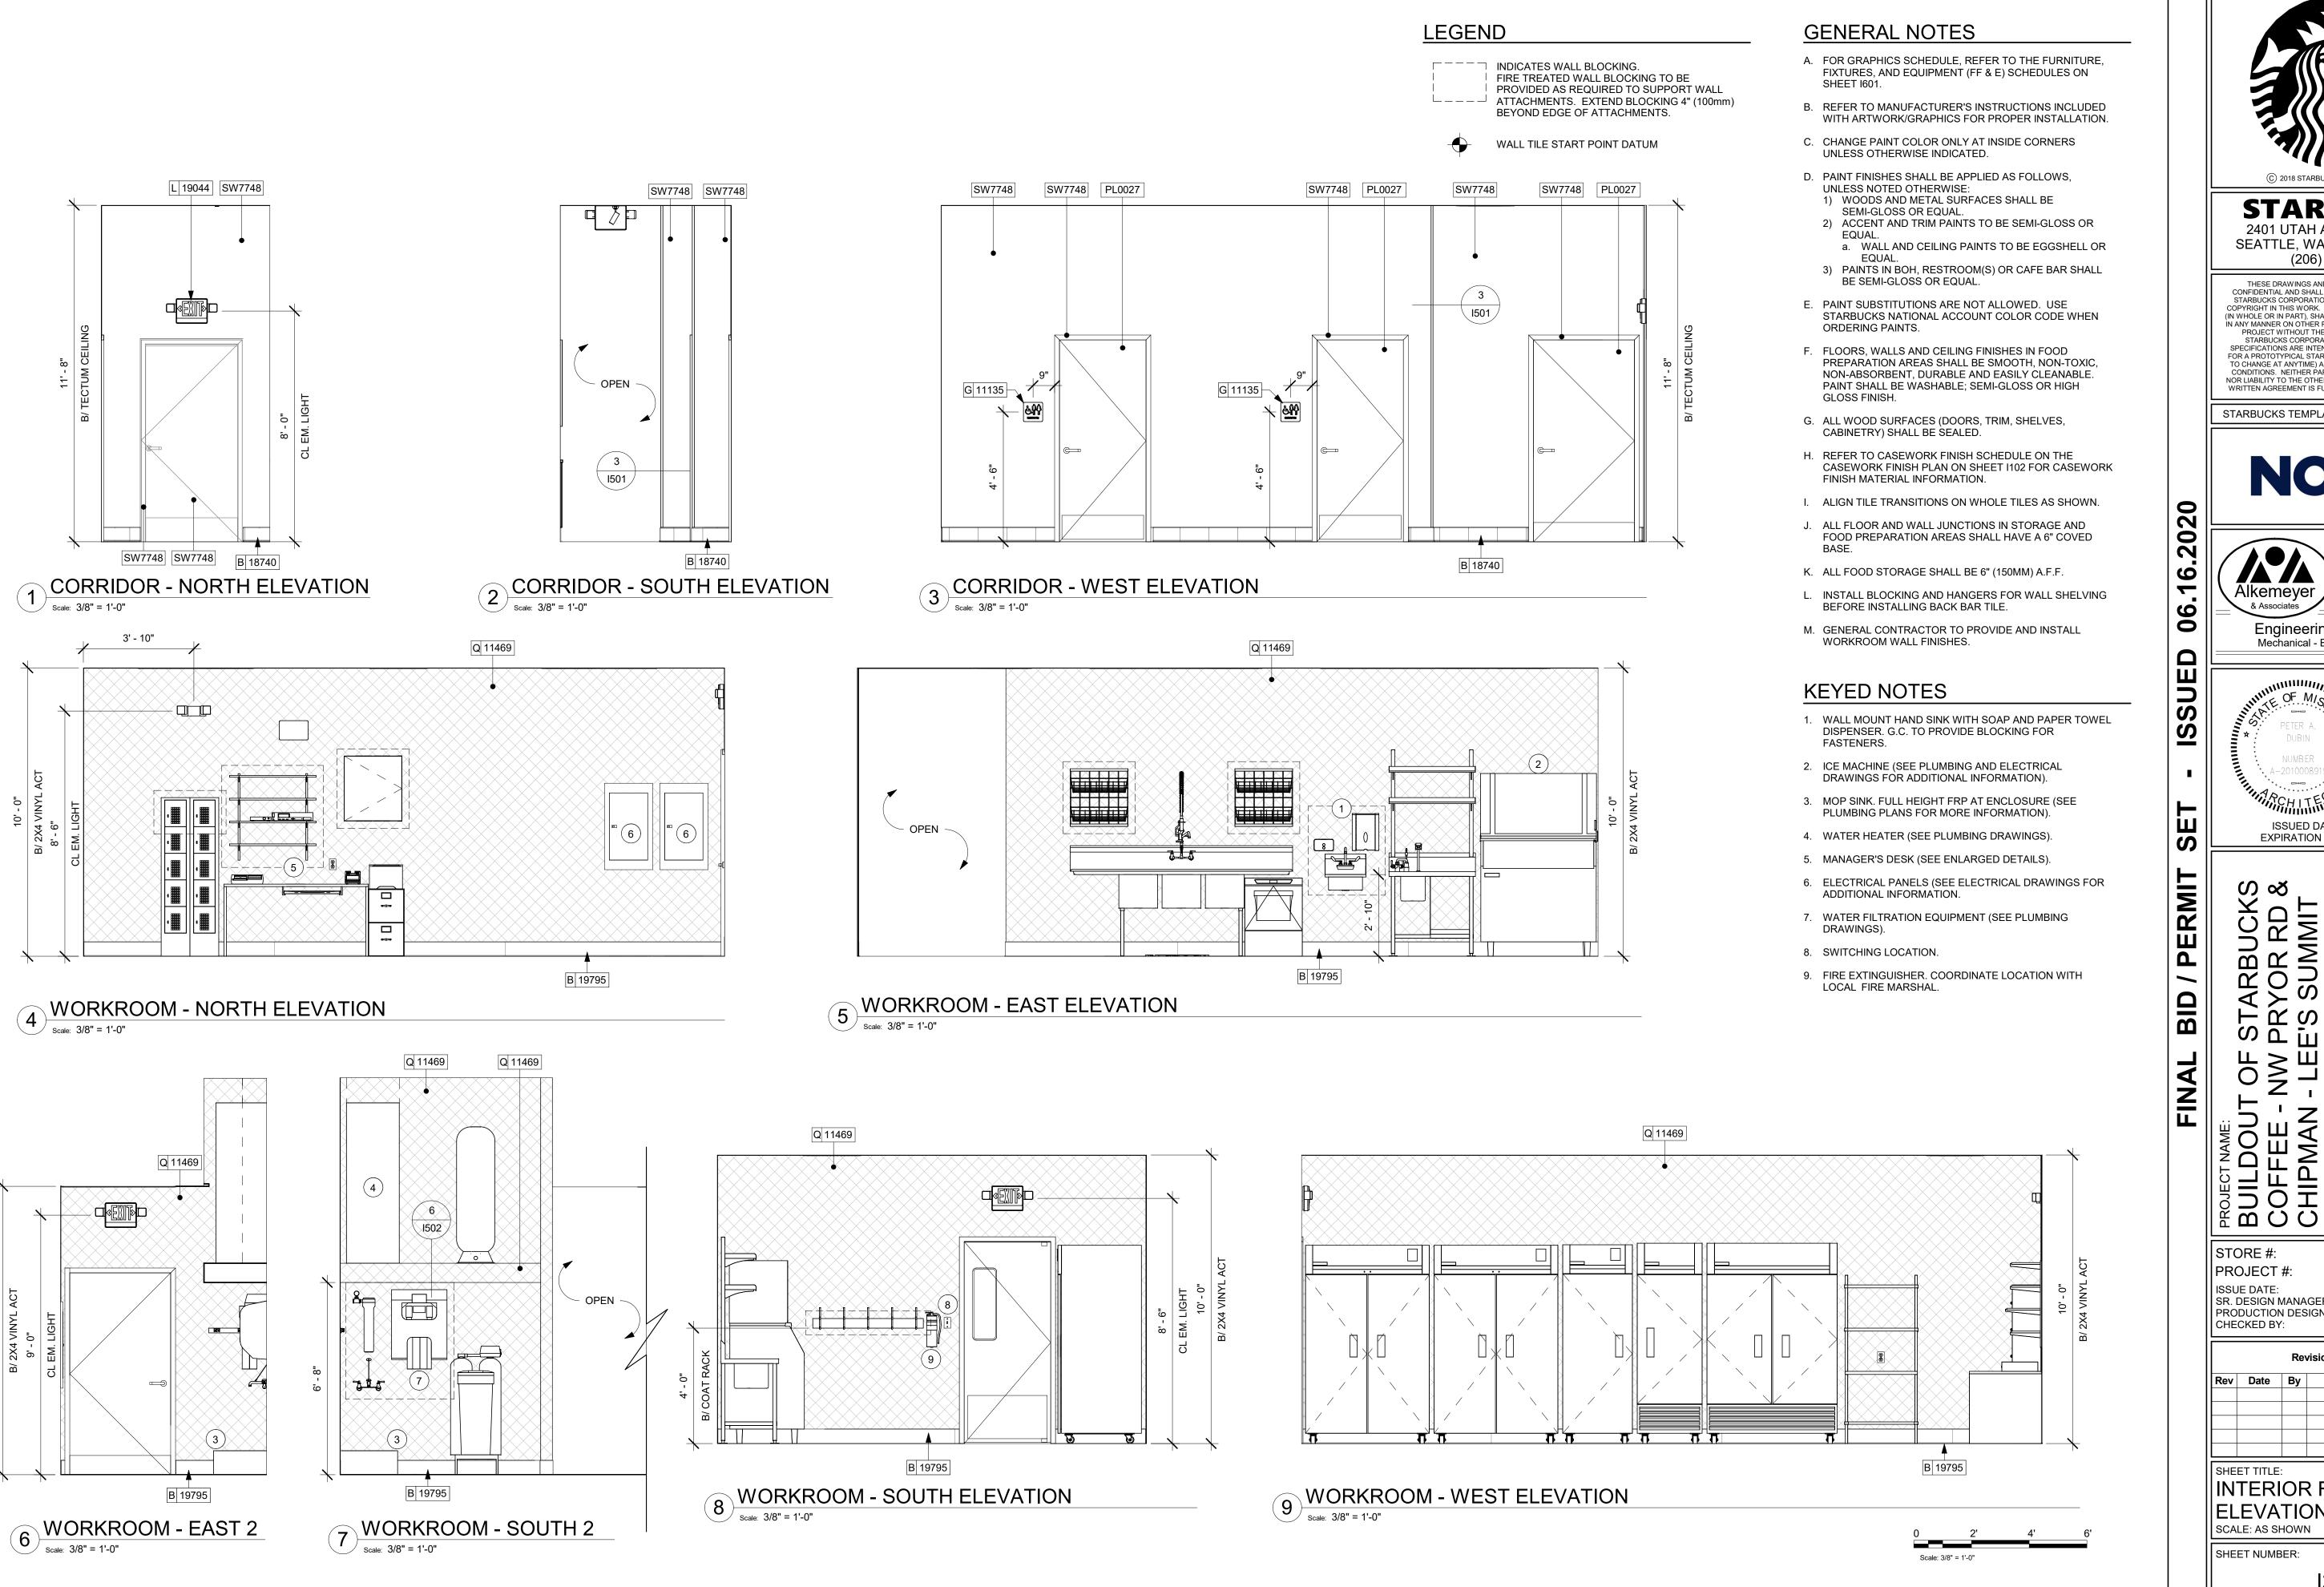
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Engineering Consultants Mechanical - Electrical - Plumbing



ISSUED DATE: 06/16/2020 EXPIRATION DATE: 12/31/2020

⊘ ⊗ ARBUCK YOR RD SUMMIT LOT VEST PRYOR, I ENSTEIN DR. MO


STORE #: 62012 87799-001 PROJECT #: ISSUE DATE: 06-16-2020 SR. DESIGN MANAGER: K. GORIN SLONSKI PRODUCTION DESIGNER: A. HAHN CHECKED BY: NORR

Revision Schedule

SHEET TITLE:

INTERIOR FINISH ELEVATIONS

SHEET NUMBER:

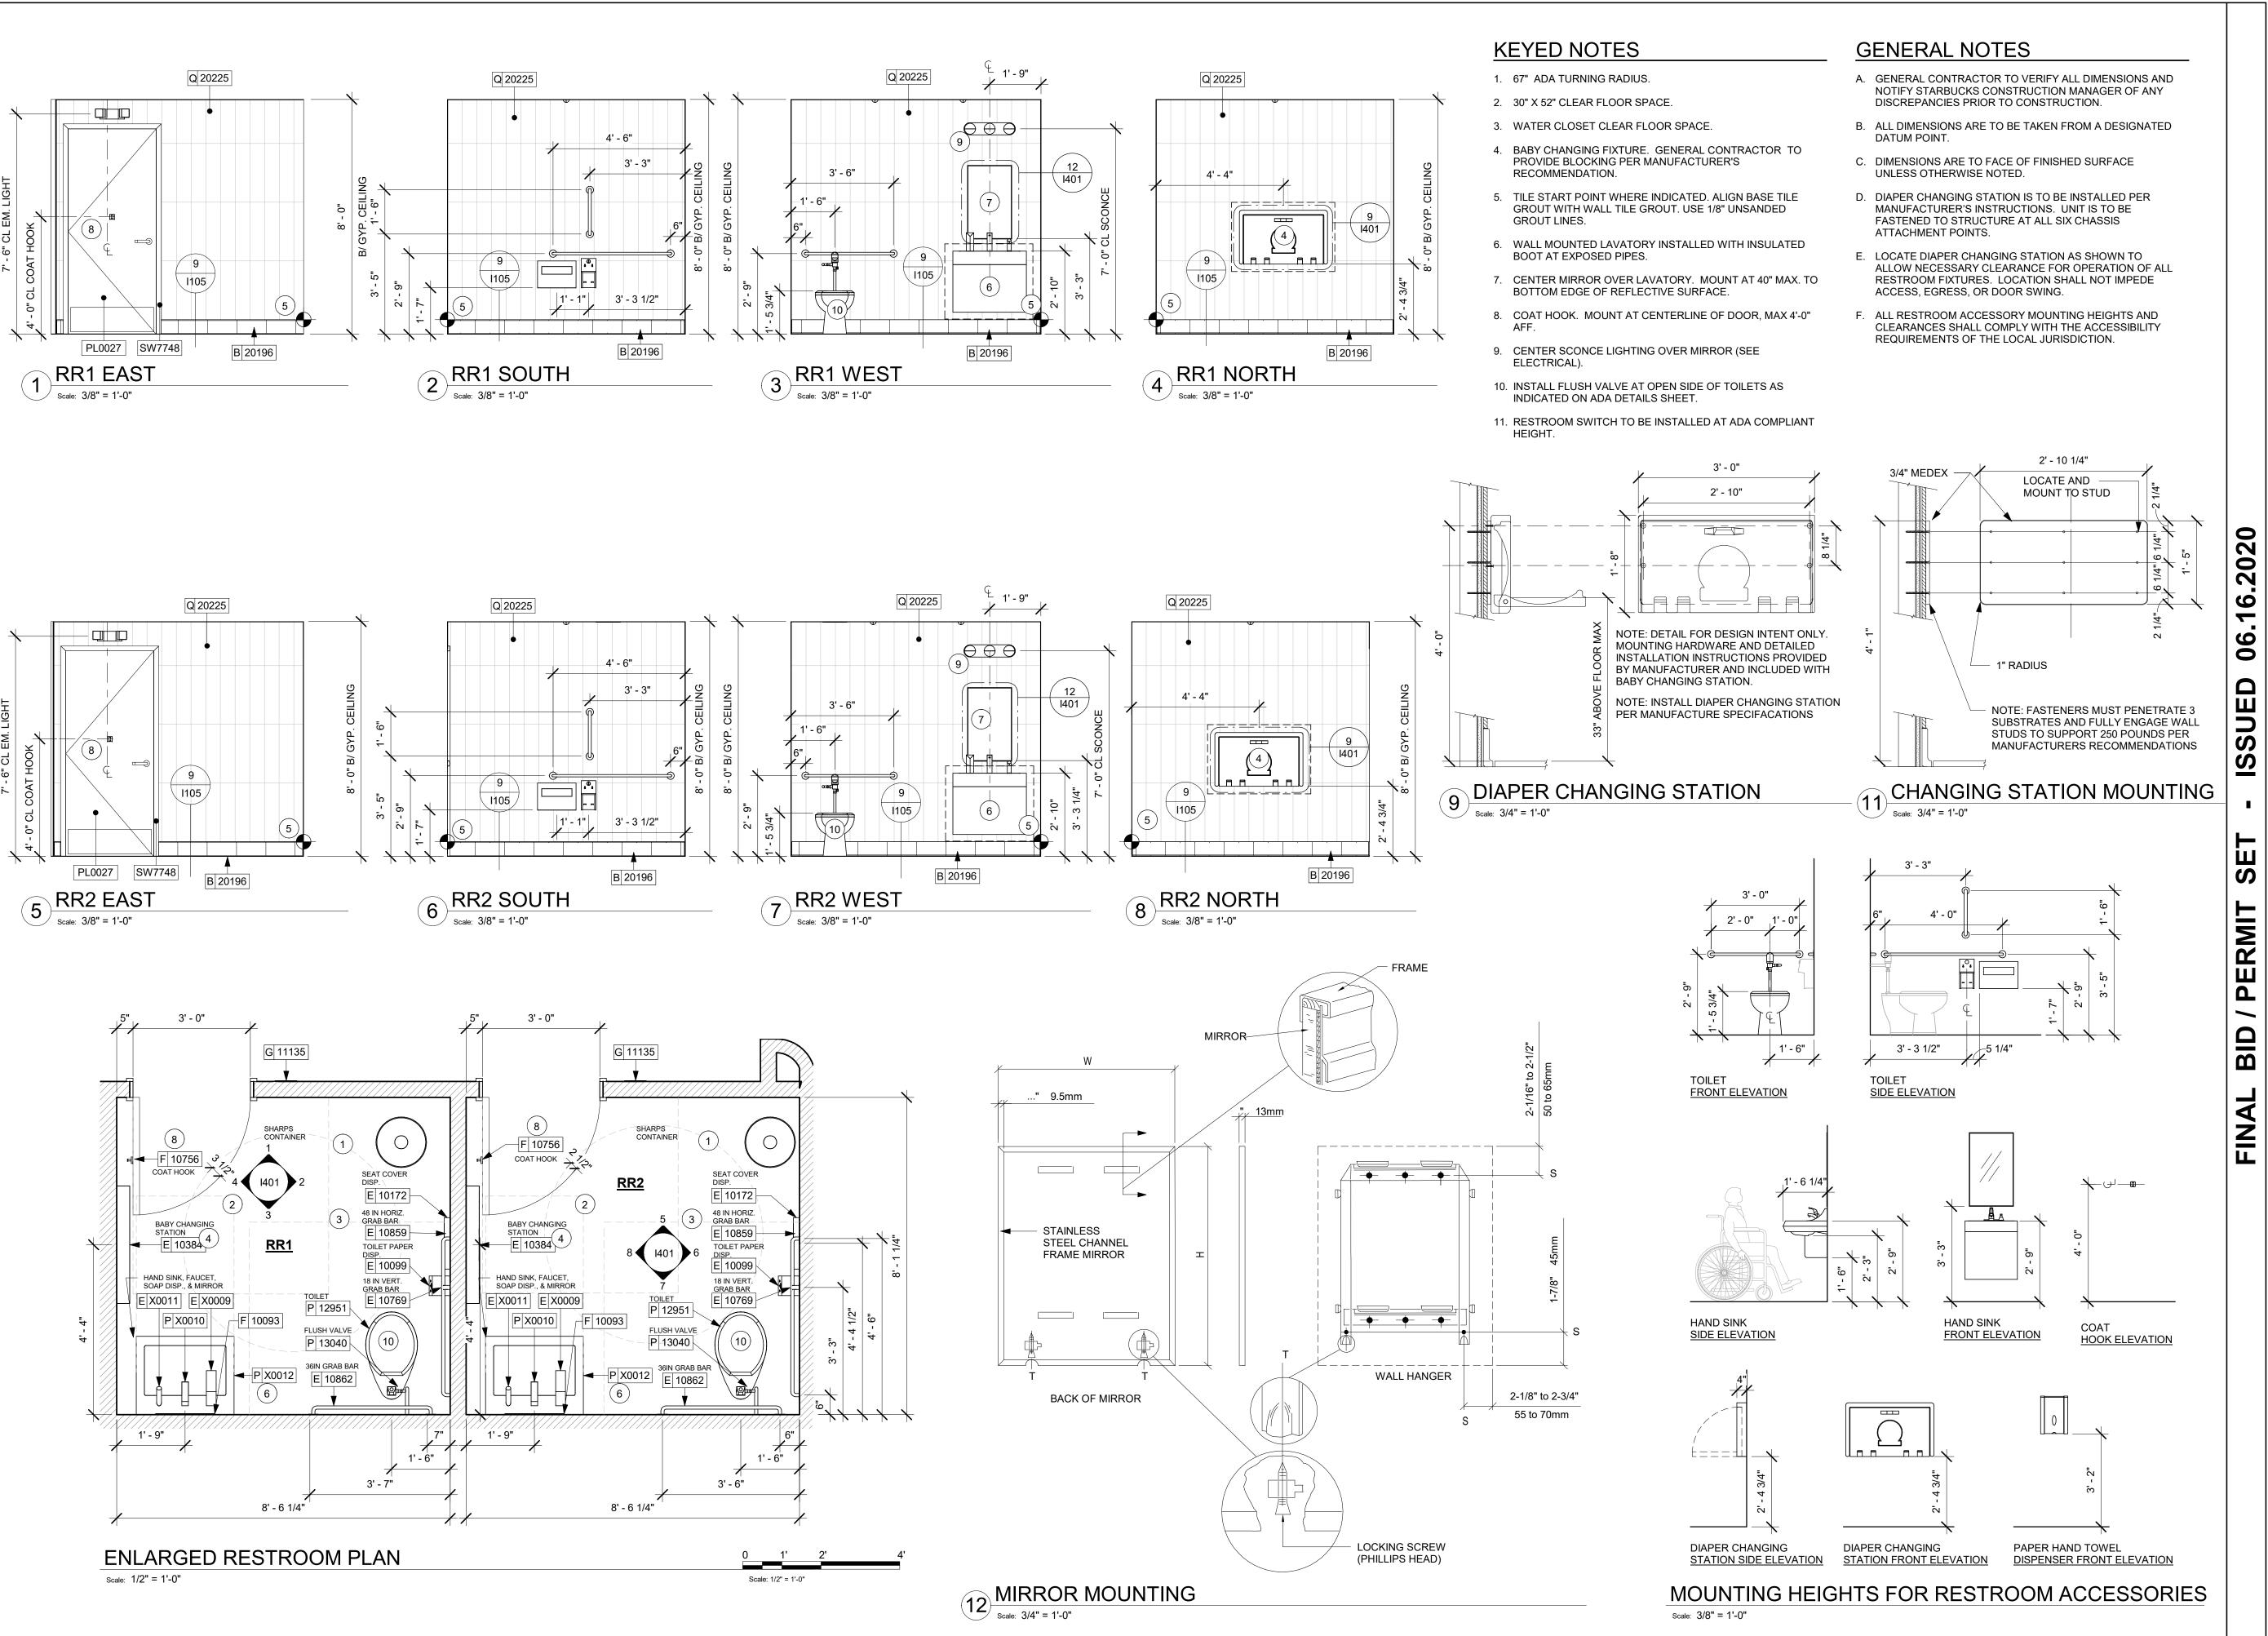



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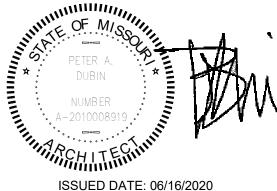


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Alkemeyer

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EXPIRATION DATE: 12/31/2020

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PRYOR, EIN DR.

STORE #: 62012 PROJECT #: 87799-001

ISSUE DATE: SR. DESIGN MANAGER: K. GORIN SLONSKI PRODUCTION DESIGNER: A. HAHN CHECKED BY: NORR

Revision Schedule SHEET TITLE:

RESTROOM PLAN & ELEVATIONS SCALE: AS SHOWN

SHEET NUMBER:

Scale: 1/2" = 1'-0"

NOTE: CASEWORK VENDOR TO PROVIDE SHOP DRAWINGS FOR SBUX REVIEW PRIOR TO FABRICATION



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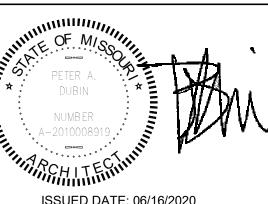
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ISSUED DATE: 06/16/2020

EXPIRATION DATE: 12/31/2020

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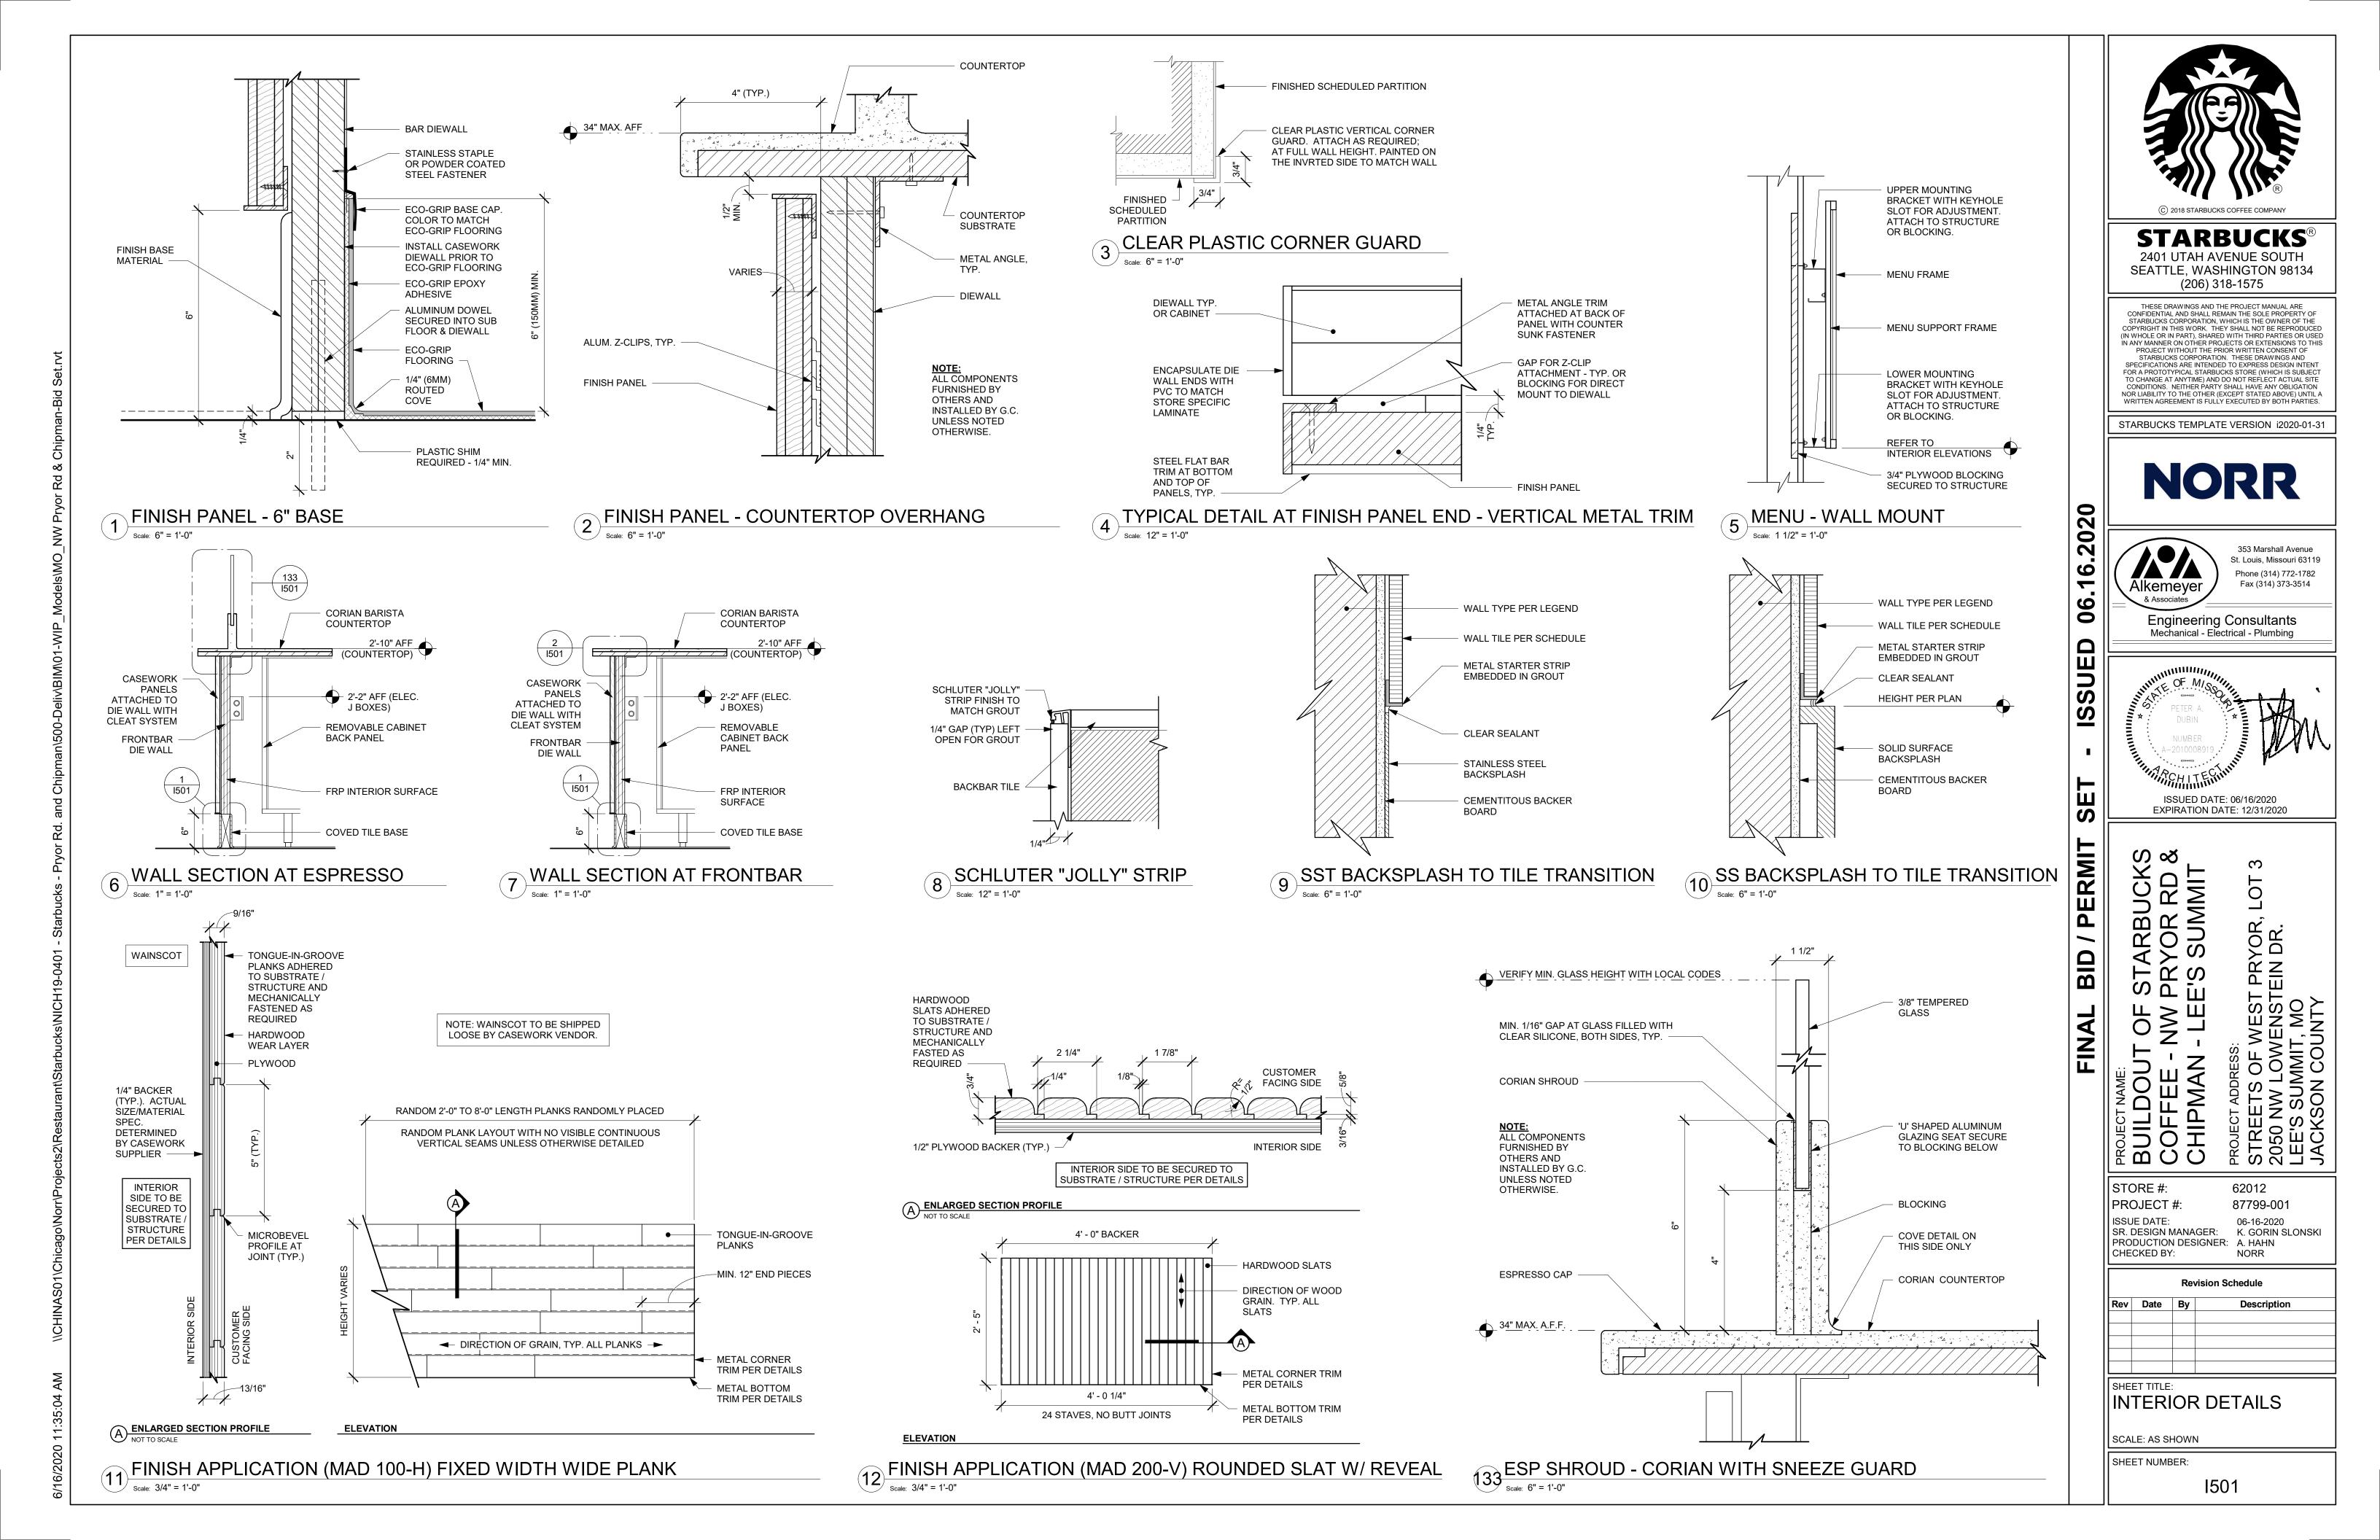
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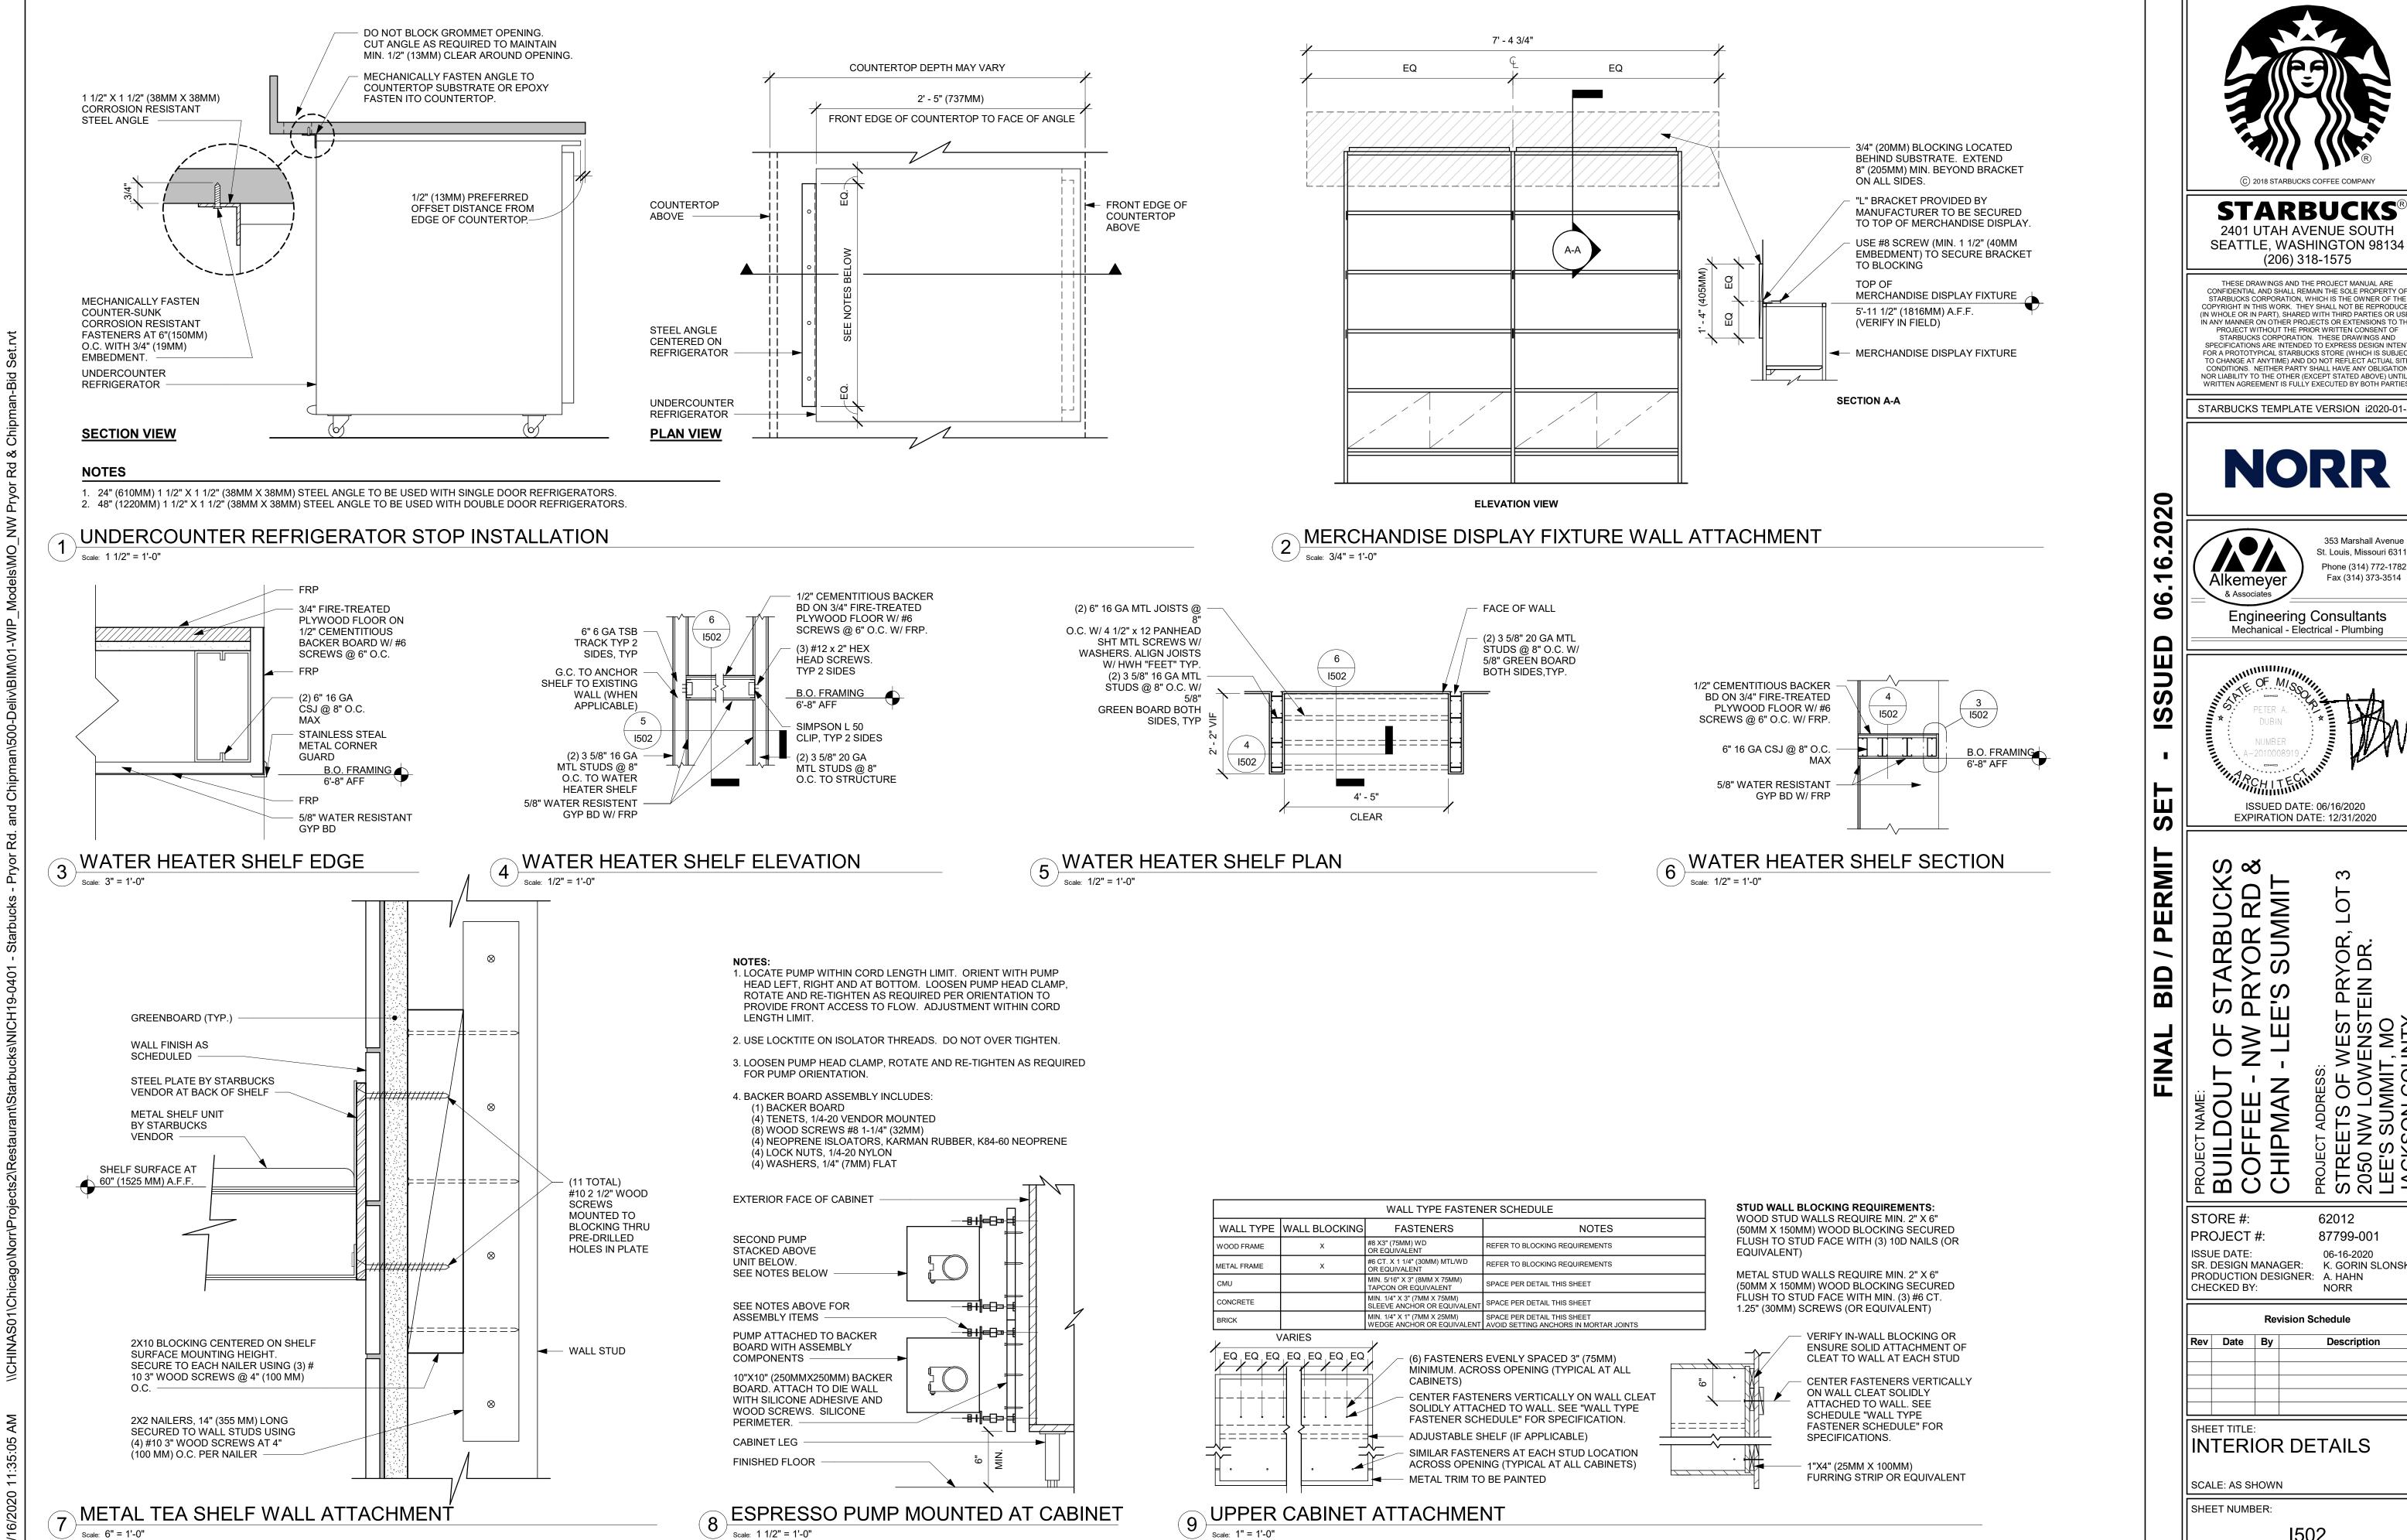
STORE #: PROJECT #: ISSUE DATE: SR. DESIGN MANAGER: K. GORIN SLONSKI PRODUCTION DESIGNER: A. HAHN CHECKED BY:

ENLARGED BAR PLANS

SCALE: AS SHOWN SHEET NUMBER:

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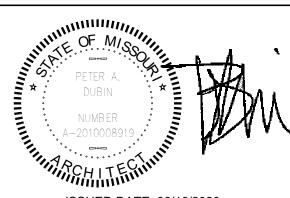
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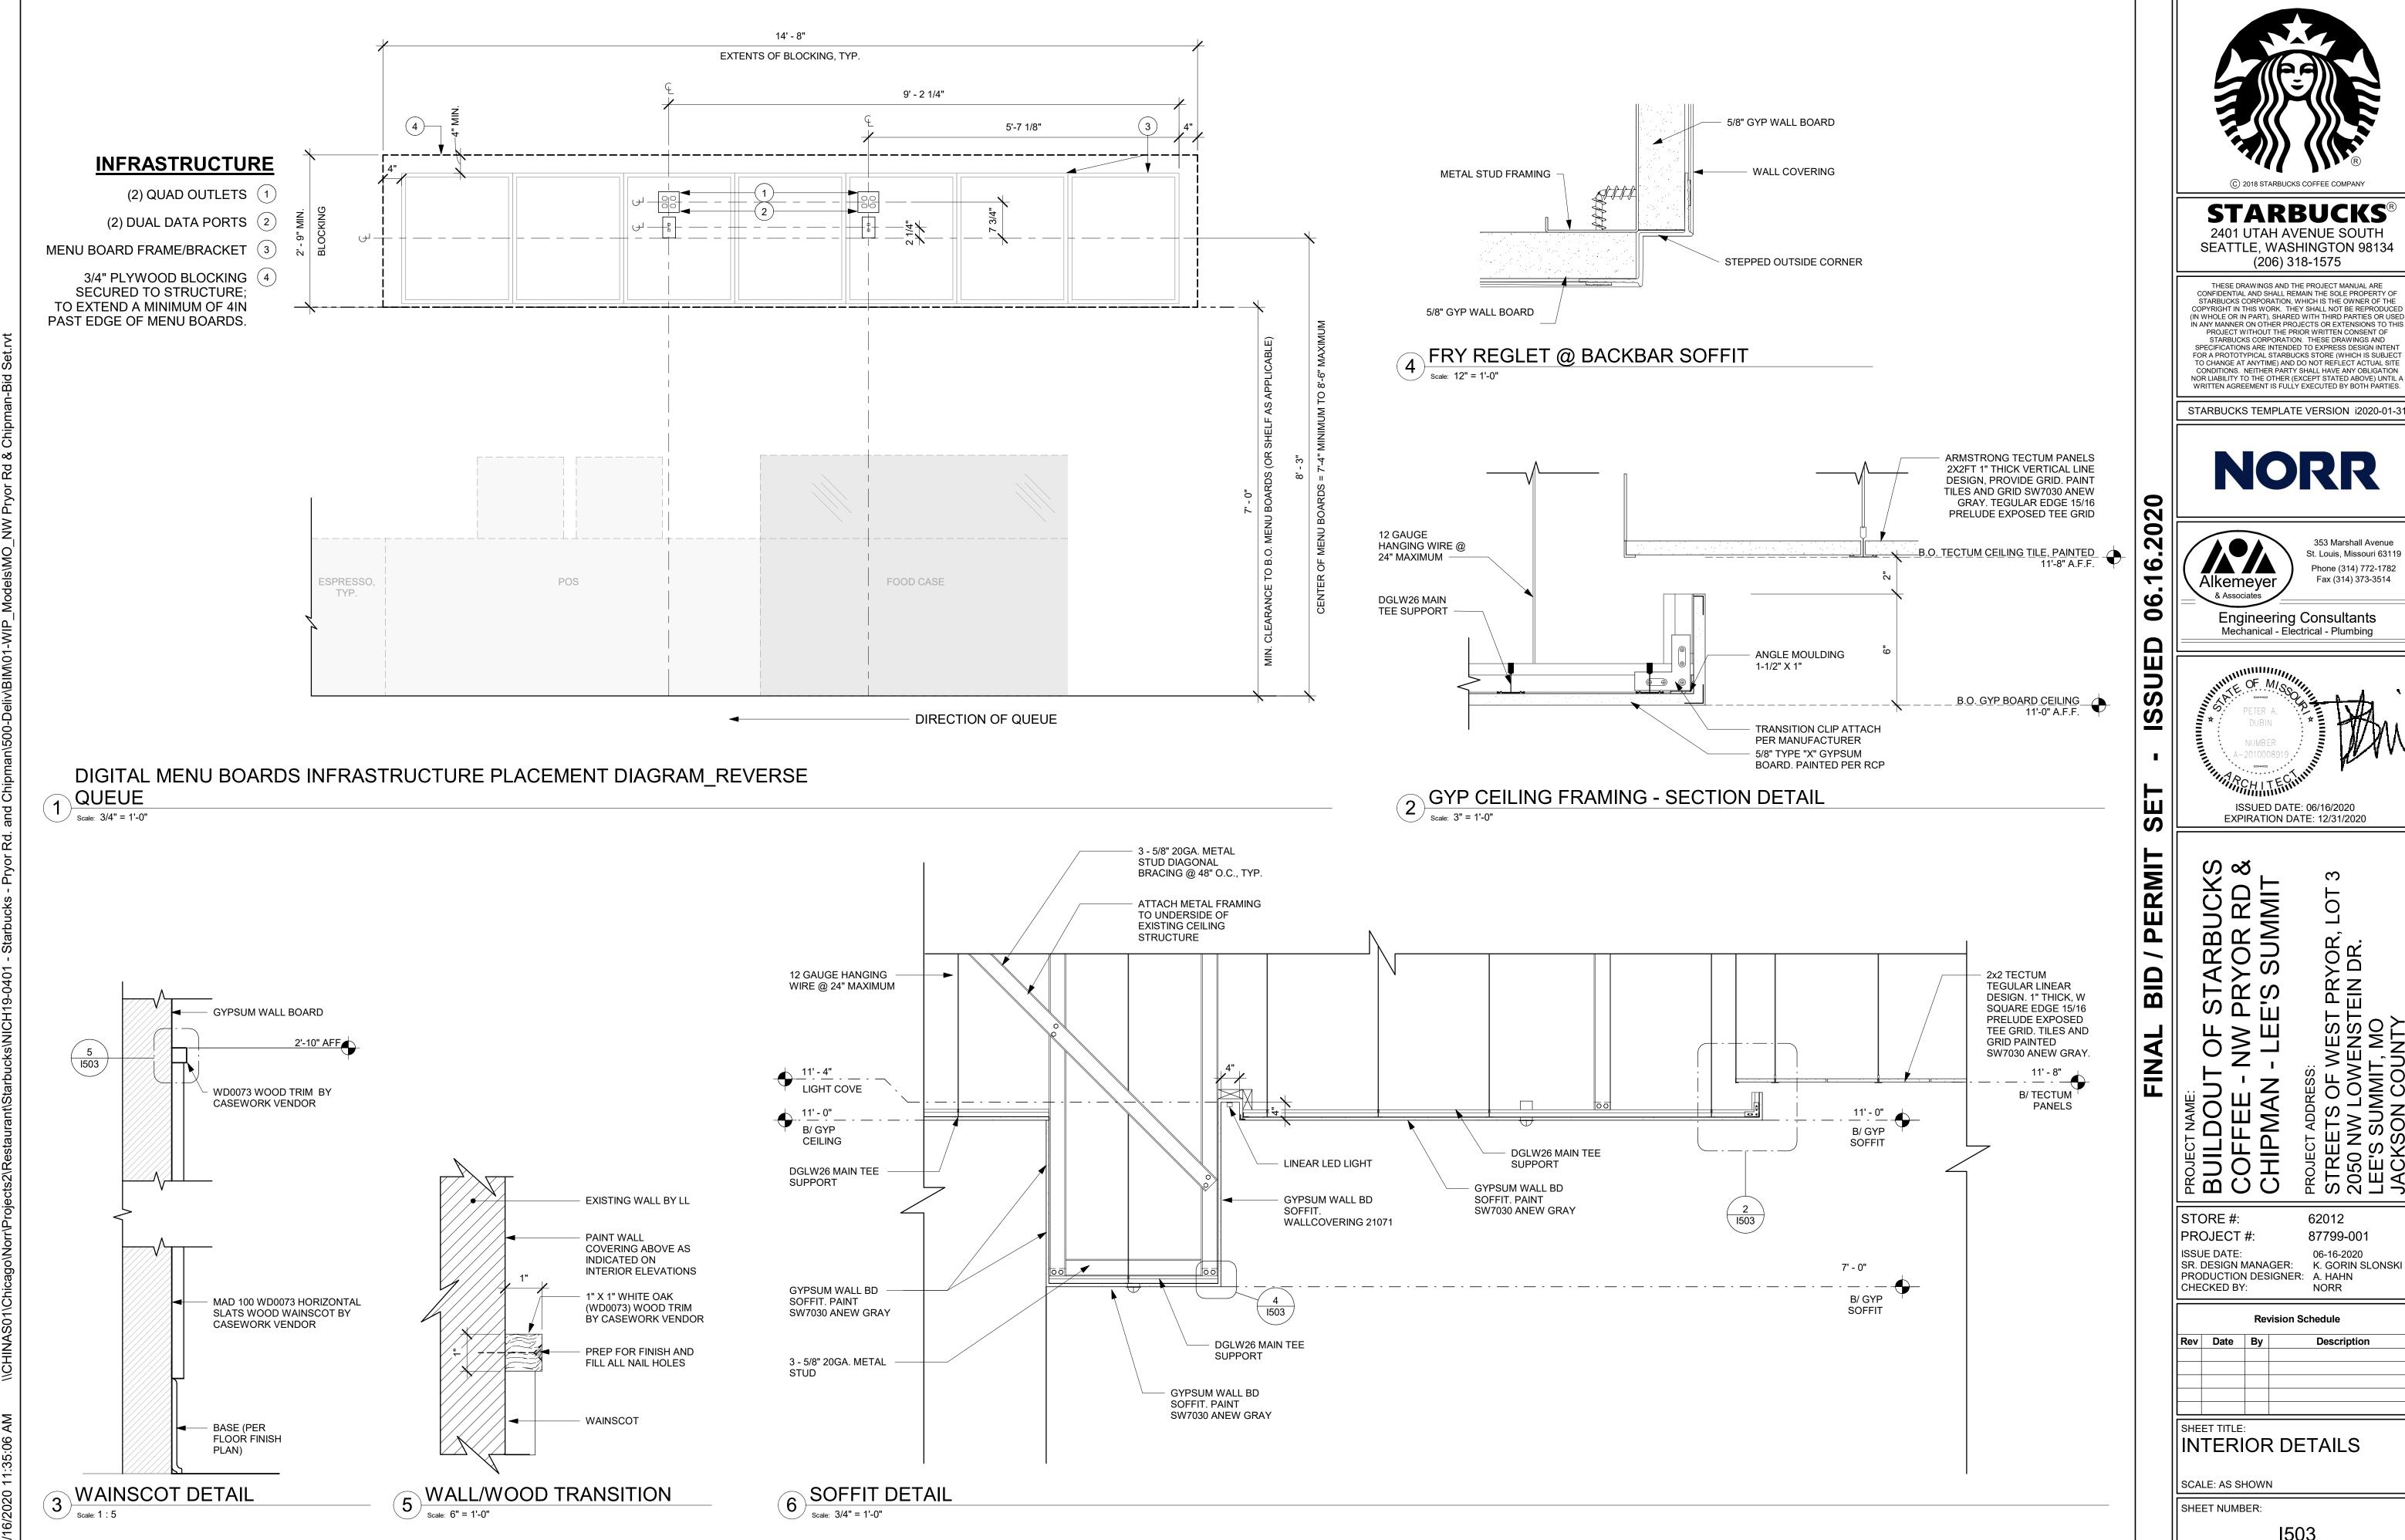
ISSUED DATE: 06/16/2020 EXPIRATION DATE: 12/31/2020

62012 87799-001 06-16-2020 SR. DESIGN MANAGER: K. GORIN SLONSKI PRODUCTION DESIGNER: A. HAHN

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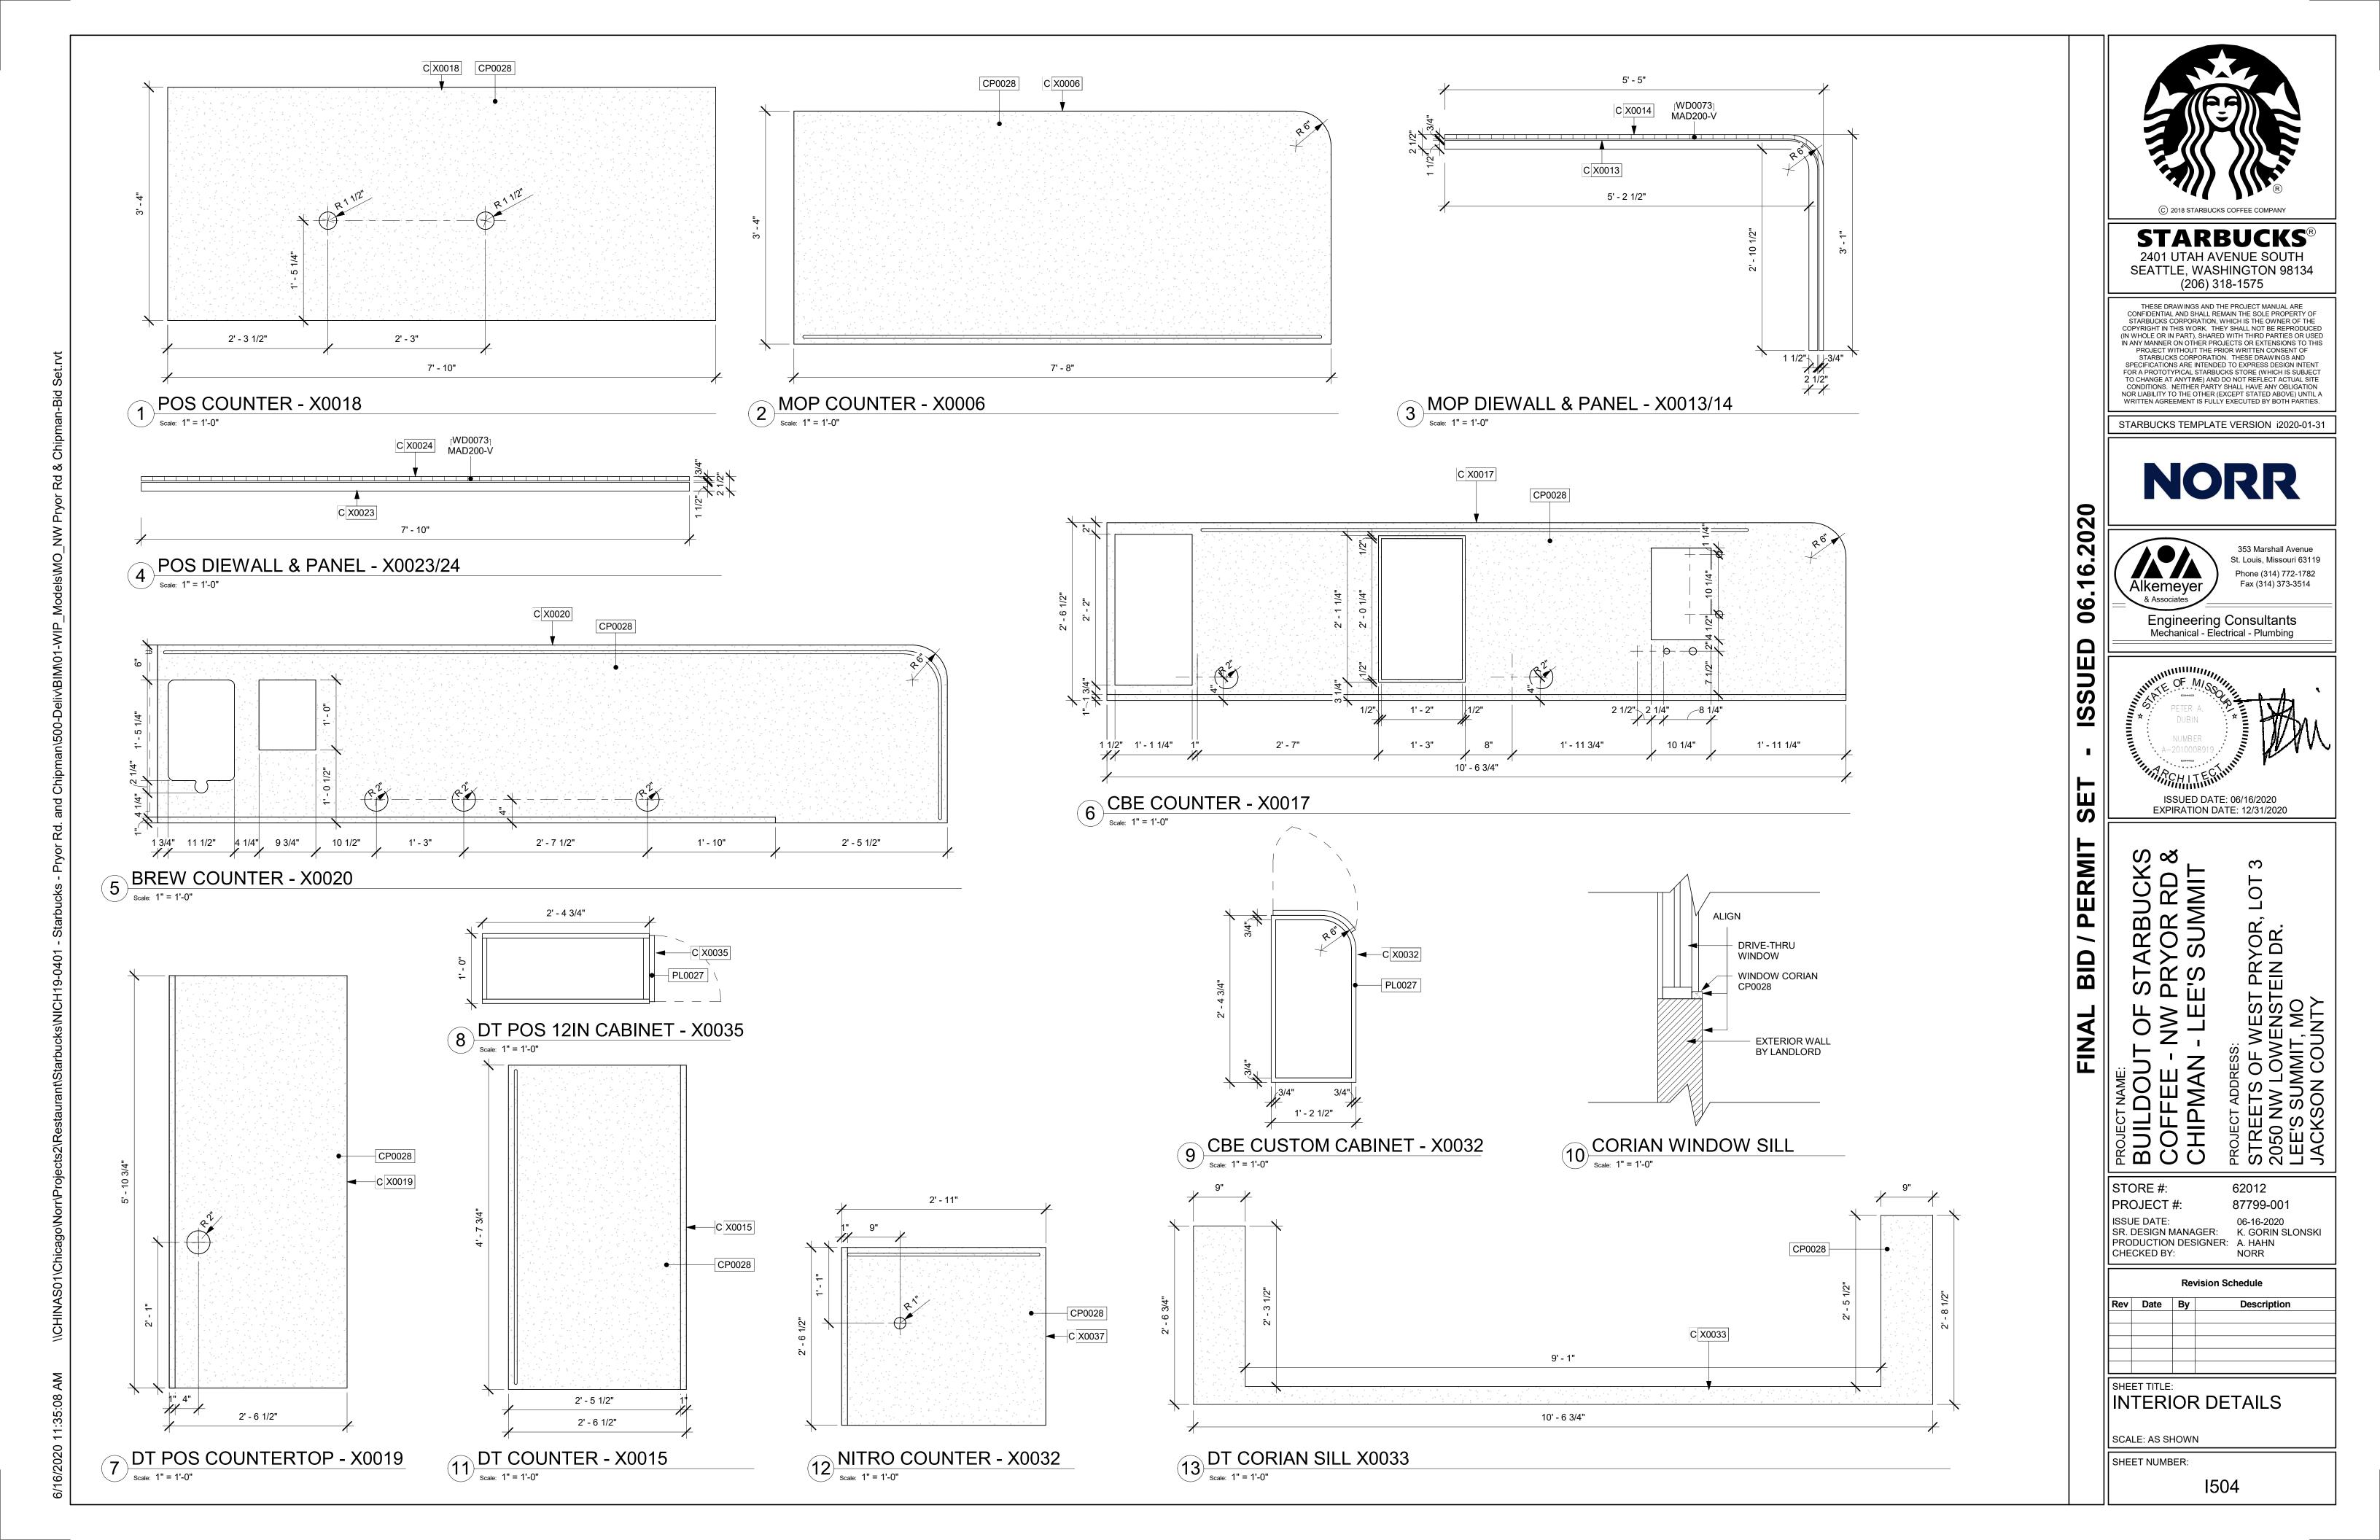
ISSUED DATE: 06/16/2020


EXPIRATION DATE: 12/31/2020


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62012 87799-001 NORR

Revision Schedule





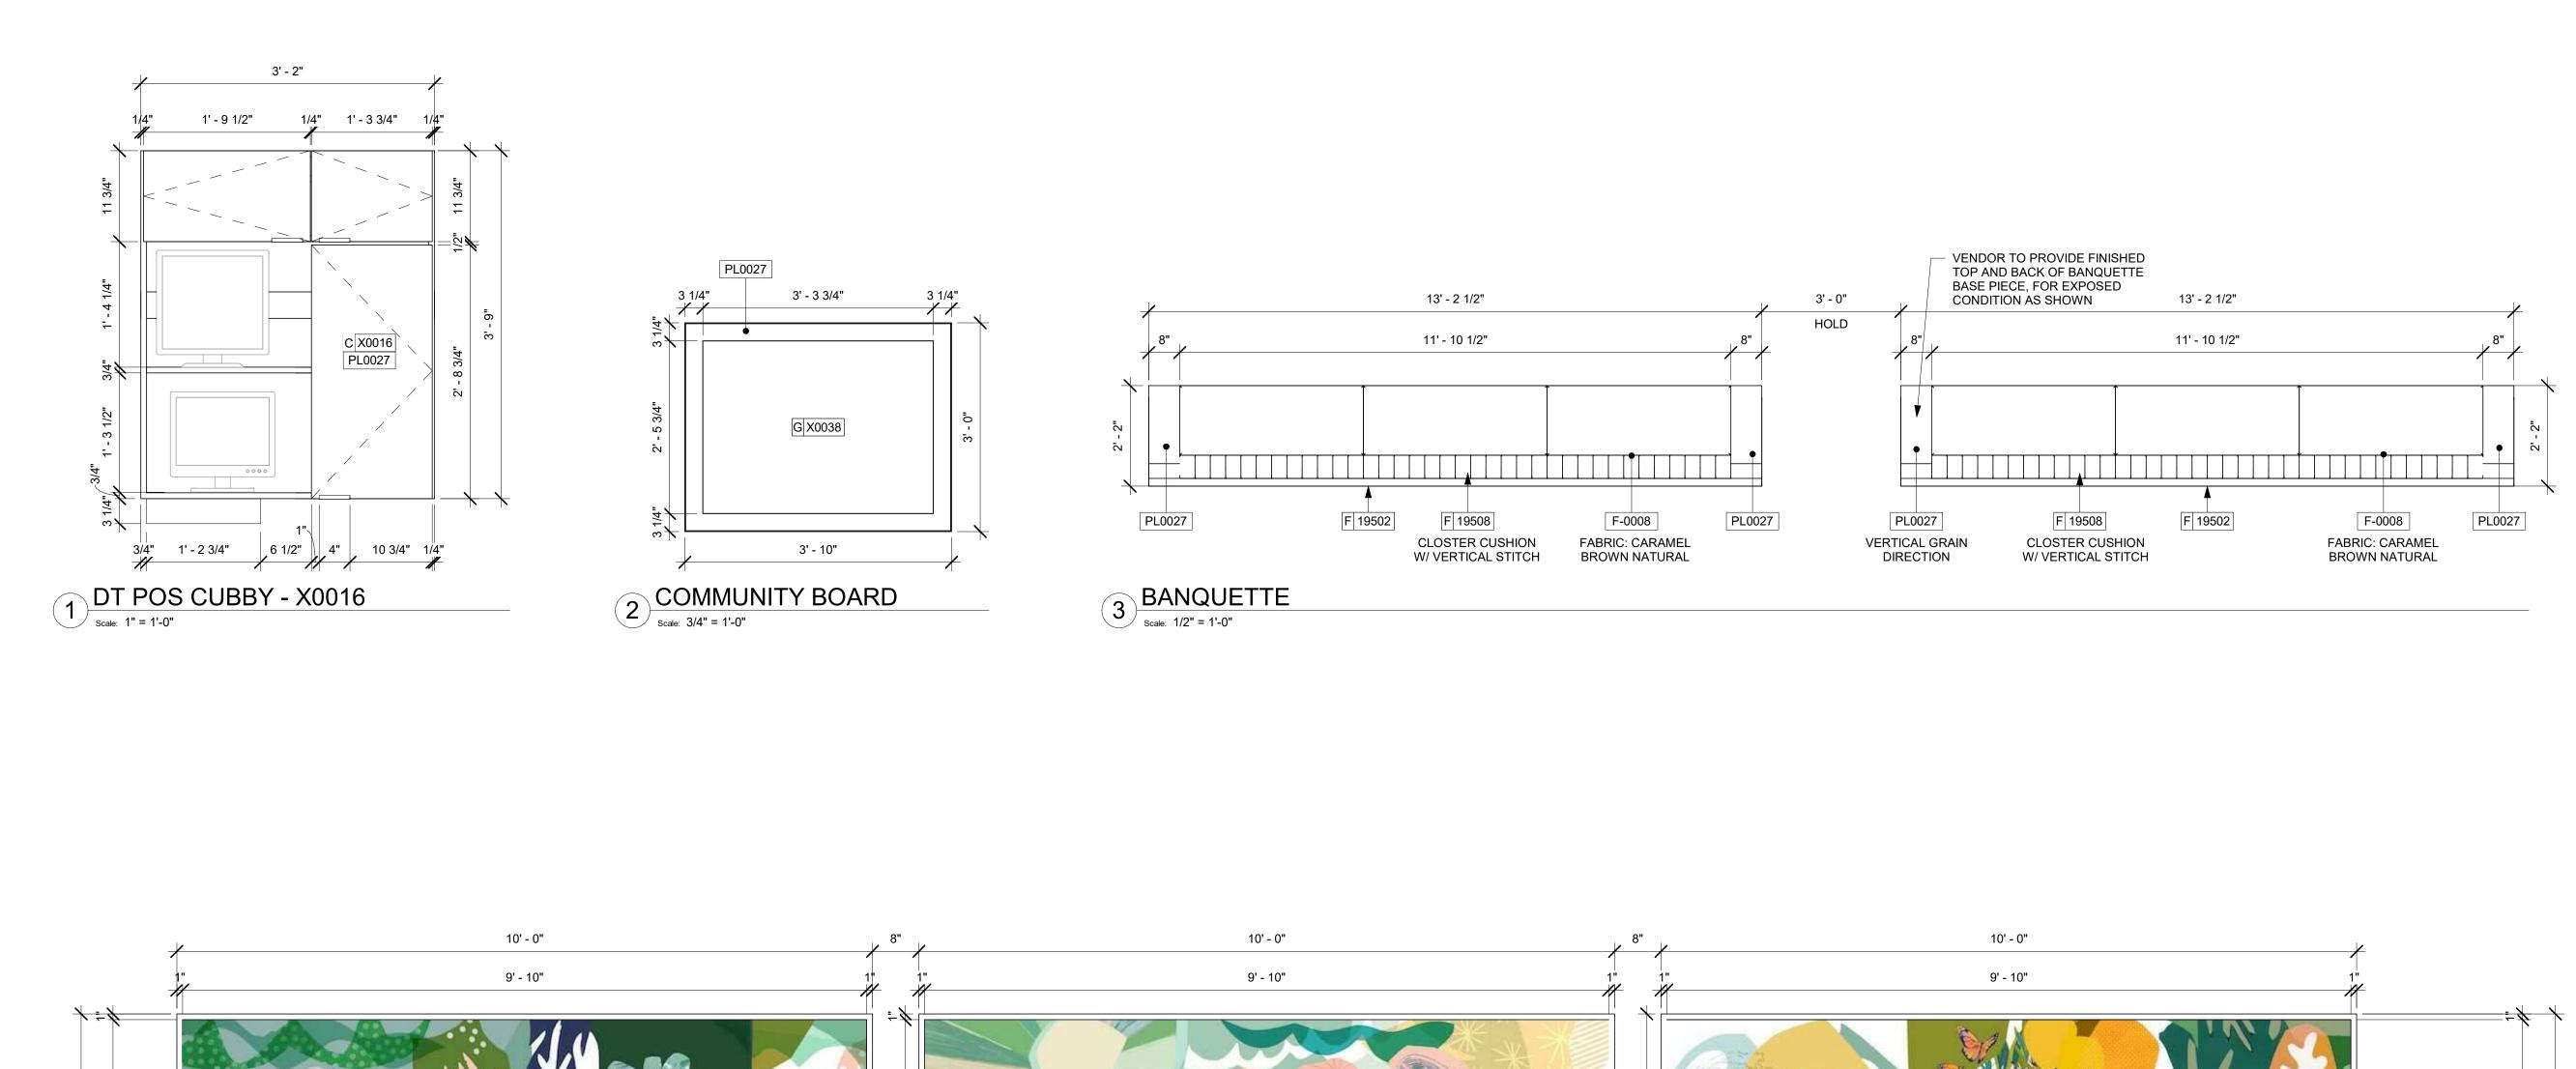

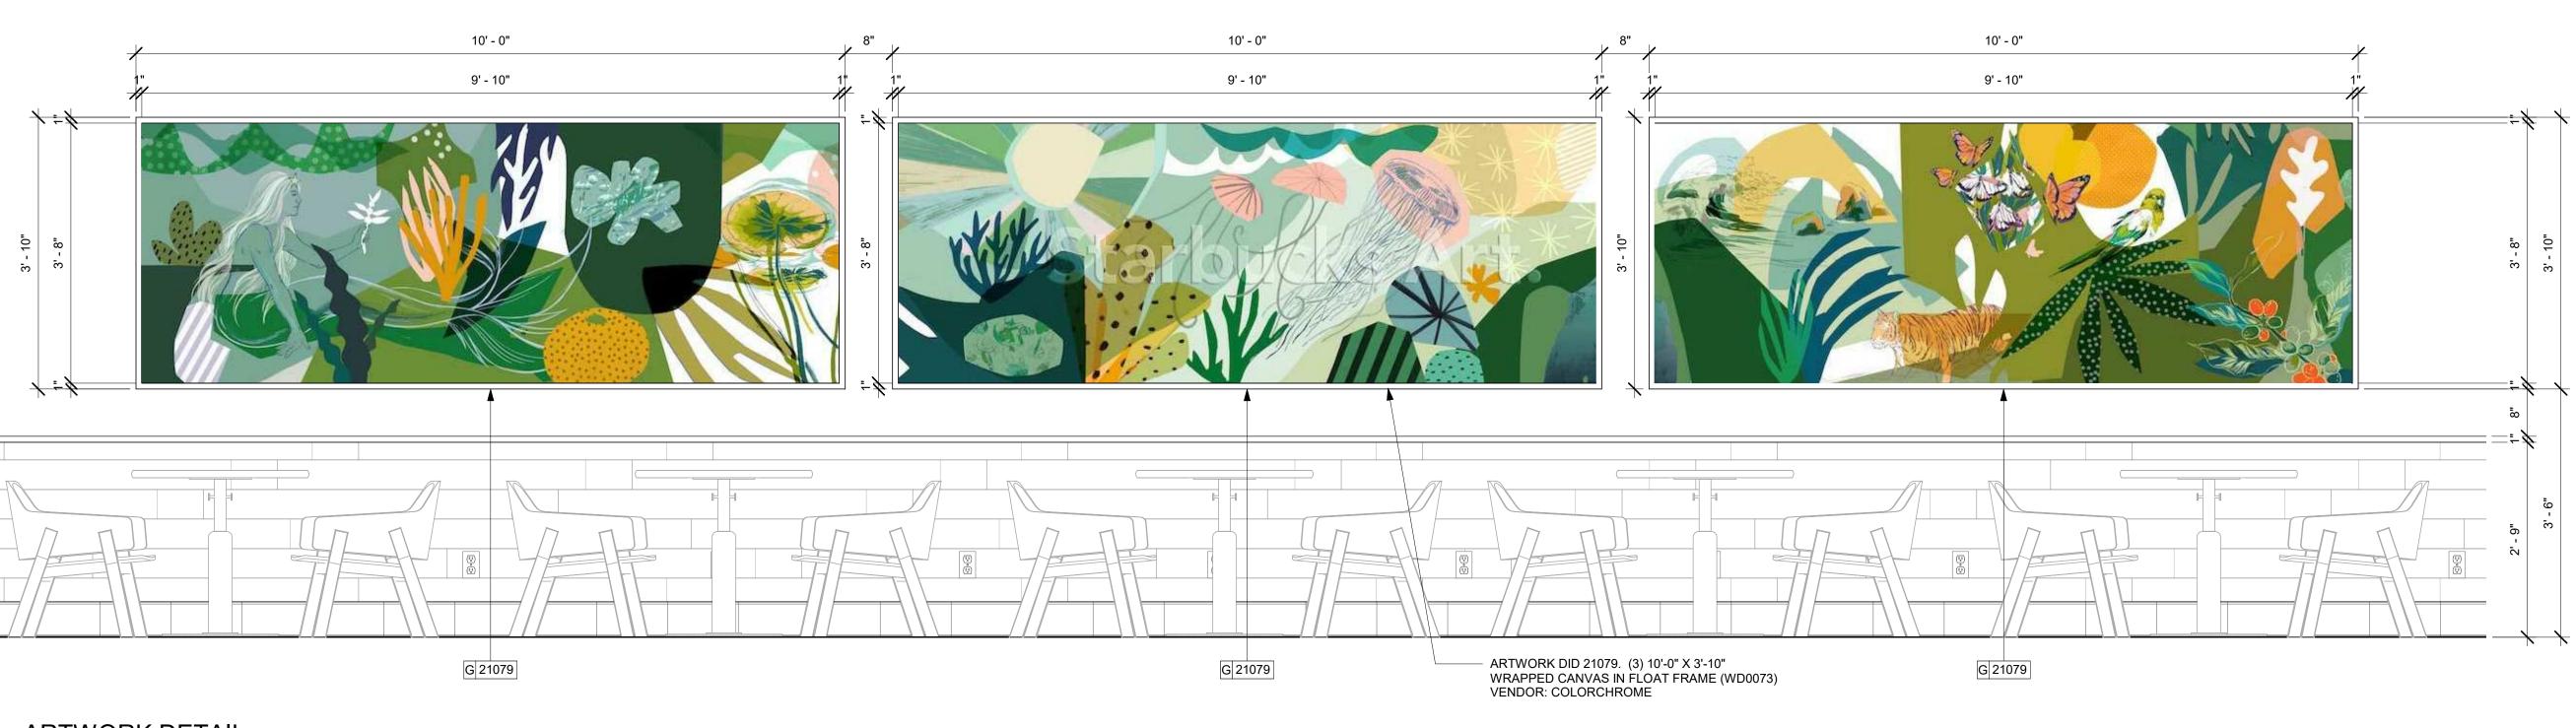ARTWORK DETAIL Scale: 3/4" = 1'-0"

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S S S BUILDOUT
COFFEE CHIPMAN

STORE #: 62012

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Alkemeyer

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Phone (314) 772-1782

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PROJECT #: 87799-001 ISSUE DATE: 06-16-2020
SR. DESIGN MANAGER: K. GORIN SLONSKI
PRODUCTION DESIGNER: A. HAHN
CHECKED BY: NORR

Rev	vision Schedule
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INTERIOR DETAILS

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		FURNITURE SCH	IEDULE - "I	F"	
DESIGN ID	COUNT	DESCRIPTION	FURN. BY	INST. BY	COMMENTS
BANQUETTE		1	T	T	I
19502	2	BANQUETTE - CLOSTER BASE - WHITE OAK WD0073	SB	GC	PROVIDE 8" SEAT SIDES FINISHED AND BACK FINISHED PER DETAIL. (2) TOTAL LENGTH: 13'-2 1/2", REFER TO DETAIL
19508	2	BANQUETTE - CLOSTER CUSHION VERTICAL STITCH - CARAMEL BROWN NATURAL F0008	SB	GC	(2) LENGTH: 13' - 2 1/2" VIF, REFER TO DETAIL
CHAIR	00	OLIAID, CAFE ANOLED BACK WITH WOVEN	OD	00	I
17852	20	CHAIR - CAFE ANGLED BACK WITH WOVEN SEAT - BLACK AND BROWN ROPE MT0028 F0194	SB	GC	
18803	10	CHAIR - LOUNGE CLUTCH - WHITE OAK AND CHARCOAL GREY NATURAL WD0073 F0188	SB	GC	
BROWN ROPE MT0028 F0194		SB	GC		
20088	2	CHAIR - LOUNGE CLAUDIA - COAL WOOL F0221	SB	GC	
21206	14	CHAIR - CAFE NOMI UPHOLSTERED - CHARCOAL GREY NATURAL F0188	SB	GC	
DESK			100		
10123	1	DESK - MANAGERS WORKSTATION - 60X30X30IN 1525X760X760MM	SB	GC	
10605	1	DESK - MANAGERS WORKSTATION KEYBOARD TRAY	SB	GC	
16505	1	DESK - MANAGERS WORKSTATION SHELVES - 36IN 915MM	SB	GC	
MIRROR		1	T	T	
10093	2	MIRROR - RESTROOM - 18X30IN 455X760MM	SB	GC	
OTHER			10-		
10756	2	COAT HOOK 1 PRONG SQUARE - 2IN 50MM - SST	SB	GC	
10820	1	COAT HOOK STRIP - 46IN 1170MM	SB	GC	
OTTOMAN		1	1	1	
21282	2	OTTOMAN - STOUT - WHITE OAK AND CARAMEL BROWN NATURAL WD0073 F0008	SB	GC	
PLANTER		Ta	1	1	
21047	1	PLANTER - DUO LARGE - FLAT BLACK MT0028		GC	
21053	1	PLANTER - DUO STAND - FLAT BLACK MT0028		GC	
X0029	1	PLANTS - INDOOR	GC	GC	GC TO ORDER & INSTALL PLANT. ARECA PALM DYPSIS LUTESCENS (LOW MAINTENANCE).
TABLE					
17340	8	TABLE - CAFE METAL PEDESTAL BASE SQUARE - 24IN 610MM - BLACK MT0028	SB	GC	
17341	2	TABLE - ACCESSIBLE METAL WITH TAPERED LEGS - 36X24IN 915X610MM - BLACK MT0028	SB	GC	
17645	8	TABLE - TOP SQUARE - 24IN 610MM - WHITE OAK WD0073	SB	GC	
18062	5	TABLE - TOP ROUND - 30IN 760MM - WHITE OAK WD0073	SB	GC	
18467	2	TABLE - TOP ACCESSIBLE OBLONG - 24X48IN 610X1220MM - WHITE OAK WD0073	SB	GC	
18468	4	TABLE - BASE CAFE T LEG - HOT ROLLED STEEL MT0011	SB	GC	
18729	13	TABLE - BASE CAFE HEIGHT APOLLO - HOT ROLLED STEEL MT0011	SB	GC	
19306	1	TABLE - TOP ROUND - 18IN 455MM - WHITE OAK WD0073	SB	GC	
19718	1	TABLE - BASE OCCASIONAL SIDE ESSENTIAL - FLAT BLACK MT0028		GC	
20125	3	TABLE - OCCASIONAL COFFEE CAMERON - OYSTER WHITE MT0045	SB	GC	
20545	1	TABLE - OCCASIONAL COCKTAIL STUDY - FLAT BLACK MT0028	SB	GC	
WINDOW TH	REATMENT		•	•	
12716	4	ROLLER SHADE - CHARCOAL TRANSLUCENT	SB	GC	VERIFY DIMENSIONS IN FIELD

MECHANICAL EQUIPMENT SCHEDULE - "M"						
DESIGN ID	COUNT	DESCRIPTION	FURN. BY	INST. BY	COMMENTS	
FAN				•		
10894	1	FAN - DT AIR CURTAIN WITH HEATER - 48IN 1220MM	LL	LL	INCLUDED AS PART OF DT WINDOW PACKAGE. READY ACCESS AA300-275 PASS THRU AIR CURTAIN SYSTEM. CONTACT: ANNA ELLIS, ANNA@READY-ACCESS.COM	
X0003	1	FAN - WALL MOUNTED FAN - PATIO	GC	GC	GLOBAL INDUSTRIAL 30IN OSCILLATING WALL MOUNTED FAN. ITEM #T9F292451. GO TO PROVIDE MOUNTING PARTS AS NEEDE LL TO PROVIDE ELECTRICAL POWER.	
HVAC						
10317	19	HVAC - VAV SUPPLY 4 WAY SQUARE - 24IN 610MM	GC	GC	SEE MECHANICAL SCHEDULES. PAINT TO MATCH ASSOCIATED CEILING COLOR.	
11163	6	HVAC - RETURN LAY IN SQUARE - 24IN 610MM	GC	GC	SEE MECHANICAL SCHEDULES. PAINT TO MATCH ASSOCIATED CEILING COLOR.	
11165	3	HVAC - RETURN CHANNEL FRAME SQUARE - 10IN 255MM	GC	GC	SEE MECHANICAL SCHEDULES. PAINT TO MATCH ASSOCIATED CEILING COLOR.	
OTHER						
17797	1	ENERGY MANAGEMENT SYSTEM - HVAC ONLY	SB	GC		
X0028	3	ACCESS PANELS	GC	GC	BAUCO PLUSS III SINGLE LEAF CEILING ACCESS PANEL. TOUCH LATCH. CONCEALED HARDWARE. CONTACT: 250.592.0033 / INFO@ACCESSPANELSOLUTIONS.COM FINSH TO MATCH HOST CEILING	

DESIGN ID	COUNT	DESCRIPTION	FURN. RY	INST. BY	COMMENTS
COOLING 10267	5	FRIDGE UNDERCOUNTER 1 DOOR - 27IN	SB	GC	COMMENTO
		685MM			
10970 11083	2	FRIDGE REACH IN 1 DOOR LH - 29IN 735MM FRIDGE REACH IN 2 DOOR - 51X35IN 1295X890MM	SB SB	GC GC	
12618	2	FRIDGE UNDERCOUNTER 1 DOOR WITH SHELF - 27IN 685MM	SB	GC	
13676	1	FREEZER REACH IN 1 DOOR RH - 27IN 685MM	SB	GC	
13682 20011	1 1	FREEZER REACH IN 2 DOOR - 54IN 1370MM FRIDGE NITRO 2 TAP JT NITCOM RH	SB SB	GC GC	KIT INCLUDES UNDERCOUNTER FRIDGE,
	· 	TRIBOL NITRO 2 TAI ST NITCONTRIT	JOB TO THE PERSON NAMED IN COLUMN TO		FONT, TRAY, AND TUBING
EQUIPMENT 10312	4	BREWER SOFT HEAT WARMING STAND SINGLE	SB	GC	
10746	1	BREWER DUAL SOFT HEAT	SB	GC	GC TO COORDINATE WITH SBUX VENDOI
10808 10856	1 6	GRINDER DITTING KR1203 BREWER SERVER SOFT HEAT	SB SB	GC GC	GC TO COORDINATE WITH SBUX VENDO
12407	2	OVEN TURBOCHEF NEXT GENERATION	SB	GC	
12508	2	BLENDER QUIET MODEL ON COUNTER	SB	GC	
12508	1	BLENDER QUIET MODEL ON COUNTER - BACK-UP	SB	GC	TO BE STORED IN BACK OF HOUSE UNLE NEEDED
15186 16623	1 1	DISHWASHER HOT LOW STEAM SCALE DIGITAL WITH ADJUSTABLE DISPLAY	SB SB	GC GC	
	•	MOUNT SMALL			
17564	1	BLENDER PITCHER RINSER WITH SENSOR	SB	GC	00 TO 0000001114TE 1110TA 1 1 TO 1
19559	1	NITROGEN GENERATOR ELEMENT	SB	GC	GC TO COORDINATE INSTALLATION & CONNECTIONS WITH SBUX VENDOR
19742	2	ESPRESSO MACHINE MASTRENA II	SB	GC	GC TO COORDINATE WITH SBUX VENDO
FOOD CASE	1	FOOD CASE - ZEPHYR - 66IN 1675MM	SB	GC	
CE					
10344	1	ICE - BIN DROP IN 90LB 40KG	SB	GC	
18029	1 1	ICE - BIN B110 ICE - MACHINE CIM1446HR SERIES REMOTE	SB SB	GC GC	
18846	·	COOLED			
19278 OTHER	2	ICE - BIN DROP IN 45LB 20KG HORIZONTAL	SB	GC	
10091	1	CUP DISPENSER TALL HOT VERTICAL	SB	GC	
10099	2	RESTROOM TOILET PAPER HOLDER	SB	GC	
10172	2	RESTROOM SEAT COVER DISPENSER	SB	GC	
10384	2	DIAPER CHANGING STATION HORIZONTAL	SB	GC	
10396 10467	1 1	CUP DISPENSER SHORT HOT VERTICAL FILE CABINET 2 DRAWER	SB SB	GC GC	
10407	<u>'</u> 1	FIRE EXTINGUISHER	GC	GC	LOCALLY SOURCED
10769	2	RESTROOM GRAB BAR VERTICAL - 18IN 455MM	SB	GC	
10791	2	CUP DISPENSER GRANDE VENTI COLD VERTICAL	SB	GC	
10855	2	CUP DISPENSER GRANDE VENTI HOT VERTICAL	SB	GC	
10858	1	CUP DISPENSER TALL COLD VERTICAL	SB	GC	
10859	2	RESTROOM GRAB BAR - 48IN 1220MM	SB	GC	
10862 10947	<u>2</u> 1	RESTROOM GRAB BAR - 36IN 915MM SOAP DISPENSER WALL MOUNTED	SB SB	GC GC	
10977	1	PAPER TOWEL DISPENSER FULL SIZE - TRANSLUCENT GRAY	SB	GC	
10992	2	PAPER TOWEL DISPENSER HALF SIZE -	SB	GC	
11115	2	TRANSLUCENT GRAY SOAP DISPENSER SINK MOUNTED	SB	GC	
13330	1	MOBILE CUP DISPENSER CADDY	SB	GC	
13584	1	CUP DISPENSER TRENTA COLD VERTICAL	SB	GC	
19495	1	NITRO 2 TAP HANDLE AND BADGE KIT	SB	GC	
20079	1	NITRO 2 TAP BADGE MOUNT BACKBAR LH	SB	GC	
20080 X0009	2	NITRO 2 TAP BADGE MOUNT BACKBAR RH HAND DRYER - INTEGRATED	GC GC	GC GC	XLERATOR SYNC HAND DYER. AUTOMAT SENSOR OPERATED. SURFACE MOUNTE CONTACT: D 13 GROUP. 245 WEST CENT STREET, NATICK, MA 01760. PH: 617-307-1140. WWW.D13GROUP.COM EM KRIZZO@D13GROUP.COM
X0011	2	SOAP DISPENSER - STERN	GC	GC	STERN. GREEN/CHROME SOAP DISPENS PART #07100008. PART OF D 13 INTEGRATED SINK SYSTEM. CONTACT: E GROUP. 245 WEST CENTRAL STREET, NATICK, MA 01760. PH: 617-307-1140. WWW.D13GROUP.COM
TORAGE		WIDE CHELF ODID AT CIVIL	CD.	00	T
10222 10416	9	WIRE SHELF GRID AT SINK WORKROOM SHELVING - 36IN 915MM	SB SB	GC GC	
10416	9	WORKROOM SHELVING - 30IN 9 ISWIM WORKROOM SHELVING POSTS	SB	GC	
10698	1	MOP RACK WITH 3 HOLDERS	SB	GC	
13834	1	BASE - 24X18IN 610X455MM	SB	GC	
15699	1	PARTNER WORK CENTER	SB	GC	
17255	1	PASTRY TRAY CART - 60IN 1525MM	SB SB	GC GC	
	1	RULLING PASTRY TRAY THAVERALIK -	100		
17264 17639		ROLLING PASTRY TRAY THAW RACK - 20X26IN 510X660MM WORKROOM CART - 24IN 610MM	SB	GC	

GRAPHICS AND ARTWORK SCHEDULE - "G"							
DESIGN ID	COUNT	DESCRIPTION	FURN. BY	INST. BY	COMMENTS		
GRAPHICS -	ARTWORK		•	•			
21079	3	ART - ASHLEY MARY AND ALLEGRA LOCKSTADT - SIREN SCENE - GREENS	SB	GC	(3) PIECES, 10'-0" X 3'-10". WRAPPED CANVAS IN FLOAT FRAME. FINISH WD0073. VENDOR COLORCHROME		
GRAPHICS -	- INTERIOR	MENU	•	•			
18984	7	MENU BOARD - UNIVERSAL WALL MOUNT BRACKET	SB	GC			
19551	6	MENU BOARD - FRONT INSERT PANEL WITH SQUARE FRAME - WHITE OAK WD0073	SB	GC			
19552	1	MENU BOARD - DAILY OFFERING CHALKBOARD WITH SQUARE FRAME - WHITE OAK WD0073	SB	GC			
GRAPHICS -	OTHER		•				
11135	2	RESTROOM SIGN UNISEX ACCESSIBLE	SB	GC			
X0038	1	COMMUNITY BOARD MAGNETIC WHITE OAK WD0073 - 46X36IN 1170X915MM	SB	GC	VENDOR: COLORCHROME		

•	COUNT	DESCRIPTION	FURN. BY	INST. BY	COMMENTS
AUDIO VISU			I	1	
10005 10010	1 1	MUSIC SYSTEM DT ORDER MONITOR	SB SB	SB SB	GC TO INSTALL AND TEST SYSTEM
10010	1	DT COMMUNICATION SYSTEM	SB	SB	
10015	3	SPEAKER RECESSED - WHITE	SB	GC	
10017	2	SPEAKER SURFACE MOUNTED - BLACK	SB	GC	
12336	1	DT TIMER SYSTEM	SB	SB	
14676	1	DT POS MONITOR ARM DOUBLE SURFACE MOUNTED	SB	GC	
19339	1	AMPLIFIER - 40W	SB	SB	GC TO INSTALL AND TEST SYSTEM
DATA					
10002	1	COMPUTER MANAGER WORKSTATION	SB	SB	
10007	1	PRINTER MANAGER WORKSTATION	SB	SB	
18744 20294	2	EQUIPMENT RACK WITH LOCK - 24IN 610MM IOT MODULE	SB SB	SB SB	
POINT OF S		IOT MODULE	36	SD	
10008	2	POS - REGISTER WITH COMPACT CASH	SB	SB	GC TO COORDINATE WITH SBUX VENDOR.
		DRAWER			
10014	4	POS PRINTER	SB	SB	GC TO COORDINATE WITH SBUX VENDOR.
10022	1	MONEY COUNTER	SB	SB	GC TO COORDINATE WITH SBUX VENDOR
10029 10075	6 3	POS BANK CUP LABELER	SB SB	GC SB	GC TO COORDINATE WITH SBUX VENDOR.
14677	3 1	POS - DT TENDERING REGISTER	SB	SB	PART OF RETAIL IT EQUIPMENT PACKAGE.
14678	1	POS - DT EXPEDITOR	SB	SB	PART OF RETAIL IT EQUIPMENT PACKAGE.
SECURITY	·	. 00 2. 2. 2. 2. 0.	100	1	
10024	1	SAFE LH - 20X18X26IN 510X455X660MM	SB	GC	GC TO COORDINATE WITH SBUX VENDOR;
					STORE MANAGER TO PROGRAM WITH VENDOR PROVIDED MANUAL.
10028	1	SAFE BASE	SB	GC	GC TO COORDINATE WITH SBUX VENDOR;
10020	1		00		STORE MANAGER TO PROGRAM WITH
					VENDOR PROVIDED MANUAL.
		PLUMBING FIXTURE	SCHEDULI	E - "P"	
DESIGN ID	COUNT	DESCRIPTION	FURN. BY	INST. BY	COMMENTS
DRAIN					
10294	7	DRAIN - FLOOR SINK SQUARE - 12IN 305MM	SB	GC	ZURN MODEL #FD2375-NH3.
10594	4	DRAIN - FLOOR SINK SQUARE - 5IN 125MM	GC	GC	JAY R. SMITH MODEL #2005Y (B) OR EQUAL
10726	7	DRAIN - GRATE HALF SQUARE - 12IN 305MM	SB	GC	ZURN MODEL #FD2375-NH2.
FAUCET 10152	1	FAUCET - DOUBLE LABORATORY WITH BENT	SB	GC	
10152	1	RISER SPOUT	ЭВ	GC	
10153	2	FAUCET - WATER TOWER - 12IN 305MM	SB	GC	
10215	3	FAUCET - DOUBLE LABORATORY WITH SWING	SB	GC	
		SPOUT			
10447	1	FAUCET - PRE RINSE SPRAYER WALL MOUNTED	SB	GC	
10597	2	FAUCET - SINGLE HANDLE	SB	GC	
10804	1	FAUCET - PRE RINSE SWING SPOUT	SB	GC	
10874	2	FAUCET - HOT WATER DISPENSER	SB	GC	
		GOOSENECK			
10922	1	FAUCET - MOP SINK WALL MOUNTED	SB	GC	
11003	3	FAUCET - METERED	SB SB	GC GC	
13588 15749	2	FAUCET - HAND SINK WALL MOUNTED FAUCET - HOT AND COLD WATER SYSTEM	SB	GC	
X0010	2	FAUCET - STERN	GC	GC	STERN. CONDOR 1010. PART #07100005.
					CHROME. PART OF D 13 INTEGRATED SINK SYSTEM. CONTACT: D 13 GROUP. 245 WES CENTRAL STREET, NATICK, MA 01760. PH: 617-307-1140. WWW.D13GROUP.COM
FILTER		FILTED DO CVOTEM COOCDD	CD	CD	CONFICURATION FULL OC TO COORDINATE
12501	1	FILTER - RO SYSTEM 600GPD	SB	SB	CONFIGURATION [III]. GC TO COORDINATE WITH SBUX VENDOR.
12507	1	FILTER - RO SYSTEM 40GAL STORAGE TANK	SB	SB	CONFIGURATION [III]. GC TO COORDINATE
					WITH SBUX VENDOR.
12896	1	FILTER - BRINE TANK	SB	SB	CONFIGURATION [III]. GC TO COORDINATE WITH SBUX VENDOR.
12899	2	FILTER - POLY GLASS VESSEL	SB	SB	CONFIGURATION [III]. GC TO COORDINATE
.2000	۷	LILLY OF SEVEN VENUE			WITH SBUX VENDOR.
13076	1	FILTER - PREFILTRATION SYSTEM	SB	SB	CONFIGURATION [III]. GC TO COORDINATE
42000		Ell TED MATER COSTENIES TAWN	CD.	CD.	WITH SBUX VENDOR.
13082	1	FILTER - WATER SOFTENER TWIN	SB	SB	CONFIGURATION [III]. GC TO COORDINATE WITH SBUX VENDOR.
13149	1	FILTER - PRESSURE GAUGE	SB	SB	CONFIGURATION [III]. GC TO COORDINATE
	• 				WITH SBUX VENDOR.
OTHER					
13384	1	WATER HEATER TANK GAS	GC	GC	AO SMITH CYCLONE XI MODEL #BTX-100,
					129 GPH RECOVERY @90 DEGREE RISE. SET WATER HEATER TO 140 DEG MAX.
					ENERGY FACTOR = 0.96
NIN II Z					
	1	SINK - RINSE DROP IN SST - 12X20IN 305X510MM	SB	GC	
10549		SINK - MOP - 24X24IN 610X610MM	SB	GC	
10549	1	UIIVIN = IVIUE = 24A24IIN D IUAD IUIVIIVI		GC	
10549 10995	1				
10549		SINK - UTENSIL RINSE WITH GRATE SST - LH - 14X20IN 355X510MM		+	
10549 10995		SINK - UTENSIL RINSE WITH GRATE SST - LH -	SB	GC	
10549 10995 12807	1	SINK - UTENSIL RINSE WITH GRATE SST - LH - 14X20IN 355X510MM SINK - 3 COMP WORK SST - 93IN 2350MM SINK - HAND WITH SIDE SPLASH WALL	SB SB	GC GC	
10549 10995 12807 13264 14688	1 1 1	SINK - UTENSIL RINSE WITH GRATE SST - LH - 14X20IN 355X510MM SINK - 3 COMP WORK SST - 93IN 2350MM SINK - HAND WITH SIDE SPLASH WALL MOUNTED SST	SB	GC	
10549 10995 12807 13264	1	SINK - UTENSIL RINSE WITH GRATE SST - LH - 14X20IN 355X510MM SINK - 3 COMP WORK SST - 93IN 2350MM SINK - HAND WITH SIDE SPLASH WALL MOUNTED SST SINK - RINSE WITH DRAINBOARD - 15X27IN			
10549 10995 12807 13264 14688 17565	1 1 1	SINK - UTENSIL RINSE WITH GRATE SST - LH - 14X20IN 355X510MM SINK - 3 COMP WORK SST - 93IN 2350MM SINK - HAND WITH SIDE SPLASH WALL MOUNTED SST SINK - RINSE WITH DRAINBOARD - 15X27IN 380X685MM	SB SB	GC GC	
10549 10995 12807 13264 14688	1 1 1	SINK - UTENSIL RINSE WITH GRATE SST - LH - 14X20IN 355X510MM SINK - 3 COMP WORK SST - 93IN 2350MM SINK - HAND WITH SIDE SPLASH WALL MOUNTED SST SINK - RINSE WITH DRAINBOARD - 15X27IN 380X685MM SINK - STACKED DRAINBOARD - 15IN 380MM	SB	GC	
10549 10995 12807 13264 14688 17565	1 1 1 1	SINK - UTENSIL RINSE WITH GRATE SST - LH - 14X20IN 355X510MM SINK - 3 COMP WORK SST - 93IN 2350MM SINK - HAND WITH SIDE SPLASH WALL MOUNTED SST SINK - RINSE WITH DRAINBOARD - 15X27IN 380X685MM	SB SB SB SB	GC GC GC GC	
10549 10995 12807 13264 14688 17565	1 1 1 1	SINK - UTENSIL RINSE WITH GRATE SST - LH - 14X20IN 355X510MM SINK - 3 COMP WORK SST - 93IN 2350MM SINK - HAND WITH SIDE SPLASH WALL MOUNTED SST SINK - RINSE WITH DRAINBOARD - 15X27IN 380X685MM SINK - STACKED DRAINBOARD - 15IN 380MM SINK - WATER FILLING STATION - 36X24IN 915X610MM SINK - COUNTERTOP RINSER WITH DRAIN	SB SB SB	GC GC GC	
10995 12807 13264 14688 17565 17632 18743	1 1 1 1 1 1 2	SINK - UTENSIL RINSE WITH GRATE SST - LH - 14X20IN 355X510MM SINK - 3 COMP WORK SST - 93IN 2350MM SINK - HAND WITH SIDE SPLASH WALL MOUNTED SST SINK - RINSE WITH DRAINBOARD - 15X27IN 380X685MM SINK - STACKED DRAINBOARD - 15IN 380MM SINK - WATER FILLING STATION - 36X24IN 915X610MM SINK - COUNTERTOP RINSER WITH DRAIN TROUGH - 26X9IN 660X235MM	SB SB SB SB SB	GC GC GC GC	
10549 10995 12807 13264 14688 17565 17632 18743	1 1 1 1 1	SINK - UTENSIL RINSE WITH GRATE SST - LH - 14X20IN 355X510MM SINK - 3 COMP WORK SST - 93IN 2350MM SINK - HAND WITH SIDE SPLASH WALL MOUNTED SST SINK - RINSE WITH DRAINBOARD - 15X27IN 380X685MM SINK - STACKED DRAINBOARD - 15IN 380MM SINK - WATER FILLING STATION - 36X24IN 915X610MM SINK - COUNTERTOP RINSER WITH DRAIN	SB SB SB SB	GC GC GC GC	D 13 INTEGRATED SINK SYSTEM. 30IN XLERATORSYNC SYSTEM WITH A SINGLE

TOILET - TANKLESS EFFICIENT SINGLE FLUSH GC

TOILET - FLUSH VALVE AUTOMATIC EFFICIENT SINGLE FLUSH

13040

RESPONSIBILITY LEGEND

SLOAN MODEL ST-2020-1.28 (1.28 GPF)

CROWN MODEL 8111-1.28 FLUSHOMETER

AND ENCLOSURE PANELS. BASIN COLOR: D|13 WHITE. ORDER WITH LOCKING SLIDING DOOR & SECURITY PANEL. CONTACT: D|13 GROUP. 245 WEST CENTRAL STREET, NATICK, MA 01760. PH: 617-307-1140.

GC GENERAL CONTRACTOR

LL LANDLORD SB STARBUCKS

(1.28 GPF)

WWW.D13GROUP.COM



STARBUCKS[®] 2401 UTAH AVENUE SOUTH SEATTLE, WASHINGTON 98134 (206) 318-1575

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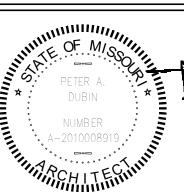
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BID

353 Marshall Avenue St. Louis, Missouri 63119 Phone (314) 772-1782 Fax (314) 373-3514

Engineering Consultants
Mechanical - Electrical - Plumbing



ISSUED DATE: 06/16/2020 EXPIRATION DATE: 12/31/2020

S S S STARBUCKS PRYOR RD 8 E'S SUMMIT WEST PRYOR, I WENSTEIN DR. IT, MO JUNTY PROJECT NAME:

BUILDOUT

COFFEE - N

CHIPMAN -

62012

STORE #: 87799-001 PROJECT #: ISSUE DATE: 06-16-2020 SR. DESIGN MANAGER: K. GORIN SLONSKI PRODUCTION DESIGNER: A. HAHN CHECKED BY: NORR

Revision Schedule

Rev	Date	Ву	Description					
SHE	SHEET TITLE:							

SCHEDULES

SCALE: AS SHOWN SHEET NUMBER:

	EXTERIOR SIGNAGE SCHEDULE - "S"							
DESIGN ID	COUNT	DESCRIPTION	FURN. BY	INST. BY	COMMENTS			
SIGNAGE -	DISK		•	-				
13164	1	SIGN - DISK SF ILLUMINATED FLUSH MOUNTED EVOLVED - 60IN 1525MM	SB	LL/ HILTON	LL TO PROVIDE BLOCKING AND CONDUIT AS REQUIRED			
SIGNAGE -	DRIVE THRI	J						
14091	1	SIGN - DT DIRECTIONAL EXIT SIGN ILLUMINATED ARROW SERIES - 46IN 1170MM	SB	GC/LL	LL TO FURNISH AND INSTALL CONCRETE FOOTINGS, ANCHOR BOLTS, AND ELECTRICAL CONDUIT PER LLWL. GC TO COORDINATE WITH SBUX VENDOR			
14106	1	SIGN - DT CLEARANCE BAR ARROW SERIES FREESTANDING	SB	GC/LL	LL TO FURNISH AND INSTALL CONCRETE FOOTINGS AND ANCHOR BOLTS PER LLWL. GC TO COORDINATE WITH SBUX VENDOR			
SIGNAGE -	OTHER		•	•				
19388	2	SIGN - 10 MINUTE PARKING	SB	LL/ HILTON	FOOTING & POST BY LL. SIGN BY SBUX SIGNAGE VENDOR			
X0002	1	MONUMENT SIGN PANELS	SB/ HILTON	HILTON/ LL	BASE SIGN FOOTING AND ELECTRICAL BY LL. PANELS BY SIGNAGE VENDOR. LL TO COORDINATE WITH SIGNAGE VENDOR			
SIGNAGE - V	WORDMARI	<						
X0007	1	SIGN - FAUX NEON GREEN WORDMARK STARBUCKS WITH WHITE INTERIOR & SURROUND. FLUSH MOUNTED - 18IN 455MM	SB	LL/ HILTON	FAUX NEON GREEN WORDMARK. LL TO PROVIDE CONDUIT AND BLOCKING AS REQUIRED.			

	FLOOR TREATMENT SCHEDULE - "T"								
DESIGN ID	AREA	DESCRIPTION	FURN. BY	INST. BY	COMMENTS				
PLASTIC	•								
19795	819 SF	POLYVINYL FLOOR TILE - ECO-GRIP - PEWTER	GC	GC	MANUFACTURER: ALLIED ECO-GRIP. PEWTER				
TILE	•								
20266	1149 SF	TILE - FRENCH CLAY - BRONZAGE - 24X24IN 600X600MM	SB	GC	GROUT: MAPEI - 09 GRAY, OR EQUAL				
WALK OFF	WALK OFF MAT								
19288	26 SF	WALK OFF MAT - HELIX Z1 - BLACK - 12X9IN 305X230MM	SB	GC	ANODIZED METAL FRAME TO BE INCLUDED IN ORDER, FROM MANUFACTURER				

	WALL BASE SCHEDULE - "B"							
DESIGN ID	LENGTH	DESCRIPTION	FURN. BY	INST. BY	COMMENTS			
TILE BASE								
18740	150' - 0 1/2"	TILE BASE - PLAZA NOVA - BLACK SHADOW - 6X12IN 150X300MM	SB	GC	GROUT: MAPEI - 47 CHARCOAL, OR EQUAL			
19795	188' - 2 1/4"	POLYVINYL FLOOR TILE - ECOGRIP - PEWTER	GC	GC	MANUFACTURER: ALLIED ECO-GRIP. PEWTER			
20196	59' - 10"	TILE BASE - FORMULA - EQUATION GREY - 6X12IN 150X300MM	SB	GC	GROUT: MAPEI - 09 GRAY			

	WINDOW SCHEDULE - "W"								
DESIGN ID	COUNT	DESCRIPTION	FURN. BY	INST. BY	COMMENTS				
WINDOW									
14077	1	WINDOW - DT WITH OPEN TRANSOM - 48X60IN 1205X1510MM - ALUMINUM	LL	LL	275 SERIES SINGLE PANEL SLIDER W/ MOER. LL TO VERIFY OPENING DIRECTION. USE IN CONJUNCTION WITH AA300-275 PASS THRU AIR CURTAIN SYSTEM. CONTACT: ANNA ELLIS, ANNA@READY-ACCESS.COM				

CASEWORK FINISH SCHEDULE								
ENGINE ZONE	MATERIAL DESCRIPTION	FINISH CODE	COMMENTS					
COMPOSITE - LINEN								
COUNTERTOPS - BACKBAR	COMPOSITE - LINEN	CP0028						
COUNTERTOPS - ESPRESSO	COMPOSITE - LINEN	CP0028						
COUNTERTOPS - FRONTBAR	COMPOSITE - LINEN	CP0028						
COUNTERTOPS - SHROUD	COMPOSITE - LINEN	CP0028						
METAL - FLAT BLACK POWDER	COAT							
CABINETS - DOOR PULL	METAL - FLAT BLACK POWDERCOAT	MT0028						
CABINETS - UNDERCOUNTER ICE BIN	METAL - FLAT BLACK POWDERCOAT	MT0028						
METAL - STAINLESS STEEL - BI	RUSHED							
CABINETS - CABINET LEG	METAL - STAINLESS STEEL - BRUSHED	#4 BRUSHED 16GA						
CABINETS - UNDERCOUNTER ICE BIN	METAL - STAINLESS STEEL - BRUSHED	#4 BRUSHED 16GA						
COUNTERTOPS - HAND SINK	METAL - STAINLESS STEEL - BRUSHED	#4 BRUSHED 16GA						
PLAM - GOLDEN BLONDE GRAI	N							
CABINETS - DT POS CUBBY	PLAM - GOLDEN BLONDE GRAIN	PL0027						
CABINETS - UNDERCOUNTER	PLAM - GOLDEN BLONDE GRAIN	PL0027						
WOOD - WHITE OAK - ROUNDE	D SLAT - VERTICAL	-						
FINISH PANELS - FRONTBAR	WOOD - WHITE OAK - ROUNDED SLAT - VERTICAL	WD0073 MAD200-V						
WOOD - WHITE OAK - FIXED W	IDTH WIDE PLANK - HORIZONTAL	•	•					
WAINSCOT	WOOD - WHITE OAK - FIXED WIDTH WIDE PLANK - HORIZONTAL	WD0073 MAD100-H	PLANKS TO BE SHIPPED LOOSE, GC TO INSTALL IN FIELD.					

PAINT SCHEDULE - "PT"								
DESIGN ID	DESCRIPTION	LRV	FURN. BY	INST. BY	COMMENTS			
SW7030	SW7030 ANEW GRAY, OR EQUIVALENT	47	GC	GC	SW USE PRIMER CP-1; NCS - S 2002-Y50R; AKZO NOBEL - 40YY 51/084			
SW7748	SW7748 GREEN EARTH, OR EQUIVALENT	31	GC	GC				

	WALL TREATMENT (AREA) SCHEDULE - "Q"							
DESIGN ID	AREA	DESCRIPTION	FURN. BY	INST. BY	COMMENTS			
PLASTIC	•		•					
11469	1026 SF	FRP - WHITE	GC	GC	MANUFACTURER: PARKLAND PLASTICS. CONTACT BRENDON EASH. PHONE (547) 312-1290. EMAIL: BRENDON.EACH@PARKLANDPLASTICS.CO M PRODUCT PLAST-TEX NRP-HC. COLOR: WHITE.			
TILE				•				
20225	624 SF	TILE - I COCCI - CALCE - 6X24IN 150X600MM	SB	GC	GROUT: MAPEI - 09 GREY. UNSANDED GROUT LINES TO BE 1/8".			
20249	393 SF	TILE - COLOR STUDIO - SAGE - SQUARE MOSAIC - 12X12IN 300X300MM SHEET	SB	GC	GROUT: MAPEI - 09 GREY, OR EQUAL			
WALL COVE	RING							
21071	173 SF	VINYL WALL COVERING - ORIGAMI - SAGE	SB	GC				

		WALL TREATMENT (LE	NG IH) SCHE	DOLE- "K	-
DESIGN ID	LENGTH	DESCRIPTION	FURN. BY	INST. BY	COMMENTS
CHAIR RAIL	_		•		
X0026	69' - 9 3/4"	WOOD TRIM - 1X1IN - WHITE OAK WD0073	SB	GC	MOUNTED AT 2'-9" AFF
OTHER			•	•	
X0034	24' - 2"	SCHLUTER JOLLY AE	GC	GC	FINISH TO MATCH TILE COLOR.
X0036	43' - 9"	STEPPED OUTSIDE CORNER FRY REGLET	GC	GC	FINISH TO MATCH PAINT COLOR.
WAINSCOT		•	•	•	•
X0025	69' - 9 1/4"	WAINSCOT - WD0073 MAD 100-H	SB	GC	MOUNTED TO 2'-9" AFF. CASEWORK VENDOR TO SHIP LOOSE.

CEILING TREATMENT SCHEDULE - "U"					
DESIGN ID	AREA	DESCRIPTION	FURN. BY	INST. BY	COMMENTS
X0022	735 SF	CEILING TILE - 2X2FT - TECTUM PANELS - PAINTED	GC	GC	ARMSTRONG TECTUM PANELS 2X2FT 1" THICK VERTICAL LINE DESIGN, PROVIDE GRID. PAINT TILES AND GRID SW7030 ANEW GRAY. TEGULAR EDGE 15/16 PRELUDE EXPOSED TEE GRID. 6-WEEK LEAD TIME.
OTHER			•		
11302	412 SF	VCT - WHITE - 2X4FT 61X122CM	GC	GC	ARMSTRONG MODE: CLEAN ROOM VL 2X4 (NONPERFORATED). COLOR: WHITE. EDGE PROFILE: SQUARE LAY-IN, ITEM #870

DESIGN ID	COUNT	DESCRIPTION	FURN. BY	INST. BY	COMMENTS	FINISH
CABINET		5200 m. 110 m.		1.1.011.21		1
17573	2	CABINET - BACKBAR COUNTER SUPPORT PANEL - 3IN	SB	GC		
17574	3	75MM CABINET - BACKBAR SINK OR ICE - 15IN 380MM	SB	GC		PL0027
17574	3 1	CABINET - BACKBAR SINK OR ICE - 19IN 360MM	SB	GC		PL0027 PL0027
17575	2	CABINET - CBE TEA SHELF - 29IN 735MM - FLAT BLACK	SB	GC	NOT PROVIDED BY	MT0028
17300	2	MT0028	OD		CASEWORK VENDOR	W110020
17581	1	CABINET - CBE DRY INCLUSION SHELF - 23IN 585MM -	SB	GC	NOT PROVIDED BY	MT0028
		FLAT BLACK MT0028			CASEWORK VENDOR	
17740	2	CABINET - BACKBAR - 30IN 760MM	SB	GC		PL0027
17741	4	CABINET - BACKBAR 15IN 380MM	SB	GC		PL0027
17743	1	CABINET - DT POS - 30IN 760MM	SB	GC		PL0027
17744	1	CABINET - FRONTBAR POS BRIDGE - 22IN 560MM	SB	GC		PL0027
17745	1	CABINET - BACKBAR DRAWER - 15IN 380MM	SB	GC		PL0027
17747	1	CABINET - BACKBAR TRASH - 15IN 380MM	SB	GC		PL0027
18122	2	CABINET - BACKBAR SINK OR ICE - 16IN 405MM	SB	GC		PL0027
19280	1	CABINET - ESPRESSO CUBBY WITH OPEN BACK - 15IN	SB	GC		PL0027
40004		380MM	CD	00		DI 0007
19281 21189	2 1	CABINET - ESPRESSO ICE BIN STAINLESS - 20IN 510MM	SB	GC GC		PL0027
21189	<u>1</u> 1	CABINET - FRONTBAR - 15IN 380MM CABINET - FRONTBAR DRAWER - 15IN 380MM	SB SB	GC		PL0027 PL0027
	2		SB	GC		PL0027
21192 21193	1	CABINET - FRONTBAR POS - 30IN 760MM CABINET - ESPRESSO CUBBY WITH OPEN BACK - 18IN	SB	GC		PL0027 PL0027
21193	ı	455MM	SB	GC		PL0027
X0016	1	CABINET - DT POS UPPER CUBBY W DOORS	SB	GC	SEE DETAILS	PL0027
X0010 X0032	2	CABINET - BACKBAR COUNTER CUSTOM CABINET	SB	GC	SEE DETAILS, CURVED	PL0027
	_	2. S. C. S. M. GOGITIER GOOTOW CADINET			DOOR	5021
X0035	1	CABINET - 12IN 305MM	SB	GC	SEE DETAILS	PL0027
CAFE		•	1	1		1
20131	1	CONDIMENT CART THREE DROP - WHITE OAK AND	SB	GC	NOT PROVIDED BY	WD0073
		WHITE WD0073 CP0002	_		CASEWORK VENDOR	CP0002
20367	1	WALL BAY 2 UNIT - 72IN 1830MM - WHITE OAK WD0073	SB	GC	NOT PROVIDED BY	WD0073
20111:===	00				CASEWORK VENDOR	
COUNTERT		OOUNITEDTOD WAND ON WOMEN CONTROL	05	00		00=
17809	2	COUNTERTOP - HAND SINK WITH LOW SPLASH STAINLESS - 15IN 380MM	SB	GC		SST
17828	1	COUNTERTOP - BACKSPLASH - VARIABLE LENGTH	SB	GC	LENGTH:5'-10 3/4". SEE	CP0028
17020	ı	COUNTERTOR - BACKSPLASH - VARIABLE LENGTH	SB	GC	DETAILS FOR ADDITIONAL	CF0026
					INFORMATION	
19711	1	COUNTERTOP - WARMING - RF - 75IN 1905MM	SB	GC		CP0028
20061	1	COUNTERTOP - ESPRESSO METRO - RF - 139IN 3530MM	SB	GC		CP0028
20063	1	COUNTERTOP - FRONTBAR CAP - 139IN 3530MM	SB	GC		CP0028
X0006	1	COUNTERTOP - FRONTBAR MOP PLANAR - 30IN 760MM	SB	GC	SEE DETAILS	CP0028
X0015	1	COUNTERTOP - AT DT	SB	GC	SEE DETAILS	CP0028
X0017	1	COUNTERTOP - CBE - w/ MAGIC SINK- RF - 112IN	SB	GC	SIMILAR TO 17577. PROVIDE	CP0028
		2845MM			OPENING FOR MAGIC SINK	
					INSTEAD OF RINSE TRAY &	
					WATER FILLER.	
X0018	1	COUNTERTOP - POS	SB	GC	SEE DETAILS	CP0028
X0019	1	COUNTERTOP - DT POS - LF - VARIABLE LENGTH	SB	GC	LENGTH: 6' - 7 153/256" SEE	CP0028
					DETAILS FOR ADDITIONAL INFORMATION	
X0020	1	COUNTERTOP - BREW WITH TRASH DROP - LF	SB	GC	SEE DETAILS	CP0028
X0033	<u>·</u> 1	CORIAN SILL @ DT WINDOW	SB	GC	1" SILL, SEE DETAILS	CP0028
X0037	<u>·</u> 1	COUNTERTOP - BACKBAR NITRO - RH	SB	GC	SIMILAR TO 20051, W/O	CP0028
7.0007	•	Brond, actual and actual actua			BACKSPLASH & WATERFALL	0. 0020
					EDGE	<u> </u>
DIEWALL						
20064	1	DIEWALL - ESPRESSO - 139IN 3530MM	SB	GC		N/A
X0013	1	DIEWALL	SB	GC	SEE DETAILS	N/A
X0023	1	DIEWALL - POS	SB	GC	SEE DETAILS	N/A
OTHER		Table 1	1	1		1
10218	2	CORNER GUARD - 0.75IN 20MM - CLEAR PLASTIC	SB	GC	GC TO INSTALL FULL	
					HEIGHT. PAINT INSIDE FACE TO MATCH ADJACENT WALL	
					COLOR.	
11142	2	CORBEL SUPPORT - 24IN 610MM	SB	GC	1 	SST
11155	2	ESPRESSO MACHINE PUMP MOUNT - 10X10IN	SB	GC		SST
	_	255X255MM				
17829	1	FRENCH CLEAT - VARIABLE LENGTH	SB	GC	OVERALL LENGTH 3' - 2"	PL0027
18145	4	COUNTERTOP SUPPORT LEG	SB	GC		SST
20066	1	SHROUD - 139IN 3530MM	SB	GC		CP0028
20067	1	SNEEZE GUARD - 139IN 3530MM	SB	GC		GLASS
20633	2	COUNTERTOP SUPPORT LEG SLIM	SB	GC		SST
X0026	1	WOOD TRIM - WD0073	SB	GC	1X1IN. WD0073 WOOD TRIM.	WD0073
					SEE WALL TREATMENT	
					LENGTH SCHEDULE.	
PANEL		T==	1	1		la a se
20065	1	PANEL - 139IN 3530MM	SB	GC		WD0073
V0044		DANIEL	CD	00	OFF DETAIL O	MAD200-V
X0014	1	PANEL	SB	GC	SEE DETAILS	WD0073 MAD200-V
V0004		DANIEL	QP.	CC	SEE DETAILS	
X0024	1	PANEL	SB	GC	SEE DETAILS	WD0073 MAD200-V
X0025	1	WAINSCOT	SB	GC	SEE WALL TREATMENT	WD0073
77UUZU		117,111,0001			(LENGTH) SCHEDULE. TOTAL	
					(LLINGTIT) SCHEDULE. TOTAL	ייטו טבועון

RESPONSIBILITY LEGEND

SHEET NUMBER:

STORE #:

PROJECT #:

1602

GC GENERAL CONTRACTOR LL LANDLORD SB STARBUCKS

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STARBUCKS TEMPLATE VERSION i2020-01-31





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St. Louis, Missouri 63119 Phone (314) 772-1782 Fax (314) 373-3514

Engineering Consultants
Mechanical - Electrical - Plumbing



ISSUED DATE: 06/16/2020

EXPIRATION DATE: 12/31/2020

T OF STARBUCKS - NW PRYOR RD & - LEE'S SUMMIT LOT /EST PRYOR, I ENSTEIN DR. MO NTY PROJECT NAME:

BUILDOUT

COFFEE - N

CHIPMAN -

62012 87799-001

ISSUE DATE: 06-16-2020
SR. DESIGN MANAGER: K. GORIN SLONSKI
PRODUCTION DESIGNER: A. HAHN
CHECKED BY: NORR

Revision Schedule				
ate	Ву	Description		

SCHEDULES

SCALE: AS SHOWN

		SITE SCHED	ULE - "Y"		
DESIGN ID	COUNT	DESCRIPTION	FURN. BY	INST. BY	COMMENTS
EXTERIOR N	ИENU				
14116	1	MENU BOARD - DT DIGITAL ORDER SCREEN - FLAT BLACK MT0028	SB	SB/GC	SUPPLIER: IT EQUIPMENT VENDOR (ZONES). SCREEN INSTALLER: REGIONAL SIGNAGE VENDOR. ELECTRICAL: GC CONNECTS DOS WHIPS & STUB-UPS TO DCB.
14119	1	MENU BOARD - DT 5 PANEL FREESTANDING - 108X65IN 2745X1650MM - FLAT BLACK MT0028	SB	SB	SUPPLIER: DT SIGNAGE VENDOR (DSA). INSTALLER: REGIONAL SIGNAGE VENDOR. LL TO PROVIDE CONDUIT, FOOTING, AND ANCHOR BOLTS PER LLWL.
14120	1	MENU BOARD - DT PRE MENU FREESTANDING - 36X65IN 915X1650MM - FLAT BLACK MT0028	SB	SB	PROVIDED AND INSTALLED BY SIGNAGE VENDOR. LANDLORD GC TO PROVIDE FOOTING & ELECTRICAL AS SPECIFIED PER LLWL.
15700	1	MENU BOARD - DT DIGITAL ORDER SCREEN CONTROL BOX	SB	SB/GC	SUPPLIER: IT EQUIPMENT VENDOR (ZONES). INSTALLER: REGIONAL SIGNAGE VENDOR. ELECTRICAL CONNECTION: GC. LL TO PROVIDE FOOTING, CONDUIT, AND ANCHOR BOLTS PER LLWL.
OTHER					
14103	11	BOLLARD NONILLUMINATED SQUARE - FLAT BLACK MT0028	LL	LL	SUPPLIER/INSTALLER: LL. DSA PHOTOTECH. SEE DETAILS.
14163	1	DT ORDER POINT CANOPY FREESTANDING - FLAT BLACK MT0028	SB	SB	SUPPLIER: DT SIGNAGE VENDOR (DSA). INSTALLER: REGIONAL SIGNAGE VENDOR. LL TO PROVIDE AND INSTALL CONDUIT, FOOTING, AND ANCHOR BOLTS PER LLWL.
18818	4	LIGHT POLE - 10FT 300CM - FLAT BLACK MT0028	LL	LL	
18820	4	LIGHT POLE BASE PLATE - FLAT BLACK MT0028	LL	LL	
X0001	2	VEHICLE DETECTOR LOOP	SB	GC/LL	SUPPLIER: DT AUDIO VENDOR (HME). INSTALLER:GC. LL TO PROVIDE CONDUIT PER LLWL.
X0004	5	PLANTER BOXES - 84X36X18IN	LL	LL	LL TO PROVIDE DRAINAGE AND AUTOMATED IRRIGATION PER LLWL REQUIREMENTS. LL TO PROVIDE SPEC TO DESIGNER FOR APPROVAL.
X0008	1	BIKE RACK - OLYMPIA	LL	LL	FORMS & SURFACES: OLYMPIA BIKE RACK. WWW.FORMS-SURFACES.COM; INSTALL PER MANUFACTURER'S RECOMMENDATIONS.
X0009	20	NATIVE PLANTS FOR PLANTER BOXES	LL	LL	LANDSCAPING SELECTION AND QTY VERIFICATION BY LANDLORD. PROVIDE DRAUGHT-RESISTANT, NATIVE PLANTS WITH MINIMUM MAINTENANCE REQUIREMENTS.
UMBRELLA					
12147	3	UMBRELLA - BASE 95LB 43KG - FLAT BLACK MT0028	SB	GC	
20075	3	UMBRELLA - WITHOUT VALANCE - 6FT 183CM - BLACK CANVAS WITH WORDMARK F0061	SB	GC	

DESIGN ID	COUNT	DESCRIPTION	FURN. BY	INST. BY	BULB	COMMENTS
EXIT			1	I		
11483	1	EXIT - SECURITY LIGHT WALL MOUNTED	LL	LL	HID 150W OR EQUAL	
19044	5	LED EXIT SIGN WITH EMERGENCY LIGHT - WHITE AND RED	SB	GC		CAFE EXIT SIGNS TO BE SUSPENDED.
19057	4	LED EMERGENCY LIGHT DOUBLE - BLACK	SB	GC	INTEGRATED LED	
OTHER			•	1		
17796	7	LED STRING LIGHTS - 48FT 1463CM	SB	GC	INTEGRATED LED	POWER BY LANDLORD. TOTAL LENGTH REQUIRED: 130FT
RECESSED	CAN					
19023	32	CAN - LED MOUNTING FRAME - 2IN 50MM - NEW CEILING	SB	GC		
19113	28	CAN - LED ADJUSTABLE GIMBAL WITH DRIVER - 2IN 50MM - WHITE - 1000LM NFL	SB	GC		
19120	4	CAN - LED DOWNLIGHT REFLECTOR WITH DRIVER SQUARE - 2IN 50MM - WHITE - 1000LM FLOOD	SB	GC	INTEGRATED LED	
SCONCE						
20711	6	SCONCE - HINKLEY ATLANTIS LARGE - BLACK	LL	LL	INTEGRATED LED	DOLAN HOSPITALITY MFR #376769 ATLANTIS OUTDOOR SCONCE
20750	2	SCONCE - KUZCO PLUTO TRIPLE - VINTAGE BRASS	SB	GC	INTEGRATED LED	
SIGNAGE -	OTHER		!	!		
21163	1	SIGN - MOBILE ORDER PICK UP ILLUMINATED BLADE MOUNT	SB	GC		GC TO PROVIDE BLOCKING AND ELECTRICAL IN SOFFIT AS REQUIRED
X0030	1	SIGN - MOBILE ORDER PICK UP SIGN EXTENSION LEGS	SB	GC		BY WALTON. ORDER 4FT LEGS, CUT IN FIELD FOR BOTTOM AT 7'-6" AFF, REFER TO INTERIOR ELEVATIONS FOR EXACT DIMENSION
STRIP						
14410	1	STRIP - LED TAPE - VARIABLE LENGTH	SB	GC	INTEGRATED LED	LENGTH: 43'-9"
TRACK						
12934	2	TRACK - WITH CONNECTORS - 4FT 122CM - WHITE - 1 CIRCUIT	SB	GC		
12944	3	TRACK - WITH CONNECTORS - 16FT 488CM - WHITE - 1 CIRCUIT	SB	GC		
12945	5	TRACK - WITH CONNECTORS - 12FT 365CM - WHITE - 1 CIRCUIT	SB	GC		
15059	1	TRACK - WITH CONNECTORS - 6FT 183CM - WHITE - 1 CIRCUIT	SB	GC		
19071	4	TRACK - LED FIXTURE - 2IN 50MM - WHITE - 900LM SPOT	SB	GC	INTEGRATED LED	
19072	14	TRACK - LED FIXTURE - 2IN 50MM - WHITE - 600LM FLOOD	SB	GC	INTEGRATED LED	
19074	35	TRACK - LED FIXTURE - 2IN 50MM - WHITE - 900LM FLOOD	SB	GC	INTEGRATED LED	
19087	53	TRACK - HEX CELL LOUVER - 2IN 50MM	SB	GC		
TROFFER						
15057	7	TROFFER - LED RECESSED - 24X48IN 600X1200MM - WHITE - 4000LM	SB	GC	INTEGRATED LED	

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T OF STARBUCKS - NW PRYOR RD & - LEE'S SUMMIT PROJECT NAME:

BUILDOUT

COFFEE - N

CHIPMAN -STORE #:

62012 PROJECT #: 87799-001

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STARBUCKS TEMPLATE VERSION i2020-01-31

NORR

Engineering Consultants
Mechanical - Electrical - Plumbing

ISSUED DATE: 06/16/2020 EXPIRATION DATE: 12/31/2020

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ISSUE DATE: 06-16-2020
SR. DESIGN MANAGER: K. GORIN SLONSKI
PRODUCTION DESIGNER: A. HAHN
CHECKED BY: NORR

Rev	Date	Ву	Description

SHEET TITLE:
SCHEDULES

SCALE: AS SHOWN

SHEET NUMBER:

1603

RESPONSIBILITY LEGEND

GC GENERAL CONTRACTOR LL LANDLORD SB STARBUCKS

ABBF	ABBREVIATIONS				
AFF AHJ APPROX	ABOVE FINISHED FLOOR AUTHORITIES HAVING JURISDICTION APPROXIMATE				
BLDG	BUILDING				
CKT CLG CM CONST CW CXA	CIRCUIT CEILING STARBUCKS CONSTRUCTION MANAGER CONSTRUCTION COLD WATER COMMISSIONING AGENT				
DEG DL DM DN DTL DWG(S)	DEGREES LIGHTS WITHIN DAYLIGHT ZONE STARBUCKS DESIGN MANAGER DOWN DETAIL DRAWING(S)				
EA EC ECP EG ELEC EM EMS EXIST EXT	EACH ELECTRICAL CONTRACTOR EQUIPMENT CONTROL PAC EXHAUST GRILLE ELECTRICAL EMERGENCY ENERGY MANAGEMENT SYSTEM EXISTING EXTERIOR				
F&I FOIC	FURNISH & INSTALL FURNISHED BY OWNER,				
FOIO	INSTALLED BY CONTRACTOR FURNISHED BY OWNER,				
FLR FT	INSTALLED BY OWNER FLOOR FOOT/FEET				
GC GFCI GND	GENERAL CONTRACTOR GROUND FAULT CIRCUIT INTERRUPTER GROUND				
HR HVAC HW	HOUR HEATING, VENTILATION, AIR CONDITIONING HOT WATER				
LCP LL LS LV	LIGHTING CONTROL PANEL LANDLORD LIGHT SENSOR PHOTOCELL LOW VOLTAGE				
MC MDP MECH MEP	MAXIMUM MECHANICAL CONTRACTOR MAIN DISTRIBUTION PANEL MECHANICAL MECHANICAL, ELECTRICAL, AND PLUMBING MANUFACTURER MINIMUM				
NL NTS	NIGHTLIGHT NOT TO SCALE				
OCP	OVERCURRENT PROTECTION				
REF REQ('D) REV	REFERENCE REQUIRE(D) REVISION				
SF SHT SPECS SST	SQUARE FEET SHEET SPECIFICATION(S) STAINLESS STEEL				
TEL TEMP TYP	TELEPHONE TEMPORARY TYPICAL				
UC UNO	UNDER COUNTER UNLESS NOTED OTHERWISE				
WH	WATER HEATER				

WATER HEATER

WEATHER PROOF

ELECTRICAL SYMBOL LEGEND

_				
	Û	JUNCTON BOX	ϕ	RECEPTACLE: DUPLEX
	\$	SWITCH	ϕ	RECEPTACLE: DUPLEX - ISOLATED GROUND WITH INTEGRAL SURGE PROTECTION
	\$3	THREE-WAY SWITCH	+	RECEPTACLE: QUAD
	\$.	MOTION (OCCUPANCY) SENSOR SWITCH		RECEPTACLE: QUAD - ISOLATED GROUND WITH INTEGRAL SURGE PROTECTION
	S	SWITCHBACK	ф	RECEPTACLE: HIGH VOLTAGE
	lacktriangle	TELEPHONE		RECEPTACLE: FLOOR DUPLEX
	\bigcirc	THERMOSTAT	\P	RECEPTACLE: CEILING DUPLEX
	<u>S</u>	SPEAKER	₹	GROUNDING ELECTRODE CONNECTION
	ф	DIMMER SWITCH	NL	NIGHTLIGHTING 24HR/DAY
	\bigcirc	RECEPTACLE: DATA	PE	PHOTOELECTRIC CELL
_	-////	RACEWAY CONCEALED IN CEILING OR WALL. HASH MARKS INDICATE		WIFI ACCESS POINT
		NUMBER OF WIRES. #12 AWG WIRE UNLESS OTHERWISE NOTED. TWO WIRES PLUS GROUND IF NO HASH MARKS SHOWN. LONG HASH MARK DENOTES NEUTRAL. GROUND WIRE NOT SHOWN.	<u>@</u>	CARBON MONOXIDE DETECTOR

FIRE ALARM SYSTEM NOTES

IF STARBUCKS IS REQUIRED TO PROVIDE A FIRE ALARM AND/OR FIRE ALARM MONITORING AND/OR PHONE LINES FOR A FIRE ALARM, AS SPECIFIED IN THE LEASE AGREEMENT, THE CONTRACTOR IS TO NOTIFY GNOC IMMEDIATELY THAT FIRE ALARM LINES ARE NEEDED. STARBUCKS PREFERRED FIRE ALARM SERVICE PROVIDER, STANLEY, IS TO BE CONTACTED BY THE CONSTRUCTION MANAGER TO INSTALL FIRE ALARM PANEL AND/OR MONITORING SERVICE AS REQUIRED.

CARBON MONOXIDE (CO) DETECTOR NOTES

COORDINATE INSTALLATION OF CARBON MONOXIDE (CO) DETECTOR DEVICE(S) AND LOW VOLTAGE WIRING WITH STARBUCKS SECURITY VENDOR FOR NEW STORES, RELOCATIONS AND MAJOR RENOVATIONS. VENDOR TO FURNISH AND INSTALL DEVICE(S) IN BOH AND FOH (AS APPLICABLE PER STARBUCKS STANDARDS). GC TO PROVIDE ROUGH-IN FOR SENSORS.

CONTROLS AND OPERATION

THE GENERAL CONTRACTOR SHALL COORDINATE INSTALLATION OF INTERMATIC TIMECLOCK. INSTALLATION OF LIGHTING CONTACTOR AND COMMISSIONING WITH ELECTRICAL CONTRACTOR PRIOR TO THE LAST WEEK OF CONSTRUCTION.

FURNISH AND INSTALL RACEWAYS WITH PULL STRINGS AND JUNCTION BOXES FOR THERMOSTAT(S) AND SENSOR(S).

SET RESTROOM OCCUPANCY SENSOR TO 5 MINUTE 'ON' DURATION IN SINGLE OCCUPANT RESTROOM AND TO 5 MINUTE 'ON' DURATION IN MULTI-OCCUPANT RESTROOM UNLESS JURISDICTION REQUIREMENTS STATE OTHERWISE.

COORDINATE WITH DRAWINGS AND MANUFACTUERE FOR DEVICE

DATA RACK AND NETWORK INSTALLATION.

THE GENERAL CONTRACTOR IS TO COMPLETE FINAL CONNECTION AFTER

SYSTEM COMMISSIONING

CONTRACTOR RESPONSIBILITIES FOR BUILDING COMMISSIONING

CONTRACTOR SHALL PROVIDE SUPPORT AND WORK AS SPECIFIED. NEEDED AND REQUIRED TO CONDUCT AND FACILITATE STARBUCKS STAFF BUILDING COMMISSIONING EFFORTS. THIS WORK WILL BE COMPRISED OF THREE DISTINCT EFFORTS:

- 1) SUPPORT STARBUCKS COMMISSIONING AGENT (CXA) DURING INSTALLATION VERIFICATION AND CORRECT DISCLOSED DEFICIENCIES;
- 2) PERFORM TESTING, ADJUSTING, BALANCING AND SYSTEM STARTUP AND SUPPORT FUNCTIONAL PERFORMANCE TESTING
- 3) CORRECT DEFICIENCIES DISCLOSED BY FUNCTIONAL PERFORMANCE TESTING AND SUBMIT REPORTS. CONTRACTOR SHALL PERFORM AND PROVIDE THE FOLLOWING:
- A. SYSTEMS SUBJECT TO COMMISSIONING MAY INCLUDE, BUT ARE NOT LIMITED TO DOMESTIC HOT WATER GENERATION, HVAC SYSTEMS, ROOFTOP UNITS, EXHAUST FANS, HVAC CONTROLS, LIGHTING CONTROLS, AIR CURTAINS, BUILT-IN REFRIGERATION EQUIPMENT, AND RENEWABLE ENERGY SYSTEMS.
- B. CONTRACTOR SHALL INCLUDE COMMISSIONING ACTIVITIES IN PROJECT SCHEDULE AND SHOW INTERVALS FOR PERFORMANCE OF WORK FOR WHICH CONTRACTOR IS RESPONSIBLE AND INTERVALS FOR WORK PERFORMED BY STARBUCKS CXA. CONTRACTOR SHALL SHOW RESOURCES FOR PERFORMING ALL WORK RELATED TO COMMISSIONING ACTIVITIES ON A LINE ITEM IN THE SCHEDULE OF VALUES.
- C. CONTRACTOR SHALL INSTALL EQUIPMENT IN ACCORDANCE WITH THE MANUFACTURER'S REQUIREMENTS AND ALL CONTRACT DOCUMENTS. ENSURE THAT ALL EQUIPMENT IS INSTALLED TOTALLY COMPLETE, AND ACCESSIBLE TO STARBUCKS CXA FOR INSTALLATION VERIFICATION AND FUNCTIONAL PERFORMANCE TESTING PRIOR TO THE SCHEDULED START OF INSTALLATION VERIFICATION.
- D. INSTALLATION VERIFICATION SHALL BE PERFORMED BY STARBUCKS CXA. CONTRACTOR SHALL SUPPORT STARBUCKS CXA INSTALLATION VERIFICATION EFFORTS AS NECESSARY. PROVIDE ALL ACCESS AND EQUIPMENT NECESSARY FOR STARBUCKS STAFF TO VERIFY THAT THE EQUIPMENT IS INSTALLED CORRECTLY.
- CONTRACTOR SHALL BE READILY AVAILABLE DURING INSTALLATION VERIFICATION TO CORRECT ANY DEFICIENCIES OR DEFECTS DISCLOSED BY THE INSTALLATION VERIFICATION PROCESS. CORRECTIONS SHALL BE MADE IN A TIMELY MANNER WITHOUT DISRUPTION OF THE CONSTRUCTION SCHEDULE.
- F. ALL HVAC, EXHAUST FAN, AND AIR CURTAIN EQUIPMENT SHALL BE TESTED, ADJUSTED AND BALANCED BY THE CONTRACTOR'S TESTING, ADJUSTING AND BALANCE AGENT(SEE TESTING, ADJUSTING AND BALANCING) AFTER THE SYSTEM IS VERIFIED TO BE COMPLETE AND CORRECT BY STARBUCKS CXA, IN ACCORDANCE WITH THE REQUIREMENTS OF THESE DOCUMENTS. ALL HVAC CONTROL SYSTEMS SHALL BE TESTED TO ENSURE THAT CONTROL DEVICES, COMPONENTS, EQUIPMENT AND SYSTEMS ARE CALIBRATED, ADJUSTED AND OPERATE IN ACCORDANCE WITH THESE PLANS AND PROJECT MANUAL. SEQUENCES OF OPERATION SHALL BE TESTED TO ENSURE THAT THEY OPERATE IN ACCORDANCE WITH THE CONTRACT REQUIREMENTS. DELIVERABLES: PRELIMINARY. WRITTEN TESTING AND AIR BALANCE REPORT CONFORMING TO THE REQUIREMENTS SPECIFIED HEREIN. DOCUMENTING THE INFORMATION SPECIFIED. ETC. TO THE STARBUCKS CXA IMMEDIATELY UPON COMPLETION OF THE WORK.
- G. CONTRACTOR SHALL INFORM STARBUCKS CXA WHEN EQUIPMENT IS READY FOR FUNCTIONAL PERFORMANCE TESTING. ALL EQUIPMENT SHALL BE READY FOR FUNCTIONAL PERFORMANCE TESTING PRIOR TO STARTING TESTING. CONTRACTOR SHALL OPERATE EQUIPMENT FOR STARBUCKS CXA AND VERIFY BY DEMONSTRATION THE CORRECT OPERATION OF EQUIPMENT, RESPONSE OF SENSORS, AND PROPER EXECUTION OF HVAC CONTROL AND LIGHTING SEQUENCES; INCLUDING BUT NOT LIMITED TO, AIR MOVEMENT, TEMPERATURE, SOUND, AND CONTROL RESPONSE. PROVIDE ANY SECURITY ACCESS. HARDWARE, SOFTWARE, OR OTHER SUPPORT AS NEEDED FOR THE STARBUCKS CXA TO EFFICIENTLY WITNESS AND DOCUMENT ALL EQUIPMENT TESTING. STARBUCKS CXA WILL RECORD THE EQUIPMENT OPERATION AND RESPONSE TO TESTING SEQUENCES AND PREPARE A LIST OF ANY DEFICIENCIES DISCLOSED BY THE FUNCTIONAL PERFORMANCE TESTS FOR CORRECTION BY THE CONTRACTOR. EQUIPMENT INCLUDES, BUT IS NOT LIMITED TO, AIR HANDLING UNITS, ROOFTOP AND SPLIT TYPE, CONDENSING UNITS, EXHAUST FANS, LIGHTING CONTROLS, ETC. DELIVERABLES: PROVIDE COMPLETED COPIES OF ALL START UP REPORTS, FILLED OUT ON THE MANUFACTURER'S FORMS, TO THE STARBUCKS CXA.
- H. CONTRACTOR IS RESPONSIBLE FOR CORRECTING ANY ISSUES OR DEFICIENCIES DISCLOSED DURING THE FUNCTIONAL PERFORMANCE TESTING PROCESS. CORRECTIONS SHOULD BE MADE IN A TIMELY MANNER WITHOUT DISRUPTION TO THE SYSTEM AND CONSTRUCTION SCHEDULE.
- CONTRACTOR SHALL BE READILY AVAILABLE FOR ANY RE-TESTING OF EQUIPMENT DEEMED NECESSARY BY STARBUCKS CXA DURING INSTALLATION VERIFICATION AND FUNCTIONAL PERFORMANCE TESTING. CONTRACTOR IS RESPONSIBLE FOR CORRECTING ANY ISSUES OR DEFICIENCIES FOUND IN THE SYSTEM DURING ANY AND ALL RE-TESTING. CORRECTIONS SHOULD BE MADE IN A TIMELY MANNER WITHOUT DISRUPTION TO THE SYSTEM AND CONSTRUCTION SCHEDULE. DELIVERABLES: FINAL BALANCE REPORT, DEFICIENCIES LIST NOTING CORRECTIVE ACTIONS PERFORMED BY CONTRACTOR IN RESPONSE TO INSTALLATION VERIFICATION AND FUNCTIONAL PERFORMANCE TEST RESULTS.
- J. CONSTRUCTION AND POST CONSTRUCTION TESTING: ADDITIONAL TESTING MAY BE REQUIRED AND OTHER PROCESSES THAT MAY OCCUR OUT OF SEQUENCE WITH COMMISSIONING SERVICE. CONTRACTOR SHALL CONDUCT, DOCUMENT, SUPPORT AND SCHEDULE THIS TESTING AS DIRECTED BY STARBUCKS CXA.

SECURITY SYSTEM NOTES

STARBUCKS CONTRACTS DIRECTLY WITH SECURITY VENDOR TO SUPPLY AND INSTALL THE SECURITY SYSTEM. CONTRACTOR TO SCHEDULE INSTALLATION OF SECURITY SYSTEM FOR FOUR (4) TIMES:

- . MEET TO PLAN SECURITY CABLE PULL WITH SECURITY CABLE INSTALLER PRIOR TO DRYWALL INSTALLATION.
- 2. SECURITY CABLE INSTALLER PULLS SECURITY CABLES, MOUNTS PANEL. KEYPAD AND SENSORS.
- 3. SECURITY EQUIPMENT INSTALL OF CAMERA, NVR AND MONITOR.
- 4. SECURITY MONITORING COMPANY TO BRING SYSTEM ONLINE AND

SECURITY VENDOR REQUIRES A MINIMUM TWO (2) WEEKS LEAD TIME FOR EACH INSTALLATION. SECURITY VENDOR WILL COORDINATE REGIONAL INSTALLERS. ALL ADDITIONAL EXPENSES INCURRED DUE TO THE CONTRACTOR'S FAILURE TO SCHEDULE ACCORDINGLY WILL BE THE RESPONSIBILITY OF THE CONTRACTOR.

TELEPHONE SYSTEM NOTES

TRAIN PARTNERS AFTER POS INSTALL.

IF ADDITIONAL TELEPHONE LINES ARE REQUIRED BEYOND THE STANDARD SINGLE LINE (SUCH AS FOR A FIRE ALARM) THE GENERAL CONTRACTOR SHALL CONTACT THE STARBUCKS CONSTRUCTION MANAGER PRIOR TO BEGINNING CONSTRUCTION TO ORDER THE ADDITIONAL TELEPHONE LINE(S). REPORT ANY TELEPHONE INSTALLATION ISSUES IMMEDIATELY TO THE STARBUCKS CONSTRUCTION MANAGER.

CONFIRM PRIOR TO BEGINNING CONSTRUCTION THAT THERE ARE EXISTING, WORKING TELCO FACILITIES TO THE BUILDING OR THAT LANDLORD HAS FURNISHED AND INSTALLED ONE (1) 2" (51MM) MIN. (ENTRANCE) CONDUIT INCLUDING PULL STRING FROM TELCO STREET FEED LINE TO THE BUILDING AS IDENTIFIED BY THE PHONE COMPANY. NOTIFY STARBUCKS CONSTRUCTION MANAGER IMMEDIATELY IF FACILITIES OR CONDUIT AND PULL STRING ARE NOT INSTALLED.

GENERAL CONTRACTOR IS TO ENSURE THAT THERE IS A 2" (51MM) MIN. CONDUIT WITH PULL STRING FROM THE DATA RACK TO THE DEMARC (TELCO TO CUSTOMER HAND OFF EQUIPMENT) WHEN THE DEMARC IS MORE THAN 10' FROM THE DATA RACK. DISTANCES LESS THAN 10' WILL NOT REQUIRE CONDUIT.

PROVIDE A 3-POSITION GROUND LUG, GROUNDED WITH #6 AWG GROUND WIRE, IF REQUIRED BY TELEPHONE COMPANY.

ALL TELEPHONE/NETWORK CABLING IS THE SCOPE OF WORK OF THE TELEPHONE/NETWORK CABLING VENDOR.

POS \ DATA LINE NOTES

STARBUCKS CONTRACTS DIRECTLY WITH THE DATA CABLING VENDOR TO SUPPLY AND INSTALL CATEGORY 5e (CAT5e) LAN CABLE AND CONNECTORS FOR THE POINT OF SALE (POS) SYSTEMS. CONTRACTOR TO SCHEDULE INSTALLATION OF DATA CABLING WITH DATA CABLING VENDOR. DATA CABLING VENDOR REQUIRES A LEAD TIME FOR INSTALLATION. DATA CABLING VENDOR WILL COORDINATE REGIONAL INSTALLERS.

AT THE START OF CONSTRUCTION, STARBUCKS CONSTRUCTION MANAGER SCHEDULES DELIVERY OF CASH REGISTER/MANAGER'S WORKSTATION EQUIPMENT AND INSTALLATION BY A POS INSTALL TECHNICIAN FOR ONE (1) MONTH PRIOR TO STORE OPEN. CONTRACTOR TO VERIFY DELIVERY SCHEDULE TWO (2) WEEKS PRIOR TO DELIVERY AND INSTALLATION DATE. EQUIPMENT IS SHIPPED DIRECTLY TO THE STORE. CONTRACTOR TO ACCEPT POS EQUIPMENT DELIVERY. DO NOT REFUSE DELIVERY.

DATA CABLING TECHNICIAN TO PROVIDE ALL CAT5e LAN CABLING AND CONNECTORS FROM ALL DESIGNED AND FUTURE CASH REGISTER LOCATIONS, MANAGER'S WORKSTATION, ALL OTHER NETWORKED EQUIPMENT (CUP LABELERS, CLOVER, BUMP BAR, ETC...) AND WIRELESS ACCESS POINT TO THE DATA RACK AREA. CONTRACTOR IS TO HAVE CONDUIT WITH PULL STRING IN PLACE FOR ALL CABLE RUNS PRIOR TO CABLE INSTALL DATE.

STARBUCKS NEW STORE GROUP IS RESPONSIBLE FOR COORDINATING STARBUCKS POS SYSTEMS DELIVERY AND INSTALLATION WITH THE POS VENDOR. THIS GROUP MAY BE CONTACTED AT: NEWSTORES@STARBUCKS.COM.

COMMUNICATION SYSTEM NOTES

CONFIRM PRIOR TO BEGINNING CONSTRUCTION THAT THE LANDLORD HAS FURNISHED AND INSTALLED ONE (1) ADDITIONAL 2" (51MM) (ENTRANCE) CONDUIT INCLUDING PULL STRING (FOR A TOTAL OF TWO (2)) FROM THE STREET FEED TO THE BUILDING AS IDENTIFIED BY THE INTERNET SERVICE PROVIDER.

WIRELESS NETWORK NOTES

CABLING FOR INTERNET SERVICE SHALL BE FURNISHED AND INSTALLED BY THE VENDOR FOR FIBER OR BROADBAND CONNECTIONS. T1 AND ETHERNET EXTENSION CABLING IS PROVIDED BY THE STARBUCKS (TELEPHONE/ NETWORK) CABLING VENDOR. COORDINATE WITH STARBUCKS.

MUSIC SYSTEM NOTES

MOUNT OWNER FURNISHED SPEAKERS WHERE SHOWN ON INTERIOR REFLECTED CEILING PLANS AND IN COORDINATION WITH ALL PLANS, DETAILS AND MANUFACTURER'S INSTALLATION REQUIREMENTS. INSTALL AND CONNECT OWNER FURNISHED WIRING SYSTEM BETWEEN ALL SPEAKERS AND THE OWNER PROVIDED MUSIC SYSTEM. SET WATTAGE TAP ON EACH SPEAKER'S ROTARY SWITCH PER TAP SETTINGS NOTED ON PLANS.

GENERAL ELECTRICAL NOTES

- 1. THE ELECTRICAL CONTRACTOR SHALL COORDINATE ELECTRICAL WORK WITH OTHER TRADES. THE ARCHITECTURAL DRAWINGS SHALL TAKE PRECEDENCE OVER ALL OTHER DRAWINGS. DO NOT SCALE DISTANCES OFF THE ELECTRICAL DRAWINGS; USE ACTUAL BUILDING DIMENSIONS. OVERALL CASEWORK COMPONENT DIMENSIONING ON ELECTRICAL DETAILS ARE SHOWN FOR REFERENCE AND COORDINATION ONLY. SEE PROJECT MANUAL
- 2. ALL ELECTRICAL SYSTEMS SHALL BE TESTED FOR PROPER OPERATION. BALANCE ALL BRANCH CIRCUIT LOADS BETWEEN THE PHASES OF THE SYSTEM WITHIN 10% OF THE HIGHEST PHASE LOAD IN EACH PANEL BOARD.
- 3. THE ELECTRICAL CONTRACTOR SHALL BE RESPONSIBLE FOR DE-ENERGIZING CIRCUITS IN DEMOLITION AREAS TO INSURE A SAFE CONDITION. ELECTRICAL DEVICES AND ASSOCIATED WIRING LOCATED WITHIN THE DEMOLITION AREA THAT WILL NO LONGER BE USED SHALL BE REMOVED AND PROPERLY DISPOSED OF AT CONTRACTORS EXPENSE UNLESS OTHERWISE NOTED.
- 4. THE ELECTRICAL CONTRACTOR SHALL SCHEDULE ALL ELECTRICAL SYSTEM OUTAGES WITH THE GENERAL CONTRACTOR AND LANDLORD AT LEAST 24 HOURS IN ADVANCE. UNLESS APPROVED OTHERWISE ALL OUTAGES SHALL OCCUR BETWEEN 11:00PM AND
- 5. ELECTRICAL CONTRACTOR SHALL FURNISH AND INSTALL ALL NECESSARY CONDUIT AND J-BOXES TO SUPPORT A COMPLETE SECURITY, PHONE, POS AND DATA SYSTEMS. SEE MANAGER WORKSTATION AND BAR POINT OF SALE (POS) POWER/TELECOM/SECURITY DIAGRAM. COORDINATE ALL DEVICE LOCATIONS AND MOUNTING HEIGHTS WITH SECURITY VENDOR PRIOR TO ROUGH-IN. PROVIDE END-TO-END PULL STRINGS IN ALL CONDUITS. LABEL EACH END OF THE PULL STRING WITH CONDUIT SYSTEM ("SECURITY") AND DESTINATION ("CAFÉ". "FRONT BAR". ETC.). PROVIDE INSULATED BUSHINGS ON ALL STUBBED-UP AND EXPOSED CONDUIT ENDS.
- 6. ELECTRICAL CONTRACTOR SHALL COORDINATE WITH THE GENERAL CONTRACTOR TO PATCH AND REPAIR ALL EXISTING WALLS, FLOORS, CEILINGS OR OTHER SURFACES IDENTIFIED TO REMAIN THAT MAY BECOME DAMAGED DURING THE COURSE OF
- 7. EXPOSED/SURFACE MOUNTED CONDUITS SHALL ONLY BE ALLOWED WHERE NECESSARY IN EXPOSED CEILING AREAS. IF CONDUITS NEED TO BE SURFACE MOUNTED TO WALLS, COORDINATE WITH STARBUCKS CONSTRUCTION MANAGER FOR APPROVAL.
- 8. VERIFY LOCATION OF ALL OUTLETS AND SWITCHES WITH ARCHITECTURAL DRAWINGS, INTERIOR DETAILS, FINISH SCHEDULES, GENERAL CONTRACTOR, EQUIPMENT VENDORS, STARBUCKS AND EXISTING SITE CONDITIONS. VERIFY FINAL DOOR HINGE LOCATION PRIOR TO SWITCH INSTALLATION AND ADJUST SWITCH LOCATION IF NEEDED. DO NOT MOUNT RECEPTACLES/SWITCHES IN LOCATIONS THAT WOULD CONFLICT WITH MIRRORS, SEAMS OF WALLS, WAINSCOTS, TILE TRANSITIONS, ETC...

GENERAL NOTES

THE INTENT OF THE DRAWINGS AND PROJECT MANUAL IS TO PROVIDE A COMPLETE AND FULLY OPERATIONAL ELECTRICAL SYSTEM. THE ELECTRICAL CONTRACTOR SHALL FURNISH AND INSTALL ALL LABOR, MATERIAL, AND EQUIPMENT NECESSARY TO COMPLETE THE ELECTRICAL WORK.

THE ELECTRICAL CONTRACTOR SHALL THOROUGHLY EXAMINE ALL AREAS WHERE EQUIPMENT. CONDUIT. AND WIRING WILL BE INSTALLED AND WILL REPORT ANY CONDITION THAT, IN HIS OPINION, PREVENTS THE PROPER INSTALLATION OF THE ELECTRICAL WORK.

EQUIPMENT AND MATERIALS SHALL CONFORM WITH APPROPRIATE PROVISIONS OF CSA. ULC. NEC. ASTM. UL. ETL. NEMA. ANSI. AS APPLICABLE TO EACH INDIVIDUAL UNIT OR ASSEMBLY.

ALL WORK SHALL BE PERFORMED IN STRICT ACCORDANCE WITH ALL APPLICABLE PROVINCIAL AND LOCAL CODES AND ORDINANCES. IN CASE OF CONFLICT BETWEEN THE DRAWINGS AND SPECIFICATIONS AND THE CODES, THE HIGHEST STANDARD SHALL APPLY. ELECTRICAL CONTRACTOR SHALL SATISFY CODE REQUIREMENTS AS A MINIMUM STANDARD WITHOUT ANY EXTRA COST TO STARBUCKS.

PERMITS AND FEES

THE ELECTRICAL CONTRACTOR SHALL PROCURE AND PAY FOR ALL PERMITS, FEES, AND INSPECTIONS NECESSARY TO COMPLETE THE ELECTRICAL WORK.

THE ELECTRICAL CONTRACTOR SHALL UNCONDITIONALLY WARRANT ALL WORK TO BE FREE OF DEFECTS IN MATERIAL AND WORKMANSHIP FOR A PERIOD OF ONE (1) YEAR FROM THE DATE OF FINAL ACCEPTANCE BY STARBUCKS AND WILL REPAIR OR REPLACE ANY DEFECTIVE WORK PROMPTLY AND WITHOUT CHARGE AND RESTORE ANY OTHER EXISTING WORK DAMAGED IN THE COURSE OF REPAIRING DEFECTIVE MATERIALS AND WORKMANSHIP.

LANDLORD REQUIREMENTS

PRIOR TO BID: THE CONTRACTOR SHALL COORDINATE WITH LANDLORD / BUILDING OWNER FOR ANY CONSTRUCTION REQUIREMENTS. IF LANDLORD / BUILDING OWNER DOES HAVE REQUIREMENTS, CONTRACTOR SHALL BECOME COMPLETELY FAMILIAR WITH REQUIREMENTS AND ADHERE TO THEM. WHERE LANDLORD / BUILDING OWNER REQUIREMENTS ARE MORE STRINGENT THAN SHOWN IN THESE PLANS (IN THE OPINION OF THE ENGINEER). LANDLORD / BUILDING OWNER REQUIREMENTS SHALL GOVERN.

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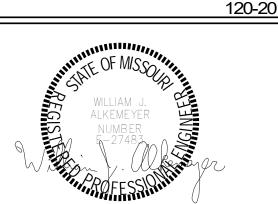


2020

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Engineering Consultant



06-15-20

STORE #: PROJECT#:

ISSUE DATE:

CHECKED BY:

Rev Date

HPM/

62012 87799-001 06-16-2020 SR. DESIGN MANAGER: K. GORIN SLONSKI

PRODUCTION DESIGNER: A. HAHN NJD/BMS

Revision Schedule		
Ву	Description	

ELECTRICAL NOTES

SCALE: AS SHOWN SHEET NUMBER:

▲ COMcheck Software Version 4.1.2.1

Interior Lighting Compliance Certificate

Project Information

2018 IECC Energy Code: Project Title: Starbucks Coffee Company Project Type: New Construction

Construction Site: Designer/Contractor:

Additional Efficiency Package(s)

Reduced interior lighting power. Requirements are implicitly enforced within interior lighting allowance calculations.

Allowed Interior Lighting Power

Α	В	С	D
Area Category	Floor Area (ft2)	Allowed Watts / ft2	Allowed Watts (B X C)
1-Dining: Bar Lounge/Leisure	2220	0.81	1798
		Total Allowed Watte	- 1709

Proposed Interior Lighting Power

A Fixture ID : Description / Lamp / Wattage Per Lamp / Ballast	B Lamps/ Fixture	C # of Fixtures	D Fixture Watt.	(C X D) E
1-Dining: Bar Lounge/Leisure				
15057: 15057: Other:	1	7	36	252
LED 2: 20057: Other:	3	2	16	33
LED 3: 19113: Other:	1	25	11	280
LED 3 copy 1: 19120: Other:	1	4	12	46
Track lighting 1: Wattage based on 122 feet of track	0	0	976	976
		Total Propos	sed Watts =	1587

nterior Lighting PASSES: Design 12% better than code

Interior Lighting Compliance Statement

Name - Title

Compliance Statement: The proposed interior lighting design represented in this document is consistent with the building plans, specifications, and other calculations submitted with this permit application. The proposed interior lighting systems have been designed to meet the 2018 IECC requirements in COMcheck Version 4.1.2.1 and to comply with any applicable mandatory requirements listed in the Inspection Checklist.

SEE TITLE BLOCK FOR SEAL, SIGNATURE, AND DATE

Project Title: Starbucks Coffee Company

Section # & Req.ID	Final Inspection	Complies?	Comments/Assumptions
C303.3, C408.2.5. 2 [FI17] ³	Furnished O&M instructions for systems and equipment to the building owner or designated representative.	☐Complies ☐Does Not ☐Not Observable ☐Not Applicable	Requirement will be met.
C405.4.1 [FI18] ¹	Interior installed lamp and fixture lighting power is consistent with what is shown on the approved lighting plans, demonstrating proposed watts are less than or equal to allowed watts.	□Complies □Does Not □Not Observable □Not Applicable	See the Interior Lighting fixture schedule for values.
C408.1.1 [FI57] ¹	Building operations and maintenance documents will be provided to the owner. Documents will cover manufacturers' information, specifications, programming procedures and means of illustrating to owner how building, equipment and systems are intended to be installed, maintained, and operated.	Complies Does Not Not Observable Not Applicable	Requirement will be met.
C408.2.5. 1 [FI16] ³	Furnished as-built drawings for electric power systems within 90 days of system acceptance.	Complies Does Not Not Observable Not Applicable	Requirement will be met.
C408.3 [FI33] ¹	Lighting systems have been tested to ensure proper calibration, adjustment, programming, and operation.	□Complies □Does Not □Not Observable □Not Applicable	Requirement will be met.

Additional Comments/Assumptions:

Inspection Checklist Energy Code: 2018 IECC Requirements: 100.0% were addressed directly in the COMcheck software

COMcheck Software Version 4.1.2.1

Text in the "Comments/Assumptions" column is provided by the user in the COMcheck Requirements screen. For each requirement, the user certifies that a code requirement will be met and how that is documented, or that an exception is being claimed. Where compliance is itemized in a separate table, a reference to that table is provided.

& Req.ID

C405.2.2. Spaces required to have light-

C405.2.1, Occupancy sensors installed in

C405.2.1. classrooms/lecture/training rooms,

rooms, copy/print rooms,

reduction controls have a manual

control that allows the occupant to

a reasonably uniform illumination pattern >= 50 percent.

conference/meeting/multipurpose

open plan office areas, restrooms, storage rooms, locker rooms,

warehouse storage areas, and other spaces <= 300 sqft that are enclosed by floor-to-ceiling height partitions.

warehouses and section C405.2.1.3

by 50% or more when the areas are unoccupied. The occupant sensors

control lighting in each aisleway

independently and do not control

controlled by the sensor.

lighting beyond the aisleway being

open plan office areas: Occupant

be controlled separately in control zones with floor areas <= 600 sq.ft.

within the space, 2) automatically turn off general lighting in all control zones

within 20 minutes after all occupants have left the space, 3) are configured so that general lighting power in each control zone is reduced by >= 80% of

the full zone general lighting power within 20 minutes of all occupants

configured such that any daylight

leaving that control zone, and 4) are

responsive control will activate space general lighting or control zone

general lighting only when occupancy for the same area is detected.

C405.2.2, Each area not served by occupancy Complies

C405.2.2. sensors (per C405.2.1) have time-switch controls and functions detailed 1, switch controls and functions detailed C405.2.2. in sections C405.2.2.1 and C405.2.2.2. Not Observable Not Applicable

2405.2.1. Occupant sensor control function in Complies

C405.2.1. Occupancy sensors control function in Complies

warehouses: In warehouses, the Does Not

lighting in aisleways and open areas is controlled with occupant sensors that automatically reduce lighting power

sensor controls in open office spaces

| Not Observable

Reference section language C405.2.1.2 for control function in

for open plan office spaces.

reduce the connected lighting load in

Rough-In Electrical Inspection Complies?

lounges/breakrooms, enclosed offices, Not Applicable

□Complies

□Not Observable

☐Not Applicable

☐Not Observable

Does Not

Complies

Does Not

□Does Not

Section # & Req.ID	Plan Review	Complies?	Comments/Assumptions
C103.2 [PR4] ¹	Plans, specifications, and/or calculations provide all information with which compliance can be determined for the interior lighting and electrical systems and equipment and document where exceptions to the standard are claimed. Information provided should include interior lighting power calculations, wattage of bulbs and ballasts, transformers and control devices.	□Complies □Does Not □Not Observable □Not Applicable	Requirement will be met.
C406 [PR9] ¹	Plans, specifications, and/or calculations provide all information with which compliance can be determined for the additional energy efficiency package options.	□Complies □Does Not □Not Observable □Not Applicable	Requirement will be met.

Additional Comments/Assumptions:

1 High Impact (Tier 1) 2 Medium Impact (Tier 2) 3 Low Impact (Tier 3)

Project Title: Starbucks Coffee Company Data filename: F:\2020\100-20 SB - NORR\120-20 SB - Pryor Rd & Chipman, MO\DOCS\120-20 COMCheck.cck Page 2 of 6

1 High Impact (Tier 1) 2 Medium Impact (Tier 2) 3 Low Impact (Tier 3) Project Title: Starbucks Coffee Company Data filename: F:\2020\100-20 SB - NORR\120-20 SB - Pryor Rd & Chipman, MO\DOCS\120-20 COMCheck.cck Page 3 of 6

Comments/Assumptions

Requirement will be met.

Section # & Req.ID	Rough-In Electrical Inspection	Complies?	Comments/Assumptions
C405.2.3, C405.2.3. 1,	Daylight zones provided with individual controls that control the lights independent of general area lighting. See code section C405.2.3 Daylight-responsive controls for applicable spaces, C405.2.3.1 Daylight responsive control function and section C405.2.3.2 Sidelit zone.	□Complies □Does Not □Not Observable □Not Applicable	Exception: Sidelit zones on first floor in Group A-2 and Noccupancies.
C405.2.4 [EL26] ¹	Separate lighting control devices for specific uses installed per approved lighting plans.	□Complies □Does Not □Not Observable □Not Applicable	Requirement will be met.
C405.2.4 [EL27] ¹	Additional interior lighting power allowed for special functions per the approved lighting plans and is automatically controlled and separated from general lighting.	□Complies □Does Not □Not Observable □Not Applicable	Requirement will be met.
C405.3 [EL6] ¹	Exit signs do not exceed 5 watts per face.	Complies Does Not Not Observable Not Applicable	Requirement will be met.
C405.6 [EL26] ²	Low-voltage dry-type distribution electric transformers meet the minimum efficiency requirements of Table C405.6.	Complies Does Not Not Observable Not Applicable	Exception: Requirement does not apply.
C405.7 [EL27] ²	Electric motors meet the minimum efficiency requirements of Tables C405.7(1) through C405.7(4). Efficiency verified through certification under an approved certification program or the equipment efficiency ratings shall be provided by motor manufacturer (where certification programs do not exist).	☐Complies ☐Does Not ☐Not Observable ☐Not Applicable	Exception: Requirement does not apply.
C405.8.2, C405.8.2. 1 [EL28] ²		☐Complies ☐Does Not ☐Not Observable ☐Not Applicable	Exception: Requirement does not apply.
C405.9 [EL29] ²	Total voltage drop across the combination of feeders and branch circuits <= 5%.	Complies Does Not Not Observable Not Applicable	Requirement will be met.

1 High Impact (Tier 1) 2 Medium Impact (Tier 2) 3 Low Impact (Tier 3)

Project Title: Starbucks Coffee Company Data filename: F:\2020\100-20 SB - NORR\120-20 SB - Pryor Rd & Chipman, MO\DOCS\120-20 COMCheck.cck Page 4 of 6 2020

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STORE #:

ISSUE DATE:

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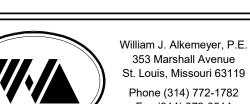
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120-20

Engineering Consultant

06-15-20

62012

87799-001 SR. DESIGN MANAGER: K. GORIN SLONSKI PRODUCTION DESIGNER: A. HAHN

NJD/BMS

Revision Schedule

ENERGY CALCULATIONS


SCALE: AS SHOWN SHEET NUMBER:

E002

1 High Impact (Tier 1) 2 Medium Impact (Tier 2) 3 Low Impact (Tier 3)

Report date: 05/21/20 Project Title: Starbucks Coffee Company Data filename: F:\2020\100-20 SB - NORR\120-20 SB - Pryor Rd & Chipman, MO\DOCS\120-20 COMCheck.cck Page 5 of 6 Project Title: Starbucks Coffee Company

Report date: 05/21/20 Data filename: F:\2020\100-20 SB - NORR\120-20 SB - Pryor Rd & Chipman, MO\DOCS\120-20 COMCheck.cck Page 6 of 6

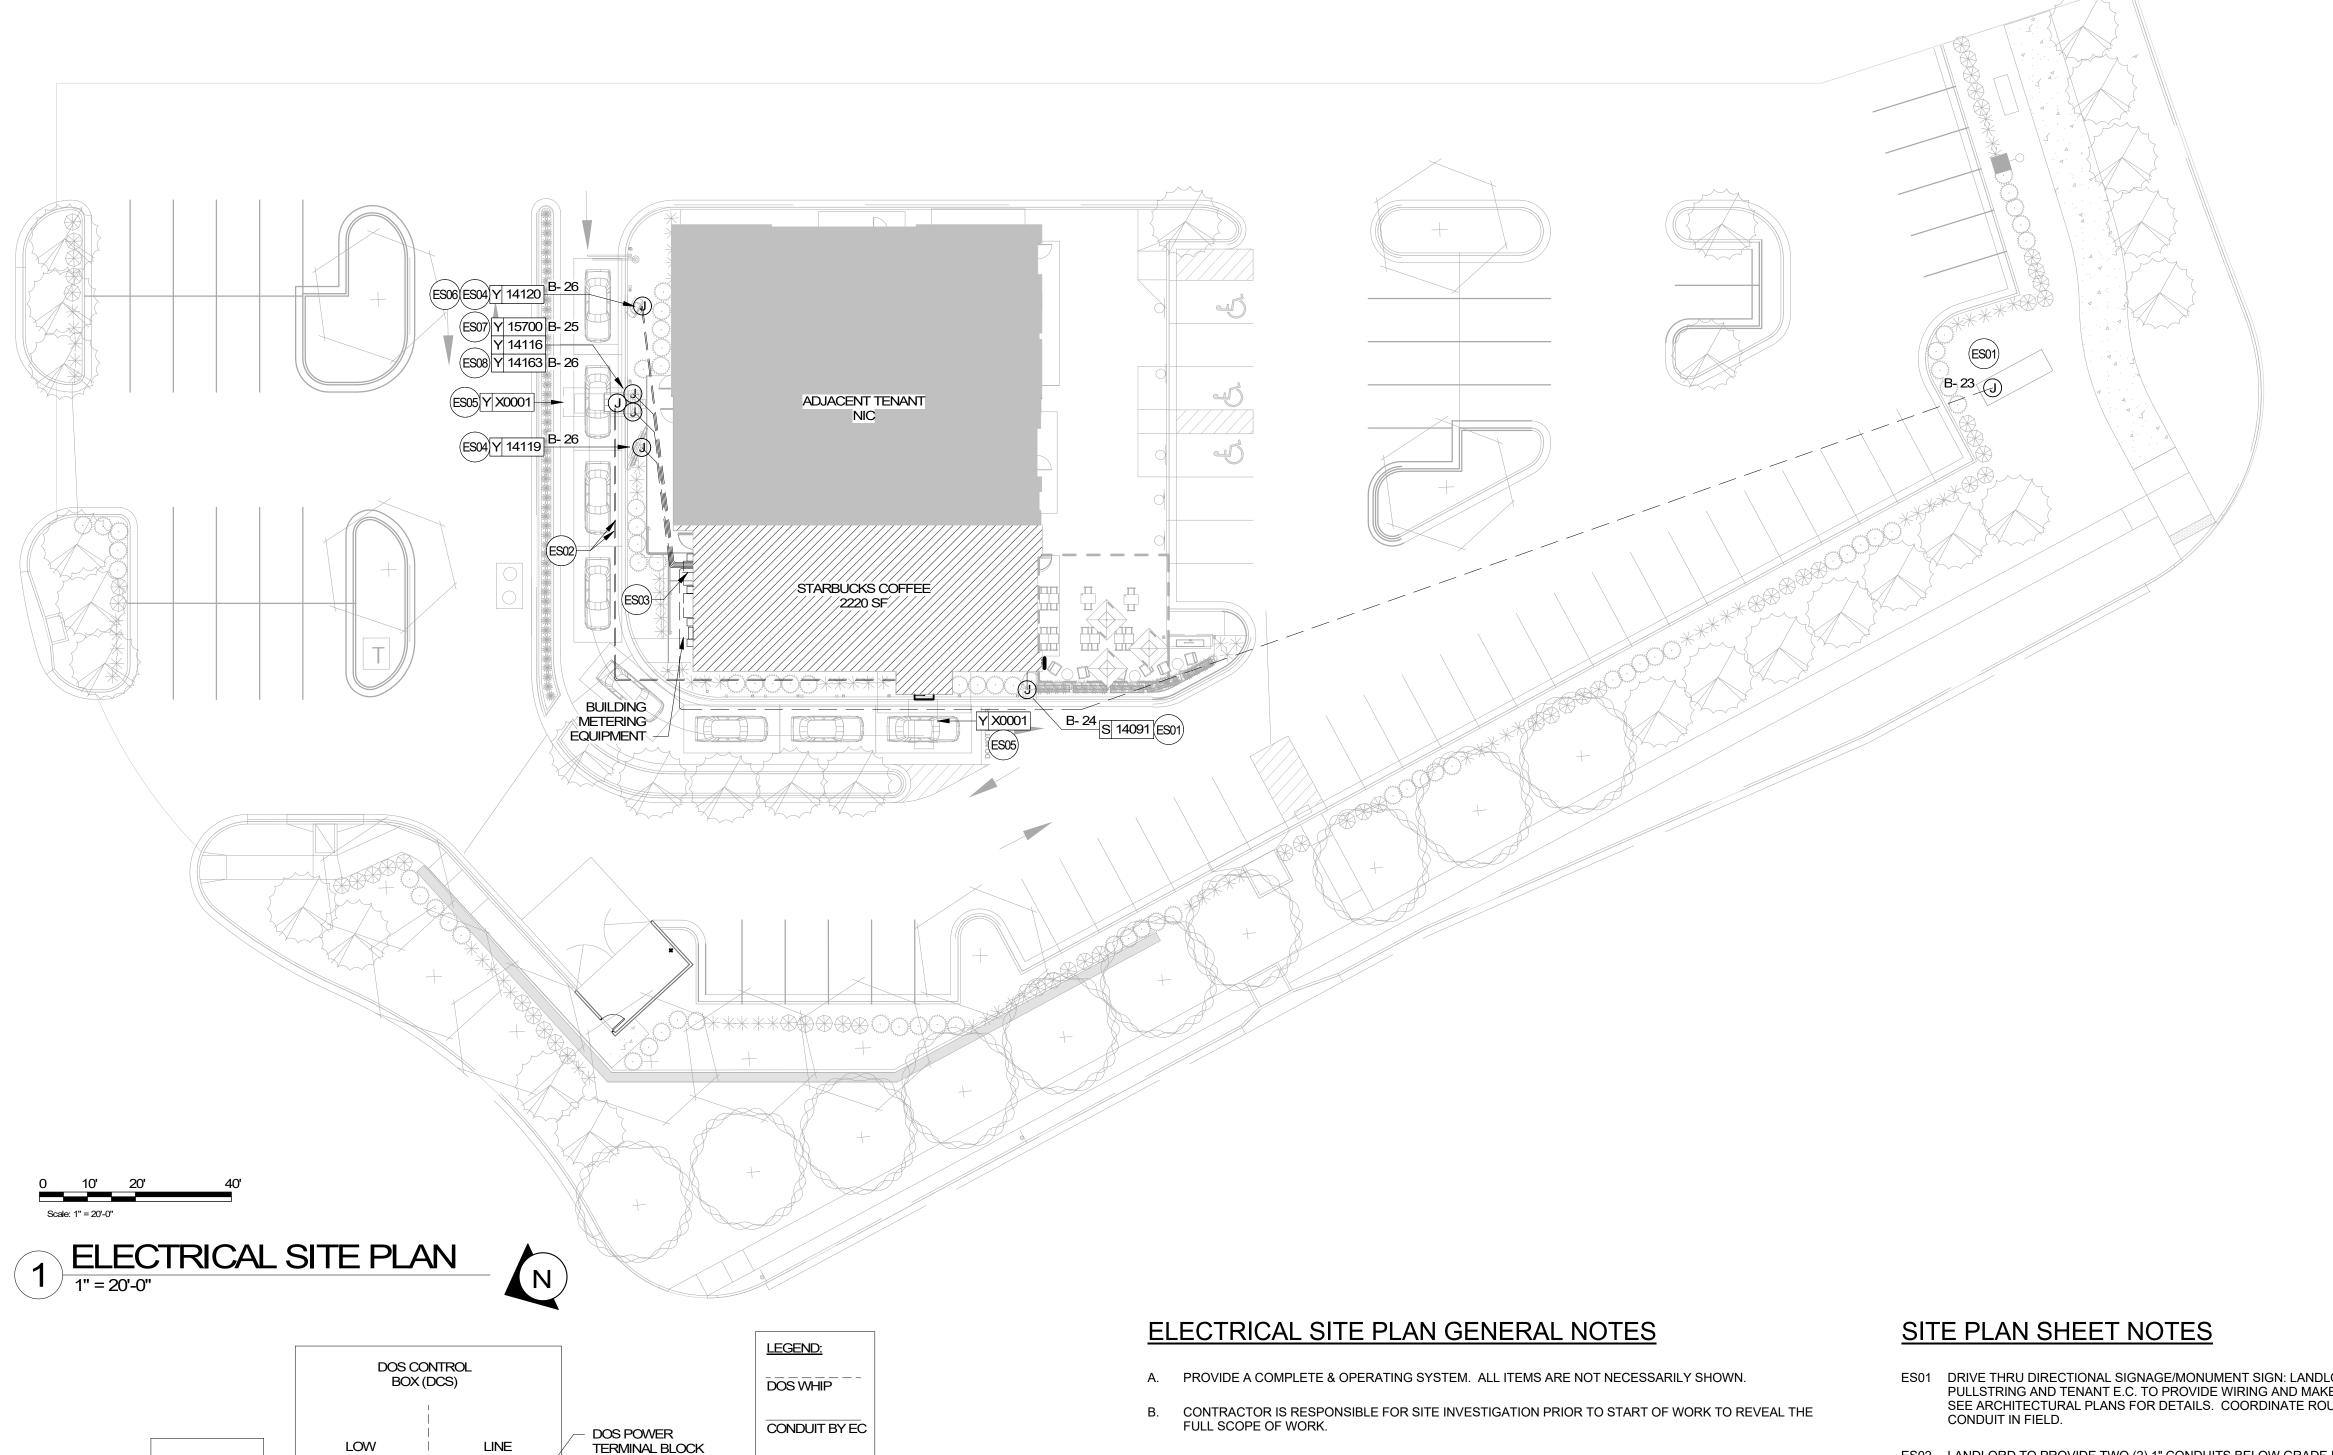

- C. REVIEW ALL CIVIL DRAWINGS AND COORDINATE EXISTING CONDUIT ROUTES WITH LANDLORD PRIOR TO PLACING BID AND/OR COMMENCING WORK.
- D. SEE ARCHITECTURAL SHEETS FOR FURTHER SIGNAGE INFORMATION AND EXACT LOCATIONS.
- 1. MINIMUM LIGHT LEVELS OF 1.5 FOOT CANDLES AT 30" AFF IN PATIO AREAS.

E. EXTERIOR SITE LIGHTING TO BE ON A PHOTO-ELECTRICAL CELL.

- 2. MINIMUM LIGHT LEVELS OF 1.5 FOOT CANDLES AT PAVED AREAS.
- 3. NO DARK AREAS ON SITE, INCLUDING TRASH ENCLOSURE.
- 4. LED LIGHTING PREFERRED.

LIGHTING REQUIREMENTS:

- LABELED INCOMING DEDICATED POWER. F. LANDLORD PROVIDED AND INSTALLED CONDUITS SHALL HAVE OPENINGS PROTECTED AND PULLWIRES LABELED SO VENDORS WILL KNOW WHICH CONDUITS TO USE. 7. TERMINATE POWER TO DOS ON TERMINAL BLOCKS
 - G. FURNISH AND INSTALL APPROPRIATE HAND HOLES WHERE NEEDED AND PER CODE TO INSTALL
 - H. INCREASE SIZE OF CONDUCTORS INDICATED IF NEEDED TO ACCOUNT FOR VOLTAGE DROP.

- ES01 DRIVE THRU DIRECTIONAL SIGNAGE/MONUMENT SIGN: LANDLORD TO PROVIDE 1" CONDUIT WITH PULLSTRING AND TENANT E.C. TO PROVIDE WIRING AND MAKE FINAL CONNECTION AS REQUIRED. SEE ARCHITECTURAL PLANS FOR DETAILS. COORDINATE ROUTING OF LANDLORD PROVIDED
- ES02 LANDLORD TO PROVIDE TWO (2) 1" CONDUITS BELOW GRADE FROM DIGITAL ORDER SCREEN CONTROL BOX TO DRIVE-THRU WINDOW AREA AND TENANT E.C. TO PROVIDE WIRING AND MAKE FINAL CONNECTIONS. VERIFY ALL REQUIREMENTS WITH EQUIPMENT MANUFACTURER PRIOR TO COMMENCING WORK. COORDINATE ROUTING OF LANDLORD PROVIDED CONDUITS IN FIELD.
- ES03 LANDLORD TO PROVIDE ONE (1) SPARE 1" CONDUIT BELOW GRADE THROUGH FOUNDATION WALL OF BUILDING, CAPPED AND TERMINATED ABOVE INTERIOR CEILING FOR FUTURE USE AT THE REAR OF SPACE. VERIFY LOCATIONS FOR STUB UP WITH STARBUCKS REPRESENTATIVE PRIOR TO COMMENCING WORK.
- ES04 LANDLORD TO PROVIDE ONE (1) 1" CONDUIT BELOW GRADE WITH PULLSTRING FROM DRIVE-THRU EQUIPMENT TO ELECTRICAL PANELS AND TENANT E.C. TO PROVIDE WIRING AND MAKE FINAL CONNECTION AS REQUIRED. VERIFY ALL REQUIREMENTS WITH EQUIPMENT MANUFACTURER PRIOR TO COMMENCING WORK. COORDINATE ROUTING OF CONDUIT IN FIELD. COORDINATE WITH OWNER AND STARBUCKS REPRESENTATIVE PRIOR TO COMMENCING WORK.
- ES05 LANDLORD TO PROVIDE ONE (1) 1" CONDUIT WITH PULLSTRING FOR EACH OF TWO DETECTOR LOOP SETS (ONE AT THE SPEAKER POST AND THE OTHER AT THE DRIVE THRU WINDOW) AND TENANT E.C. TO PROVIDE WIRING AND MAKE FINAL CONNECTIONS.
- ES06 LANDLORD TO PROVIDE 1" CONDUIT BELOW GRADE WITH PULLSTRING FROM PRE-MENU BOARD TO BUILDING FOR FUTURE USE.
- ES07 LANDLORD TO PROVIDE ONE (1) 1" CONDUIT WITH PULL STRING FROM TO ELECTRICAL PANEL TO DRIVE-THRU DOS CONTROL BOX. PROVIDE FINAL CONNECTION TO DOS CONTROL BOX AS REQUIRED. SEE DETAIL #2 ON THIS SHEET FOR MORE INFORMATION.
- ES08 PROVIDE ONE (1) 1" CONDUIT, WIRING, AND FINAL CONNECTION FOR POWER TO CANOPY LIGHTING. SEE ARCHITECTURAL SHEETS FOR CONDUIT STUB-UP DETAILS AND ADDITIONAL INFORMATION.



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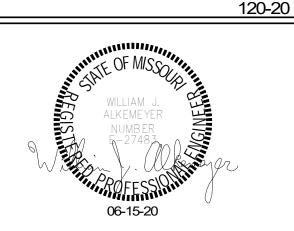
William J. Alkemeyer, P.E 353 Marshall Avenue

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Engineering Consultant

2020

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62012 PROJECT#:

87799-001 06-16-2020 SR. DESIGN MANAGER: K. GORIN SLONSKI

PRODUCTION DESIGNER: A. HAHN CHECKED BY: NJD/BMS

Revision Schedule

Description

ELECTRICAL SITE PLAN

SCALE: AS SHOWN SHEET NUMBER:

STORE #:

ISSUE DATE:

E003

DTE - DOS CONTROL BOX WIRING

VOLTAG

E SIDE

INTERIOR

PARTITION

REFERENCE

SHOWN

DIGITAL

ORDER

SCREEN (DOS)

VOLTAGE

SIDE

BY VENDOR

1. ALL SHOWN SHALL BE INSTALLED PER THIS DETAIL

2. CONFIRM MOUNTING POSITIONS OF ALL DEVICES

3. EC TO PROVIDE, INSTALL AND CONNECT ALL LINE

5. DCB VENDOR TO CONNECT ALL LOW VOLTAGE CABLING,

6. TERMINATE INCOMING POWER ON TERMINAL BLOCKS

8. POWER TO DCB SHALL BE INDIVIDUAL BRANCH CIRCUIT IN DEDICATED CONDUIT (I.E. NOT BE ON EMS OR LIGHTING

CODE AND MANUFACTURER'S INSTRUCTIONS.

SHOWN WITH GC AND VENDOR.

LIQUID TIGHT FLEX 4. EC TO CONNECT DEDICATED POWER BETWEEN DOS

INCLUDING DOS WHIPS TO DCB.

LABELED DOS DEDICATED POWER.

VOLTAGE CONDUCTORS.

AND DCB.

CONTROL).

(NOTE 7)

INCOMING

BY VENDOR

LINE VOLTAGE

CONDUCTORS

CONDUIT (TYP.)

1/2"C-POWER

TO DOS

CONCRETE

FOOTING

TERMINAL BLOCK

POWER

(NOTE 6)

SCALE: NTS

1" C-CAMERA

1/2"C-

SPEAKER

1/2"C-AUDIO/

VIDEO CABELS

COUPLINGS (TYP.)


3/4" C-FROM DETECTOR LOOP

1" C-DETECTOR LOOP/SPEAKER MIC -

1"C-DCB INCOMING POWER (NOTE 8)

ALL CONDUIT STUB UPS TO BE WITHIN THIS BOUNDARY 3/4" POWER CONDUIT TO ELECTRICAL PANEL (FOODCASE) 3/4" ISOLATED GROUND POWER 3/4" DATA TO MANAGERS DESK (POS) CONDUIT TO ELECTRICAL PANEL (POS) 3/4" DATA TO MANAGERS DESK 3/4" ISOLATED GROUND POWER CONDUIT (WITH PULL WIRE FOR FUTURE) TO ELECTRICAL PANEL (SAFE)

ELECTRICAL STUB UP DETAIL - POS

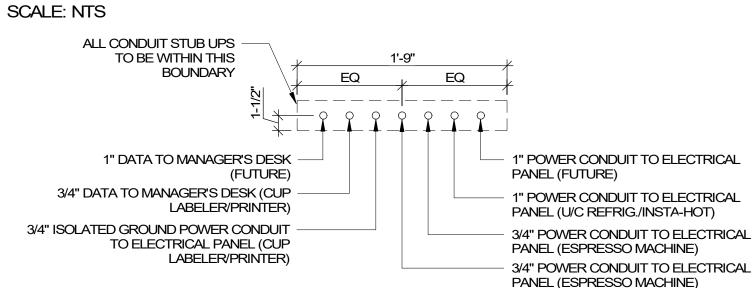

ELECTRICAL STUB UP DETAIL - ESPRESSO

ELECTRICAL DESIGN NOTES

- A. REFER TO ARCHITECTURAL DETAIL SHEETS FOR EXACT LOCATIONS AND MOUNTING HEIGHTS OF ELECTRICAL DEVICES.
- THE ELECTRICAL CONTRACTOR IS RESPONSIBLE FOR CONFIRMING ALL VOLTAGE REQUIREMENTS
- ELECTRICAL CONTRACTOR SHALL COORDINATE WITH PLUMBING AND HEATING, VENTILATING, AND AIR CONDITIONING (HVAC) CONTRACTORS FOR ANY ADDITIONAL EQUIPMENT NEEDING POWER.
- D. ALL FUTURE EQUIPMENT NEEDED HEREIN SHALL BE PROVIDED WITH AN APPROPRIATE RECEPTACLE AND FULLY WIRED. EVEN IF NOT SPECIFICALLY INDICATED.
- GROUND FAULT CIRCUIT INTERRUPTER (GFCI) BREAKERS (NOT RECEPTACLES) SHALL BE UTILIZED WHERE RÉQUIRED BY CODE AND AT ANY FLOOR BOXES. PROVIDE DEDICATED NEUTRAL WIRE FOR ALL THESE CIRCUITS.
- EQUIPMENT REQUIRES CONNECTION TO THE BUILDING ELECTRICAL SYSTEM. FURNISH AND INSTALL ALL NECESSARY CONDUIT, WIRE, CONNECTIONS, RECEPTACLES AND OVERCURRENT PROTECTION NECESSARY TO ENSURE THE EQUIPMENT FUNCTIONS PROPERLY AND COMPLIES WITH ALL APPLICABLE LOCAL AND NATIONAL CODES. COORDINATE EQUIPMENT REQUIREMENTS WITH MANUFACTURER CUT SHEET PRIOR TO ROUGH-IN.
- ALL BACK BAR AND FRONT BAR J-BOXES AND OUTLETS SHALL BE SURFACE MOUNTED. PROVIDE CONDUITS AS NEEDED AND ONE (1) ADDITIONAL SPARE CONDUIT BETWEEN ALL J-BOXES FOR FUTURE ELECTRICAL REQUIREMENTS. ALL J-BOXES SHALL BE POSITIONED TO AVOID OBSTRUCTION OF ANY EQUIPMENT SUCH AS REFRIGERATORS AND DISHWASHERS.
- REFERENCE LANDLORD WORK LETTER FOR DIVISION OF ELECTRICAL SCOPE OF WORK AND COORDINATE WITH STARBUCKS CONSTRUCTION MANAGER.
- I. ALL UNDERSLAB WORK BY STARBUCKS CONTRACTOR.
- REFER TO CALLOUTS DETAILS INDICATED ON SHEET FOR ADDITIONAL INFORMATION.

(EF-1) A- 1(E02) 9' - 6 1/2" (E11) B- 19 🖰 -ROUTE CONDUIT | UNDERSLAB TO ELECTRICAL PANELS (E09) B- 19 🔂 E16 A- 14 3' - 6" POWER PLAN 1/4" = 1'-0"

POWER PLAN SHEET NOTES

- E01 PROVIDE ELECTRICAL CONNECTION TO WATER HEATER. CONFIRM ELECTRICAL REQUIREMENTS PRIOR TO ROUGH-IN.
- E02 LANDLORD TO PROVIDE ROUGH-IN AND FINAL CONNECTION TO RESTROOM EXHAUST FAN. FAN TO BE CONTROLLED BY TIMECLOCK. CONNECT TO TIMECLOCK AS REQUIRED. SEE TIMECLOCK DETAIL ON SHEET E102 FOR MORE INFORMATION.
- E03 REFRIGERATOR AND/OR FREEZER: PROVIDE RECEPTACLE AS SHOWN AT 84" AFF. DETAIL 5 ON SHEET E501 FOR MORE INFORMATION.
- E04 ICE MACHINE: PROVIDE ROUGH-IN AND FINAL CONNECTION. PROVIDE CONNECTION TO REMOTE CONDENSER LOCATED ON ROOF. FURNISH AND INSTALL ALL NECESSARY CONDUIT, WIRE CONNECTIONS AND BREAKERS TO SUPPORT ICE MACHINE AND REMOTE CONDENSER LOCATED ON ROOF.
- E05 WAREWASHER: PROVIDE AND INSTALL NEMA 14-50R RECEPTACLE TO SUPPORT WAREWASHER. VERIFY ALL REQUIREMENTS WITH EQUIPMENT SUPPLIER PRIOR TO COMMENCING WORK INCLUDING, BUT NOT LIMITED TOO, PROVISION OF POWER CORD ACCESSORY KIT WITH NEMA 14-50P PLUG.
- E06 PROVIDE 1" CONDUIT WITH POWER TO BANQUETTE FOR POWER TO BANQUETTE MOUNTED RECEPTACLES. VERIFY EXACT ROUGH-IN AND CONNECTION REQUIREMENTS WITH FURNITURE MANUFACTURER PRIOR TO COMMENCING WORK. COORDINATE LOCATION OF FLOOR PENETRATION AND ROUTING OF 1" CONDUIT PRIOR TO COMMENCING WORK.
- E07 PROVIDE RECEPTACLE AT 18" A.F.F. IN SEATING AREAS.
- E08 STUB UP POWER, DATA, AND PHONE CONDUITS 6" AFF IN THIS LOCATION. ROUTE POWER CONDUCTORS IN FLEXIBLE METAL CONDUIT TIGHT TO WALL FROM RECEPTACLES TO NEARBY RIGID STUB-UP AND BACK TO SERVING POWER PANEL. ROUTE DATA AND PHONE CONDUITS UNDERFLOOR BACK TO DATA RACK NEAR MANAGERS WORKSTATION. LABEL DATA AND PHONE CONDUITS "FOR DATA CABLING". PROVIDE INSULATED BUSHINGS, AND PROVIDE PULL STRING FROM END TO END. LABEL SECURITY CONDUIT "FOR SECURITY" AND PROVIDE PULL STRING FROM END TO END. SEE DETAIL INDICATED FOR MORE INFORMATION.
- E09 MANAGER'S DESK: FURNISH AND INSTALL ALL NECESSARY POWER AND DATA ROUGH-INS FOR MANAGER'S DESK FOUIPMENT. ALL RECEPTACIES TO BE ISOLATED-GROUNDING TYPE RECEPTACLES WITH SURGE PROTECTION. SEE MANAGER'S DESK ELEVATIONS AND MANAGER'S DESK PLAN VIEW DETAILS INDICATED FOR EXACT ROUGH-IN TYPES, QUANTITIES, LOCATIONS, DIMENSIONS, AND
- E10 HAND DRYER/SOAP DISPENSER/FAUCET: FURNISH AND INSTALL CIRCUIT AND ROUGH-IN AT 14-13/16" A.F.F. ON GFI CIRCUIT BREAKER SIZED PER CODE TO SUPPORT INTEGRATED SINK EQUIPMENT. VERIFY EXACT ROUGH-IN LOCATION WITH MANUFACTURE AND EQUIPMENT PROVIDED PRIOR TO COMMENCING WORK
- E11 FURNISH AND INSTALL CEILING MOUNTED SHOW WINDOW RECEPTACLE. RECEPTACLES ARE TO BE PLACED WITHIN 18" OF WINDOW. COORDINATE EXACT RECEPTACLE AND COVER PLATE COLOR WITH OWNER PRIOR TO COMMENCING WORK.
- E12 PROVIDE SERVICE RECEPTACLE AT ELECTRICAL PANELS. VERIFY HEIGHT WITH OWNER PRIOR TO COMMENCING WORK.
- E13 PROVIDE ROUGH-IN AND FINAL CONNECTION TO HOT WATER RETURN PUMP. SEE PLUMBING SHEETS FOR MORE INFORMATION. VERIFY ALL REQUIREMENTS WITH EQUIPMENT MANUFACTURER PRIOR TO COMMENCING WORK. COORDINATE ALL WORK WITH PLUMBING CONTRACTOR IN FIELD.
- E14 LANDLORD TO PROVIDE ROUGH-IN AND FINAL CONNECTION TO NEW RTU. RTU-MOUNTED DISCONNECT AND SERVICE RECEPTACLE TO BE FACTORY INSTALLED AND CIRCUITED BY LANDLORD. SHOWN FOR REFERENCE ONLY.
- E15 PROVIDE ROUGH-IN AND FINAL CONNECTION FOR BOOSTER PUMP AS REQUIRED. VERIFY REQUIREMENTS WITH LANDLORD AND PLUMBING CONTRACTOR PRIOR TO COMMENCING WORK.
- E16 EXISTING EXTERIOR WEATHER PROOF RECEPTACLE PROVIDED AND INSTALLED BY LANDLORD TO REMAIN AND BE REUSED. SHOWN FOR REFERENCE ONLY.
- E17 LANDLORD TO PROVIDE AND INSTALL WEATHERPROOF GFCI DUPLEX RECEPTACLE FOR WALL MOUNTED FAN. VERIFY EXACT HEIGHT WITH GC IN FIELD PRIOR TO INSTALLATION. FANS TO BE SWITCHED TO RUN INDEPENDENTLY FROM PATIO LIGHTING. VERIFY WITH OWNER AND GC PRIOR TO INSTALLATION OF FAN SWITCH FOR
- E18 LANDLORD TO PROVIDE AND INSTALL WALL MOUNTED WEATHERPROOF GFCI DUPLEX RECEPTACLE FOR PATIO LIGHTING. VERIFY EXACT HEIGHT WITH GC IN FIELD PRIOR TO INSTALLATION. PATIO LIGHTING FIXTURES SHALL BE CONTROLLED VIA ASTRONOMICAL TIME CLOCK WITH EXTERIOR LIGHTING. SEE CONTACTOR DETAIL ON SHEET E102 FOR MORE INFORMATION.



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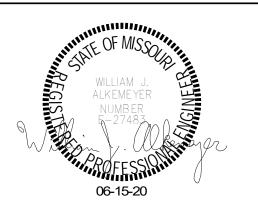
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120-20



STORE #: PROJECT#: ISSUE DATE: SR. DESIGN MANAGER: K. GORIN SLONSKI

CHECKED BY:

87799-001 PRODUCTION DESIGNER: A. HAHN NJD/BMS


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Revision Schedule


POWER PLAN

SCALE: AS SHOWN

SHEET NUMBER:

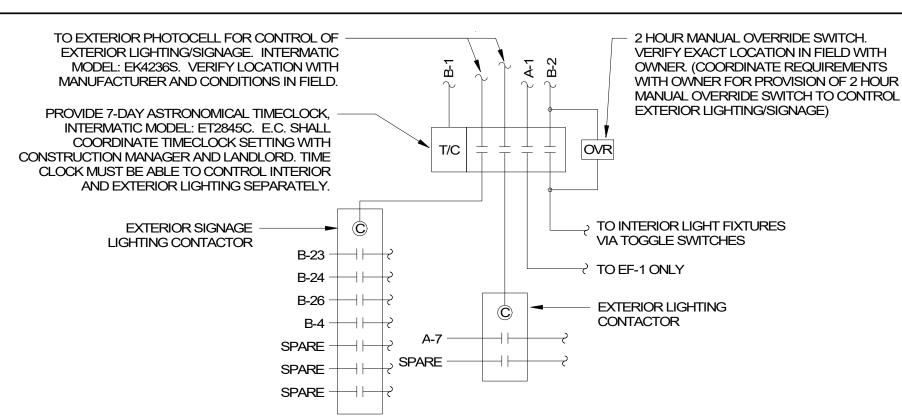

2 LIGHTING CONTROL DIAGRAM SCALE: NTS

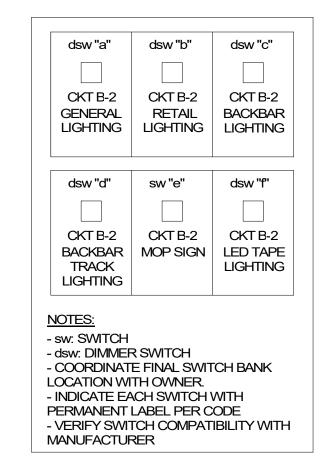

JIGHTING SWITCHBANK DETAIL

EGRESS LIGHTING NOTES

- A. EXIT SIGNS SHALL BE INTERNALLY ILLUMINATED, LISTED AND LABELED IN ACCORDANCE WITH UL 924 AND INSTALLED IN ACCORDANCE WITH THE MANUFACTURER'S INSTRUCTIONS.
- B. ANYTIME A BUILDING OR A PORTION OF A BUILDING IS OCCUPIED, THE MEANS OF EGRESS SERVING THE OCCUPIED PORTION SHALL BE ILLUMINATED AT AN INTENSITY OF NOT LESS THAN 1 FOOT CANDLE (11 LUX) AT THE WALKING SURFACE LEVEL.
- C. THE POWER SUPPLY FOR MEANS OF EGRESS ILLUMINATION SHALL BE PROVIDED BY THE PREMISE'S ELECTRICAL SUPPLY, IN THE EVENT OF POWER SUPPLY FAILURE, ILLUMINATION SHALL BE AUTOMATICALLY PROVIDED FROM AN EMERGENCY SYSTEM FOR THE FOLLOWING AREAS.
- 1) AISLES AND UNENCLOSED EGRESS STAIRWAYS IN ROOMS AND SPACES THAT REQUIRE TWO OR MORE MEANS OF EGRESS.
- 2) CORRIDORS, INTERIOR EXIT STAIRWAYS & RAMPS AND EXIT PASSAGEWAYS IN BUILDINGS REQUIRED TO HAVE TWO OR MORE EXITS.
- 3) EXTERIOR EGRESS COMPONENTS AT OTHER THAN THE LEVEL OF EXIT DISCHARGE UNTIL EXIT DISCHARGE IS ACCOMPLISHED FOR BUILDINGS REQUIRED TO HAVE TWO OR MORE EXITS.
- 4) INTERIOR EXIT DISCHARGE ELEMENTS, AS REQUIRED BY CODE IN BUILDINGS REQUIRED TO HAVE TWO OR MORE EXITS.
- 5) EXTERIOR LANDINGS, AS REQUIRED BY CODE, EXIT DISCHARGE DOORWAYS IN BUILDING REQUIRED TO HAVE TWO OR MORE EXITS.
- D. THE EMERGENCY POWER SYSTEM SHALL ALSO BE CONNECTED TO AN EMERGENCY ELECTRICAL SYSTEM WHICH IS TO PROVIDE CONTINUED ILLUMINATION FOR A DURATION OF NOT LESS THAN 1 1/2 HOUR IN CASE OF PRIMARY POWER LOSS. CONTINUED ILLUMINATION IS TO BE PROVIDED FROM STORAGE BATTERIES, UNIT EQUIPMENT OR AN ON-SITE GENERATOR AND THE INSTALLATION OF THE EMERGENCY POWER SYSTEM SHALL BE INSTALLED IN ACCORDANCE WITH THE MANUFACTURER'S INSTRUCTIONS.

EMERGENCY LIGHTING FACILITIES SHALL BE ARRANGED TO PROVIDE INITIAL ILLUMINATION THAT IS AT LEAST AN AVERAGE OF 1 FOOT CANDLE (11 LUX) AND A MINIMUM AT ANY POINT OF 0.1 FOOT CANDLE (1 LUX) MEASURED ALONG THE PATH OF EGRESS AT FLOOR LEVEL. A MAXIMUM TO MINIMUM ILLUMINATION UNIFORMITY RATION OF 40:1 SHALL NOT BE EXCEEDED.

LIGHTING DESIGN PLAN NOTES

- REFER TO ARCHITECTURAL PLANS FOR DIMENSIONED FIXTURE LOCATIONS.
- ALL FIXTURES IN WORK ROOM, BACK AND FRONT LINE, ABOVE CONDIMENT CART, AND ANY OTHER AREAS WHERE EXPOSED FOOD, CLEAN EQUIPMENT OR UTENSILS, OR UNWRAPPED SINGLE SERVICE ITEMS WILL BE EXPOSED, SHALL HAVE SHATTERPROOF LAMPS IF THE FIXTURE IS NOT LENSED. ARCHITECT OF RECORD TO INCLUDE APPROPRIATE LAMPS / FIXTURES ON DRAWINGS AND SCHEDULES, AND COMPLY WITH ANY ADDITIONAL JURISDICTIONAL LIGHTING REQUIREMENT.
- PROVIDE GROMMET AT ALL CEILING PENETRATIONS FOR FIXTURES/SUPPORTS.
- D. CENTER EMERGENCY/EXIT LIGHTS ABOVE DOORS, UNLESS OTHERWISE NOTED.
- ADJUST FOCUS OF ALL TRACK AND RECESSED DIRECTIONAL LIGHTING TO FULLY ILLUMINATE ALL ARTWORK, MENU BOARDS, AND MERCHANDISE BAYS.
- IF PENDANT CYLINDERS CAN SUSPENDED LENGTH EXCEEDS 48" (1220MM) FROM CEILING, REPLACE WITH SURFACE MOUNTED CYLINDER CANS AND SUSPEND WITH GENERAL CONTRACTOR SUPPLIED CONDUIT AND J-BOX TO DIMENSIONED HEIGHT.
- CONTRACTOR SHALL FURNISH AS-BUILTS DRAWINGS FOR ELECTRICAL POWER SYSTEMS WITHIN 30 DAYS OF SYSTEM ACCEPTANCE.
- CONTRACTOR TO FURNISH OPERATIONS AND MAINTENANCE INSTRUCTIONS FOR SYSTEMS AND EQUIPMENT TO THE BUILDING OWNER OR DESIGNATED REPRESENTATIVE UPON COMPLETION.
- CONTRACTOR TO VERIFY LIGHTING SYSTEMS HAVE BEEN TESTED TO ENSURE PROPER CALIBRATION, ADJUSTMENT, PROGRAMING, AND OPERATION.
- J. ALL EMERGENCY LIGHTING TO BE CIRCUITED TO LOCAL LIGHTING CIRCUIT AHEAD OF ANY SWITCHING OR TIMECLOCK CONTROLS UNLESS NOTED OTHERWISE.
- K. ALL EXIT SIGNS TO BE ON DEDICATED CIRCUIT INDICATED ON

LIGHTING PLAN SHEET NOTES

- PROVIDE QUADPLEX RECEPTACLES AND DUAL DATA CONNECTIONS L01 BEHIND MENUBOARD. DATA LINES SHALL RUN FROM MENUBOARD PORT TO DATA RACK AT MANAGER'S DESK. QUANTITY AND LOCATIONS OF ROUGH-INS SHOWN FOR REFERENCE ONLY. FIELD VERIFY EXACT MOUNTING HEIGHT AND LOCATION WITH GENERAL CONTRACTOR PRIOR TO COMMENCING WORK.
- INTERIOR LIGHTING FIXTURES SHALL BE CONTROLLED VIA SWITCH BANK AND ASTRONOMICAL TIME CLOCK. SEE DETAILS 2 & 3 ON THIS SHEET FOR MORE INFORMATION. VERIFY EXACT LOCATION WITH OWNER PRIOR TO COMMENCING WORK. TIME CLOCK SHALL BE LOCATED ADJACENT TO ELECTRICAL PANELS. FURNISH AND INSTALL ALL CONDUIT, WIRE, CONNECTIONS AND TIME CLOCK MODULES NECESSARY TO INSURE A FUNCTIONAL TIME CLOCK SYSTEM.
- LOCATION OF SWITCH BANK SHOWN FOR REFERENCE ONLY. COORDINATE EXACT LOCATION FOR SWITCH BANK WITH GENERAL CONTRACTOR PRIOR TO COMMENCING WORK.
- CIRCUIT SERVING EXTERIOR SIGNAGE SHALL BE CONTROLLED BY L04 ASTRONOMICAL TIME CLOCK. PHOTOCELL AND LIGHTING CONTACTOR TIME CLOCK SHALL BE LOCATED ADJACENT TO ELECTRICAL PANELS. VERIFY LOCATION OF PHOTOCELL WITH MANUFACTURER. FURNISH AND INSTALL ALL CONDUIT, WIRE, CONNECTIONS AND TIME CLOCK MODULES NECESSARY TO INSURE A FUNCTIONAL TIME CLOCK SYSTEM IF LANDLORD PROVIDED SYSTEM IS NOT ADEQUATE. SEE DETAIL 2 ON THIS SHEET FOR MORE INFORMATION.
- E.C. SHALL PROVIDE ROUGH-IN AND FINAL CONNECTION TO STOREFRONT SIGN. FIELD VERIFY EXACT MOUNTING HEIGHT AND LOCATION WITH OWNER PRIOR TO COMMENCING WORK AND/OR PLACING BID. PROVIDE ALL CONNECTIONS AND EQUIPMENT NECESSARY TO MEET ALL LOCAL CODES AND SIGNAGE REQUIREMENTS. VERIFY WITH SIGN VENDOR AND LOCAL AUTHORITY HAVING JURISDICTION PRIOR TO COMMENCING WORK. REUSE EXISTING CONDUIT AND PENETRATIONS PROVIDED BY LANDLORD WHERE POSSIBLE. VERIFY WITH CONDITIONS IN FIELD.
- LANDLORD TO PROVIDE, CIRCUIT, INSTALL, AND CONTROLL EXTERIOR LIGHT FIXTURE. SHOWN FOR REFERENCE ONLY.
- PROVIDE AND INSTALL EXTERIOR EGRESS LIGHTING IF NOT EXISTING BY LANDLORD. REUSE EXISTING EGRESS LIGHTING PROVIDED BY LANDLORD AND CONNECT TO NEW EXIT/EMERGENCY LIGHT IF COMPATIBLE, PROVIDE NEW IF NECESSARY. VERIFY WITH CONDITIONS IN FIELD PRIOR TO COMMENCING WORK.
- PATIO STRING LIGHTING TO BE POWERED BY WALL MOUNTED RECEPTACLE PROVIDED AND INSTALLED BY LANDLORD. LIGHTING TO BE CONTROLLED BY ASTRONOMICAL TIME CLOCK, PHOTOCELL AND LIGHTING CONTACTOR. SEE DETAIL 2 ON THIS SHEET FOR MORE INFORMATION.
- PROVIDE ROUGH-IN AND FINAL CONNECTION TO MOP SIGN. VERIFY EXACT ROUGH-IN AND CONTROL REQUIREMENTS WITH OWNER AND EQUIPMENT PROVIDED IN FIELD.
- PROVIDE AND INSTALL ALL EQUIPMENT NECESSARY FOR LED TAPE LIGHTING AT BAR INCLUDING, BUT NOT LIMITED TOO, LED DRIVER(S) AND ADDITIONAL CONNECTIONS. VERIFY EXACT QUANTITY AND LOCATION OF LED DRIVERS AND ADDITIONAL EQUIPMENT. LIGHTING SHALL BE CONTROLLED VIA SWITCH BANK AND ASTRONOMICAL TIME



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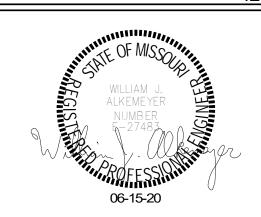
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FINAL

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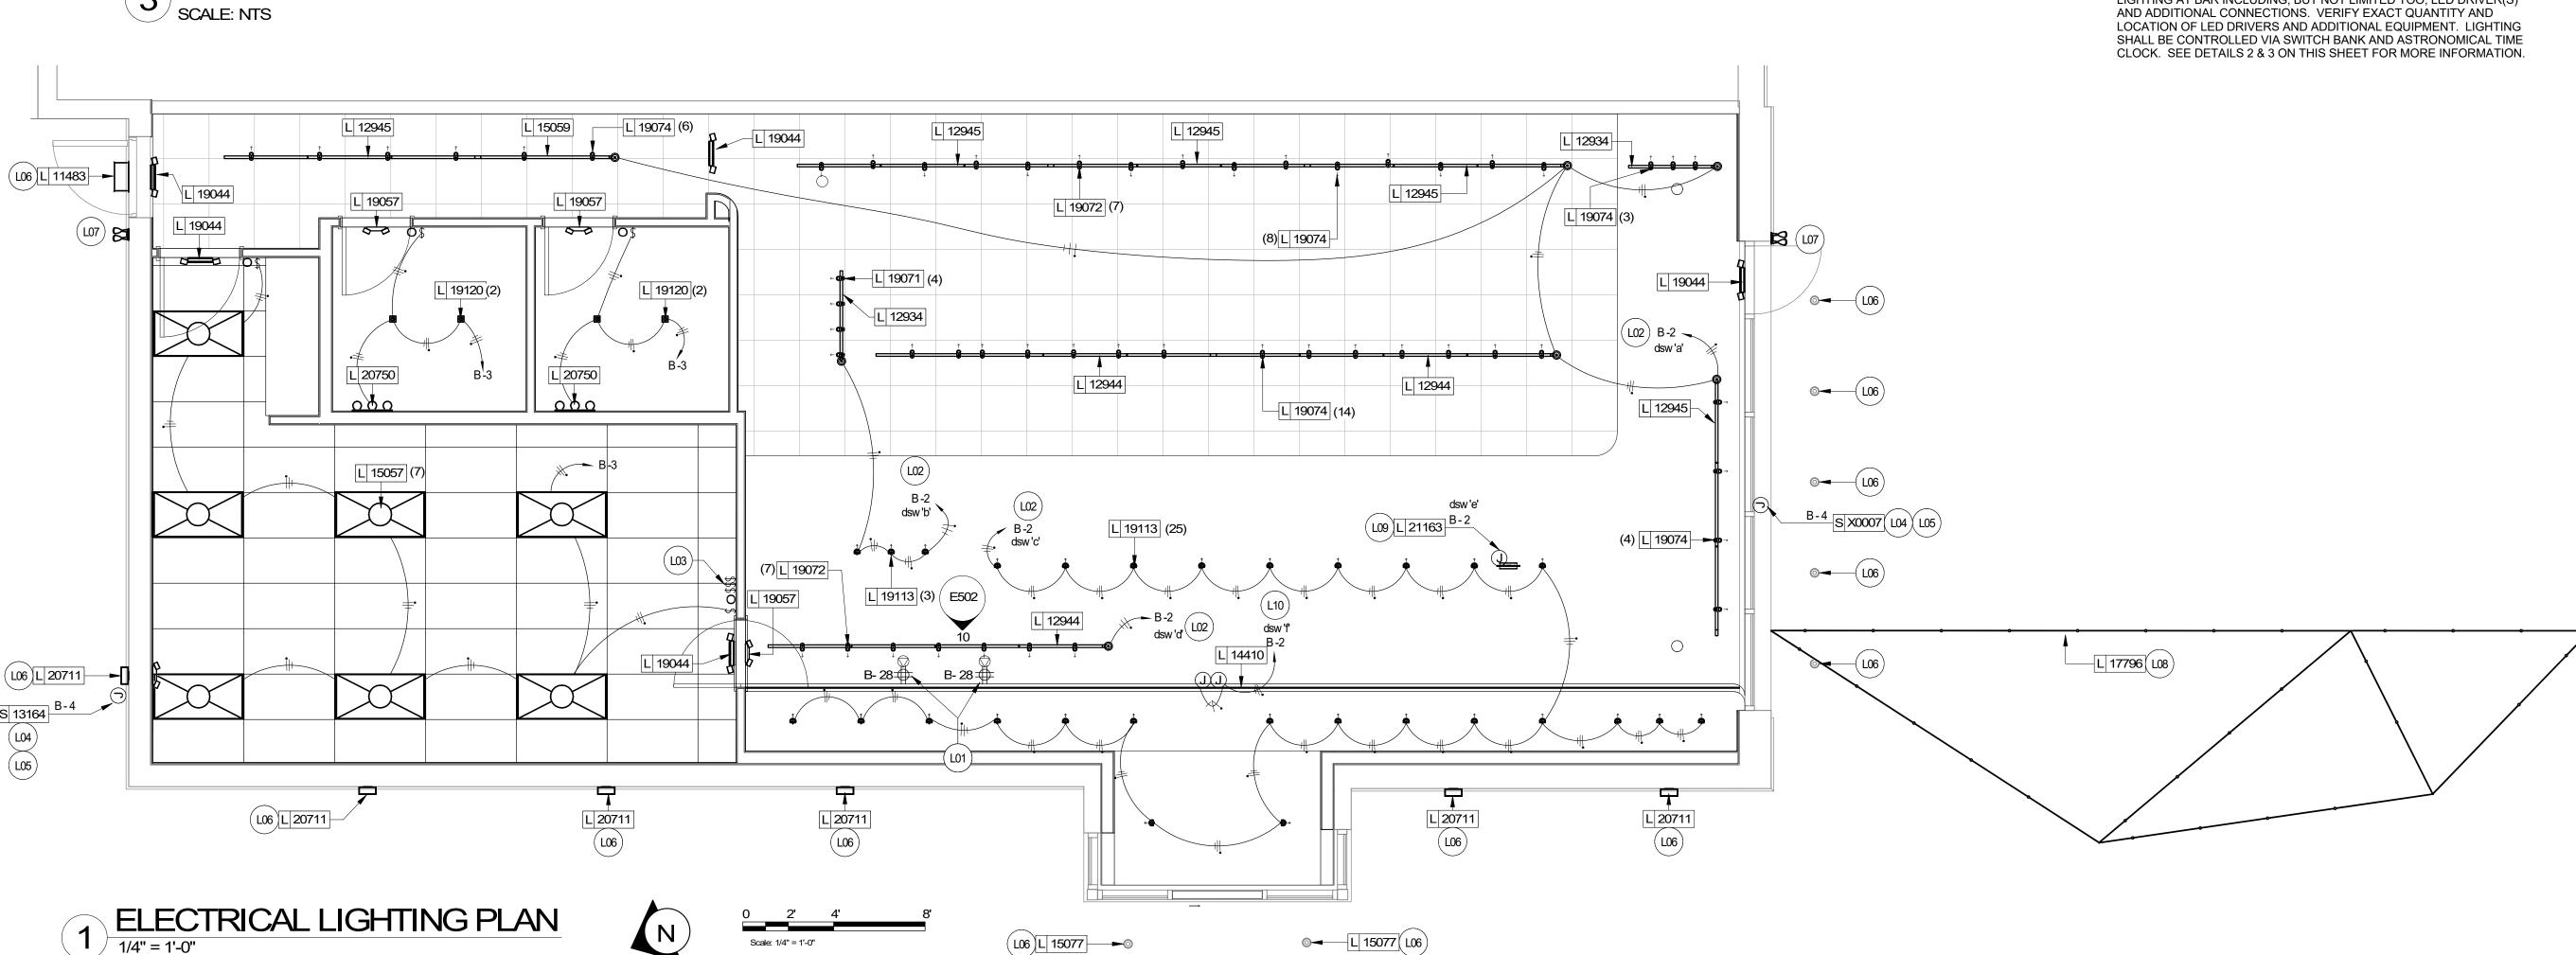
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STORE #: 62012 PROJECT#: ISSUE DATE

87799-001 SR. DESIGN MANAGER: K. GORIN SLONSKI PRODUCTION DESIGNER: A. HAHN CHECKED BY: NJD/BMS

ELECTRICAL LIGHTING PLAN SCALE: AS SHOWN SHEET NUMBER: E102



ENLARGED ELECTRICAL GENERAL NOTES

- REFER TO ELECTRICAL DETAIL SHEETS FOR EXACT LOCATIONS AND MOUNTING HEIGHTS OF ELECTRICAL DEVICES.
- THE ELECTRICAL CONTRACTOR IS RESPONSIBLE FOR CONFIRMING ALL VOLTAGE REQUIREMENTS ON ALL EQUIPMENT AND PROVIDING BUCK-BOOST TRANSFORMERS AS MAY BE NEEDED PER MANUFACTURER'S RECOMMENDATIONS OR FOR CODE. ALL ARE NOT NECESSARILY INDICATED.
- ELECTRICAL CONTRACTOR SHALL COORDINATE WITH PLUMBING AND HEATING. VENTILATING, AND AIR CONDITIONING (HVAC) CONTRACTORS FOR ANY ADDITIONAL EQUIPMENT NEEDING POWER.
- ANY EQUIPMENT NOTED AS 'FUTURE' SHALL BE PROVIDED WITH APPROPRIATE RECEPTACLES AND WIRING TO ENABLE FUTURE OPERATION.
- GROUND FAULT CIRCUIT INTERRUPTER (GFCI) BREAKERS (NOT RECEPTACLES) SHALL BE UTILIZED WHERE REQUIRED BY CODE AND AT ANY FLOOR BOXES. PROVIDE DEDICATED NEUTRAL WIRE FOR ALL THESE CIRCUITS.
- EQUIPMENT REQUIRES CONNECTION TO THE BUILDING ELECTRICAL SYSTEM. FURNISH AND INSTALL ALL NECESSARY CONDUIT, WIRE, CONNECTIONS, RECEPTACLES AND OVERCURRENT PROTECTION NECESSARY TO ENSURE THE EQUIPMENT FUNCTIONS PROPERLY AND COMPLIES WITH ALL APPLICABLE LOCAL AND NATIONAL CODES. COORDINATE EQUIPMENT REQUIREMENTS WITH MANUFACTURER CUT SHEET PRIOR TO ROUGH-IN.
- ALL BACK BAR AND FRONT BAR J-BOXES AND OUTLETS SHALL BE SURFACE MOUNTED. PROVIDE CONDUITS AS NEEDED AND ONE (1) ADDITIONAL SPARE CONDUIT BETWEEN ALL J-BOXES FOR FUTURE ELECTRICAL REQUIREMENTS. ALL J-BOXES SHALL BE POSITIONED TO AVOID OBSTRUCTION OF ANY EQUIPMENT SUCH AS REFRIGERATORS AND DISHWASHERS.
- REFERENCE LANDLORD WORK LETTER FOR DIVISION OF ELECTRICAL SCOPE OF WORK AND COORDINATE WITH STARBUCKS CONSTRUCTION MANAGER.
- ALL DATA OUTLETS TO BE ROUTED BACK TO DATA RACK AT MANAGER'S DESK WITH 3/4" UNLESS NOTED OTHERWISE.
- DIMENSION TO BOXED TOGETHER ROUGH-INS IN CASWORK INDICATING CENTERLINE OF ROUGH-IN GROUP.

ENLARGED ELECTRICAL SHEET NOTES

- EL01 PROVIDE ROUGH-IN(S) @ 26" AFF. CIRCUIT RECEPTACLE AS INDICATED. ROUTE DATA BACK TO DATA RACK AT MANAGERS DESK.
- EL02 DRIVE-THRU EQUIPMENT: FURNISH AND INSTALL ALL NECESSARY POWER AND DATA ROUGH-INS FOR DRIVE-THRU EQUIPMENT. ALL RECEPTACLES FOR DRIVE-THRU EQUIPMENT TO BE ISOLATED-GROUNDING TYPE RECEPTACLE WITH SURGE PROTECTION. SEE DRIVE-THRU ELEVATION AND DRIVE-THRU PLAN VIEW DETAILS INDICATED FOR EXACT ROUGH-IN TYPES, QUANTITIES, LOCATIONS, DIMENSIONS, AND CIRCUITING.
- EL03 ESPRESSO MACHINES: FURNISH AND INSTALL HEAVY DUTY RECEPTACLE AT 26" AFF. FURNISH AND INSTALL HEAVY DUTY ANGLED PLUG. PROVIDE ANY ADDITIONAL CONDUIT, WIRE, PRIMARY AND SECONDARY PROTECTION, AND CONNECTIONS NECESSARY TO INSURE A FUNCTIONAL SYSTEM. VERIFY EXACT ROUGH-IN AND OVERCURRENT PROTECTION REQUIREMENTS WITH MANUFACTURER PRIOR TO COMMENCING WORK.
- EL04 POS PRINTER: FURNISH AND INSTALL QUADPLEX ISOLATED-GROUNDING TYPE RECEPTACLE WITH SURGE PROTECTION AT 26" AFF. FURNISH AND INSTALL DATA OUTLET AT 26" AFF.
- EL05 SAFE: FURNISH AND INSTALL QUADPLEX ISOLATED-GROUNDING TYPE RECEPTACLE WITH SURGE PROTECTION AT 18" AFF.
- EL06 POS: FURNISH AND INSTALL DUPLEX ISOLATED-GROUNDING TYPE RECEPTACLE WITH SURGE PROTECTION AT 18" AFF. FURNISH AND INSTALL (1) DATA OUTLET AND AT 18"
- EL07 FURNISH AND INSTALL NEMA 6-30R RECEPTACLE AT 26" AFF TO SUPPORT WARMING OVENS, PROVIDE DATA CONNECTION AS REQUIRED FOR WARMING OVEN, WORK SHALL INCLUDE ROUGH-IN AND CONDUIT WITH CAT5 CABLE FROM EQUIPMENT TO DATA RACK. COORDINATE LOCATION AND CONNECTION REQUIREMENTS WITH STARBUCKS PROJECT MANAGER IN FIELD.
- EL08 FURNISH AND INSTALL NEMA 6-50R RECEPTACLES AT 26" AFF TO SUPPORT DUAL BREWER. FURNISH AND INSTALL POWER CORD WITH NEMA 6-50P PLUG. COORDINATE EXACT INSTALLATION REQUIREMENTS WITH MANUFACTURER AND LOCATION AND CONNECTION REQUIREMENTS WITH STARBUCKS PROJECT MANAGER IN FIELD.
- EL09 D/T WINDOW CONTROL: LANDLORD TO PROVIDE ROUGH-IN AT WINDOW HEADER HEIGHT. PROVIDE FINAL CONNECTION AS REQUIRED. VERIFY EXACT SCOPE OF WORK WITH LANDLORD AND CONDITIONS IN FIELD PRIOR TO COMMENCING WORK.
- EL10 PROVIDE ROUGH-IN AT 26" AFF FOR FUTURE USE. CIRCUIT RECEPTACLE AS INDICATED. ROUTE DATA BACK TO DATA RACK AT MANAGERS DESK.
- EL11 D/T AIR CURTAIN: LANDLORD TO PROVIDE DEDICATED CONDUIT TO POWER PANEL AND ALL NECESSARY WIRE AND CONNECTIONS FOR A FUNCTIONAL AIR CURTAIN SYSTEM. COORDINATE WITH MANUFACTURER'S REQUIREMENTS PRIOR TO ROUGH-IN.
- EL12 INSTALL OWNER PROVIDED IOT MODULE FOR ESPRESSO MACHINE AND MAKE FINAL CONNECTIONS AS REQUIRED.



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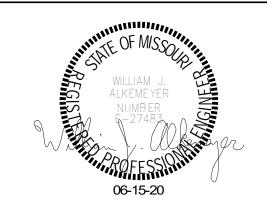


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STORE #: PROJECT#: ISSUE DATE:

62012 87799-001

SR. DESIGN MANAGER: K. GORIN SLONSKI PRODUCTION DESIGNER: A. HAHN CHECKED BY: NJD/BMS

ENLARGED ELECTRICAL PLACEMENT PLAN

SCALE: AS SHOWN SHEET NUMBER:

E103



2' - 3 1/2"

3' - 11 1/2"

ET08 8 41000 4 1002 4 ET02

(EL10) (EL10)

2' - 4 1/2"

1' - 5"

5' - 8"

3' - 9"

E 19559 A- 25

E502

(EL01)E 20011 A- 25

E501)

1' - 11"

4' - 3 1/2"


1' - 7"

A- 5 W 14077 EL09

A 20294 (EL12)

3' - 10 1/2"

2' - 0 1/2"

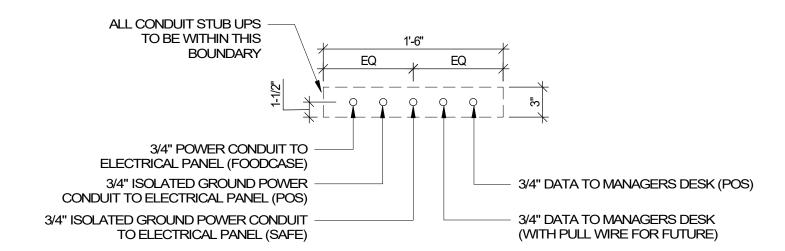

ELECTRICAL STUB UP DETAIL - POS

SCALE: NTS ALL CONDUIT STUB UPS TO BE WITHIN THIS BOUNDARY 1" DATA TO MANAGER'S DESK 1" POWER CONDUIT TO ELECTRICAL (FUTURE) PANEL (FUTURE) 3/4" DATA TO MANAGER'S DESK (CUP 1" POWER CONDUIT TO ELECTRICAL LABELER/PRINTER) PANEL (U/C REFRIG./INSTA-HOT) 3/4" ISOLATED GROUND POWER CONDUIT 3/4" POWER CONDUIT TO ELECTRICAL TO ELECTRICAL PANEL (CUP PANEL (ESPRESSO MACHINE) LABELER/PRINTER) 3/4" POWER CONDUIT TO ELECTRICAL PANEL (ESPRESSO MACHINE)

ELECTRICAL STUB UP DETAIL - ESPRESSO

DATA PLAN SHEET NOTES

- D01 CEILING MOUNTED WIRELESS ACCESS POINT (WAP). PROVIDE ROUGH-IN FOR WAP AND CAT6 CABLE FROM EQUIPMENT RACK PATCH PANEL AT MANAGERS DESK TO WAP LOCATION. PROVIDE ROUGH-IN FOR WAP OVER POS COUNTER CENTERED BETWEEN CASH REGISTERS AND OVER MANAGERS DESK. STARBUCKS VENDOR TO INSTALL WAP DEVICE.
- D02 PROVIDE DRIVE THRU SECURITY CAMERA ON EXTERIOR OF BUILDING ONLY AS REQUIRED. VERIFY EXACT REQUIREMENTS WITH OWNER AND/OR OWNERS REPRESENTATIVE PRIOR TO COMMENCING WORK.
- D03 PROVIDE ROUGH-IN AND FINAL CONNECTION TO AUDIO SPEAKER. WALL MOUNTED SPEAKER WATTAGE SETTING TO BE 5 VOLT. CEILING MOUNTED PENDANT SPEAKER WATTAGE SETTING TO BE 7.5 VOLT. COORDINATE EXACT LOCATION AND REQUIREMENTS, INCLUDING FINAL WATTAGE SETTING, WITH CONSTRUCTION MANAGER PRIOR TO COMMENCING WORK.
- D04 STUB UP POWER, DATA, AND PHONE CONDUITS 6" AFF IN THIS LOCATION. ROUTE POWER CONDUCTORS IN FLEXIBLE METAL CONDUIT TIGHT TO WALL FROM RECEPTACLES TO NEARBY RIGID STUB-UP AND BACK TO SERVING POWER PANEL. ROUTE DATA AND PHONE CONDUITS UNDERFLOOR BACK TO DATA RACK NEAR MANAGERS WORKSTATION. LABEL DATA AND PHONE CONDUITS "FOR DATA CABLING", PROVIDE INSULATED BUSHINGS, AND PROVIDE PULL STRING FROM END TO END. LABEL SECURITY CONDUIT "FOR SECURITY" AND PROVIDE PULL STRING FROM END TO END. SEE SHEET E102 FOR MORE INFORMATION.
- D05 MANAGER'S DESK: FURNISH AND INSTALL ALL NECESSARY POWER AND DATA ROUGH-INS FOR MANAGER'S DESK EQUIPMENT. ALL RECEPTACLES TO BE ISOLATED-GROUNDING TYPE RECEPTACLES WITH SURGE PROTECTION. SEE MANAGER'S DESK ELEVATIONS AND MANAGER'S DESK PLAN VIEW DETAILS INDICATED FOR EXACT ROUGH-IN TYPES, QUANTITIES, LOCATIONS, DIMENSIONS, AND CIRCUITING.
- D06 INSTALL CARBON MONOXIDE DETECTOR IN REAR OF SPACE AT LEAST 10 FEET FROM WATER HEATER PER STARBUCKS DESIGN STANDARDS. CARBON MONOXIDE DETECTOR SHALL BE #US 260 CO-SAFEAIR DETECTOR CONNECTED TO SECURITY CONTROL PANEL. VERIFY MOUNTING HEIGHT WITH EQUIPMENT SUPPLIER AND G.C. IN
- D07 DOOR POSITION SWITCH. LOCATE ONE AT EACH EXTERIOR DOOR LEAF.
- D08 ALARM KEY PAD. LOCATED WITHIN 10'-0" OF EMPLOYEE ENTRANCE. MOUNT AT 42"
- D09 PIR MOTION DETECTOR REQUIRED PER STORE AT FOLLOWING LOCATIONS: (1) BEHIND BAR NEAR POS, (1) CENTRALLY LOCATED IN CAFE, (1) AT MANAGER'S WORKSTATION, (1) CENTRALLY LOCATED IN BOH. VERIFY FINAL LOCATIONS PRIOR TO COMMENCING
- D10 SECURITY CAMERA. CEILING MOUNT TYPICAL. IN OPEN CEILING CONDITION LOCATE BOTTOM OF CAMERA AT SAME HEIGHT AS STORE LIGHTING.
- D11 DRIVE THRU SECURITY CAMERA. LOCATE 6'-0" TO 8'-0" FROM WINDOW WITH CLEAR VIEW OF CUSTOMER AND DT POS.

(D03)A 10015 A 10017 (D03) (D03) (M) (D09) (D08) -STUB UP DATA CONDUIT IN WALL AT LOCATIO INDICATED. (D03) A 10015 (D09) (M) E501 EXTEND DATA CONDUITS OVERHEAD TO MANAGER'S IT/DATA RACK.— (ω) → A 10017 (D03) SC SC D02 E501 DATA DEVICE PLAN

DATA GENERAL NOTES

- A. REFER TO SHEET E104 FOR EXACT LOCATIONS AND MOUNTING HEIGHTS OF DATA DEVICES IN BAR AREA. REFER TO DETAILS ON SHEETS E501 AND 502 FOR ADDITIONAL INFORMATION.
- B. THE ELECTRICAL CONTRACTOR IS RESPONSIBLE FOR CONFIRMING ALL VOLTAGE REQUIREMENTS ON ALL EQUIPMENT AND PROVIDING BUCK-BOOST TRANSFORMERS AS MAY BE NEEDED FOR CODE. ALL ARE NOT NECESSARILY INDICATED.
- C. ANY EQUIPMENT NOTED AS 'FUTURE' SHALL BE PROVIDED WITH APPROPRIATE RECEPTACLES AND WIRING TO ENABLE FUTURE OPERATION.
- D. REFERENCE LANDLORD WORK LETTER FOR DIVISION OF ELECTRICAL SCOPE OF WORK AND COORDINATE WITH STARBUCKS CONSTRUCTION
- E. DATA CABLING LOCATED ABOVE HEAD SHALL BE PLENUM.
- F. DATA CABLING LOCATED UNDERGROUND SHALL BE RATED FOR BELOW GROUND USE.
- G. DATA CABLING AT EXPOSED CEILING SHALL BE INSTALLED IN METAL CONDUIT OR PER LOCAL CODE REQUIREMENT.

2. MUSIC SYSTEM

- H. GC SHALL INSTALL SPEAKERS AND WIRING PER DRAWING
- I. SPEAKER PLACEMENT: LOCATE (1) PER 250 SF OF CAFE SPACE @ 14'-0" MIN. TO 18'-0" MAX. O.C.
- J. SPEAKER PAINTING: SPEAKER GRILLS CAN BE PAINTED. NOTE: GRILL HOLES SHALL REMAIN OPEN.
- K. G.C. SHALL INSTALL MUSIC SYSTEM, CONNECT WIRING, AND TEST.

- L. ENTRY CAMERA: CAPTURE ENTIRE DOORWAY ANDCUSTOMER TOP OF HEAD TO KNEES. PROVIDE (1) CAMERA @ EACH ENTRY.
- M. POS CAMERA: PRIMARY OBJECTIVE IS CUSTOMER; SECONDARY IS TRANSACTION PLANE. CAPTURE MULTIPLE POS LOCATIONS.
- N. SAFE CAMERA: POSITION TO VIEW FROM HANDLE SIDE OF DOOR. POS CAMERA CAN BE USED WHEN SAFE IS LOCATED BELOW TERMINALS.
- O. DRIVE THRU CAMERA: PRIMARY OBJECTIVE IS CUSTOMER; SECONDARY IS POS. IDEAL PLACEMENT WOULD CAPTURE BOTH.
- P. BOH CAMERA: CAPTURES CASH HANDLING.
- Q. CARBON MONOXIDE: AT LEAST ONE CARBON MONOXIDE (CO) DETECTOR IS TO BE LOCATED IN THE BACK OF HOUSE. PROVIDE SECOND DETECTOR IN CAFE IF SPACE INCLUDES A FIREPLACE.

4. LOW VOLTAGE CABLING

- R. GC TO PROVIDE PATHWAYS FOR ALL DATA AND LOWVOLTAGE CABLING DEVICES. CONDUITS CONTAINING MULTIPLE CABLES SHALL BE UP-SIZED FOR FUTURE CAPACITY, 1" [25MM] TYPICAL.
- S. PROVIDE LABELED, END-TO-END PULL STRINGS RATED TO 20 LBS IN ALL CONDUITS.
- T. CONDUIT BEND RADIUS SHALL BE A MIN. OF 6x THE INTERNAL CONDUIT
- U. TERMINATE CONDUITS THAT EXTEND THROUGH SLAB MIN. 3" [75MM]
- V. FLEX CONDUIT IS GENERALLY UNACCEPTABLE FOR USE AS A COMMUNICATIONS CONDUIT EXCEPT AT SEISMIC JOINTS.
- W. ALL SUB-SLAB CONDUITS SHALL BE INSTALLED IN A MATTER THAT PREVENTS WATER INFILTRATION OF THE CONDUIT. IT IS THE GC'S RESPONSIBILITY TO ENSURE RAIN WATER OR CONSTRUCTION WATER IS PREVENTED FROM ENTERING AND/OR REMOVED FROM CONDUIT PRIOR TO PLACEMENT OF CABLES.
- X. ALL PULL BOXES SHALL BE SIZED AND INSTALLED PER ANSI/TIA/EIA-569-A. PULL BOXES FOR UNDERGROUND CONDUITS ARE NOT PERMITTED UNLESS OTHERWISE NOTED.

5. BROADBAND CABLE

Y. MAIN POINT OF ENTRY: GC TO PROVIDE MIN. 2" [50MM] CONDUIT PATH FROM THE BUILDING'S MAIN POINT OF ENTRY (MPOE) TO THE CEILING AT THE MANAGER'S WORKSTATION. THE INTERNET SERVICE PROVIDER (ISP) WILL DESIGNATE THE START AND END LOCATIONS OF THE CONDUIT, AND ANY BACKBOARD, GROUNDING, AND POWER



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CONDITIONS. NEITHER PARTY SHALL HAVE ANY OBLIGATION NOR LIABILITY TO THE OTHER (EXCEPT STATED ABOVE) UNTIL A

WRITTEN AGREEMENT IS FULLY EXECUTED BY BOTH PARTIES


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2020

Engineering Consultant



STORE #: 62012 PROJECT#: 87799-001 ISSUE DATE:

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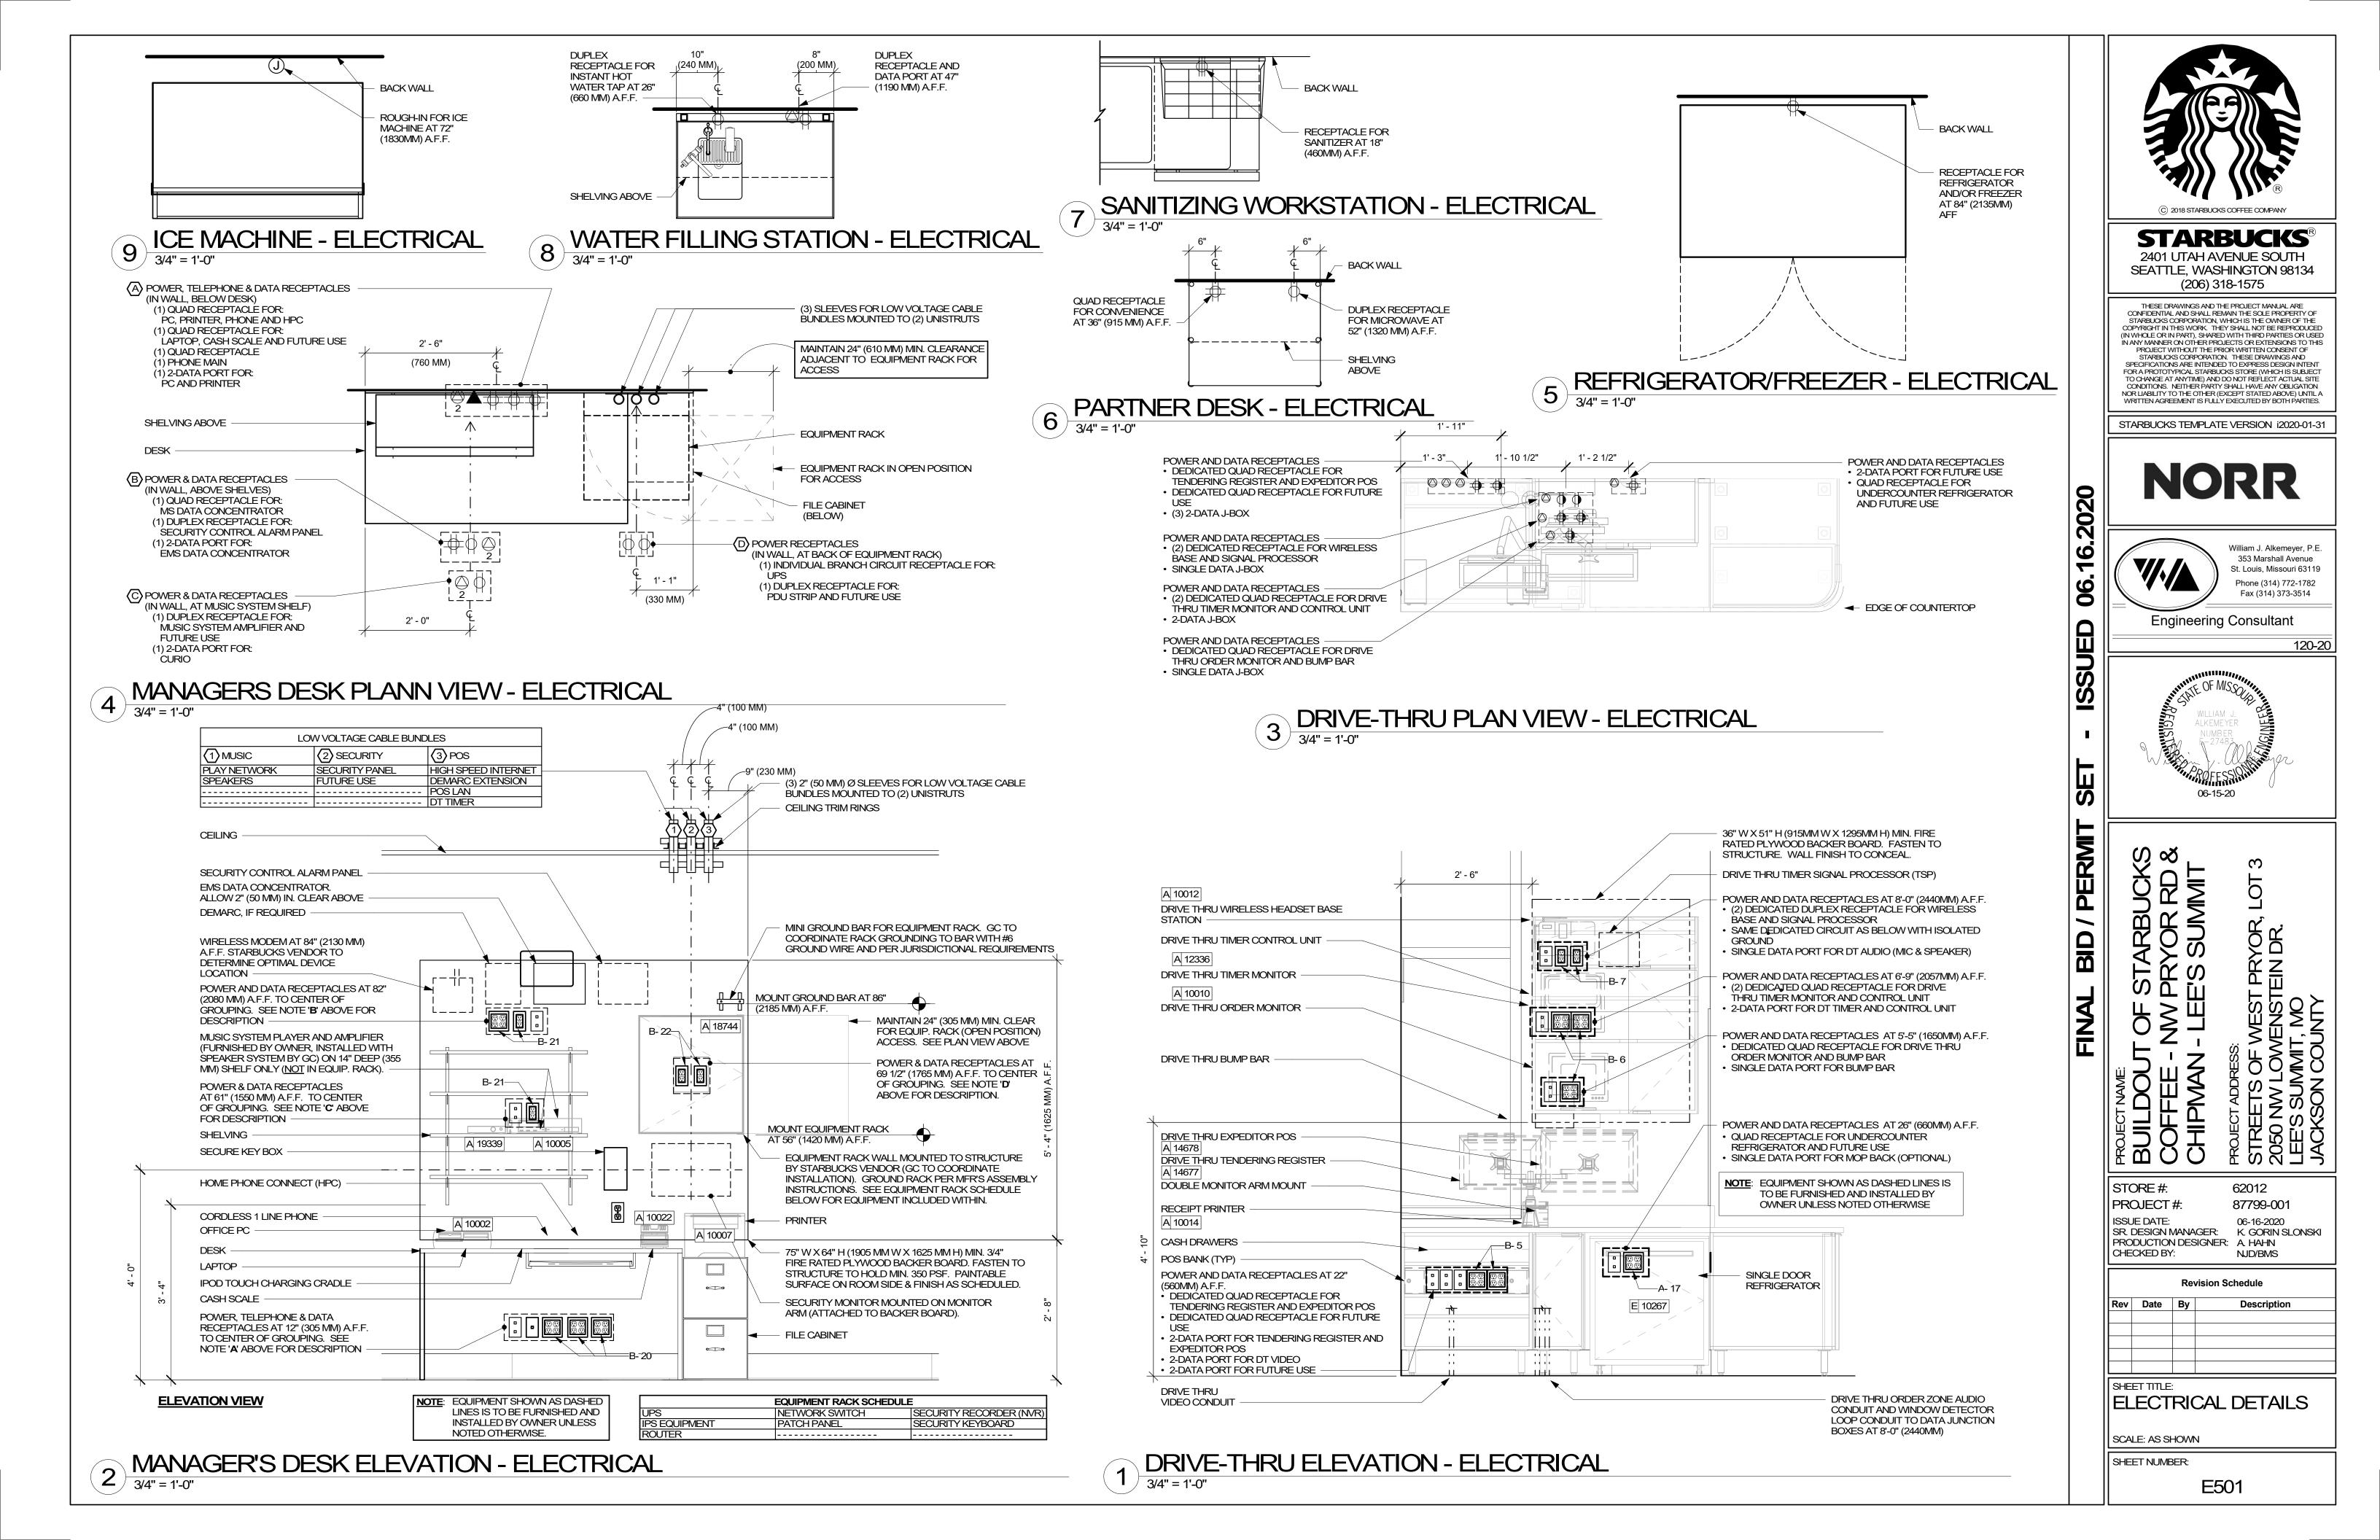
06-16-2020 SR. DESIGN MANAGER: K. GORIN SLONSKI PRODUCTION DESIGNER: A. HAHN NJD/BMS

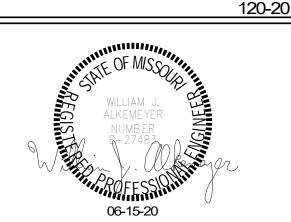
Revision Schedule

DATA DEVICE PLAN

CHECKED BY:

SCALE: AS SHOWN SHEET NUMBER:



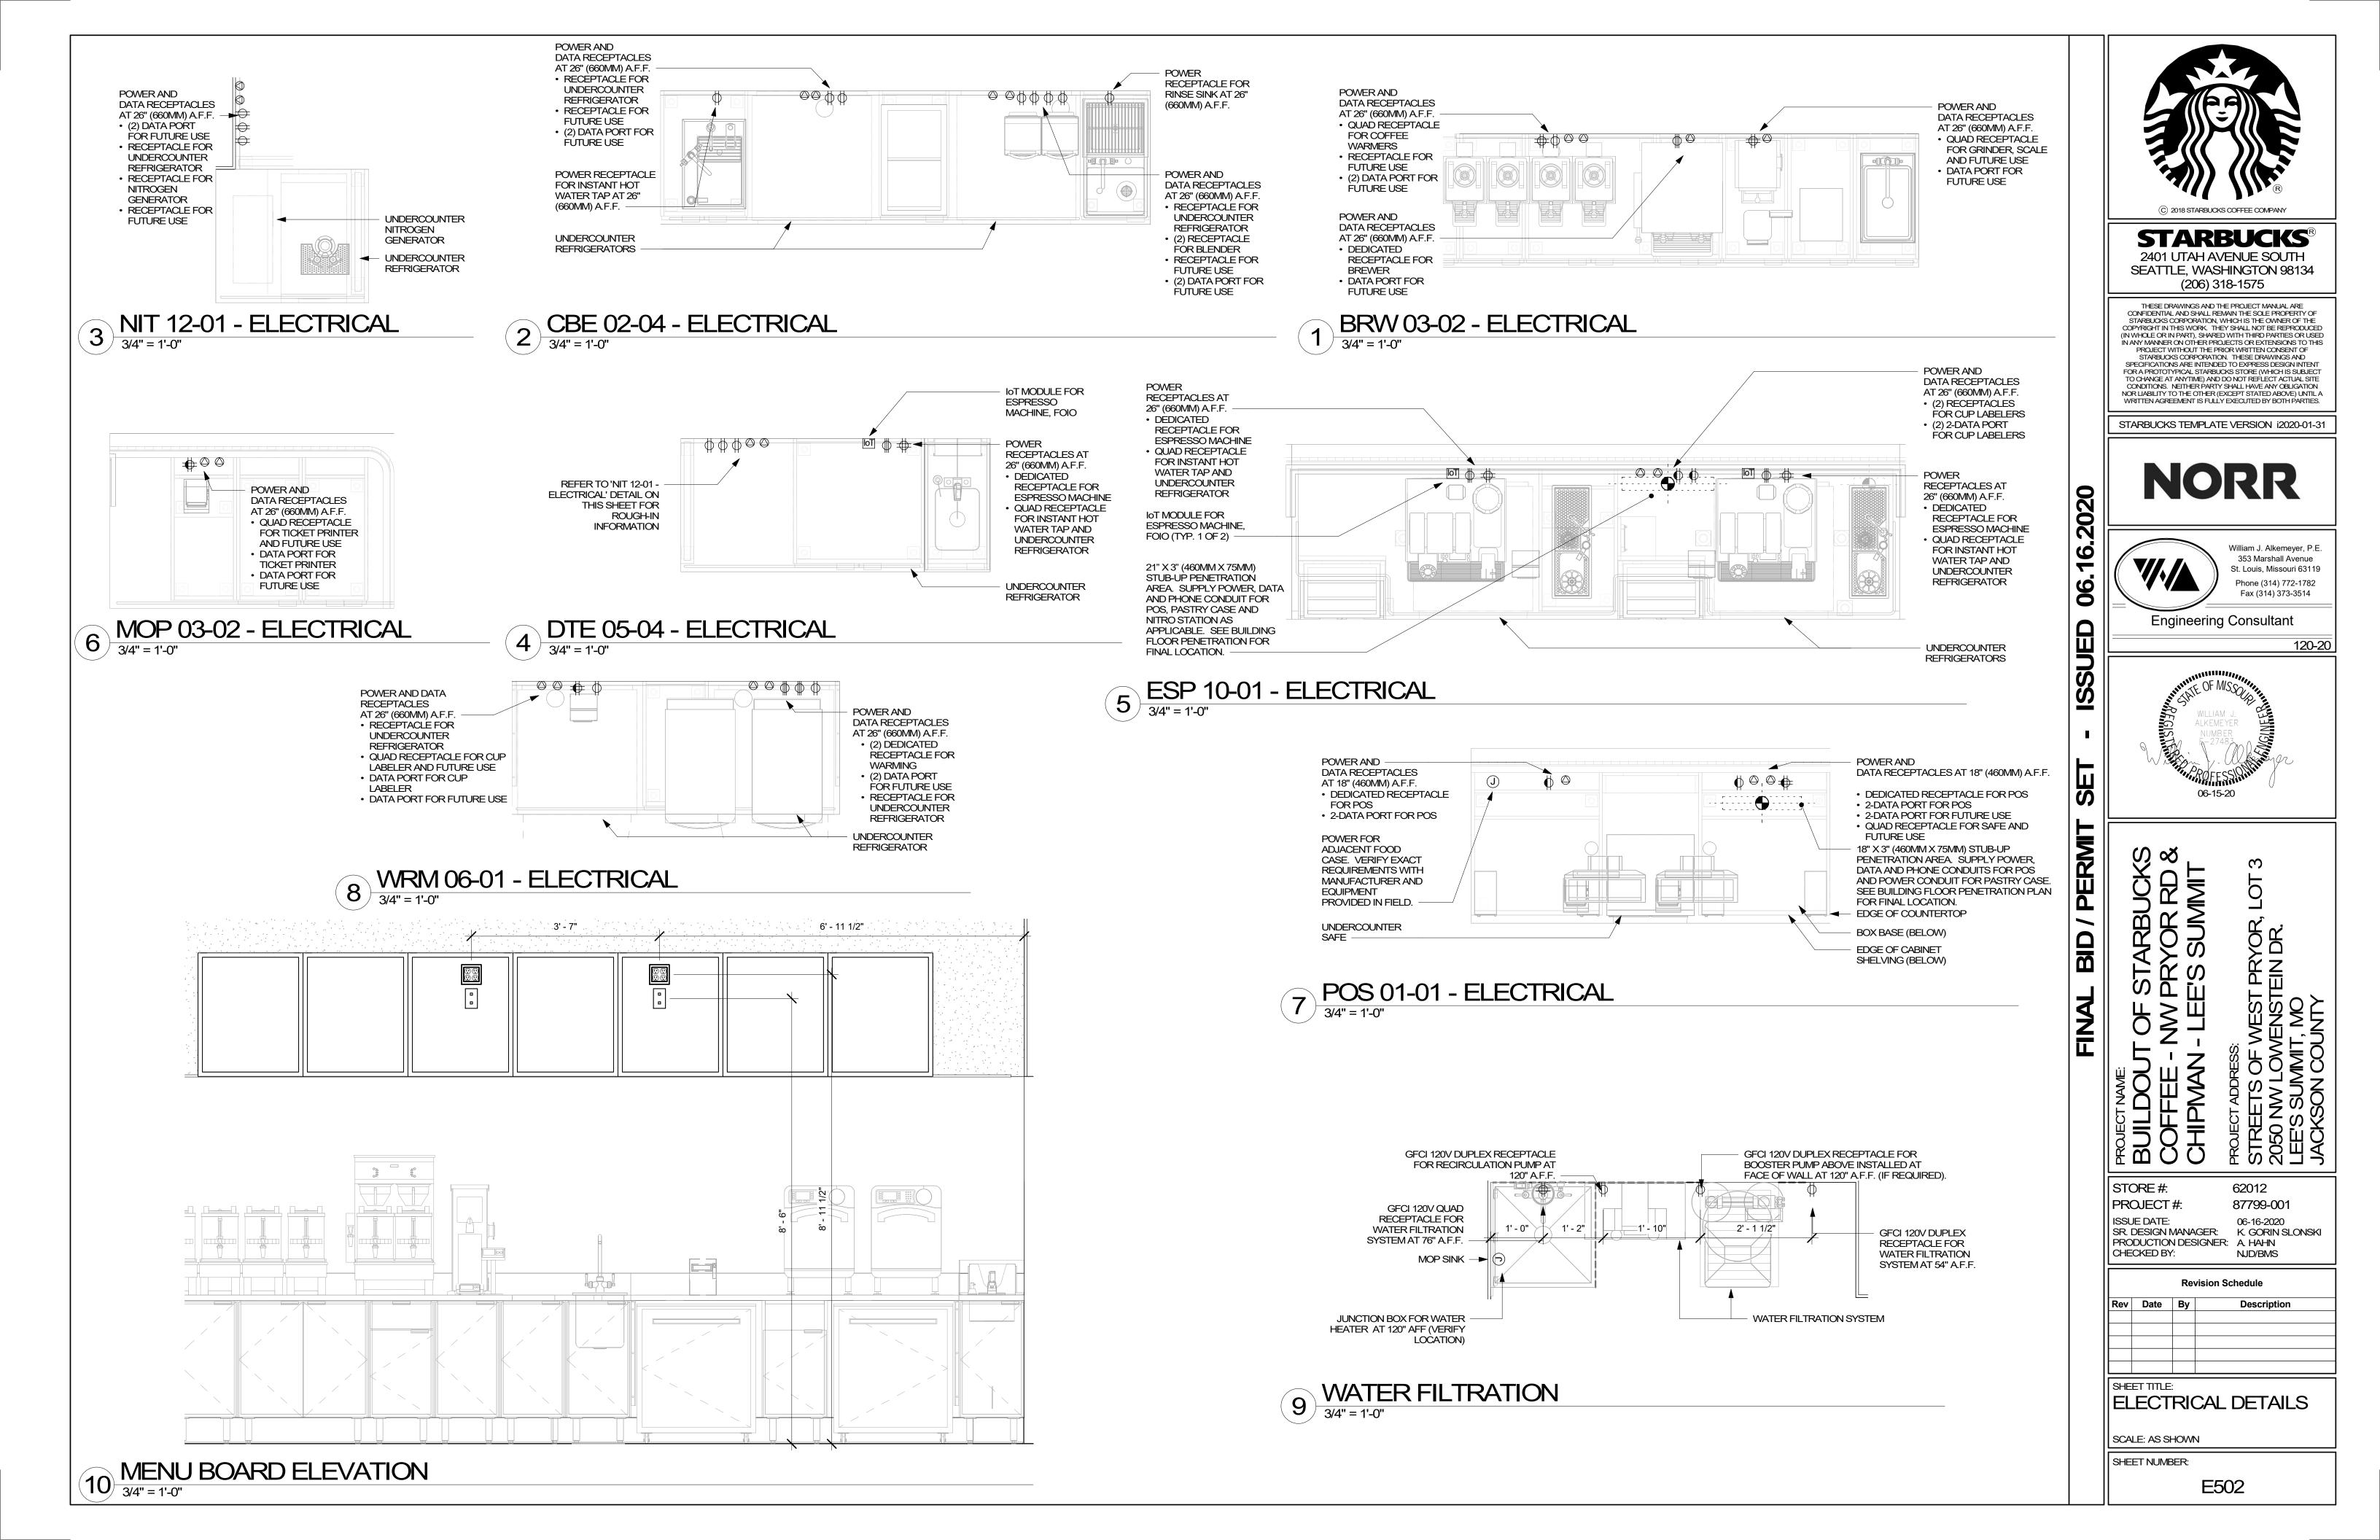

Panel: A

Mounting: Recessed Enclosure: Type 1 AIC Rating: By Landlord

Volts: 120/208 Wye Phases: 3 Wires: 4 Responsibility: Landlord

MCB Rating: 400A MLO Mains Type: CU Mains Rating: 400 A

	СКТ	Schedule Circuit Notes	Trip	Poles		4	I	3		С	Poles	Trip	Schedule Circuit Notes	СКТ	
Е	1	EF-1	20 A	1	528 VA	5536 VA								2	T
G	3	REACH-IN REFRIGERATOR	20 A	1			1344 VA	5536 VA			3	60 A	RTU-1	4	
Е	5	DRIVE-THRU WINDOW	20 A	1					600 VA	5536 VA				6	1
Е	7	PATIO STRING LIGHTS	20 A	1	180 VA	5536 VA								8	Ī
G	9	REACH-IN REFRIGERATOR/FREEZER	20 A	1			1164 VA	5536 VA			3	60 A	RTU-2	10	1
G	11	REACH-IN FREEZER	20 A	1					1152 VA	5536 VA				12	
G	13	PARTNER DESK	20 A	1	1560 VA	1080 VA					1	20 A	RECEPTACLES: EXTERIOR	14	
G	15	CUP LABELERS/PRINTER	20 A	1			960 VA	0 VA			1	20 A	SPARE	16	
G	17	U.C. REFRIGERATOR (X3)	20 A	1					1440 VA	3328 VA	2	40 A	HEATED AIR CURTAIN	18	
G	19	GRINDER/SCALE	20 A	1	1660 VA	3328 VA					2	40 A	HEATED AIR CORTAIN	20	
3	21	COFFEE WARMERS/FUTURE POWER	20 A	1			540 VA	2288 VA			2	30 A	TURBO CHEF	22	
3	23	INSTA-HOT/U.C. FRIG	20 A	1					1836 VA	2288 VA		30 A	TONDO CHEI	24	
3	25	NITRO SYSTEM	20 A	1	990 VA	2288 VA					2	30 A	TURBO CHEF	26	
3	27	FUTURE POWER/PITCHER RINSER	20 A	1			660 VA	2288 VA			2	30 A	TONDO CHEI	28	
G	29	BLENDER	20 A	1					1200 VA	4170 VA	2	50 A	DUEL BREWER	30	
3	31	BLENDER	20 A	1	1200 VA	4170 VA					2	30 A	BOLL BILLWEIX	32	
G	33	U.C. REFRIGERATOR (X2)	20 A	1			960 VA	2901 VA			2	40 A	ESPRESSO MACHINE	34	
3	35	INSTA-HOT WATER TAP	20 A	1					1301 VA	2901 VA	2	40 A	ESPINESSO IVIACI IIINE	36	
G	37	INSTA-HOT/U.C. FRIG	20 A	1	1836 VA	2901 VA					2	40 A	ESPRESSO MACHINE	38	
G	39	INSTA-HOT/U.C. FRIG	20 A	1			1836 VA	2901 VA				40 A	ESPRESSO WACHINE	40	
G	41	SAFE	20 A	1					360 VA	2901 VA	2	40.4	ESPRESSO MACHINE	42	
G	43	POS REGISTER	20 A	1	360 VA	2901 VA					2	40 A	ESPRESSO MACHINE	44	
G	45	POS REGISTER	20 A	1			360 VA	1799 VA			2	20 A	ICE MACHINE	46	
	47	FOOD CASE	20 A	2					708 VA	1799 VA		20 A	ICE MACHINE	48	
	49	FOOD CASE	20 A		708 VA	3172 VA					2	50 A	SANITIZING STATION	50	
G	51	SPARE	20 A	1			0 VA	3172 VA				50 A	SANTIZING STATION	52	
G	53	SPARE	20 A	1					0 VA	0 VA	1	20 A	SPARE	54	
	55				0 VA	0 VA					1	20 A	SPARE	56	
	57	SURGE PROTECTION	40 A	3			0 VA	0 VA			1	20 A	SPARE	58	
	59								0 VA	0 VA	1	20 A	SPARE	60	
			Tota	al Load:	4764	3 VA	4087	6 VA	4341	6 VA					

G = GFI - FURNISH AND INSTALL GFI BREAKERS AND DEDICATED NEUTRALS FOR THESE CIRCUITS TO PREVENT FALSE TRIPPING. EQUIPMENT AIC RATINGS SHALL EXCEED THE AVAILABLE FAULT CURRENT. CONTRACTOR SHALL VERIFY AVAILABLE FAULT CURRENT WITH UTILITY PRIOR TO CONSTRUCTION. SYSTEM SHALL BE SERIES RATED IF NECESSARY TO LIMIT SHORT CIRCUIT CURRENT TO BELOW 22,000 AIC (FOR GFI BREAKERS). COORDINATE WITH LANDLORD. E = E = EXISTING BY LANDLORD

341 A

365 A

Total Amps: 400 A

Load Classification	Connected Load	Demand Factor	Estimated Demand	Panel	Totals
HVAC	33745 VA	100.00%	33745 VA		
Kitchen Equipment - Non-Dwelling Unit	70210 VA	65.00%	45637 VA	Total Conn. Load:	131934 VA
Lighting - General	990 VA	125.00%	1238 VA	Total Est. Demand:	101280 VA
Power - General	2280 VA	100.00%	2280 VA	Total Conn.:	366 A
Receptacle	23340 VA	71.42%	16670 VA	Total Est. Demand:	281 A
Lighting	1369 VA	125.00%	1712 VA		

Panel: B

Mounting: Recessed Enclosure: Type 1 **AIC Rating:** By Landlord

Volts: 120/208 Wye Phases: 3 Wires: 4

Responsibility: Landlord

MCB Rating:	400A MLO
Mains Type:	CU
Mains Rating:	400 A

	CKT	Schedule Circuit Notes	Trip	Poles	,	4	E	3	(C P		Trip	Schedule Circuit Notes	CKT	
G	1	TIME CLOCK	20 A	1	120 VA	1308 VA					1	20 A	CAFE LIGHTING	2	G
G	3	BOH/RR LIGHTING	20 A	1			331 VA	720 VA			1	20 A	EXTERIOR SIGNS	4	G
G	5	DRIVE-THRU EQUIPMENT	20 A	1					720 VA	1080 VA	1	20 A	DRIVE-THRU EQUIPMENT	6	G
G	7	DRIVE-THRU EQUIPMENT	20 A	1	360 VA	600 VA					1	20 A	WATER HEATER	8	G
G	9	WATER FILTER SYSTEM	20 A	1			1440 VA	360 VA			1	20 A	RECIRC/BOOSER PUMP	10	G
G	11	RESTROOM FAUCT/SOAP DISPENSERS	20 A	1					720 VA	1440 VA	1	20 A	RESTROOM HAND DRYER	12	G
G	13	RESTROOM HAND DRYER	20 A	1	1440 VA	1481 VA					1	20 A	WATER FILLING STATION	14	G
G	15	BANQUETTE POWER	20 A	1			720 VA	1080 VA			1	20 A	CAFE CONVENIENCE RECEPTACLES	16	G
G	17	CAFE CONVENIENCE RECEPTACLES	20 A	1					1260 VA	540 VA	1	20 A	CAFE CONVENIENCE RECEPTACLES	18	G
G	19	SHOW WINDOW RECEPTACLES	20 A	1	360 VA	1080 VA					1	20 A	MANAGERS DESK POWER	20	G
G	21	MANAGERS DESK POWER	20 A	1			720 VA	360 VA			1	20 A	MANAGERS DESK POWER	22	G
G	23	MONUMENT SIGN	20 A	1					500 VA	100 VA	1	20 A	DRIVE-THRU DIRECTIONAL SIGN	24	G
G	25	DOS CONTROL BOX	20 A	1	600 VA	360 VA					1	20 A	MENU/PRE-MENU/CANOPY LIGHT	26	G
G	27	PANEL SERVICE RECEPTACLE	20 A	1			180 VA	720 VA			1	20 A	FUTURE DIGITAL MENU BOARD	28	G
G	29	SPARE	20 A	1					0 VA	0 VA	1	20 A	SPARE	30	G
G	31	SPARE	20 A	1	0 VA	0 VA					1	20 A	SPARE	32	G
G	33	SPARE	20 A	1			0 VA	0 VA			1	20 A	SPARE	34	G
G	35	SPARE	20 A	1					0 VA	0 VA	1	20 A	SPARE	36	G
G	37	SPARE	20 A	1	0 VA	0 VA					1	20 A	SPARE	38	G
G	39	SPARE	20 A	1			0 VA	0 VA			1	20 A	SPARE	40	G
	41								0 VA	0 VA				42	
	43				0 VA	0 VA								44	
	45						0 VA	0 VA						46	
	47								0 VA	0 VA				48	
	49				0 VA	0 VA								50	
	51						0 VA	0 VA						52	
	53								0 VA	0 VA				54	
	55				0 VA	0 VA								56	
	57						0 VA	0 VA						58	
	59								0 VA	0 VA				60	
			Tota	al Load:	7709	9 VA	663	1 VA	6360) VA					
			Tota	I Amps:	65	5 A	56	i A	53	S A					


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0444344			i dilei	Totals
2141 VA	90.00%	1927 VA		
990 VA	125.00%	1238 VA	Total Conn. Load:	20700 VA
1680 VA	100.00%	1680 VA	Total Est. Demand:	18816 VA
14520 VA	84.44%	12260 VA	Total Conn.:	57 A
1369 VA	125.00%	1712 VA	Total Est. Demand:	52 A
_	1680 VA 14520 VA	1680 VA 100.00% 14520 VA 84.44%	1680 VA 100.00% 1680 VA 14520 VA 84.44% 12260 VA	1680 VA 100.00% 1680 VA Total Est. Demand: 14520 VA 84.44% 12260 VA Total Conn.:

	WIRE SIZING	G SCHEDUL	E		
BREAKER	WIRE SIZE	GROUND	CONDUIT		
20A-1P	(2) #12	#12	3/4"		
20A-2P	(3) #12	#12	3/4"		
20A-3P	(4) #12	#12	3/4"		
30A-1P	(2) #10	#10	3/4"		
30A-2P	(3) #10	#10	3/4"		
30A-3P	(4) #10	#10	3/4"		
40A-2P	(3) #8	#10	3/4"		
40A-3P	(4) #8	#10	1"		
50A-2P	(3) #6	#10	1"		
50A-3P	(4) #6	#10	1"		
60A-2P	(3) #4	#10	1"		
60A-3P	(4) #4	#10	1-1/4"		
70A-3P	(4) #4	#8	1-1/4"		
80A-3P	(4) #3	#8	1-1/4"		
90A-3P	(4) #2	#8	1-1/4"		
100A-3P	(4) #2	#8	1-1/4"		
125A-3P	(4) #1	#6	1-1/2"		
150A-3P	(4) #1/o	#6	2"		
200A-3P	(4) #3/o	#6	2"		

| 200A-3P | (4)#3/o | #6 | 2" CONTRACTOR TO PROVIDE AND INSTALL SURGE PROTECTOR CLOSE TO PANELBOARD AND CONNECT USING THE SHORTEST RUN



ONE-LINE DIAGRAM

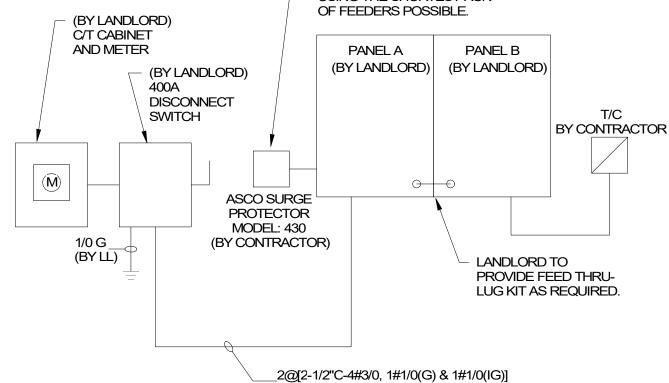ONE-LINE NOTES: LANDLORD TO PROVIDE NEW 400A, 120/208V-3PH ELECTRICAL SERVICE TO SPACE INCLUDING INSTALLATION OF ANY REQUIRED CT'S AND METERING AND DISCONNECT IN SPACE. LANDLORD SHALL ALSO PROVIDE, INSTALL AND CONNECT ELECTRICAL SERVICE TO, TWO (2) 400 AMP RATED ELECTRICAL PANELS.

(BY LANDLORD)

WIRE AND CONDUIT SIZES SHOWN ARE FOR COPPER CONDUCTORS WITH 75°C RATED INSULATION. LANDLORD CONTRACTOR TO PROVIDE PROPERLY SIZED CONDUIT & WIRE TO COMPENSATE FOR ALUMINUM FEEDERS OR VOLTAGE DROP AS REQUIRED.

CONTRACTOR IS RESPONSIBLE FOR, BUT NOT LIMITED TO, ALL WORK DOWNSTREAM OF LANDLORD PROVIDED ELECTRICAL PANELS.

ALL WORK SHALL BE IN ACCORDANCE WITH UTILITY COMPANY REQUIREMENTS AND LOCAL CODE. CONTRACTOR BID SHALL INCLUDE ALL WORK NECESSARY FOR A FULLY OPERATIONAL

LANDLORD SHALL CONTACT THE ELECTRIC UTILITY CO. TO VERIFY ALL DETAILS OF NEW SERVICE IF EXISTING BUILDING ELECTRICAL SERVICE IS NOT ADEQUATE AND IS RESPONSIBLE

CONTRACTOR IS RESPONSIBLE FOR A COMPLETE AND OPERATIONAL SYSTEM IN COMPLIANCE WITH NEC AND ALL STATE AND LOCAL CODES.




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STARBUCKS TEMPLATE VERSION i2020-01-31





2020

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Phone (314) 772-1782 Fax (314) 373-3514
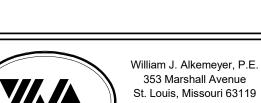
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Engineering Consultant

06-15-20

OFFEE

62012

STORE #: PROJECT#: ISSUE DATE:

87799-001 06-16-2020 SR. DESIGN MANAGER: K. GORIN SLONSKI PRODUCTION DESIGNER: A. HAHN CHECKED BY: NJD/BMS

Revision Schedule

Rev Date By Description

SHEET TITLE: ELECTRICAL PANEL SCHEDULES

SCALE: AS SHOWN SHEET NUMBER:

CONTRACTOR IN LOCAL	T DESCRIPTION	FURN.	BY INST. BY	COMMENTS	DESIGN ID		DESCRIPTION F	URN. BY INST	г. вү	COMMENTS	DESIGN ID	COUNT	DESCRIPTION		FURN. BY	INST. BY
OOLING 10267 5	FRIDGE UNDERCOUNTER 1 DOOR - 27IN 685MM	SB	GC		AUDIO VISU 10005	AL 1	MUSIC SYSTEM SE		G	C TO INSTALL AND TEST SYSTEM	FAN 10894	1	FAN - DT AIR CURTAIN WITH HEATER -	- 48IN L	L	LL
10970 1	FRIDGE REACH IN 1 DOOR LH - 29IN 735MM	SB	GC		10010 10012	1	DT ORDER MONITOR SE DT COMMUNICATION SYSTEM SE	SB SB			X0003	1	FAN - WALL MOUNTED FAN - PATIO		GC .	GC
11083 2	FRIDGE REACH IN 2 DOOR - 51X35IN 1295X890MM FRIDGE UNDERCOUNTER 1 DOOR WITH	SB	GC GC		10015 10017	3 2	SPEAKER RECESSED - WHITE SE SPEAKER SURFACE MOUNTED - BLACK SE	GC GC				I I	TAN-WALL MOUNTED TAN-TATIO			
12618 2 13676 1	SHELF - 27IN 685MM FREEZER REACH IN 1 DOOR RH - 27IN 685M		GC		12336 14676	1 1	DT TIMER SYSTEM SE DT POS MONITOR ARM DOUBLE SURFACE SE	3			OTHER 17797	1	ENERGY MANAGEMENT SYSTEM - HVA	AC S	SR.	GC
13682 1	FREEZER REACH IN 2 DOOR - 54IN 1370MM		GC	WIT INOUTINES LINDEDOOUNTED EDIDOE	19339	1	MOUNTED AMPLIFIER - 40W SB	B SB	G	C TO INSTALL AND TEST SYSTEM	X0028	3	ONLY ACCESS PANELS		GC	GC
20011 1	FRIDGE NITRO 2 TAP JT NITCOM RH	SB	GC	KIT INCLUDES UNDERCOUNTER FRIDGE, FONT, TRAY, AND TUBING	DATA 10002	1	COMPUTER MANAGER WORKSTATION SE	B SB			1 7,0020		, toolog i / titleg			
QUIPMENT 10312 4	BREWER SOFT HEAT WARMING STAND SINGLE	SB	GC		10007 18744	1	PRINTER MANAGER WORKSTATION SE EQUIPMENT RACK WITH LOCK - 24IN 610MM SE	SB SB								
10746 1	BREWER DUAL SOFT HEAT	SB	GC	GC TO COORDINATE WITH SBUX VENDOR.	20294 POINT OF S	2 Al F	IOT MODULE SB							SITE	SCHEDUL	.E - "Y"
10808 1 10856 6	GRINDER DITTING KR1203 BREWER SERVER SOFT HEAT	SB SB	GC GC	GC TO COORDINATE WITH SBUX VENDOR.	10008	2	POS - REGISTER WITH COMPACT CASH DRAWER	3 SB	G	C TO COORDINATE WITH SBUX VENDOR.	DESIGN ID		DESCRIPTION F	URN. BY	INST. BY	
12407 2 12508 2	OVEN TURBOCHEF NEXT GENERATION BLENDER QUIET MODEL ON COUNTER	SB SB	GC GC		10014 10022	4	POS PRINTER SE MONEY COUNTER SE			C TO COORDINATE WITH SBUX VENDOR. C TO COORDINATE WITH SBUX VENDOR	EXTERIOR N	MENU 1	MENU BOARD - DT DIGITAL ORDER SE	3	SB/GC	SUPPLIER:
12508 1	BLENDER QUIET MODEL ON COUNTER - BACK-UP	SB	GC	TO BE STORED IN BACK OF HOUSE UNLESS NEEDED	10029	6	POS BANK SE	GC GC			11110		SCREEN - FLAT BLACK MT0028	_		REGIONAL & STUB-UP
15186 1 16623 1	DISHWASHER HOT LOW STEAM SCALE DIGITAL WITH ADJUSTABLE DISPLAY	SB 'SB	GC GC		10075 14677	1	CUP LABELER SE POS - DT TENDERING REGISTER SE		P/	C TO COORDINATE WITH SBUX VENDOR. ART OF RETAIL IT EQUIPMENT PACKAGE.	14119	1	MENU BOARD - DT 5 PANEL FREESTANDING - 108X65IN 2745X1650MM - FLAT BLACK	3	SB	SUPPLIER: VENDOR. L LLWL.
17564 1	MOUNT SMALL BLENDER PITCHER RINSER WITH SENSOR	SB	GC		14678 SECURITY	1	POS - DT EXPEDITOR SE			ART OF RETAIL IT EQUIPMENT PACKAGE.	14120	1	MT0028 MENU BOARD - DT PRE MENU SE	3	SB	PROVIDED
19559 1	NITROGEN GENERATOR ELEMENT	SB	GC	GC TO COORDINATE INSTALLATION & CONNECTIONS WITH SBUX VENDOR	10024	1	SAFE LH - 20X18X26IN 510X455X660MM SB	GC GC	M	C TO COORDINATE WITH SBUX VENDOR; STORE ANAGER TO PROGRAM WITH VENDOR PROVIDED	14120	I I	FREESTANDING - 36X65IN 915X1650MM - FLAT BLACK MT0028		OD	PROVIDE F
19742 2 OD CASE	ESPRESSO MACHINE MASTRENA II	SB	GC	GC TO COORDINATE WITH SBUX VENDOR.	10028	1	SAFE BASE SB	GC GC	G	ANUAL. C TO COORDINATE WITH SBUX VENDOR; STORE	15700	1	MENU BOARD - DT DIGITAL ORDER SE SCREEN CONTROL BOX	3	SB/GC	SUPPLIER: SIGNAGE \
16238 1	FOOD CASE - ZEPHYR - 66IN 1675MM	SB	GC							IANAGER TO PROGRAM WITH VENDOR PROVIDED IANUAL.	OTHER					FOOTING,
0344 1 8029 1	ICE - BIN DROP IN 90LB 40KG	SB SB	GC GC				PLUMBING FIXTU	IRE SCHEDULE	- "P"		14103	11	BOLLARD NONILLUMINATED LL SQUARE - FLAT BLACK MT0028	-	LL	SUPPLIER/
8846 1	ICE - MACHINE CIM1446HR SERIES REMOTE COOLED		GC		DESIGN ID	COUNT	DESCRIPTION	FURN. BY	INST. B	COMMENTS	14163	1	DT ORDER POINT CANOPY SE FREESTANDING - FLAT BLACK	3	SB	SUPPLIER: VENDOR. L
19278 2	ICE - BIN DROP IN 45LB 20KG HORIZONTAL	SB	GC		DRAIN 10294	7	DRAIN - FLOOR SINK SQUARE - 12IN 305MM	SB (GC	ZURN MODEL #FD2375-NH3.	18818	4	MT0028 LIGHT POLE - 10FT 300CM - FLAT LL	_	LL	ANCHOR B
HER 10091 1	CUP DISPENSER TALL HOT VERTICAL	SB	GC		10594 10726	4 7	DRAIN - FLOOR SINK SQUARE - 5IN 125MM DRAIN - GRATE HALF SQUARE - 12IN 305MM		GC GC	JAY R. SMITH MODEL #2005Y (B) OR EQUAL ZURN MODEL #FD2375-NH2.	18820	4	BLACK MT0028 LIGHT POLE BASE PLATE - FLAT LL	_	LL	
10099 2 10172 2	RESTROOM TOILET PAPER HOLDER RESTROOM SEAT COVER DISPENSER	SB SB	GC GC		FAUCET 10152	1	FAUCET - DOUBLE LABORATORY WITH BENT		GC		X0001	2	BLACK MT0028 VEHICLE DETECTOR LOOP SE	3	GC/LL	SUPPLIER:
10384 2 10396 1	DIAPER CHANGING STATION HORIZONTAL CUP DISPENSER SHORT HOT VERTICAL	SB SB	GC GC		10153	2	RISER SPOUT FAUCET - WATER TOWER - 12IN 305MM		GC		X0004	5	PLANTER BOXES - 84X36X18IN LL	-	LL	CONDUIT F
10467 1 10501 1	FILE CABINET 2 DRAWER FIRE EXTINGUISHER	SB GC	GC GC	LOCALLY SOURCED	10215	3	FAUCET - DOUBLE LABORATORY WITH SWING SPOUT		GC		X0008	1	BIKE RACK - OLYMPIA LL	_	LL	REQUIREM FORMS & S
10769 2	RESTROOM GRAB BAR VERTICAL - 18IN 455MM	SB	GC		10447 10597	1	FAUCET - PRE RINSE SPRAYER WALL MOUNTED FAUCET - SINGLE HANDLE		GC GC							WWW.FOR RECOMME
10791 2	CUP DISPENSER GRANDE VENTI COLD VERTICAL	SB	GC		10804 10874	1	FAUCET - PRE RINSE SWING SPOUT FAUCET - HOT WATER DISPENSER GOOSENECK	SB (GC GC		X0009	20	NATIVE PLANTS FOR PLANTER BOXES	-	LL	LANDSCAP PROVIDE D MAINTENA
10855 2	CUP DISPENSER GRANDE VENTI HOT VERTICAL	SB	GC		10922	1	FAUCET - MOP SINK WALL MOUNTED	SB (GC		UMBRELLA			_		
0858 1 0859 2	CUP DISPENSER TALL COLD VERTICAL RESTROOM GRAB BAR - 48IN 1220MM	SB SB	GC GC		11003 13588	1	FAUCET - METERED FAUCET - HAND SINK WALL MOUNTED	SB (GC GC		12147	3	UMBRELLA - BASE 95LB 43KG - SE FLAT BLACK MT0028		GC	
0862 2 0947 1	RESTROOM GRAB BAR - 36IN 915MM SOAP DISPENSER WALL MOUNTED	SB SB	GC GC		15749 X0010	2	FAUCET - HOT AND COLD WATER SYSTEM FAUCET - STERN		GC GC	STERN. CONDOR 1010. PART #07100005.	20075	3	UMBRELLA - WITHOUT VALANCE - SE 6FT 183CM - BLACK CANVAS WITH	3	GC	
0977 1	PAPER TOWEL DISPENSER FULL SIZE -					_	FAUCET - STERN	GC	GC							T.
10977	TRANSLUCENT GRAY	SB	GC			_	FAUCET - STERN	GC C	GC	CHROME. PART OF D 13 INTEGRATED SINK SYSTEM. CONTACT: D 13 GROUP. 245 WEST			WORDMARK F0061			
	TRANSLUCENT GRAY PAPER TOWEL DISPENSER HALF SIZE - TRANSLUCENT GRAY	SB SB	GC		EN TED	_	PAUCET - STERN	GC (GC	CHROME. PART OF D 13 INTEGRATED SINK						
10992 2 111115 2	TRANSLUCENT GRAY PAPER TOWEL DISPENSER HALF SIZE - TRANSLUCENT GRAY SOAP DISPENSER SINK MOUNTED	SB SB	GC GC		FILTER 12501	1	FILTER - RO SYSTEM 600GPD		SB	CHROME. PART OF D 13 INTEGRATED SINK SYSTEM. CONTACT: D 13 GROUP. 245 WEST CENTRAL STREET, NATICK, MA 01760. PH: 617-307-1140. WWW.D13GROUP.COM CONFIGURATION [III]. GC TO COORDINATE			WORDMARK F0061	IGHTING F	IXTURE SO	HEDULE - '
0992 2 1115 2 3330 1 3584 1	TRANSLUCENT GRAY PAPER TOWEL DISPENSER HALF SIZE - TRANSLUCENT GRAY SOAP DISPENSER SINK MOUNTED MOBILE CUP DISPENSER CADDY CUP DISPENSER TRENTA COLD VERTICAL	SB SB SB SB	GC GC GC			1		SB S		CHROME. PART OF D 13 INTEGRATED SINK SYSTEM. CONTACT: D 13 GROUP. 245 WEST CENTRAL STREET, NATICK, MA 01760. PH: 617-307-1140. WWW.D13GROUP.COM CONFIGURATION [III]. GC TO COORDINATE WITH SBUX VENDOR. CONFIGURATION [III]. GC TO COORDINATE	DESIGN ID EXIT	COUNT	WORDMARK F0061		INST. BY	
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0992 2 1115 2 3330 1 3584 1 9495 1 0079 1 0080 1 0081 2 0009 2	TRANSLUCENT GRAY PAPER TOWEL DISPENSER HALF SIZE - TRANSLUCENT GRAY SOAP DISPENSER SINK MOUNTED MOBILE CUP DISPENSER CADDY CUP DISPENSER TRENTA COLD VERTICAL NITRO 2 TAP HANDLE AND BADGE KIT NITRO 2 TAP BADGE MOUNT BACKBAR LH NITRO 2 TAP BADGE MOUNT BACKBAR RH SHARPS CONTAINER HAND DRYER - INTEGRATED	SB SB SB SB SB SB SB SB GC	GC GC GC GC GC GC GC	SENSOR OPERATED. SURFACE MOUNTED. CONTACT: D 13 GROUP. 245 WEST CENTRAL STREET, NATICK, MA 01760. PH: 617-307-1140. WWW.D13GROUP.COM STERN. GREEN/CHROME SOAP DISPENSER. PART #07100008. PART OF D 13 INTEGRATED SINK SYSTEM.	12501 12507 12896 12899 13076 13082 13149	1 1 1 2 1 1	FILTER - RO SYSTEM 600GPD FILTER - RO SYSTEM 40GAL STORAGE TANK FILTER - BRINE TANK FILTER - POLY GLASS VESSEL FILTER - PREFILTRATION SYSTEM FILTER - WATER SOFTENER TWIN	SB	SB SB SB SB SB SB	CHROME. PART OF D 13 INTEGRATED SINK SYSTEM. CONTACT: D 13 GROUP. 245 WEST CENTRAL STREET, NATICK, MA 01760. PH: 617-307-1140. WWW.D13GROUP.COM CONFIGURATION [III]. GC TO COORDINATE WITH SBUX VENDOR.	EXIT 11483 19044 19057 OTHER 17796 RECESSED	1 5 4 7 CAN	DESCRIPTION EXIT - SECURITY LIGHT WALL MOUNTED LED EXIT SIGN WITH EMERGENCY LIGHT - WHITE AND RED LED EMERGENCY LIGHT DOUBLE - BLACK LED STRING LIGHTS - 48FT 1463CM CAN - LED MOUNTING FRAME - 2IN 50MM - NEW CEILING CAN - LED ADJUSTABLE GIMBAL WITH DRIVER - 2IN 50MM - WHITE -	FURN. BY LL SB SB	LL GC GC	HID 150W (
9992 2 115 2 1330 1 1584 1 1495 1 1079 1 1080 1 1081 2 10009 2	TRANSLUCENT GRAY PAPER TOWEL DISPENSER HALF SIZE - TRANSLUCENT GRAY SOAP DISPENSER SINK MOUNTED MOBILE CUP DISPENSER CADDY CUP DISPENSER TRENTA COLD VERTICAL NITRO 2 TAP HANDLE AND BADGE KIT NITRO 2 TAP BADGE MOUNT BACKBAR LH NITRO 2 TAP BADGE MOUNT BACKBAR RH SHARPS CONTAINER HAND DRYER - INTEGRATED WIRE SHELF GRID AT SINK	SB SB SB SB SB SB SB GC GC	GC GC GC GC GC GC GC GC	SENSOR OPERATED. SURFACE MOUNTED. CONTACT: D 13 GROUP. 245 WEST CENTRAL STREET, NATICK, MA 01760. PH: 617-307-1140. WWW.D13GROUP.COM STERN. GREEN/CHROME SOAP DISPENSER. PART #07100008. PART OF D 13 INTEGRATED SINK SYSTEM. CONTACT: D 13 GROUP. 245 WEST CENTRAL STREET, NATICK, MA 01760. PH:	12501 12507 12896 12899 13076 13082 13149 OTHER	1 1 2 1 1	FILTER - RO SYSTEM 600GPD FILTER - RO SYSTEM 40GAL STORAGE TANK FILTER - BRINE TANK FILTER - POLY GLASS VESSEL FILTER - PREFILTRATION SYSTEM FILTER - WATER SOFTENER TWIN FILTER - PRESSURE GAUGE	SB	SB SB SB SB SB SB SB	CHROME. PART OF D 13 INTEGRATED SINK SYSTEM. CONTACT: D 13 GROUP. 245 WEST CENTRAL STREET, NATICK, MA 01760. PH: 617-307-1140. WWW.D13GROUP.COM CONFIGURATION [III]. GC TO COORDINATE WITH SBUX VENDOR.	EXIT 11483 19044 19057 OTHER 17796 RECESSED 19023	1 5 4 7 CAN 32	WORDMARK F0061 LI DESCRIPTION EXIT - SECURITY LIGHT WALL MOUNTED LED EXIT SIGN WITH EMERGENCY LIGHT - WHITE AND RED LED EMERGENCY LIGHT DOUBLE - BLACK LED STRING LIGHTS - 48FT 1463CM CAN - LED MOUNTING FRAME - 2IN 50MM - NEW CEILING CAN - LED ADJUSTABLE GIMBAL WITH DRIVER - 2IN 50MM - WHITE - 1000LM NFL CAN - LED DOWNLIGHT REFLECTOR SE	FURN. BY LL SB SB SB SB SB	LL GC GC GC	HID 150W (
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WWW.D13GROUP.COM	EXIT 11483 19044 19057 OTHER 17796 RECESSED 19023 19113 19120 SCONCE 20711 20750 SIGNAGE - 0 21163 X0030 STRIP 14410 TRACK 12934 12944 12945 15059 19071 19072	1 5 4 7 CAN 32 28 4 6 2 OTHER 1 1 1 2 3 5 1 4 4 14	DESCRIPTION EXIT - SECURITY LIGHT WALL MOUNTED LED EXIT SIGN WITH EMERGENCY LIGHT - WHITE AND RED LED EMERGENCY LIGHT DOUBLE - BLACK LED STRING LIGHTS - 48FT 1463CM CAN - LED MOUNTING FRAME - 2IN 50MM - NEW CEILING CAN - LED ADJUSTABLE GIMBAL WITH DRIVER - 2IN 50MM - WHITE - 1000LM NFL CAN - LED DOWNLIGHT REFLECTOR WITH DRIVER SQUARE - 2IN 50MM - WHITE - 1000LM FLOOD SCONCE - HINKLEY ATLANTIS LARGE - BLACK SCONCE - KUZCO PLUTO TRIPLE - VINTAGE BRASS SIGN - MOBILE ORDER PICK UP ILLUMINATED BLADE MOUNT SIGN - MOBILE ORDER PICK UP SIGN EXTENSION LEGS STRIP - LED TAPE - VARIABLE LENGTH TRACK - WITH CONNECTORS - 4FT 122CM - WHITE - 1 CIRCUIT TRACK - WITH CONNECTORS - 16FT 488CM - WHITE - 1 CIRCUIT TRACK - WITH CONNECTORS - 16FT 488CM - WHITE - 1 CIRCUIT TRACK - WITH CONNECTORS - 16FT 488CM - WHITE - 1 CIRCUIT TRACK - WITH CONNECTORS - 16FT 183CM - WHITE - 1 CIRCUIT TRACK - WITH CONNECTORS - 6FT 183CM - WHITE - 1 CIRCUIT TRACK - WITH CONNECTORS - 6FT 183CM - WHITE - 1 CIRCUIT TRACK - WITH CONNECTORS - 6FT 183CM - WHITE - 1 CIRCUIT TRACK - WITH CONNECTORS - 6FT 183CM - WHITE - 1 CIRCUIT TRACK - WITH CONNECTORS - 6FT 183CM - WHITE - 1 CIRCUIT TRACK - WITH CONNECTORS - 6FT 183CM - WHITE - 1 CIRCUIT TRACK - WITH CONNECTORS - 12FT 365CM - WHITE - 1 CIRCUIT TRACK - WITH CONNECTORS - 12FT 365CM - WHITE - 1 CIRCUIT TRACK - WITH CONNECTORS - 12FT 365CM - WHITE - 1 CIRCUIT TRACK - WITH CONNECTORS - 12FT 365CM - WHITE - 1 CIRCUIT TRACK - WITH CONNECTORS - 12FT 365CM - WHITE - 1 CIRCUIT TRACK - WITH CONNECTORS - 10FT 37CM - WHITE - 1 CIRCUIT TRACK - WITH CONNECTORS - 10FT 37CM - WHITE - 1 CIRCUIT TRACK - WITH CONNECTORS - 10FT 37CM - WHITE - 1 CIRCUIT TRACK - WITH CONNECTORS - 10FT 37CM - WHITE - 1 CIRCUIT TRACK - WITH CONNECTORS - 10FT 37CM - WHITE - 1 CIRCUIT TRACK - WITH CONNECTORS - 21N 50MM - WHITE - 600LM FLOOD	FURN. 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0992 2 1115 2 3330 1 3584 1 9495 1 0079 1 0080 1 0081 2 0009 2 0011 2 0011 2 0022 2 0416 9 0462 9 0462 9 0462 9 0698 1 3834 1 5699 1 7255 1 7264 1 7639 1 9476 2	TRANSLUCENT GRAY PAPER TOWEL DISPENSER HALF SIZE - TRANSLUCENT GRAY SOAP DISPENSER SINK MOUNTED MOBILE CUP DISPENSER CADDY CUP DISPENSER TRENTA COLD VERTICAL NITRO 2 TAP HANDLE AND BADGE KIT NITRO 2 TAP BADGE MOUNT BACKBAR LH NITRO 2 TAP BADGE MOUNT BACKBAR RH SHARPS CONTAINER HAND DRYER - INTEGRATED WIRE SHELF GRID AT SINK WORKROOM SHELVING - 36IN 915MM WORKROOM SHELVING POSTS MOP RACK WITH 3 HOLDERS BASE - 24X18IN 610X455MM PARTNER WORK CENTER PASTRY TRAY CART - 60IN 1525MM ROLLING PASTRY TRAY THAW RACK - 20X26IN 510X660MM WORKROOM CART - 24IN 610MM 5 COMP LOCKER - 12IN 305MM EXTERIOR SIGNA COUNT DESCRIPTION FU 1 SIGN - DISK SF ILLUMINATED FLUSH MOUNTED EVOLVED - 60IN 1525MM COUNT SIGN - DT DIRECTIONAL EXIT SIGN ILLUMINATED ARROW SERIES - 46IN 1170MM 1 SIGN - DT CLEARANCE BAR ARROW SERIES FREESTANDING 2 SIGN - 10 MINUTE PARKING SB	SB SB SB SB SB SB SB SB SB SC	GC GC GC GC GC GC GC GC	SENSOR OPERATED. SURFACE MOUNTED. CONTACT: D 13 GROUP. 245 WEST CENTRAL STREET, NATICK, MA 01760. PH: 617-307-1140. WWW.D13GROUP.COM STERN. GREEN/CHROME SOAP DISPENSER. PART #07100008. PART OF D 13 INTEGRATED SINK SYSTEM. CONTACT: D 13 GROUP. 245 WEST CENTRAL STREET, NATICK, MA 01760. PH: 617-307-1140. WWW.D13GROUP.COM LL TO PROVIDE BLOCKING AND CONDUIT AS REQUIRED LL TO FURNISH AND INSTALL CONCRETE FOOTINGS, ANCHOR BOLTS, AND ELECTRICAL CONDUIT PER LLWL. GC TO COORDINATE WITH SBUX VENDOR LL TO FURNISH AND INSTALL CONCRETE FOOTINGS AND ANCHOR BOLTS PER LLWL. GC TO COORDINATE WITH SBUX VENDOR FOOTING & POST BY LL. SIGN BY SBUX SIGNAGE VENDOR BASE SIGN FOOTING AND ELECTRICAL BY	12501 12507 12896 12899 13076 13082 13149 OTHER 13384 SINK 10549 10995 12807 13264 14688 17565 17632 18743 19277 X0012 TOILET 12951 13040	ONSI GENE	FILTER - RO SYSTEM 600GPD FILTER - RO SYSTEM 40GAL STORAGE TANK FILTER - BRINE TANK FILTER - PREFILTRATION SYSTEM FILTER - PREFILTRATION SYSTEM FILTER - WATER SOFTENER TWIN FILTER - PRESSURE GAUGE WATER HEATER TANK GAS SINK - RINSE DROP IN SST - 12X20IN 305X510MM SINK - MOP - 24X24IN 610X610MM SINK - UTENSIL RINSE WITH GRATE SST - LH - 14X20IN 355X510MM SINK - BAND WITH SIDE SPLASH WALL MOUNTER SST SINK - RINSE WITH DRAINBOARD - 15X27IN 380X685MM SINK - STACKED DRAINBOARD - 15IN 380MM SINK - WATER FILLING STATION - 36X24IN 915X610MM SINK - COUNTERTOP RINSER WITH DRAIN TROUGH - 26X9IN 660X235MM SINK - D13 TOILET - TANKLESS EFFICIENT SINGLE FLUSH TOILET - FLUSH VALVE AUTOMATIC EFFICIENT SINGLE FLUSH TOILET - FLUSH VALVE AUTOMATIC EFFICIENT SINGLE FLUSH BILITY LEGEND RAL CONTRACTOR	SB	SB SB SB SB SB SC GC	CHROME. PART OF D 13 INTEGRATED SINK SYSTEM. CONTACT: D 13 GROUP. 245 WEST CENTRAL STREET, NATICK, MA 01760. PH: 617-307-1140. WWW.D13GROUP.COM CONFIGURATION [III]. GC TO COORDINATE WITH SBUX VENDOR. AO SMITH CYCLONE XI MODEL #BTX-100, 129 GPH RECOVERY @90 DEGREE RISE. SET WATER HEATER TO 140 DEG MAX. ENERGY FACTOR = 0.96 D 13 INTEGRATED SINK SYSTEM. 30IN XLERATORSYNC SYSTEM WITH A SINGLE BASIN SINK WITH A PIVOT DRAIN COVER. GLACIER WHITE CORIAN COUNTER TOP AND ENCLOSURE PANELS. BASIN COLOR: D 13 WHITE. ORDER WITH LOCKING SLIDING DOOR & SECURITY PANEL. CONTACT: D 13 GROUP. 245 WEST CENTRAL STREET, NATICK, MA 01760. PH: 617-307-1140. WWW.D13GROUP.COM	EXIT 11483 19044 19057 OTHER 17796 RECESSED 19023 19113 19120 SCONCE 20711 20750 SIGNAGE - 0 21163 X0030 STRIP 14410 TRACK 12934 12944 12945 15059 19071 19072 19074	1 5 4 7 CAN 32 28 4 4 6 2 OTHER 1 1 1 2 3 5 1 4 14 35	DESCRIPTION EXIT - SECURITY LIGHT WALL MOUNTED LED EXIT SIGN WITH EMERGENCY LIGHT - WHITE AND RED LED EMERGENCY LIGHT DOUBLE - BLACK LED STRING LIGHTS - 48FT 1463CM CAN - LED MOUNTING FRAME - 2IN 50MM - NEW CEILING CAN - LED ADJUSTABLE GIMBAL WITH DRIVER - 2IN 50MM - WHITE - 1000LM NFL CAN - LED DOWNLIGHT REFLECTOR S WITH DRIVER SQUARE - 2IN 50MM - WHITE - 1000LM FLOOD SCONCE - HINKLEY ATLANTIS LARGE - BLACK SCONCE - KUZCO PLUTO TRIPLE - VINTAGE BRASS SIGN - MOBILE ORDER PICK UP ILLUMINATED BLADE MOUNT SIGN EXTENSION LEGS STRIP - LED TAPE - VARIABLE LENGTH TRACK - WITH CONNECTORS - 16FT 488CM - WHITE - 1 CIRCUIT TRACK - WITH CONNECTORS - 12FT 365CM - WHITE - 1 CIRCUIT TRACK - WITH CONNECTORS - 12FT 365CM - WHITE - 1 CIRCUIT TRACK - WITH CONNECTORS - 12FT 365CM - WHITE - 1 CIRCUIT TRACK - WITH CONNECTORS - 12FT 365CM - WHITE - 1 CIRCUIT TRACK - WITH CONNECTORS - 12FT 365CM - WHITE - 1 CIRCUIT TRACK - WITH CONNECTORS - 12FT 365CM - WHITE - 1 CIRCUIT TRACK - WITH CONNECTORS - 12FT 365CM - WHITE - 1 CIRCUIT TRACK - WITH CONNECTORS - 12FT 365CM - WHITE - 1 CIRCUIT TRACK - WITH CONNECTORS - 12FT 365CM - WHITE - 1 CIRCUIT TRACK - LED FIXTURE - 2IN 50MM - WHITE - 600LM FLOOD TRACK - LED FIXTURE - 2IN 50MM - WHITE - 900LM FLOOD	FURN. BY LL SB	GC	INTEGRAT INTEGRAT INTEGRAT INTEGRAT INTEGRAT INTEGRAT
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115	TRANSLUCENT GRAY PAPER TOWEL DISPENSER HALF SIZE - TRANSLUCENT GRAY SOAP DISPENSER SINK MOUNTED MOBILE CUP DISPENSER CADDY CUP DISPENSER TRENTA COLD VERTICAL NITRO 2 TAP HANDLE AND BADGE KIT NITRO 2 TAP BADGE MOUNT BACKBAR LH NITRO 2 TAP BADGE MOUNT BACKBAR RH SHARPS CONTAINER HAND DRYER - INTEGRATED WIRE SHELF GRID AT SINK WORKROOM SHELVING - 36IN 915MM WORKROOM SHELVING POSTS MOP RACK WITH 3 HOLDERS BASE - 24X18IN 610X455MM PARTNER WORK CENTER PASTRY TRAY CART - 60IN 1525MM ROLLING PASTRY TRAY THAW RACK - 20X26IN 510X660MM WORKROOM CART - 24IN 610MM 5 COMP LOCKER - 12IN 305MM EXTERIOR SIGNA COUNT DESCRIPTION FUNCTION I SIGN - DISK SF ILLUMINATED FLUSH MOUNTED EVOLVED - 60IN 1525MM HRU SIGN - DT DIRECTIONAL EXIT SIGN ILLUMINATED ARROW SERIES - 46IN 1170MM SERIES - 46IN 1170MM SIGN - DT CLEARANCE BAR ARROW SERIES FREESTANDING SB HONUMENT SIGN PANELS SB H MONUMENT SIGN PANELS SB H MONUMENT SIGN PANELS SB H MONUMENT SIGN PANELS SB H	SB SB SB SB SB SB SB SB SB SC	GC G	SENSOR OPERATED. 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DESIGN ID	COUNT	DESCRIPTION	FURN. BY	INST. BY	COMMENTS
FAN			- 1		
10894	1	FAN - DT AIR CURTAIN WITH HEATER - 48IN 1220MM	LL	LL	INCLUDED AS PART OF DT WINDOW PACKAGE. READY ACCESS AA300-275 PASS THRU AIR CURTAIN SYSTEM. CONTACT: ANNA ELLIS, ANNA@READY-ACCESS.COM
X0003	1	FAN - WALL MOUNTED FAN - PATIO	GC	GC	GLOBAL INDUSTRIAL 30IN OSCILLATING WALL MOUNTED FAN. ITEM #T9F292451. GC TO PROVIDE MOUNTING PARTS AS NEEDED. LL TO PROVIDE ELECTRICAL POWER.
OTHER				•	
17797	1	ENERGY MANAGEMENT SYSTEM - HVAC ONLY	SB	GC	
X0028	3	ACCESS PANELS	GC	GC	BAUCO PLUSS III SINGLE LEAF CEILING ACCESS PANEL. TOUCH LATCH. CONCEALED HARDWARE. CONTACT: 250.592.0033 / INFO@ACCESSPANELSOLUTIONS.COM FINSH TO MATCH HOST CEILING

	DESIGN ID	COUNT	DESCRIPTION	FURN. BY	INST. BY	COMMENTS
	EXTERIOR N	MENU				
	14116	1	MENU BOARD - DT DIGITAL ORDER SCREEN - FLAT BLACK MT0028	SB	SB/GC	SUPPLIER: IT EQUIPMENT VENDOR (ZONES). SCREEN INSTALLER: REGIONAL SIGNAGE VENDOR. ELECTRICAL: GC CONNECTS DOS WHIPS & STUB-UPS TO DCB.
	14119	1	MENU BOARD - DT 5 PANEL FREESTANDING - 108X65IN 2745X1650MM - FLAT BLACK MT0028	SB	SB	SUPPLIER: DT SIGNAGE VENDOR (DSA). INSTALLER: REGIONAL SIGNAGE VENDOR. LL TO PROVIDE CONDUIT, FOOTING, AND ANCHOR BOLTS PER LLWL.
D	14120	1	MENU BOARD - DT PRE MENU FREESTANDING - 36X65IN 915X1650MM - FLAT BLACK MT0028	SB	SB	PROVIDED AND INSTALLED BY SIGNAGE VENDOR. LANDLORD GC TO PROVIDE FOOTING & ELECTRICAL AS SPECIFIED PER LLWL.
D	15700	1	MENU BOARD - DT DIGITAL ORDER SCREEN CONTROL BOX	SB	SB/GC	SUPPLIER: IT EQUIPMENT VENDOR (ZONES). INSTALLER: REGIONAL SIGNAGE VENDOR. ELECTRICAL CONNECTION: GC. LL TO PROVIDE FOOTING, CONDUIT, AND ANCHOR BOLTS PER LLWL.
	OTHER					
	14103	11	BOLLARD NONILLUMINATED SQUARE - FLAT BLACK MT0028	LL	LL	SUPPLIER/INSTALLER: LL. DSA PHOTOTECH. SEE DETAILS.
	14163	1	DT ORDER POINT CANOPY FREESTANDING - FLAT BLACK MT0028	SB	SB	SUPPLIER: DT SIGNAGE VENDOR (DSA). INSTALLER: REGIONAL SIGNAGE VENDOR. LL TO PROVIDE AND INSTALL CONDUIT, FOOTING, AND ANCHOR BOLTS PER LLWL.
	18818	4	LIGHT POLE - 10FT 300CM - FLAT BLACK MT0028	LL	LL	
	18820	4	LIGHT POLE BASE PLATE - FLAT BLACK MT0028	LL	LL	
	X0001	2	VEHICLE DETECTOR LOOP	SB	GC/LL	SUPPLIER: DT AUDIO VENDOR (HME). INSTALLER:GC. LL TO PROVIDE CONDUIT PER LLWL.
	X0004	5	PLANTER BOXES - 84X36X18IN	LL	LL	LL TO PROVIDE DRAINAGE AND AUTOMATED IRRIGATION PER LLWL REQUIREMENTS. LL TO PROVIDE SPEC TO DESIGNER FOR APPROVAL.
	X0008	1	BIKE RACK - OLYMPIA	LL	LL	FORMS & SURFACES: OLYMPIA BIKE RACK. WWW.FORMS-SURFACES.COM; INSTALL PER MANUFACTURER'S RECOMMENDATIONS.
	X0009	20	NATIVE PLANTS FOR PLANTER BOXES	LL	LL	LANDSCAPING SELECTION AND QTY VERIFICATION BY LANDLORD. PROVIDE DRAUGHT-RESISTANT, NATIVE PLANTS WITH MINIMUM MAINTENANCE REQUIREMENTS.
	UMBRELLA				•	
	12147	3	UMBRELLA - BASE 95LB 43KG - FLAT BLACK MT0028	SB	GC	
	20075	3	UMBRELLA - WITHOUT VALANCE - 6FT 183CM - BLACK CANVAS WITH WORDMARK F0061	SB	GC	

DESIGN ID	COUNT	DESCRIPTION	FURN. BY	INST. BY	BULB	COMMENTS
EXIT				1		
11483	1	EXIT - SECURITY LIGHT WALL MOUNTED	LL	LL	HID 150W OR EQUAL	
19044	5	LED EXIT SIGN WITH EMERGENCY LIGHT - WHITE AND RED	SB	GC		CAFE EXIT SIGNS TO BE SUSPENDED.
19057	4	LED EMERGENCY LIGHT DOUBLE - BLACK	SB	GC	INTEGRATED LED	
OTHER						
17796	7	LED STRING LIGHTS - 48FT 1463CM	SB	GC	INTEGRATED LED	POWER BY LANDLORD. TOTAL LENGTH REQUIRED: 130FT
RECESSED	CAN					
19023	32	CAN - LED MOUNTING FRAME - 2IN 50MM - NEW CEILING	SB	GC		
19113	28	CAN - LED ADJUSTABLE GIMBAL WITH DRIVER - 2IN 50MM - WHITE - 1000LM NFL	SB	GC		
19120	4	CAN - LED DOWNLIGHT REFLECTOR WITH DRIVER SQUARE - 2IN 50MM - WHITE - 1000LM FLOOD	SB	GC	INTEGRATED LED	
SCONCE					1	
20711	6	SCONCE - HINKLEY ATLANTIS LARGE - BLACK	LL	LL	INTEGRATED LED	DOLAN HOSPITALITY MFR #376769 ATLANTIS OUTDOOR SCONCE
20750	2	SCONCE - KUZCO PLUTO TRIPLE - VINTAGE BRASS	SB	GC	INTEGRATED LED	
SIGNAGE - C	THER					
21163	1	SIGN - MOBILE ORDER PICK UP ILLUMINATED BLADE MOUNT	SB	GC		GC TO PROVIDE BLOCKING AND ELECTRICAL IN SOFFIT AS REQUIRED
X0030	1	SIGN - MOBILE ORDER PICK UP SIGN EXTENSION LEGS	SB	GC		BY WALTON. ORDER 4FT LEGS, CUT IN FIELD FOR BOTTOM AT 7'-6" AFF, REFER TO INTERIOR ELEVATIONS FOR EXACT DIMENSION
STRIP						
14410	1	STRIP - LED TAPE - VARIABLE LENGTH	SB	GC	INTEGRATED LED	LENGTH: 43'-9"
TRACK						
12934	2	TRACK - WITH CONNECTORS - 4FT 122CM - WHITE - 1 CIRCUIT	SB	GC		
12944	3	TRACK - WITH CONNECTORS - 16FT 488CM - WHITE - 1 CIRCUIT	SB	GC		
12945	5	TRACK - WITH CONNECTORS - 12FT 365CM - WHITE - 1 CIRCUIT	SB	GC		
15059	1	TRACK - WITH CONNECTORS - 6FT 183CM - WHITE - 1 CIRCUIT	SB	GC		
19071	4	TRACK - LED FIXTURE - 2IN 50MM - WHITE - 900LM SPOT	SB	GC	INTEGRATED LED	
19072	14	TRACK - LED FIXTURE - 2IN 50MM - WHITE - 600LM FLOOD	SB	GC	INTEGRATED LED	
19074	35	TRACK - LED FIXTURE - 2IN 50MM - WHITE - 900LM FLOOD	SB	GC	INTEGRATED LED	
19087	53	TRACK - HEX CELL LOUVER - 2IN 50MM	SB	GC		
TROFFER						
15057	7	TROFFER - LED RECESSED - 24X48IN 600X1200MM - WHITE - 4000LM	SB	GC	INTEGRATED LED	




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STORE #: PROJECT#:

87799-001 ISSUE DATE: 06-16-2020
SR. DESIGN MANAGER: K. GORIN SLONSKI
PRODUCTION DESIGNER: A. HAHN
CHECKED BY: NJD/BMS

62012

Revision Schedule

Rev	Date	Ву	Description
	ET TITLE		ES

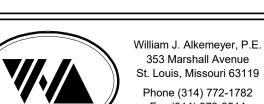SCALE: AS SHOWN

SHEET NUMBER:

REV REVISION RT ROOFTOP SQUARE FEET SHT SHEET SPECS SPECIFICATION(S) SST STAINLESS STEEL TEMP TEMPORARY TYP TYPICAL

UNLESS NOTED OTHERWISE WATER HEATER

WATER SOURCE HEAT PUMP

MECHANICAL SYMBOL LEGEND

TYPICAL SUPPLY DUCT UP/DN TYPICAL RETURN OR EXHAUST DUCT UP/DN **TURNING VANES** EF-1 EQUIPMENT DESIGNATION

THERMOSTAT

TEMPERATURE SENSOR

AIRFLOW ARROW

INDICATES UNLINED 12" X 8" O.D. SHEETMETAL 1ST FIGURE = SIDE SHOWN 12 X 8 2ND FIGURE = SIDE NOT SHOWN

FLEXIBLE DUCT M H001

DIFFUSER ITEM# XXX CFM DESIGN CFM (WHERE APPLICABLE) **NECK SIZE**

CEILING DIFFUSER **CEILING RETURN GRILLE** CEILING EXHAUST GRILLE

CONTROLS AND OPERATION NOTES

THE GENERAL CONTRACTOR SHALL FURNISH AND INSTALL THE FOLLOWING COMPONENTS:

THE MECHANICAL CONTRACTOR SHALL PROVIDE ALL CONTROL WIRING IN CONDUIT NECESSARY FOR THE COMPLETE AND PROPER OPERATING TEMPERATURE CONTROL SYSTEM INCLUDING ALL MODES OF OPERATION AND INTERLOCK.

RESTROOM EXHAUST FAN(S) TO BE OPERATED IN CONJUNCTION WITH STORE HOURS UNLESS OTHERWISE NOTED OR APPROVED OR AS REQUIRED BY JURISDICTION (COORDINATE WITH ELECTRICAL).

THERMOSTAT

PERMANENT THERMOSTAT(S) AND REMOTE SENSOR(S) SHALL BE FURNISHED AND INSTALLED. ONE THERMOSTAT AND SENSOR IS PROVIDED FOR EACH UNIT. MOUNT THERMOSTAT(S) AND SENSOR(S) IN LOCATION & HEIGHT AS INDICATED ON DRAWINGS. MECHANICAL CONTRACTOR TO PROVIDE THERMOSTAT IDENTIFICATION LABELS PER SPECIFICATION REQUIREMENTS. REFER TO THERMOSTAT SETUP INSTRUCTIONS BELOW FOR ADDITIONAL REQUIREMENTS.

THERMOSTAT SETUP INSTRUCTIONS

PROVIDE THE FOLLOWING SETUP AND PROGRAMMING:

1. CONFIGURE AS FOLLOWS:

A. DEGREES "F" DISPLAY B. 12 HOUR CLOCK

C. CONTINUOUS FAN OPERATION IN OCCUPIED

D. DISABLE KEYBOARD PROGRAMMING

2. SET TIME AND DATE. SET TO DISPLAY CURRENT TEMPERATURE. SET OCCUPIED START TIME AT 30 MIN. BEFORE OPENING. SET UNOCCUPIED START TIME AT 30 MIN. AFTER CLOSING. VERIFY HOURS WITH STORE MANAGER OR CONSTRUCTION MANAGER.

5. SET POINTS SHALL BE AS FOLLOWS OR AS APPROPRIATE

FOR CLIMATE: A. OCCUPIED (5° F DEADBAND) (3° C DEADBAND) HEATING: 70° F (21° C) II. COOLING: 75° F (24° C)

B. UNOCCUPIED HEATING: 60° F (15° C) II. COOLING: 78° F (25° C)

6. SET TWO (2) HOUR OCCUPIED OVERRIDE FUNCTION TO PROVIDE THE FOLLOWING SET POINT OVERRIDES: A. HEATING: $+2^{\circ}$ F (1° C) B COOLING: -2° F (1° C)

SYSTEM COMMISSIONING

CONTRACTOR RESPONSIBILITIES FOR BUILDING COMMISSIONING

CONTRACTOR SHALL PROVIDE SUPPORT AND WORK AS SPECIFIED, NEEDED AND REQUIRED TO CONDUCT AND FACILITATE STARBUCKS STAFF BUILDING COMMISSIONING EFFORTS. THIS WORK WILL BE COMPRISED OF THREE DISTINCT EFFORTS:

1. SUPPORT STARBUCKS COMMISSIONING AGENT (CXA) DURING INSTALLATION VERIFICATION AND CORRECT DISCLOSED DEFICIENCIES.

PERFORM TESTING, ADJUSTING, BALANCING AND SYSTEM STARTUP AND SUPPORT FUNCTIONAL PERFORMANCE TESTING

BY STARBUCKS CXA; 3. CORRECT DEFICIENCIES DISCLOSED BY FUNCTIONAL PERFORMANCE TESTING AND SUBMIT REPORTS.

CONTRACTOR SHALL PERFORM AND PROVIDE THE FOLLOWING:

A. SYSTEMS SUBJECT TO COMMISSIONING MAY INCLUDE. BUT ARE NOT LIMITED TO DOMESTIC HOT WATER GENERATION, HVAC SYSTEMS, ROOFTOP UNITS, EXHAUST FANS, HVAC CONTROLS, LIGHTING CONTROLS. AIR CURTAINS, BUILT-IN REFRIGERATION, EQUIPMENT AND RENEWABLE ENERGY SYSTEMS.

B. CONTRACTOR SHALL PROVIDE WRITTEN RESPONSES TO ALL CXA'S REVIEWS AND COMMENTS. RESPONSES SHALL BE PROVIDED IN A TIMELY MANNER.

C. CONTRACTOR SHALL INCLUDE COMMISSIONING ACTIVITIES IN PROJECT SCHEDULE AND SHOW INTERVALS FOR PERFORMANCE OF WORK FOR WHICH CONTRACTOR IS RESPONSIBLE AND INTERVALS FOR WORK PERFORMED BY STARBUCKS CXA. CONTRACTOR SHALL SHOW RESOURCES FOR PERFORMING ALL WORK RELATED TO COMMISSIONING ACTIVITIES ON A LINE ITEM IN THE SCHEDULE OF VALUES.

D. CONTRACTOR SHALL INSTALL EQUIPMENT IN ACCORDANCE WITH THE MANUFACTURER'S REQUIREMENTS AND ALL CONTRACT. DOCUMENTS. ENSURE THAT ALL EQUIPMENT IS INSTALLED TOTALLY COMPLETE AND ACCESSIBLE TO STARBUCKS CXA FOR INSTALLATION VERIFICATION AND FUNCTIONAL PERFORMANCE TESTING PRIOR TO THE SCHEDULED START OF INSTALLATION

. CONTRACTOR SHALL COMPLETE MANUFACTURER'S STARTUP PROCEDURES PRIOR TO COMMISSIONING COORDINATION WITH

F. CONTRACTOR SHALL BE READILY AVAILABLE DURING INSTALLATION VERIFICATION TO CORRECT ANY DEFICIENCIES OR DEFECTS IS CLOSED BY THE INSTALLATION VERIFICATION PROCESS. CORRECTIONS SHALL BE MADE IN A TIMELY MANNER WITHOUT DISRUPTION OF THE CONSTRUCTION SCHEDULE.

G. ALL HVAC EXHAUST FAN AND AIR CURTAIN EQUIPMENT SHALL BE TESTED, ADJUSTED AND BALANCED BY THE CONTRACTOR'S TESTING, ADJUSTING AND BALANCE AGENT (SEE TESTING ADJUSTING AND BALANCING) AFTER THE SYSTEM IS VERIFIED TO BE COMPLETE AND CORRECT BY STARBUCKS CXA. IN ACCORDANCE WITH THE REQUIREMENTS OF THESE DOCUMENTS. ALL HVAC CONTROL SYSTEMS SHALL BE TESTED TO ENSURE THAT CONTROL DEVICES, COMPONENTS, EQUIPMENT AND SYSTEMS ARE CALIBRATED, ADJUSTED AND OPERATE IN ACCORDANCE WITH THESE PLANS AND SPECIFICATIONS. SEQUENCES OF OPERATION SHALL BE TESTED TO ENSURE THAT THEY OPERATE IN ACCORDANCE WITH THE CONTRACT REQUIREMENTS. DELIVERABLES: PRELIMINARY, WRITTEN TESTING AND AIR BALANCE REPORT CONFORMING TO THE REQUIREMENTS SPECIFIED HEREIN, DOCUMENTING THE INFORMATION SPECIFIED, ETC... TO THE STARBUCKS CXA IMMEDIATELY UPON COMPLETION OF THE WORK.

H. PROVIDE A LIST OF ALL FACTORY AND FIELD SETTINGS THAT HAVE BEEN PROGRAMMED INTO THE EQUIPMENT (SUCH AS SETPOINTS. SCHEDULES. DIP SWITCH SETTINGS. CONDENSER AND EVAPORATOR OPERATING PRESSURE/TEMPERATURE,

CONTRACTOR SHALL INFORM STARBUCKS CXA WHEN EQUIPMENT IS READY FOR FUNCTIONAL PERFORMANCE TESTING. ALL EQUIPMENT SHALL BE READY FOR FUNCTIONAL PERFORMANCE TESTING PRIOR TO STARTING TESTING. THIS INCLUDES REHEARSING ALL FUNCTIONAL PERFORMANCE TESTS BEFORE DEMONSTRATING TO THE CXA. CONTRACTOR SHALL OPERATE EQUIPMENT FOR STARBUCKS CXA AND VERIFY BY DEMONSTRATING THE CORRECT OPERATION OF EQUIPMENT SENSOR CALIBRATION, RESPONSE OF ACTUATORS AND PROPER EXECUTION OF HVAC CONTROL AND LIGHTING SEQUENCES, INCLUDING BUT NOT LIMITED TO AIR MOVEMENT, TEMPERATURE, SOUND AND CONTROL RESPONSE. PROVIDE ANY SECURITY ACCESS, HARDWARE, SOFTWARE OR OTHER SUPPORT AS NEEDED FOR THE STARBUCKS CXA TO EFFICIENTLY WITNESS AND DOCUMENT ALL EQUIPMENT TESTING. STARBUCKS CXA WILL RECORD THE EQUIPMENT OPERATION AND RESPONSE TO TESTING SEQUENCES AND PREPARE A LIST OF ANY DEFICIENCIES DISCLOSED BY THE FUNCTIONAL PERFORMANCE TESTS FOR CORRECTION BY THE CONTRACTOR. EQUIPMENT INCLUDES, BUT IS NOT LIMITED TO, AIR HANDLING UNITS, ROOFTOP AND SPLIT TYPE, CONDENSING UNITS, EXHAUST FANS, LIGHTING CONTROLS, ETC... DELIVERABLES: PROVIDE COMPLETED COPIES OF ALL START UP REPORTS, FILLED OUT ON THE MANUFACTURER'S FORMS, TO THE STARBUCKS CXA.

J. CONTRACTOR IS RESPONSIBLE FOR CORRECTING ANY ISSUES OR DEFICIENCIES DISCLOSED DURING THE FUNCTIONAL PERFORMANCE TESTING PROCESS. CORRECTIONS SHOULD BE MADE IN A TIMELY MANNER WITHOUT DISRUPTION TO THE SYSTEM AND CONSTRUCTION SCHEDULE.

K. CONTRACTOR SHALL BE READILY AVAILABLE FOR ANY RE-TESTING OF EQUIPMENT DEEMED NECESSARY BY STARBUCKS CXA DURING INSTALLATION VERIFICATION AND FUNCTIONAL PERFORMANCE TESTING. CONTRACTOR IS RESPONSIBLE FOR CORRECTING ANY ISSUES OR DEFICIENCIES FOUND IN THE SYSTEM DURING ANY AND ALL RE-TESTING. CORRECTIONS SHOULD BE MADE IN A TIMELY MANNER WITHOUT DISRUPTION TO THE SYSTEM AND CONSTRUCTION SCHEDULE. DELIVERABLES: FINAL BALANCE REPORT, DEFICIENCIES LIST NOTING CORRECTIVE ACTIONS PERFORMED BY CONTRACTOR IN RESPONSE TO INSTALLATION VERIFICATION AND FUNCTIONAL PERFORMANCE TEST RESULTS.

CONSTRUCTION AND POST CONSTRUCTION TESTING: ADDITIONAL TESTING MAY BE REQUIRED BY LEED AND OTHER PROCESSES THAT MAY OCCUR OUT OF SEQUENCE WITH COMMISSIONING SERVICE. CONTRACTOR SHALL CONDUCT. DOCUMENT, SUPPORT AND SCHEDULE THIS TESTING AS DIRECTED BY STARBUCKS CXA.

SYSTEM COMMISSIONING (continued)

- M. CONTRACTOR SHALL PROVIDE A TRAINING PLAN FOR EACH TRADE (MECHANICAL, ELECTRICAL, PLUMBING, RENEWABLE SYSTEMS) FOR THE CXA'S APPROVAL. THE TRAINING PLAN SHALL OUTLINE ALL THE TOPICS THAT ARE TO BE COVERED ALONG WITH THE TIME DURATION FOR EACH TOPIC. IT SHALL ALSO INCLUDE THE INSTRUCTOR'S NAME, QUALIFICATIONS AND COMPANY LOGO.
- N. THE CONTRACTOR IS RESPONSIBLE FOR RECORDING ATTENDANCE FOR EACH TRAINING SESSION. COPIES OF THESE SHALL BE SUBMITTED TO THE CXA.
- O. CONTRACTOR SHALL SUBMIT O&M MANUALS FOR ALL PIECES OF EQUIPMENT AT LEAST 6 WEEKS IN ADVANCE OF THE TRAINING

HVAC EQUIPMENT AND MATERIALS

FILTERS

IF OPERATING HVAC DURING CONSTRUCTION, PROVIDE THREE (3) SETS OF 2" (51MM) MERV6 PLEATED DISPOSABLE FILTERS (OR HIGHER RATING IF REQUIRED BY LEED). USE ONE SET UNTIL COMPLETION OF CONSTRUCTION. INSTALL ONE SET AT COMPLETION OF CONSTRUCTION (PRIOR TO TAB) AND DELIVER ONE SET OF MERV13 FILTERS TO STARBUCKS LABELED TO DENOTE THEIR RESPECTIVE AIR HANDLING UNIT.

BRACING AND ANCHORING

ALL MECHANICAL EQUIPMENT, FIXED OR FLEXIBLY MOUNTED, SHALL BE BRACED OR ANCHORED TO COMPLY WITH LOCAL CODES.

DUCTWORK AND ACCESSORIES

SHEET METAL DUCTWORK
ASSEMBLE AND INSTALL DUCTWORK IN ACCORDANCE WITH RECOGNIZED INDUSTRY PRACTICE FOR ACHIEVING AIR TIGHT (5% LEAKAGE) AND NOISELESS (NO OBJECTIONABLE NOISE) SYSTEMS. NO VARIATION OF DUCT CONFIGURATION OR SIZES WILL BE PERMITTED EXCEPT BY PERMISSION FROM THE ENGINEER.

PROVIDE CONVENIENTLY LOCATED ACCESS DOORS OF AMPLE SIZE AND QUANTITY FOR SERVICING THE DAMPERS. PROVIDE MOTORIZED DAMPERS AT ALL INTAKE & EXHAUST BUILDING OPENINGS. COORDINATE WITH OTHER TRADES FOR ACCESS PANELS, POWER AND FIRE ALARM INTERFACES. SEE PROJECT MANUAL.

UNLESS OTHERWISE INDICATED ON THE PLANS, PROVIDE 1" (25MM) ACOUSTICAL DUCT LINER IN SUPPLY AND RETURN DUCTWORK WITHIN 10'-0" (305CM) OF THE DISCHARGE AND INTAKE OF AIR HANDLING UNITS. INCREASE DUCT SIZE INDICATED ON PLANS AS NEEDED TO ACCOMMODATE LINER. LINER TO BE PROVIDED AND FASTENED TO DUCT WITH MECHANICAL LINER FASTENERS IN ACCORDANCE WITH SMACNA AND PROJECT MANUAL.

FLEXIBLE DUCT WORK SHALL ONLY BE INSTALLED AS SHOWN IN PLAN AND NOT ABOVE HARD LID CEILINGS. FLEXIBLE DUCTWORK SHALL NOT EXCEED 5'-0" (152CM) IN LENGTH AND TWO 45° ELBOWS. IT SHALL BE PULLED TAUT AND APPROPRIATELY FASTENED TO RIGID BRANCH DUCT & DIFFUSER. BENDS SHALL BE MINIMIZED AND WHERE NEEDED BE A FULL RADIUS BEND. SUPPORT BANDS SHALL BE INSTALLED SO AS TO NOT CRIMP FLEX DUCT. FLEXIBLE DUCTWORK SHALL MEET REQUIREMENTS.

TESTING, ADJUSTING, BALANCING

INDEPENDENT AIR BALANCE CONTRACTOR OR QUALIFIED MECHANICAL CONTRACTOR SHALL BE QUALIFIED BY NEBB OR AABC STANDARDS. BALANCER SHALL ACCURATELY BALANCE THE SUPPLY, RETURN AND OUTSIDE AIR, EXHAUST FAN(S), HYDRONIC (WHERE APPLICABLE) AND EXHAUST FAN(S) SYSTEMS TO PROVIDE AIR AND WATER QUANTITIES WITHIN 10% PLUS MINUS OF THE VALUES INDICATED ON THE DRAWINGS AND IN THE SPECIFICATIONS UNLESS MANUFACTURER REQUIRES TIGHTER TOLERANCES. OPERATE AUTOMATIC CONTROLS SYSTEMS AND VERIFY SETPOINTS FOR THERMOSTATS, CO2 SENSORS, DCV, EMS AND ECONOMIZER/OUTSIDE AIR DAMPER. SEE CONTROLS AND OPERATION NOTES AND HVAC SCHEDULES AND NOTES FOR DETAILS. IF DEFICIENCIES OR SITE CONDITIONS PREVENT COMPLETE AND PROPER BALANCING, DO NOT COMPLETE WORK AND SUBMIT A REQUEST FOR INFORMATION TO GET COMPLETE INFORMATION PRIOR TO COMPLETING WORK. SUBMIT THREE (3) COPIES OF THE BALANCE REPORT TO THE ENGINEER, CONSTRUCTION MANAGER AND COMMISSIONING AGENT FOR APPROVAL. THE BALANCE REPORT SHALL INCLUDE NEBB OR AABC CREDENTIALS. EQUIPMENT/INSTRUMENT LIST WIT THE MOST RECENT CALIBRATION DATE AND BALANCE REPORTS FOR ALL HVAC AND EXHAUST SYSTEMS. T&B REPORT SHOULD MATCH NEBB OR AABC STANDARD REPORTS INCLUDING UNIT TEST DATA WITH TEMPERATURES, PRESSURES AND STATIC PRESSURE PROFILES. INCLUDE A COPY OF THE BALANCE REPORT AS APPROVED BY THE ENGINEER WITH APPLICATION FOR FINAL CONTRACT PAYMENT.

IAQ MANAGEMENT PLAN

DURING CONSTRUCTION, CONTRACTOR SHALL COMPLY WITH CHAPTER 3 OF SMACNA'S IAQ GUIDELINES FOR OCCUPIED BUILDINGS UNDER CONSTRUCTION. CONTRACTOR SHALL PERFORM AND SUBMIT ALL INFORMATION AS REQUIRED. IF HVAC SYSTEM IS TO BE USED DURING CONSTRUCTION, INSTALL MERV 8 FILTERS AT EACH RETURN AIR GRILL AND COMPLY WITH SMACNA'S GUIDELINES.

ENERGY MANAGEMENT SYSTEM (EMS)

THE GENERAL CONTRACTOR SHALL INSTALL (OR DEMO AND REINSTALL FOR RENOVATIONS) THE VENSTAR SURVEYOR EMS SYSTEMS PRIOR TO THE LAST WEEK OF CONSTRUCTION. GENERAL CONTRACTOR TO PROVIDE ONE PERMANENT THERMOSTAT AND REMOTE SENSOR PER HVAC UNIT. LOCATE AND MOUNT THERMOSTAT(S) AND SENSOR(S) PER THE DRAWINGS. PROVIDE THERMOSTAT IDENTIFICATION LABELS PER SPECIFICATION REQUIREMENTS.

GENERAL CONTRACTOR TO PROGRAM, START-UP AND COMMISSION THE CONTROL SYSTEM. GENERAL CONTRACTOR IS TO COMPLETE FINAL CONNECTION AFTER DATA RACK AND NETWORK INSTALLATIONS. GENERAL CONTRACTOR VENDOR TO VERIFY SYSTEM OPERATION AND TROUBLESHOOT IF REQUIRED. GENERAL CONTRACTOR TO COMPLETE SURVEYOR'S STARBUCKS INSTALLATION SURVEY FORM AND PROVIDE TWO (2) COMPLETED COPIES OF THIS DOCUMENT TO THE CONSTRUCTION MANAGER AND COMMISSIONING AGENT PRIOR TO FINAL PAYMENT.

GENERAL MECHANICAL NOTES

- 1. MECHANICAL CONTRACTOR SHALL COORDINATE WITH THE GENERAL CONTRACTOR TO PATCH AND REPAIR ALL EXISTING WALLS, FLOORS, CEILINGS OR OTHER SURFACES IDENTIFIED TO REMAIN THAT MAY BECOME DAMAGED DURING THE COURSE OF
- 2. DRAWINGS ARE DIAGRAMMATIC AND INDICATE GENERAL INTENT OR ARRANGEMENT OF SYSTEM(S). FURNISH & INSTALL ALL COMPONENTS NEEDED WHETHER INDICATED OR NOT TO PROVIDE A COMPLETE AND OPERATING SYSTEM.
- CONTRACTOR TO VERIFY ALL DIMENSIONS, INCLUDING CLEARANCES REQUIRED BY OTHER TRADES, AND NOTIFY STARBUCKS CONSTRUCTION MANAGER OF ANY DISCREPANCIES PRIOR TO PROCEEDING WITH THE WORK. ALL DIMENSIONS ARE TO THE FACE OF THE FINISHED SURFACE UNLESS NOTED OTHERWISE. ALL DIMENSIONS TO BE TAKEN FROM ACTUAL BUILDING DIMENSIONS.
- 4. THE MECHANICAL CONTRACTOR SHALL COORDINATE HVAC WORK WITH OTHER TRADES. THE ARCHITECTURAL DRAWINGS AND PROJECT MANUAL SHALL TAKE PRECEDENCE OVER ALL OTHER DRAWINGS. SEE ARCHITECTURAL DRAWINGS AND PROJECT MANUAL FOR DIMENSIONED DIFFUSER LOCATIONS AND MOUNTING HEIGHTS WHERE EXPOSED.
- 5. NEW DUCTWORK AND EQUIPMENT SHALL NOT BE INSTALLED WHERE IT OBSTRUCTS ANY EXISTING OR NEW AREAS THAT REQUIRE ACCESS.
- INSULATE DUCTWORK PER CODE AND SPEC. REQUIREMENTS. COORDINATE CLEARANCE REQUIREMENTS FOR ADDED INSULATION.
- 7. ALL IS NEW UNLESS NOTED OTHERWISE.

GENERAL NOTES

THE INTENT OF THE PROJECT MANUAL AND THE DRAWINGS IS TO PROVIDE A COMPLETE AND FULLY OPERATIONAL MECHANICAL SYSTEM. THE MECHANICAL CONTRACTOR SHALL FURNISH ALL LABOR, MATERIAL, AND EQUIPMENT NECESSARY TO COMPLETE THE MECHANICAL WORK.

THE MECHANICAL CONTRACTOR SHALL THOROUGHLY EXAMINE ALL AREAS WHERE EQUIPMENT, DUCTWORK, AND PIPING WILL BE INSTALLED AND WILL REPORT ANY CONDITION THAT, IN HIS OPINION, PREVENTS THE PROPER INSTALLATION OF THE MECHANICAL WORK.

WHERE PIPES AND DUCTS PENETRATE WALL, SEAL OPENINGS TO

PREVENT AIR TRANSFER BETWEEN SPACES. USE FIRE RATED SEALANTS ON ALL FIRE SEPARATION PENETRATIONS, INCLUDING FLOORS. SEAL AROUND ALL PIPES AND DUCTS PENETRATING FIRE SEPARATIONS WITH NON-COMBUSTIBLE PACKING RETAINED BY METAL COLLARS. THE ASSEMBLY SHALL BE APPROVED BY STATE FIRE MARSHALL.

EQUIPMENT AND MATERIALS SHALL CONFORM WITH THE APPROPRIATE PROVISIONS OF CSA, ULC, ARL, ASME, ASTM, UL, NEMA, ANSI, SMACNA, ASHRAE, NFPA, AS APPLICABLE TO EACH INDIVIDUAL UNIT OR ASSEMBLY.

ALL WORK SHALL BE PERFORMED IN STRICT ACCORDANCE WITH ALL APPLICABLE PROVINCIAL AND LOCAL CODES AND ORDINANCES. IN CASE OF CONFLICT BETWEEN THE DRAWINGS AND PROJECT MANUAL AND THE CODES AND ORDINANCES, USE WHICHEVER IS MORE STRINGENT. THE MECHANICAL CONTRACTOR SHALL SATISFY CODE REQUIREMENTS AS A MINIMUM STANDARD WITHOUT ANY EXTRA COST TO STARBUCKS.

PERMITS AND FEES

THE MECHANICAL CONTRACTOR SHALL PROCURE AND PAY FOR ALL PERMITS, FEES, AND INSPECTIONS NECESSARY TO COMPLETE THE MECHANICAL WORK.

THE MECHANICAL CONTRACTOR SHALL UNCONDITIONALLY WARRANT ALL WORK TO BE FREE OF DEFECTS IN MATERIAL AND WORKMANSHIP FOR A PERIOD OF ONE (1) YEAR FROM THE DATE OF FINAL ACCEPTANCE BY STARBUCKS AND WILL REPAIR OR REPLACE ANY DEFECTIVE WORK PROMPTLY AND WITHOUT CHARGE AND RESTORE ANY OTHER EXISTING WORK DAMAGED IN THE COURSE OF REPAIRING DEFECTIVE MATERIALS AND WORKMANSHIP.

LANDLORD REQUIREMENTS

PRIOR TO BID: THE GENERAL CONTRACTOR SHALL COORDINATE WITH LANDLORD / BUILDING OWNER FOR ANY CONSTRUCTION REQUIREMENTS. IF LANDLORD / BUILDING OWNER DOES HAVE REQUIREMENTS, CONTRACTOR SHALL BECOME COMPLETELY FAMILIAR WITH REQUIREMENTS AND ADHERE TO THEM. WHERE LANDLORD / BUILDING OWNER REQUIREMENTS ARE MORE STRINGENT THAN SHOWN IN THESE PLANS (IN THE OPINION OF THE ENGINEER). LANDLORD / BUILDING OWNER REQUIREMENTS SHALL GOVERN.



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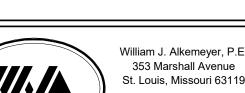
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STARBUCKS TEMPLATE VERSION i2020-01-31

WRITTEN AGREEMENT IS FULLY EXECUTED BY BOTH PARTIES






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Engineering Consultant

2020



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87799-001

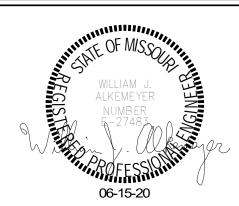06-16-2020

STORE #: PROJECT#: ISSUE DATE: SR. DESIGN MANAGER: K. GORIN SLONSKI PRODUCTION DESIGNER: A. HAHN

CHECKED BY:

DMC Revision Schedule

Rev	Date	Ву	Description

MECHANICAL NOTES

SCALE: AS SHOWN

SHEET NUMBER:

M001

ROOFTOP PACKAGED UNIT SCHEDULE (BY L.L.) FAN SELECTION COOLING CAP. HTG. CAP. WEIGHT MARK **MANUFACTURER** EER SEER LOCATION **HEAT** SERVICE NOTES O.A. E.S.P. MOTOR (LBS) | DB/WB | NOMINAL | TOTAL/SENS | OUT & MODEL CFM RPM (KW) Hz MCA MOCP (TON) (MBH) (MBH) (MBH) TRANE 1465 208 **ROOF** CAFE 1,2,3,4,5,6,7,8,9,10 1500 RTU-1 4000 700 1.0 3.8 80/67 10 113.97/94.06 250 200 60 46.1 12.4 YHC120F BACKBAR/ TRANE RTU-2 1,2,3,4,5,6,7,8,9,10 4000 200 1.0 1465 80/67 113.97/94.06 250 200 208 60 46.1 60 12.4 **ROOF** 1500 3.8 10 YHC120F WORKROOM

NEW ELECTRIC COOLING/GAS HEATING ROOFTOP PACKAGED UNIT BY LANDLORD. VERIFY FINAL LOCATION AT JOBSITE.

HIGH EFFICIENCY, DOWN DISCHARGE CONFIGURATION. MOUNT ON CURB WITH NEW ROOF OPENING.

PROVIDE WITH FACTORY INSTALLED UNIT MOUNTED DISCONNECT SWITCH.

PROVIDE WITH FACTORY INSTALLED NON-POWERED CONVENIENCE SERVICE OUTLET (115V GFCI). PROVIDE WITH FACTORY INSTALLED ENTHALPY TYPE ECONOMIZER.

PROVIDE SMOKE DETECTOR IN RETURN AIR DUCT TO SHUT DOWN UNIT UPON DETECTION.

PROGRAMMABLE THERMOSTAT WITH REMOTE SENSOR. SEE CONTROLS SPEC

PROVIDE WITH HAIL GUARDS 10. PROVIDE WITH POWER EXHAUST


VOLTAGE PHASE HP		EXHAUST FAN SCHEDULE (BY L.L.)												
VOLTAGE PHASE HP	MARK	SERVICE			RPM	`	DRIVE	SONES (MAX)			MANUFACTURER	MODEL	NOTES	
EF-1 RESTROOMS/OVENS 500 360 1405 0.31 DIRECT 6.2 115 1 1/10 GREENHECK G-090-VG 1,			GI WI	G W G W		vvG)			VOLTAGE	PHASE	HP		1	
	EF-1	RESTROOMS / OVENS	500	360	1405	0.31	DIRECT	6.2	115	1	1/10	GREENHECK	G-090-VG	1,2

NOTES: 1. PROVIDE WITH FACTORY ROOF CURB AND BACKDRAFT DAMPER

2. PROVIDE WITH SPEED CONTROLLER

AIR TERMINAL SCHEDULE								
DIFFUSER ITEM#	COUNT	DESCRIPTION	MANUFACTURER	MODEL	AIR TERMINAL REMARKS			
H001	17	SQUARE SUPPLY - LAY-IN OR SURFACE - SEE PLAN	TITUS	TDC-A4	24x24			
H002	1	SQUARE SUPPLY - LAY-IN OR SURFACE - SEE PLAN	TITUS	TDC-A4	24x24			
H254	6	SQUARE RETURN - LAY-IN OR SURFACE	TITUS	350RL	24X24			
H255	3	SQUARE EXHAUST - SURFACE	TITUS	350 RL	12X12			

OUTSIDE AIR CALCULATIONS									
Summary Ventilation Sizing Method	1)	F	leating operation 1.00 1.00 58 0.8	on 00 86 CFM 11					
2. Opade Ventilation Analysis		Space Floor Area (ft²)	Area Outdoor Air Rate (CFM/ft²)	Time Averaged Occupancy (Occupants)	Rate	Air	Space Outdoor Air (CFM)	Breathing Zone Outdoor Air (CFM)	Space Ventilation Efficiency
Zone Name / Space Name	Mult.	(Az)	(Ra)	(Pz)		(Ez)	(Voz)	(Vbz)	(Evz)
Zone 1									
Backbar	1	408.0	0.18	2.0	7.50	0.8	111	88	1.046
0.1	1	878.0	0.18	36.0	7.50	0.8	535	428	0.811
Cafe									
RR	1	134.0	0.00	0.0	0.00	0.8	0	0	1.100
1177.077.53.73	1	134.0 127.0	0.00 0.06	0.0 0.0	0.00	0.8	0 10	8	1.100 0.942
RR	1 1	-5/9 103/5	71.7.5		515.5	2.17	0 10 78	0 8 62	100000000000000000000000000000000000000

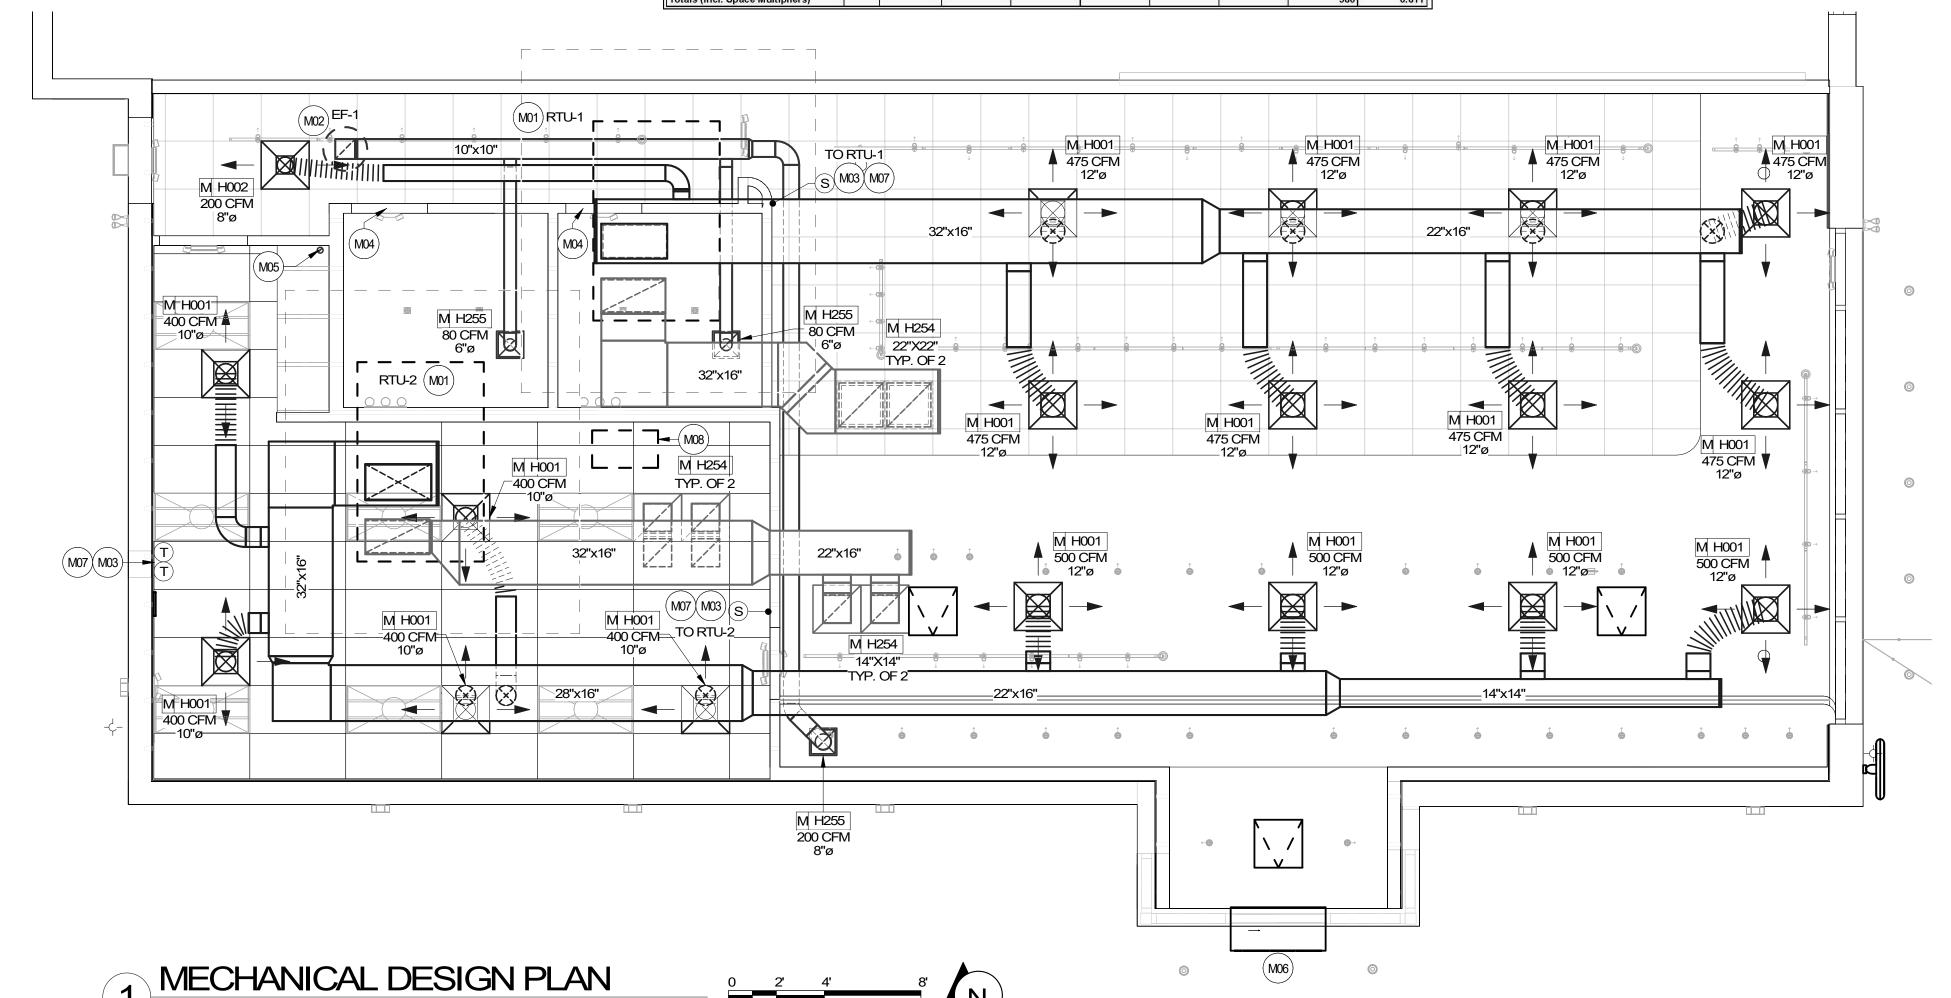

MECHANICALDESIGN PLAN NOTES

- SEE MECHANICAL SPECIFICATIONS FOR FURTHER
- SEE ARCHITECTURAL SHEETS FOR PAINTING AND COLORS OF ALL EXPOSED DUCTWORK, DIFFUSERS AND GRILLES.
- SEE ARCHITECTURAL SHEETS FOR DIMENSIONED DIFFUSER AND EXPOSED DUCT LOCATIONS.
- DIFFUSERS AND RETURN GRILLES SHALL BE CENTERED IN CEILING TILE, UNLESS OTHERWISE NOTED.
- REFERENCE LANDLORD WORK LETTER FOR DIVISION OF MECHANICAL SCOPE OF WORK AND COORDINATE WITH STARBUCKS CONSTRUCTION MANAGER.
- THIS CONTRACTOR SHALL COORDINATE WITH ALL OTHER TRADES IN LOCATING DUCTWORK, PIPING AND EQUIPMENT TO AVOID ANY INTERFERENCE.
- COORDINATE INSTALLATION OF NEW DUCT WITH STRUCTURE.
- CONTRACTOR TO INSTALL ALL WORK IN STRUCT COMPLIANCE WITH LOCAL CODES AND ORDINANCES.
- PROVIDE ADJUSTABLE VOLUME DAMPER AT ALL BRANCH
- PROVIDE TURNING VANES AT ALL RECTANGULAR ELBOWS
- MECHANICAL CONTRACTOR TO REPLACE FILTERS AFTER CONSTRUCTION IS COMPLETED.

MECHANICAL SHEET NOTES

- ROOFTOP UNIT (RTU-1&2) PROVIDED AND INSTALLED BY LANDLORD. FINAL OUTDOOR AIR SETTING SHALL BE AS INDICATED IN SCHEDULE ON THIS SHEET. FACTORY INSTALLED SMOKE DETECTOR SHALL DE-ENERGIZE UNIT SUPPLY FAN AND ACTIVATE AUDIO/VISUAL INDICATOR IF SMOKE IS DETECTED IN RETURN AIR DUCT. PROVIDE PERMANENT ACCESS TO SMOKE DETECTOR. PROVIDE AND INSTALL REMOTE TEST SWITCH FOR ALARM THAT IS ACCESSIBLE WHILE STANDING ON THE FLOOR. COORDINATE WITH ELECTRICAL CONTRACTOR FOR POWER CONNECTIONS TO ALL MECHANICAL EQUIPMENT.
- LANDLORD SHALL PROVIDE AND INSTALL NEW ROOF MOUNTED EXHAUST FAN WITH SPEED CONTROLLER (SEE SCHEDULE THIS SHEET) PER MANUFACTURER'S RECOMMENDATION. PROPERLY SEAL AROUND ALL ROOF PENETRATIONS. EXTEND EXHAUST DUCT FROM EACH GRILLE WITH BACKDRAFT DAMPER TO MAIN EXHAUST DUCT CONNECTING TO EF-1 ON ROOF. FAN SHALL BE 10' MINIMUM FROM ANY AIR INTAKE. VERIFY EXACT LOCATION IN THE FIELD. SEE CONTROLS AND OPERATION FOR FAN ON SHEET M001. BALANCE PER STARBUCKS DESIGN GUIDELINES.
- LANDLORD SHALL PROVIDE AND INSTALL TEMPORARY THERMOSTAT AND WALL MOUNTED SENSOR FOR CONTROL OF RTU-1. MOUNT THERMOSTATS AT 44" A.F.F. AT MANAGER'S DESK. COORDINATE EXACT LOCATION WITH OWNER. MOUNT SENSORS AT 60" A.F.F. COORDINATE LOCATIONS WITH OTHER ELEMENTS. VERIFY EXACT LOCATIONS IN FIELD. REFER TO LANDLORD WORK LETTER, MECHANICAL NOTES AND MECHANICAL SCHEDULE. MULTIPLE THERMOSTATS SHALL BE STACKED IN A VERTICAL CONFIGURATION WITH A MINIMUM 8" CLEARANCE BELOW EACH
- M04 UNDERCUT RESTROOM DOOR 1" TO PROVIDE MAKE UP AIR. IF LOCAL CODE DOES NOT ALLOW UNDERCUT, PROVIDE A DOOR LOUVER SIZED FOR 160 CFM AT A VELOCITY OF 300 FPM.
- M05 DIRECT VENT CLOSED COMBUSTION AND FLUE PVC LINES FROM WATER HEATER UP THROUGH ROOF. TERMINATE WITH CONCENTRIC VENT KIT PER MANUFACTURER'S RECOMMENDATIONS. MAINTAIN 10' MINIMUM FROM OUTLET TO ANY AIR INTAKE. SEE DETAIL ON SHEET M501.
- M06 LANDLORD SHALL PROVIDE AND INSTALL 48" HEATED AIR CURTAIN OVER DRIVE THRU WINDOW. UNIT SHALL BE EQUAL TO READY ACCESS SERIES AA300, 208/240 V, 1 PH, 32 AMPS, 7.1 KW HEATER.
- M07 G.C. TO PROVIDE AND INSTALL VENSTAR THERMOSTATS AND REMOTE SENSORS TO REPLACE EXISTING CONTROLS PROVIDED BY LANDLORD AND HVAC CONTRACTOR. COORDINATE COMMISSIONING WITH VENSTAR PER STARBUCKS GUIDELINES. SEE EMS DETAILS ON SHEET M502.
- REMOTE CONDENSING UNIT FOR ICE MACHINE MOUNTED ON ROOF. ROUTE REFRIGERATION PIPING DOWN TO MATCHING INDOOR UNIT AND MAKE ALL CONNECTIONS PER MANUFACTURER'S RECOMMENDATIONS.



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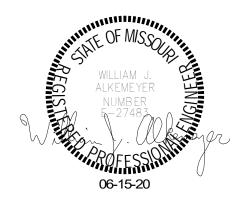
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120-20



-IPMAN

STORE #: 62012 PROJECT#: 87799-001 ISSUE DATE: 06-16-2020 SR. DESIGN MANAGER: K. GORIN SLONSKI PRODUCTION DESIGNER: A. HAHN

Revision	Schedule

DMC

Description


MECHANICAL DESIGN

CHECKED BY:

PLAN SCALE: AS SHOWN

SHEET NUMBER:

M101

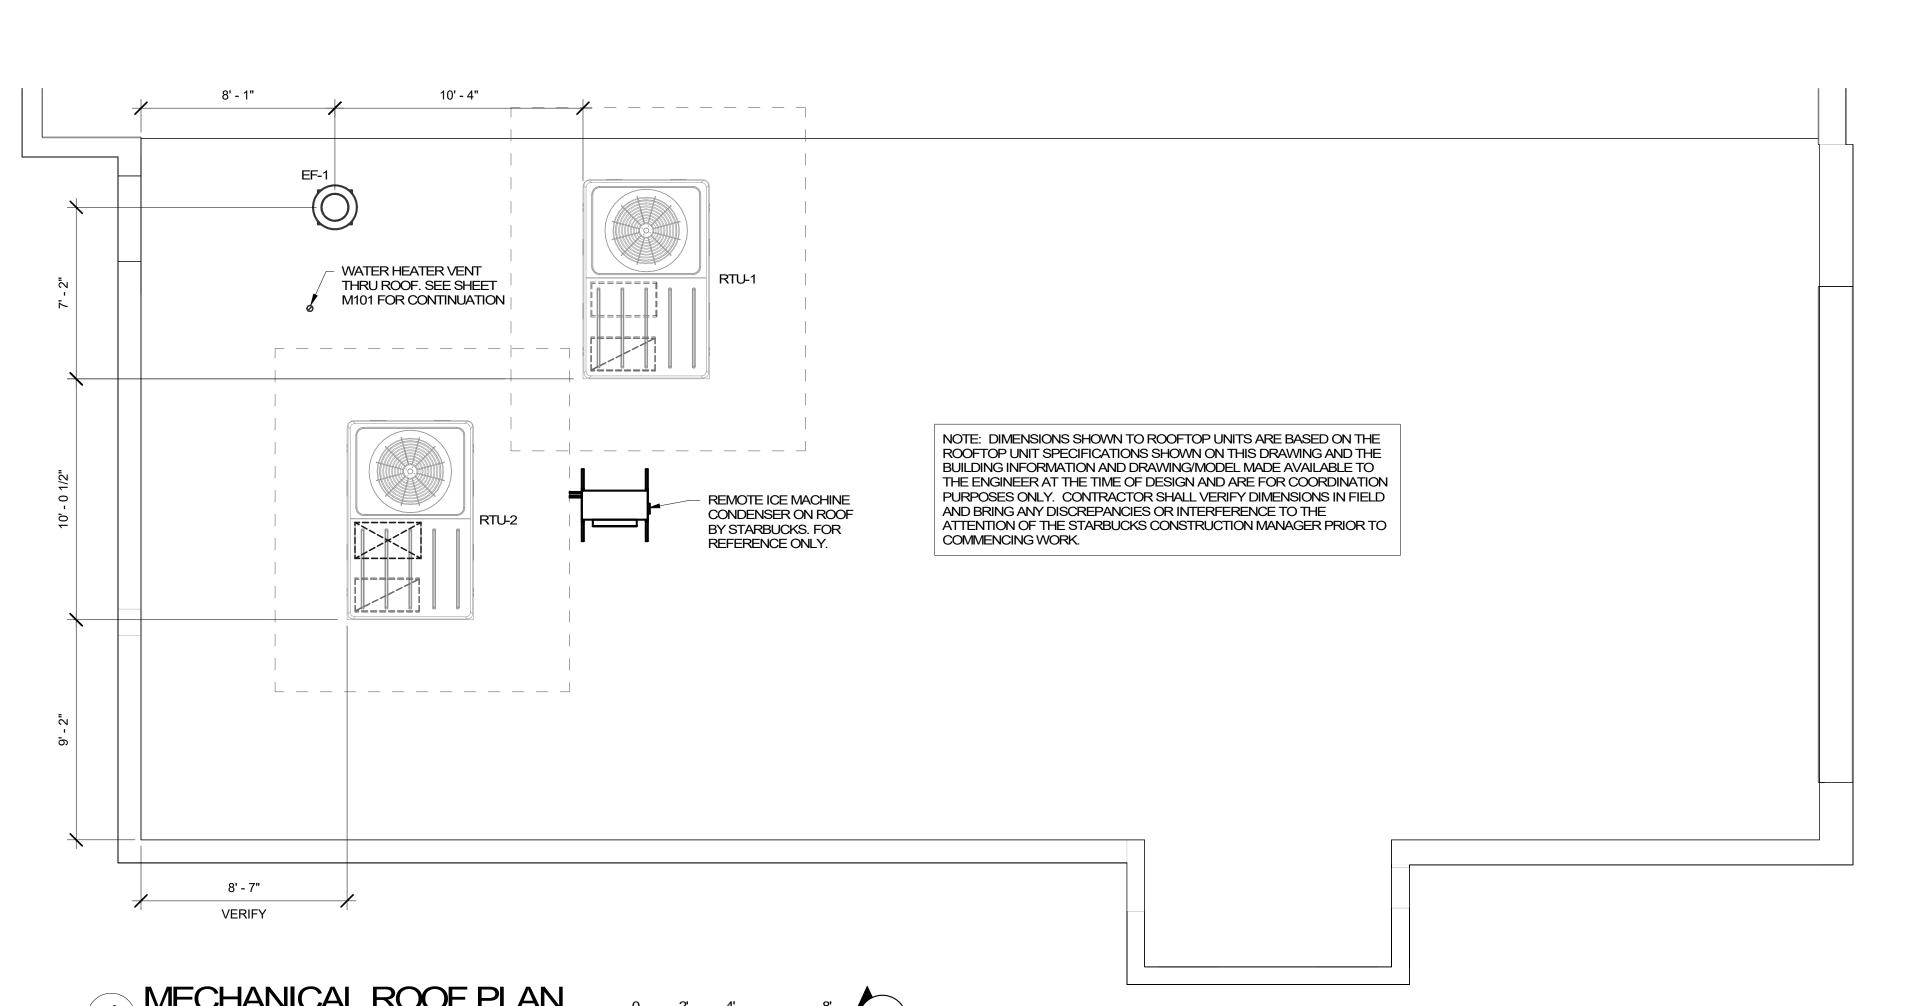



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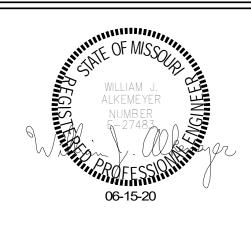
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STORE #: 62012 87799-001 PROJECT#:

ISSUE DATE: 06-16-2020
SR. DESIGN MANAGER: K. GORIN SLONSKI
PRODUCTION DESIGNER: A. HAHN
CHECKED BY: DMC

Revision Schedule

MECHANICAL ROOF PLAN SCALE: AS SHOWN


SHEET NUMBER:

M102

1 MECHANICAL ROOF PLAN
1/4" = 1'-0"




	DES	IGN COOLING	DES	IGN HEATING			
	COOLING DATA A	T Aug 1400		HEATING DATA AT DES HTG			
	COOLING OA DB /	WB 95.4 °F / 7	4.9 °F	HEATING OA DB /	WB -1.0 °F / -2.	5 °F	
ZONE LOADS	Details	Sensible (BTU/hr)	Latent (BTU/hr)	Details	Sensible (BTU/hr)	Later (BTU/h	
Window & Skylight Solar Loads	310 ft ²	14592	_	310 ft ²	-	387701/1/2014	
Wall Transmission	1017 ft²	1199	_	1017 ft²	3263		
Roof Transmission	1981 ft²	7106	-	1981 ft²	6834		
Window Transmission	310 ft ²	2744	_	310 ft ²	11445		
Skylight Transmission	0 ft²	0	_	0 ft²	0		
Door Loads	37 ft²	806	-	37 ft²	976		
Floor Transmission	1981 ft²	0	1	1981 ft²	2613		
Partitions	0 ft²	0	-	0 ft²	0		
Ceiling	0 ft²	0	0.2	0 ft²	0		
Overhead Lighting	1585 W	5407		0	0		
Task Lighting	0 W	0	-	0	0		
Electric Equipment	0 W	0	-	.0	0		
People	40	7562	7080	0	0		
Infiltration	14	0	0	H	0		
Miscellaneous		53953	7554		0		
Safety Factor	10% / 10%	9337	1463	0%	0		
>> Total Zone Loads		102705	16097	_	25132	ı.	
Zone Conditioning	37	105595	16097	-	24998		
Plenum Wall Load	0%	0	4	0	0		
Plenum Roof Load	0%	0	4	.0	.0		
Plenum Lighting Load	0%	0	(2)	0	0		
Return Fan Load	5846 CFM	0	-	5846 CFM	0		
Ventilation Load	723 CFM	14481	12207	723 CFM	53205		
Supply Fan Load	5846 CFM	0	-	5846 CFM	0		
Space Fan Coil Fans	1=	0	-	+	0		
Duct Heat Gain / Loss	0%	0	-	0%	0		
>> Total System Loads	V+	120076	28305	-	78203		
Central Cooling Coil		120076	28307		0		
Central Heating Coil		0	4		78203		
>> Total Conditioning	(8)	120076	28307	-	78203		
Key:		alues are clg lo values are htg lo			values are htg lo values are clg lo		

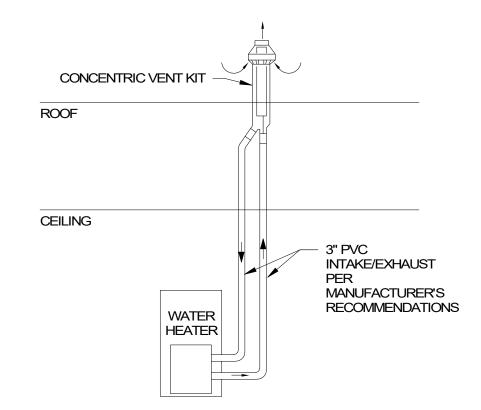

5 WATER HEATER VENT DETAIL SCALE: NTS

BOLT

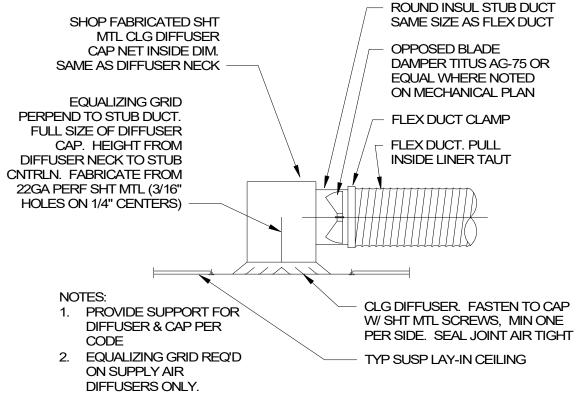

EXPANSION INSERT & BOLT BOTTOM OF DUCT & FASTEN

HANGER \LOW/ STRAP **PRESSURE** SELF TAPPING / DUCT SCREWS DUCT SIZE HANGER SIZE MAX SPACING FOR DUCTS OVER 48" WIDE, TURN UNDER UP THRU 2 SF 1" x 1/16" 2 THRU 4 SF 1" x 1/8" 4 THRU 10 SF 1" x 1/8" 6'-0" OVER 10 SF 1" x 1/8" 4'-0"

DUCT HANGING DETAIL

FOR DAMPER ATTACHED TO 1/4" SPONGE ROOFTOP AIR HANDLING UNIT AS RUBBER GASKET ALL AROUND FLASH AND COUNTERFLASH PENETRATION, TYP. FLASHING AND COUNTER FLASHING ROOF CURB COORDINATE WITH LANDLORD FOR APPLICATION OF ROOFING AT AREAS OF NEW WORK FACTORY CURB SUPPLIED WITH FRAMING ALL AROUND FRAMING SUPPORT BACKDRAFT → PENETRATIONS DAMPER - REFER TO MECH PLAN FOR DUCT USE SAME CURB AND FLASHING ARRANGEMENT FOR ROOF MOUNTED SUPPLY AIR FANS.

SCHEDULED

WATERTIGHT

AIR AND

UNIT

FOR

SIZES, TYP.

SUPPORT ANGLE

CURB

ROOFTOP UNIT DETAIL

- CONDENSATE

DRAIN, SEE PLBG DWGS.

FLEXIBLE

CONNECTION TYPICAL

ROOF MOUNTED EXHAUST FAN DETAIL

ROOF MOUNTED

SCREEN

ANCHOR

TO HOOD

CURB

EXHAUST DUCT SEE SCHEDULES FOR

EXHAUST FAN WITH BIRD

CANT STRIP

INSULATION

SCALE: NTS




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HPMAN


STORE #: 62012 PROJECT#: 87799-001 ISSUE DATE: SR. DESIGN MANAGER: K. GORIN SLONSKI PRODUCTION DESIGNER: A. HAHN DMC CHECKED BY:

> **Revision Schedule** Description

MECHANICAL DETAILS


SCALE: AS SHOWN

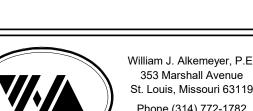SHEET NUMBER: M501

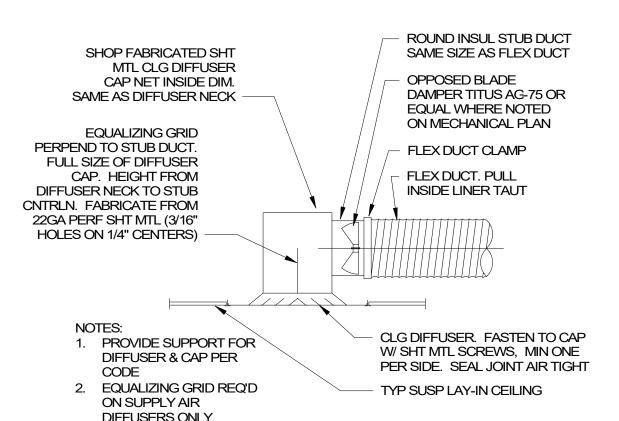

2 LAY-IN DIFFUSER DETAIL SCALE: NTS

SCALE: NTS

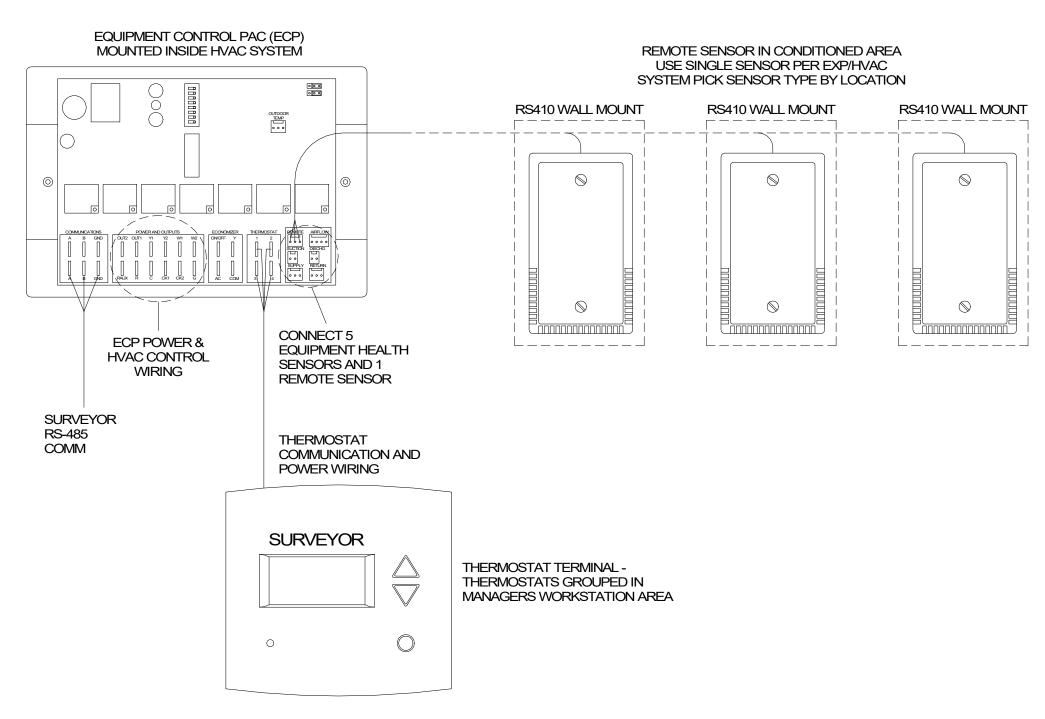


SCALE: NTS

1. OUTDOOR TEMPERATURE SENSOR CONNECTED TO ONE ECP ONLY PER LOCATION.

FACE NORTH WHEN POSSIBLE. 2. SEE GENERAL NOTES 7 AND 8 FOR REMOTE SENSOR MOUNTING LOCATION DETAILS.

Venstar EMS - No Lighting Control - HVAC Controls

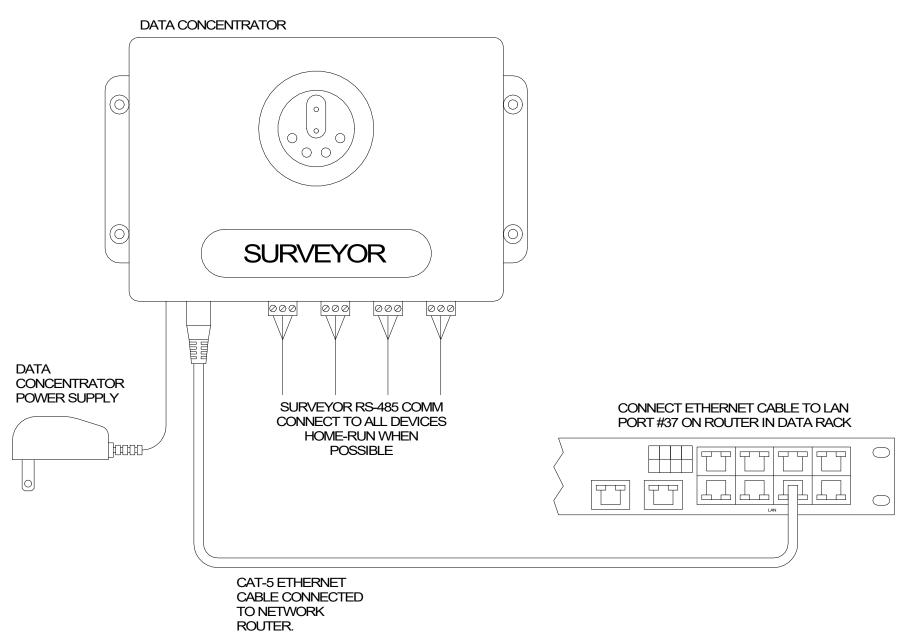

Venstar EMS - No Lighting Control - Data


2 Concentrator

Venstar EMS - No Lighting Control - Basic Low Voltage Wire Runs SCALE: NTS

GENERAL NOTES

- 1. SURVEYOR ENERGY MANAGEMENT SYSTEM HARDWARE IS SUPPLIED BY STARBUCKS.
- 2. DRAWING FOR GENERAL INFORMATION, DESIGN INTENT, AND COORDINATION ONLY.
- 3. LOCAL BUILDING CODES TAKE PRECEDENCE OVER THIS DOCUMENT.
- 4. NOT ALL WIRING IS SHOWN ON THIS DRAWING. FOR CLARITY, ONLY ONE EXAMPLE OF EACH TYPE OF DEVICE IS SHOWN.
- 5. REFER TO THE SURVEYOR INSTALLATION INSTRUCTIONS FOR EACH COMPONENT FOR DETAILED WIRING AND ADDITIONAL CRITICAL INFORMATION.
- 6. CAUTION! INSTALLATION REQUIRES THE REMOVAL OF SAFETY COVERS AND EXPOSE THE INSTALLER TO HIGH VOLTAGE AND ELECTRICAL HAZARDS. USE OF A LICENSED ELECTRICIAN IS REQUIRED. FOLLOW ALL APPROPRIATE SAFETY PRECAUTIONS. ADDITIONAL SAFETY INFORMATION IS IN THE SURVEYOR INSTALLATION MANUALS.
- 7. WALL MOUNTED REMOTE SENSOR IS MOUNTED ON WALL 4 TO 5 FT AFF. AVOID AREAS WITH DIRECT AIRFLOW FROM SUPPLY REGISTERS.
- 8. USE A DROP DOWN SENSOR IF A WALL MOUNT SENSOR CANNOT BE INSTALLED DUE TO SPACE CONSTRAINTS (SEE NOTE 7 FOR REQUIREMENTS). THE SENSOR CLIPS TO THE T-BAR GRID AND ADJUSTED SO THE BOTTOM OF THE SENSOR IS 8 TO 9 FT AFF. ALLOW 2 FT OF CLEARANCE FROM METRO SHELVING AND AVOID AREAS WITH DIRECT AIRFLOW FROM SUPPLY REGISTERS.
- 9. FOR SURVEYOR EMS TECHNICAL SUPPORT AND SYSTEM COMMISSIONING, CONTACT SURVEYOR TECHNICAL SUPPORT, (855) 647-7660, OPTION 1 OR EMAIL INSTALLSUPPORT@VENSTAR.COM. HOURS 6:00 AM TO 8:00 PM PACIFIC, MON-FRI.

SURVEYOR EMS COMPONENTS							
VENSTAR PART	SBUX ITEM#	<u>DESCRIPTION</u>	QUANTITY				
DC400	011029485	DATA CONCENTRATOR	1				
OTS400	011029487	OUTDOOR TEMPERATURE SENSOR	1				
ECP400	011029489	EQUIPMENT CONTROL PAC	1 PER HVAC				
CT414	011029490	COMMUNICATING THERMOSTAT	1 PER HVAC				
SP400	011029491	SENSOR PAC	1 PER HVAC				
RS410	011029492	WALL MOUNT REMOTE SENSOR	1 PER HVAC				

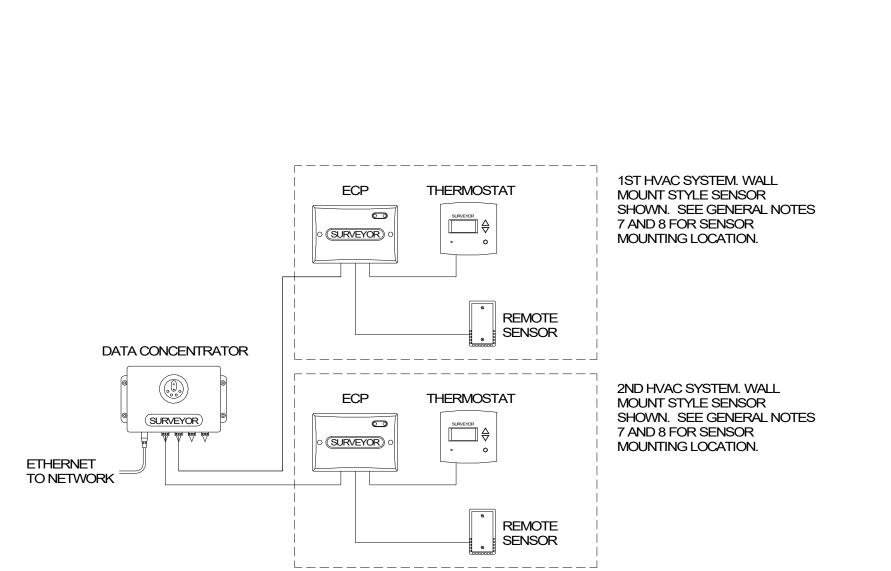

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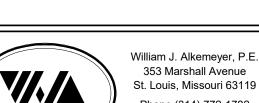
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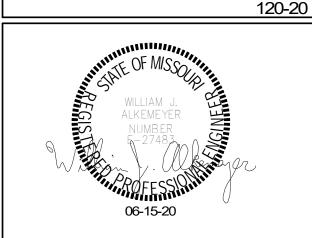


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62012

STORE #: PROJECT#: ISSUE DATE:

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Revision Schedule


Description

EMS DETAILS

SCALE: AS SHOWN

SHEET NUMBER:

M502

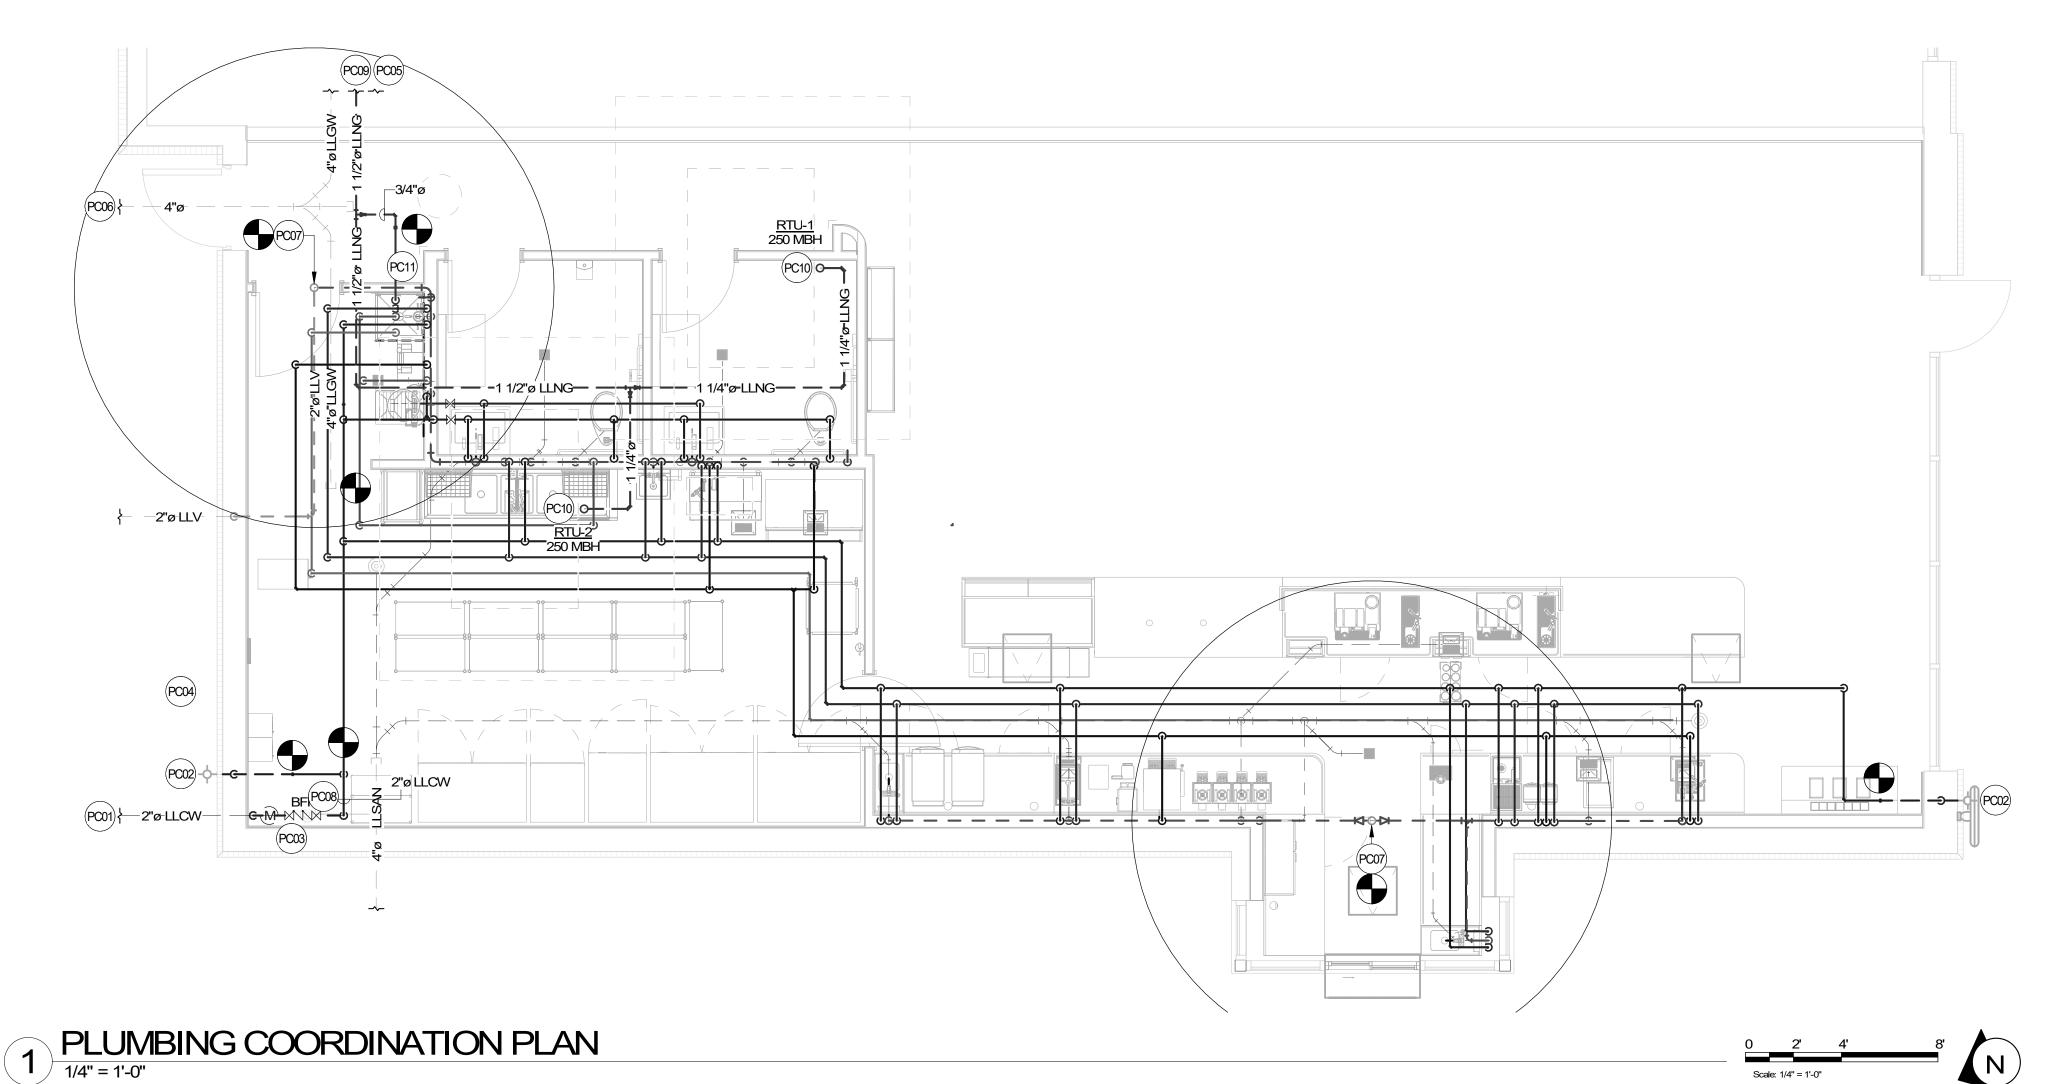

PLUMBING COORDINATION SHEET NOTES

- PC01 LANDLORD TO FURNISH AND INSTALL DOMESTIC WATER SERVICE LOCATION. FURNISH AND INSTALL ONE DOMESTIC WATER SERVICE SIZED PER LOCAL CODE MINIMUM OF 2" AFTER METER, MODIFY TO LARGER SERVICE PER TENANT'S DOCUMENTS FOR MULTI-USER RESTROOMS, AND A METER INDEPENDENTLY DESIGNATED FOR TENANT'S USE, STUBBED VIA COPPER PIPING INTO THE PREMISES WITH SHUT OFF VALVE, EXTENDED FROM THE METER AND STUB UP TO A LOCATION INSIDE TENANT'S SPACE, IN LOCATION IDENTIFIED ON TENANT CONSTRUCTION DOCUMENTS. THE DW SERVICE MUST BE CAPABLE OF PROVIDING A MINIMUM OPERATING FLOW RATE OF 50 GALLONS PER MINUTE; AT A MINIMUM OPERATING PRESSURE OF 50 PSI AND A MAXIMUM OF 65 PSI DYNAMIC PRESSURE AT ALL TIMES. IF FLOW RATE OR PRESSURE IS NOT SUFFICIENT, LANDLORD SHALL ENGINEER, FURNISH AND INSTALL A BOOSTER PUMP IN A LOCATION AGREED UPON WITH THE TENANT. SUBMITTAL ON DESIGNED UNITS SHALL BE DELIVERED TO TENANT FOR REVIEW AND APPROVAL PRIOR TO PURCHASE AND INSTALLATION. SEE CIVIL AND LANDLORD DRAWINGS FOR ADDITIONAL INFORMATION AND CONTINUATION.
- PC02 LANDLORD TO FURNISH AND INSTALL KEYED, FROST-FREE RECESSED HOSE BIB AT THE FRONT AND REAR OF PREMISES. HOSE BIB MUST BE CONNECTED TO 1/2" INSULATED, COPPER PIPE AND RUN WITHIN CONDITIONED SPACE. IT MUST BE EXPOSED AND VISIBLE FOR TENANT'S CONNECTION. VERIFY LOCATION WITH CONSTRUCTION MANAGER.
- PC03 LANDLORD TO FURNISH AND INSTALL AN APPROVED, TESTED AND CERTIFIED BACKFLOW PREVENTION ASSEMBLY IF REQUIRED BY APPLICABLE CODES. LANDLORD SHALL SELECT BACKFLOW PREVENTION ASSEMBLY WITH A MAXIMUM WATER PRESSURE DROP OF 15 PSI AT 50 GPM. SEE LANDLORD'S PLAN FOR LOCATION OF METER AND BACKFLOW PREVENTER IN UTILITY CLOSET.
- PC04 IF REQUIRED, LANDLORD TO PROVIDE AND INSTALL KEYED, FROST-FREE RECESSED HOSE BIB LOCATED INSIDE TRASH ENCLOSURE.
- PC05 SANITARY SEWER (4" MIN) PROVIDED BY LANDLORD. INVERT ELEVATION AT THE FURTHEST POINT OF CONNECTION SHALL BE 27" BELOW FINISHED FLOOR AND MAINTAIN A MINIMUM SLOPE OF 1/4" PER LINEAR FOOT AND SHALL BE PER LOCAL CODE. VERIFY EXACT LOCATION, INVERTS AND REQUIREMENTS ON SITE. SEE LANDLORD DRAWINGS FOR ADDITIONAL INFORMATION.
- PC06 GREASE WASTE LINE (4" MIN) PROVIDED BY LANDLORD. INVERT ELEVATION AT THE FURTHEST POINT OF CONNECTION SHALL BE 27" BELOW FINISHED FLOOR AND MAINTAIN A MINIMUM SLOPE OF 1/4" PER LINEAR FOOT AND SHALL BE PER LOCAL CODE. LANDLORD PROVIDED GREASE WASTE LINE SHALL EXTEND TO A LANDLORD PROVIDED GREASE INTERCEPTOR SIZED PER CODE AND ALL LOCAL REQUIREMENTS. VERIFY EXACT LOCATION, INVERTS AND REQUIREMENTS ON SITE. SEE LANDLORD DRAWINGS FOR ADDITIONAL INFORMATION.
- PC07 LANDLORD TO PROVIDE FURNISH AND INSTALL 4" VENT THROUGH ROOF LOCATION. A MINIMUMOF 10' CLEARANCE TO AIR INTAKES SHALL BE MAINTAINED. VERIFY EXACT LOCATION, SIZE AND REQUIREMENTS ON SITE.
- PC08 VERIFY DRAINAGE OF BACKFLOW PREVENTER AND PROVIDE DRAIN AS REQUIRED.
- PC09 LANDLORD TO DELIVER GAS SERVICE, PER APPLICABLE LOCAL CODES, TO A LOCATION FIVE (5) FEET INSIDE OF THE PREMISES WITH SHUT OFF VALVE AND TEE. THIS SCOPE OF WORK MUST INCLUDE, LOCAL UTILITY APPROVED, PIPING MANIFOLD SIZED AND READY TO RECEIVE UTILITY GAS METER. VERIFY THAT SERVICE IS ADEQUATE TO SUPPLY 600 MBH. ALL GAS PIPE SIZES SHOWN FOR LOW PRESSURE (LESS THAN 2 LBS.). VERIFY EXACT LOCATION, PRESSURE AND REQUIREMENTS ON SITE. SEE CIVIL DRAWINGS FOR ADDITIONAL INFORMATION AND CONTINUATION.
- PC10 1-1/4" GAS TO MECHANICAL RTU-1 & 2 ON ROOF WITH APPROVED SHUT-OFF VALVE & DIRT LEG BY LANDLORD.
- PC11 1" GAS STUB FOR FUTURE WATER HEATER BY TENANT.

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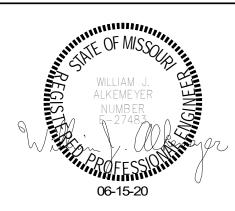




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Engineering Consultant

120-20



STORE #: 62012 PROJECT#:

87799-001 ISSUE DATE: 06-16-2020 SR. DESIGN MANAGER: K. GORIN SLONSKI PRODUCTION DESIGNER: A. HAHN CHECKED BY:

SHEET TITLE: PLUMBING COORDINATION PLAN SCALE: AS SHOWN

SHEET NUMBER:

ABBREVIATIONS

	NEVIATIONS
AFF AHJ APPROX	ABOVE FINISHED FLOOR AUTHORITIES HAVING JURISDICTION APPROXIMATE
BLDG	BUILDING
CLG CO CONST CW CXA	CEILING CLEANOUT CONSTRUCTION DOMESTIC COLD WATER COMMISSIONING AGENT
DEG DN DTL DWG(S)	DEGREES DOWN DETAIL DRAWING(S)
EA EC ELEC EMER EX EXT	EACH ELECTRICAL CONTRACTOR ELECTRICAL EMERGENCY EXISTING EXTERIOR
FCO FD F&I FLR FOIC	FLOOR CLEANOUT FLOOR DRAIN FURNISH & INSTALL FLOOR FURNISHED BY OWNER, INSTALLED BY CONTRACTOR
FOIO	FURNISHED BY OWNER, INSTALLED BY OWNER
FPT FS FT	FEMALE PIPE THREAD FLOOR SINK FOOT/FEET

GT GREASE TRAP GW **GREASE WASTE**

HR HOUR HS **HANDSINK** HEATING, VENTILATION, AND AIR HVAC CONDITIONING

GENERAL CONTRACTOR

GREASE INTERCEPTOR

GROUND FAULT CIRCUIT INTERRUPTER

HOT WATER HOT WATER SUPPLY HWS HOT WATER RETURN HWR

INSIDE DIAMETER LANDLORD LV LOW VOLTAGE

MAX MAXIMUM MC MECHANICAL CONTRACTOR

MECH **MECHANICAL** MEP MECHANICAL, ELECTRICAL, AND PLUMBING MFG MANUFACTURER

MAIN DISTRIBUTION PANEL

MIN MINIMUM MOP SINK

MDP

NTS NOT TO SCALE **OUTSIDE DIAMETER**

PC PLUMBING CONTRACTOR

NIGHTLIGHT

PREP SINK POINT OF CONNECTION

REQ'D REQUIRED REV REVISION

SHEET SQUARE FEET SOW SCOPE OF WORK SPECS SPECIFICATION(S) SST STAINLESS STEEL

TELEPHONE TEMP **TEMPORARY** TMV TEMPERATURE MIXING VALVE TW TEMPERED HOT WATER

TYP TYPICAL UC UNDER COUNTER

UNLESS NOTED OTHERWISE UNO

VENT SANITARY WASTE WCO WALL CLEANOUT WH WATER HEATER WP WEATHER PROOF

YCO **CLEANOUT** (EXTERIOR)

PLUMBING SYMBOL LEGEND

—SAN. OR GW—	SAN. OR GW	SANITARY OR GREASE WASTE PIPING
V	V	VENT PIPING
CD	CD	CONDENSATE DRAIN PIPING
CW	CW	COLD WATER PIPING
HW	HW	HOT WATER PIPING
CWF	CWF	COLD WATER FILTERED PIPING
CWS	CWS	COLD WATER SOFTENED PIPING
TW	TW	TEMPERED WATER PIPING
G	G	GAS PIPING
Ŵ	BV	BALANCING VALVE
\bowtie	SOV	SHUT OFF VALVE
- -	HB	HOSE BIBB
<u> </u>	WCO	WALL CLEANOUT
(+)	FCO	FLOOR CLEANOUT
	FD	FLOOR DRAIN (SQUARE)
	FD	FLOOR DRAIN (ROUND)
0	HD	HUB DRAIN
0000000	FS	FLOOR SINK (SQUARE)
(1)	FS	FLOOR SINK (ROUND)
\mathbf{M}	WM	WATER METER
	GM	GAS METER
	BFP	BACKFLOW PREVENTER
	POC	CONNECT TO EXISTING

EXISTING PIPING SHOWN ON PLANS IN A LIGHTER SHADE

SYSTEM COMMISSIONING

CONTRACTOR RESPONSIBILITIES FOR BUILDING COMMISSIONING

CONTRACTOR SHALL PROVIDE SUPPORT AND WORK AS SPECIFIED. NEEDED AND REQUIRED TO CONDUCT AND FACILITATE STARBUCKS STAFF BUILDING COMMISSIONING EFFORTS. THIS WORK WILL BE COMPRISED OF THREE DISTINCT EFFORTS:

1) SUPPORT STARBUCKS COMMISSIONING AGENT (CXA) DURING INSTALLATION VERIFICATION AND CORRECT DISCLOSED

- 2) PERFORM TESTING, ADJUSTING, BALANCING AND SYSTEM STARTUP AND SUPPORT FUNCTIONAL PERFORMANCE TESTING BY STARBUCKS 3) CORRECT DEFICIENCIES DISCLOSED BY FUNCTIONAL PERFORMANCE
- TESTING AND SUBMIT REPORTS. CONTRACTOR SHALL PERFORM AND PROVIDE THE FOLLOWING:
- A. SYSTEMS SUBJECT TO COMMISSIONING MAY INCLUDE, BUT ARE NOT LIMITED TO, DOMESTIC HOT WATER GENERATION.
- B. CONTRACTOR SHALL INCLUDE COMMISSIONING ACTIVITIES IN PROJECT SCHEDULE AND SHOW INTERVALS FOR PERFORMANCE OF WORK FOR WHICH CONTRACTOR IS RESPONSIBLE AND INTERVALS FOR WORK PERFORMED BY STARBUCKS CXA. CONTRACTOR SHALL SHOW RESOURCES FOR PERFORMING ALL WORK RELATED TO COMMISSIONING ACTIVITIES ON A LINE ITEM IN THE SCHEDULE OF VALUES.
- C. CONTRACTOR SHALL INSTALL EQUIPMENT IN ACCORDANCE WITH THE MANUFACTURER'S REQUIREMENTS AND ALL CONTRACT DOCUMENTS. ENSURE THAT ALL EQUIPMENT IS INSTALLED TOTALLY COMPLETE, AND ACCESSIBLE TO STARBUCKS CXA FOR INSTALLATION VERIFICATION AND FUNCTIONAL PERFORMANCE TESTING PRIOR TO THE SCHEDULED START OF INSTALLATION VERIFICATION.
- D. INSTALLATION VERIFICATION SHALL BE PERFORMED BY STARBUCKS CXA. CONTRACTOR SHALL SUPPORT STARBUCKS CXA INSTALLATION VERIFICATION EFFORTS AS NECESSARY. PROVIDE ALL ACCESS AND EQUIPMENT NECESSARY FOR STARBUCKS STAFF TO VERIFY THAT THE EQUIPMENT IS INSTALLED CORRECTLY.
- E. CONTRACTOR SHALL BE READILY AVAILABLE DURING INSTALLATION VERIFICATION TO CORRECT ANY DEFICIENCIES OR DEFECTS DISCLOSED BY THE INSTALLATION VERIFICATION PROCESS. CORRECTIONS SHALL BE MADE IN A TIMELY MANNER WITHOUT DISRUPTION OF THE CONSTRUCTION SCHEDULE.
- F. ALL DOMESTIC WATER HEATING, RECIRCULATING, FILTER AND SOFTENING EQUIPMENT SHALL BE TESTED AND/OR ADJUSTED AND BALANCED BY THE CONTRACTOR'S TESTING, ADJUSTING AND BALANCE AGENT (SEE TESTING ADJUSTING AND BALANCING) OR THE MANUFACTURER'S CERTIFIED STARTUP REPRESENTATIVE AFTER THE SYSTEM IS VERIFIED TO BE COMPLETE AND CORRECT BY STARBUCKS CXA IN ACCORDANCE WITH THE REQUIREMENTS OF THESE DOCUMENTS. SEQUENCES OF OPERATION SHALL BE TESTED TO ENSURE THAT THEY OPERATE IN ACCORDANCE WITH THE CONTRACT REQUIREMENTS. DELIVERABLES: PRELIMINARY, WRITTEN FUNCTIONAL PERFORMANCE REPORT CONFORMING TO THE REQUIREMENTS SPECIFIED HEREIN, DOCUMENTING THE INFORMATION SPECIFIED, ETC. TO THE STARBUCKS CXA IMMEDIATELY UPON COMPLETION OF THE WORK.
- G. CONTRACTOR SHALL INFORM STARBUCKS CXA WHEN EQUIPMENT IS READY FOR FUNCTIONAL PERFORMANCE TESTING. ALL EQUIPMENT SHALL BE READY FOR FUNCTIONAL PERFORMANCE TESTING PRIOR TO STARTING TESTING. CONTRACTOR SHALL OPERATE EQUIPMENT FOR STARBUCKS CXA AND VERIFY BY DEMONSTRATION THE CORRECT OPERATION OF EQUIPMENT, RESPONSE OF SENSORS, AND PROPER EXECUTION OF HVAC CONTROL AND LIGHTING SEQUENCES: INCLUDING BUT NOT LIMITED TO, AIR MOVEMENT, TEMPERATURE, SOUND, AND CONTROL RESPONSE. PROVIDE ANY SECURIT ACCESS, HARDWARE, SOFTWARE, OR OTHER SUPPORT AS NEEDED FOR THE STARBUCKS CXA TO EFFICIENTLY WITNESS AND DOCUMENT ALL EQUIPMENT TESTING. STARBUCKS CXA WILL RECORD THE EQUIPMENT OPERATION AND RESPONSE TO TESTING SEQUENCES AND PREPARE A LIST OF ANY DEFICIENCIES DISCLOSED BY THE FUNCTIONAL PERFORMANCE TESTS FOR CORRECTION BY THE CONTRACTOR. EQUIPMENT INCLUDES, BUT IS NOT LIMITED TO, AIR HANDLING UNITS, ROOFTOP AND SPLIT TYPE, CONDENSING UNITS, EXHAUST FANS, LIGHTING CONTROLS, ETC. DELIVERABLES: PROVIDE COMPLETED COPIES OF ALL START UP REPORTS, FILLED OUT ON THE MANUFACTURER'S FORMS. TO THE STARBUCKS CXA.
- H. CONTRACTOR IS RESPONSIBLE FOR CORRECTING ANY ISSUES. OR DEFICIENCIES DISCLOSED DURING THE FUNCTIONAL PERFORMANCE TESTING PROCESS. CORRECTIONS SHOULD BE MADE IN A TIMELY MANNER WITHOUT DISRUPTION TO THE SYSTEM AND CONSTRUCTION SCHEDULE.
- I. CONTRACTOR SHALL BE READILY AVAILABLE FOR ANY RE-TESTING OF EQUIPMENT DEEMED NECESSARY BY STARBUCKS CXA DURING INSTALLATION VERIFICATION AND FUNCTIONAL PERFORMANCE TESTING. CONTRACTOR IS RESPONSIBLE FOR CORRECTING ANY ISSUES OR DEFICIENCIES FOUND IN THE SYSTEM DURING ANY AND ALL RE-TESTING. CORRECTIONS SHOULD BE MADE IN A TIMELY MANNER WITHOUT DISRUPTION TO THE SYSTEM AND CONSTRUCTION SCHEDULE. DELIVERABLES: FINAL BALANCE REPORT, DEFICIENCIES LIST NOTING CORRECTIVE ACTIONS PERFORMED BY CONTRACTOR IN RESPONSE TO INSTALLATION VERIFICATION AND FUNCTIONAL PERFORMANCE TEST RESULTS.
- J. CONSTRUCTION AND POST CONSTRUCTION TESTING: ADDITIONAL TESTING MAY BE REQUIRED BY LEED AND OTHER PROCESSES THAT MAY OCCUR OUT OF SEQUENCE WITH COMMISSIONING SERVICE. CONTRACTOR SHALL CONDUCT, DOCUMENT, SUPPORT AND SCHEDULE THIS TESTING AS DIRECTED BY STARBUCKS CXA.

VALVES

INSTALL VALVES FOR EACH FIXTURE AND ITEM OF EQUIPMENT. PROVIDE BRAIDED STAINLESS STEEL HOSE (UNLESS OTHERWISE NOTED) BETWEEN VALVE AND EQUIPMENT IN ACCORDANCE WITH MANUFACTURER'S SPECIFICATIONS. LOCATE SHUT-OFF VALVES ADJACENT TO EQUIPMENT FOR EASY ACCESS SUCH THAT VALVES CAN BE REACHED WITHOUT MOVING EQUIPMENT. SHUT OFF VALVES TO BE BALL TYPE. VALVES SHALL BE LISTED/APPROVED FOR USE PER AUTHORITIES HAVING JURISDICTION (AHJ) AND CODE REQUIREMENTS. PROVIDE VALVE IDENTIFICATION PER THE PROJECT MANUAL FOR MAIN WATER SERVICE SHUT-OFF AND ANY OTHER VALVES WHICH ARE NOT CLEARLY EVIDENT WHAT THEY SERVE.

PLUMBING FIXTURES

SIZE WATER HEATER PER STARBUCKS STANDARD AND PER AUTHORITIES HAVING JURISDICTION (AHJ), WHICHEVER IS MORE STRINGENT. PROVIDE INSTALLATION COMPLETE WITH FITTINGS AS SHOWN IN THE DRAWINGS. SET HOT WATER TEMPERATURE AT 140° F OR ADJUST AS REQUIRED BY AHJ. PROVIDE THERMOMETER ON HOT WATER PIPE LEAVING WATER HEATER.

STARBUCKS WATER FILTRATION VENDOR WILL PROVIDE FILTRATION SYSTEM. CONTRACTOR SHALL CONFIRM WITH STARBUCKS CONSTRUCTION MANAGER WHETHER VENDOR OR PLUMBING CONTRACTOR IS TO INSTALL FILTRATION SYSTEM. PROVIDE AND COORDINATE INSTALLATION COMPLETE WITH ALL PIPING, FITTINGS, AND EQUIPMENT AS INDICATED ON THE DRAWINGS.

THE PLUMBING CONTRACTOR SHALL MAKE ALL FINAL CONNECTIONS TO EQUIPMENT INCLUDING REQUIRED MATERIAL SUCH AS PIPING, VALVES, FILTERS, TRAPS, CHECKS VALVES, VACUUM BREAKERS, AND FLEXIBLE AND

SCHEDULES

REFER TO SCHEDULES ON DRAWINGS FOR A DESCRIPTION OF LISTED ITEMS AND FURNISH ANY AND ALL PLUMBING FIXTURES LISTED AS "GC". ANY DISCREPANCIES ABOUT WHO IS TO PROVIDE PLUMBING FIXTURES IN THE SCHEDULE SHALL BE BROUGHT TO STARBUCKS ATTENTION FOR CLARIFICATION. INSTALL ALL FIXTURES LISTED REGARDLESS OF WHO SUPPLIES.

G.C. TO FURNISH AND INSTALL POWER CORD FOR DISHWASHER PER JURISDICTIONAL REQUIREMENTS. IF EQUIPMENT IS SPECIFIED AS HOBART ADVANSYS, THE UNIT IS TO BE PLUMBED WITH COLD, NON-FILTERED WATER. IF THE WATER FILTRATION SYSTEM IS A PENTAIR. CONFIGURATION II OR III, THEN THE COLD, NON-FILTERED WATER MUST ALSO BE SOFTENED.

INSULATION

PROVIDE THERMAL INSULATION PER THE SPECIFICATIONS.

FURNISH AND INSTALL SPECIFIED NO SCALD SAFETY COVERS WITH INSULATED FOAM LINER AND TAMPER PROOF STRAP AT ALL EXPOSED ADA SINK P-TRAPS AND WATER SUPPLIES AND AS REQUIRED BY JURISDICTION

PIPING

CONDENSATE DRAINAGE PIPING

THE PLUMBING CONTRACTOR SHALL PROVIDE CONDENSATE DRAINS FOR AIR HANDLING UNITS AND STARBUCKS EQUIPMENT (REFER TO COPPER TUBING WITH WROUGHT COPPER SWEAT FITTINGS JOINED WITH 50/50 SOLDER.

ALL PIPES SHALL BE TESTED BY AN APPROVED METHOD BEFORE THEY BACKFILLED OR CONCEALED. AFTER TESTING IS COMPLETE, THE

PLUMBING CONTRACTOR SHALL DISINFECT THE POTABLE WATER SYSTEM AS REQUIRED BY LOCAL AUTHORITY. TEST WATER PURITY ACCORDING TO LOCAL REQUIREMENTS AND SUBMIT CERTIFIED TEST RESULTS TO ENGINEER FOR REVIEW AND APPROVAL

CARBONATION

IF APPLICABLE TO PROJECT SCOPE FOR CBE STATION, STARBUCKS CARBONATION VENDOR WILL PROVIDE AND INSTALL EQUIPMENT, CO2 TANKS AND FITTINGS. STARBUCKS SHALL PROVIDE AND CONTRACTOR SHALL INSTALL CO2 TANK MOUNTING BRACKET, PROTECTIVE SHELVING UNIT AND CO2 GAS TUBING AS SHOWN ON DRAWINGS AND PER MANUFACTURER'S INSTRUCTIONS. MAXIMUM TUBING LENGTH INCLUDING COILED ENDS IS 100 FT (30 M) AND MAXIMUM BEND IS TO 3 INCH (75 MM) MINIMUM RADIUS. ROUTE CO2 TUBING PREFERABLY THROUGH WALL AND/OR CEILING CAVITIES, WITHOUT KINKS AND SO AS TO NOT TOUCH ANY HOT SURFACE (BALLAST, STEAM PIPE, ETC.) OR RUB AGAINST A SHARP EDGE THAT MAY ABRADE OR CUT TUBING. ALL HOLES MUST BE SEALED WITH A GROMMET OR ESCUTCHEON. TUBING IS TO BE SECURED TO APPROPRIATE PERMANENT SURFACES TO KEEP IT OFF THE FLOOR OR CABINET BOTTOMS AND AWAY FROM OTHER EQUIPMENT. LABEL BOTH ENDS OF TUBING AND REGULARLY AT TEN (10) FOOT INTERVALS ALONG ROUTE AS "CO2."

NITROGENATION

STARBUCKS NITROGENATION VENDOR WILL PROVIDE AND INSTALL EQUIPMENT AND FITTINGS IF APPLICABLE TO PROJECT SCOPE FOR NITRO STATION. GENERAL CONTRACTOR SHALL COORDINATE NITRO SYSTEM INSTALLATION WITH STARBUCKS VENDOR.

GENERAL PLUMBING NOTES

- 1. PLUMBING CONTRACTOR SHALL COORDINATE WITH THE GENERAL CONTRACTOR TO PATCH AND REPAIR ALL EXISTING WALLS, FLOORS, CEILINGS OR OTHER SURFACES IDENTIFIED TO REMAIN THAT MAY BECOME DAMAGED DURING THE COURSE OF WORK.
- 2. EXPOSED/SURFACE MOUNTED PIPING IS ONLY ALLOWED IN THE BAR AREA UNDER COUNTERTOPS, WHERE IT DOES NOT OBSTRUCT CABINETS/DEVICES AND WHERE APPROVED BY STARBUCKS CONSTRUCTION MANAGER. IF ROUTED THROUGH CABINETS, IT SHALL BE ROUTED TO MAXIMIZE STORAGE SPACE AND BE PROTECTED FROM DAMAGE.
- 3. DRAWINGS ARE DIAGRAMMATIC AND INDICATE GENERAL INTENT OR ARRANGEMENT OF SYSTEM(S). FURNISH AND INSTALL ALL COMPONENTS NEEDED WHETHER INDICATED OR NOT TO PROVIDE A COMPLETE AND OPERATING SYSTEM. OVERALL CASEWORK COMPONENT DIMENSIONING ON PLUMBING DETAILS ARE SHOWN FOR REFERENCE AND COORDINATION ONLY.
- 4. CONTRACTOR TO VERIFY ALL DIMENSIONS, INCLUDING CLEARANCES REQUIRED BY OTHER TRADES, AND NOTIFY STARBUCKS CONSTRUCTION MANAGER OF ANY DISCREPANCIES PRIOR TO PROCEEDING WITH THE WORK. ALL DIMENSIONS ARE TO THE FACE OF THE FINISHED SURFACE UNLESS NOTED OTHERWISE. ALL DIMENSIONS TO BE TAKEN FROM ACTUAL BUILDING DIMENSIONS.
- THE PLUMBING CONTRACTOR SHALL COORDINATE PLUMBING WORK WITH OTHER TRADES. THE ARCHITECTURAL DRAWINGS AND SPECIFICATIONS SHALL TAKE PRECEDENCE OVER ALL OTHER DRAWINGS. SEE ARCHITECTURAL DRAWINGS FOR FIXTURES IN CASEWORK AND PLUMBING DETAILS. SEE THE PROJECT MANUAL FOR PLUMBING SPECIFICATION SECTIONS.
- 6. ALL PIPING AND/OR PLUMBING DEVICES SHALL BE SUPPORTED FROM STRUCTURE (NOT FROM HVAC DUCTS OR OTHER PIPES/CONDUITS).
- 7. WHEN BUNDLING SEVERAL INDIRECT WASTE LINES TO DRAIN INTO FLOOR SINK, A UNISTRUT IS REQUIRED FOR SECURING AND BRACING ALL LINES ABOVE THE DRAIN.
- 8. FURNISH AND INSTALL ALL NEEDED DRAIN LINES PER CODE (NOT ALL SHOWN). INSTALL DRAINS AT 2% SLOPE WHERE POSSIBLE WITHOUT DIPS OR SAGS. ALL INDIRECT DRAINS SHALL RUN SEPARATELY FROM EACH OTHER TO INDIRECT DRAIN RECEPTOR AND SHALL TERMINATE WITH AN AIR GAP PER CODE.
- 9. FURNISH AND INSTALL WALL CLEANOUTS AT ALL SINKS AND AS NEEDED PER CODE (NOT ALL SHOWN).
- 10. INSULATE ICE BIN DRAINAGE PIPES PER THE REQUIREMENTS IN THE PROJECT MANUAL

GENERAL NOTES

THE INTENT OF THE PROJECT MANUAL AND THE DRAWINGS IS TO PROVIDE A COMPLETE AND FULLY OPERATIONAL PLUMBING SYSTEM. THE CONTRACTOR SHALL FURNISH ALL LABOR, MATERIAL, AND EQUIPMENT RELATED TO THE INSTALLATION OF THE PLUMBING WORK.

THE CONTRACTOR SHALL THOROUGHLY EXAMINE ALL AREAS WHERE FIXTURES, EQUIPMENT, AND PIPING WILL BE INSTALLED AND WILL REPORT ANY CONDITION THAT PREVENTS THE PROPER INSTALLATION OF THE PLUMBING WORK.

EQUIPMENT AND MATERIALS SHALL CONFORM WITH THE APPROPRIATE PROVISIONS OF LISTING STANDARD IN EFFECT AS APPLICABLE TO EACH INDIVIDUAL UNIT OR ASSEMBLY.

ALL WORK SHALL BE PERFORMED IN STRICT ACCORDANCE WITH ALL APPLICABLE PROVINCIAL AND LOCAL CODES AND ORDINANCES. IN CASE OF CONFLICT BETWEEN THE DRAWINGS AND SPECIFICATIONS AND THE CODES AND ORDINANCES. THE HIGHEST STANDARD SHALL APPLY. THE CONTRACTOR SHALL SATISFY CODE REQUIREMENTS AS A MINIMUM STANDARD WITHOUT ANY EXTRA COST TO STARBUCKS.

THE CONTRACTOR SHALL PROCURE AND PAY FOR ALL PERMITS, FEES, AND INSPECTIONS NECESSARY TO COMPLETE THE PLUMBING WORK.

THE CONTRACTOR SHALL UNCONDITIONALLY WARRANT ALL WORK TO BE FREE OF DEFECTS IN MATERIAL AND WORKMANSHIP FOR A PERIOD OF ONE (1) YEAR FROM THE DATE OF FINAL ACCEPTANCE BY STARBUCKS AND WILL REPAIR OR REPLACE ANY DEFECTIVE WORK PROMPTLY AND WITHOUT CHARGE AND RESTORE ANY OTHER EXISTING WORK DAMAGED IN THE COURSE OF REPAIRING DEFECTIVE MATERIALS AND WORKMANSHIP.

LANDLORD REQUIREMENTS

PRIOR TO BID: THE CONTRACTOR SHALL COORDINATE WITH LANDLORD / BUILDING OWNER FOR ANY CONSTRUCTION REQUIREMENTS. CONTRACTOR SHALL BECOME COMPLETELY FAMILIAR WITH REQUIREMENTS AND ADHERE TO THEM. WHERE LANDLORD / BUILDING OWNER REQUIREMENTS ARE MORE STRINGENT THAN SHOWN IN THESE PLANS. LANDLORD / BUILDING OWNER REQUIREMENTS SHALL GOVERN.

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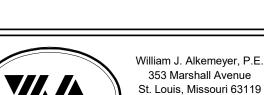
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CONDITIONS. NEITHER PARTY SHALL HAVE ANY OBLIGATION

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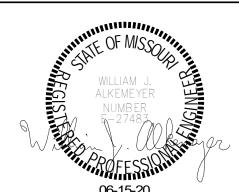
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87799-001 06-16-2020 SR. DESIGN MANAGER: K. GORIN SLONSKI PRODUCTION DESIGNER: A. HAHN SMD/SWE

62012

Revision Schedule

Description

PLUMBING NOTES

SCALE: AS SHOWN SHEET NUMBER:

CROSS CONNECTI	ON CC	NTROL SO	CHEDULE		
FIXTURE	MAKE	MODEL	ASSE, ASME OR		
T IXTORE		IVIODEL	ANSI STANDARD		
MOP SINK (FAUCET CONTAINS	WATTS &	9DM2-S	ASSE 1012		
INTEGRAL BACKFLOW DEVICE)	INTEGRAL	-	ASSE 1001		
DISHWASHER	WATTS	LF008PCQT	ASSE 1056		
ICE MACHINE	AIR GAP	INTERNAL	ASME A112.1.2		
COFFEE BREWER	WATTS	SD-3	ASSE 1022		
ESPRESSO MACHINE	WATTS	SD-3	ASSE 1022		
WATER FILTER SYSTEM	WATTS	LF009QT	ASSE 1013		
CHEMICAL DISPENSER	WATTS	LF009 W/ AIR GAP	ASSE 1013		
		FITTING 909AGA			
FREEZEPROOF HOSEBIBB	WATTS	LF8	ASSE 1011		
HOSEBIBB FOR CHEM. DISP. @ MSB	WATTS	LF8	ASSE 1011		
BLENDER PITCHER RINSER	WATTS	SD-3	ASSE 1022		
3-COMPARTMENT SINK	AIR GAP	-	ASME A112.1.2		
WORK SINK	AIR GAP	-	ASME A112.1.2		
HAND SINKS	AIR GAP	-	ASME A112.1.2		
DROP-IN SINKS	AIR GAP	-	ASME A112.1.2		
LAVATORIES	AIR GAP	-	ASME A112.1.2		
WATER CLOSETS (FLUSH VALVE)	WATTS	118A	ASSE 1001		
WATER HEATER	WATTS	LFN36	ANSI Z21.22		
BUILDING WATER SUPPLY	WATTS	LF009 M2-QT	ASSE 1013		
(BY LANDLORD)		OR EQUAL			

ALL BRASS VALVES SHALL COMPLY WITH THE 2014 EPA LEAD FREE REQUIREMENTS.

10922 PW02PW19

P X0010 P 13040

P 10447

P 10804

(PW04(PW19)

3/4"ø≯ 1/2"ø-140 —

1/2"ø 🖎 🛪 🗕 1 1/2"ø-CW-

1' - 9 1/2"

-1"ø-140-

-3/4"ø-HWR-

+3/4"ø-FCW-

6' - 1"

SCW 1 1/2"ø-LLNG 1 1/4"ø LLNG -

|E| 15186 | P| 13588 |

(PW05): PW07)

3' - 2 1/2" | 2' - 6" | 2' - 4"

P X0010

-1"ø-140---

-3/4"ø-HWR----

>─3/4"ø FCW y - U

P 10597

(PW07)

GAS LINE CALCULCATION

TAG	MBH	GAS LINE SIZE TO EQUIPMENT
RTU-1	250	1-1/4"
RTU-2	250	1-1/4"
WH	100	3/4"
TOTAL MBH =	600	TOTAL PIPE SIZE = 1-1/2"

GAS PIPING IS SIZED PER TABLE 402.4(2) OF THE 2015 INTERNATIONAL FUEL & GAS CODE AND A DISTANCE OF 100' TO THE FURTHEST PIECE OF EQUIPMENT FROM THE METER.

P 12501

P 12507

P 12896

P 13076 P 13082

P 13149

PW03 P 12899

(PW17) { 2"ø-LLCW-

HOT MATER DEMAND DECLIDEMENT

P 11003 PW10

P 19277 PW20 E 19742 (PW14)

PW11P 15749

(PW21)E 20011

PW16 E 17564

PW15 P 10215

-1"ø---140-

-3/4"ø-HWR-

-3/4"ø-FCW-

P 11003 PW10

P 19277 PW20

-3/4"ø-140---

-3/4"ø-HWR-

-3/4"ø-FCW-

FCW-

CW-

(PW11)

P 10153 P 10874 P 10215 P 11003

(PW15)

PW11P 15749

ALL DOMESTIC WATER PIPING TO BE

1/2" UNLESS OTHERWISE INDICATED.

HOT WATER DEIVIAND REQUIREMENT						
EQUIPMENT#	<u>FIXTURE</u>	NO. OF FIXTURES	TEMP. RISE	GPH PER FIX.	TOTAL GPH	
10597 / 13588	HAND SINKS	3	100	5	15	
10597	LAVATORIES	2	100	5	10	
10152 / 10215	DROP-IN SINK	3	100	10	30	
10922	MOP SINK BASIN	1	100	5	5	
10447 / 10804	3 COMPARTMENT SI	NK 1	100	50	50	
	110 GAL. X 100°F X 8	3.33 = 95,448 BTUI	H REQUIRED			

100,000 BTUH WATER HEATER TO BE INSTALLED. SEE SPECIFICATION ON SHEET P601.

P 13040 PW13

E 18029 PW06

P 10215 PW15

P 10153 PW12

P 11003 PW10

P 10874 PW11

-3/4"ø-HWR-

-3/4"ø-FCW-

7' - 5 1/2"

P 10152

3' - 11"

E 10746

(PW08)

4' - 3"

E 18846

PLUMBING SUPPLY NOTES

- FURNISH AND INSTALL A COMPLETE AND OPERATING SYSTEM. ALL ITEMS ARE NOT NECESSARILY SHOWN.
- PLUMBING CONTRACTOR RESPONSIBLE FOR SITE INVESTIGATION PRIOR TO START OF WORK TO REVEAL FULL SCOPE OF WORK.
- ALL PLUMBING LINES TO BE ROUTED SUCH THAT THEY ARE NOT VISIBLE TO CUSTOMERS EXCEPT WHERE FIRST APPROVED BY STARBUCKS AT EXPOSED CEILING AREAS.
- REFER TO MANUFACTURER SPECIFICATIONS FOR LOCATION OF CONNECTIONS UNLESS OTHERWISE NOTED.
- COORRDINATE WITH ELECTRICAL CONTRACTOR FOR POWER CONNECTION TO ALL PLUMBING EQUIPMENT.
- REFERENCE WORK LETTER FOR DIVISION OF PLUMBING SCOPE OF WORK AND COORDINATE WITH STARBUCKS CONSTRUCTION MANAGER.
- DIMENSIONS ARE TO FINISH FACE UNLESS OTHERWISE NOTED.
- REFER TO DETAIL SHEETS FOR PLUMBING FITTINGS LOCATED IN
- COLD WATER SUPPLY LINES INSIDE CASEWORK AND BAR AREA TO BE COVERED WITH (10MM) THICK SELF SEALING, SECTIONAL CLOSED-CELL FOAM INSULATION, REFER TO SPECIFICATIONS FOR HOT WATER SUPPLY LINE INSULATION REQUIREMENTS.
- INSULATE ALL PIPING INCLUDING PIPES AT BAR AND IN CASEWORK PER THE REQUIREMENTS LISTED IN THE PLUMBING PROJECT MANUAL
- GENERAL CONTRACTOR SHALL CONTACT WATER FILTRATION SUPPLIER TO COORDINATE SCOPE OF WORK AND SCHEDULE PRIOR TO INSTALLATION OF WATER FILTRATION SYSTEM.

SUPPLY KEYED NOTES

PW03

PW10

- 1" CSW & 1/2" HWR TO WATER HEATER & 1" HW FROM WATER HEATER. WATER HEATER AS SPECIFIED AND IN COMPLIANCE WITH APPLICABLE CODES AND ORDINANCES. DIMENSIONS OF THE HEATER SHALL ALLOW INSTALLATION ABOVE THE MOP SINK. REFER TO WATER HEATER DETAIL
- 1/2" HW & CW TO FAUCET AT MOP SINK. CAULK AND SEAL BACK OF SINK PW02 TO WALL. PROVIDE TACO MODEL 5122 OR APPROVED ASSE 1070 EQUAL POINT OF USE THERMOSTATIC MIXING VALVE AT MOP SINK TO PROVIDE
 - 1" CW TO WATER FILTER AND 1" CSW & 3/4" CWF FROM WATER FILTER. PLUMBING CONTRACTOR TO FOLLOW MANUFACTURER'S INSTALLATION INSTRUCTIONS AND ACTIVATION PROCEDURES FOR FILTERS. VERIFY REQUIREMENTS PRIOR TO BID. SEE DETAIL ON SHEET P501.
 - 3/4" HW & CW TO FAUCET AND SPRAY AT COMPARTMENT SINK. CAULK AND SEAL BACK OF SINK TO WALL. PROVIDE TACO MODEL 5123 OR APPROVED ASSE 1070 EQUAL POINT OF USE THERMOSTATIC MIXING VALVE AT COMPARTMENT SINK TO PROVIDE 120° WATER.
 - 3/4" CSW TO DISHWASHER. INSTALL SHUT-OFF WITH 3/4" MALE HOSE-END FITTING @ 18" A.F.F. UNDER COMPARTMENT SINK. SHUT-OFF TO INCLUDE PRESSURE REDUCING VALVE, PRESSURE GAUGE (SET @ 20 PSI, +/- 5 PSI) LINE STRAINER, AND SHOCK ARRESTOR IN WALL. CONNECT SANITIZER TO CSW SUPPLY WITH 72" LONG BRAIDED STAINLESS STEEL HOSE. PROVIDE 3/8" TEE OFF OF COLD WATER LINE SERVING 3-COMPARTMENT SINK AND CONNECT TO DRAIN WATER TEMPERING KIT ACCESSORY ON DISHWASHER TO PROVIDE 140° MAX. WASTE WATER DISCHARGE TO DRAINAGE SYSTEM.
 - 1/2" CWF TO ICE MACHINE. REDUCE TO 3/8" AT MACHINE.
 - 1/2" HW & CW TO SINK. PROVIDE TACO MODEL 5122 OR APPROVED EQUAL POINT OF USE THERMOSTATIC MIXING VALVE AT EACH HAND SINK TO PROVIDE 110° TEMPERED WATER
 - 3/4" CWF TO SERVE COFFEE BREWER AND FUTURE AERO BREWER. INSTALL SHUT-OFFS IN CABINET @ 24" AFF. REDUCE TO 3/8" AT UNIT. PROVIDE ASSE 1022 BACKFLOW PREVENTER. PROVIDE CWF STUB FOR FUTURE AERO BREWER PER STARBUCKS GUIDELINES.
 - 1/2" CWF TO ESPRESSO MACHINE PUMP. SEE DETAIL PROVIDED ON SHEET P501. PROVIDE ASSE 1022 BACKFLOW PREVENTER.

1/2" CW TO DIPPERWELL FAUCET. REDUCE TO 1/4" AT UNIT.

- 1/2" CWF TO INSTAHOT TAP. REDUCE TO 1/4" AT UNIT.
- 1/2" CWF TO WATER TOWER FAUCET LOCATED IN WATER STATION.
- 1" CW TO TOILET. PROVIDE WATER HAMMER ARRESTOR IN SUPPLY LINE. PW13
 - 3/4" CWF, CW AND HW TO DROP DOWN IN WALL AND ROUTE THROUGH CABINETRY FOR FRONT BAR AREA. CONNECT TO EQUIPMENT (2) 10153, (2) 10215, (2) 10874, (2) 11003 AND (2) 12694. REFER TO NOTES 9, 10, 11, 12, AND 15. VERIFY ROUTING IN FIELD WITH GC PRIOR TO INSTALLATION.
- 1/2" HW & CW TO SINK. PROVIDE TACO MODEL 5122 OR APPROVED ASSE 1070 EQUAL POINT OF USE THERMOSTATIC MIXING VALVE AT EACH WORK SINK TO PROVIDE 120° HOT WATER.
- 1/2" CW SUPPLY TO PITCHER RINSER SINK, PROVIDE AN ASSE 1022 BACKFLOW PREVENTER AND ANY ADDITIONAL VALVES AS REQUIRED BY CODE AND MANUFACTURES INSTALLATION INSTRUCTIONS.
- MAKE CONNECTION TO 2" WATER LINE STUBBED INTO PREMISES BY LANDLORD. LANDLORD TO PROVIDE METER AND BACKFLOW PREVENTER IN LOCATION SHOWN. VERIFY THAT THE DOMESTIC WATER SERVICE IS ADEQUATE TO SUPPLY A MINIMUM OPERATING FLOW RATE OF 50 GALLONS PER MINUTE: AT A MINIMUM 50 PSIG AND A MAXIMUM OF 65 PSIG DYNAMIC PRESSURE AT ALL TIMES. IF FLOW RATE OR PRESSURE IS NOT SUFFICIENT, LANDLORD SHALL SIZE, FURNISH AND INSTALL A BOOSTER PUMP IN A LOCATION AGREED UPON WITH THE TENANT. ENTIRE INSTALLATION SHALL BE IN ACCORDANCE WITH LOCAL CODES. CONTRACTOR SHALL FIELD VERIFY REQUIREMENTS PRIOR TO BID. BID SHALL INCLUDE ALL WORK NECESSARY FOR A FULLY OPERATIONAL SYSTEM. SEE LANDLORD & CIVIL DRAWINGS FOR ADDITIONAL

INFORMATION AND CONTINUATION.

- FREEZE PROOF HOSE BIBS BY LANDLORD. COORDINATE PROVISION OF HOSE BIBS WITH LANDLORD AND VERIFY REQUIREMENTS PRIOR TO COMMENCING WORK. HOSE BIB MUST BE CONNECTED TO 1/2" INSULATED, COPPER PIPE AND RUN WITHIN CONDITIONED SPACE. IT MUST BE EXPOSED AND VISIBLE FOR TENANT'S CONNECTION. VERIFY LOCATION WITH CONSTRUCTION MANAGER.
- PROVIDE A BACKFLOW PREVENTER FOR CHEMICAL DISPENSERS AT MOP SINK AND 3-COMPARTMENT SINK AS REQUIRED BY AHJ. VERIFY REQUIREMENTS PRIOR TO COMMENCING WORK.
- 1/2" CW SUPPLY FOR IN-COUNTER RINSER AT 20-1/2" AFF FOR BACK BAR PITCHER RINSER. FRONT BAR PITCHER RINSERS TO BE ROUTED FROM UNDER COUNTER WATER PIPING. SEE NOTE 14 FOR ADDITIONAL
- INSTALL N/2-FUSION NITRO DISPENSING SYSTEM PER MANUFACTURER'S RECOMMENDATIONS. COORDINATE ROUTING, INSTALLATION AND RESPONSIBILITY WITH GENERAL CONTRACTOR AND STARBUCKS NITROGENATION VENDOR.
- PROVIDE 3/4" CWF AND 1/2" HW & CW DROP FOR WATER FILLING STATION. PW22
 - MAKE CONNECTION TO NATURAL GAS LINE STUB BY LANDLORD. LANDLORD TO PROVIDE METER AND ANY REQUIRED VALVING. VERIFY THAT SERVICE IS ADEQUATE TO SUPPLY 550 MBH. ALL WORK SHALL BE COMPLETED IN ACCORDANCE WITH LOCAL CODES. BID SHALL INCLUDE ALL WORK FOR A FULLY OPERATIONAL SYSTEM. ALL GAS PIPE SIZES SHOWN FOR LOW PRESSURE (LESS THAN 2 LBS.). VERIFY EXACT LOCATION, PRESSURE AND REQUIREMENTS ON SITE. SEE LANDLORD & CIVIL DRAWINGS FOR ADDITIONAL INFORMATION AND CONTINUATION.
 - 1-1/4" GAS TO MECHANICAL RTU-1 & 2 ON ROOF WITH APPROVED
- SHUT-OFF VALVE & DIRT LEG BY LANDLORD.
 - 3/4" GAS TO WATER HEATER WITH APPROVED SHUT-OFF VALVE & DIRT



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WRITTEN AGREEMENT IS FULLY EXECUTED BY BOTH PARTIES






2020

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Phone (314) 772-1782 Fax (314) 373-3514

Engineering Consultant

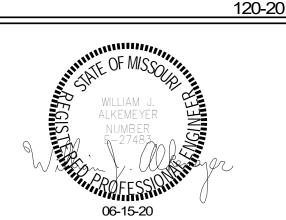

62012 87799-001

06-16-2020 SR. DESIGN MANAGER: K. GORIN SLONSKI PRODUCTION DESIGNER: A. HAHN SMD/SWE

Revision Schedule

-IPMAN

Rev Date Description

PLUMBING SUPPLY

PLAN SCALE: AS SHOWN

SHEET NUMBER:

STORE #:

ISSUE DATE:

CHECKED BY:

PROJECT#:

P101

PLUMBING SUPPLY PLAN

-C- LLCW--3/4"ø-

2"øLLCW



-3/4"ø-CW---

PLUMBING WASTE NOTES

- ALL PLUMBING LINES TO BE ROUTED SUCH THAT THEY ARE NOT VISIBLE TO CUSTOMERS EXCEPT WHERE FIRST APPROVED BY STARBUCKS AT EXPOSED CEILING AREAS.
- REFER TO MANUFACTURER SPECIFICATIONS FOR LOCATION OF CONNECTIONS UNLESS OTHERWISE NOTED.
- COORDINATE WITH ELECTRICAL CONTRACTOR FOR POWER CONNECTION TO ALL PLUMBING EQUIPMENT.
- DIMENSIONS ARE TO FINISH FACE UNLESS OTHERWISE NOTED.
- E. REFER TO DETAIL SHEETS FOR PLUMBING FITTINGS LOCATED IN CASEWORK.
- WHEN BUNDLING SEVERAL INDIRECT WASTE LINES TO DRAIN INTO A FLOOR SINK, A UNISTRUT IS REQUIRED FOR SECURING AND BRACING ALL LINES ABOVE THE DRAIN.
- FURNISH & INSTALL ALL NEEDED INDIRECT DRAINS PER CODE (NOT ALL SHOWN). INSTALL DRAINS AT 2% SLOPE WHERE POSSIBLE WITHOUT DIPS OR SAGS. ALL INDIRECT DRAINS SHALL RUN SEPARATELY FROM EACH OTHER TO INDIRECT DRAIN RECEPTOR AND SHALL TERMINATE WITH AN AIR GAP
- FURNISH & INSTALL WALL CLEANOUTS AT ALL SINKS AND AS NEEDED AND PER CODE (NOT ALL SHOWN).
- INSULATE ICE BIN DRAINAGE PIPES PER THE REQUIREMENTS ON THE PLUMBING SPECIFICATION SHEET.

SANITARY KEYED NOTES

- PS01 1" INDIRECT DRAIN FROM DRIP PAN AND 3/4" PRESSURE RELIEF FROM WATER HEATER TO FLOOR DRAIN. SEE DETAIL ON SHEET P501 FOR ADDITIONAL INFORMATION.
- PS02 3" WASTE FROM MOP SINK.
- PS03 2" INDIRECT DRAINS FROM THE 3-COMP SINK TO FLOOR SINK. FLOOR SINK UTILIZED FOR THE 3 COMP AND DISHWASHER TO BE ROUTED TO AN INTERIOR GREASE TRAP.
- 1-1/2" INDIRECT DRAIN FROM DISHWASHER TO FUNNEL OVER FLOOR SINK (IF PERMITTED). 1-1/2" TRADE SIZE PIPE MINIMUM REDUCED TO 3/4" FPT
- PS05 (2) 3/4" INDIRECT DRAIN FROM ICE MACHINE AND BIN TO INDIRECT DRAIN AT FLOOR SINK.
- PS06 5/8" DRAIN HOSE FROM ESPRESSO MACHINE TO INDIRECT DRAIN RISER. SEE DETAIL ON SHEET P501.
- PS07 1" INDIRECT INSULATED DRAIN LINE FROM ICE BIN DROP TO FLOOR SINK.
- 1" INDIRECT WASTE FROM DRAIN HOSE OF THE WARE RINSER TO FLOOR SINK AS REQUIRED.
- 3" WASTE FROM FLOOR SINK. GENERAL CONTRACTOR MAY NEED TO MODIFY CABINET BASE TO ALLOW ACCESS TO FLOOR SINK.
- PS10 2" WASTE FROM SINK.
- 4" WASTE FROM TOILET, CONTRACTOR TO VERIFY THAT A 1/4" SLOPE FROM TOILET WASTE CAN BE ACHIEVED WITH GENERAL CONTRACTOR BEFORE INSTALLING LOW FLUSH TOILET.
- PS12 LANDLORD TO PERMIT AND DISTRIBUTE ALL UNDER-SLAB SANITARY SEWER WASTE LINES PER TENANTS UNDER-SLAB DRAWINGS AND/OR CONSTRUCTION DOCUMENTS, AND VENTS PER TENANT REQUIREMENT DOCUMENTS. LANDLORD TO PROVIDE A MINIMUM 4" SANITARY SEWER WASTE LINE TO THE PREMISES. DEDICATED TO THE TENANTS USE. THE INVERT ELEVATION AT THE FURTHEST POINT OF CONNECTION SHALL BE A MINIMUM DEPTH OF 27" BELOW FINISHED FLOOR AND MAINTAIN A MINIMUM SLOPE OF 1/4" PER LINEAL FOOT AND SHALL BE PER LOCAL CODE.
- PS13 1-1/2" INDIRECT DRAIN TO FLOOR SINK.
- PS14 3" WASTE FROM FLOOR DRAIN. PROVIDE TRAP PRIMERS FOR ALL FLOOR
- PS15 (2) 1-1/2" INDIRECT DRAINS FROM PITCHER RINSER SINK TO FLOOR SINK.
- PS16 MAKE CONNECTION TO EXISTING 4" VENT THROUGH ROOF BY LANDLORD. A MINIMUM OF 10' CLEARANCE TO AIR INTAKES SHALL BE MAINTAINED. VERIFY EXACT LOCATION, SIZE AND REQUIREMENTS ON SITE. SEE LANDLORD DRAWINGS FOR ADDITIONAL INFORMATION AND CONTINUATION.
- INDIRECT DRAIN FROM WATER EQUIPMENT TO NEAREST DRAIN RECEPTACLE. CONTRACTOR TO VERIFY EXACT REQUIREMENTS WITH EQUIPMENT SUPPLIER. SEE DETAIL ON SHEET P501.
- PS18 ROUTE INDIRECT WASTE FROM THE DRAIN TRAY AND 1/2" INDIRECT CONDENSATE WASTE FORM THE COLD BREW NITRO SYSTEM TO FLOOR SINK. INSTALL PER MANUFACTURER'S RECOMMENDATION. COORDINATE INSTALLATION AND RESPONSIBILITY WITH GENERAL CONTRACTOR AND STARBUCKS NITROGENATION VENDOR.
- 3" WASTE FROM EXISTING FLOOR DRAIN PROVIDED BY LANDLORD FOR WATER SERVICE BACKFLOW PREVENTER AS REQUIRED BY CODE. FIELD VERIFY EXACT LOCATION AND REQUIREMENTS.



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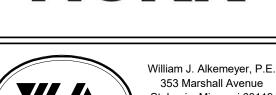
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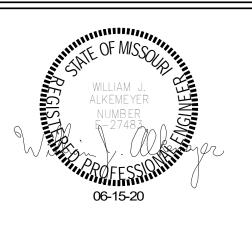
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FINAL

St. Louis, Missouri 63119 Phone (314) 772-1782 Fax (314) 373-3514

Engineering Consultant

120-20



STORE #: 62012 PROJECT#:

HIPMAN

87799-001 SR. DESIGN MANAGER: K. GORIN SLONSKI PRODUCTION DESIGNER: A. HAHN SMD/SWE

Revision Schedule


PLUMBING WASTE & VENT PLAN

SCALE: AS SHOWN SHEET NUMBER:

ISSUE DATE:

CHECKED BY:

P102

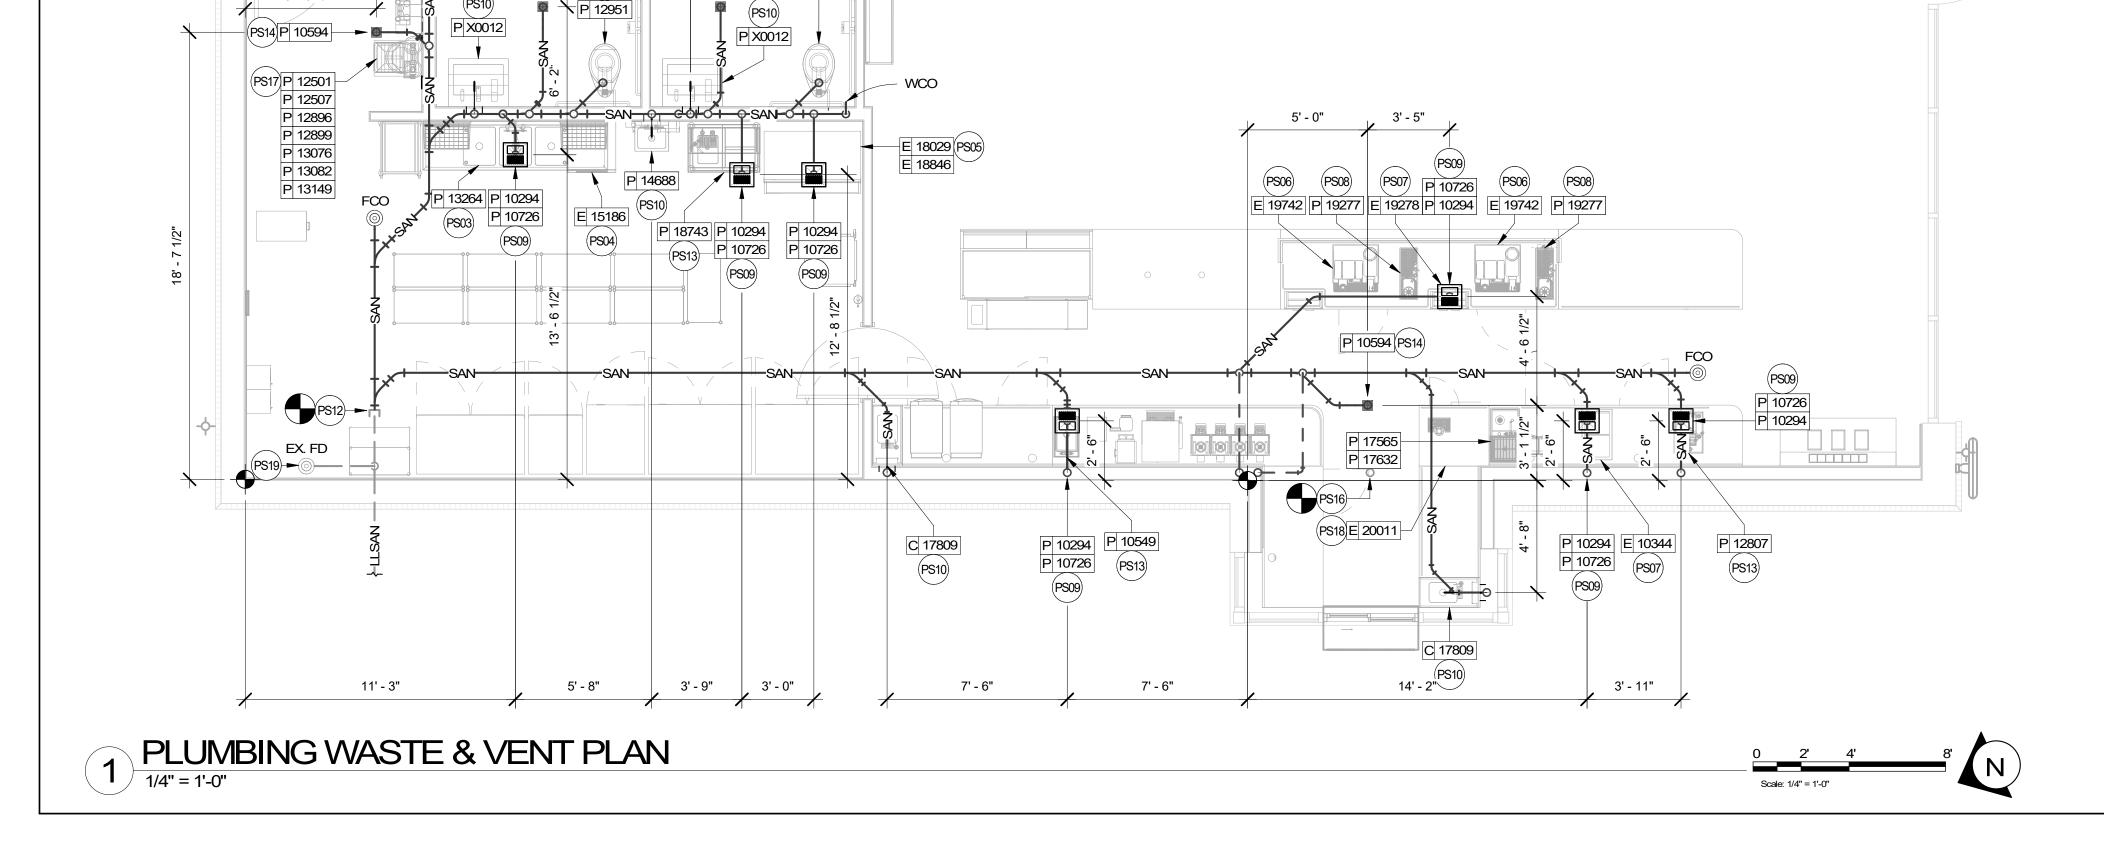

9' - 6 1/2"

(PS02)P 10995


5' - 5 1/2"

3' - 7" 1' - 3", 4' - 1"

P 10594

PS11) P 12951

, 2' - 10 1/2", 2' - 7"

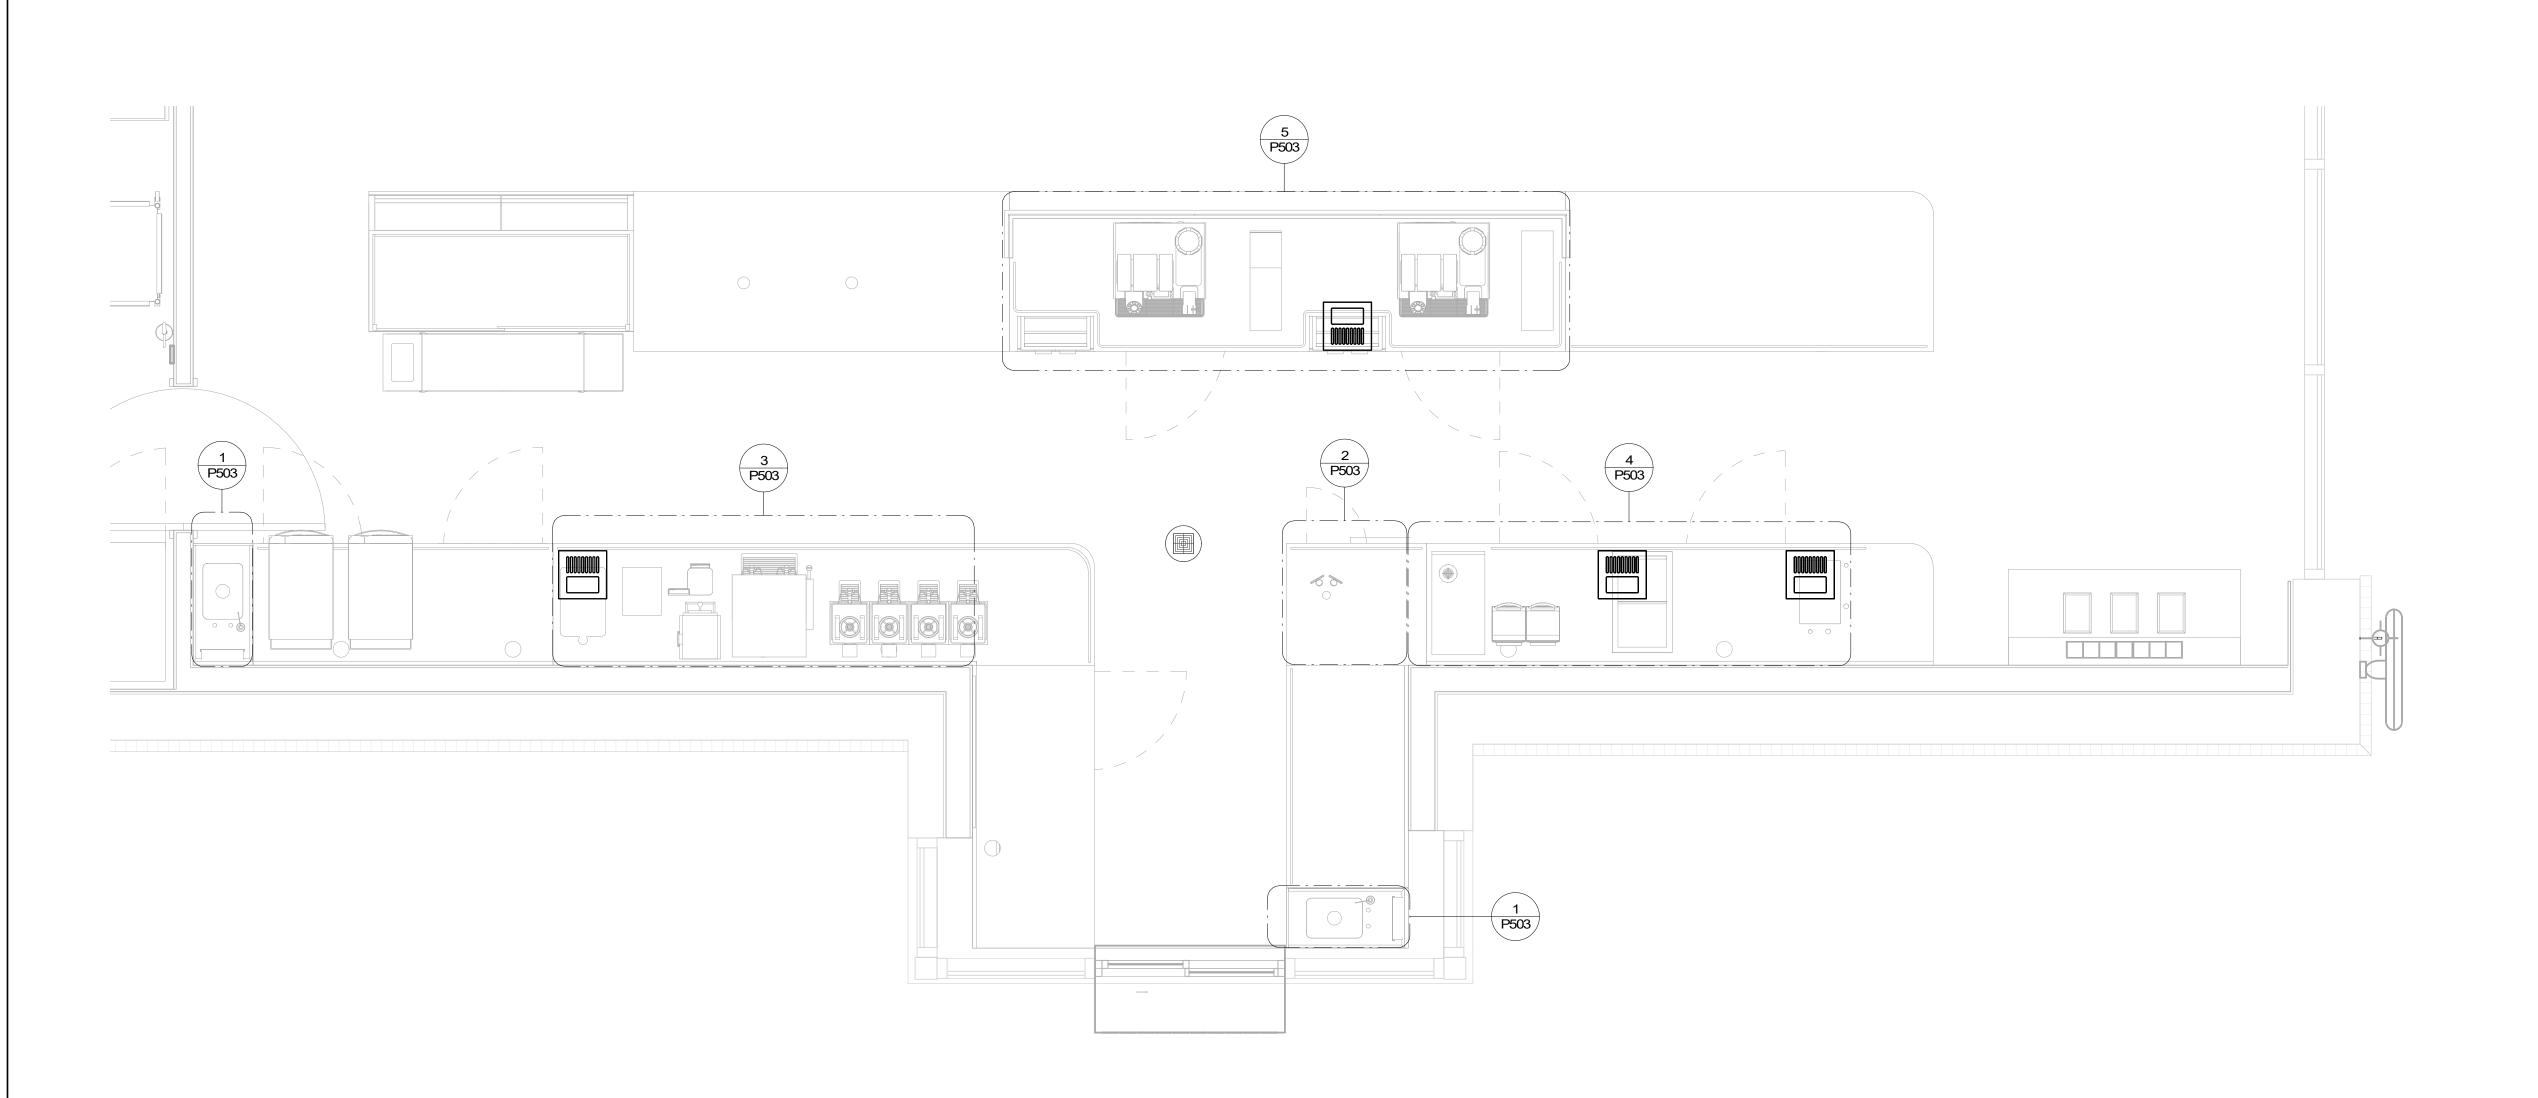

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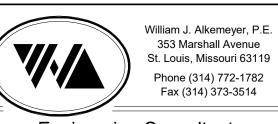
FOR A PROTOTYPICAL STARBUCKS STORE (WHICH IS SUBJECT

TO CHANCE AT ANYTHIRD AND DO NOT BELL ECT ACTUAL STEEL

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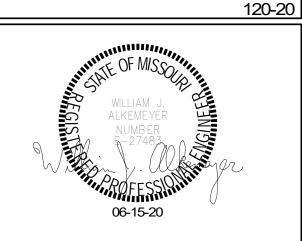




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62012

STORE #: PROJECT#:

87799-001 ISSUE DATE: 06-16-2020
SR. DESIGN MANAGER: K. GORIN SLONSKI
PRODUCTION DESIGNER: A. HAHN
CHECKED BY: SMD / SWE

ENLARGED PLUMBING PLACEMENT PLAN SCALE: AS SHOWN

SHEET NUMBER:

P103

1 ENLARGED PLUMBING DESIGN PLAN
1/2" = 1'-0"



(PS10)P 14688 (PS10)PX0012 P 10549 PS13 P 10294 P 10726 PS09 ✓ P 10294 PS09 P 10294 P 18029 P 18846 17565 12507 10344 (PS07) P 12896 PS14 P 10594 10294 P 12899 P 10726 PS09 P 13076 P 13082 PS09 P 10294 P 10726 PS13 P 12807 P 10294 P 10726 PS04 E 15186 P 13149 PS17 (PS08) E 19277 (2) P 10294 P 10726 PS07 E 19278 (2) PS06 E 19742 (2)

SANITARY ISOMETRIC DIAGRAM

SANITARY ISO KEYED NOTES

- PS01 1" INDIRECT DRAIN FROM DRIP PAN AND 3/4" PRESSURE RELIEF FROM WATER HEATER TO FLOOR DRAIN. SEE DETAIL ON SHEET P501 FOR ADDITIONAL INFORMATION.
- PS02 3" WASTE FROM MOP SINK.
- PS03 2" INDIRECT DRAINS FROM THE 3-COMP SINK TO FLOOR SINK. FLOOR SINK UTILIZED FOR THE 3 COMP AND DISHWASHER TO BE ROUTED TO AN INTERIOR GREASE TRAP.
- PS04 1-1/2" INDIRECT DRAIN FROM DISHWASHER TO FUNNEL OVER FLOOR SINK (IF PERMITTED). 1-1/2" TRADE SIZE PIPE MINIMUM REDUCED TO 3/4" FPT CONNECTION.
- PS05 (2) 3/4" INDIRECT DRAIN FROM ICE MACHINE AND BIN TO INDIRECT DRAIN AT FLOOR SINK.
- 5/8" DRAIN HOSE FROM ESPRESSO MACHINE TO INDIRECT DRAIN RISER. SEE DETAIL ON SHEET P501.
- PS07 1" INDIRECT INSULATED DRAIN LINE FROM ICE BIN DROP TO FLOOR SINK.
- 1" INDIRECT WASTE FROM DRAIN HOSE OF THE WARE RINSER TO FLOOR SINK AS REQUIRED.
- PS09 3" WASTE FROM FLOOR SINK. GENERAL CONTRACTOR MAY NEED TO MODIFY CABINET BASE TO ALLOW ACCESS TO FLOOR SINK.
- PS10 2" WASTE FROM SINK.
- PS11 4" WASTE FROM TOILET. CONTRACTOR TO VERIFY THAT A 1/4" SLOPE FROM TOILET WASTE CAN BE ACHIEVED WITH GENERAL CONTRACTOR BEFORE INSTALLING LOW FLUSH TOILET.
- PS12 LANDLORD TO PERMIT AND DISTRIBUTE ALL UNDER-SLAB SANITARY SEWER WASTE LINES PER TENANTS UNDER-SLAB DRAWINGS AND/OR CONSTRUCTION DOCUMENTS, AND VENTS PER TENANT REQUIREMENT DOCUMENTS. LANDLORD TO PROVIDE A MINIMUM 4" SANITARY SEWER WASTE LINE TO THE PREMISES, DEDICATED TO THE TENANTS USE. THE INVERT ELEVATION AT THE FURTHEST POINT OF CONNECTION SHALL BE A MINIMUM DEPTH OF 27" BELOW FINISHED FLOOR AND MAINTAIN A MINIMUM SLOPE OF 1/4" PER LINEAL FOOT AND SHALL BE PER LOCAL CODE.
- PS13 1-1/2" INDIRECT DRAIN TO FLOOR SINK.
- PS14 3" WASTE FROM FLOOR DRAIN. PROVIDE TRAP PRIMERS FOR ALL FLOOR DRAINS.
- PS15 (2) 1-1/2" INDIRECT DRAINS FROM PITCHER RINSER SINK TO FLOOR SINK.
- PS16 MAKE CONNECTION TO EXISTING 4" VENT THROUGH ROOF BY LANDLORD. A MINIMUM OF 10' CLEARANCE TO AIR INTAKES SHALL BE MAINTAINED. VERIFY EXACT LOCATION, SIZE AND REQUIREMENTS ON SITE. SEE LANDLORD DRAWINGS FOR ADDITIONAL INFORMATION AND CONTINUATION.
- PS17 INDIRECT DRAIN FROM WATER EQUIPMENT TO NEAREST DRAIN RECEPTACLE. CONTRACTOR TO VERIFY EXACT REQUIREMENTS WITH EQUIPMENT SUPPLIER. SEE DETAIL ON SHEET P501.
- PS18 ROUTE INDIRECT WASTE FROM THE DRAIN TRAY AND 1/2" INDIRECT CONDENSATE WASTE FORM THE COLD BREW NITRO SYSTEM TO FLOOR SINK. INSTALL PER MANUFACTURER'S RECOMMENDATION. COORDINATE INSTALLATION AND RESPONSIBILITY WITH GENERAL CONTRACTOR AND STARBUCKS NITROGENATION VENDOR.
- PS19 3" WASTE FROM EXISTING FLOOR DRAIN PROVIDED BY LANDLORD FOR WATER SERVICE BACKFLOW PREVENTER AS REQUIRED BY CODE. FIELD VERIFY EXACT LOCATION AND REQUIREMENTS.



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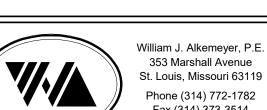
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PRYOR RD & EE'S SUMMIT

REETS OF WEST SO NW LOWENST S'S SUMMIT, MO

62012 87799-001 06-16-2020

PROJECT #: 87799-001

ISSUE DATE: 06-16-2020

SR. DESIGN MANAGER: K. GORIN SLONSKI
PRODUCTION DESIGNER: A. HAHN
CHECKED BY: SMD / SWE

Revision Schedule


Rev Date By Description

SHEET TITLE:

STORE #:

SANITARY ISOMETRIC DIAGRAM
SCALE: AS SHOWN

SHEET NUMBER:

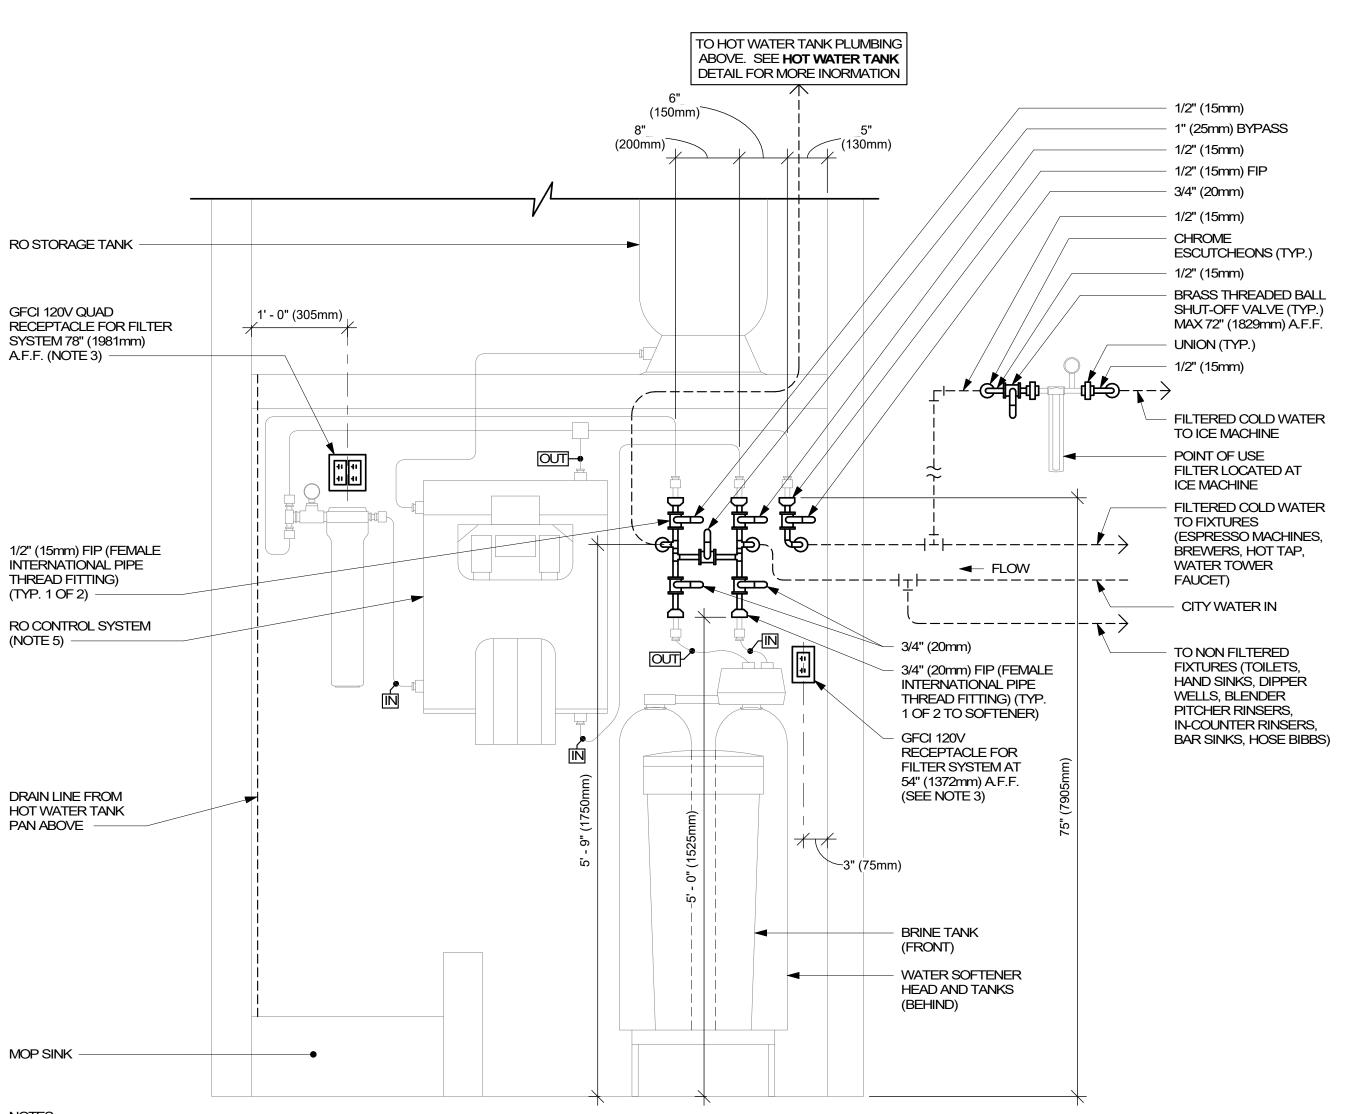

I. ALL COMPONENTS DRAWN IN BOLD ARE GC RESPONSIBILITY. GC TO COORDINATE INSTALLATION OF ALL OTHER COMPONENTS SHOWN WITH FILTER VENDOR.

2. ALL PIPING SHALL BE COPPER EXCEPT PEX TYPE PIPING WHICH IS ACCEPTABLE BETWEEN FILTER SYSTEM COMPONENTS AND ADVANSYS DISHWASHER WHERE ALLOWED BY CODE.


COORDINATE WITH ELECTRICAL CONTRACTOR FOR RECEPTACLES.


4. PROVIDE WATER SOFTENER INDIRECT DRAIN TO SINK, INSTALLED PER CODE. (CONFIRM REQUIREMENTS WITH SOFTENER EQUIPMENT CUTSHEETS IN ITEM SPECIFICATIONS).

5. IN MUNICIPALITIES WITH BRINE RESTRICTIONS, REFER TO THE WATER SYSTEM CONFIGURATIONS APPENDIX UNDER ITEM SPECIFICATIONS FOR WATER SOFTENER EXCHANGE TANK SCHEMATIC. 6. COMPONENTS ARE TO BE POSITIONED TO MAXIMIZE ACCESS FOR REGULAR SERVICING. PRE-FILTER, BYPASS VALVES, AND SOFTENER TANKS MUST BE INSTALLED 72" (1828MM) AFF OR LOWER.

CONFIGURATION III, RO AND SOFTENER WATER FILTRATION

SCALE: NTS

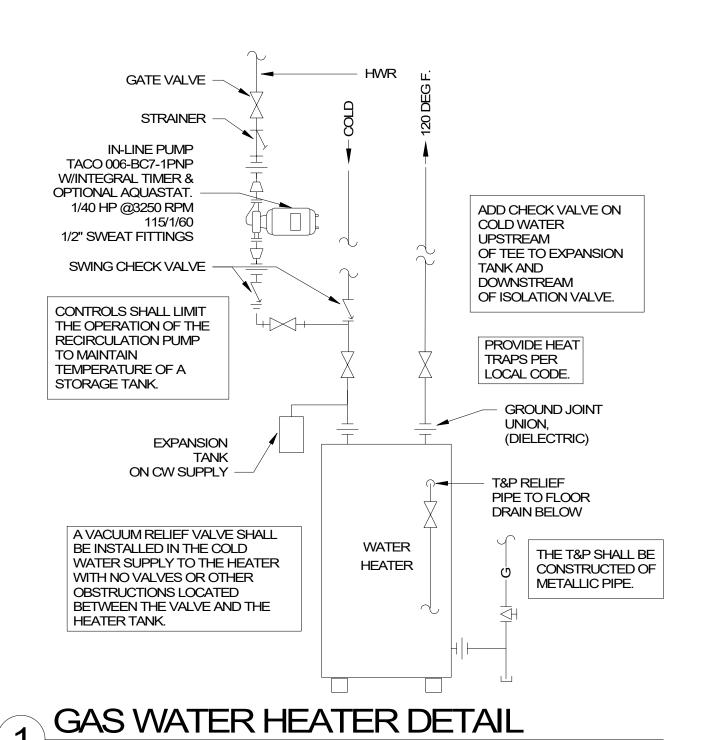

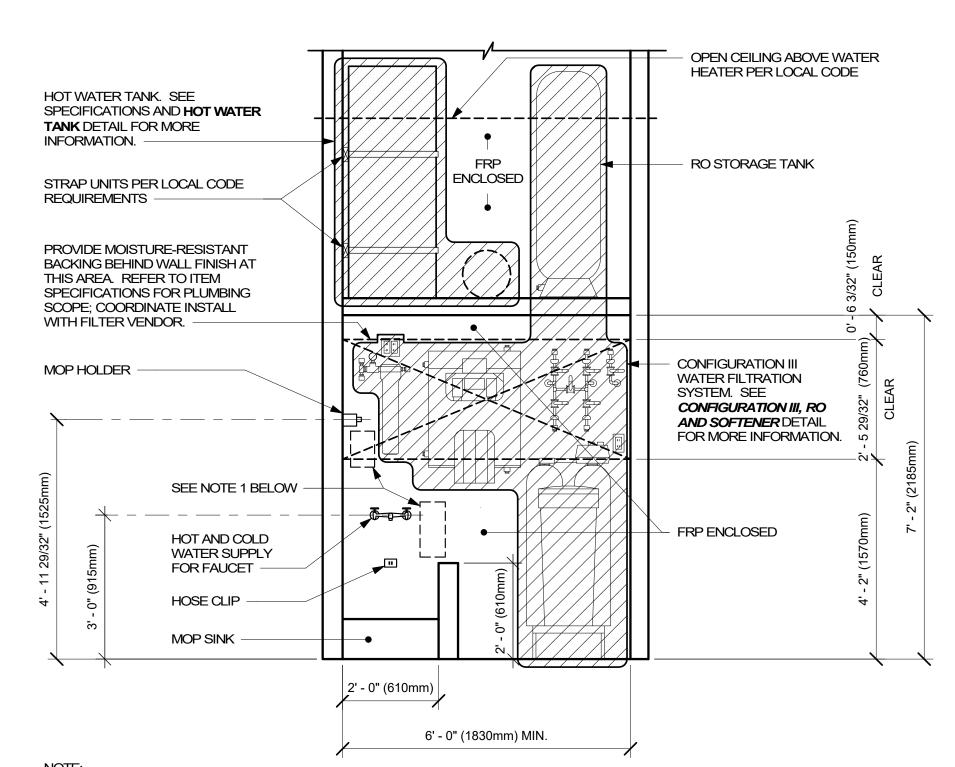

1. KEEP CLEAR AT BACKWALL FOR CHEMICAL DISPENSING SYSTEM COMPONENTS, TO BE INSTALLED BY SYSTEM VENDOR. REFER TO POSTED INSTALLATION GUIDELINES FOR MORE INFORMATION.





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William J. Alkemeyer, P.E 353 Marshall Avenue St. Louis, Missouri 63119


Phone (314) 772-1782 Fax (314) 373-3514

Engineering Consultant

2020

16

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62012

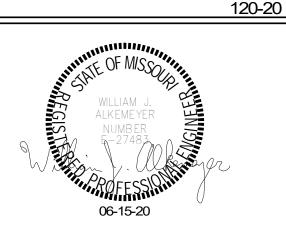STORE #: PROJECT #: 87799-001 ISSUE DATE: 06-16-2020 SR. DESIGN MANAGER: K. GORIN SLONSKI PRODUCTION DESIGNER: A. HAHN CHECKED BY:


SMD/SWE **Revision Schedule**

Rev	Date	Ву	Description

PLUMBING DETAILS

SCALE: AS SHOWN

SHEET NUMBER:

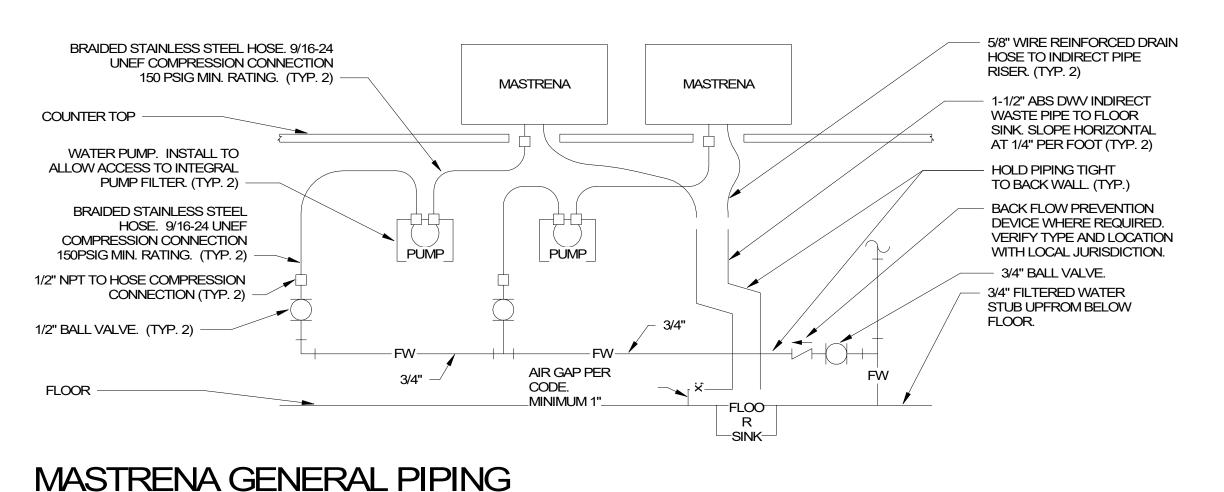

CONNECTION SCHEMATIC

DETAIL NOTES

1. THIS DETAIL IS SCHEMATIC ONLY. FOR THE LOCATION OF THE COMPONENTS SHOWN,

EXTENT OF THE WORK REQUIRED, SEE THE PLAN DRAWINGS. 2. ALL WATER HOSE SHALL BE THE MINIMUM

LENGTH NEEDED AND SUPPORTED AS REQUIRED TO AVOID STRESSING CONNECTIONS AND COILING EXCESSIVE


ROUTE TO AVOID KINKING AND ALLOW SPACE FOR UNDER COUNTER REFRIGERATOR AND ACCESS TO EQUIPMENT AND VALVES.

3. ALL PIPING SHALL BE HELD TIGHT TO


FLOW ACCESS TO EQUIPMENT AND VALVES. 4. ROUTE HORIZONTAL PIPING A MINIMUM OF 6" ABOVE FLOOR.

SLOPED WHERE REQUIRED AND ROUTED TO


5. INSTALL PUMP AS SHOWN ON PLANS. COORDINATE LOCATION AND ELEVATION WITH OTHER TRADES. ORIENT PUMP AS REQUIRED TO ALLOW MAINTENANCE.

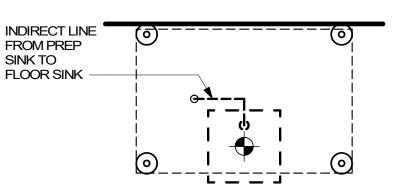

AT FLOOR LEVEL

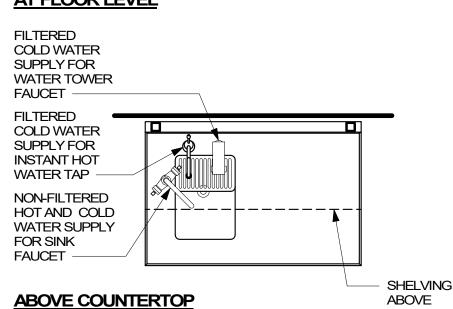

2 WATER FILLING STATION
3/4" = 1'-0"

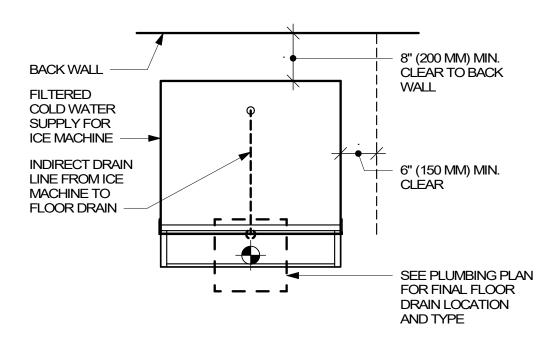



HOSE TO


KADET

BALL VALVE


1/2" HOT

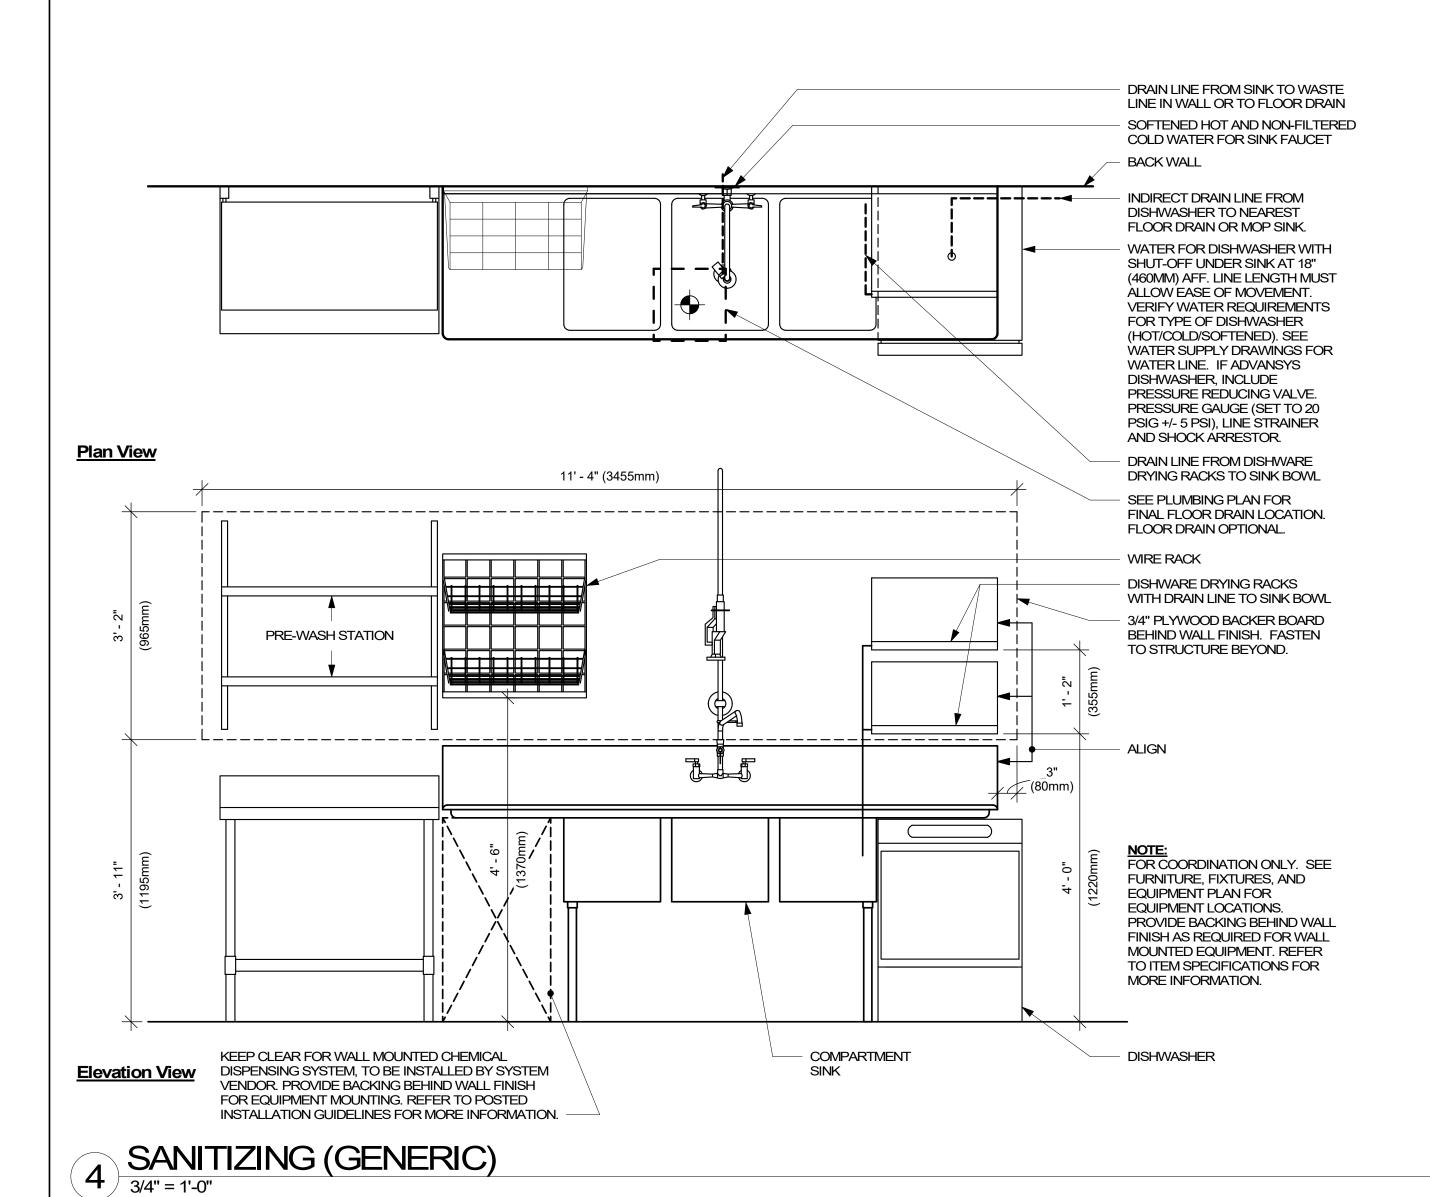


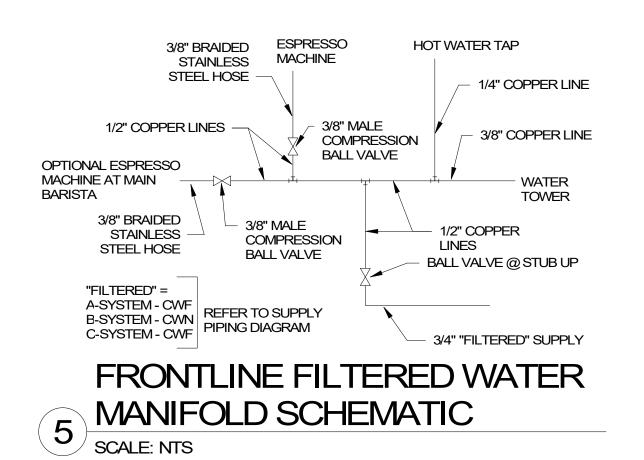

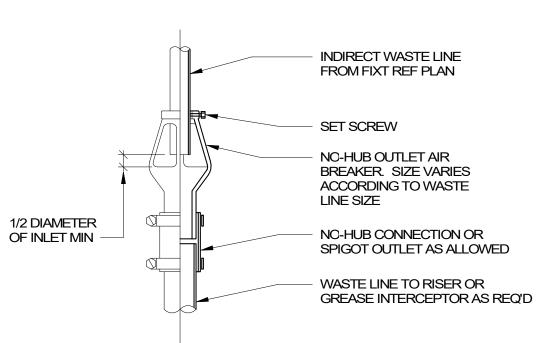



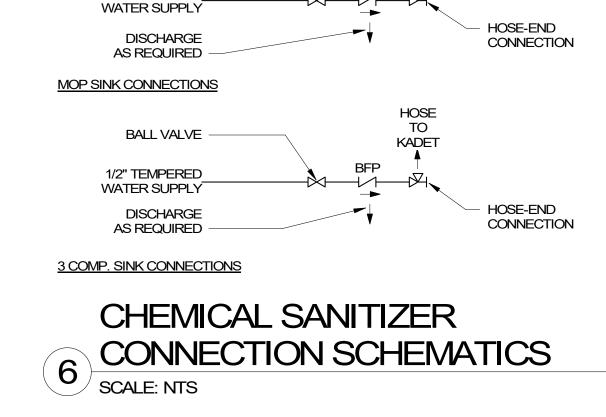

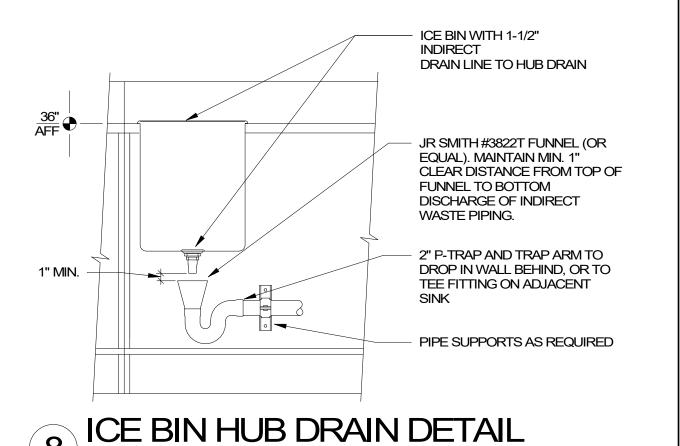



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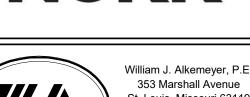
2020

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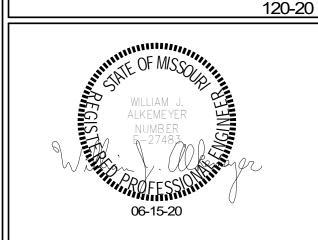
BID





St. Louis, Missouri 63119 Phone (314) 772-1782 Fax (314) 373-3514

Engineering Consultant




STORE #: 62012 PROJECT#: 87799-001 06-16-2020


HIPMAN

ISSUE DATE: SR. DESIGN MANAGER: K. GORIN SLONSKI PRODUCTION DESIGNER: A. HAHN CHECKED BY: SMD/SWE

Revision Schedule Description PLUMBING DETAILS


SCALE: AS SHOWN SHEET NUMBER:

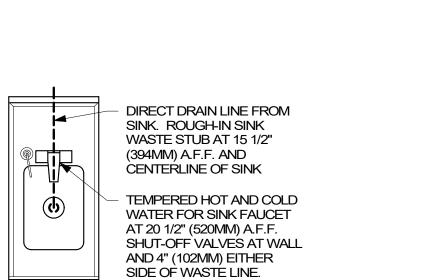

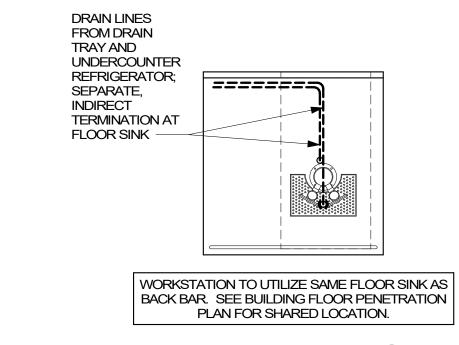







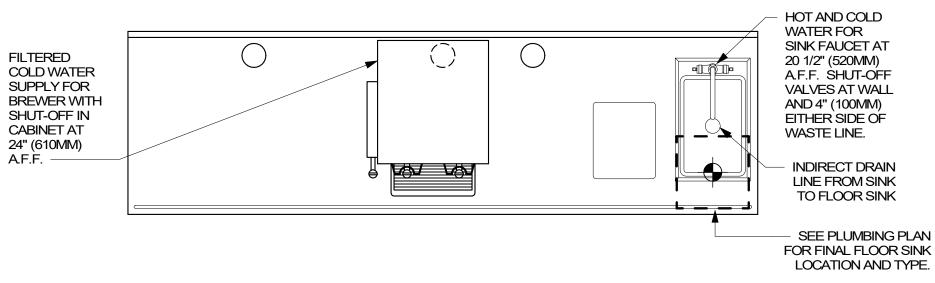



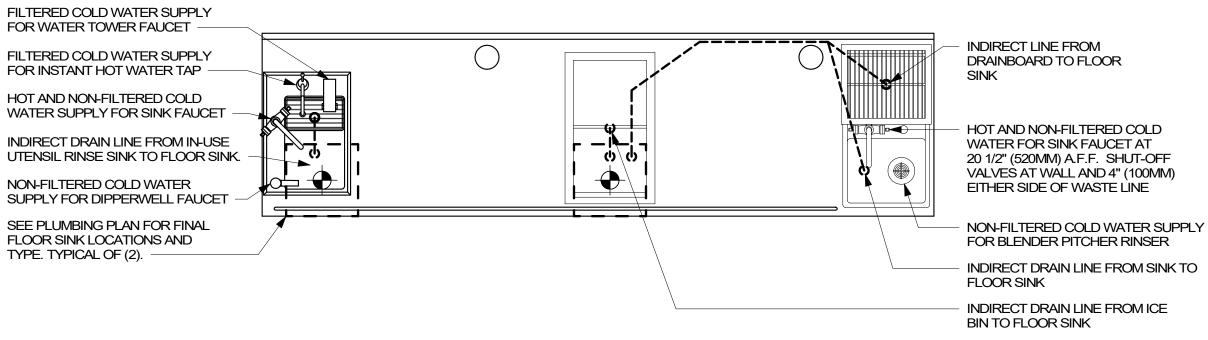



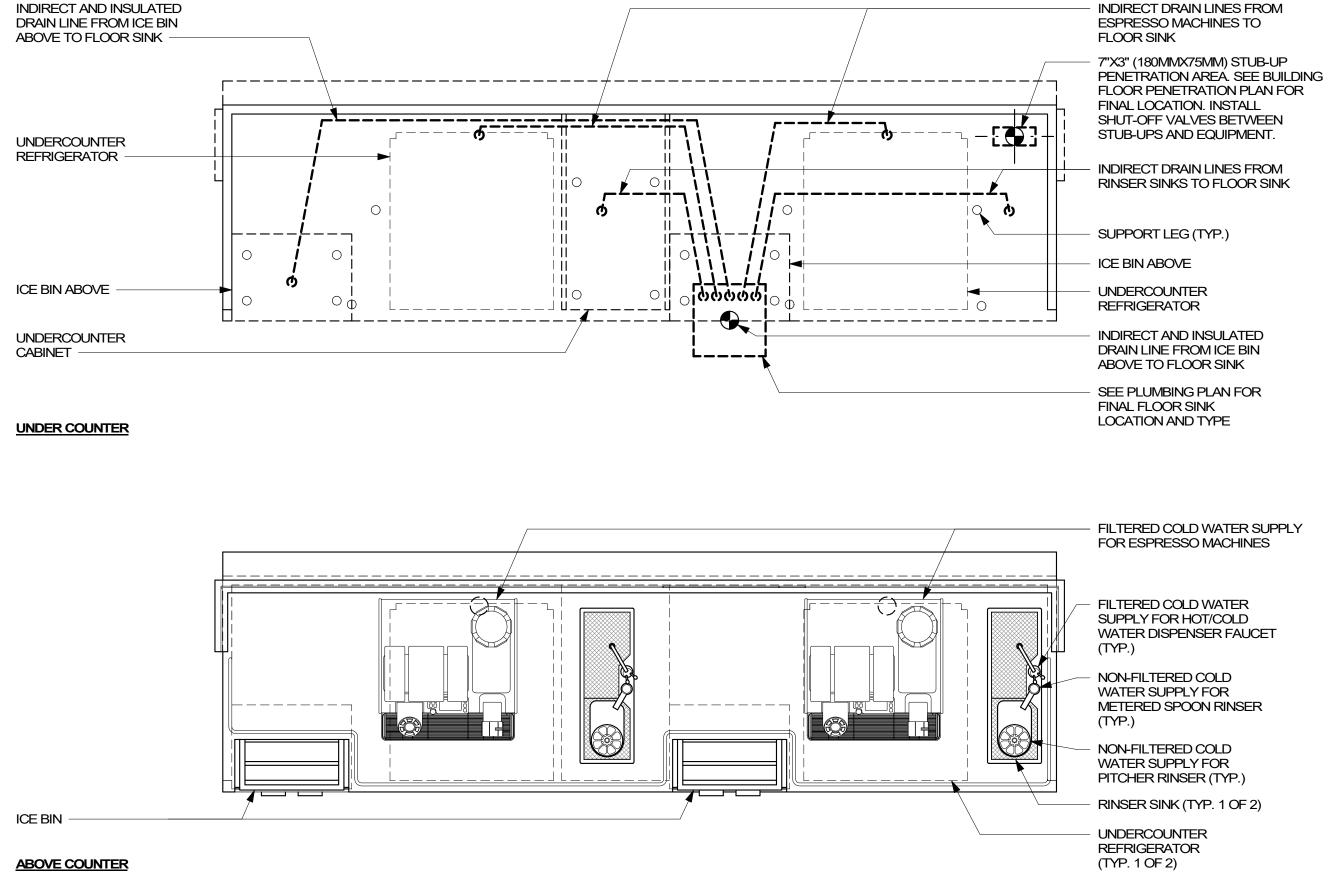



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WRITTEN AGREEMENT IS FULLY EXECUTED BY BOTH PARTIES






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E'S SUMMIT

DECT ADDRESS:
REETS OF WEST
50 NW LOWENSTE
E'S SUMMIT, MO

STORE #: 62012 PROJECT #: 87799-001 ISSUE DATE: 06-16-2020

-IPMAN

ISSUE DATE: 06-16-2020
SR. DESIGN MANAGER: K. GORIN SLONSKI
PRODUCTION DESIGNER: A. HAHN
CHECKED BY: SMD / SWE

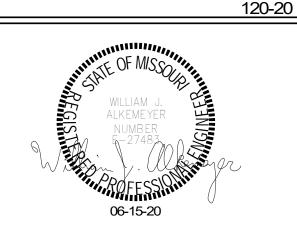Revision Schedule

Rev Date By Description

PLUMBING DETAILS

SCALE: AS SHOWN

SHEET NUMBER:

			1	_	
DESIGN ID	COUNT	DESCRIPTION	FURN. BY	INST. BY	COMMENTS
DRAIN		DDAIN ELOOD OINIK OOLIADE 40IN 005MM	00	00	ZUDNIMODEL #ED00ZE NIU0
10294	7	DRAIN - FLOOR SINK SQUARE - 12IN 305MM	SB	GC	ZURN MODEL #FD2375-NH3.
10594	4	DRAIN - FLOOR SINK SQUARE - 5IN 125MM	GC	GC	JAY R. SMITH MODEL #2005Y (B) OR EQUAL
10726	7	DRAIN - GRATE HALF SQUARE - 12IN 305MM	SB	GC	ZURN MODEL #FD2375-NH2.
AUCET		EALIGET BOURIELABORATORY/AUTURENT	100	00	1
10152	1	FAUCET - DOUBLE LABORATORY WITH BENT RISER SPOUT	SB	GC	
10153	2	FAUCET - WATER TOWER - 12IN 305MM	SB	GC	
10215	3	FAUCET - DOUBLE LABORATORY WITH SWING SPOUT	SB	GC	
10447	1	FAUCET - PRE RINSE SPRAYER WALL MOUNTED	SB	GC	
10597	2	FAUCET - SINGLE HANDLE	SB	GC	
10804	1	FAUCET - PRE RINSE SWING SPOUT	SB	GC	
10874	2	FAUCET - HOT WATER DISPENSER GOOSENECK	SB	GC	
10922	1	FAUCET - MOP SINK WALL MOUNTED	SB	GC	
11003	3	FAUCET - METERED	SB	GC	
13588	1	FAUCET - HAND SINK WALL MOUNTED	SB	GC	
15749	2	FAUCET - HOT AND COLD WATER SYSTEM	SB	GC	
X0010	2	FAUCET - STERN	GC	GC	STERN. CONDOR 1010. PART #07100005. CHROME. PART OF D 13 INTEGRATED SINK SYSTEM. CONTACT: D 13 GROUP. 245 WEST CENTRAL STREET, NATICK, MA 01760. PH: 617-307-1140. WWW.D13GROUP.COM
12501	1	FILTER - RO SYSTEM 600GPD	SB	SB	CONFIGURATION [III]. GC TO COORDINATE
12507	1	FILTER - RO SYSTEM 40GAL STORAGE TANK	SB	SB	WITH SBUX VENDOR. CONFIGURATION [III]. GC TO COORDINATE
12896	1	FILTER - BRINE TANK	SB	SB	WITH SBUX VENDOR. CONFIGURATION [III]. GC TO COORDINATE
12899	·	FILTER - POLY GLASS VESSEL	SB	SB	WITH SBUX VENDOR.
	2				CONFIGURATION [III]. GC TO COORDINATE WITH SBUX VENDOR.
13076	1	FILTER - PREFILTRATION SYSTEM	SB	SB	CONFIGURATION [III]. GC TO COORDINATE WITH SBUX VENDOR.
13082	1	FILTER - WATER SOFTENER TWIN	SB	SB	CONFIGURATION [III]. GC TO COORDINATE WITH SBUX VENDOR.
13149	1	FILTER - PRESSURE GAUGE	SB	SB	CONFIGURATION [III]. GC TO COORDINATE WITH SBUX VENDOR.
THER		I	T = -		T
13384	1	WATER HEATER TANK GAS	GC	GC	AO SMITH CYCLONE Xi MODEL #BTX-100, 129 GPH RECOVERY @90 DEGREE RISE. SET WATER HEATER TO 140 DEG MAX. ENERGY FACTOR = 0.96
SINK					
10549	1	SINK - RINSE DROP IN SST - 12X20IN 305X510MM	SB	GC	
10995 12807	1	SINK - MOP - 24X24IN 610X610MM SINK - UTENSIL RINSE WITH GRATE SST - LH -	SB SB	GC GC	
13264	1	14X20IN 355X510MM SINK - 3 COMP WORK SST - 93IN 2350MM	SB	GC	
14688	1	SINK - HAND WITH SIDE SPLASH WALL MOUNTED SST	SB	GC	
17565	1	SINK - RINSE WITH DRAINBOARD - 15X27IN 380X685MM	SB	GC	
17632	1	SINK - STACKED DRAINBOARD - 15IN 380MM	SB	GC	+
18743	1	SINK - WATER FILLING STATION - 36X24IN 915X610MM	SB	GC	
19277	2	SINK - COUNTERTOP RINSER WITH DRAIN TROUGH - 26X9IN 660X235MM	SB	GC	
X0012	2	SINK - D13	GC	GC	DJ13 INTEGRATED SINK SYSTEM. 30IN
X0012	2	SIIR - DIS	GC	GC	XLERATORSYNC SYSTEM WITH A SINGLE BASIN SINK WITH A PIVOT DRAIN COVER. GLACIER WHITE CORIAN COUNTER TOP AND ENCLOSURE PANELS. BASIN COLOR: D 13 WHITE. ORDER WITH LOCKING SLIDING DOOR & SECURITY PANEL. CONTACT: D 13 GROUP. 245 WEST CENTRAL STREET, NATICK, MA 01760. PH: 617-307-1140. WWW.D13GROUP.COM
OII ET					01700.111.017 007 1140. WWW.B100R001.00W
		TOURT TANK FOR FERIOURN TOURGUE STUDY	00	00	
OILET 12951 13040	2 2	TOILET - TANKLESS EFFICIENT SINGLE FLUSH TOILET - FLUSH VALVE AUTOMATIC EFFICIENT	GC GC	GC GC	SLOAN MODEL ST-2020-1.28 (1.28 GPF) CROWN MODEL 8111-1.28 FLUSHOMETER (1.28

SPECIALTY EQUIPMENT SCHEDULE - "E"						
DESIGN ID	COUNT	DESCRIPTION	FURN. BY	INST. BY	COMMENTS	
10267	5	FRIDGE UNDERCOUNTER 1 DOOR - 27IN 685MM	SB	GC		
10970 11083	1 2	FRIDGE REACH IN 1 DOOR LH - 29IN 735MM FRIDGE REACH IN 2 DOOR - 51X35IN	SB SB	GC GC		
12618	2	1295X890MM FRIDGE UNDERCOUNTER 1 DOOR WITH	SB	GC		
13676	1	SHELF - 27IN 685MM FREEZER REACH IN 1 DOOR RH - 27IN 685MM	SB	GC		
13682	1	FREEZER REACH IN 2 DOOR - 54IN 1370MM	SB	GC		
20011	1	FRIDGE NITRO 2 TAP JT NITCOM RH	SB	GC	KIT INCLUDES UNDERCOUNTER FRIDGE, FONT, TRAY, AND TUBING	
10312	4	BREWER SOFT HEAT WARMING STAND SINGLE	SB	GC		
10746	1	BREWER DUAL SOFT HEAT	SB	GC	GC TO COORDINATE WITH SBUX VENDOR.	
10808 10856	1 6	GRINDER DITTING KR1203 BREWER SERVER SOFT HEAT	SB SB	GC GC	GC TO COORDINATE WITH SBUX VENDOR.	
12407	2	OVEN TURBOCHEF NEXT GENERATION	SB	GC		
12508	2	BLENDER QUIET MODEL ON COUNTER	SB	GC		
12508	1	BLENDER QUIET MODEL ON COUNTER - BACK-UP	SB	GC	TO BE STORED IN BACK OF HOUSE UNLESS NEEDED	
15186 16623	1	DISHWASHER HOT LOW STEAM SCALE DIGITAL WITH ADJUSTABLE DISPLAY	SB SB	GC GC		
17564	1	MOUNT SMALL RI ENDED DITCHED DINGED WITH SENSOD	SP.	GC		
17564 19559	1	BLENDER PITCHER RINSER WITH SENSOR NITROGEN GENERATOR ELEMENT	SB SB	GC	GC TO COORDINATE INSTALLATION & CONNECTIONS WITH SBUX VENDOR	
19742	2	ESPRESSO MACHINE MASTRENA II	SB	GC	GC TO COORDINATE WITH SBUX VENDOR.	
OOD CASE 16238	1	FOOD CASE - ZEPHYR - 66IN 1675MM	SB	GC		
CE						
10344 18029	<u>1</u> 1	ICE - BIN DROP IN 90LB 40KG	SB SB	GC GC		
18846	1	ICE - MACHINE CIM1446HR SERIES REMOTE COOLED	SB	GC		
19278 THER	2	ICE - BIN DROP IN 45LB 20KG HORIZONTAL	SB	GC		
10091	1	CUP DISPENSER TALL HOT VERTICAL	SB	GC		
10099	2	RESTROOM TOILET PAPER HOLDER	SB	GC		
10172	2	RESTROOM SEAT COVER DISPENSER	SB	GC		
10384 10396	2 1	DIAPER CHANGING STATION HORIZONTAL CUP DISPENSER SHORT HOT VERTICAL	SB SB	GC GC		
10390	1	FILE CABINET 2 DRAWER	SB	GC		
10501	1	FIRE EXTINGUISHER	GC	GC	LOCALLY SOURCED	
10769	2	RESTROOM GRAB BAR VERTICAL - 18IN 455MM	SB	GC		
10791	2	CUP DISPENSER GRANDE VENTI COLD VERTICAL	SB	GC		
10855	2	CUP DISPENSER GRANDE VENTI HOT VERTICAL	SB	GC		
10858	1	CUP DISPENSER TALL COLD VERTICAL	SB	GC		
10859	2	RESTROOM GRAB BAR - 48IN 1220MM	SB	GC		
10862 10947	2 1	RESTROOM GRAB BAR - 36IN 915MM SOAP DISPENSER WALL MOUNTED	SB SB	GC GC		
10947	1	PAPER TOWEL DISPENSER FULL SIZE -	SB	GC		
10992	2	TRANSLUCENT GRAY PAPER TOWEL DISPENSER HALF SIZE -	SB	GC		
11115	2	TRANSLUCENT GRAY	SB	GC		
11115 13330	1	SOAP DISPENSER SINK MOUNTED MOBILE CUP DISPENSER CADDY	SB	GC		
13584	1	CUP DISPENSER TRENTA COLD VERTICAL	SB	GC		
19495	1	NITRO 2 TAP HANDLE AND BADGE KIT	SB	GC		
20079	1	NITRO 2 TAP BADGE MOUNT BACKBAR LH	SB	GC		
20080	2	NITRO 2 TAP BADGE MOUNT BACKBAR RH SHARPS CONTAINER	SB SB	GC GC		
X0009	2	HAND DRYER - INTEGRATED	GC	GC	XLERATOR SYNC HAND DYER. AUTOMATIC SENSOR OPERATED. SURFACE MOUNTED. CONTACT: D 13 GROUP. 245 WEST CENTRAL STREET, NATICK, MA 01760. PH:	
X0011	2	SOAP DISPENSER - STERN	GC	GC	617-307-1140. WWW.D13GROUP.COM STERN. GREEN/CHROME SOAP DISPENSER. PART #07100008. PART OF D 13 INTEGRATED SINK SYSTEM. CONTACT: D 13 GROUP. 245 WEST CENTRAL STREET, NATICK, MA 01760. PH: 617-307-1140. WWW.D13GROUP.COM	
STORAGE					1	
10222	2	WIRE SHELF GRID AT SINK	SB	GC		
10416 10462	9	WORKROOM SHELVING - 36IN 915MM WORKROOM SHELVING POSTS	SB SB	GC GC		
10402	1	MOP RACK WITH 3 HOLDERS	SB	GC		
13834	1	BASE - 24X18IN 610X455MM	SB	GC		
15699	1	PARTNER WORK CENTER	SB	GC		
17255 17264	1	PASTRY TRAY CART - 60IN 1525MM ROLLING PASTRY TRAY THAW RACK - 20X26IN 510X660MM	SB SB	GC GC		
17639	1	WORKROOM CART - 24IN 610MM	SB	GC		
	2	5 COMP LOCKER - 12IN 305MM	SB	GC		

DESIGN ID	COUNT	DESCRIPTION	FURN. BY	INST. BY	COMMENTS
17573	2	CABINET - BACKBAR COUNTER SUPPORT PANEL - 3IN 75MM	SB	GC	
17574	3	CABINET - BACKBAR SINK OR ICE - 15IN 380MM	SB	GC	
17575	1	CABINET - BACKBAR SINK OR ICE - 20IN 510MM	SB	GC	
17575	2	CABINET - CBE TEA SHELF - 29IN 735MM - FLAT BLACK MT0028	SB	GC	NOT PROVIDED BY CASEWORK VENDOR
17581	1	CABINET - CBE DRY INCLUSION SHELF - 23IN 585MM - FLAT BLACK MT0028	SB	GC	NOT PROVIDED BY CASEWORK VENDOR
17740	2	CABINET - BACKBAR - 30IN 760MM	SB	GC	
17741	4	CABINET - BACKBAR 15IN 380MM	SB	GC	
17743	1	CABINET - DT POS - 30IN 760MM	SB	GC	
17744	1	CABINET - FRONTBAR POS BRIDGE - 22IN 560MM	SB	GC	
17745	1	CABINET - BACKBAR DRAWER - 15IN 380MM	SB	GC	
17747	1	CABINET - BACKBAR TRASH - 15IN 380MM	SB	GC	
18122 19280	1	CABINET - BACKBAR SINK OR ICE - 16IN 405MM CABINET - ESPRESSO CUBBY WITH OPEN BACK - 15IN 380MM	SB SB	GC GC	
19281	2	CABINET - ESPRESSO ICE BIN STAINLESS - 20IN 510MM	SB	GC	
21189	1	CABINET - FRONTBAR - 15IN 380MM	SB	GC	
21191	1	CABINET - FRONTBAR DRAWER - 15IN 380MM	SB	GC	
21192	2	CABINET - FRONTBAR POS - 30IN 760MM	SB	GC	
21193	1	CABINET - ESPRESSO CUBBY WITH OPEN BACK - 18IN 455MM	SB	GC	
X0016	1	CABINET - DT POS UPPER CUBBY W DOORS	SB	GC	SEE DETAILS
X0032	2	CABINET - BACKBAR COUNTER CUSTOM CABINET	SB	GC	SEE DETAILS
X0035	1	CABINET - 12IN 305MM	SB	GC	SEE DETAILS
20131	1	CONDIMENT CART THREE DROP - WHITE OAK AND WHITE WD0073 CP0002	SB	GC	NOT PROVIDED BY CASEWORK VENDOR
20367	1	WALL BAY 2 UNIT - 72IN 1830MM - WHITE OAK WD0073	SB	GC	NOT PROVIDED BY CASEWORK VENDOR
COUNTERT)P				
17809	2	COUNTERTOP - HAND SINK WITH LOW SPLASH STAINLESS - 15IN 380MM	SB	GC	
17828	1	COUNTERTOP - BACKSPLASH - VARIABLE LENGTH	SB	GC	LENGTH:5'-10 3/4". SEE DETAILS FOR ADDITIONAL INFORMATION
19711 20061	1	COUNTERTOP - WARMING - RF - 75IN 1905MM SB GC COUNTERTOP - ESPRESSO METRO - RF - 139IN SB GC 3530MM SB GC			
20063	1	COUNTERTOP - FRONTBAR CAP - 139IN 3530MM	SB	GC	
X0006	1	COUNTERTOP - FRONTBAR MOP PLANAR - 30IN 760MM	SB	GC	SEE DETAILS
X0015	1	COUNTERTOP - AT DT	SB	GC	SEE DETAILS
X0017	1	COUNTERTOP - CBE - w/ MAGIC SINK- RF - 112IN 2845MM	SB	GC	SIMILAR TO 17577. PROVIDE OPENING FOR MAGIC SINK INSTEAD OF RINSE TRAY & WATER FILLER.
X0018 X0019	1	COUNTERTOP - POS COUNTERTOP - DT POS - LF - VARIABLE LENGTH	SB SB	GC GC	SEE DETAILS LENGTH: 6' - 7 153/256" SEE DETAILS FOR ADDITIONAL INFORMATION
X0020	1	COUNTERTOP - BREW WITH TRASH DROP - LF	SB	GC	SEE DETAILS
X0033	1	CORIAN SILL @ DT WINDOW	SB	GC	1" SILL, SEE DETAILS
X0037 DIEWALL	1	COUNTERTOP - BACKBAR NITRO - RH	SB	GC	SIMILAR TO 20051, W/O BACKSPLASH & WATERFALL EDGE
20064	1	DIEWALL - ESPRESSO - 139IN 3530MM	SB	GC	
X0013	1	DIEWALL	SB	GC	SEE DETAILS
X0023	1	DIEWALL - POS	SB	GC	SEE DETAILS
OTHER 10218	2	CORNER GUARD - 0.75IN 20MM - CLEAR PLASTIC	SB	GC	GC TO INSTALL FULL HEIGHT. PAINT INSIDE FACE TO MATCH ADJACENT WALL COLOR.
11142 11155	2 2	CORBEL SUPPORT - 24IN 610MM ESPRESSO MACHINE PUMP MOUNT - 10X10IN 255X255MM	SB SB	GC GC	
17829	1	FRENCH CLEAT - VARIABLE LENGTH	SB	GC	OVERALL LENGTH 3' - 2"
18145	4	COUNTERTOP SUPPORT LEG	SB	GC	
20066	1 1	SHROUD - 139IN 3530MM SNEEZE GUARD - 139IN 3530MM	SB SB	GC GC	
20067	2	COUNTERTOP SUPPORT LEG SLIM	SB	GC	
X0026	1	WOOD TRIM - WD0073	SB	GC	1X1IN. WD0073 WOOD TRIM. SEE WALL TREATMENT LENGTH SCHEDULE.
PANEL					
20065	1	PANEL - 139IN 3530MM	SB	GC	
X0014	1	PANEL	SB	GC	SEE DETAILS
X0024	1	PANEL	SB	GC GC	SEE DETAILS
X0025	1	WAINSCOT	SB		SEE WALL TREATMENT (LENGTH)

RESPONSIBILITY LEGEND				
GC	GENERAL CONTRACTOR			
LL	LANDLORD			
SB	STARBUCKS			



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STARBUCKS TEMPLATE VERSION i2020-01-31





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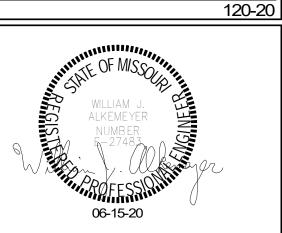
Engineering Consultant

2020

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SET



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STORE #: PROJECT#: ISSUE DATE: 06-16-2020
SR. DESIGN MANAGER: K. GORIN SLONSKI
PRODUCTION DESIGNER: A. HAHN
CHECKED BY: SMD / SWE

Revision Schedule

Rev	Date	Ву	Description

PLUMBING SCHEDULES

SCALE: AS SHOWN SHEET NUMBER: