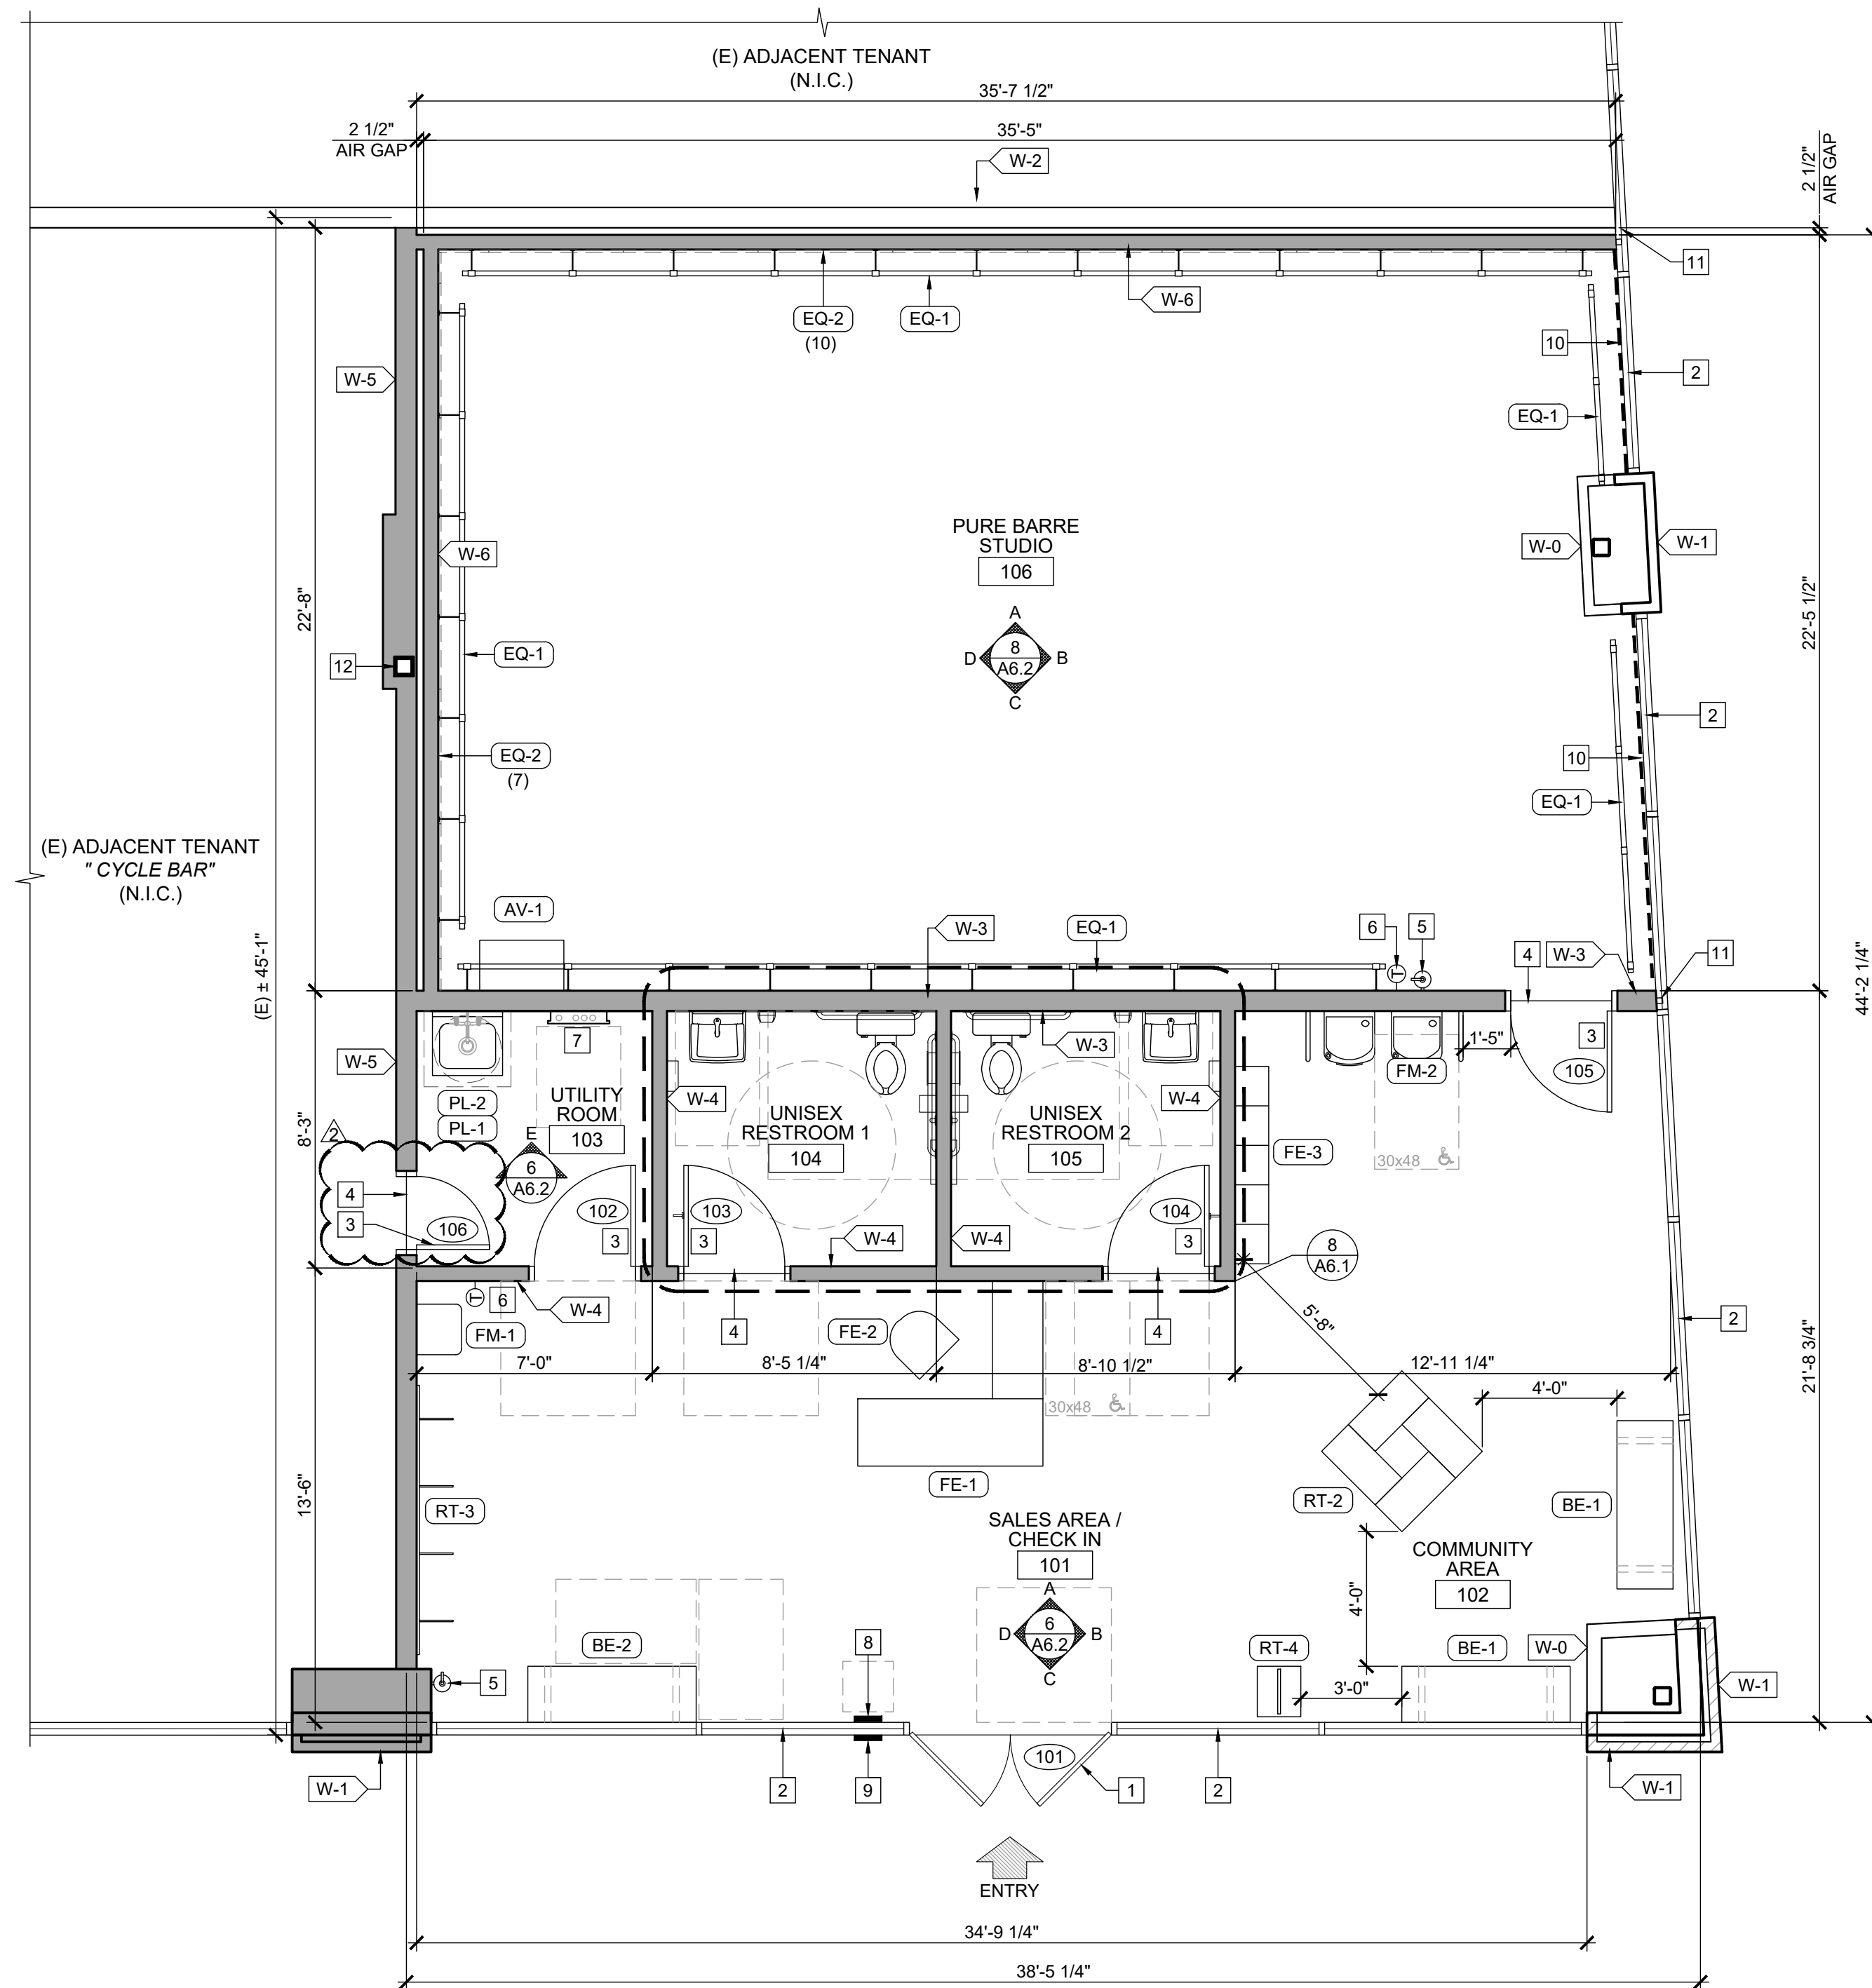


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GENERAL NOTES

- | | | | |
|--|---|---|---|
| <p>SEE REFLECTED CEILING PLAN FOR SOFFIT AND LIGHTING INFORMATION.</p> <p>NOTIFY ARCHITECT IMMEDIATELY OF ANY INCONSISTENCIES OR DISCREPANCIES WITH PLANS IN RELATION TO EXISTING FIELD CONDITIONS.</p> <p>WRITTEN DIMENSIONS TAKE PRECEDENCE OVER SCALE ON THE CONSTRUCTION DOCUMENTS. DO NOT EVER SCALE DRAWINGS.</p> <p>DIMENSIONS ARE FROM THE FACE OF FINISHED WALL (GWB) TO FACE OF FINISHED WALL (GWB), UNLESS OTHERWISE NOTED ON PLANS.</p> <p>ALL MANUFACTURED ARTICLES, MATERIALS AND EQUIPMENT SHALL BE APPLIED, INSTALLED, CONNECTED, ERECTED, CLEANED AND CONDITIONED IN ACCORDANCE WITH THE MANUFACTURER'S WRITTEN SPECIFICATIONS AND/OR INSTRUCTIONS.</p> | <p>ALL WORK SHALL BE EXECUTED IN A MANNER ACCEPTABLE TO THE ARCHITECT, OWNER, AND LANDLORD UNLESS NOTED OTHERWISE. THE GENERAL CONTRACTOR SHALL PROVIDE AND PAY ALL LABOR, MATERIALS EQUIPMENTS, TOOLS, CONSTRUCTION EQUIPMENT, MACHINERY, TRANSPORTATION AND OTHER SERVICES AND FACILITIES NECESSARY FOR PROPER AND TIMELY EXECUTION OF WORK.</p> <p>THE CONTRACTOR WARRANT TO THE OWNER AND TO THE ARCHITECT THAT ALL MATERIALS AND EQUIPMENT FURNISHED UNDER THE CONTRACT ARE NEW UNLESS OTHERWISE SPECIFIED, AND THAT ALL WORKS SHALL BE AS SPECIFIED AND FREE OF DEFECTS.</p> <p>ALL OUTSIDE CORNERS AT DRYWALL PARTITION AND FURRING TO HAVE METAL CORNER BEADS SPACKLE AND SMOOTH.</p> | <p>PROVIDE DIAGONAL BRACING TO STRUCTURE ABOVE ALL NEW DOORS, GLAZING HEADS AND JAMBS AS REQUIRED TO MAKE ASSEMBLY RIGID.</p> <p>THE GENERAL CONTRACTOR (G.C.) IS RESPONSIBLE FOR THE FINAL CLEAN UP OF THE AREA OF WORK AND AREA AFFECTED BY CONSTRUCTION, TO INCLUDE BUT NOT LIMITED TO FLOORS, MILLWORK, FIXTURES, ETC. FOLLOWING THE INSTALLATION OF THE MILLWORK.</p> <p>THE GENERAL CONTRACTOR SHALL COORDINATE THE LOCATIONS FOR THE WALL MOUNTED TELEVISIONS AND GRAPHIC SIGNAGE TO PROVIDE BLOCKING FOR MOUNTING.</p> <p>ALL WET / PLUMBING WALLS ARE TO BE PROVIDED w/ MOISTURE RESISTANT GYPSUM BOARD. PROVIDE CEMENT BACKER BOARD WHEN TILE IS IN USED.</p> | <p>ALL PLUMBING WALLS ARE TO BE 6" METAL STUD FRAMING. PROVIDE REQUIRED BLOCKING FOR WALL MOUNTED FIXTURES, GRAB BARS, SHELVING, CABINETY, ETC.</p> <p>THERE SHALL BE NO PENETRATIONS TO A DEMISING WALL, U.O.N. IF PENETRATIONS ARE TO BE NOTED, THEN ALL PENETRATIONS INCLUDING CONDUTIS, PIPES, DUCTWORK, ETC. SHALL BE UL RATED PER CURRENT CODE REQUIREMENTS.</p> <p>NO PLUMBING IS ALLOWED IN DEMISING WALLS. FURRED OUT AS REQUIRED.</p> <p>ALL (E) DEMISING WALLS FOR TENANT SEPARATION ARE NOT TO BE DISTURBED OR MODIFIED IN ANY WAY.</p> |
|--|---|---|---|



(N) FLOOR PLAN AND EQUIPMENT PLAN




SCALE
1/4" = 1'-0"

FIX #		EQUIPMENT LIST		
REF	QT	DESCRIPTION		
AF-1	-	SUBWOOFER		
AV-1	1	AV EQUIPMENT	TBD	
BE-1	2	SEATING BENCH	60" L x 20" W x 17" H	MOVABLE
BE-2	1	ADA SEATING BENCH	MIN 42" L x 20" W	x17"H FLOOR MOUNTED
EQ-1	96FT	BALLET BARRE	FIELD VERIFY LENGTH	
EQ-2	17	MIRROR	SEE ELEVATIONS	
EQ-3	-	DEHUMIDIFIER	TBD - MOVABLE	
FE-1	1	RECEPTIONIST DESK W/ ACCESSIBLE SPACE	SEE DETAIL 2/A8.4	
FE-2	1	RECEPTIONIST CHAIR BY OWNER	TBD - MOVABLE	
FE-3	1	CUBBIES	SEE DETAIL 4/A8.4	
RT-1	-	RETAIL - 2-WAY DISPLAY	SEE DETAIL 9/A8.4	
RT-2	1	RETAIL - 4-WAY DISPLAY	SEE DETAIL 10/A8.4	
RT-3	1	RETAIL - SLAT WALL	WALL-MOUNTED	SEE DETAIL 12/A8.4
RT-4	1	RETAIL - TOE SOX DISPLAY	15.5"W x 18" D x 65" H	
FM-1	1	ADA COMPLAINT WATER DISPENSER	SEE DETAIL 12/A8.1	
FM-2	1	HIGH LOW DRINKING FOUNTAIN - ADA	SEE DETAIL 4/T1.3	
PL-1	1	MOP BASIN w/ BACKFLOW PREVENTER	24" L x 24" D x 13" H	
PL-2	1	TANK WATER HEATER	30 GALLONS	
PL-3	-	WASHER	4.5 CU. FT. CAPACITY	STACKED
PL-4	-	DRYER w/ BOOSTER FAN	7.3 CU. FT.	STACKED
PL-5	-	HANDSINK	TBD	
TV-1	-	TELEVISION	TBD	

WALL TYPES

- | | | |
|------|--|------------|
| W-0 | (E) INTERIOR WALL TO REMAIN | |
| W-1 | (E) EXTERIOR WALL TO REMAIN | |
| W-2 | (E) DEMISING WALL TO REMAIN. FULL HEIGHT, TYPE 'X' ON BOTH SIDES | |
| W-3 | (N) 6" x 20GA. METAL STUDS @ 16" O.C. w/ 5/8" GYPSUM BD. ON EACH SIDE
ADD ADDITIONAL 5/8" GYPSUM BD. ON THEATRE SIDE | 12
A7.1 |
| W-4 | (N) 3 5/8" x 20GA. METAL STUDS @ 12" O.C. w/ 5/8" GYPSUM BD. ON EACH SIDE | 8
A7.1 |
| W-4A | (N) 6" x 20GA. METAL STUDS @ 16" O.C. w/ 5/8" GYPSUM BD. ON EACH SIDE
(N) DEMISING WALL 6" x 20GA. METAL STUDS @ 16" O.C. W/ 1 LAYER OF 5/8" TYPE 'X' GYPSUM BD. ON ADJACENT TENANT SIDE (BY OTHERS) AND
(1) LAYERS OF 5/8" TYPE 'X' GYP. BD. ON PURE BARRE SIDE, FULL HEIGHT. | 8
A7.1 |
| W-5 | (N) SOUND WALL, 3 5/8" x 20GA. METAL STUDS @ 12" O.C. w/ (2) 5/8" GYPSUM BD. ON ONE SIDE, 2 1/2" AIR GAP, AND (1) 5/8" GYPSUM BD. ON DEMISING WALL | 16
A7.1 |
| W-6 | | 20
A7.1 |
- NOTE:
- PROVIDE 5/8" WATER AND MOLD RESISTANT GYPSUM BOARD WHERE PLUMBING WALLS OCCUR, TYP.
 - PROVIDE 5/8" TYPE "X" GYP. BOARD WHERE DEMISING WALLS OCCUR, TYP.
 - ALL WALLS TO RECEIVE 5/8" GYP. BOARD. (U.N.O.).

LEGEND

-  1 DAY PROGRAMMABLE THERMOSTAT, MOUNT T-STAT AT 48" A.F.F., SENSOR AT 96" A.F.F.
-  FIRE EXTINGUISHER UNIT. MOUNT HANDLE AT 48" A.F.F. MAX.
-  ELECTRICAL PANEL

KEYNOTES

- | | |
|----|--|
| 1 | (E) DOOR AND FRAME TO REMAIN. SEE DOOR SCHEDULE ON SHEET A8.1 |
| 2 | (E) FIXED STOREFRONT WINDOW TO REMAIN |
| 3 | (N) DOOR AND FRAME. SEE DOOR SCHEDULE ON SHEET A8.1 |
| 4 | (N) TRANSITION STRIP. SEE FINISH SCHEDULE ON SHEET A8.2 |
| 5 | (N) WALL-MOUNTED FIRE EXTINGUISHER UNIT. MOUNT HANDLE AT +4'-0" AFF. MAX. |
| 6 | PROVIDE (N) THERMOSTAT @ +4'-0" MAX. A.F.F. SEE TYP. HEIGHT 17
A7.1 |
| 7 | (N) ELECTRICAL PANEL. SEE ELECTRICAL DRAWINGS |
| 8 | (N) TACTILE EXIT SIGN. PROVIDE 18"x18" CLEAR FLOOR SPACE CTR. TO SIGN |
| 9 | (N) INTERNATIONAL ACCESSIBILITY SYMBOL |
| 10 | PROVIDE ROLL-A-SHADE MANUAL CONTRACT SERIES BLACK-OUT SHADE FABRIC W/ SIDE & BOTTOM CHANNELS WITH 60% TRANSMITTANCE AND STAINLESS STEEL CHAIN AND BLACK HARDWARE GC TO DETERMINE SIZE OF THE POCKET O.F.C.I. |
| 11 | ADD (N) MULL-T-OVER TRIM CLOSURE PIECES AT END WALL PLATE, OR EQUAL. |
| 12 | (E) STRUCTURAL COLUMN TO REMAIN |

Plotted: 5/29/2020 9:18 AM (nhaque) File: 07_a2275_a1.1_floor plan.dwg

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rachel.hilton@purebarre.com

CONSULTANT

**RELEASE FOR
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AS NOTED ON PLANS REVIEW
DEVELOPMENT SERVICES
LEE'S SUMMIT, MISSOURI**

06/02/2020

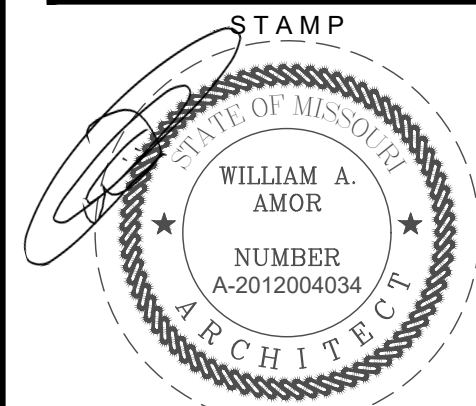
PURE BARRE
INTERIOR TENANT IMPROVEMENT
910-J NORTHWEST BLUE PARKWAY
LEE'S SUMMIT, MO 64086

NORTHWEST BLUE PARK
LEE'S SUMMIT, MO 64086

(N) FLOOR PLAN
AND EQUIPMENT PLAN









PROJECT LOCATION

SHEET TITLE



DATE SIGNED: 2020-05-29
RENEWAL DATE: 2020-12-31
SHEETS BEARING THIS SEAL AND WET SIGNATURE
ARE AUTHENTICATED. RESPONSIBILITY FOR ALL
OLDER PLANS, SPECIFICATIONS OR INSTRUMENTS

REVISIONS

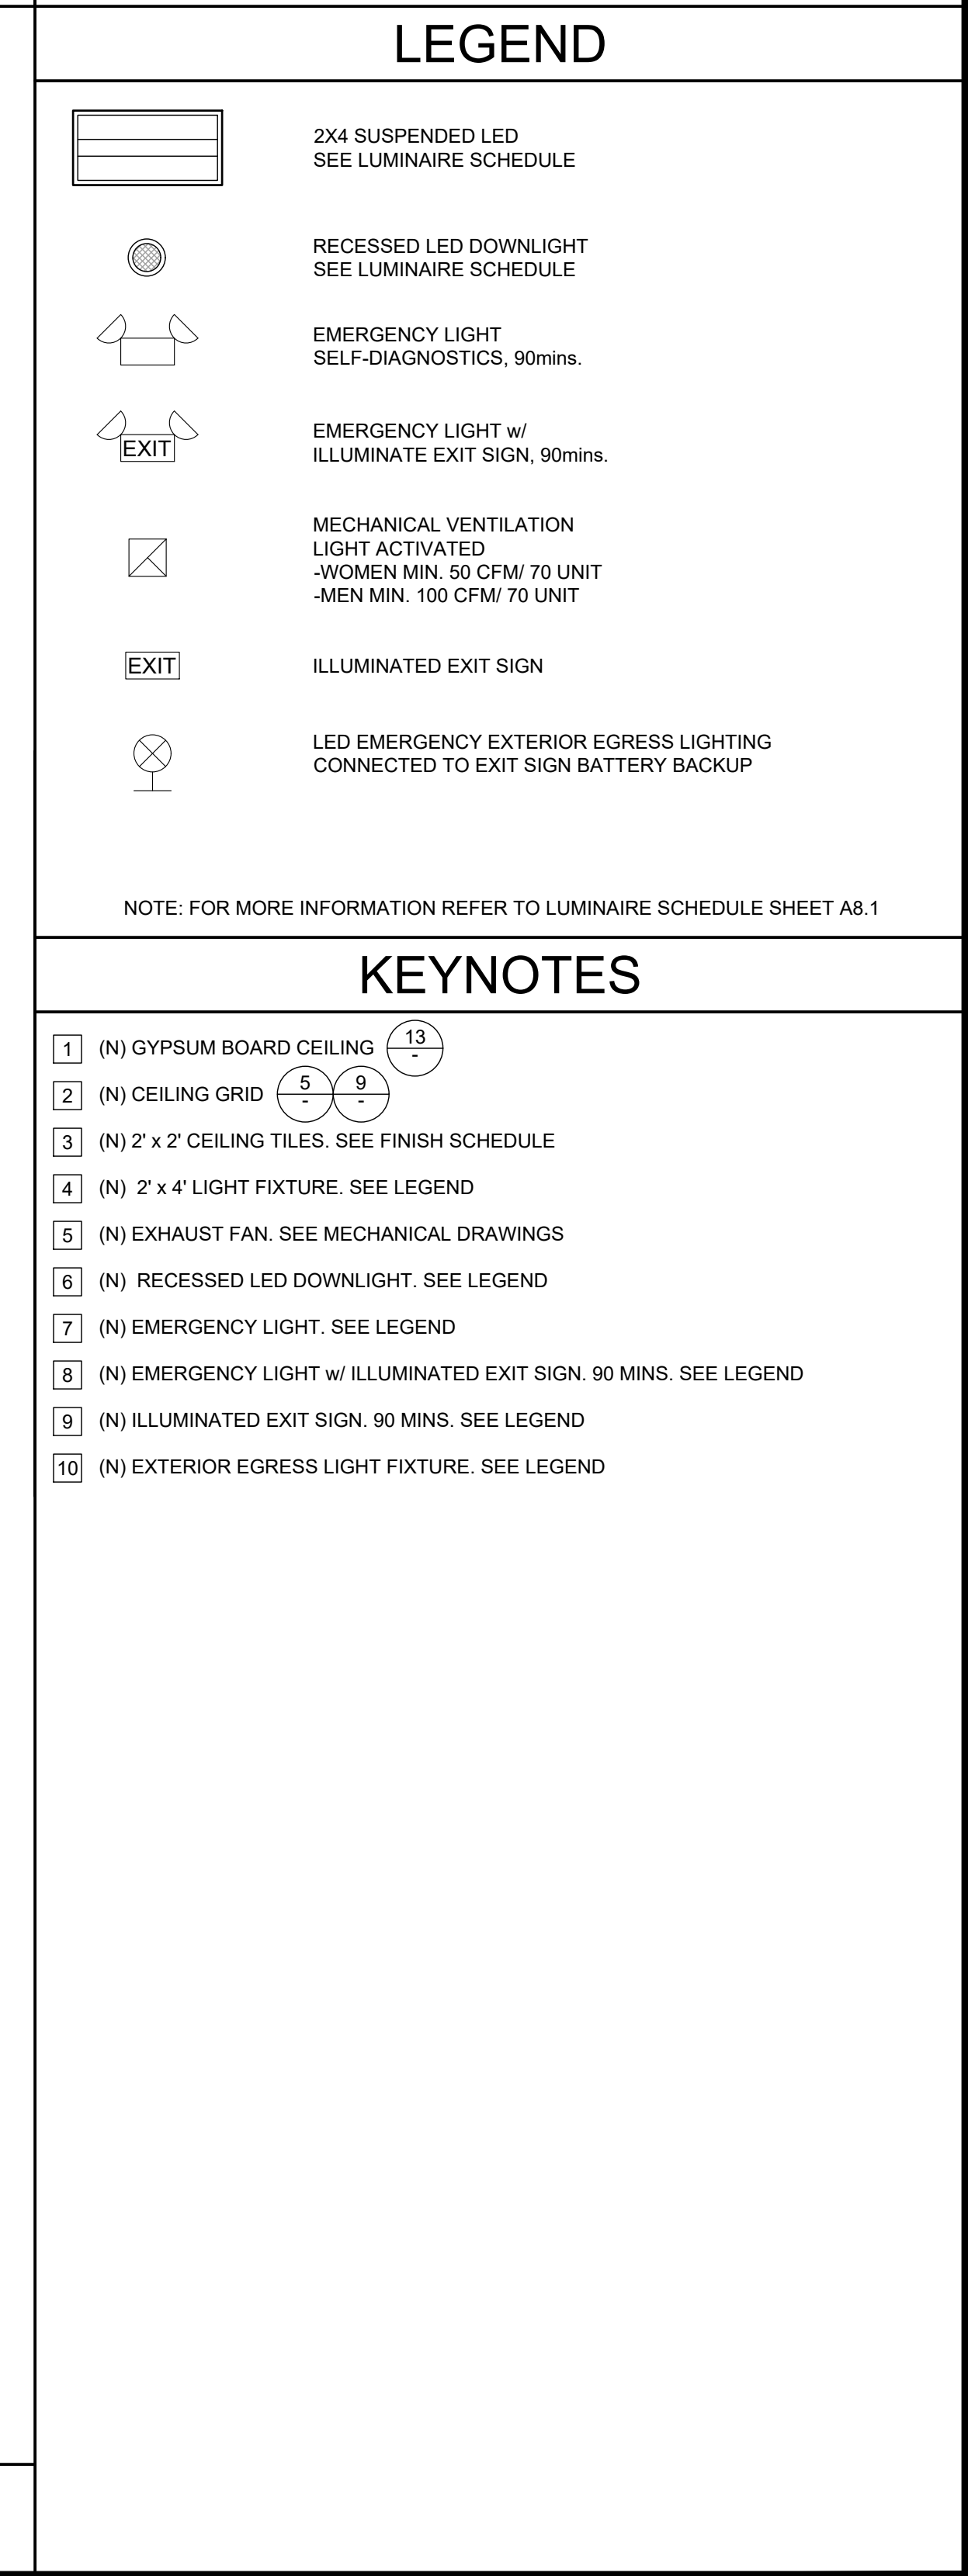
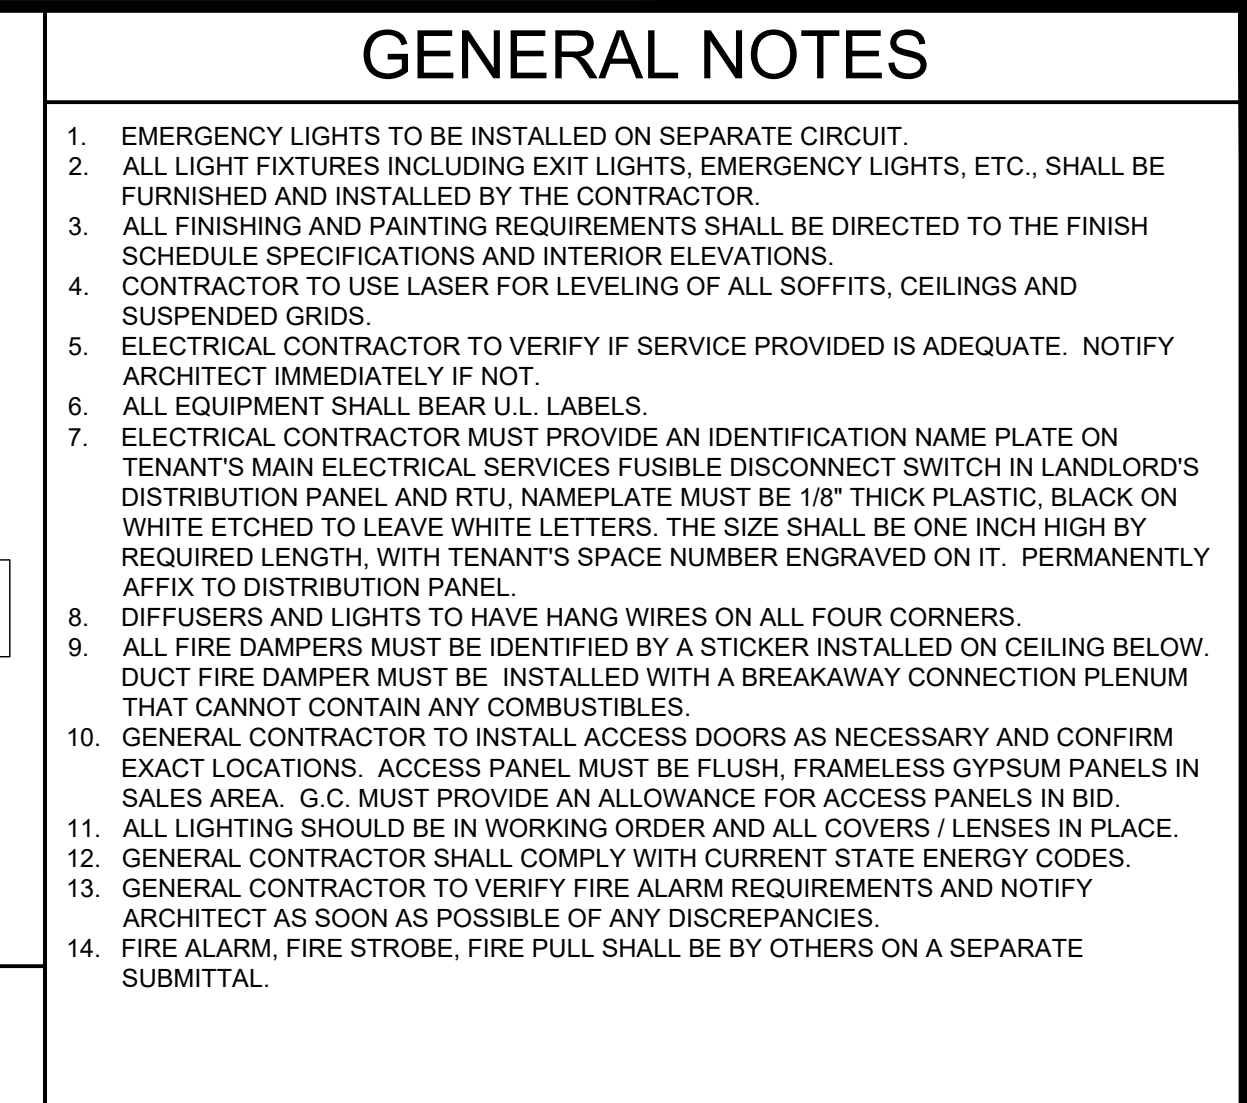
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|  | 2020-05-26 FIELD COORDINATION |
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DATE
2020.05.29
PROJECT NUM
A2275

SHEET NUMBER

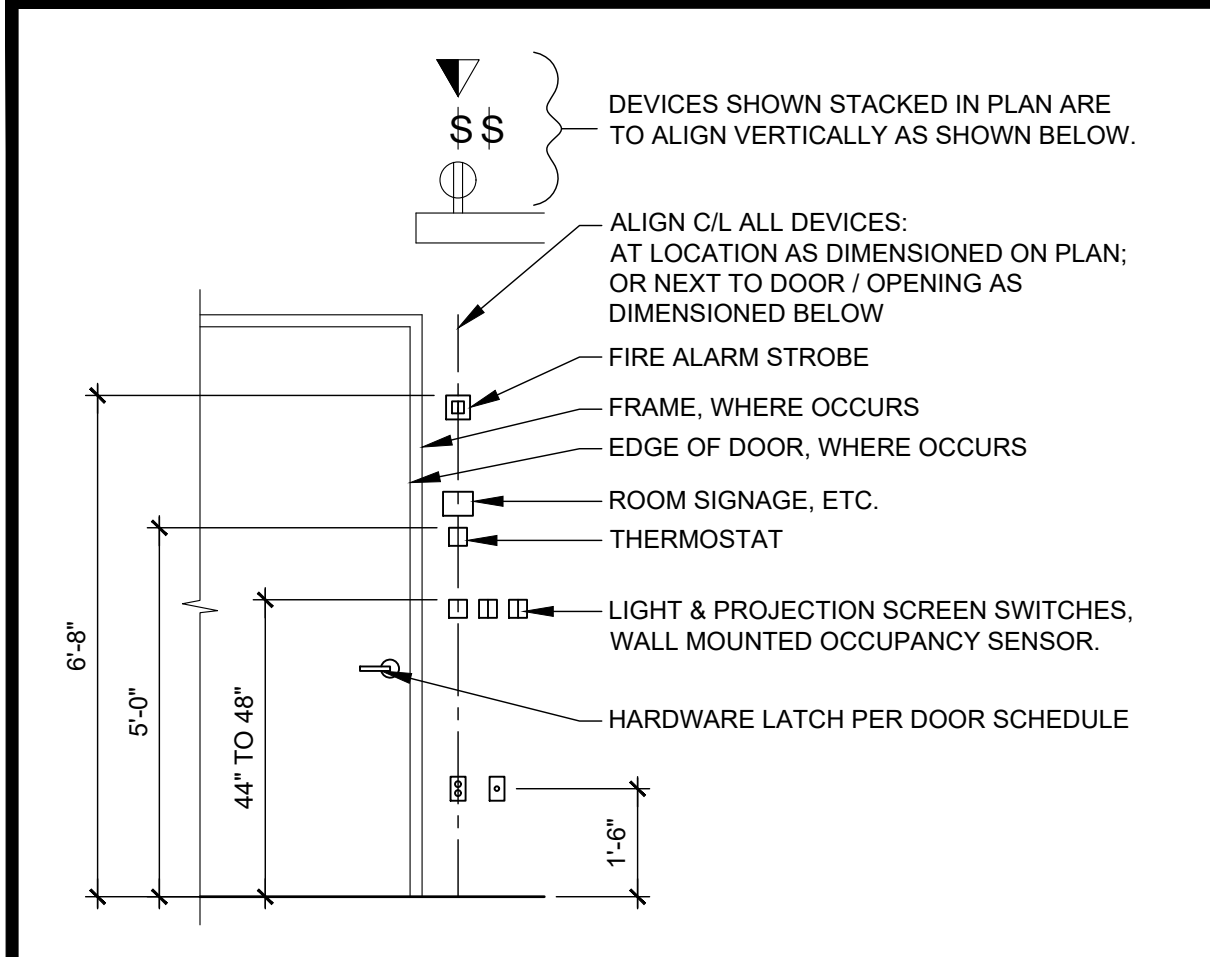
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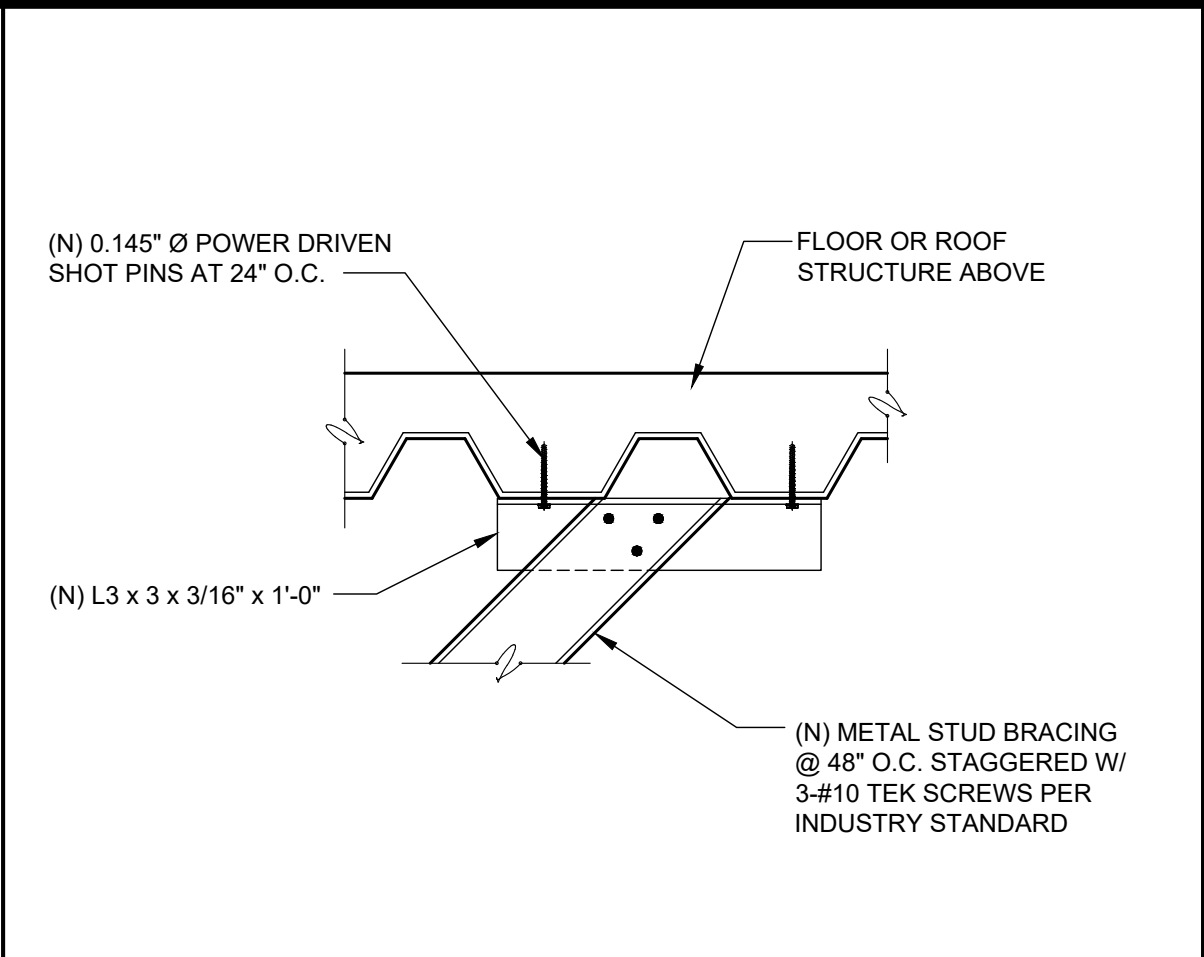
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TYPICAL ELECTRICAL HEIGHTS

SCALE
NTS

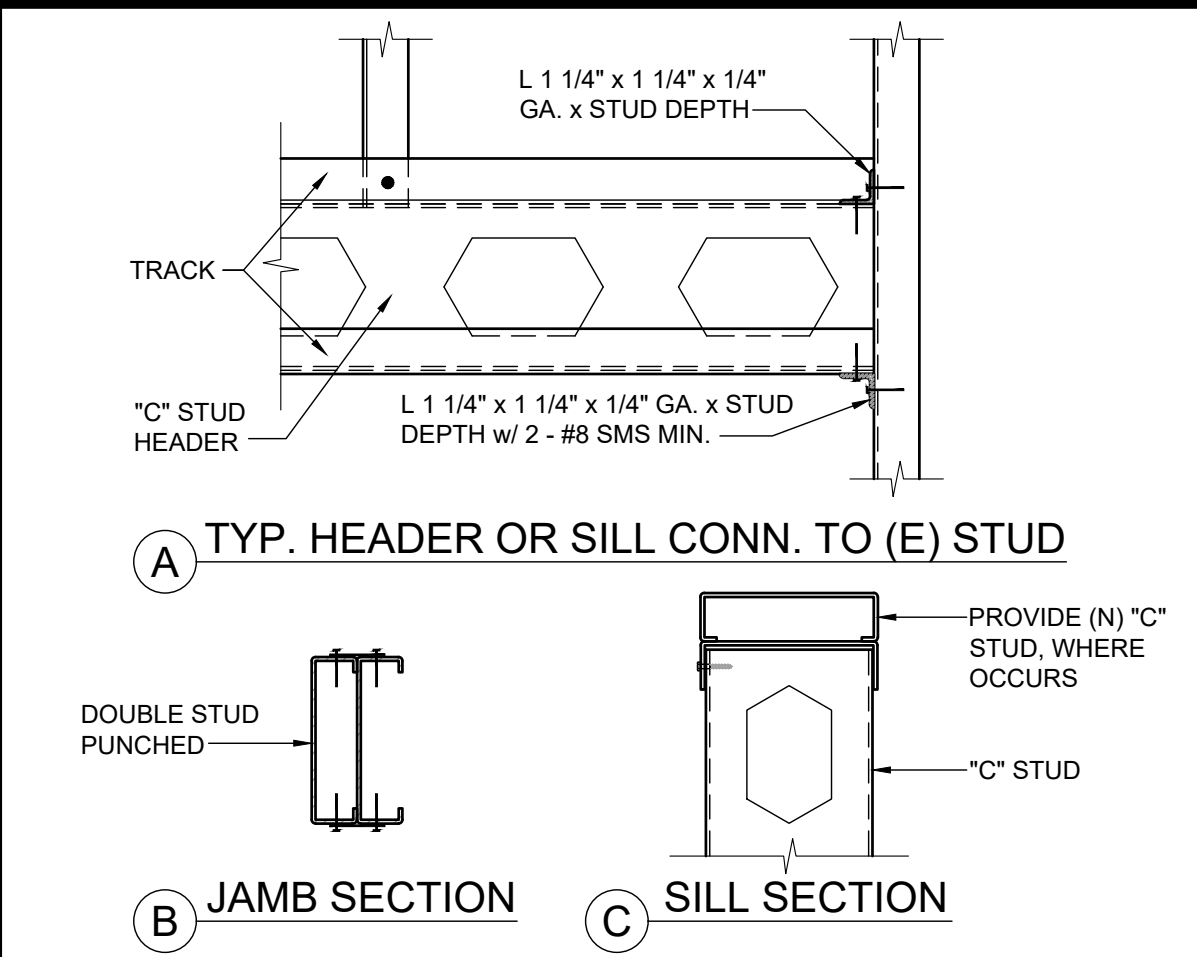
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BRACING @ METAL DECK

SCALE
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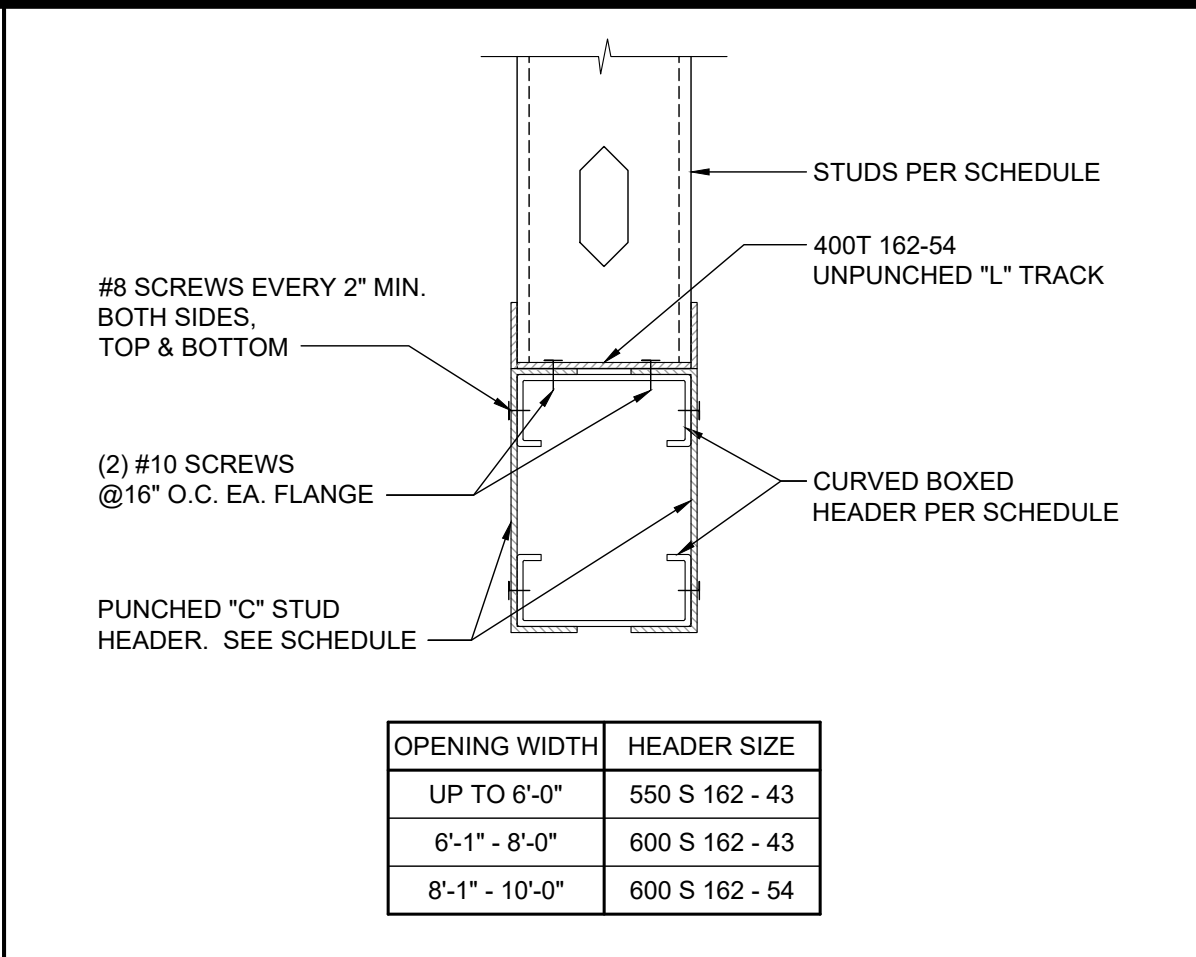
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STUD CONNECTION

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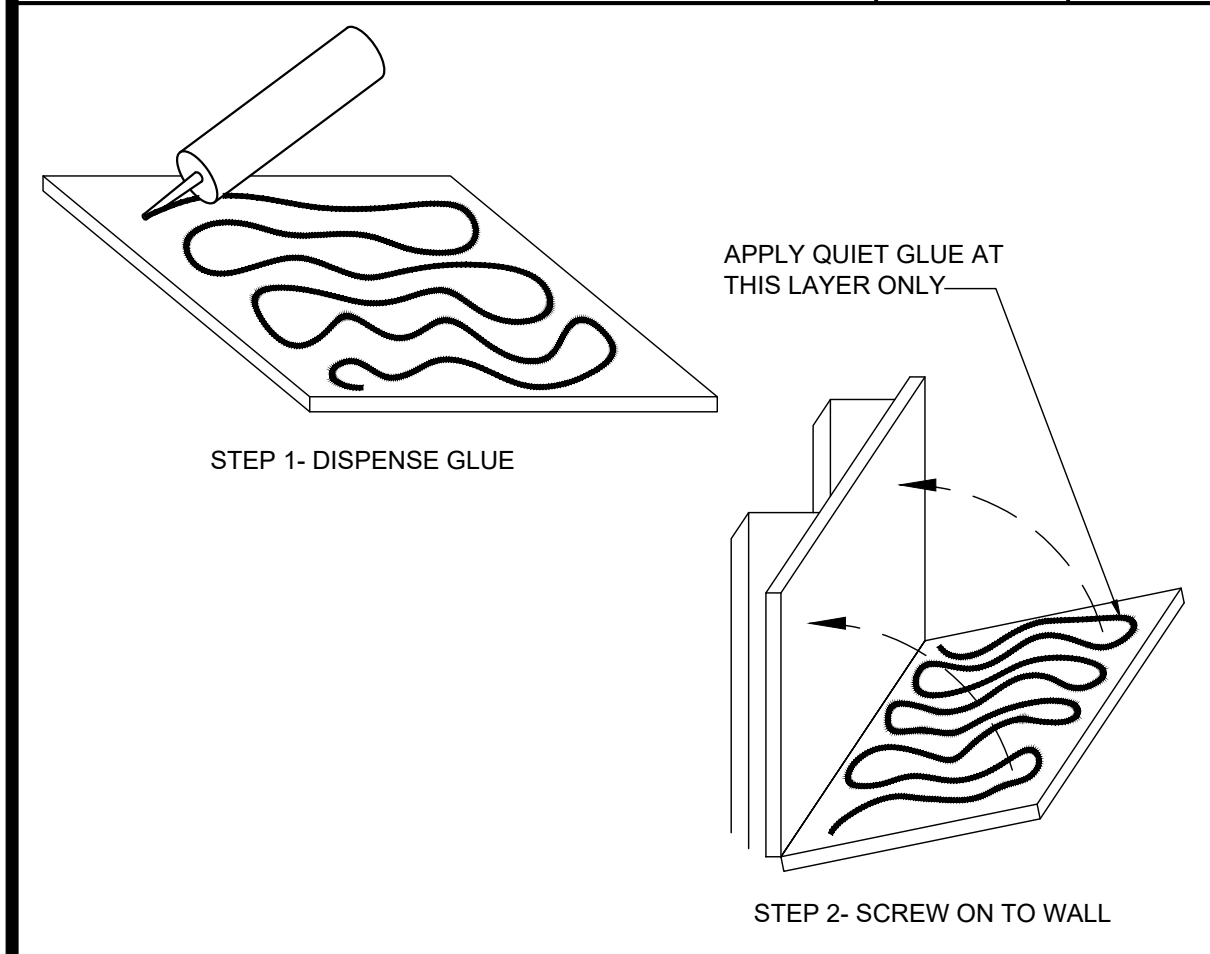
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BOX HEADER

SCALE
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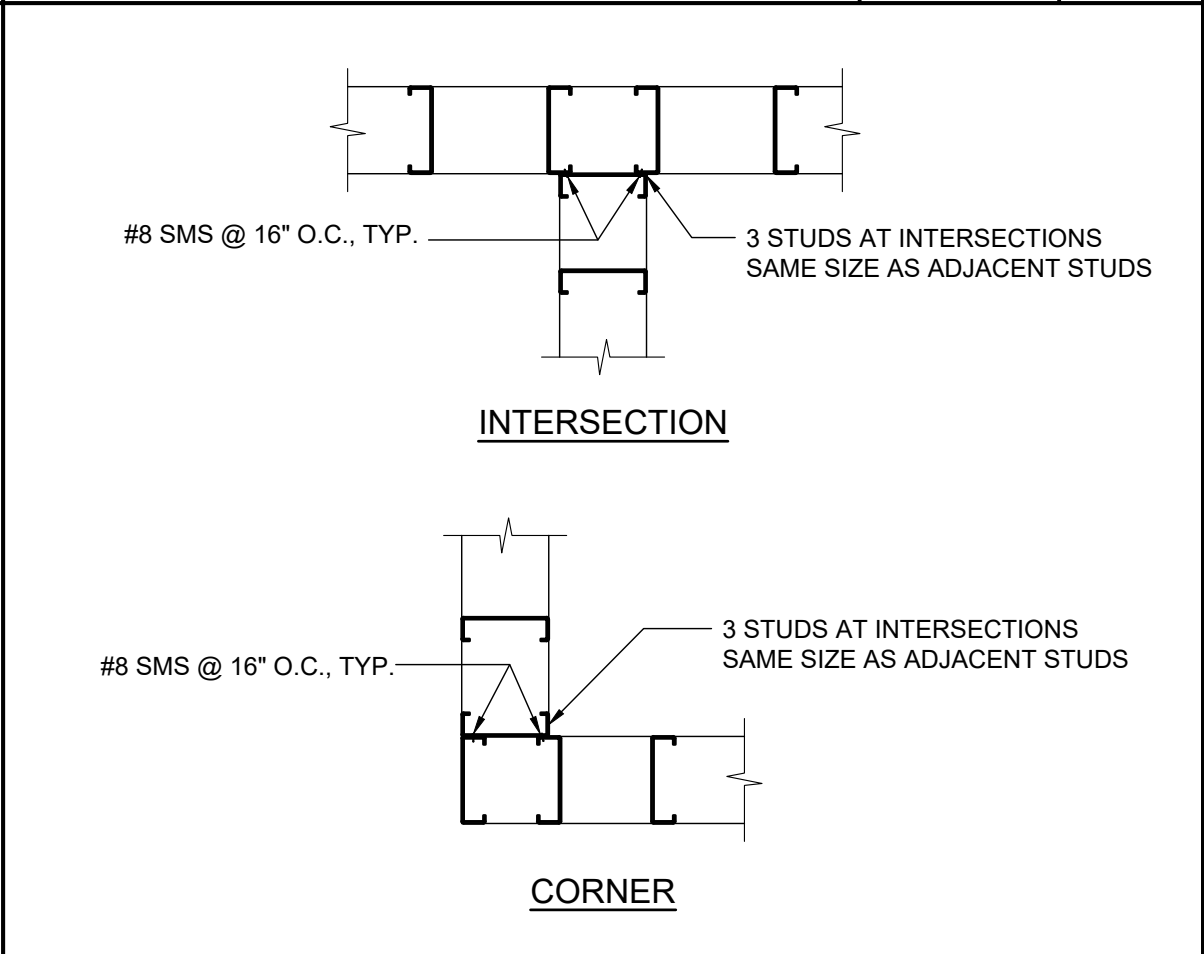
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QUIET GLUE

SCALE
NTS

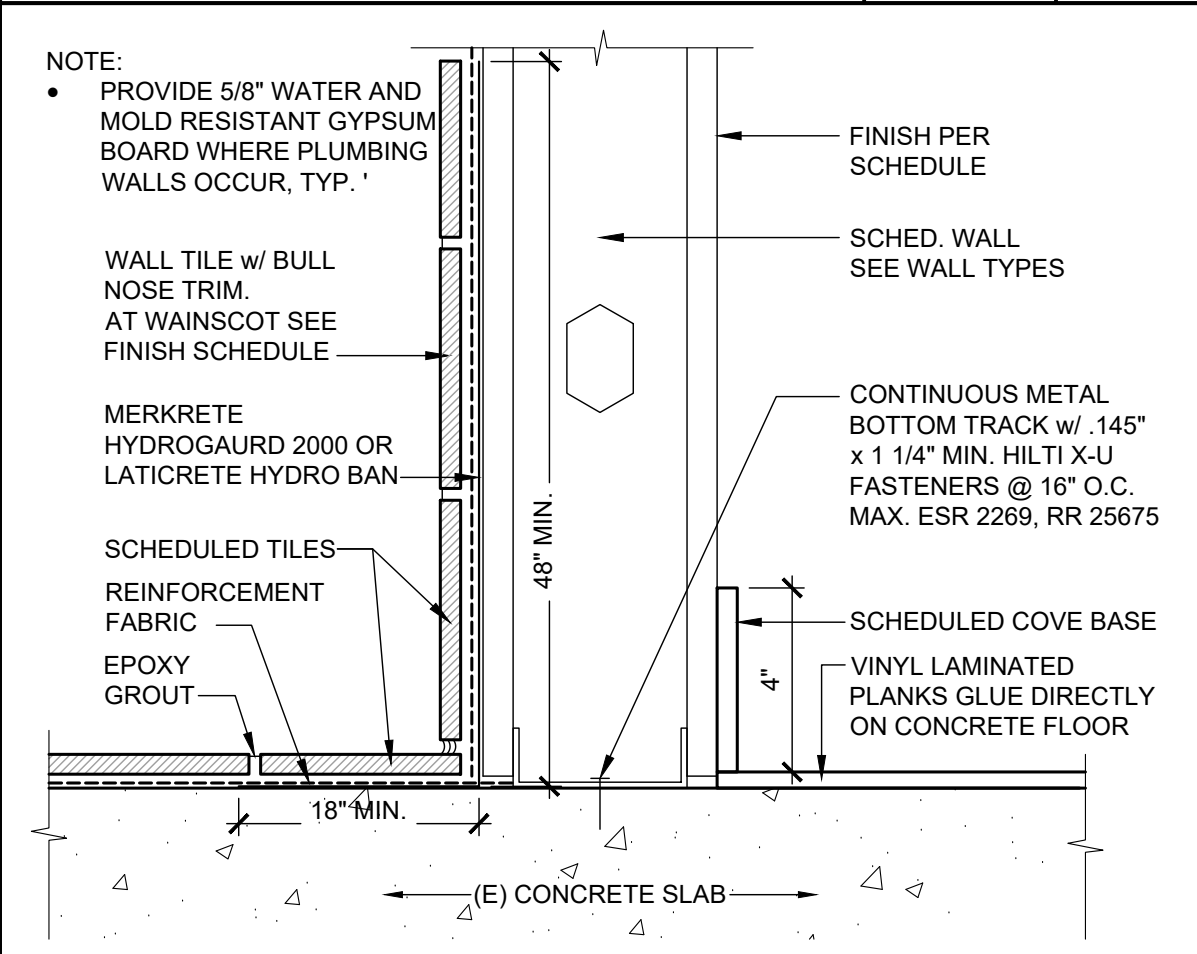
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TYP. STUD FRAMING

SCALE
1 1/2" = 1'-0"

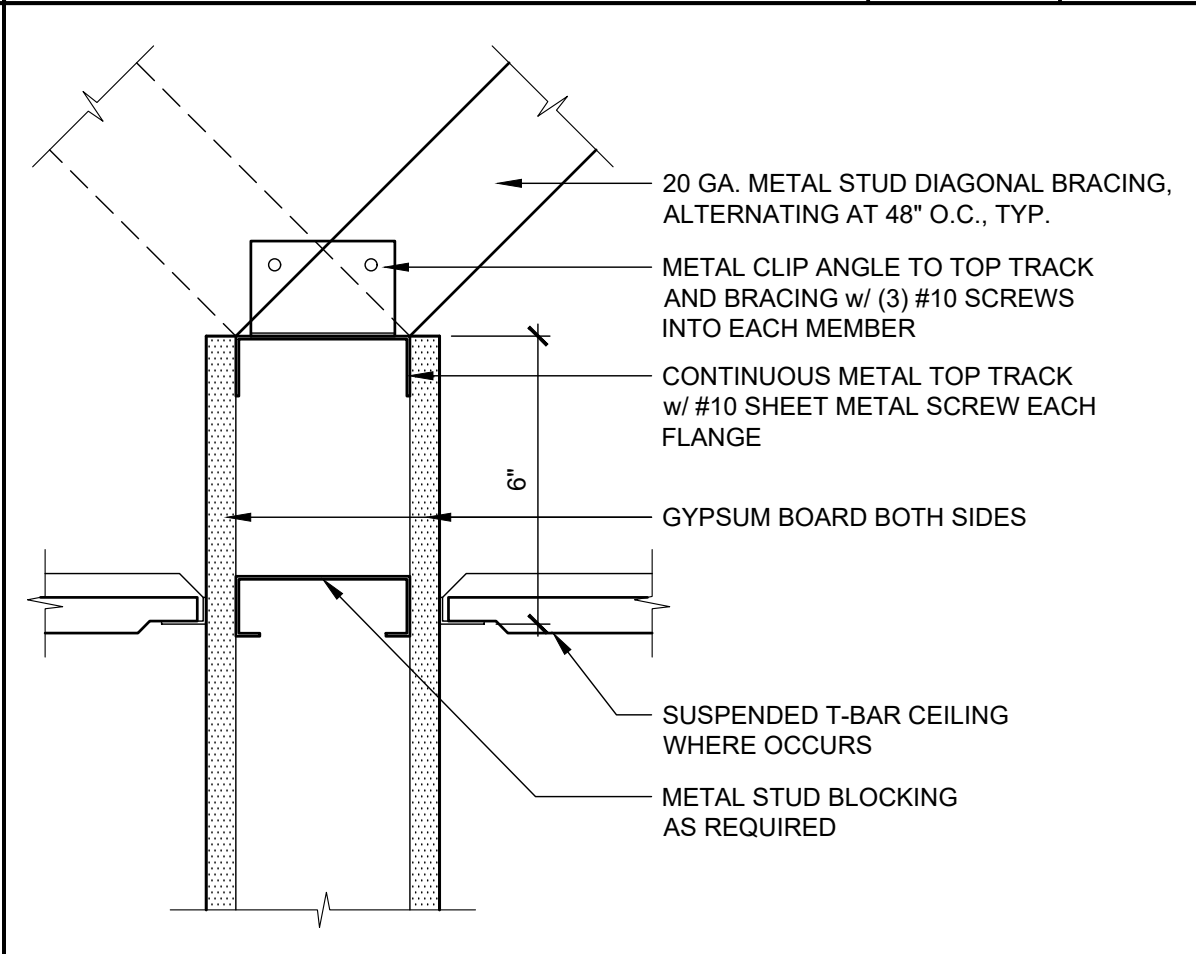
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WALL BASE DETAIL

SCALE
3" = 1'-0"

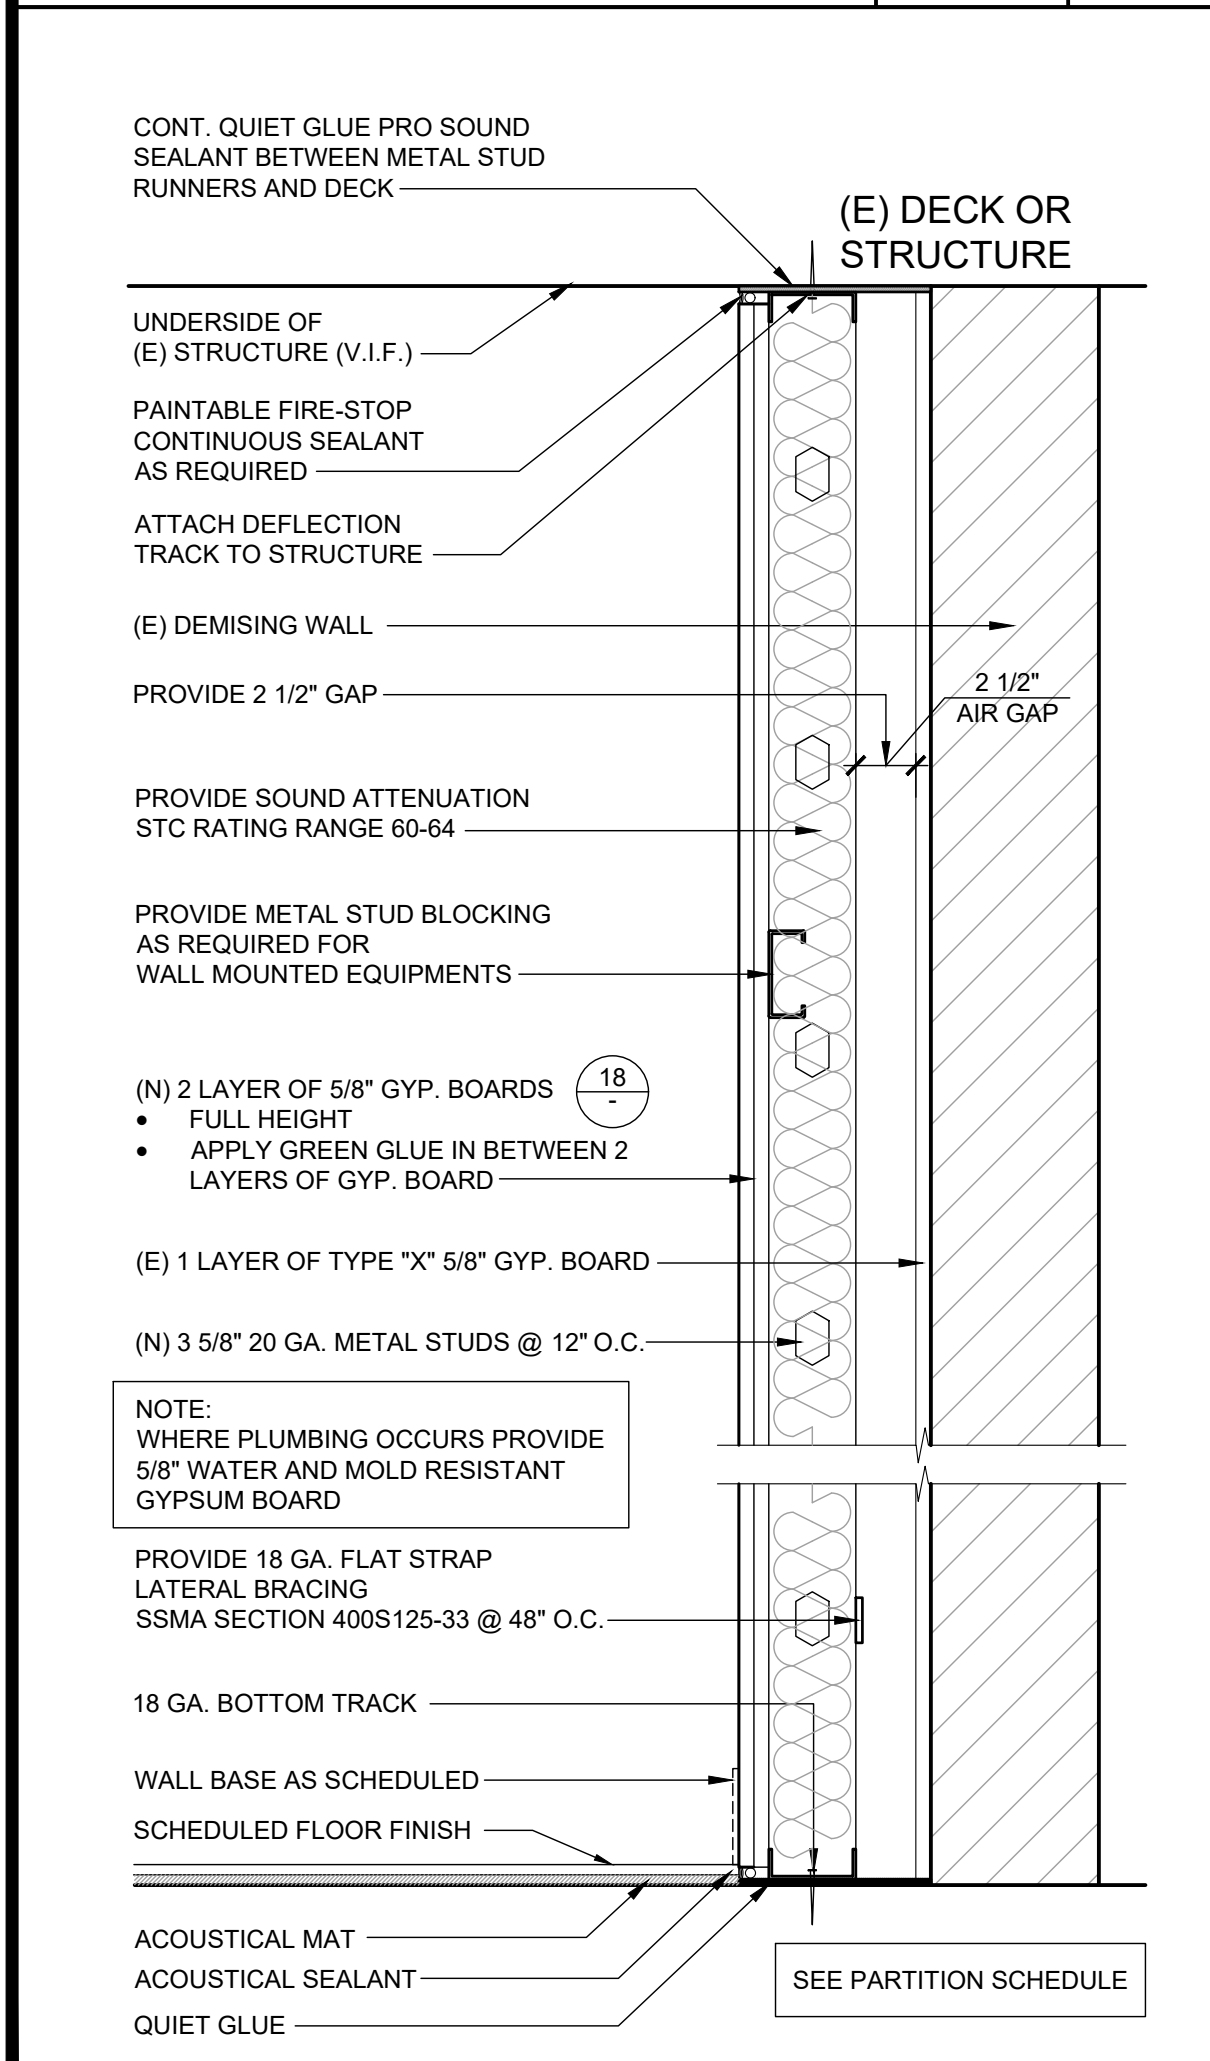
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TOP TRACK BRACING

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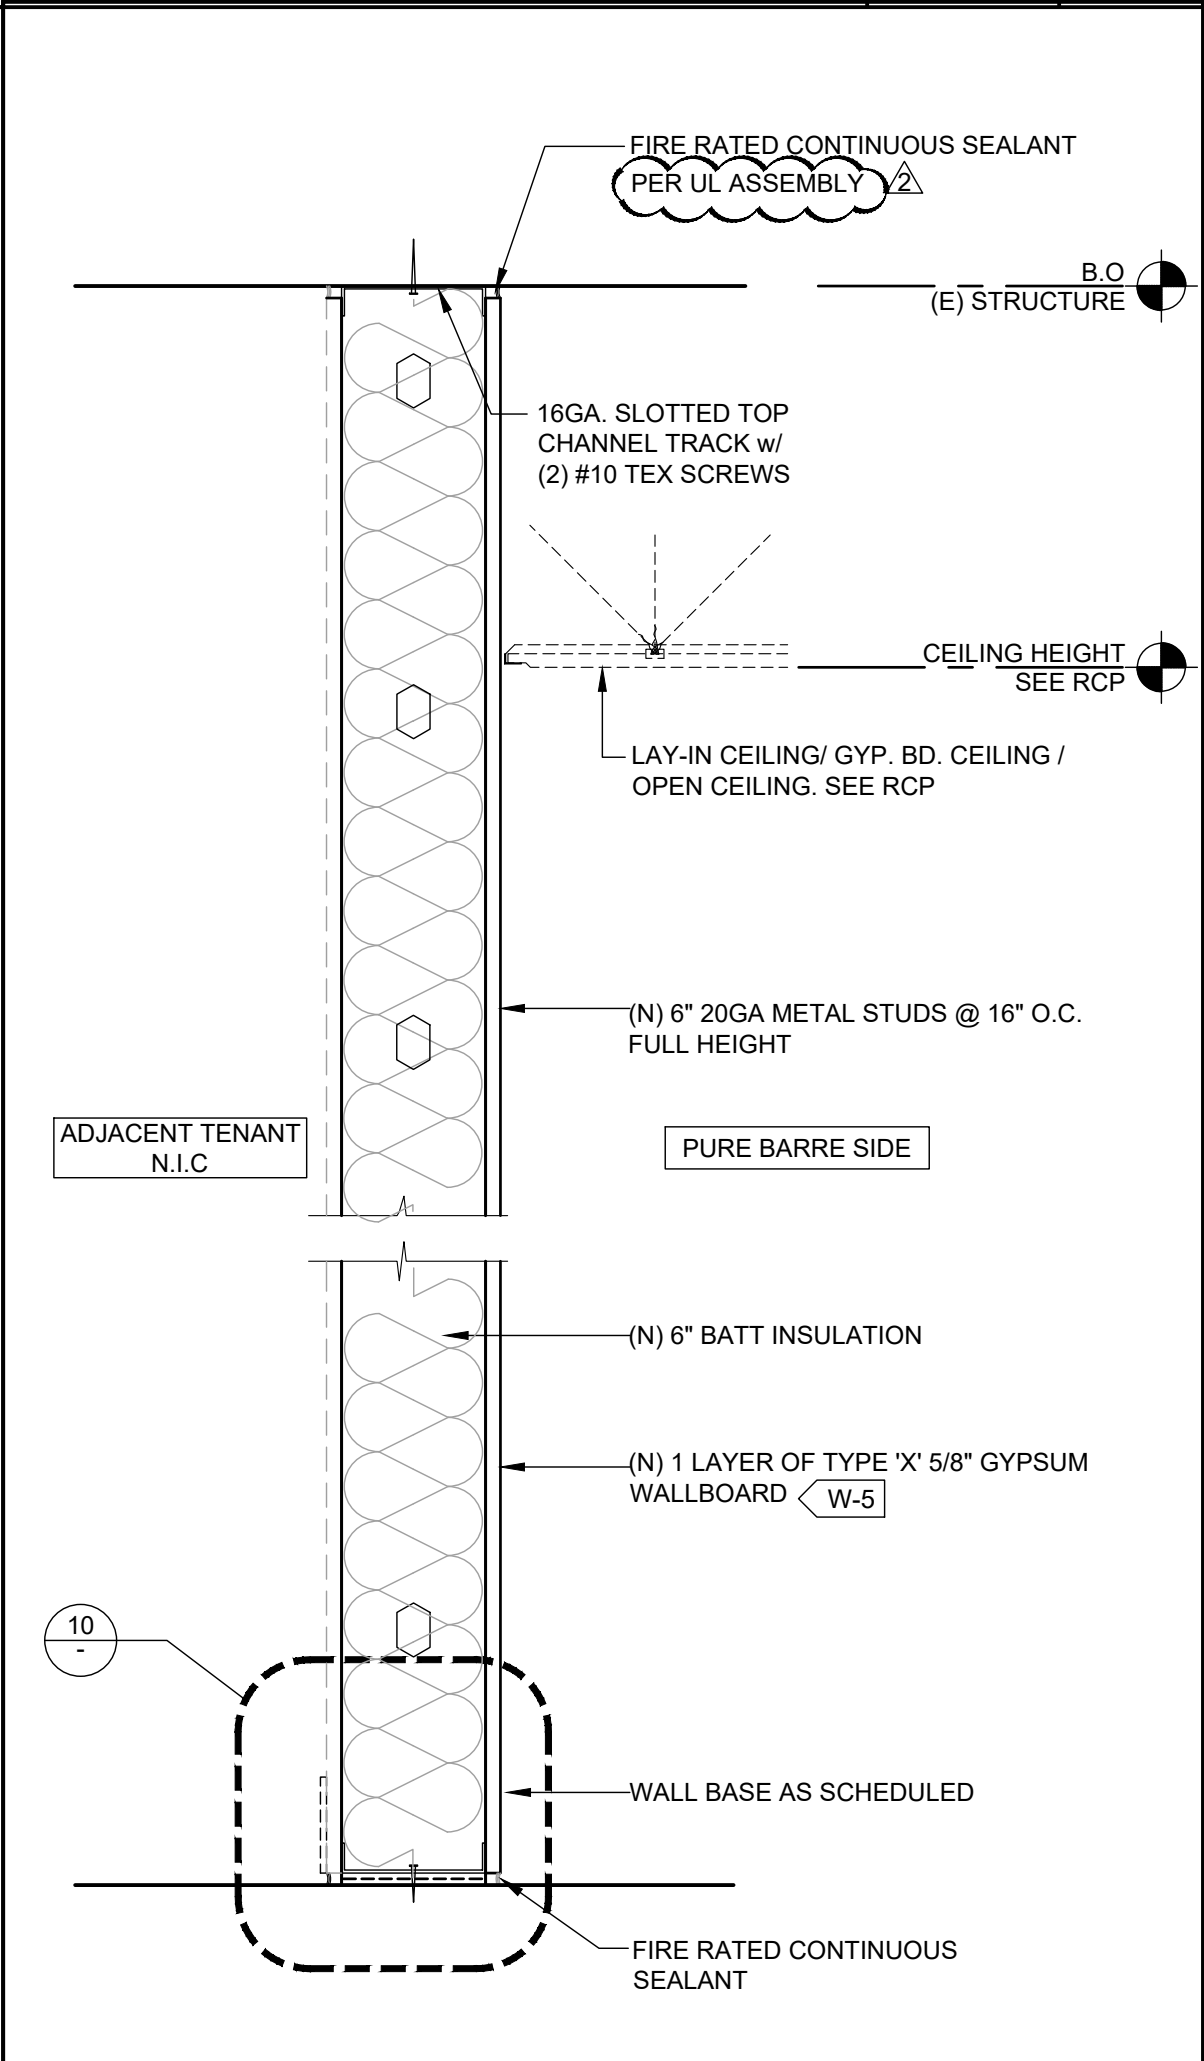
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WALL FURRING @ DEMISING WALL

SCALE
1 1/2" = 1'-0"

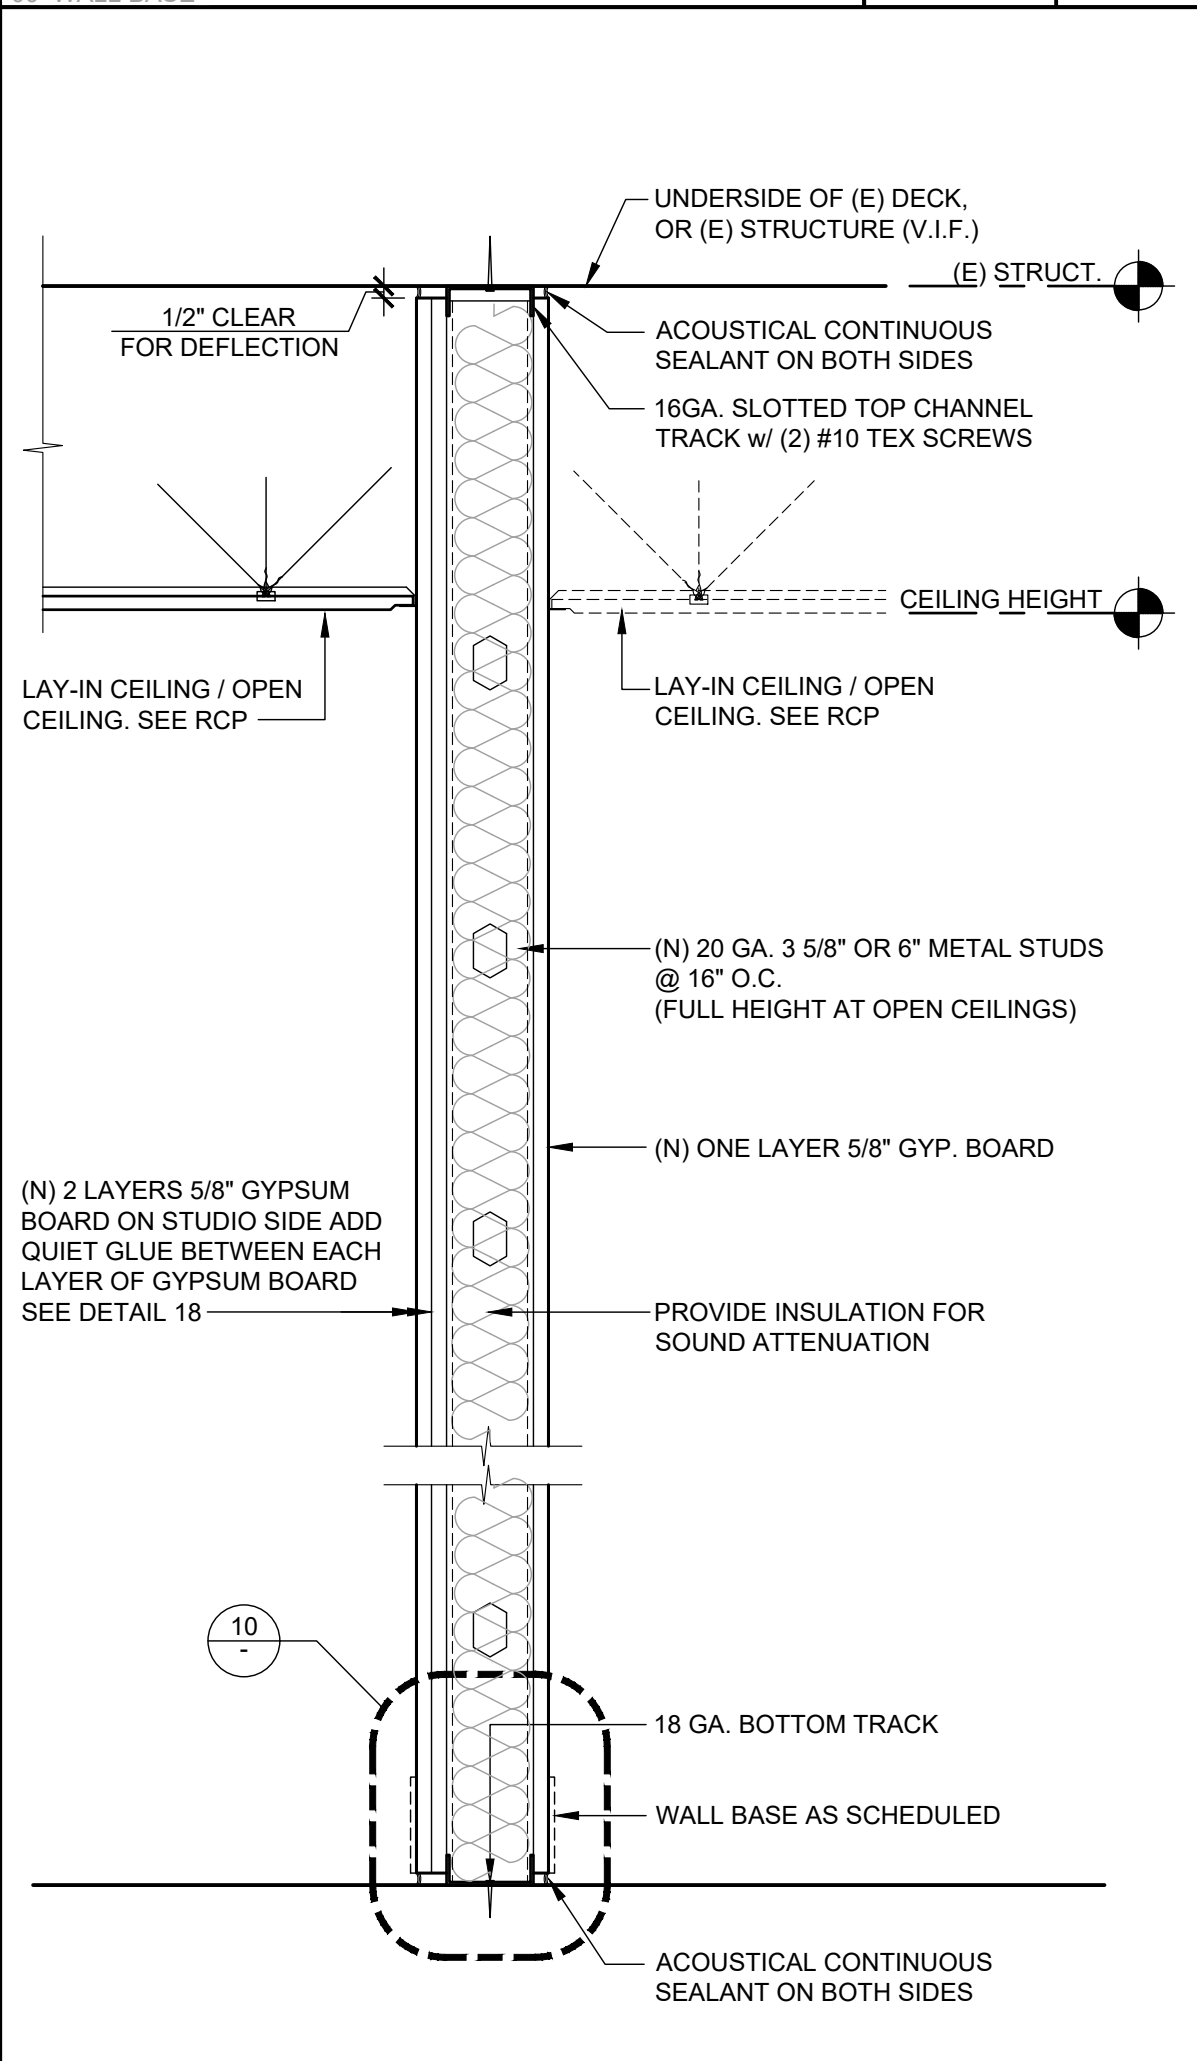
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1-HR FIRE RATED DEMISING WALL

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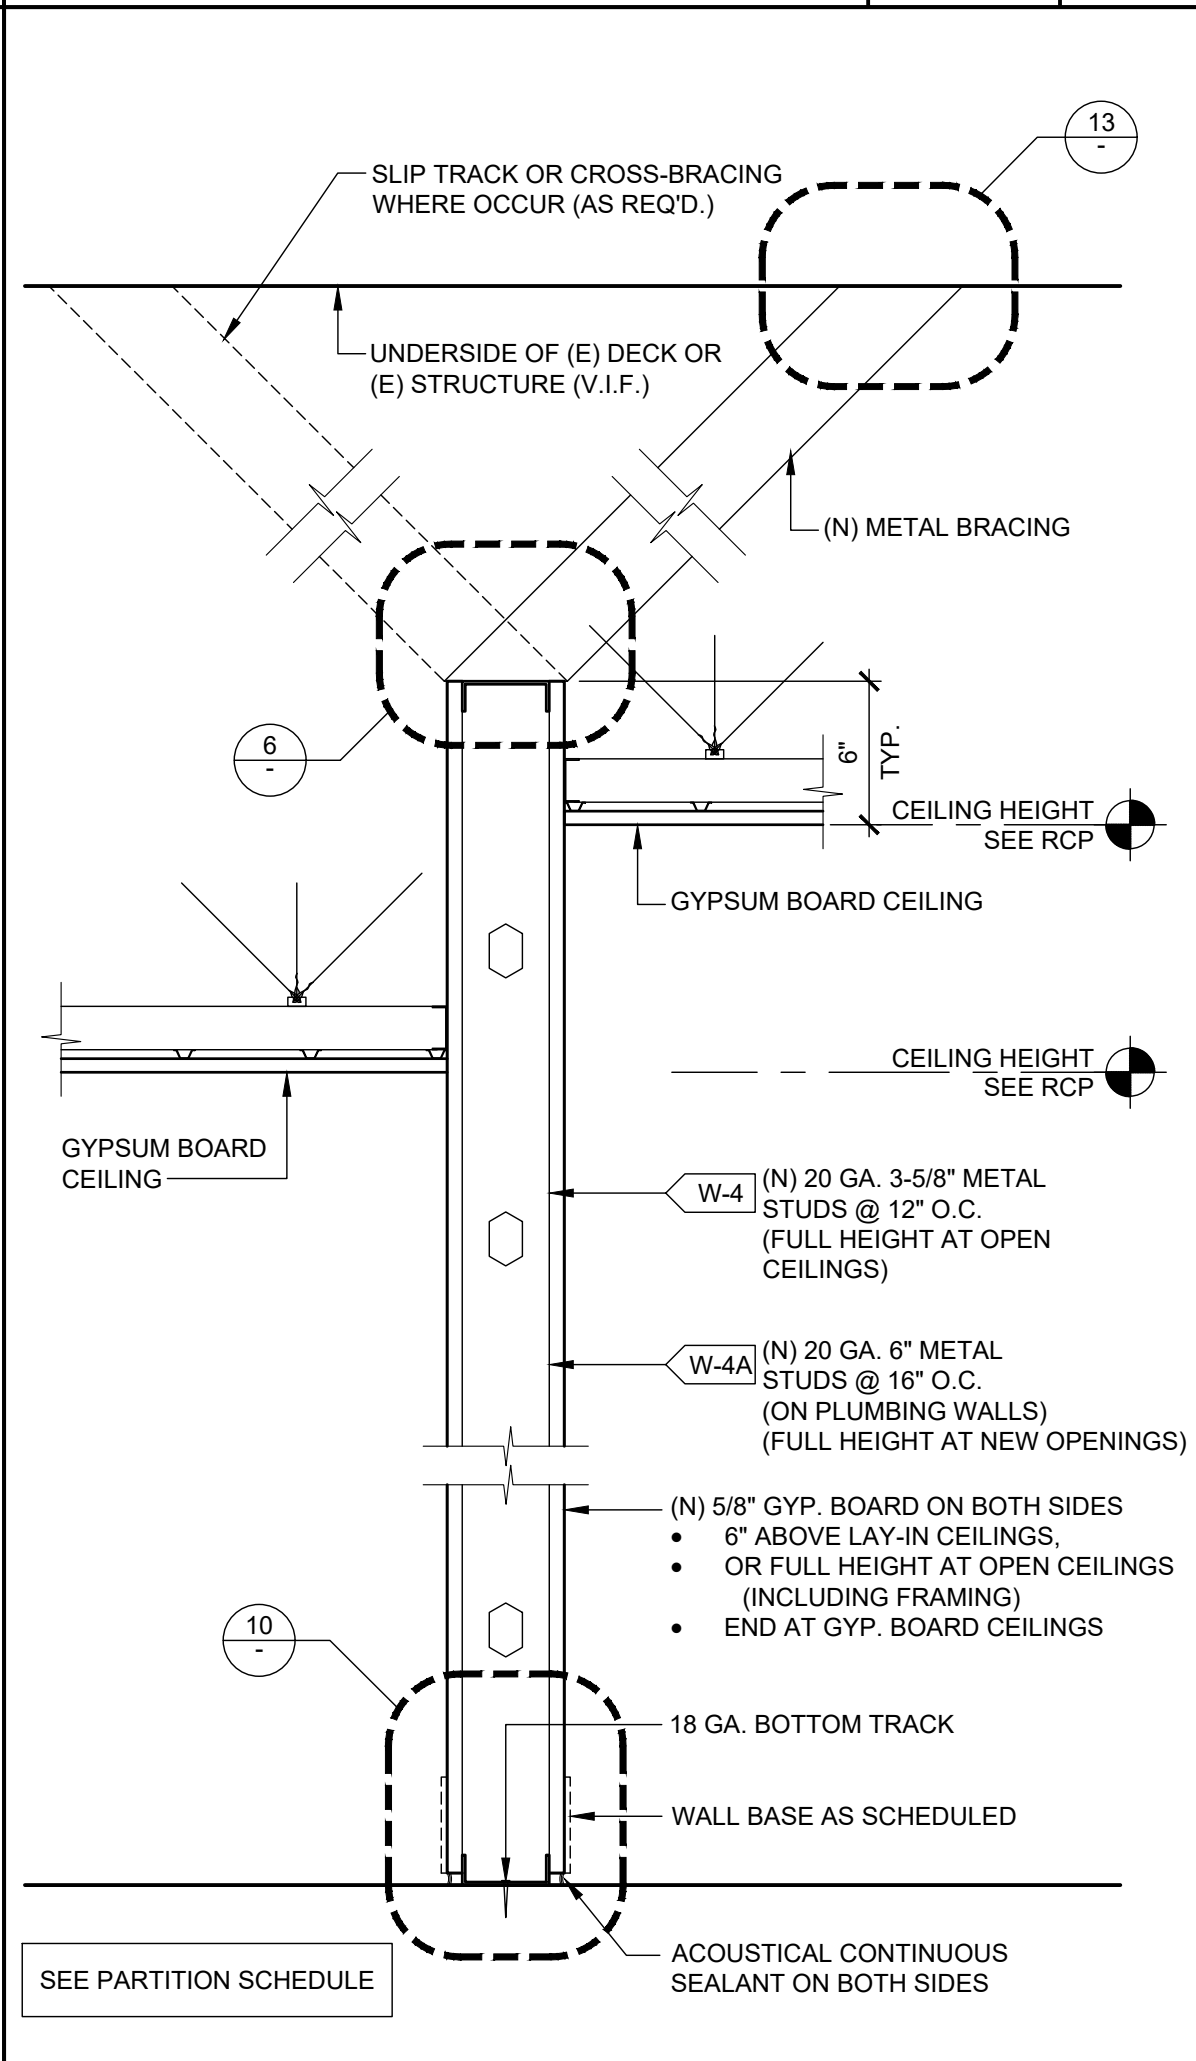
16



WALL PARTITION

SCALE
1 1/2" = 1'-0"

12



WALL PARTITION NON RATED

SCALE
1 1/2" = 1'-0"

8

FRAMING NOTES

- GALVANIZED STEEL MUST MEET THE MINIMUM REQUIREMENTS OF ASTM A446 GRADE D (F_y=50KSI) FOR 12 GAUGE, ASTM A446 GRADE A (F_y=33KSI) FOR 14 & 16 GAUGE, AND LIGHTER FOR THE ITEM AND USE INTENDED. GALVANIZED COATINGS MUST MEET THE ASTM A525 SPECIFICATIONS.
- CARBON SHEET STEEL MUST MEET THE MINIMUM REQUIREMENTS OF ASTM A570 GRADE 50 KSI FOR 12 GAUGE, ASTM A570 GRADE 50 KSI OR GRADE 33 KSI FOR 14 & 16 GAUGE AND GRADE 33 KSI FOR 18 GAUGE AND LIGHTER MEMBERS. CARBON SHEET STEEL PRODUCTS MUST BE THOROUGHLY COATED WITH A RUST INHIBITIVE PAINT.
- ALL STRUCTURAL MEMBERS SHALL BE DESIGNED IN ACCORDANCE WITH AMERICAN IRON AND STEEL INSTITUTE (AISI) "SPECIFICATION FOR THE DESIGN OF COLD-FORMED STEEL STRUCTURAL MEMBERS" 2010 EDITION WITH SUPPLEMENT 2.
- METAL STUDS AND / OR JOISTS:
 - FOR METAL STUD WALLS, UNLESS OTHERWISE SHOWN ON THE DRAWINGS, PROVIDE STANDARD PUNCHED STEEL MEMBERS OF THE GAUGES SHOWN ON THE DRAWINGS.
 - USE ONLY ONE TYPE THROUGHOUT THE WORK, UNLESS OTHERWISE SHOWN ON THE DRAWINGS OR SPECIFICALLY APPROVED IN ADVANCE BY THE ENGINEER AND/OR ARCHITECT.
- ACCESSORIES: PROVIDE ALL ACCESSORIES INCLUDING, BUT NOT NECESSARILY LIMITED TO, TRACKS, CLIPS, WEB STIFFENERS, ANCHORS, FASTENING DEVICES, RESILIENT CLIPS, AND OTHER ACCESSORIES REQUIRED FOR A COMPLETE AND PROPER INSTALLATION, AND AS RECOMMENDED BY THE MANUFACTURER FOR THE STEEL MEMBERS USED.
- FASTENING OF COMPONENTS SHALL BE WITH SELF-DRILLING SCREWS OR WELDING. ALL WELDS OF GALVANIZED STEEL SHALL BE TOUCHED UP WITH A ZINC RICH PAINT. ALL WELDS OF CARBON SHEET STEEL SHALL BE TOUCHED UP WITH PAINT.
- PROVIDE A GOOD GRADE OF COMMERCIAL GROUT FOR LEVELING THE FLOOR RUNNER MEMBER OF STEEL STUD PARTITIONS AS REQUIRED.

PARTITION SCHEDULE

- ALL THE METAL STUDS USED SHALL BE "ICC-ES" TYPE OR APPROVED EQUAL.
- THE BRIDGING, BLOCKING OR END BEARING STIFFENERS SHALL BE AS REQUIRED BY THE MANUFACTURER UNLESS NOTED OTHERWISE ON THE DRAWINGS.
- ALL THE STUDS SHALL CONFORM TO "ICC-ES EVALUATION REPORT" ESR-3064P OR APPROVED EQUAL.
- UNLESS OTHERWISE NOTED ON THE PLANS, USE THE FOLLOWING GUIDELINE FOR STUD SIZE & SPACING FOR INTERIOR PARTITIONS.
- TOP TRACK SIZE WILL BE 20 GA. MINIMUM FOR PARTITION, U.N.O.
- SCAFCO SLOTTED TRACK, 400SLT250-43 OR 600SLT250-33, 18 GA. "ICC-ES EVALUATION REPORT" ESR-3064P OR APPROVED EQUAL.

S I Z E	MAXIMUM PARTITION HEIGHT (5psf L/240)			
	SPACING	HEIGHT (COMPOSITE)	HEIGHT (NON-COMP.)	HEIGHT (BRACED 48" OC)
362 S 125 - 33	12"	19' - 2"	17' - 7"	17' - 8"
362 S 125 - 33	16"	17' - 5"	16' - 0"	16' - 1"
400 S 125 - 33	16"	18' - 3"	17' - 3"	17' - 4"
600 S 125 - 33	16"	25' - 6"	23' - 9"	23' - 11"

METAL JOIST SCHEDULE

- USE "ICC-ES EVALUATION REPORT" ESR-3064P OR APPROVED EQUAL.
- USE 600S125-43 @ 16" O.C. UP TO 16'-0" MAXIMUM SPAN WHERE CEILING SUPPORTED TOILET PARTITIONS OCCUR.
- STUD TRACKS SHALL BE UNPUNCHED STUDS OF SAME GAUGE AS STUD UNLESS NOTED OTHERWISE.
- ACOUSTIC CEILING TIES (SEE FINISH SCHEDULE) WITH 1 - #8 SCREWS AT EACH JOIST.

GYPSUM BOARD CEILING	CEILING TIES (BRACING) SPACING	S I Z E	MAXIMUM SPAN		MAXIMUM SPAN	
			SPACING	SPAN	SPACING	SPAN
	4' - 0"	362 S 125 - 30	16"	8' - 0"	24"	7' - 0"
	3' - 6"	550 S 125 - 30	16"	11' - 0"	24"	9' - 0"
	3' - 6"	600 S 125 - 30	16"	16' - 0"	24"	13' - 0"

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CONSULTANT

RELEASE FOR CONSTRUCTION
AS NOTED ON PLANS REVIEW
DEVELOPMENT SERVICES
LEE'S SUMMIT, MISSOURI
06/02/2020

PURE BARRE

INTERIOR TENANT IMPROVEMENT

910-U NORTHWEST BLUE PARKWAY
LEE'S SUMMIT, MO 64086

PROJECT LOCATION

WALL AND MISCELLANEOUS DETAILS

SHEET TITLE

STAMP

STATE OF MISSOURI
WILLIAM A. AMOR
NUMBER A-2012004034
ARCHITECT

DATE SIGNED: 2020-05-29
RENEWAL DATE: 2020-12-31
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REVISIONS

△ 2020-05-26 FIELD COORDINATION

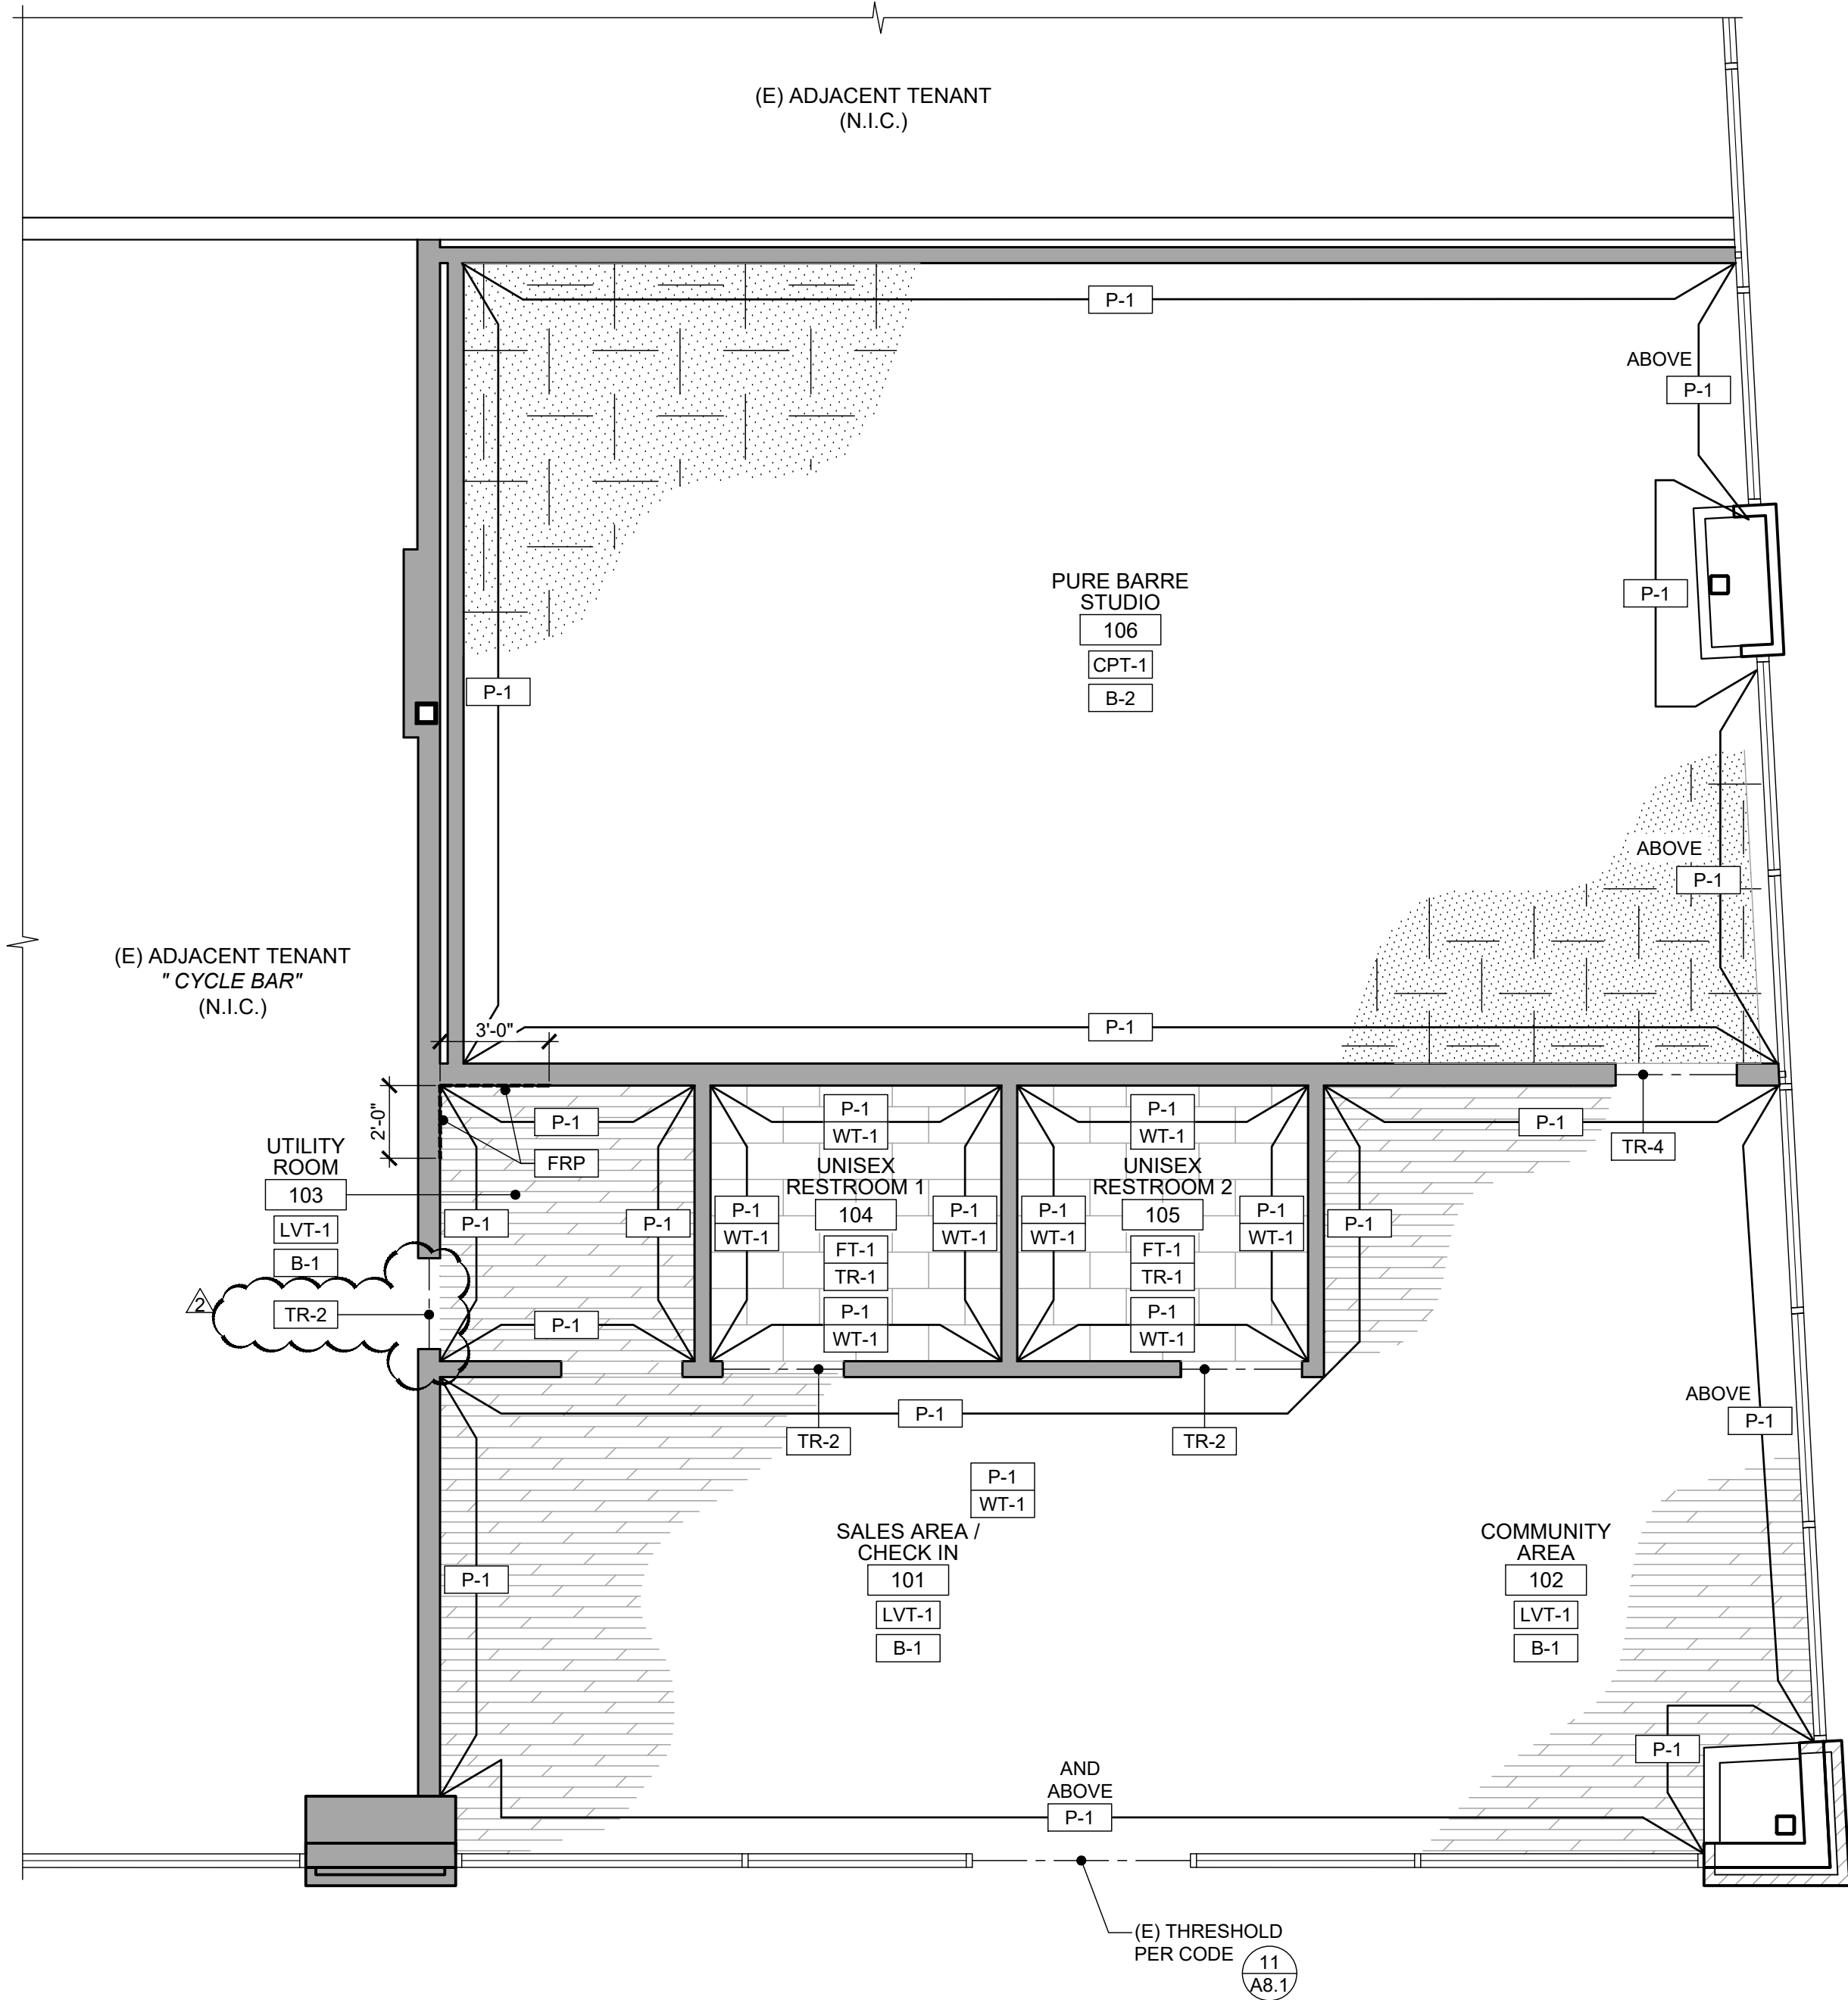
DATE
2020.05.29
PROJECT NUMBER
A2275

SHEET NUMBER

A7.1

PERMIT SET : 2020_04_10

Plotted: 5/29/2020 9:18 AM (thasun) File: 15_a2275_a8.2_room_fln.sched.dwg



ROOM FINISH PLAN

SCALE
1/4" = 1'-0"

12

FINISH SCHEDULE

ROOM NO.	ROOM NAME	FLOOR	BASE	WALLS								CEILING			REMARKS (NUMBERS REFER TO NOTES BELOW) <div><div></div><div>A D C B</div></div>
				A		B		C		D		MATERIAL	PAINT	HEIGHT	
				MATERIAL	PAINT	MATERIAL	PAINT	MATERIAL	PAINT	MATERIAL	PAINT				
101	SALES AREA / CHECK IN	LVT-1	B-1	GWB	P-1	-	-	(E)	P-1	GWB	P-1	OPEN	P-2	SEE REFLECTED CEILING PLAN 8/A2.1	①②③④⑤
102	COMMUNITY AREA	LVT-1	B-1	GWB	P-1	(E)	P-1	(E)	P-1	GWB	P-1	OPEN	P-2		①②③④⑤
103	UTILITY	LVT-1	B-1	GWB	P-1/FRP	GWB	P-1	GWB	P-1	GWB	P-1/FRP	ACT-1	-		①②⑤
104	UNISEX RESTROOM 1	FT-1	B-1	GWB	P-1/ WT-1	GWB	P-1/ WT-1	GWB	P-1/ WT-1	GWB	P-1/ WT-1	GWB	P-2		①②⑤
105	UNISEX RESTROOM 2	FT-1	-	GWB	P-1/ WT-1	GWB	P-1/ WT-1	GWB	P-1/ WT-1	GWB	P-1/ WT-1	GWB	P-2		①②⑤
106	PURE BARRE STUDIO	CPT-1	B-2	GWB	P-1	(E)	P-1	GWB	P-1	GWB	P-1	ACT-1	-		①②⑤

FINISH SCHEDULE REMARKS

- REFERENCE INTERIOR ELEVATIONS AND ROOM FINISH PLAN FOR EXTENT OF FINISHES AND WALL GRAPHICS
- ALL GYPSUM BOARD TO BE 5/8" THICK TAPED, SPACKLED, SANDED AND READY FOR PAINT. ALL EXISTING AND NEW GYP. BOARD WILL RECEIVE MIN. LEVEL 4 FINISH.
- G.C. TO REPAIR / PROVIDE INSULATION AS REQUIRED PRIOR TO PAINT
- ALL SURFACES AT UNDERSIDE OF EXPOSED CEILING/ROOF DECK TO RECEIVE WHITE SCRIM SHEET, OR PAINT WHERE NEEDED (U.N.O.)
- ALL NEW AND EXISTING GYPSUM BOARD RECEIVE MINIMUM LEVEL 4 FINISH

FINISH LEGEND

TYPE	MARK	MANUFACTURER/ VENDOR	MATERIAL NAME	PRODUCT / SERIES	COLOR	REMARKS
FLOORING	LVT-1	SPS ¹	HIGH PERFORMANCE LUXURY VINYL TILE (LVT)	18" x 36" - 0.098" OVERALL THICKNESS. CLASS III COMMERCIAL GRADE	GRAY	FINISH: LVT TO BE INSTALLED RUNNING PARALLEL TO STOREFRONT LOCATION: LOBBY AND UTILITY
	CPT-1	SPS	SYNTHETIC FLOOR TILES	24 x 24	BLACK	LOCATION: STUDIO ADD 1/4" PAD UNDER CARPET TILES.
	FT-1	SPS	CERAMIC FLOOR TILE	12 x 24 x 5/16"	SHADE VARIATION MEDIUM (V2)	LOCATION: RESTROOM FLOOR
	SC-1	APPROVED VENDOR	SEALED CONCRETE			
BASE	B-1	ROPPE	4" COVE BASE	700	193 BLACK BROWN	LOCATION: LOBBY AND COMMON AREAS
	B-2		1 1/2" x 6" BASE		RED OAK	LOCATION: STUDIO
WALLS	P-1	SHERWIN WILLIAMS	PAINT	SW 7005	PURE WHITE	FINISH: SEMI-GLOSS
	WT-1	SPS	CERAMIC WALL TILE	4 x 16 x 1/4"	WHITE	INSTALLATION: STACKED LOCATION: RESTROOM WALL
	FRP	MARLITE OR EQUAL	FIBER REINFORCED PLASTIC	STANDARD FRP, SMOOTH SURFACE	STANDARD FRP, SMOOTH SURFACE	S100G- WHITE INSTALL W/ PVC TRIM
GROUT	GR-1	LATICRETE PERMACOLOR		-	34 SANDSTONE SANDED	GROUT AT FT-1 3/16" GROUT JOINT
	GR-2	LATICRETE PERMACOLOR		-	44 BRIGHT WHITE NON SAND	GROUT AT WT-1 1/16" GROUT JOINT
CEILING	ACT-1	ARMSTRONG	FINE FISSURED TEGULAR TILES OR APPROVED EQUAL	-	WHITE	2' x 4' ACOUSTIC SUSPENDED CEILING GRID: STANDARD 15/16" STEEL (WHITE FINISH)
	P-2	SHERWIN WILLIAMS	PAINT	SW 7005	PURE WHITE	FINISH: SEMI-GLOSS
TRANSITION	TR-1	SCHLUTER SCHEINE	-	AE100	-	HORIZONTAL WAINSCOT AND VERTICAL CORNERS AT CERAMIC WALL TILE
	TR-2	SCHLUTER RENO	-	U AEU125	-	FT-1 CERAMIC FLOOR TILE TO LVT
	TR-3	ROPPE	-	#22	BLACK	LVT-1 TO CONCRETE
	TR-4	ROPPE	-	#196	BLACK	CPT-1 TO LVT-1
	TR-5	ROPPE	-	#196	BLACK	CPT-1 TO CONCRETE
DOORS	P-5	SHERWIN WILLIAMS	PAINT	SW 6991	BLACK MAGIC	FINISH: EGG SHELL (LOBBY, STUDIO)
	P-6	SHERWIN WILLIAMS	PAINT	SW 7005	WHITE	FINISH: SEMI-GLOSS (RESTROOM, UTILITY)

NOTES:

- SPS STANDS FOR SPORT PRO SURFACING VENDOR.
- ALL GROUTS JOINT TO BE 1/8", UNLESS NOTED OTHERWISE.
- ADHESIVE FOR CPT-1 AND LVT-1 WILL BE PROVIDED BY SPS.

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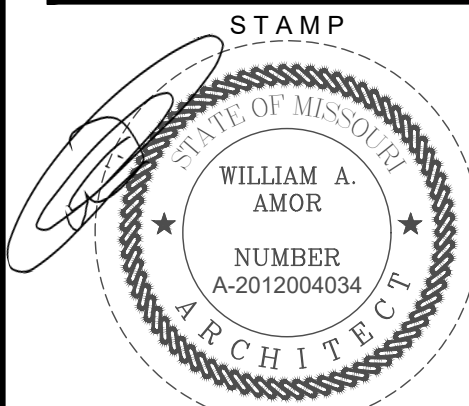
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CONSULTANT

RELEASE FOR CONSTRUCTION
AS NOTED ON PLANS REVIEW
DEVELOPMENT SERVICES
LEE'S SUMMIT, MISSOURI

06/02/2020

PURE BARRE
INTERIOR TENANT IMPROVEMENT
910-U NORTHWEST BLUE PARKWAY
LEE'S SUMMIT, MO 64086
PROJECT LOCATION
SHEET TITLE
ROOM FINISH PLAN, SCHEDULE & LEGEND
AND GRAPHIC KEYS



DATE SIGNED: 2020-05-29
RENEWAL DATE: 2020-12-31
SHEETS BEARING THIS SEAL AND NET SIGNATURE
ARE AUTHENTICATED. RESPONSIBILITY FOR ALL
OLDER PLANS, SPECIFICATIONS OR INSTRUMENTS
ARE DISCLAIMED.

REVISIONS

- 2020-05-26 FIELD COORDINATION

DATE
2020.05.29
PROJECT NUMBER
A2275

SHEET NUMBER

A8.2

PERMIT SET : 2020_04_10