


02 ENLARGED FLOOR PLAN - RESTROOM

1/2" = 1'-0"

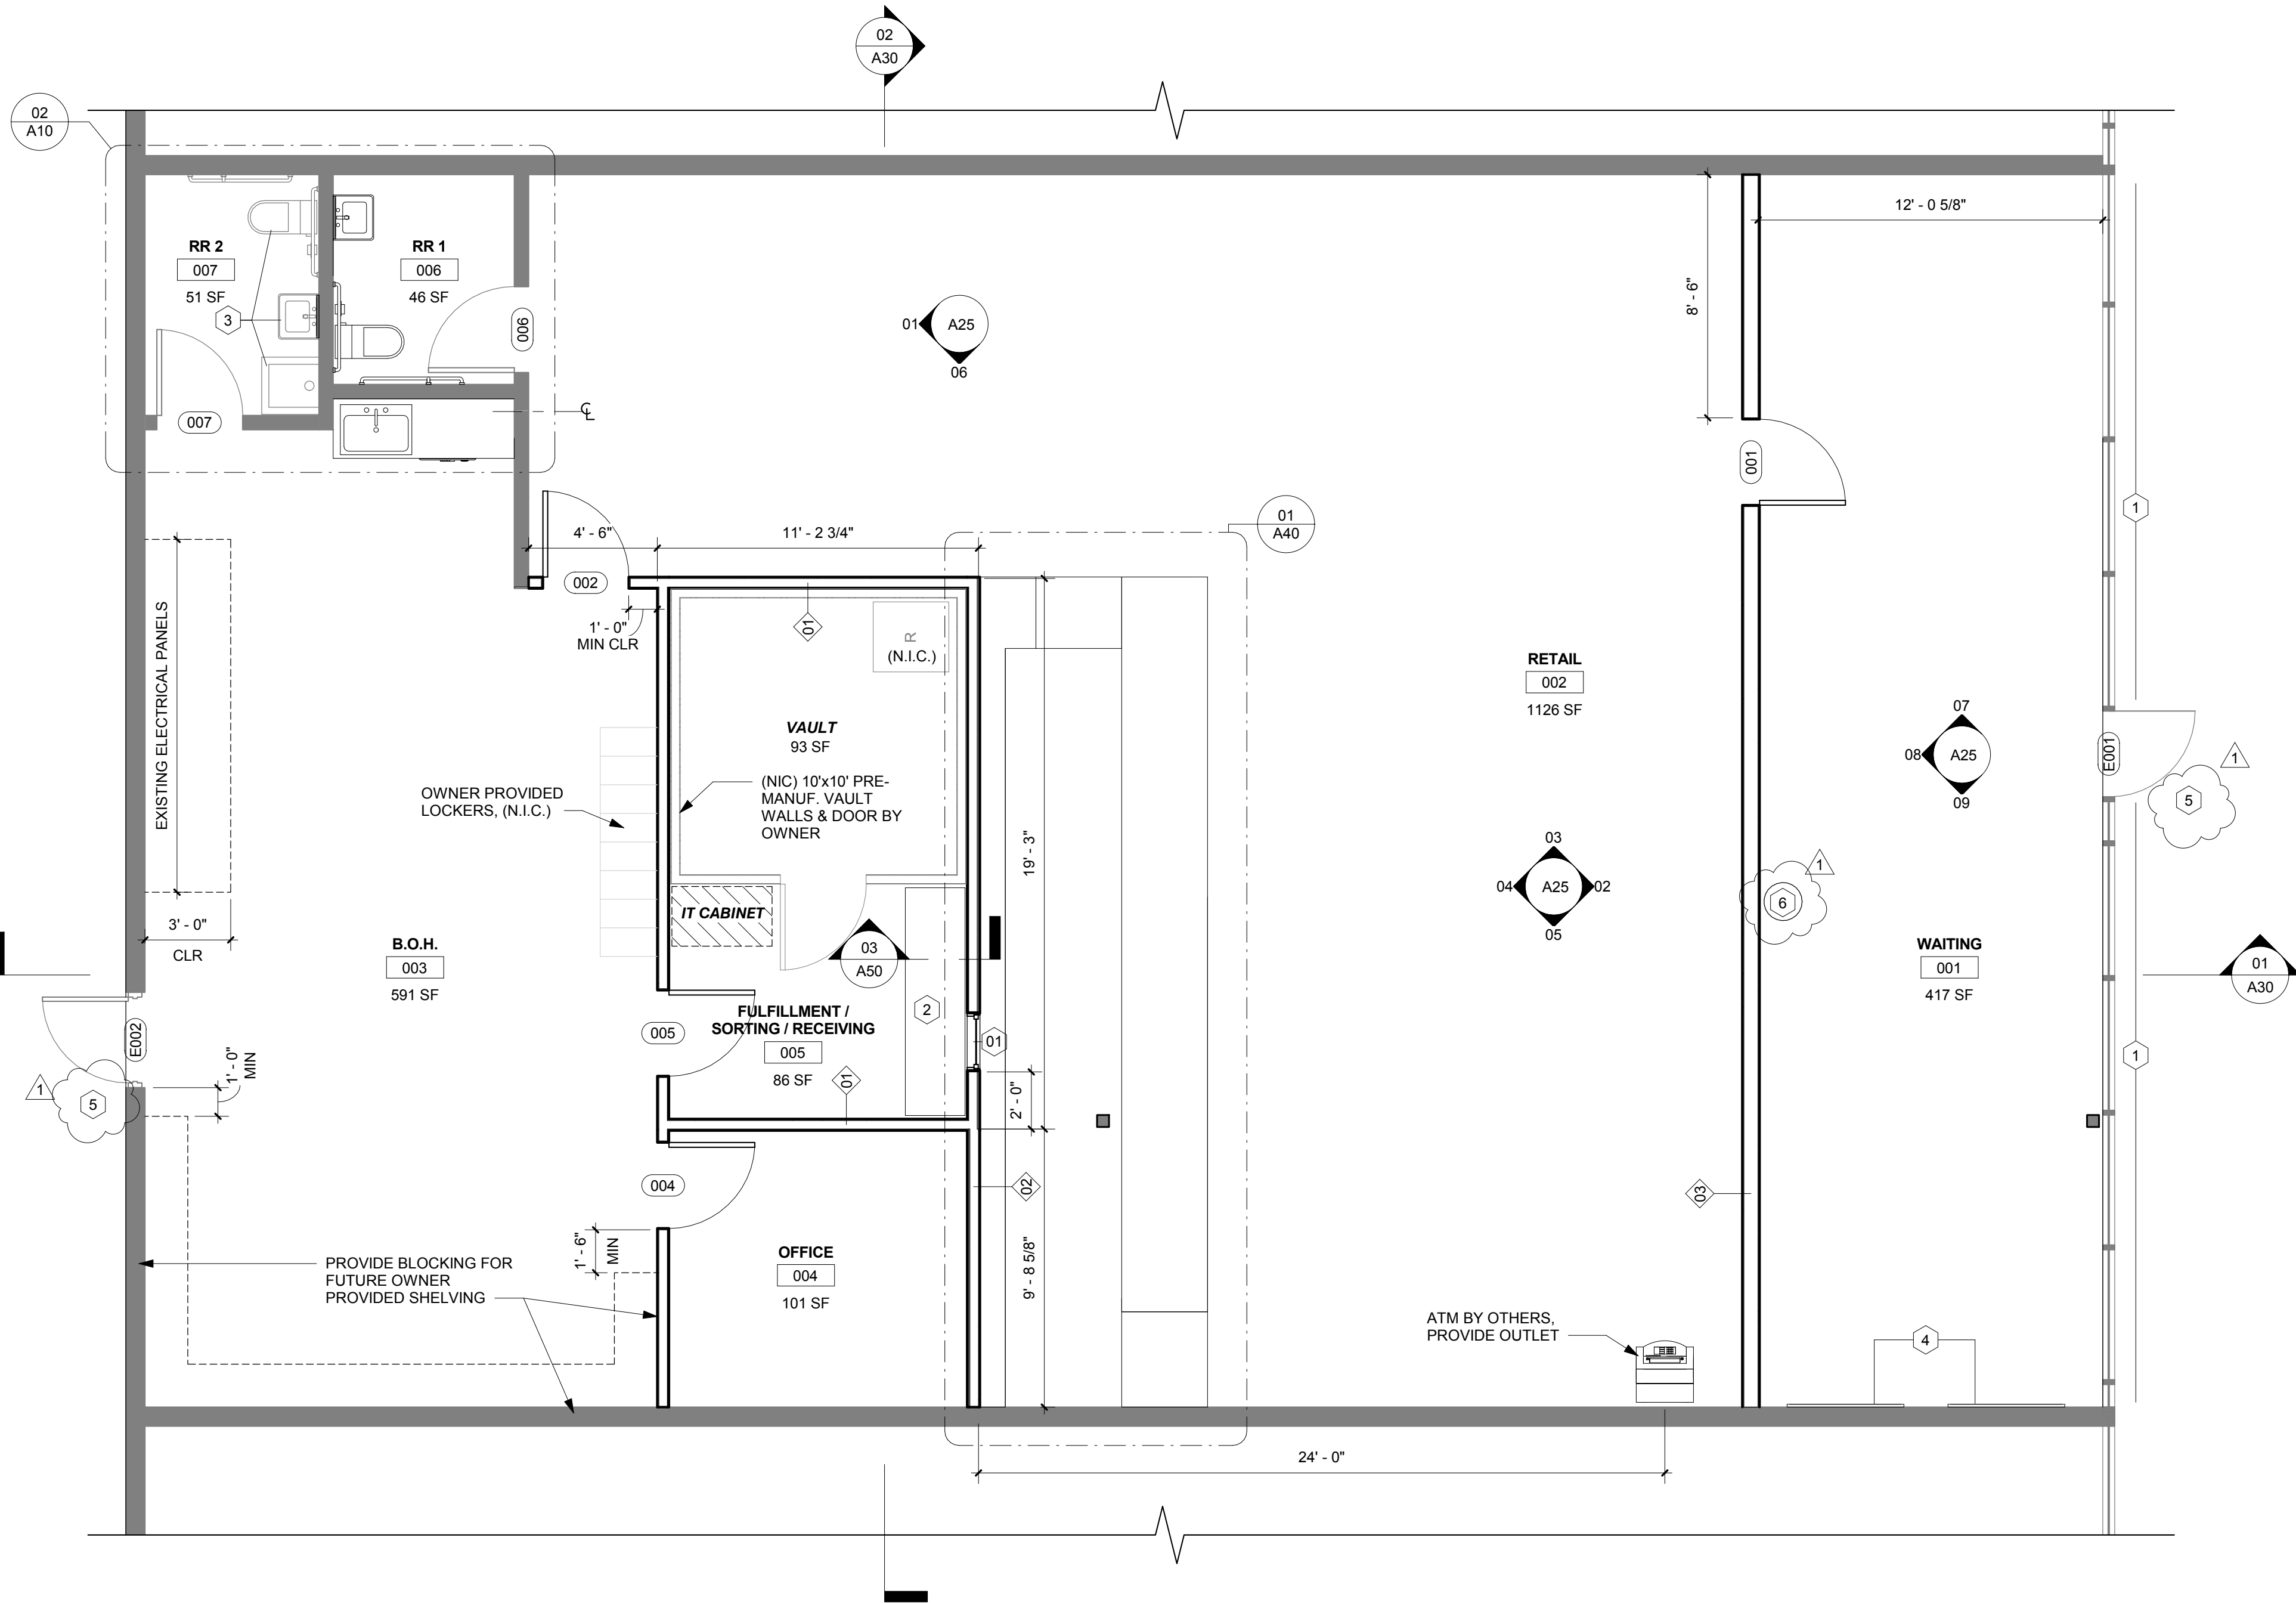

01 FLOOR PLAN

1/4" = 1'-0"

FLOOR PLAN GENERAL NOTES:

- a. **U.N.O.**, ALL WALL DIMENSIONS TO FACE OF STUD.
- b. ALL FURNITURE AND WALL HUNG SHELIVING SHOWN FOR REFERENCE ONLY.
- c. CONTRACTOR TO FIELD VERIFY ALL DIMENSIONS AND EXISTING CONDITIONS.
- d. REFER TO MEP DRAWINGS FOR ALL PLUMBING/HVAC/ELECTRICAL REQUIREMENTS/INFORMATION/LOCATIONS.
- e. **ALL** INTERIOR WALLS TO BE TYPE 1 UNLESS OTHERWISE NOTED. SEE SHEET G01 FOR WALL TYPES.
- f. **U.N.O.**, CONTRACTOR TO INSPECT EXISTING SLAB, MACHINE GRIND TO RECEIVE POLISHED FINISHES LEVEL & SMOOTH PRIOR TO CONSTRUCTION OF NEW WALLS.
- g. GYP. BD WALLS NOT TO EXCEED 30 FEET WITHOUT A CONTROL JOINT, UNDIVIDED GYP. BD SURFACES NOT TO EXCEED 900 S.F. OR AS OTHERWISE INDICATED
- h. **ALL** MISCELLANEOUS CARPENTRY AND WOOD BLOCKING TO BE FIRE TREATED.
- i. PATCH AND REPAIR EXISTING GYP. BD WALLS FOR PAINT READY FINISH. CONTRACTOR TO REPAIR ANY EXISTING FIRE RATED ASSEMBLY THAT IS DISTURBED DURING CONSTRUCTION TO ITS ORIGINAL FIRE RATING.
- k. PATCH ALL EXISTING WALLS WHERE ADJACENT WALLS AND/OR CASEWORK, EQUIPMENT, ETC. WERE REMOVED. PREPARE FOR PAINT FINISH.
- l. **U.N.O.**, ALL NEW WALLS TO ALIGN WITH ADJACENT, EXISTING WALLS TO PROVIDE SEAMLESS TRANSITION.
- m. CLEAN ALL EXISTING STOREFRONT & DOOR HEAD, JAMB, & SILLS. PROTECT FROM DAMAGE DURING CONSTRUCTION.
- n. **ALL** TOILET ROOMS/BATHROOMS TO PROVIDE BLOCKING FOR GRAB BARS. REFER TO RESTROOM ADA STANDARD ELEVATIONS FOR HEIGHT AND LOCATIONS.
- o. **ALL** PENETRATIONS INTO FIRE-RATED ASSEMBLIES ARE TO BE FIRESTOPPED WITH UL APPROVED FIRESTOPPING ASSEMBLIES. UL INFORMATION SHALL BE PROVIDED BY TRADE RESPONSIBLE FOR PENETRATION.
- p. PROVIDE FIREBLOCKING AND DRAFTSTOPPING AS REQUIRED AND IN ACCORDANCE WITH 2012 IBC, SECTION 717.0.
- q. AT ALL DOORS TO REMAIN, CONTRACTOR TO REPLACE EXISTING HARDWARE WITH HARDWARE SET NOTED IN SPECIFICATIONS.
- r. **U.N.O.**, ALL EXTERIOR GLAZING TO RECEIVE TRANSLUCENT APPLIED FILM RE: SPECIFICATIONS.
- s. MAXIMUM OCCUPANCY MUST BE POSTED IN VISIBLE LOCATION IN THE WAITING ROOM. COORDINATE WITH OWNER FOR FINAL LOCATION.

FLOOR PLAN KEY NOTES:

- 1 GLAZING TO RECEIVE SELF-ADHERING TRANSLUCENT FILM APPLIED TO INTERIOR FACE OF GLASS. WINDOW COVERING TO COVER FULL EXTENT OF GLASS OBSCURING ANY VIEWS INTO THE BUILDING.
- 2 BUILT-IN WORK-SURFACE.
- 3 EXISTING PLUMBING FIXTURES TO REMAIN.
- 4 OWNER PROVIDED, CONTRACTOR INSTALLED TV AND BRACKET, BOTTOM OF TV TO BE MOUNTED RE: ELEVATIONS CONTRACTOR TO PROVIDE BLOCKING IN WALL.
- 5 ADDRESS TO BE LOCATED AND PLAINLY VISIBLE PER 2018 IFC 505.1. COORDINATE WITH OWNER FOR FINAL LOCATION
- 6 WATER DISPENSER, COORDINATE FINAL LOCATION WITH OWNER



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FLOOR PLAN

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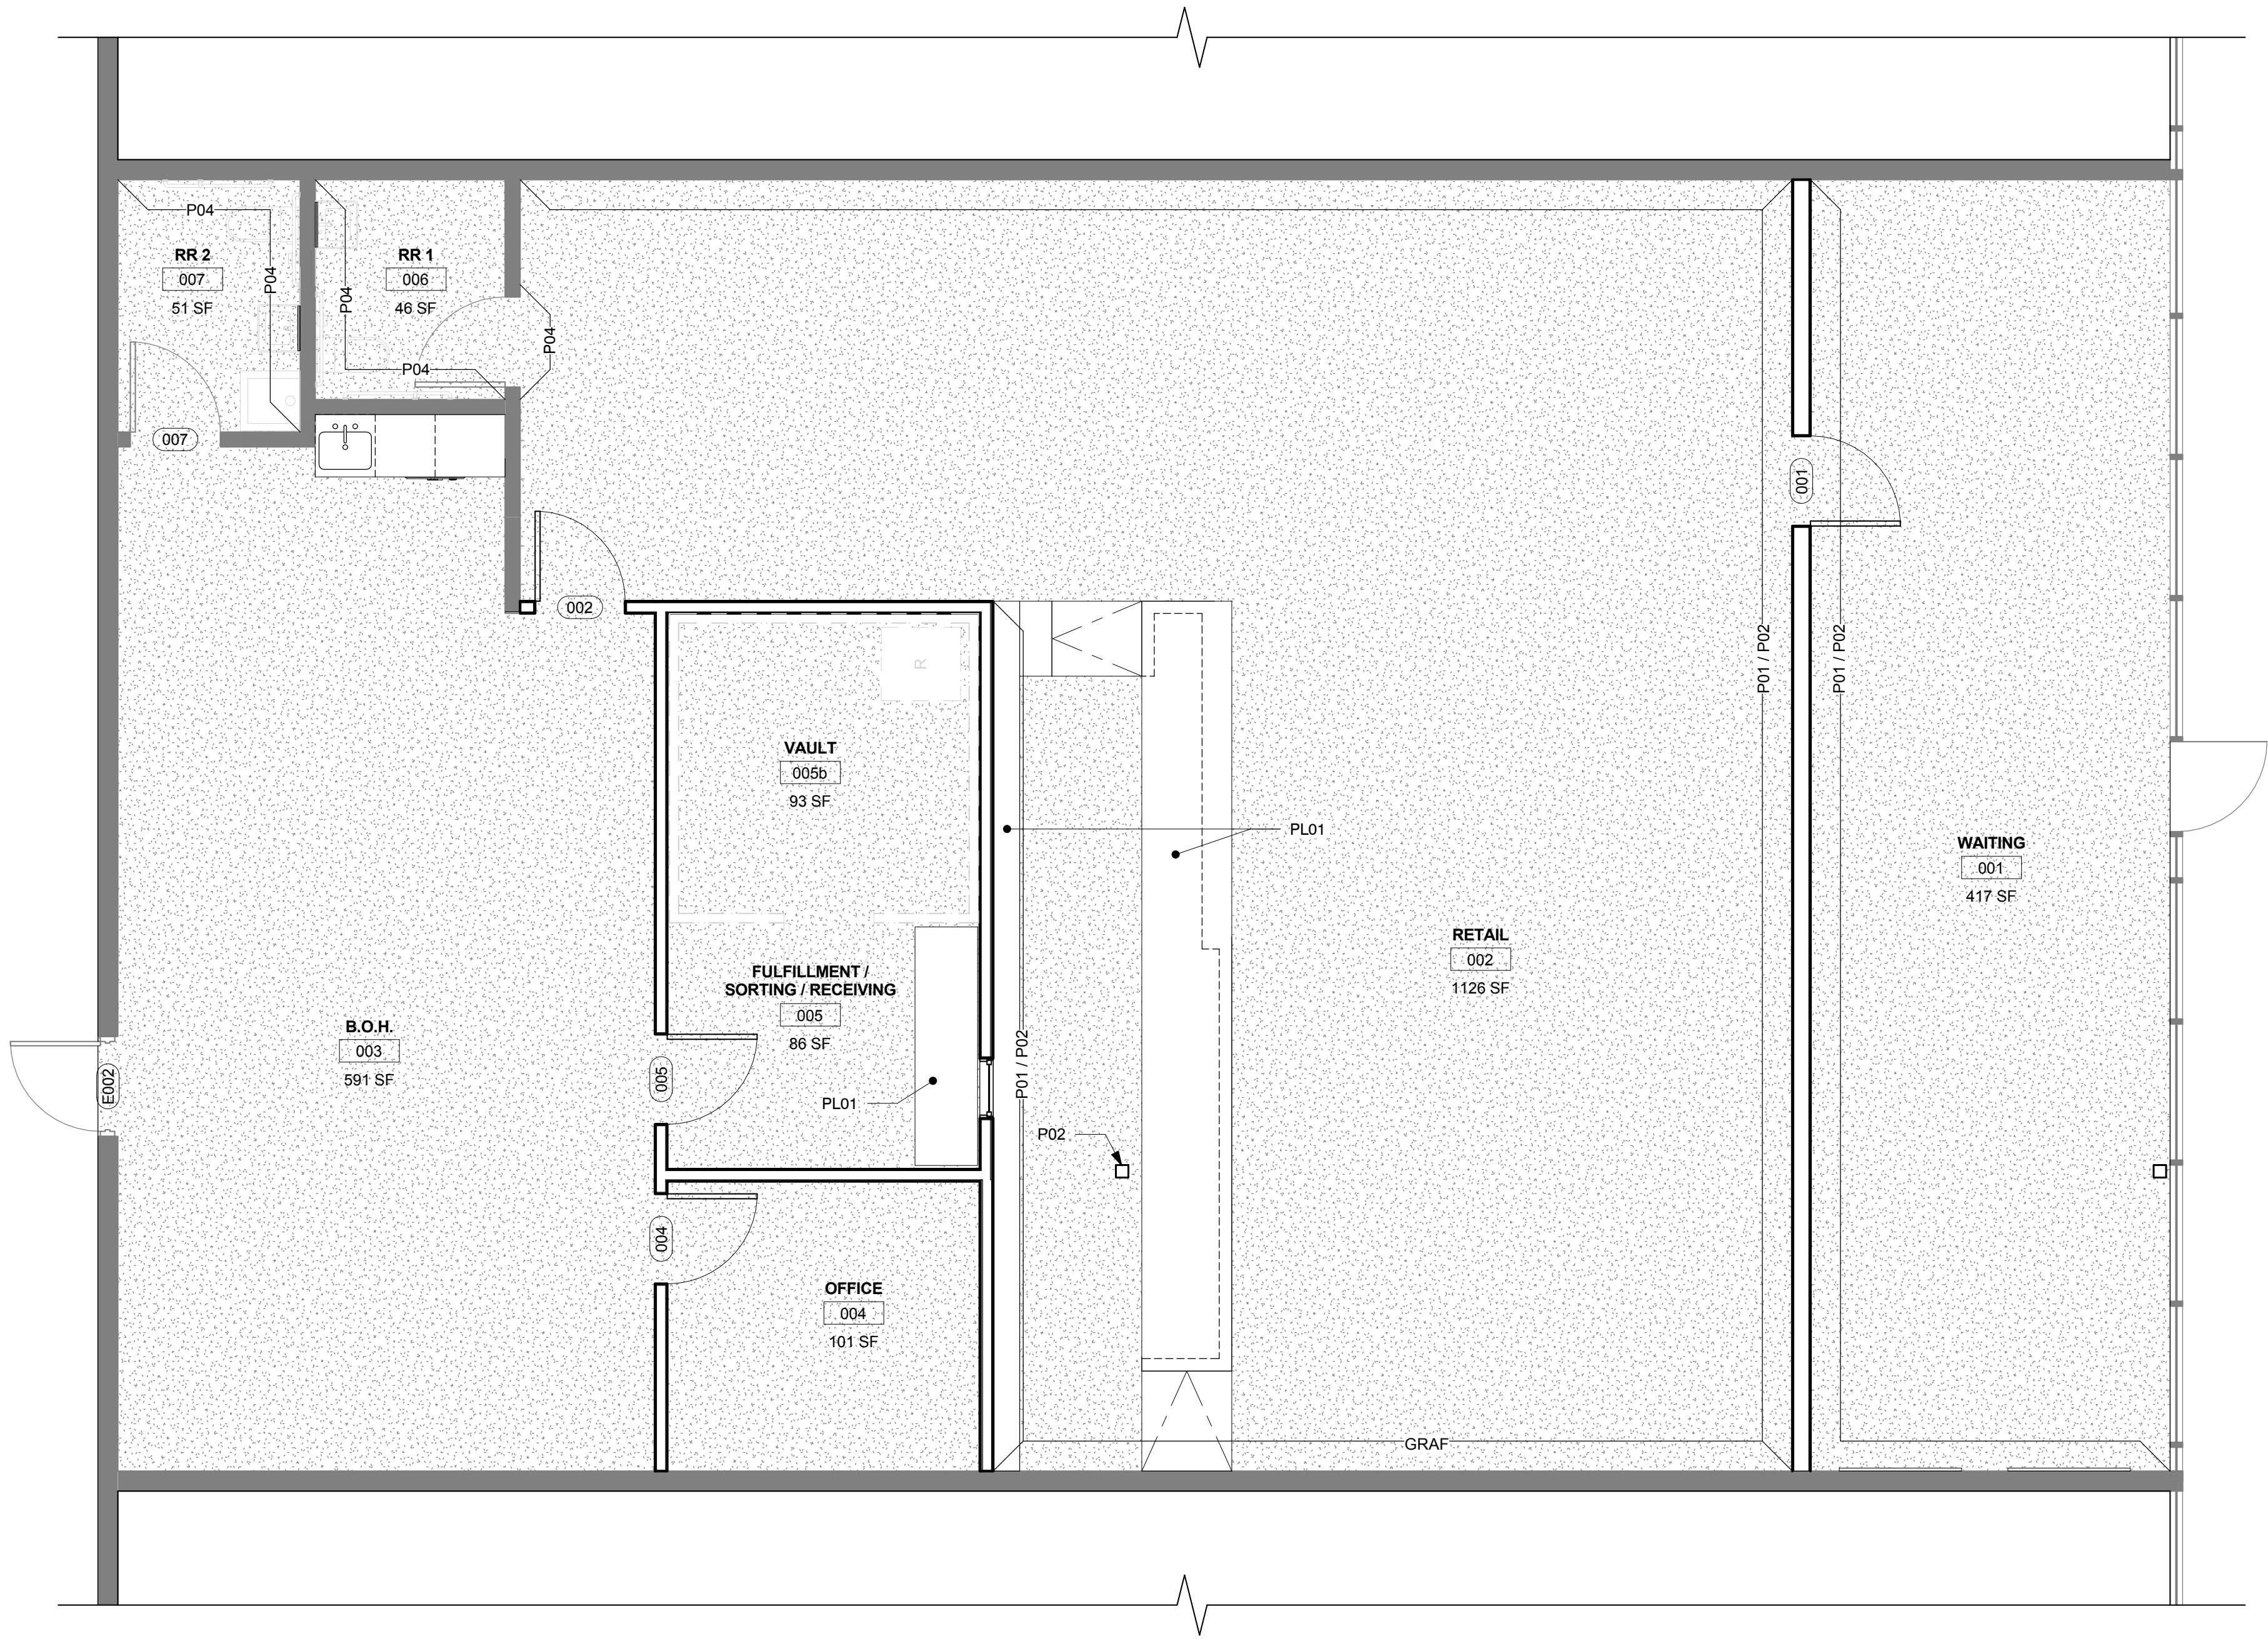
A10

FINISH SCHEDULE									
ROOM #	ROOM NAME	FLOOR FINISH	BASE FINISH	WALL FINISH				CEILING FINISH	NOTES
				NORTH	EAST	SOUTH	WEST		
001	WAITING	CONC	RB 01	P01 / P02	STOREFRONT	P01 / P02	P01 / P02	P02 - OPEN	
002	RETAIL	CONC	WD 01	P01 - COORD. ART	P01 - COORD. ART	P01 - COORD. ART	P01 - COORD. ART	P02 - OPEN	
003	B.O.H.	CONC	RB 01	P01	P01	P01	P01	P02 - OPEN	
004	OFFICE	CONC	RB 01	P01	P01	P01	P01	P02 - OPEN	
005	FULFILLMENT / SORTING / RECEIVING	CONC	RB 01	P02	P02	P02	P01 - COORD. ART	P02 - OPEN	
005b	VAULT	CONC	RB 01	BY OTHERS	BY OTHERS	BY OTHERS	BY OTHERS	BY OTHERS	
006	RR 1	CONC	RB 01	P01	P01	P04	P04	P01	
007	RR 2	CONC	RB 01	P04	P04	P01	P01	P01	

FINISH LEGEND					NOTES
CODE	MATERIAL	MANUFACTURER	STYLE, COLOR, SIZE		
CONC	CONCRETE		TRANSPARENT FINISH		GRIND SMOOTH AND FINISH EXISTING FLOORS
RB01	RUBBER WALL BASE	ROPPE	4" COVE BASE, 177 STEEL BLUE		ROLL GOODS ONLY
WD01	WOOD WALL BASE		PAINT TO MATCH WALL		1X4 RE. WALL ASSEMBLIES
WD02	PLYWOOD		BALTIC BIRCH PLYWOOD		
WD03	MAPLE HARDWOOD		TRANSPARENT FINISH		
P01	PAINT	BENJAMIN MOORE	OC-57 - WHITE HERON		EGGSHELL, TYP. / SEMI-GLOSS EPOXY BASED PAINT IN RESTROOMS
P02	PAINT	BENJAMIN MOORE	2140-30 - DARK OLIVE		EGGSHELL, TYP.
P03	PAINT	BENJAMIN MOORE	2703-40 - PURPLE HYACINTH		EGGSHELL, TYP.
P04	PAINT	BENJAMIN MOORE	2102-70 - FIRST LIGHT		EGGSHELL, TYP. / SEMI-GLOSS EPOXY BASED PAINT IN RESTROOMS
CMP01	CORRUGATED MTL PANEL	MORIN	C-29 7/8" PANEL, PRE-WEATHERED & CLEAR FINISH		EXPOSED FASTENER
PL01	LAMINATE	NAVAMAR	S6054T - WROUGHT IRON, TEXTURED		SATIN FINISH
GRAF	GRAFFITI ART WALL	PER OWNER			COORDINATE WITH OWNER & SELECTED ARTIST ON HOW TO PREPARE SURFACE
WF01	VINYL WINDOW FILM	3M	FASARA SH2MLCRX, MILKY CRYSTAL (60" WIDTH - CONFIRM WIDTH)		APPLY TO INTERIOR FACE OF GLASS

NOTES

- REFERENCE ELEVATIONS ON SHEET A20 FOR ADDT'L INFORMATION
- REFERENCE PLAN & ELEVATIONS ON SHEET A40 FOR POS COUNTER FINISHES
- PAINT FREESTANDING COLUMNS P03



GENERAL FINISH NOTES:

- ALL FINISHES SHALL BE APPLIED IN ACCORDANCE WITH THE MANUFACTURERS LATEST WRITTEN SPECIFICATIONS AND INITIAL MAINTENANCE INSTRUCTIONS.
- NEW DRYWALL SURFACES SHALL RECEIVE (1) COAT OF PRIMER AND (2) FINISH COATS.
- INSTALLATION OF NEW FINISHES BY THE CONTRACTOR SHALL INDICATE ACCEPTANCE OF WALL AND FLOOR PREPARATION, AND FULL RESPONSIBILITY FOR COMPLETED WORK.
- CONTRACTOR SHALL SUBMIT TO TENANT, FOR REVIEW AND APPROVAL, SAMPLES OR DRAW DOWNS OF FINISHES AND MATERIALS SPECIFIED IN "FINISH SCHEDULE".
- EXISTING SUB FLOOR SHALL BE FLASH-PATCHED AT ALL AREAS WHERE FLOOR IS NOT LEVEL OR TRUE.
- GENERAL CONTRACTOR SHALL VERIFY WITH TENANT THE PLACEMENT OF ALL ATTIC STOCK OF NEW FINISH MATERIALS, I.E.: CARPET, VINYL COMPOSITION TILE, VINYL BASE, ETC. FOR TENANT STORAGE.
- ALL HOLLOW METAL DOOR AND INTERIOR WINDOW FRAMES TO BE PAINTED TO MATCH ADJACENT WALL, U.N.O.
- ALL EXISTING WOOD DOORS & FRAMES TO BE STRIPPED PAINTED
- ALL EXISTING WOOD SILL TRIM TO BE PREPPED AND PAINTED TO MATCH COLOR OF ADJACENT WALL
- NOT ALL FINISHES INDICATED ON FINISH PLAN. REFERENCE FINISH SCHEDULE.
- FURNITURE SHOWN FOR REFERENCE ONLY. NOT IN CONTRACTORS SCOPE.



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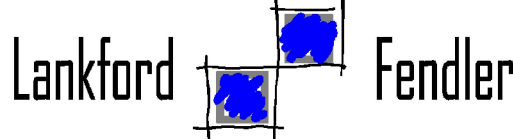
FINISH PLAN & SCHEDULE

sheet number

A60

01 FINISH FLOOR PLAN

1/4" = 1'-0"



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FLOOR PLAN
MECHANICAL
DEMOLITION


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M01

DM## FLOOR PLAN NOTES


1. DISCONNECT AND REMOVE ALL DUCTWORK, DIFFUSERS, GRILLES, HANGERS, ETC. IN THEIR ENTIRETY THROUGHOUT PROJECT EXTENTS.
2. REMOVE EXHAUST DIFFUSERS, DUCTWORK, ASSOCIATED EQUIPMENT AND CONTROLS.
3. DISCONNECT AND REMOVE THERMOSTATS AND ASSOCIATED CONTROL WIRING. THERMOSTATS TO BE PROVIDED NEW UNDER NEW WORK PLAN.

- △
4. RTU-1 ON ROOF EXISTING TO REMAIN.
 5. RTU-2 ON ROOF EXISTING TO REMAIN.

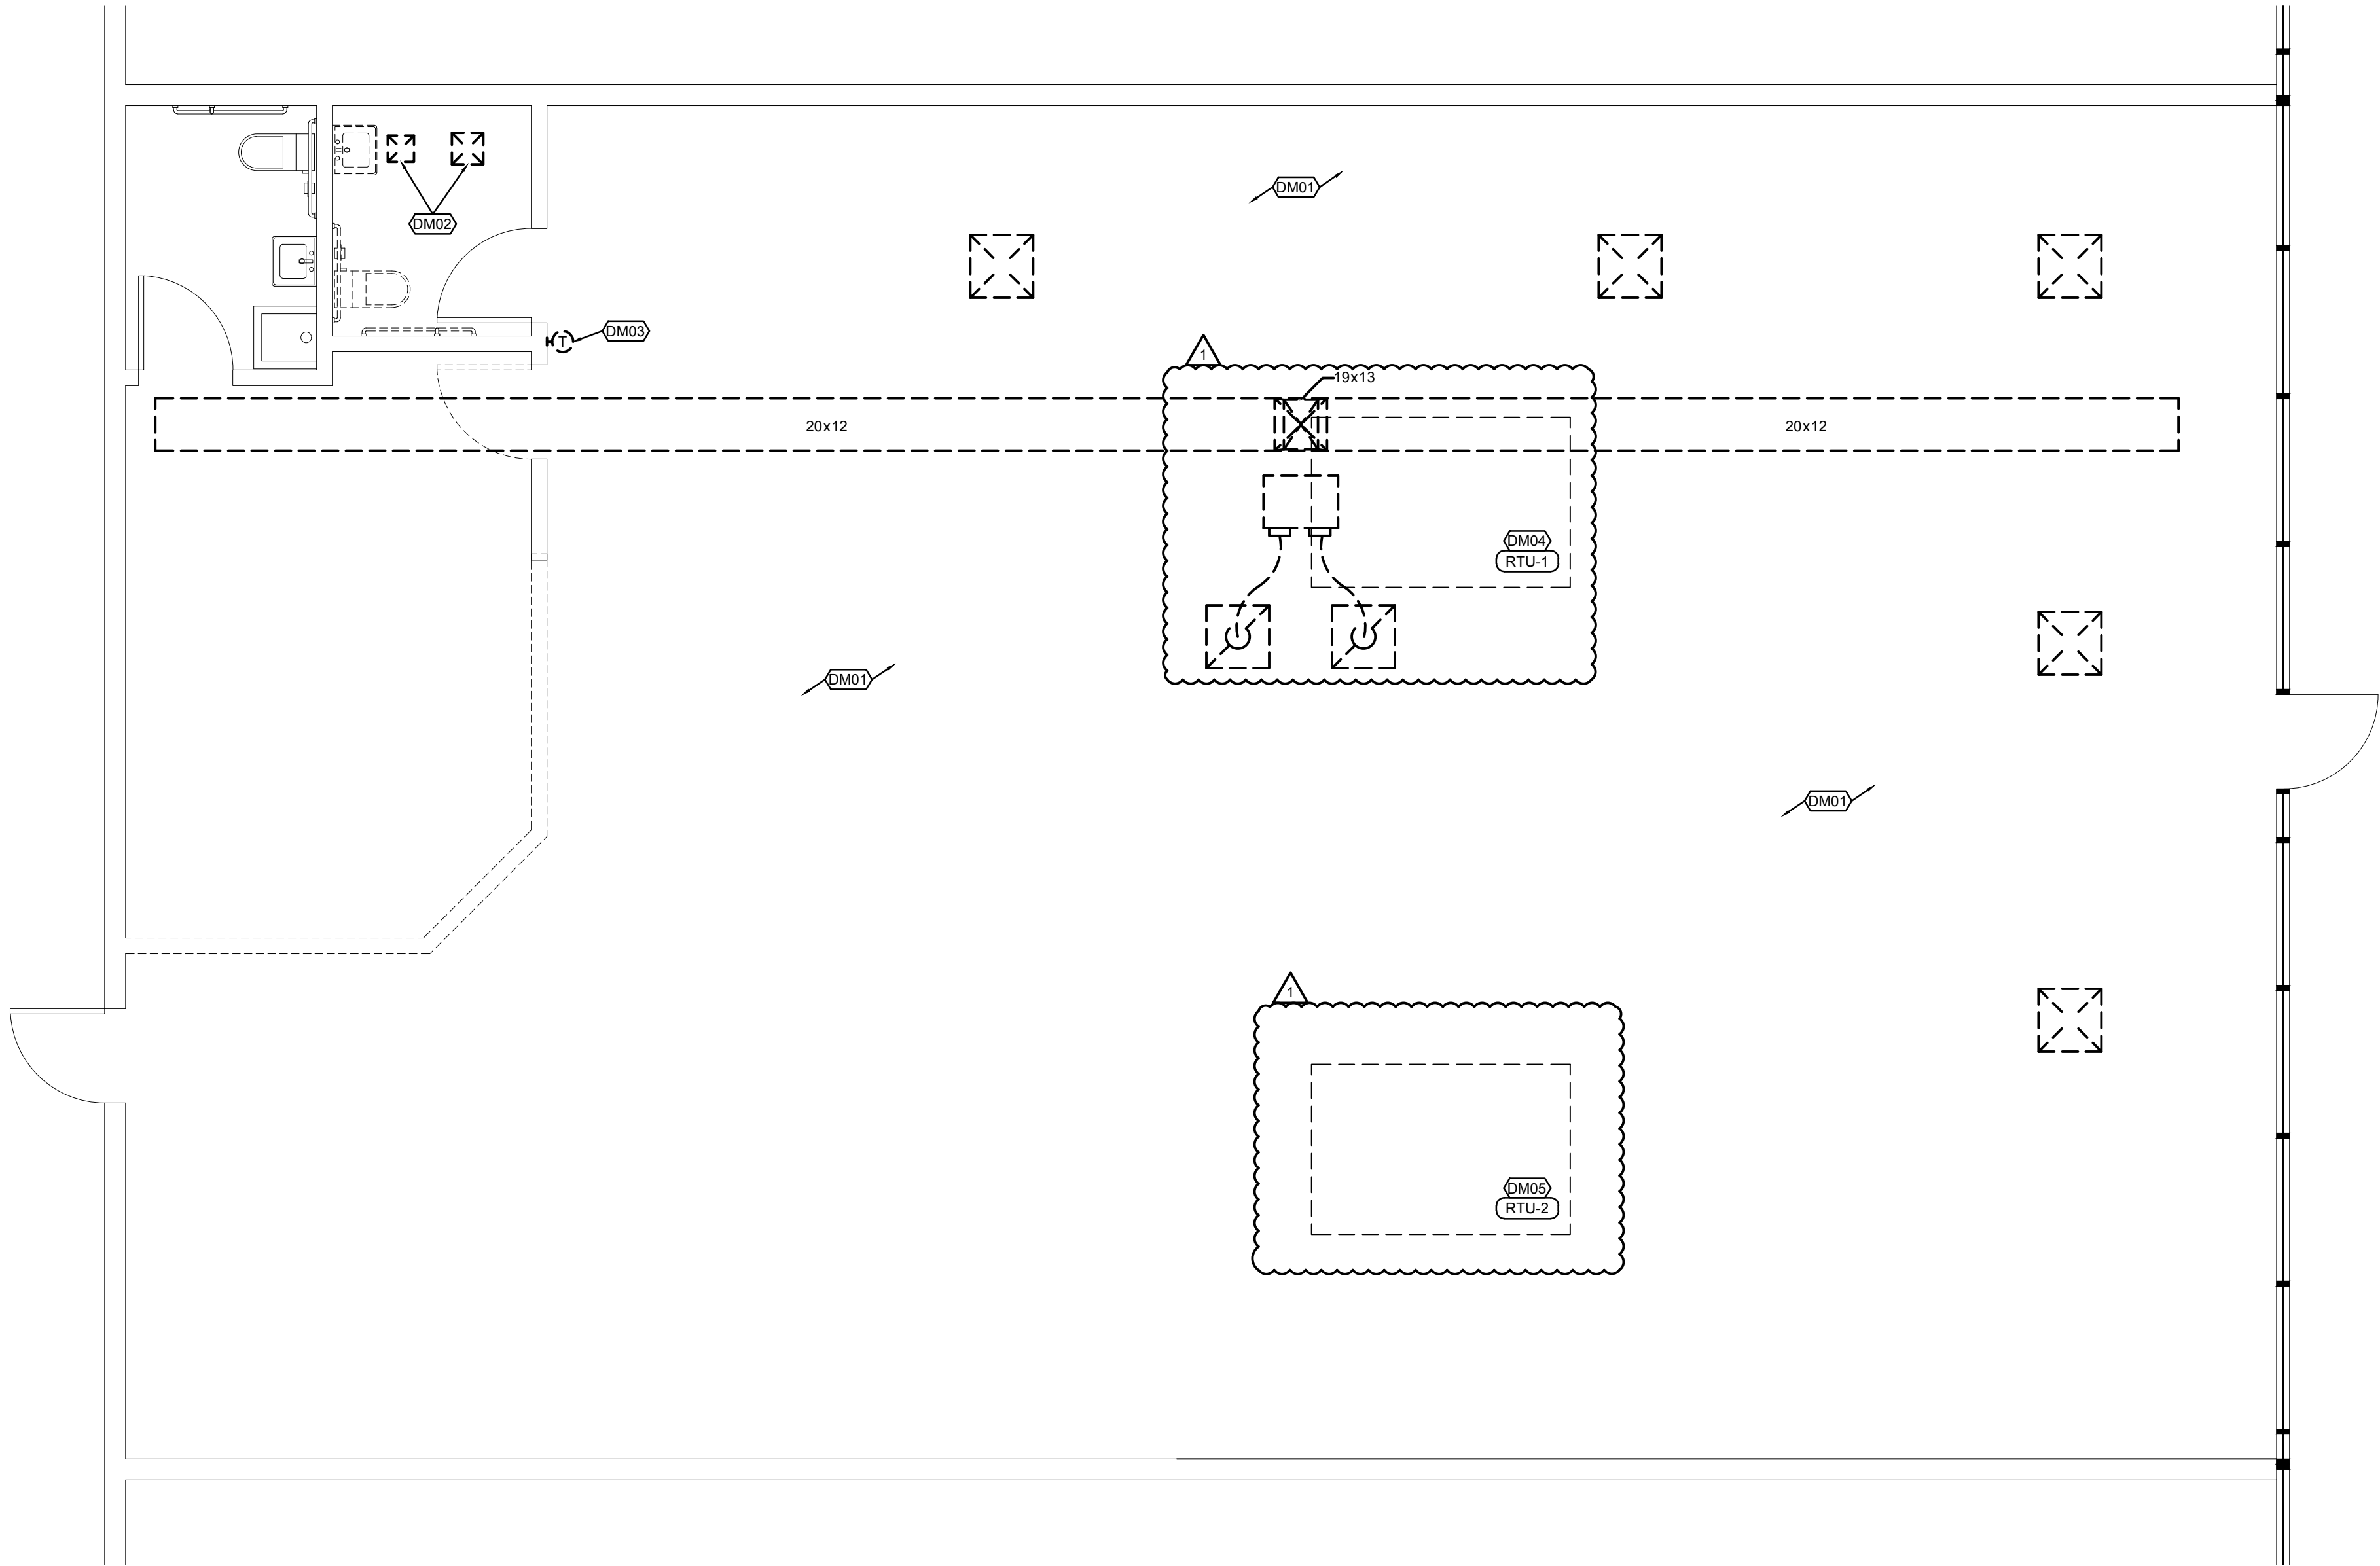


FLOOR PLAN-MECHANICAL DEMOLITION

SCALE: 1/4" = 1'-0"

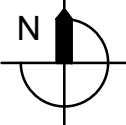


FLOOR PLAN NOTES


1. MAIN DUCT UP TO EXISTING RTU-1 ON ROOF. FIELD VERIFY RTU AND DUCT RISE LOCATION.
2. RETURN DUCT UP TO EXISTING RTU-1 ON ROOF. FIELD VERIFY RTU AND DUCT RISE LOCATION.
3. MAIN DUCT UP TO EXISTING RTU-2 ON ROOF. FIELD VERIFY RTU AND DUCT RISE LOCATION.
4. RETURN DUCT UP TO EXISTING RTU-2 ON ROOF. FIELD VERIFY RTU AND DUCT RISE LOCATION.
5. EXHAUST DUCT UP TO NEW EF-1 ON ROOF.
6. REFRIGERANT PIPING DOWN FROM CU-1 ON ROOF TO AC-1.
7. WALL MOUNTED SPLIT SYSTEM INDOOR UNIT. MOUNT 12" BELOW VAULT CEILING. ROUTE LINESET TO ASSOCIATED OUTDOOR UNIT AND CONNECT PER MANUFACTURERS RECOMMENDATIONS. ROUTE 3/4" CONDENSATE TO ADJACENT MECHANICAL ROOM FLOOR DRAIN AND INDIRECT WASTE.
8. WALL MOUNTED HUMIDIFIER. INSTALL PER MANUFACTURERS RECOMMENDATIONS. ROUTE DISPERSION TUBE TO FAN PACK IN VAULT ROOM.
9. WALL MOUNTED FAN PACK PROVIDED WITH HUMIDIFIER. INSTALL 12" BELOW VAULT CEILING.
10. CONDENSATE DRAINAGE DOWN TO JANITOR'S SINK.
11. INSTALL RETURN GRILLE IN ROOM TIGHT TO STRUCTURE. INSTALL OPPOSITE RETURN GRILLE AT SAME HEIGHT. PROVIDE IN WALL SHEETMETAL SLEEVE.
12. MOUNT DIFFUSER TIGHT TO STRUCTURE.
13. MOUNT SUPPLY DUCTWORK TIGHT TO STRUCTURE.
14. INSTALL ROOF MOUNTED CONDENSING UNIT ON 4x4 PRESSURE TREATED LUMBER. ROUTE LINESET THROUGH ROOF PER SPECIFICATIONS. COORDINATE ANY ROOF WARRANTY WITH BUILDING OWNER.
15. COORDINATE WITH ELECTRICAL CONTRACTOR TO INTERLOCK FAN WITH RESTROOM MOTION SENSOR.
16. MOUNT EXHAUST DIFFUSERS ON BOTTOM OF DUCT.

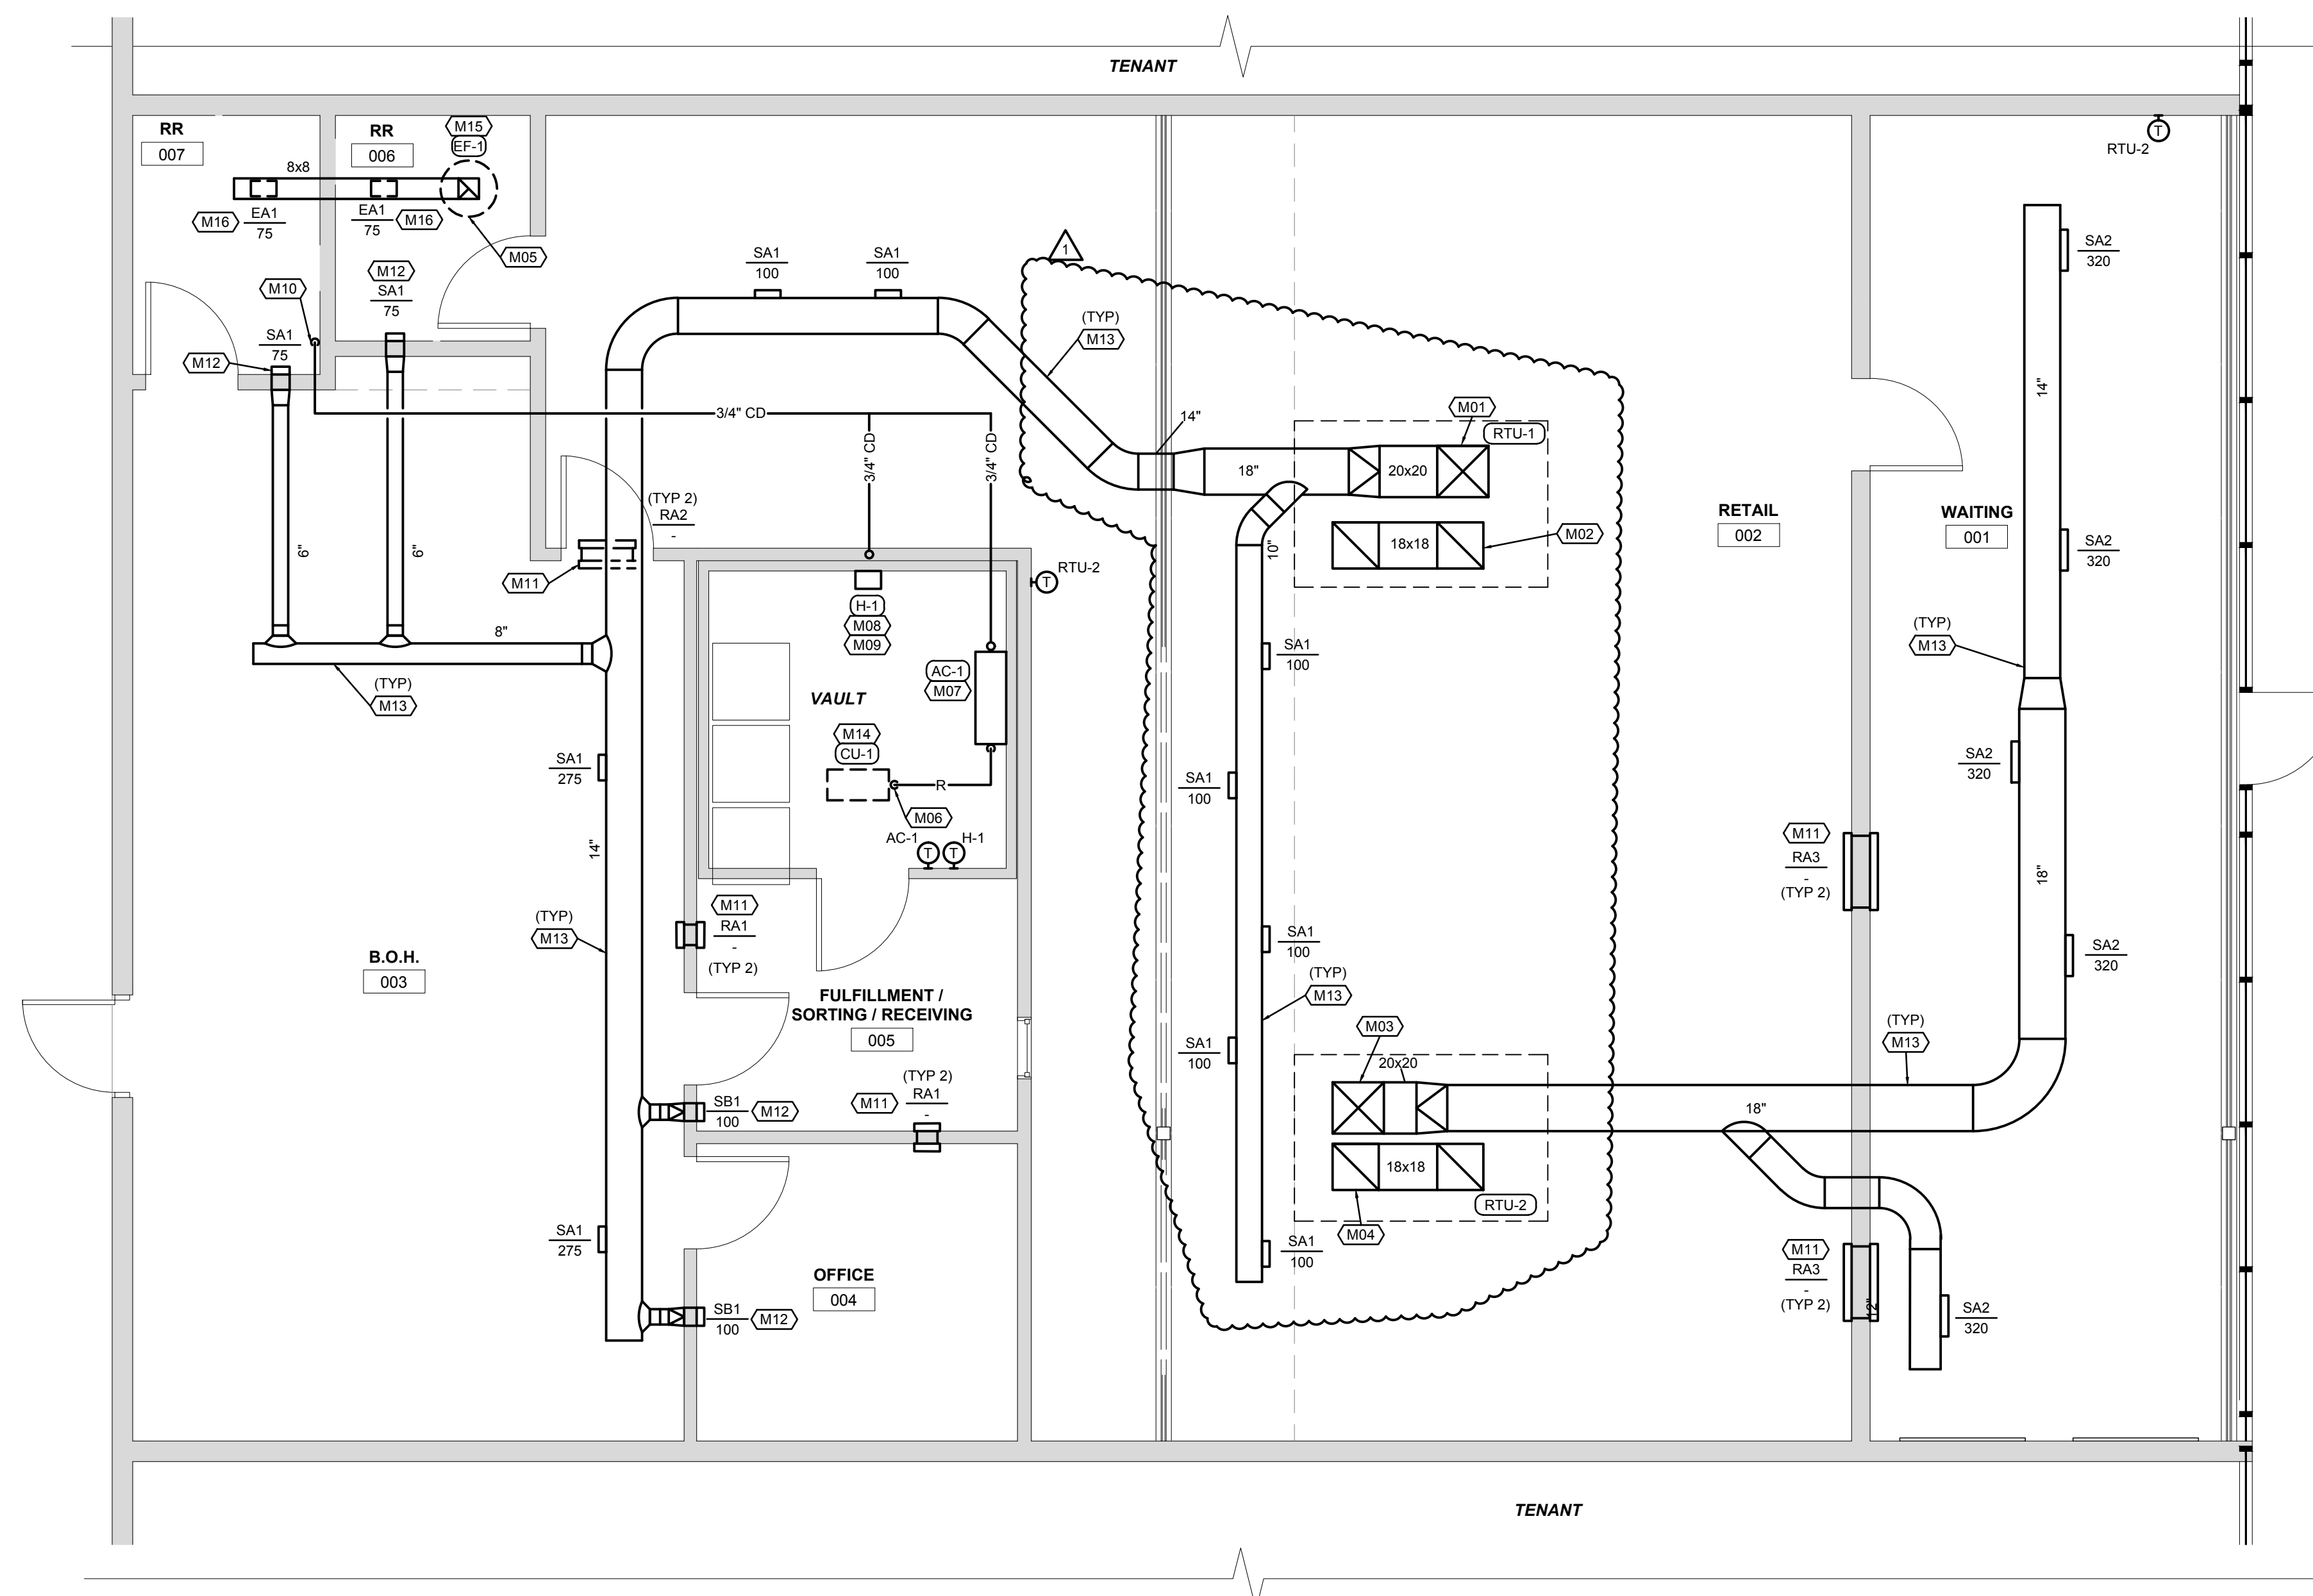

FLOOR PLAN-MECHANICAL NEW WORK

SCALE: 1/4" = 1'-0"

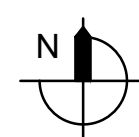

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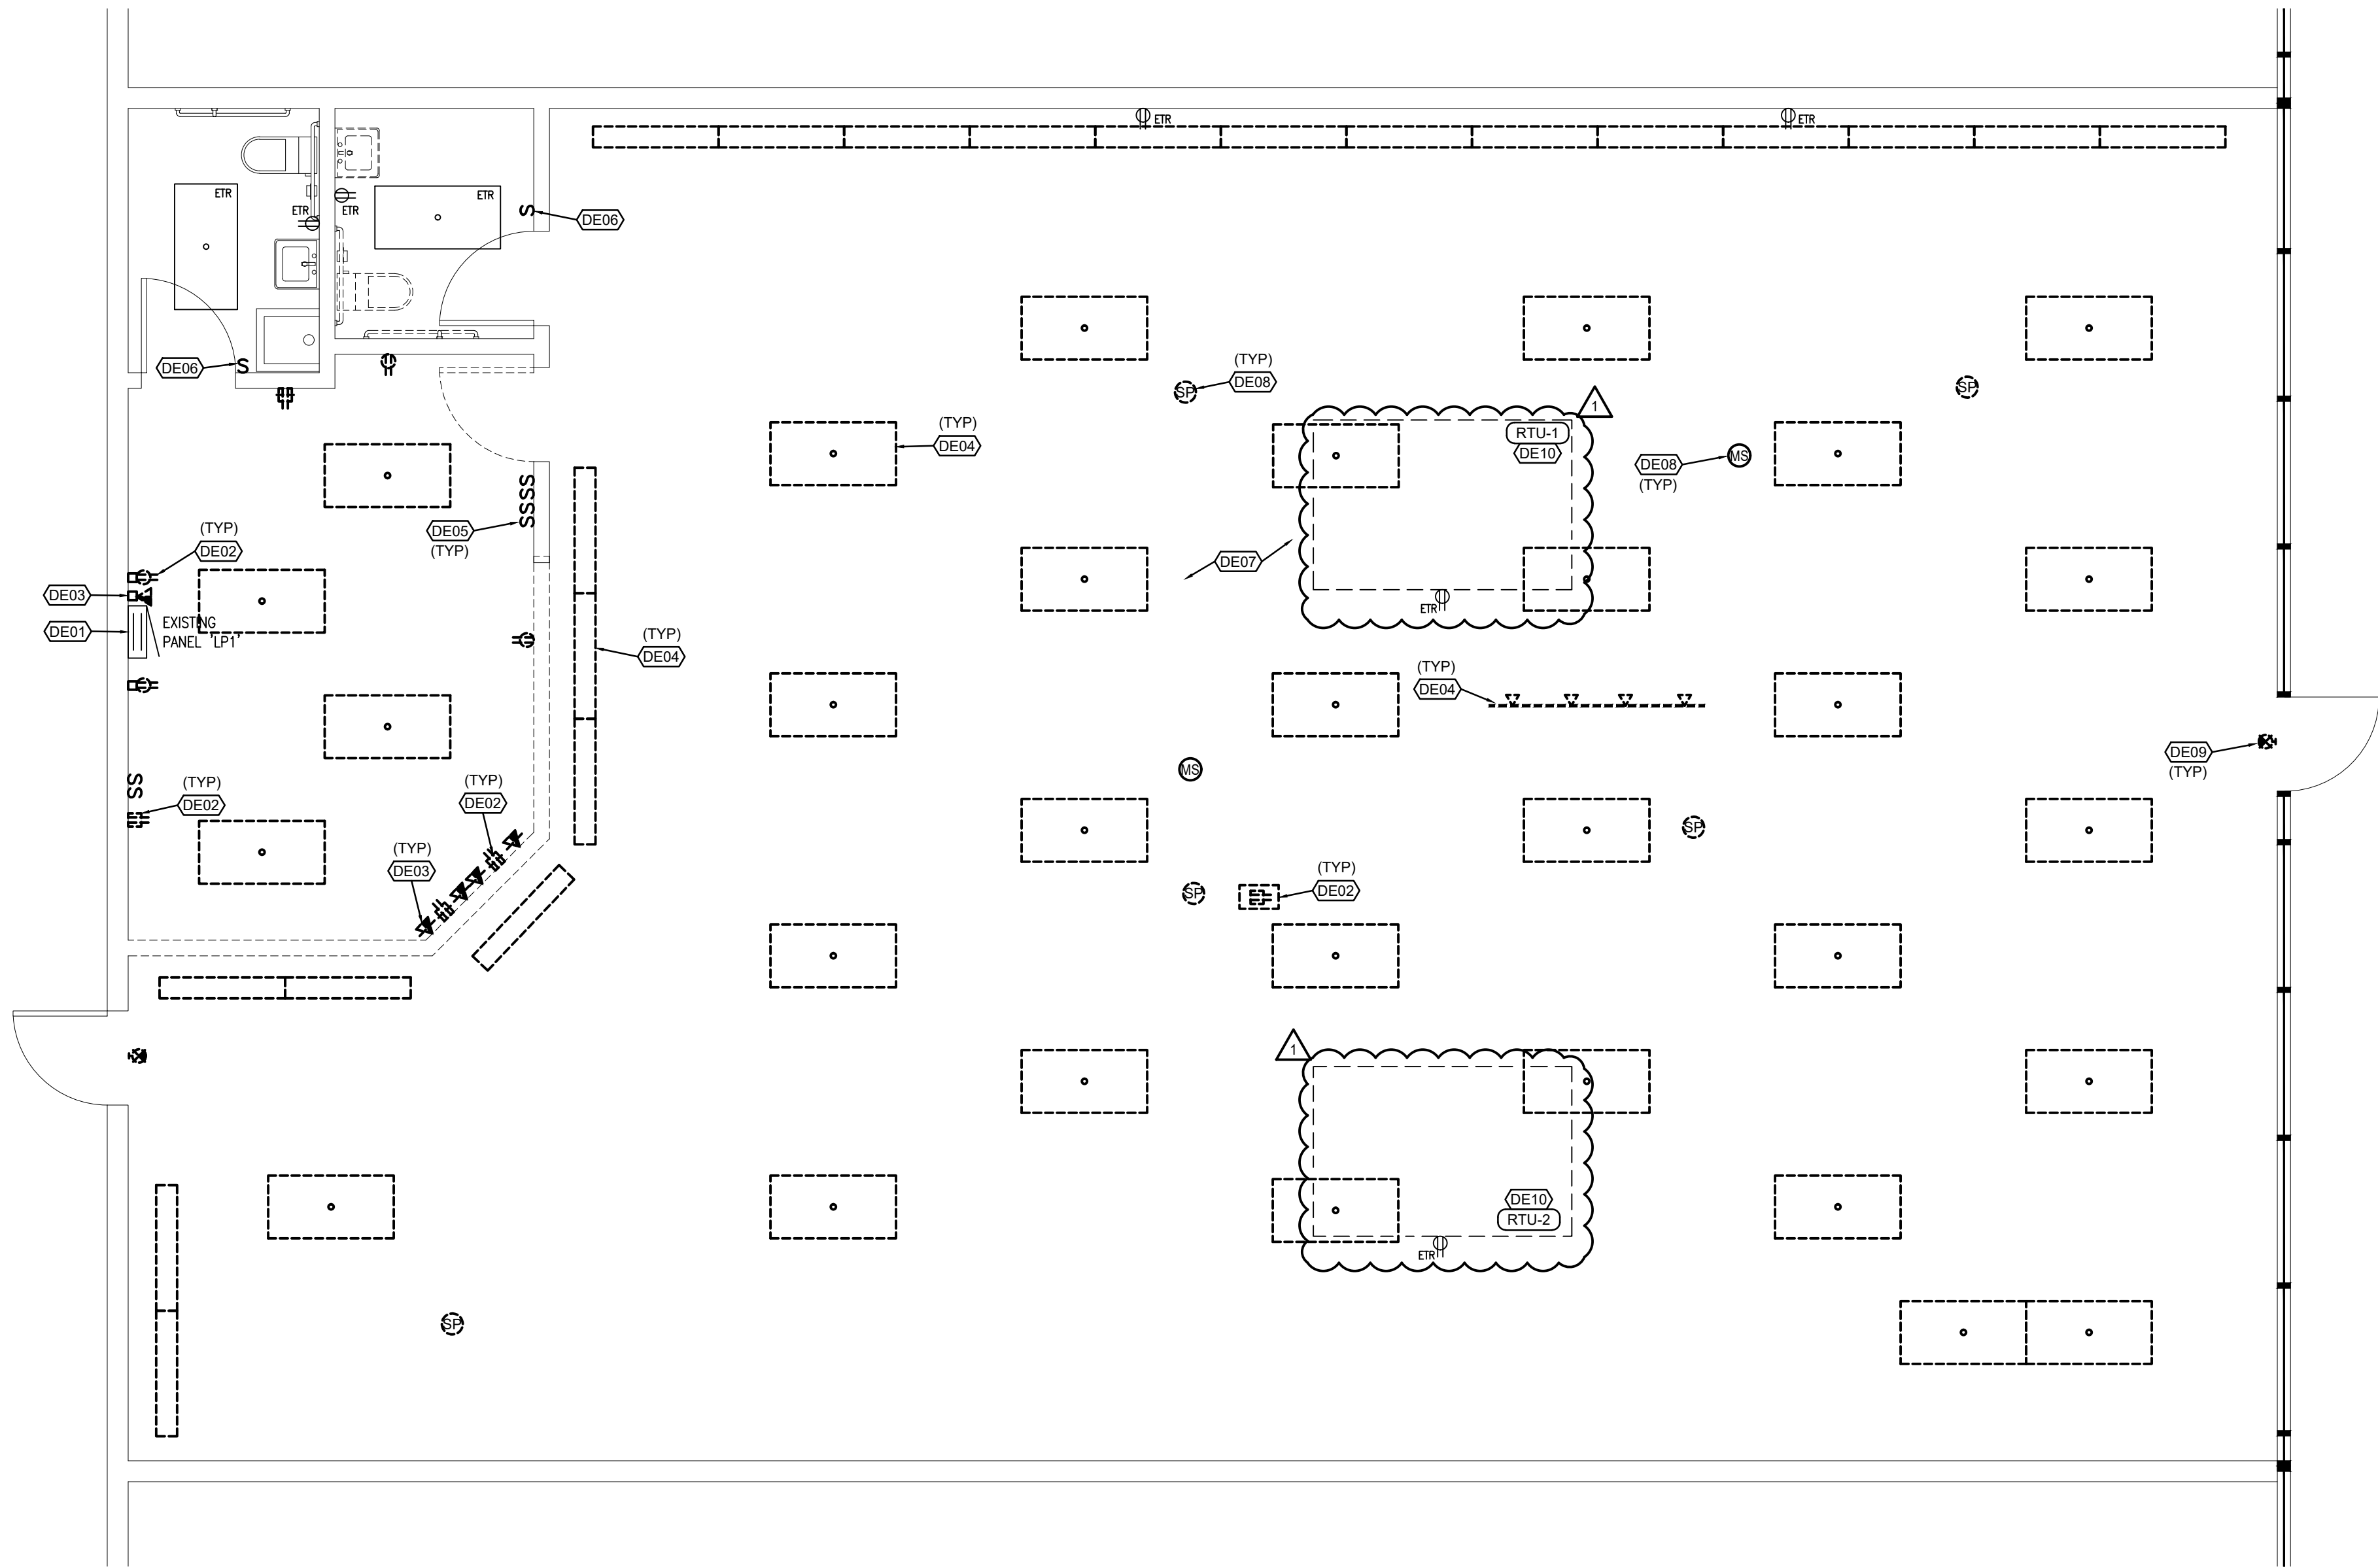
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FLOOR PLAN
MECHANICAL
NEW WORK

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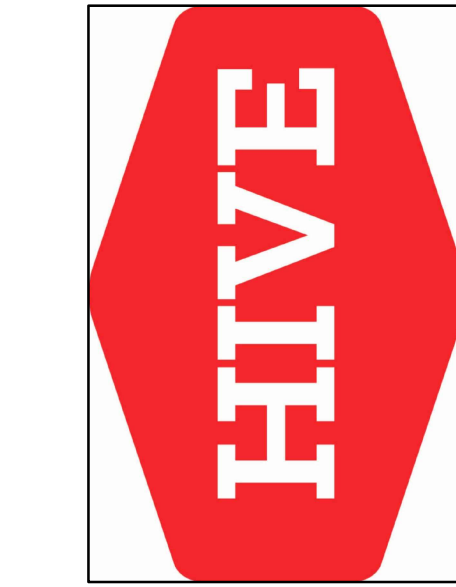
M10



FLOOR PLAN-ELECTRICAL DEMOLITION
SCALE: 1/4" = 1'-0"

DE## FLOOR PLAN NOTES

- EXISTING PANELBOARDS TO REMAIN.
- EXISTING RECEPTACLE TO BE REMOVED. REMOVE ALL ASSOCIATED WIRING AND CONDUIT BACK TO NEAREST DEVICE TO REMAIN.
- EXISTING DATA DEVICE TO BE REMOVED. REMOVE ALL ASSOCIATED WIRING AND CONDUIT BACK TO NEAREST DEVICE TO REMAIN.
- EXISTING LIGHT FIXTURE TO BE REMOVED. REMOVE ALL ASSOCIATED WIRING AND CONDUIT BACK TO NEAREST DEVICE TO REMAIN.
- EXISTING LIGHT SWITCH TO BE REMOVED. REMOVE ALL ASSOCIATED WIRING AND CONDUIT BACK TO NEAREST DEVICE TO REMAIN.
- EXISTING LIGHT SWITCH TO BE REPLACED. REMOVE DEVICE AND PREP FOR NEW DEVICE AND CONNECTION TO NEW LIGHTING AS INDICATED ON NEW WORK PLAN.
- REMOVE ALL ABANDONED WIRING, INCLUDING LOW VOLTAGE AND LINE VOLTAGE WIRING, IN AREAS WITH OPEN-TO-STRUCTURE CEILING SCHEME - RE: ARCHITECTURAL PLAN FOR THESE AREAS.
- EXISTING CEILING DEVICE TO BE REMOVED. REMOVE ALL ASSOCIATED WIRING AND CONDUIT BACK TO NEAREST DEVICE TO REMAIN.
- EXISTING EMERGENCY EXIT SIGN TO BE REMOVED. REMOVE ALL ASSOCIATED WIRING AND CONDUIT BACK TO NEAREST DEVICE TO REMAIN.
- EXISTING RTU AND ASSOCIATED SERVICE RECEPTACLES TO REMAIN



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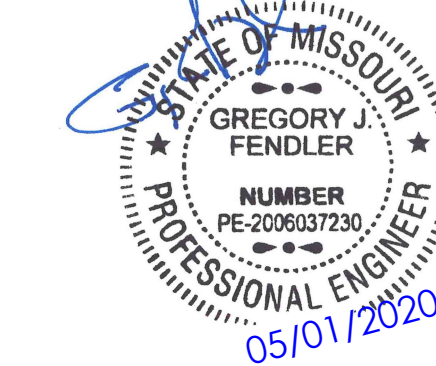
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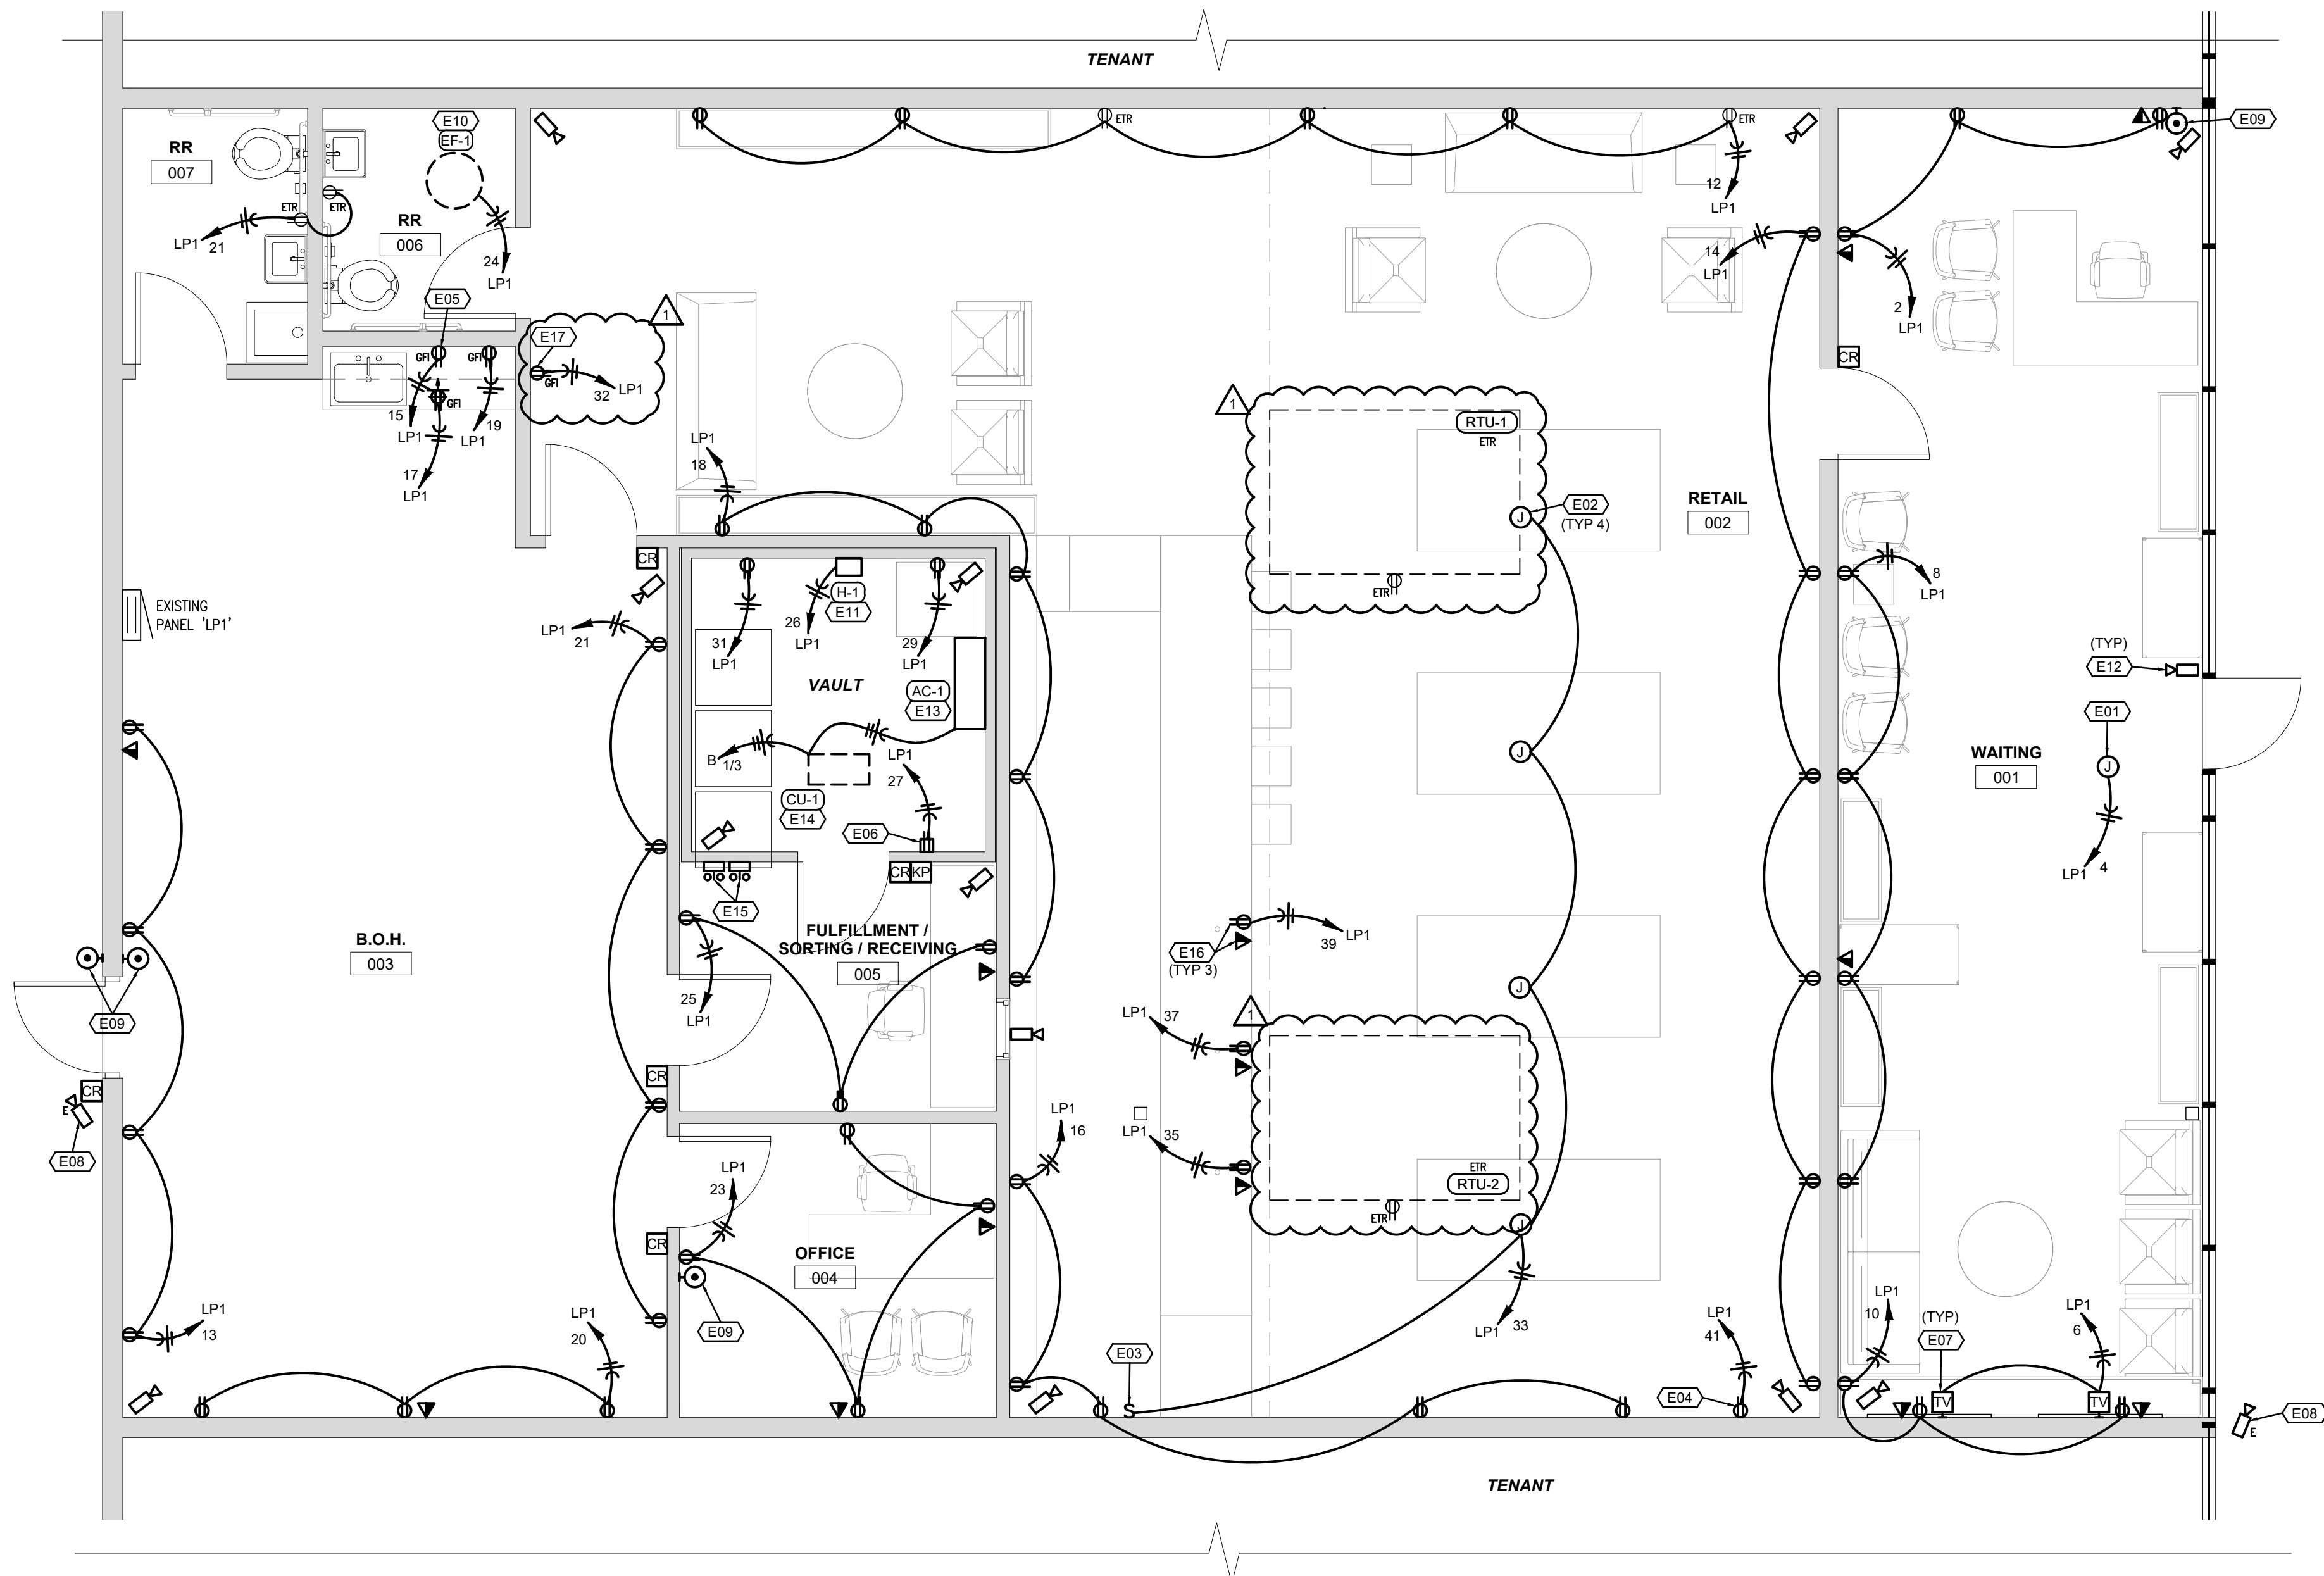
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FLOOR PLAN
ELECTRICAL
DEMOLITION

sheet number

E01



FLOOR PLAN-POWER/SYSTEMS
SCALE: 1/4" = 1'-0"

FLOOR PLAN NOTES

1. POWER CONNECTION TO ILLUMINATED SIGNAGE. CONFIRM LOCATION AND CONNECTION REQUIREMENTS WITH ARCHITECT.
2. JUNCTION BOX MOUNTED AT STRUCTURE ABOVE DISPLAY TABLES FOR FUTURE USE. ROUTE WIRING TO EACH BOX AND CAP FOR FUTURE USE. PROVIDE BLANK COVERPLATE.
3. INTERCONNECT JUNCTION BOXES WITH SWITCH. MOUNT SWITCH NEXT TO LIGHT SWITCHES. RE: LIGHTING PLAN.
4. RECEPTACLE FOR ATM. CONFIRM LOCATION OF DEVICE WITH ARCHITECT PRIOR TO ROUGH-IN.
5. RECEPTACLE FOR DISHWASHER. COORDINATE LOCATION AND CONNECTION REQUIREMENTS WITH GC PRIOR TO ROUGH-IN.
6. RECEPTACLE FOR IT RACK. CONFIRM LOCATION WITH TENANT PRIOR TO ROUGH-IN.
7. TV MEDIA BOX. RE: DETAIL FOR ADDITIONAL INFORMATION.
8. EXTERIOR CAMERA LOCATION. E.C. TO PROVIDE CONDUIT PATHWAY BACK TO IT CABINET AND WET-RATED J-BOX FOR CAMERA. COORDINATE WITH SECURITY CONSULTANT.
9. PROVIDE ROUGH-IN FOR "A-I PHONE" STYLE INTERCOM. COORDINATE WITH SECURITY CONSULTANT.
10. MAKE POWER CONNECTION TO EXHAUST FAN WITH INTEGRAL DISCONNECT. INTERLOCK FAN WITH LIGHTING CONTROLS IN RESTROOM - ACTIVATION OF MOTION SENSOR IN EITHER RESTROOM SHALL TRIGGER EXHAUST FAN. RE: LIGHTING PLANS.
11. PROVIDE 120V/30A/1P DISCONNECT AT UNIT AND MAKE POWER CONNECTION TO HUMIDIFIER. SYSTEM IS SHIPPED AS MULTI-VOLT; CONNECT TO PROPER TERMINAL BLOCK FOR 120V OPERATION.
12. INTERIOR CAMERA LOCATION. E.C. TO PROVIDE CONDUIT PATHWAY BACK TO IT CABINET AND J-BOX FOR CAMERA.
13. PROVIDE 250V/20A/2P DISCONNECT AT UNIT AND MAKE POWER CONNECTION TO INDOOR SPLIT SYSTEM. WIRE TO INDOOR UNIT FROM OUTDOOR UNIT.
14. PROVIDE 250V/20A/2P/3R DISCONNECT AND MOUNT AT UNIT AND MAKE POWER CONNECTION TO OUTDOOR SPLIT SYSTEM MOUNTED TO ROOF. CONNECT TO INDOOR UNIT.
15. PROVIDE AUDIBLE ALARM AND REMOTE TEST SWITCH FOR DUCT DETECTORS MOUNTED IN (2) EXISTING RTUS. COORDINATE EXACT MAKE/MODEL WITH LANDLORD. MOUNTING HEIGHT PER ARCHITECT.
16. PROVIDE (1) ALUMINUM DUAL-SERVICE POLE FOR POWER AND DATA DROPS TO P.O.S. RECEPTACLES. WIREMOLD SERIES 25DTP OR EQUAL. ROUTE WIRING FOR ALL THREE LOCATIONS UP WITHIN THE SAME POLE. POLE LOCATION AND FINISH PER ARCHITECT. EXTEND POLE FROM OVERHEAD STRUCTURE DOWN THROUGH CASEWORK AND ANCHOR AT FLOOR. AT OVERHEAD TERMINATION POINT OF POLE, PROVIDE 1" LOW VOLTAGE CONDUIT BACK TO IT RACK.
17. RECEPTACLE FOR DRINKING FOUNTAIN; COORDINATE REQUIREMENTS WITH PLUMBING CONTRACTOR.



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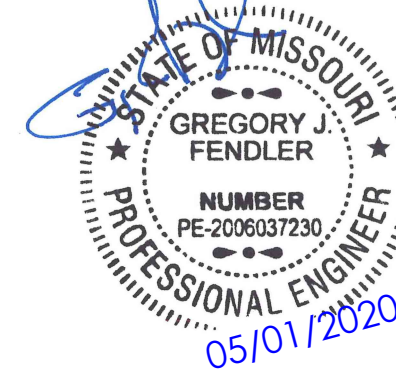
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FLOOR PLAN
POWER &
SYSTEMS


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1. DIMMER, LOWER CASE LETTER REPRESENTS ZONE CONTROLLED. RE: LIGHT FIXTURE SCHEDULE FOR DIMMER MAKE/MODEL FOR EACH FIXTURE TYPE CONTROLLED.
2. EMERGENCY BUGEYE UNIT MOUNTED UP IN STRUCTURE.
3. DUAL TECH WALLBOX OCCUPANCY SENSOR WITH INTEGRAL 0-10V DIMMER. WATTSTOPPER DW-311 OR EQUAL BY ACUITY, LUTRON, LEVITON.
4. DUAL TECH WALLBOX OCCUPANCY SENSOR WITH INTEGRAL ON/OFF SWITCH. WATTSTOPPER DW-100 OR EQUAL BY ACUITY, LUTRON, LEVITON.
5. RE: LIGHTING CONTROLS DETAILS FOR ADDITIONAL INFORMATION.
6. REPLACE EXISTING SWITCH WITH NEW AND RECONNECT TO EXISTING LIGHTING.
7. COORDINATE FINAL LOCATION OF PN1-1 (FINISH 1) VS PN1-2 (FINISH 2) FIXTURES AT EACH GROUPING OF THREE WITH ARCHITECT.
8. ROUTE EXTERIOR LIGHTING CIRCUIT THROUGH PHOTOCELL MOUNTED TO ROOF. POINT PHOTOCELL NORTH. MAKE/MODEL TO BE WATTSTOPPER EM-24 WITH BZ-150 POWERPACK.



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FLOOR PLAN LIGHTING

sheet number

E20

EXISTING PANELBOARD LP1 SCHEDULE										RATING: EXISTING A.I.C. LOCATION: B.O.H.									
SERVICE: 208/120 VOLT, 3 - PHASE, 4 - WIRE AMP FRAME: 200 AMP MAINS: MCB / 200 AMP MAIN BREAKER										MOUNTING: SURFACE									
REV NO.	NOTE NO.	LOAD CRT#	DESCRIPTION	BRKR P	AMP	A	B	C	3PH	LOAD CRT#	DESCRIPTION	BRKR P	AMP	A	B	C	3PH	NOTE NO.	REV NO.
		1								2	REC: WAITING 001 NORTH	1	20	0.54				1	
	E 3		RTU-A	3	30				9.3	4	REC: BUILDING SIGNAGE	1	20		1			1	
		5								6	REC: WAITING 001 TV'S	1	20			0.36		1	
		7								8	REC: WAITING 001 WEST	1	20	0.72				1	
	E 9		RTU-B	3	30				9.3	10	REC: WAITING 001 SOUTH	1	20		0.54			1	
		11								12	REC: RETAIL 002 NORTH	1	20			1.08		1	
1	13		REC: B.O.H. GENERAL	1	20	0.72				14	REC: RETAIL 002 EAST	1	20	1.08				1	
1	15		REC: BREAK RM DISHWASHER	1	20		1			16	REC: RETAIL 002 SOUTH/SOUTHWEST	1	20		0.9			1	
1	17		REC: BREAK RM COUNTERTOP	1	20			0.18		18	REC: RETAIL 002 WEST	1	20			0.9		1	
1	19		REC: BREAK RM FRIDGE	1	20	0.8				20	REC: B.O.H. GENERAL	1	20	0.54				1	
1	21		REC: RR 006, 007	1	20		0.36			22	REC: B.O.H. GENERAL	1	20		0.72			1	
1	23		REC: OFFICE 004	1	20			0.54		24	EXHAUST FAN EF-1	1	20			0.53		1	
1	25		REC: FULFILLMENT 005	1	20	0.54				26	HUMIDIFIER HU-1	1	25	1.38				1	
1	27		REC: VAULT I.T. RACK	1	20		0.36			28	CU-1/AC-1	2	15		1			1	
1	29		REC: VAULT FRIDGE	1	20			0.8		30									
1	31		REC: VAULT GENERAL	1	20	0.18				32	REC: DRINKING FOUNTAIN	1	20	0.18					
1	33		DISPLAY TABLE CEILING J-BOXES	1	20		1			34									
1	35		REC: RETAIL 002 P.O.S.	1	20			0.18		36									
1	37		REC: RETAIL 002 P.O.S.	1	20	0.18				38	LTG: EXTERIOR	1	20	0.05					
1	39		REC: RETAIL 002 P.O.S.	1	20		0.18			40	LTG: FRONT PORCH HOUSE	1	20		1.08				
1	41		REC: RETAIL 002 ATM	1	20			0.18		42	LTG: BACK OF HOUSE	1	20			0.37			
TOTAL:						2.42	2.9	1.88	18.6	TOTAL:						4.49	5.12	4.24	0.0
																2.42	2.9	1.88	18.6
																6.91	8.02	6.12	18.6
																109.2	118.5	102.6	
NOTES:										KVA / PHASE TOTAL:									
1 PROVIDE NEW BREAKER WITHIN EXISTING PROVISION.										AMP / PHASE TOTAL:									
E = EXISTING BREAKER/INDEX/LOAD (ESTIMATED)										TOTAL CONNECTED LOAD: 39.65 KVA									
REV:										TOTAL CONNECTED CURRENT: 110.06 AMPS									
										LIGHTS @ 125%: 1.73 KVA									
										RECEPTACLES @ 100%: 10.00 KVA									
										RECEPTACLES @ 50%: 1.88 KVA									
										LARGEST MOTOR LOAD @ 125%: 0.00 KVA									
										CONTINUOUS LOAD @ 125%: 1.25 KVA									
										OTHER AND NON-CONTINUOUS LOADS @ 100%: 23.51 KVA									
										TOTAL DEMAND LOAD: 38.37 KVA									
										POWER FACTOR: 0.95 % PF									
										TOTAL DEMAND CURRENT: 112.10 AMPS									
GENERAL NOTE:																			
CONDUCTOR & CONDUIT SIZING CHART FOR SIZING OF BRANCH																			
CIRCUITS AND OR FEEDERS AT OR BELOW 100 AMPS																			