

ISSUI	E INFO
DATE:	2/26/2020
DRAWN BY:	BTM

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SHEET TITLE

MECHANICAL PLAN




MECHANICAL NOTES


- 1. ALL WORK PER 2018 INTERNATIONAL MECHANICAL CODE.
- 2. VERIFY CLEARANCES IN ALL AREAS.
- DUCT INSTALLATION TO BE STUB OUTS AS INDICATED ON M2
 ALL CONTROLS TO BE MANUFACTURED STANDARD DEVICES ELECTRIC/ELECTRONIC. ALL CONTROL WIRING BY ELECTRICAL
- CONTRACTOR. .
 5. IF POSSIBLE, M.C. TO REUSE EXISTING RTU ROOF CURB FOR RTU-A .
- 6. NEW RTU ROOF CURB AND ROOF REPAIR FOR RTU-B.7. NEW RTU'S SHALL BE MINIMUM 14 SEER.


REQUIRED AIR FLOWS FROM IMC									
BASIS	SF	SUPPLY	CFM						
ASSUME 38 PEOPLE		38x7.5/PER.	290						
NET OCCUP. SALES AREA	2585	.12 CFM/SF	310						
TOTAL REQUIRED O.A.			600						
SUPPLIED BY RTU			640						


MARK	MANUF	MODEL NO	TYPE	TOTAL kBTUH	SENSIBLE kBTUH	CFM	HEAT kBTU	FRSH AIR CFM	
RTU A	*	4-TON RTU	RTU	50	17.4	1600	85	245	@ 100 F DB 75F WB
RTU B	*	4-TON RTU	RTU	50	17.4	1600	85	245	@ 100 F DB 75F WB

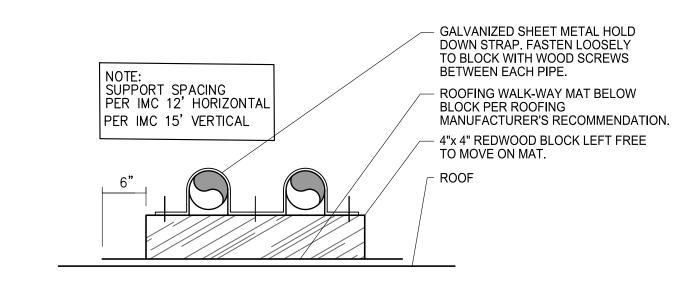



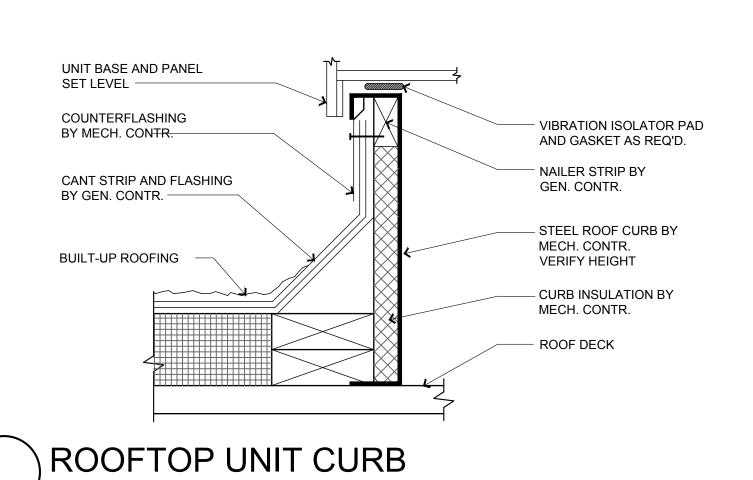

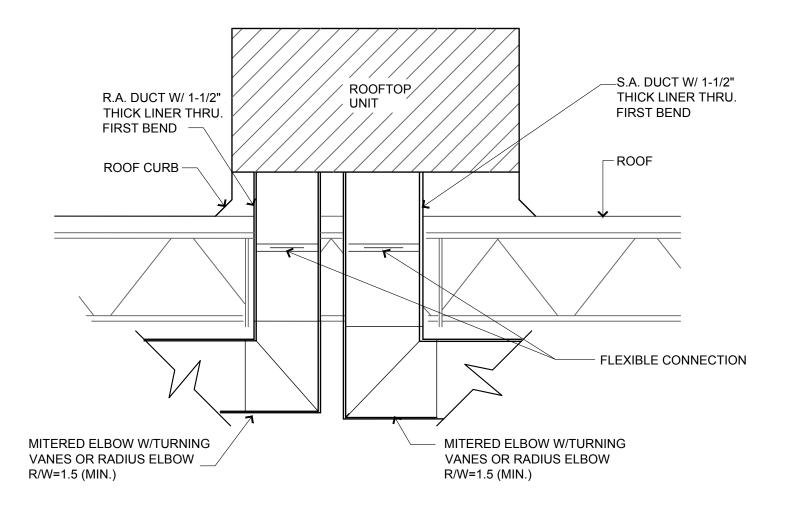

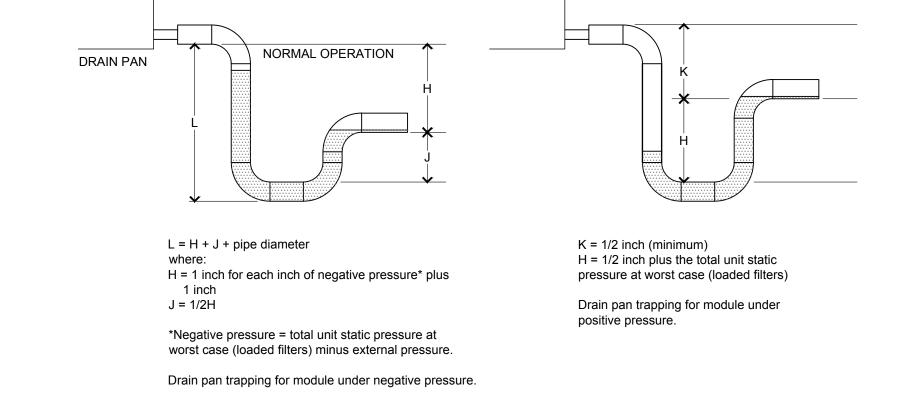




ECONOMIZER

4. MINIMUM SEER 14.0





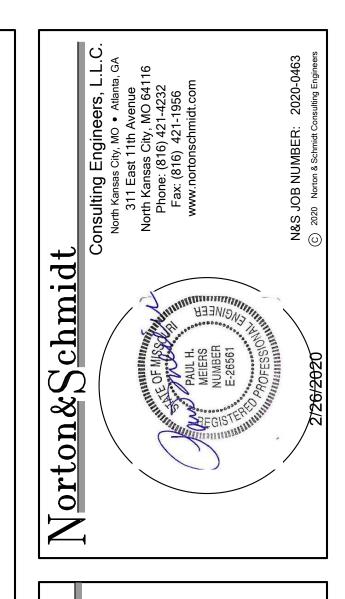

LANDLORD'S WORK 1041 NE SAM WALTON LANE LEE'S SUMMIT, MISSOURI

ISSUE INFO

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SHEET TITLE

MECHANICAL NOTES & SCHEDULES



M2

ELECTRICAL PLAN NOTES

- 1. USE EXISTING PANEL BOARDS AND CIRCUITS AS MUCH AS POSSIBLE. COORDINATE WITH
- OWNER.
 2. ALL ELECTRICAL WORK TO BE IN ACCORDANCE WITH THE 2017 NATIONAL ELECTRICAL
- CODE.
- THWN. BRANCH CIRCUITS SHALL BE WITH 3-M SCOTCHLOK OR T&B "STA-KON" OR EQUAL.
 4. ALL OUTLET AND JUNCTION BOXES SHALL BE STEEL WITH ACCESSORIES AS REQUIRED.

3. MINIMUM WIRE SIZE SHALL BE #12 COPPER WITH THHN INSL. WET LOCATIONS SHALL BE

- ALL OUTLET AND JUNCTION BOXES SHALL BE STEEL WITH ACCESSORIES AS REQUIRED.
 120V RECEPTACLES SHALL BE HEAVY DUTY 20 AMP, 125 VOLT, DUPLEX NEMA 2-20R, COLOR TO BE SELECTED BY OWNER.
- 6. 208V/220V RECEPTACLES SHALL BE HEAVY DUTY 50 AMP, 250V, NEMA RATED TO MATCH PLUG.
- 7. PROVIDE AND INSTALL INSULATED GROUND COPPER GROUND WIRES FOR EACH BRANCH CIRCUIT AND FOR GROUNDING EQUIPMENT AS PER NEC.
- 8. SWITCHES SHALL BE HEAVY DUTY, 20 AMP, 125 VOLT, COLOR AS DETERMINED BY OWNER.9. POWER AND COMMUNICATIONS SHALL BE IN SEPARATE CONDUITS.
- 10. COMMUNICATION AND PHONE JACKS SHALL BE KEYSTONE OR EQUAL WALL MOUNTED OR FLOOR MOUNTED, WITH RJ-11 AND RJ-45 MODULAR JACKS. COLOR TO BE SELECTED BY OWNER.
- OWNER.


 11. GENERAL LIGHT LAYOUT IS INDICATED, CONTRACTOR TO FOLLOW LAYOUT FROM OWNER IF
- NO EXTRA LIGHTS ARE ADDED TO A CIRCUIT.


 12. EXIT LIGHTS AND EMERGENCY LIGHTS TO BE ROUTED UN-SWITCHED IN SAME CIRCUIT AS
- ADJACENT LIGHTS AND UN-SWITCHED TO PANEL, MOUNT EXIT LIGHTS AT CEILING AND ABOVE DOORS.
- 13. ELECTRICAL CONTRACTOR SHALL PROVIDE CONTROL WIRING BETWEEN THE EXHAUST
- FANS AND THEIR RESPECTIVE SWITCHES AND THERMOSTATS.


 14. WIRING METHODS TO INCLUDE EFFECTIVE GROUND FAULT PATH WITH METALLIC ARMOR OR
- SHEATH.

 15. COMPLY WITH ALL REQUIREMENTS OF NEC 2011 ART. 517.13 (A) AND (B)
- 16. FIRE ALARM STROBE LIGHTS SHALL COMPLY WITH NFPA 72-10.

						FA	INCL	_ 5(CHE	JUL					
DESCRIPTION	kVA	Vphase		WIRE	WIRE BKR	BKR POLES		CKT PO	POLES	BKR	WIRE SIZE	kVA/phase			DESCRIPTION
DESCRIPTION	А	В	С	SIZE	AMPS				POLES	AMPS		Α	В	С	DESCRIPTION
RTU-A	3.1			10			1	2	1	20	12	1.8			OUTLETS, NORTH
RTU-A		3.1		10	30*	3	3	4	1	20	12		1.8		OUTLETS, SOUTH
RTU-A			3.1	10			5	6							
RTU-B	3.1			10			7	8							
RTU-B		3.1		10	30*	3	9	10							
RTU-B			3.1	10			11	12							
							13	14							
							15	16							
							17	18							
							19	20							
							21	22							
							23	24							
							25	26							
							27	28							
							29	30							
							31	32							
							33	34							
							35	36							
							37	38							
							39	40							
							41	42							
SUBTOTAL * HCAR BREAKER	-	-	-		4 W 200 MOUNTED				MAIN BREA MOUNTED BROUND BA	PANEL 22 R WITH IS	2,000 AIC	-	-	-	SUBTOTAL

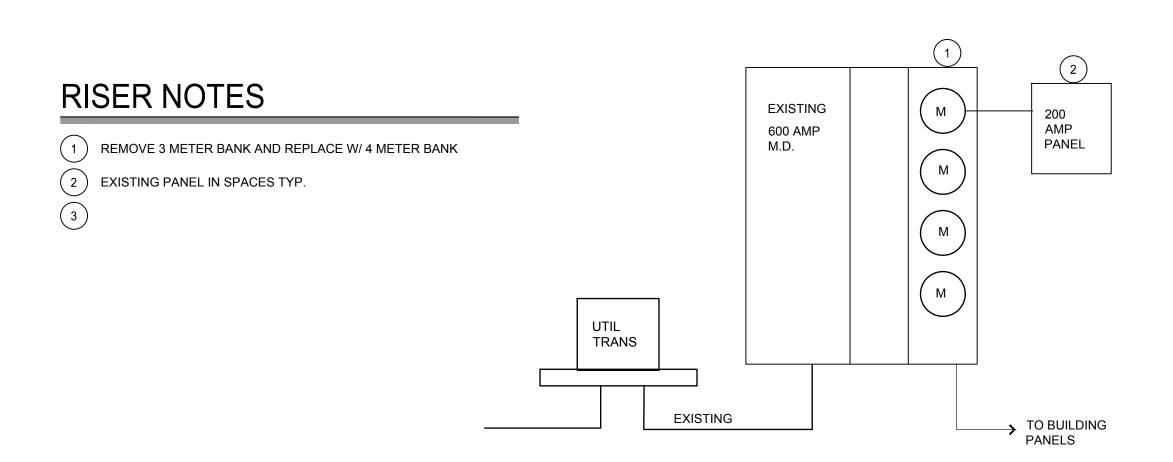

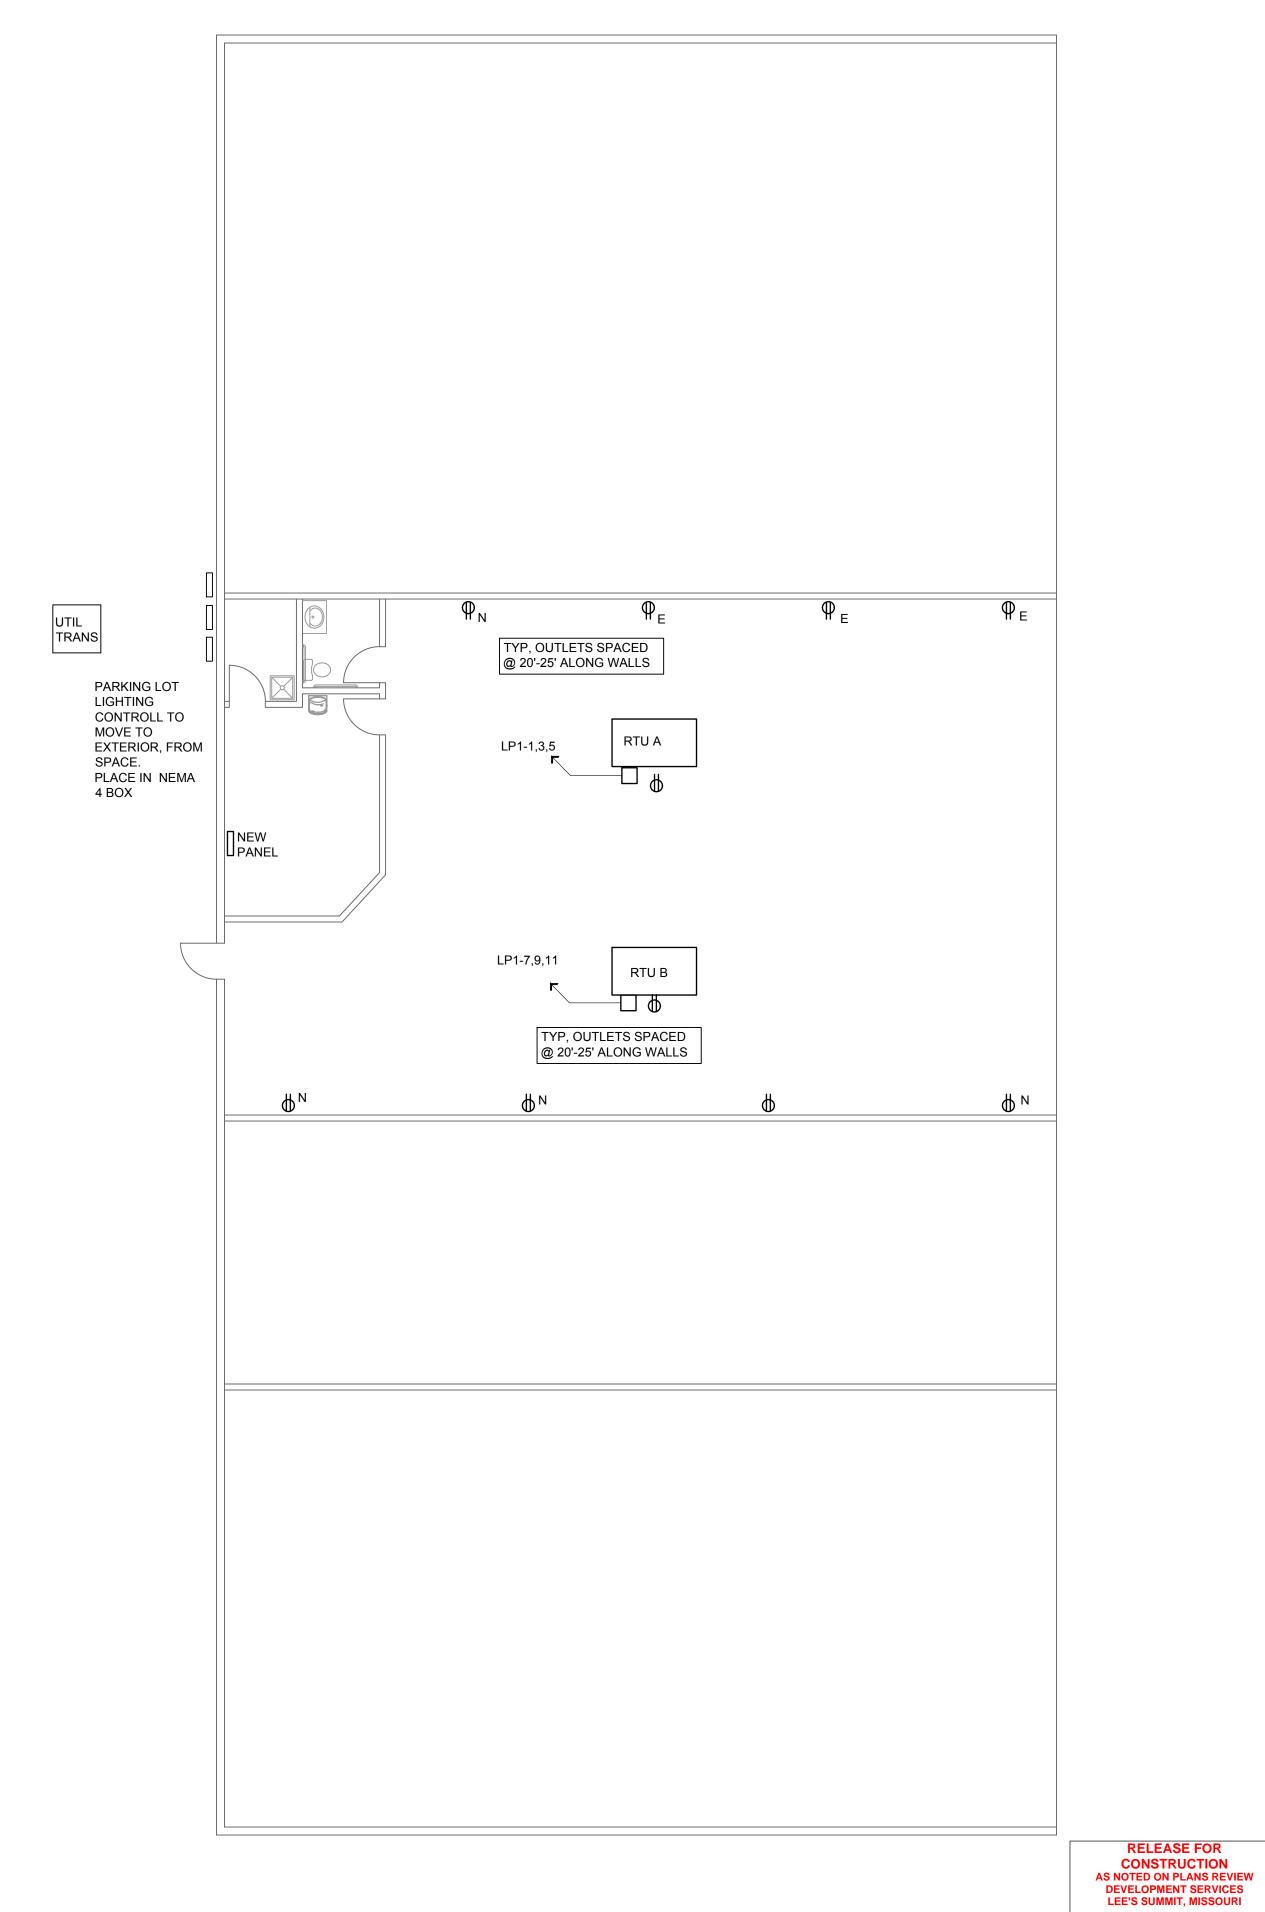

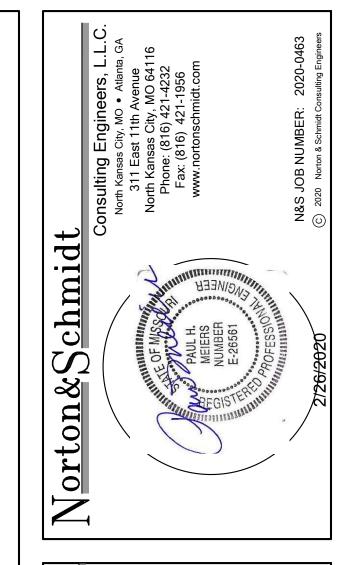

LANDLORD'S WORK
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LEE'S SUMMIT, MISSOURI

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REVIEW

ELECTRICAL POWER PLAN, NOTES & SCHEDULES




PLAN SCALE: 1/8" = 1'-0"

RE: ARCHITECTURAL DRAWINGS FOR ALL DIMENSIONS

GAS LINE NOTES

1. COORDINATE WITH ALL OTHER TRADES.

- 2. ALL PIPING TO BE INSTALLED PER THE 2018 IFGC.
- 3. PIPING TO BE ASTM A53, GR B SCHEDULE 40.

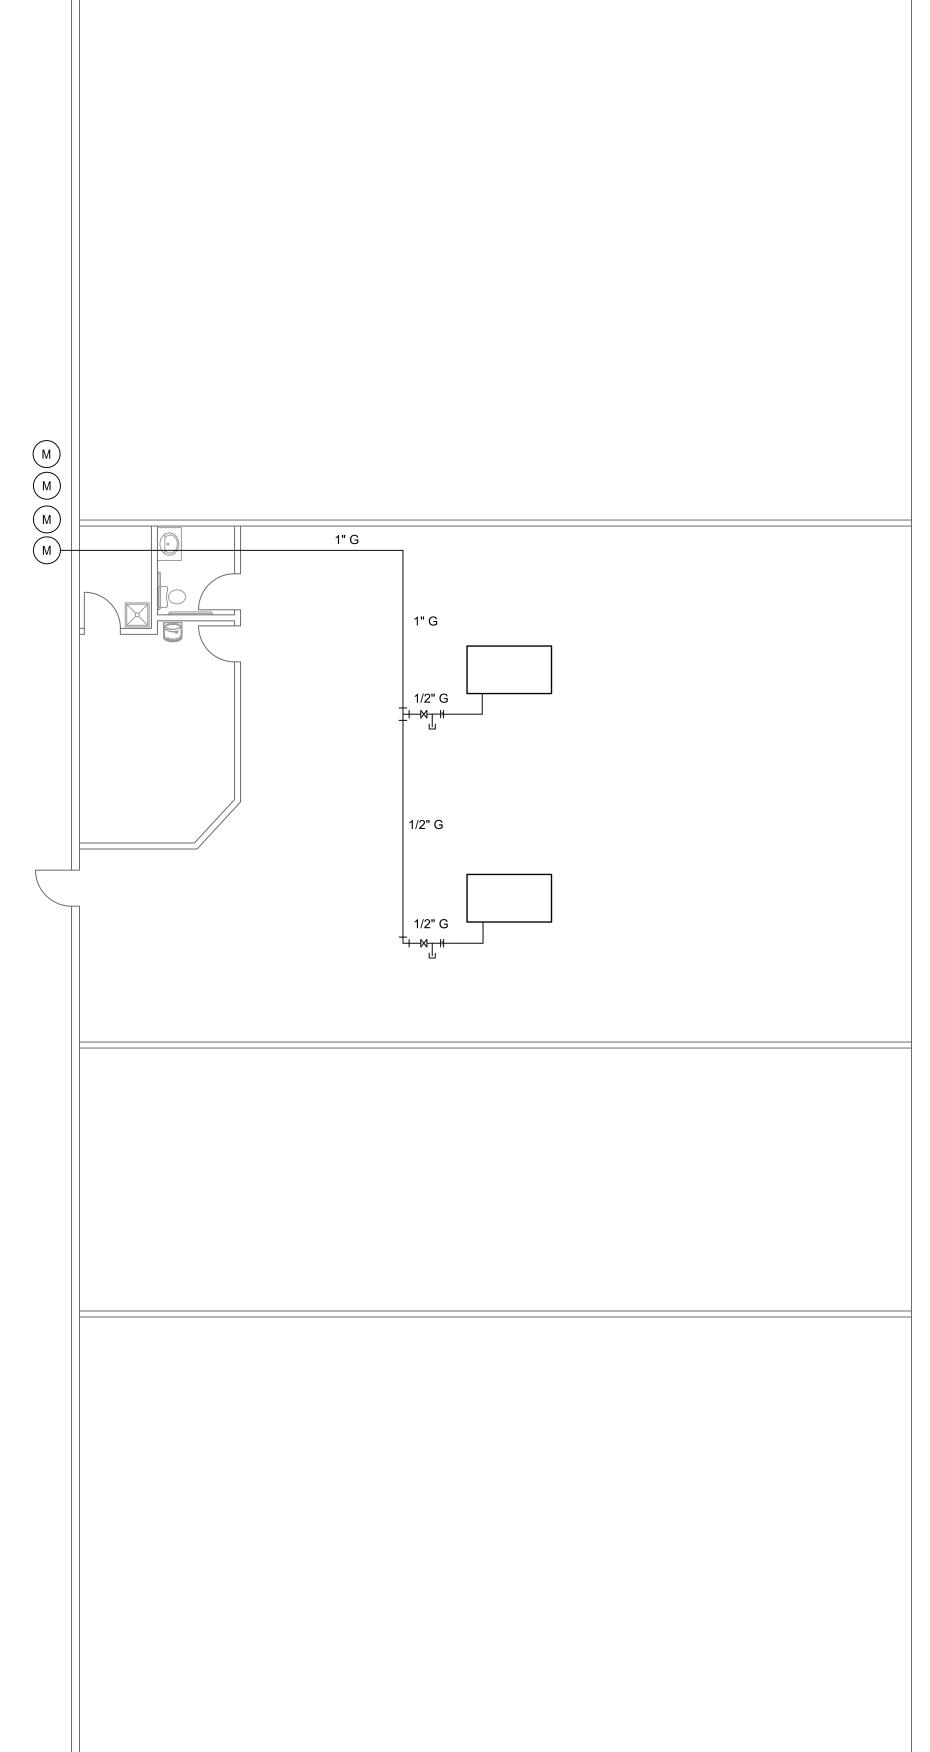

1 PLUMBING PLAN

SCALE: 1/4" = 1'-0"
RE: ARCHITECTURAL DRAWINGS FOR ALL DIMENSIONS





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PLUMBING PLAN



