



INTERIOR TENANT IMPROVEMENT
910-U NORTHWEST BLUE PARKWAY
LEE'S SUMMIT, MO 64086

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PROJECT LOCATION

PURE BARRE
INTERIOR TENANT IMPROVEMENT
910-U NORTHWEST BLUE PARKWAY
LEE'S SUMMIT, MO 64086

SHEET TITLE

TITLE SHEET, PROJECT INFORMATION AND GENERAL NOTES

STAMP



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REVISIONS

Table with 2 columns: Description, Date

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ABBREVIATIONS table with columns for Abbreviation and Full Name

GENERAL NOTES: 1. ALL CONTRACTORS AND SUBCONTRACTORS WILL THOROUGHLY FAMILIARIZE THEMSELVES WITH THESE CONSTRUCTION DOCUMENTS AND WILL VERIFY EXISTING SITE AND CONDITIONS PRIOR TO SUBMITTING A BID...

SYMBOL AND LEGEND: ELEVATION IDENTIFICATION, ENLARGED DETAIL IDENTIFICATION, PARTIAL SECTION IDENTIFICATION, SECTION DETAIL IDENTIFICATION, INTERIOR ELEVATION IDENTIFICATION, ELEVATION REFERENCE IDENTIFICATION, GRID LINE IDENTIFICATION, PROJECT SYMBOL IDENTIFICATION, CEILING IDENTIFICATION, ROOM IDENTIFICATION, PROJECT ANNOTATION IDENTIFICATION

DEFERRED SUBMITTAL: PROVIDE WHERE REQUIRE, MODIFY (E) FIRE SPRINKLER

SEPARATE SUBMITTAL: (N) EXTERIOR WALL MOUNTED BUILDING SIGNAGE, (N) INTERIOR AND EXTERIOR LED SIGNAGE

DESCRIPTIVE SUMMARY OF WORK: PROPOSED TENANT IMPROVEMENT / ALTERATION FOR A 1,743 S.F. OF FITNESS STUDIO (LESS THAN 49 OCCUPANCIES) ON A (E) BUILDING.

PROJECT INFORMATION: PROPOSED USE, CURRENT CODES, ACCESSIBILITY, CODE COMPLIANCE, LEGAL DESCRIPTION, BUILDING SUMMARY, PARKING SUMMARY

PROJECT TEAM: TENANT PURE BARRE, MECHANICAL, PLUMBING & ELECTRICAL DUNHAM ENGINEERING, ARCHITECT AMOR ARCHITECTURAL CORPORATION, APPROVED VENDOR PLATINUM SLV, LLC

SHEET INDEX: ARCHITECTURAL, MECHANICAL, PLUMBING, ELECTRICAL, VICINITY MAP showing project location on a map of Rancho Cucamonga, CA

GENERAL CONSTRUCTION NOTES

FIRE ALARM / BURGLAR ALARM SYSTEM (WHERE APPLIES)
IT IS THE GENERAL CONTRACTOR'S RESPONSIBILITY TO VERIFY IF THE EXISTING FIRE ALARM / BURGLAR ALARM SYSTEM NEEDS TO BE MODIFIED IN ORDER TO ACCOMMODATE THE RENOVATION SPACE. THIS INCLUDES ALL AFFECTED AREAS TO INCLUDE MAIN LOBBY AND ADJACENT ROOMS. IF REQUIRED, THE CONTRACTOR MUST SUBMIT FIRE ALARM / BURGLAR ALARM SYSTEM SHOP DRAWINGS. ALL COSTS AND FEES SHOULD BE INCLUDED IN THE CONTRACTOR'S BID PROPOSAL TO THE OWNER. AT THE COMPLETION OF THE PROJECT, THE CONTRACTOR SHALL BE RESPONSIBLE TO OBTAIN APPROVAL AND SIGN-OFF FOR THE MODIFIED FIRE ALARM / BURGLAR ALARM SYSTEM BY ANY JURISDICTIONAL REQUIREMENTS.

ENTRANCES AND EXITS

- ALL ENTRANCES AND ALL EXTERIOR GROUND FLOOR EXIT DOORS TO BUILDING AND FACILITIES SHALL BE MADE ACCESSIBLE OR REMAIN ACCESSIBLE.
- EXIT DOORS SHALL BE OPENABLE FROM THE INSIDE WITHOUT THE USE OF A KEY OR ANY SPECIAL KNOWLEDGE OR EFFORT.
- MANUALLY OPERATED EDGE OR SURFACE MOUNTED FLUSH BOLTS AND SURFACE BOLTS ARE PROHIBITED. WHEN EXIT DOORS ARE USED IN PAIRS AND APPROVED AUTOMATIC FLUSH BOLTS ARE USED, THE DOOR LEAF HAVING THE AUTOMATIC FLUSH BOLTS SHALL HAVE NO DOOR KNOBS OR SURFACE MOUNTED HARDWARE. THE UNLATCHING OF ANY LEAF SHALL NOT REQUIRE MORE THAN ONE OPERATION.
- LATCHING AND LOCKING DOORS THAT ARE HAND ACTIVATED AND WHICH ARE IN A PATH OF TRAVEL SHALL BE OPERABLE WITH A SINGLE EFFORT BY LEVER TYPE HARDWARE, PANIC BARS, PUSH-PULL ACTIVATION BARS, OR OTHER HARDWARE DESIGNED TO PROVIDE PASSAGE WITHOUT REQUIRING THE ABILITY TO GRASP THE OPENING HARDWARE. LOCKED EXIT DOORS SHALL OPERATE AS ABOVE IN EGRESS DIRECTION.
- NEW HAND ACTIVATED DOOR OPENING HARDWARE SHALL MATCH EXISTING DOORS (WHERE APPLIES.) LEVER MUST BE CENTERED BETWEEN 34" MIN. AND 44" MAX. ABOVE THE FLOOR.
- EVERY DOORWAY LOCATED WITHIN AN ACCESSIBLE PATH OF TRAVEL SHALL BE OF A SIZE AS TO PERMIT THE INSTALLATION OF A DOOR NOT LESS THAN 3'-0" IN WIDTH AND NOT LESS THAN 6'-8" IN HEIGHT. WHEN INSTALLED, EXIT DOORS SHALL BE CAPABLE OF OPENING SO THAT THE CLEAR WIDTH OF THE EXIT IS NOT LESS THAN 32".
- THERE SHALL BE A LEVEL AND CLEAR FLOOR OR LANDING ON EACH SIDE OF A DOOR. THE LEVEL AREA SHALL HAVE A LENGTH IN THE DIRECTION OF DOOR SWING OF AT LEAST 60" (5'-0") AND THE LENGTH OPPOSITE THE DIRECTION OF DOOR SWING OF 48" (4'-0") AS MEASURED AT RIGHT ANGLE TO THE PLANE OF THE DOOR IN THE CLOSED POSITION.
- FLOOR OR LANDING SHALL BE NOT MORE THAN 1/2" LOWER THAN THE THRESHOLD OF THE DOORWAY.
- DOORS SHALL HAVE A SMOOTH UNINTERRUPTED SURFACE TO ALLOW THE DOOR TO BE OPENED BY A WHEELCHAIR FOOTREST WITHOUT CREATING A TRAP OR HAZARDOUS CONDITION. WHERE NARROW FRAME DOORS ARE USED, A 10" HIGH (KICK PLATE) SMOOTH PANEL SHALL BE INSTALLED ON THE PUSH SIDE OF THE DOOR WHICH WILL ALLOW THE DOOR TO BE OPENED BY A WHEELCHAIR FOOTREST WITHOUT CREATING A TRAP OR HAZARDOUS CONDITION.
- MAXIMUM EFFORT TO OPERATED DOORS SHALL NOT EXCEED 5 POUNDS FOR EXTERIOR DOORS AND 5 POUNDS FOR INTERIOR DOORS. SUCH PUSH OR PULL EFFORT BEING APPLIED AT RIGHT ANGLES TO HINGED DOORS AND AT THE CENTER PLANE OF SLIDING OR FOLDING DOORS. COMPENSATION DEVICES OR AUTOMATIC DOOR OPERATORS MAY BE UTILIZED TO MEET THE ABOVE STANDARDS. WHEN FIRE DOORS ARE REQUIRED, THE MAXIMUM EFFORT TO OPERATE THE DOOR MAY BE INCREASED TO THE MAXIMUM ALLOWABLE BY THE APPROPRIATE ADMINISTRATIVE AUTHORITY NOT TO EXCEED 15 POUNDS.
- DOORS WITH CLOSING DEVICES TO CLOSE SLOWER THAN 5 SECONDS WHEN OPEN TO 70° OR MORE.

DEMOLITION (WHERE APPLIES)

GENERAL CONTRACTOR IS RESPONSIBLE FOR THE REMOVAL, HAULING AWAY, AND RECYCLING OF ALL DEMOLISHED ITEMS TO INCLUDE WALL PARTITIONS, CEILINGS, DOORS AND FRAMES, MILLWORK, CONVEYOR SYSTEM, FLOORING, SIGNAGE, ETC. ON-SITE DUMPSTERS ARE NOT ALLOWED TO BE USED FOR CONSTRUCTION DUMPING. (RECYCLE AND / OR SALVAGE FOR REUSE A MINIMUM OF 65% OF THE NON-HAZARDOUS CONSTRUCTION AND DEMOLITION WASTE IN ACCORDANCE WITH SECTION 5.408.1.1, 5.408.1.3 OF CGBSC)

GENERAL RESPONSIBILITIES

- GENERAL CONTRACTOR SHALL BE RESPONSIBLE TO VERIFY ALL CONTACT INFORMATION REGARDING THE PROJECT SITE TO INCLUDE NAMES AND TELEPHONE NUMBERS. CONTACTS SHOULD INCLUDE STORE MANAGER, LANDLORD / PROPERTY MANAGER, CITY BUILDING INSPECTORS, FIRE DEPARTMENT INSPECTORS, ETC. THIS MUST BE DONE AT LEAST (2) TWO WEEKS PRIOR TO START OF CONSTRUCTION SO THAT G.C. CAN GAIN ACCESS TO ALL AREAS OF THE SITE AND COMPLETE ALL NECESSARY INSPECTIONS FOR THE PROJECT.
- THE GENERAL CONTRACTOR SHALL PROVIDE STORAGE CONTAINERS, IF NECESSARY, TO RECEIVE CONSTRUCTION ITEMS SUCH AS MILLWORK, CONVEYOR SYSTEM, CART, ETC. G.C. SHALL, UPON RECEIVING OF OWNER FURNISHED ITEMS, REPORT ALL DAMAGED OR MISSING PARTS OR COMPONENTS TO THE ARCHITECT IMMEDIATELY. G.C. MUST COORDINATE FOR THE DELIVERY OF OWNER FURNISHED ITEMS TO BE PLACED IN THE G.C.'S DESIGNATED STORAGE CONTAINER LOCATION (2) TWO DAYS PRIOR TO START OF INSTALLATION OF THESE ITEMS.
- IT IS THE INTENT OF THE TENANT TO SALVAGE AND RECYCLE AS MUCH OF THE EXISTING MATERIALS AT THE JOBSITE AS POSSIBLE. FOR THE EXISTING MILLWORK, GENERAL CONTRACTOR SHALL PHYSICALLY VERIFY IF THE FIXTURES ARE STILL IN GOOD OR REASONABLE CONDITION FOR REUSE AT OTHER TENANT FACILITIES. G.C. SHALL INFORM THE TENANT OF HIS ANALYSIS. IF IT IS VERIFIED THAT THE FIXTURES ARE SO DAMAGED THAT IT WOULD NOT BE WORTH SALVAGING, THEN THE FIXTURES WOULD BE DEMOLISHED. IF THE FIXTURES ARE SALVAGEABLE WHEN DISCONNECTED FROM ITS CURRENT LOCATION, THEN THE G.C. SHALL MOVE THEM INTO THE EXISTING WAREHOUSE AT A LOCATION DETERMINED WITH THE TENANT AND / OR STORE MANAGER. THE TENANT SHALL PICK THE FIXTURES UP AT A LATER TIME FOR STORAGE AND FUTURE REUSE. FOR OTHER MATERIALS, THE G.C. SHALL PROVIDE AN ALTERNATE PRICED IN THE PROJECT BID FORM TO THE TENANT TO RECYCLE THESE MATERIALS (I.E., CEILING TILES, DRYWALL, DOORS, FLOORING, ETC.) THE TENANT SHALL INFORM THE G.C. WHETHER TO RECYCLE THE MATERIALS OR TO HAUL AWAY TO THE LOCAL LANDFILL.
- THE G.C. IS RESPONSIBLE FOR MATERIALS AND LABOR REQUIRED FOR ANY ALTERATIONS TO FIRE SPRINKLERS, ELECTRICAL EQUIPMENT, PLUMBING, EMERGENCY & EXISTING LIGHTING, ALARM AND MECHANICAL SYSTEMS AS REQUIRED TO COMPLETE THE PROJECT AND OBTAIN FINAL INSPECTIONS.
- ANY DISCREPANCIES BETWEEN THESE DOCUMENTS AND THE ACTUAL FIELD CONDITIONS SHALL BE BROUGHT TO THE ATTENTION OF THE ARCHITECT BEFORE PROCEEDING WITH ANY WORK.
- THE GENERAL CONTRACTOR SHALL REVIEW ALL DOCUMENTS AND VERIFY ALL DIMENSIONS AND FIELD CONDITIONS AND SHALL CONFIRM THAT WORK IS CONSTRUCTIBLE AS SHOWN. ANY CONFLICTS OR OMISSIONS, ETC., SHALL BE IMMEDIATELY REPORTED TO THE ARCHITECT FOR CLARIFICATION PRIOR TO THE PERFORMANCE OF ANY WORK IN QUESTION.
- DO NOT SCALE DRAWINGS. WRITTEN DIMENSIONS GOVERN ALL PARTITION LOCATIONS. ALL DOOR AND OPENING LOCATIONS SHALL BE SHOWN ON FLOOR PLAN. IN CASE OF CONFLICT, NOTIFY THE ARCHITECT OF RECORD. FLOOR PLAN BY ARCHITECT OF RECORD SUPERSEDES OTHER PLANS. ALL DIMENSIONS MARKED "CLEAR" SHALL BE MAINTAINED AND SHALL ALLOW FOR THICKNESS OF ALL FINISHES INCLUDING CARPET, PAD, CERAMIC TILE, VINYL COMPOSITE TILE, ETC.
- ALL INTERIOR DIMENSIONS ARE TO THE FACE OF NEW STUD, UNLESS NOTED OTHERWISE. COLUMN CENTER LINE (OR GRID LINES) ARE SHOWN FOR DIMENSIONING. VERIFY EXACT LOCATIONS IN FIELD (AS REQUIRED).
- THE GENERAL CONTRACTOR SHALL MARK LOCATIONS OF PARTITIONS AND DOORS FOR REVIEW BY THE OWNER'S REPRESENTATIVE PRIOR TO INSTALLATION. REVIEW WILL BE FOR DESIGN INTENT. SUB CONTRACTOR SHALL COORDINATE AND VERIFY ALL CONDITIONS TO ENSURE PROPER FIT.
- THE GENERAL CONTRACTOR IS RESPONSIBLE TO FOLLOW OWNER'S GROUP RULES AND REGULATIONS, WHEN THE G.C. ACCEPTS DELIVERY OF ALL ITEMS NOTED ON PLANS WHETHER IN CONTRACT OR NOT IN CONTRACT, (S)HE SHALL BE RESPONSIBLE FOR LOSS AND/OR DAMAGE TO THESE ITEMS.
- THE GENERAL CONTRACTOR SHALL MAINTAIN, FOR THE ENTIRE DURATION OF THE WORK, ALL EXITS, EXIT / EGRESS LIGHTING, FIRE PROTECTION DEVICES AND ALARMS IN CONFORMANCE WITH ALL APPLICABLE CODES AND ORDINANCES.
- ALL SAW CUTTING AND CORING LOCATIONS SHALL BE REVIEWED IN FIELD BY THE GENERAL CONTRACTOR AND COORDINATED WITH THE OWNER'S REPRESENTATIVE PRIOR TO CUTTING / CORING.
- DURING ALL PHASES OF WORK, DO NOT DISTURB THE DELIVERIES AND FUNCTIONS OF ALL ADJACENT AND NEIGHBORING TENANTS.
- PROVIDE PORTABLE FIRE EXTINGUISHER(S) IN ACCORDANCE WITH NFPA 10, WITH U.L. LABEL AND A RATING OF NOT LESS THAN 2-A WITH 7.5 FEET OF TRAVEL DISTANCE TO ALL POSITIONS OF STORE AND / OR AS DIRECTED BY THE FIRE DEPARTMENT FIELD INSPECTOR.
- ALL EXTERIOR BUILDING SIGNAGES SHALL BE SUBMITTED UNDER SEPARATE PERMIT APPLICATION FOR REVIEW AND APPROVAL AS REQUIRED BY LOCAL AUTHORITIES. EXTERIOR SIGNAGES ARE NOT WITHIN THE SCOPE OF BUILDING DEPARTMENT APPROVAL.
- PRIOR TO COMMENCEMENT OF ANY WORK - THE OWNER OR OWNER'S REPRESENTATIVE SHALL ENGAGE LICENSED DESIGN PROFESSIONAL(S) TO PROVIDED ALL REQUIRED DOCUMENTATION FOR REVIEW, AND RECEIVE APPROVAL BY THE LOCAL AUTHORITIES HAVING JURISDICTION. INCLUDING BUT NOT LIMITED TO STRUCTURAL VERIFICATION AND DESIGN, BUILDING, FIRE, LIFE SAFETY, HEALTH, PLUMBING, ELECTRICAL, AND MECHANICAL APPROVALS.
- IF REQUIRED BY LOCAL JURISDICTION - SPRINKLER, LIFE SAFETY, AND FIRE ALARM SYSTEMS ARE TO BE DESIGNED AND SUBMITTED FOR REVIEW AND APPROVAL BY LOCALLY LICENSED DESIGN PROFESSIONAL. THE DESIGN OF ALL SYSTEM(S) MUST COMPLY TO ALL FEDERAL, NATIONAL, STATE, AND LOCAL CODES AND ORDINANCES.
- EXISTING ENERGY MANAGEMENT SYSTEM (VERIFY IN FIELD) TO REMAIN IN STORE AND BE FULLY FUNCTIONAL AND OPERATIONAL AT COMPLETION OF REMODEL PROJECT.

FINISHES

GYPSUM WALLBOARD (WHERE APPLIES)

- PROVIDE GYPSUM WALLBOARD, STEEL FRAMING COMPONENTS, AND ACCESSORIES ARE TO BE CONSTRUCTED IN ACCORDANCE WITH THE CONTRACT DOCUMENTS GYPSUM ASSOCIATION'S FIRE RESISTANCE DESIGN MANUAL. PRODUCTS SPECIFIED HEREIN ARE AS MANUFACTURED BY U.S. GYPSUM ASSOCIATION. EQUIVALENT PRODUCTS OF OTHER MANUFACTURERS WILL BE CONSIDERED PROVIDED THEY MEET THOSE ESTABLISHED STANDARDS. MAKE APPROPRIATE SUBMITTAL FOR ANY SUBSTITUTIONS.
- ARCHITECT WILL NOT REIMBURSE CONTRACTOR OR SUB-CONTRACTOR FOR CITY OR STATE LICENSE FEES WHICH MAY BE REQUIRED TO PERFORM WORK.
- FINISHES
 - UNLESS NOTED OTHERWISE (E.G. SPECIAL WALL COVERING AREAS) ALL GYPSUM WALLBOARD SHALL BE TAPED, SMOOTH, AND PAINTED.
 - VERIFY ANY SPECIAL FINISH AREA PRIOR TO COMMENCING WORK.

PAINTING

- SEE FINISH SCHEDULE FOR ALL PAINT PRODUCTS AND SPECIFICATIONS.
- THE WORK INCLUDES, BUT IS NOT LIMITED TO FURNISHING OF MATERIALS AND EQUIPMENT, AND COMPLETION OF PAINTING AND PAINTER'S FINISH ON EXPOSED SURFACES AS REQUIRED TO COMPLETE FINISHING OF THE WORK INDICATED ON THE DRAWINGS OR SPECIFIED HEREIN.
- THE CONTRACTOR SHALL BE RESPONSIBLE FOR COMPLIANCE OF MATERIALS AND APPLICATION WITH GOVERNING AGENCIES (LOCAL STATE AND FEDERAL) IN CONNECTION WITH THIS PROJECT.
- THE FOLLOWING EXPOSED SURFACES ARE TO BE PAINTED:
 - UNLESS NOTED OTHERWISE, ALL GYPSUM WALLBOARD NOT COVERED BY OTHER MATERIALS.
 - ALL EXISTING WALLBOARD TO A MIN. OF 6' ABOVE ROOM CEILING. TYPICAL, UNLESS NOTED OTHERWISE ON ROOM FINISH SCHEDULE.
 - ALL METAL IN IMPROVED AREAS NOT PRE-FINISHED PRIOR TO INSTALLATION.
 - ALL WOOD SURFACES, TRIM, OR PIECES NOT PRE-FINISHED PRIOR TO INSTALLATION. (DO NOT PAINT INTERIOR ELEMENTS NORMALLY CONCEALED SUCH AS STRUCTURAL COMPONENTS AND ELECTRICAL WIRING)
- MATERIALS
 - PAINTED PRODUCTS SHALL BE MANUFACTURED BY APPROVED OR SCHEDULED PRODUCT.
 - ACCESSORY MATERIALS SUCH AS TURPENTINE / THINNER / UNSEED OIL SHALL BE APPROVED BY THE COATING MANUFACTURER.
 - THE NUMBER OF COATS IS TO BE THREE (3) MINIMUM. ADDITIONAL COATS SHALL BE APPLIED AT NO ADDITIONAL COST IF NECESSARY TO COMPLETELY HIDE BASE MATERIALS, PRODUCE UNIFORM COLOR, AND PROVIDE SATISFACTORY FINISH RESULTS.
 - APPLICATION AND SURFACE PREPARATION SHALL BE DONE ACCORDING TO MANUFACTURER'S WRITTEN SPECIFICATIONS AND APPLICATION INSTRUCTIONS. ALL FINISHES SHALL BE APPLIED EVENLY AND BE FREE OF RUNS, SAGS, SKIPS, CRAWLS, AND / OR DEFECTS.
 - THE CONTRACTOR SHALL PROTECT HIS OWN WORK, AND ADJACENT EXISTING WORK AND MATERIALS, WITH SUITABLE COVERINGS OR MASKINGS. THE CONTRACTOR SHALL ALSO BE RESPONSIBLE FOR CLEANING THE AREA OF HIS WORK AS WELL AS REMOVAL OF ALL EXCESS MATERIAL (EITHER FROM ADJACENT SURFACES OR EXTRA MATERIALS). CONTRACTOR TO PAINT, REPAIR, OR REPLACE ANY BUILDING OR ELECTRICAL COMPONENTS DURING CONSTRUCTION AT HIS OWN EXPENSE.
 - SURFACES TO BE PAINTED SHALL BE FREE OF OIL GREASE, LOOSE PAINT, OR OTHER FOREIGN MATERIAL.
- CONTRACTOR TO VERIFY FINISHES ON SIGNAGE WITH THE ARCHITECT.

CABINET WORK

- MAKE ALL FINISHED WORK PER THE DETAILED DRAWINGS.
- TAKE SUCH FIELD MEASUREMENTS AS MAY BE REQUIRED.
- ALL FINISHED CABINET MATERIALS TO BE AS CALLED OUT PER THE CONSTRUCTION DOCUMENTS.
- PLASTIC LAMINATE FINISHING SHALL CONFORM TO REQUIREMENTS OF ARCHITECTURAL WOODWORK INSTITUTE. "QUALITY STANDARDS" FOR "CUSTOM" GRADE AND NOTES CONTAINED HEREIN.
- INSTALLATION - INSTALL UNITS LEVEL AND PLUMB WITH TIGHT JOINTS BETWEEN ANY MULTIPLE UNITS. SCRIBE TO WALL AND OTHER SURFACES AS REQUIRED. ADJUST ALL DRAWERS, DOORS AND MOVABLE PARTS TO OPERATE EASILY AND SMOOTHLY WITHOUT BINDING.
- ALL DRAWERS TO BE FULL EXTENSION SIDES WITH A 75 LBS. LOAD CAPACITY.
- MILLWORK CONTRACTOR IS TO PROVIDE SHOP DRAWINGS FOR REVIEW AND APPROVAL PRIOR TO FABRICATION.
- THE GENERAL CONTRACTOR AND MILLWORK CONTRACTOR ARE TO COORDINATE AND INSTALL ALL REQUIRED BLOCKING, ANGLE BRACES, SUPPORTS, ETC., TO SUFFICIENTLY SUPPORT ALL COUNTERS.
- FINISHES
 - COUNTERTOP FINISHES TO BE PER FINISH SCHEDULE AND / OR SHOP DRAWINGS
 - CABINET FACES TO BE PER FINISH SCHEDULE AND / OR SHOP DRAWINGS
- HARDWARES TO BE AS CALLED OUT PER PLANS AND SCHEDULES. (TYPICAL)

ELECTRICAL - IN ACCORDANCE TO DETAIL 12 / T1.3

- BOTTOM OF ELECTRICAL OUTLET J-BOXES SHALL BE INSTALLED NOT LESS THAN 15" ABOVE THE FINISHED FLOOR OR WORKING PLATFORM.
- THE TOP OF THE J-BOX OF CONTROLS OR SWITCHES INTENDED TO BE USED BY THE OCCUPANT OF THE ROOM OR AREA TO CONTROL LIGHTING AND RECEPTACLE OUTLETS, APPLIANCES, OR COOLING, HEATING, AND VENTILATING EQUIPMENT SHALL NOT BE MORE THAN 48" ABOVE THE FINISHED FLOOR OR WORKING PLATFORM.
- THE TOP OF FIRE ALARM INITIATING DEVICES (BOXES) SHALL BE LOCATED 48" ABOVE THE LEVEL OF THE FINISHED FLOOR, WORKING PLATFORM, GROUND SURFACE OR SIDEWALK.
- THE INSTALLATION OF FIRE ALARM EQUIPMENT AND SYSTEMS IN ANY OCCUPANCY WITHIN THE SCOPE OF THESE REGULATIONS SHALL BE IN ACCORDANCE WITH THE PROVISIONS OF THE LOCAL, STATE & FEDERAL CODES AND REGULATIONS.
- (WHERE APPLIES) GENERAL CONTRACTOR TO SUPPLY (N) PANEL SCHEDULES FOR ALL ELECTRICAL PANELS PRIOR TO COMPLETION OF THE REMODEL.

HAZARDS AND PROTRUDING OBJECTS - IN ACCORDANCE TO DETAIL 8 / T1.3

- OBJECTS PROJECTING FROM WALLS WITH THEIR LEADING EDGES ABOVE 27" AND BELOW 80" ABOVE THE FINISHED FLOOR SHALL PROTRUDE NO MORE THAN 4" INTO WALKS, HALLS, CORRIDORS, PASSAGEWAYS, OR AISLES.
- OBJECTS MOUNTED WITH THEIR LEADING EDGES AT OR BELOW 27" ABOVE THE FINISHED FLOOR MAY PROTRUDE ANY AMOUNT INTO WALKS, HALLS, CORRIDORS, PASSAGE WAYS OR AISLES. ANY OBSTRUCTION THAT OVERHANGS A PEDESTRIAN WAY SHALL BE A MINIMUM OF 80" ABOVE THE WALKING SURFACE AS MEASURED FROM THE BOTTOM OF THE OBSTRUCTION.
- FREESTANDING OBJECTS MOUNTED ON POSTS OR PVLONS MAY OVERHANG 12" MAXIMUM FROM 27" TO 80" ABOVE THE GROUND OR FINISHED FLOOR.
- PROTRUDING OBJECTS SHALL NOT REDUCE THE CLEAR WIDTH OF AN ACCESSIBLE ROUTE OR MANEUVERING SPACE.
- WALKS, HALLS, CORRIDORS, PASSAGEWAYS, AISLES OR OTHER CIRCULATION SPACES SHALL HAVE 80" (INCHES) MINIMUM CLEAR HEAD ROOM.
- CONTRACTOR TO CONTACT ARCHITECT IF ROOF PENETRATIONS ARE DEEMED NECESSARY. ANY ROOF PENETRATIONS MUST BE COMPLETED BY LANDLORD APPROVED ROOFING CONTRACTOR.

SIGNAGE

- THE SIGNAGE AT THE STOREFRONT WILL BE CONTRACTED DIRECTLY BY THE GENERAL CONTRACTOR. THE G.C. MUST PROVIDE ANY AND ALL REQUIRED J-BOXES AS WELL AS ACCESS PANELS TO ALL SIGNAGE AS NECESSARY. THE GENERAL CONTRACTOR IS RESPONSIBLE FOR ALL COORDINATION WITH HIS SIGN CONTRACTOR AND MAKING SURE THE JOB IS DONE ON TIME. FULLY DETAILED SHOP DRAWINGS MUST BE SUBMITTED TO THE ARCHITECT FOR REVIEW. THESE ARCHITECTURAL PLANS ONLY SHOW LIMITED DESIGN DETAILS AND ARE NOT ADEQUATE FOR CONSTRUCTION OF THE SIGN. SEE SIGN SHOP DRAWINGS. SIGN DRAWINGS WILL BE PREPARED BY OTHERS AND ARE UNDER SEPARATE PERMIT.
- BARRIER LAWS FOR THE PHYSICALLY HANDICAPPED ARE MINIMUM GUIDELINES. SHOULD THERE BE A CONFLICT BETWEEN THESE MINIMUM REQUIREMENTS AND WHAT IS CALLED FOR ON THE DRAWINGS, THE CONTRACTOR IS TO INFORM THE ARCHITECT FOR WRITTEN AND/OR GRAPHIC CLARIFICATION PRIOR TO PROCEEDING WITH WORK SO AFFECTED.

FIRE SPRINKLER SYSTEM (WHERE APPLIES)

IT IS THE GENERAL CONTRACTOR'S RESPONSIBILITY TO VERIFY IF THE EXISTING FIRE SPRINKLER SYSTEM NEEDS TO BE MODIFIED IN ORDER TO ACCOMMODATE THE RENOVATION SPACE. THIS INCLUDES ALL AFFECTED AREAS TO INCLUDE MAIN LOBBY AND ADJACENT ROOMS. IF REQUIRED, THE CONTRACTOR MUST SUBMIT FIRE SPRINKLER SHOP DRAWINGS AND OBTAIN A FIRE SPRINKLER PERMIT FROM THE LOCAL FIRE DEPARTMENT AND / OR BUILDING DEPARTMENT. ALL COSTS AND FEES SHOULD BE INCLUDED IN THE CONTRACTOR'S BID PROPOSAL TO THE OWNER. AT THE COMPLETION OF THE PROJECT, THE CONTRACTOR SHALL BE RESPONSIBLE TO OBTAIN AN INSPECTION FOR APPROVAL AND SIGN-OFF FOR THE MODIFIED FIRE SPRINKLER SYSTEM BY THE FIRE DEPARTMENT AND BUILDING INSPECTOR.

PLUMBING (WHERE APPLIES)

GENERAL CONTRACTOR TO PERFORM A LINE JETTING OF ALL PLUMBING LINES AFTER NEW WORK IS COMPLETE. GENERAL CONTRACTOR MUST SUPPLY CERTIFICATE OF INVOICE WITH CLOSE OUT PACKAGE.

1. CODES

ALL WORK SHALL CONFORM TO ALL APPLICABLE FEDERAL, STATE AND LOCAL CODES AND ORDINANCES. NOTHING SHOWN IN THESE DRAWINGS SHALL BE CONSTRUED AS PERMISSION TO VIOLATE ANY GOVERNING CODES.

2. PERMITS

- THE GENERAL CONTRACTOR (G.C.) WILL PAY FOR ALL APPLICABLE BUILDING AND SIGNAGE PERMIT AND ANY LOCAL JURISDICTIONAL FEES OR ASSESSMENTS AS APPLICABLE. HOWEVER, THE GENERAL CONTRACTOR SHALL INCORPORATE ALL MECHANICAL, ELECTRICAL, PLUMBING (M.E.P.) AND CIVIL PERMITS AS NECESSARY IN HIS / HER BID PROPOSAL TO THE OWNER. THE M.E.P. AND CIVIL PERMITS WILL NOT BE PAID BY THE ARCHITECT. THE G.C. WILL PHYSICALLY PULL THE BUILDING PERMIT AND THE SIGNAGE PERMIT. THE G.C. MUST COORDINATE WITH HIS / HER SUBCONTRACTORS TO ENSURE THEIR APPLICABLE PERMITS ARE PULLED. THE G.C. AND ALL SUBCONTRACTORS PERFORMING WORK ON SITE MUST OBTAIN THEIR MUNICIPALITY BUSINESS LICENSES AT THEIR EXPENSE PRIOR TO START OF CONSTRUCTION. NOT HAVING ALL SUBCONTRACTOR BUSINESS LICENSES PAID FOR AT THE MUNICIPALITY MAY PREVENT THE PROJECT FROM FINAL LOCAL JURISDICTION APPROVAL AND SIGN-OFF.
- THERE MAY BE INSTANCES WHERE THERE ARE OUTSTANDING PLAN CHECK FEES THAT HAVE NOT BEEN PAID. THE G.C. WILL COORDINATE WITH THE APPROPRIATE MUNICIPALITY PLANNING AND / OR BUILDING DEPARTMENT AND DETERMINE ANY OUTSTANDING FEES. THE G.C. WILL NOTIFY THE ARCHITECT AND RECEIVE APPROVAL PRIOR TO PAYING THESE OUTSTANDING FEES. THIS WILL ALLOW THE G.C. TO NOT BE DELAYED IN PULLING THE BUILDING PERMIT.
- THE GENERAL CONTRACTOR WILL BE RESPONSIBLE TO HIRE HIS / HER OWN SIGNAGE SUBCONTRACTOR FOR THE PROJECT.

3. CONSTRUCTION DOCUMENTS

- THE INTENTION OF THESE DOCUMENTS IS TO INCLUDE ALL LABOR, MATERIALS, SERVICES, EQUIPMENT AND TRANSPORTATION NECESSARY FOR THE COMPLETE AND PROPER EXECUTION OF THE WORK INDICATED ON THE DRAWINGS OR REASONABLY INFERRED THESE FROM. THE ARCHITECT WILL IN NO WAY BE RESPONSIBLE FOR HOW THE FIELD WORK IS PERFORMED, SAFETY IN, OR ABOUT, THE JOB SITE METHODS OF PERFORMANCE OR TIMELINES IN THE PERFORMANCE OF THE WORK. IF DISCREPANCIES EXIST BETWEEN PLANS OF DIFFERENT SCOPES, THE LARGER SCOPE PLAN TYPICALLY WILL GOVERN. NOTIFY ARCHITECT FOR A WRITTEN OR GRAPHIC CLARIFICATION OF SUCH DISCREPANCIES BEFORE PROCEEDING WITH THE WORK.
 - ALL ARCHITECT CLARIFICATIONS WILL BE WRITTEN AND / OR GRAPHIC VIA ARCHITECTURAL SUPPLEMENTAL INSTRUCTIONS, CHANGE ORDERS OR CONSTRUCTION DIRECTIVES.
- 4. BIDS**
- ALL BIDDERS PRIOR TO SUBMITTAL OF BIDS SHALL THOROUGHLY FAMILIARIZE THEMSELVES WITH THE ARCHITECT'S PLANS & EXISTING CONDITIONS AND SHALL NOTIFY THE ARCHITECT OF ANY DISCREPANCY OR OMISSIONS OF ANY INFORMATION NECESSARY FOR COMPLETION OF THEIR SCOPE OF WORK.
 - ALL TRADES SHALL FURNISH ALL LABOR, EQUIPMENT, MATERIALS AND SERVICES REQUIRED TO PERFORM ALL WORK NECESSARY, INDICATED OR REASONABLY INFERRED OR REQUIRED BY ANY APPLICABLE CODE TO COMPLETE THEIR SCOPE OF WORK FOR A COMPLETE AND PROPERLY FINISHED JOB.
 - CONTRACTORS PRIOR TO BIDDING SHALL GUARANTEE THAT ALL OTHER SUB-BIDDERS OR SUB CONTRACTORS SHALL BE GIVEN COMPLETE FULL SETS OF PLANS TO INSURE THAT THEY HAVE INCLUDED ALL ITEMS NECESSARY TO COMPLETE THEIR WORK. ANY ITEM MISSED BY THESE SUBCONTRACTORS IN THEIR BIDS SHALL BE ABSORBED BY THE GENERAL CONTRACTOR AT HIS OR HER OWN EXPENSE AND IN NO WAY WILL AFFECT ANY ADDITIONAL COST OVER AND ABOVE THE FINAL BID.
 - ALL TRADES SHALL PROVIDE BIDS ACCORDING TO THE PLANS AND SPECIFICATIONS. ANY ALTERNATE SHALL BE SUBMITTED TO THE OWNER (IN WRITING) FOR APPROVAL PRIOR TO ACCEPTANCE OF BID.

5. CONTRACTOR

- PRIOR TO COMMENCING, THE GENERAL CONTRACTOR AND ALL SUBCONTRACTORS SHALL REVIEW ALL DRAWINGS AND SPECIFICATIONS AND VERIFY CONDITIONS AT THE SITE. ANY DISCREPANCIES SHALL BE REPORTED TO THE ARCHITECT BEFORE PROCEEDING WITH THE WORK. CONTRACTOR SHALL VERIFY W/ THE PROPER UTILITY COMPANY OR OTHER AGENCY OR COMPANY THE LOCATIONS OF ALL EXISTING BELOW GRADE UTILITIES AND THEIR SERVICE CONNECTION PRIOR TO THE COMMENCEMENT OF WORK.
- NO CONTRACTOR OR SUB-CONTRACTOR IS TO START ANY WORK UNTIL A THOROUGH EXAMINATION OF ALL THE EXISTING CONDITIONS IS PERFORMED. IF FOR ANY REASON A SATISFACTORY JOB IS IMPOSSIBLE, IT SHALL BE IMMEDIATELY REPORTED TO THE PROJECT SUPERINTENDENT AND ARCHITECT FOR WRITTEN OR GRAPHIC CLARIFICATION BEFORE PROCEEDING WITH THE JOB.
- THE CONTRACTOR SHALL BE RESPONSIBLE FOR CONFIRMING AND CORRELATING ALL QUANTITIES AND DIMENSIONS, FOR SELECTING FABRICATION PROCESSES, FOR TECHNIQUES OF ASSEMBLY, FOR COORDINATION OF HIS WORK WITH THAT OF OTHER TRADES AND FOR PERFORMING ALL WORK IN A SAFE AND SATISFACTORY MANNER.
- CONTRACTOR TO VERIFY AND ENSURE AVAILABILITY AND TIMELY DELIVERY OF SPECIFIED OR SUBSTITUTED PRODUCTS PRIOR TO CONSTRUCTION. CONTRACTOR SHALL NOTIFY ARCHITECT OF POSSIBLE CHANGES TO CONSTRUCTION DOCUMENTS OR ANY CONSTRUCTION DELAY DUE TO NON AVAILABILITY OR LATE DELIVERY OF MATERIALS. CONTRACTOR (& NOT THE ARCHITECT) IS RESPONSIBLE FOR NON AVAILABILITY OR LATE DELIVERY OF PRODUCTS DURING CONSTRUCTION.
- ANY CONTRACTOR PRIOR TO INSTALLATION OR PROCUREMENT OF MATERIALS SHALL NOTIFY ARCHITECT OF PROBLEMS IF ANY. FAILURE TO DO SO SHALL MEAN THAT ALL NECESSARY CORRECTIVE MEASURE, DOCUMENTATION, ETC. SHALL BE DONE BY THAT CONTRACTOR AT HIS OWN EXPENSE AND TIME.
- THE CONTRACTOR SHALL BE RESPONSIBLE FOR THE ACCURACY OF THE BUILDING LINES AND LEVELS. THE CONTRACTOR SHALL COMPARE CAREFULLY THE LINES AND LEVELS SHOWN ON THE DRAWINGS WITH EXISTING LEVELS FOR THE CONSTRUCTION OF THE WORK AND SHALL BRING TO THE ARCHITECT'S ATTENTION OF ANY DISCREPANCIES BEFORE PROCEEDING WITH THE WORK.
- PROVIDE ALL NECESSARY BACKING AND FRAMING FOR ALL WALL MOUNTED ITEMS, LIGHT FIXTURES AND ALL OTHER ITEMS REQUIRED.

6. LIABILITIES

- THE DESIGN PROFESSIONAL (DP) SHALL CONSULT WITH THE CLIENT REGARDING THE PROBABLE SERVICES REQUIRED TO COMPLY WITH BUILDING CODES AND AMERICANS WITH DISABILITIES ACT (ADA). THE DP IS NOT AN ATTORNEY NOR SHOULD THE DPs RENDERING AN OPINION OF PROBABLE SERVICES REQUIREMENTS BE CONSIDERED EQUIVALENT TO A LEGAL INTERPRETATION OF ADA. THE DP'S OPINION WILL BE BASED SOLELY ON HIS / HER OWN EXPERIENCE AND KNOWLEDGE. THIS REQUIRES THE DP TO MAKE A CERTAIN NUMBER OF ASSUMPTIONS AS TO THE TYPES OF DISABILITIES COVERED BY ADA. THE DEGREE OF ACCESS THAT IS READILY ACHIEVABLE AND WHAT CONSTITUTES 'READILY ACCESSIBLE AND USABLE'. GIVEN THE ASSUMPTIONS WHICH MUST BE MADE THE DP CANNOT AND DOES NOT GUARANTEE THE ACCURACY OF HIS / HER OPINION AS TO FULL COMPLIANCE AND IN RECOGNITION OF THAT FACT, THE CLIENT WAIVES ANY CLAIM AGAINST THE DP RELATIVE TO THE ADEQUACY OF THE OPINION TO FULLY COMPLY WITH BUILDING CODES AND ADA REQUIREMENTS.
- THE ARCHITECT WHO SIGN THESE PLANS, SPECIFICATIONS AND OTHER INSTRUMENTS OF SERVICE SHALL NOT BE HELD RESPONSIBLE FOR DAMAGES RESULTING FROM CHANGES OR USES NOT AUTHORIZED OR APPROVED BY THE ARCHITECT. THE SIGNING OF THESE DOCUMENTS WILL NOT IMPOSE A LEGAL DUTY OR RESPONSIBILITY TO OBSERVE THE CONSTRUCTION AND / OR INSTALLATION OF THE FIXED WORKS SUBJECT TO THESE DOCUMENTS.
- ALL BRACING NECESSARY FOR CONSTRUCTION PURPOSES SHALL BE THE SOLE RESPONSIBILITY OF THE CONTRACTOR.
- THE DESIGN ADEQUACY AND SAFETY OF THE ERECTION BRACING, SHORING, TEMPORARY SUPPORTS, ETC. SHALL BE THE SOLE RESPONSIBILITY OF THE CONTRACTOR. THE CONTRACTOR SHALL BE RESPONSIBLE FOR THE STABILITY OF THE STRUCTURE PRIOR TO THE APPLICATION OF ALL SHEAR WALLS, ROOF AND FLOOR DIAPHRAGMS AND FINISH MATERIALS. THE CONTRACTOR SHALL PROVIDE THE NECESSARY BRACING TO MAINTAIN STABILITY TO FULL COMPLIANCE AND IN RECOGNITION OF THAT FACT, THE CLIENT WAIVES ANY CLAIM AGAINST THE DP RELATIVE TO THE APPLICATION OF THE AFOREMENTIONED MATERIALS. OBSERVATION VISITS TO THE SITE BY THE ARCHITECT SHALL NOT INCLUDE INSPECTION OF THE ABOVE ITEMS.

7. INTENTION

UNLESS NOTED OTHERWISE, THE INTENTION OF THE DOCUMENTS IS TO INCLUDE ALL LABOR, MATERIALS AND EQUIPMENT & TRANSPORTATION NECESSARY FOR COMPLETE AND PROPER EXECUTION OF THE WORK.

8. SUBSTITUTION

NO SUBSTITUTION SHALL BE MADE WITHOUT THE ARCHITECT'S APPROVAL.

9. CHANGES

THE OWNER OR ARCHITECT MAY ORDER EXTRA WORK OR MAKE CHANGES BY ALTERING, ADDING TO, OR DEDUCTING FROM THE WORK. THE CONTRACT SUM BEING ADJUSTED ACCORDINGLY.

10. SCOPE

ALL TRADES SHALL FURNISH ALL LABOR, EQUIPMENT, MATERIALS AND PERFORM ALL WORK NECESSARY, REASONABLY INFERRED OR REQUIRED BY ANY CODE OR REGULATION ADOPTED BY LOCAL JURISDICTION, TO COMPLETE THEIR SCOPE OF WORK FOR A COMPLETE AND PROPERLY FINISHED JOB.

11. CUTTING AND PATCHING

ALL TRADES SHALL DO THEIR OWN CUTTING, FITTING, PATCHING, ETC. TO MAKE THE SEVERAL PARTS COME TOGETHER PROPERLY AND FIT IT TO RECEIVE OR BE RECEIVED BY WORK OF OTHER TRADES.

12. CLEANING


THE CONTRACTOR SHALL CLEAN-UP, REMOVE AND RECYCLE IN A LEGAL MANNER AND NOT DISPOSE IN LANDFILL, ALL DEBRIS AND WASTE ATTRIBUTED TO THE JOB.

13. (AS-BUILT) DRAWINGS

GENERAL CONTRACTOR TO KEEP AN ACCURATE RECORD OF CHANGES IN FIELD AND SUBMIT A COMPLETE SET OF AS-BUILT DRAWINGS TO THE ARCHITECT FOR HIS / HER REVIEW AND TO THE OWNER. FOREMAN TO HAVE AN ACCURATE FLOOR PLAN AND PROJECT SCHEDULE ON-SITE AT ALL TIMES.

RESPONSIBILITY MATRIX

DESCRIPTION	NOT RECD	EXISTING	FRCHS	FB	G.C.	NOTE:	PB PACK	PURE BARRE PACKAGE
			FRCHS	FB	G.C.		FRCHS	FRANCHISEE
			INSTALL	INSTALL	INSTALL		SPS	SPORT PRO SURFACING
REMARKS								
DIVISION 01 - GENERAL REQUIREMENTS								
1. BUILDING PERMITS			●		●			PERMITS & FEES PAID BY G.C.
2. THIRD PARTY INSPECTION								ANY 3RD PARTY INSPECTION REQUIRED BY CITY
A. TEST AND BALANCE								
3. TEMPORARY UTILITIES								
4. FINAL CLEAN UP								
5. INSURANCE								
6. PROTECTION OF ALL FINISHED SURFACES								BOTH OWNER AND GENERAL CONTRACTOR
7. TEMPORARY LABOR								
8. DUMPSTER								
9. STORAGE CONTAINER								G.C. TO COORDINATE AND PROVIDE STORAGE CONTAINER FOR OWNER FURNISHED ITEMS DURING LAST 2 WEEKS OF CONSTRUCTION
DIVISION 03 - CONCRETE								
DIVISION 04 - MASONRY								
DIVISION 05 - METALS								
1. BALLET BAR			●		●			
2. "L" BRACKET (REFORM)			●					
DIVISION 06 - WOOD & PLASTICS								
1. WOOD FRAMING - STUDS, BACKING								G.C. IS RESPONSIBLE FOR RECEIVING, STORING, PROTECTING ALL MILLWORK ON SITE. SEE MILLWORK SHIT. FOR SPECIFIC SIZES & DETAILS.
3. WOOD CARPENTRY - CASEWORK, MILLWORK								
A. RECEPTION DESK								G.C. TO SET IN PLACE
B. CUBBIES								G.C. TO SET IN PLACE
C. BENCH								G.C. TO SET IN PLACE
D. 2 WAY OR 4 WAY DISPLAY								G.C. TO SET IN PLACE
E. WEIGHT CABINET								G.C. TO SET IN PLACE
E. SLAT WALL								G.C. TO SET IN PLACE
DIVISION 07 - THERMAL AND MOISTURE								
1. ROOFING PENETRATIONS								
2. INSULATION (INTERIOR WALLS)								
3. INSULATION (ROOF DECK)								
DIVISION 08 - OPENINGS								
1. INTERIOR DOORS & FRAMES								
2. HOLLOW METAL FRAMES								
3. DOOR HARDWARE								
4. ENTRANCES AND STOREFRONT (IF REQ'D)								
5. MIRRORS								
6. REAR SERVICE DOOR								G.C. TO BRING REAR DOOR TO PROPER WORKING
DIVISION 09 - FINISHES								
1. SYNTHETIC FLOORING			●		●			MUST BE ORDERED THROUGH S.P.S. VENDOR
2. TILE FLOORING			●		●			MUST BE ORDERED THROUGH S.P.S. VENDOR
3. VINYL FLOORING			●		●			

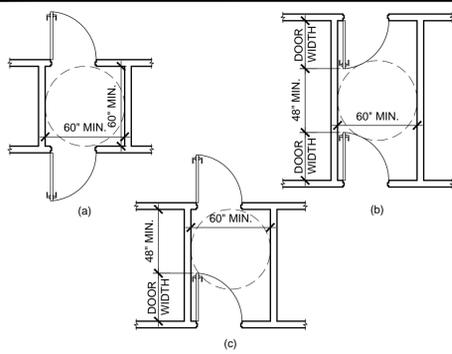

NOTE: THE DISTANCE BETWEEN TWO HINGED OR PIVOTED DOORS IN SERIES AND GATES IN SERIES SHALL BE 48" MINIMUM U.N.O. PLUS WIDTH OF DOORS OR GATES SWINGING INTO THE SPACE

ACCESSIBLE DOORS IN A SERIES

SCALE	17
N.T.S.	

SIGNS

- WHERE BOTH VISUAL AND TACTILE CHARACTERS ARE REQUIRED AT SIGNS, EITHER ONE SIGN WITH BOTH VISUAL AND TACTILE CHARACTERS, OR TWO SEPARATE SIGNS, ONE WITH VISUAL, AND ONE WITH TACTILE CHARACTERS, SHALL BE PROVIDED.
- RAISED CHARACTERS SHALL BE DUPLICATED IN BRAILLE. RAISED CHARACTERS SHALL BE 1/32 INCH (0.8 MM) MINIMUM ABOVE THEIR BACKGROUND. CHARACTERS SHALL BE UPPERCASE CHARACTERS SHALL BE SANS SERIF. CHARACTERS SHALL NOT BE ITALIC, OBLIQUE, SCRIPT, HIGHLY DECORATIVE, OR OF OTHER UNUSUAL FORMS. CHARACTERS SHALL BE SELECTED FROM FONTS WHERE THE WIDTH OF THE UPPERCASE LETTER "O" IS 55 PERCENT MINIMUM AND 110 PERCENT MAXIMUM OF THE HEIGHT OF THE UPPERCASE LETTER "I". CHARACTER HEIGHT MEASURED VERTICALLY FROM THE BASELINE OF THE CHARACTER SHALL BE 5/8 INCH (16 MM) MINIMUM, AND 2 INCH MAXIMUM. THE STROKE WIDTH SHALL BE 15 PERCENT MAXIMUM OF THE HEIGHT OF THE UPPERCASE LETTER "I" MEASURED AT THE TOP SURFACE OF THE CHARACTER, AND 30 PERCENT MAXIMUM OF THE HEIGHT OF THE UPPERCASE LETTER "I" MEASURED AT THE BASE OF THE CHARACTER. CHARACTER SPACING SHALL BE MEASURED BETWEEN THE TWO CLOSEST POINTS OF ADJACENT RAISED CHARACTERS WITHIN A MESSAGE, EXCLUDING WORD SPACES. SPACING BETWEEN INDIVIDUAL RAISED CHARACTERS SHALL BE 1/8 INCH (3.2 MM) MINIMUM MEASURED AT THE TOP SURFACE OF THE CHARACTERS, 1/16 INCH MINIMUM MEASURED AT THE BASE OF THE CHARACTERS AND 4 TIMES THE RAISED CHARACTER STROKE WIDTH MAXIMUM. CHARACTERS SHALL BE SEPARATED FROM RAISED BORDERS AND DECORATIVE ELEMENTS 3/8 INCH (9.5 MM) MINIMUM. SPACING BETWEEN THE BASELINES OF SEPARATE LINES OF RAISED CHARACTERS WITHIN A MESSAGE SHALL BE 135 PERCENT MINIMUM AND 170 PERCENT MAXIMUM OF THE RAISED CHARACTER HEIGHT.

TABLE 703.4.3 BRAILLE DIMENSIONS

MEASUREMENT RANGE	MINIMUM IN INCHES	MAXIMUM IN INCHES
DOT BASE DIAMETER	0.059	0.063
DISTANCE BETWEEN TWO DOTS IN THE SAME CELL	0.090	0.100
DISTANCE BETWEEN CORRESPONDING DOTS IN ADJACENT CELLS ¹	0.241	0.300
DOT HEIGHT	0.025	0.037
DISTANCE BETWEEN CORRESPONDING DOTS FROM ONE CELL DIRECTLY BELOW ¹	0.395	0.400

1. MEASURED CENTER TO CENTER

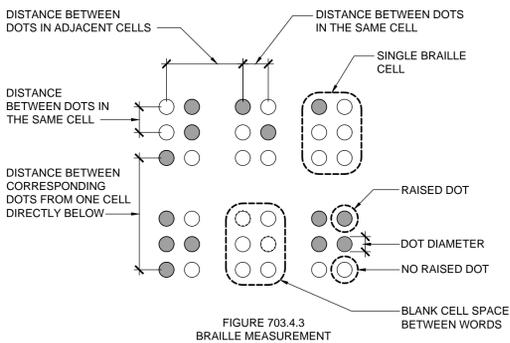


FIGURE 703.4.3 BRAILLE MEASUREMENT

- BRAILLE SHALL BE CONTRACTED (GRADE 2)
- BRAILLE DOTS SHALL HAVE A DOMED OR ROUNDED SHAPE AND SHALL COMPLY WITH TABLE 703.4.1. THE INDICATION OF AN UPPERCASE LETTER OR LETTERS SHALL ONLY BE USED BEFORE THE FIRST WORD OF SENTENCES, PROPER NOUNS AND NAMES, INDIVIDUAL LETTERS OF THE ALPHABET, INITIALS, AND ACRONYMS
- BRAILLE SHALL BE POSITIONED BELOW THE CORRESPONDING TEXT. IF TEXT IS MULTI-LINED, BRAILLE SHALL BE PLACED BELOW THE ENTIRE TEXT. BRAILLE SHALL BE SEPARATED 3/8 INCH (9.5 MM) MINIMUM FROM ANY OTHER TACTILE CHARACTERS AND 3/8 INCH (9.5 MM) MINIMUM FROM RAISED BORDERS AND DECORATIVE ELEMENTS.

SIGNS / BRAILLE

SCALE	20
N.T.S.	

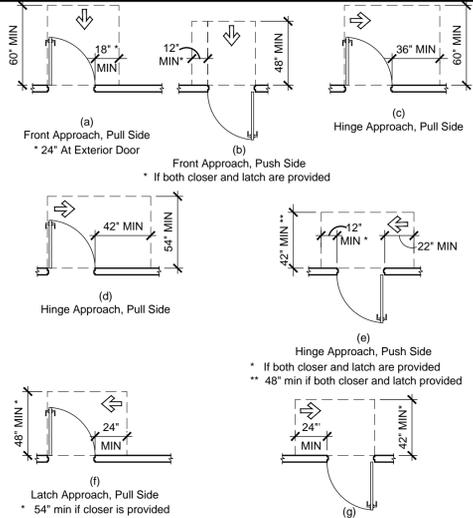


FIGURE 404.2.3.1 MANEUVERING CLEARANCE AT MANUAL SWINGING DOORS

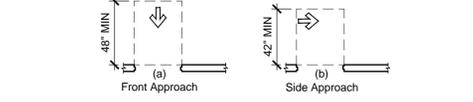


FIGURE 404.2.3.3 MANEUVERING CLEARANCE AT DOORWAYS WITHOUT DOORS

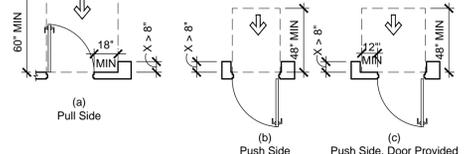


FIGURE 404.2.3.4 MANEUVERING CLEARANCE AT RECESSED DOORS

TYPE OF USE	MINIMUM MANEUVERING CLEARANCE		
APPROACH DIRECTION	DOOR OR GATE	PERPENDICULAR TO DOORWAY	PARALLEL TO DOORWAY (beyond latch side unless noted)
FRONT	PULL	60 INCHES	18 INCHES
FRONT	PUSH	48 INCHES	0 INCHES ³
HINGE	PULL	60 INCHES	36 INCHES
HINGE	PULL	54 INCHES	42 INCHES
HINGE	PUSH	42 INCHES ¹	22 INCHES ^{3,4}
LATCH	PULL	48 INCHES ²	24 INCHES
LATCH	PUSH	42 INCHES ²	24 INCHES

- ADD 6" IF CLOSER AND LATCH ARE PROVIDED.
- ADD 6" IF CLOSER IS PROVIDED.
- ADD 12" BEYOND LATCH IF CLOSER AND LATCH ARE PROVIDED.
- BEYOND HINGE SIDE

TABLE 404.2.3.1 MANEUVERING CLEARANCE AT MANUAL SWINGING DOORS

- NOTES:
- DOOR HARDWARE: HANDLES, PULLS, LATCHES, LOCKS AND OTHER OPERABLE PARTS ON DOORS SHALL BE 34 INCHES MINIMUM AND 48 INCHES MAXIMUM ABOVE THE FINISH FLOOR OR GROUND
 - DOORWAYS SHALL HAVE A CLEAR OPENING WIDTH OF 32 INCHES MINIMUM

ACCESSIBLE DOOR CLEARANCES

SCALE	15
N.T.S.	

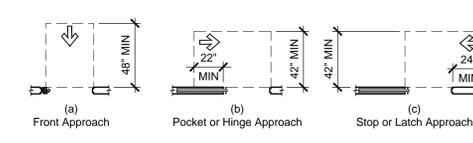


FIGURE 404.2.3.3 MANEUVERING CLEARANCE AT SLIDING AND FOLDING DOORS

MANEUVERING CLEARANCE AT DOORWAYS WITHOUT DOORS

APPROACH DIRECTION	PERPENDICULAR TO DOORWAY	PARALLEL TO DOORWAY (beyond stop or latch side unless noted)
FROM FRONT	48 INCHES	0 INCHES
FROM NON-LATCH SIDE	42 INCHES	22 INCHES ¹
FROM LATCH SIDE	42 INCHES	24 INCHES

- BEYOND POCKET / HINGE SIDE.

ACCESSIBLE DOOR CLEARANCES

SCALE	16
N.T.S.	

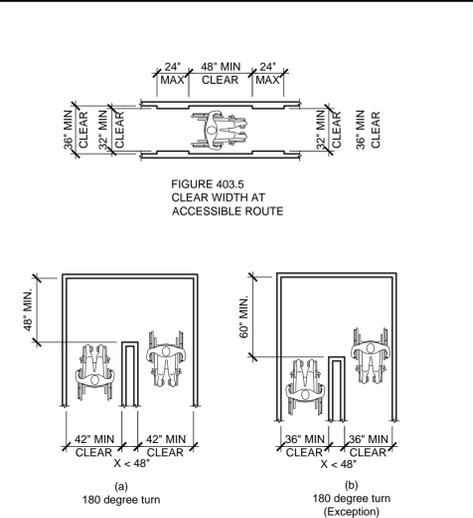


FIGURE 403.5 CLEAR WIDTH AT ACCESSIBLE ROUTE

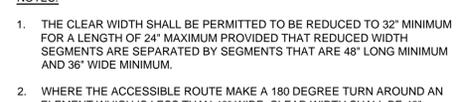


FIGURE 403.5.1 CLEAR WIDTH AT TURN

- NOTES:
- THE CLEAR WIDTH SHALL BE PERMITTED TO BE REDUCED TO 32" MINIMUM FOR A LENGTH OF 24" MAXIMUM PROVIDED THAT REDUCED WIDTH SEGMENTS ARE SEPARATED BY SEGMENTS THAT ARE 48" LONG MINIMUM AND 36" WIDE MINIMUM.
 - WHERE THE ACCESSIBLE ROUTE MAKE A 180 DEGREE TURN AROUND AN ELEMENT WHICH IS LESS THAN 48" WIDE, CLEAR WIDTH SHALL BE 42" MINIMUM APPROACHING THE TURN, 48" MINIMUM AT THE TURN AND 42" MINIMUM LEAVING THE TURN.
 - WHERE THE CLEAR WIDTH AT THE TURN IS 60" MINIMUM COMPLIANCE WITH NOTE 2 SHALL NOT BE REQUIRED.
 - AN ACCESSIBLE ROUTE WITH A CLEAR WIDTH LESS THAN 60" SHALL PROVIDE PASSING SPACES AT INTERVALS OF 200' MAXIMUM. PASSING SPACES SHALL BE EITHER: 60" MINIMUM BY 60" MINIMUM; OR, AN INTERSECTION OF TWO WALKING SURFACES PROVIDING A T-SHAPED SPACE COMPLYING WITH FIGURE 304.3.2 WHERE THE BASE AND ARMS OF THE T-SHAPED SPACE EXTEND 48" MINIMUM BEYOND INTERSECTION.

CLEAR WIDTHS

SCALE	10
N.T.S.	

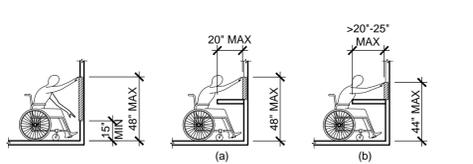


FIGURE 308.2.1 UNOBSTRUCTED FORWARD REACH

FIGURE 308.2.2 OBSTRUCTED HIGH FORWARD REACH

- NOTES:
- WHERE A FORWARD REACH IS UNOBSTRUCTED, THE HIGH FORWARD REACH SHALL BE 48" MAXIMUM AND THE LOW FORWARD REACH SHALL BE 15" MINIMUM ABOVE THE FINISH FLOOR OR GROUND.
 - WHERE A HIGH FORWARD REACH IS OVER AN OBSTRUCTION, THE CLEAR FLOOR SPACE SHALL EXTEND BENEATH THE ELEMENT FOR A DISTANCE NOT LESS THAN THE REQUIRED REACH DEPTH OVER THE OBSTRUCTION. THE HIGH FORWARD REACH SHALL BE 48" MAXIMUM WHERE THE REACH DEPTH IS 20" MAXIMUM. WHERE THE REACH DEPTH EXCEEDS 20", THE HIGH FORWARD REACH SHALL BE 44" MAXIMUM AND THE REACH DEPTH SHALL BE 25" MAXIMUM.

FORWARD REACH

SCALE	11
N.T.S.	

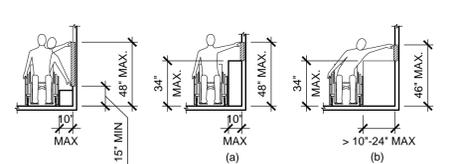


FIGURE 308.3.1 UNOBSTRUCTED SIDE REACH

FIGURE 308.3.2 OBSTRUCTED HIGH SIDE REACH

- NOTES:
- WHERE A CLEAR FLOOR SPACE COMPLYING WITH SECTION 305 ALLOWS A PARALLEL APPROACH TO AN ELEMENT AND THE EDGE OF THE CLEAR FLOOR SPACE IS 10 INCHES MAXIMUM FROM THE ELEMENT, THE HIGH SIDE REACH SHALL BE 48" MAXIMUM AND THE LOW SIDE REACH SHALL BE 15" MINIMUM.
 - WHERE A CLEAR FLOOR SPACE COMPLYING WITH SECTION 305 ALLOWS A PARALLEL APPROACH TO AN ELEMENT AND THE HIGH SIDE REACH IS OVER AN OBSTRUCTION, THE HEIGHT OF THE OBSTRUCTION SHALL BE 34" MAXIMUM ABOVE THE FLOOR AND THE DEPTH OF THE OBSTRUCTION SHALL BE 24" MAXIMUM. THE HIGH SIDE REACH SHALL BE 48" MAXIMUM ABOVE THE FLOOR FOR A REACH DEPTH OF 10" MAXIMUM. WHERE THE REACH DEPTH EXCEEDS 10", THE HIGH SIDE REACH SHALL BE 46" MAXIMUM ABOVE THE FLOOR FOR A REACH DEPTH OF 24" MAXIMUM.

SIDE REACH

SCALE	12
N.T.S.	

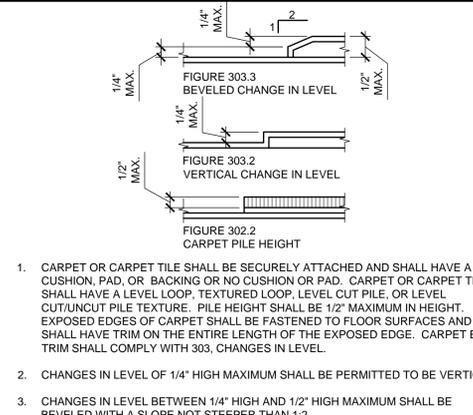


FIGURE 303.3 BEVELED CHANGE IN LEVEL

FIGURE 303.2 CARPET PILE HEIGHT

FLOOR/GROUND SURFACE

SCALE	5
N.T.S.	

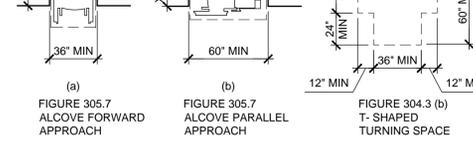


FIGURE 305.7 ALCOVE FORWARD APPROACH

FIGURE 305.7 ALCOVE PARALLEL APPROACH

FIGURE 304.3 (b) T-SHAPED TURNING SPACE

- NOTES:
- THE TURNING SPACE SHALL BE A T-SHAPED SPACE WITHIN A 60" SQUARE MINIMUM WITH ARMS AND BASE 36" WIDE MINIMUM. EACH ARM OF THE T SHALL BE CLEAR OF OBSTRUCTIONS 12" MINIMUM IN EACH DIRECTION AND THE BASE SHALL BE CLEAR OF OBSTRUCTIONS 24" MINIMUM. THE TURNING SPACE SHALL BE PERMITTED TO INCLUDE KNEE AND TOE CLEARANCE COMPLYING WITH SECTION 306 ONLY AT THE END OF EITHER THE BASE OR ONE ARM.
 - ALCOVES SHALL BE 36" WIDE MINIMUM WHERE THE DEPTH EXCEEDS 24".
 - ALCOVES SHALL BE 60" WIDE MINIMUM WHERE THE DEPTH EXCEEDS 15".

MANEUVERING

SCALE	6
N.T.S.	

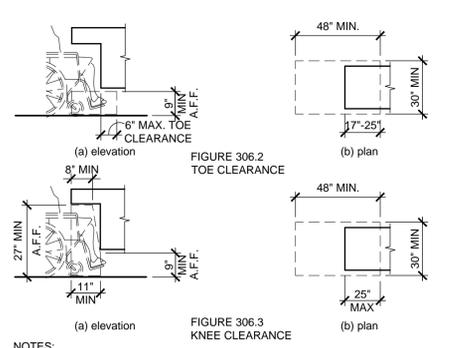


FIGURE 306.2 TOE CLEARANCE

FIGURE 306.3 KNEE CLEARANCE

- NOTES:
- SPACE UNDER AN ELEMENT BETWEEN THE FINISH FLOOR OR GROUND AND 9" ABOVE THE FINISH FLOOR OR GROUND SHALL BE CONSIDERED TOE CLEARANCE.
 - SPACE UNDER AN ELEMENT BETWEEN 9" AND 27" ABOVE FINISH FLOOR OR GROUND SHALL BE CONSIDERED KNEE CLEARANCE.

TOE & KNEE CLEARANCE

SCALE	7
N.T.S.	

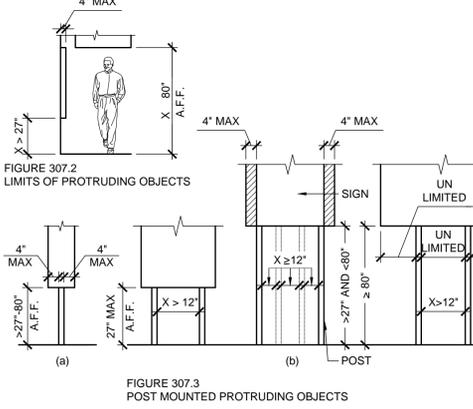


FIGURE 307.2 LIMITS OF PROTRUDING OBJECTS

FIGURE 307.3 POST MOUNTED PROTRUDING OBJECTS

PROTRUDING OBJECTS

SCALE	8
N.T.S.	

ACCESSIBILITY NOTES

- GROUND AND FLOOR SURFACES ALONG ACCESSIBLE ROUTES AND IN ACCESSIBLE ROOMS AND SPACES INCLUDING FLOORS, WALKS, RAMPS, STAIRS AND CURB RAMPS ARE STABLE, FIRM AND SLIP RESISTANT.
- GRATINGS LOCATED IN WALKING SURFACES HAVE GRID OPENINGS A MAXIMUM OF 1/2" WIDE IN ONE DIRECTIONS.
- WHEN GRATINGS HAVE ELONGATED OPENINGS, THEY SHALL BE PLACED SO THAT THE LONG DIMENSION IS PERPENDICULAR TO THE DOMINANT DIRECTION OF TRAVEL.
- ALL NEW CONSTRUCTION MUST COMPLY WITH DIMENSIONS AS DENOTED ON THESE CONSTRUCTION DOCUMENTS AND WITH THE ICC / ANSI A117.1, 2009 AND IBC 2015. DIMENSIONS WITHIN A SPECIFIED DIMENSIONAL "RANGE" MUST BE LESS THAN THE MAXIMUM DIMENSIONAL RANGE OR GREATER THAN THE MINIMUM DIMENSIONAL RANGE. IN OTHER WORDS, NEW CONSTRUCTION SHALL NOT BE EQUAL TO EITHER THE MAXIMUM OR MINIMUM DIMENSIONS, BUT SHALL BE LESS THAN THE MAXIMUM AND GREATER THAN THE MINIMUM. MAXIMUM SLOPES FOR NEW RAMPS SHALL BE 1 VERTICAL TO 13 HORIZONTAL MAXIMUM. DESIGN INTENT OF THE ARCHITECT IS TO PROVIDE REASONABLE DIMENSIONAL TOLERANCES, ENSURE COMPLIANCE WITH THE ADA, AND TO SIMPLIFY AND EXPEDITE THE CONSTRUCTION PROCESS. CONTRACTOR SHALL BE HELD FULLY RESPONSIBLE FOR NON-COMPLIANCE WITH THIS NOTICE. CONTRACTOR TO NOTIFY THE ARCHITECT PRIOR TO BIDDING OF ANY QUESTIONS OR CONCERNS RELATING TO THIS MATTER.
- INTERIOR DOOR CLOSERS SHALL BE ADJUSTED SO THAT FROM AN OPEN POSITION OF 90-DEGREES, THE TIME REQUIRED TO MOVE THE DOOR TO AN OPEN POSITION OF 12-DEGREES SHALL BE 5 SECONDS MINIMUM.
- INTERIOR DOOR SPRING HINGES SHALL BE ADJUSTED SO THAT FROM THE OPEN POSITION OF 70-DEGREES, THE DOOR SHALL MOVE TO THE CLOSED POSITION IN 1.5-SECONDS MINIMUM.
- DOOR OPENING FORCE, THE FORCE FOR PUSHING OR PULLING OPEN INTERIOR SWINGING EGRESS DOORS, OTHER THAN FIRE DOORS, SHALL NOT EXCEED 5 POUNDS (22 N). FOR REQUIRED FIRE DOORS, THE DOOR LATCH SHALL RELEASE WHEN SUBJECTED TO A 15-POUND (67 N) FORCE. THE DOOR SHALL BE SET IN MOTION WHEN SUBJECTED TO A 30-POUND (133 N) FORCE. THE DOOR SHALL SWING TO A FULL-OPEN POSITION WHEN SUBJECTED TO A 15-POUND (67 N) FORCE.
- TEST DOORS FOR DOOR OPENING FORCE AND CLOSING SPEED WITH AIR CONDITIONING AND OTHER FORMS OF MECHANICAL PRESSURIZATION TURNED ON AND ALSO WHEN TURNED OFF.
- POWER-OPERATED DOORS, WHERE MEANS OF EGRESS DOORS ARE OPERATED BY POWER, SUCH AS DOORS WITH A PHOTOELECTRIC-ACTUATED MECHANISM TO OPEN THE DOOR UPON THE APPROACH OF A PERSON, OR DOORS WITH POWER-ASSISTED MANUAL OPERATION, THE DESIGN SHALL BE SUCH THAT IN THE EVENT OF POWER FAILURE, THE DOOR IS CAPABLE OF BEING OPENED MANUALLY TO PERMIT MEANS OF EGRESS TRAVEL OR CLOSED WHERE NECESSARY TO SAFEGUARD MEANS OF EGRESS. THE FORCES REQUIRED TO OPEN THESE DOORS MANUALLY SHALL NOT EXCEED THOSE SPECIFIED IN SECTION 1008.1.3, 2015 IBC, EXCEPT THAT THE FORCE TO SET THE DOOR IN MOTION SHALL NOT EXCEED 50 POUNDS (220 N). THE DOOR SHALL BE CAPABLE OF SWINGING FROM ANY POSITION TO THE FULL WIDTH OF THE OPENING IN WHICH SUCH DOOR IS INSTALLED WHEN A FORCE IS APPLIED TO THE DOOR ON THE SIDE FROM WHICH EGRESS IS MADE. FULL-POWER-OPERATED DOORS SHALL COMPLY WITH BHMA A156.10. POWER-ASSISTED AND LOW-ENERGY DOORS SHALL COMPLY WITH BHMA A156.19.

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ADA STANDARDS
ACCESSIBLE DESIGN PLAN

PROJECT LOCATION
SHEET TITLE

STAMP
STATE OF MISSOURI
WILLIAM A. HILTON
REGISTERED ARCHITECT
NUMBER A-2012004034

DATE SIGNED: 2020-04-13
RENEWAL DATE: 2020-12-31
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DATE: 2020.04.10
PROJECT NUMBER: A2275

SHEET NUMBER

T1.3

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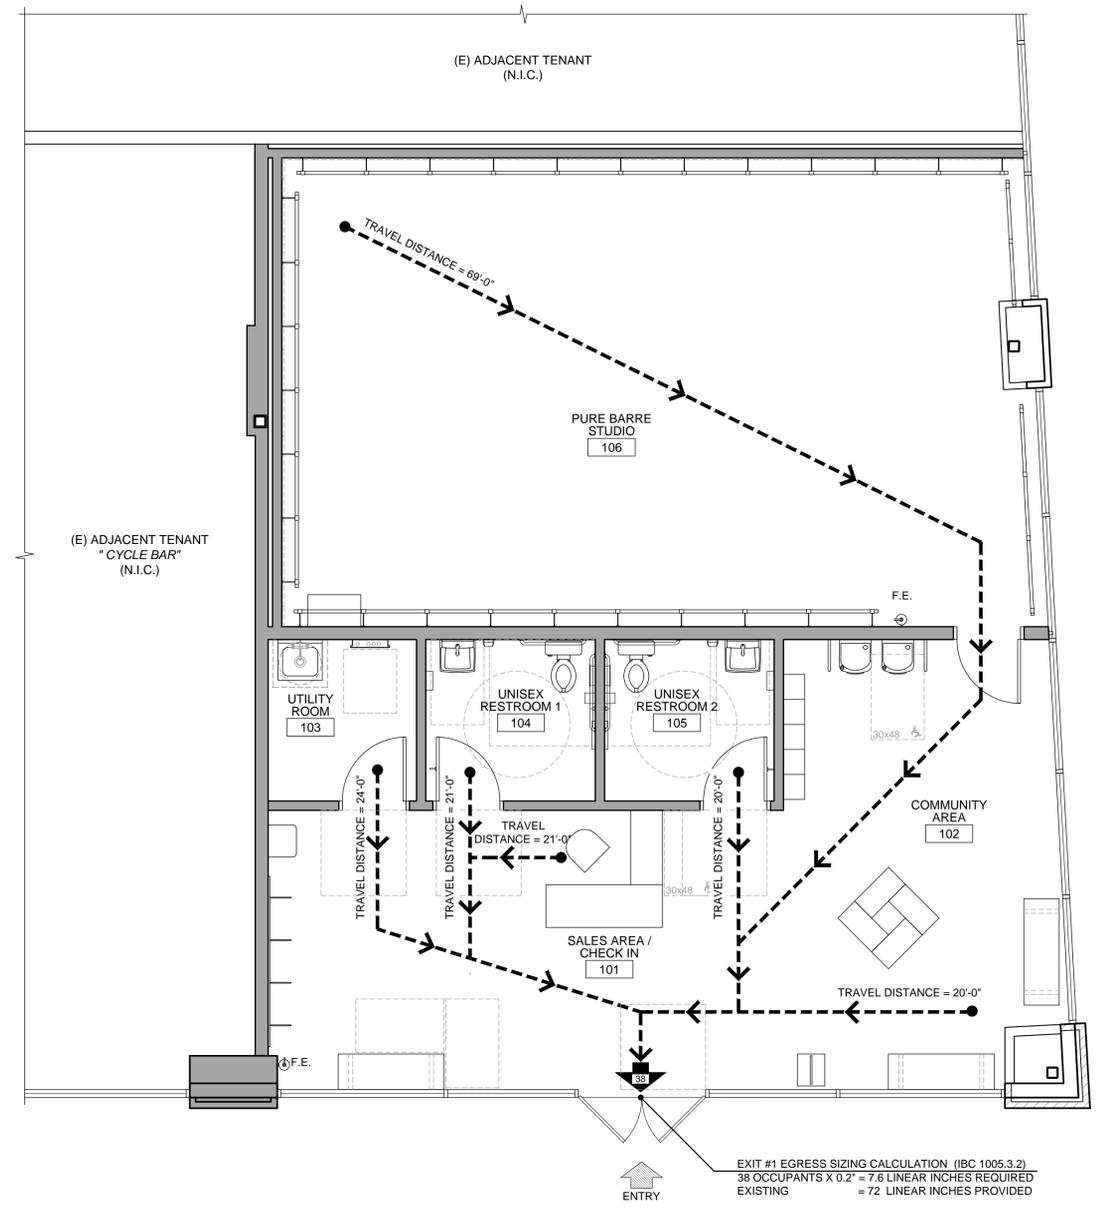
LEGEND

- ➔ NUMBER OF PEOPLE EXITING
- PER IBC 2018 & AMENDMENTS, SECTION AND TABLE 1006.2.1
MAXIMUM COMMON PATH OF EGRESS TRAVEL DISTANCE WITHOUT
SPRINKLER SYSTEM IS 75 FEET.
- SEE PLAN FOR TRAVEL DISTANCE ON EACH AREA
MAXIMUM EXIT ACCESS TRAVEL DISTANCE IS 200 FT WITH
SPRINKLER
- ANSUL FIRE EXTINGUISHER EXTINGUISHER WILL BE SERVICED
EVERY SIX (6) MONTHS.
- F.E. CLASS A FIRE EXTINGUISHER REQUIRED:
CLASS C FIRE EXTINGUISHERS FOR FIRE HAZARDS
- ORDINARY HAZARD OCCUPANCY.
- 2-A RATED SINGLE EXTINGUISHER - THE MAXIMUM TRAVEL
DISTANCE TO EXTINGUISHER IS 75 FEET PER IFC TABLE 906.3(1)

- TO BE MOUNTED AT 4'-0" HIGH FROM FINISH FLOOR TO HANDLE
OF FIRE EXTINGUISHER

OCCUPANT LOAD CALCULATION

ROOM NO.	ROOM NAME	AREA (SF)	FACTOR	OCCUPANT
101	SALES AREA / CHECK-IN	100 S.F.	15	7
102	COMMUNITY AREA	485 S.F.	100	5
103	UTILITY	53 S.F.	300	1
104	UNISEX RESTROOM 1	61 S.F.	-	-
105	UNISEX RESTROOM 2	61 S.F.	-	-
106	STUDIO @ 50 LOAD FACTOR = 17 OCCUPANTS	791 S.F.	-	-
ACTUAL NUMBER OF OCCUPANTS				25
NET AREA TOTAL:		1,551 S.F.		
GROSS LEASEABLE AREA TOTAL (INCLUDING WALLS):		1,687 S.F.		
TOTAL OCCUPANTS				38



EXIT #1 EGRESS SIZING CALCULATION (IBC 1005.3.2)
 38 OCCUPANTS X 0.2" = 7.6 LINEAR INCHES REQUIRED
 EXISTING = 72 LINEAR INCHES PROVIDED



LIFE SAFETY PLAN

SCALE 1/4" = 1'-0"
 8




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 LEE'S SUMMIT, MO 64086
 SHEET TITLE
LIFE SAFETY PLAN



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DATE: 2020.04.10
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SHEET NUMBER

T2.1

PERMIT SET : 2020_04_10

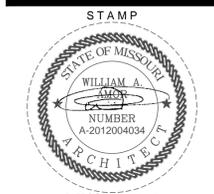GENERAL NOTES

1. GENERAL (E) SURFACE DRAINAGE PATTERN, INCLUDING (E) ROOF DRAINAGE LOAD TRANSFERRED TO GROUND LEVEL, IS TO REMAIN AS IS.
2. THIS IS A CONCEPTUAL SITE PLAN. UNLESS OTHERWISE NOTED, ALL ELEMENTS AND CONDITIONS ARE EXISTING.
3. VEHICULAR ACCESS DRIVES MUST BE PROVIDED AND MAINTAINED SERVICEABLE THROUGHOUT CONSTRUCTION.
4. CONTRACTOR SHALL ERECT AND MAINTAIN BARRICADES, WARNING SIGNS AND TRAFFIC CONES PER LOCAL REQUIREMENTS. ACCESS TO DRIVEWAYS TO BE MAINTAINED AT ALL TIMES. ALL TRAFFIC CONTROL MEASURES SHALL BE APPROVED AND IN PLACE PRIOR TO ANY CONSTRUCTION ACTIVITY.
5. ALL MATERIALS AND WORKMANSHIP FOR PUBLIC FACILITIES TO CONFORM TO CITY STANDARD CONSTRUCTION SPECIFICATIONS.
6. CONTRACTOR SHALL SWEEP ENTIRE SITE OR PORTIONS OF SITE TO BE USED BY THE PUBLIC AND SURROUNDING RIGHT-OF-WAY AREA OF THE STREET PRIOR TO USE BY THE GENERAL PUBLIC.
7. THE SITE SHALL BE KEPT FREE OF FIRE HAZARDS FROM THE START OF CONSTRUCTION TO FINAL INSPECTION.
8. THE G.C. SHALL IMPLEMENT A BEST MANAGEMENT PRACTICE STORMWATER FOR ALL ACTIVITIES PER LOCAL REQUIREMENTS.
9. THE G.C. IS RESPONSIBLE TO VERIFY ALL UNDERGROUND UTILITIES PRIOR TO PERFORMING EXTERIOR WORK. CALL 811 BEFORE DIGGING.
10. G.C. TO VERIFY ANY ABRUPT CHANGE IN LEVEL EXCEEDING 1/2' EXISTING CONCRETE SLAB/ASPHALT TRANSITION FROM ENTRY TO PUBLIC WAY ACCESS. G.C. TO PROVIDE CLEAR PATH OF TRAVEL, OR PER LOCAL ORDINANCES.
11. SITE & PARKING ARE EXISTING TO REMAIN UNCHANGED.
12. NEW AND EXISTING BUILDINGS SHALL HAVE APPROVED ADDRESS NUMBERS, BUILDING NUMBERS OR APPROVED BUILDING IDENTIFICATION PLACED IN A POSITION THAT IS PLAINLY LEGIBLE AND VISIBLE FROM THE STREET OR ROAD FRONTING THE PROPERTY, CONTRASTING WITH THEIR BACKGROUND, PER LOCAL ORDINANCES.
13. THE G.C. IS RESPONSIBLE TO FIELD VERIFY AND LOCATE ALL WET AND DRY UTILITIES CONNECTION POINTS PRIOR TO ANY DEMOLITION OR CONSTRUCTION. (I.E. GAS, WATER AND SEWER, CLEAN OUTS, ETC.
14. GENERAL CONTRACTOR SHALL REDUCE CONSTRUCTION WASTE AS REQUIRED BY LOCAL REQUIREMENT.

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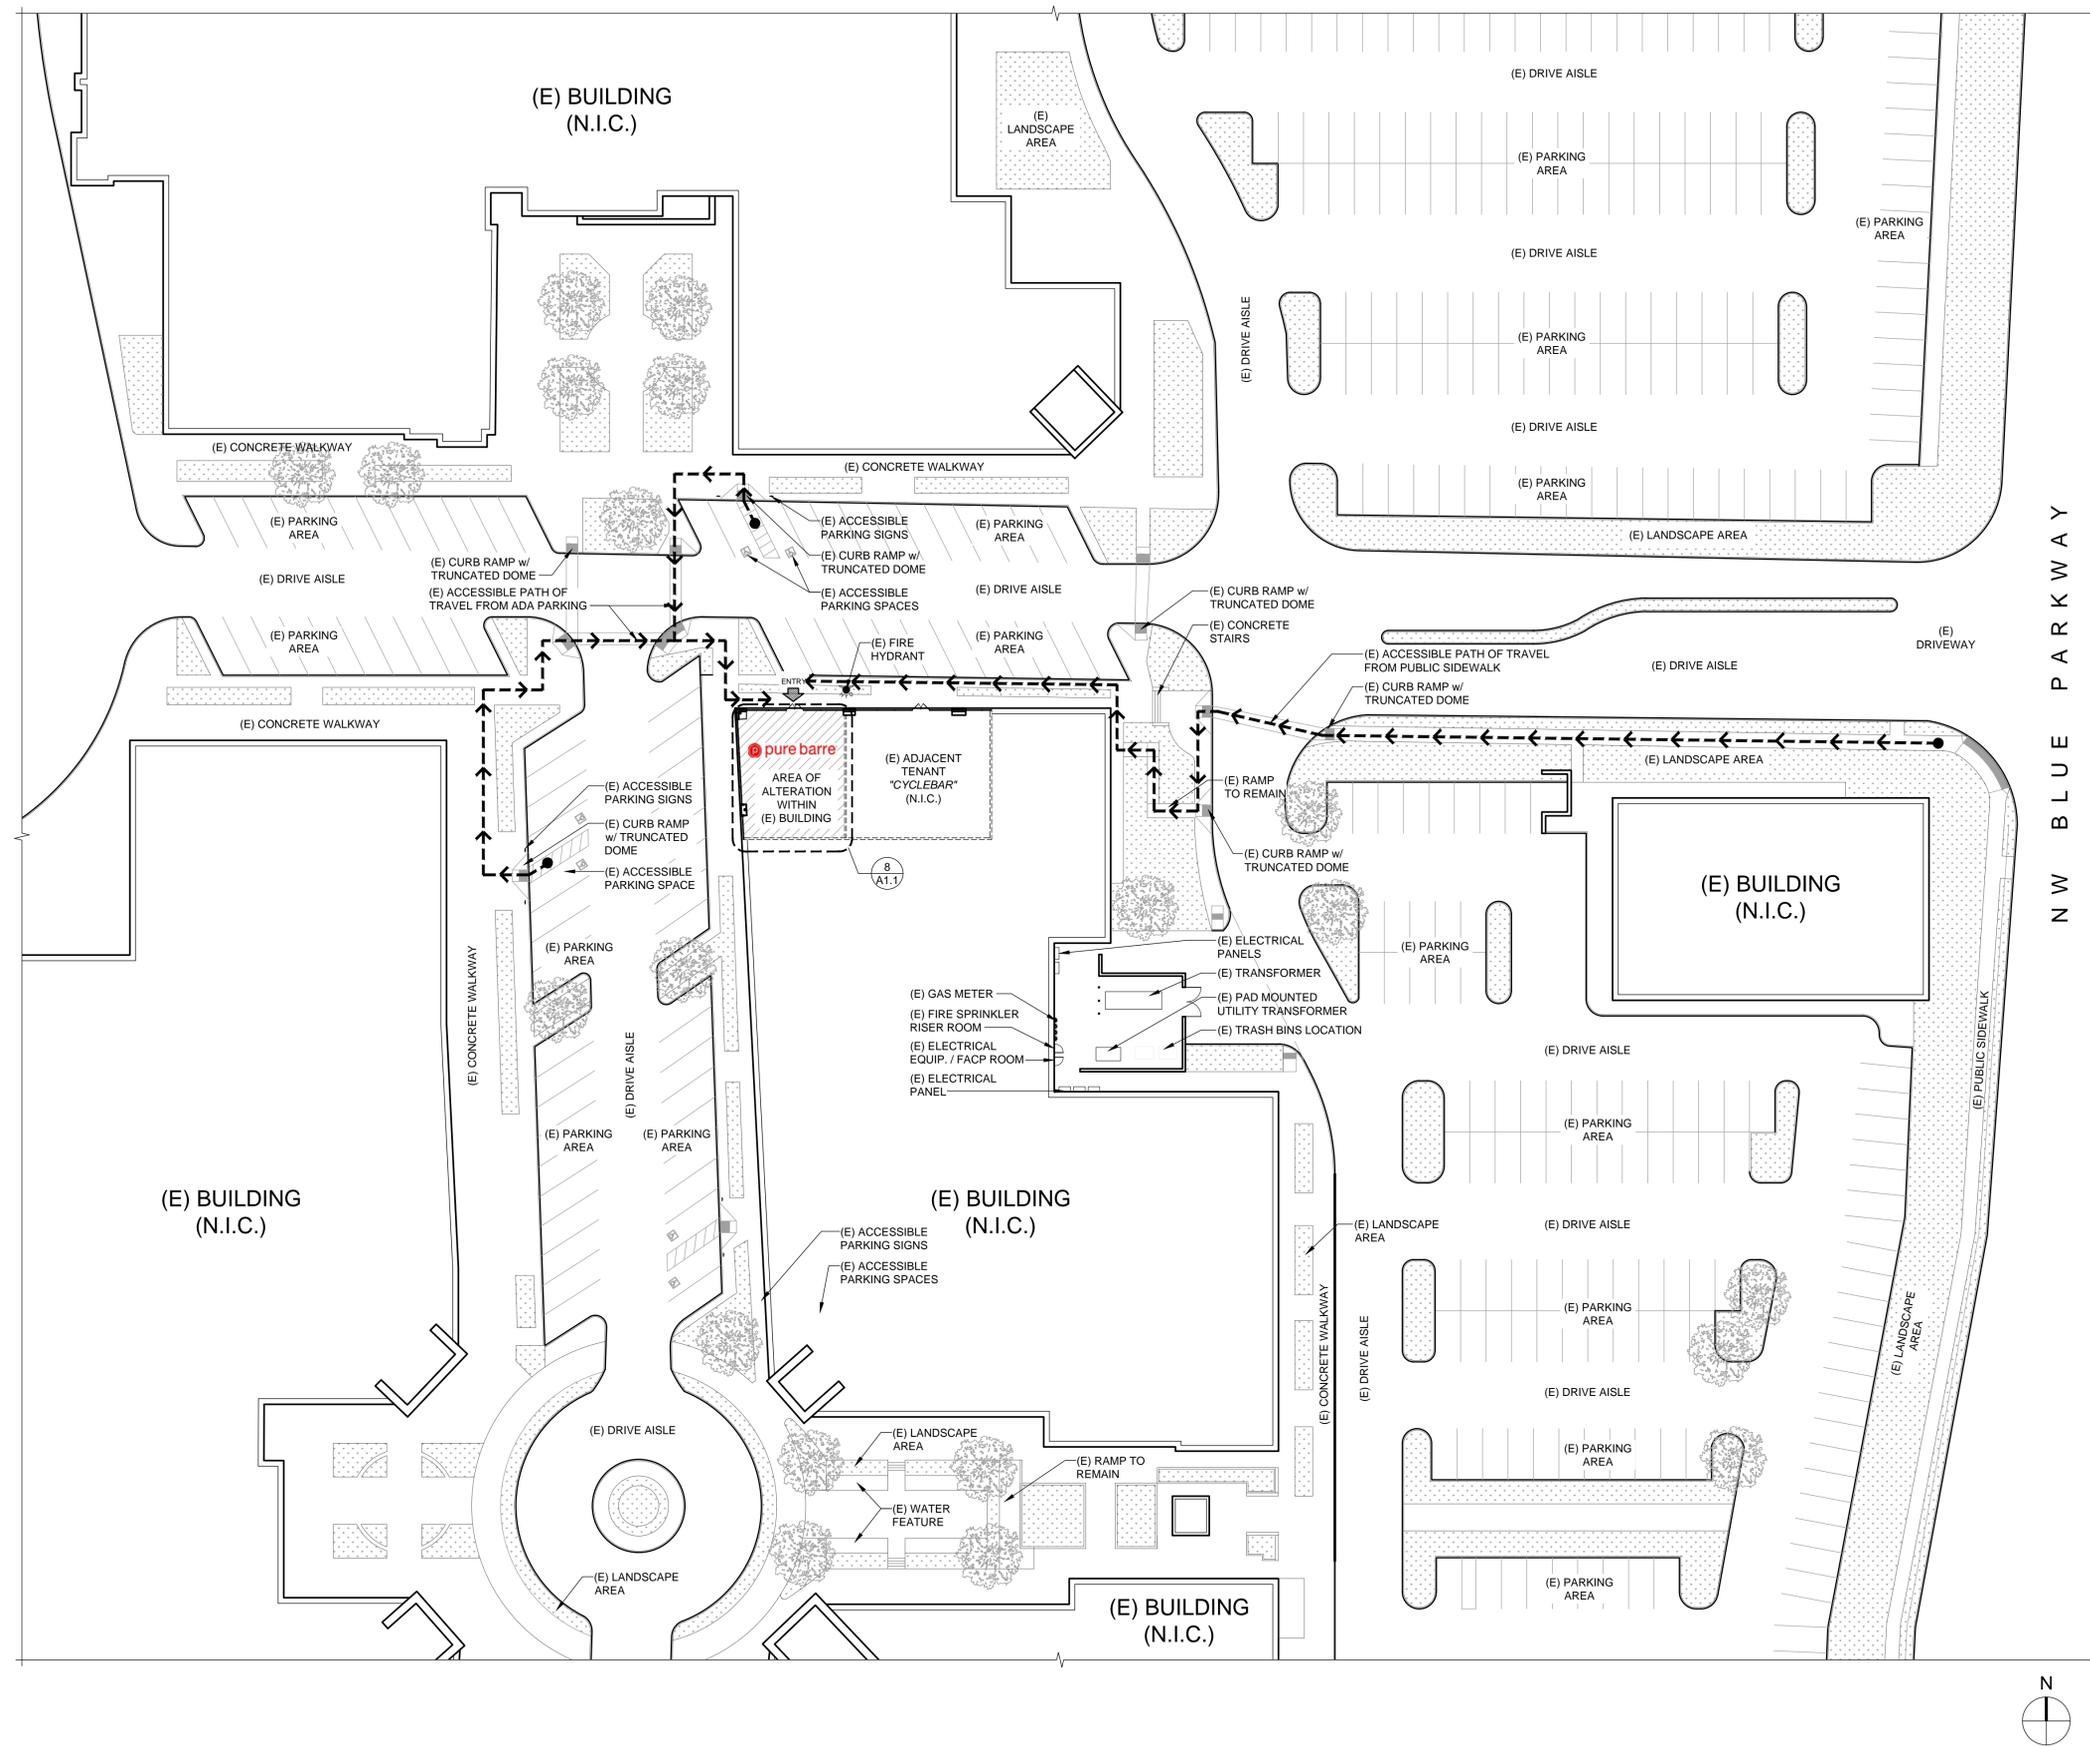
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NW BLUE PARKWAY



EXISTING SITE PLAN - (FOR REFERENCE ONLY)

SCALE
1" = 30'-0" 8


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EXISTING SITE PLAN
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SHEET TITLE

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SHEET NUMBER

AS1.1

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GENERAL NOTES

- SEE REFLECTED CEILING PLAN FOR SOFFIT AND LIGHTING INFORMATION.
- NOTIFY ARCHITECT IMMEDIATELY OF ANY INCONSISTENCIES OR DISCREPANCIES WITH PLANS IN RELATION TO EXISTING FIELD CONDITIONS.
- WRITTEN DIMENSIONS TAKE PRECEDENCE OVER SCALE ON THE CONSTRUCTION DOCUMENTS. DO NOT EVER SCALE DRAWINGS.
- DIMENSIONS ARE FROM THE FACE OF FINISHED WALL (GWB) TO FACE OF FINISHED WALL (GWB), UNLESS OTHERWISE NOTED ON PLANS.
- ALL MANUFACTURED ARTICLES, MATERIALS AND EQUIPMENT SHALL BE APPLIED, INSTALLED, CONNECTED, ERECTED, CLEANED AND CONDITIONED IN ACCORDANCE WITH THE MANUFACTURER'S WRITTEN SPECIFICATIONS AND/OR INSTRUCTIONS.
- ALL WORK SHALL BE EXECUTED IN A MANNER ACCEPTABLE TO THE ARCHITECT, OWNER, AND LANDLORD UNLESS NOTED OTHERWISE. THE GENERAL CONTRACTOR SHALL PROVIDE AND PAY ALL LABOR, MATERIALS, EQUIPMENTS, TOOLS, CONSTRUCTION EQUIPMENT, MACHINERY, TRANSPORTATION AND OTHER SERVICES AND FACILITIES NECESSARY FOR PROPER AND TIMELY EXECUTION OF WORK.
- THE CONTRACTOR WARRANT TO THE OWNER AND TO THE ARCHITECT THAT ALL MATERIALS AND EQUIPMENT FURNISHED UNDER THE CONTRACT ARE NEW UNLESS OTHERWISE SPECIFIED, AND THAT ALL WORKS SHALL BE AS SPECIFIED AND FREE OF DEFECTS.
- ALL OUTSIDE CORNERS AT DRYWALL PARTITION AND FURRING TO HAVE METAL CORNER BEADS SPACKLE AND SMOOTH.
- PROVIDE DIAGONAL BRACING TO STRUCTURE ABOVE ALL NEW DOORS, GLAZING HEADS AND JAMBS AS REQUIRED TO MAKE ASSEMBLY RIGID.
- THE GENERAL CONTRACTOR (G.C.) IS RESPONSIBLE FOR THE FINAL CLEAN UP OF THE AREA OF WORK AND AREA AFFECTED BY CONSTRUCTION, TO INCLUDE BUT NOT LIMITED TO FLOORS, MILLWORK, FIXTURES, ETC. FOLLOWING THE INSTALLATION OF THE MILLWORK.
- THE GENERAL CONTRACTOR SHALL COORDINATE THE LOCATIONS FOR THE WALL MOUNTED TELEVISIONS AND GRAPHIC SIGNAGE TO PROVIDE BLOCKING FOR MOUNTING.
- ALL WET / PLUMBING WALLS ARE TO BE PROVIDED W/ MOISTURE RESISTANT GYPSUM BOARD. PROVIDE CEMENT BACKER BOARD WHEN TILE IS IN USED.
- ALL PLUMBING WALLS ARE TO BE 6" METAL STUD FRAMING. PROVIDE REQUIRED BLOCKING FOR WALL MOUNTED FIXTURES, GRAB BARS, SHELVING, CABINETRY, ETC.
- THERE SHALL BE NO PENETRATIONS TO A DEMISING WALL, U.O.N. IF PENETRATIONS ARE TO BE NOTED, THEN ALL PENETRATIONS INCLUDING CONDUITS, PIPES, DUCTWORK, ETC. SHALL BE UL RATED PER CURRENT CODE REQUIREMENTS.
- NO PLUMBING IS ALLOWED IN DEMISING WALLS. FURRED OUT AS REQUIRED.
- ALL (E) DEMISING WALLS FOR TENANT SEPARATION ARE NOT TO BE DISTURBED OR MODIFIED IN ANY WAY.

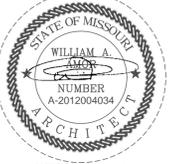EQUIPMENT LIST		
FIX #	QT	DESCRIPTION
AF-1	-	SUBWOOFER
AV-1	1	AV EQUIPMENT TBD
BE-1	2	SEATING BENCH 60" L x 20" W x 17" H MOVABLE
BE-2	1	ADA SEATING BENCH MIN.42" L x 20" W x 17" H FLOOR MOUNTED
EQ-1	96FT	BALLET BARRE FIELD VERIFY LENGTH
EQ-2	17	MIRROR SEE ELEVATIONS
EQ-3	-	DEHUMIDIFIER TBD - MOVABLE
FE-1	1	RECEPTIONIST DESK W/ ACCESSIBLE SPACE SEE DETAIL 2/A8.4
FE-2	1	RECEPTIONIST CHAIR BY OWNER TBD - MOVABLE
FE-3	1	CUBBIES SEE DETAIL 4/A8.4
RT-1	-	RETAIL - 2-WAY DISPLAY SEE DETAIL 9/A8.4
RT-2	1	RETAIL - 4-WAY DISPLAY SEE DETAIL 10/A8.4
RT-3	1	RETAIL - SLAT WALL WALL-MOUNTED SEE DETAIL 12/A8.4
RT-4	1	RETAIL - TOE SOX DISPLAY 15.5"W x 18" D x 65" H
FM-1	1	ADA COMPLIANT WATER DISPENSER SEE DETAIL 12/A8.1
FM-2	1	HIGH LOW DRINKING FOUNTAIN - ADA SEE DETAIL 4/T1.3
PL-1	1	MOP BASIN w/ BACKFLOW PREVENTER 24" L x 24" D x 13" H
PL-2	1	TANK WATER HEATER 30 GALLONS
PL-3	-	WASHER 4.5 CU. FT. CAPACITY STACKED
PL-4	-	DRYER w/ BOOSTER FAN 7.3 CU. FT. STACKED
PL-5	-	HANDSINK TBD
TV-1	-	TELEVISION TBD


WALL TYPES	
W-0	(E) INTERIOR WALL TO REMAIN
W-1	(E) EXTERIOR WALL TO REMAIN
W-2	(E) DEMISING WALL TO REMAIN. FULL HEIGHT, TYPE 'X' ON BOTH SIDES
W-3	(N) 6" x 20GA. METAL STUDS @ 16" O.C. w/ 5/8" GYPSUM BD. ON EACH SIDE ADD ADDITIONAL 5/8" GYPSUM BD. ON THEATRE SIDE
W-4	(N) 3 5/8" x 20GA. METAL STUDS @ 12" O.C. w/ 5/8" GYPSUM BD. ON EACH SIDE
W-4A	(N) 6" x 20GA. METAL STUDS @ 16" O.C. w/ 5/8" GYPSUM BD. ON EACH SIDE
W-5	(N) DEMISING WALL 6" x 20GA. METAL STUDS @ 16" O.C. W/ 1 LAYER OF 5/8" TYPE 'X' GYPSUM BD. ON ADJACENT TENANT SIDE (BY OTHERS) AND (1) LAYERS OF 5/8" TYPE 'X' GYP. BD. ON PURE BARRE SIDE, FULL HEIGHT.
W-6	(N) SOUND WALL, 3 5/8" x 20GA. METAL STUDS @ 12" O.C. w/ (2) 5/8" GYPSUM BD. ON ONE SIDE, 2 1/2" AIR GAP, AND (1) 5/8" GYPSUM BD. ON DEMISING WALL

NOTE:

- PROVIDE 5/8" WATER AND MOLD RESISTANT GYPSUM BOARD WHERE PLUMBING WALLS OCCUR, TYP.
- PROVIDE 5/8" TYPE "X" GYP. BOARD WHERE DEMISING WALLS OCCUR, TYP.
- ALL WALLS TO RECEIVE 5/8" GYP. BOARD, (U.N.O.).

LEGEND	
	1 DAY PROGRAMMABLE THERMOSTAT, MOUNT T-STAT AT 48" A.F.F., SENSOR AT 96" A.F.F.
	FIRE EXTINGUISHER UNIT. MOUNT HANDLE AT 48" A.F.F. MAX.
	ELECTRICAL PANEL

KEYNOTES	
1	(E) DOOR AND FRAME TO REMAIN. SEE DOOR SCHEDULE ON SHEET A8.1
2	(E) FIXED STOREFRONT WINDOW TO REMAIN
3	(N) DOOR AND FRAME. SEE DOOR SCHEDULE ON SHEET A8.1
4	(N) TRANSITION STRIP. SEE FINISH SCHEDULE ON SHEET A8.2
5	(N) WALL-MOUNTED FIRE EXTINGUISHER UNIT. MOUNT HANDLE AT 44"-0" AFF. MAX.
6	PROVIDE (N) THERMOSTAT @ 44"-0" MAX. A.F.F. SEE TYP. HEIGHT
7	(N) ELECTRICAL PANEL. SEE ELECTRICAL DRAWINGS
8	(N) TACTILE EXIT SIGN. PROVIDE 18"x18" CLEAR FLOOR SPACE CTR. TO SIGN
9	(N) INTERNATIONAL ACCESSIBILITY SYMBOL
10	PROVIDE ROLL-A-SHADE MANUAL CONTRACT SERIES BLACK-OUT SHADE FABRIC W/ SIDE & BOTTOM CHANNELS WITH 60% TRANSMITTANCE AND STAINLESS STEEL CHAIN AND BLACK HARDWARE GC TO DETERMINE SIZE OF THE POCKET O.F.C.I.
11	ADD (N) MULL-IT-OVER TRIM CLOSURE PIECES AT END WALL PLATE, OR EQUAL.
12	(E) STRUCTURAL COLUMN TO REMAIN

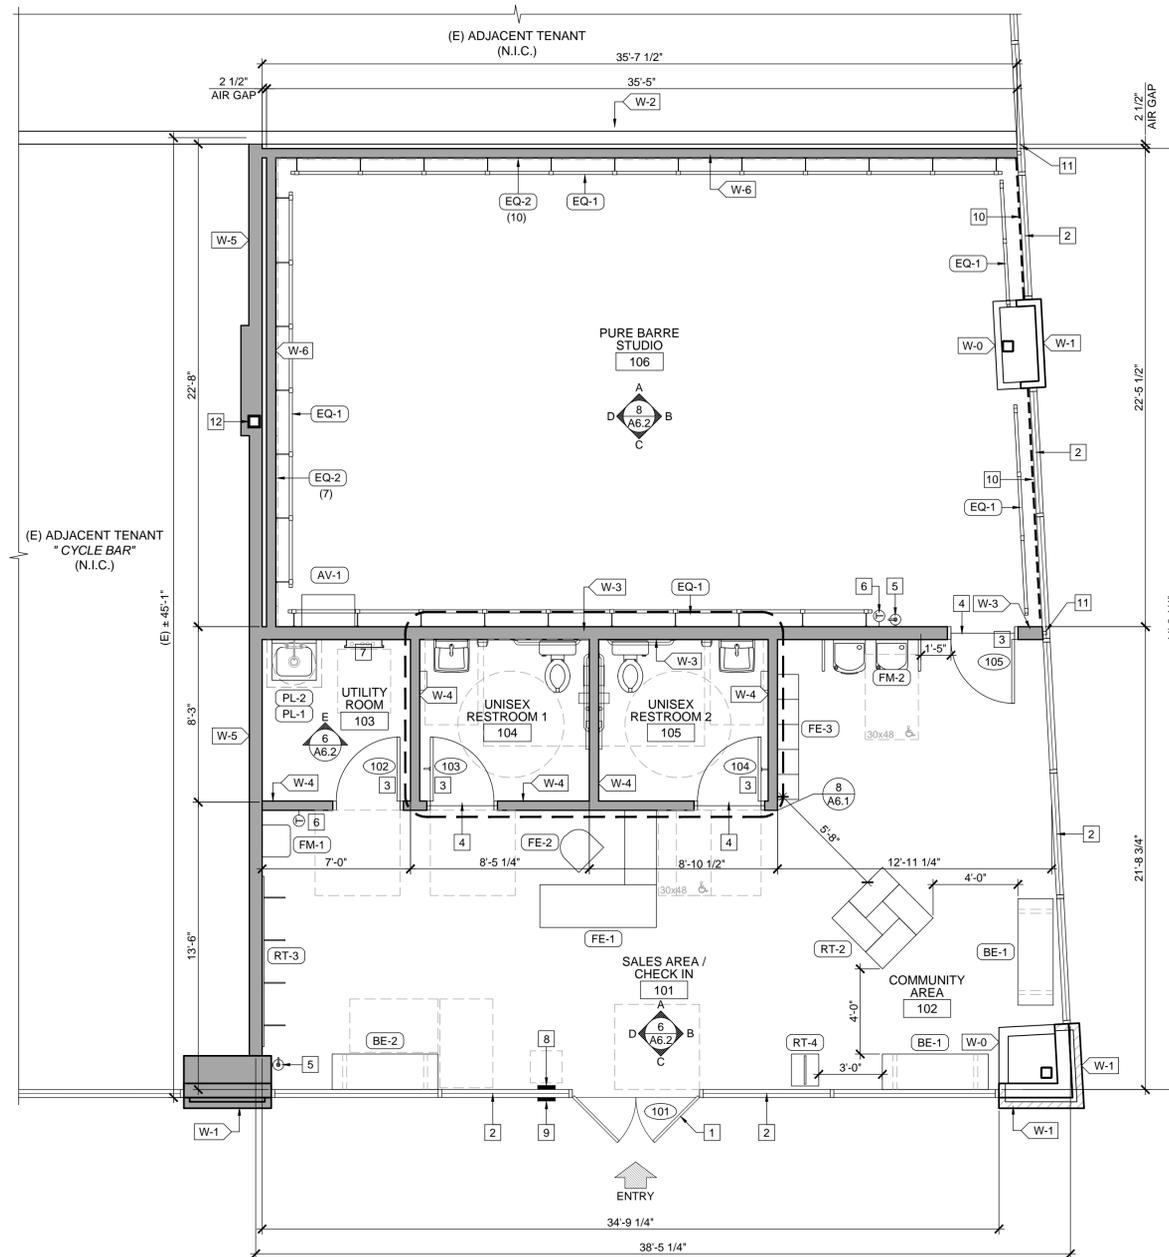

(N) FLOOR PLAN AND EQUIPMENT PLAN

SCALE	8
1/4" = 1'-0"	



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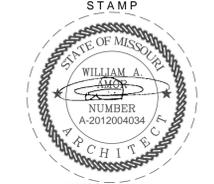
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PROJECT LOCATION



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REVISIONS	
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2020.04.10

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A2275

SHEET NUMBER

A1.1

PERMIT SET : 2020_04_10


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LEGEND

- 120V, 20A DUPLEX OUTLET MOUNTED 18" A.F.F. (U.N.O.)
- 120V, 20A DUPLEX OUTLET (DIMENSION DENOTES MOUNTING HEIGHT)
- 120V, 20A QUAD OUTLET MOUNTED 18" A.F.F. (U.N.O.)
- DATA JACK
- TELEPHONE JACK
- CAMERA

KEYNOTES

- 1 (2) 20 AMP CIRCUITS VIA (2) QUAD RECEPTACLES LOCATED AT AV RACK
- 2 G.C. TO PROVIDE (1) CAT6 PLENUM RATED CABLE FOR CAMERAS
- 3 EACH CAMERA CABLE TO BE RAN BACK TO AV RACK LOCATION WITH 15' OF SLACK AT CAMERA LOCATION AND 15' OF SLACK PROTRUDING FROM AV CUT IN RING
- 4 G.C. TO PROVIDE (1) 15 AMP CIRCUIT VIA (1) QUAD RECEPTACLE AT FRONT DESK FOR POS COMPUTER
- 5 G.C. TO PROVIDE (2) CAT 6 PLENUM DATA DROPS NEXT TO FRONT DESK POWER AND TERMINATED WITH KEYSTONE JACKS. DATA DROPS ARE TO BE RAN BACK TO AV RACK LOCATION WITH 15' OF SLACK PROTRUDING FROM 2 GANG AV CUT IN RING
- 6 (2) 1 1/2" CONDUITS STUBBED OUT 6" ABOVE DROP CEILING AND RAN TO A 2 GANG CUT OUT RING AT AV RACK LOCATION
- 7 CONVENIENCE OUTLETS AS NEEDED
- 8 (2) USB/DUPLEX RECEPTACLE FOR IPAD CHECK IN AT FRONT DESK
- 9 (1) 16/2 PLENUM RATED SPEAKER CABLE AT EACH LOCATION. SPEAKER MOUNT HEIGHT @ 9'-0"

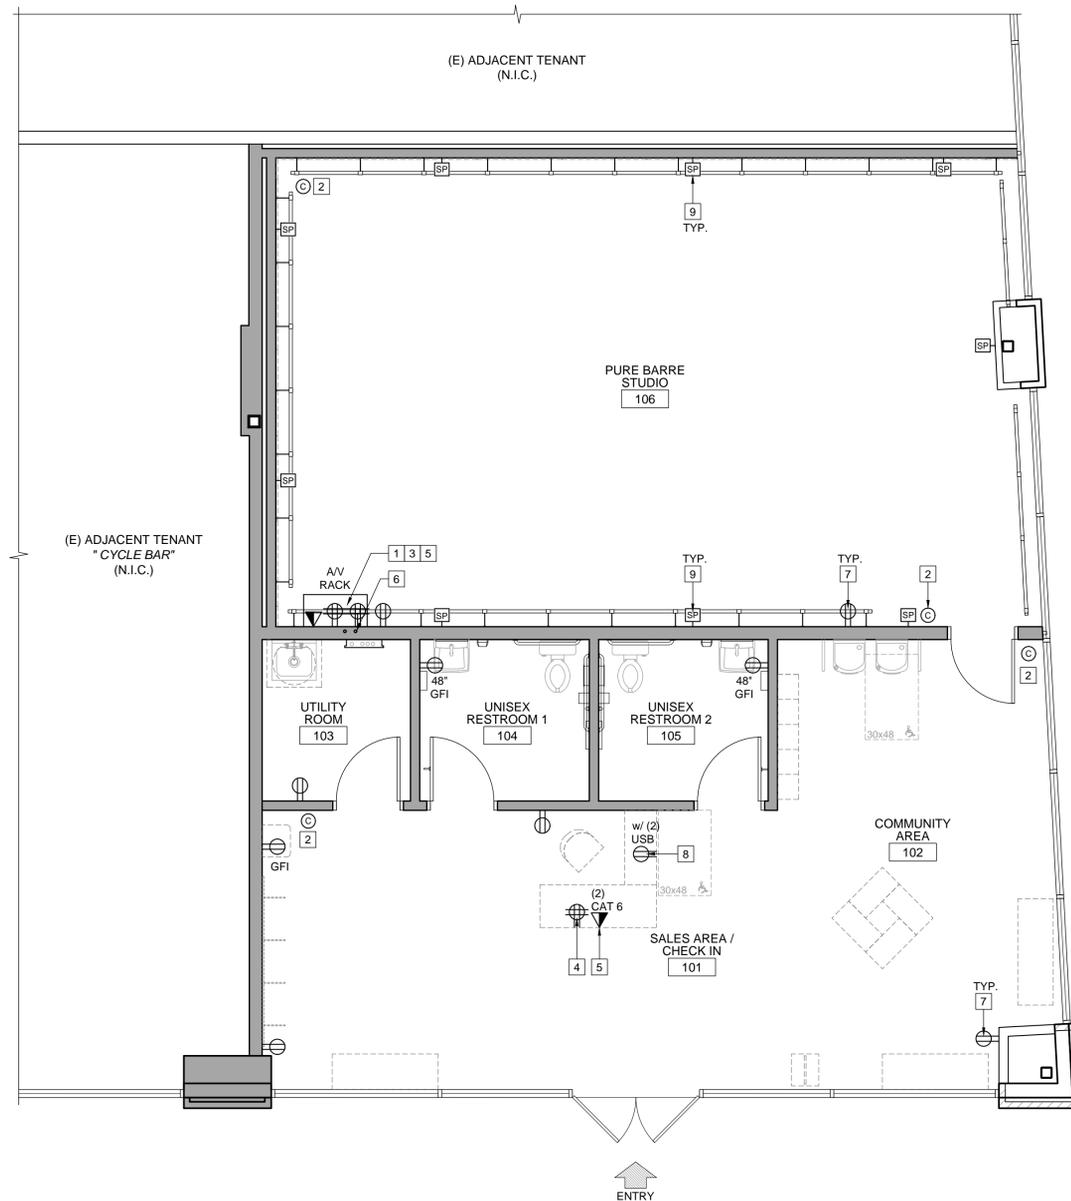


(N) POWER / AUDIO / VISUAL PLAN

SCALE 1/4" = 1'-0" 8



PROJECT LOCATION
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INTERIOR TENANT IMPROVEMENT
910-U NORTHWEST BLUE PARKWAY
LEE'S SUMMIT, MO 64086

SHEET TITLE
(N) POWER / AUDIO / VISUAL PLAN

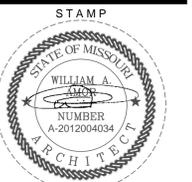

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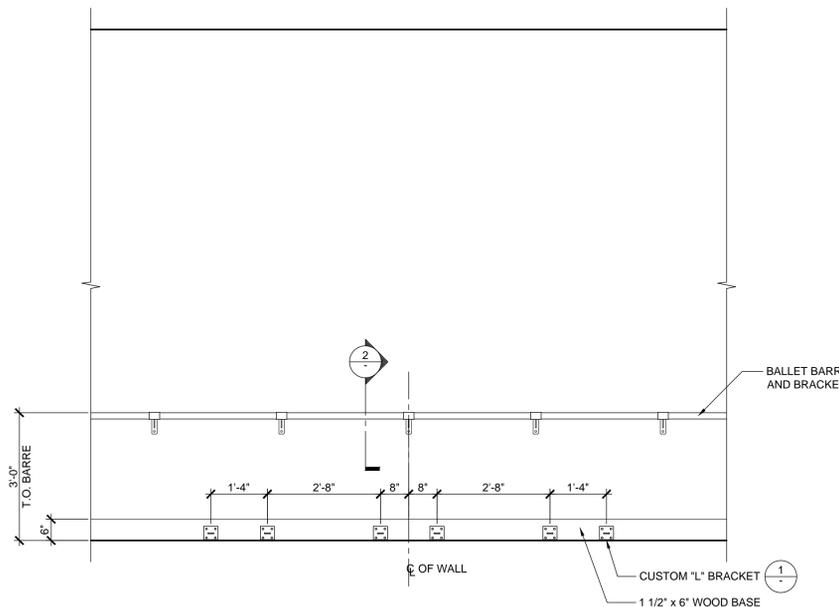
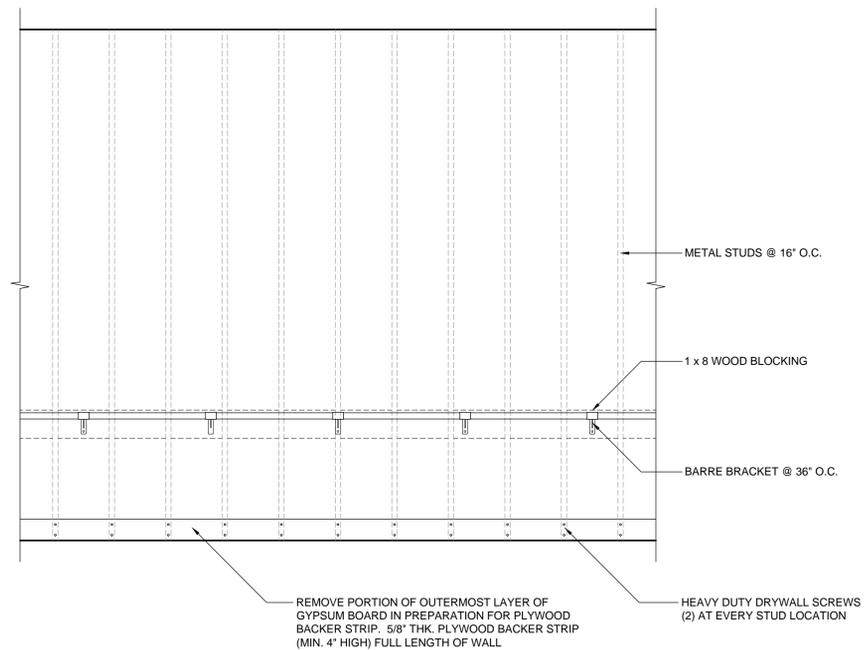
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PROJECT NUMBER A2275

SHEET NUMBER

A1.2

PERMIT SET : 2020_04_10

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NOTE:
START THE BRACKET PLACEMENT BY MARKING THE CENTER POINT ALONG EACH WALL. FROM THERE START MEASURING OUTWARD TOWARDS THE CORNERS OF EACH WALL STARTING 8" ON EACH SIDE OF THE CENTER POINT THEN FOLLOW THE ILLUSTRATION ABOVE BY SPACING TO THE CENTER OF EACH BRACKET THEN SCREW INTO PLACE PER THE INSTALLATION INSTRUCTIONS.

PARTIAL ELEVATION - WALL BASE ANCHOR / BARRE AND BRACKET

SCALE
1/2" = 1'-0"

6

BARRE BRACKET DETAIL




SCALE
3" = 1'-0"

2

L-BRACKET WALL MOUNT

SCALE
3" = 1'-0"

1

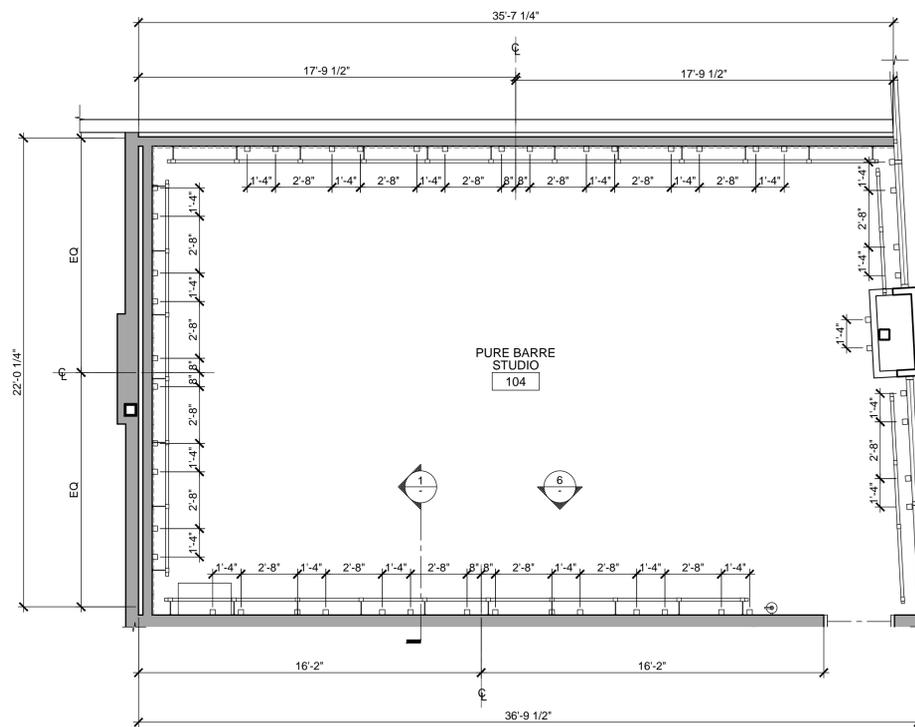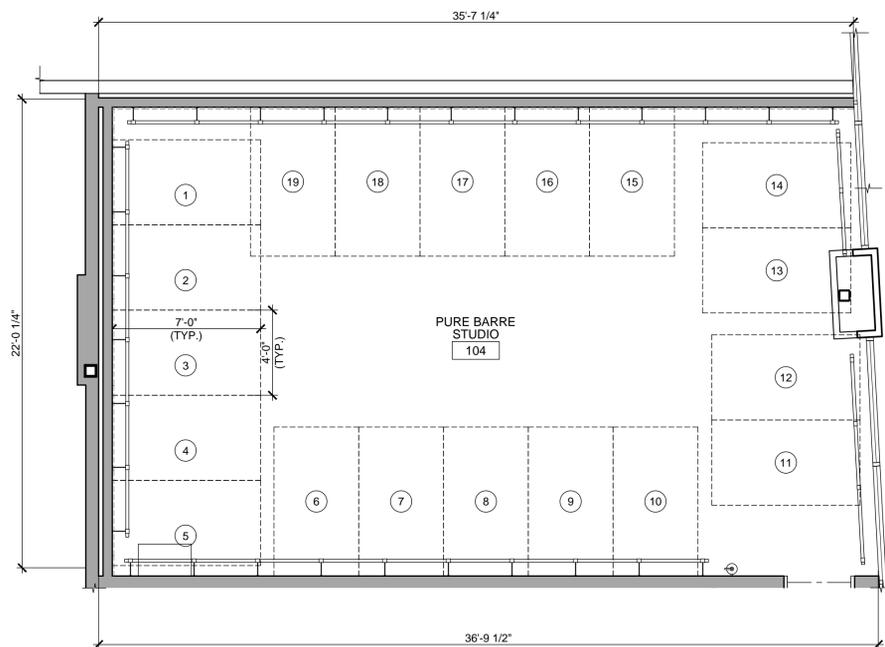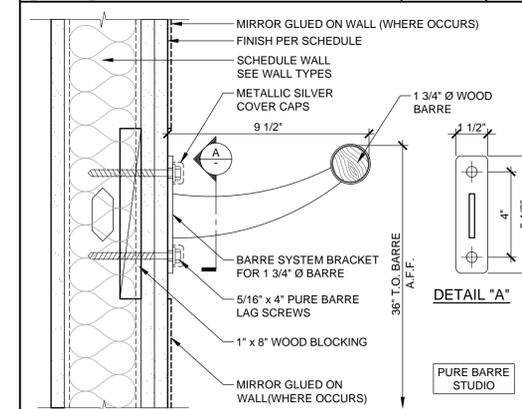

REFORM PLAN

L - BRACKET PLAN

REFORM / L - BRACKET PLAN


SCALE
1/4" = 1'-0"

8


L-BRACKET WALL MOUNT

SCALE
3" = 1'-0"


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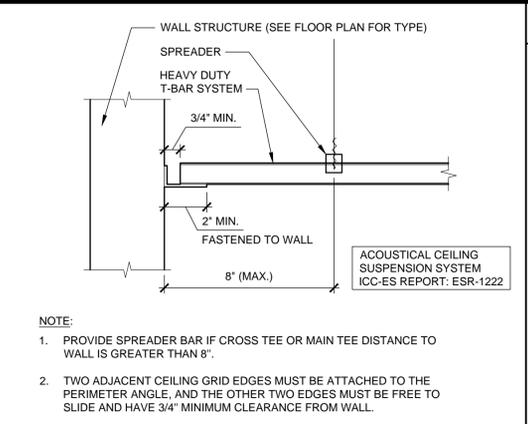
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GYP. BD. CEILING DETAIL SCALE 3" = 1'-0" 13

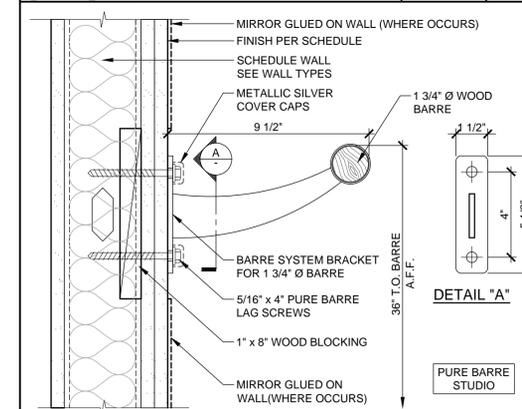

CEILING BRACING DETAIL SCALE 3" = 1'-0" 9

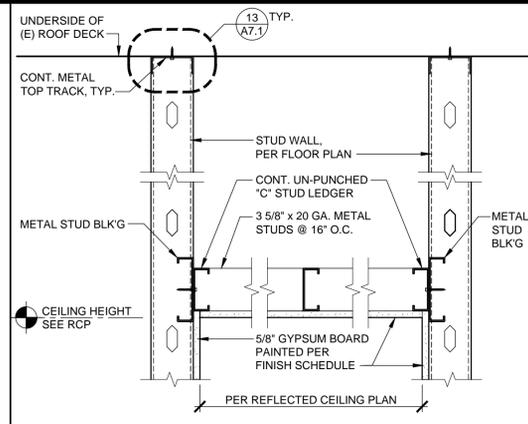

CEILING PERIMETER SCALE 3" = 1'-0" 5

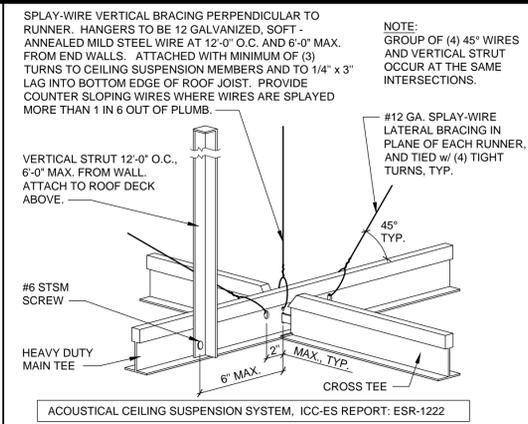GENERAL NOTES

- EMERGENCY LIGHTS TO BE INSTALLED ON SEPARATE CIRCUIT.
- ALL LIGHT FIXTURES INCLUDING EXIT LIGHTS, EMERGENCY LIGHTS, ETC., SHALL BE FURNISHED AND INSTALLED BY THE CONTRACTOR.
- ALL FINISHING AND PAINTING REQUIREMENTS SHALL BE DIRECTED TO THE FINISH SCHEDULE SPECIFICATIONS AND INTERIOR ELEVATIONS.
- CONTRACTOR TO USE LASER FOR LEVELING OF ALL SOFFITS, CEILINGS AND SUSPENDED GRIDS.
- ELECTRICAL CONTRACTOR TO VERIFY IF SERVICE PROVIDED IS ADEQUATE. NOTIFY ARCHITECT IMMEDIATELY IF NOT.
- ALL EQUIPMENT SHALL BEAR U.L. LABELS.
- ELECTRICAL CONTRACTOR MUST PROVIDE AN IDENTIFICATION NAME PLATE ON TENANT'S MAIN ELECTRICAL SERVICES FUSIBLE DISCONNECT SWITCH IN LANDLORD'S DISTRIBUTION PANEL AND RTU. NAMEPLATE MUST BE 1/8" THICK PLASTIC, BLACK ON WHITE ETCHED TO LEAVE WHITE LETTERS. THE SIZE SHALL BE ONE INCH HIGH BY REQUIRED LENGTH, WITH TENANT'S SPACE NUMBER ENGRAVED ON IT. PERMANENTLY AFFIX TO DISTRIBUTION PANEL.
- DIFFUSERS AND LIGHTS TO HAVE HANG WIRES ON ALL FOUR CORNERS.
- ALL FIRE DAMPERS MUST BE IDENTIFIED BY A STICKER INSTALLED ON CEILING BELOW. DUCT FIRE DAMPER MUST BE INSTALLED WITH A BREAKAWAY CONNECTION PLENUM THAT CANNOT CONTAIN ANY COMBUSTIBLES.
- GENERAL CONTRACTOR TO INSTALL ACCESS DOORS AS NECESSARY AND CONFIRM EXACT LOCATIONS. ACCESS PANEL MUST BE FLUSH, FRAMELESS GYPSUM PANELS IN SALES AREA. G.C. MUST PROVIDE AN ALLOWANCE FOR ACCESS PANELS IN BID.
- ALL LIGHTING SHOULD BE IN WORKING ORDER AND ALL COVERS / LENSES IN PLACE.
- GENERAL CONTRACTOR SHALL COMPLY WITH CURRENT STATE ENERGY CODES.
- GENERAL CONTRACTOR TO VERIFY FIRE ALARM REQUIREMENTS AND NOTIFY ARCHITECT AS SOON AS POSSIBLE OF ANY DISCREPANCIES.
- FIRE ALARM, FIRE STROBE, FIRE PULL SHALL BE BY OTHERS ON A SEPARATE SUBMITTAL.


LEGEND

- 2X4 SUSPENDED LED SEE LUMINAIRE SCHEDULE
- RECESSED LED DOWNLIGHT SEE LUMINAIRE SCHEDULE
- EMERGENCY LIGHT SELF-DIAGNOSTICS, 90mins.
- EMERGENCY LIGHT w/ ILLUMINATE EXIT SIGN, 90mins.
- MECHANICAL VENTILATION LIGHT ACTIVATED -WOMEN MIN. 50 CFM/ 70 UNIT -MEN MIN. 100 CFM/ 70 UNIT
- ILLUMINATED EXIT SIGN
- LED EMERGENCY EXTERIOR EGRESS LIGHTING CONNECTED TO EXIT SIGN BATTERY BACKUP

NOTE: FOR MORE INFORMATION REFER TO LUMINAIRE SCHEDULE SHEET A8.1

KEYNOTES

- (N) GYPSUM BOARD CEILING
- (N) CEILING GRID
- (N) 2' x 2' CEILING TILES
- (N) 2' x 4' LIGHT FIXTURE. SEE LEGEND
- (N) EXHAUST FAN. SEE MECHANICAL DRAWINGS
- (N) RECESSED LED DOWNLIGHT. SEE LEGEND
- (N) EMERGENCY LIGHT. SEE LEGEND
- (N) EMERGENCY LIGHT w/ ILLUMINATED EXIT SIGN. 90 MINS. SEE LEGEND
- (N) ILLUMINATED EXIT SIGN. 90 MINS. SEE LEGEND
- (N) EXTERIOR EGRESS LIGHT FIXTURE. SEE LEGEND

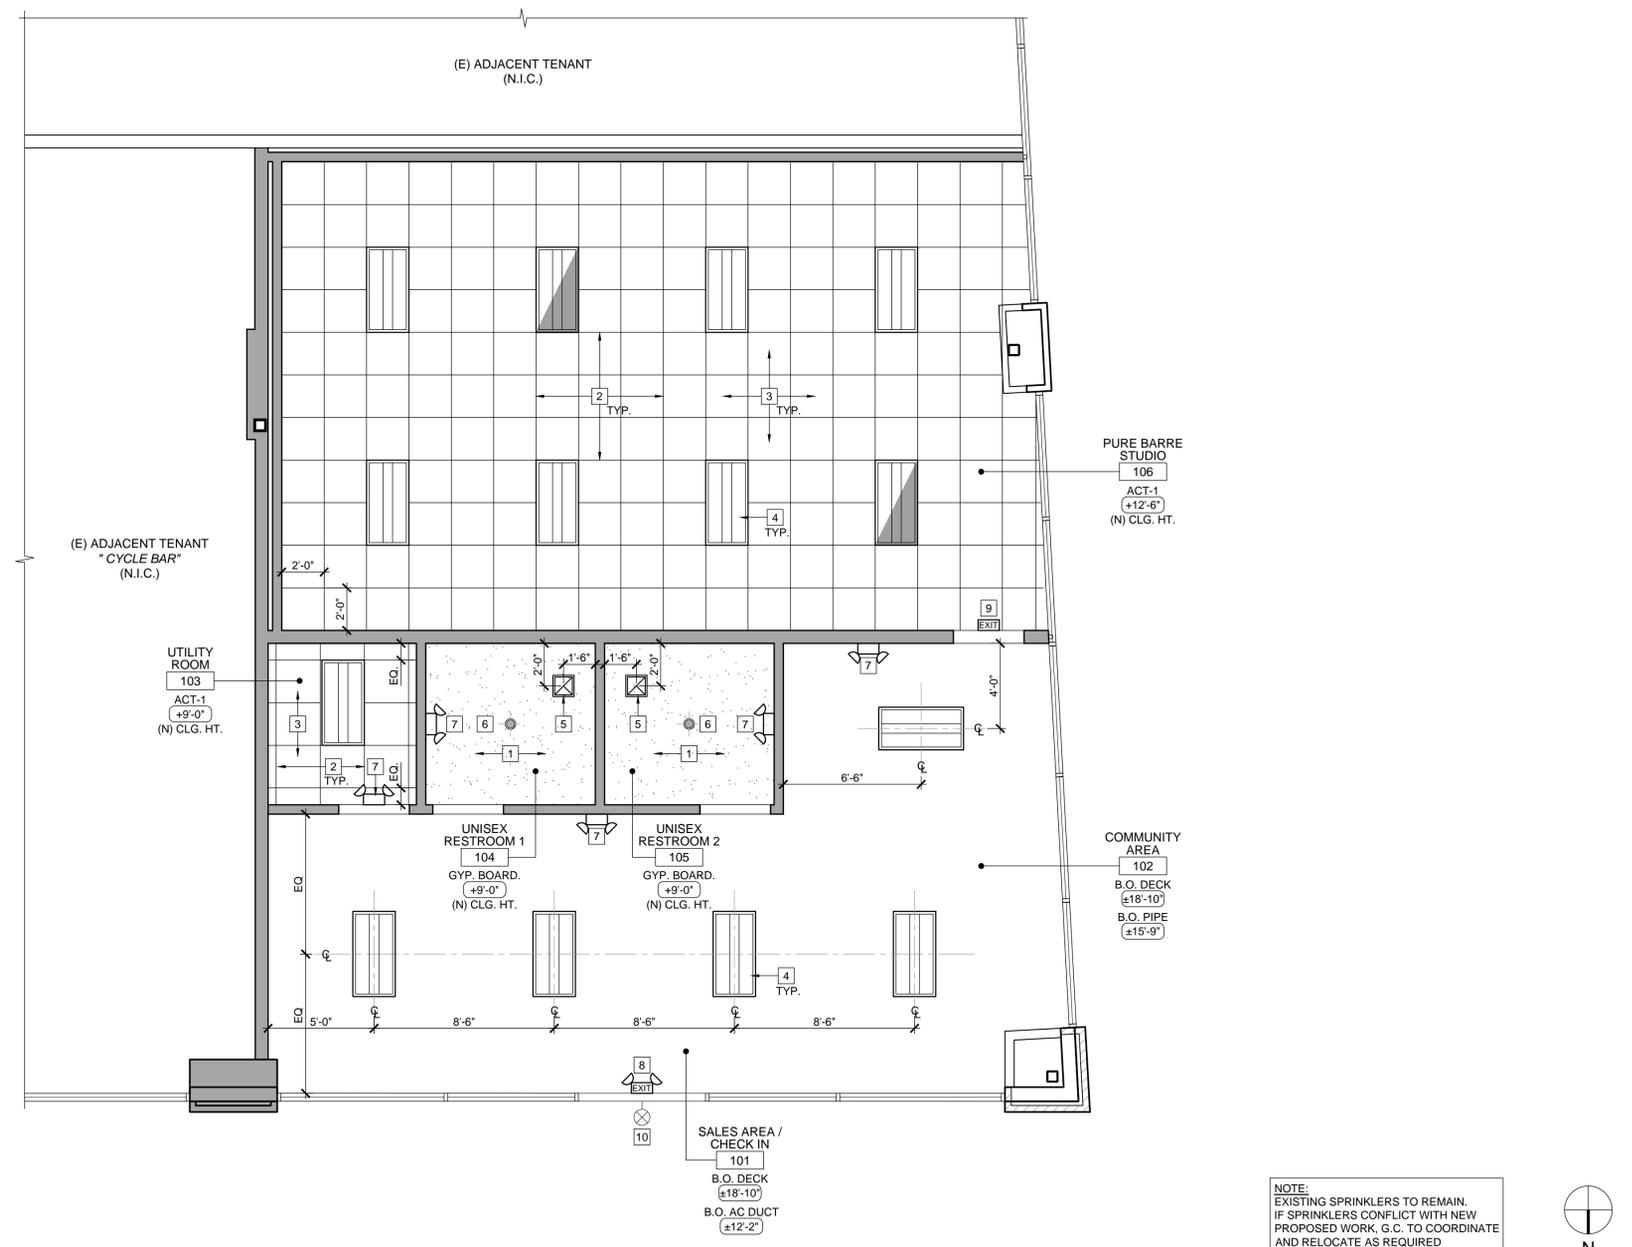

(N) REFLECTED CEILING PLAN SCALE 1/4" = 1'-0" 8



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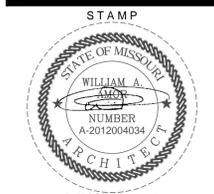
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PROJECT LOCATION
 SHEET TITLE
 (N) REFLECTED CEILING PLAN



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REVISIONS

DATE: 2020.04.10
 PROJECT NUMBER: A2275

SHEET NUMBER

A2.1

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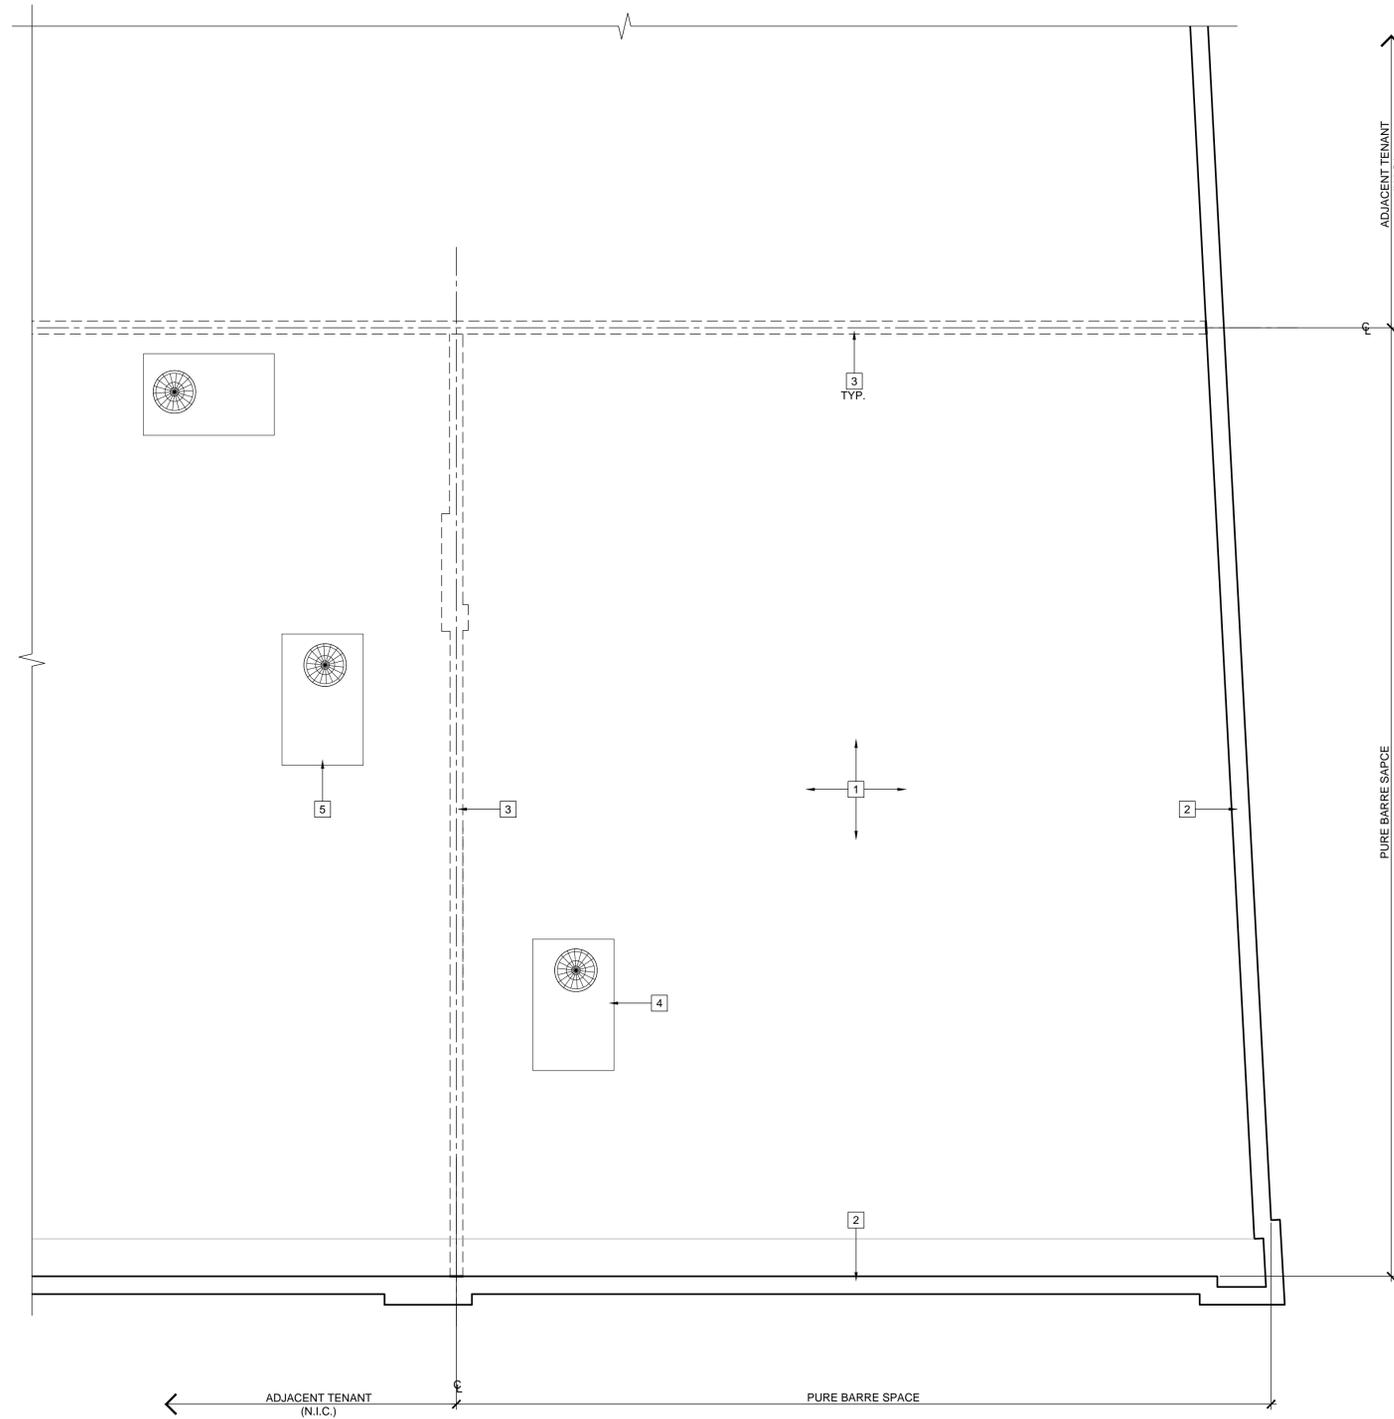
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GENERAL NOTES

1. PROVIDE TAPERED INSULATION CRICKET - 1/2"-12" AT ALL NEW UNITS.
2. SEE MECHANICAL DRAWINGS FOR PIPE PENETRATION TO ROOF AND ADDITIONAL INFORMATION NOT SHOWN HERE
3. VERIFY ROOF SYSTEM AND MATCH EXISTING WHERE NEW WORK TO BE IMPLEMENTED MEMBRANE ROOF (CLASS A PER SPECIFICATIONS). SLOPE 1/4":12"(MIN.), TYP.

KEYNOTES

- 1 (E) BUILT-UP ROOF TO REMAIN
- 2 (E) PARAPET WALL TO REMAIN
- 3 OUTLINE OF (E) DEMISING WALL BELOW
- 4 (E) ROOF TOP UNIT TO REMAIN.
- 5 (E) ADJACENT ROOF TOP UNIT TO REMAIN.



SCALE
1/4" = 1'-0"

8

PARTIAL ROOF PLAN



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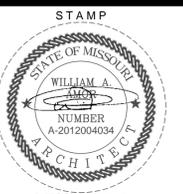


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SHEET TITLE
PARTIAL ROOF PLAN



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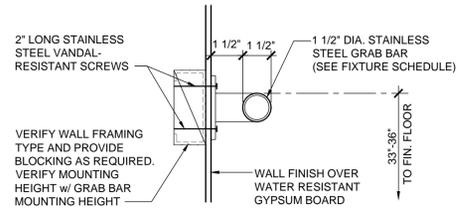
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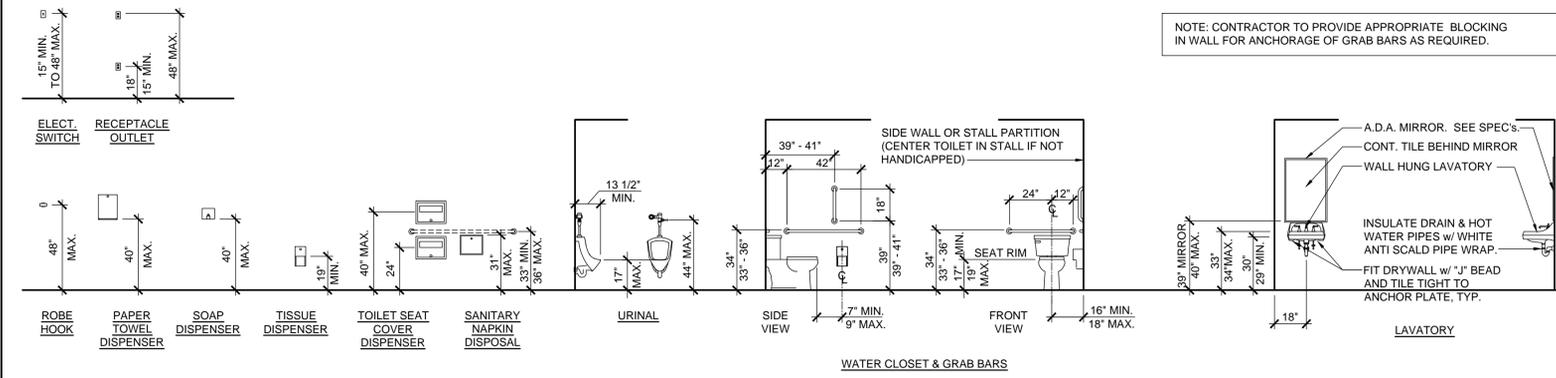
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NOTES:
 GRAB BARS AT WATER CLOSET (511.1A-9)
 1. ONE AT SIDE 42" LONG EXTENDING 24" IN FRONT OF WATER CLOSET; ONE AT REAR OF WATER CLOSET 36" LONG; BOTH MOUNTED 33" ABOVE FINISH FLOOR.
 (EXCEPTION: REAR GRAB BAR OVER TANK TYPE WATER CLOSER MAY BE UP TO 36" ABOVE FINISH FLOOR)
 2. BARS SHALL BE 1-1/4" TO 1-1/2" IN DIAMETER WITH 1-1/2" CLEARANCE TO WALL.
 3. BAR FASTENERS AND MOUNTING SUPPORT SHALL BE ABLE TO WITHSTAND 250 LBS. POINT LOAD IN BENDING, SHEAR TENSION. ROTATION IN FITTING NOT ALLOWED.
 4. SURFACE OF WALL ADJACENT TO GRAB BAR IS TO BE FREE OF SHARP OR ABRASIVE ELEMENTS.



GRAB BAR DETAIL

SCALE
 3" = 1'-0" 17




TYP. MOUNTING HEIGHT: RESTROOM ACCESSORIES AND FIXTURES

SCALE
 1/4" = 1'-0" 5


GENERAL NOTES

- PROVIDE 1-1/2" CLEARANCE BETWEEN WALL AND GRAB BARS.
- DRAIN AND HOT WATER PIPES UNDER ALL LAVATORIES TO BE INSULATED.
- GRAB BARS SHALL BE DESIGNED TO SUPPORT A 250# LOAD AND SHALL NOT ROTATE WITHIN THEIR FITTINGS.
- FLUSH VALVE CONTROL ON WATER CLOSET SHALL BE OPERABLE BY AN OSCILLATING HANDLE WITH MAXIMUM FORCE OF 5 LBS. TOP OF ALL ELECTRICAL SWITCHES AND CONVENIENCE OUTLET NOT TO EXCEED 40", TYPICAL THROUGH-OUT.
- NO SHARP OR ABRASIVE SURFACES IN FRONT OF LAVATORIES.
- A CLEAR SPACE OF 30" X 48" SHALL BE PROVIDED IN FRONT OF LAVATORY TO ALLOW A FORWARD APPROACH TO COMPLY WITH.
- OPERATING PARTS OF DISPENSING AND DISPOSAL FIXTURES (TOWELS, WASTE, COIN SLOTS, ETC.) ARE TO BE AT 40" A.F.F. MAX.
- MIRRORS - MOUNT MIRRORS AT 39" ABOVE FINISH FLOOR TO BOTTOM OF REFLECTIVE SURFACE. (MAXIMUM 40" A.F.F.)
- TOILET TISSUE DISPENSER TO BE MOUNTED WITHIN 12" FROM THE FRONT EDGE OF TOILET SEAT.
- THE RESTROOM DOORS MUST BE WELL FITTING AND SELF-CLOSING.
- PROVIDE SUFFICIENT VENTILATION IN RESTROOMS BY MEANS OF A WINDOW OR MECHANICAL CEILING VENTILATION.
- TOILET ACCESSORIES LOCATED ON OR WITHIN WALLS BE INSTALLED AND SEALED TO PROTECT STRUCTURAL ELEMENTS FROM MOISTURE.
- FAUCET CONTROLS AND OPERATING MECHANISM (OPERABLE W/ ONE HAND) SHALL BE OF TYPE NOT REQUIRING TIGHT GRASPING, PINCHING OR TWISTING OF THE WRIST AND AN OPERATING FORCE NOT EXCEEDING 5 LBS.
- LAVATORIES SHALL BE MOUNTED WITH THE RIM OR COUNTER SURFACE NO HIGHER THAN 34" ABOVE THE FINISHED FLOOR & WITH A CLEARANCE OF AT LEAST 29" FROM THE FLOOR TO THE BOTTOM OF THE APRON WITH KNEE CLEARANCE UNDER THE FRONT LIP. EXTENDING A MIN. OF 30" IN WIDTH & 8" MIN. DEPTH AT THE TOP. TOE CLEARANCE SHALL BE A MIN. OF 9" HIGH FROM THE FLOOR & A MIN. OF 17" DEEP FROM THE FRONT OF THE LAVATORY.
- CONTROLS FOR WATER CLOSET FLUSH VALVES SHALL BE MOUNTED ON THE WIDE SIDE OF TOILET AREAS.
- REGARDLESS OF STALL CONFIGURATION, A 48" LONG MINIMUM CLEARANCE FLOOR SPACE SHALL BE PROVIDED IN FRONT OF THE WATER CLOSET.
- SEE FIXTURE AND STANDARD ACCESSIBILITY MOUNTING HEIGHTS DETAIL 5 / A6.1.
- WATER CLOSET COMPARTMENTS SHALL BE EQUIPPED WITH A DOOR THAT HAS AN AUTOMATIC CLOSING DEVICE, AND SHALL HAVE A CLEAR UNOBSTRUCTED OPENING WIDTH OF 32" WHEN LOCATED AT THE END & 34" WHEN LOCATED AT THE SIDE WITH THE DOOR POSITIONED AT AN ANGLE OF 90 DEGREES FROM ITS CLOSED POSITION.
- THE INSIDE & OUTSIDE OF THE COMPARTMENT DOOR SHALL BE EQUIPPED W/ A LOOP OR U-SHAPED HANDLE IMMEDIATELY BELOW THE LATCH. THE LATCH SHALL FLIP OVER STYLE, SLIDING OR OTHER HARDWARE NOT REQUIRING THE USER TO GRASP OR TWIST.

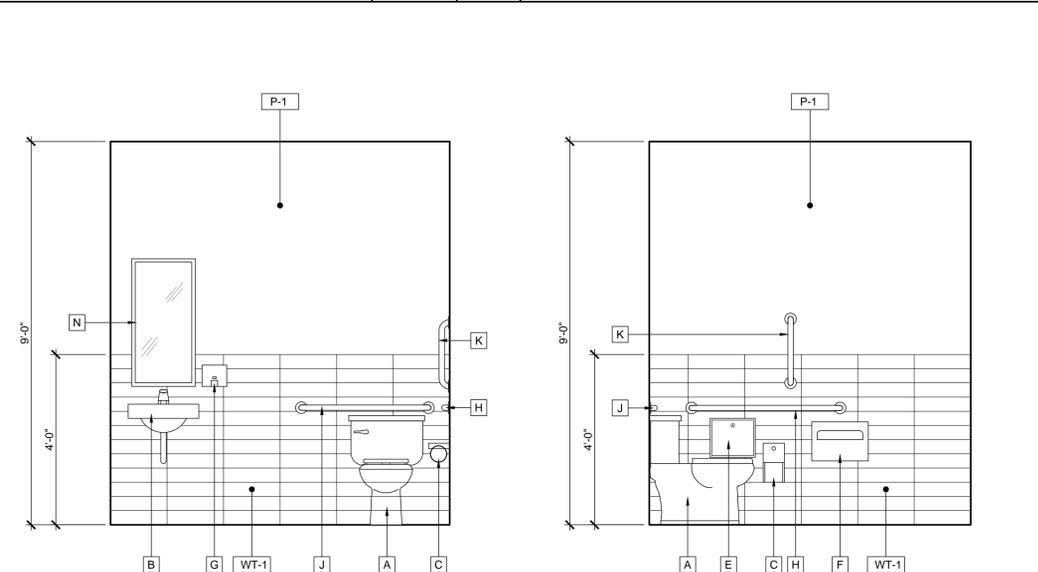

ELEVATION - A

ELEVATION - B

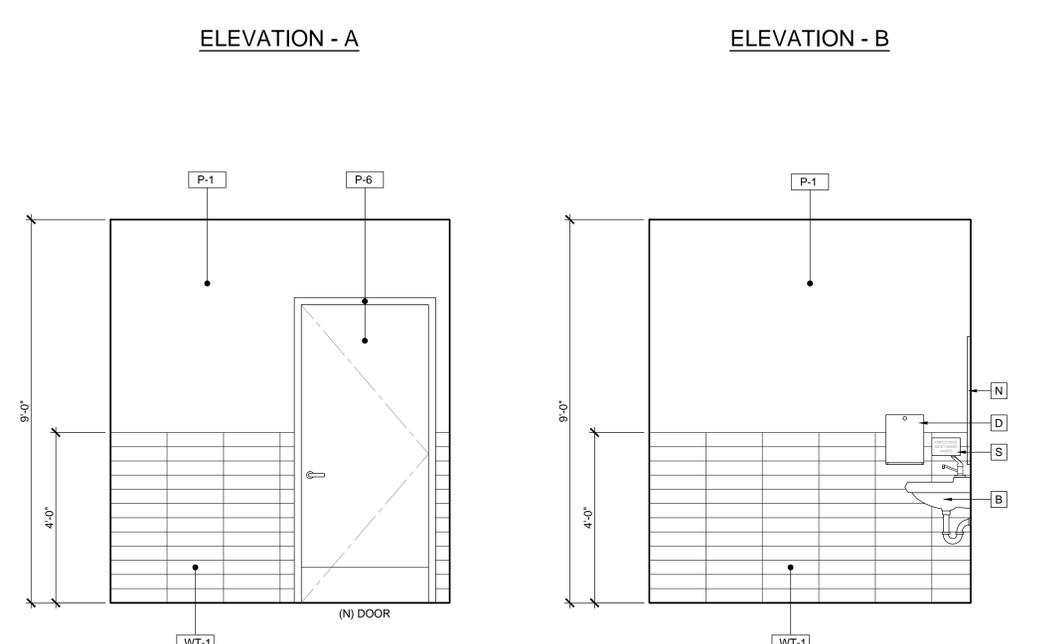


ELEVATION - C

ELEVATION - D

NOTE:
 TRIM TILE BEHIND MIRROR AND PAPER TOWEL DISPENSER


INTERIOR ELEVATIONS - RESTROOM

SCALE
 1/2" = 1'-0" 16

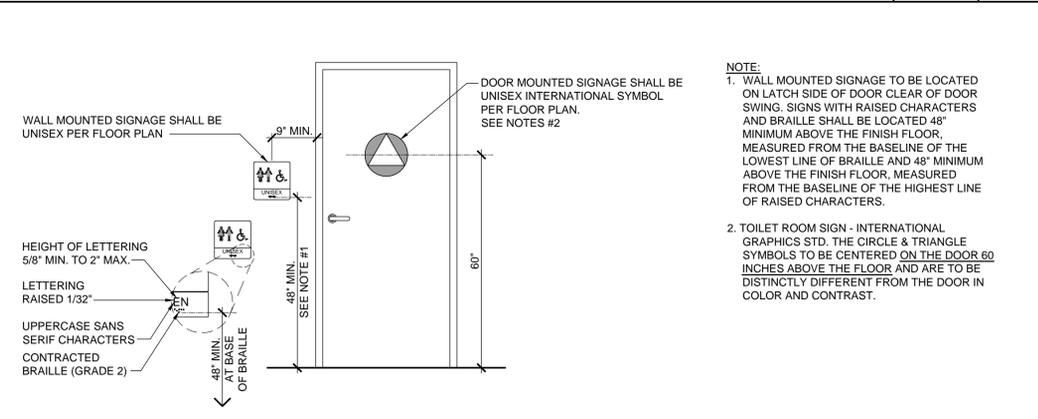

DOOR SIGNAGE - MOUNTING HEIGHTS

SCALE
 1/2" = 1'-0" 6

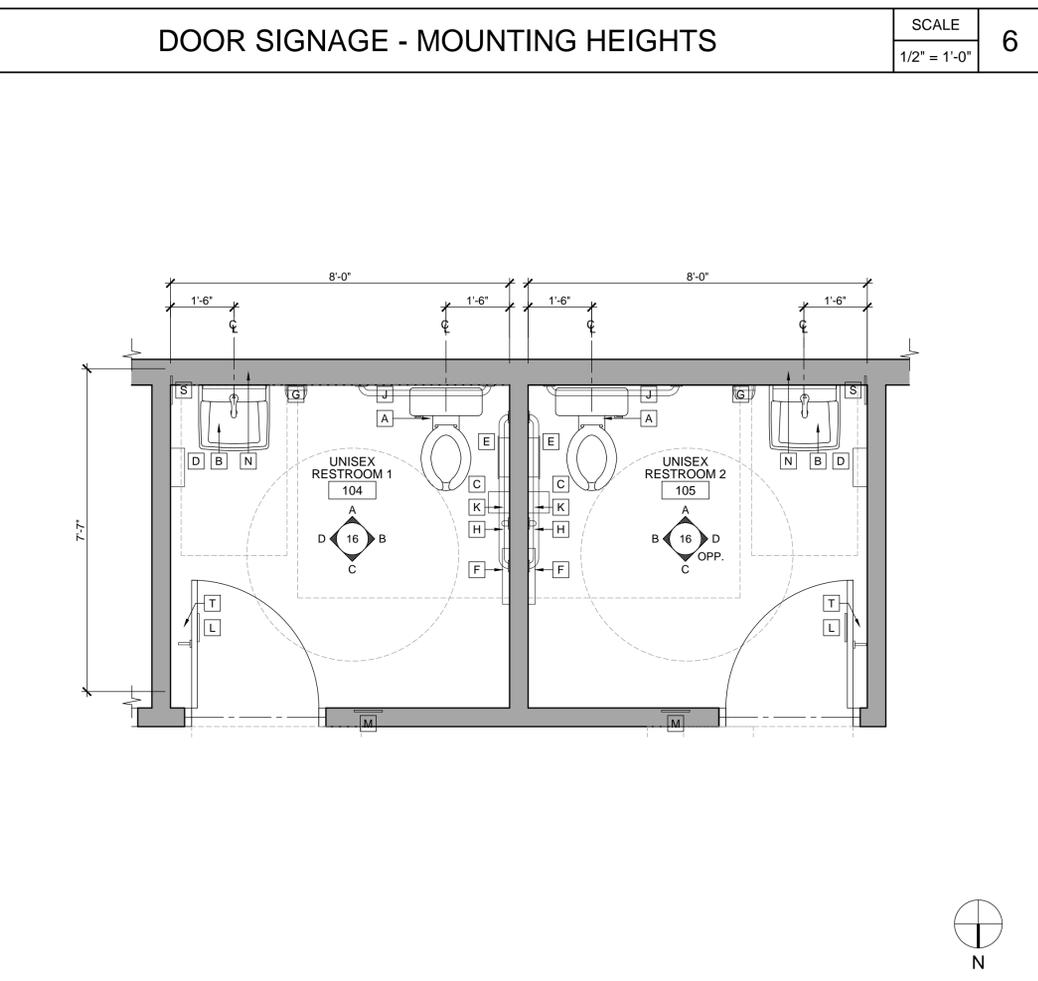

ENLARGED RESTROOM PLAN

SCALE
 1/2" = 1'-0" 8

RESTROOM ACCESSORIES

MARK	QTY	ITEMS	REMARKS
A	2	FLOOR MOUNTED ELONGATED TOILET	AMERICAN STANDARD ELONGATED TOILET 1.28 GPF OR EQUAL
B	2	WALL MOUNTED LAVATORY	AMERICAN STANDARD COMRADE MODEL #0124.024 OR EQUAL
B	2	ELECTRONIC LAVATORY FAUCET	SLOAN MODEL #EAF-200 OR EQUAL
C	2	INSULATE DRAIN AND HOT WATER PIPES	
D	2	SURFACE MOUNTED TOILET TISSUE DISPENSER	CINTAS - SIGNATURE SERIES SANDSTONE; OR EQUAL
E	2	AUTOMATIC PAPER TOWEL DISPENSER	CINTAS - SIGNATURE SERIES SANDSTONE; OR EQUAL
F	2	SURFACE-MOUNTED SANITARY NAPKIN DISPOSAL	BOBRICK MODEL #B-270 OR EQUAL
G	2	SURFACE MOUNTED SEAT-COVER DISPENSER	BOBRICK MODEL #B-221 CLASSICS SERIES (SATIN FINISH) OR EQUAL
H	2	AUTOMATIC HAND SOAP DISPENSER	CINTAS - SIGNATURE SERIES SANDSTONE; OR EQUAL
I	2	3'-6" GRAB BAR	BOBRICK MODEL #B-6806x42" (SATIN FINISH)
J	2	3'-0" GRAB BAR	BOBRICK MODEL #B-6806x36" (SATIN FINISH)
K	2	1'-6" VERTICAL GRAB BAR	BOBRICK MODEL #B-6806x18" (SATIN FINISH), OR EQUAL
L	2	DOOR MOUNTED SIGNAGE	
M	2	DOOR STRIKE SIDE MOUNTED ACCESSIBLE SIGNAGE	
N	2	MIRROR	BOBRICK MODEL #B-290 1836 SERIES (SATIN FINISH) OR EQUAL
P	-	URINAL	AMERICAN STANDARD PINTBROOK URINAL OR EQUAL AT 0.125 GPF
Q	-	URINAL SCREEN	BRADLEY - LEATHER GRAIN STAINLESS STEEL (SATIN FINISH), INCL. ALL HDW.
R	-	PARTITION	BRADLEY MODEL 400 SERIES - SENTINEL LEATHER GRAIN STAINLESS STEEL (SATIN BRUSH), FLR-MOUNTED OVERHEAD BRACED, OR EQUAL
S	2	SIGNAGE	SIGNAGE - CREW MUST WASH HANDS
T	2	COAT HOOK w/ BUMPER	BOBRICK MODEL #B-212 (SOLID CAST ALUM. w/ MATTE FINISH) OR EQUAL

REFER TO SHEET A8.2 FOR FINISH PLAN AND SCHEDULE.



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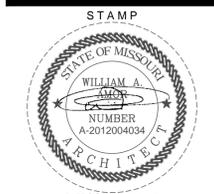


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PROJECT LOCATION
 SHEET TITLE
 ENLARGED RESTROOM PLAN,
 INTERIOR ELEVATIONS, AND DETAILS



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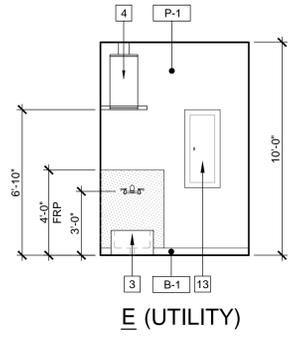
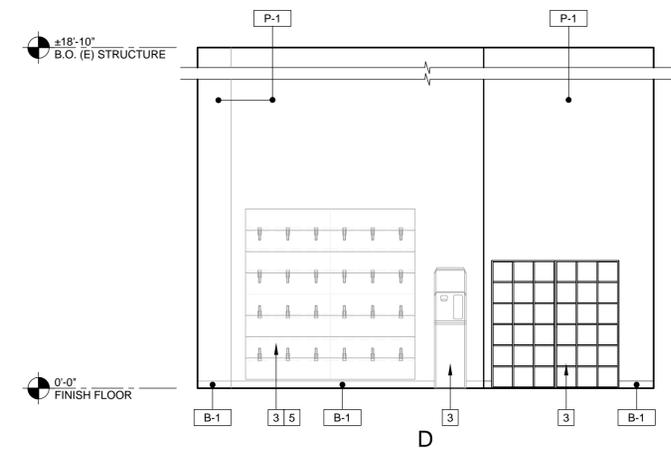
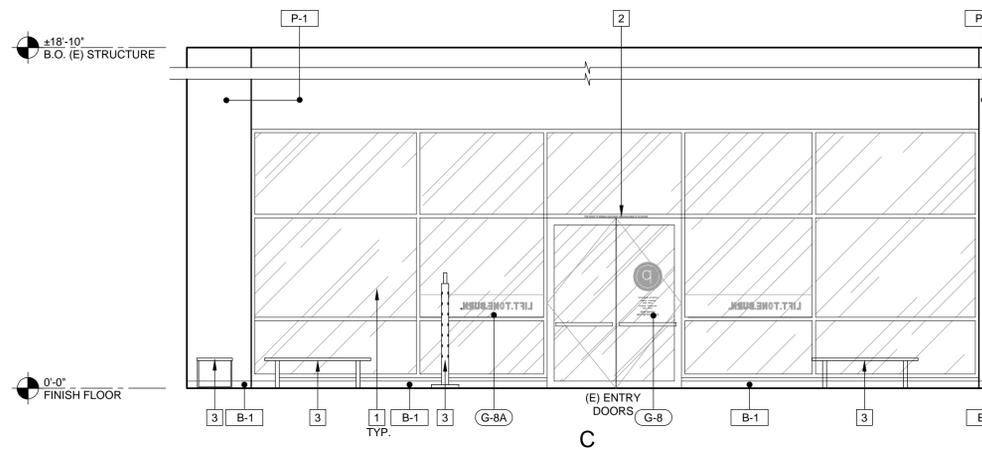
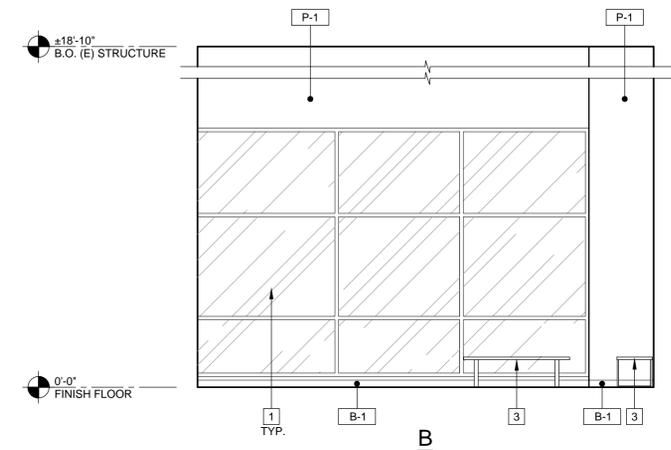
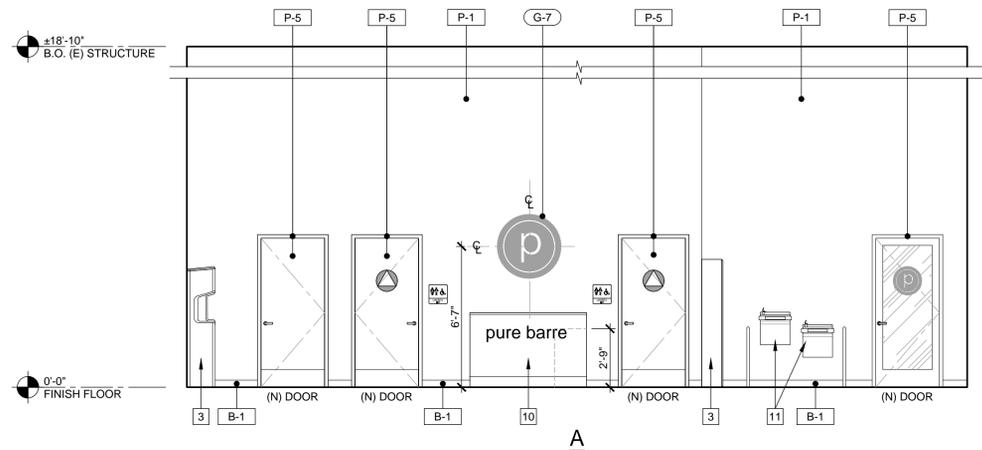
DATE
 2020.04.10
 PROJECT NUMBER
 A2275

SHEET NUMBER

A6.1

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INTERIOR ELEVATIONS @ SALES & COMMUNITY AREA

SCALE	6
1/4" = 1'-0"	

SIGNAGE/ GRAPHICS LEGEND

REFER TO GRAPHIC KEY ON SHEET A8.3





- (G-1) WALL GRAPHICS - STUDIO - PURE ENERGY
- (G-2) WALL GRAPHICS - STUDIO - LIFE TONE BURN
- (G-3) WALL GRAPHICS - STUDIO - LIFE TONE BURN 2
- (G-4) WALL GRAPHICS - STUDIO - LIFE TONE BURN 2
- (G-5) WALL GRAPHICS - STUDIO - CIRCLE GRAPHICS 1
- (G-6) WALL GRAPHICS - STUDIO - CIRCLE GRAPHICS 2
- (G-7) "P" LOGO BEHIND DESK
- (G-8) VINYL GRAPHICS ON GLAZING
- (G-8A) VINYL GRAPHICS ON GLAZING

NOTE:
CONTRACTOR TO PROVIDE AND INSTALL SOLID WOOD BLOCKING OR PLYWOOD FOR ALL WALL MOUNTED ITEMS. SIGNAGE, EQUIPMENT, MILLWORK, ETC. COORDINATE EXACT LOCATIONS w/ PURE BARRE CONSTRUCTION REPRESENTATIVE AS REQUIRED.

FINISH LEGEND

NOTE:
REFER TO FINISH SCHEDULE AND FINISH LEGEND ON SHEET A8.2 FOR SPECIFICATION OF ALL INTERIOR MATERIALS AND FINISHES

- WALLS
- (P-1) PAINT - FINISH LEGEND A8.2
 - (FRP) FIBER REINFORCED PLASTIC - FINISH LEGEND A8.2
- BASE
- (B-1) WALL BASE - FINISH LEGEND A8.2
- DOORS
- (P-5) PAINT - FINISH LEGEND A8.2
 - (P-6) PAINT - FINISH LEGEND A8.2

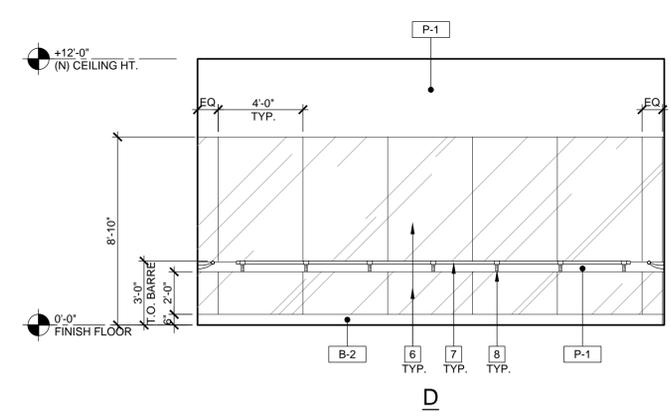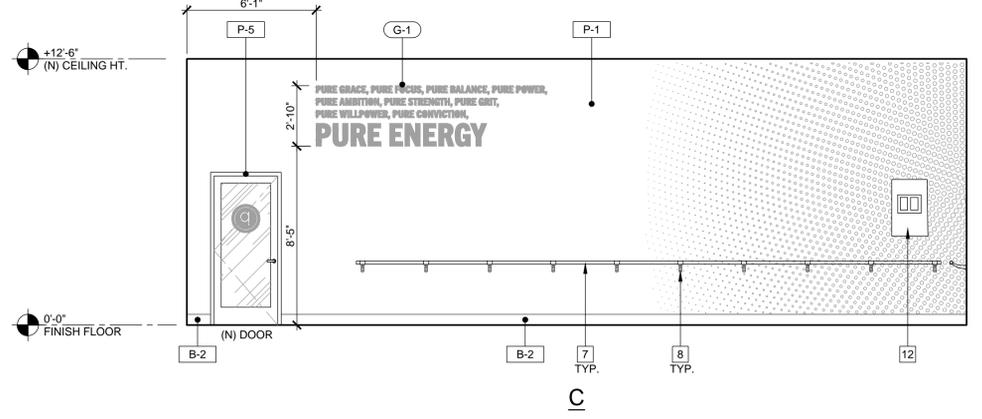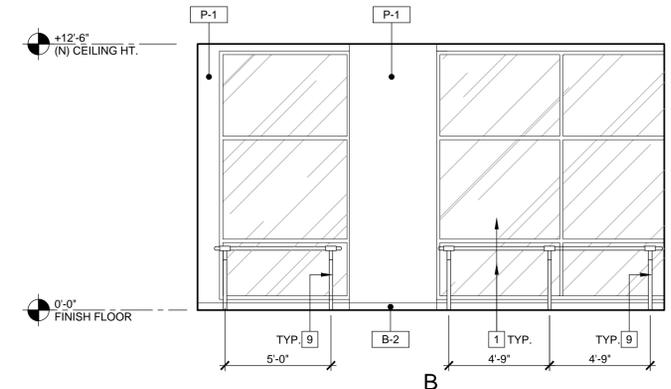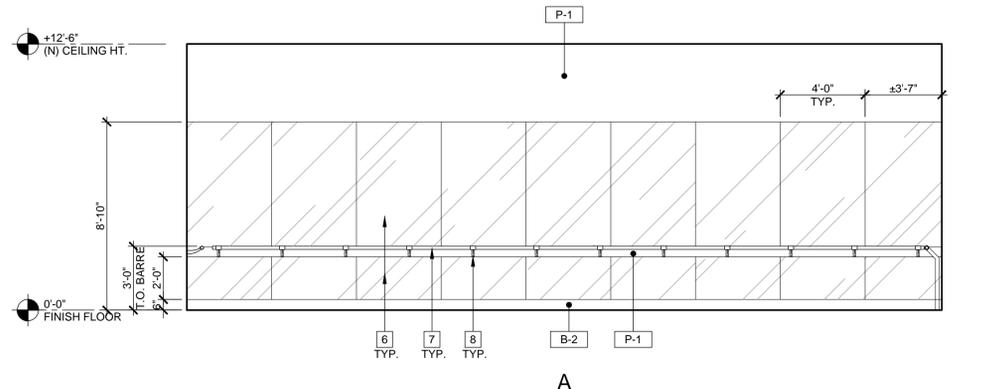

INTERIOR ELEVATIONS @ STUDIO

SCALE	8
1/4" = 1'-0"	

KEYNOTES

- 1 (E) FIXED STOREFRONT WINDOW TO REMAIN
- 2 (E) "THIS DOOR TO REMAIN UNLOCKED WHEN BUILDING IS OCCUPIED" - ADD DECAL
- 3 (N) EQUIPMENT AND MILLWORKS. SEE EQUIPMENT LIST ON SHEET A1.1
- 4 (N) WATER HEATER AND SUSPENDED PLATFORM WITH DRAIN PAN. PROVIDE CLEARANCE AS NEEDED PER MANUFACTURER'S DETAILS FOR SERVICING BETWEEN CEILING AND TANK. (16) (A8.1)
- 5 G.C. TO PROVIDE SUFFICIENT BACKING FOR WALL MOUNT EQUIPMENT
- 6 (2) MIRRORS: (1st) MOUNTED AT TOP OF BASE TO UNDERSIDE OF BARRE BRACKET. (2nd) MOUNTED ABOVE BARRE BRACKET TO 8'-10" AFF. (2) (A1.3)
- 7 (N) 1 3/4" DIA. WOOD BARRE. BARRE HEIGHT 36" AFF. (2) (A1.3)
- 8 (N) BARRE SYSTEM BRACKET. PROVIDE BLOCKING IN WALL AT BARRE MOUNTS (2) (A1.3)
- 9 (N) PURE BARRE METALLIC SILVER FLOOR STANCHION 36" (FIXED HEIGHT)
- 10 (N) RECEPTION DESK WITH ADA COUNTER
- 11 (N) HIGH-LOW DRINKING FOUNTAIN
- 12 (N) AV RACK
- 13 (N) ELECTRICAL PANEL. SEE ELECTRICAL DRAWINGS.



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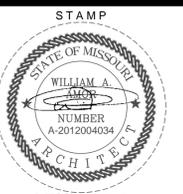
CONSULTANT

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LEE'S SUMMIT, MO 64086

INTERIOR ELEVATIONS

PROJECT LOCATION

SHEET TITLE



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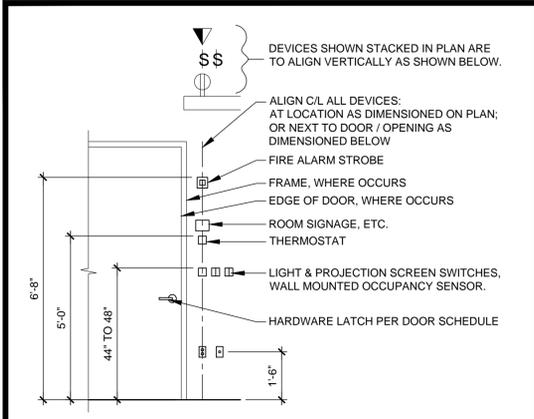
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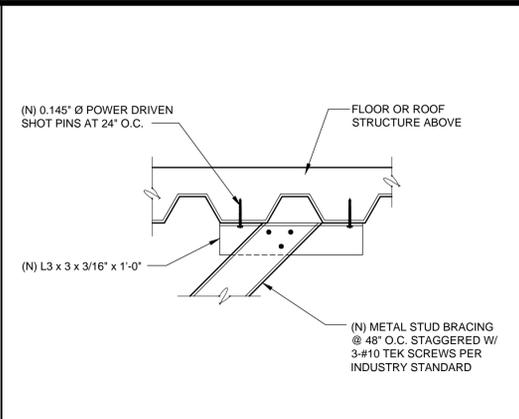
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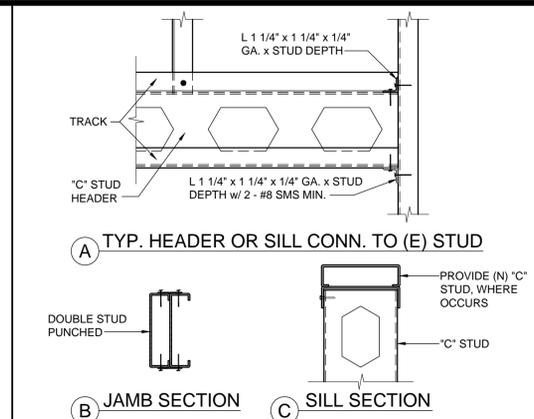
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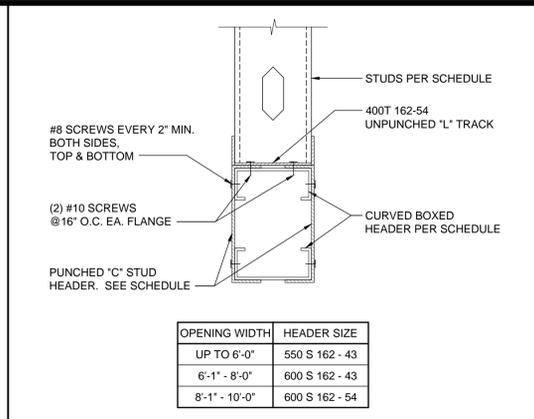
TYPICAL ELECTRICAL HEIGHTS SCALE: 1/2" = 1'-0" 17




BRACING @ METAL DECK SCALE: 1/2" = 1'-0" 13




STUD CONNECTION SCALE: 3" = 1'-0" 9




BOX HEADER SCALE: 3" = 1'-0" 5

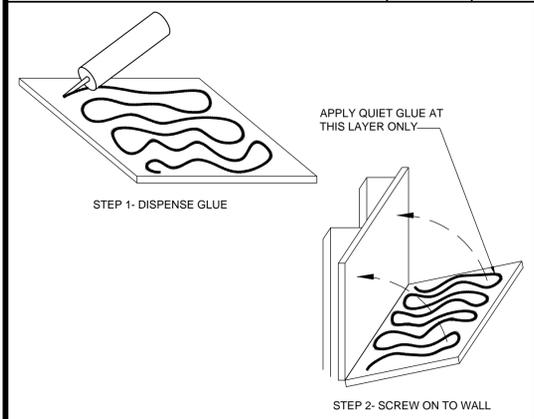


QUIET GLUE SCALE: 1/2" = 1'-0" 18

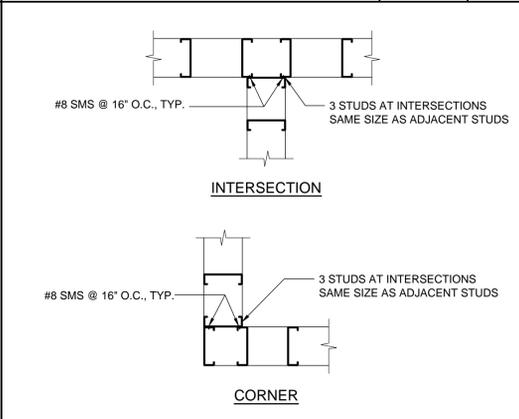


TYP. STUD FRAMING SCALE: 1/2" = 1'-0" 14

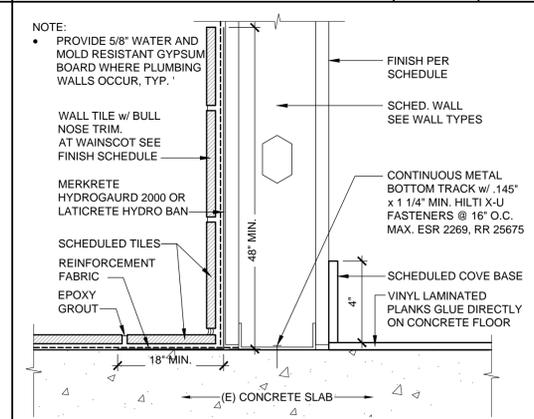


WALL BASE DETAIL SCALE: 3" = 1'-0" 10

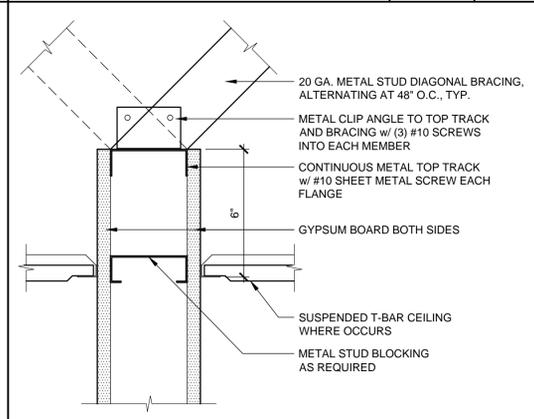


TOP TRACK BRACING SCALE: 3" = 1'-0" 6

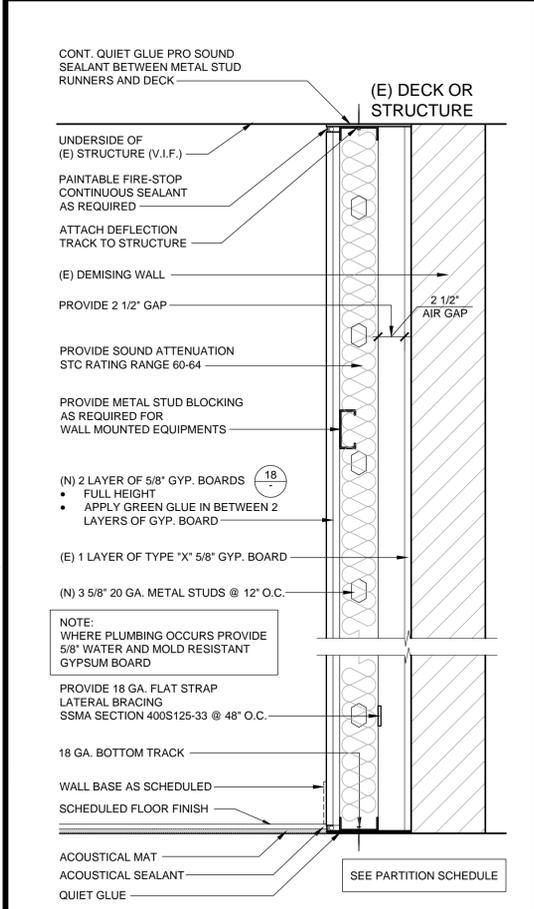


WALL FURRING @ DEMISING WALL SCALE: 1/2" = 1'-0" 20

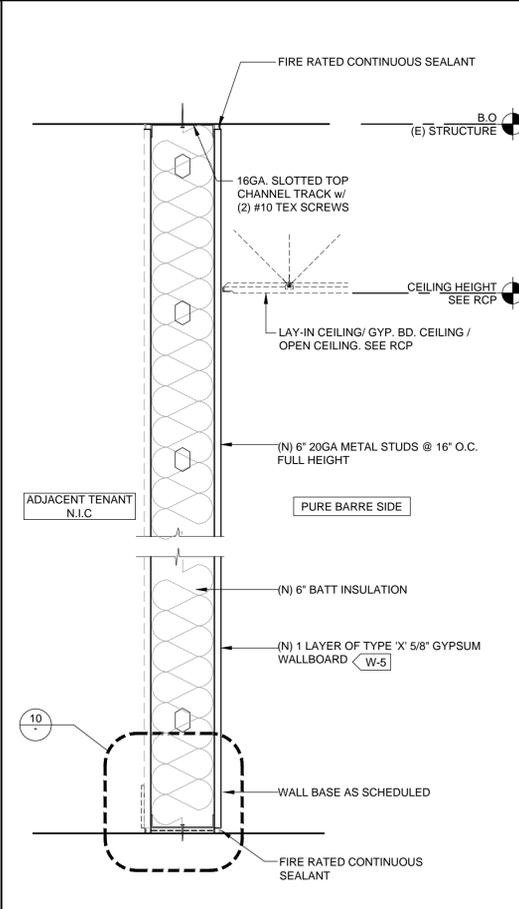

1-HR FIRE RATED DEMISING WALL SCALE: 1/2" = 1'-0" 16

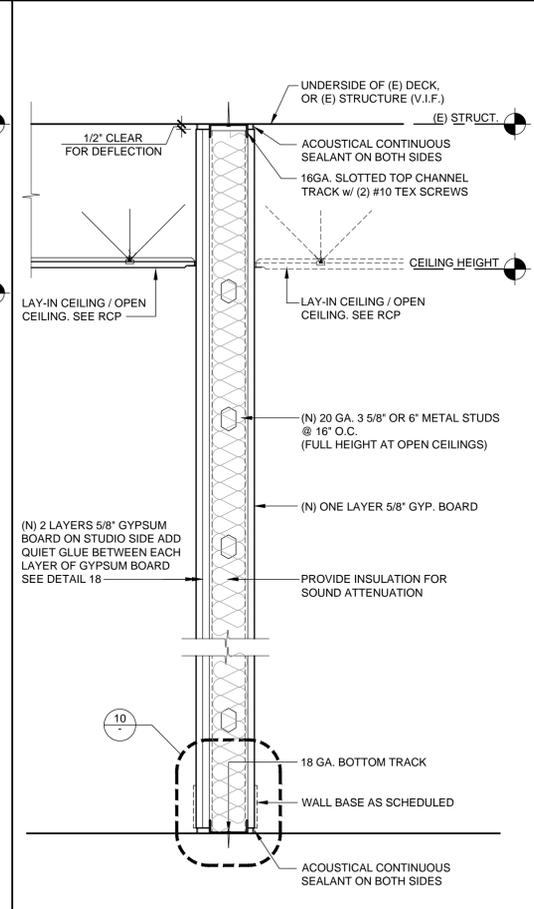

WALL PARTITION SCALE: 1/2" = 1'-0" 12

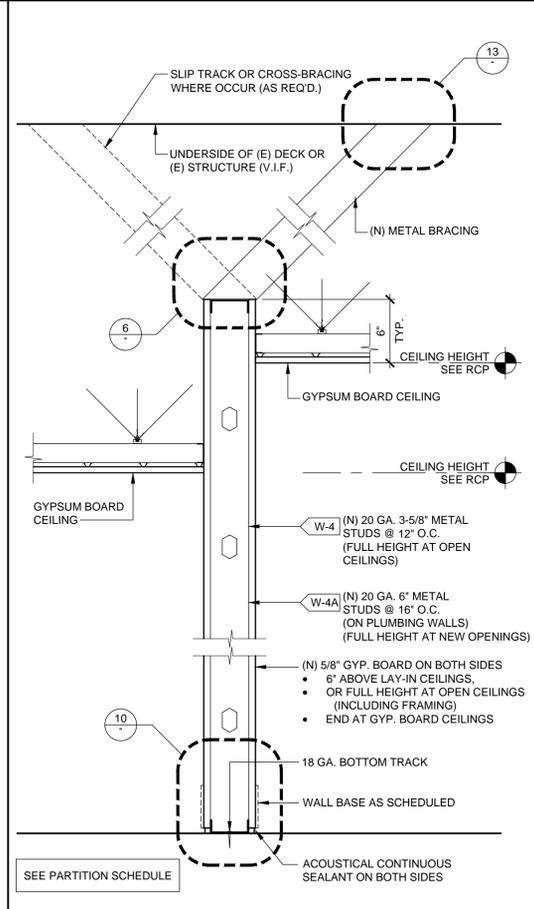

WALL PARTITION NON RATED SCALE: 1/2" = 1'-0" 8

- ### FRAMING NOTES
- GALVANIZED STEEL MUST MEET THE MINIMUM REQUIREMENTS OF ASTM A446 GRADE D (Fy=50KSI) FOR 12 GAUGE, ASTM A446 GRADE A (Fy=33KSI) FOR 14 & 16 GAUGE, AND ASTM A446 GRADE A (Fy=33KSI) FOR 18 GAUGE AND LIGHTER FOR THE ITEM AND USE INTENDED. GALVANIZED COATINGS MUST MEET THE ASTM A525 SPECIFICATIONS.
 - CARBON SHEET STEEL MUST MEET THE MINIMUM REQUIREMENTS OF ASTM A570 GRADE 50 KSI FOR 12 GAUGE, ASTM A570 GRADE 50 KSI OR GRADE 33 KSI FOR 14 & 16 GAUGE AND GRADE 33 KSI FOR 18 GAUGE AND LIGHTER MEMBERS. CARBON SHEET STEEL PRODUCTS MUST BE THOROUGHLY COATED WITH A RUST INHIBITIVE PAINT.
 - ALL STRUCTURAL MEMBERS SHALL BE DESIGNED IN ACCORDANCE WITH AMERICAN IRON AND STEEL INSTITUTE (AISI) SPECIFICATION FOR THE DESIGN OF COLD-FORMED STEEL STRUCTURAL MEMBERS' 2010 EDITION WITH SUPPLEMENT 2.
 - METAL STUDS AND / OR JOISTS:
 - FOR METAL STUD WALLS, UNLESS OTHERWISE SHOWN ON THE DRAWINGS, PROVIDE STANDARD PUNCHED STEEL MEMBERS OF THE GAUGES SHOWN ON THE DRAWINGS.
 - USE ONLY ONE TYPE THROUGHOUT THE WORK, UNLESS OTHERWISE SHOWN ON THE DRAWINGS OR SPECIFICALLY APPROVED IN ADVANCE BY THE ENGINEER AND/OR ARCHITECT.
 - ACCESSORIES: PROVIDE ALL ACCESSORIES INCLUDING, BUT NOT NECESSARILY LIMITED TO, TRACKS, CLIPS, WEB STIFFENERS, ANCHORS, FASTENING DEVICES, RESILIENT CLIPS, AND OTHER ACCESSORIES REQUIRED FOR A COMPLETE AND PROPER INSTALLATION, AND AS RECOMMENDED BY THE MANUFACTURER FOR THE STEEL MEMBERS USED.
 - FASTENING OF COMPONENTS SHALL BE WITH SELF-DRILLING SCREWS OR WELDING SCREWS OR WELDS SHALL BE OF SUFFICIENT SIZE TO INSURE THE STRENGTH OF THE CONNECTION. ALL WELDS OF GALVANIZED STEEL SHALL BE TOUCHED UP WITH A ZINC RICH PAINT. ALL WELDS OF CARBON SHEET STEEL SHALL BE TOUCHED UP WITH PAINT.
 - PROVIDE A GOOD GRADE OF COMMERCIAL GROUT FOR LEVELING THE FLOOR RUNNER MEMBER OF STEEL STUD PARTITIONS AS REQUIRED.

- ### PARTITION SCHEDULE
- ALL THE METAL STUDS USED SHALL BE "ICC-ES" TYPE OR APPROVED EQUAL.
 - THE BRIDGING, BLOCKING OR END BEARING STIFFENERS SHALL BE AS REQUIRED BY THE MANUFACTURER UNLESS NOTED OTHERWISE ON THE DRAWINGS.
 - ALL THE STUDS SHALL CONFORM TO "ICC-ES EVALUATION REPORT" ESR-3064P OR APPROVED EQUAL.
 - UNLESS OTHERWISE NOTED ON THE PLANS, USE THE FOLLOWING GUIDELINE FOR STUD SIZE & SPACING FOR INTERIOR PARTITIONS.
 - TOP TRACK SIZE WILL BE 20 GA. MINIMUM FOR PARTITION, U.N.O.
 - SCAFCO SLOTTED TRACK, 400SLT250-43 OR 600SLT250-33, 18 GA. "ICC-ES EVALUATION REPORT" ESR-3064P OR APPROVED EQUAL.

SIZE	MAXIMUM PARTITION HEIGHT (5psf L/240)			
	SPACING	HEIGHT (COMPOSITE)	HEIGHT (NON-COMP.)	HEIGHT (BRACED 48" OC)
362 S 125 - 33	12"	19' - 2"	17' - 7"	17' - 8"
362 S 125 - 33	16"	17' - 5"	16' - 0"	16' - 1"
400 S 125 - 33	16"	18' - 3"	17' - 3"	17' - 4"
600 S 125 - 33	16"	25' - 6"	23' - 9"	23' - 11"

METAL JOIST SCHEDULE

- USE "ICC-ES EVALUATION REPORT" ESR-3064P OR APPROVED EQUAL.
- USE 600S125-43 @ 16" O.C. UP TO 16'-0" MAXIMUM SPAN WHERE CEILING SUPPORTED TOILET PARTITIONS OCCUR.
- STUD TRACKS SHALL BE UNPUNCHED STUDS OF SAME GAUGE AS STUD UNLESS NOTED OTHERWISE.
- ACOUSTIC CEILING TIES (SEE FINISH SCHEDULE) WITH 1 - #8 SCREWS AT EACH JOIST.

GYPSUM BOARD CEILING	CEILING TIES (BRACING) SPACING	SIZE	MAXIMUM SPAN		MAXIMUM SPAN	
			SPACING	SPAN	SPACING	SPAN
	4' - 0"	362 S 125 - 30	16"	8' - 0"	24"	7' - 0"
	3' - 6"	550 S 125 - 30	16"	11' - 0"	24"	9' - 0"
	3' - 6"	600 S 125 - 30	16"	16' - 0"	24"	13' - 0"

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WALL AND MISCELLANEOUS DETAILS

PROJECT LOCATION SHEET TITLE

STAMP

STATE OF MISSOURI
WILLIAM A. HILTON
ARCHITECT
NUMBER A-2012004034

DATE SIGNED: 2020-04-13
RENEWAL DATE: 2020-12-31
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REVISIONS

DATE: 2020.04.10
PROJECT NUMBER: A2275

SHEET NUMBER

PERMIT SET : 2020_04_10

A7.1

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LUMINAIRE SCHEDULE

Luminaire Schedule (Issue: July 29th, 2019)		Project No. 90217		Pure Barre - Prototype					
Contact Mike Herrell with Commercial Lighting Industries, 800-755-0155 x124, MHerrell@Commercial-Lighting.net for pricing									
Fixture Type	Reference Image	Description	Dimming Interface	Product Registration ID	Lamps, CCT, Lumen, Optics, CRI	Input Voltage	Fixture Wattage	Mounting, Finishes, Remarks & Other Notes	
ARCHITECTURAL FIXTURE TYPES									
A		Recessed 2x4 LED Troffer, Direct/Indirect	0-10 (10% Default)	CLI-NAPBA	LED Module, 3500K, 5400 lm	120/277	57	Recessed mount in Studio	
B		6" Recessed LED Downlight	0-10V (1%)	CLI-NAPBB	LED Module, 3500K, 1500 lm, 80 CRI	120/277	13	Recessed mount in Restroom	
EMERGENCY FIXTURE TYPES									
EM		2-Head LED Emergency Light, high lumen, remote capable	N/A	CLI-NAPBEM	LED Incl	DV	2	Wall mount. Self Diagnostics. Finish color to be verified by Architect.	
EXEM		Exit, Sngl/DbL, Red letters, emergency light combination, high lumen, universal mount, Self Powered, remote capable	N/A	CLI-NAPBEXEM	2-LED Incl	DV	3	Universal Wall or Ceiling. Finish color to be verified by Architect.	
EX		Exit Sign, Sngl/DbL, Red letters, emergency light combination, universal mount	N/A	CLI-NAPBEX	LEDM	DV	TBD	Universal Wall or Ceiling. Finish color to be verified by Architect. Damp location rated.	

DOOR SCHEDULE

NO.	ROOM NAME	DOOR				SET NO.	FRAME				REMARKS
		SIZE	THK.	TYPE	MAT'L		FINISH	MAT'L	FINISH	HEAD	
101	SALES AREA / CHECK IN	PR 3'-0" x 7'-0"	(E)	(E)	(E)	4	(E)	(E)	(E)	(E)	
102	UTILITY	3'-0" x 7'-0"	1-3/4"	A	S.C.	P-5 /P-6	1	H.M.	P-5 /P-6	4/A8.1	8/A8.1
103	UNISEX RESTROOM 1	3'-0" x 7'-0"	1-3/4"	A	S.C.	P-5 /P-6	3	H.M.	P-5 /P-6	4/A8.1	8/A8.1
104	UNISEX RESTROOM 2	3'-0" x 7'-0"	1-3/4"	A	S.C.	P-5 /P-6	3	H.M.	P-5 /P-6	4/A8.1	8/A8.1
105	PURE BARRE STUDIO	3'-0" x 7'-0"	1-3/4"	B	S.C.	P-5	2	H.M.	P-5	4/A8.1	8/A8.1

DOOR AND HARDWARE NOTES


- G.C. TO VERIFY THAT EXISTING DOORS TO REMAIN ARE IN GOOD WORKING CONDITION.
 - ALL EXISTING DOORS TO REMAIN SHALL KEEP THE EXISTING HARDWARE U.N.C. OR FOUND TO NOT FUNCTION PROPERLY. G.C. TO CLEAN AND REPAIR HARDWARE TO AS-NEW CONDITION.
 - NEW BEST LOCK LEVER TYPE HARDWARE. FINISH TO MATCH EXISTING. G.C. TO VERIFY IN FIELD.
 - EXIT DOORS SHALL BE OPERABLE FROM THE INSIDE WITHOUT THE USE OF A KEY OR SPECIAL KNOWLEDGE OR EFFORT.
 - G.C. TO PROVIDE SIGNAGE ON PRIMARY EGRESS DOORS STATING "THIS DOOR TO REMAIN UNLOCKED WHEN THIS SPACE IS OCCUPIED."
 - ALL FINISH HARDWARE SHALL COMPLY WITH ALL GOVERNING CODES AND ACCESSIBILITY CODES.
 - ALL DOOR EDGES SHALL BE PRIMED AND PAINTED. VERIFY COLOR WITH INTERIOR ELEVATIONS.
 - G.C. SHALL PROVIDE A FLOOR MOUNTED DOOR STOP FOR DOORS THAT SWING AGAINST THE WALL.
 - ALL DOOR SILENCERS SHALL BE INSTALLED AFTER DOOR AND FRAME HAVE RECEIVED FINAL PAINTED.
 - INSTALL CAULKING AROUND DOOR FRAME JAMBS, HEAD AND AT BOTTOM OF FRAME.
 - DOOR OPENING FORCE: FIRE DOORS SHALL HAVE A MINIMUM OPENING FORCE ALLOWABLE BY THE APPROPRIATE ADMINISTRATIVE AUTHORITY. THE MAXIMUM FORCE FOR PUSHING OR PULLING OPEN, EXTERIOR OR INTERIOR HINGED DOORS WITH CLOSERS AND SLIDING OR FOLDING DOORS, SHALL NOT EXCEED FIVE POUNDS (22.2 N) MAXIMUM.
 - HANDLES, PULLS, LATCHES, LOCKS, AND OTHER OPERABLE PARTS ON DOORS AND GATES SHALL COMPLY WITH CODE. OPERABLE PARTS SHALL BE OPERABLE WITH ONE HAND AND SHALL NOT REQUIRE TIGHT GRASPING, PINCHING OR TWISTING OF THE WRIST. OPERABLE PARTS OF SUCH HARDWARE SHALL BE 34" MINIMUM AND 48" MAXIMUM ABOVE THE FINISH FLOOR OR GROUND. WHERE SLIDING DOORS ARE IN FULLY OPEN POSITION, OPERATING HARDWARE SHALL BE EXPOSED AND USABLE FROM BOTH SIDES.
- SET # 1: UTILITY DOOR**
- | | | | |
|---------------------|-----------------------------|-------|-----------------------------|
| 3 HINGES | FBB179-4 1/2 x 4 1/2 NRP | US26D | STANLEY |
| 1 STOREROOM LOCKSET | QCL271 478S LC | 626 | STANLEY COMMERCIAL HARDWARE |
| 1 CYLINDER | OWNER STANDARD | 626 | BEST TRIMCO |
| 1 KICK PLATE | K0050 10"x2" LDWX X CSK B4E | 630 | TRIMCO |
| 1 WALL BUMPER | 1270WV | 630 | TRIMCO |
| 3 DOOR SILENCERS | 1229 SERIES | GREY | TRIMCO |
- SET # 2: STUDIO DOOR**
- | | | | |
|-------------------|--------------------------|-------|-----------------------------|
| 3 HINGES | FBB179-4 1/2 x 4 1/2 NRP | US26D | STANLEY |
| 1 PRIVACY LOCKSET | QCL255 E 478S | 626 | STANLEY COMMERCIAL HARDWARE |
| 1 CYLINDER | OWNER STANDARD | 626 | BEST TRIMCO |
| 1 WALL BUMPER | 1270WV | 630 | TRIMCO |
| 3 DOOR SILENCERS | 1229 SERIES | GREY | TRIMCO |
- SET # 3: RESTROOM DOOR**
- | | | | |
|------------------------------|-----------------------------|-------|-----------------------------|
| 3 HINGES | FBB179-4 1/2 x 4 1/2 NRP | US26D | STANLEY |
| 1 PRIVACY LOCKSET | QCL240 E 478S | 626 | STANLEY COMMERCIAL HARDWARE |
| 1 CLOSURE | 8916-AFP | 689 | DORMA |
| 1 KICK PLATE | K0050 10"x2" LDWX X CSK B4E | 630 | TRIMCO |
| 1 WALL BUMPER | 1270WV | 630 | TRIMCO |
| 1 SOLID THRESHOLD PER DETAIL | | | |
| 3 DOOR SILENCER | 1229 SERIES | GREY | TRIMCO |
- SET # 4: ENTRY/EXITING DOOR**



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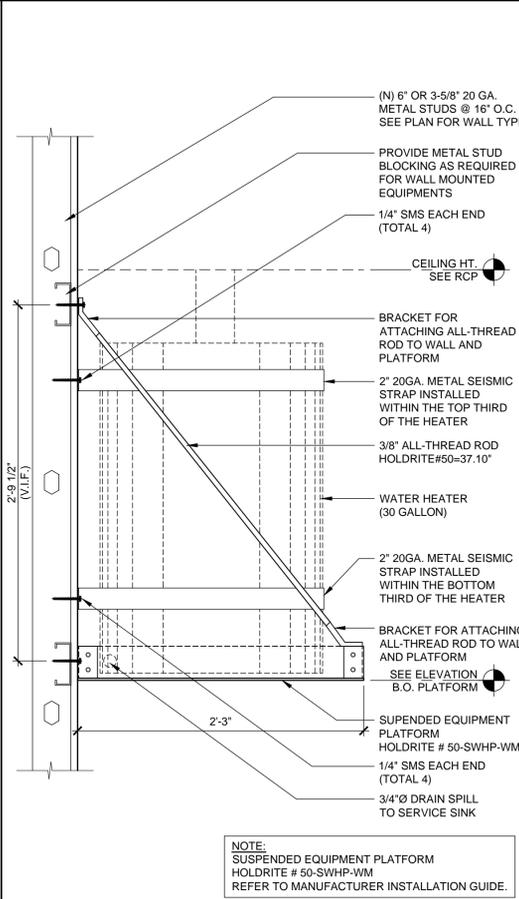
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SHEET TITLE
DOOR SCHEDULE AND HARDWARE NOTES & DETAILS




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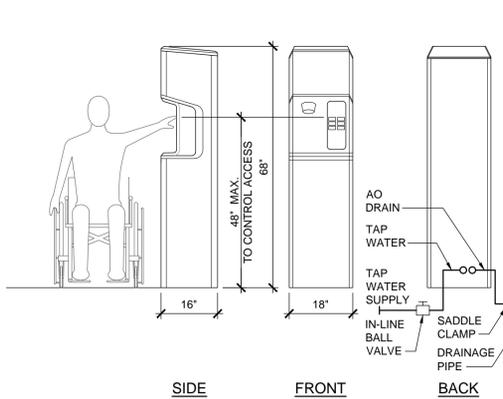
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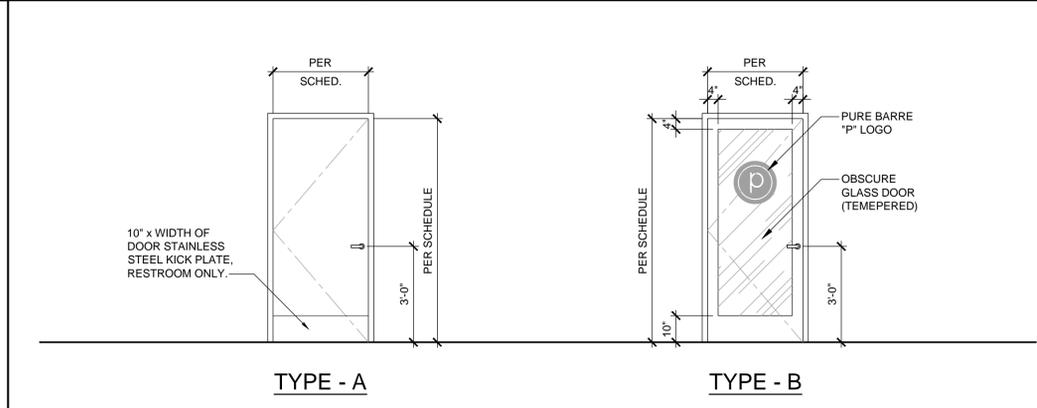
SUSPENDED PLATFORM DETAILS
SCALE: 1 1/2" = 1'-0"
16

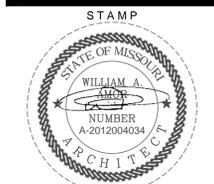


THRESHOLD DETAIL
SCALE: 3" = 1'-0"
11




ADA COMPLIANCE WATER DISPENSER
SCALE: 1/2" = 1'-0"
12

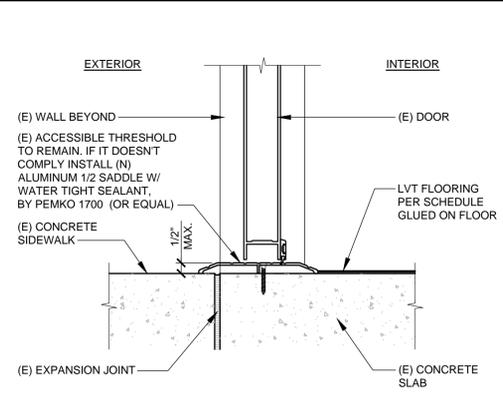

DOOR TYPES
SCALE: 3/8" = 1'-0"
3

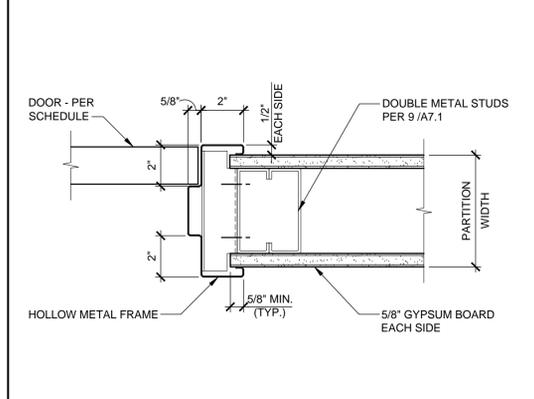


INTERIOR DOOR JAMB
SCALE: 3" = 1'-0"
8

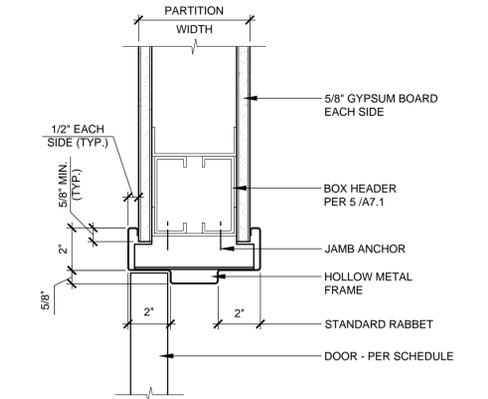


INTERIOR DOOR HEAD
SCALE: 3" = 1'-0"
4


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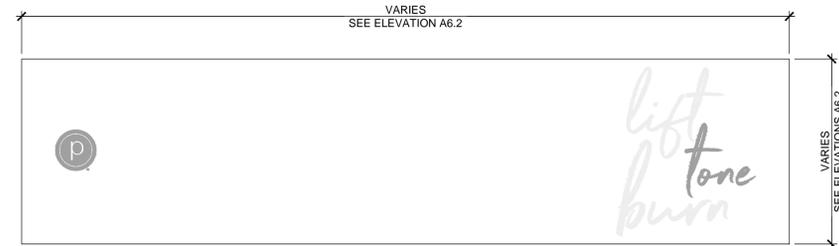
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STUDIO GRAPHICS - OPTION 5

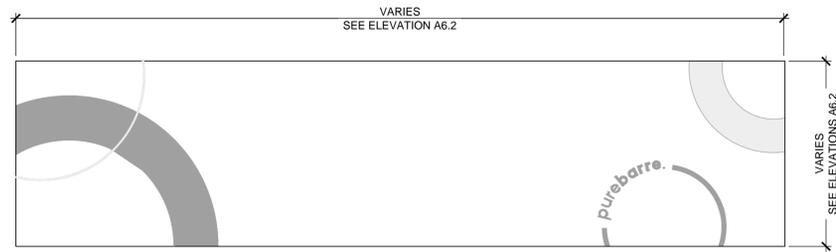


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STUDIO GRAPHICS - OPTION 1

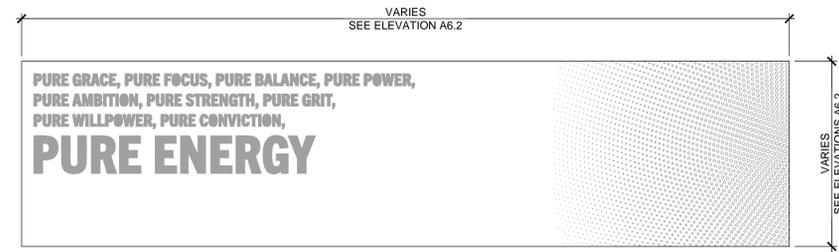


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STUDIO GRAPHICS - OPTION 6

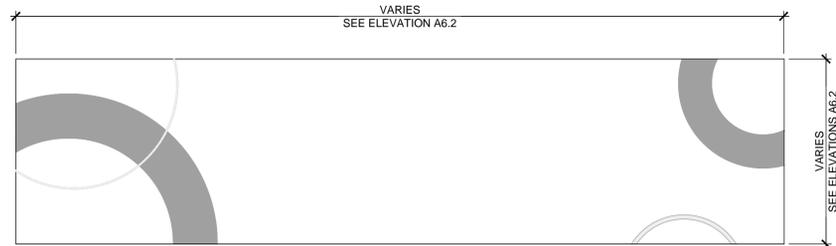


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STUDIO GRAPHICS - OPTION 2

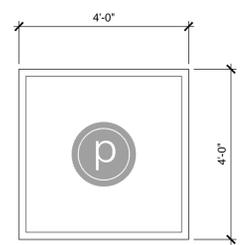


G-7
"P" LOGO BEHIND FRONT DESK

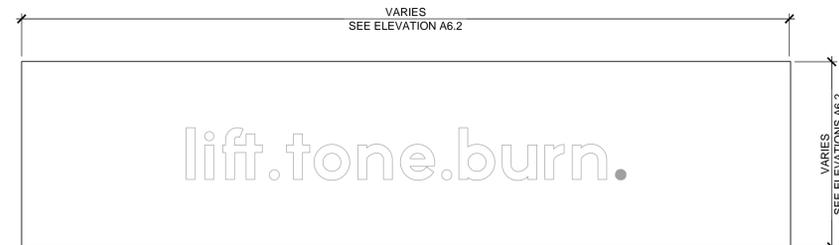


G-3
STUDIO GRAPHICS - OPTION 3

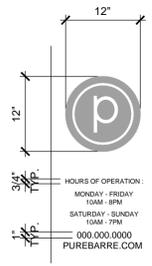

G-8
VINYL ADHESIVE ON GLAZING

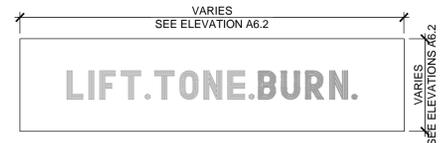

G-8A
VINYL ADHESIVE ON GLAZING

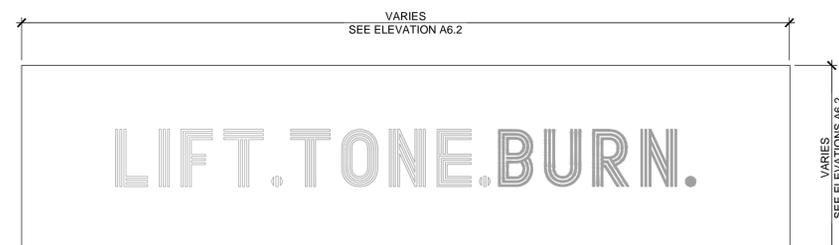

G-4
STUDIO GRAPHICS - OPTION 4

NOTE:
GENERAL CONTRACTOR TO COORDINATE
WITH OWNER'S SIGNAGE VENDOR

WALL SIGNAGE AND GRAPHICS

SCALE
1/2"=1'-0"

4



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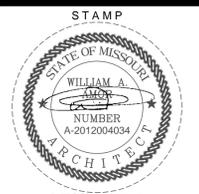
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PROJECT LOCATION
WALL SIGNAGE AND GRAPHICS
SHEET TITLE



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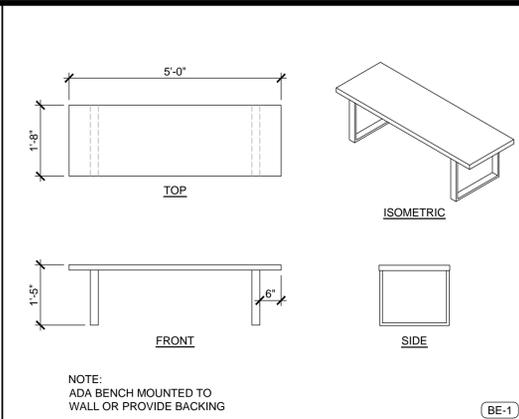
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PROJECT NUMBER
A2275

SHEET NUMBER


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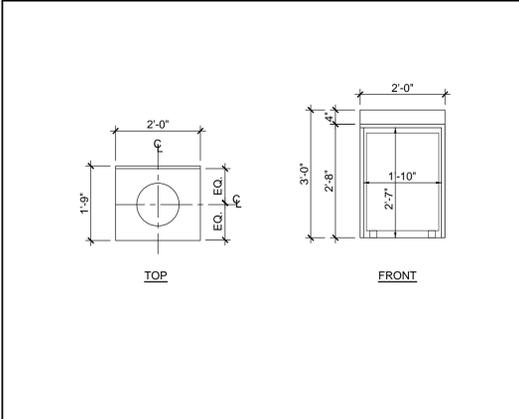
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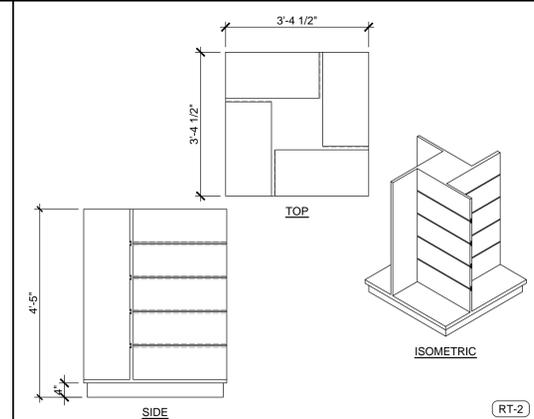
LOBBY - BENCH SCALE 13
1/2" = 1'-0"




LOBBY - 2-WAY DISPLAY SCALE 9
1/2" = 1'-0"



LOBBY - TOWEL BIN SCALE 14
1/2" = 1'-0"

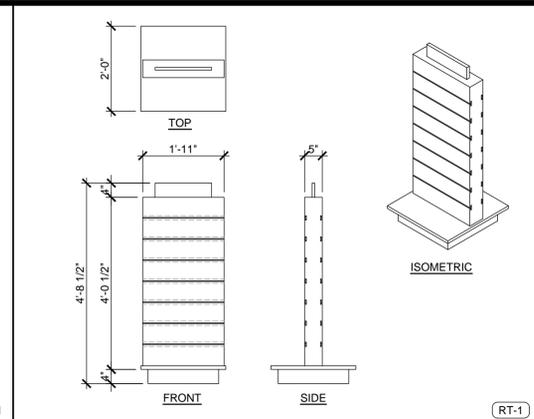

LOBBY - 4-WAY DISPLAY SCALE 10
1/2" = 1'-0"

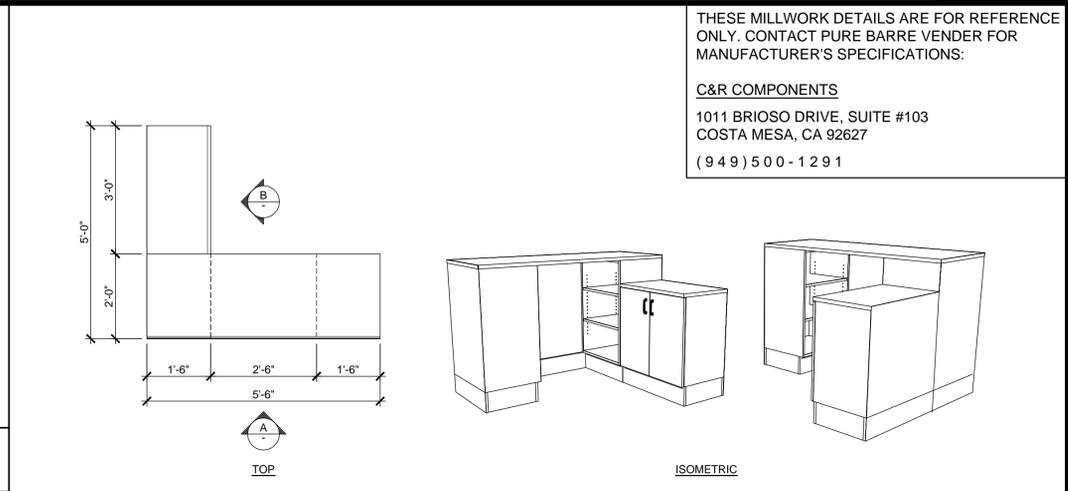


LOBBY - FRONT DESK SCALE 2
1/2" = 1'-0"

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C&R COMPONENTS
1011 BRIOSO DRIVE, SUITE #103
COSTA MESA, CA 92627
(949) 500-1291


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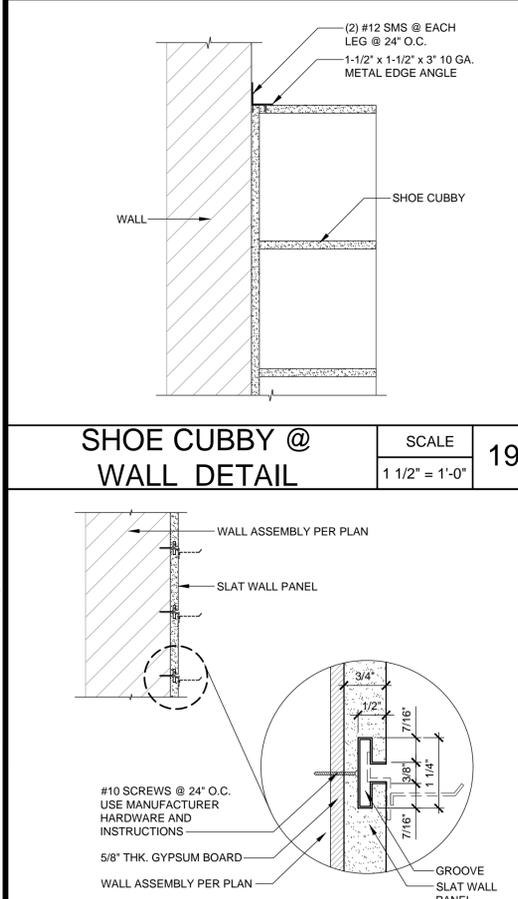
SHOE CUBBY @ WALL DETAIL SCALE 19
1 1/2" = 1'-0"



RETAIL - SLAT WALL SCALE 12
1/2" = 1'-0"

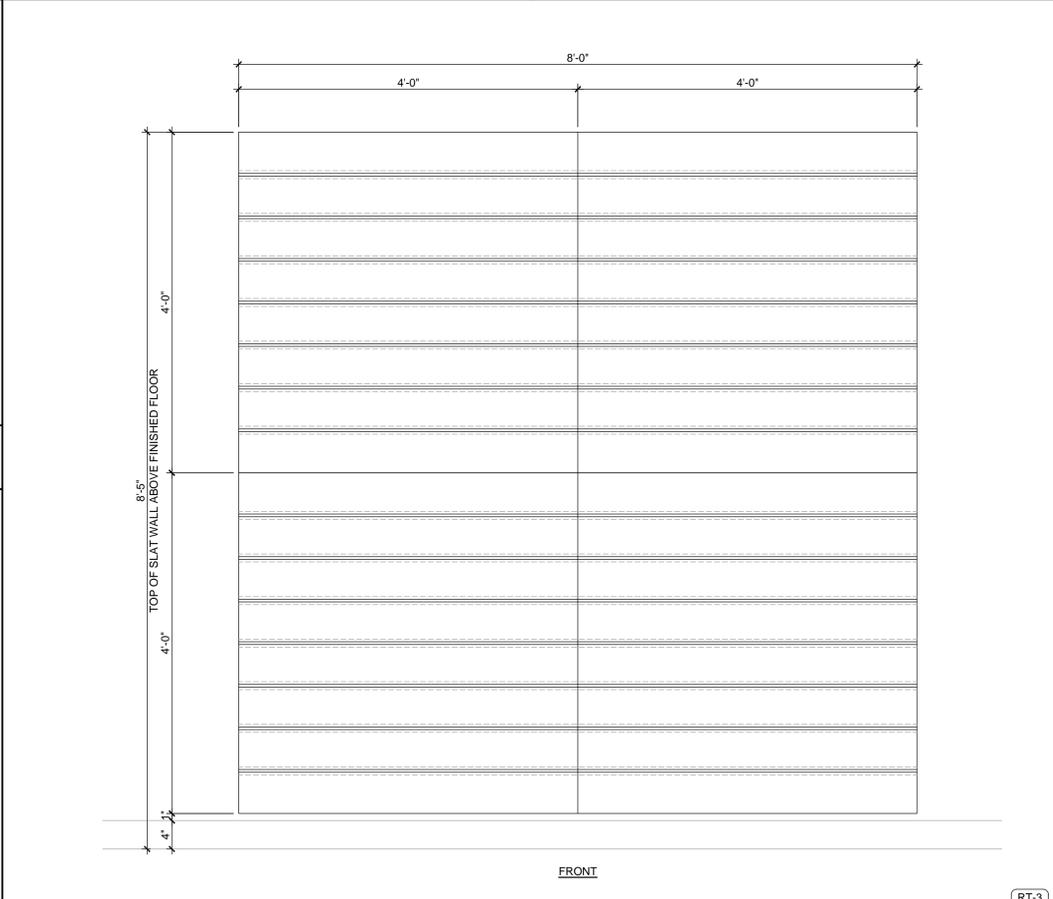

LOBBY - CUBBIES SCALE 4
1/2" = 1'-0"

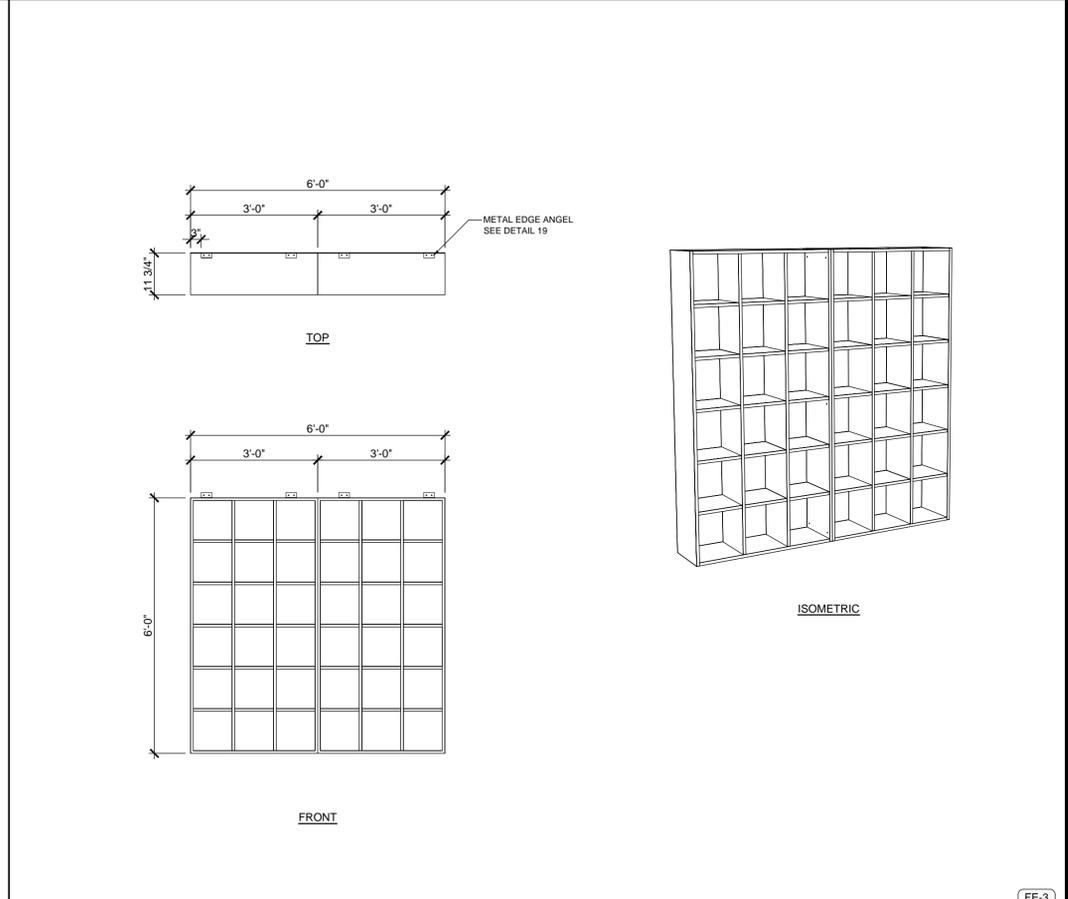

SLAT WALL CONNECTION DETAIL SCALE 20
1 1/2" = 1'-0"

PURE BARRE
INTERIOR TENANT IMPROVEMENT
910-U NORTHWEST BLUE PARKWAY
LEE'S SUMMIT, MO 64086
PROJECT LOCATION
MILLWORK DETAILS (FOR REFERENCE ONLY)
SHEET TITLE
STAMP
STATE OF MISSOURI
WILLIAM A. HILTON
ARCHITECT
NUMBER A-2012004034
DATE SIGNED: 2020-04-13
RENEWAL DATE: 2020-12-31
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REVISIONS
DATE 2020.04.10
PROJECT NUMBER A2275
SHEET NUMBER
A8.4
PERMIT SET : 2020_04_10

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TESTING, ADJUSTING, AND BALANCING	
1.1 QUALITY ASSURANCE	<p>A. TAB SPECIALISTS QUALIFICATIONS: CERTIFIED BY AABC.</p> <p>1. TAB FIELD SUPERVISOR: EMPLOYEE OF THE TAB SPECIALIST AND CERTIFIED BY AABC.</p> <p>2. TAB TECHNICIAN: EMPLOYEE OF THE TAB SPECIALIST AND CERTIFIED BY AABC AS A TAB TECHNICIAN.</p>
1.2 GENERAL PROCEDURES FOR TESTING AND BALANCING	<p>A. PERFORM TESTING AND BALANCING PROCEDURES ON EACH SYSTEM ACCORDING TO THE PROCEDURES CONTAINED IN AABC'S "NATIONAL STANDARDS FOR TOTAL SYSTEM BALANCE".</p> <p>B. CUT INSULATION, DUCTS, PIPES, AND EQUIPMENT CABINETS FOR INSTALLATION OF TEST PROBES TO THE MINIMUM EXTENT NECESSARY FOR TAB PROCEDURES.</p> <p>1. AFTER TESTING AND BALANCING, PATCH PROBE HOLES IN DUCTS WITH SAME MATERIAL AND THICKNESS AS USED TO CONSTRUCT DUCTS.</p> <p>3. INSTALL AND JOIN NEW INSULATION THAT MATCHES REMOVED MATERIALS. RESTORE INSULATION, COVERINGS, VAPOR BARRIER, AND FINISH.</p> <p>C. MARK EQUIPMENT AND BALANCING DEVICES, INCLUDING DAMPER-CONTROL POSITIONS, VALVE POSITION INDICATORS, FAN-SPEED-CONTROL LEVERS, AND SIMILAR CONTROLS AND DEVICES, WITH PAINT OR OTHER SUITABLE, PERMANENT IDENTIFICATION MATERIAL TO SHOW FINAL SETTINGS.</p> <p>D. TAKE AND REPORT TESTING AND BALANCING MEASUREMENTS IN INCH-POUND UNITS.</p>
1.3 GENERAL PROCEDURES FOR BALANCING AIR SYSTEMS	<p>A. PREPARE TEST REPORTS FOR BOTH FANS AND OUTLETS. OBTAIN MANUFACTURER'S OUTLET FACTORS AND RECOMMENDED TESTING PROCEDURES. CROSS-CHECK THE SUMMATION OF REQUIRED OUTLET VOLUMES WITH REQUIRED FAN VOLUMES.</p> <p>B. PREPARE SCHEMATIC DIAGRAMS OF SYSTEMS' "AS-BUILT" DUCT LAYOUTS.</p> <p>C. FOR VARIABLE-AIR-VOLUME SYSTEMS, DEVELOP A PLAN TO SIMULATE DIVERSITY.</p> <p>D. DETERMINE THE BEST LOCATIONS IN MAIN AND BRANCH DUCTS FOR ACCURATE DUCT-AIRFLOW MEASUREMENTS.</p> <p>E. CHECK AIRFLOW PATTERNS FROM THE OUTDOOR-AIR LOUVERS AND DAMPERS AND THE RETURN- AND EXHAUST-AIR DAMPERS THROUGH THE SUPPLY-FAN DISCHARGE AND MIXING DAMPERS.</p> <p>F. LOCATE START-STOP AND DISCONNECT SWITCHES, ELECTRICAL INTERLOCKS, AND MOTOR STARTERS.</p> <p>G. VERIFY THAT MOTOR STARTERS ARE EQUIPPED WITH PROPERLY SIZED THERMAL PROTECTION.</p> <p>H. CHECK DAMPERS FOR PROPER POSITION TO ACHIEVE DESIRED AIRFLOW PATH.</p> <p>I. CHECK FOR AIRFLOW BLOCKAGES.</p> <p>J. CHECK CONDENSATE DRAINS FOR PROPER CONNECTIONS AND FUNCTIONING.</p> <p>K. CHECK FOR PROPER SEALING OF AIR-HANDLING-UNIT COMPONENTS.</p> <p>L. VERIFY THAT AIR DUCT SYSTEM IS SEALED AS SPECIFIED.</p>
1.4 PROCEDURES FOR CONSTANT-VOLUME AIR SYSTEMS	<p>A. ADJUST FANS TO DELIVER TOTAL INDICATED AIRFLOWS WITHIN THE MAXIMUM ALLOWABLE FAN SPEED LISTED BY FAN MANUFACTURER.</p> <p>1. MEASURE TOTAL AIRFLOW.</p> <p>A. SET OUTSIDE-AIR, RETURN-AIR, AND RELIEF-AIR DAMPERS FOR PROPER POSITION THAT SIMULATES MINIMUM OUTDOOR-AIR CONDITIONS.</p> <p>B. WHERE DUCT CONDITIONS ALLOW, MEASURE AIRFLOW BY PITOT-TUBE TRAVERSE. IF NECESSARY, PERFORM MULTIPLE PITOT-TUBE TRAVERSES TO OBTAIN TOTAL AIRFLOW.</p> <p>C. WHERE DUCT CONDITIONS ARE NOT SUITABLE FOR PITOT-TUBE TRAVERSE MEASUREMENTS, A COIL TRAVERSE MAY BE ACCEPTABLE.</p> <p>D. IF A RELIABLE PITOT-TUBE TRAVERSE OR COIL TRAVERSE IS NOT POSSIBLE, MEASURE AIRFLOW AT TERMINALS AND CALCULATE THE TOTAL AIRFLOW.</p> <p>2. MEASURE FAN STATIC PRESSURES AS FOLLOWS:</p> <p>A. MEASURE STATIC PRESSURE DIRECTLY AT THE FAN OUTLET OR THROUGH THE FLEXIBLE CONNECTION.</p> <p>B. MEASURE STATIC PRESSURE DIRECTLY AT THE FAN INLET OR THROUGH THE FLEXIBLE CONNECTION.</p> <p>C. MEASURE STATIC PRESSURE ACROSS EACH COMPONENT THAT MAKES UP THE AIR-HANDLING SYSTEM.</p> <p>D. REPORT ARTIFICIAL LOADING OF FILTERS AT THE TIME STATIC PRESSURES ARE MEASURED.</p> <p>3. REVIEW RECORD DOCUMENTS TO DETERMINE VARIATIONS IN DESIGN STATIC PRESSURES VERSUS ACTUAL STATIC PRESSURES. CALCULATE ACTUAL SYSTEM-EFFECT FACTORS. RECOMMEND ADJUSTMENTS TO ACCOMMODATE ACTUAL CONDITIONS.</p> <p>4. OBTAIN APPROVAL FROM ENGINEER FOR ADJUSTMENT OF FAN SPEED HIGHER OR LOWER THAN INDICATED SPEED. COMPLY WITH REQUIREMENTS IN HVAC SECTIONS FOR AIR-HANDLING UNITS FOR ADJUSTMENT OF FANS, BELTS, AND PULLEY SIZES TO ACHIEVE INDICATED AIR-HANDLING-UNIT PERFORMANCE.</p> <p>5. DO NOT MAKE FAN-SPEED ADJUSTMENTS THAT RESULT IN MOTOR OVERLOAD. CONSULT EQUIPMENT MANUFACTURERS ABOUT FAN-SPEED SAFETY FACTORS. MODULATE DAMPERS AND MEASURE FAN-MOTOR AMPERAGE TO ENSURE THAT NO OVERLOAD OCCURS. MEASURE AMPERAGE IN FULL-COOLING, FULL-HEATING, ECONOMIZER, AND ANY OTHER OPERATING MODE TO DETERMINE THE MAXIMUM REQUIRED BRAKE HORSEPOWER.</p> <p>B. ADJUST VOLUME DAMPERS FOR MAIN DUCT, SUBMAIN DUCTS, AND MAJOR BRANCH DUCTS TO INDICATED AIRFLOWS.</p> <p>1. MEASURE AIRFLOW OF SUBMAIN AND BRANCH DUCTS.</p> <p>2. ADJUST SUBMAIN AND BRANCH DUCT VOLUME DAMPERS FOR SPECIFIED AIRFLOW.</p> <p>3. RE-MEASURE EACH SUBMAIN AND BRANCH DUCT AFTER ALL HAVE BEEN ADJUSTED.</p> <p>C. ADJUST AIR INLETS AND OUTLETS FOR EACH SPACE TO INDICATED AIRFLOWS.</p> <p>1. SET AIRFLOW PATTERNS OF ADJUSTABLE OUTLETS FOR PROPER DISTRIBUTION WITHOUT DRAFTS.</p> <p>2. MEASURE INLETS AND OUTLETS AIRFLOW.</p> <p>3. ADJUST EACH INLET AND OUTLET FOR SPECIFIED AIRFLOW.</p> <p>4. RE-MEASURE EACH INLET AND OUTLET AFTER THEY HAVE BEEN ADJUSTED.</p> <p>D. VERIFY FINAL SYSTEM CONDITIONS.</p> <p>1. RE-MEASURE AND CONFIRM THAT MINIMUM OUTDOOR, RETURN, AND RELIEF AIRFLOWS ARE WITHIN DESIGN. READJUST TO DESIGN IF NECESSARY.</p> <p>2. RE-MEASURE AND CONFIRM THAT TOTAL AIRFLOW IS WITHIN DESIGN.</p> <p>3. RE-MEASURE ALL FINAL FAN OPERATING DATA, RPMs, VOLTS, AMPS, AND STATIC PROFILE.</p> <p>4. MARK ALL FINAL SETTINGS.</p> <p>5. TEST SYSTEM IN ECONOMIZER MODE. VERIFY PROPER OPERATION AND ADJUST IF NECESSARY.</p> <p>6. MEASURE AND RECORD ALL OPERATING DATA.</p> <p>7. RECORD FINAL FAN-PERFORMANCE DATA.</p>
1.5 TOLERANCES	<p>A. SET HVAC SYSTEM'S AIRFLOW RATES AND WATER FLOW RATES WITHIN THE FOLLOWING TOLERANCES:</p> <p>1. SUPPLY, RETURN, AND EXHAUST FANS AND EQUIPMENT WITH FANS: PLUS OR MINUS 10 PERCENT.</p> <p>2. AIR OUTLETS AND INLETS: PLUS OR MINUS 10 PERCENT.</p> <p>3. HEATING-WATER FLOW RATE: PLUS OR MINUS 10 PERCENT.</p> <p>4. COOLING-WATER FLOW RATE: PLUS OR MINUS 10 PERCENT.</p> <p>B. MAINTAINING PRESSURE RELATIONSHIPS AS DESIGNED SHALL HAVE PRIORITY OVER THE TOLERANCES SPECIFIED ABOVE.</p>

GENERAL NOTES	
1. PROVIDE MATERIALS AND EQUIPMENT AND PERFORM LABOR TO INSTALL COMPLETE AND OPERATIONAL MECHANICAL SYSTEMS AS INDICATED ON THE DRAWINGS, AS SPECIFIED AND AS REQUIRED PER APPLICABLE LOCAL BUILDING CODES (IBC, IMC, IPC, ETC.), AMENDMENTS, OTHER GOVERNING CODES AND ORDINANCES AS APPLICABLE.	28. CONTRACTOR SHALL NOTE THE CRITICAL SPACE AVAILABLE ABOVE CEILINGS. PROVIDE TRANSITION PIECES AND BEAM BOXES AT CROSSOVERS, UNDER BEAMS, OVER/UNDER PIPES AS REQUIRED TO ACCOMMODATE TO ACCOMMODATE DUCTS WITHIN SPACE AVAILABLE. PROVIDE EQUIVALENT DUCT SIZE TO THE DIAMETER SHOWN COORDINATE CLOSELY WITH OTHER SECTIONS TO REDUCE NECESSITY OF TRANSITION TO A MINIMUM. NO ADDITIONAL COSTS WILL BE PAID FOR ANY REQUIRED TRANSITIONS, BEAM BOXES OR OTHER SPECIAL CHANGE SHAPE PIECES.
2. CONTRACT DOCUMENT DRAWINGS FOR MECHANICAL WORK ARE DIAGRAMMATIC AND ARE INTENDED TO CONVEY SCOPE AND GENERAL ARRANGEMENT ONLY.	29. NO WATER PIPING IS ALLOWED ABOVE THE ELECTRICAL ROOM, TELEPHONE SWITCH ROOM AND DATA/COMMUNICATION ROOM.
3. INSTALL MECHANICAL EQUIPMENT AND APPURTENANCES IN ACCORDANCE WITH MANUFACTURERS' RECOMMENDATIONS, CONTRACT DOCUMENTS, AND APPLICABLE CODES AND REGULATIONS.	30. UPON COMPLETION OF WORK, CONTRACTOR SHALL CLEAN AND REMOVE ALL DEBRIS ASSOCIATED WITH HIS/HER WORK AND DISPOSE OF IT. AREA SHALL BE LEFT IN A CONDITION ACCEPTABLE TO OWNER.
4. PROVIDE VIBRATION ISOLATION FOR MECHANICAL EQUIPMENT TO PREVENT TRANSMISSION OF VIBRATION TO BUILDING STRUCTURE AND A VIBRATION FREE INSTALLATION.	31. DUCT SMOKE DETECTORS SHALL BE INSTALLED PER MANUFACTURER'S WRITTEN RECOMMENDATIONS AND SHALL BE TIED-IN TO THE BUILDING FIRE ALARM SYSTEM. CONNECTION TO FIRE ALARM FOR SUPERVISION ONLY.
5. COORDINATE CONSTRUCTION OF MECHANICAL WORK WITH ALL OTHER TRADES SHOWN ON OTHER CONTRACT DOCUMENT DRAWINGS.	32. ALL REQUEST FOR ACCESS OR CONNECTIONS MUST BE MADE IN WRITING IN ADVANCE OF WORK ACTIVITY THROUGH THE BUILDING MANAGER. CONTRACTOR COORDINATE DURATION OF REQUEST REQUIRED.
6. LEAKAGE / PRESSURE TESTS SHALL BE COMPLETED BEFORE ANY DUCTWORK INSULATION IS APPLIED.	33. ALL SYMBOLS SHOWN ON SYMBOL LIST ARE NOT NECESSARILY USED ON THIS PROJECT.
7. PROVIDE ACCESS PANELS FOR INSTALLATION IN WALLS AND CEILINGS, WHERE REQUIRED, TO SERVICE DAMPERS, VALVES, SMOKE DETECTORS AND OTHER CONCEALED MECHANICAL EQUIPMENT. ACCESS PANELS SHALL BE PROVIDED TO GENERAL CONTRACTOR FOR INSTALLATION. CONTRACTOR SHALL COORDINATE LOCATION.	
8. TESTING, ADJUSTING AND BALANCING AGENCY SHALL BE A MEMBER OF THE ASSOCIATED AIR BALANCE COUNCIL (AABC) OR THE NATIONAL ENVIRONMENTAL BALANCING BUREAU (NEBB). TESTING, ADJUSTING AND BALANCING SHALL BE PERFORMED IN ACCORDANCE WITH THE AABC STANDARDS.	
9. COORDINATE EQUIPMENT CONNECTIONS WITH MANUFACTURERS' CERTIFIED DRAWINGS. COORDINATE AND PROVIDE DUCT TRANSITIONS REQUIRED FOR FINAL EQUIPMENT CONNECTIONS TO FURNISHED EQUIPMENT. FIELD VERIFY AND COORDINATE DUCT DIMENSIONS BEFORE FABRICATION.	
10. MISCELLANEOUS STEEL REQUIRED TO ENSURE PROPER INSTALLATION AND AS SHOWN IN DETAILS FOR DUCTWORK AND EQUIPMENT (UNLESS OTHERWISE NOTED) SHALL BE FURNISHED AND INSTALLED BY THE MECHANICAL CONTRACTOR. OTHER TRADES SHALL NOT SHARE SUPPORTS.	
11. ROUND DUCT CAN BE INSTALLED IN LIEU OF RECTANGULAR AND VICE VERSA AS LONG AS IT HAS EQUIVALENT DUCT DIMENSIONS PER THE ASHRAE FUNDAMENTALS HANDBOOK.	
12. DUCTWORK AND EQUIPMENT SUPPORTED FROM STRUCTURAL STEEL SHALL BE COORDINATED WITH GENERAL CONTRACTOR. ATTACHMENTS TO STEEL BAR JOISTS, TRUSSES OR JOIST GIRDERS SHALL BE AT PANEL POINTS. PROVIDE BEAM CLAMPS MEETING MSS STANDARDS. WELDING TO STRUCTURAL MEMBERS SHALL NOT BE PERMITTED. THE USE OF C-CLAMPS SHALL NOT BE PERMITTED.	
13. OPENINGS IN FIRE WALLS DUE TO DUCTWORK, PIPING, CONDUIT, ETC., SHALL BE SEALED WITH FIRE STOPPING WITH A PRODUCT SIMILAR TO 3M OR APPROVED EQUAL.	
14. SUPPORTS, SEISMIC RESTRAINTS, BRACING AND ANCHORING OF DUCTWORK, PIPING AND EQUIPMENT IS REQUIRED IN ACCORDANCE WITH THE REQUIREMENTS OF APPLICABLE CODES AND STANDARDS. (DELEGATED DESIGN).	
15. THE LOCATIONS OF ITEMS SHOWN ON THE DRAWINGS OR CALLED FOR IN THE SPECIFICATIONS THAT ARE NOT FIXED BY DIMENSIONS ARE APPROXIMATE ONLY. THE EXACT LOCATIONS NECESSARY TO SECURE THE BEST CONDITIONS AND RESULTS MUST BE DETERMINED BY THE PROJECT SITE CONDITIONS AND SHALL HAVE THE APPROVAL OF THE CONTRACTING OFFICER OF RECORD BEFORE BEING INSTALLED. DO NOT SCALE DRAWINGS.	
16. REFER TO SPECIFICATIONS FOR MATERIALS AND METHODS FOR CONSTRUCTION. WHERE THE WORD "PROVIDE" OR "NEW" IS USED SHALL BE UNDERSTOOD TO MEAN "THE CONTRACTOR SHALL FURNISH AND INSTALL." EQUIPMENT AND MATERIALS PROVIDED SHALL BE NEW AND FREE FROM DEFECTS. NO SALVAGED OR REBURNISHED OR USED EQUIPMENT OR MATERIAL WILL BE ACCEPTED.	
17. LOCATIONS AND SIZES OF WALL AND ROOF OPENINGS SHALL BE COORDINATED WITH OTHER TRADES INVOLVED.	
18. AIR CONDITIONING CONDENSATE DRAIN LINES FROM EACH HVAC UNIT SHALL BE PIPED FULL SIZE FROM THE UNIT DRAIN OUTLET, WITH "P" TRAP AND PIPED TO NEAREST DRAIN. INSULATE INTERIOR LINES WHERE CONDENSATE CAN OCCUR. REFER TO PLUMBING DRAWINGS.	
19. PROVIDE AND INSTALL LOW VOLTAGE (50V OR LESS) WIRING AND CONDUIT NEEDED FOR MECHANICAL SYSTEM OPERATION. THIS SHALL INCLUDE WIRING FOR ANY SENSOR, THERMOSTAT, VALVE, DAMPER, SPLIT SYSTEM (REMOTE AIR-COOLED CONDENSER), ETC. CONTROL WIRE AND CONDUIT SHALL COMPLY WITH THE LATEST NATIONAL ELECTRICAL CODE.	
20. SUBMIT DETAILED DUCTWORK SHOP DRAWINGS TO ENGINEER FOR REVIEW. SHOP DRAWINGS SHALL BE COMPLETE WITH TOP AND BOTTOM DIMENSIONS, INCLUDING SUPPORTS, SEISMIC ATTACHMENT DETAILS AND LOCATIONS. SHOP DRAWINGS SHALL BE APPROVED BEFORE ANY MATERIALS ARE ORDERED OR CONSTRUCTION IS STARTED.	
21. SCHEDULED EQUIPMENT IS THE BASIS OF DESIGN. IF THE CONTRACTOR SUBMITS ON OTHER APPROVED MANUFACTURERS OR MODEL NUMBERS, THE CONTRACTOR WILL FULLY COORDINATE EQUIPMENT REQUIREMENTS WITH OTHER TRADES AND SHALL INCUR ANY RELATED COSTS.	
22. MAINTAIN A SAFE WORKING ENVIRONMENT AT THE CONSTRUCTION SITE AND SURROUNDING AREAS.	
23. ACCURATE "AS-BUILT" DRAWINGS SHALL BE MAINTAINED DURING CONSTRUCTION AND SUBMITTED FOR APPROVAL UPON COMPLETION OF INSTALLATION. INDICATE DUCT AND EQUIPMENT SIZES AND LOCATIONS.	
24. SHEET METAL DUCTWORK SHALL BE FABRICATED AND INSTALLED IN ACCORDANCE WITH THE LATEST SMACNA DESIGN AND CONSTRUCTION STANDARDS.	
25. PERFORM WORK IN A COMPLETE AND WORKMANLIKE MANNER IN CONFORMANCE WITH CODES, AND MANUFACTURER'S RECOMMENDATIONS. CONTRACTOR SHALL COORDINATE WITH OTHER TRADES TO PROVIDE A COMPLETE AND WORKING SYSTEM.	
26. TRAVERSE JOINTS FOR SUPPLY DUCTS SHALL BE SEALED WITH APPROVED MASTIC.	
27. EQUIPMENT DESIGNED TO BE FIXED IN POSITION SHALL BE SECURELY FASTENED IN PLACE.	

GENERAL NOTES	
28. CONTRACTOR SHALL NOTE THE CRITICAL SPACE AVAILABLE ABOVE CEILINGS. PROVIDE TRANSITION PIECES AND BEAM BOXES AT CROSSOVERS, UNDER BEAMS, OVER/UNDER PIPES AS REQUIRED TO ACCOMMODATE TO ACCOMMODATE DUCTS WITHIN SPACE AVAILABLE. PROVIDE EQUIVALENT DUCT SIZE TO THE DIAMETER SHOWN COORDINATE CLOSELY WITH OTHER SECTIONS TO REDUCE NECESSITY OF TRANSITION TO A MINIMUM. NO ADDITIONAL COSTS WILL BE PAID FOR ANY REQUIRED TRANSITIONS, BEAM BOXES OR OTHER SPECIAL CHANGE SHAPE PIECES.	
29. NO WATER PIPING IS ALLOWED ABOVE THE ELECTRICAL ROOM, TELEPHONE SWITCH ROOM AND DATA/COMMUNICATION ROOM.	
30. UPON COMPLETION OF WORK, CONTRACTOR SHALL CLEAN AND REMOVE ALL DEBRIS ASSOCIATED WITH HIS/HER WORK AND DISPOSE OF IT. AREA SHALL BE LEFT IN A CONDITION ACCEPTABLE TO OWNER.	
31. DUCT SMOKE DETECTORS SHALL BE INSTALLED PER MANUFACTURER'S WRITTEN RECOMMENDATIONS AND SHALL BE TIED-IN TO THE BUILDING FIRE ALARM SYSTEM. CONNECTION TO FIRE ALARM FOR SUPERVISION ONLY.	
32. ALL REQUEST FOR ACCESS OR CONNECTIONS MUST BE MADE IN WRITING IN ADVANCE OF WORK ACTIVITY THROUGH THE BUILDING MANAGER. CONTRACTOR COORDINATE DURATION OF REQUEST REQUIRED.	
33. ALL SYMBOLS SHOWN ON SYMBOL LIST ARE NOT NECESSARILY USED ON THIS PROJECT.	

DEMOLITION NOTES	
THESE DOCUMENTS WERE PREPARED PER AVAILABLE AS-BUILT DOCUMENTS. FIELD VERIFY ALL EXISTING CONDITIONS (SIZE, LOCATION, ETC.) PRIOR TO BEGINNING DEMOLITION. NOTIFY ARCHITECT/ENGINEER OF ANY DISCREPANCIES BETWEEN CONTRACT DOCUMENTS AND EXISTING CONDITIONS.	
DEMOLITION OR INTERRUPTION TO EXISTING SERVICES SHALL BE MINIMIZED AND COORDINATED WITH THE OWNER'S REPRESENTATIVE.	
PATCH AND REPAIR AREAS, PIPING, DUCTWORK, ETC., EXISTING OR NEW, DAMAGED AS A RESULT OF THE DEMOLITION WORK. REPAIR TO MATCH EXISTING CONDITIONS.	
BEFORE DEMOLITION AND REMOVAL OF DUCTWORK OR PIPING, VERIFY HVAC EQUIPMENT CONNECTED ONLY SERVES THE AREA INCLUDED IN THE CURRENT PHASE OF DEMOLITION. ONCE CONFIRMED, DUCTWORK OR PIPING SHALL BE REMOVED TO THE POINTS INDICATED ON PLANS, UNLESS NOTED OTHERWISE.	
REMOVE ASSOCIATED HANGERS, SUPPORTS, AND ANCHORS OF DEMOLISHED EQUIPMENT, DUCTWORK OR DEVICES.	
PROVIDE TEMPORARY OR PERMANENT CAPS FOR EXISTING PIPING. NO PIPING SHALL BE LEFT OPEN ENDED.	
PROVIDE TEMPORARY OR PERMANENT MECHANICALLY FASTENED SHEET METAL CAPS FOR REMAINING DUCTWORK OPENINGS. SEAL AIRTIGHT PER SMACNA GUIDELINES.	
REPAIR AND OR REPLACE INSULATION REMOVED OR DAMAGED AS A RESULT OF DEMOLITION	
DEMOLISHED MATERIAL SHALL BE PROMPTLY REMOVED FROM PROJECT SITE AND DISPOSED OF IN AN EPA-APPROVED MANNER. EQUIPMENT OR DEVICES IN FAIR CONDITION SHALL BE REVIEWED WITH THE OWNER FOR POSSIBLE SALVAGE PRIOR TO DISPOSAL.	

CONTRACTOR BIDDING NOTES	
1. DESIGN DRAWINGS ARE SCHEMATIC. THIS CONTRACTOR SHALL VISIT THE SITE PRIOR TO BIDDING OR AWARD OF CONTRACT TO INSPECT EXISTING FIELD CONDITIONS. THIS CONTRACT SHALL INCLUDE ALL LABOR AND MATERIALS NECESSARY FOR FIELD MODIFICATIONS DUE TO EXISTING CONDITIONS.	
2. THE CONTRACTOR SHALL CONTACT THE ARCHITECT, ENGINEER OR OWNER PRIOR TO BIDDING FOR INTERPRETATIONS AND CLARIFICATIONS OF THE DESIGN AND INCLUDE IN HIS BID ALL COSTS TO MEET THE DESIGN INTENT. CLARIFICATIONS MADE BY THE ARCHITECT, ENGINEER OR OWNER AFTER BIDDING WILL BE FINAL AND SHALL BE IMPLEMENTED AT CONTRACTORS COST.	
3. BIDDING CONTRACTORS SHALL HAVE A WORKING KNOWLEDGE OF LOCAL CODES AND ORDINANCES AND SHALL INCLUDE IN THEIR BIDS THE COSTS FOR ALL WORK INSTALLED IN STRICT ACCORDANCE WITH GOVERNING CODES, THE PLANS AND SPECIFICATIONS NOT WITHSTANDING. THE CONTRACTOR SHALL ALERT ARCHITECT, ENGINEER OR OWNER OF ANY APPARENT DISCREPANCIES BETWEEN GOVERNING CODES AND DESIGN INTENT.	

FIRE LIFE SAFETY NOTES	
1. THE ELECTRICAL CONTRACTOR SHALL INTERCONNECT ALL FANS AND AC UNITS WITH THE BUILDING LIFE SAFETY SYSTEM FOR UNIT SHUT DOWN UPON A SIGNAL FROM THE LIFE SAFETY SYSTEM.	
2. WHERE DUCT MOUNTED SMOKE DETECTORS FOR FANS AND AC UNITS ARE REQUIRED, THE HVAC CONTRACTOR SHALL FURNISH AND INSTALL THE SMOKE DETECTORS, THE ELECTRICAL CONTRACTOR PROVIDE ALL WIRING AND CONDUIT TO SIGNAL THE LIFE SAFETY SYSTEM. THE LIFE SAFETY SYSTEM SHALL SHUT DOWN THE EXHAUST FANS OR AC UNITS AS DESCRIBED IN NOTE #1.	
3. ALL SMOKE DETECTORS SHALL BE INSTALLED PER MANUFACTURER'S RECOMMENDATION AND SHALL BE COMPATIBLE WITH WITH THE BASE BUILDING STANDARDS.	
4. EACH SINGLE SYSTEM PROVIDING HEATING OR COOLING AIR IN EXCESS OF 2000 CFM SHALL BE EQUIPPED WITH A SMOKE DETECTOR/AUTOMATIC SHUT-OFF.	

HVAC GENERAL NOTES	
1. MECHANICAL DRAWINGS ARE ESSENTIALLY DIAGRAMMATIC TO THE EXTENT THAT MANY OFFSETS, BENDS, ELBOWS, SPECIAL FITTINGS, AND EXACT LOCATIONS OF EQUIPMENT, DUCTWORK, PIPING, AND RELATED APPURTENANCES ARE NOT INDICATED. THE CONTRACTOR SHALL CAREFULLY STUDY THE DRAWINGS AND VERIFY ACTUAL FIELD CONDITIONS IN ORDER TO DETERMINE THE BEST METHODS, EXACT LOCATION, ROUTING, AND OBSTRUCTIONS, WORK BY OTHER TRADES, ETC. WHICH AFFECT THE INSTALLATION OF HIS (HER) WORK.	
2. PRIOR TO BID, THE CONTRACTOR SHALL VERIFY ALL EXISTING SITE CONDITIONS. IT IS THE CONTRACTORS RESPONSIBILITY TO ASSURE THAT ALL DUCTWORKS, PIPING, AND EQUIPMENT WILL IT IN THE EXISTING BUILDING AREAS. ALL CUTTING, PATCHING, RELOCATION OF EXISTING WORK, AND THE TRANSPORTATION OF ALL NECESSARY MATERIALS AND EQUIPMENT TO THE INDICATED SITE LOCATION SHALL ALSO BE INCLUDED IN THE BID.	
3. IF FIELD ALTERATIONS TO DUCT SYSTEMS HAVE TO BE MADE DUE TO JOB SITE CONDITIONS, THE CONTRACTOR, AT NO ADDITIONAL COST TO THE OWNER, SHALL PREPARE HIS (HER) OWN SHOP AND INSTALLATION DRAWINGS AND SUBMIT TO THE ARCHITECT / ENGINEER FOR APPROVAL PRIOR BEGINNING OF WORK.	
4. COORDINATE ALL LOCATION OF GRILLES, REGISTERS, AND SIDEWALL REGISTERS W/ ARCHITECTURAL, STRUCTURAL, AND ELECTRICAL ELEMENTS. THE CONTRACTOR IS ALSO REQUIRED TO COORDINATE ALL MECHANICAL UNIT LOCATIONS WITH OTHER GENERAL TRADES.	
5. IT IS THE RESPONSIBILITY OF THE MECHANICAL CONTRACTOR TO PAY FOR ALL NECESSARY PERMITS AND FEES AND OBTAIN APPROVALS PRIOR TO INSTALLATION.	
6. ALL WORK SHALL COMPLY WITH ALL (APPLICABLE) FEDERAL, STATE, AND LOCAL JURISDICTION CODES. WHERE THE PLANS SHOW MORE RESTRICTIVE REQUIREMENTS, THE PLANS SHALL GOVERN AND NOTHING ON THESE PLANS SHALL BE INTERPRETED AS AUTHORITY TO VIOLATE ANY CODE AND/OR REGULATIONS.	
7. SCOPE OF WORK CONSISTS OF FURNISHING LABOR, MATERIALS AND EQUIPMENT FOR THE INSTALLATION. THE WORK ALSO INCLUDES PLACING INTO OPERATION COMPLETE AND OPERABLE HEATING, VENTILATING AND AIR CONDITIONING (HVAC) SYSTEMS AS SPECIFIED AND SHOWN ON PLANS. THIS INCLUDES, BUT NOT LIMITED TO: HVAC UNITS, EXHAUST FANS, DUCTLESS SPLIT-SYSTEMS, DUCTWORK, AIR DISTRIBUTION, CONTROLS AND ACCESSORIES.	
8. CONTRACTOR SHALL INSPECT ANY EXISTING DUCTWORK FOR DEFECTS AND REPORT TO THE ARCHITECT / ENGINEER AND THE OWNER ANY DEFICIENCIES FOUND PRIOR TO PERFORMING ANY WORK. CONTRACTOR SHALL CLEAN ALL EXISTING DUCTWORK, GRILLES, REGISTERS AND DIFFUSERS PRIOR TO INSTALLING THE NEW WORK.	
9. HVAC UNIT FLEXIBLE DUCT CONNECTIONS SHALL BE A MINIMUM OF 6 INCHES LONG, HOLD IN-PLACE WITH HEAVY METAL BANDS, AND SECURELY ATTACHED TO PREVENT ANY LEAKAGE AT THE CONNECTION POINTS. FLEXIBLE CONNECTIONS SHALL BE FABRICATED FROM APPROVED FLAME PROOF FABRIC CONFORMING TO NFPA 90A. ASBESTOS CLOTH IS NOT ACCEPTABLE.	
10. THE CONTRACTOR SHALL FURNISH AND INSTALL ACCESS DOORS AND / OR ACCESS PANELS AS NECESSARY TO SERVICE CONTROL EQUIPMENT. ALL ACCESS DOOR AND PANELS LOCATIONS SHALL BE VERIFIED WITH THE ARCHITECT PRIOR TO INSTALLATION.	
11. CONTRACTOR SHALL PROVIDE ALL AIR TEMPERATURE CONTROLS INCLUDING WIRING, TUBING AND THERMOSTATS (WITH LOCKING COVERS) AND ALL MISCELLANEOUS APPURTENANCES TO MEET THE INTENT OF THESE DOCUMENTS.	
12. ALL ACCESS AND WORKING SPACE MUST BE PROVIDED AND MAINTAINED ABOUT ALL AIR CONDITION UNITS, ELECTRICAL AND CONTROL EQUIPMENT TO PERMIT READY AND SAFE OPERATION, EXAMINATION, AND MAINTENANCE.	
13. ALL DUCTS, PLENUMS, FLASHING, EQUIPMENT AND WORKS EXPOSED TO THE WEATHER MUST BE WATERTIGHT AND PROTECTED.	
14. HANGER FOR SUSPENDED EQUIPMENT AND DUCTWORK SHALL BE SWAY BRACED IN (2) TWO DIRECTIONS PER "GUIDELINES" FOR SEISMIC RESTRAINTS OF MECHANICAL EQUIPMENT AS REQUIRED PER SMACNA.	
15. ALL INSULATION MATERIALS SHALL HAVE A FLAME SPREAD RATING OF NO MORE THAN 25 AND A SMOKE DEVELOPED RATING OF NO MORE THAN 50.	
16. VERIFY EXACT LOCATION OF ALL THERMOSTATS, CONTROL PANELS, AND REMOTE SENSORS BEFORE ROUGH-IN. COORDINATE WITH ARCHITECTURAL PLANS FOR EXACT LOCATION. INSTALL ALL WALL-MOUNTED THERMOSTAT AT <u>±4" -0" MAX. ABOVE FINISH FLOOR.</u>	
17. PERFORM PRE-READING AIR BALANCE REPORT AFTER AIR DIFFUSERS INSTALLATION. BALANCE ALL SUPPLY DIFFUSERS, RETURN AND EXHAUST AIR DEVICES AS REQUIRED. AIR BALANCE SHALL BALANCE WITH ALL SUPPLY DIFFUSERS, RETURN AND EXHAUST AIR DEVICES. AIR BALANCE SHALL BE PERFORMED BY AN INDEPENDENT CONTRACTOR OR A CERTIFIED MEMBER OF A.A.B.C. OR N.E.E.B. SUBMIT A COMPLETE CERTIFIED TEST AND AIR BALANCE REPORT FOR FINAL REVIEW AND APPROVAL.	
18. PROVIDE EXTRACTORS AT ALL SUPPLY AIR DUCTS "T" CONNECTIONS AND MANUAL VOLUME DAMPERS IN ALL SUPPLY AIR AND RETURN AIR BRANCH DUCTS TO DIFFUSERS AND REGISTERS.	
19. PRIOR INSTALLATION OF ROOFTOP UNITS, COORDINATE WITH ARCHITECTURAL AND STRUCTURAL DRAWINGS FOR EXACT LOCATION, OPENING DETAILS, AND ADDITIONAL CONSTRUCTION REQUIREMENTS.	
20. ALL OUTSIDE AIR INTAKES SHALL BE LOCATED AT A MINIMUM OF 10 FEET AWAY FROM ANY PLUMBING VENT, EXHAUST, AND FLUE OUTLETS.	
21. INSTALLATIONS OF AESTHETICS ARE A VERY IMPORTANT COMPONENT OF THIS PROJECT. INSTALLATION OF MECHANICAL WORK SHALL BE OF THE HIGHEST QUALITY AND PROFESSIONAL CRAFTSMANSHIP POSSIBLE.	
22. PREPARE ALL FINAL AS-BUILT DRAWINGS AT THE END OF THE PROJECT COMPLETION AND SUBMIT TO ARCHITECT AND ENGINEER (AS REQUIRED) FOR RECORD.	

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DIVISION 15000 – MECHANICAL

SECTION 15001 – BASIC MECHANICAL REQUIREMENTS

A. GENERAL CONDITIONS

- DRAWINGS AND GENERAL PROVISIONS OF CONTRACT, INCLUDING GENERAL AND SUPPLEMENTARY CONDITIONS AND ALL OTHER SPECIFICATION SECTIONS, APPLY TO THIS AND THE OTHER SECTIONS OF DIVISION 15000.
- THE CONTRACTOR FOR THIS DIVISION OF WORK IS REQUIRED TO READ THE SPECIFICATIONS AND REVIEW DRAWINGS FOR ALL DIVISIONS OF WORK AND IS RESPONSIBLE FOR THE COORDINATION OF THEIR WORK AND THE WORK OF THEIR SUBCONTRACTORS WITH ALL DIVISIONS OF WORK. IT IS THIS CONTRACTOR'S RESPONSIBILITY TO PROVIDE THEIR SUBCONTRACTORS WITH A COMPLETE SET OF BID DOCUMENTS.
- THIS CONTRACTOR IS RESPONSIBLE FOR SCHEDULING THE COMPLETION AND INSPECTION OF THEIR WORK AND THE WORK OF THEIR SUBCONTRACTORS TO COMPLY WITH THE SCHEDULE AND THE PROJECT COMPLETION DATE.
- THIS CONTRACTOR SHALL VISIT THE SITE PRIOR TO SUBMITTAL OF BID TO DETERMINE CONDITIONS AFFECTING THE WORK. ANY ITEMS WHICH ARE NOT COVERED IN THE BID DOCUMENTS OR ANY PROPOSED SUBSTITUTIONS SHALL BE LISTED SEPARATELY AND QUALIFIED IN THE CONTRACTORS BID. SUBMITTAL OF BID SHALL SERVE AS EVIDENCE OF KNOWLEDGE OF EXISTING CONDITIONS AND ANY MODIFICATIONS WHICH ARE REQUIRED TO MEET THE INTENT OF THE DRAWINGS AND SPECIFICATIONS. FAILURE TO VISIT THE SITE DOES NOT RELIEVE THE CONTRACTOR OF RESPONSIBILITY IN PERFORMANCE OF WORK.
- REFER TO RESPONSIBILITY SCHEDULE FOR INFORMATION IN REGARD TO RESPONSIBILITY OF WORK OR ITEMS WHICH MAY AFFECT BID.

SECTION 15002 – GENERAL REQUIREMENTS

- THIS CONTRACTOR SHALL PROVIDE ALL LABOR, MATERIALS, EQUIPMENT, SERVICES, TOOLS, TRANSPORTATION, INCIDENTALS AND DETAILS NECESSARY TO PROVIDE A COMPLETE MECHANICAL SYSTEM AS SHOWN ON THE DRAWINGS, CALLED FOR IN THE SPECIFICATIONS, AND AS REQUIRED BY JOB CONDITIONS. ALL WORK NOT SPECIFICALLY NOTED AS BEING BY THE LANDLORD OR TENANT SHALL BE PROVIDED BY THE MECHANICAL CONTRACTOR. CLOSELY COORDINATE THE ENTIRE INSTALLATION WITH THE LANDLORD AND THE TENANT PROJECT MANAGER, AS REQUIRED.
- DRAWINGS AND SPECIFICATIONS ARE TO BE CONSIDERED AS SUPPLEMENTING EACH OTHER. WORK SPECIFIED BUT NOT SHOWN ON DRAWINGS, OR SHOWN ON DRAWINGS BUT NOT SPECIFIED, SHALL BE PERFORMED OR FURNISHED AS THOUGH MENTIONED IN BOTH SPECIFICATIONS AND DRAWINGS. IF NOT OTHERWISE DIRECTED, INSTALLATION OF ALL SYSTEMS AND EQUIPMENT SHALL BE IN ACCORDANCE WITH APPLICABLE CODES AND IN ACCORDANCE WITH MANUFACTURER'S INSTALLATION INSTRUCTIONS. WHERE WORK DESCRIBED IN THE SPECIFICATIONS IS IN CONFLICT WITH THE WORK SHOWN ON THE DRAWINGS, THE CONTRACTOR SHALL SUPPLY THE GREATER QUANTITY, QUALITY AND COST VIA THE BID AND CONTACT THE ENGINEER FOR CLARIFICATION ON DIRECTION PRIOR TO INSTALLATION.
- WHERE THE DRAWINGS OR SPECIFICATIONS CALL FOR ITEMS WHICH EXCEED CODES OR THE LANDLORD'S TENANT CRITERIA, THE CONTRACTOR IS RESPONSIBLE FOR FURNISHING AND INSTALLING THE SYSTEM WITH THE MORE STRINGENT REQUIREMENTS AS DESIGNED AND DESCRIBED ON THESE DRAWINGS, UNLESS SPECIFICALLY NOTED OTHERWISE.
- ALL MECHANICAL WORK SHALL BE INSTALLED SO AS TO BE READILY ACCESSIBLE FOR OPERATING, SERVICING, MAINTAINING, AND REPAIRING. THIS CONTRACTOR IS RESPONSIBLE FOR PROVIDING ACCESS PANELS FOR SUFFICIENT SERVICE ACCESS TO ALL EQUIPMENT.
- ALL WORK SHALL BE PERFORMED IN A NEAT PROFESSIONAL MANNER USING GOOD ENGINEERING AND CONSTRUCTION PRACTICES.
- UNLESS SPECIFICALLY NOTED OTHERWISE, MATERIALS, PRODUCTS, AND EQUIPMENT, INCLUDING ALL COMPONENTS THEREOF, SHALL BE NEW, UNDERWRITERS LABORATORIES LISTED AND LABELED AND SIZED IN CONFORMANCE WITH REQUIREMENTS OF STATE AND LOCAL CODES, WHICHEVER IS MORE STRINGENT.

SECTION 15003 – CODES

- ALL WORK SHALL CONFORM TO THE LANDLORDS' CRITERIA, THE STATE'S, COUNTY'S, CITY'S AND LOCAL ORDINANCES, SAFETY AND HEALTH CODES, NFPA CODES, ENERGY CODES AND ALL OTHER APPLICABLE CODES AND REQUIREMENTS. THIS CONTRACTOR SHALL INQUIRE INTO AND COMPLY WITH ALL APPLICABLE CODES, ORDINANCES, AND REGULATIONS. THIS CONTRACTOR SHALL INCLUDE ANY CHANGES REQUIRED BY CODES IN THE BID AND IF THESE CHANGES ARE NOT INCLUDED IN THE BID, THEY MUST BE QUALIFIED AS A SEPARATE LINE ITEM IN THE BID. AFTER CONTRACT IS ISSUED, NO ADDITIONAL COST DUE TO CODE ISSUES SHALL BE REIMBURSED BY TENANT TO THE CONTRACTOR.

SECTION 15004 – LICENSES, PERMITS, INSPECTIONS & FEES

- THIS CONTRACTOR SHALL OBTAIN AND PAY FOR ALL LICENSES, PERMITS, INSPECTIONS, AND FEES REQUIRED OR RELATED TO THEIR WORK.
- FURNISH TO TENANT'S PROJECT MANAGER ALL CERTIFICATES OF INSPECTION AND FINAL INSPECTION APPROVAL AT COMPLETION OF PROJECT.

SECTION 15005 – TRADE NAMES, MANUFACTURERS AND SHOP DRAWINGS

- WHERE TRADE NAMES AND MANUFACTURERS ARE USED ON THE DRAWINGS OR IN THE SPECIFICATIONS, THE EXACT EQUIPMENT SHALL BE USED AS A MINIMUM FOR THE BASE BID. MANUFACTURERS CONSIDERED AS AN EQUAL OR BETTER IN ALL ASPECTS TO THAT SPECIFIED WILL BE SUBJECT TO APPROVAL IN WRITING BY TENANT'S PROJECT MANAGER THROUGH PRIOR SHOP DRAWING SUBMITTAL PROCESS, FOR ACCEPTANCE. THE USE OF ANY UNAUTHORIZED EQUIPMENT SHALL BE SUBJECT TO REMOVAL AND REPLACEMENT AT THE CONTRACTOR'S EXPENSE.
- MECHANICAL CONTRACTOR SHALL SUBMIT ONLY SUBSTITUTION REQUESTS TO TENANT'S PROJECT MANAGER FOR APPROVAL. SUBMISSIONS SHALL BE MADE EARLY ENOUGH IN PROJECT TO ALLOW FOUR (4) WORKING DAYS FOR TENANT'S PROJECT MANAGER'S REVIEW WITHOUT CAUSING DELAYS OR CONFLICTS TO THE JOB'S PROGRESS. SUBMITTALS SHALL BEAR THE STAMP OF GENERAL CONTRACTOR AND THE SUB-CONTRACTOR SHOWING THAT THEY HAVE REVIEWED AND CONFIRMED THAT THE SUBMITTALS ARE IN CONFORMANCE WITH THE CONTRACT DRAWINGS AND SPECIFICATIONS OR INDICATE WHERE EXCEPTIONS HAVE BEEN TAKEN.

SECTION 15006 – GUARANTEE

- THIS CONTRACTOR SHALL GUARANTEE ALL MATERIALS AND WORK PROVIDED UNDER THEIR CONTRACT AND SHALL MAKE GOOD, REPAIR OR REPLACE AT THEIR OWN EXPENSE, ANY DEFECTIVE WORK, MATERIAL, OR EQUIPMENT WHICH MAY BE DISCOVERED WITHIN A PERIOD OF 12 MONTHS FROM THE DATE OF ACCEPTANCE (IN WRITING) OF THE INSTALLATION BY TENANT'S PROJECT MANAGER. EXTENDED WARRANTIES ARE AS SPECIFIED WITH INDIVIDUAL EQUIPMENT.

SECTION 15007 – RECORD DRAWINGS

- THIS CONTRACTOR SHALL MAINTAIN ONE COPY OF DRAWINGS ON THE JOB SITE TO RECORD DEVIATIONS FROM CONTRACT DRAWINGS, SUCH AS:
 - LOCATION OF CONCEALED PIPING VALVES AND DUCTS.
 - REVISIONS, ADDENDUMS, AND CHANGE ORDERS.
 - SIGNIFICANT DEVIATIONS MADE NECESSARY BY FIELD CONDITIONS, APPROVED EQUIPMENT SUBSTITUTIONS, AND CONTRACTOR'S COORDINATION WITH OTHER TRADES.
- AT COMPLETION OF THE PROJECT AND BEFORE FINAL APPROVAL, THE CONTRACTOR SHALL MAKE ANY FINAL CORRECTIONS TO DRAWINGS AND CERTIFY THE ACCURACY OF EACH PRINT BY SIGNATURE THEREON. ONE COPY OF THE MOST RECENT SET OF DRAWINGS WITH TEMPERATURE CONTROL DRAWINGS INCLUDED SHALL BE DELIVERED TO TENANT'S PROJECT MANAGER.

SECTION 15008 – DISCREPANCIES IN DOCUMENTS

- DRAWINGS AND SPECIFICATIONS ARE TO BE CONSIDERED AS SUPPLEMENTING EACH OTHER. WORK SPECIFIED BUT NOT SHOWN ON DRAWINGS, OR SHOWN ON DRAWINGS BUT NOT SPECIFIED, SHALL BE PERFORMED OR FURNISHED AS THOUGH MENTIONED IN BOTH SPECIFICATIONS AND DRAWINGS. IF NOT OTHERWISE DIRECTED, INSTALLATION OF ALL SYSTEMS AND EQUIPMENT SHALL BE IN ACCORDANCE WITH APPLICABLE CODES AND IN ACCORDANCE WITH MANUFACTURER'S INSTALLATION INSTRUCTIONS. WHERE WORK DESCRIBED IN THE SPECIFICATIONS IS IN CONFLICT WITH THE WORK SHOWN ON THE DRAWINGS, THE CONTRACTOR SHALL SUPPLY THE GREATER QUANTITY, QUALITY AND COST VIA THE BID AND CONTACT THE ENGINEER FOR CLARIFICATION ON DIRECTION PRIOR TO INSTALLATION.

SECTION 15009 DEMOLITION

- THIS CONTRACTOR SHALL BE RESPONSIBLE FOR THE COORDINATION OF THE DEMOLITION OF EXISTING WORK AND THE DEMOLITION PROVIDED BY THE GENERAL CONTRACTOR. COORDINATE WITH THE GENERAL CONTRACTOR ANY EXISTING EQUIPMENT REQUIRED TO BE LEFT INTACT.
- EACH CONTRACTOR SHALL VERIFY SCOPE OF WORK WITH THE GENERAL CONTRACTOR FOR THE REMOVAL OF ALL EXISTING FIRE PROTECTION, PLUMBING FIXTURES, PIPING, HVAC UNITS, REFRIGERANT RECAPTURE, EXHAUST FANS, ETC. AND ASSOCIATED ROOF CURBS NOT BEING REUSED ON THIS PROJECT, UNLESS SPECIFICALLY NOTED OTHERWISE. CONTRACTOR MUST VERIFY WITH THE LANDLORD ALL PRESUMED ABANDONED EQUIPMENT, PIPES, DUCTWORK, AND EQUIPMENT PRIOR TO REMOVAL. ROOF CURBS SHALL BE REMOVED AND THE ROOF PATCHED. ALL EXTRANEOUS ITEMS IN THE SPACE OR ON THE ROOF NOT APPLICABLE TO THE NEW WORK MUST BE REMOVED AND ROOF/FLOOR PATCHED/REPAIRED TO MATCH EXISTING STRUCTURE. EXISTING ABANDONED PIPES, DUCTS, OR EQUIPMENT IN THE FLOOR, EMBEDDED IN CONCRETE, OR OTHERWISE INACCESSIBLE ARE TO BE CUT OFF AND SEALED BELOW OR WITHIN FLOOR OR WALL LEVEL WHEN THEY ARE NOT TO BE REUSED IN THIS PROJECT. IF REQUIRED BY LANDLORD OR CODES, ABANDONED PIPING AND/OR DUCTWORK MUST BE REMOVED TO POINT OF ORIGIN. CONFIRM THE EXTENT OF DEMOLITION WITH THE GENERAL CONTRACTOR AND TENANT PRIOR TO BID AND INCLUDE IN BID PROPOSAL AS DIRECTED BY THE GENERAL CONTRACTOR AND TENANT.

SECTION 15010 – CUTTING AND PATCHING

- THE CONTRACTOR SHALL PERFORM ALL CUTTING AND PATCHING AS REQUIRED FOR THE INSTALLATION OF THE WORK UNDER THIS SPECIFICATION. NO CUTTING OF THE STRUCTURE SHALL BE PERMITTED WITHOUT WRITTEN APPROVAL OF THE LANDLORD AND ARCHITECT OR ENGINEER.
- PATCHING SHALL BE OF THE SAME WORKMANSHIP, MATERIAL AND FINISH WITH MANUFACTURER'S INSTALLATION INSTRUCTIONS. PATCHING CONSTRUCTION IN A MANNER SATISFACTORY TO THE ARCHITECT AND TENANT'S PROJECT MANAGER.
- EXISTING UTILITIES, ETC. THAT ARE DAMAGED DURING THE CONSTRUCTION PERIOD, WHETHER OR NOT DUE TO THE CONTRACTOR'S NEGLIGENCE SHALL BE REPAIRED OR REPLACED BY THE CONTRACTOR AND LEFT IN A CONDITION SUITABLE TO THE LANDLORD AND TENANT'S PROJECT MANAGER.

SECTION 15011 – SLEEVES

- THIS CONTRACTOR SHALL PROVIDE SLEEVES TO PROTECT EQUIPMENT OR FACILITIES IN THE INSTALLATION. EACH SLEEVE SHALL EXTEND THROUGH ITS RESPECTIVE FLOOR, WALL OR PARTITION AND SHALL BE CUT FLUSH WITH EACH SURFACE EXCEPT SLEEVES THAT PENETRATE THE FLOOR, WHICH SHALL EXTEND 2" ABOVE THE FLOOR. CONTRACTOR MUST COORDINATE THROUGH THE LANDLORD ANY CORE DRILLING OR CUTTING OF OPENINGS IN MASONRY FLOORS OR WALLS.
- ALL SLEEVES AND OPENINGS THROUGH FIRE RATED WALLS AND/OR FLOORS SHALL BE FIRE SEALED WITH CALCIUM SILICATE, SILICONE "RTV" FOAM, "3M" FIRE RATED SEALANTS LISTED AND LABELED AND SIZED IN CONFORMANCE WITH REQUIREMENTS OF STATE AND LOCAL CODES, WHICHEVER IS MORE STRINGENT.
- SLEEVES IN BEARING AND MASONRY WALLS, FLOORS, AND PARTITIONS SHALL BE STANDARD WEIGHT STEEL PIPE FINISHED WITH SMOOTH EDGES. FOR OTHER THAN MASONRY PARTITIONS, THROUGH SUSPENDED CEILINGS, OR FOR CONCEALED VERTICAL PIPING, SLEEVES SHALL BE NO. 22 U.S.G. GALVANIZED STEEL MINIMUM.

SECTION 15012 – HANGERS

- HANGERS SHALL INCLUDE ALL MISCELLANEOUS STEEL SUCH AS ANGLE IRON, BANDS, C-CLAMPS WITH RETAINING CLIPS, CHANNELS, HANGER RODS, ETC., NECESSARY FOR THE INSTALLATION OF WORK.
- HANGERS SHALL BE FASTENED TO BUILDING STEEL, CONCRETE, OR MASONRY, BUT NOT TO PIPING. HANGING FROM METAL DECK IS NOT PERMITTED. HANGERS MUST BE ATTACHED TO UPPER CHORD OF BAR JOIST. WHERE INTERFERENCES OCCUR, AND IN ORDER TO SUPPORT DUCTWORK OR PIPING, THE CONTRACTOR MUST INSTALL TRAPEZE TYPE HANGERS OR SUPPORTS WHICH SHALL BE LOCATED WHERE THEY DO NOT INTERFERE WITH ACCESS TO FIRE DAMPERS, VALVES, AND OTHER EQUIPMENT. HANGER TYPES AND INSTALLATION METHODS ARE ALSO SUBJECT TO LANDLORD CRITERIA.
- HANGERS FOR ALL INSULATED PIPING SHALL BE SIZED AND INSTALLED FOR THE OUTER DIAMETER OF INSULATION. INSTALL 6" LONG SPLIT CIRCLE GALVANIZED SADDLE BETWEEN THE HANGER AND THE PIPE INSULATION.
- HANGERS AND PIPING OF DISSIMILAR METALS SHALL BE DI-ELECTRICALLY SEPARATED.

DIVISION 15500 – HEATING, VENTILATING, AIR CONDITIONING

SECTION 15501 – SUMMARY OF WORK

- THIS CONTRACTOR SHALL FURNISH ALL LABOR, MATERIALS, EQUIPMENT, ETC. NECESSARY FOR REASONABLY IMPLIED AND INCIDENTAL TO THE FURNISHING, INSTALLATION, COMPLETION AND TESTING OF ALL THE WORK FOR THE HVAC SYSTEMS AS CALLED FOR IN THE SPECIFICATIONS, SHOWN ON DRAWINGS AND AS REQUIRED BY JOB CONDITIONS, TO INCLUDE, BUT NOT BE LIMITED TO THE FOLLOWING:
 - (1) EXISTING 12.5 TON HEAT PUMP/ELEC. COOLING ROOFTOP UNIT WITH ALL ASSOCIATED CONTROLS AND COMPONENTS TO BE REUSED, (3) NEW GENERAL EXHAUST FANS, NEW SUPPLY, RETURN AND EXHAUST DUCTWORK WITH ALL CONTROLS AND ACCESSORIES SPECIFIED.
 - THE AIR DEVICES AS NOTED ON THE PLANS SHALL BE PURCHASED BY THE CONTRACTOR. THE CONTRACTOR SHALL BE RESPONSIBLE FOR SCHEDULING, RECEIVING, VERIFYING QUANTITIES AND INSPECTING FOR DAMAGE AND FILING OF ANY CLAIM FORMS. REFER TO RESPONSIBILITY SCHEDULE AND AIR DEVICE SCHEDULE ON PLANS.
 - ALL MATERIALS SHALL BE NEW AND SHALL FIT THE SPACE AVAILABLE. VERIFY ALL DIMENSIONS AT THE SITE.
 - ALL VALVES, DAMPERS, ETC. SHALL BE SO LOCATED AND INSTALLED TO PERMIT ACCESS FOR SERVICE WITHOUT DAMAGE TO BUILDING OR FINISHED MATERIALS.
- SEQUENCE OF CONTROL (ROOF TOP UNIT)
 - OCCUPIED HOURS.
 - UNIT OUTDOOR AIR DAMPER SHALL OPEN TO ITS MINIMUM POSITION AND UNIT SUPPLY FAN SHALL OPERATE CONTINUOUSLY.
 - UNIT COMPRESSOR(S) SHALL CYCLE SHALL STAGE TO MAINTAIN SPACE SETPOINT.
 - UNIT ECONOMIZER CYCLE SHALL BE INITIATED UPON A SIGNAL FROM OUT DOOR AIR SENSORS, OUTDOOR AIR DAMPER, RETURN AIR DAMPER, AND UNIT COMPRESSOR(S) SHALL CYCLE TO MAINTAIN SPACE SETPOINT.
 - UNOCCUPIED HOURS.
 - UNIT OUTDOOR AIR DAMPER SHALL REMAIN CLOSED AND UNIT SUPPLY FAN SHALL CYCLE ON A SIGNAL FROM SPACE SENSOR.
 - UNIT COMPRESSOR(S) SHALL CYCLE SHALL STAGE WITH UNIT SUPPLY FAN TO MAINTAIN SPACE SETPOINT.

SECTION 15502 – MATERIALS

- REFER TO PLANS FOR SCHEDULES OF EQUIPMENT. ALL EQUIPMENT SHALL BE COMPLETE IN EVERY RESPECT WITH ALL DESIGNS, APPURTENANCES, AND ACCESSORIES PROVIDED TO MEET THE DEVICE INTENT AND OPERATION OF THE SYSTEMS SHOWN ON THE DRAWINGS AND SPECIFIED HEREIN. EQUIPMENT SHALL BE INSTALLED IN STRICT ACCORDANCE WITH THE MANUFACTURER'S INSTRUCTIONS. ALL AIR CONDITIONING EQUIPMENT MUST BE TRAPPED IN ACCORDANCE WITH MANUFACTURERS DATA.
- METAL DUCTWORK – NO FIBERGLASS DUCT ALLOWED
 - EXCEPT AS OTHERWISE INDICATED, FABRICATE AND INSTALL RECTANGULAR AND ROUND DUCTWORK WITH GALVANIZED STEEL, IN ACCORDANCE WITH SMACNA "HVAC DUCT CONSTRUCTION STANDARDS" OF THE LATEST EDITION.
 - INSTALL TURNING VANES IN ALL RIGHT ANGLE ELBOWS IN ALL DUCTS.
 - INSTALL RIGID ROUND AND RECTANGULAR METAL DUCT WITH SUPPORT SYSTEMS INDICATED IN SMACNA STANDARDS. PROVIDE SWAY AND SEISMIC BRACING AS REQUIRED BY STATE AND LOCAL CODES OR BY LANDLORD.
 - ALL JOINTS AND SEAMS SHALL BE SEALED WITH UNITED MCGILL DUCT SEALER OR EQUAL.
 - ALL JOINTS, LONGITUDINAL AND TRANSVERSE SEAMS, AND CONNECTIONS IN DUCTWORK MUST BE SECURELY SEALED USING WELDMENTS; MECHANICAL FASTENERS WITH SEALS, GASKETS, OR MASTICS; MESH AND MASTIC SEALING SYSTEMS; OR TAPES. TAPES AND MASTICS MUST BE LISTED AND LABELED IN ACCORDANCE WITH UL 181A OR UL 181B. ALL LONGITUDINAL AND TRANSVERSE JOINTS, SEAMS AND CONNECTIONS OF SUPPLY AND RETURN DUCTS OPERATING AT STATIC PRESSURES LESS THAN OR EQUAL TO 2" W.G. SHALL BE SECURELY FASTENED AND SEALED WITH WELDS GASKETS, MASTICS (ADHESIVES), MASTIC-PLUS-EMBEDDED FABRIC SYSTEMS OR TAPES (INSTALLED IN ACCORDANCE WITH MANUFACTURER'S INSTALLATION INSTRUCTIONS).
 - MECHANICAL FASTENERS AND SEALS, MASTICS, OR GASKETS MUST BE USED WHEN CONNECTING DUCTS TO FANS AND OTHER AIR DISTRIBUTION EQUIPMENT.
- ALL DUCTWORK SHALL BE INSTALLED WITH INSIDE CLEAR DIMENSIONS AS NOTED ON DRAWINGS. WHERE DUCTWORK SIZE IN LARGER THAN CONNECTED DEVICE SMOOTH DUCT TRANSITIONS SHALL BE INSTALLED JUST PRIOR TO DEVICE CONNECTION.
- MEDIUM PRESSURE DUCT
 - WHERE DUCTWORK IS SPECIFICALLY NOTED AS MEDIUM PRESSURE, IT SHALL BE CONSTRUCTED IN ACCORDANCE WITH SMACNA STANDARDS FOR A PRESSURE RATING OF 4 INCHES WATER COLUMN MINIMUM OR LARGER AS REQUIRED BY LANDLORD.
 - ALL GAUGES AND REINFORCEMENT MUST MEET WITH THE LATEST EDITION OF SMACNA STANDARDS FOR MEDIUM PRESSURE DUCT AND WITH THE LANDLORD'S CRITERIA.
 - CONNECTIONS TO THE LANDLORD'S MEDIUM PRESSURE DUCTWORK SHALL BE MADE WITH "LO-LOSS" SADDLE TEE TAPS BY UNITED MCGILL CORP., OR AS OTHERWISE REQUIRED BY THE LANDLORD.
 - ALL OTHER ITEMS FROM METAL DUCTWORK SPECIFICATION SECTION APPLY TO THIS SECTION, WITH THE EXCEPTION THAT ALL MEDIUM PRESSURE DUCTWORK MUST BE WRAPPED INSULATION, NOT LINED.
- FLEXIBLE COLLARS AT EQUIPMENT SHALL BE PROVIDED IN ALL CONNECTIONS BETWEEN VIBRATING EQUIPMENT AND DUCTS OR CASINGS. FLEXIBLE CONNECTIONS SHALL CONSTRUCTION OF NEOPRENE-COATED FLAMEPROOF FABRIC. PROVIDE ADEQUATE JOINT FLEXIBILITY TO ALLOW FOR MOVEMENT AND PREVENT THE TRANSMISSION OF VIBRATION.
- FLEXIBLE AIR DUCT AT AIR DEVICES SHALL BE MIN. R-5 INSULATED CLASS 1 AND RATED FOR THE OPERATING PRESSURE OF THE SYSTEM. DUCT CONSTRUCTION MATERIAL MUST ADHERE TO LOCAL CODES AND LANDLORD'S REQUIREMENTS.
- FIRE RATED SEALANTS OR EQUAL, SO AS TO RETAIN THEIR FIRE RATING. PROVIDE MANUAL LOCKING QUADRANT VOLUME CONTROL DAMPERS WITH HANDLE OPERATORS IN EACH BRANCH DUCT AND AS SHOWN ON PLANS TO FACILITATE AIR BALANCING. ALL RECTANGULAR DAMPERS IN OUTSIDE AIR, RELIEF AIR, OR RETURN AIR DUCTS ARE TO BE OF OPPOSED BLADE TYPE.
- PROVIDE PRIMARY FIRE DAMPERS WHERE INDICATED OR REQUIRED BY CODES. FIRE DAMPERS SHALL HAVE THE BLADES OUT OF THE AIRSTREAM AND A 165 F FUSIBLE LINK, TYPE B, AS MINIMUM.
- DUCTWORK INSULATION
 - INSTALL INSULATION PRODUCTS IN ACCORDANCE WITH MANUFACTURER'S WRITTEN INSTRUCTIONS, AND IN ACCORDANCE WITH RECOGNIZED INDUSTRY PRACTICES. INSULATION MUST COMPLY WITH NFPA 90A.
 - DUCT SIZES SHOWN ON DRAWINGS ARE INSIDE CLEAR DIMENSIONS.
 - ALL JOINTS MUST BE TAPED SO THAT NO INSULATION FIBER IS VISIBLE. EXTEND DUCTWORK INSULATION WITHOUT INTERRUPTION THROUGH WALLS, FLOORS, AND SIMILAR PENETRATIONS.
 - ALL SUPPLY AIR DUCTWORK IN UNCONDITIONED/INDIRECTLY CONDITIONED SPACE (INCLUDING CONCEALED DIFFUSER BACKS) SHALL BE EXTERNALLY INSULATED WITH 1 1/2" THICK, 1-1/2 LB. DENSITY (R=4.8) DUCT WRAP WITH VAPOR BARRIER. VAPOR BARRIER IS TO BE MAINTAINED THROUGHOUT DUCT SYSTEM.
 - ALL SUPPLY AIR DUCTWORK IN DIRECTLY CONDITIONED SPACE: NONE REQUIRED.
 - RETURN DUCTS (WITHIN 3' OF FIRST CHANGE IN DUCT DIRECTION) : FLEXIBLE GLASS FIBER DUCT LINER: 1/2 INCH THICK
 - ALL ROUND, MEDIUM PRESSURE AND OUTSIDE AIR DUCTWORK SHALL BE EXTERNALLY INSULATED WITH A MINIMUM OF 2" THICK, 1 LB. DENSITY (R=6.0) DUCT WRAP WITH VAPOR BARRIER. VAPOR BARRIER IS TO BE MAINTAINED THROUGHOUT DUCT SYSTEM.

I. TESTING, ADJUSTING, AND BALANCING

- CONTRACTOR SHALL BALANCE, ADJUST & TEST EQUIPMENT TO PROVIDE DESIGN AIR QUANTITIES AND ASSURE PROPER OPERATION OF SYSTEMS. CONTRACTOR SHALL SUBMIT COPIES OF BALANCE/TEST REPORT TO OWNER FOR REVIEW PRIOR TO COMPLETION OF PROJECT. IF A CERTIFIED TEST AND BALANCE REPORT IS REQUIRED BY LANDLORD, CONTRACTOR SHALL COORDINATE ALL REQUIREMENTS WITH LANDLORD AND LOCAL AUTHORITY HAVING JURISDICTION, CONTRACT DIRECTLY WITH AN APPROVED TESTING AND BALANCING AGENCY, AND PROVIDE COMPLETE REPORT TO OWNER AND LANDLORD.

- IF REQUIRED BY THE LANDLORD OR THE LOCAL AUTHORITY HAVING JURISDICTION THE BALANCE REPORT SHALL BE ON THE AABC NATIONAL STANDARD REPORT FORMS OR THE NEBB CERTIFIED REPORT FORMS AS PUBLISHED IN THEIR MOST CURRENT EDITIONS AND SHALL INCLUDE AS A MINIMUM THE FOLLOWING INFORMATION:
 - AABC OR NEBB CERTIFICATION NUMBER AND SIGNATURE OF BALANCING CONTRACTOR.
 - COPY OF A CERTIFICATE OF CONFORMANCE WITH NATIONAL STANDARDS FOR THIS PROJECT.
 - INSTRUMENTATION LIST WITH LAST CALIBRATION DATES.
 - MAKE AND MODEL NUMBERS OF ALL HVAC EQUIPMENT TESTED. AIR CFM AND STATIC PRESSURE READINGS (DISCHARGE AND SUCTION) AS MEASURED BY PITOT TUBE DUCT TRAVERSE AT THE UNIT.
 - MOTOR NAMEPLATE DATA WITH ACTUAL FIELD VOLTAGE AND AMPERAGE READINGS FOR EACH LEG.
 - MOTOR AND FAN RPMs, SHEAVE SIZES AND BELT SIZES.
 - OUTSIDE, RETURN, MIXED AND SUPPLY AIR TEMPERATURES AND VOLUMES SHALL BE MEASURED AT FULL COOLING WITH MINIMUM OUTSIDE AIR. RETURN/RELIEF/SMOKE EVACUATION AIRFLOW SHALL BE BALANCED AND MEASUREMENTS RECORDED BY PITOT DUCT TRAVERSE AT FULL ECONOMIZER AND POWER EXHAUST.
 - MAKE AND MODEL NUMBERS OF ALL AIR DISTRIBUTION EQUIPMENT.
 - FINAL BALANCED AIR VOLUMES AT ALL OUTLETS (INCLUDING RETURNS WHERE DUCTED).
 - INDEXED PLAN WITH DIFFUSER AND RETURN LOCATIONS. ALSO INDICATE IF DIFFUSER IS 3-WAY OR 2-WAY.
 - FINAL BALANCED GPM AT ALL UNITS FOR CHILLED/HOT/CONDENSER WATER WHEN APPLICABLE.
 - CHILLED/HOT/CONDENSER ENTERING AND LEAVING WATER TEMPERATURES WHEN APPLICABLE.
 - PRESSURE DROP THROUGH COILS AND CONTROL VALVES WHEN APPLICABLE.
- IF REQUIRED BY THE LANDLORD OR THE LOCAL AUTHORITY HAVING JURISDICTION THE GENERAL CONTRACTOR SHALL ARRANGE FOR THE TEST AND BALANCE A MINIMUM OF TWO WEEKS PRIOR TO THE REQUIRED DATE AFTER RETURNING TABCO'S "START UP CHECK LIST". ALL WORK SHALL BE COMPLETED PRIOR TO SCHEDULING AIR BALANCE. IN ADDITION, THE BALANCE CONTRACTOR WILL INSPECT AND PREPARE A FINAL PUNCH LIST. THE HVAC CONTRACTOR SHALL REPAIR OR REPLACE ANY DEFECTIVE MATERIALS, EQUIPMENT OR WORKMANSHIP PRIOR TO TENANT'S FINAL WALK THRU AND BEFORE FINAL PAYMENT WILL BE MADE.
- FOUR COPIES OF THE BALANCE REPORT SHALL BE SUBMITTED TO TENANT AND FOUR COPIES TO THE LANDLORD FOR APPROVAL.
- OPERATION AND MAINTENANCE DOCUMENTATION MUST BE PROVIDED TO THE OWNER THAT INCLUDES AT LEAST THE FOLLOWING INFORMATION:
 - EQUIPMENT CAPACITY (INPUT AND OUTPUT) AND REQUIRED MAINTENANCE ACTIONS.
 - EQUIPMENT OPERATION AND MAINTENANCE MANUALS.
 - HVAC SYSTEM CONTROL MAINTENANCE AND CALIBRATION INFORMATION, INCLUDING WIRING DIAGRAMS, SCHEMATICS, AND CONTROL SEQUENCE DESCRIPTIONS; DESIRED OR FIELD-DETERMINED SET POINTS MUST BE PERMANENTLY RECORDED ON CONTROL DRAWINGS, AT CONTROL DEVICES, OR, FOR DIGITAL CONTROL SYSTEMS, IN PROGRAMMING COMMENTS.
 - COMPLETE NARRATIVE OF HOW EACH SYSTEM IS INTENDED TO OPERATE, ALL PIPING SHALL WITHSTAND AIR PRESSURE TESTING PER GOVERNING PLUMBING CODE.

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MISSOURI STATE CERTIFICATE OF AGENCY #C019851 mechanical • electrical consulting engineering 0420758-07-00

PURE BARRE INTERIOR TENANT IMPROVEMENT 910-U NORTHWEST BLUE PARKWAY LEE'S SUMMIT, MO 64086 MECHANICAL SPECIFICATIONS

PROJECT LOCATION SHEET TITLE

STAMP

STATE OF MISSOURI GREGORY M. STEINMETZ REGISTERED PROFESSIONAL ENGINEER

4/13/20

REVISIONS

- 4/13/2020 OWNER CHANGES
-
-
DATE 2020.04.10 PROJECT NUMBER A2275

SHEET NUMBER

M2.0

FLOWATER REFILL STATIONS

SPECIFICATIONS

GENERAL

Indoor/outdoor stand-alone, refrigerated, 7x purified water Refill Station. Refill Stations require 1" clearance (5" recommended) from walls and/or structures and must be placed under cover when outdoors. No direct sunlight.

CERTIFICATIONS/STANDARDS

ISO 9001

NSF/ANSI 42, 53 & 58
NSF/ANSI 42: ensures that chlorine, taste, odor, and particulates are filtered out. NSF/ANSI 53: ensures health-related contaminants are filtered out. NSF/ANSI 58: ensures fluoride, chromium, nitrates, and TDS are reduced.

ADA Compliant: These Refill Stations comply with the requirements of the ADA (Americans with Disabilities Act).

FEED WATER

Refill Stations have been designed and built to purify municipal tap water most efficiently at 70 psi. Refill Stations are designed to operate on 50 psi to 100 psi supply line pressure. If inlet pressure is above 100 psi, a pressure regulator must be installed in the supply line. Any damage caused by reason of connecting this product to supply line pressure slower than 50 psi or higher than 100 psi is not covered under FloWater's service policy. Refill Stations are designed to operate in ambient temperatures 40°F-104°F (ambient temperatures greater than 104°F can result in damage to the carbon and advanced osmosis filters). Refill Stations should be placed indoors if ambient temperatures ever drop below 32°F. Any damage caused by exposure to ambient temperatures below 32°F is not covered under FloWater's service policy. Operate only in non condensing humidity. Refill Stations are prepped with a 1/4" John Guest quick-connect fitting located in rear, lower left of unit and require a 1/4" waterline. A water shut-off valve located behind should be installed.

DRAIN WATER

Advanced Osmosis: Refill Stations utilizing advanced osmosis require a drain. Advanced osmosis product water to bypass water is a 1:2 ratio at 70 psi. Lower water pressure results in lower advanced osmosis efficiency. Refill Stations are prepped with a 1/4" John Guest quick-connect fitting located in rear, lower left of unit and require 1/4" drain line. Depending on local plumbing codes, FloWater may install an FDA and NSF certified check valve/backflow preventer on the drain line. Drain lines can be run up to 10' vertically and 100' horizontally with system pressure.

PURIFICATION

Refill Stations use a 7x purification system, including: a semi-carbon filter, carbon filter, advanced osmosis, coconut carbon filter, mineral filter, alkaline filter, and activated oxygen. This purification system has been designed to handle hard water, but may require more regular advanced osmosis or UF filter changes.

CHILLING SYSTEM

Chilling Capacity:
33.8°F-34.7°F
32.9°F-35.6°F (factory default)
35.6°F-42.8°F
37.4°F-44.6°F

Chilling capacity of drinking water based upon 80°F inlet water and 90°F ambient. The reserve tank that feeds the chilling tank is five gallons. The chilling tank is two gallons.

Power Draw:

119.3 volts, 0.29 Amps, 30 Watts, 60 Hz (compressor off), 121 volts, 2.5 Amps, 165 Watts 60 Hz (compressor running)

Motor Compressor: Hermetically sealed, rotating type, 110-115VAC, 60Hz single phase. Sealed-in lifetime oil supply. Equipped with electric cord and three prong (grounded) molded rubber plug.

Condenser: Air-cooled condenser with steel wire tube. Tube emits heat in natural ambient air. Cooling Unit: Combination tube-tank type. Tube portion is continuous coil of copper tubing. Tank is stainless steel. Fully insulated with EPS foam which meets Underwriters Laboratories Inc. requirements for self-extinguishing material.

Refrigerant Control: Refrigerant HFC134a is controlled by accurately calibrated capillary tube for trouble-free operation. It is an environmentally friendly refrigerant gas.

Temperature Control: Enclosed adjustable thermostat is initially set to maintain water temperature between 32.9°F and 35.6°F. Requires no adjustment other than for altitude requirements. See Chilling Capacity section for available temperature ranges.

ADA COMPLIANCE

FloWater Refill Stations comply with ADA reach requirements with a maximum reach of 48".

PLUMBING

---	DOMESTIC COLD WATER
---	DOMESTIC HOT WATER
---	DOMESTIC RECIRCULATING HOT WATER
---	SANITARY VENT - ABOVE GRADE
---	SANITARY WASTE - BELOW GRADE
---	SANITARY WASTE - ABOVE GRADE
---	STORM DRAIN - BELOW GRADE
---	STORM DRAIN - ABOVE GRADE
---	FIRE PROTECTION

PLUMBING/PIPING

---	ELBOW DOWN	
---	PIPE CAP	
---	ELBOW UP	
---	TEE, OUTLET UP	
---	TEE, OUTLET DOWN	
---	CONNECTION, BOTTOM	
---	CONNECTION, TOP	
---	FLEXIBLE CONNECTION	
---	CHECK VALVE	
---	SHUTOFF VALVE	
---	PLUG VALVE	
---	STRAINER W/BLOWDOWN VALVE AND CAP	
---	PRESSURE REDUCING VALVE (SETTING AS NOTED, PSI)	
---	AUTOMATIC CONTROL VALVE, 2-WAY	
---	THERMOSTATIC MIXING VALVE	
---	VACUUM BREAKER	
---	PRESSURE RELIEF/SAFETY VALVE (SETTING AS NOTED, PSI)	
---	DRAIN VALVE	
---	BALL VALVE	
---	BUTTERFLY VALVE	
---	GLOBE ANGLE VALVE	
---	REDUCED PRESSURE ZONE BACKFLOW PREVENTER	
---	GLOBE VALVE	
---	GAS PRESSURE REGULATOR VALVE	
---	FLOW DIRECTION	
---	PIPE UNION	
---	PIPE FLANGE	
---	PUMP	
---	PRESSURE GAUGE W/ PIGTAIL & PETCOCK	
---	THERMOMETER	
---	PRESSURE/TEMPERATURE TEST PORT	
---	SHOCK ABSORBER	
---	ELBOW	
---	TEE	
---	FLOOR DRAIN	
---	FLOOR SINK	
---	WH	WALL HYDRANT
---	HB	HOSE BIBB
---	---	FLOOR CLEANOUT
---	---	GRADE CLEANOUT
---	---	WALL CLEANOUT
---	---	CLEANOUT
---	---	GAS COCK VALVE
---	---	ROOF DRAIN
---	---	POINT OF CONNECTION, NEW TO EXISTING
---	---	POINT OF DISCONNECTION

FIXTURE UNIT COUNT

ITEM	DESCRIPTION	QTY	TRAP SIZE	D.F.U.	TOTAL D.F.U.	W.S.F.U.	TOTAL W.S.F.U.
WC-1	WATER CLOSET (TANK TYPE)	2	3"	4.0	8.0	5.0	10.0
L-1	LAVATORY	2	1.50"	2.0	4.0	2.0	4.0
SS-1	MOP SINK	1	2"	2.0	2.0	3.0	3.0
DF-1	DRINKING FOUNTAIN	1	1.50"	.5	.5	.5	.5
FD-1	FLOOR DRAIN (EMGY)	2	2"	0.0	0.0	-	-
FW-1	FLOW WATER	1	1.50"	.5	.5	.5	.5
TOTAL FIXTURE UNITS:				D.F.U.	15.0	W.S.F.U.	18.0
W.S.F.U.	18.0 FU = 18.5 GPM (1" METER AND WATER SERVICE)						
D.F.U. SAN	15.0 FU = 4" PIPING HORIZONTAL @ 1/4" PER FOOT SLOPE						


WATER HEATER SCHEDULE

EQUIP NO	STORAGE CAPACITY (GALLONS)	RECOVERY (GPH)	TEMP RISE (°F)	ELECTRIC INPUT (KW)	MANUFACTURER	MODEL NUMBER	REMARKS
WH-1	6	6	100	1.5	A.O. SMITH	DEL-6	APPROVED EQUALS ACCEPTED - CONFIRM VOLTAGE WITH ELECTRICAL CONTRACTOR

PLUMBING FIXTURE SCHEDULE


KEY	FIXTURE	WASTE	TRAP	VENT	COLD WATER	HOT WATER	REMARKS
WC-1	AMERICAN STANDARD: CADET RIGHT HEIGHT 2467.100 ELONGATED - 1.1 GPF - PRESSURE ASSISTED ADA COMPLIANT	3"	INT	2"	1/2"	-	FURNISH WITH CHURCH OPEN FRONT SEAT MODEL NO. 5901.110 A.D.A. COMPLIANT COLOR TO BE WHITE.
L-1	AMERICAN STANDARD: LUCERNE MODEL: 0355.012 - FACTORY SET .25 GALLON PER FLOW ACTIVATION (METERING FAUCET).	2"	1 1/2"	1 1/2"	1/2"	1/2"	ADA, PROVIDE AMERICAN STANDARD METERING FAUCET:1340.225 W/ METAL DRAIN & BRASS P-TRAP
FD-1	ZURN: Z415 (ADJUSTABLE)	2"	2"	1 1/2"	-	-	6"ø TYPE 'N' NICKEL BRONZE TOP W/ TRAP PRIMER CONNECTION
SS-1	FIAT #MSB2424 - WITH CHICAGO FAUCET 897-CP WITH INTEGRAL VACUUM BREAKER & PAIL HOOK.	3"	3"	1 1/2"	3/4"	3/4"	FLOOR MOUNTED MOP SINK, 24"x24"x10" MOLDED HIGH DENSITY COMPOSITE MOP BASIN WITH INTEGRAL MOLDED SELF DRAINING MOP SHELF.
IP-1	TRAP PRIMER: JOSAM MODEL 88300	-	-	-	1/2"	-	INTEGRAL BFP AND VACUUM BREAKER MOUNT ABOVE CEILING
DF-1	HI-LO DRINKING FOUNTAIN ELKAY MODEL LVRCCHTL8SC	2"	1 1/2"	1 1/2"	1/2"	-	ADA COMPLIANT, WALL MOUNTED ACCESSIBLE
TMV-1	WATTS: LFMMV	-	-	-	1/2"	1/2"	THERMAL MIXING VALVE. MAX OUTLET TEMP. 110 DEG F. IN ACCORDANCE WITH ANSI/ASSE 1017, 1069 & 1070 LISTINGS
FCO	ZURN: ZN-1400 (ADJUSTABLE)	4"	-	-	-	-	NICKEL BRONZE TOP
FW-1	FLOWATER REFILL STATION	2"	2"	1 1/2"	1/2"	-	PROVIDE WALL MOUNTED INDIRECT DRAIN WITH AIR GAP AND A ASSE 1024 DUAL CHECK VALVE. COORDINATE ALL REQUIREMENTS WITH FLOWATER REPRESENTATIVE IN FIELD.

NOTE: ALL FIXTURES MAY BE SUBSTITUTED WITH APPROVED EQUAL. CONTACT OWNER FOR APPROVAL

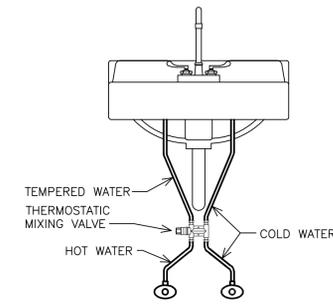

NOTE: SET TEMPERED WATER TEMPERATURE TO 110 DEG F MAX.

1 THERMOSTATIC MIXING VALVE DETAIL NOT TO SCALE

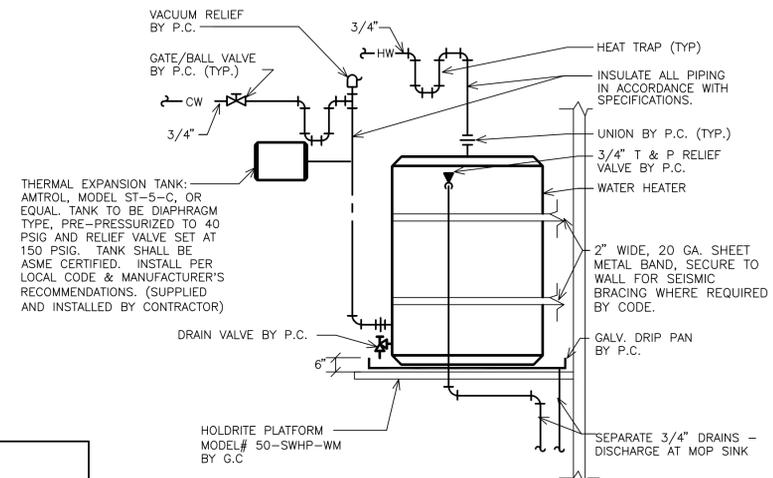


2 WATER HEATER DETAIL NOT TO SCALE

myflowater.com **FLOWATER** 877.772.7775

FLOWATER REFILL STATIONS

INSTALLATION

Installation with Advanced Osmosis

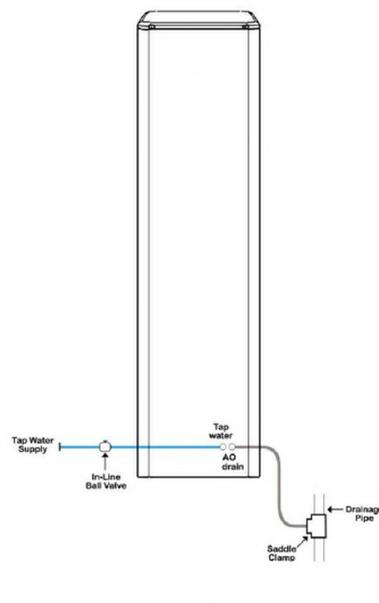

myflowater.com **FLOWATER** 877.772.7775

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consulting engineering
0420758-073-00

PURE BARRE
INTERIOR TENANT IMPROVEMENT
910-U NORTHWEST BLUE PARKWAY
LEE'S SUMMIT, MO 64086

PROJECT LOCATION

SHEET TITLE
PLUMBING SCHEDULES AND DETAILS

STAMP

STATE OF MISSOURI
GREGORY M. STEINMETZ
PLUMBING CONTRACTOR

4/13/20

REVISIONS

4/13/2020 OWNER CHANGES

DATE
2020.04.10

PROJECT NUMBER
A2275


SHEET NUMBER

P2.0

PERMIT SET : 2020_04_10

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LIGHTING SCHEDULE							
ARCHITECTURAL FIXTURE TYPES - ROW HOUSE PROTOTYPE							
FIXTURE DESIGNATION	SYMBOL	DESCRIPTION	WATTS	VOLTAGE	MANUFACTURER	MODEL #	REMARKS
F1		SUSPENDED 2'X4' LED PANEL LIGHT, DIRECT/INDIRECT	50W	120V	KONLITE	KK-PS-24DW-50-LFSZ	SUSPENSION MOUNTED AT 10' A.F.F. IN LOBBY / CHECK-IN AREA. G.C. TO PROVIDE SUSPENSION MOUNTING KIT.
F2		RECESSED 2'X4' LED TROFFER, DIRECT/INDIRECT	31W	120V	LITHONIA LIGHTING	2BLT4-48L-ADP-EZ1-LP840	RECESSED AT STUDIO AREA.
F2E		RECESSED 2'X4' LED TROFFER, WITH EMERGENCY BATTERY PACK	31W	120V	LITHONIA LIGHTING	2BLT4-48L-ADP-EZ1-LP840-E10WLC	RECESSED AT STUDIO AREA.
F3		6" RECESSED LED DOWNLIGHT	12.7W	120V	LITHONIA LIGHTING	LDN6-40-20-L06-WH-LD-MVOLT-EZ1	RECESSED MOUNT IN GYP. CEILING IN RESTROOM AND RECESSED MOUNT IN ACT CEILING IN STUDIO.
F5A		EXIT, SNGL/DOUBLE, RED LETTERS, HIGH LUMEN, UNIVERSAL MOUNTED, SELF POWERED, REMOTE CAPABLE	3	DV	LITHONIA LIGHTING	LHQM-LED-R-HO RO	WALL/ CEILING MOUNT
F5B		EXIT, SNGL/DOUBLE, RED LETTERS, EMERGENCY LIGHT COMBINATION, HIGH LUMEN, UNIVERSAL MOUNTED, SELF POWERED, REMOTE CAPABLE	3	DV	LITHONIA LIGHTING	LHQM-LED-R-HO	WALL/ CEILING MOUNT
F6		DOUBLE HEAD EMERGENCY UNIT	14.2	UNIV	LITHONIA LIGHTING	ELM6L EMERGENCY LIGHT	WALL/ CEILING MOUNT PROVIDE WITH 90 MINUTE BATTERY.
F7		DOUBLE HEAD EMERGENCY UNIT, WET LOCATION REMOTE CAPABLE	7W	120V	LITHONIA LIGHTING	WLTU MR	WALL MOUNT PROVIDE WITH 90 MINUTE BATTERY AT FRONT ENTRY ON EXTERIOR SIDE.

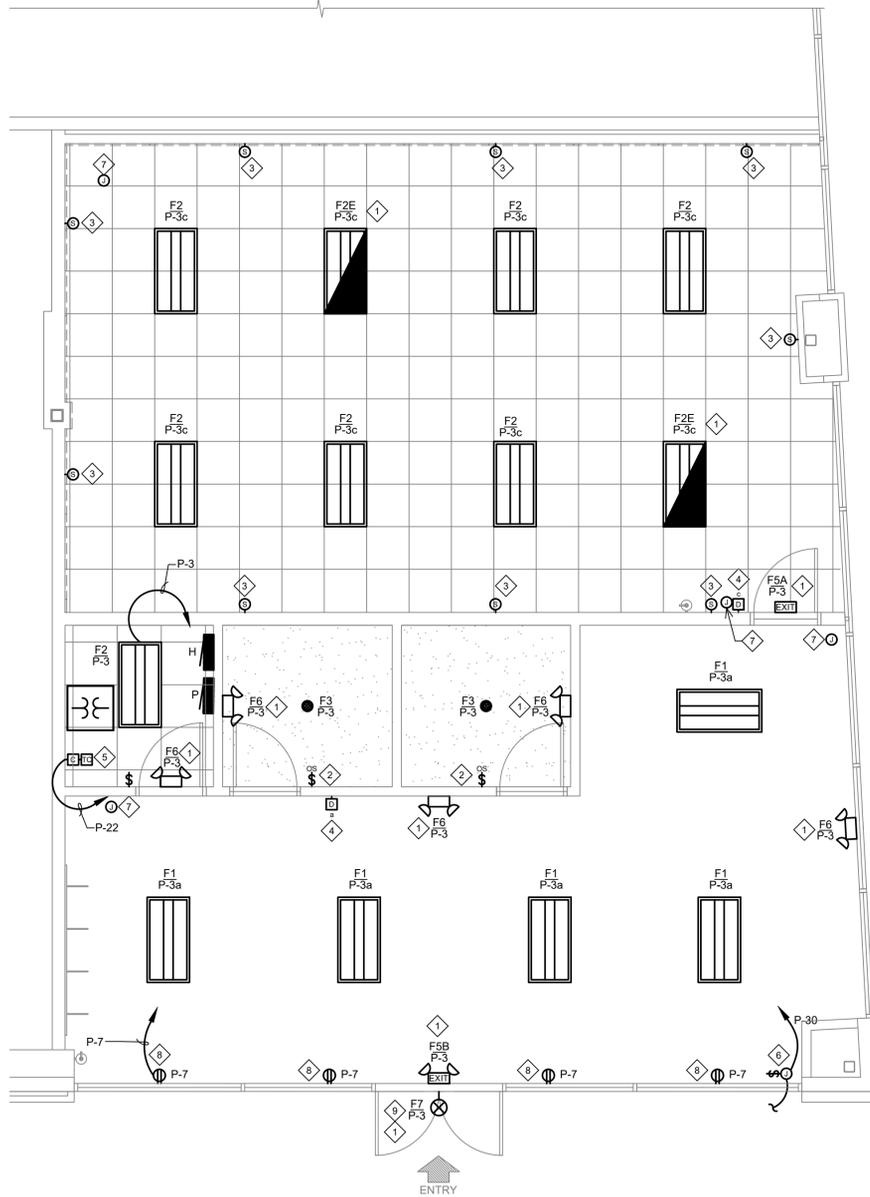

1 LIGHTING FLOOR PLAN
1/4" = 1'-0"

GENERAL NOTES:

- REFER TO ARCHITECTURAL REFLECTED CEILING PLAN FOR EXACT LOCATIONS OF LUMINAIRES.
- EACH LUMINAIRE SHALL BE STRUCTURALLY SUPPORTED; DO NOT USE CONDUIT FOR SUPPORT FOR EITHER FIXTURES OR BOXES.
- USE FLEXIBLE METAL CONDUIT (GREENFIELD) FOR CONNECTION OF LAY-IN FIXTURES.
- PROVIDE GROUND CONDUCTOR IN ALL CONDUIT RUNS.
- THOUGH WIRING OF FIXTURES SHALL NOT BE PERMITTED UNLESS SPECIFICALLY ILLUSTRATED.
- EACH LUMINAIRE SHALL HAVE ITS OWN BOX UNLESS OTHERWISE ILLUSTRATED.
- VERIFY LOCATION OF WALL MOUNTED EMERGENCY LUMINAIRES TO AVOID CONFLICT WITH WOOD TRIM
- REFER TO ARCHITECTURAL FOR EXACT LOCATION OF LUMINAIRES COORDINATE WITH ARCHITECT FOR LOCATION OF LUMINAIRES AND DEVICES BEFORE ROUGH-IN.
- ALL ELECTRICAL RUNS IN THE OPEN CEILING AREA OF THE TENANT PREMISES IN THE FRONT OF HOUSE MUST BE RIGID CONDUIT. THE USE OF FLEX CONDUIT IS PROHIBITED. IN ADDITION, ANY ELECTRICAL RUN FROM THE CEILING TO A SUSPENDED LIGHT FIXTURE MUST BE HIDDEN IN A RIGID SLEEVE. RIGID CONDUIT IS REQUIRED EVERYWHERE VISIBLE TO THE PUBLIC.
- G.C. SHALL BE RESPONSIBLE FOR FUNCTIONAL TESTING OF LIGHTING CONTROL SYSTEMS TO ENSURE PROPER CALIBRATION, ADJUSTMENT, AND OPERATION PER SECTION C408.3 OF THE 2015 INTERNATIONAL ENERGY CONSERVATION CODE.

KEY NOTES:

- PROVIDE UNSWITCHED HOT TO ALL, EXIT, EMERGENCY, AND NIGHT LIGHTS TO BYPASS SWITCH CONTROLS. THIS MAY BE IN ADDITION TO SWITCHED HOT.
- PROVIDE LUTRON MAESTRO WALL MOUNTED OCCUPANCY SENSOR MODEL NO. MS-A102-0.
- PROVIDE 16/2 PLENUM RATED SPEAKER CABLE AT LOCATION SHOWN. SPEAKERS MOUNTED AT 9'0" A.F.F. ROUTE SPEAKER TO A/V RACK. PROVIDE 15' SLACK AT EACH END. SEE SHEET E3.0 FOR A/V RACK LOCATION.
- PROVIDE LUTRON DIVA 0-10V DIMMER DVTV-WH WITH POWER PACK PP-DV.
- PROVIDE 2 CHANNEL INTERMATIC ASTRONOMIC TIME CLOCK MODEL NO. ET8215C WITH 0-2 HOUR SPRING WOUND TIMER AND 4 POLE LIGHTING CONTACTOR, CONNECT SIGN, INTERIOR LIGHTING AND SHOW WINDOW RECEPTACLES.
- PROVIDE JUNCTION BOX WITH DISCONNECT SWITCH IN CONCEALED LOCATION FOR CONNECTION TO STOREFRONT SIGN LIGHTING. LOCATE DISCONNECT SWITCH IN CONCEALED ACCESSIBLE LOCATION PER NEC 600.6. E.C. SHALL MAKE FINAL CONNECTION TO SIGN AND CONTROL VIA TIME CLOCK.
- PROVIDE (1) CAT6 PLENUM RATED CABLE FOR EACH CAMERA LOCATION. THE CABLE SHALL RUN FROM EACH CAMERA BACK TO THE A/V RACK WITH A 15' WHIP LEFT AT EACH CAMERA LOCATION AND A 15' WHIP PROTRUDING FROM THE 2 GANG A/V CUT IN RING AT THE AV RACK. SEE SHEET E3.0 FOR A/V RACK LOCATION.
- PROVIDE SHOW WINDOW RECEPTACLE WITHIN 18" OF THE TOP OF THE WINDOW PER NEC 210.62.
- VERIFY IF THERE IS ADEQUATE GENERAL & EMERGENCY LIGHTING PRESENT. IF NOT COORDINATE WITH LANDLORD AND PROVIDE NEW.



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PURE BARRE
INTERIOR TENANT IMPROVEMENT
910-U NORTHWEST BLUE PARKWAY
LEE'S SUMMIT, MO 64086
PROJECT LOCATION
SHEET TITLE
FLOOR PLAN - LIGHTING

PROJECT LOCATION
SHEET TITLE



4/13/2020

REVISIONS

▲	4/13/2020	OWNER CHANGES
▲		
▲		
▲		
▲		
▲		

DATE
2020.04.10
PROJECT NUMBER
A2275

SHEET NUMBER

E2.0

PERMIT SET : 2020_04_10


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ITEM NO	DESCRIPTION	MCA	KW	VOLTS	PHASE	DISCONNECT	BKR	PNL-CKT	WIRE	GROUND	NOTES
RTU-1	EXISTING ROOFTOP UNIT	84.00	--	480	3	100A/3P NON-FUSED	90A/3P	H-2,4,6 H-8,10,12	1 1/4" C. 3#3	1 #8	1,2,3,4
WH-1	WATER HEATER		1.5	120	1	LOCK OFF DEVICE	20A/1P	P-1	1/2" C. 2 #12	1 #12	1,3,4
EF-1	EXHAUST FAN	--	0.137	120	1	20A/1P MOTOR RTD. SW.	20A/1P	P-3	1/2" C. 2 #12	1 #12	1
EF-2	EXHAUST FAN	--	0.137	120	1	20A/1P MOTOR RTD. SW.	20A/1P	P-3	1/2" C. 2 #12	1 #12	1
EF-3	EXHAUST FAN	--	0.137	120	1	20A/1P MOTOR RTD. SW.	20A/1P	P-3	1/2" C. 2 #12	1 #12	1

- MOTOR/EQUIPMENT SCHEDULE NOTE (NOT ALL NOTES MAY BE USED)**
- VERIFY REQUIREMENTS OF EQUIPMENT.
 - PROVIDE DUCT SMOKE DETECTOR & ALL CONNECTIONS WITHIN RETURN DUCT TO SHUT DOWN UNIT UPON ALARM. SEE KEYNOTE 11 ON SHEET E3.0
 - VERIFY NAMEPLATE RATING ON UNIT AS IT MAY DIFFER FROM LOADS SHOWN HERE.
 - PROVIDE CONNECTION TO MECHANICAL CONTRACTOR PROVIDED CONTROLS AS REQUIRED.
 - FAN TO REMAIN ON DURING OCCUPIED HOURS

- GENERAL NOTES:**
- REFER TO MECHANICAL AND PLUMBING DRAWINGS FOR EQUIPMENT LOCATION & REQUIREMENTS.
 - ALL RECEPTACLES & OUTLETS LOCATED ON FURNITURE SHALL BE COORDINATED WITH ARCHITECTURAL DRAWINGS PRIOR TO ROUGH-IN.
 - VERIFY EXACT LOCATION OF ALL EQUIPMENT PER THE ARCHITECTURAL DRAWINGS.
 - ALL EXTERIOR DISCONNECTS SHALL BE N.E.M.A. 3R RATED.
 - EXTERIOR RECEPTACLES SHALL BE WEATHERPROOF TYPE WITH IN-USE COVERS.
 - COORDINATE WITH ARCHITECTURAL PLANS FOR TV MOUNTING HEIGHTS & LOCATIONS PRIOR TO ROUGH-IN.
 - ALL CAT6 PLENUM 16/2 S0ESL0Z CABLES NEED 10' MINIMUM OF SLACK AT ALL FIELD LOCATIONS AND 15' MINIMUM OF SLACK AT A/V RACK LOCATION FOR RACK AND INSTRUCTOR STAND CABLE DRESSING.

- KEY NOTES:**
- EXISTING ELECTRICAL PANELS & SUSPENDED TRANSFORMER TO REMAIN. SEE RISER DIAGRAM FOR MORE INFORMATION.
 - PROVIDE (2) DEDICATED 20A CIRCUITS WITH (2) QUAD RECEPTACLES LOCATED AT A/V RACK.
 - PROVIDE (2) 1-1/2" CONDUITS STUBBED UP 6" ABOVE DROP CEILING TILE AND RUN TO A 2 GANG CUT OUT RING AT THE AV RACK ADJACENT TO THE RECEPTACLE. PROVIDE (2) CAT 6 PLENUM RATED CABLES FROM TENANT UTILITY TELEPHONE BACKBOARD TO A/V RACK LOCATION.
 - PROVIDE QUAD RECEPTACLE AT FRONT DESK FOR POS COMPUTER. SEE ARCHITECTURAL AND MILLWORK DRAWINGS FOR ADDITIONAL INFORMATION.
 - PROVIDE A/V CUT IN RING AT LOCATION SHOWN.
 - PROVIDE (2) CAT6 PLENUM RATED DATA CABLES ADJACENT TO FRONT DESK POWER AND TERMINATE WITH KEYSTONE JACKS ABOVE FLOOR WITHIN MILLWORK. ROUTE DATA CABLES TO A/V RACK WITH A 15' WHIP.
 - COORDINATE WITH LANDLORD FOR EXACT LOCATION OF INCOMING CONDUIT AND PULL STRING FOR TELEPHONE SERVICE. EXTEND CONDUIT TO TELEPHONE BACKBOARD. COORDINATE WITH PHONE COMPANY & LANDLORD FOR CABLE REQUIREMENTS. PROVIDE ALL REQUIRED CABLE AND FINAL CONNECTIONS.
 - ROUTE CONDUIT AND CABLING ABOVE FINISHED FLOOR, WITHIN INTERIOR SIDE OF MILLWORK.
 - 42"x16"x3/4" FIRE RETARDANT AC GRADE PLYWOOD TELEPHONE BOARD. EXTEND CONDUIT FROM EXISTING LANDLORD COMMUNICATION CONDUIT. COORDINATE EXACT LOCATION.
 - PROVIDE (2) USB/COMBO RECEPTACLES FOR IPAD CHECK IN AT FRONT DESK. ROUTE CONDUIT ALONG INSIDE PATH OF MILLWORK.
 - ELECTRICAL CONTRACTOR TO INSTALL NEW DUCT SMOKE DETECTOR IN RETURN MAIN DUCT OF EXISTING RTU IF NOT EXISTING. SMOKE DETECTOR FURNISHED BY MECHANICAL CONTRACTOR IF NOT EXISTING. SMOKE DETECTOR SHALL SHUT DOWN HVAC UNIT UPON DETECTION OF SMOKE AND BE CONNECTED TO THE FIRE ALARM SYSTEM AS REQUIRED.
 - EXISTING RTU TO REMAIN. VERIFY EXISTING DISCONNECT & SERVICE RECEPTACLE WITH IN USE COVER. PROVIDE NEW AS REQUIRED. PROVIDE NEW CONNECTIONS. SEE MECHANICAL EQUIPMENT SCHEDULE ON THIS SHEET FOR ADDITIONAL INFORMATION.

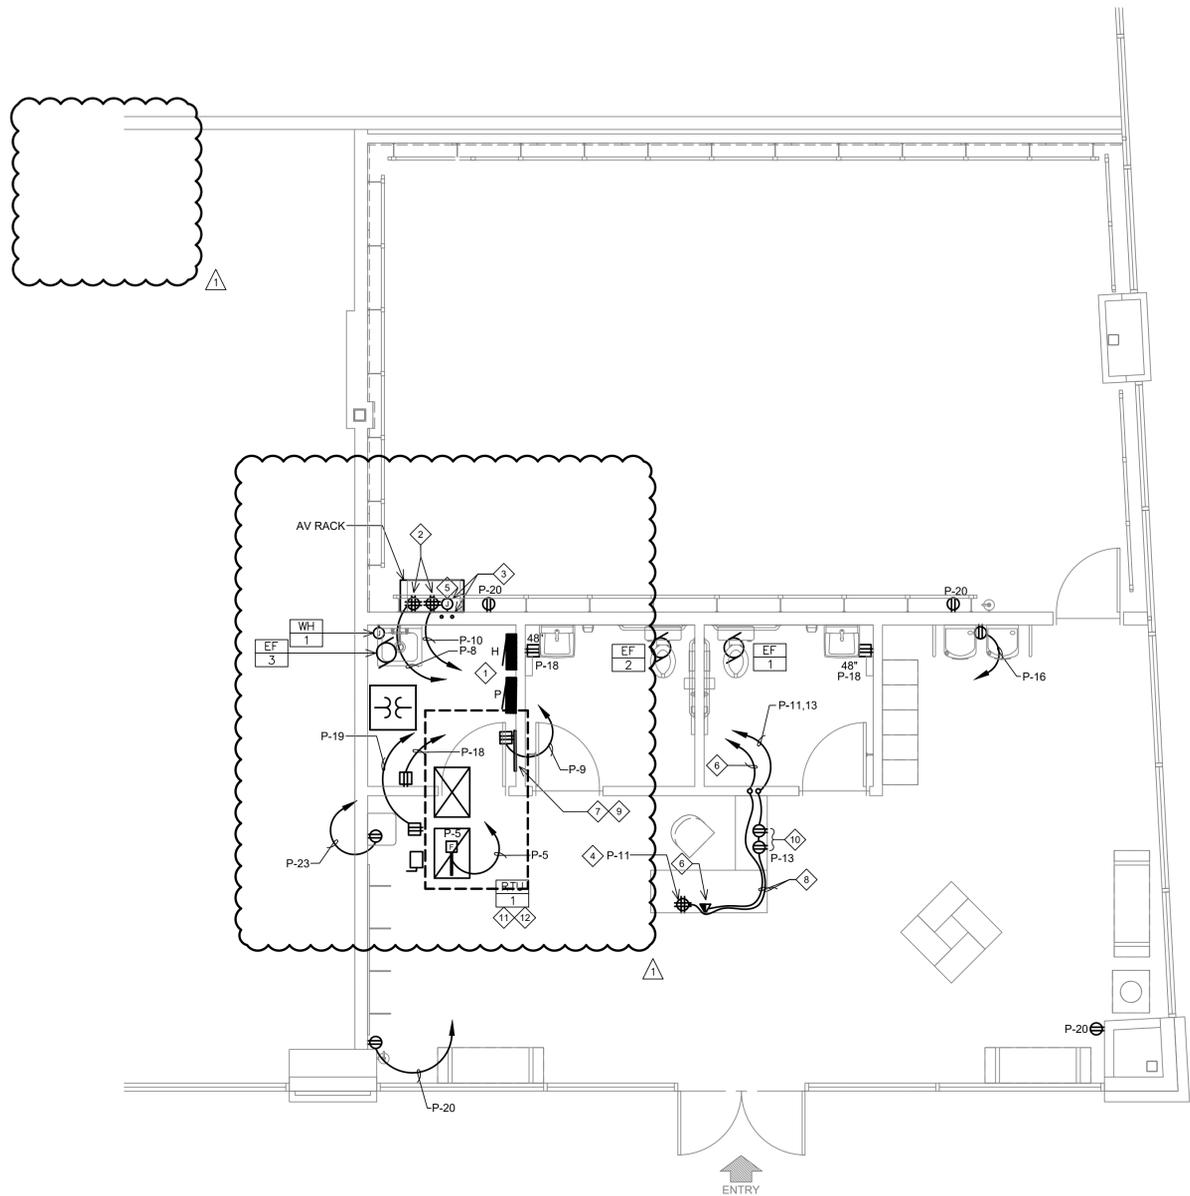

1 POWER FLOOR PLAN
1/4" = 1'-0"



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consulting engineering
0420758-073-00

PURE BARRE
INTERIOR TENANT IMPROVEMENT
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PROJECT LOCATION
SHEET TITLE
FLOOR PLAN - POWER & SYSTEMS

STAMP
Mark J. Azire
2020.04.13
14:06:25-05:00
PROFESSIONAL ENGINEER
NUMBER
070036244
4/13/2020

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REVISIONS

△	4/13/2020	OWNER CHANGES
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DATE
2020.04.10
PROJECT NUMBER
A2275

SHEET NUMBER
E3.0

PERMIT SET : 2020_04_10

Filename: 4/13/2020_1220_PMI (revs) File: 073_04.10.dwg


ELECTRICAL CONTRACTOR SHALL VISIT SITE AND NOTIFY ENGINEER OF ANY DISCREPANCIES PRIOR TO BID. EXISTING EQUIPMENT TO BE REUSED WILL BE REQUIRED TO SATISFY THE REQUIREMENTS OF THE CURRENT NEC WITH REGARDS TO RATING, IDENTIFICATION, USE, WIRE BENDING SPACE, ETC. AS IF THEY WERE NEW.

PROVIDE NEW CIRCUIT BREAKERS IN PANELS AS REQUIRED. MATCH EXISTING EQUIPMENT WITH RESPECT TO MANUFACTURER AND RATING

RISER LEGEND

DASH LINE TYPE INDICATES EXISTING EQUIPMENT TO REMAIN

CONTINUOUS LINE TYPE INDICATES NEW EQUIPMENT TO BE INSTALLED BY CONTRACTOR

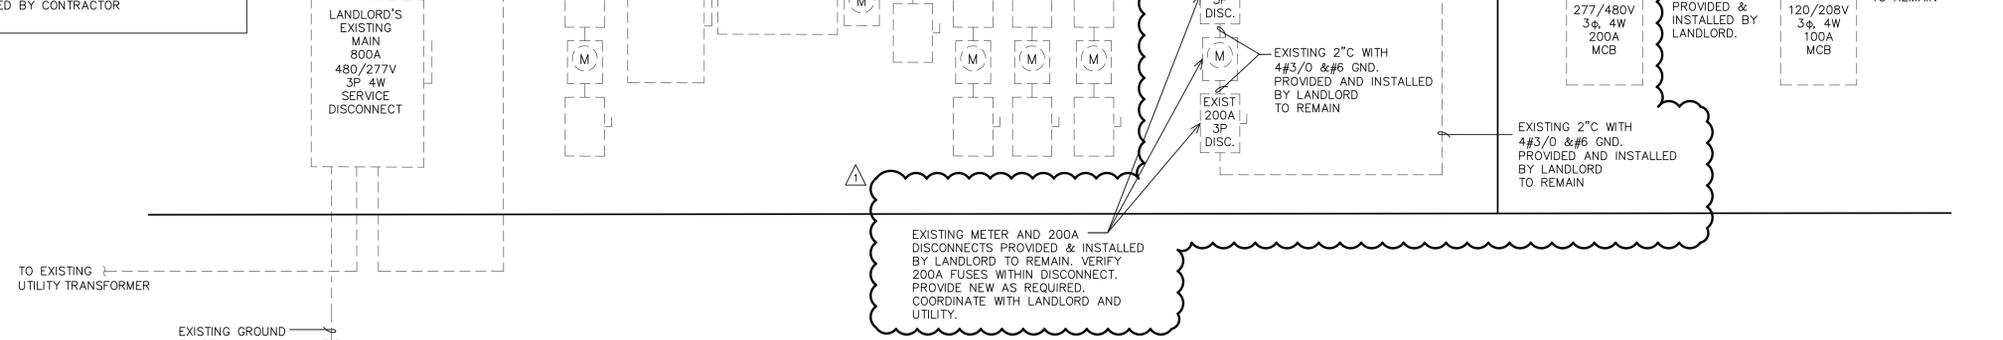

1 RISER DIAGRAM
NO SCALE

Panel : H		Voltage: 277/480V, 3PH, 4W								
No.	Amp/φ Note	Description	Ph	Code L VA	Code C VA	Code R VA	Code M VA	Code E VA	Code K VA	Code D VA
1	50 1	30 KVA TRANSFORMER PANEL P	- A -		1440	2580				
3	/		- B -	617		970	410			
5	3		- C -	1200	540	1260				
7	-	SPACE	- A -							
9	-	SPACE	- B -							
11	-	SPACE	- C -							
13	-	SPACE	- A -							
15	-	SPACE	- B -							
17	-	SPACE	- C -							
19	-	SPACE	- A -							
21	-	SPACE	- B -							
23	-	SPACE	- C -							
25	-	SPACE	- A -							
27	-	SPACE	- B -							
2	90	EXISTING RTU-1	- A -			4986	20000			
4	/		- B -			4986	20000			
6	3		- C -			4986	20000			
8	-	SPACE	- A -							
10	-	SPACE	- B -							
12	-	SPACE	- C -							
14	-	SPACE	- A -							
16	-	SPACE	- B -							
18	-	SPACE	- C -							
Through - Feed Lug Connection			- A -							
			- B -							
			- C -							
Main Breaker			- A -		1440	2580	4986	20000		
			- B -	617		970	5396	20000		
			- C -	1200	540	1260	4986	20000		
Breaker Notes:										
1 - PROVIDE HACR BREAKER										
2 -										
3 -										
4 -										
5 -										
Panelboard Notes:										
1 -										
2 -										
3 -										
4 -										
5 -										
SURFACE : Mounting				86	Adjusted KVA (Demand KVA + Spare KVA)					
EXISTING : Amps AIC Rating				104	Adjusted Demand Amps					
100 : Amp Rating of Bus				107	High Phase Demand Amps			13-Apr-20		
MCB : Panel Amp Rating (Min Main or Bus Rating)					File Name:	Project Number :	Project Name :			
480 : Phase to Phase Voltage					PANEL H	0420758-073-00	PURE BARRE			

Panel : P		Voltage: 120/208V, 3PH, 4W								
No.	Amp/φ Note	Description	Ph	Code L VA	Code C VA	Code R VA	Code M VA	Code E VA	Code K VA	Code D VA
1	20/1 2	WATER HEATER	- A -				1500			
3	20/1 1,5	LIGHTING EF-1, EF-2, EF-3	- B -	617			410			
5	20/1	DUCT SMOKE DETECTORS	- C -			100				
7	20/1 5	SHOW WINDOW RECEPTACLES	- A -		720					
9	20/1	TELEPHONE BOARD	- B -			360				
11	20/1	RECEPTION DESK	- C -			360				
13	20/1	IPAD RECEPTACLES	- A -			360				
15	20/1	SPARE	- B -							
17	20/1	SPARE	- C -							
19	20/1	ROOFTOP RECEPTACLES	- A -			360				
21	20/1	SPARE	- B -							
23	20/1 3	FLOWATER REFILL STATION	- C -			800				
25	-	SPACE	- A -							
27	-	SPACE	- B -							
29	-	SPACE	- C -							
31	-	SPACE	- A -							
33	-	SPACE	- B -							
35	-	SPACE	- C -							
37	-	SPACE	- A -							
39	-	SPACE	- B -							
41	-	SPACE	- C -							
2	20/1	SPARE	- A -							
4	20/1	SPARE	- B -							
6	20/1	SPARE	- C -							
8	20/1	A/V RACK	- A -			360				
10	20/1	A/V RACK	- B -			360				
12	20/1	SPARE	- C -							
14	20/1	SPARE	- A -							
16	20/1 3	HI-LOW DRINKING FOUNTAIN	- B -			50				
18	20/1	RESTROOM & UTILITY RM RECS.	- C -		540					
20	20/1	GENERAL RECEPTACLES	- A -		720					
22	20/1	TIME CLOCK	- B -			200				
24	20/1	SPARE	- C -							
26	20/1	SPARE	- A -							
28	20/1	SPARE	- B -							
30	20/1 5	SIGN	- C -	1200						
32	20/1	SPARE	- A -							
34	-	SPACE	- B -							
36	-	SPACE	- C -							
38	-	SPACE	- A -							
40	-	SPACE	- B -							
42	-	SPACE	- C -							
Through - Feed Lug Connection			- A -							
			- B -							
			- C -							
Main Breaker			- A -		1440	2580				
			- B -	617		970	410			
			- C -	1200	540	1260				
Breaker Notes:										
1 - PROVIDE LOCK-ON DEVICE										
2 - PROVIDE LOCK-OFF DEVICE										
3 - PROVIDE GFI BREAKER										
4 - PROVIDE HACR BREAKER										
5 - CONTROL VIA TIME CLOCK										
Panelboard Notes:										
1 -										
2 -										
3 -										
4 -										
5 -										
RECESSED : Mounting				27	Adjusted KVA (Demand KVA + Spare KVA)					
EXISTING : Amps AIC Rating				75	Adjusted Demand Amps					
100 : Amp Rating of Bus				86	High Phase Demand Amps			13-Apr-20		
MCB : Main Lug Only (MLO) or Main Circuit Breaker (MCB)					File Name:	Project Number :	Project Name :			
208 : Phase to Phase Voltage					PANEL P	0420758-073-00	PURE BARRE			



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PROJECT LOCATION
PURE BARRE
 INTERIOR TENANT IMPROVEMENT
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 LEE'S SUMMIT, MO 64086
 SHEET TITLE
RISER DIAGRAM & PANEL SCHEDULE



4/13/2020
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REVISIONS

1	4/13/2020	OWNER CHANGES
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DATE
 2020.04.10
 PROJECT NUMBER
 A2275

SHEET NUMBER
E4.0

PERMIT SET : 2020_04_10

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PART 1 - General
1.1 General conditions
A. The general, special, and other conditions of the architectural, mechanical and electrical specifications shall be considered an integral part of these electrical specifications.
B. Reference to "contractor" in this specification shall mean "electrical contractor (EC)," unless otherwise noted.
1.2 Scope of work
A. Furnish labor, materials, equipment, tools, and other items necessary for, or incidental to, installation of a complete electrical system as required for this project.
1.3 Drawings and documents
A. The drawings and specifications form a complete set of plans for the electrical work to be installed.
1.4 Codes, inspections, and fees
A. The completed electrical installation shall comply with the latest edition of the national electrical code as applicable.
1.5 Job site safety
A. The electrical contractor is responsible for electrical job site safety, including safety of people and property.
1.6 Conditions at site
A. Examine the site and be familiar with existing building conditions and limitations prior to submitting bid.
1.7 Workmanship and contractor qualifications
A. Install electrical equipment and materials in a neat and competent manner by persons experienced and skilled in the trade.
1.8 Coordination of work
A. Give careful consideration to the work of the general, mechanical and other contractors/subcontractors on the project.
1.9 Materials and equipment
A. Unless otherwise specified, material and equipment shall be new and manufactured by approved or listed manufacturers.
1.10 Temporary installations
A. Comply with the owner and general contractor requirements.
1.11 Demolition
A. Where electrical work to remain is damaged or disturbed in the course of the work, remove damaged portions and provide products of equal capacity, quality, and functionality.



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PROJECT LOCATION
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INTERIOR TENANT IMPROVEMENT
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SPECIFICATIONS
SHEET TITLE

STAMP
Mark A. Azize
2020.04.13 14:06:06
PROFESSIONAL ENGINEER
STATE OF MISSOURI

4/13/2020

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