

ALURA APARTMENTS - VILLAGE AT DISCOVERY PARK

APARTMENT BUILDING TYPE "A"

LEE'S SUMMIT, JACKSON COUNTY, MISSOURI

PROJECT INFORMATION

SITE DATA					
SITE ZONING: (SEE CIVIL)					
SITE SIZE: (SEE CIVIL)					
SITE DENSITY: (SEE CIVIL)					
NO. OF PARKING SPACES: (SEE CIVIL)					
BUILDING DATA (BLDG. 4, 6, 8 & 11)					
DWELLING UNITS	LABEL	COMPLIANCE WITH	SQ FT	QTY	SUBTOTAL
1-BR-A	ANSI "B"	ANSI "B", FHA	692	16	11,072 SF
1-BR-B	ANSI "B"	ANSI "B", FHA	795	8	6,360 SF
1-BR-C	ANSI "B"	ANSI "B", FHA	572	4	2,288 SF
2-BR-A	ANSI "B"	ANSI "B", FHA	1051	6	6,306 SF
2-BR-A	ANSI "A"	ANSI "A", FHA	1051	1	1,051 SF
2-BR-A	ANSI "B"/AY	ANSI "B", FHA/AY	1051	1	1,051 SF
2-BR-B	ANSI "B"	ANSI "B", FHA	1137	8	9,096 SF
DWELLING UNIT AREA:			44		37,224 SF
NON-DWELLING AREA:			BALCONIES, CORRIDOR, COMMON AREA & SPRINKLER ROOM		
TOTAL BUILDING AREA:			47,450 SF		
TOTAL RENTAL UNITS:			(44) TOTAL UNITS, PER BUILDING: (28) 1-BR UNITS, (16) 2-BR UNITS		
BUILDING DATA (BLDG. 1)					
DWELLING UNITS	LABEL	COMPLIANCE WITH	SQ FT	QTY	SUBTOTAL
1-BR-A	ANSI "B"	ANSI "B", FHA	692	16	11,072 SF
1-BR-B	ANSI "B"	ANSI "B", FHA	795	8	6,360 SF
1-BR-C	ANSI "B"	ANSI "B", FHA	572	4	2,288 SF
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TOTAL BUILDING AREA:			47,450 SF		
TOTAL RENTAL UNITS:			(44) TOTAL UNITS, PER BUILDING: (28) 1-BR UNITS, (16) 2-BR UNITS		
CODES AND REGULATIONS					
BLDG. & RELATED CODES: 2018 IBC, 2018 IPC, 2018 IMC, 2018 IECC					
ELECT. CODE: 2017 NEC					
FIRE CODE: 2018 IFC					
ACCESSIBILITY: 2009 ICC/ANSI A117.1, FAIR HOUSING ACT					
MISC.: ALL APPLICABLE FEDERAL, STATE, LOCAL CODES, LAWS AND ORDINANCES					
BUILDING CODE DATA					
USE GROUP: R-2					
CONSTRUCTION TYPE: VA					
EXT. WALL CONSTRUCTION: 1-HR RATED EXTERIOR WALLS (RATED FROM INSIDE)					
OTHER CONSTRUCTION: 1/2-HR RATED CORRIDOR WALLS, 1-HR RATED UNIT SEPARATION WALLS, LOAD BEARING WALLS, ROOF/CEILING & FLOOR/CEILING ASSEMBLIES, 2-HR WALLS & ROOF/CEILING @ ELEVATOR & STAIR SHAFTS, UNRATED INTERIOR WALLS					
ALLOW. AREA PER FLOOR: R-2 = 12,000 SF					
AREA ADJUSTMENTS: FULL FRONTAGE INCREASE R-2 = 12,000(100-25) x 30/30 = 9,000 SF/FLOOR INCREASE = 21,000 SF / FLOOR TOTAL ALLOWABLE FOR R-2					
ACTUAL AREA PER FLOOR: 1ST FLOOR = 12,101 SF, 2ND, 3RD & 4TH FLOORS = 11,783 SF EACH					
ALLOW. HEIGHT & FLOORS: R-2 = 60'-0", 4 STORIES					
HEIGHT ADJUSTMENTS: NONE REQUIRED, NONE TAKEN					
ACTUAL HEIGHT & FLOORS: 58'-4 1/2", 4 STORIES					
SPRINKLER SYSTEM: NFPA 13R DESIGNED AND INSTALLED BY ACCREDITED FIRE PROTECTION SYSTEM DESIGNER AND INSTALLER. PROTECTION SHALL INCLUDE ALL AREAS AS APPLICABLE BY LOCAL AND STATE CODES. COORDINATE WITH GC/OWNER REGARDING THE INSTALLATION OF THE WET/DRY FIRE SUPPRESSION SYSTEM FOR UNCONDITIONED FREEZE PROTECTION PER D.O. CODE DATA, PROVIDE FLEXIBLE DRY HEADS AT BALCONIES, PROVIDE FREEZE PROTECTED SOFFITS AS REQUIRED ON THE TOP FLOOR PER D.O. CODE DATA INFORMATION. THIS COORDINATION SHOULD BE INCLUDED IN THE BASE BID.					

INDEX TO DRAWINGS

Sheet Number	Sheet Name	Sheet Issue Date	Current Revision Date	Current Revision Description
1 - COVER SHEET				
0.0A	COVER SHEET	15 APR 2025	16 JAN 2026	ASI #2
SP1.0A	SPECIFICATIONS	15 APR 2025	15 APR 2025	ISSUE SET
SP1.1A	SPECIFICATIONS	15 APR 2025	15 APR 2025	ISSUE SET
SP1.2A	SPECIFICATIONS	15 APR 2025	15 APR 2025	ISSUE SET
SP1.3A	SPECIFICATIONS	15 APR 2025	15 APR 2025	ISSUE SET
2 - STRUCTURAL (BY CROCKETT ENGINEERING CONSULTANTS)				
5100	GENERAL STRUCTURAL DATA	15 APR 2025	15 APR 2025	ISSUE SET
5200	FOUNDATION PLAN	15 APR 2025	16 JAN 2026	ASI #2
5210	FOUNDATION DETAILS	15 APR 2025	15 APR 2025	ISSUE SET
5211	FOUNDATION DETAILS	15 APR 2025	16 JAN 2026	ASI #2
5300	2ND FLOOR FRAMING PLAN	15 APR 2025	16 JAN 2026	ASI #2
5300A	SHEAR WALL PLAN	15 APR 2025	15 APR 2025	ISSUE SET
5400	3RD FLOOR FRAMING PLAN	15 APR 2025	16 JAN 2026	ASI #2
5500	4TH FLOOR FRAMING PLAN	15 APR 2025	16 JAN 2026	ASI #2
5510	FLOOR FRAMING DETAILS	15 APR 2025	31 OCT 2025	ASI #1
5511	FLOOR FRAMING DETAILS	15 APR 2025	15 APR 2025	ISSUE SET
5600	ROOF FRAMING PLAN	15 APR 2025	16 JAN 2026	ASI #2
5610	ROOF FRAMING DETAILS	15 APR 2025	15 APR 2025	ISSUE SET
5611	ROOF FRAMING DETAILS	15 APR 2025	31 OCT 2025	ASI #1
5612	ROOF FRAMING DETAILS	15 APR 2025	16 JAN 2026	ASI #2
3 - ARCHITECTURAL				
A1.0A	FIRST FLOOR BUILDING PLAN	15 APR 2025	16 MAY 2025	ADDENDUM #1
A1.1A	SECOND FLOOR BUILDING PLAN	15 APR 2025	15 APR 2025	ISSUE SET
A1.2A	THIRD FLOOR BUILDING PLAN	15 APR 2025	15 APR 2025	ISSUE SET
A1.3A	FOURTH FLOOR BUILDING PLAN	15 APR 2025	15 APR 2025	ISSUE SET
A1.4A	1-BR UNIT DIMENSION PLANS, DOOR SCHEDULE, NOTES & WALL TYPES	15 APR 2025	15 APR 2025	ISSUE SET
A1.5A	2-BR UNIT DIMENSION PLANS	15 APR 2025	15 APR 2025	ISSUE SET
A1.6A	ENLARGED COMMON AREA DIMENSION PLANS	15 APR 2025	15 APR 2025	ISSUE SET
A1.7A	1-BR ACCESSIBILITY PLANS & NOTES	15 APR 2025	15 APR 2025	ISSUE SET
A1.8A	2-BR ACCESSIBILITY PLANS	15 APR 2025	15 APR 2025	ISSUE SET
A1.9A	ENLARGED COMMON AREA ACCESSIBILITY PLANS	15 APR 2025	15 APR 2025	ISSUE SET
A2.0A	ROOF PLAN, DETAILS & NOTES	15 APR 2025	15 APR 2025	ISSUE SET
A3.0A	EXTERIOR ELEVATIONS	15 APR 2025	15 APR 2025	ISSUE SET
A3.1A	EXTERIOR ELEVATIONS	15 APR 2025	15 APR 2025	ISSUE SET
A4.0A	WALL SECTIONS	15 APR 2025	15 APR 2025	ISSUE SET
A4.1A	WALL SECTIONS	15 APR 2025	15 APR 2025	ISSUE SET
A4.2A	WALL SECTIONS	15 APR 2025	15 APR 2025	ISSUE SET
A4.3A	WALL SECTIONS	15 APR 2025	15 APR 2025	ISSUE SET
A4.4A	ELEVATOR WALL SECTIONS	15 APR 2025	15 APR 2025	ISSUE SET
A4.5A	STAIR SHAFT WALL SECTION & DETAILS	15 APR 2025	15 APR 2025	ISSUE SET
A4.6A	FRAMING DETAILS	15 APR 2025	15 APR 2025	ISSUE SET
A4.7A	FRAMING DETAILS	15 APR 2025	15 APR 2025	ISSUE SET
A4.8A	FLASHING DETAILS	15 APR 2025	15 APR 2025	ISSUE SET
A5.0A	FIRE RATED ASSEMBLIES	15 APR 2025	15 APR 2025	ISSUE SET
A5.1A	FIRE RATED ASSEMBLIES	15 APR 2025	15 APR 2025	ISSUE SET
A5.2A	FIRE RATED ASSEMBLIES	15 APR 2025	15 APR 2025	ISSUE SET
A5.3A	FIRE RATED ASSEMBLIES	15 APR 2025	15 APR 2025	ISSUE SET
A5.4A	FIRE RATED ASSEMBLIES	15 APR 2025	15 APR 2025	ISSUE SET
A5.5A	FIRE RATED ASSEMBLIES	15 APR 2025	15 APR 2025	ISSUE SET
A5.6A	FIRE RATED ASSEMBLIES	15 APR 2025	15 APR 2025	ISSUE SET
A6.0A	1-BR FINISH PLANS, FINISH SCHEDULE & NOTES	15 APR 2025	15 APR 2025	ISSUE SET
A6.1A	2-BR FINISH PLANS & FINISH SCHEDULE	15 APR 2025	15 APR 2025	ISSUE SET
A6.2A	COMMON AREA FINISH PLANS & FINISH SCHEDULE	15 APR 2025	16 MAY 2025	ADDENDUM #1
A7.0A	INTERIOR ELEVATIONS NOTES AND DETAILS	15 APR 2025	15 APR 2025	ISSUE SET
A7.1A	1-BR INTERIOR ELEVATIONS	15 APR 2025	15 APR 2025	ISSUE SET
A7.2A	1-BR INTERIOR ELEVATIONS	15 APR 2025	15 APR 2025	ISSUE SET
A7.3A	2-BR INTERIOR ELEVATIONS	15 APR 2025	15 APR 2025	ISSUE SET
A7.4A	2-BR INTERIOR ELEVATIONS	15 APR 2025	15 APR 2025	ISSUE SET
A8.0A	1ST & 2ND FLOOR REFLECTED CEILING PLANS	15 APR 2025	15 APR 2025	ISSUE SET
A8.1A	3RD & 4TH FLOOR REFLECTED CEILING PLANS	15 APR 2025	15 APR 2025	ISSUE SET
LS1.0A	1ST & 2ND FLOOR LIFE SAFETY PLANS	15 APR 2025	15 APR 2025	ISSUE SET
LS1.1A	3RD & 4TH FLOOR LIFE SAFETY PLANS	15 APR 2025	15 APR 2025	ISSUE SET

NOTE: INDEX TO DRAWINGS HAS BEEN UPDATED TO REFLECT THE SHEETS REVISED BY ASI #2.

ARCHITECT'S JOB NO. 4938

PROJECT LOCATION MAP



SIGNATURE AREAS

NOTE: PROJECT CONSTRUCTION MUST BE IN COMPLIANCE WITH ALL APPLICABLE CODES, ORDINANCES, LAWS, AND REGULATIONS AS ENUMERATED ELSEWHERE IN THE PLANS AND SPECIFICATIONS.

ARCHITECT: WALLACE ARCHITECTS, LLC
302 CAMPUSVIEW DRIVE SUITE 208, COLUMBIA, MO 65201

BY: _____ DATE: _____

OWNER: THE VILLAGE AT DISCOVERY PARK, LLC
3622 ENDEAVOR AVE., STE. 101, COLUMBIA, MO 65201

BY: _____ DATE: _____

CONTRACTOR: INTRINSIC DEVELOPMENT, LLC
3622 ENDEAVOR AVE., STE. 101, COLUMBIA, MO 65201

BY: _____ DATE: _____

PM: RS DT: TY
PC: CD QC: MK

PLAN SET NO. _____

ASI #2

RELEASE FOR CONSTRUCTION AS NOTED ON PLANS REVIEW BY: M. RANDALL PORTER 01/29/2026 10:05:34

M. RANDALL PORTER
2012006244
ARCHITECT
16 JAN 2026
M. RANDALL PORTER
ARCHITECT LICENSE#
A-2012006244

ALURA APARTMENTS - VILLAGE AT DISCOVERY PARK
LEE'S SUMMIT, JACKSON COUNTY, MISSOURI

Wallace ARCHITECTS, LLC
COLUMBIA, MO
P. 573-258-7200

WALLACE ARCHITECTS, LLC
MISSOURI STATE CERTIFICATE OF AUTHORITY: 2003019614
COPYRIGHT © 2025
1ST ISSUE
15 APR 2025

ISSUE/REVISIONS
 ▲ 15 APR 2025 ISSUE SET
 ▲ 16 MAY 2025 ADDENDUM #1
 ▲ 31 OCT 2025 ASI #1
 ▲ 16 JAN 2026 ASI #2

0.0A
JOB NO.
4938

NOTE:
 ALL DIMENSIONS ARE FROM FACE OF FOUNDATION WALL OR FRAMING;
 EDGE OF SLAB OR TRUSS/RAFTER, OR CENTERLINE
 OF COLUMN, BEAM, OR JOIST UNLESS NOTED OTHERWISE.

FOUNDATION NOTES

- ① REINFRANT CORNER BARS, REFER TO TYPICAL CRACK CONTROL REINFORCING DETAIL ON SHEET S210.
- ② FOOTING STEP, REFER TO DETAIL FS1/S211.
- ③ FOOTING STEP, REFER TO DETAIL FS2/S211.
- ④ CONFIRM FINAL ELEVATOR SHAFT DIMENSIONS w/ ELEVATOR SUPPLIER PRIOR TO INSTALLATION OF PIT.
- ⑤ 3'-0" SQ. x 2'-0" DEEP PAD FOOTING w/ (3) #5 x 2'-6" EACH WAY; TOP & BOTTOM.
- ⑥ RECESSED FLOOR SLAB FOR ADA SHOWER (CONFIRM SIZE w/ SHOWER MANUFACTURER PRIOR TO INSTALLATION) (REFER TO ARCHITECTURAL FOR ADDITIONAL INFORMATION.)

No.	Date
ISSUE SET	04/15/2025
ASI #1	10/31/2025
ASI #2	01/16/2026

THIS SHEET HAS BEEN SIGNED, SEALED AND DATED ELECTRONICALLY




STRUCTURAL ENGINEER:
CROCKETT
 ENGINEERING CONSULTANTS
 1000 W. NIKOS BLVD. SUITE 1
 COLUMBIA, MISSOURI 65205
 (573) 447-0292
 www.crockettengineering.com
 Crockett Engineering Consultants, LLC
 Missouri Certificate of Authority #200201001

CLIENT:
INTRINSIC DEVELOPMENT
 3622 ELEVATOR AVE.
 COLUMBIA, MISSOURI

Alura Village Apartment Building Type "A"
 Lee's Summit, Jackson County, Missouri

DRAWING INCLUDES:
 FOUNDATION PLAN

DESIGNED: JWV
 DRAWN: SEH
 PROJECT NO.: 230286
 SHEET: S200

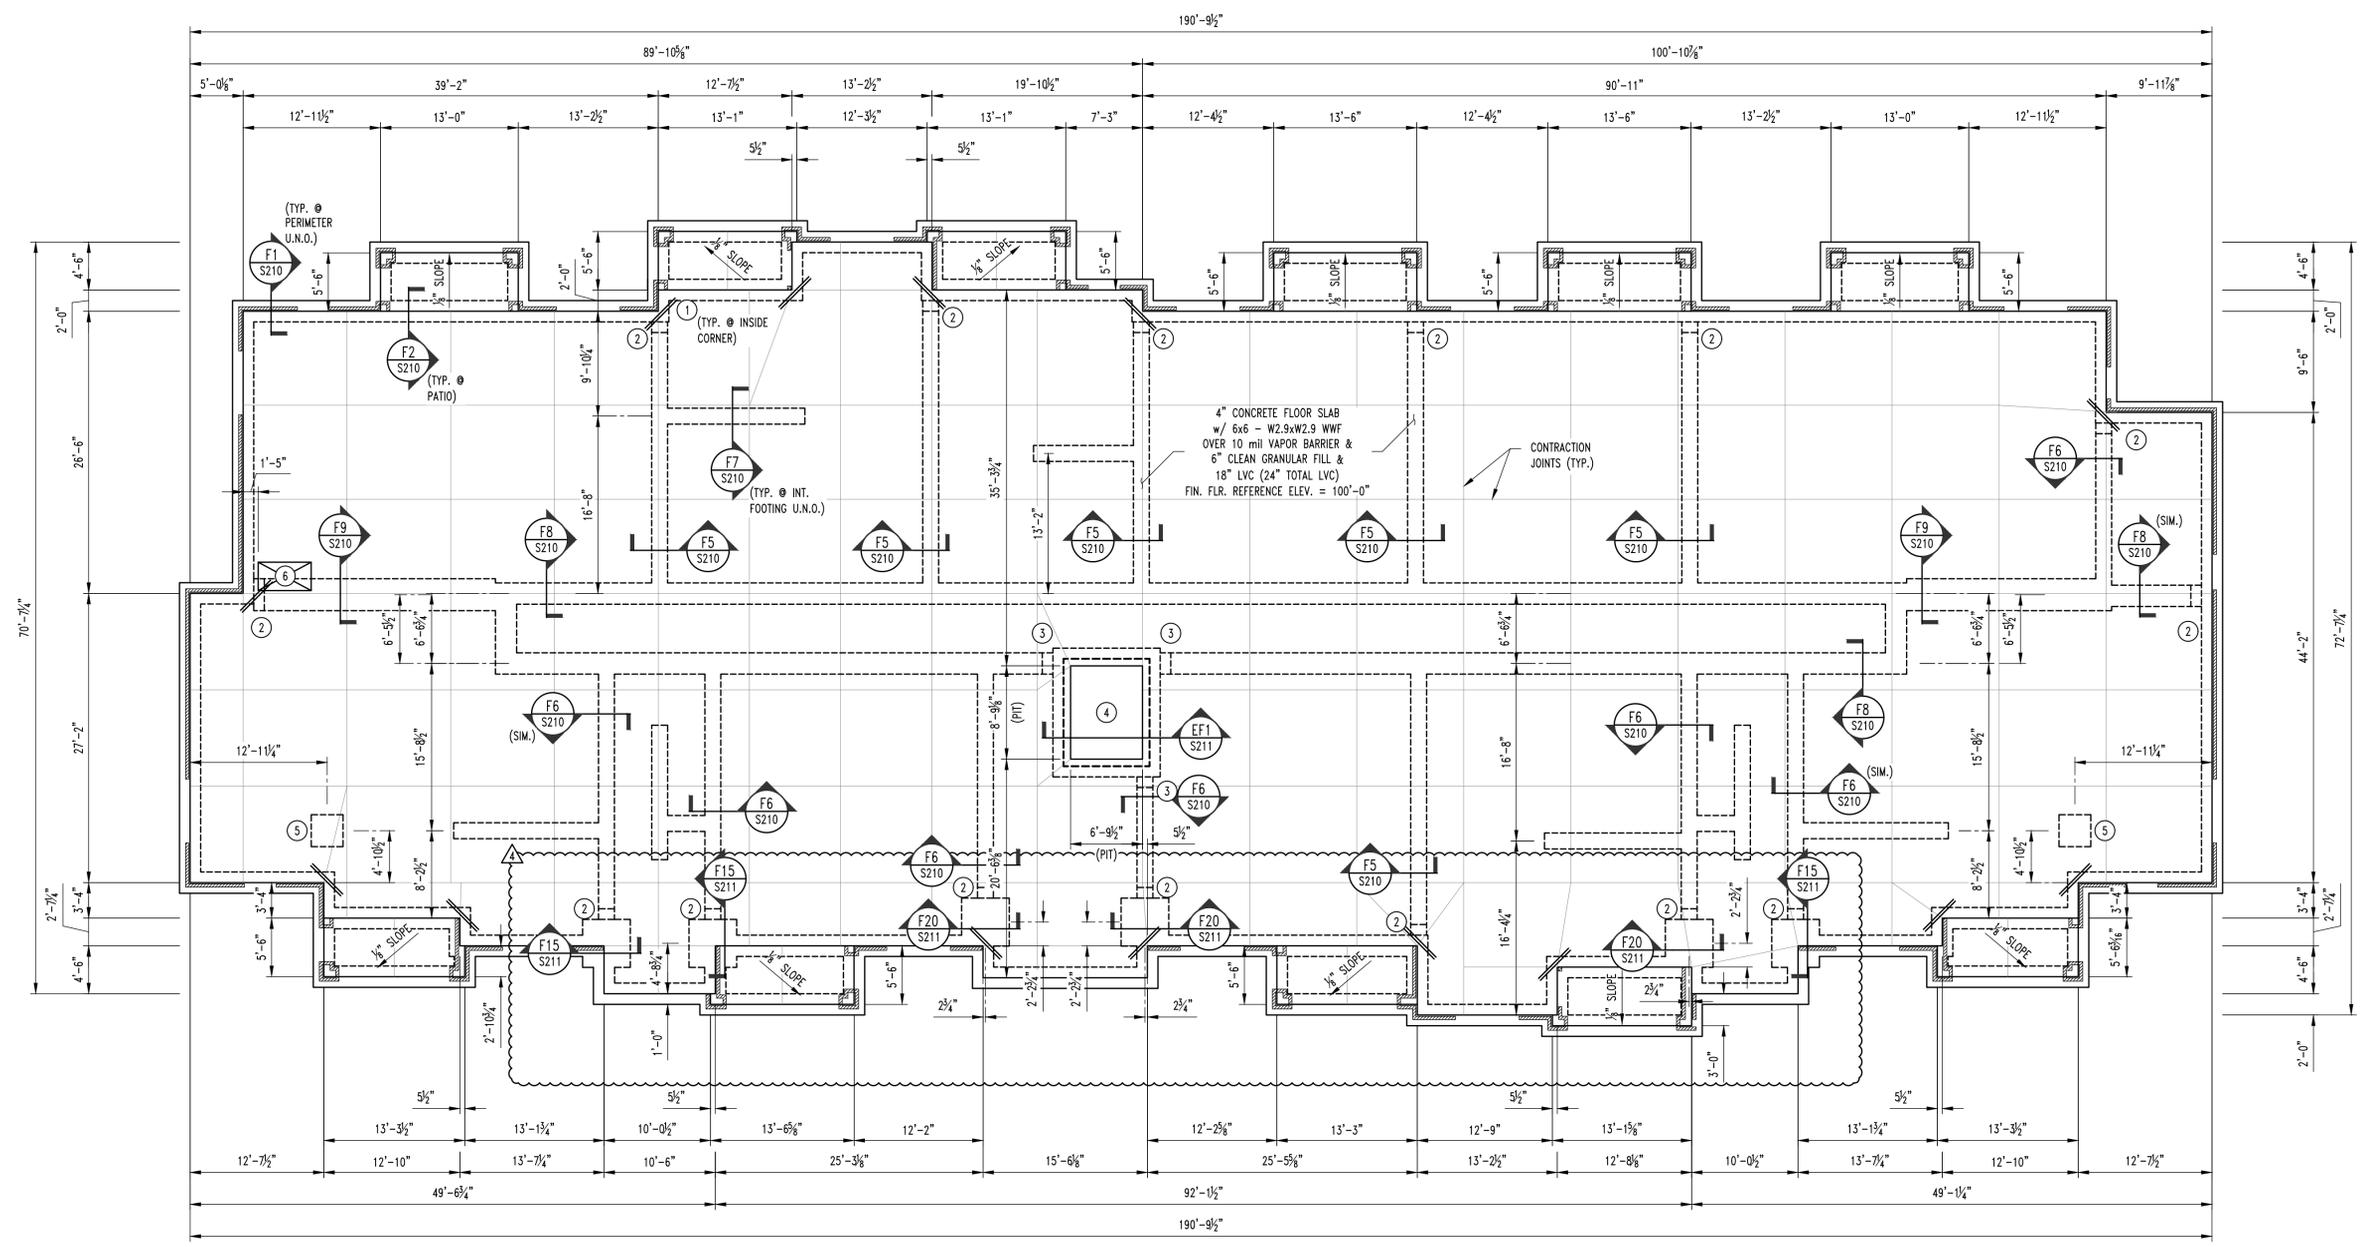

APARTMENT BUILDING TYPE "A" FOUNDATION PLAN
 SCALE: 1/8" = 1'-0"
 1 S200

REVISIONS:	
No.	Date
ISSUE SET	04/15/2025
ASI #1	10/31/2025
ASI #2	01/16/2026

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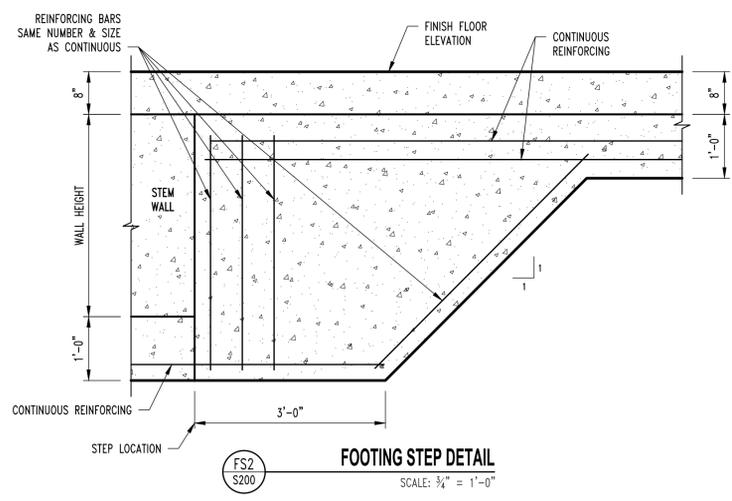
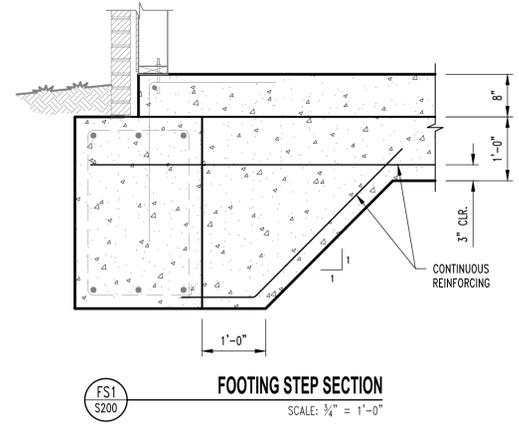
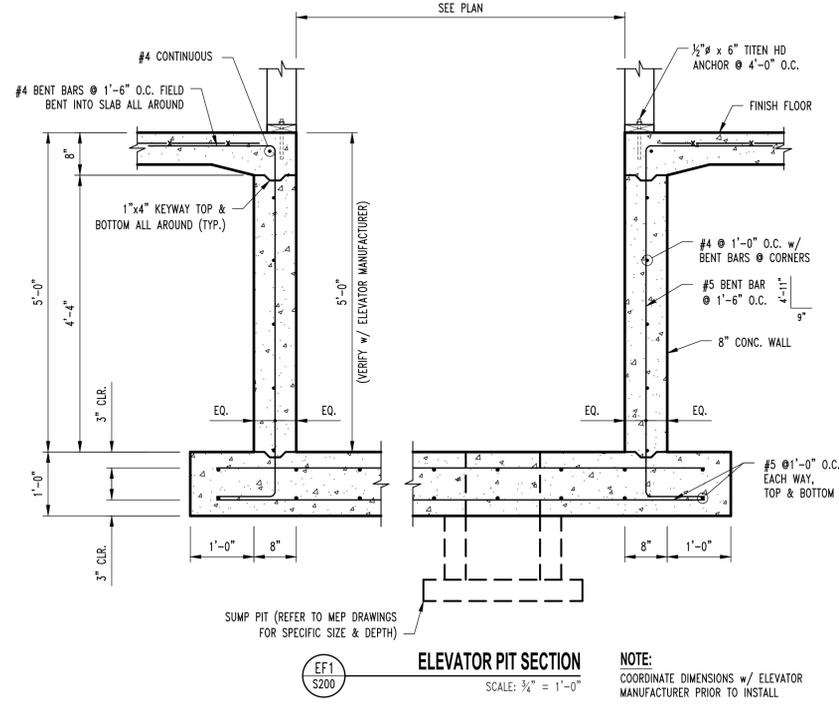
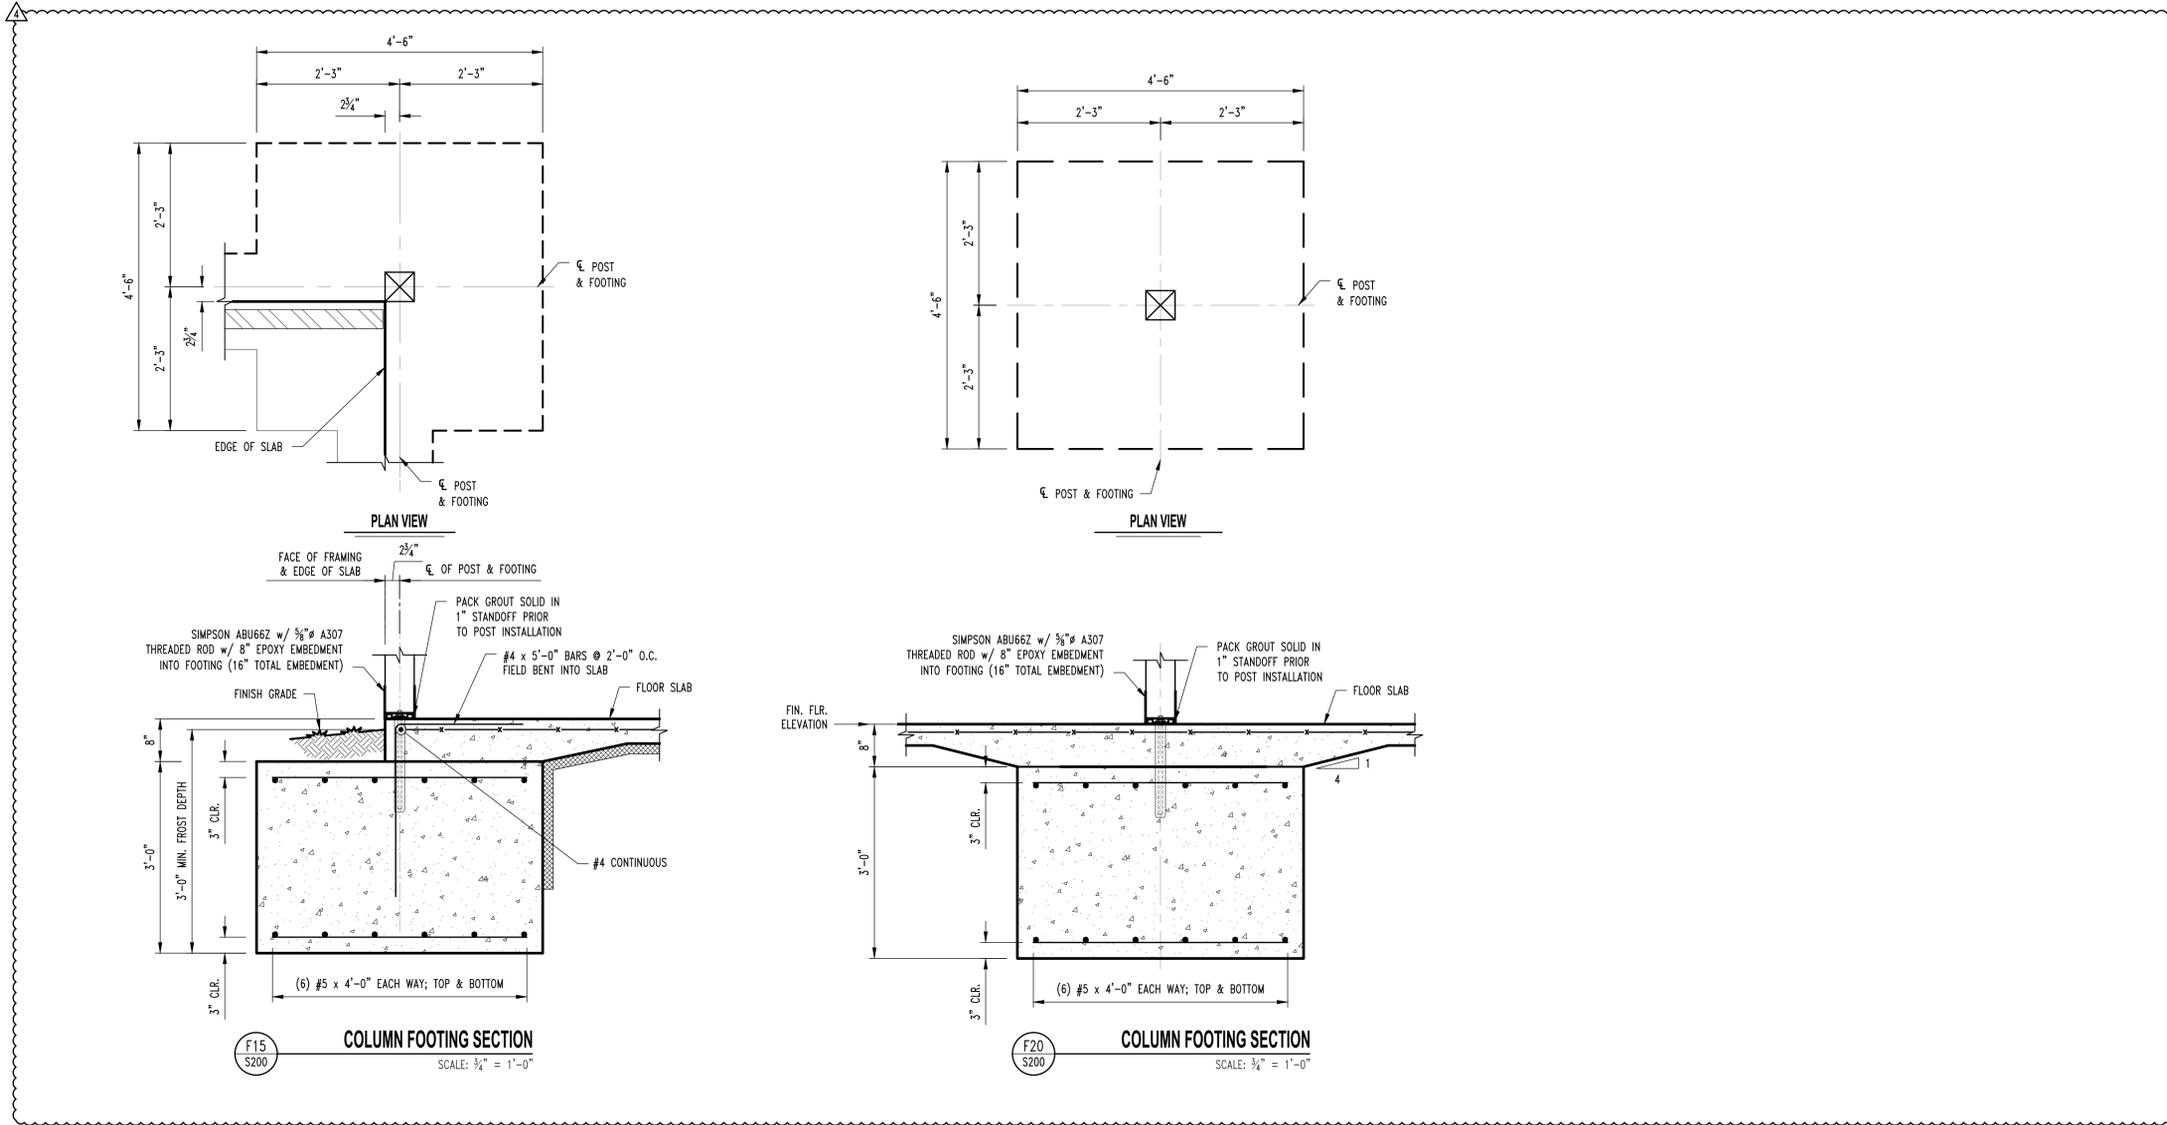
STRUCTURAL ENGINEER
CROCKETT
 ENGINEERING CONSULTANTS
 1000 W. Kings Blvd., Suite 1
 Columbia, Missouri 65205
 (573) 447-0992
 www.crockettengineering.com
 Missouri Certificate of Authority
 #200213101

CLIENT:
INTRINSIC DEVELOPMENT
 3622 ENDAVOR AVE.
 COLUMBIA, MISSOURI

Alura Village Apartment Building Type "A"
 Lee's Summit, Jackson County, Missouri

DRAWING INCLUDES:
 FOUNDATION DETAILS

DESIGNED: JWW
 DRAWN: SEH
 PROJECT NO.: 230286
 SHEET: S211



No.	Date
ISSUE SET	04/15/2025
ASI #1	10/31/2025
ASI #2	01/16/2026

THIS SHEET HAS BEEN SIGNED, SEALED AND DATED ELECTRONICALLY.

STRUCTURAL ENGINEER:
CROCKETT
 ENGINEERING CONSULTANTS
 1000 W. Kings Blvd., Suite 1
 Columbia, Missouri 65203
 (573) 447-0992
 www.crockettengineering.com
 Missouri Certificate of Authority #200210301

CLIENT:
INTRINSIC DEVELOPMENT
 3622 ENDAVOR AVE.
 COLUMBIA, MISSOURI

Alura Village Apartment Building Type "A"
 Lee's Summit, Jackson County, Missouri


DRAWING INCLUDES:
 2ND FLOOR FRAMING PLAN

DESIGNED: JWW
 DRAWN: SEH
 PROJECT NO.: 230286
 SHEET: S300

- ### FLOOR FRAMING NOTES
- (1) TREATED So. PINE No.2 2x12's w/ 2-PLY BUILT-UP POST @ EACH END.
 - (2) TREATED So. PINE No.2 2x12's w/ 2-PLY BUILT-UP POST @ EACH END.
 - GIRDER TRUSS
 - 3-PLY BUILT-UP POST BENEATH GIRDER TRUSS THIS LEVEL TO FLOOR SLAB CONNECTIONS ARE AS FOLLOWS:
 FLOOR SLAB: SIMPSON LTP2.
 FLOOR FRAMING STUD ATTACHMENT: SIMPSON MSTC52
 ROOF TRUSS: BY TRUSS MANUFACTURER
 - (3) DF SEL. STR. 2x12's w/ 3-PLY BUILT-UP POST @ EACH END.
 - 5-PLY 1.75x5.5 MICROLAM LVL 2.0E STUD PACK CENTERED BELOW HOIST BEAMED AND ON ELEVATOR RAIL. (CONTINUOUS THROUGH FLOOR FRAMING)
 - 3-PLY 1.75x5.5 MICROLAM LVL 2.0E STUD PACK CENTERED BELOW FALL PROTECTION BEAM. (CONTINUOUS THROUGH FLOOR FRAMING)
 - (4) 1.75x20 MICROLAM LVL 2.0E BEAM w/ FULL BEARING ON 6x6 POST IN WALL CAVITY @ EACH END.

3/8" ROOF SHEATHING FASTENED w/ 10d NAILS @ 6" O.C. @ PERIMETER / 12" O.C. FIELD OVER PRE-ENGINEERED ROOF TRUSSES @ 24" O.C. MAX. (TRUSS BEARING ELEV. = 109'-1 1/8")

NOTE:
 ALL DIMENSIONS ARE FROM FACE OF FOUNDATION WALL OR FRAMING;
 EDGE OF SLAB OR TRUSS/RAFTER; OR CENTERLINE
 OF COLUMN, BEAM, OR JOIST UNLESS NOTED OTHERWISE.

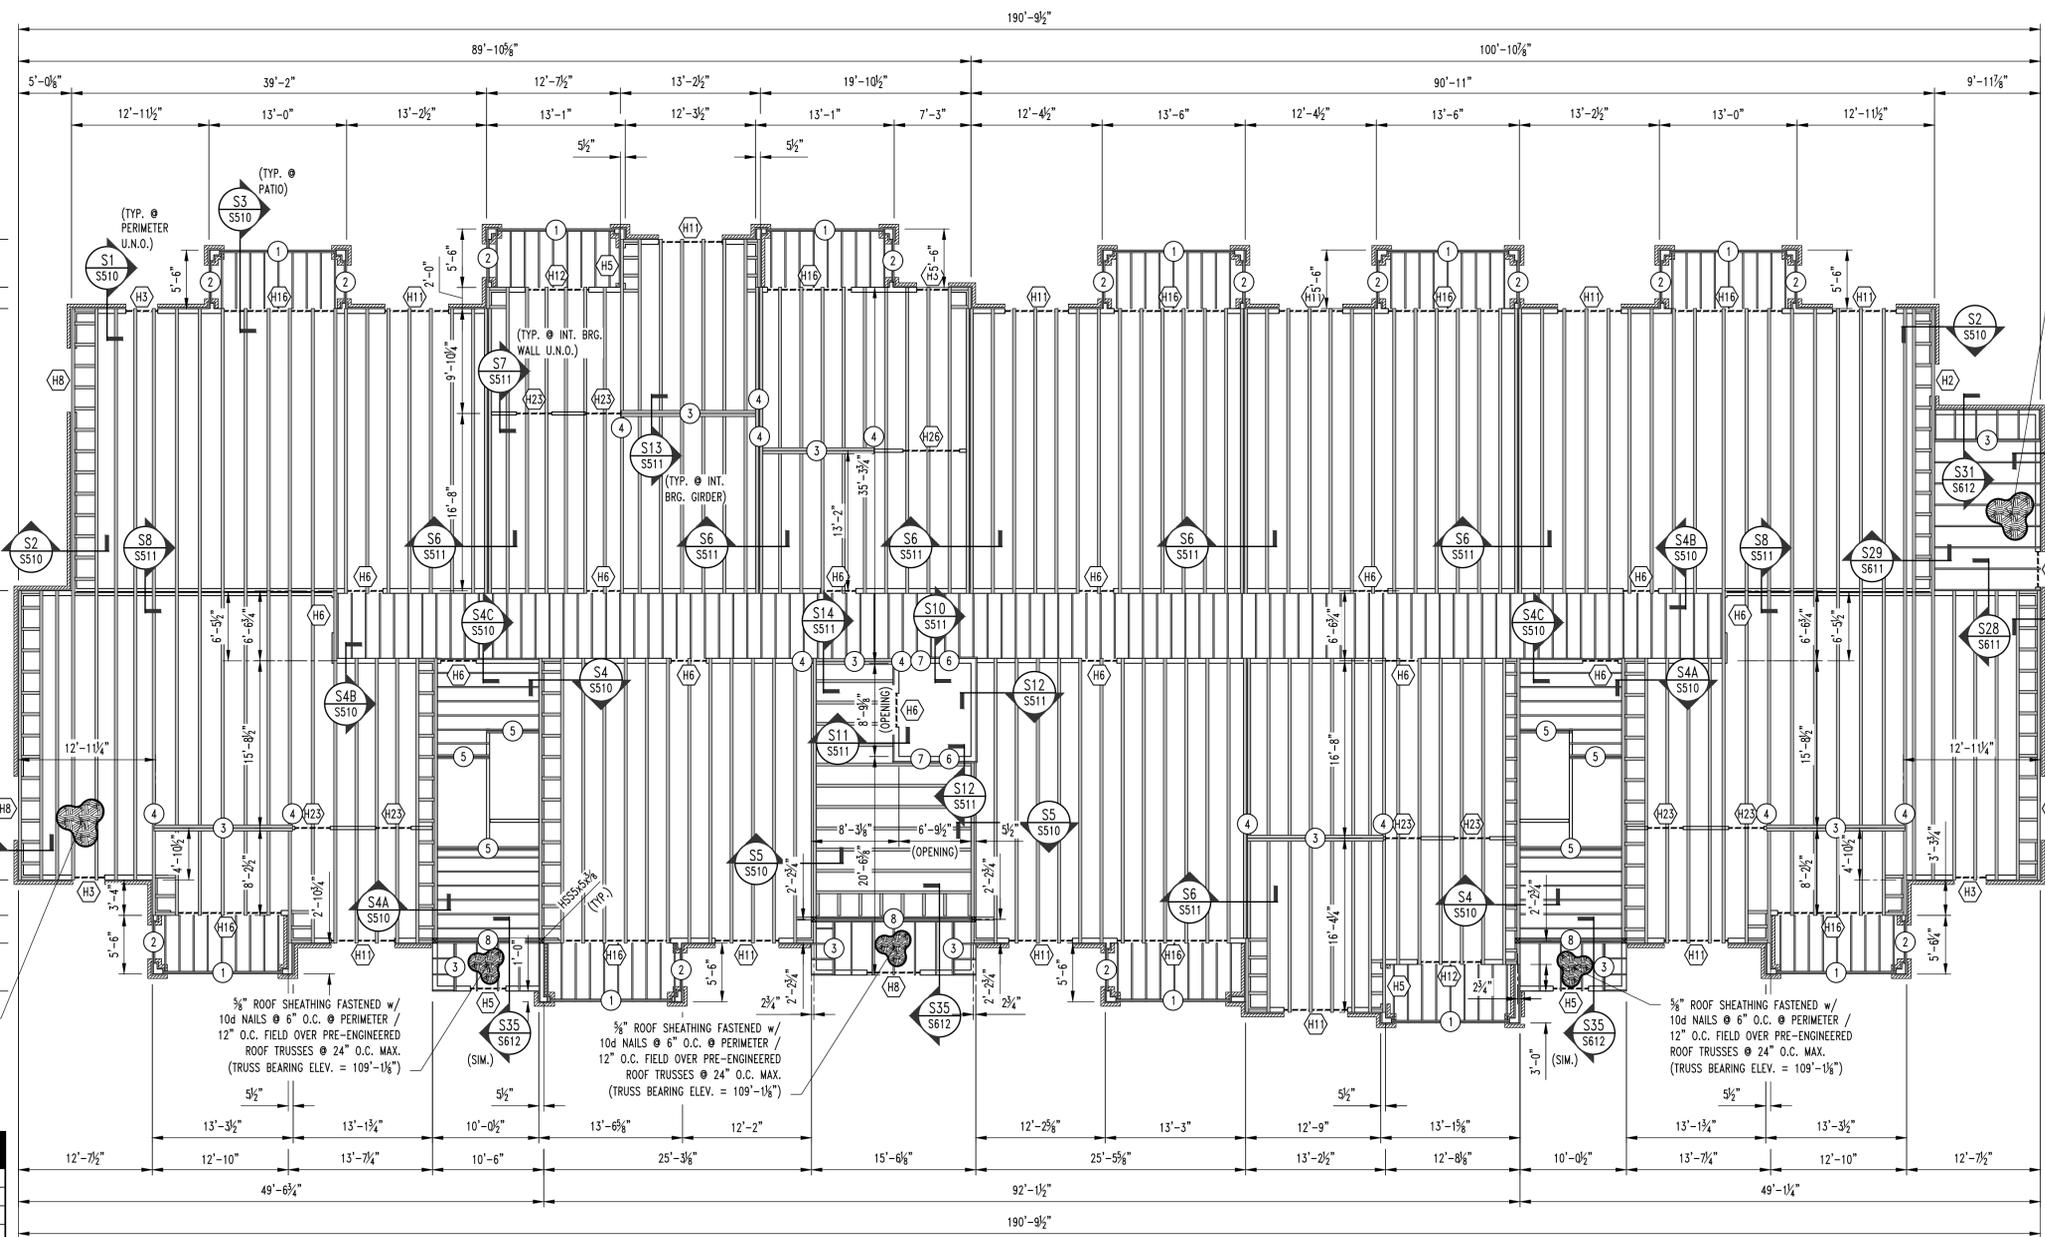

HEADER SCHEDULE			
LABEL	HEADER	CRIPPLE/JACK	JAMMING
"H1"	2 Ply 2x6 SPF #2	Single Ply 2x6 SPF #2	Single Ply 2x6 SPF #2
"H2"	2 Ply 2x6 SPF #2	2 Ply 2x6 SPF #2	Single Ply 2x6 SPF #2
"H3"	2 Ply 2x6 SPF #2	3 Ply 2x6 SPF #2	Single Ply 2x6 SPF #2
"H4"	2 Ply 2x8 Doug Fr #2	Single Ply 2x6 SPF #2	Single Ply 2x6 SPF #2
"H5"	2 Ply 2x8 Doug Fr #2	2 Ply 2x6 SPF #2	Single Ply 2x6 SPF #2
"H6"	2 Ply 2x8 Doug Fr #2	4 Ply 2x6 SPF #2	Single Ply 2x6 SPF #2
"H7"	2 Ply 2x10 Doug Fr Sel. Struct	Single Ply 2x6 SPF #2	2 Ply 2x6 SPF #2
"H8"	2 Ply 2x10 Doug Fr Sel. Struct	2 Ply 2x6 SPF #2	2 Ply 2x6 SPF #2
"H9"	2 Ply 2x10 Doug Fr Sel. Struct	3 Ply 2x6 SPF #2	2 Ply 2x6 SPF #2
"H10"	2 Ply 2x10 Doug Fr Sel. Struct	6 Ply 2x6 SPF #2	2 Ply 2x6 SPF #2
"H11"	2 Ply 2x10 Doug Fr Sel. Struct	6 Ply 2x6 SPF #2	2 Ply 2x6 SPF #2
"H12"	2 Ply 2x10 Doug Fr Sel. Struct	7 Ply 2x6 SPF #2	2 Ply 2x6 SPF #2
"H13"	3 Ply 2x10 Doug Fr Sel. Struct	2 Ply 2x6 SPF #2	3 Ply 2x6 SPF #2
"H14"	3 Ply 1.75x11.25 Microlam LVL 2.0E	3 Ply 2x6 SPF #2	3 Ply 2x6 SPF #2
"H15"	3 Ply 1.75x11.25 Microlam LVL 2.0E	4 Ply 2x6 SPF #2	3 Ply 2x6 SPF #2
"H16"	3 Ply 1.75x11.25 Microlam LVL 2.0E	5 Ply 2x6 SPF #2	3 Ply 2x6 SPF #2
"H21"	2 Ply 2x8 Doug Fr #2	Single Ply 2x4 SPF #2	Single Ply 2x4 SPF #2
"H22"	2 Ply 2x8 Doug Fr #2	2 Ply 2x4 SPF #2	Single Ply 2x4 SPF #2
"H23"	2 Ply 2x8 Doug Fr #2	3 Ply 2x4 SPF #2	Single Ply 2x4 SPF #2
"H24"	2 Ply 2x10 Doug Fr Sel. Struct	2 Ply 2x4 SPF #2	Single Ply 2x4 SPF #2
"H25"	2 Ply 2x10 Doug Fr Sel. Struct	3 Ply 2x4 SPF #2	Single Ply 2x4 SPF #2
"H26"	2 Ply 2x10 Doug Fr Sel. Struct	4 Ply 2x4 SPF #2	Single Ply 2x4 SPF #2

BRICK LINTEL SCHEDULE	
LENGTH	MEMBER SIZE (GALVANIZED)
L ≤ 4'-0"	L4x4x3/8 WITH 6" BEARING EACH END
L ≤ 6'-6"	L6x4x3/8 (LLV) WITH 6" BEARING EACH END

1 S300 APARTMENT BUILDING TYPE "A" 2ND FLOOR FRAMING PLAN
 SCALE: 1/8" = 1'-0"

No.	Date
ISSUE SET	04/15/2025
ASI #1	10/31/2025
ASI #2	01/16/2026

THIS SHEET HAS BEEN SIGNED, SEALED AND DATED ELECTRONICALLY.

STRUCTURAL ENGINEER:
CROCKETT
 ENGINEERING CONSULTANTS
 1000 W. Kings Blvd. Suite 1
 Columbia, Missouri 65205
 www.crockettengineering.com
 Crockett Engineering Consultants, LLC
 Missouri Certificate of Authority #200310301

CLIENT:
INTRINSIC DEVELOPMENT
 3622 ENDEAVOR AVE.
 COLUMBIA, MISSOURI


Alura Village Apartment Building Type "A"
 Lee's Summit, Jackson County, Missouri

DRAWING INCLUDES:
 3RD FLOOR FRAMING PLAN

DESIGNED: JWV
 DRAWN: SEH
 PROJECT NO.: 230286
 SHEET: S400

NOTE:
 ALL DIMENSIONS ARE FROM FACE OF FOUNDATION WALL OR FRAMING;
 EDGE OF SLAB OR TRUSS/RAFTER; OR CENTERLINE
 OF COLUMN, BEAM, OR JOIST UNLESS NOTED OTHERWISE.

- FLOOR FRAMING NOTES**
- (3) So. PINE SEL. STR. 2x12's w/ 2-PLY BUILT-UP POST @ EACH END.
 - (2) So. PINE SEL. STR. 2x12's w/ 2-PLY BUILT-UP POST @ EACH END.
 - GIRDER TRUSS
 - 3-PLY BUILT-UP POST BENEATH GIRDER TRUSS THIS LEVEL TO FLOOR SLAB CONNECTIONS ARE AS FOLLOWS:
 FLOOR SLAB: SIMPSON LTP2.
 FLOOR FRAMING STUD ATTACHMENT: SIMPSON MSTC52
 ROOF TRUSS: BY TRUSS MANUFACTURER
 - (3) DF SEL. STR. 2x12's w/ 3-PLY BUILT-UP POST @ EACH END.
 - 5-PLY 1.75x5.5 MICROLAM LVL 2.0E STUD PACK CENTERED BELOW HOIST BEAMED AND ON ELEVATOR RAIL. (CONTINUOUS THROUGH FLOOR FRAMING)
 - 3-PLY 1.75x5.5 MICROLAM LVL 2.0E STUD PACK CENTERED BELOW FALL PROTECTION BEAM. (CONTINUOUS THROUGH FLOOR FRAMING)

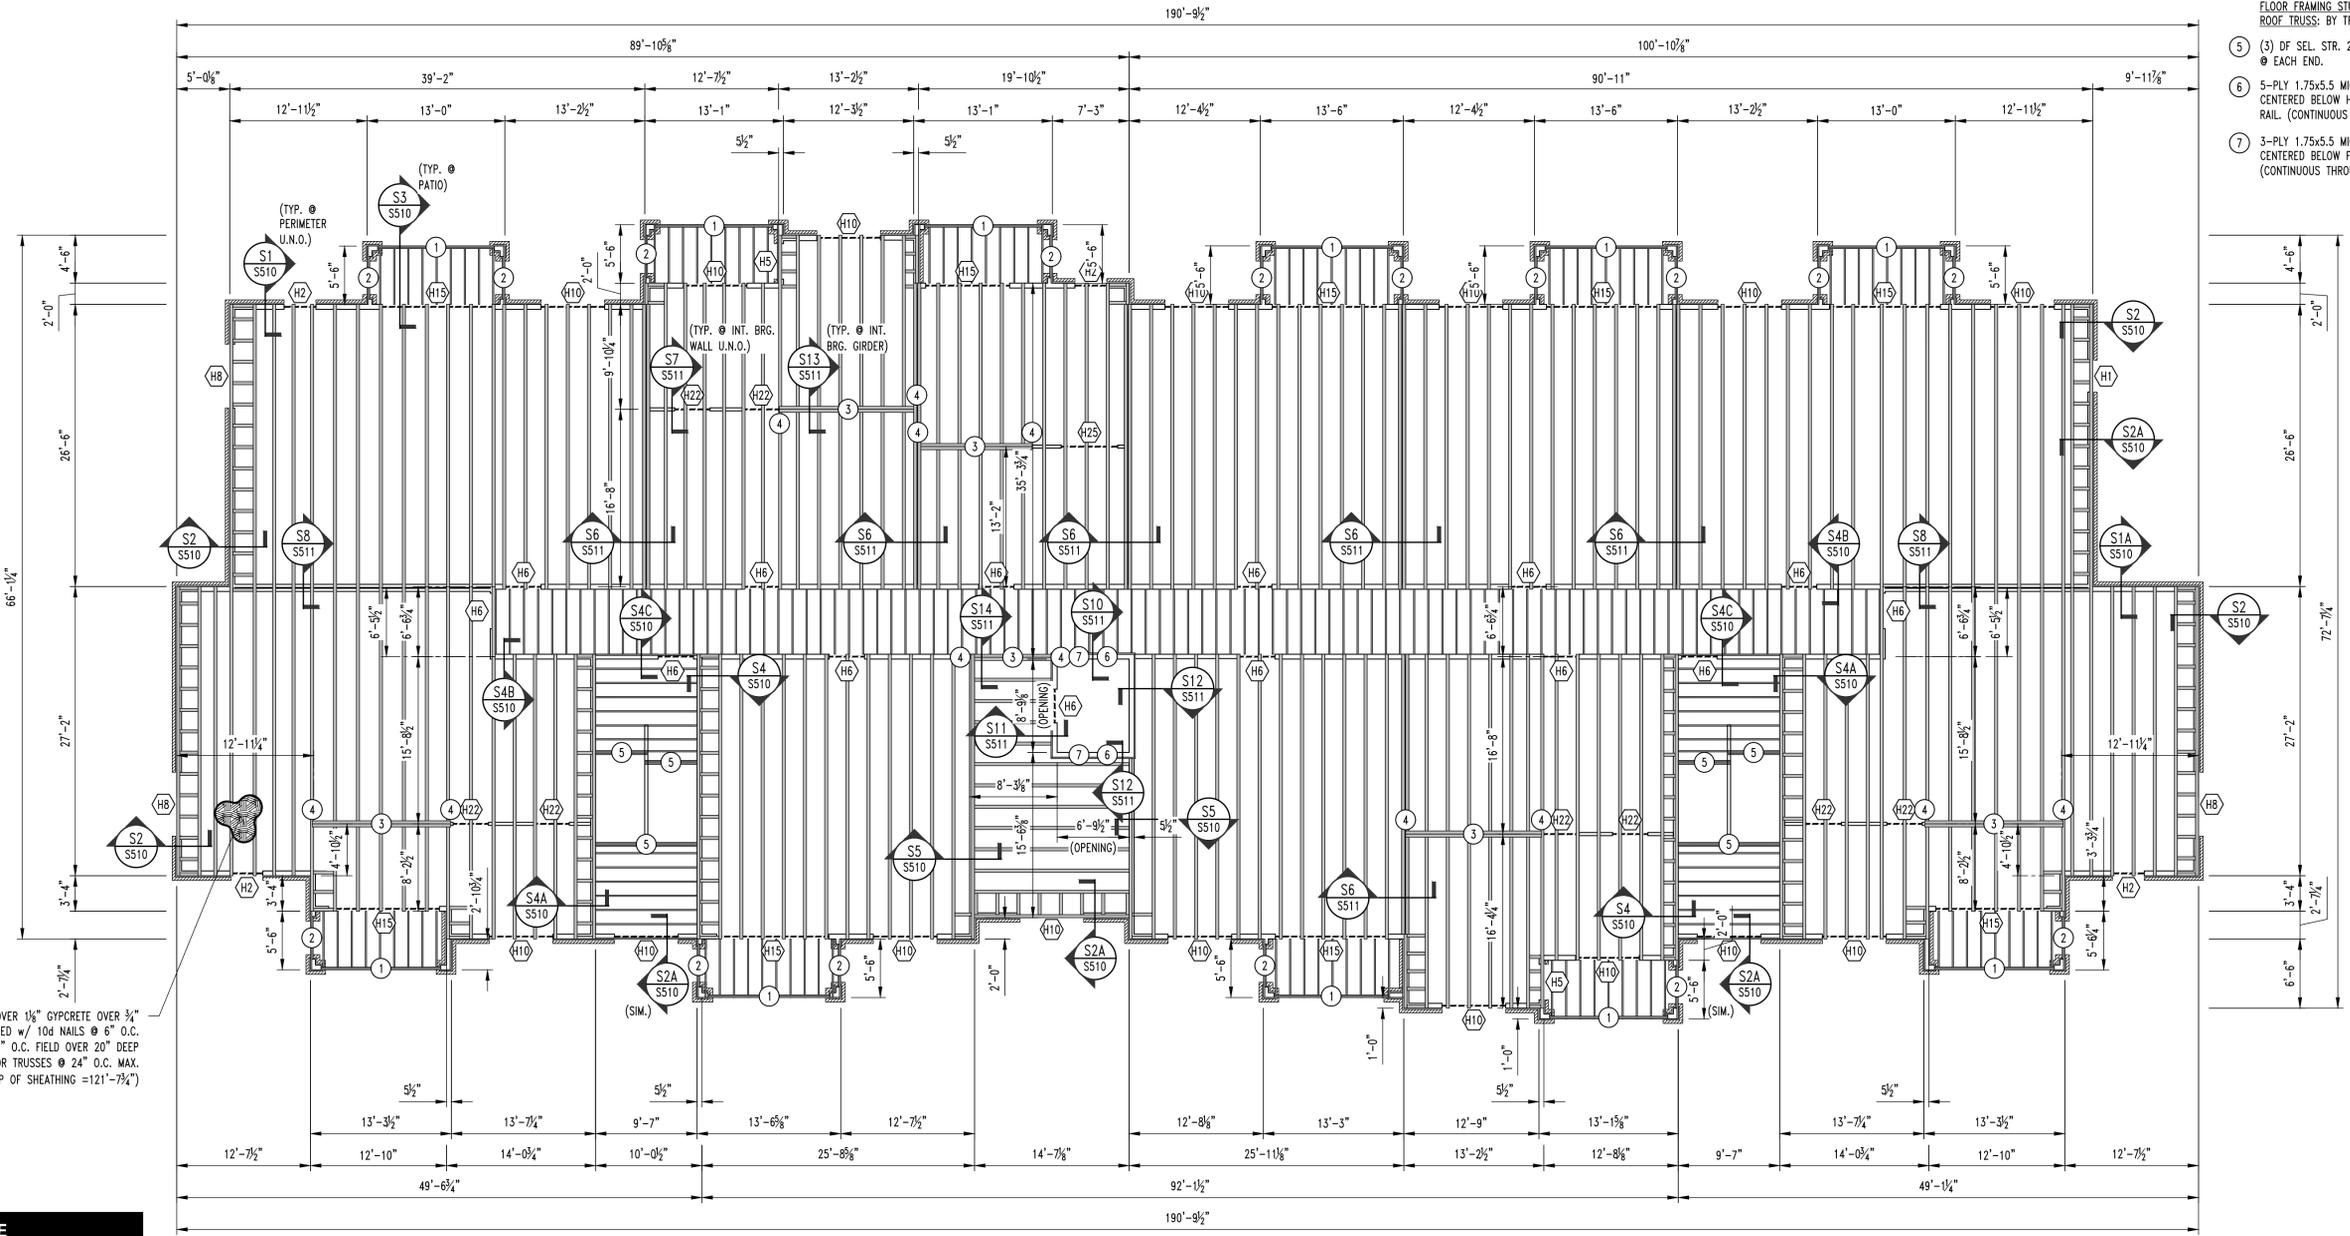

3/8" UNDERLAYMENT OVER 1 1/2" GYPCRETE OVER 3/4" FLOOR SHEATHING FASTENED w/ 10d NAILS @ 6" O.C. PERIMETER / 12" O.C. FIELD OVER 20" DEEP PRE-ENGINEERED FLOOR TRUSSES @ 24" O.C. MAX. (TOP OF SHEATHING = 121'-7 1/4")

HEADER SCHEDULE			
LABEL	HEADER	CRIPPLE/JACK	JAMB/KING
"H1"	2 Ply 2x6 SPF #2	Single Ply 2x6 SPF #2	Single Ply 2x6 SPF #2
"H2"	2 Ply 2x6 SPF #2	2 Ply 2x6 SPF #2	Single Ply 2x6 SPF #2
"H3"	2 Ply 2x6 SPF #2	3 Ply 2x6 SPF #2	Single Ply 2x6 SPF #2
"H4"	2 Ply 2x8 Doug Fr #2	Single Ply 2x6 SPF #2	Single Ply 2x6 SPF #2
"H5"	2 Ply 2x8 Doug Fr #2	2 Ply 2x6 SPF #2	Single Ply 2x6 SPF #2
"H6"	2 Ply 2x8 Doug Fr #2	4 Ply 2x6 SPF #2	Single Ply 2x6 SPF #2
"H7"	2 Ply 2x10 Doug Fr Sel. Struct	Single Ply 2x6 SPF #2	2 Ply 2x6 SPF #2
"H8"	2 Ply 2x10 Doug Fr Sel. Struct	2 Ply 2x6 SPF #2	2 Ply 2x6 SPF #2
"H9"	2 Ply 2x10 Doug Fr Sel. Struct	3 Ply 2x6 SPF #2	2 Ply 2x6 SPF #2
"H10"	2 Ply 2x10 Doug Fr Sel. Struct	5 Ply 2x6 SPF #2	2 Ply 2x6 SPF #2
"H11"	2 Ply 2x10 Doug Fr Sel. Struct	6 Ply 2x6 SPF #2	2 Ply 2x6 SPF #2
"H12"	2 Ply 2x10 Doug Fr Sel. Struct	7 Ply 2x6 SPF #2	2 Ply 2x6 SPF #2
"H13"	3 Ply 2x10 Doug Fr Sel. Struct	2 Ply 2x6 SPF #2	3 Ply 2x6 SPF #2
"H14"	3 Ply 1.75x11.25 Microlam LVL 2.0E	3 Ply 2x6 SPF #2	3 Ply 2x6 SPF #2
"H15"	3 Ply 1.75x11.25 Microlam LVL 2.0E	4 Ply 2x6 SPF #2	3 Ply 2x6 SPF #2
"H16"	3 Ply 1.75x11.25 Microlam LVL 2.0E	5 Ply 2x6 SPF #2	3 Ply 2x6 SPF #2
"H21"	2 Ply 2x8 Doug Fr #2	Single Ply 2x4 SPF #2	Single Ply 2x4 SPF #2
"H22"	2 Ply 2x8 Doug Fr #2	2 Ply 2x4 SPF #2	Single Ply 2x4 SPF #2
"H23"	2 Ply 2x8 Doug Fr #2	3 Ply 2x4 SPF #2	Single Ply 2x4 SPF #2
"H24"	2 Ply 2x10 Doug Fr Sel. Struct	2 Ply 2x4 SPF #2	Single Ply 2x4 SPF #2
"H25"	2 Ply 2x10 Doug Fr Sel. Struct	3 Ply 2x4 SPF #2	Single Ply 2x4 SPF #2
"H26"	2 Ply 2x10 Doug Fr Sel. Struct	4 Ply 2x4 SPF #2	Single Ply 2x4 SPF #2

BRICK LINTEL SCHEDULE	
LENGTH	MEMBER SIZE (GALVANIZED)
L ≤ 4'-0"	L4x4x3/8 WITH 6" BEARING EACH END
L ≤ 6'-6"	L6x4x3/8 (LLV) WITH 6" BEARING EACH END

1 S400 APARTMENT BUILDING TYPE "A" 3RD FLOOR FRAMING PLAN
 SCALE: 1/8" = 1'-0"

No.	Date
ISSUE SET	04/15/2025
ASI #1	10/31/2025
ASI #2	01/16/2026

THIS SHEET HAS BEEN SIGNED, SEALED AND DATED ELECTRONICALLY.

STRUCTURAL ENGINEER:
CROCKETT
 ENGINEERING CONSULTANTS
 1000 W. N. High Blvd. Suite 1
 Columbia, Missouri 65205
 www.crockettengineering.com
 Crockett Engineering Consultants, LLC
 Missouri Certificate of Authority #200210101

CLIENT:
INTRINSIC DEVELOPMENT
 3622 ENDAVOR AVE.
 COLUMBIA, MISSOURI


Alura Village Apartment Building Type "A"
 Lee's Summit, Jackson County, Missouri

DRAWING INCLUDES:
 4TH FLOOR FRAMING PLAN

DESIGNED: JWW
 DRAWN: SEH
 PROJECT NO.: 230286
 SHEET: S500

- ### FLOOR FRAMING NOTES
- (3) So. PINE SEL. STR. 2x12's w/ 2-PLY BUILT-UP POST @ EACH END.
 - (2) So. PINE SEL. STR. 2x12's w/ 2-PLY BUILT-UP POST @ EACH END.
 - GIRDER TRUSS
 - 3-PLY BUILT-UP POST BENEATH GIRDER TRUSS THIS LEVEL TO FLOOR SLAB CONNECTIONS ARE AS FOLLOWS:
 FLOOR SLAB: SIMPSON LTP2.
 FLOOR FRAMING STUD ATTACHMENT: SIMPSON MSTC52
 ROOF TRUSS: BY TRUSS MANUFACTURER
 - (3) DF SEL. STR. 2x12's w/ 3-PLY BUILT-UP POST @ EACH END.
 - 5-PLY 1.75x5.5 MICROLAM LVL 2.0E STUD PACK CENTERED BELOW HOIST BEAMED AND ON ELEVATOR RAIL. (CONTINUOUS THROUGH FLOOR FRAMING)
 - 3-PLY 1.75x5.5 MICROLAM LVL 2.0E STUD PACK CENTERED BELOW FALL PROTECTION BEAM. (CONTINUOUS THROUGH FLOOR FRAMING)

NOTE:
 ALL DIMENSIONS ARE FROM FACE OF FOUNDATION WALL OR FRAMING;
 EDGE OF SLAB OR TRUSS/RAFTER; OR CENTERLINE
 OF COLUMN, BEAM, OR JOIST UNLESS NOTED OTHERWISE.

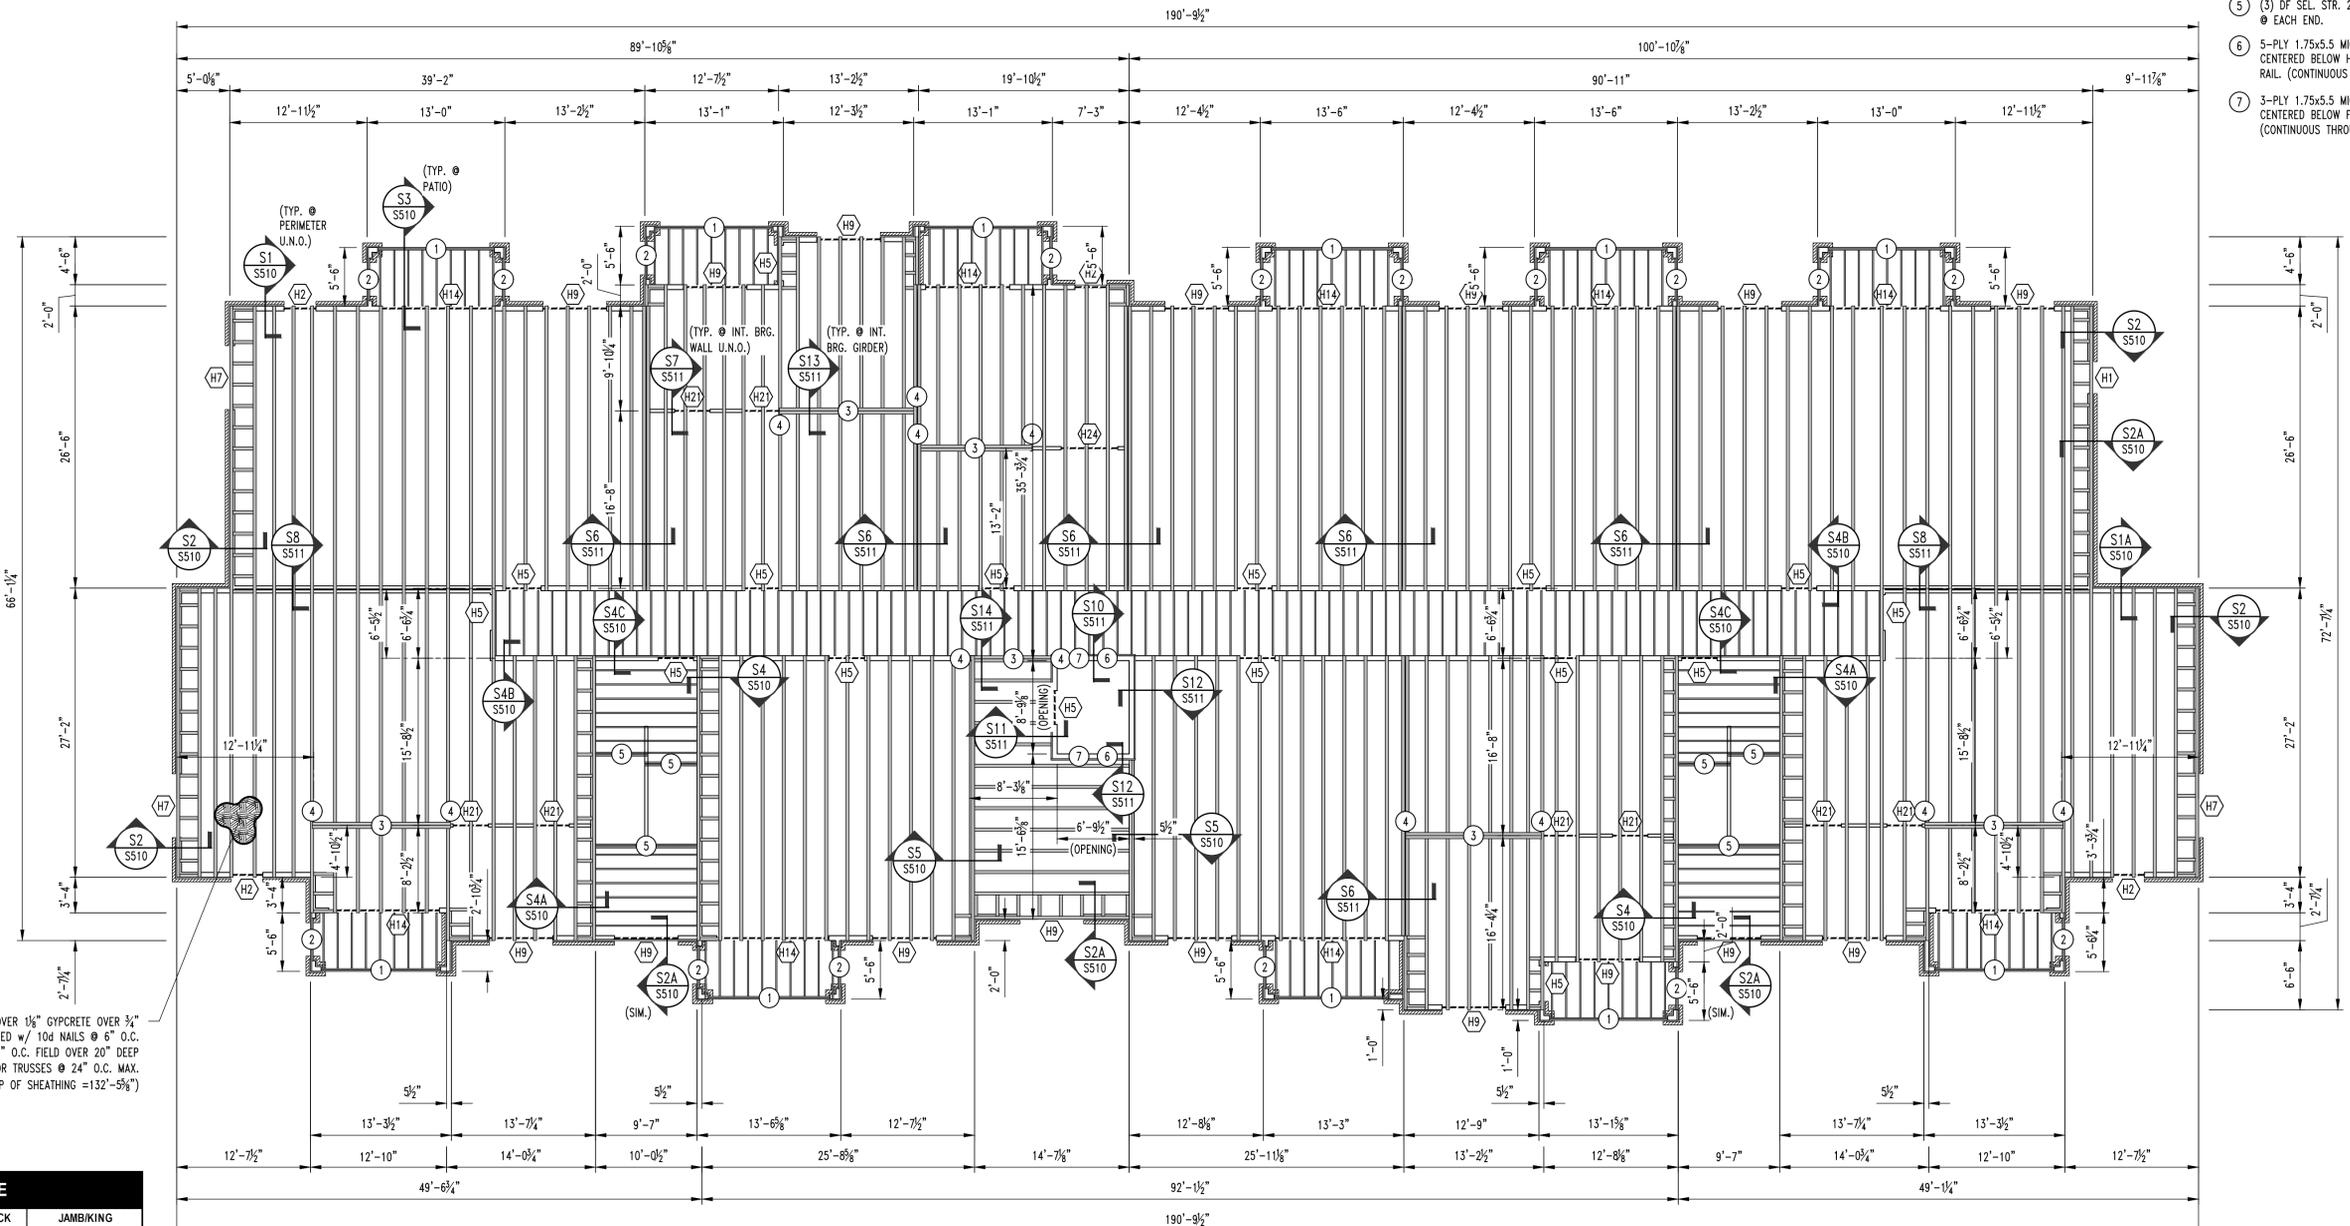

3/8" UNDERLAYMENT OVER 1 1/2" GYPCRETE OVER 3/4" FLOOR SHEATHING FASTENED w/ 10d NAILS @ 6" O.C. PERIMETER / 12" O.C. FIELD OVER 20" DEEP PRE-ENGINEERED FLOOR TRUSSES @ 24" O.C. MAX. (TOP OF SHEATHING = 132'-5 1/4")

HEADER SCHEDULE			
LABEL	HEADER	CRIPPLE/JACK	JAMBUKING
"H1"	2 Ply 2x6 SPF #2	Single Ply 2x6 SPF #2	Single Ply 2x6 SPF #2
"H2"	2 Ply 2x6 SPF #2	2 Ply 2x6 SPF #2	Single Ply 2x6 SPF #2
"H3"	2 Ply 2x6 SPF #2	3 Ply 2x6 SPF #2	Single Ply 2x6 SPF #2
"H4"	2 Ply 2x8 Doug Fr #2	Single Ply 2x6 SPF #2	Single Ply 2x6 SPF #2
"H5"	2 Ply 2x8 Doug Fr #2	2 Ply 2x6 SPF #2	Single Ply 2x6 SPF #2
"H6"	2 Ply 2x8 Doug Fr #2	4 Ply 2x6 SPF #2	Single Ply 2x6 SPF #2
"H7"	2 Ply 2x10 Doug Fr Sel. Struct	Single Ply 2x6 SPF #2	2 Ply 2x6 SPF #2
"H8"	2 Ply 2x10 Doug Fr Sel. Struct	2 Ply 2x6 SPF #2	2 Ply 2x6 SPF #2
"H9"	2 Ply 2x10 Doug Fr Sel. Struct	3 Ply 2x6 SPF #2	2 Ply 2x6 SPF #2
"H10"	2 Ply 2x10 Doug Fr Sel. Struct	6 Ply 2x6 SPF #2	2 Ply 2x6 SPF #2
"H11"	2 Ply 2x10 Doug Fr Sel. Struct	6 Ply 2x6 SPF #2	2 Ply 2x6 SPF #2
"H12"	2 Ply 2x10 Doug Fr Sel. Struct	7 Ply 2x6 SPF #2	2 Ply 2x6 SPF #2
"H13"	3 Ply 2x10 Doug Fr Sel. Struct	2 Ply 2x6 SPF #2	3 Ply 2x6 SPF #2
"H14"	3 Ply 1.75x11.25 Microlam LVL 2.0E	3 Ply 2x6 SPF #2	3 Ply 2x6 SPF #2
"H15"	3 Ply 1.75x11.25 Microlam LVL 2.0E	4 Ply 2x6 SPF #2	3 Ply 2x6 SPF #2
"H16"	3 Ply 1.75x11.25 Microlam LVL 2.0E	5 Ply 2x6 SPF #2	3 Ply 2x6 SPF #2
"H21"	2 Ply 2x8 Doug Fr #2	Single Ply 2x4 SPF #2	Single Ply 2x4 SPF #2
"H22"	2 Ply 2x8 Doug Fr #2	2 Ply 2x4 SPF #2	Single Ply 2x4 SPF #2
"H23"	2 Ply 2x8 Doug Fr #2	3 Ply 2x4 SPF #2	Single Ply 2x4 SPF #2
"H24"	2 Ply 2x10 Doug Fr Sel. Struct	2 Ply 2x4 SPF #2	Single Ply 2x4 SPF #2
"H25"	2 Ply 2x10 Doug Fr Sel. Struct	3 Ply 2x4 SPF #2	Single Ply 2x4 SPF #2
"H26"	2 Ply 2x10 Doug Fr Sel. Struct	4 Ply 2x4 SPF #2	Single Ply 2x4 SPF #2

BRICK LINTEL SCHEDULE	
LENGTH	MEMBER SIZE (GALVANIZED)
L ≤ 4'-0"	L4x4x3/8 WITH 6" BEARING EACH END
L ≤ 6'-6"	L6x4x3/8 (LLV) WITH 6" BEARING EACH END

APARTMENT BUILDING TYPE "A" 4TH FLOOR FRAMING PLAN
 SCALE: 1/8" = 1'-0"



NOTE:
 ALL DIMENSIONS ARE FROM FACE OF FOUNDATION WALL OR FRAMING;
 EDGE OF SLAB OR TRUSS/RAFTER; OR CENTERLINE
 OF COLUMN, BEAM, OR JOIST UNLESS NOTED OTHERWISE.

ROOF FRAMING NOTES

- 1 (2) TREATED So. PINE No.2 2x10's w/ 2-PLY BUILT-UP POST @ EACH END.
- 2 FRAME ROOF OVER PRE-ENGINEERED TRUSSES TO CREATE RIDGE, VALLEY, OR HIP AS SHOWN w/ No.1/No.2 SPF 2x RAFTERS @ 16" O.C. OR PRE-ENGINEERED ROOF TRUSSES @ 2'-0" O.C. MAX.
- 3 GIRDER TRUSS
- 4 3-PLY BUILT-UP POST BENEATH GIRDER TRUSS THIS LEVEL TO FLOOR SLAB CONNECTIONS ARE AS FOLLOWS:
 FLOOR SLAB: SIMPSON LITTP2.
 FLOOR FRAMING STUD ATTACHMENT: SIMPSON MSTCS2
 ROOF TRUSS: BY TRUSS MANUFACTURER
- 5 REFER TO TYPICAL GIRDER TO HEADER DETAIL ON SHEET S612.
- 6 ROOF HATCH REFER TO ARCHITECTURAL DRAWINGS FOR ADDITIONAL INFORMATION.
- 7 5-PLY 1.75x5.5 MICROLAM LVL 2.0E STUD PACK CENTERED BELOW HOIST BEAMED AND ON ELEVATOR RAIL. (CONTINUOUS THROUGH FLOOR FRAMING)
- 8 3-PLY 1.75x5.5 MICROLAM LVL 2.0E STUD PACK CENTERED BELOW FALL PROTECTION BEAM. (CONTINUOUS THROUGH FLOOR FRAMING)

No.	Date
ISSUE SET	04/15/2025
AS1 #1	10/31/2025
AS1 #2	01/16/2026

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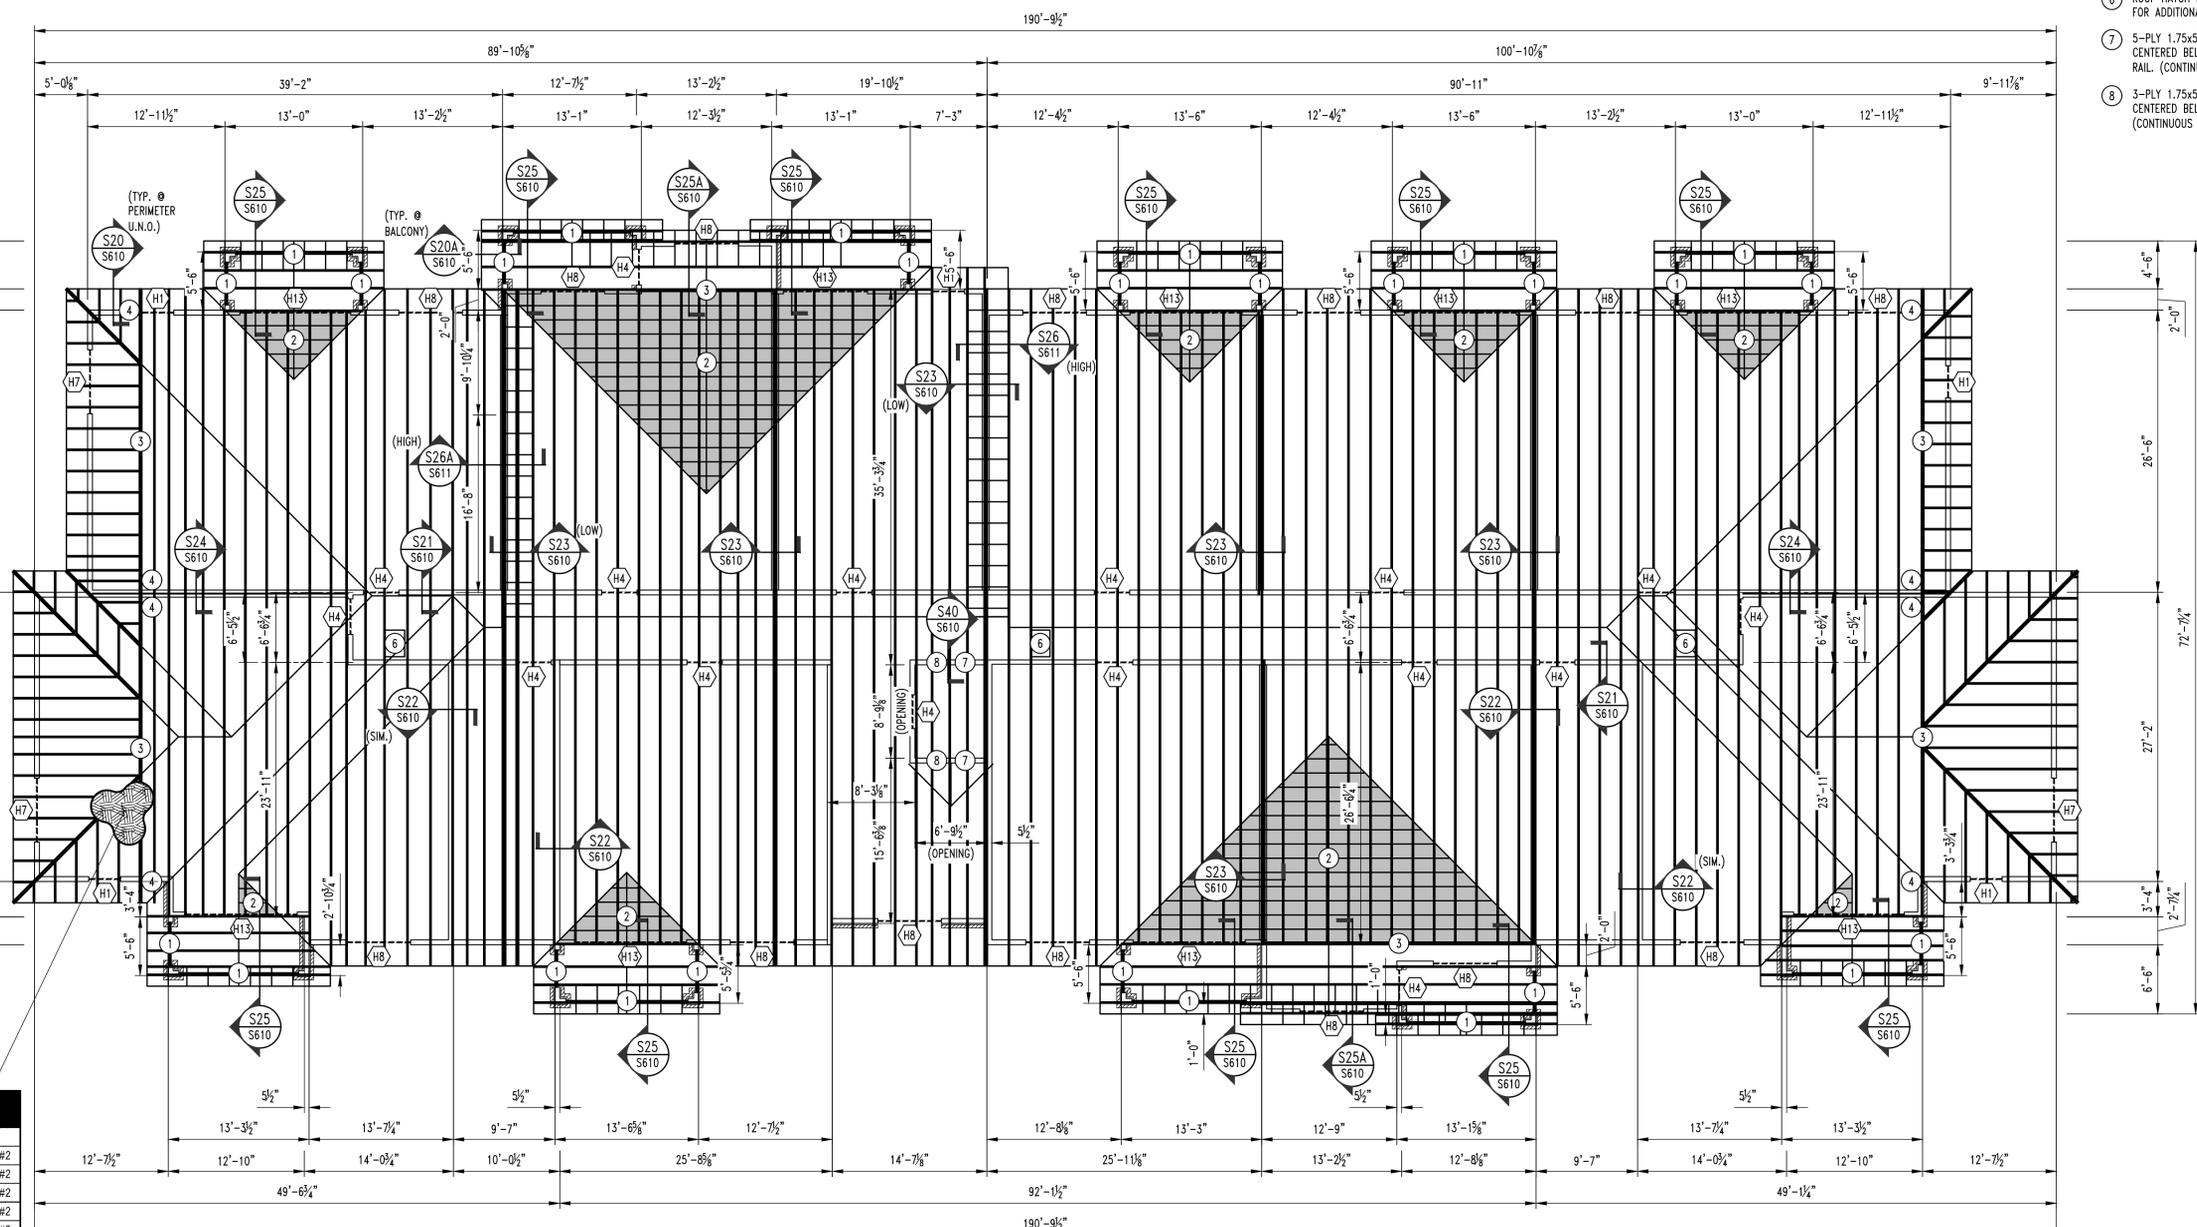
STRUCTURAL ENGINEER:
CROCKETT
 ENGINEERING CONSULTANTS
 1000 W. N. Kings Blvd., Suite 1
 Columbia, Missouri 65205
 (573) 447-0992
 www.crockettengineering.com
 Crockett Engineering Consultants, LLC
 Missouri Certificate of Authority #200201001

CLIENT:
INTRINSIC DEVELOPMENT
 3622 ENDAVOR AVE.
 COLUMBIA, MISSOURI

Alura Village Apartment Building Type "A"
 Lee's Summit, Jackson County, Missouri

DRAWING INCLUDES:
 ROOF FRAMING PLAN

DESIGNED: JWV
DRAWN: SEH
PROJECT NO.: 230286
SHEET: S600



1/4" ROOF SHEATHING FASTENED w/
 10d NAILS @ 6" O.C. @ PERIMETER / 12" O.C. FIELD
 OVER PRE-ENGINEERED ROOF TRUSSES @ 24" O.C. MAX.
 (TRUSS BEARING ELEV. = 141'-6 1/4")

HEADER SCHEDULE			
LABEL	HEADER	CRIPPLE/JACK	JAMB/KING
"H1"	2 Ply 2x6 SPF #2	Single Ply 2x6 SPF #2	Single Ply 2x6 SPF #2
"H2"	2 Ply 2x6 SPF #2	2 Ply 2x6 SPF #2	Single Ply 2x6 SPF #2
"H3"	2 Ply 2x6 SPF #2	3 Ply 2x6 SPF #2	Single Ply 2x6 SPF #2
"H4"	2 Ply 2x8 Doug Fir #2	Single Ply 2x6 SPF #2	Single Ply 2x6 SPF #2
"H5"	2 Ply 2x8 Doug Fir #2	2 Ply 2x6 SPF #2	Single Ply 2x6 SPF #2
"H6"	2 Ply 2x8 Doug Fir #2	4 Ply 2x6 SPF #2	Single Ply 2x6 SPF #2
"H7"	2 Ply 2x10 Doug Fir Sel. Struct	Single Ply 2x6 SPF #2	2 Ply 2x6 SPF #2
"H8"	2 Ply 2x10 Doug Fir Sel. Struct	2 Ply 2x6 SPF #2	2 Ply 2x6 SPF #2
"H9"	2 Ply 2x10 Doug Fir Sel. Struct	3 Ply 2x6 SPF #2	2 Ply 2x6 SPF #2
"H10"	2 Ply 2x10 Doug Fir Sel. Struct	5 Ply 2x6 SPF #2	2 Ply 2x6 SPF #2
"H11"	2 Ply 2x10 Doug Fir Sel. Struct	6 Ply 2x6 SPF #2	2 Ply 2x6 SPF #2
"H12"	2 Ply 2x10 Doug Fir Sel. Struct	7 Ply 2x6 SPF #2	2 Ply 2x6 SPF #2
"H13"	3 Ply 2x10 Doug Fir Sel. Struct	2 Ply 2x6 SPF #2	3 Ply 2x6 SPF #2
"H14"	3 Ply 1.75x11.25 Microlam LVL 2.0E	3 Ply 2x6 SPF #2	3 Ply 2x6 SPF #2
"H15"	3 Ply 1.75x11.25 Microlam LVL 2.0E	4 Ply 2x6 SPF #2	3 Ply 2x6 SPF #2
"H16"	3 Ply 1.75x11.25 Microlam LVL 2.0E	5 Ply 2x6 SPF #2	3 Ply 2x6 SPF #2
"H21"	2 Ply 2x8 Doug Fir #2	Single Ply 2x4 SPF #2	Single Ply 2x4 SPF #2
"H22"	2 Ply 2x8 Doug Fir #2	2 Ply 2x4 SPF #2	Single Ply 2x4 SPF #2
"H23"	2 Ply 2x8 Doug Fir #2	3 Ply 2x4 SPF #2	Single Ply 2x4 SPF #2
"H24"	2 Ply 2x10 Doug Fir Sel. Struct	2 Ply 2x4 SPF #2	Single Ply 2x4 SPF #2
"H25"	2 Ply 2x10 Doug Fir Sel. Struct	3 Ply 2x4 SPF #2	Single Ply 2x4 SPF #2
"H26"	2 Ply 2x10 Doug Fir Sel. Struct	4 Ply 2x4 SPF #2	Single Ply 2x4 SPF #2

APARTMENT BUILDING TYPE "A" ROOF FRAMING PLAN

SCALE: 1/8" = 1'-0"



No.	Date
ISSUE SET	04/15/2025
AS1 #1	10/31/2025
AS1 #2	01/16/2026

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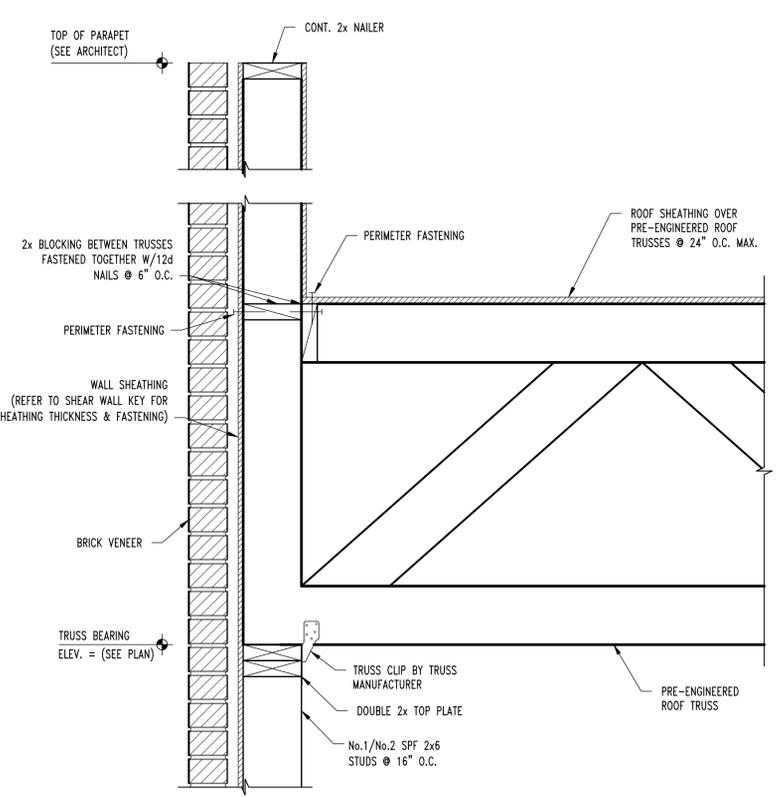
STRUCTURAL ENGINEER
CROCKETT
 ENGINEERING CONSULTANTS
 1000 W. Kings Blvd., Suite 1
 Columbia, Missouri 65203
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 362 E. ENDOR AVE.
 COLUMBIA, MISSOURI


Alura Village Apartment Building Type "A"
 Lee's Summit, Jackson County, Missouri

DRAWING INCLUDES:
 ROOF FRAMING DETAILS


DESIGNED: JWW
 DRAWN: SEH
 PROJECT NO.: 230286
 SHEET: S612




S30
S300
ROOF FRAMING SECTION
 SCALE: 1/2" = 1'-0"

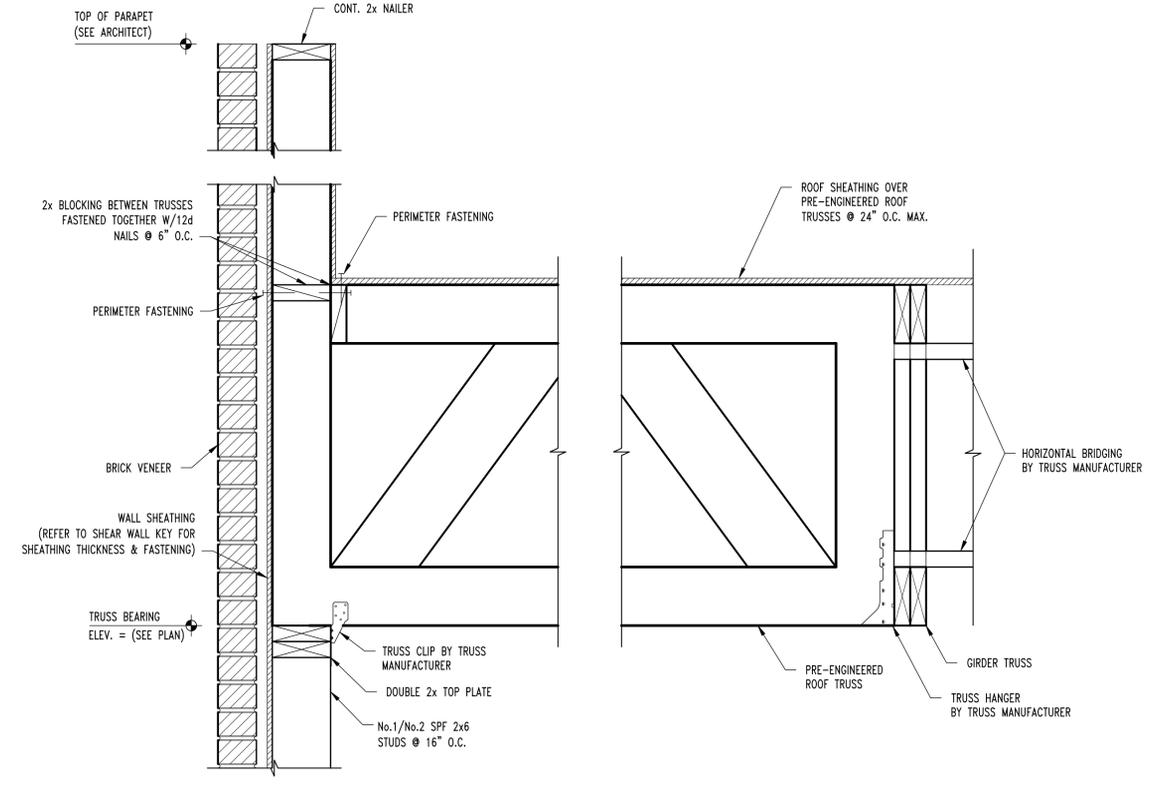


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S300
ROOF FRAMING SECTION
 SCALE: 1/2" = 1'-0"

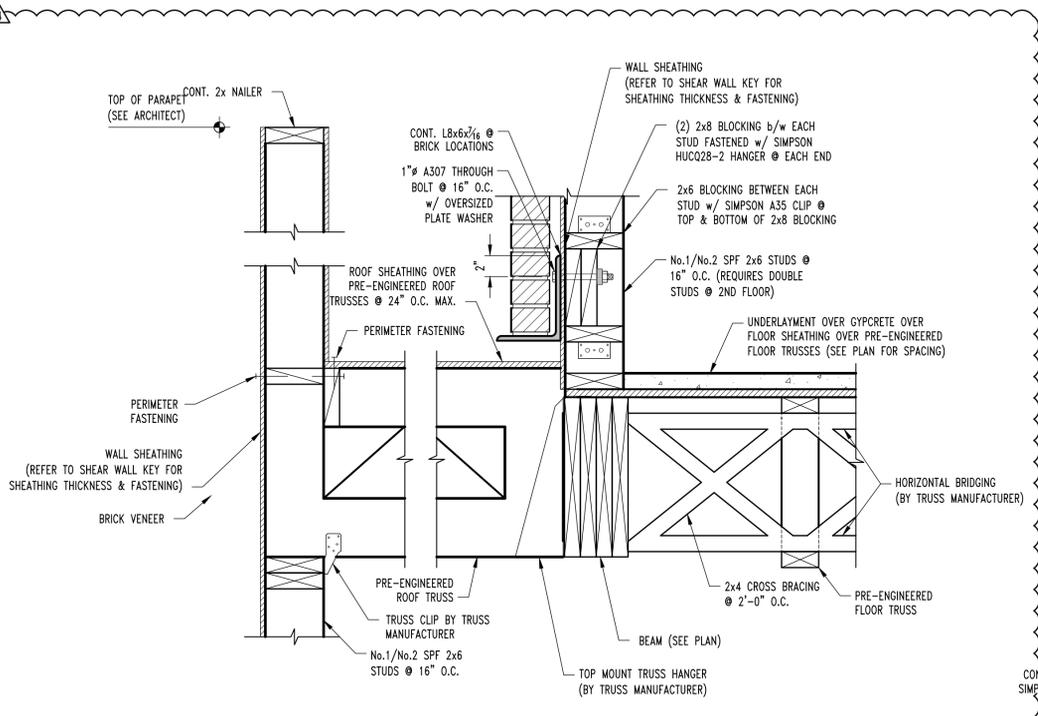


S35
S300
FRAMING SECTION
 SCALE: 1/2" = 1'-0"

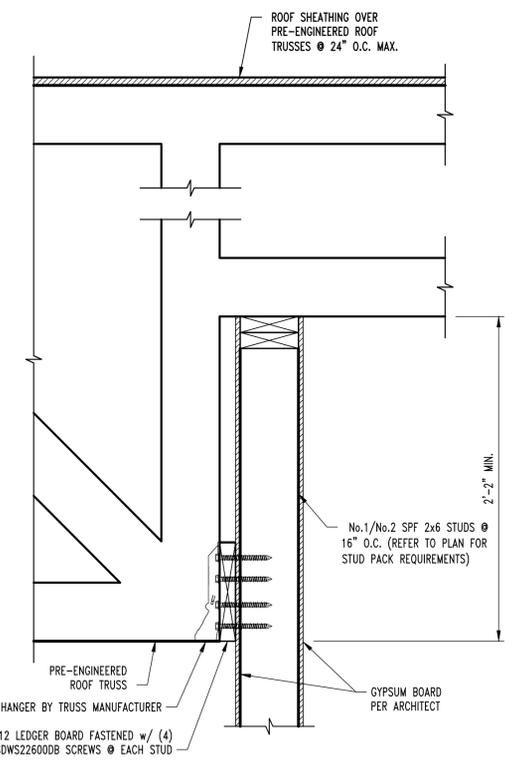


S40
S600
TYP. ROOF FRAMING SECTION
 SCALE: 1/2" = 1'-0"

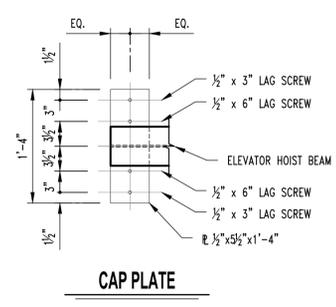


S41
S612
HOIST BEAM BEARING DETAIL
 SCALE: 1/2" = 1'-0"

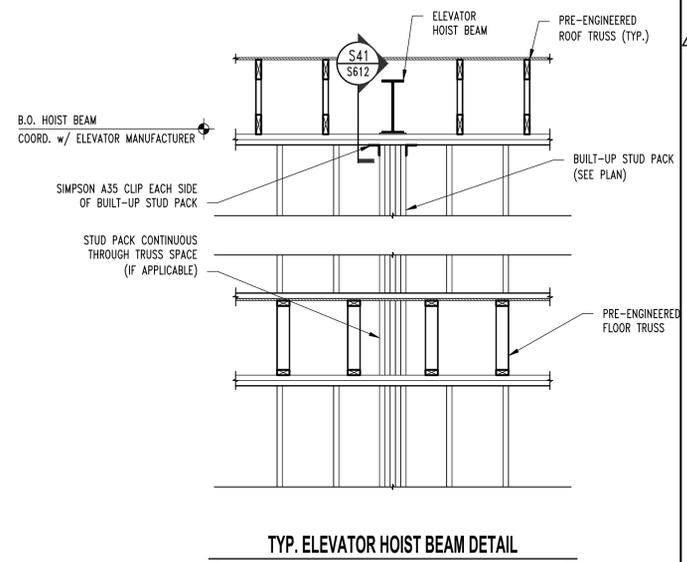

TYP. ELEVATOR HOIST BEAM DETAIL

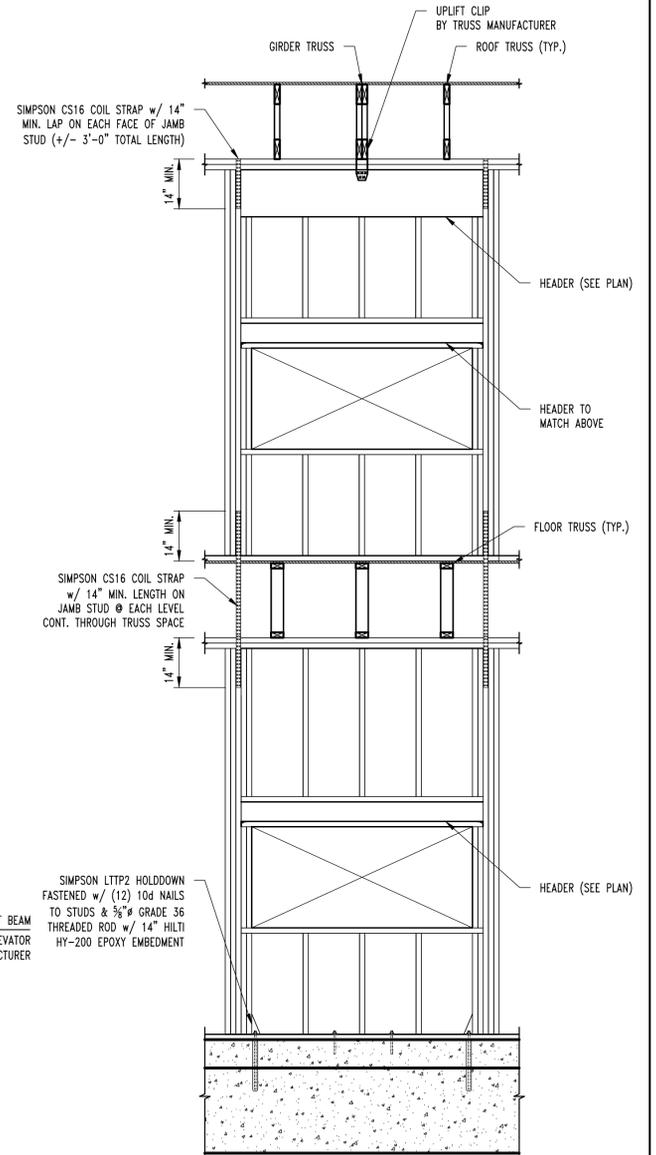

TYP. MULTI-STORY GIRDER TO HEADER DETAIL

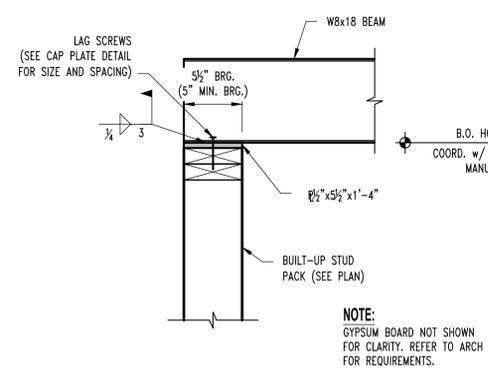

NOTE:
 GYPSUM BOARD NOT SHOWN FOR CLARITY. REFER TO ARCH FOR REQUIREMENTS.