WOODLAND MASTER PLAN

ADDRESS: 2213 SW Heartland Court, Lees Summit, MO

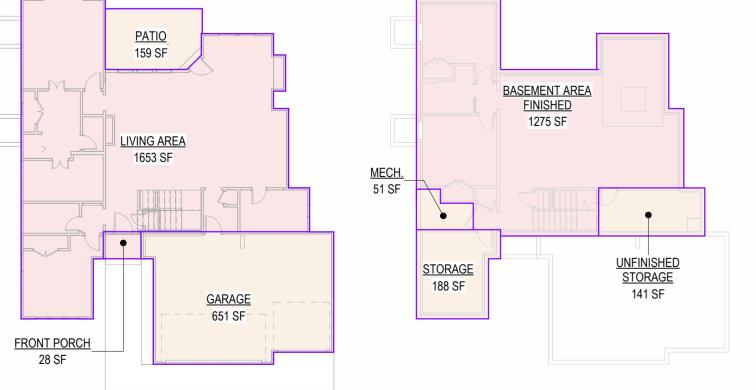
: HF 215 LOT




| | Sheet List | | |
|---------|--------------------------------------|--|--|
| heet No | Sheet Name | | |
|) | Cover | | |
| 101 | Main Base Elevation | | |
| 201 | Elevation options | | |
| 301 | Full Basement side Elevation options | | |
| 302 | Daylight Basement Side elevations | | |
| 303 | Walkout Side elevations | | |
| 101 | Foundation Plan | | |
| 501 | Basemenet Floor Plan | | |
| 601 | Floor Plan -Main Level | | |
| 602 | Floor Plan - Extended Roof Option | | |
| 701 | Floor Plan - Roof Plan | | |
| 301 | POD Options - Kitchen | | |
| 302 | POD Options - Kitchen | | |
| 303 | <varies></varies> | | |
| 304 | POD Options - Primary Bath | | |
| 305 | POD Options - Primary Bath | | |
| 901 | Details | | |
| 902 | Details | | |
| 903 | Details | | |
| 101 | RCP/Electrical Plan | | |
| 102 | RCP/Electrical Plan | | |
| 101 | HVAC Plans | | |
| 101 | Plumbing Plans | | |
| | | | |





5 Main Level Area Plan 1/16" = 1'-0"




| | | BASEMENT AREA FINISHED 1275 SF | |
|---------------|-------------------|---------------------------------|--|
| MECH 51 SF | STORAGE 188 SF | UNFINISHED STORAGE 141 SF | |
| 4 | Baseme 1/16" = | ent Area Plan 1'-0" | |

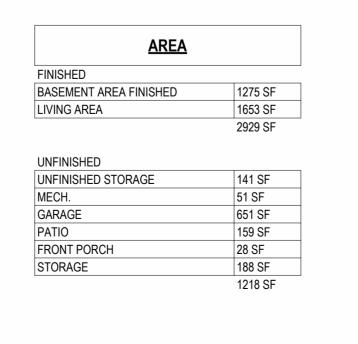

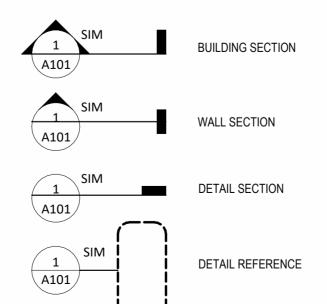

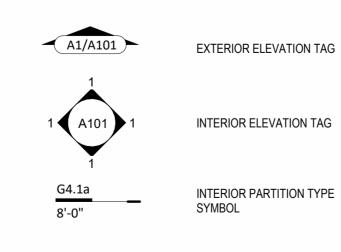

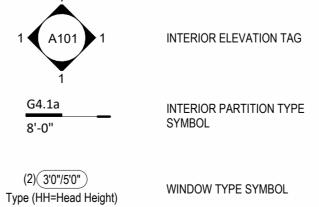(2)(3'0"/5'0")



BENCHMARK/SPOT ELEV. SYMBOL COLUMN LINE/GRID INDICATOR FLOOR LEVEL SYMBOL CEILING HEIGHT SYMBOL 1'-0"A.F.F DIMENSION

General Information

| 2018 Interior Energy Cons. C | ode (Table N1102.1.2) |
|------------------------------|------------------------|
| Doors & Windows: | U-0.32 MAX |
| Glazing SHGF: | 0.40 |
| Skylights: | U-0.55 MAX |
| Roof | |
| Attic Ceilings: | R-49 MIN |
| Vaults: | R-38 MIN |
| Vaults < 500sf: | R-30 MIN |
| | |
| Wood Frame Walls: | R-20 or R-13 + 5 MIN |
| Basement Walls: | R-13 or R-10 Continuou |
| Floor (over unconditioned): | R-19 MIN |
| Slab on Grade: | R-10 for 24" MIN |
| Ductwork: | R-8 MIN |
| Fuel Fired Furnace: | 90% AFUE MIN |
| Electic Furnace: | No Minimum |
| Cooling System: | 13 SEER MIN |
| 0 , | |
| Water Heater | |
| Gas Fired Storage: | 0.67 EF MIN |
| Gas Fired Instant: | 0.62 EF MIN |
| Electic Storage: | 0.97 EF MIN |
| Electic Instant: | |

An energy efficient certificate is required to be posted in or on the electrical panel before the final inspection. The certificate will be provided with all new residential permits. It is the permit certificate has accurate information and is posted before final inspection -- Owner/Contractor is responsibile for meeting the prescriptive requirments of IRC chapter 11 unless a HER Index Analysis for Performance Compliance based on the plans is submitted to the AHJ for

Wind Speed: Topography Effects: Seismic Design Category: Damage From Weather: Frost Line Depth: Winter Design Temperature: 6 F Ice Barrier Underlayment:

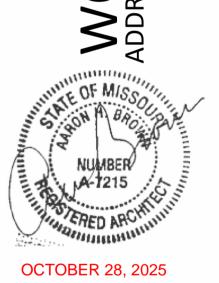
Flood Hazard: THESE DRAWINGS HAVE BEEN PREPARED WITH CORRECTLY IDENTIFIED TO THESE CODES SHALL BE BROUGHT TO THE ATTENTION OF SSIONAL 3. Steel columns shall be minimum schedule 40

- 4. Deck Ledger attachment to house shall be per
- Tables 507.9.1.3. 5. New provisions for attachment of rafters, trusses and roof beams. (R802.3 and
- 6. Programmable thermostat required
- (N1103.1.1)
- air leakage rate (N1103.2.2.1) 8. Building cavities used as return air plenums shall be sealed to prevent leakage across the
- thermal envelope. (N1103.2.3) 9. Certain hot water pipes shall be insulated (N1103.4)
- 10. All exhaust fans shall terminate to the building exterior (M1507.2) 11. Makeup air system required for kitchen
- exhaust hoods that exceed 400 CFM M1503.4 12. Building cavities in a thermal envelope wall (including the wall between the house and garage) shall not be used as return air plenums (unless the required insulation and air
- barrier are maintained) (M1601.1.1,#7.5) 13. An air handling system shall not serve both the living space and the garage (M1601.6) 14. A concrete-Encased grounding electrode
- ('UFER' Ground) connection complies with the requirments of the 2018 IRC Section E3608.1.2 in providing a connection with no less than the required minimum of steel. 15. Compliance with the requirments and show connection as needed for roof beam, trus,
- rafter, and girder connections for uplift per IRC 16. Garage Door Rating: DASMA 115 MPH Rated

2018 IRC BUILDING CODE COMPLIANCE THESE DRAWINGS HAVE BEEN PREPARED WITH RESPECT TO COMPLIANCE OF THE 2018 IRC AND NEC 2017 ANY REFERENCES FOUND NOT CORRECTLY IDENTIFIED TO THESE CODES SHALL BE BROUGHT TO THE ATTENTION OF SSIONAL THE DESIGN PROFESSIONAL


RELEASE FOR CONSTRUCTION AS NOTED ON PLANS REVIEW DEVELOPMENT SERVICES LEE'S SUMMIT, MISSOURI 11/12/2025 3:44:45






Original Issue Date: REVISIONS

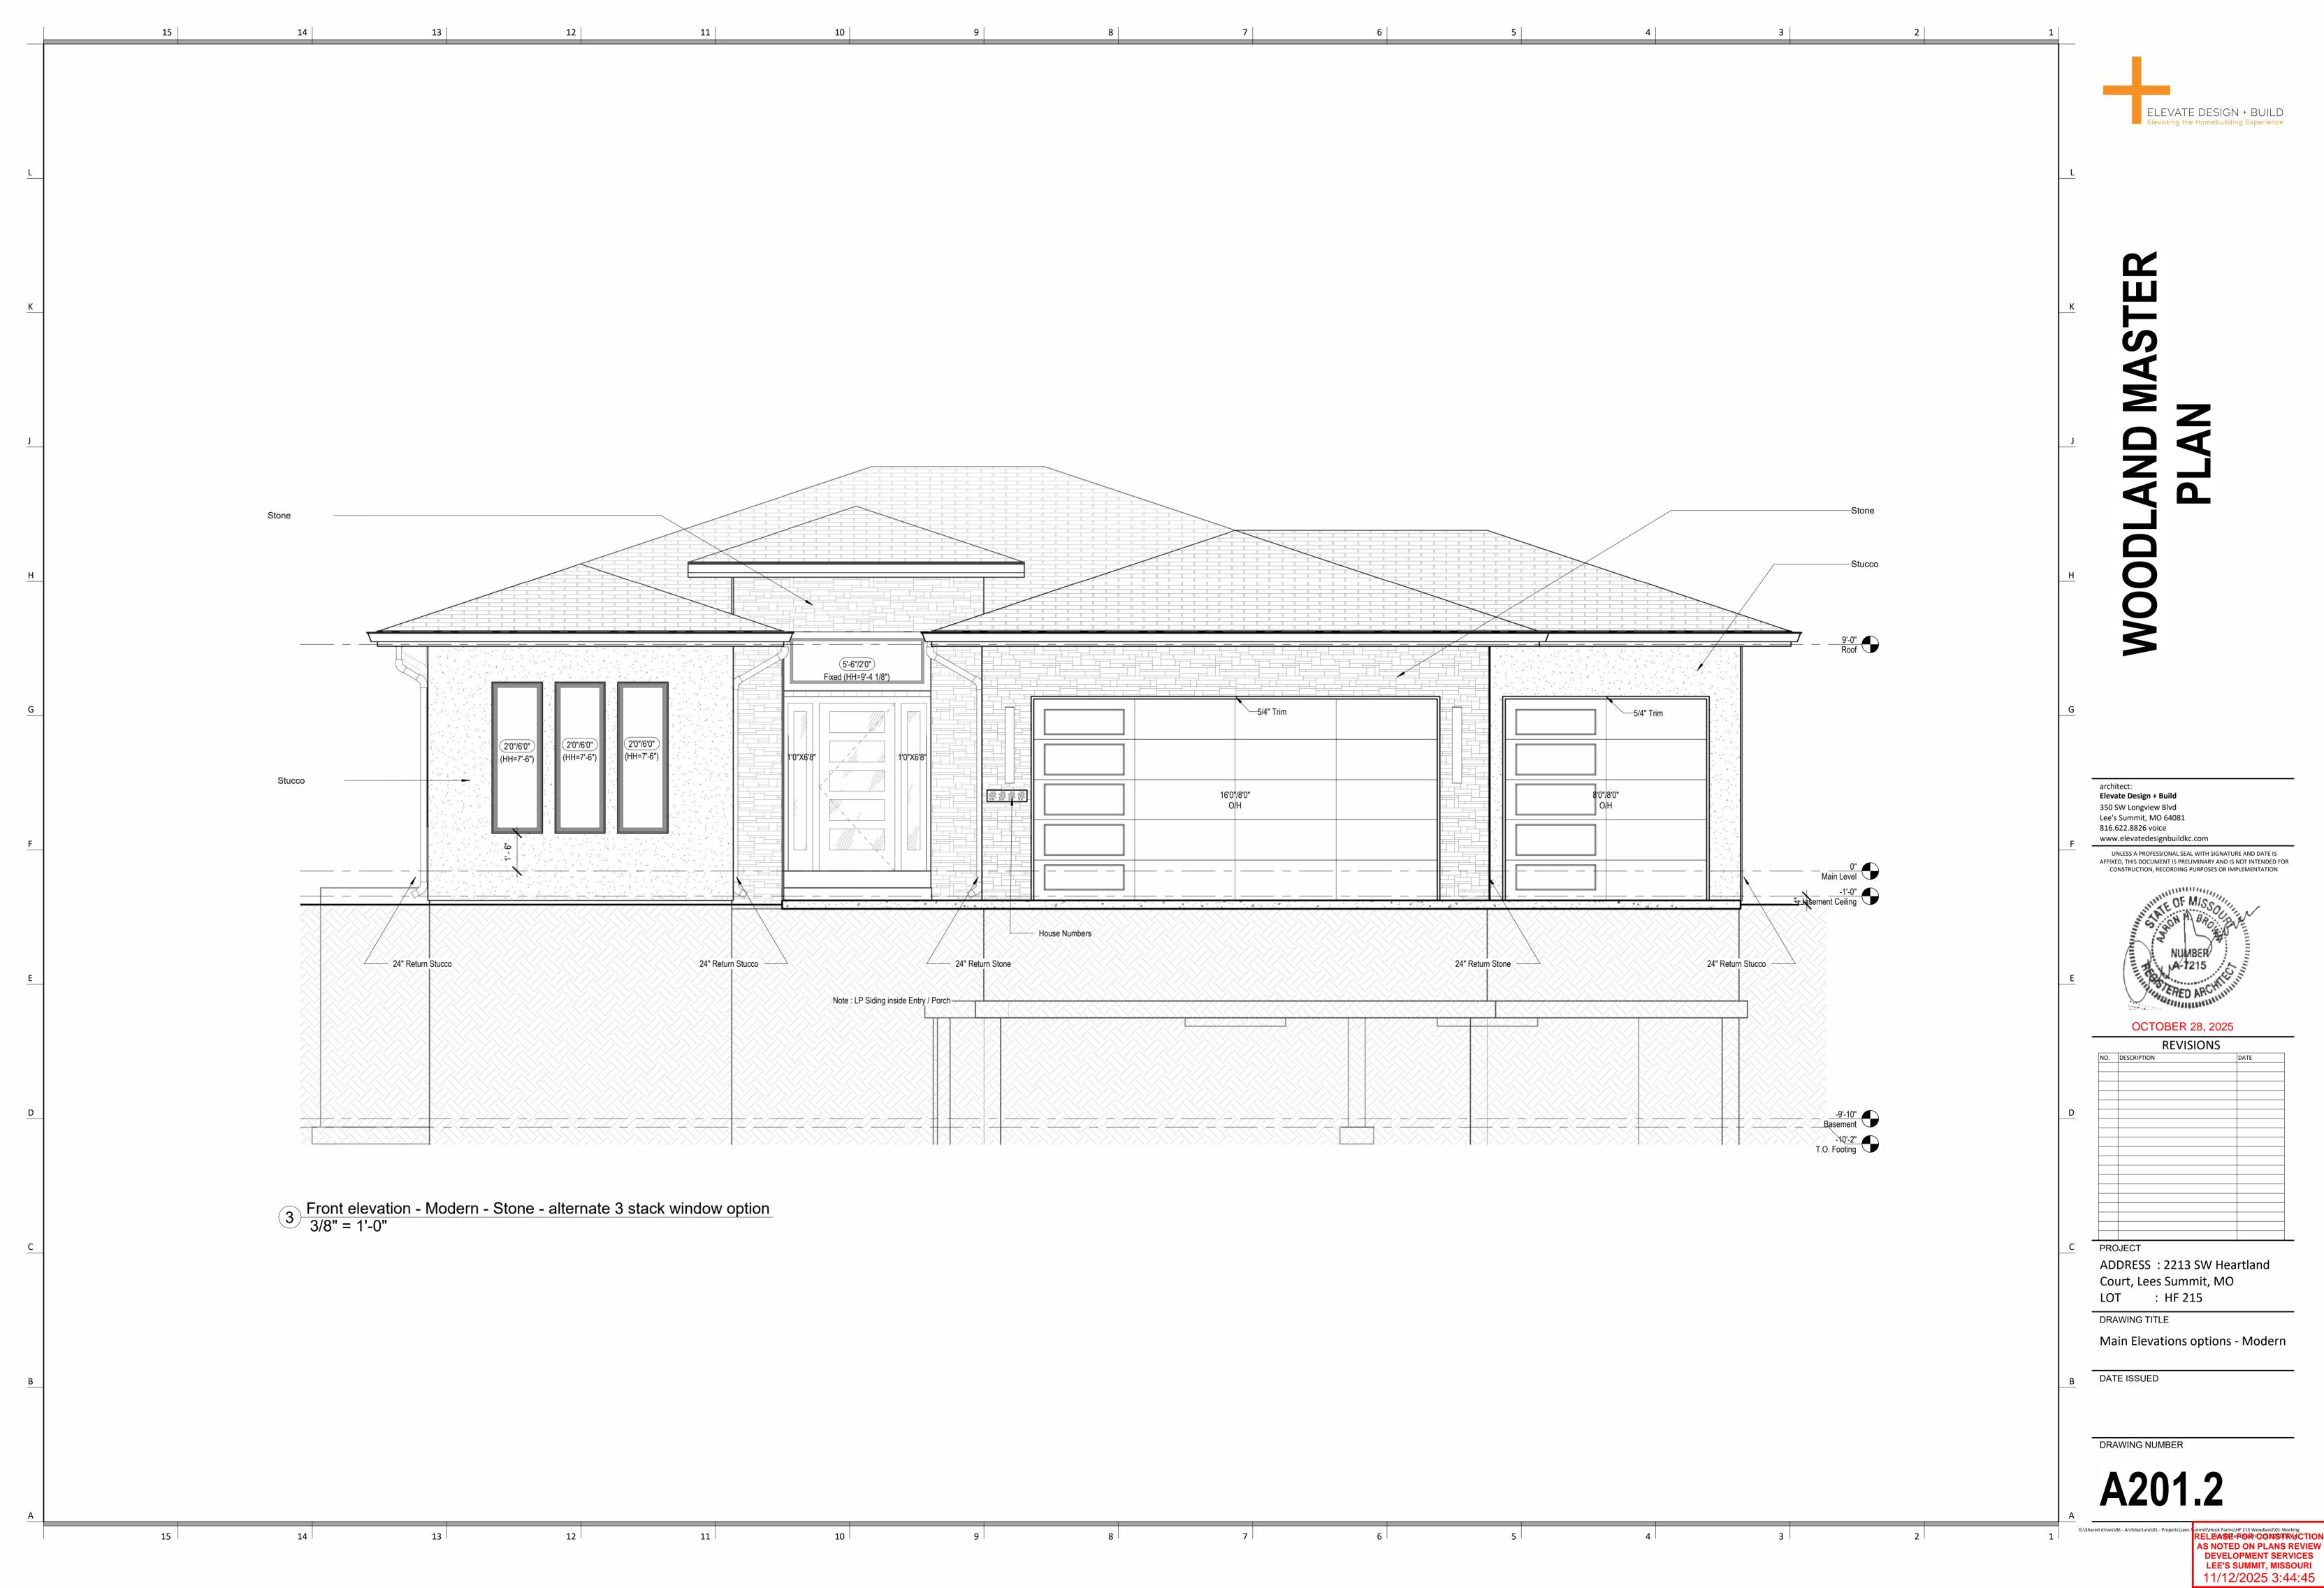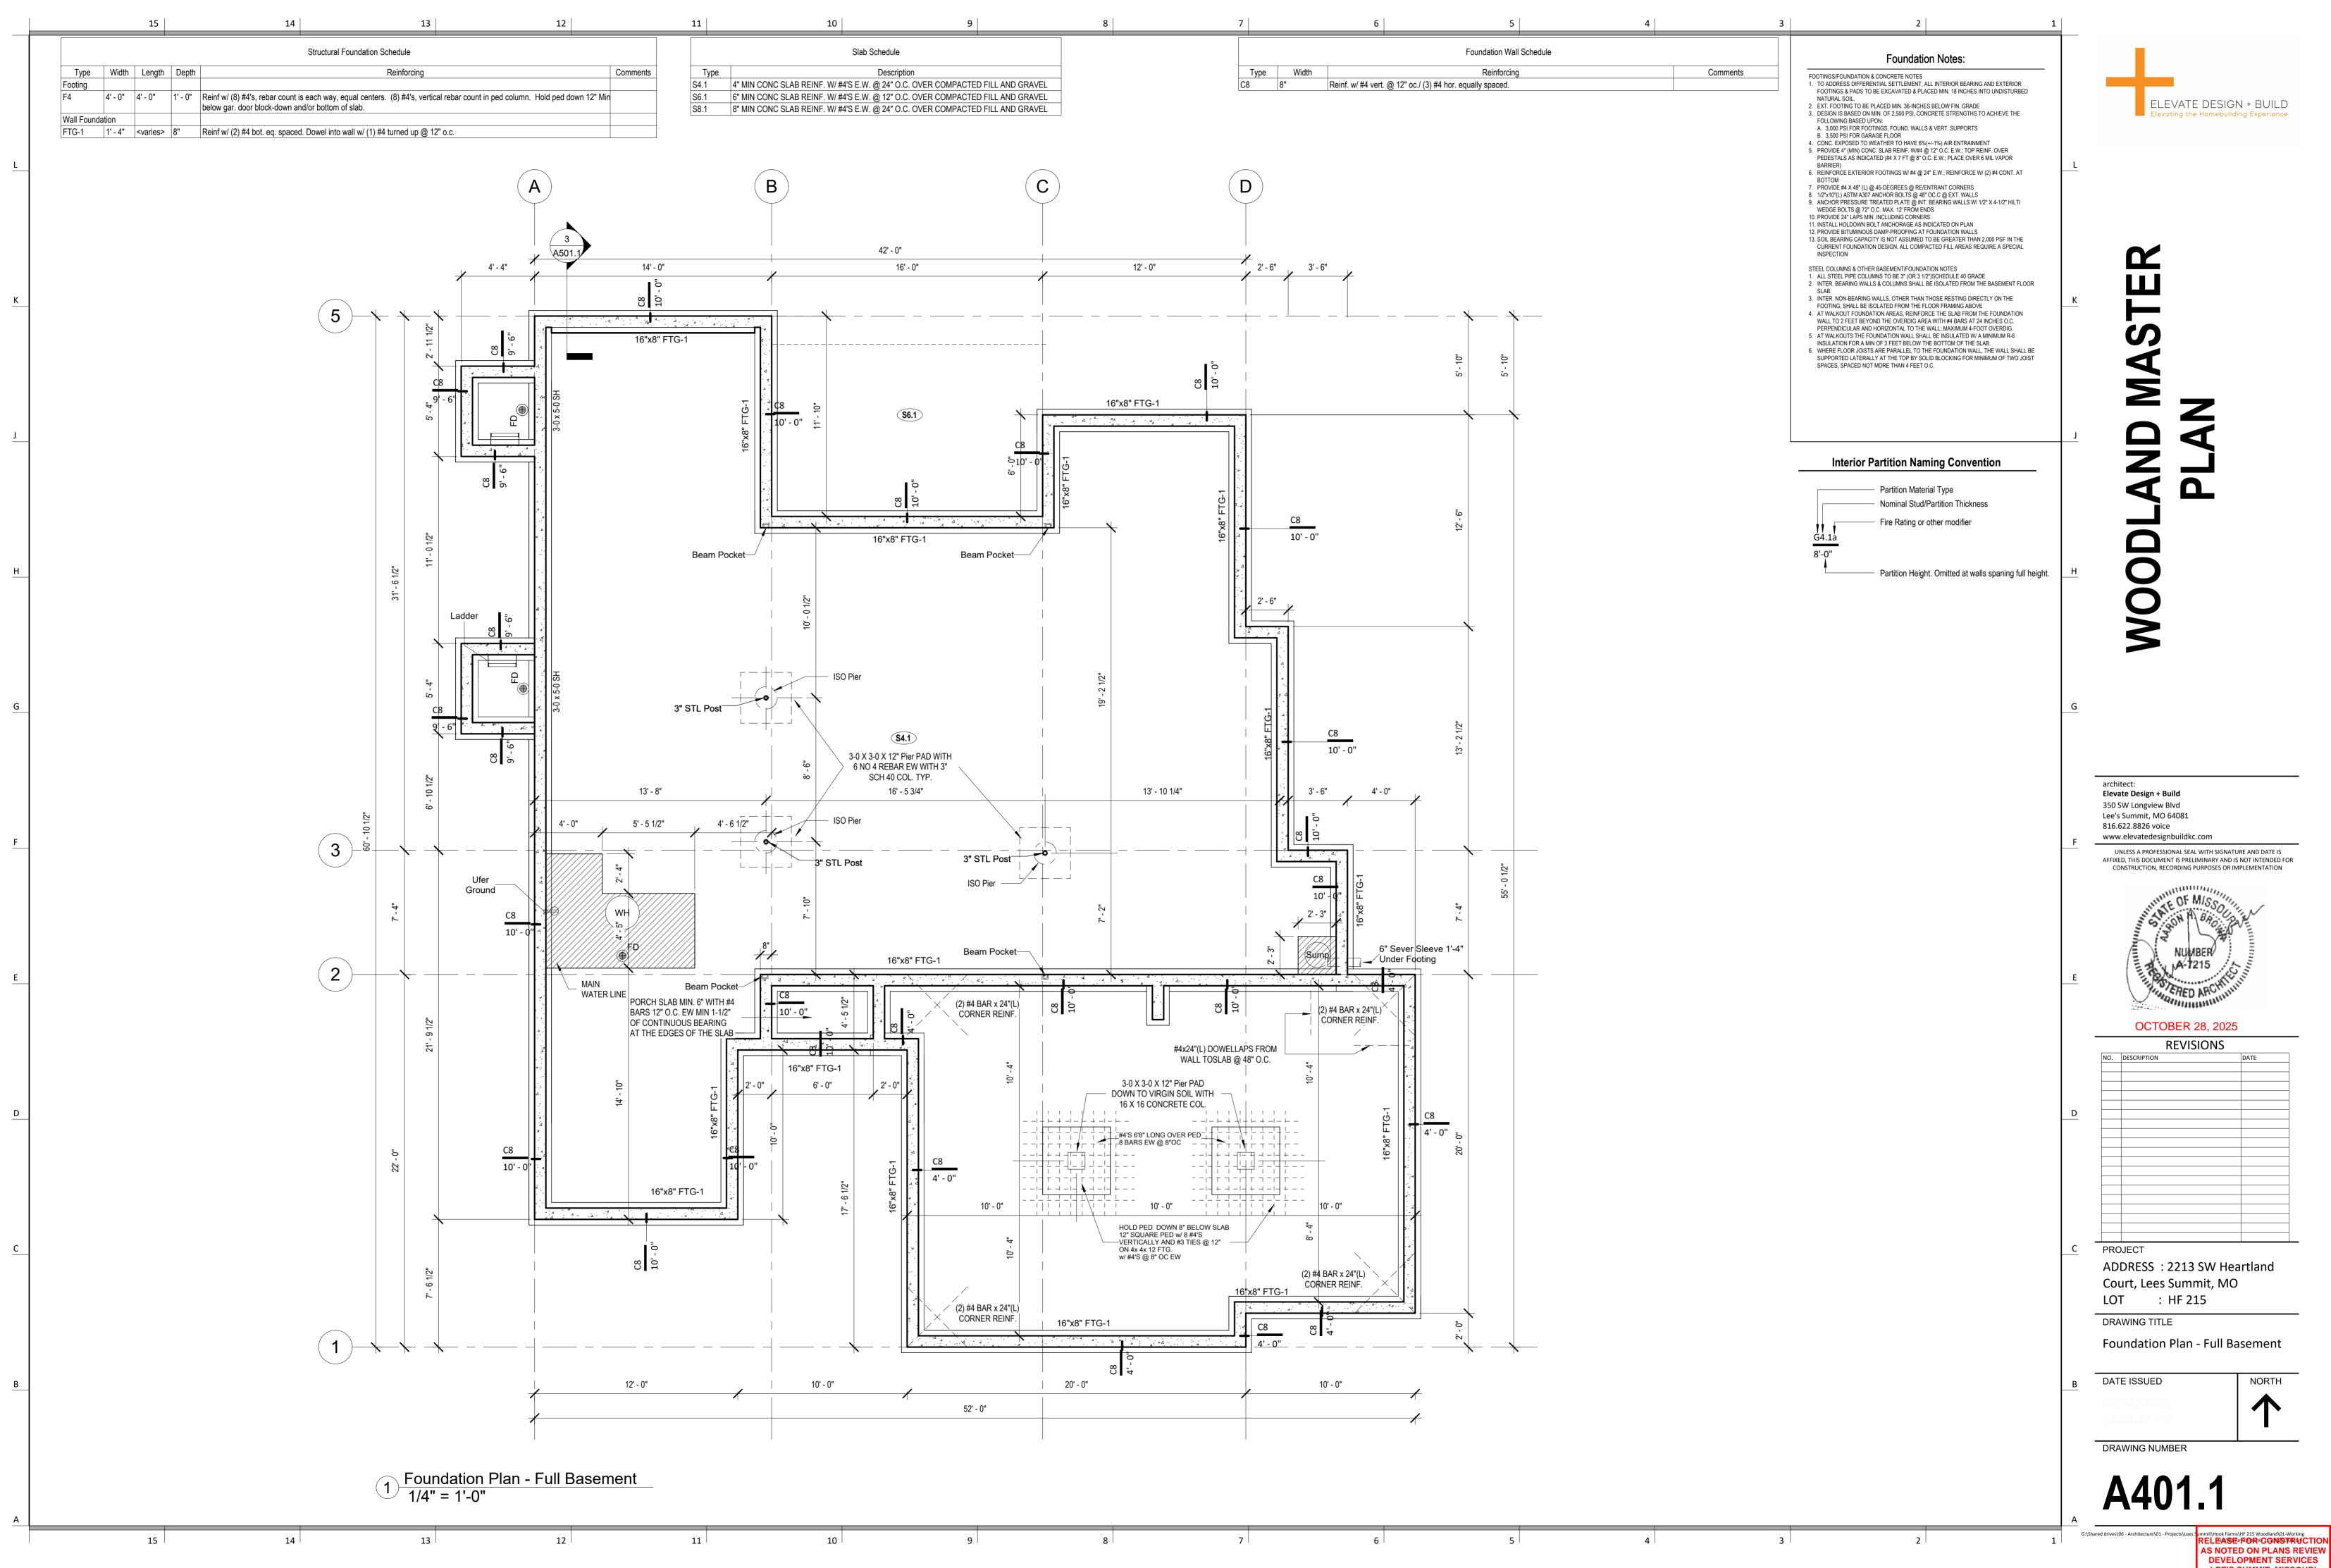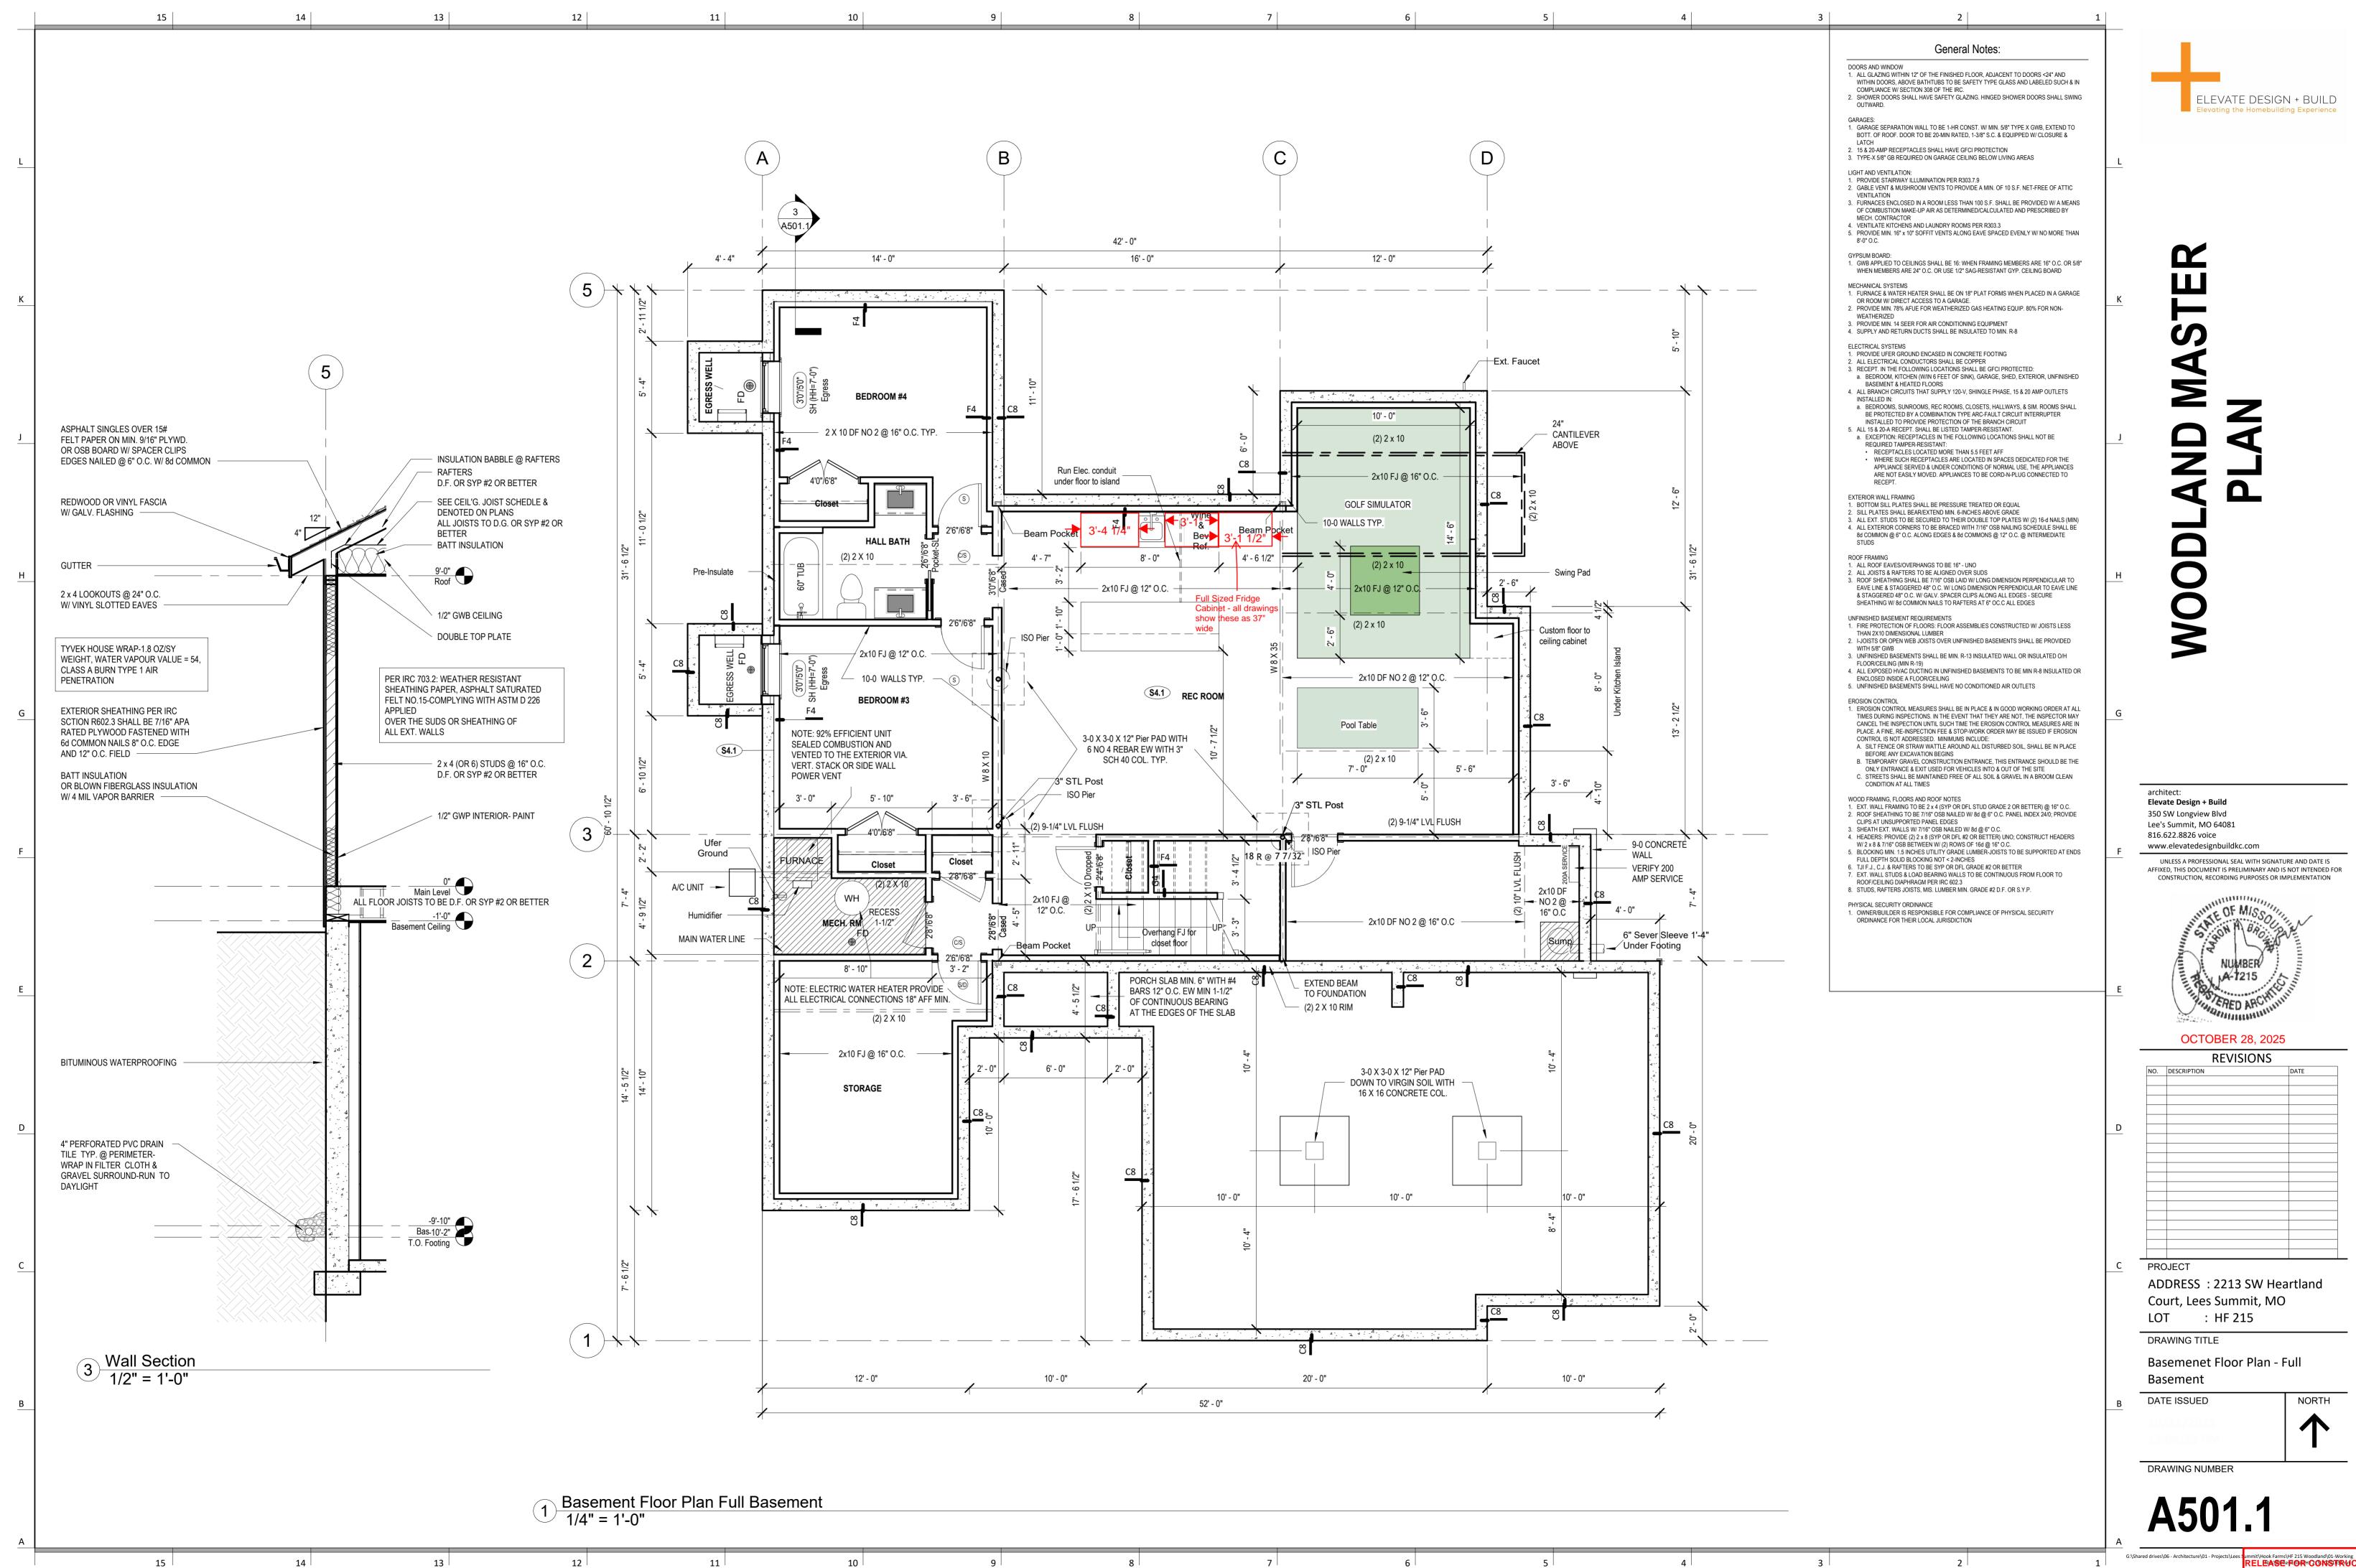
PLAN DESCRIPTION: Cover



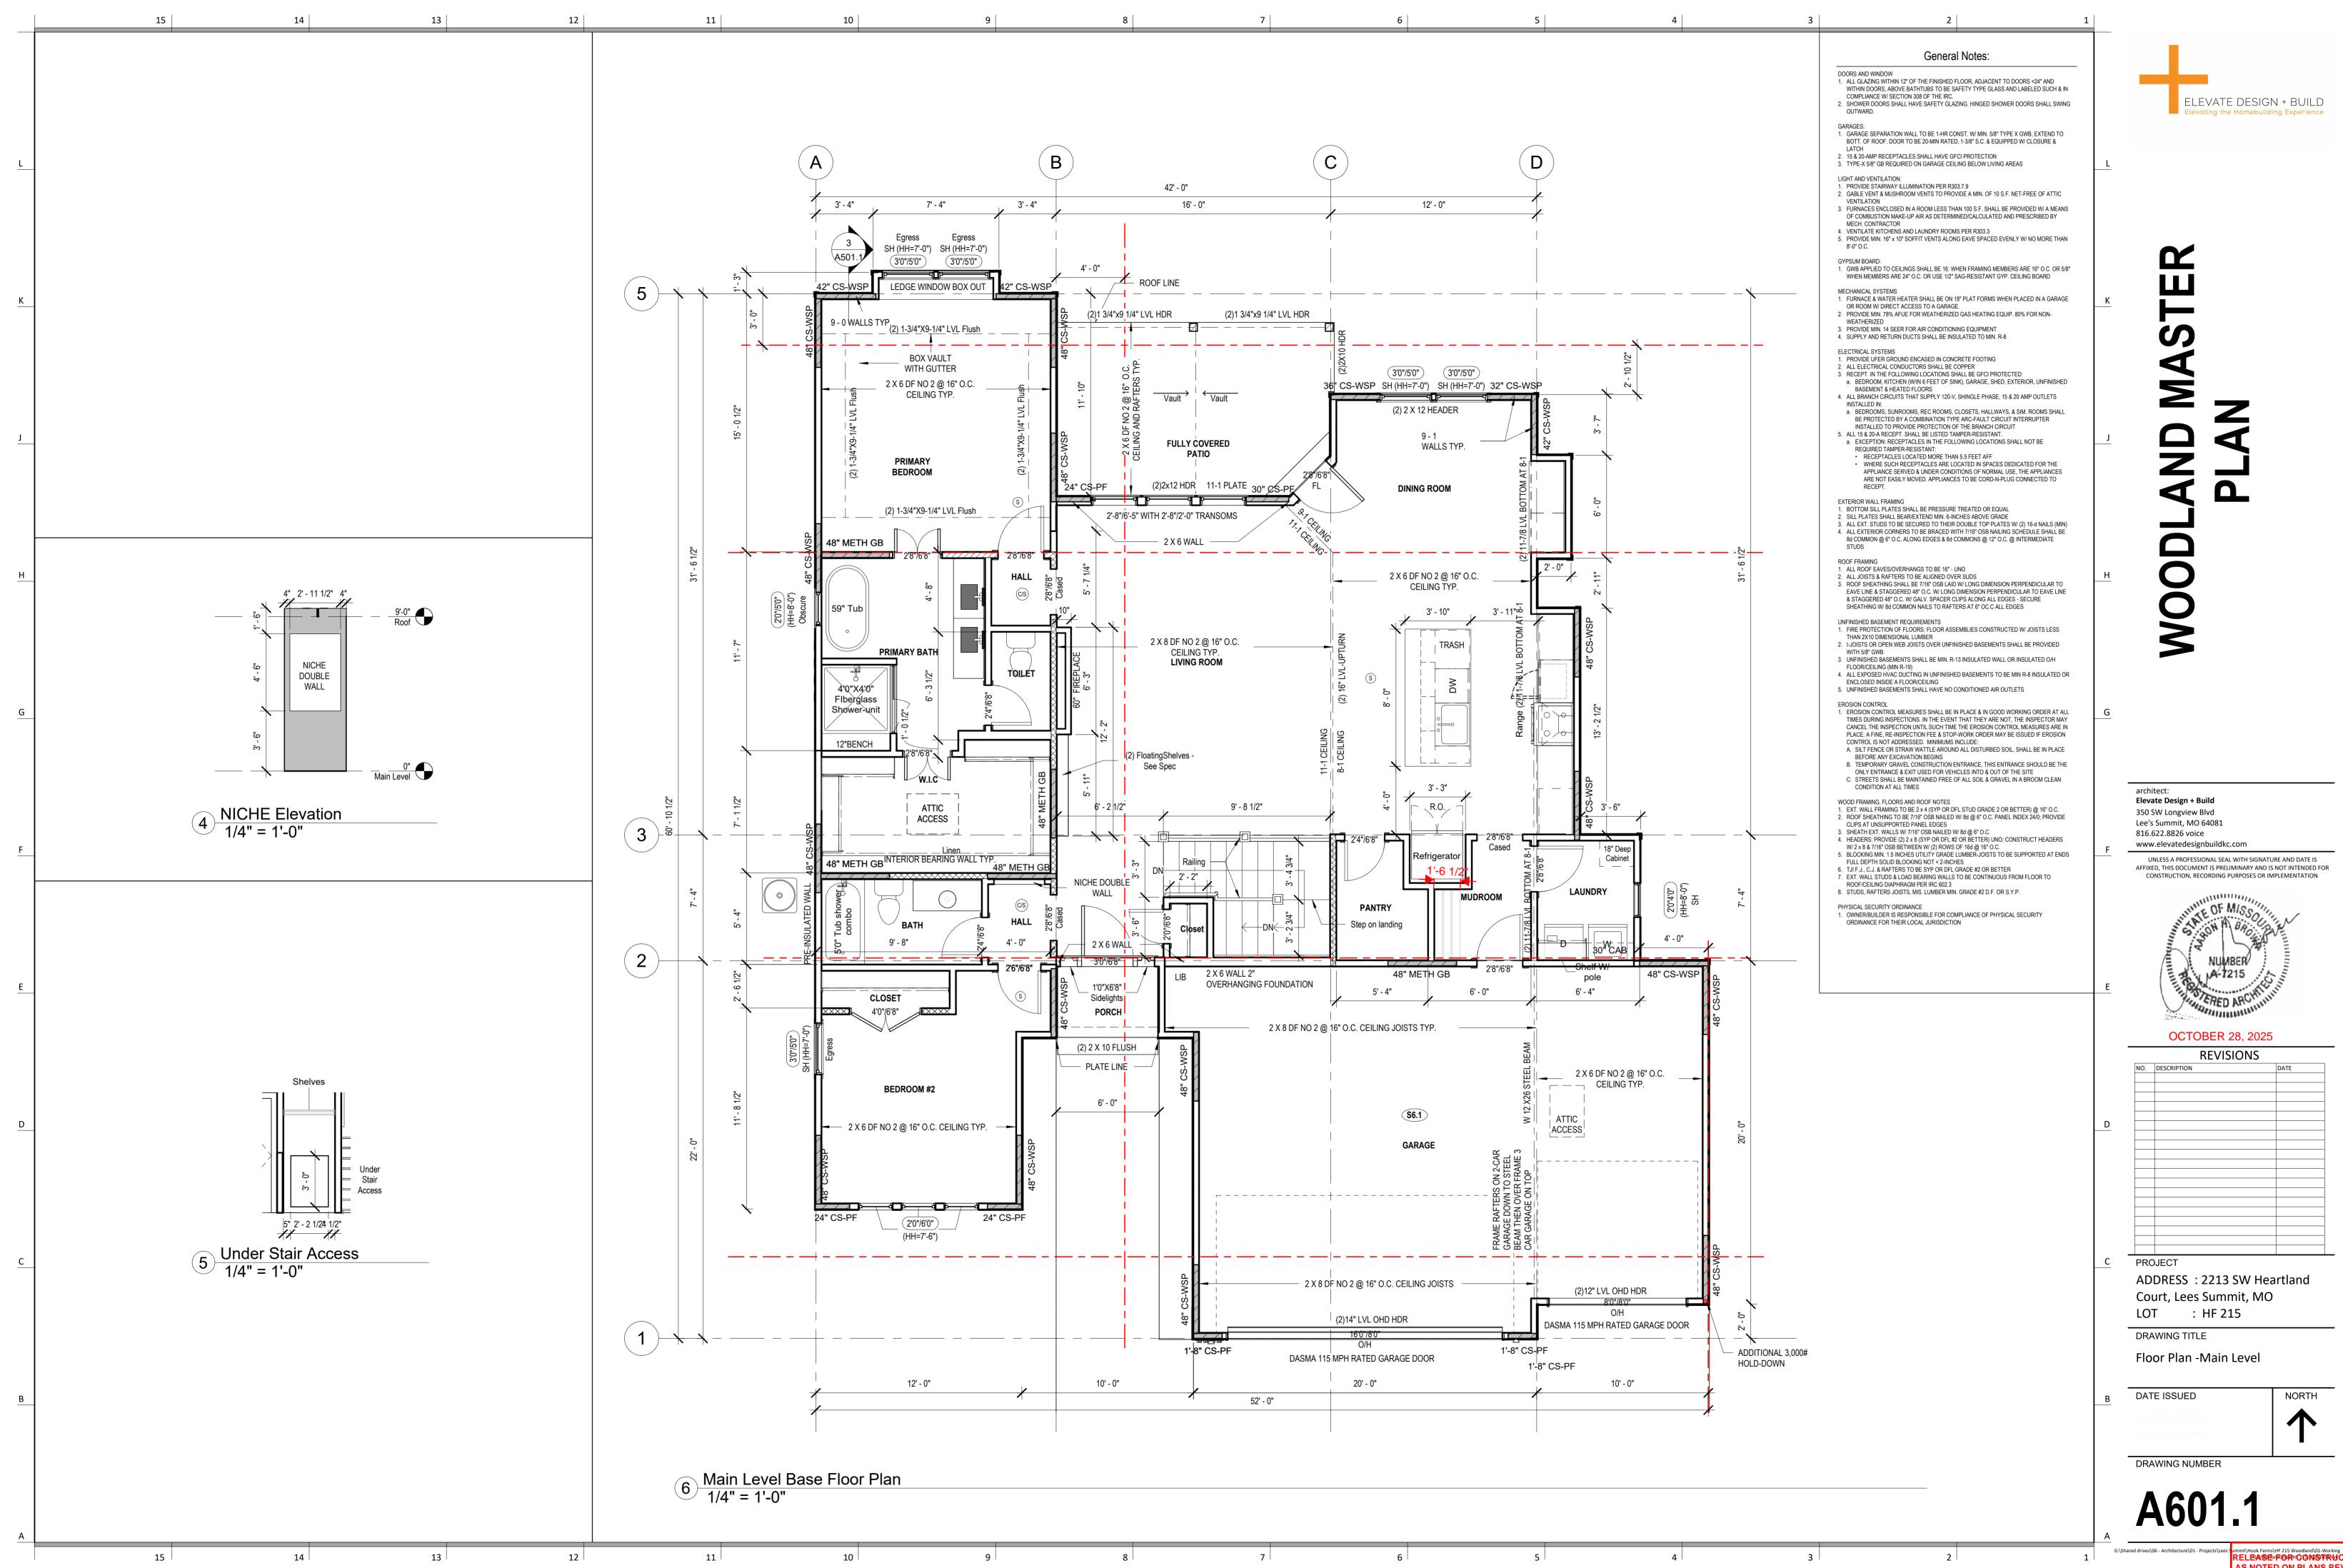




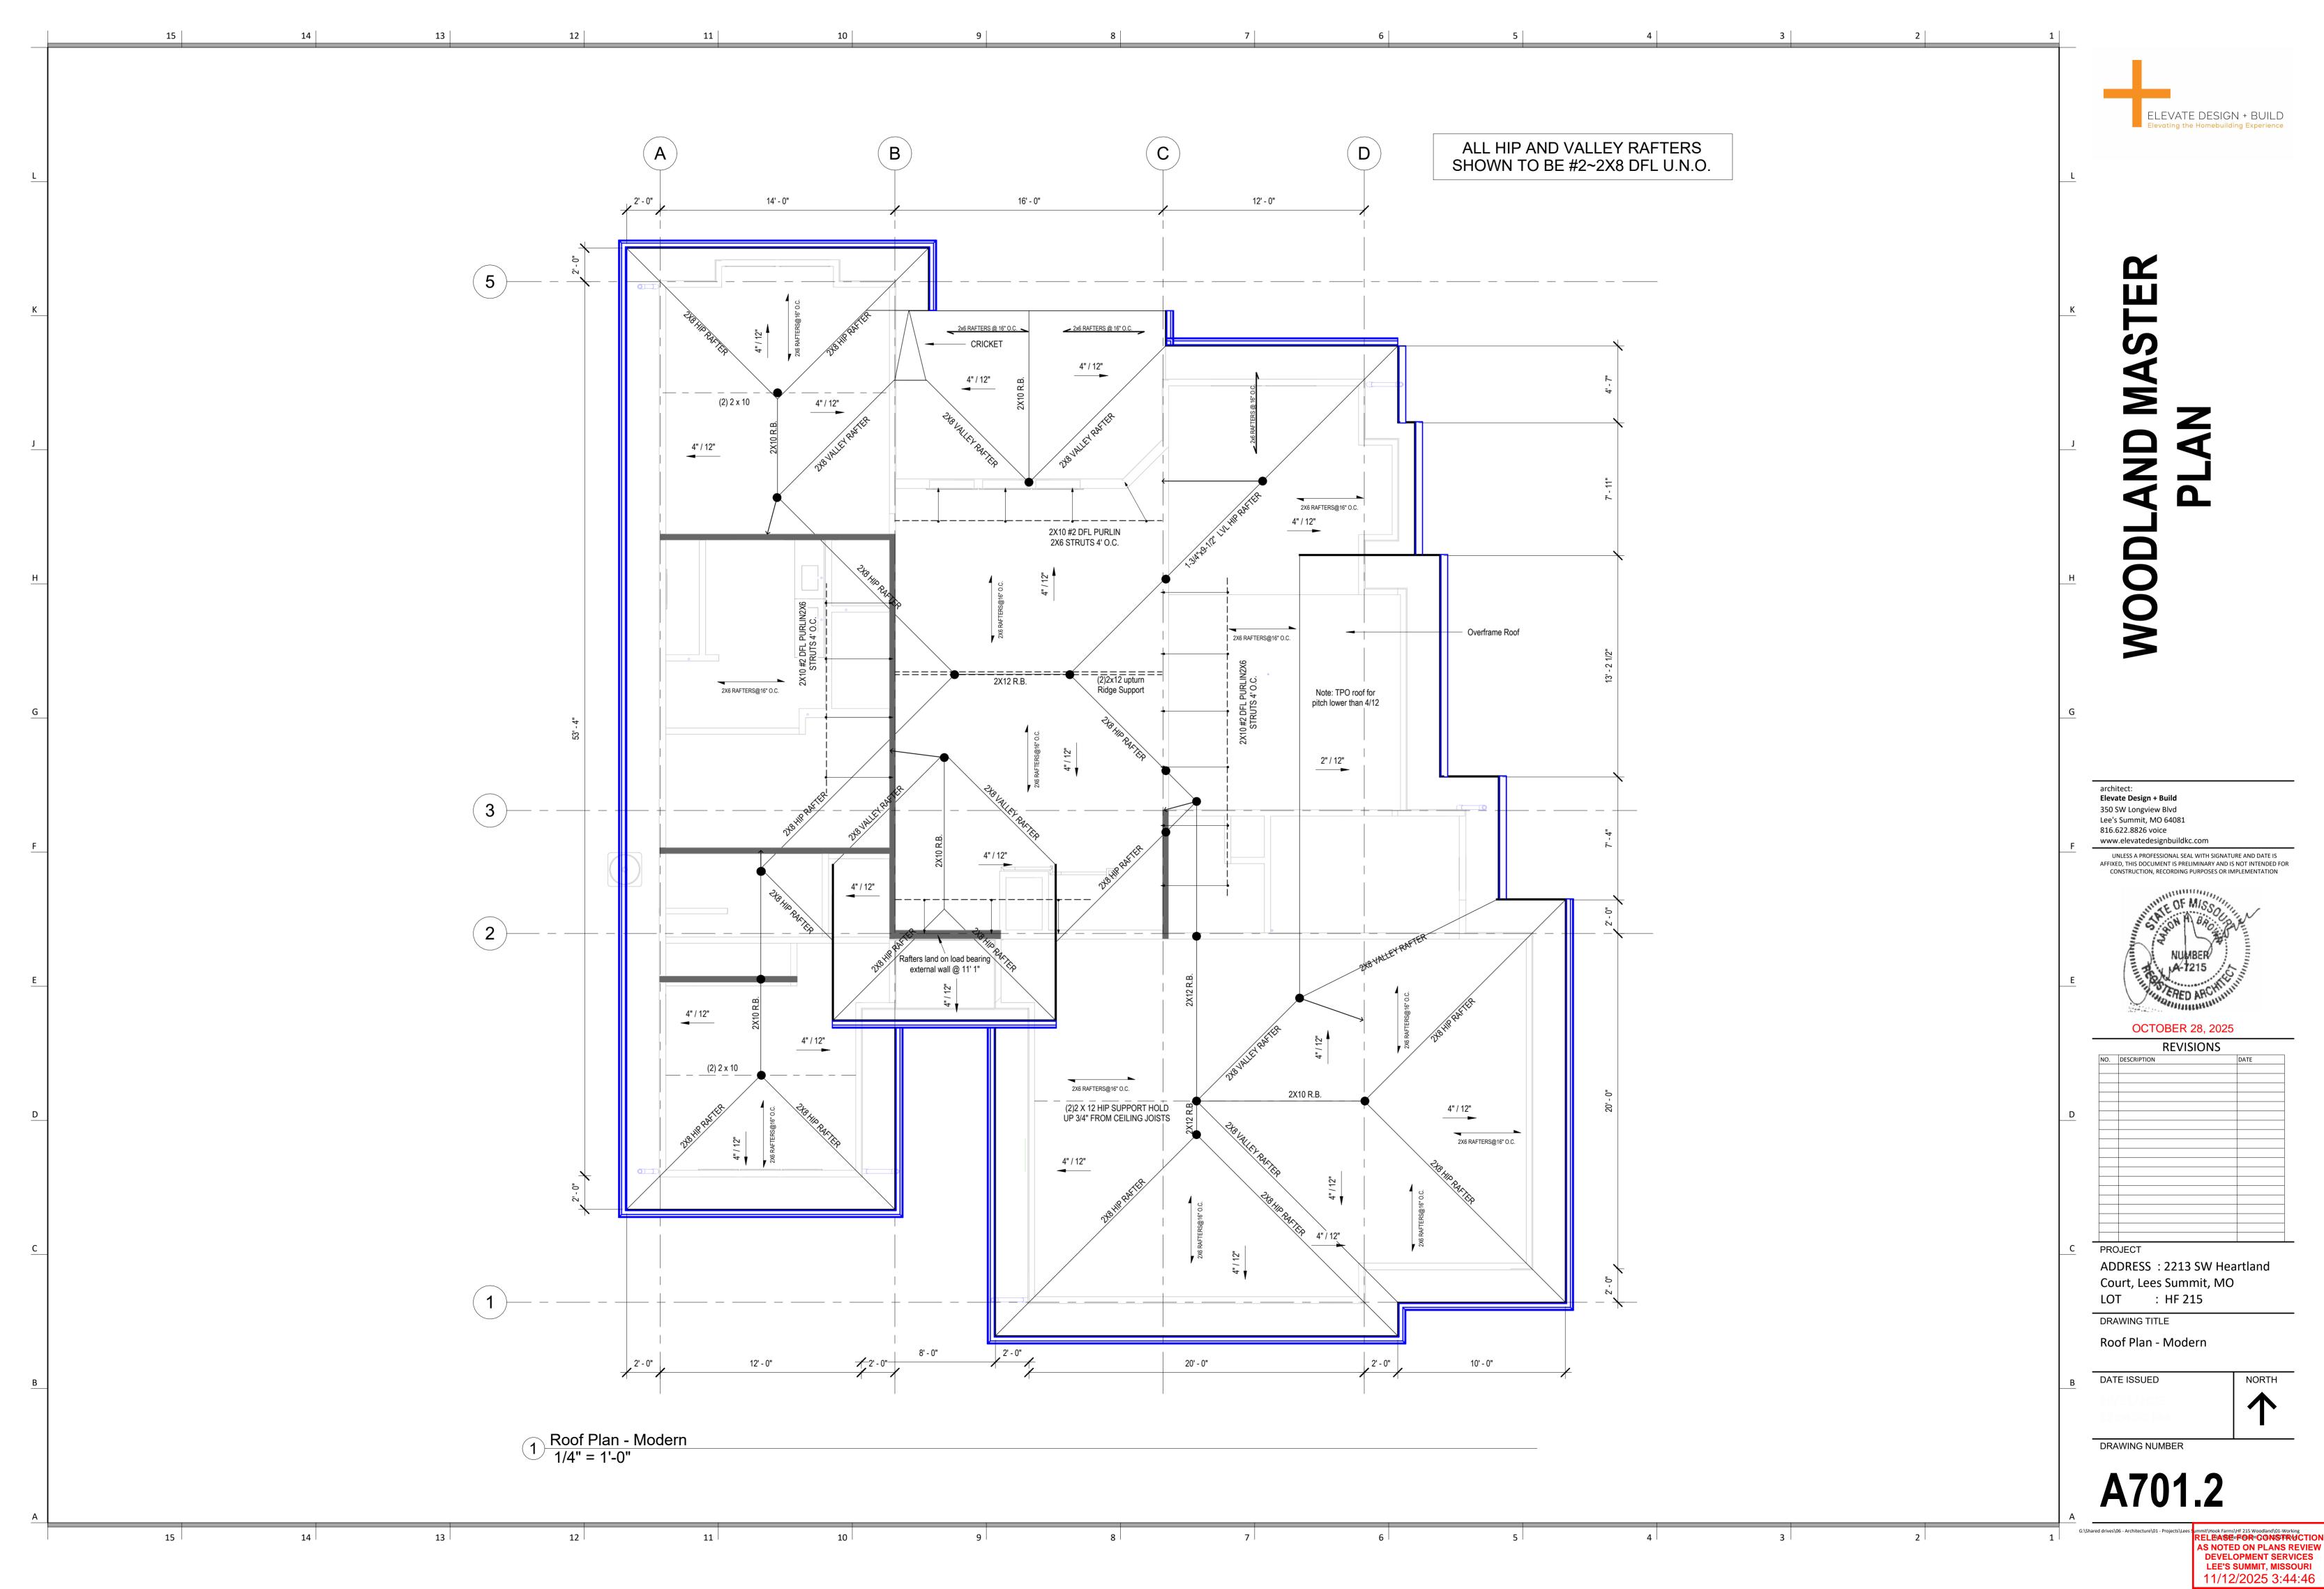
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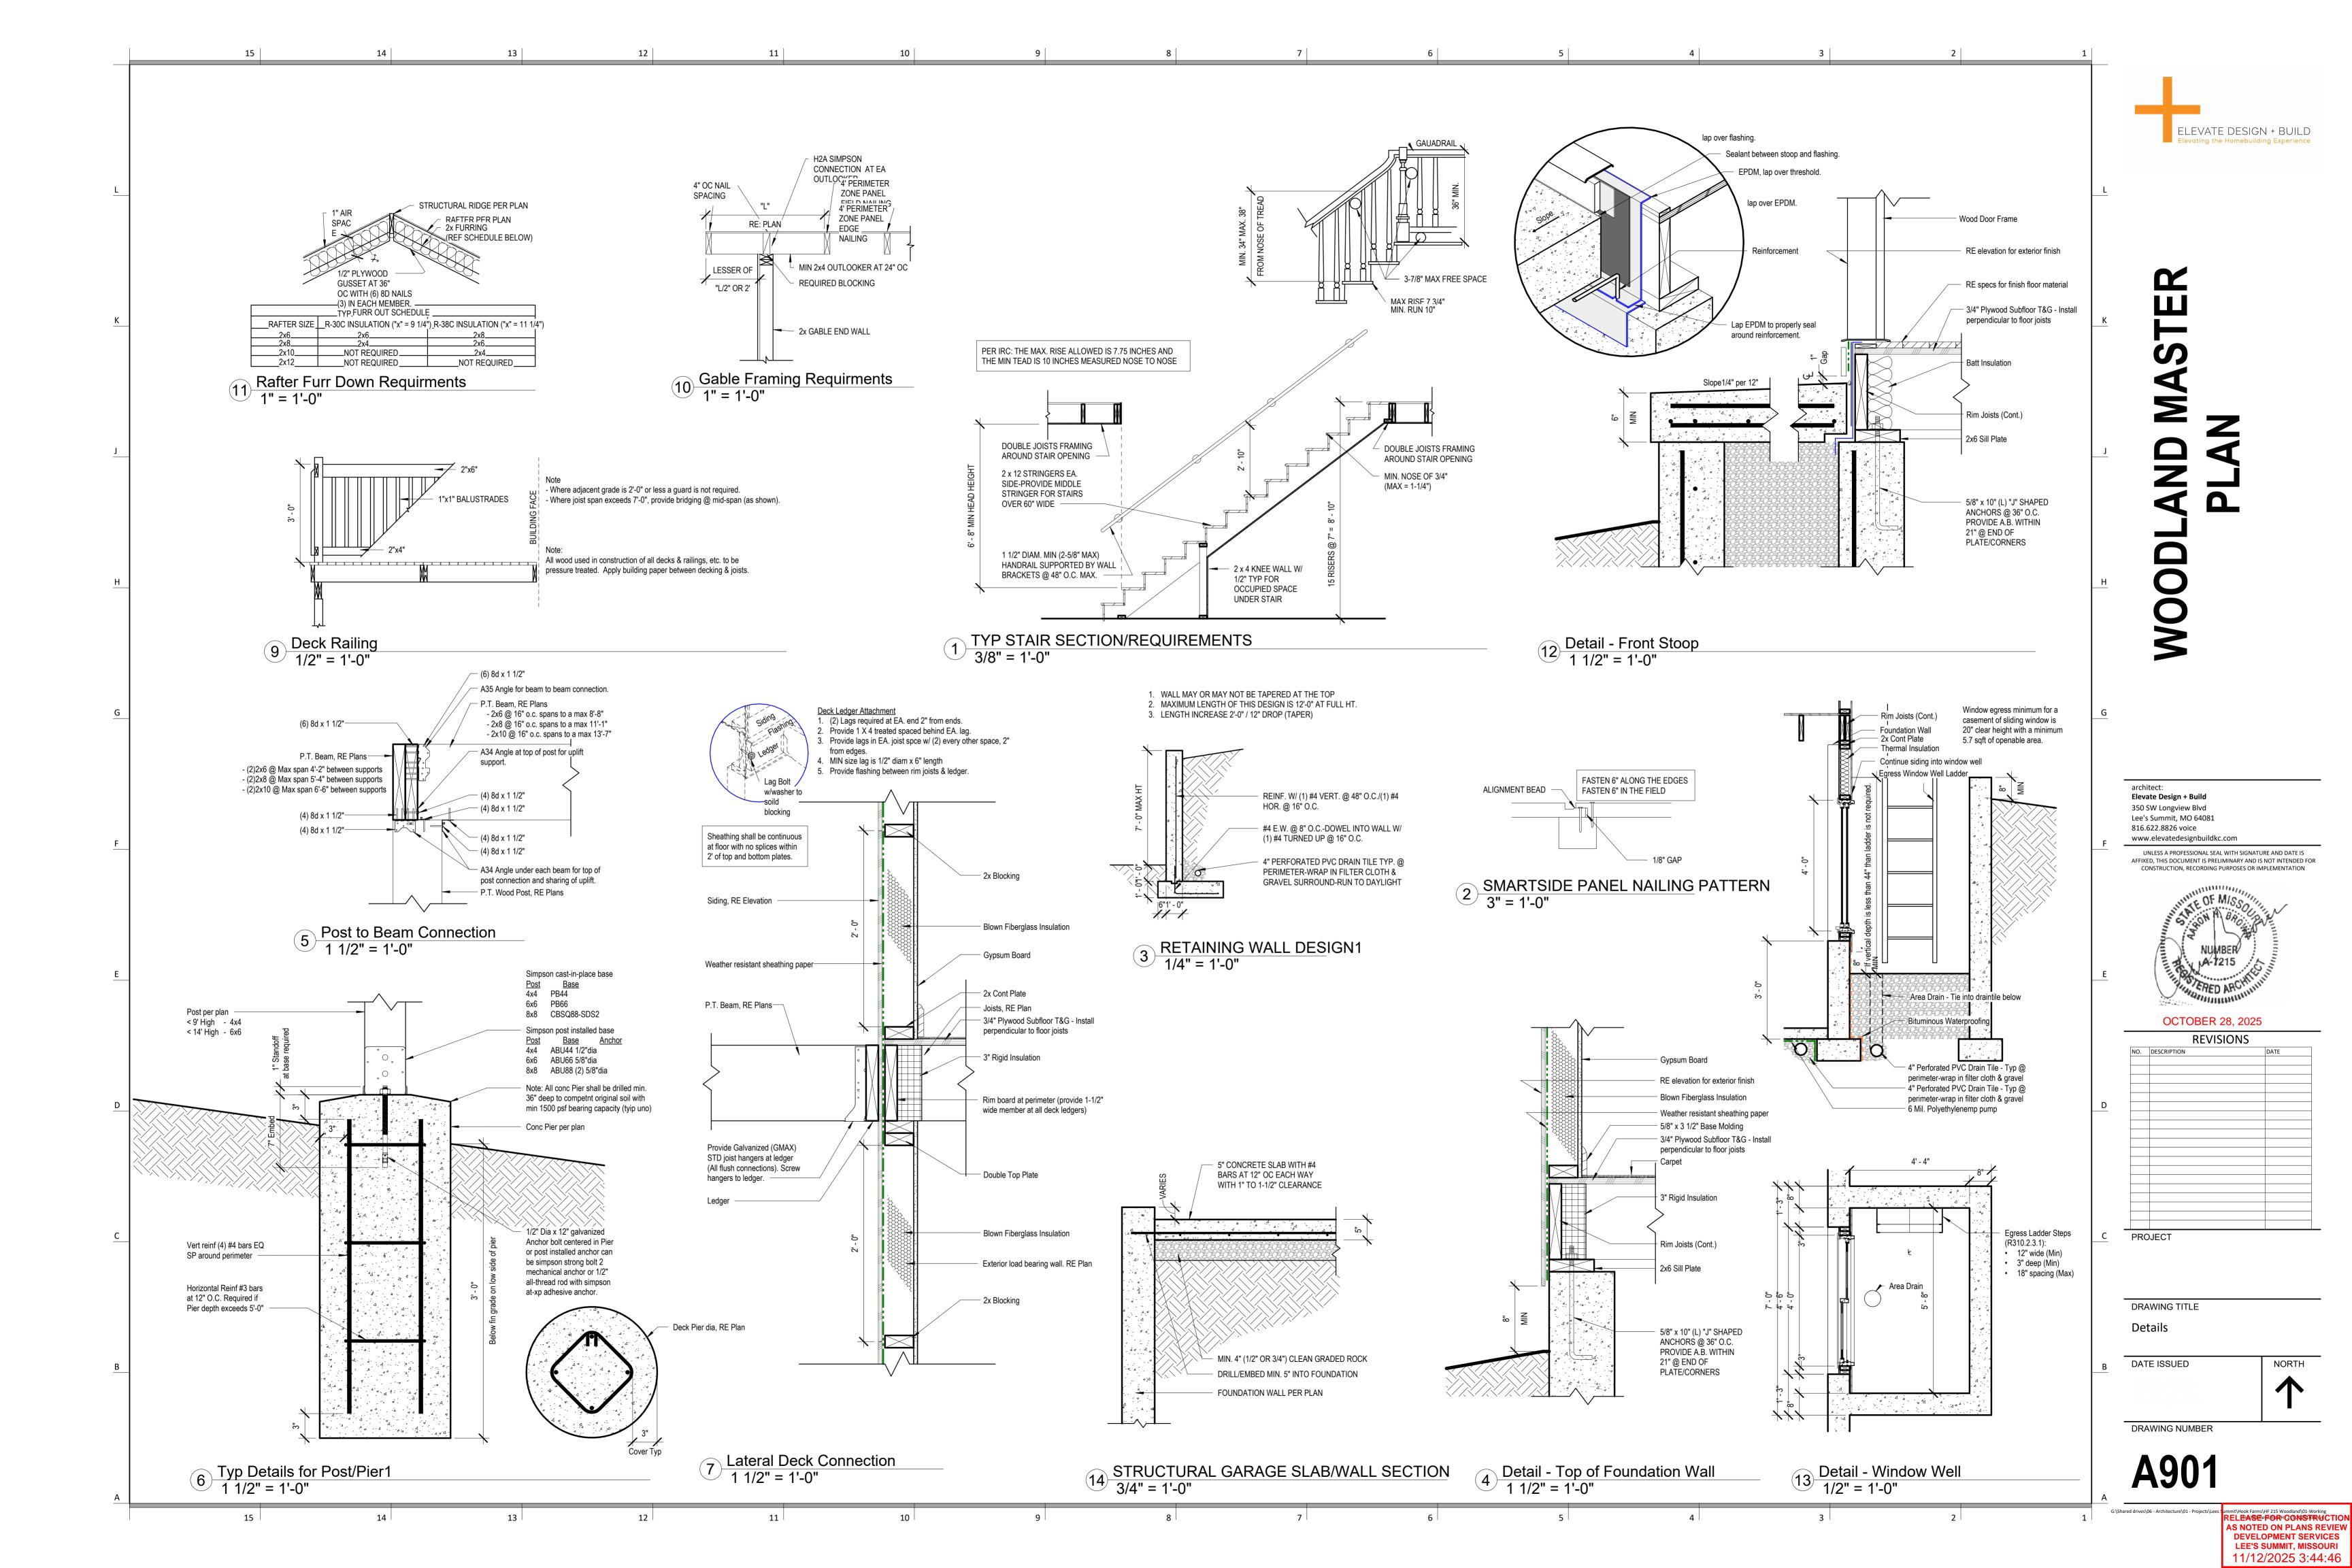


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RELEASE FORH CONSTRUCTION
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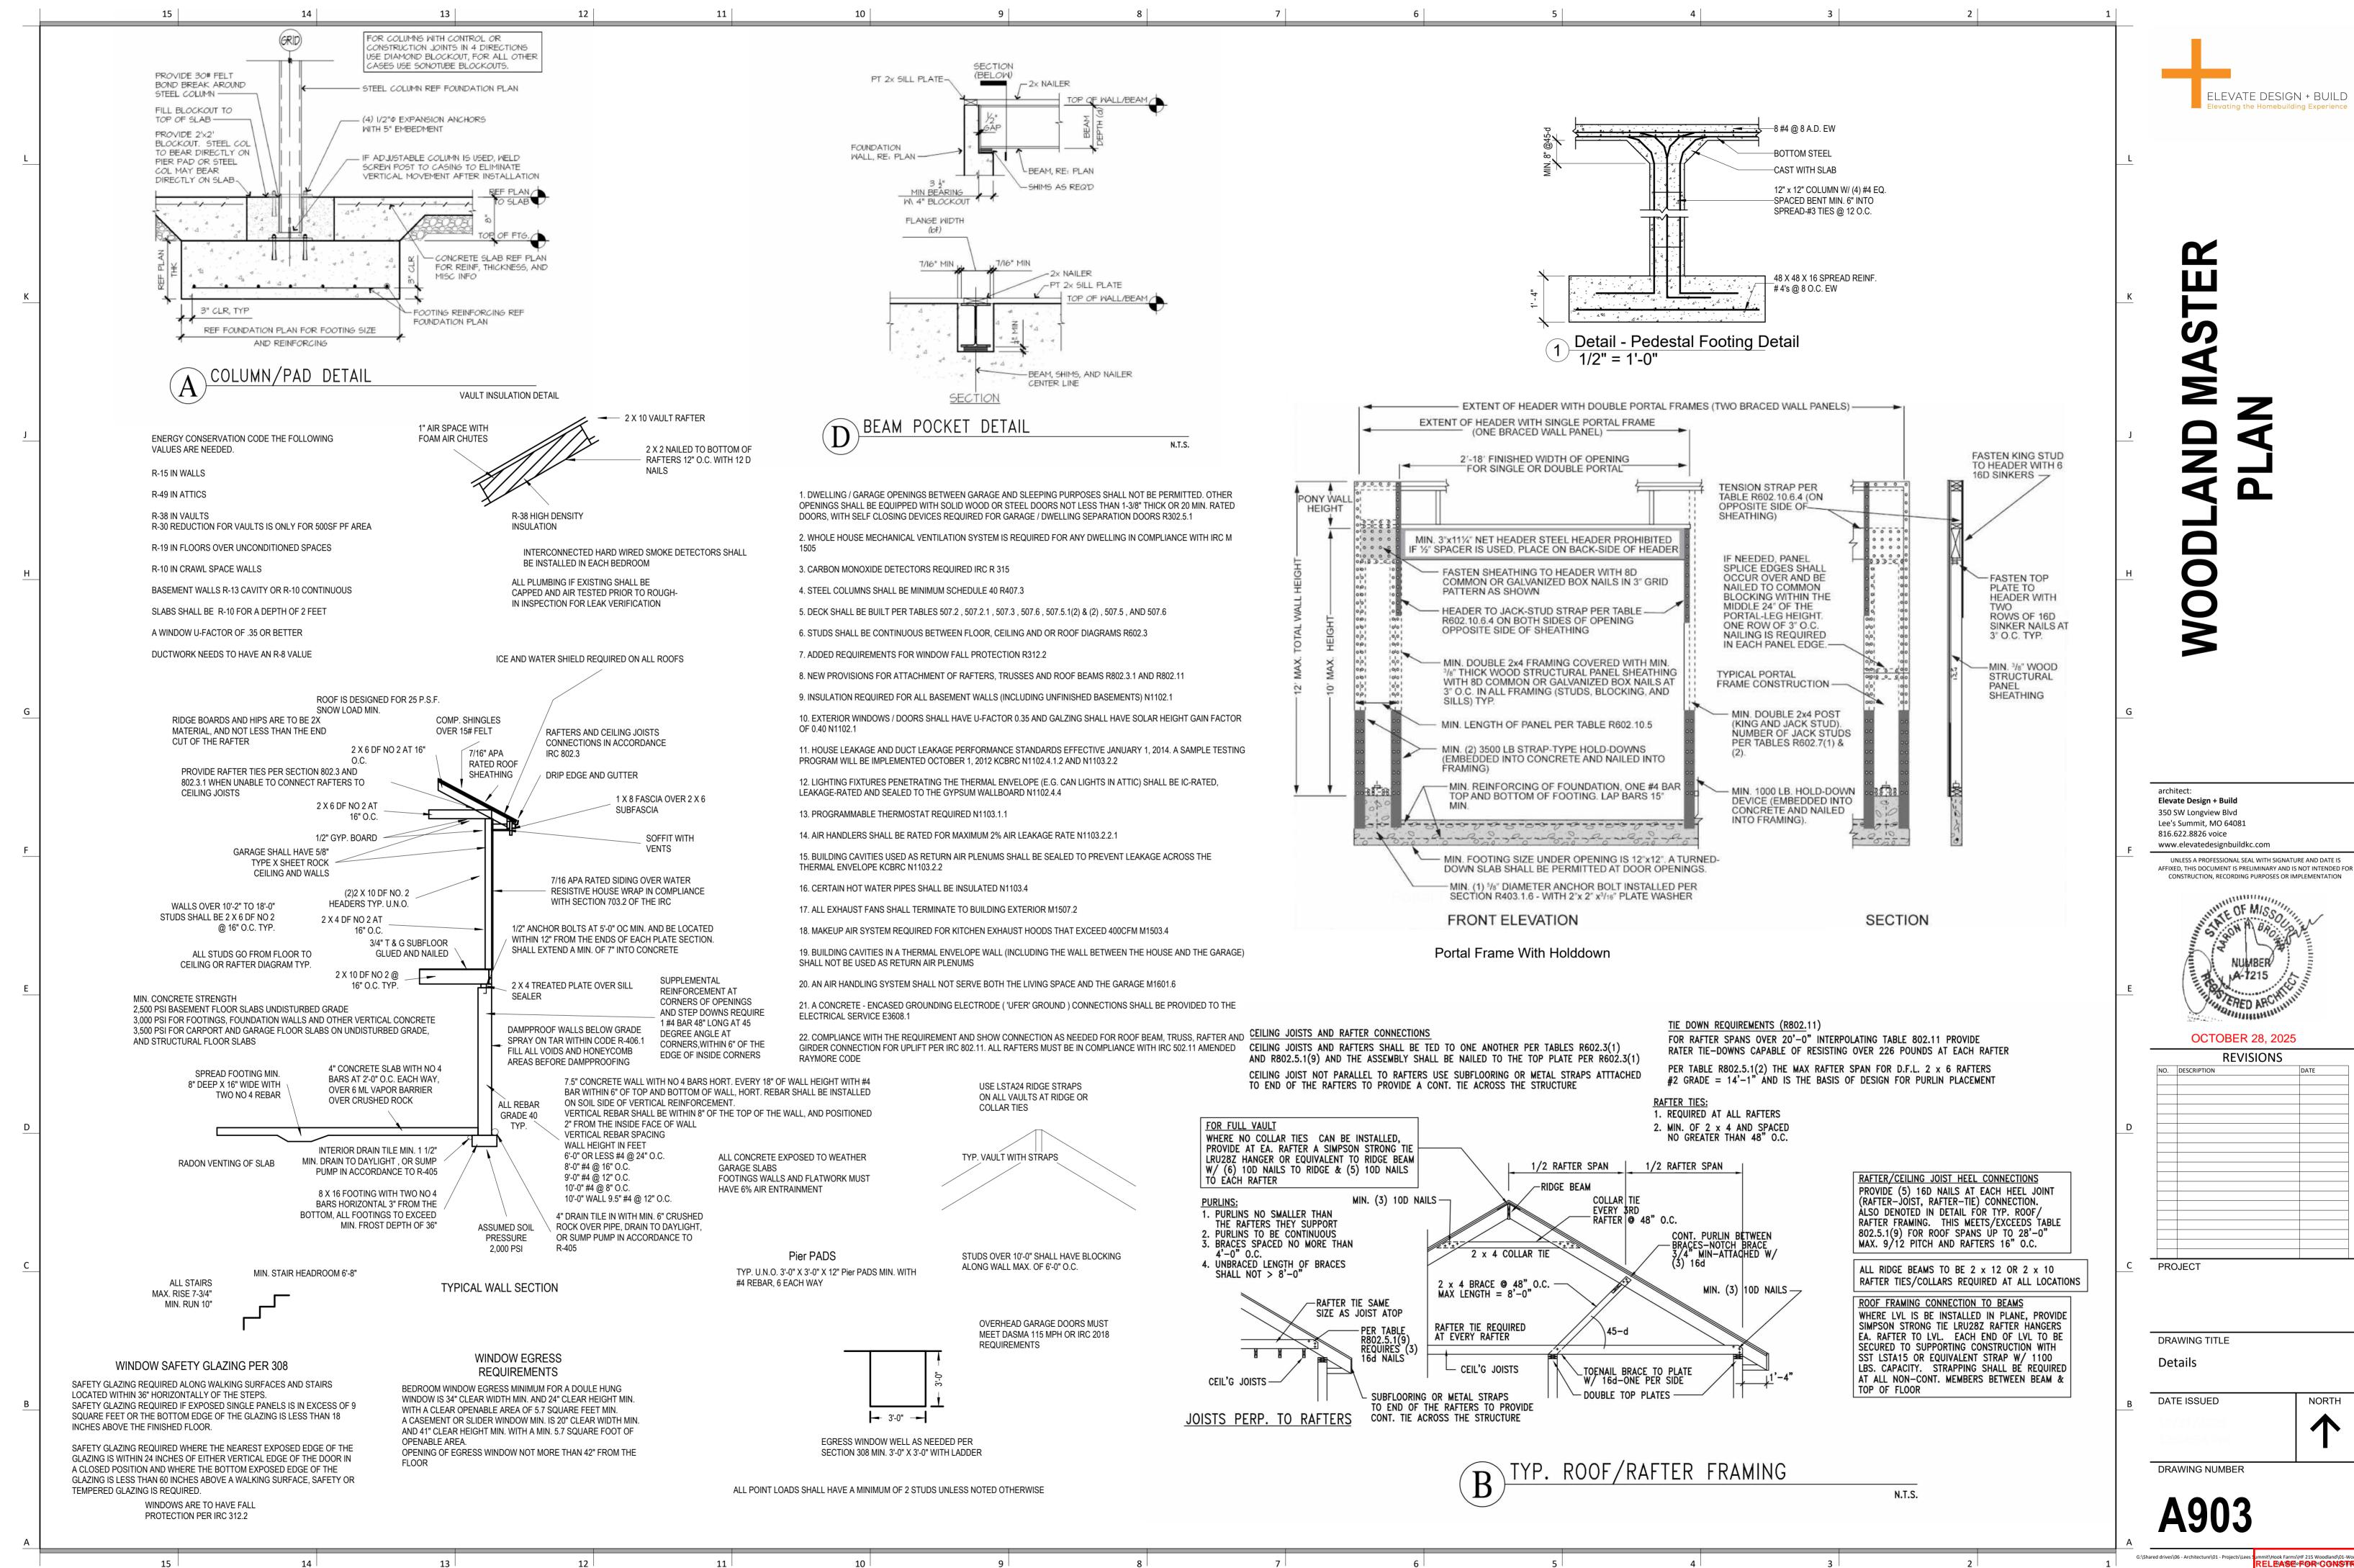


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