

Missouri Public Service Commission Manufactured Housing & Modular Units Program Application for Modular Unit Plan Approvals

Transmittal N	umber (PSC Office	325	91/192	Check Number	1839	Che	eck Amount	50.ce
INSTR	UCTIONS	411	Juvene		V - 1) (
Submit fees to y Manufact P.O. Box	the complet rour Third F ured Housing 360, Jefferso	ed application, Party to forward & Modular Units on City, MO 6510 I., Jefferson City,	d to: s Program 2 or	Plan Approval Fees (non-r model Make all checks and money ord Missouri Director of Revenu	ers payable to:	per Ho	ow to reach us: Phone: 800-81 Fax: 573-522 Web Page: <u>w</u>	-2509
				MANUFACTUR				
Registration	n Number:		Must u	se the actual facility name & a	Registration Expira		aucea.	MISSOURI
Manufactur		Valiant Mod	dular LLC		1			PUBLIC SERVIC
Contact Na	^{me:} Denn	is Amendoli	200 Co. 20 Co. 2		Email Address:	Dennis@vali	iantmodular.com	COMMISSION
Mailing Add	• • • • • • • • • • • • • • • • • • • •	. Tower Circ	1000		Physical Location:			
City/State/2	Zip: Ormo	ond Beach,	FL 32174					APPROVE
Phone Nur	nber: 386-	310-3495		==	Fax Number:			04/05/2024
	N	NOTE: A letter f	Tom the author	HIRD PARTY INSPECTION ized representative approving	ON AGENCY II models listed below	NFORMATION w must be attach	N ned to this Plan Approv	MANUFACTURE val Form. HOUSING
Third Party				nd Associates, inc.				
Contact Na	30	ott Francis			Email Address:	modular@hv	vceng.com	
Mailing Add	102	27 S. Myrtle	AND DESCRIPTION OF THE PARTY OF					λ.
City/State/A	· CIE	earwater, FL	33756		Fax Number:	200200 November 21200		3
Phone Nun	727	7-584-8151				727-586-334	43	()
				DEALER OR CONS Attach additional	sheets if necessa		MANUFA MA	y the
Dealer or C	onsumer Name	:			Dealer Registration	ı#:	"VEA	10
Physical Ac	Idress:				Dealer Email Addre		DESTY.	TED /
City/State/2	Zip:					Phone Number:	40	8
		NOTE: Plans ar	e approved for	MODEL IN Please list the mode r a period of one year and mus			ction of the model has	ceased.
New Model	Please indicate Model Revision	Model Renewal		Model Name		COMPLE	Model Destination- TE ADDRESS REQU Iress, City, State & Zip	Seismic Design Category
Х			Slide	ers Drive-Thru (2581-0	265)	S	St. Peters, MO	D
							'S SUMMIT, MO	
Code, the NFPA. Co	2015 Interna urrent models g to the Public	ational Mechanica approved prior t c Service Commis	o March 30, 20 ssion's Rules 40	e constructed to the criteria set for 15 International Residential Code, 118, are good until October 1, 201 CSR 240-123.010(I) governing m the State of Missouri. Questions	2015 International 8. odular units, modula	Fuel Gas Code, ar ar units must be co	nd the 2014 National El	ectric Code
		7			IATURE			
Authorized C	ompany Official	Prites	hoth				RE	CEMEN
Tile U	ville		WI)ala		TIL	
Plans	Examir	ner		(3/11/24			MAR 1 4 2024



ENGINEERING • INSPECTIONS CERTIFICATIONS • TESTING

Date: February 23, 2024

Missouri Public Service Commission Manufactured Housing Department

MISSOURI
PUBLIC SERVICE
COMMISSION

APPROVED

04/05/2024 MANUFACTURED HOUSING

We have reviewed and approved the following plans from:

Manufacturer: Valiant Modular, LLC

Job No: Sliders Drive-Thru (2581-0265)

These plans meet or exceed the requirements of:

(X) 2015 International Building Code

(X) 2015 International Mechanical Code

(X) 2015 International Plumbing Code

(X) 2014 National Electrical Code

On-Line inspection for compliance will be completed for units in accordance to the approved quality control manual.

Third Party Name:

Hilborn, Werner, Carter, and Associates, Inc.

Company Address:

1627 South Myrtle Avenue Clearwater, FL 33756

Phone:

727-584-8151

Signed:

Scott Francis

Plans Examiner



Missouri Public Service Commission Manufactured Housing & Modular Unit Program Plan Review Form

To be completed by the Third Party Agency.

Manufacturer Name Valiant Modular LLC		
Project Name Sliders Drive- Thru		
Job Number 2581-0265		
Number of Units 1		
Location of Project (Exact Location Required) St. Peters, MO L	_EE'S SUMMIT, MO	
This unit meets or exceeds the: • 2015 Internation	onal Building Code (IBC)	RECEL
	onal Residential Code (IRC)	MAR 1 4 26.4
2015 Internation	onal Mechanical Code onal Fuel Gas Code Electric Code (NFPA)	MO PUBLIC SERVICE COA MAIL ROOM
Seismic Design Category (Please specify)	Licente Gode (111 1 7 1)	
An on-line inspection for compliance will be comple	eted for the above units.	MISSOURI
Third Party Name Hilborn, Werner, Carter, and Ass	ociates	PUBLIC SERVICE COMMISSION
Address 1627 South Myrtle Avenue, Clearwat	ter, FL 33756	APPROVED
Phone 727-584-8151	Fax 727-586-3343	04/05/2024 MANUFACTURED
Contact Email Address: modular@hwceng.com		HOUSING
Representative Name: Scott Francis	Representative Title Plans Ex	aminer
Please send the comp	plete plan approval submission (al Checklist for Submission Guidelines)	to:
Mailing Address:	Street Address:	
Missouri Public Service Commission Manufactured Housing & Modular Unit Program P.O. Box 360 Jefferson City, MO 65102	Missouri Public Service Co Manufactured Housing & N 200 Madison Street, Suite Jefferson City, MO 65101	Modular Unit Program
Phone: 800-819-3180	Web Address: www.psc.n	no.gov

ENGINEERING - INSPECTIONS HVC TRANSMITTAL SHEET **CERTIFICATIONS - TESTIN**

TO: STATE OF MISSOURI

MOPSC

MANUFACTURED HOUSING AND MODULAR UNITS PROGRAM 200 MADISON STREET, SUITE 500

JEFFERSON CITY, MO 65101

DATE: 3/11/2024

TR NO: 59429

SHIP VIA: FEDEX GROUND

SHIP NO

SHIP ACCT:

ATTN: TIM HADEN

SUBJECT: VALIANT MODULAR

PLEASE FIND ENCLOSED THE FOLLOWING:

HWC NO.

QTY 1

ITEM

DESCRIPTION

2581-0265

\$150

VALIANT CK #18398 FOR

CHECK

2581-0265

8.5 X 11 COPIES

R/A:MO NEW MODEL SLIDERS DRIVE-THRU, BUSINESS

MISSOURI PUBLIC SERVICE COMMISSION **APPROVED**

04/05/2024

MANUFACTURED HOUSING

NOTE

18398

63-1403/631

DOLLARS

0

BCHECK ARMOR

2/27/2024

VALIANT MODULAR LLC 15 W TOWER CIR ORMOND BEACH, FL 32174-8762

PAY TO THE ORDER OF_

Missouri Director of Revenue

**150.00

Missouri Public Service Commission Manufactured Housing & Modular Units Prog

PO Box 360

Jefferson City, MO 65102

мемо

PLAN REVIEW

AUTHCRIZED SIGNATURE

#O18398# #O63114030#

204602000

VALIANT MODULAR LLC

Missouri Director of Revenue

Date 2/27/2024

Bill

Type Reference **PLAN REVIEW** Original Amt.

150.00

Balance Due 150.00 2/27/2024 Discount

Payment 150.00 150.00

18398

Check Amount

RECEIVED

MAR 1 4 2024

MO PUBLIC SERVICE COMMISSION MAIL ROOM

Center State - Checki PLAN REVIEW

150.00


MISSOURI PUBLIC SERVICE COMMISSION

APPROVED

04/05/2024

MANUFACTURED HOUSING

SLIDERS DRIVE-IN

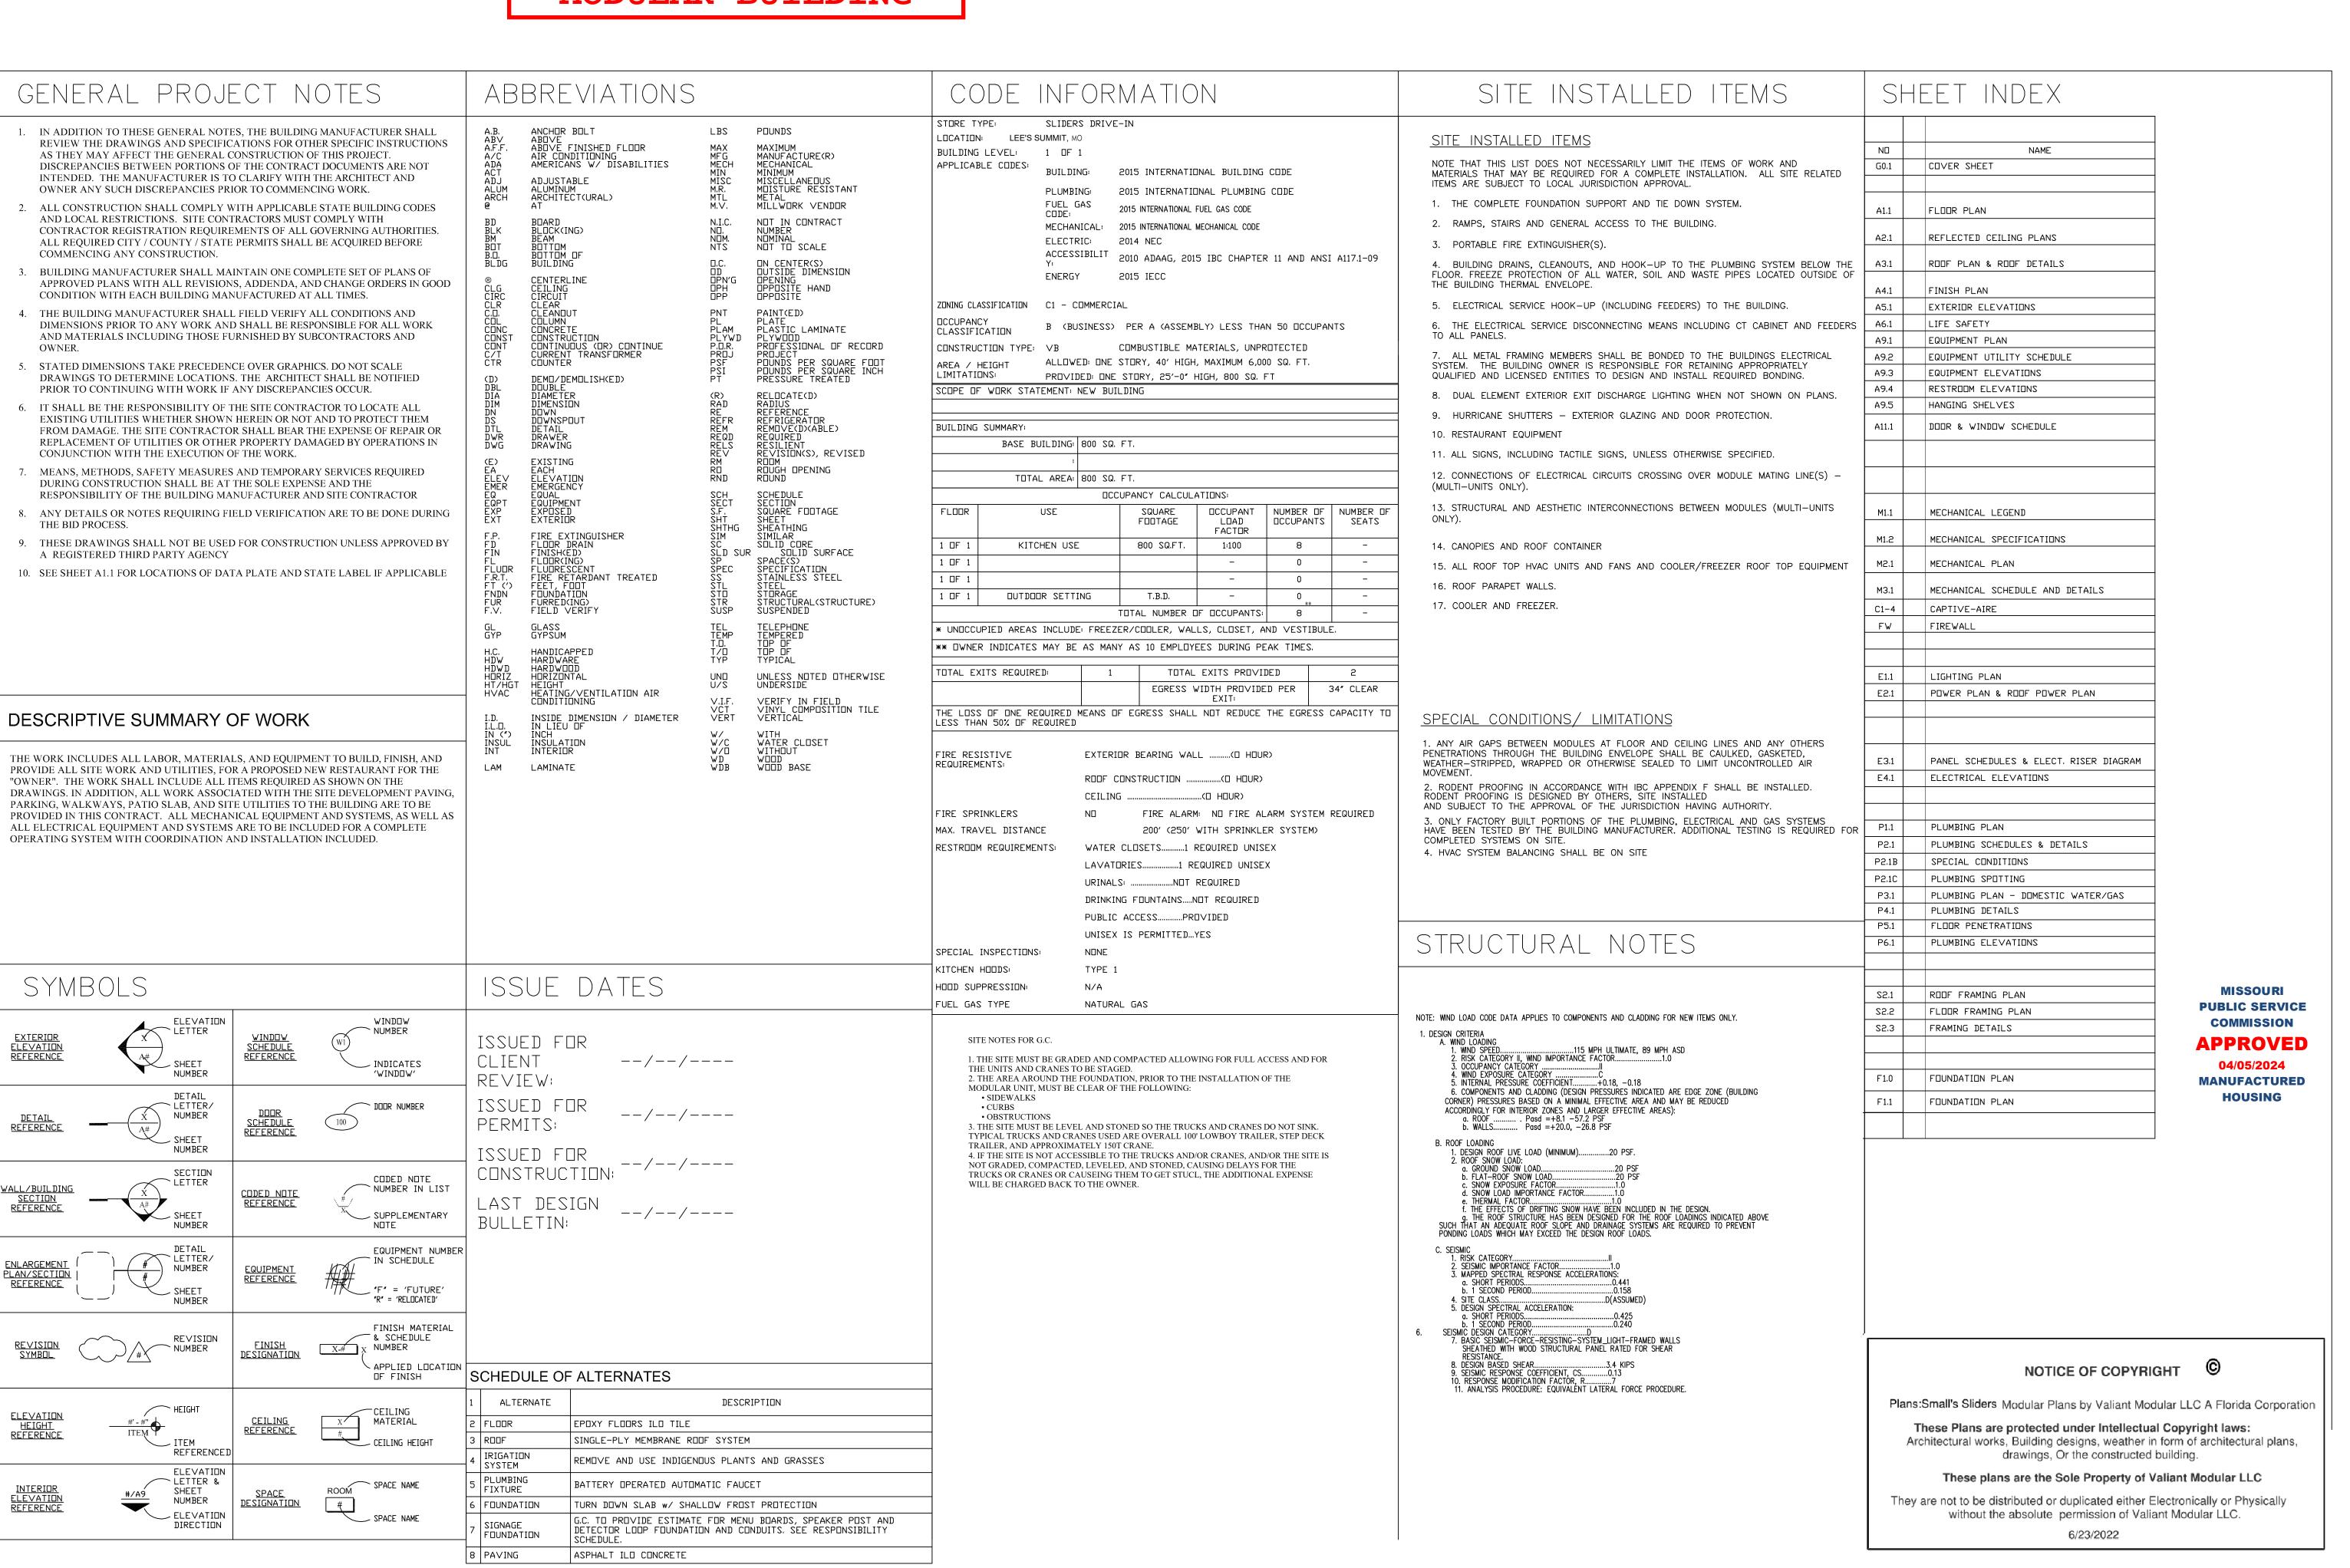


REVISION/ UPLOAD DATE

REV. DATE DESCRIPTION

LAST DESIGN BULLETIN

WALTER E. WOOD, P.E. MO PE # 2017022072 168 W. LONGLEAF DR.

NUM. DATE DESCRIPTION

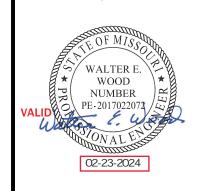

SYVESTER, GA 31791

MECODELAR VALIANT MODULAR, LLC

Third Party: HWC & Asc. Inc 1627 SouthMyrtle Ave. Clearwater, Fl. 34616 (717)-584-8151




SHEET NAME

COVER SHEET

SHEET NUMBER


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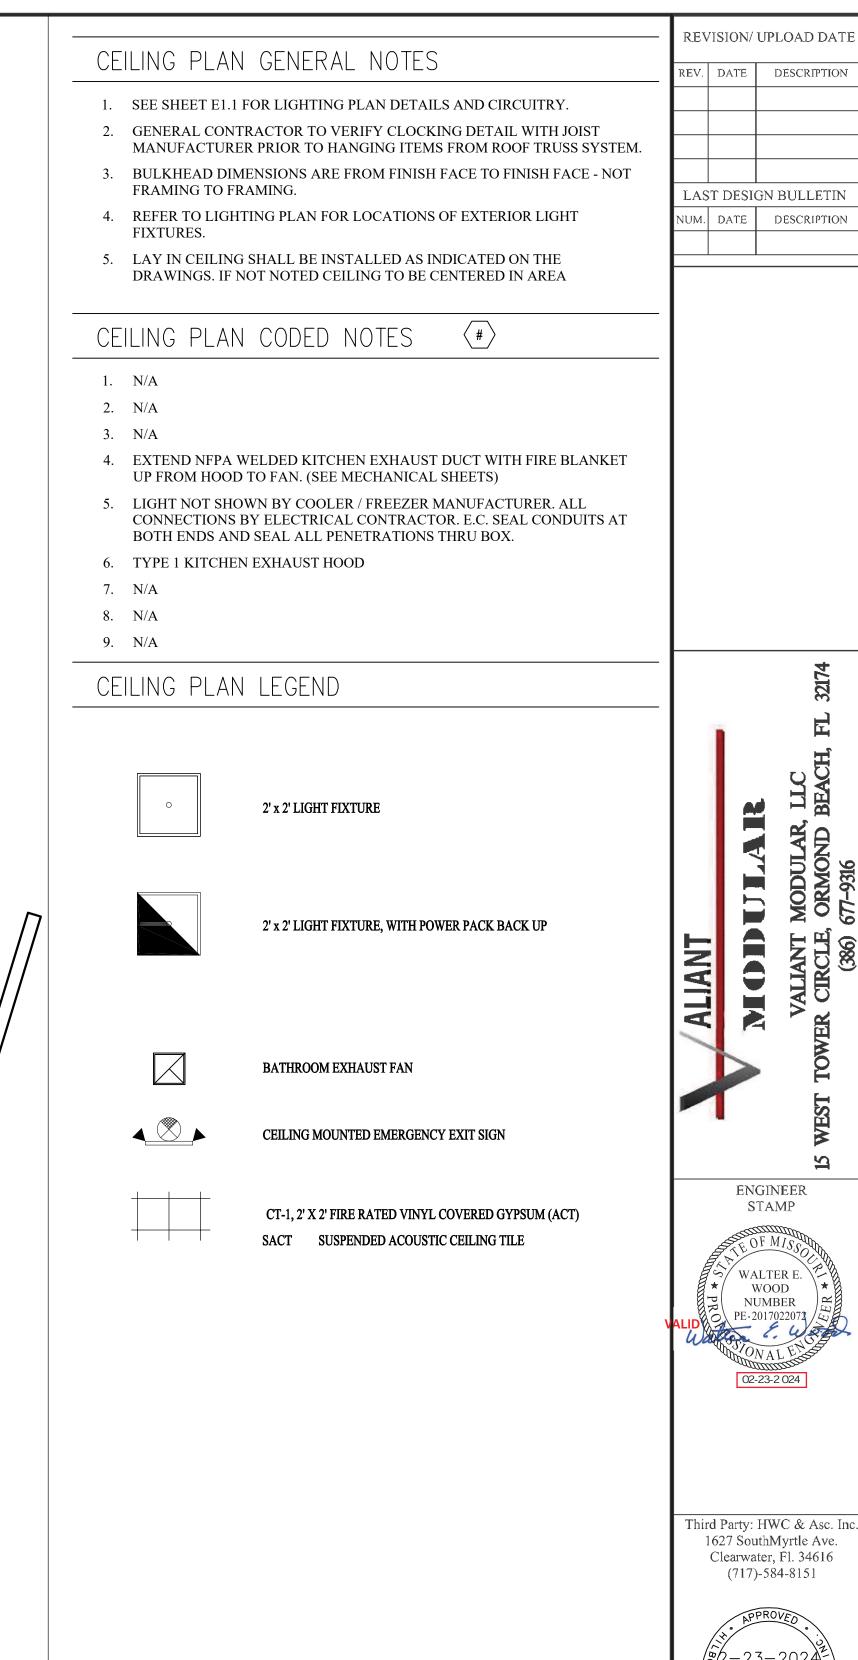
THIS IS A STATE

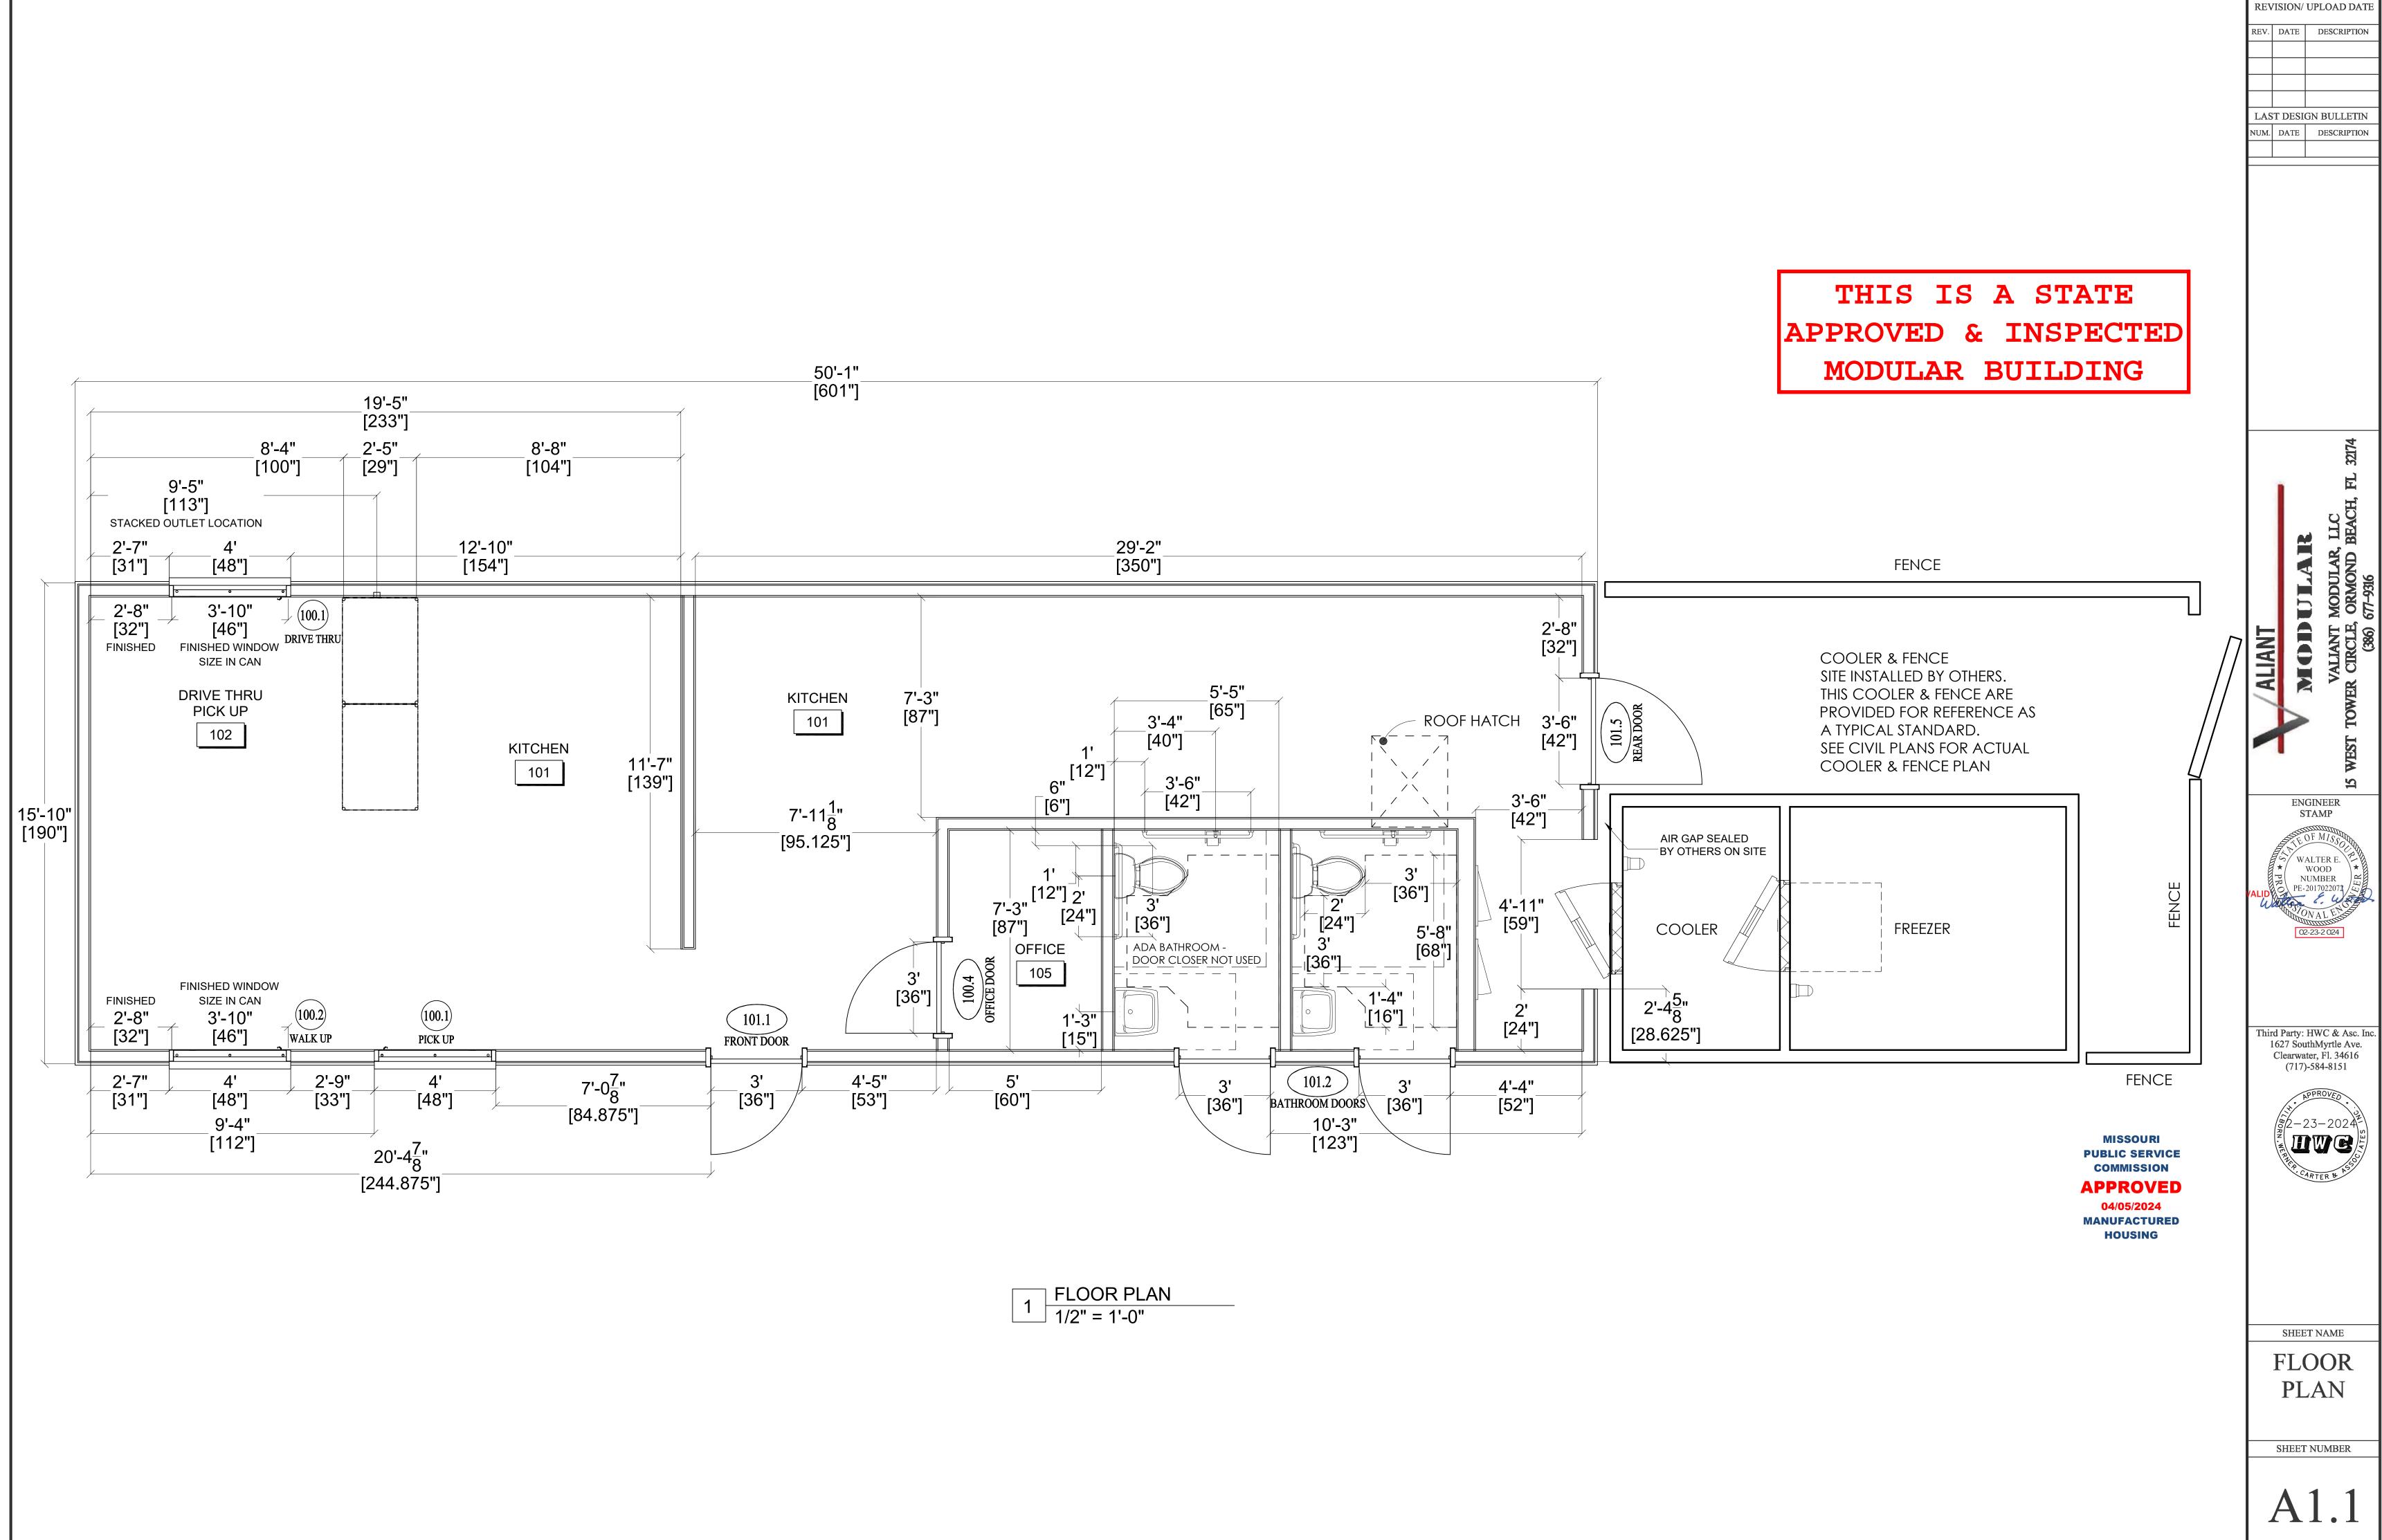APPROVED & INSPECTED

MODULAR BUILDING



1 REFLECTIVE CEILING PLAN

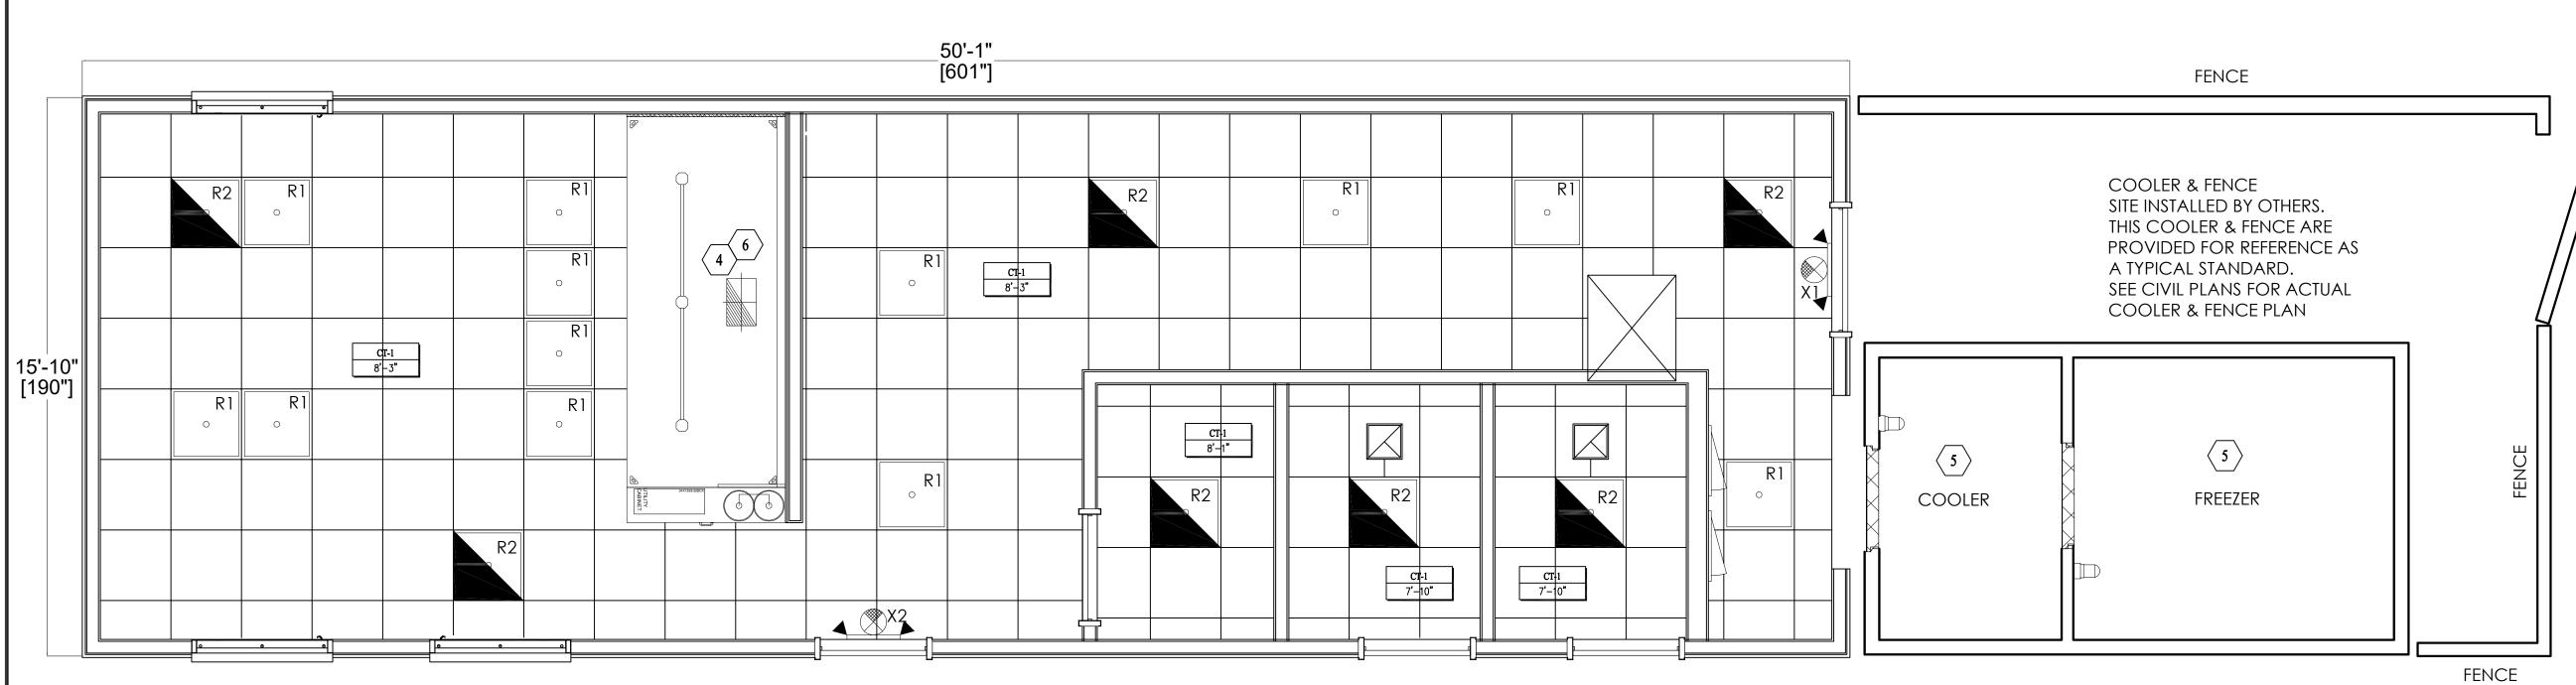

MISSOURI
PUBLIC SERVICE
COMMISSION
APPROVED
04/05/2024
MANUFACTURED

HOUSING


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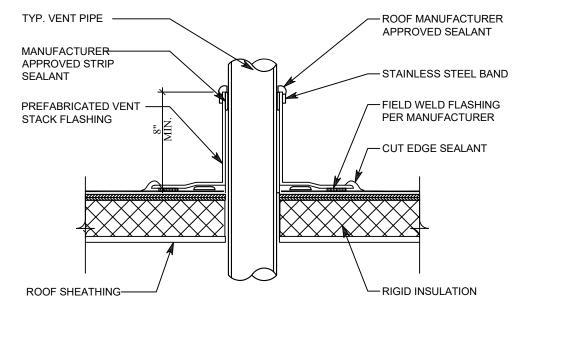
REFLECTIVE CEILING PLAN


uve

SHEET NUMBER

A2.1



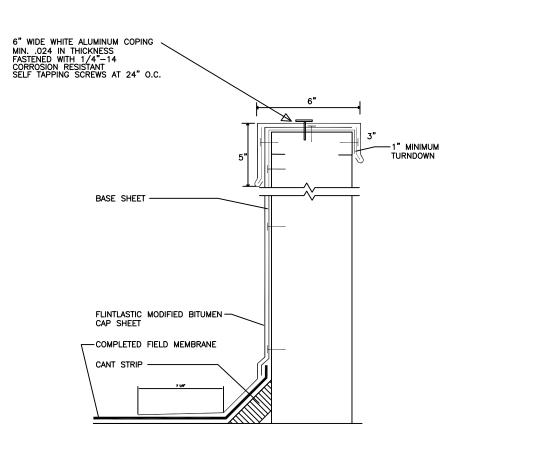

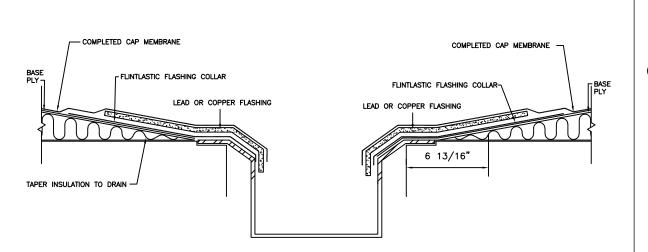



VENT PENETRATION DETAIL

ALLOWABLE

UPLIFT

CAPACITY

(PSF)

60

ROOF COVER

A 4-INCH LAP AND 12-INCH | FLINTLASTIC SA | SELF-ADHERED

MID PLY,

SELF-ADHERED

BASE

FLINTLASTIC SA NAILBASE

O.C. IN TWO, EQUALLY

SPACED, STAGGERED

CENTER ROWS

ATTACHED 12-INCH O.C. IN (OPTIONAL)





ROOF PLAN GENERAL NOTES

- A. THE BUILDING MANUFACTURER SHALL COORDINATE ALL WORK WITH RESPECTIVE TRADES, BUILDING / FIRE / HEALTH OFFICIALS, AND OWNER
 - THE BUILDING MANUFACTURER SHALL VERIFY EXISTING CONDITIONS, LOAD BEARING WALLS, AND STRUCTURAL ITEMS PRIOR TO STARTING WORK. NOTIFY AND COORDINATE WITH ARCHITECT ALL DISCREPANCIES BETWEEN EXISTING CONDITIONS AND CONSTRUCTION DOCUMENTS.
 - ROOF WORK TO BE INSTALLED WITH APPROVED ROOF MATERIAL SPECIFICATIONS. PROVIDE AND INSTALL ROOF INCLUDING BUT NOT LIMITED TO, INSULATION BOARD, EDGE FLASHING(S), COPINGS, SEALED TERMINATIONS AS REQUIRED BY THE MANUFACTURER'S INSTALLATION INSTRUCTIONS AND SPECIFICATIONS. AT PENETRATIONS/ ATTACHMENTS IN THE ROOF, FLASH/ PROVIDE WEATHER TIGHT SEAL PER ROOFING SYSTEM MANUFACTURER'S WARRANTY REQUIREMENTS. METHOD AND HARDWARE FOR ATTACHMENTS TO STRUCTURE TO BE REVIEWED AND VERIFIED BY A.O.R. UPON COMPLETION. THE ROOFING CONTRACTOR SHALL ENSURE THE ENTIRE ROOF SHALL BE WEATHER AND WATER TIGHT WITH POSITIVE DRAINAGE TO THE ROOF DRAINS AND NO STANDING WATER/ PONDING.
 - BUILDING MANUFACTURER SHALL INSTALL RIGID INSULATION TO MEMBRANE INSTALLATION IN ACCORDANCE WITH THE ROOFING MATERIAL LISTING. SYSTEM TO BE COMPLETE WITH ALL ACCEPTABLE PRODUCTS AND INSTALLATION REQUIRED TO PROVIDE A FULL MANUFACTURER'S WARRANTY.
 - ROOFING DESIGN: E.• CERTAINTEED - SELF-ADHERED ROOF SYSTEM

ROOF PLAN CODED NOTES

FREEZER/ COOLER AND ICE MAKER CONDENSER UNITS BY OWNER, G.C. TO CONNECT ELECTRICAL. PIPING CONTRACTOR TO BRAZE ANY ROOF PENETRATIONS FOR REMOTE EQUIPMENT. G.C. TO VERIFY AND BE RESPONSIBLE FOR ANY AND ALL MECHANICAL AND ELECTRICAL CONNECTIONS.


(#)

- EXTEND ROOF MEMBRANE UP ROOF EDGE AND OVER TOP OF FRAMING (TYPICAL). SECURE PREFABRICATED DRIP EDGE THROUGH MEMBRANE AS SPECIFIED BY MANUFACTURER. SEE DETAIL C.
- SELF-ADHERED ROOF SYSTEM. SEE SPECIFICATIONS.
- ROOF DRAIN TROUGH STAINLESS STEEL 4" X 8".
- 5. EXTERIOR LIGHTING FIXTURES. (REFER TO ELECTRICAL)
- 6. HVAC UNITS AND EXHAUST FANS. (REFER TO MECHANICAL)
- 7. METAL ROOF EDGE: DRIP EDGE.
- TAPER INSULATION OVER RIGID INSULATION AT ROOF DRAIN (TYPICAL). FIELD VERIFY ROOF DRAIN LOCATIONS PRIOR TO INSTALLATION, AND INSTALL PER ROOF MANUFACTURER'S SPECIFICATIONS. G.C. TO COORDINATE ACTUAL EXTENTS OF TAPERED INSULATION MATERIALS WITH ROOF INSTALLER AND VERIFY INSTALLED COUNTER-SLOPE OF 1/4" PER FOOT TO DIRECT STORM WATER TOWARD ROOF DRAINS AS INDICATED ON PLAN.
- 9. ROOF CRICKETS. (TYPICAL).
- 10. FREEZER/ COOLER BOX AND ROOF BY FRANCHISEE.
- 11. DASHED LINE INDICATES EXTENTS OF PARAPET BRACING, 1:1 SLOPE. (REFER TO STRUCTURAL)
- 12. ROOFTOP PARAPET. (REFER TO STRUCTURAL)
- 13. 3" DIA. MIN. ROOF DRAIN FROM ROOF DRAIN TROUGH.

MISSOURI PUBLIC SERVICE COMMISSION **APPROVED** 04/05/2024

MANUFACTURED HOUSING

THIS IS A STATE APPROVED & INSPECTED MODULAR BUILDING

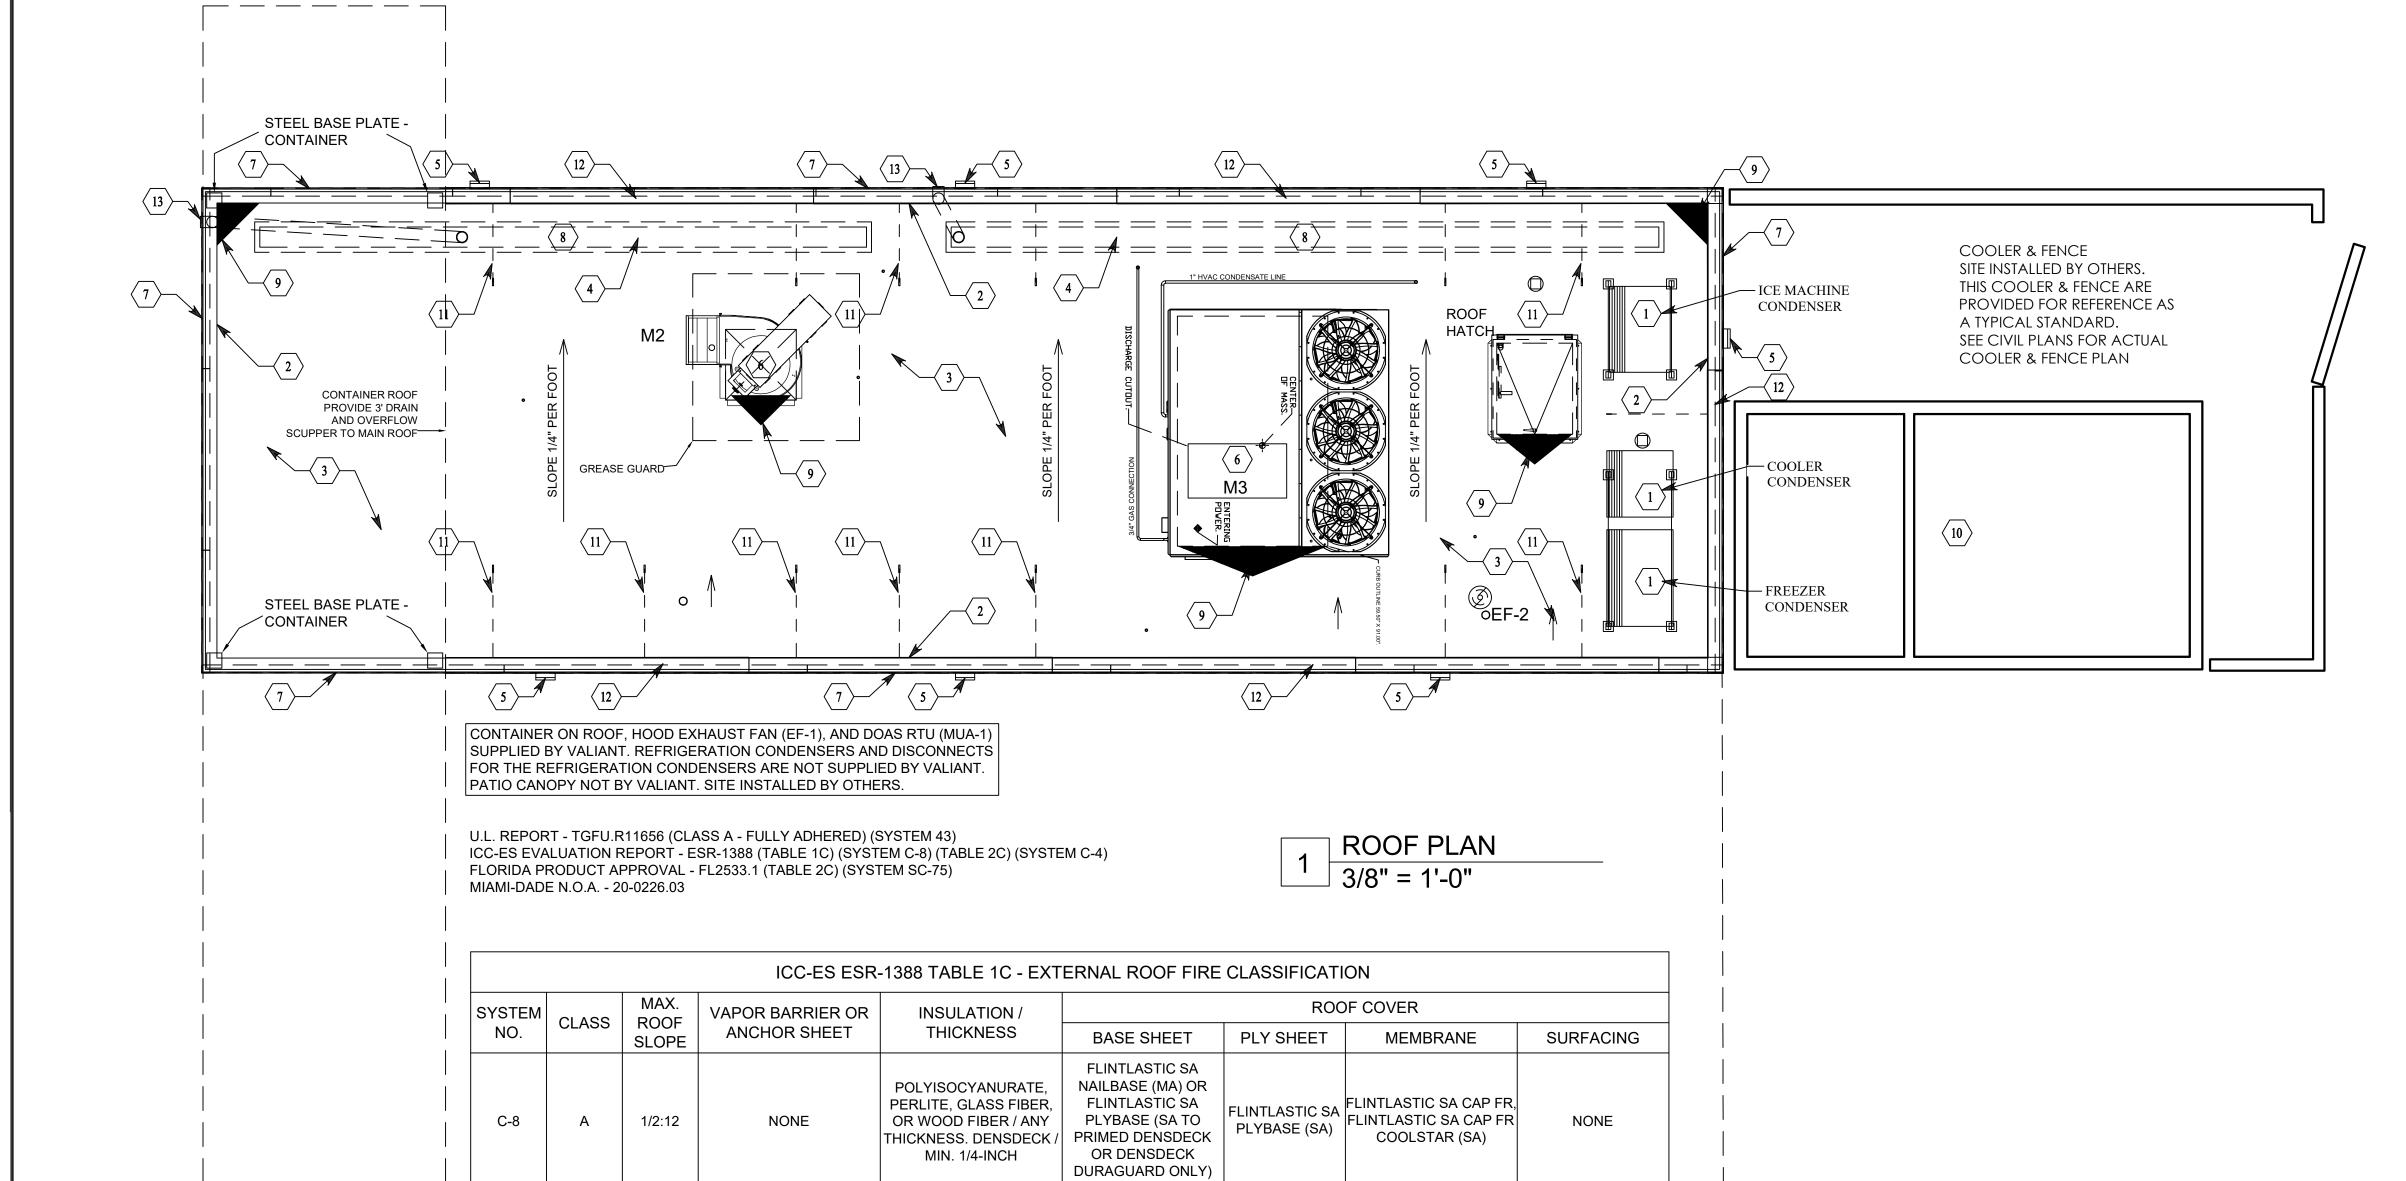

ICC-ES ESR-1388 TABLE 2C - WIND UPLIFT RESISTANCE

ATTACHMENT

METHOD

LOOSE LAID

COVERBOARD

TYPE

(OPTIONAL) FM

APPROVED MIN.

1/2-INCH WOOD

FIBERBOARD, OR MIN.

1/4-INCH DENSDECK

LOOSE LAID 3/4-INCH PERLITE, MIN.

INSULATION

MIN. 1.5-INCH,

MIN. 2.0 PCF

POLYISOCYANURATE

ATTACH

|SYSTEM|SUBSTRATE

MIN. 22 GA.

STEEL OR MIN.

CONCRETE

2,500 PSI

MODE ALIANT ENGINEER 〜 WALTER E. WOOD NUMBER

REVISION/ UPLOAD DATE

EV. DATE DESCRIPTION

LAST DESIGN BULLETIN

DESCRIPTION

UM. DATE

Third Party: HWC & Asc. In 1627 SouthMyrtle Ave. Clearwater, Fl. 34616 (717)-584-8151



SHEET NAME

ROOF PLAN DETAIL

RO	OM FINI	SH	SC	CHEC)UL	Ε				
ROOM	FLOORS	WALLS BASE			CEI	LING	S/SOFFIT			
NAME	FT-1	WF-1	WF-2	WB-1	CT-1	PT-1	HEIGHT			
KITCHEN	•	•	•	•	•		8'-3"			
DRIVE THRU	•	•		•	•		8'-3"			
UNISEX RESTROOM	•	•		•	•		7'-10"			
UTILITY/OFFICE	•	•		•	•		8'-1"			

CT-1 C CLASS A: = FLAME SPREAD INDEX 0-25; SMOKE-DEVELOPED INDEX 0-450.

WF-1 W CLASS C: = FLAME SPREAD INDEX 76-200; SMOKE-DEVELOPED INDEX 0-450.

WB-1 B FIRE TEST NFPA TYPE 1 RATED

FT-1 F FIRE TEST NFPA TYPE 1 RATED


INTERIOR WALL AND CEILING FINISH MATERIAL; FLAME SPREAD AND SMOKE-DEVELOPED INDEXES

INDEX 0-450.

CLASS A: = FLAME SPREAD INDEX 0-25; SMOKE-DEVELOPED INDEX 0-450. CLASS B: = FLAME SPREAD INDEX 26-75; SMOKE-DEVELOPED INDEX 0-450. CLASS C: = FLAME SPREAD INDEX 76-200; SMOKE-DEVELOPED INTERIOR FLOOR FINISH AND FLOOR COVERING MATERIAL; -MINIMUM CRITICAL RADIANT FLUX

> NOT LESS THAN CLASS II IN ACCORDANCE WITH NFPA 253 CLASS II, 0.22 WATTS/CM² OR GREATER

> > THIS IS A STATE APPROVED & INSPECTED MODULAR BUILDING

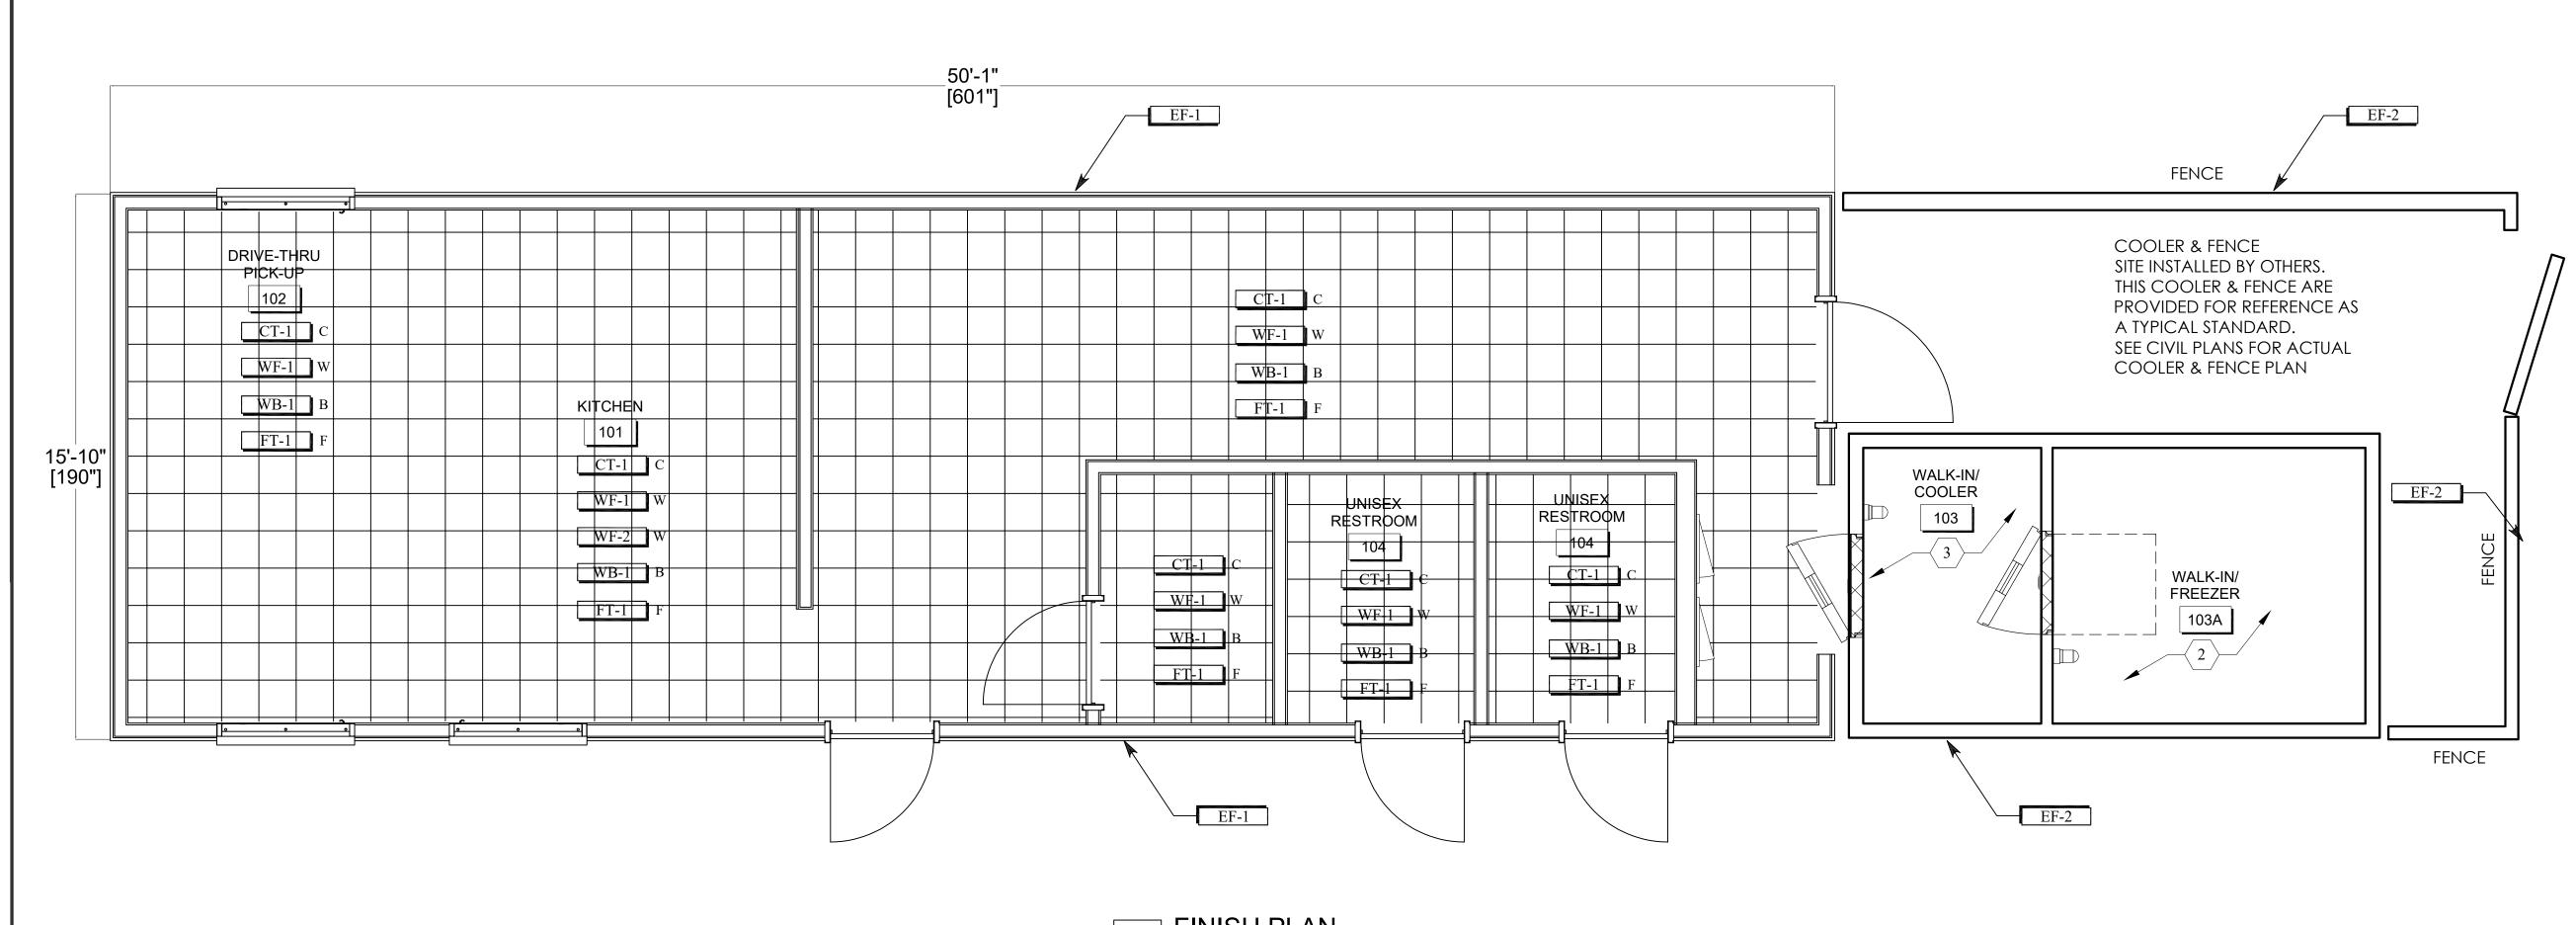

1 FINISH PLAN 3/8" = 1'-0"

FINISH PLAN CODED NOTES (#)

2. FREEZER TO HAVE INSULATED METAL FLOOR BY UNIT MANUFACTURER.

3. COOLER TO RECEIVE TILE FLOOR & BASE BY G.C. AFTER THE UNIT HAS BEEN INSTALLED.

4. NOT USED

5. NOT USED 6. NOT USED

FINISH SCHEDULE: INTERIOR MATERIALS

	NISH SCR	HEDULE: INTERIOR MATERIALS
CT-1	CEILING TILE	USG SHEETROCK: GYPSUM CEILING PANELS - VINYL COATED 24" X 24" SQUARE EDGE LAY IN - WHITE
EF-1	EXTERIOR FINISH	SEE EXTERIOR FINISH SCHEDULE ON ELEVATION SHEET A5.1
EF-2	EXTERIOR FENCE FINISH	MATCH EF-1
FT-1	FLOOR FINISH	PROTECT-ALL: FLOORING - DARK GRAY
PT-1	PAINT	SHERWIN WILLIAMS COLLECTION: HARMONY #SW7006 EXTRA WHITE, EGGSHELL
WB-1	WALL BASE	PROTECT-ALL: COVE BASE - DARK GRAY
WF-1	WALL FINISH	FRP: LP-S9 - SMOOTH FINISH, WHITE
WF-2	WALL FINISH	14GA. STAINLESS STEEL, FULL HEIGHT OF WALL TO

MISSOURI PUBLIC SERVICE COMMISSION **APPROVED**

MIN. 18" BEYOND HOOD

04/05/2024 **MANUFACTURED** HOUSING

SHEET NAME

FINISH PLAN

SHEET NUMBER

ENGINEER STAMP WALTER E. WALTER E.
WOOD
NUMBER
PE-2017022071

Third Party: HWC & Asc. Inc. 1627 SouthMyrtle Ave.

Clearwater, Fl. 34616 (717)-584-8151

<u>\$</u>2-23-2024

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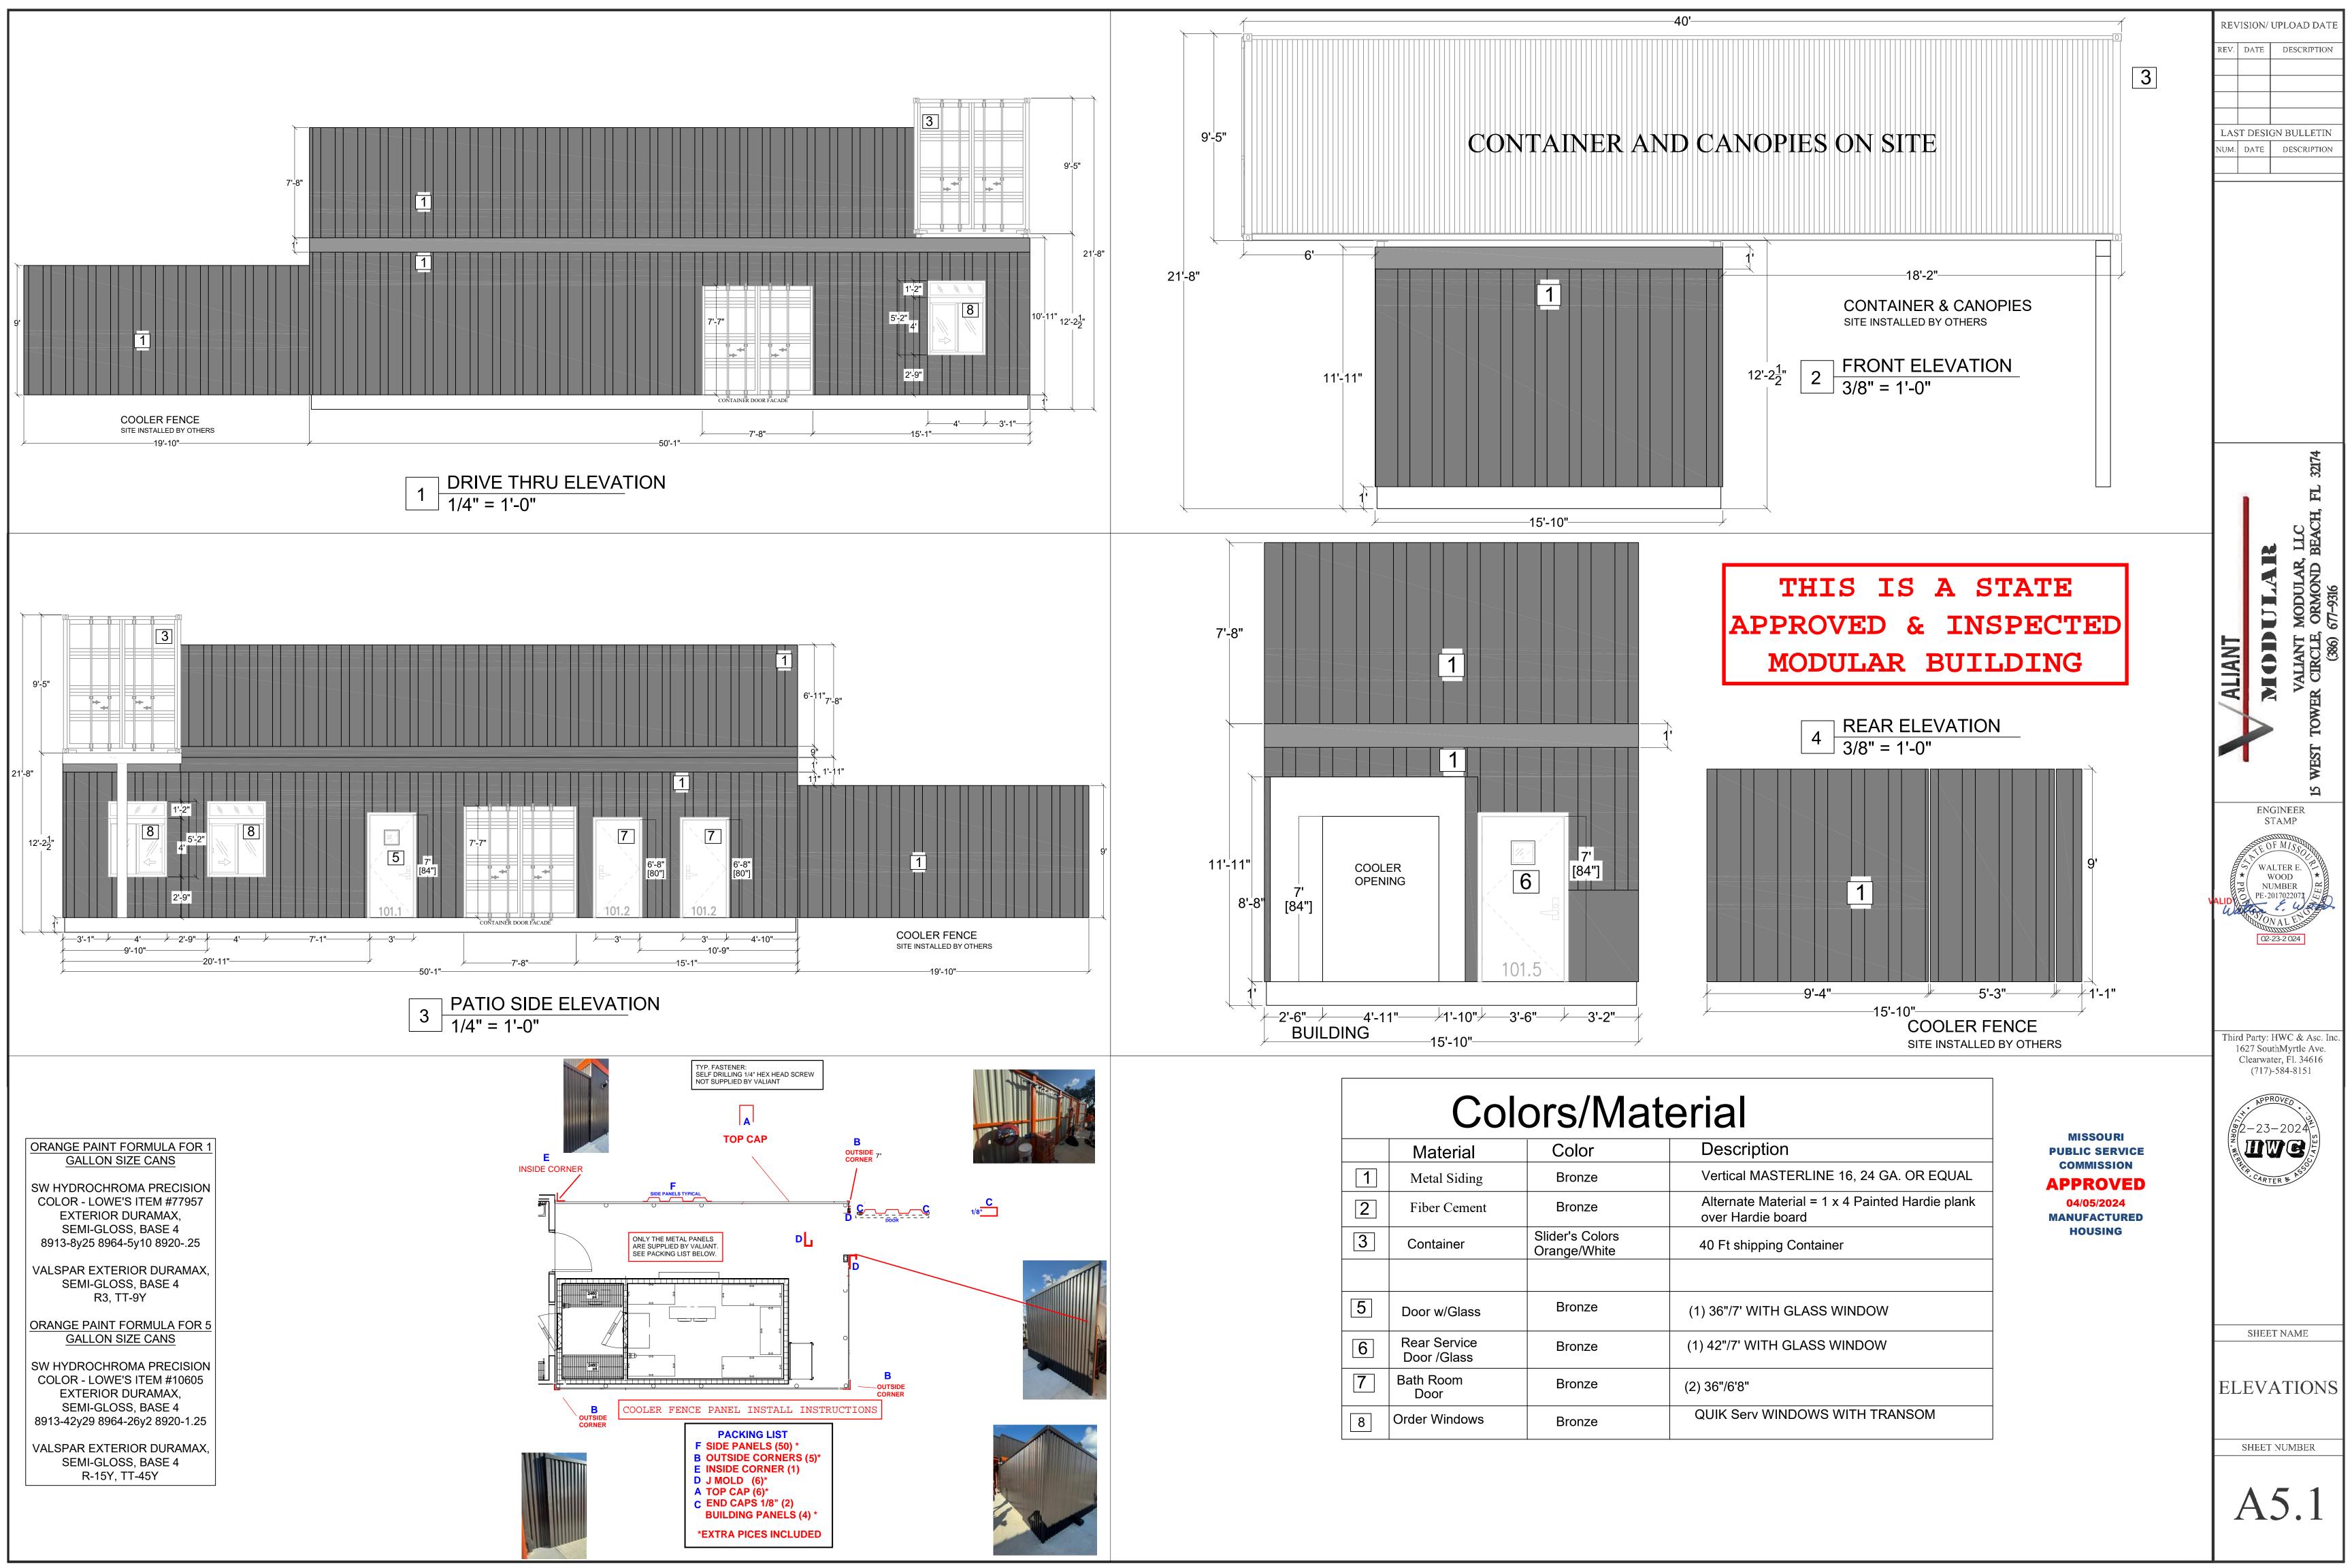
CARTER & ASS


REVISION/ UPLOAD DATE

REV. DATE DESCRIPTION

LAST DESIGN BULLETIN

NUM. DATE DESCRIPTION



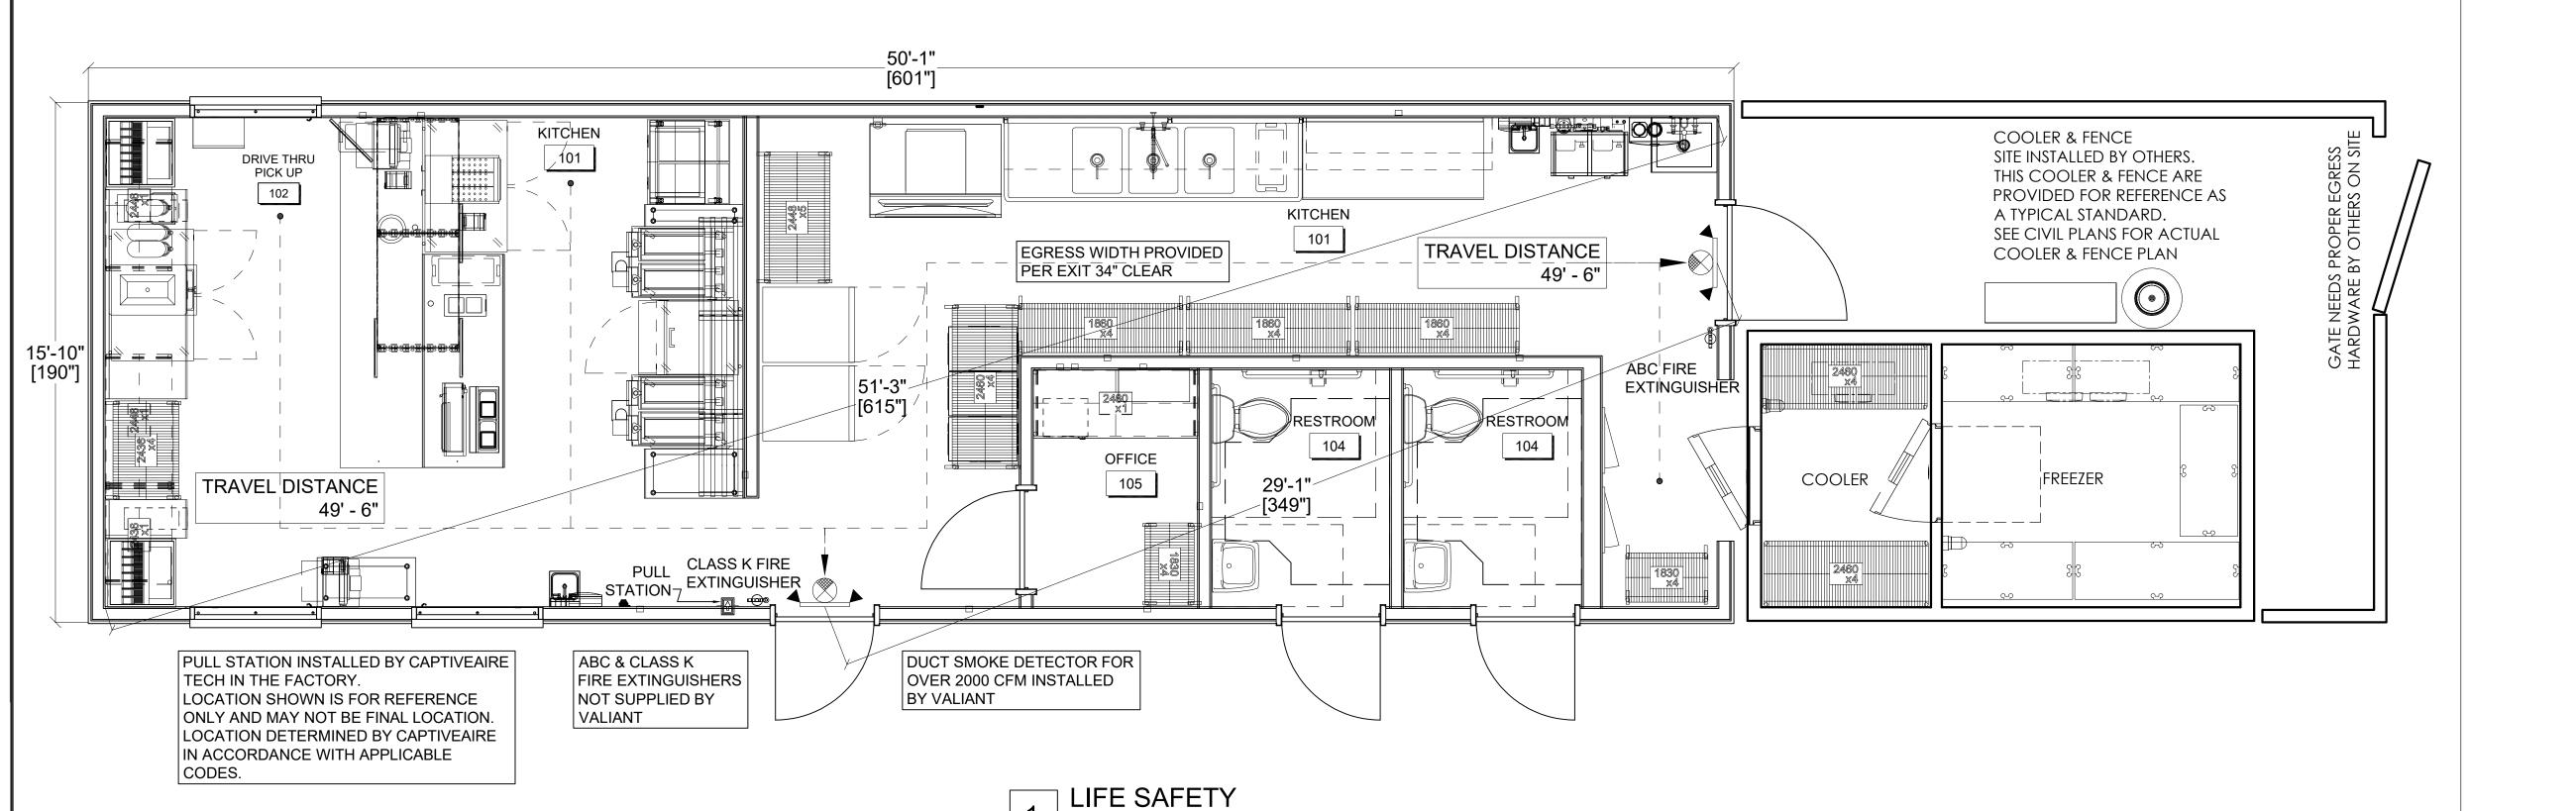

3/8" = 1'-0"

GENERAL NOTES

- 1. ALL INTERIOR NON-STRUCTURAL PARTITIONS SHALL BE 3 ½" 20G METAL STUDS @ 16" O.C. FROM FLOOR TO 6" ABOVE FINISHED CEILING, U.N.O. DIAGONALLY BRACE TOP OF WALL TO ROOF STRUCTURE AS REQUIRED TO SUPPORT ADDITIONAL LOADS.
- 2. INTERIOR SOFFITS (SHOWN DASHED) ARE DIMENSIONED ON REFLECTED
- SEE SITE PLAN FOR LOCATIONS & EXTENTS OF SIDEWALKS, ETC.
 ALL EXTERIOR WALLS SHALL BE FRAMED WITH 3 5'8" or (6"as noted on
- plan) METAL STUDS @ 16" O.C. SEE STRUCTURAL DRAWINGS & SPECIFICATIONS FOR LAYOUT DIMENSIONS, DETAILS, MATERIALS INFORMATION, & SPECIFIC STRUCTURAL DESIGN REQUIREMENTS.
- 5. PROVIDE SOLID WOOD BLOCKING BEHIND ALL WALL MOUNTED FIXTURES AND ACCESSORIES.
- 6. EXTERIOR DIMENSIONS ARE FROM FACE OF SHEATHING U.N.O INTERIOR DIMENSIONS ARE TO FACE OF SHEATHING U.N.O
- INTERIOR DIMENSIONS ARE TO FACE OF SHEATHING U.N.O
 COORDINATE CURB CUTS AT DOOR WITH STOREFRONT MANUFACTURER PRODUCT DETAILS AND SHOP DRAWINGS.
- 8. EXTERIOR WALLS SHALL BE INSULATED WITH CLOSED CELL SPRAY FOAM INSULATION AND HAVE A $\frac{19}{32}$ " PLYWOOD THERMAL BARRIER ON INTERIOR SIDE OF WALL
- 9. EXTERIOR FINISHES ARE NOTED ON EXTERIOR ELEVATIONS.
- 10. SEE FINISH PLAN AND INTERIOR ELEVATIONS FOR EXTENT OR INTERIOR FINISHES.
- 11. INSTALL TYVEK COMMERCIAL WRAP WEATHER BARRIER OVER SHEATHING BEHIND METAL PANELS. PROVIDE FLUID-APPLIED WEATHER BARRIER TO SHEATHING AT E.I.F.S LOCATIONS. PROVIDE TILE MANUFACTURER APPROVED WEATHER BARRIER BEHIND NEW CERAMIC TILE. APPROVE ALTERNATES INSTALL STO FLUID APPLIED AIR & MOISTURE BARRIER BEHIND ALL EXTERIOR FINISHES.
- 12. HOLD DOWN CLIPS SHALL BE PROVIDED FOR CEILING TILES IN THE VESTIBULES.
- 13. SEE INTERIOR FINISH SPECIFICATIONS FOR CEILING TILE.
- 14. DO NOT SCREW THE CEILING GRID TO THE STAINLESS STEAL HOODS. USE DOUBLE-FACED TAPE.
- 15. REFER TO ELECTRICAL AND/OR HVAC DRAWINGS FOR ADDITIONAL INFORMATION. REGARDING FIXTURES, DEVICES. AND EQUIPMENT SHOWN ON THIS PLAN.
- 16. TYPICAL RECESSED FIXTURES TO BE CENTERED IN CEILING TILE, U.N.O17. CENTER CEILING GRID WITHIN ROOM ARE UNLESS NOTED/ DIMENSIONED OTHERWISE.
- 18. VOIDED
- SEE FINAL APPROVED SECURITY PLAN FOR LOCATIONS OF CEILING MOUNTED CAMERAS AND MONITORS.

MISSOURI
PUBLIC SERVICE
COMMISSION
APPROVED
04/05/2024
MANUFACTURED

HOUSING

THIS IS A STATE
APPROVED & INSPECTED
MODULAR BUILDING


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NUM. DATE DESCRIPTION

REVISION/ UPLOAD DATE

VALIANT MODULAR, LLC
VALIANT MODULAR, LLC



Third Party: HWC & Asc. Inc. 1627 SouthMyrtle Ave. Clearwater, Fl. 34616 (717)-584-8151

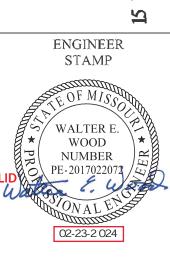


SHEET NAME


LIFE SAFETY

SHEET NUMBER

A6.1

		Equipment	Schedule		
tem umber 1	Qty	Description Shelving, Wall Mounted	Manufacturer JLS	Model Custom	Furnished By DON
2	1	Spare Number			
3A 3B	1	Soda Dispenser - Patio Soda Dispenser - Drive Thru	By Vendor By Vendor	By Vendor By Vendor	VENDOR VENDOR
4	2	Cup Dispenser	San Jamar	C2903BK	DON
5 6	3	Tea Brewer Tea Dispenser	By Owner By Owner	TBD TBD	VENDOR VENDOR
7.1	2	Shelving, Wall Mounted	Quantum	2448C/DWB24/DWBD24	DON
7.3	1	Shelving, Wall Mounted Beverage Counter	Quantum JLS	2436C/DWB24 Custom	DON DON
9	1	Stainless Steel Work Table w/ Base	JLS	Custom	DON
10	1	Spare Number Shake Machine	Taylor	 490-A	DON
12	1	Refrigerator, Undercounter	Hoshizaki	UR48B	DON
13 14	1 4	POS Table Floor Trough Drain	JLS By Others	Custom Custom 6x48	DON VALIANT
15	1	Spare Number			.,,,,
16 17	1	Spare Number Warmer	 APW Wyott	 RCW-7SP	DON
18	1	Stainless Steel Top Work Tables	JLS	Custom	DON
19A 19B	3	Kitchen Display System Kitchen Display System	By Owner By Owner	TBD TBD	OWN
20	1	Spare Number			OWIN
21	1	Overhead Shelving, Ceiling Mounted Spare Number	Quantum	3042C/P63C/S-Hook/FP	DON
23	1	Phone	By Owner	TBD	OWNER
24 25	2 2	Hand Sink Soap & Towel Dispensers	By Contractor Smallwares	By Contractor Custom	VALIANT VENDOR
26	1	Freezer, Worktop	Hoshizaki	WF48B	DON
27-30 31	1	Spare Number Hot Food Holding Station	 Carter-Hoffmann	 CNH18	DON
32	1	Food Pan Warmer	Server Products	86090	DON
33 34-35	1	Stainless Steel Work Table w/ Undershelf	JLS	Custom	DON
34-35 36	1	Spare Number Fryers	Vulcan	 2TR45DF	DON
37	2	Shelving, Tubular 2 Platen Flectric Double Sided Grill	JLS Taylor	Custom	DON
38 39.1	1	2 Platen Electric Double-Sided Grill Work Top Filler	Taylor John Boos	L852 EFT8-3608SSK Custom	DON DON
39.2 40	1	Work Top Filler Refrigerated Prep Table	John Boos Hoshizaki	EFT8-3618SSK SR27B-12M	DON DON
41	1	Spare Number		SK2/B-12M	DON
42	1	Toaster, Vertical	Prince Castle	297-T20	DON
42.1	1	Butter Wheel Shelving, Tubular	Smallwares JLS	TBD Custom	VENDOR DON
44	2	Fire Extinguisher	By Contractor	Per Code	OWNER
45 46	1	Refrigerator	Hoshizaki Hoshizaki	F1A-FS R1A-FS	DON DON
48.1	1	Shelving, Wall Mounted	JLS	Custom	DON
48.2	1	Shelving, Wall Mounted Spare Number	JLS 	Custom 	DON
50	1	Spare Number			
51 52	1	Spare Number Spare Number			
53	1	Work Table, Stainless Steel Top	JLS	Custom	DON
54 55	1	Ice Bin Ice Cube Machine, Remote w/ 50' Line Set	Manitowoc Ice Manitowoc Ice	D-970 RNF1020C/RC51	DON DON
55.1	1	Ice Bin Adapter	Manitowoc Ice	K00473	DON
55.2 55A	1	Icemaker Condenser, Remote Filter System, Ice Maker	Manitowoc Ice Manitowoc Ice	RCUF1000-261 AR-20000-P	DON DON
56-59	1	Spare Number			
60 61	1	Smart Wall Dish Station Kit Spare Number	Quantum	Lot	DON
62	1	Pre-Rinse Faucet Assembly, With Add-On Faucet	T&S Brass	B-0133-ADF12-B	DON
63.1	3	Three (3) Compartment Sink Drain, Lever Handle	JLS T&S Brass	Custom B-3952	DON DON
64	1	Wire Shelving	Quantum	2460C/P86C/WR-00H/DB	DON
64.1 64.2	1	Wire Shelving Wire Shelving	Quantum Quantum	2436C/P54C/WR-00H/DB 2448C/P86C/WR-00H-DB	DON DON
65	1	Spare Number			DON
66 67	2 2	Soda Carbonator BIB Rack	By Vendor By Vendor	E2000 Big Mac By Vendor	VENDOR VENDOR
68	1	Water Filtration System	Everpure Everpure	EV929322	DON
69-70	1	Spare Number		Ry Contractor	\/ A I I A b IT
71 71.1	1	Mop Sink Stainless Steel Splash Shield	By Contractor By Contractor	By Contractor By Contractor	VALIANT VALIANT
72	1	Service Faucet	By Contractor	By Contractor	VALIANT
73 73.1	1	Walk-In Cooler Evaporator Coil (Refrigerator)	Thermalrite Thermalrite	Custom Custom	DON DON
73.2	1	Cooler Condenser	Thermalrite	Custom	DON
74 74.1	1	Walk-In Freezer Evaporator Coil (Freezer)	Thermalrite Thermalrite	Custom Custom	DON DON
74.2	1	Freezer Condenser	Thermalrite	Custom	DON
75 76	2	Wire Shelving Dunnage Rack	Quantum Quantum	2460P/P74P QFSD-2260	DON DON
76.1	3	Dunnage Rack	Quantum	QFSD-2248	DON
77 78	2	Spare Number Wire Shelving	 Quantum	 1860C/P86C/WR-00H/DB	DON
78.1	1	Wire Shelving	Quantum	1860C/P54C/WR-00H/DB	DON
79 80-81	1 1	Wire Shelving Spare Number	Quantum 	1830C/P74C/WR-00H/DB	DON
82	1	Safe	By Owner	TBD	OWN
83 84	1	Formica Desktop Networking Box	By Contractor By Vendor	Custom TBD	VALIANT VENDOR
84 85-86	1	Spare Number			V EINDUK
87	1	Shelving, Wall Mounted	Quantum	2460C/DQB24	DON
88 CO2	1	Wire Shelving Bulk CO2	Quantum By Vendor	1830C/P74C/WR-00H/DB TBD	DON VENDOR
EP	2	Electrical Panel	By EC		VALIANT
M1 M2	1 1	Hood System Exhaust Fan	CaptiveAire CaptiveAire	By Contractor By Contractor	VALIANT VALIANT
МЗ	1	Dedicated Outside Air System RTU	CaptiveAire	By Contractor	VALIANT
POS1	1	POS - Patio POS - Drive Thru	By Owner By Owner	TBD TBD	OWN
			Ansul	LRD LRD	VALIANT
POS2 PS	1	Fire System Pull Station	Arisui	1 3	V ALIAINI

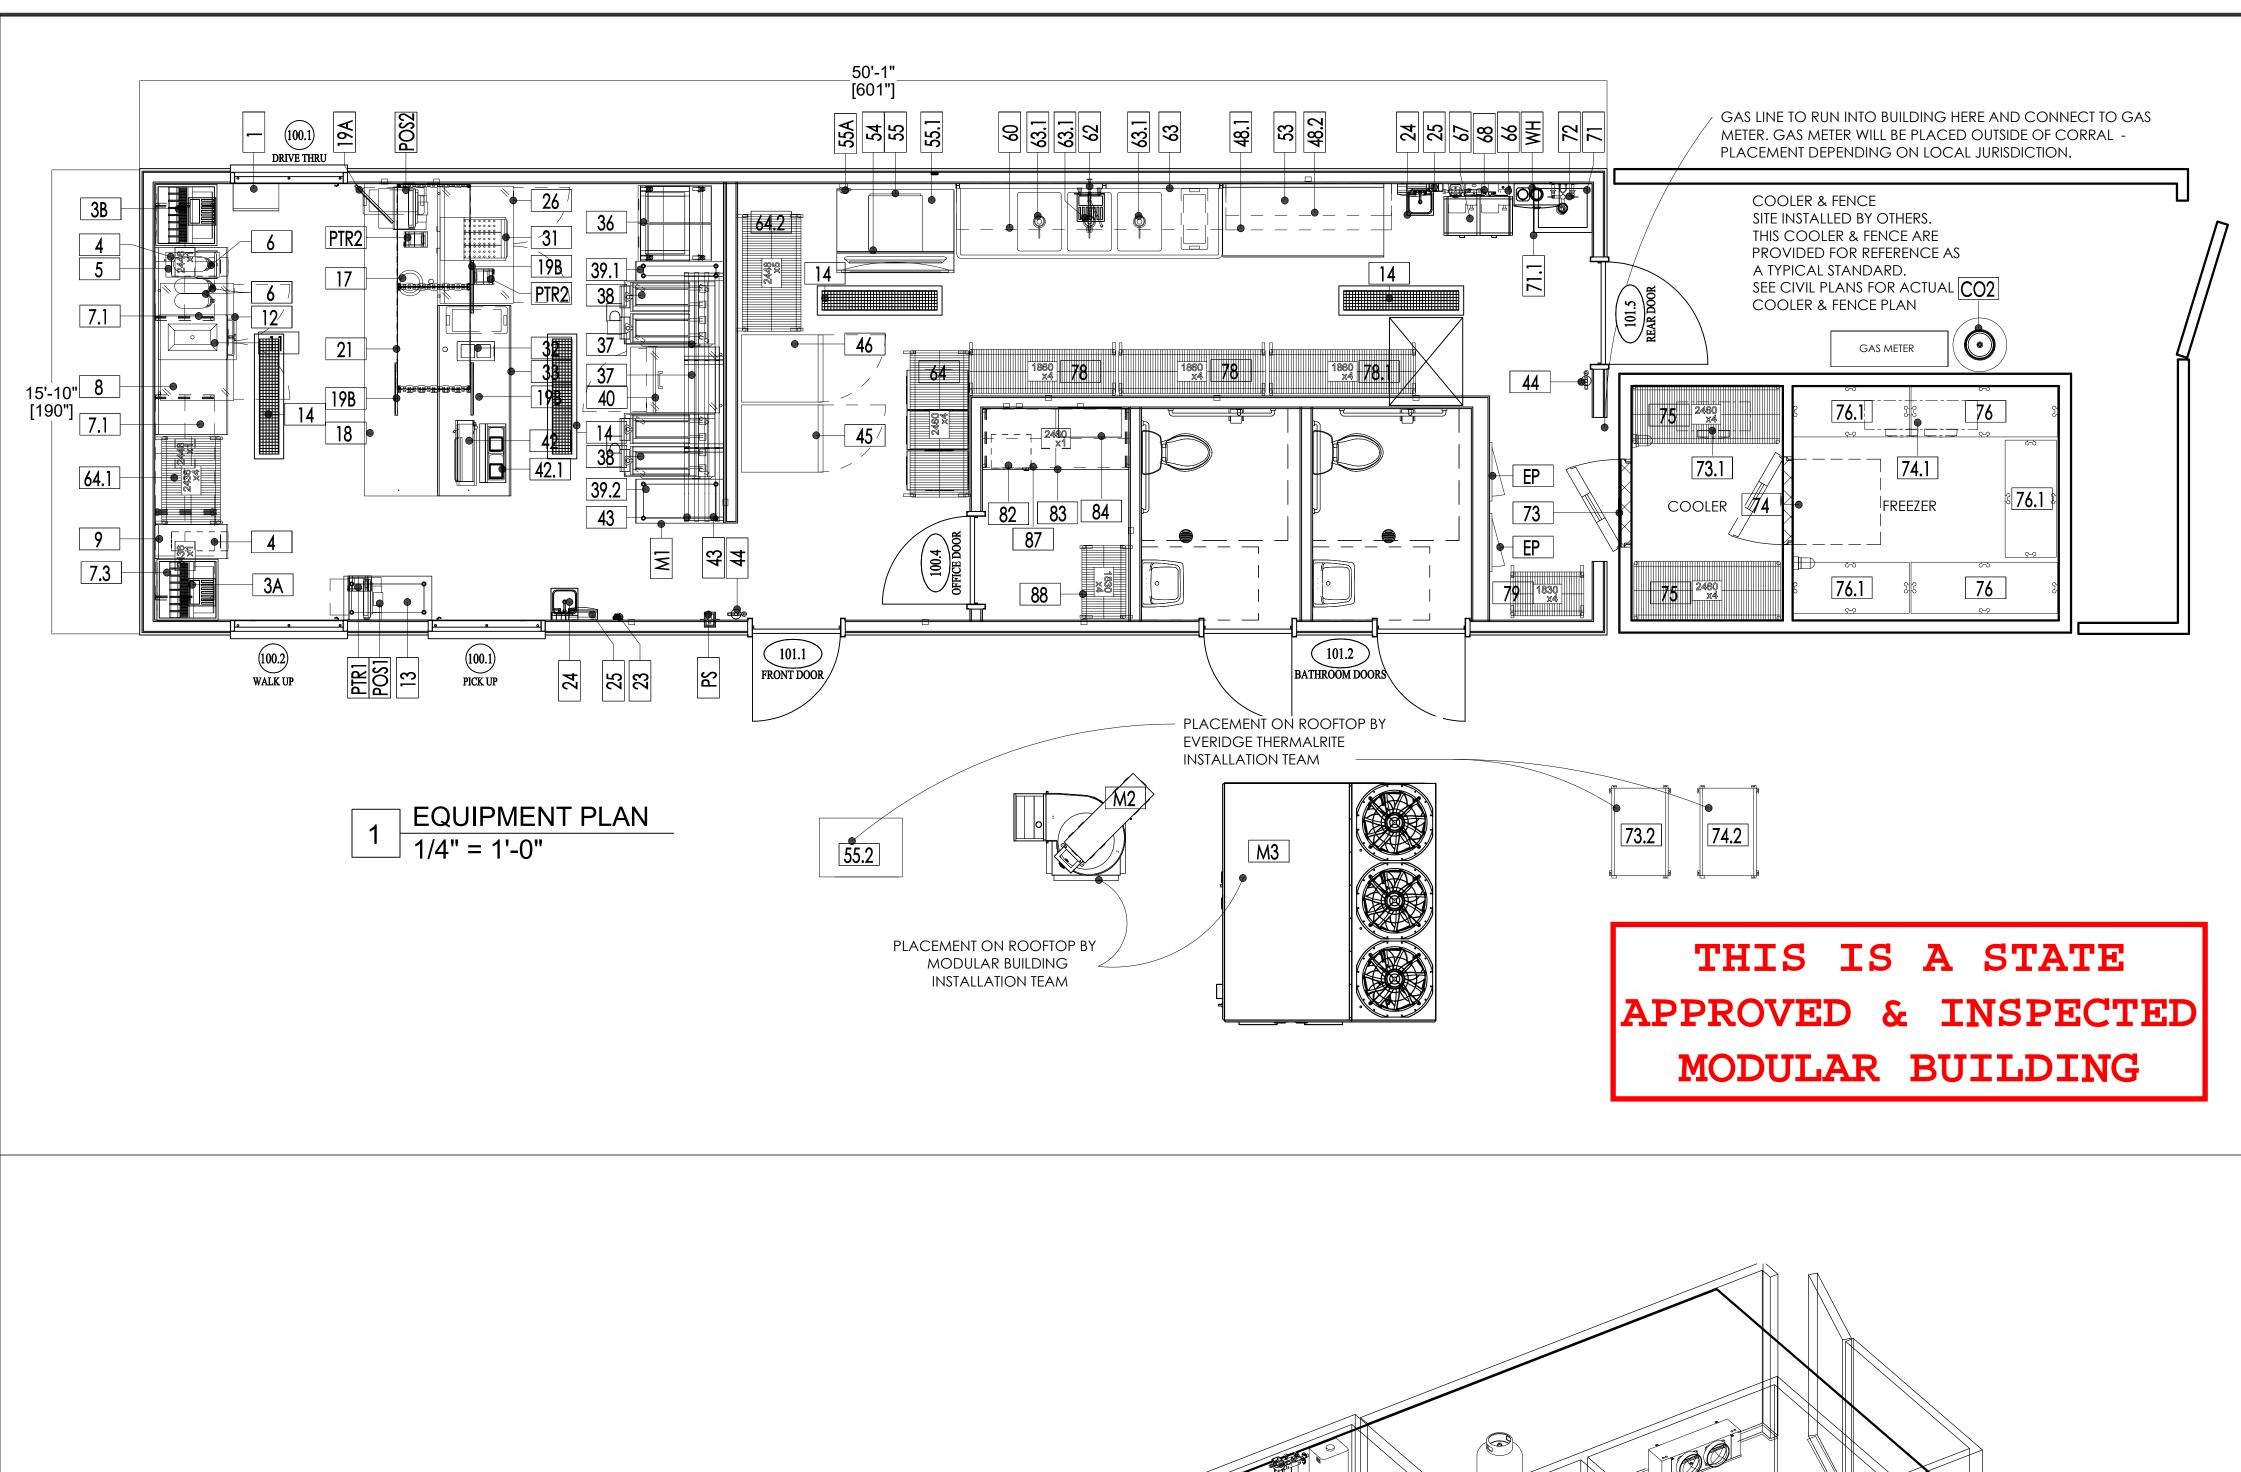

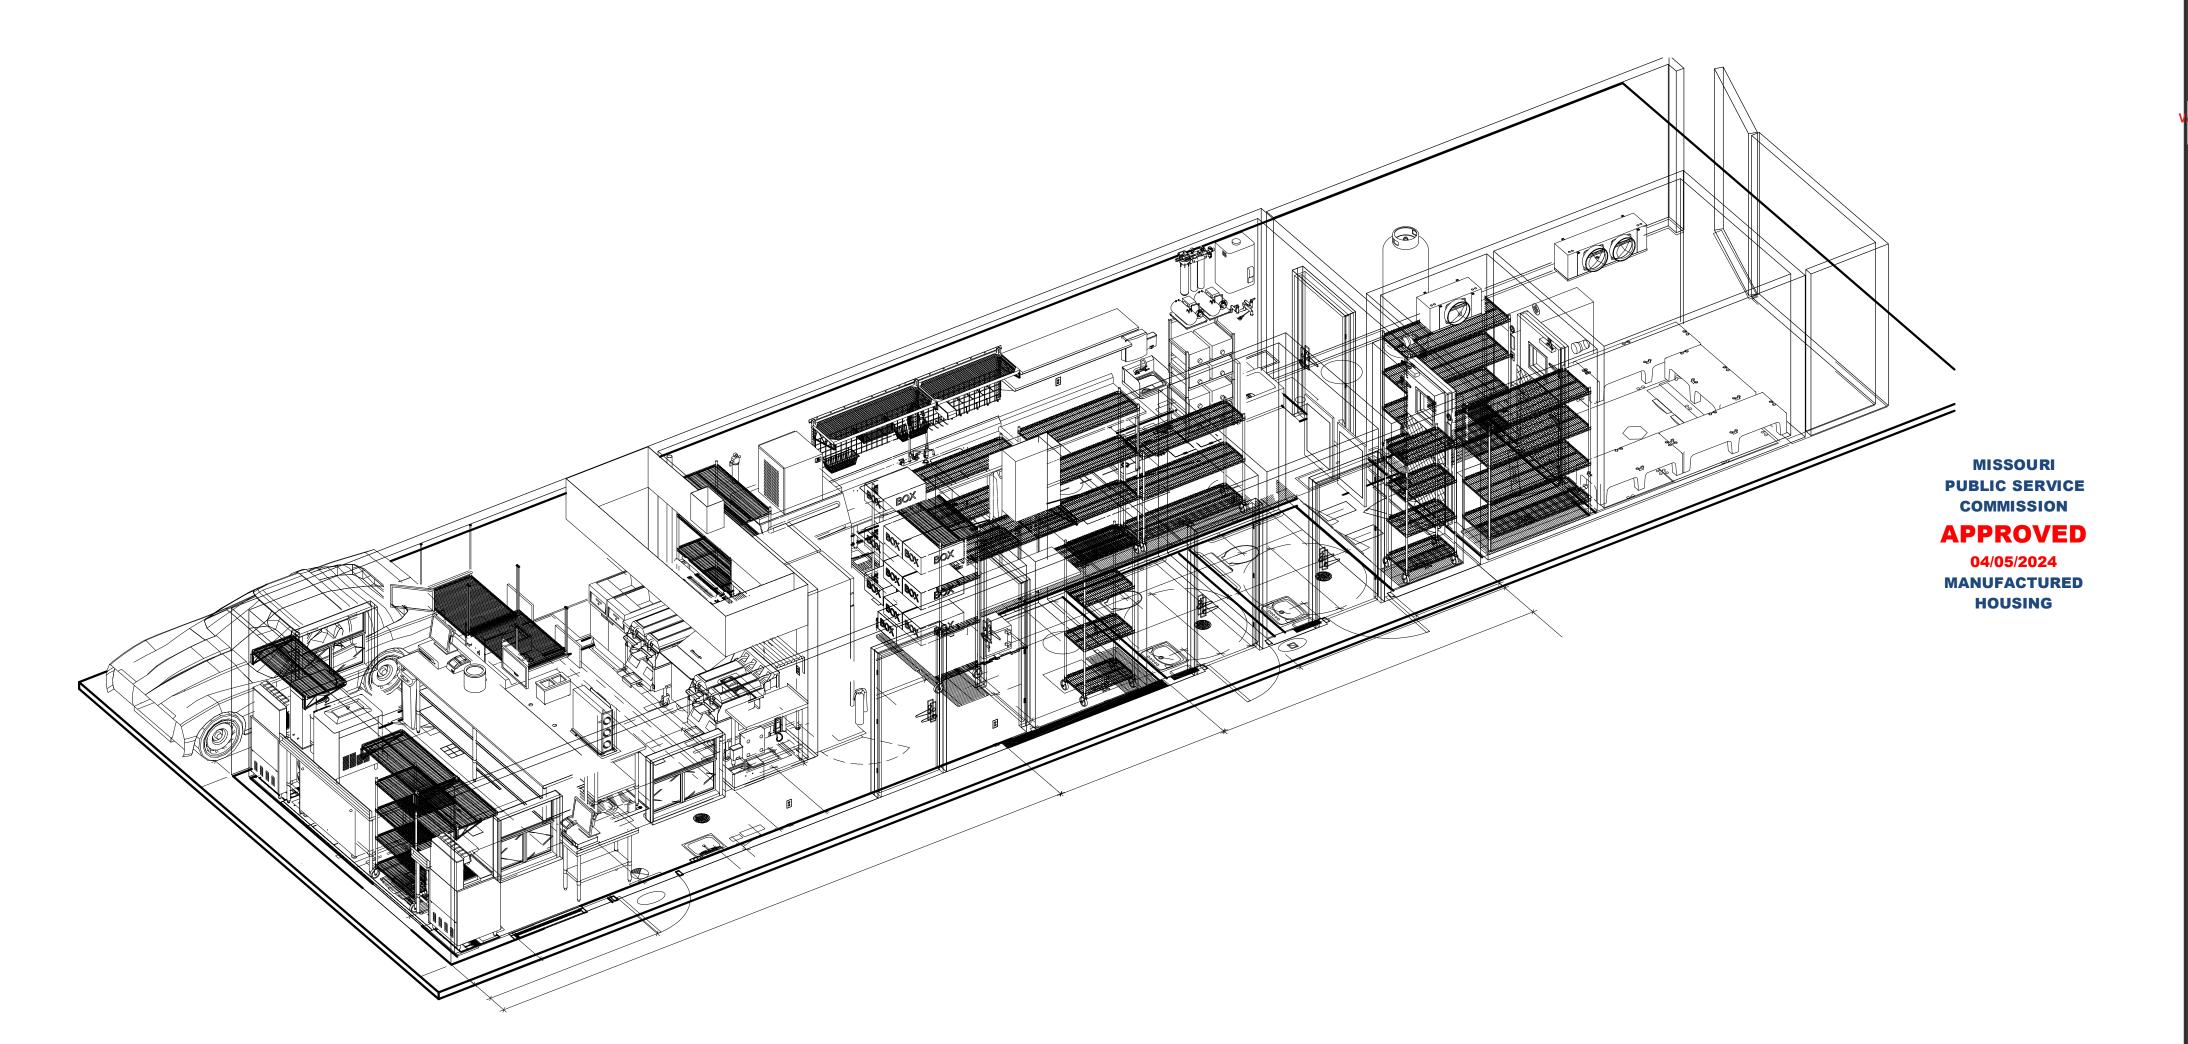

REVISION/ UPLOAD DATE

REV. DATE DESCRIPTION

LAST DESIGN BULLETIN

NUM. DATE DESCRIPTION

ALIANT

NECOLO DE LA RE

VALIANT MODULAR, LLC
ER CIRCLE, ORMOND BEACH.

ENGINEER STAMP

ENGINEER STAMP

WALTER E.

WOOD

NUMBER

PE-2017022071

OO-23-2 024

Third Party: HWC & Asc. Inc. 1627 SouthMyrtle Ave. Clearwater, Fl. 34616 (717)-584-8151



SHEET NAME

EQUIPMENT PLAN

SHEET NUMBER

A9.1

												Equipment Utility Schedule								
										50	<u>R</u>		ater Size	ater RI	er Size er RI	Water Size	aste Size	aste RI	out Btu/h	
Item Number (Qty	Description	Manufacturer	Model	FL Amps	Watts	НР	Volts	Phase	Conn Pl	Electrico	Electrical Remarks	Cold WG	Cold Wo	Hot Wat	Filtered '	Direct W	Direct W.	Sp Sp Sp Sp Plumbing Remarks	Item Number
1 2 3A	1 5	Shelving, Wall Mounted Spare Number Soda Dispenser - Patio	JLS By Vendor	Custom By Vendor	10.0 A			120 V				E.C. To Verify Loads w/ Vendor Supplied Equipment				3/4'			Verify Requirements w/ Owner, Air-Gap To FS	1 2 3A
3B 4 5	2 (Soda Dispenser - Drive Thru Cup Dispenser Tea Brewer	By Vendor San Jamar By Owner	By Vendor C2903BK TBD	10.0 A							E.C. To Verify Loads w/ Vendor Supplied Equipment By Owner-Verify w/ Owner				1/4"			Verify Requirements w/ Owner, Air-Gap To FS Filtered Water From 68, By Vendor - Verify w/ Vendor	3B 4 5
7.1 7.3	2 5	Tea Dispenser Shelving, Wall Mounted Shelving, Wall Mounted	By Owner Quantum Quantum	TBD 2448C/DWB24/DWBD24 2436C/DWB24																7.1 7.3
9 10	1 5	Severage Counter Stainless Steel Work Table w/ Base Spare Number	JLS JLS	Custom 490-A	120 A	2407 W	1 /2	208 V	1 1	/ 15D	40"	Verify plug connection w/ Vender					1 1/2"	19"		9 10
11 12 13 14	1 F	Shake Machine Refrigerator, Undercounter POS Table Floor Trough Drain	Taylor Hoshizaki JLS By Others	UR48B Custom Custom 6x48		2496 W 345 W		115 V				Verify plug connection w/ Vendor					3"		Verify w/ Fabricator	11 12 13 14
15 16 17	1 5	Spare Number Spare Number Warmer	 APW Wyott	 RCW-7SP	8.3 A	1000 W		120 V	1 :	5-15P	24"	3+WIRE							Yelliy W/ Fabricator	15 16 17
18 19A 19B	1 k	Stainless Steel Top Work Tables Kitchen Display System Kitchen Display System - Ceiling	JLS By Owner By Owner	Custom TBD TBD				120 V 120 V	1 .	5-20P <	varies>	By Owner - Verify w/ Owner, Data required By Owner - Verify w/ Owner, Data required								18 19A 19B
22	1 (Spare Number Overhead Shelving, Ceiling Mounted Spare Number	 Quantum 	 3042C/P63C/S-Hook/FP 																20 21 22
25	2 H	Phone Hand Sink Soap & Towel Dispensers	By Owner By Contractor Smallwares	TBD By Contractor Custom								By Owner - Verify w/ Owner	1/2"	19"	1/2" 19'		1 1/2"	21"		23 24 25
26 27-30 31	1 S	Freezer, Worktop Spare Number Hot Food Holding Station	Hoshizaki Carter-Hoffmann	WF48B CNH18	15.1 A	1820 W	1/5	115 V		5-20P	18" 42"									26 27-30 31
32 33 34-35 36	1 5	Food Pan Warmer Stainless Steel Work Table w/ Undershelf Spare Number Fryers	Server Products JLS Vulcan	86090 Custom 2TR45DF	4.2 A 6.0 A	500 W		120 V			10"							1 1/	4" 140000 28"	32 33 34-35 36
36 37 38 39.1	2 2	Shelving, Tubular 2 Platen Electric Double-Sided Grill Work Top Filler	JLS Taylor John Boos	Custom L852 EFT8-3608SSK Custom		16800 W		208 V										1 1/	4 14000 28	36 37 38 39.1
39.2 40 41	1 \	Work Top Filler Refrigerated Prep Table Spare Number	John Boos Hoshizaki	EFT8-3618SSK SR27B-12M	2.3 A	265 W	1/5	115 V	1 ,	5-15P	18"									39.2 40 41
42 42.1 43	1 1 1 E	Toaster, Vertical Butter Wheel Shelving, Tubular	Prince Castle Smallwares JLS	297-T20 TBD Custom	13.0 A	1500 W		120 V	1 ,	5-15P		Plug into work table outlet								42 42.1 43
44 45 46	1 F	Fire Extinguisher Freezer Refrigerator	By Contractor Hoshizaki Hoshizaki	Per Code F1A-FS R1A-FS	8.5 A 5.0 A	973 W 575 W		115 V 115 V		5-15P 5-15P										44 45 46
48.1 48.2 49	1 5	Shelving, Wall Mounted Shelving, Wall Mounted Spare Number	JLS JLS 	Custom Custom																48.1 48.2 49
50 51 52	1 5	Spare Number Spare Number Spare Number Work Table, Stainless Steel Top		 Custom																50 51 52 53
53 54 55 55.1	1	ce Bin ce Cube Machine, Remote w/ 50' Line Set ce Bin Adapter	Manitowoc Ice Manitowoc Ice Manitowoc Ice	D-970 RNF1020C/RC51 K00473	2.9 A	334 W		115 V	1 [Direct	72"		3/8"			3/4' 1/2" 3/4'			Air-Gap to FS	55 54 55 55.1
55.2 55A 56-59	1 F	cemaker Condenser, Remote Filter System, Ice Maker Spare Number	Manitowoc Ice Manitowoc Ice Manitowoc Ice	RCUF1000-261 AR-20000-P	15.0 A	3120 W		208 V	1 [Direct		208-230V/60/1	3/8"	78"		1/2" 3/8'	'		Filtered water to 55	55.2 55A 56-59
60 61 62	1 5	Smart Wall Dish Station Kit Spare Number Pre-Rinse Faucet Assembly, With Add-On Faucet	Quantum T&S Brass	Lot B-0133-ADF12-B									1/2"	14"	1/2" 14"					60 61 62
63 63.1 64	3 [1 \	Three (3) Compartment Sink Drain, Lever Handle Wire Shelving	JLS T&S Brass Quantum	Custom B-3952 2460C/P86C/WR-00H/DB												2" 3/4"	'		Air-Gap To FS, Waste Per Code	63 63.1 64
64.1 64.2 65	1 \	Wire Shelving Wire Shelving Spare Number	Quantum Quantum 	2436C/P54C/WR-00H/DB 2448C/P86C/WR-00H-DB 																64.1 64.2 65
67 68	2 E	Soda Carbonator BIB Rack Water Filtration System	By Vendor By Vendor Everpure	E2000 Big Mac By Vendor EV929322	15.0 A		1/3	120 V 120 V		5-20P 5-15P		By Vendor - verify requirements By Vendor - Verify w/ Vendor	3/4"	90"		3/4"			By Vendor - verify requirements By Vendor - Verify w/ Vendor Filtered Water To 5 and 66	66 67 68
69-70 71 71.1 72	1 1	Spare Number Mop Sink Stainless Steel Splash Shield Service Faucet	By Contractor By Contractor By Contractor	By Contractor By Contractor By Contractor									1/2"	36"	1/2" 36'		2"	0"		69-70 71 71.1 72
73 73.1 73.2	1 \	Walk-In Cooler Evaporator Coil (Refrigerator) Cooler Condenser	Thermalrite Thermalrite Thermalrite	Custom Custom Custom				120 V		Direct Direct	80''	See Shop Drawings See Shop Drawings See Shop Drawings	1/2		172 00	3/4	'		Air-Gap To FS, See Shop Drawings See Shop Drawings	73 73.1 73.2
74 74.1 74.2	1 \	Walk-In Freezer Evaporator Coil (Freezer) Freezer Condenser	Thermalrite Thermalrite Thermalrite	Custom Custom Custom				120 V	1 [102'' 80''	See Shop Drawings See Shop Drawings See Shop Drawings				3/4'	'		Air-Gap To FS, See Shop Drawings See Shop Drawings	74 74.1 74.2
75 76 76.1	2 [3 [Wire Shelving Dunnage Rack Dunnage Rack	Quantum Quantum Quantum	2460P/P74P QFSD-2260 QFSD-2248							_									75 76 76.1
77 78 78.1	2 \	Spare Number Wire Shelving Wire Shelving	Quantum Quantum	 1860C/P86C/WR-00H/DB 1860C/P54C/WR-00H/DB																77 78 78.1
79 80-81 82	1 5	Wire Shelving Spare Number Safe	Quantum By Owner	1830C/P74C/WR-00H/DB TBD Custom								Verify electrical requirements w/ Vendor								79 80-81 82
83 84 85-86 87	1 1	Desktop Networking Box Spare Number Shelving, Wall Mounted	By Contractor By Vendor Quantum	Custom TBD 2460C/DQB24						Direct		Data, By Vendor - Verify w/ Vendor								83 84 85-86 87
88	1 \\3 [Wire Shelving Duplex Convenience Outlet - Rear Duplex Convenience Outlet - Front Door	Quantum By EC By EC	1830C/P74C/WR-00H/DB				120 V 120 V			12" 12"									88 C12A C12B
C12C C18 C44A	2 [Duplex Convenience Outlet - Office Duplex Convenience Outlet Duplex Convenience Outlet - Office	By EC By EC By EC					120 V 120 V 120 V	1 ;	5-20R 5-20R 5-20R	12" 18" 44"	By EC By EC								C12C C18 C44A
C44B C48A C48B	2 [1 [1 [Duplex Convenience Outlet - Bathrooms Duplex Convenience Outlet - Drive Thru Duplex Convenience Outlet - Hood	By EC By EC By EC	 				120 V 120 V 120 V	1 ;	5-20R 5-20R 5-20R	44" 48" 48"	By EC By EC								C44B C48 C48
C48C C48D CO2	1 [Duplex Convenience Outlet - Office Duplex Convenience Outlet - Rear Bulk CO2	By EC By EC By Vendor	 TBD				120 V 120 V		5-20R 5-20R	48" 48"	-								C48 C48 CO2
M1 M2	1 F	Electrical Panel Hood System Exhaust Fan	By EC CaptiveAire CaptiveAire	By Contractor By Contractor				120 V 208 V	3 [See Shop Drawings See Shop Drawings							1014/1	EP M1 M2
M3 POS1 POS2 PS	1 F	Dedicated Outside Air System RTU POS - Patio POS - Drive Thru Fire System Pull Station	CaptiveAire By Owner By Owner	By Contractor TBD TBD				120 V 120 V	1 .	5-15P < 5-15P <	varies> varies>	See Shop Drawings By Owner - Verify w/ Owner, Data required By Owner - Verify w/ Owner, Data required Final Conn. By Fire Safety Contractor						1"	181461 See Shop Drawings	POS1 POS2 PS
PS PTR1 PTR2 Q24	1 F	PTR - Patio PTR - Prive Thru Quadplex Convenience Outlet - BIB Rack	Ansul By Owner By Owner By EC	PS TBD TBD				120 V 120 V 120 V 120 V	1 ;	5-15P <	varies> varies>	Final Conn. By Fire Safety Contractor By Owner - Verify w/ Owner, Data required By Owner - Verify w/ Owner, Data required By EC							By Vendor-Verify w/ Vendor	PS PTR1 PTR2 Q24
Q48 Q66 Q72	1 (Quadplex Convenience Outlet - BIB Rack Quadplex Convenience Outlet - Front Quadplex Convenience Outlet - Office Quadplex Convenience Outlet - Soda Carbonator	By EC By EC	 				120 V 120 V 120 V 120 V	1 :	5-20R	48" 66"	By EC By EC							By Vendor-Verify w/ Vendor By Vendor-Verify w/ Vendor By Vendor-Verify w/ Vendor By Vendor-Verify w/ Vendor	Q24 Q48 Q66 Q72
WH		Water Heater	By PC	By PC				V				By Vendor - Verify w/ Vendor	3/4"		3/4"				2, 151.33. 1511, 11, 151.331	WH

LAST DESIGN BULLETIN
NUM. DATE DESCRIPTION

APPROVED & INSPECTED MODULAR BUILDING

MISSOURI
PUBLIC SERVICE
COMMISSION
APPROVED
04/05/2024
MANUFACTURED
HOUSING

WALTER E. WOOD NUMBER PE-2017022072

ON A L FOR THE PERIOD OF THE PROPERTY OF

ENGINEER


ALIANT

SHEET NAME

EQUIPMENT UTILITY SCHEDULE

SHEET NUMBER

A9.2

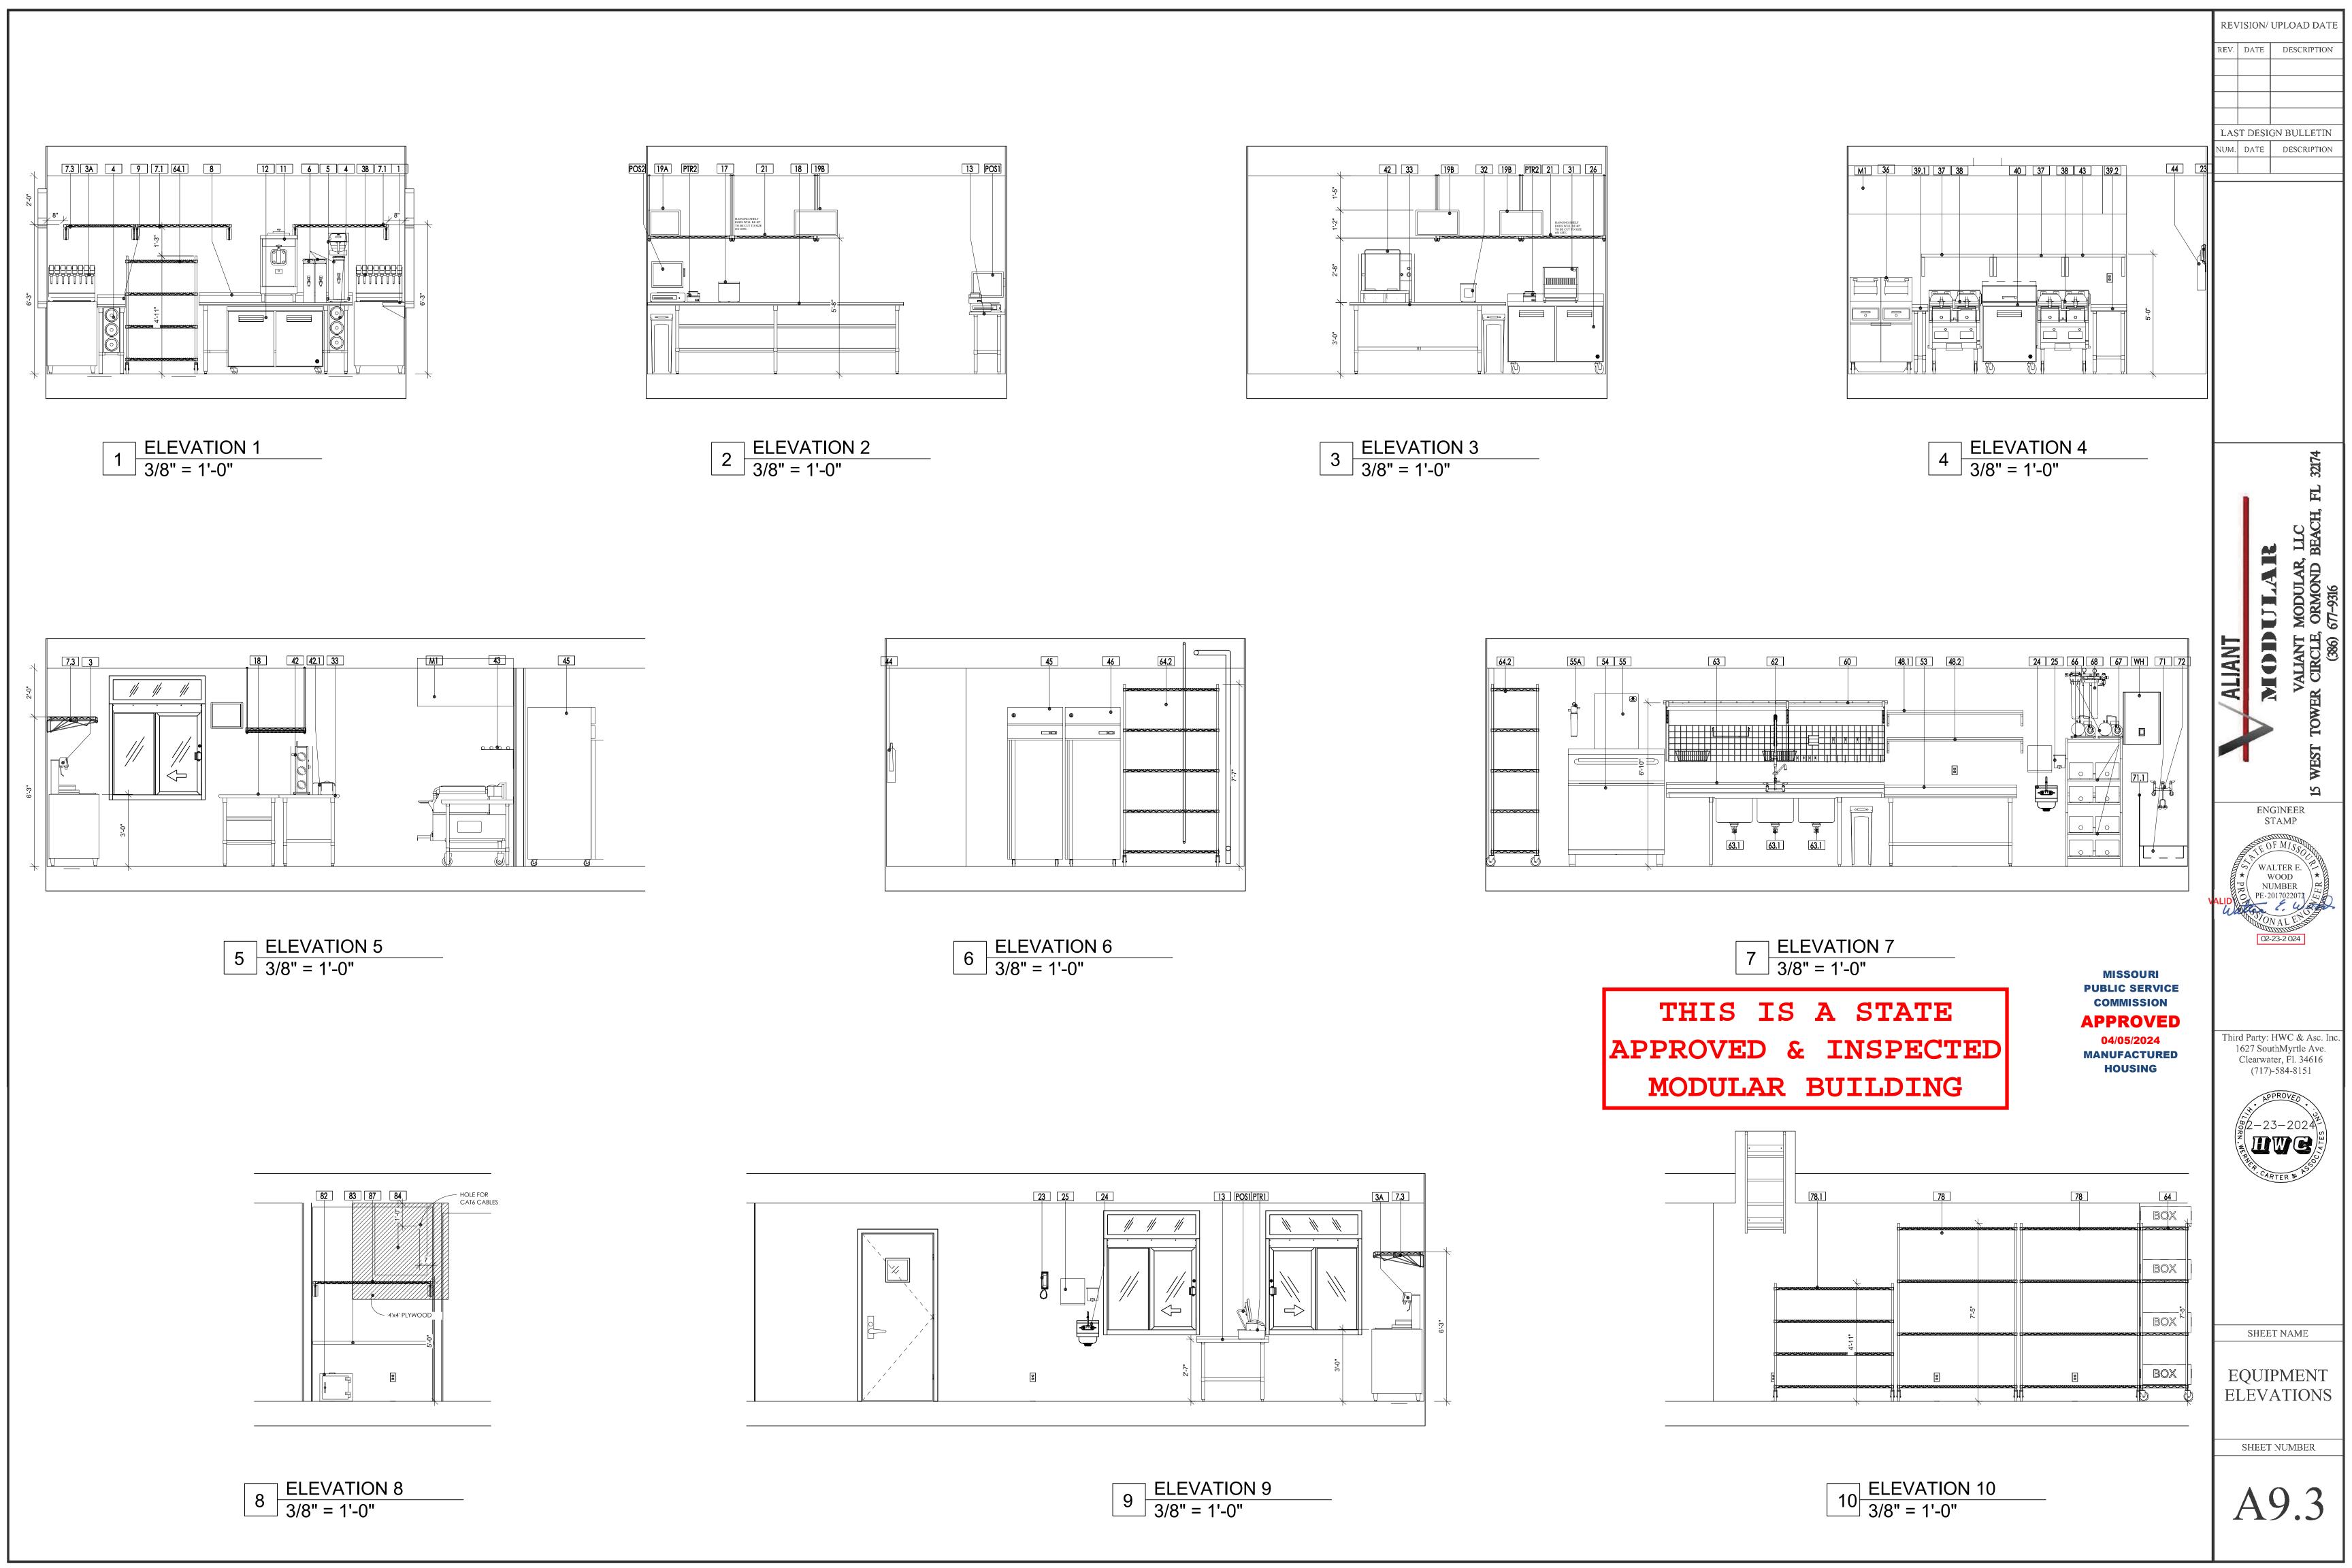

WF-1

WB-1

APPROVED & INSPECTED MODULAR BUILDING

APPROVED 04/05/2024 **MANUFACTURED** HOUSING



MODEL NO. AS SHOWN OR EQUIVALENT

BOBRICK - B-5806.99 x 36 - SEE SPECIFICATIONS

BOBRICK - B-5806.99 x 42 - SEE SPECIFICATIONS

BOBRICK - B-5806.99 x 18 - SEE SPECIFICATIONS

BOBRICK - B-4112 - SEE SPECIFICATIONS

BOBRICK - B-4262 - SEE SPECIFICATIONS

BOBRICK - B-2892 - SEE SPECIFICATIONS

| BOBRICK - B-270 - SEE SPECIFICATIONS

BOBRICK - B-4221 - SEE SPECIFICATIONS

BOBRICK - B-6707 - SEE SPECIFICATIONS

INSULATION FOR DRAIN AND WATER LINES IN LAVATORY = TRUEBRO LAV GUARD 2 MOLDED P-TRAP & SUPPLY COVER

AQUAPURE - DP-290 - SEE SPECIFICATIONS

BOBRICK - B-165-1836 - SEE SPECIFICATIONS

REPUBLIC STORAGE SYSTEMS LLC. - SEE SPECIFICATIONS

| XLERATOR HAND DRYERS - XL-GR - SEE SPECIFICATIONS

ZURN - Z6000AV - AQUAVANTAGE - SEE PLUMBING DRAWINGS

AMERICAN STANDARD - ADA COMPLAINT SEE PLUMBING DRAWINGS

AMERICAN STANDARD — ADA COMPLAINT SEE PLUMBING DRAWINGS

ACCESSORY SCHEDULE #

ITEM NO. QUANTITY SUPPL'D INSTL'D DESCRIPTION

G.C.

O.W.

O.W.

O.W.

G.C.

G.C.

O.W.

G.C.

G.C.

G.C.

G.C.

G.C.

1

0

0

0

LAVATORY FAUCET

GRAB BAR 36" LONG

GRAB BAR 42" LONG

GRAB BAR 18" LONG

SOAP DISPENSER 15 oz. LIQUID

PAPER TOWEL DISPENSER

TOILET PAPER DISPENSER

WATER FILTRATION SYSTEM

SANITARY NAPKIN RECEPTACLE

EMPLOYEE LOCKERS

FLUSH VALVE

COAT HOOK


HAND DRYER


SEAT COVER DISPENSER

BABY CHANGING TABLE

WATER CLOSET

MIRROR

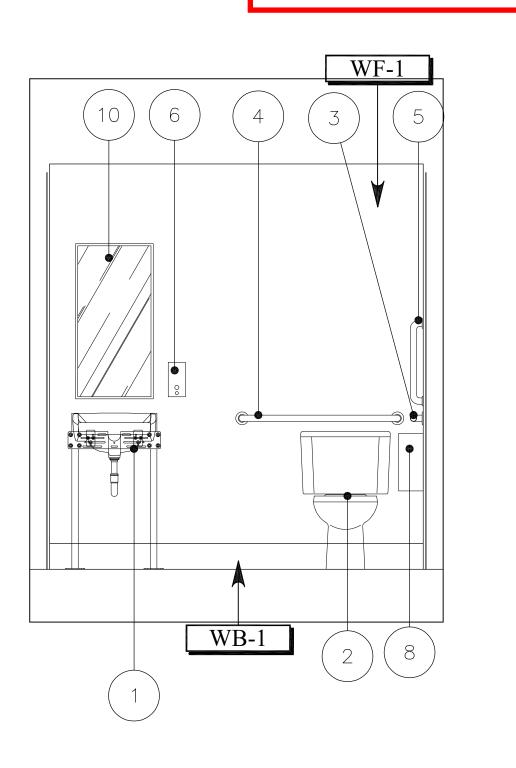

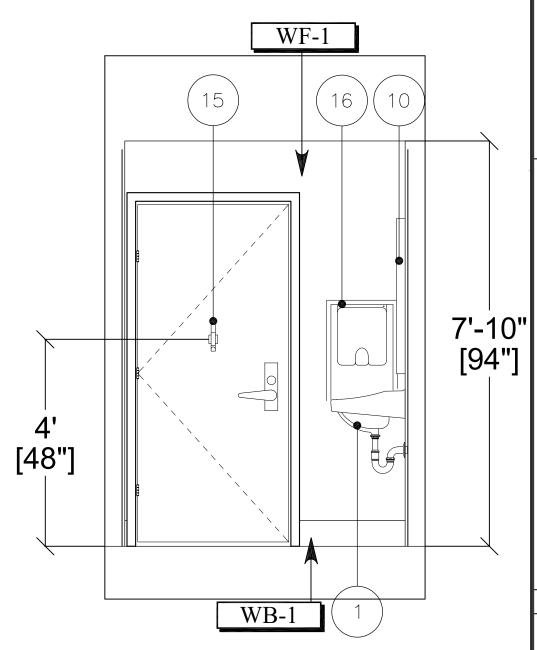

1 RESTROOM ELEVATIONS
1/2" = 1'-0"

REVISION/ UPLOAD DATE REV. DATE DESCRIPTION

LAST DESIGN BULLETIN NUM. DATE DESCRIPTION

MODULA

ENGINEER STAMP S WALTER E. WOOD NUMBER


Clearwater, Fl. 34616 (717)-584-8151 ive/

Third Party: HWC & Asc. Inc. 1627 SouthMyrtle Ave.



SHEET NAME


RESTROOM **ELEVATIONS**

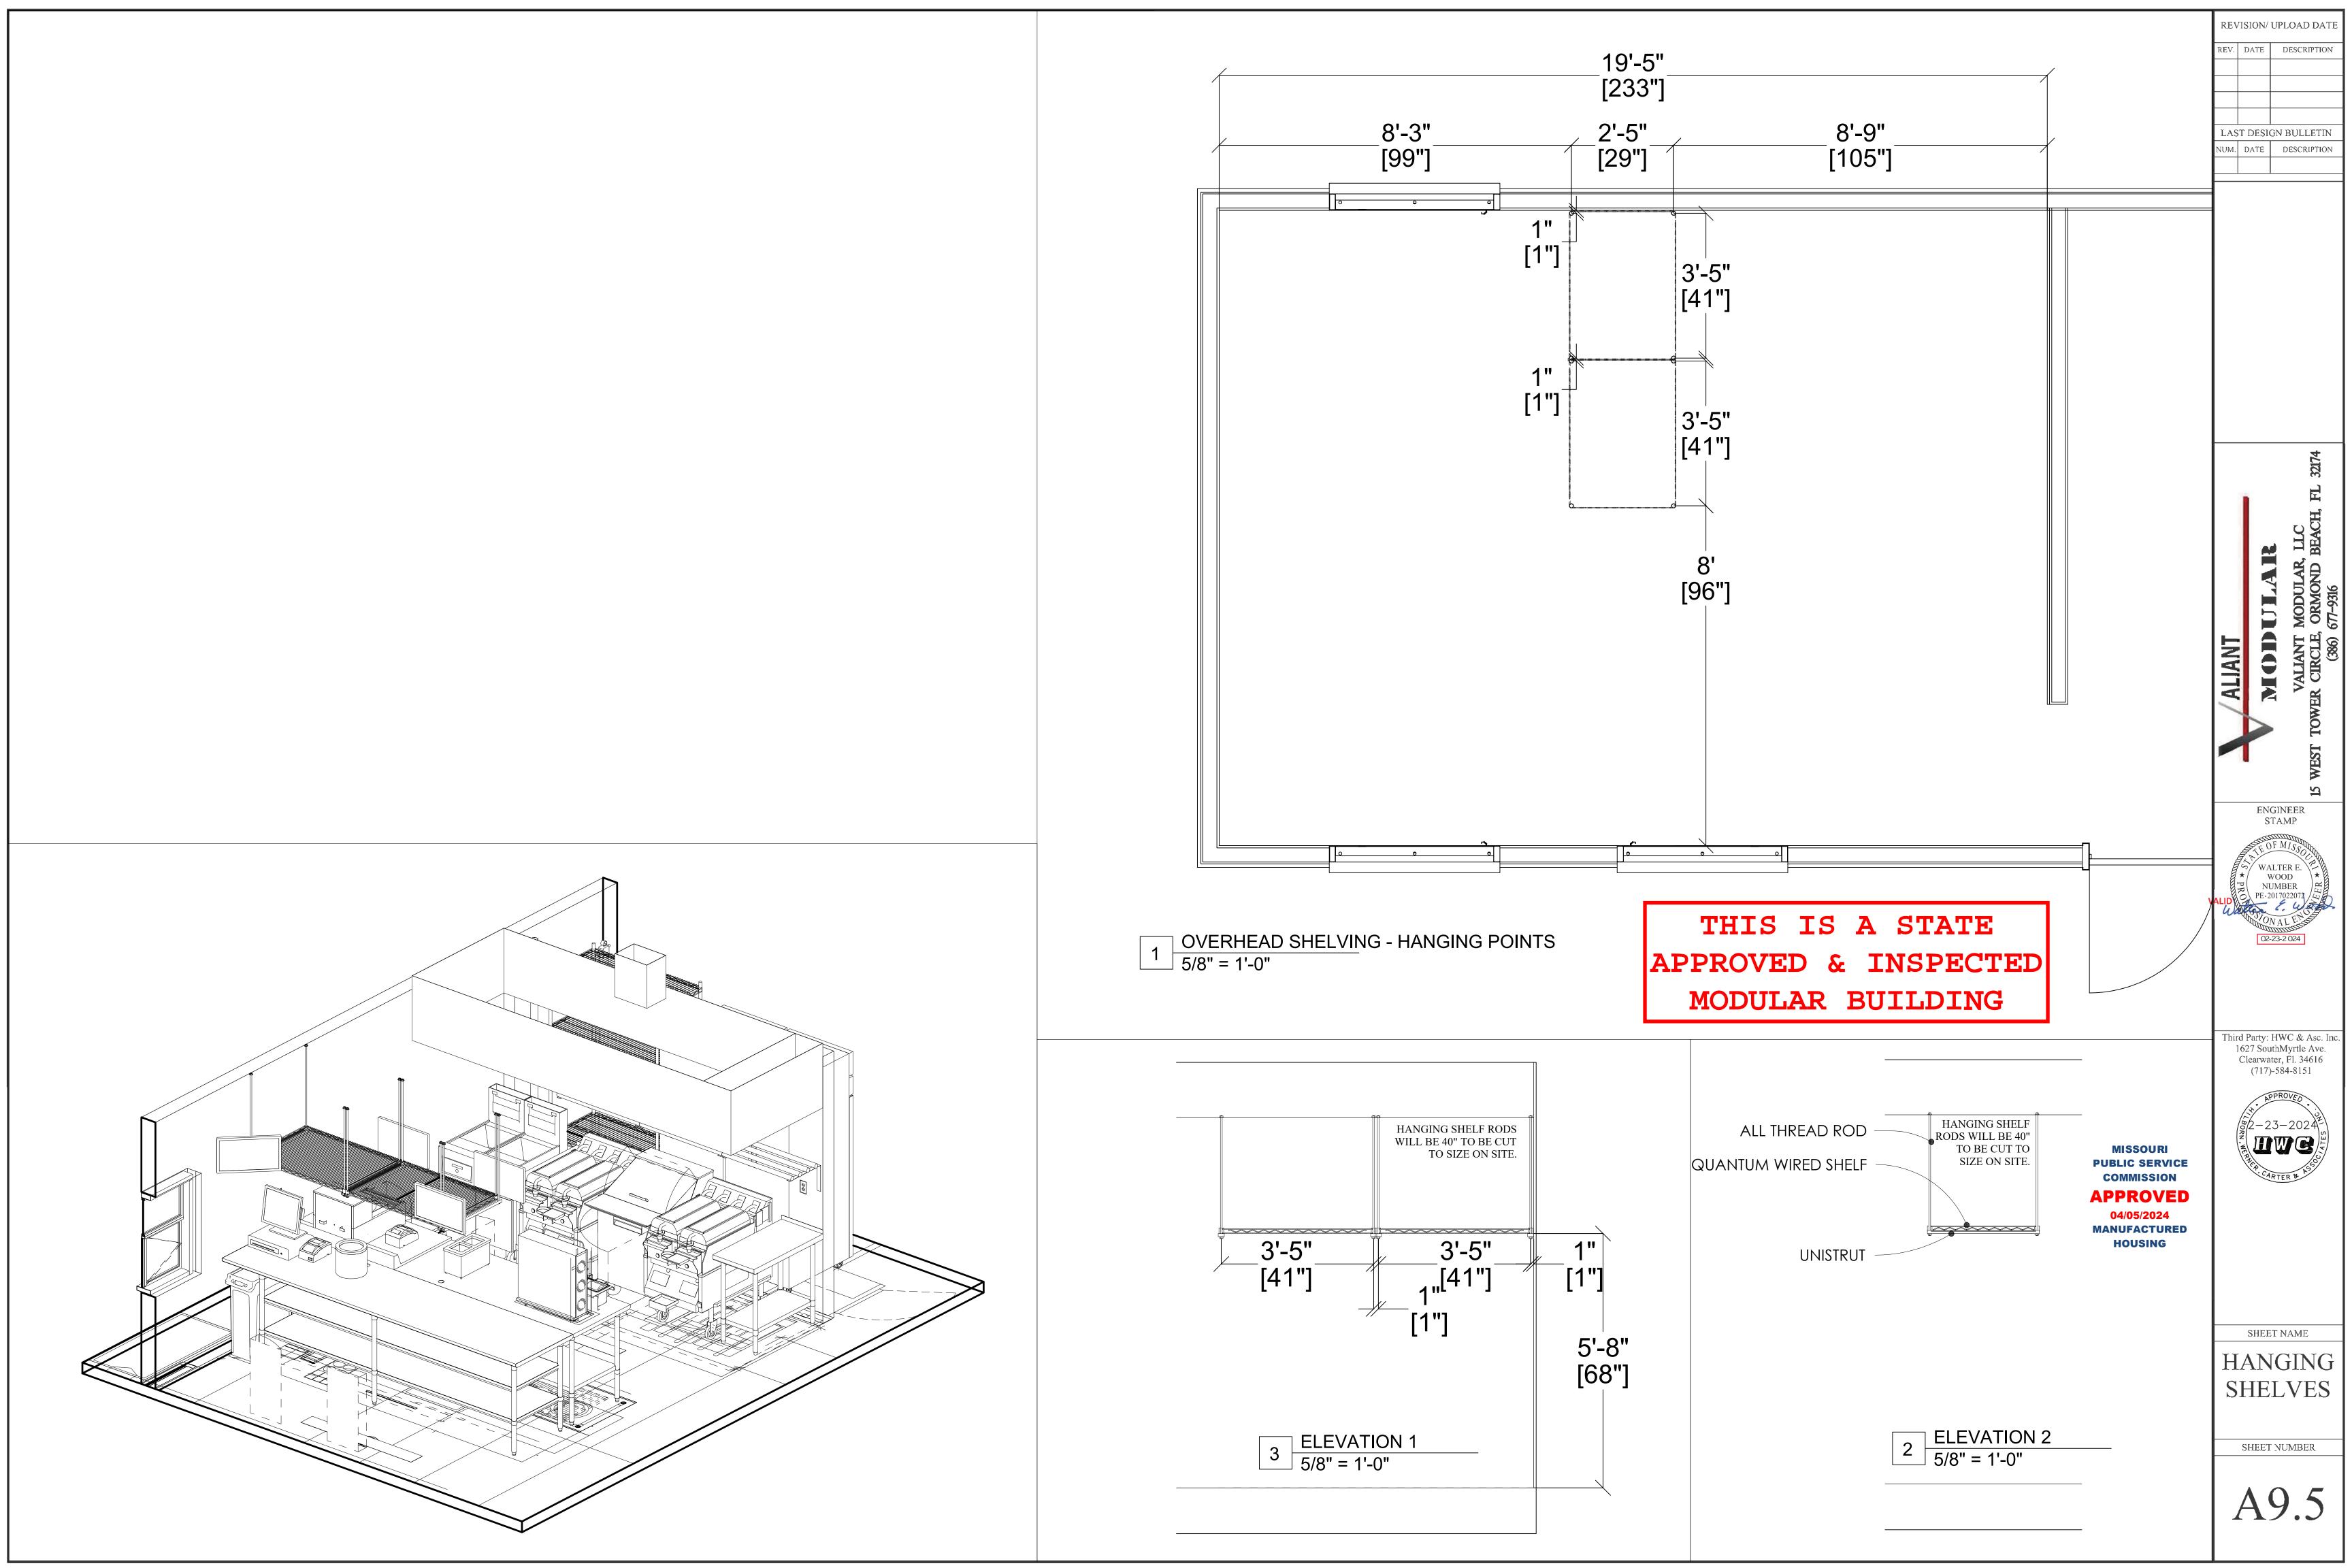

1 PANIC DEVICE 1 KEYPAD ACCESS LOCK 1 CLOSER 1 WEATHER-STRIPPING 1 DOOR SWEEP 1 THRESHOLD 1 KICKPLATE 2 SET-02 - WATER CLOSET 3 HINGES 1 CYLINDRICAL LOCKSET 1 WEATHER-STRIPPING 1 DOOR SWEEP 1 THRESHOLD 1 KICKPLATE 1 SET-03 - OFFICE 3 HINGES 1 CYLINDRICAL LOCKSET 1 KICKPLATE 1 SET-04 - FRONT 3 HINGES 1 PANIC DEVICE 1 CYLINDRICAL LEVER/ CLUTCH 1 CLOSER		JLE AS SHOWN OR EQUIV	/ALENT		DIVISION 8		
QTY.	DESCRIPTION	D1 - REAR ES CAL-ROYAL MARKS USA (OR CAL-ROYAL) AD ACCESS LOCK ALARM LOCK ER CAL-ROYAL THER-STRIPPING PEMKO PLATE DIAMOND PLATE SHEET DIAMOND PLATE SHEET DIAMOND PEMKO CAL-ROYAL CAL-ROYAL DIAMOND PLATE SHEET DIAMOND PLATE SHEET DIAMOND PEMKO DIAMOND PLATE SHEET	MODEL#	FINISH	REMARKS		
1	SET-01 - REAR	·					
3	HINGES	CAL-ROYAL	BB31	US32D	NRP		
1	PANIC DEVICE	MARKS USA (OR CAL-ROYAL)	M9900H (OR A7700)	US32D			
1	KEYPAD ACCESS LOCK	ALARM LOCK	ETDL27-S1G-26D-M99	US26D	TRILOGY T2 SERIES		
1	CLOSER	CAL-ROYAL	300	ALUM	PCOV		
1	WEATHER-STRIPPING	РЕМКО	303	MILL FINISH	ECO-V		
1	DOOR SWEEP	РЕМКО	3452	MILL FINISH	ECO-V		
1	THRESHOLD	РЕМКО	270	ALUM			
1	KICKPLATE	DIAMOND PLATE SHEET	.06 THICK		32" X 39.5"		
2	SET-02 - WATER CLOSET						
3	HINGES	CAL-ROYAL	BB31	US32D	NRP		
1	CYLINDRICAL LOCKSET	CAL-ROYAL	SL101	US26D			
1	CLOSER	CAL-ROYAL	300	ALUM	PCOV		
1	WEATHER-STRIPPING	РЕМКО	303	MILL FINISH	ECO-V		
1	DOOR SWEEP	РЕМКО	3452	MILL FINISH	ECO-V		
1	THRESHOLD	РЕМКО	270	ALUM			
1	KICKPLATE	DIAMOND PLATE SHEET	.06 THICK		12" X 34"		
1	SET-03 - OFFICE						
3	HINGES	CAL-ROYAL	BB31	US32D	NRP		
1	CYLINDRICAL LOCKSET	CAL-ROYAL	SL05	US26D			
1	KICKPLATE	DIAMOND PLATE SHEET	.06 THICK		12" X 34"		
1	SET-04 - FRONT						
3	HINGES	CAL-ROYAL	BB31	US32D	NRP		
1	PANIC DEVICE	CAL-ROYAL (OR MARKS USA)	A7700 (OR M9900H)	ALUM			
1	CYLINDRICAL LEVER/ CLUTCH	CAL-ROYAL	ENT-00L	US26D			
1	CLOSER	CAL-ROYAL	300	ALUM	PCOV		
1	WEATHER-STRIPPING	РЕМКО	303	MILL FINISH	ECO-V		
1	DOOR SWEEP	РЕМКО	3452	MILL FINISH	ECO-V		
1	THRESHOLD	РЕМКО	270	ALUM			
1	KICKPLATE	DIAMOND PLATE SHEET	.06 THICK		12" X 34"		

3. ALL DOOR HANDLES, PULLS, LATCHES, LOCKS, AND/OR OTHER OPERATING DEVICES SHALL BE INSTALLED BETWEEN 34" MIN. AND 48" MAXIMUM ABOVE FINISHED FLOOR.

DOOR, FRAME	Ξ, & H	ARDWARE	SCHEDULE AS	SHOWN	I OR	EQU	IIVALEN'	Τ		DIVISION 8
DOOR						FRAN	ИΕ		SET	REMARKS
	NO.	SIZE	R.O. SIZE	MATERIAL	FINISH	TYPE	MATERIAL	FINISH	NO.	
OFFICE DOOR (1)	100.4	3'-0" x 6'-8" x 1 3/4" W/ LT KIT & GLASS 1'-11 1/2" X 2'-6"	DOOR WIDTH + 1-1/4" X DOOR HEIGHT + 5/8"	H.M.	PT	F1	H.M.	РТ	03	1,2,3 U=.35 MAX
FRONT DOOR (1)	101.1	3'-0" x 7' x 1 3/4" W/ LT KIT & GLASS 10" X 10"	DOOR WIDTH + 1-1/4" X DOOR HEIGHT + 5/8"	H.M.	PT	F1	H.M.	PT	04	1,2,3 U=.35 MAX
BATHROOM DOOR (2)	101.2	3'-0" x 6'-8" x 1 3/4"	DOOR WIDTH + 1-1/4" X DOOR HEIGHT + 5/8"	H.M.	PT	F1	H.M.	PT	02	1,2,3 U=.35 MAX
REAR DOOR (1)	101.5	3'-6" x 7' x 1 3/4" W/ LT KIT & GLASS 10" X 10"	DOOR WIDTH + 1-1/4" X DOOR HEIGHT + 5/8"	H.M.	PT	F1	H.M.	PT	01	1,2,3 U=.35 MAX
	DO	OR TYPES						FRA	ME	TYPES

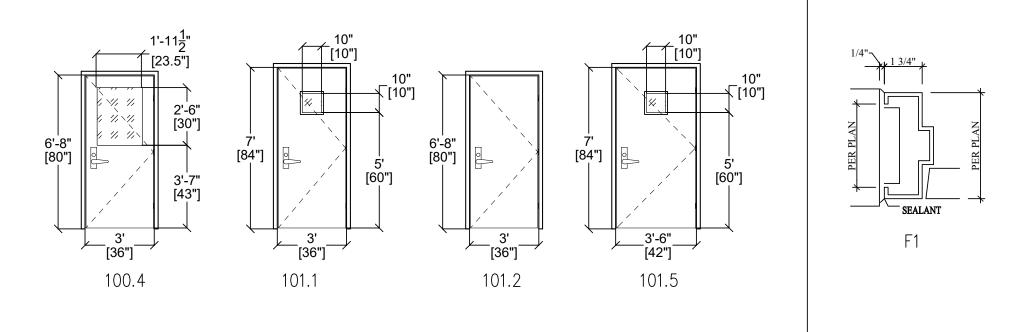

GENERAL NOTES DOOR REMARKS LEGEND

UNDER CUT DOOR 5/8"

INSULATED, GALVANIZED HOLLOW METAL DOOR AND FRAME.

DAYBAR DELTA R-7 HURRICANE UP TO 75PSF

- THE BUILDING MANUFACTURER SHALL COORDINATE ALL WORK WITH RESPECTIVE TRADES, BUILDING / FIRE / HEALTH OFFICIALS AND OWNER.

- 5. GRADES SHALL BE 2" MIN. BELOW FLOOR SLAB AND SHALL SLOPE AWAY FROM BUILDING @ 5% SLOPE EXCEPT @ PEDESTRIAN PATHS WHICH SHALL BE SLOPED AWAY FROM BUILDING @ { PER FOOT MIN. AND { PER FOOT MAX.
- 7. SEE STRUCTURAL PLAN AND DETAILS FOR ADDITIONAL FRAMING REQUIREMENTS. 8. 1/2" COVER BOARD SHALL BE INSTALLED OVER RIGID INSULATION TYP. ALL ROOF SURFACES. ALL VERTICAL PARAPET WALLS CONSTRUCTED OF CONCRETE MASONRY UNITS SHALL ALSO RECEIVE \(\frac{1}{2} \)" COVER BOARD, TYP.

THIS IS A STATE

APPROVED & INSPECTED

MODULAR BUILDING

MISSOURI PUBLIC SERVICE COMMISSION

APPROVED 04/05/2024 **MANUFACTURED** HOUSING


CODED NOTES

DATE ISSUED:

REVISION/UPLOAD DATE REV. DATE DESCRIPTION

LART DESIGN BULLETIN HUNL DATE DESCRIPTION

2 LIGEB 2.

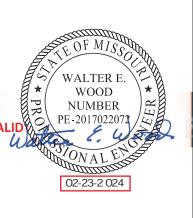



DOOR AND WINDOW SCHEDULE

DRAWING NUMBER:

4. ALL DOOR THRESHOLDS SHALL BE ½" HIGH MAXIMUM . 5. ALL DOOR CLOSERS SHALL BE ADJUSTED SO THAT FROM THE OPEN POSITION OF 70 DEGREES, THE DOOR WILL TAKE AT LEAST 3 SECONDS TO MOVE TO A POINT 3 INCHES FROM THE LATCH, MEASURED TO THE LEAD EDGE.


1. ALL HARDWARE IS NEW (UNLESS NOTED OTHERWISE).

2. ALL DOOR LOCKSETS/LATCHSETS SHALL BE "LEVER TYPE" IN COMPLIANCE WITH TAS 2012.

6. SET-02 - WATER CLOSET - OMIT DOOR CLOSER FOR ONE OF THE BATHROOMS TO COMPLY WITH ADA.

HARDWARE SCHEDULE NOTES:

WINDOW ELEVATIONS ELEVATIONS CODED NOTES

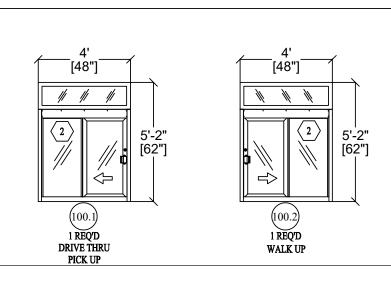

- (GL-1): 1" INSULATED GLAZING PANEL, CLEAR GLASS
- (GL-2): 1" INSULATED GLAZING PANEL, CLEAR TEMPERED GLASS
- (GL-3): 1" INSULATED GLAZING PANEL, CLEAR STORM IMPACT GLASS

MARK ROUGH OPENING SIZE TYPE CONSTRUCTION GLASS TYPE HEAD HEIGHT REMARKS TOO.1 4'W + \$' × 4'H + \$' IFSC - 4040 - B - R ALUM. GL-2 7'-11\$" DARK BRONZE ANODIZED (CLASS II, .4 MILS MINIMUM) F												
MARK		TYPE	CONSTRUCTION	1		REMARKS						
100.1	4'W + ½" × 4'H + ½"	QUICK SERV IFSC — 4040 — B — R MODEL: 181	ALUM.	GL-2	7'-11 ‡ "	DARK BRONZE ANODIZED (CLASS II, .4 MILS MINIMUM) FINISH, U=.30 MAX, SHGC=28 MAX						
100.2	4'W + ½" × 4'H + ½"	QUICK SERV IFSC — 4040 — B — L MODEL: 180	ALUM.	GL-2	7'-11 ‡ "	DARK BRONZE ANODIZED (CLASS II, .4 MILS MINIMUM) FINISH, U=.30 MAX, SHGC=28 MAX						

WINDOW SCHEDULE NOTES:

- 1. REFER TO WINDOW ELEVATIONS FOR SPECIFIC DIMENSIONS AND ADDITIONAL DETAIL INFORMATION.
- 2. WINDOW CONTRACTOR SHALL FIELD VERIFY ALL ROUGH OPENINGS FOR ALL WINDOWS PRIOR TO PREPARATION OF SHOP DRAWINGS.
- 3. IF VELOCITY WIND SPEEDS ARE EQUAL TO OR GREATER THAN 140 MPH OR INSTALL LOCATION IS WITHIN A MILE OF THE COAST, STORM IMPACT GLASS WILL BE USED.

DEFINE

DESIGN

DELIVER

VARIABLE REFRIGERANT FLOW

DIRECTIONS. (4-WAY GRILLE)

WATER PRESSURE DROP

WET BULB

WATER GAGE

	MECHANICAL	. ABB	REVIATIONS
AD	ACCESS DOOR	HWS	HEATING HOT WATER SUPPLY
ADA	AMERICANS WITH DISABILITIES ACT	HWR	HEATING HOT WATER RETURN
AFF	ABOVE FINISHED FLOOR	KH	KITCHEN HOOD
AHU	AIR HANDLING UNIT	KW	KILOWATT
APD	AIR PRESSURE DROP	LAT	LEAVING AIR TEMPERATURE
3OD	BOTTOM OF DUCT	LWT	LEAVING WATER TEMPERATURE
30P	BOTTOM OF PIPE	МВН	1000 BRITISH THERMAL UNITS PER HOU
BTUH	BRITISH THERMAL UNITS PER HOUR	MVD	MANUAL VOLUME DAMPER
0	CONDENSATE	N.O.	NORMALLY OPEN
CFM	CUBIC FEET PER MINUTE	N.C.	NORMALLY CLOSED
СТ	CHILLER	NTS	NOT TO SCALE
CHS	CHILLED WATER SUPPLY	NC	NOISE CRITERIA
CHR	CHILLED WATER RETURN	OA	OUTSIDE AIR
COP	COEFFICIENT OF PERFORMANCE	OBD	OPPOSED BLADE DAMPER
СТ	COOLING TOWER	PD	PRESSURE DROP
CU	CONDENSING UNIT	PHWR	PLANT HEATING HOT WATER RETURN
CV	CONSTANT VOLUME	PHWS	PLANT HEATING HOT WATER SUPPLY
CS	CONDENSER WATER SUPPLY	PRV	PRESSURE REDUCING VALVE
CR	CONDENSER WATER RETURN	PSIG	POUNDS PER SQUARE INCH GAGE
ОВ	DRY BULB	RA	RETURN AIR
DOAS	DEDICATED 100% OUTSIDE AIR UNIT	RH	RELATIVE HUMIDITY
ΞA	EXHAUST AIR	RHC	REHEAT COIL
EAT	ENTERING AIR TEMPERATURE	RPM	REVOLUTIONS PER MINUTE
ECO	EXTERIOR CLEANOUT	RTU	ROOFTOP A/C UNIT
EDH	ELECTRIC DUCT HEATER	SA	SUPPLY AIR
EER	ENERGY EFFICIENCY RATIO	SD	STORM DRAIN
ΞF	EXHAUST FAN	SEER	SEASONAL ENERGY EFFICIENCY RATIO
EMS	ENERGY MANAGEMENT SYSTEM	SF	SUPPLY FAN
ESP	EXTERNAL STATIC PRESSURE	SP	STATIC PRESSURE
EUH	ELECTRIC UNIT HEATER	SWR	SIDE WALL REGISTER
EWC	ELECTRIC WATER COOLER	TSP	TOTAL STATIC PRESSURE
EWH	ELECTRIC WATER HEATER	TYP	TYPICAL
EWT	ENTERING WATER TEMPERATURE	UNO	UNLESS NOTED OTHERWISE
=	FAHRENHEIT	VAV	VARIABLE AIR VOLUME
-co	FLOOR CLEANOUT	VFD	VARIABLE FREQUENCY DRIVE
		I	

WB

WG

FLOOR DRAIN

FINS PER INCH

HORSEPOWER

FFE

FULL LOAD AMPS

FINISHED FLOOR ELEVATION

MECHANICAL LEGEND

GRILLES	S, REGISTE	RS, DIFFU	ISERS, AND LOUVERS	EQUIPMI	ENT		
EXISTING	DEMO	NEW	DESCRIPTION	EXISTING	DEMO	NEW	DESCRIPTION
		A100	GRILLE DESIGNATION AND CFM		[]		MECHANICAL EQUIPMENT. REFER TO SCHEDULES
<u> </u>	5.2	5.7	OUDEAGE MOUNT	7	<u>P</u>	7	IONIZATION UNIT
→ □	-23-		SURFACE MOUNT	(SD)	(\$D)	(SD)	SMOKE DETECTOR
<u> </u>			LAY-IN SUPPLY CEILING	MP	MP)	MP	MANUAL PULL STATION
			DIFFUSER	CONTRO	DLS		
	Ĺij →		SUPPLY WALL DIFFUSER	EXISTING	DEMO	NEW	DESCRIPTION
	E====		LINEAR SLOT DIFFUSER	Ī	(Ī)	①	THERMOSTAT
1	555 555 555 555 555 555 555 555 555 55	<u> </u>	RETURN/EXHAUST CEILING GRILLE	\oplus	(H)	Θ	HUMIDISTAT
	[RETURN/EXHAUST WALL GRILLE	(S)	(<u>\$</u>)	<u>\$</u>	SENSOR
			EXHAUST LOUVER	P	(P)	P	STATIC PRESSURE SENSOR
□ - ✓-	□ ~~	□ →-	EXHAUST WALL CAP	RS	(RS)	RS	REMOTE TEMPERATURE SENSOR
			GRAVITY RELIEF HOOD	\$	\$	\$	WALL SWITCH
		·	INTAKE LOUVER				CONTROL WIRING
<u> </u>		□ → ~	INTAKE WALL CAP				
			GRAVITY INTAKE HOOD				
DUCTWO	ORK						
EXISTING	DEMO	NEW	DESCRIPTION				
	<u> </u>		RECTANGULAR DUCTWORK. REFER TO PLANS FOR SIZE.				
\\	├ ┤	├	ROUND DUCTWORK. REFER TO PLANS FOR SIZE.				
\	├ ⇒	}	ROUND DUCTWORK DROP/RISE.				
	F-Tx3		DUCT DROP/RISE				
PIPING							
EXISTING	DEMO	NEW	DESCRIPTION				
—cws—	CWS	—cws—	CHILLED WATER SUPPLY PIPING				
—CWR—	CWR	—CWR—	CHILLED WATER RETURN PIPING				
—HWS —	HWS	—HWS—	HOT WATER SUPPLY PIPING				
—HWR—	HWR	—HWR—	HOT WATER RETURN PIPING				
— cs —	CS	— cs —	CONDENSER WATER SUPPLY PIPING				
— CR —	CR	— CR —	CONDENSER WATER RETURN PIPING				
DAMPER	RS						
EXISTING	DEMO	NEW	DESCRIPTION				
	ø		BALANCING DAMPER				
-≠M	- ø-{M)	- ≠ (M)	MOTORIZED DAMPER				
FD	ŪFD	0 _{FD}	FIRE DAMPER				
SD	[∏] SD	I _{sd}	SMOKE DAMPER				
FDSD	FDSD	FDSD	FIRE & SMOKE DAMPER				

NOTES: 1. EXISTING ITEMS ON DEMO PLANS ARE "EXISTING TO REMAIN" UNLESS NOTED "EXISTING TO BE RELOCATED.

3. REFER TO SCHEDULES FOR GRILLE, REGISTER, DIFFUSER, AND LOUVER SIZES.

6. NOT ALL ITEMS SHOWN ON THIS LIST MAY BE APPLICABLE TO THIS PROJECT.

5. WALL MOUNTED CONTROL DEVICES SHALL BE MOUNTED AT 48" A.F.F.

2. ITEMS ON NEW CONSTRUCTION PLANS ARE NEW UNLESS NOTED "RELOCATED FROM PREVIOUS LOCATION".

4. REFER TO DRAWINGS FOR DIRECTION OF AIRFLOW FOR DIFFUSERS. IF DIRECTIONAL ARROWS ARE NOT INCLUDED, AIRFLOW IS IN FOUR

MECHANICAL GENERAL NOTES

- CONTRACTOR SHALL VISIT THE SITE AND DETERMINE THE EXTENT OF DEMOLITION WORK AND NEW WORK NEEDED FOR THIS PROJECT, PRIOR TO SUBMITTING BID.
- 2. CONTRACTOR SHALL BECOME FAMILIAR WITH THE PROJECT SCOPE, CONSTRAINTS, UTILITY CONNECTIONS, AND BUILDING SERVICES, PRIOR TO SUBMITTING BID.
- CONTRACTOR SHALL GIVE FIRST RIGHT TO REFUSAL OF SALVAGE TO THE OWNER. IF THE OWNER ELECTS TO NOT KEEP SALVAGE, CONTRACTOR SHALL REMOVE SALVAGE BY LAWFUL
- 4. DRAWINGS ARE SCHEMATIC AND DIAGRAMMATIC IN NATURE. DRAWINGS SHALL NOT BE SCALED. COORDINATE ROUTING OF SERVICES WITH SITE CONDITIONS AND WITH WORK OF
- 5. FIELD VERIFY DIMENSIONS PRIOR TO ORDERING, FABRICATING, AND ERECTION OF MATERIAL AND/OR EQUIPMENT. NOTIFY THE ENGINEER OF DISCREPANCIES IN A TIMELY MANNER.
- 6. VERIFY CLEARANCE REQUIREMENTS AND ROUTING OF DUCTWORK AND PIPING PRIOR TO PIPING, SPRINKLER, DUCTWORK, ELECTRICAL, ETC. AS SHOWN ON THE DRAWINGS OR REQUIRED TO COMPLETE THE INSTALLATION OF A COMPLETED WORKABLE SYSTEM.
- MAINTAIN WEATHER-TIGHT BARRIERS TO PREVENT DAMAGE FROM THE ELEMENTS DURING DEMOLITION AND NEW CONSTRUCTION PERIOD.
- 8. SEAL PENETRATIONS THROUGH THE BUILDING ENVELOPE.
- 9. PENETRATIONS THROUGH RATED WALLS, FLOORS, PARTITIONS AND ASSEMBLIES SHALL BE INSTALLED AND FIRESAFED TO MEET UL. FIRE RESISTANCE LISTING AND NFPA EQUIREMENTS FOR THE PENETRATION.
- 10. COORDINATE DEVICES REQUIRING ACCESS PANELS WITH THE ARCHITECT AND OTHER TRADES.COORDINATE DEVICES REQUIRING ACCESS PANELS WITH THE ARCHITECT AND OTHER
- 11. MAINTAIN MINIMUM CLEARANCE 10'-0" BETWEEN OUTSIDE INTAKES AND EXHAUST OUTLETS AND PLUMBING VENTS.
- 12. COORDINATE FINAL LOCATIONS AND ELEVATIONS WITH THE ARCHITECT PRIOR TO INSTALLATION.
- 13. COORDINATE FINAL FINISH COLORS OF MATERIALS, DEVICES, DIFFUSER, GRILLES, LOUVERS, AND/OR EQUIPMENT WITH THE ARCHITECT PRIOR TO ORDERING, FABRICATION AND INSTALLATION.
- 14. SCHEDULE UTILITY SERVICES SHUTDOWNS WITH OWNER AND ARCHITECT. MINIMIZE DISRUPTIONS AND DOWNTIME TO THE OWNER.
- 15. INSTALL DEVICES AND EQUIPMENT TO MEET ADA REQUIREMENTS.
- ROUTE DUCT AND PIPING CONCEALED IN INTERSTITIAL SPACE UNLESS NOTED OTHERWISE.
- 17. DOCUMENT LOCATIONS OF DEVICES, DUCT, PIPING, AND EQUIPMENT ON "AS-BUILT" RECORD DRAWINGS AS PER THE SPECIFICATIONS.
- 18. PAY FOR SERVICE, DEPOSITS, INSPECTION, AND CONNECTION FEES REQUIRED FOR A COMPLETE INSTALLATION. COORDINATE WITH THE UTILITY SERVICE PROVIDER FOR THE REQUIREMENTS NEEDED FOR THIS PROJECT.
- 19. HVAC SYSTEMS SHALL BE CONSTRUCTED IN ACCORDANCE WITH NFPA 90A AND NFPA 101.
- 20. WORK SHOWN IN THE DRAWINGS SHALL COMPLY WITH APPLICABLE NATIONAL, STATE, AND LOCAL ORDINANCES AND CODES.


MISSOURI PUBLIC SERVICE COMMISSION **APPROVED** 04/05/2024 **MANUFACTURED**

HOUSING

THIS IS A STATE APPROVED & INSPECTED MODULAR BUILDING

LAST DESIGN BULLETIN UM. DATE DESCRIPTION

ENGINEER

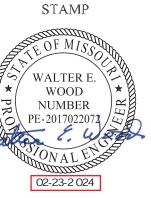

Third Party: HWC & Asc. In 1627 SouthMyrtle Ave. Clearwater, Fl. 34616 (717)-584-8151



SHEET NAME

MECHANICAL LEGEND

HVAC DUCTWORK INSULATION:

LOW PRESSURE SUPPLY, RETURN, OUTSIDE AIR, AND EXHAUST TYPE DUCTS SHALL BE WRAPPED ON OUTSIDE WITH 2.125" MINIMUM THICKNESS, 3/4# DENSITY, MINIMUM INSTALLED R-VALUE OF R-6.0, FIBERGLASS INSULATION WITH ALUMINUM FOIL VAPOR BARRIER. INSULATION SHALL BE TAPED AT ALL JOINTS AND INSTALLED PER THE MANUFACTURER'S RECOMMENDATIONS.

SECURE INSULATION WITH VAPOR BARRIER AND SEAL JACKET JOINTS WITH VAPOR BARRIER ADHESIVE OR TAPE TO MATCH JACKET. INSTALL WITHOUT SAG ON UNDERSIDE OF DUCTWORK. USE 4"WIDE STRIPS OF ADHESIVE (FOSTER 85-60 OR CHILDERS CP-127 WATER BASED ADHESIVE) ON 8 INCH CENTERS OR MECHANICAL FASTENERS 12" ON CENTER TO PREVENT SAGGING. SEAL VAPOR BARRIER PENETRATIONS BY MECHANICAL FASTENERS WITH VAPOR BARRIER ADHESIVE. STOP AND POINT INSULATION AROUND ACCESS DOORS AND DAMPER OPERATORS TO ALLOW OPERATION WITHOUT DISTURBING WRAPPING. COVER SEAMS, JOINTS, PIN PENETRATIONS AND OTHER BREAKS WITH FOSTER 30-65 OR CHILDERS CP-34 VAPOR BARRIER COATING REINFORCED WITH REINFORCED GLASS CLOTH. REINFORCING MESH SHALL BE FOSTER MAST A FAB OR CHILDERS CHIL GLAS #10.

INSULATION SHALL HAVE A MINIMUM R-VALUE OF R-6 IF LOCATED IN AN UNCONDITIONED SPACE OR R-8 IF LOCATED OUTSIDE OF BUILDING.

LOW PRESSURE DUCTWORK:

ALL DUCTWORK SHALL BE GALVANIZED STEEL AND SHALL BE OF GAUGES AND CONSTRUCTION AS RECOMMENDED BY ASHRAE GUIDE AND DATA BOOK. GAUGES ARE AS FOLLOWS, WITH LONGEST SIDE GOVERNING. (DUCT DIMENSIONS ON PLANS ARE METAL-TO-METAL

DIMENSIONS OF LONGEST SIDE: SHEET METAL GAUGE:

13" TO 30" 24 GAUGE 31" TO 54" 22 GAUGE 55" TO 84" 20 GAUGE

ALL DUCTWORK SHALL BE SEALED AT SEAMS AND JOINTS WITH TAPE AND HARDCAST DUCT SEALANT MATERIAL

JOINTS AND REINFORCING SHALL BE AS PER ASHRAE GUIDE AND DATA BOOK AND ALL SLIPS SHALL BE INSTALLED WITHOUT EDGE OF INTERNAL PART OF SLIP FACING DOWNSTREAM.

CONSTRUCTION STANDARDS OF ARTICLE 110 OF THE NATIONAL BOARD OF FIRE UNDERWRITERS, BULLETIN 90, LATEST EDITION, SHALL APPLY THROUGHOUT.

FLASHINGS SHALL BE SHEET COPPER OR GALVANIZED SHEET METAL, AND SHALL BE FURNISHED AND INSTALLED AROUND ALL OUTSIDE OPENINGS USED FOR DUCTS OF FANS AND WHEREVER REQUIRED. ROOF FLASHINGS SHALL EXTEND AT LEAST 8" ABOVE ROOF. PROVIDE 1/16" THICK RUBBER GASKET MATERIAL BETWEEN FLASHING AND FAN HOUSING AND OR SHEET METAL DUCTWORK. PROVIDE SEPARATION OF DISSIMILAR MATERIALS WITH DIE-ELECTRIC MATERIAL CONNECTION.

ALL DUCTS SHALL BE STRAIGHT AND TRUE AND INSTALLED IN A NEAT AND WORKMANLIKE MANNER.

ALL EDGES SHALL BE STRAIGHT AND TRUE, AND ALL BENDS SHALL BE MADE WITH VANED TURNS. WHERE LONG RADIUS TURNS CANNOT BE USED, THE CONTRACTOR SHALL USE SQUARE TURNS AND USE AIR SPLITTERS SPACED NOT MORE THAN 3" CENTER TO CENTER, AND OF A LENGTH SO AIR WILL BE PROPERLY DISTRIBUTED OVER THE DUCTS.

PROVIDE PAINT GRIP SHEET METAL WHERE INDICATED ON PLANS.

ROUND DUCTWORK:

SHALL BE CONSTRUCTED OF 26 GAUGE GALVANIZED SHEET METAL WITH SCREWED AND TAPED JOINTS.

AT CONTRACTOR'S OPTION, PRE-INSULATED FLEXIBLE DUCTWORK AS MANUFACTURED BY THERMAFLEX MODEL MKE, FLEXMASTER 8M OR PRIOR APPROVED EQUIVALENT (MANUFACTURERS LITERATURE AND SAMPLE WILL BE REQUIRED FOR PRIOR APPROVAL) MAY BE USED TO CONNECT TO CEILING DIFFUSERS (MAXIMUM 5'-0" LENGTH). FLEXIBLE DUCTWORK SHALL BE INSTALLED IN ACCORDANCE WITH MANUFACTURERS RECOMMENDED INSTALLATION INSTRUCTIONS. INNER AND OUTER LINER SHALL BE PROPERLY SEALED AND SECURED.

SPIN COLLARS:

ALL ROUND TAKE-OFFS TO ROUND BRANCH DUCT SHALL BE MADE WITH FACTORY FABRICATED SPIN-TYPE COLLAR FITTINGS WITH BALANCING DAMPER AND CONSTRUCTED OF MINIMUM 26 GA GALVANIZED STEEL. THE DAMPER SHALL HAVE A RAISED 2" HANDLE WITH A HIGH QUALITY LOCKING QUADRANT. A 3/8" CONTINUOUS ROD WITH "U" BOLTS CONNECTS THE DAMPER TO THE ROD. NYLON END BEARING ARE REQUIRED WHERE THE ROD PENETRATES THE SPIN COLLAR BARREL. THESE SPIN-COLLARS SHALL BE AS MANUFACTURED BY FLEXMASTER MODEL FLD-B03, DACE #26GA MSD-C03 OR APPROVED EQUAL.

<u>DUCTWORK SEALANT</u>:

ALL DUCTWORK SHALL BE AIR TIGHT. ALL SEAMS, BOTH SHOP MADE AND FIELD INSTALLED, AND SHALL BE SEALED WITH MASTIC. ALL TRANSVERSE JOINTS SHALL BE SEALED AS WELL AS SPIN COLLAR TAKEOFFS AND ROUGH DUCT CONNECTIONS. ALL DUCT CONNECTIONS AND SEAMS SHALL BE SEALED WITH A UL APPROVED NON-FLAMMABLE MASTIC SYSTEM. STRICT ADHERENCE TO MANUFACTURERS INSTALLATION INSTRUCTION IS REQUIRED. THE DUCT SEALANT SHALL BE EQUAL TO HARDCAST SURE-GRIP 404, UNITED MCGILL SOLVENT BASED DUCT SEALANT, OR PRIOR APPROVED DUCT SEALING SYSTEM. IN RETURN AIR PLENUM SPACES, ALL SURFACES SHALL BE RATED FOR 25/50 FLAME SPREAD AND SMOKE DEVELOPMENT.

ALL LOW PRESSURE DUCTWORK SHALL BE SEALED TO "SEAL CLASS A". SEAL CLASS A IS TRANSVERSE JOINTS AND SEAMS AND WALL PENETRATIONS (SENSORS).

MOTORIZED DAMPERS : (RECTANGULAR TYPE DAMPERS)

MECHANICAL CONTRACTOR SHALL FURNISH AND INSTALL MOTORIZED DAMPERS AT OUTDOOR INTAKES AS INDICATED ON MECHANICAL AND ARCHITECTURAL DRAWINGS. DAMPER SHALL BE PARALLEL BLADE MOTORIZED TYPE EQUIVALENT TO RUSKIN CD36/PB, ARROW SERIES 1770, GREENHECK MODEL VCD-23 OR EQUAL. MOTORIZED DAMPERS SHALL BE OPERATED BY 120/1/60 ELECTRIC ACTUATORS PROVIDED BY THE TEMPERATURE CONTROL CONTRACTOR OR 120/1/60 ELECTRIC ACTUATOR AS INDICATED ON PLANS. DAMPER SHALL BE COMPLETE WITH OUTBOARD SUPPORT BEARING, BLADE AND JAMB SEALS. DAMPERS SHALL BE LOW - LEAKAGE TYPE.

MANUAL DAMPERS:

MECHANICAL CONTRACTOR SHALL FURNISH AND INSTALL MANUAL DAMPERS AT OUTDOOR AIR INTAKES AND IN OTHER RECTANGULAR DUCTWORK AS INDICATED ON PLANS. DAMPER SHALL BE COMPLETE WITH OUTBOARD SUPPORT BEARING, AND MANUAL LOCKING QUADRANT LEVER FOR BALANCING. DAMPERS SHALL BE MANUFACTURED BY RUSKIN MODEL MD25, GREENHECK MODEL MBD-10M OR PRIOR APPROVED EQUAL.

VENTILATING SYSTEM:

THIS CONTRACTOR SHALL FURNISH AND INSTALL ALL EXHAUST FANS SHOWN AND SCHEDULED ON PLANS. FANS SHALL BE OF THE TYPE INDICATED AND SHALL BE CAPTIVEAIRE, COOK, GREENHECK, ACME OR APPROVED EQUIVALENT.

ALL EXHAUST FANS SHALL BE EQUIPPED WITH BIRD SCREEN, AUTOMATIC BACK-DRAFT DAMPERS, SOLID STATE SPEED CONTROLLER (DIRECT DRIVE) AND INTEGRAL DISCONNECT SWITCH UNLESS NOTED OTHERWISE. FAN MOTORS SHALL BE OF THE 40 DEG C AMBIENT TEMPERATURE RISE TYPE AND SHALL BE SUITABLE FOR CONTINUOUS DUTY OPERATION.

DIRECT DRIVE FANS SHALL BE COMPLETE WITH SOLID STATE SPEED CONTROL SWITCH MOUNTED ON UNIT FOR BALANCING. INTERLOCK WITH REMOTE ON/OFF SWITCH.

THERMOSTAT:

PROVIDE <u>FULLY AUTOMATIC</u> PROGRAMMABLE (7 DAY) ROOM TYPE THERMOSTAT AS INDICATED ON PLANS TO CYCLE COMPRESSOR ON COOLING CYCLE, AND COMPRESSOR AND/OR ELECTRIC STRIPS IN STAGES ON HEATING CYCLE AS REQUIRED TO MAINTAIN SPACE CONDITIONS. UNIT SHALL BE WIRED FOR CONSTANT OR AUTOMATIC FAN OPERATION AND SHALL BE ELECTRICALLY INTERLOCKED SUCH THAT THE COMPRESSOR MAY NOT RUN NOR THE ELECTRIC STRIP HEATERS BE ENERGIZED UNLESS THE EVAPORATOR FAN IS OPERATING. THERMOSTAT SHALL BE COMPLETE WITH FAN "AUTO-ON" SWITCH AND SYSTEM "AUTO-HEAT-OFF-COOL" SWITCH. THERMOSTATS SHALL BE MOUNTED TO MEET LATEST A.D.A. REQUIREMENTS.

SMOKE DETECTOR:

THE MECHANICAL CONTRACTOR SHALL FURNISH AND INSTALL A SMOKE DETECTOR IN THE SUPPLY DUCT AND RETURN DUCT OF ALL AIR HANDLERS DELIVERING IN EXCESS OF 2000 C.F.M. AND SHALL BE INTERLOCKED TO DE-ENERGIZE FAN ON ACTUATION OF DETECTOR.

SMOKE DETECTORS SHALL HAVE AUXILIARY CONTACTS FOR INTERLOCK WITH THE FIRE ALARM SYSTEM. COORDINATE INSTALLATION AND SELECTION OF SMOKE DETECTORS. ENTIRE INSTALLATION SHALL MEET UL REQUIREMENTS FOR INTERLOCK WITH BUILDING FIRE ALARM AND SECURITY SYSTEM.

PROVIDE REMOTE AUDIBLE AND VISUAL ALARM UNIT (ONE PER AHU WITH SMOKE DETECTOR) IN ACCORDANCE WITH LATEST N.F.P.A. 90A REQUIREMENTS.

DUAL-CHAMBER, IONIZATION SMOKE DETECTORS: THE COMBINATION DETECTOR HEAD AND TWIST-LOCK BASE SHALL BE UL LISTED COMPATIBLE WITH A UL LISTED FIRE ALARM PANEL.

THE SMOKE DETECTOR SHALL HAVE A FLASHING STATUS INDICATION LED OR VISUAL SUPERVISION. WHEN THE DETECTOR IS ACTUATED, THE FLASHING LED SHALL LATCH ON STEADY AND AT FULL BRILLIANCE. THE DETECTOR MAY BE RESET BY ACTIVATING THE CONTROL PANEL RESET SWITCH.

THE SENSITIVITY OF THE DETECTOR SHALL BE MONITORED WITHOUT REMOVAL OF THE DETECTOR HEAD. METERING SETPOINTS SHALL BE ACCESSIBLE ON THE EXTERIOR OF THE DETECTOR HEAD. FIELD ADJUSTMENT THE SENSITIVITY SHALL BE POSSIBLE WHEN CONDITIONS REQUIRE A CHANGE.

IT SHALL BE POSSIBLE TO PERFORM A FUNCTIONAL TEST OF THE DETECTOR WITHOUT THE NEED OF GENERATING SMOKE. THE TEST METHOD MUST SIMULATE EFFECTS OF PRODUCTS OF COMBUSTION IN THE CHAMBER TO ENSURE TESTING OF ALL DETECTOR CIRCUITS.

VOLTAGE AND RF TRANSIENT SUPPRESSION TECHNIQUES SHALL BE EMPLOYED TO MINIMIZE FALSE ALARM POTENTIAL. A GATED ALARM OUTPUT SHALL BE USED FOR ADDITIONAL DETECTOR STABILITY.

AUXILIARY SPDT RELAYS AND/OR REMOTE LED ALARM INDICATORS SHALL BE INSTALLED AS REQUIRED.

DUCT MOUNTED SMOKE DETECTORS SHALL SHUT DOWN THE ASSOCIATED AIR HANDLING UNIT FAN MOTOR AN FIRE/SMOKE DAMPER. THIS CONTRACTOR SHALL PROVIDE ALL EQUIPMENT AND LABOR AS REQUIRED TO ACCOMPLISH SAME

FLOAT SWITCH

PROVIDE FLOAT SWITCH TO EMERGENCY DRAIN PAN OF EACH AHU. SWITCH SHALL BE INTERLOCKED WITH AHU TO DE-ENERGIZE THE UNIT WHEN THE WATER LEVEL IN THE PAN RISES ABOVE A SET LEVEL. FLOAT SWITCH SHALL MEET UL 508 REQUIREMENTS.

MOTORIZED DAMPERS

O.A. MOTORIZED DAMPERS SHALL BE INTERLOCKED WITH THEIR RESPECTIVE UNIT TO OPEN WHEN THE A/C UNIT'S SUPPLY FAN IS ENTERGIZED(ON), AND SHALL CLOSE WHEN THE UNIT'S SUPPLY FAN IS DE-ENETERGIZED(OFF). PROVIDE ALL NECESSARY RELAYS, SWITCHES, TRANSFORMERS, ETC. AS REQUIRED.

MOTORIZED DAMPERS SHALL BE FURNISHED AND SET IN PLACE BY CONTRACTOR INSTALLING THE DOAS UNIT.

DAMPER ACTUATORS SHALL BE 120/1/60 ELECTRIC ACTUATORS SPECIFICALLY SELECTED FOR DAMPER MANUFACTURER'S REQUIREMENTS. CONTROLS CONTRACTOR SHALL FURNISH AND INSTALL ACTUATORS. COORDINATE ALL WORK WITH CONTRACTOR INSTALLING DAMPERS.

CONTROL WIRING

ALL WIRING REQUIRED IN THE CONTROL SYSTEMS, INCLUDING ELECTRICAL CONNECTIONS FOR THE THERMOSTATS, FIRESTATS, SMOKE DETECTORS, EXHAUST FANS AND ALL INTERLOCKING MOTOR CONTROL WIRING SHALL BE FURNISHED AND INSTALLED BY MECHANICAL CONTRACTOR.

ALL WIRING SHALL BE IN CONDUIT AND IN ACCORDANCE WITH THE NATIONAL ELECTRICAL CODE (N.E.C.).

ALL CONTROL WIRING LOCATED OUTDOORS SHALL BE INSTALLED IN RIGID OR INTERMEDIATE METAL CONDUIT.

ALL CONTROL WIRING LOCATED INDOORS WHERE AN ACCESSIBLE CEILING IS NOT AVAILABLE SHALL BE INSTALLED IN E.M.T. CONDUIT.

ALL CONTROL WIRING LOCATED ABOVE ACCESSIBLE CEILINGS SHALL BE N.E.C. APPROVED CABLE. ALL CONTROL WIRING LOCATED ABOVE ACCESSIBLE CEILINGS USED AS AIR PLENUMS SHALL BE N.E.C. APPROVED "PLENUM CABLE".

ALL CONDUCTORS SHALL BE <u>COPPER</u>. CONDUCTORS USED FOR POWER CIRCUITS SHALL BE #12 TW MINIMUM. CONDUCTORS USED FOR CONTROL CIRCUITS SHALL BE #18 TW (SINGLE STRAND) MINIMUM. CONDUCTORS USED FOR SENSOR CIRCUITS SHALL BE #18 TW (SINGLE STRAND) MINIMUM. CONTROL WIRING FOR DX EQUIPMENT THERMOSTATS SHALL BE 10 CONDUCTOR CABLES.

OUTSIDE AIR HANDLING UNIT:

SPECIAL WARRANTY: MANUFACTURER'S STANDARD FORM IN WHICH MANUFACTURER AGREES TO REPLACE COMPONENTS OF RTUS THAT FAIL IN MATERIALS OR WORKMANSHIP WITHIN SPECIFIED WARRANTY PERIOD.

WARRANTY PERIOD FOR COMPRESSORS: MANUFACTURER'S STANDARD, BUT NOT LESS THAN FIVE YEARS FROM DATE OF SUBSTANTIAL COMPLETION.

WARRANTY PERIOD FOR GAS FURNACE HEAT EXCHANGERS: MANUFACTURER'S STANDARD, BUT NOT LESS THAN 10 YEARS FROM DATE OF SUBSTANTIAL COMPLETION.

WARRANTY PERIOD FOR VARIABLE FREQUENCY DRIVES: NOT LESS THAN 24 MONTHS FROM DATE OF SUBSTANTIAL COMPLETION.

RODUCTS

PACKAGED A/C UNIT (MARKED "OAU-1")

ROOF MOUNTED, DOUBLE WALL, ELECTRONICALLY CONTROLLED HEATING AND COOLING UNIT UTILIZING HERMETIC SCROLL COMPRESSORS WITH CRANKCASE HEATERS FOR COOLING DUTY, DUAL REFRIGERANT CIRCUIT, STAGED AIR VOLUME CONTROL, AND WITH ELECTRIC HEAT. UNITS SHALL HAVE HORIZONTAL DISCHARGE SUPPLY AND RETURN AIR AS SHOWN ON DRAWINGS.

MANUFACTURERS SHALL BE ONE OF THE FOLLOWING OR PRIOR APPROVED EQUAL: BASIS OF DESIGN: CAPTIVEAIRE.

RTU CASING

GENERAL FABRICATION REQUIREMENTS FOR CASINGS: FORMED AND REINFORCED DOUBLE-WALL INSULATED PANELS, FABRICATED TO ALLOW REMOVAL FOR ACCESS TO INTERNAL PARTS AND COMPONENTS, WITH JOINTS BETWEEN SECTIONS SEALED.

EXTERIOR CASING MATERIAL: GALVANIZED STEEL WITH FACTORY-PAINTED FINISH, WITH PITCHED ROOF PANELS AND KNOCKOUTS WITH GROMMET SEALS FOR ELECTRICAL AND PIPING CONNECTIONS AND LIFTING LUGS.

EXTERIOR CASING THICKNESS: 0.0626 INCH THICK.

TOP COVER SHALL BE 18 GAGE SHEET METAL WITH 0.75 INCH THICK, 1.5 LB DENSITY, FIBERGLASS INSULATION.

INTERIOR CASING SHALL BE GALVANIZED STEEL INNER PANELS.

CASING INSULATION AND ADHESIVE: COMPLY WITH NFPA 90A OR NFPA 90B.

MATERIALS: ASTM C 1071, TYPE I.

THICKNESS: 1/2 INCH, 1.5 LB DENSITY.

LINER MATERIALS SHALL HAVE AIR-STREAM SURFACE COATED WITH AN EROSION- AND TEMPERATURE-RESISTANT COATING OR FACED WITH A PLAIN OR COATED FIBROUS MAT OR FABRIC.

LINER ADHESIVE: COMPLY WITH ASTM C 916, TYPE I.

CONDENSATE DRAIN PANS: FORMED SECTIONS OF STAINLESS-STEEL SHEET, A MINIMUM OF 2 INCHES DEEP, AND

DOUBLE-WALL CONSTRUCTION: FILL SPACE BETWEEN WALLS WITH FOAM INSULATION AND SEAL MOISTURE TIGHT.
DRAIN CONNECTIONS: THREADED NIPPLE BOTH SIDES OF DRAIN PAN.

RTU FANS

DIRECT-DRIVEN SUPPLY-AIR FANS: DOUBLE WIDTH, FORWARD CURVED, CENTRIFUGAL; WITH PERMANENTLY LUBRICATED, MOTOR RESILIENTLY MOUNTED IN THE FAN INLET. ALUMINUM OR PAINTED-STEEL WHEELS, AND GALVANIZED- OR PAINTED-STEEL FAN SCROLLS.

CONDENSER-COIL FAN: PROPELLER, MOUNTED ON SHAFT OF PERMANENTLY LUBRICATED MOTOR.

FAN MOTOR: COMPLY WITH REQUIREMENTS IN SECTION 230513 "COMMON MOTOR REQUIREMENTS FOR HVAC EQUIPMENT." FANS SHALL BE STATICALLY AND DYNAMICALLY BALANCED.

FAN DRIVE FOR THE STAGED AIR VOLUME UNITS SHALL BE EQUIPPED WITH VARIABLE FREQUENCY DRIVE INVERTER (VFDS). THE VFD SHALL CONTROL MOTOR SPEED TO USER CONFIGURABLE SPEEDS. THE CONTROLS SHALL ALLOW USER CONFIGURABLE SPEEDS FOR COOLING AND HEATING MODES. THE VFD SHALL BE FACTORY-MOUNTED, WIRED, AND TESTED.

RTU COILS

SUPPLY-AIR REFRIGERANT COIL: COPPER-PLATE FIN AND SEAMLESS INTERNALLY GROOVED COPPER TUBE IN STEEL CASING WITH EQUALIZING-TYPE VERTICAL DISTRIBUTOR.

CONDENSATE DRAIN PAN: STAINLESS STEEL FORMED WITH PITCH AND DRAIN CONNECTIONS COMPLYING WITH ASHRAE 62.1.

RTU CIRCUIT COMPONENTS

NUMBER OF REFRIGERANT CIRCUITS: TWO.

COMPRESSOR: HERMETIC, SCROLL, MOUNTED ON VIBRATION ISOLATORS; WITH INTERNAL OVERCURRENT AND HIGH-TEMPERATURE PROTECTION, INTERNAL PRESSURE RELIEF, AND CRANKCASE HEATER. REFRIGERATION SPECIALTIES:

REFRIGERANT: R-410A.

EXPANSION VALVE WITH REPLACEABLE THERMOSTATIC ELEMENT REFRIGERANT FILTER/DRYER.

MANUAL-RESET HIGH-PRESSURE SAFETY SWITCH.

AUTOMATIC-RESET LOW-PRESSURE SAFETY SWITCH.

MINIMUM OFF-TIME RELAY.

AUTOMATIC-RESET COMPRESSOR MOTOR THERMAL OVERLOAD.
BRASS SERVICE VALVES INSTALLED IN COMPRESSOR SUCTION AND LIQUID LINES.
LOW-AMBIENT KIT HIGH-PRESSURE SENSOR.

RTU AIR FILTRATION

MINIMUM ARRESTANCE ACCORDING TO ASHRAE 52.1, AND A MINIMUM EFFICIENCY REPORTING VALUE (MERV) ACCORDING TO ASHRAE 52.2.

PLEATED: MINIMUM 2" THICK DISPOSABLE FIBERGLASS FILTERS WITH 90 PERCENT ARRESTANCE, AND MERV 7.

RTU ELECTRIC HEATER SECTION

PROVIDE AN ELECTRIC RESISTANCE HEATER SECTION WITH CAPACITY AS SCHEDULED ON DRAWINGS.

RTU DAMPERS

OUTDOOR-AIR DAMPER: LINKED DAMPER BLADES, FOR 0 TO 25 PERCENT OUTDOOR AIR, WITH MOTORIZED DAMPER FILTER DAMPER SHALL OPEN WHEN UNIT IS RUNNING AND SHALL CLOSE WHEN FAN IS OFF.

RTU ELECTRICAL POWER CONNECTION

PROVIDE FOR SINGLE CONNECTION OF POWER TO UNIT WITH UNIT-MOUNTED DISCONNECT SWITCH ACCESSIBLE FROM ADJACENT TO OUTSIDE UNIT AND CONTROL-CIRCUIT TRANSFORMER WITH BUILT-IN OVERCURRENT PROTECTION. DO NOT MOUNT DISCONNECT ON OUTDOOR UNIT.

CONTROLS

RTU BASIC UNIT CONTROLS:

CONTROL-VOLTAGE TRANSFORMER.

NON PROGRAMMABLE - WALL-MOUNTED THERMOSTAT OR SENSOR WITH THE FOLLOWING FEATURES:

HEAT-COOL-OFF SWITCH.
FAN ON-AUTO SWITCH.
FAN-SPEED SWITCH.
AUTOMATIC CHANGEOVER.
ADJUSTABLE DEADBAND.
CONCEALED SET POINT.
CONCEALED INDICATION.
DEGREE F INDICATION.
UNOCCUPIED-PERIOD-OVERRIDE PUSH BUTTON.

VARIABLE CAPACITY COMPRESSOR CONTROL:

SUPPLY AIR SENSOR SHALL BE LOCATED IN THE UNIT AND SHALL BE USED FOR COMPRESSOR STAGE CONTROL.

VARIABLE COMPRESSOR CONTROL SHALL BE CAPABLE OF UNLOADING THIS COMPRESSOR IN AN INFINITE NUMBER OF STEPS FROM 100% OF COMPRESSOR CAPACITY DOWN TO 50% OF COMPRESSOR CAPACITY TO MEET THE DEMAND FOR THE STAGED

AIR VOLUME CONTROL.
RTU ACCESSORIES

LOW-AMBIENT KIT USING STAGED CONDENSER FANS FOR OPERATION DOWN TO 35 DEG F.

FILTER DIFFERENTIAL PRESSURE SWITCH WITH SENSOR TUBING ON EITHER SIDE OF FILTER. SET FOR FINAL FILTER PRESSURE

COIL GUARDS OF PAINTED, GALVANIZED-STEEL WIRE

HAIL GUARDS OF GALVANIZED STEEL, PAINTED TO MATCH CASING

HUMIDITY SENSOR.

SECURITY GRILLES.

EQUIPMENT CURB: INSTALL ON CONCRETE BASE, LEVEL AND SECURE. SECURE RTUS TO UPPER CURB RAIL, AND SECURE CURB BASE TO CONCRETE BASE WITH ANCHOR BOLTS.

CONNECTIONS

INSTALLATION

INSTALL CONDENSATE DRAIN, MINIMUM CONNECTION SIZE, WITH TRAP AND INDIRECT CONNECTION TO NEAREST ROOF DRAIN
OR AREA DRAIN

INSTALL PIPING ADJACENT TO RTUS TO ALLOW SERVICE AND MAINTENANCE.

MISSOURI
PUBLIC SERVICE
COMMISSION
APPROVED
04/05/2024
MANUFACTURED

HOUSING

THIS IS A STATE
APPROVED & INSPECTED
MODULAR BUILDING

LAST DESIGN BULLETIN

REVISION/ UPLOAD DATE

LAST DESIGN BULLETIN

UM. DATE DESCRIPTION

TARE
DDULAR, LLC
RMOND BEACH, FL 3217

VALIANT
EST TOWER CIRCLE,

ALIANT

ENGINEER STAMP FOF MISSON

WALTER E.

WOOD
NUMBER
PE-2017022071

Fhird Party: HWC & Asc. Ir 1627 SouthMyrtle Ave. Clearwater, Fl. 34616 (717)-584-8151




SHEET NAME

MECHANICAL SPECIFICATIONS

SHEET NUMBER

M1.2

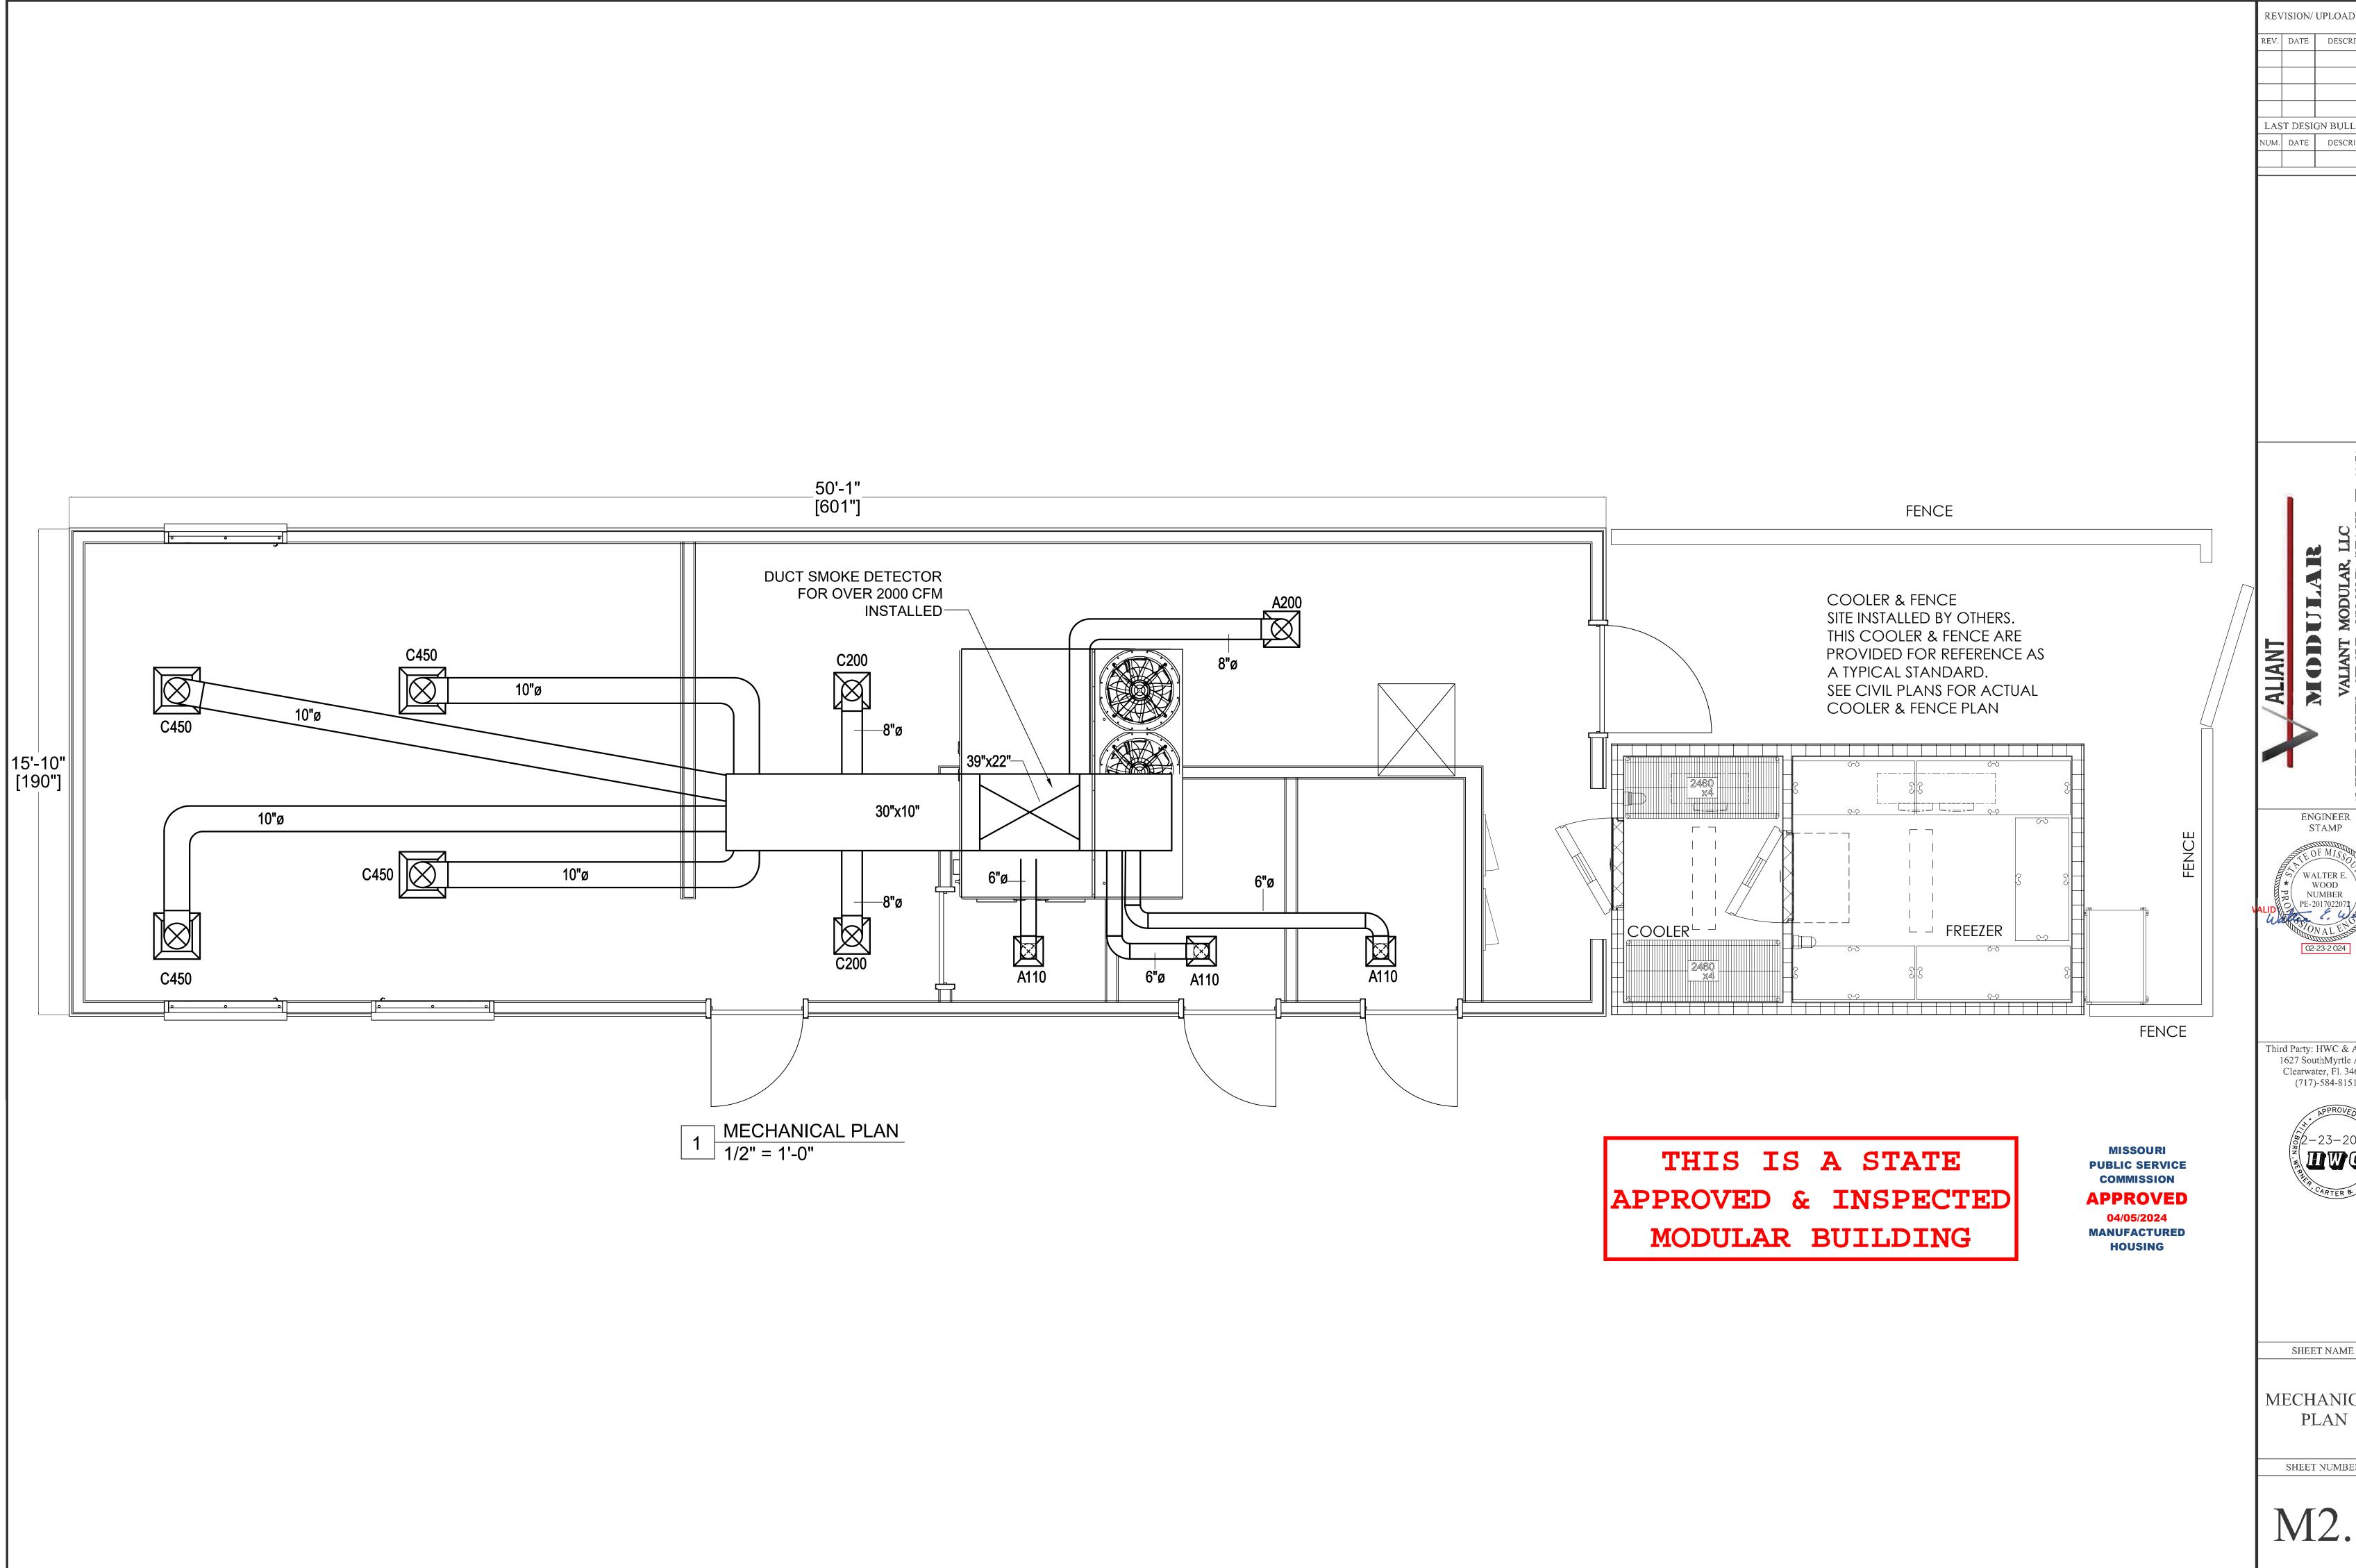


REVISION/ UPLOAD DATE LAST DESIGN BULLETIN
NUM. DATE DESCRIPTION

WALTER E.
WOOD
NUMBER
PE-2017022071

Third Party: HWC & Asc. Inc. 1627 SouthMyrtle Ave. Clearwater, Fl. 34616 (717)-584-8151



MECHANICAL

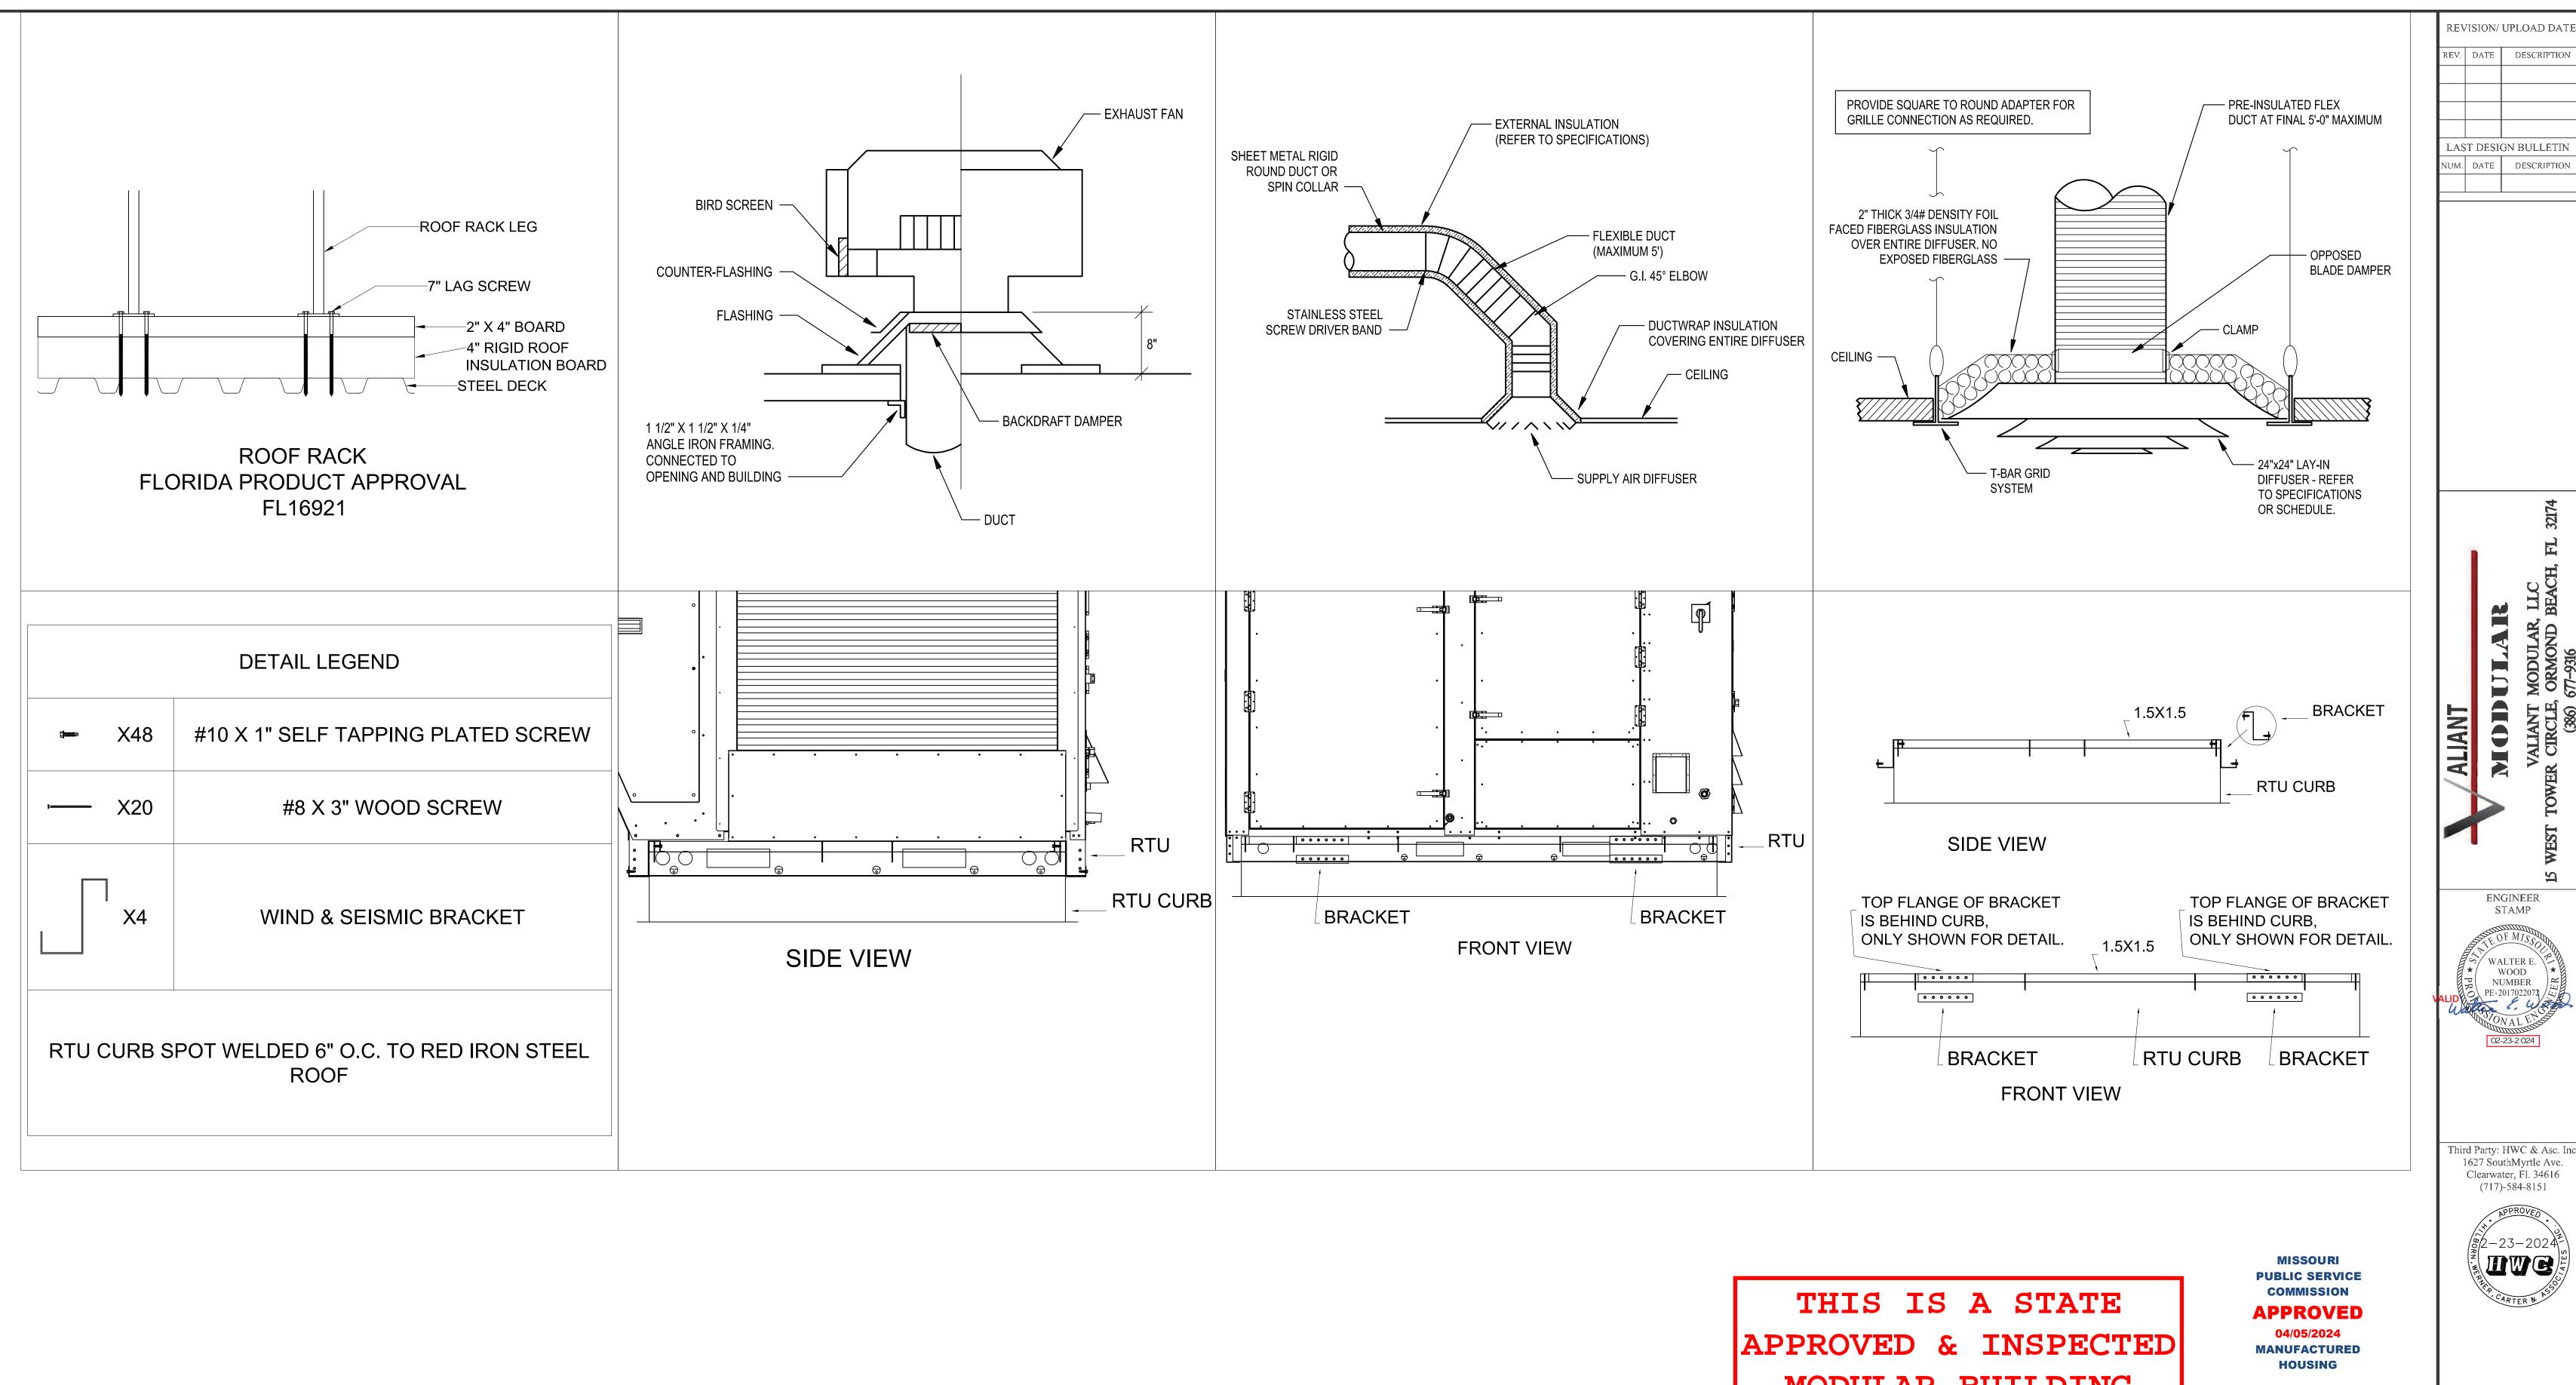

MODULAR BUILDING

REV. DATE DESCRIPTION LAST DESIGN BULLETIN NUM. DATE DESCRIPTION ENGINEER WALTER E.

WOOD

NUMBER


PE-2017022072 Third Party: HWC & Asc. Inc. 1627 SouthMyrtle Ave. Clearwater, Fl. 34616 (717)-584-8151 (g/2-23-2024) SHEET NAME **MECHANICAL SCHEDULE** & DETAILS

SHEET NUMBER


M3.1

H001	D INF	ORMATION		0690															
HOOD NO	TAG	MODEL	MANUFACTURER	LENGTH	MAX COOKING TEMP	TYPE	APPLIANCE DUTY		TOTAL EXH CFM	WIDTH	LENG		ST PL SER(S DIA		VEL	SP	HOOD CONSTRUCTION	HOOD C END TO END	
1		5424 AH-ND-2	ADVANCED HOOD	10′ 6″	450 DEG	I	MEDIUM	190	2000	10″	16"	4"		2000	1800	-1.004"	430 SS WHERE EXPOSED	ALONE	ALONE

HOOD	INF	<u>ORMATION</u>															
				FILTER(<2>			LIGHT(S)					UTILITY CABINET(S)			FIRE	HOOD
HOOD	TAG					EFFICIENCY @ 7			WIRE			FIF	RE SYSTEM	ELECTRICAL	SWITCHES		HANGING
NΠ	140	TYPE	QTY	HEIGHT	LENGTH	MICRONS	QTY	TYPE	GUARD	LOCATION	SIZE	TYPE	SIZE	MODEL #	QUANTITY		WEIGHT
1		CAPTRATE SOLO FILTER	7	16"	16"	85% SEE FILTER	3	L55 SERIES E26	ND	RIGHT	12"×54"×24"	TANK FS	4.0/4.0	SC-311110MA	1 LIGHT	YES	761
		CHITICATE SULU FILTER		16	10	SPEC		LUU SERIES EEB	INL	NIGHT	IL XJ4 XE4	I HIVIN F 3	7.07 4.0	3C SIIIIOMA	1 FAN		LBS

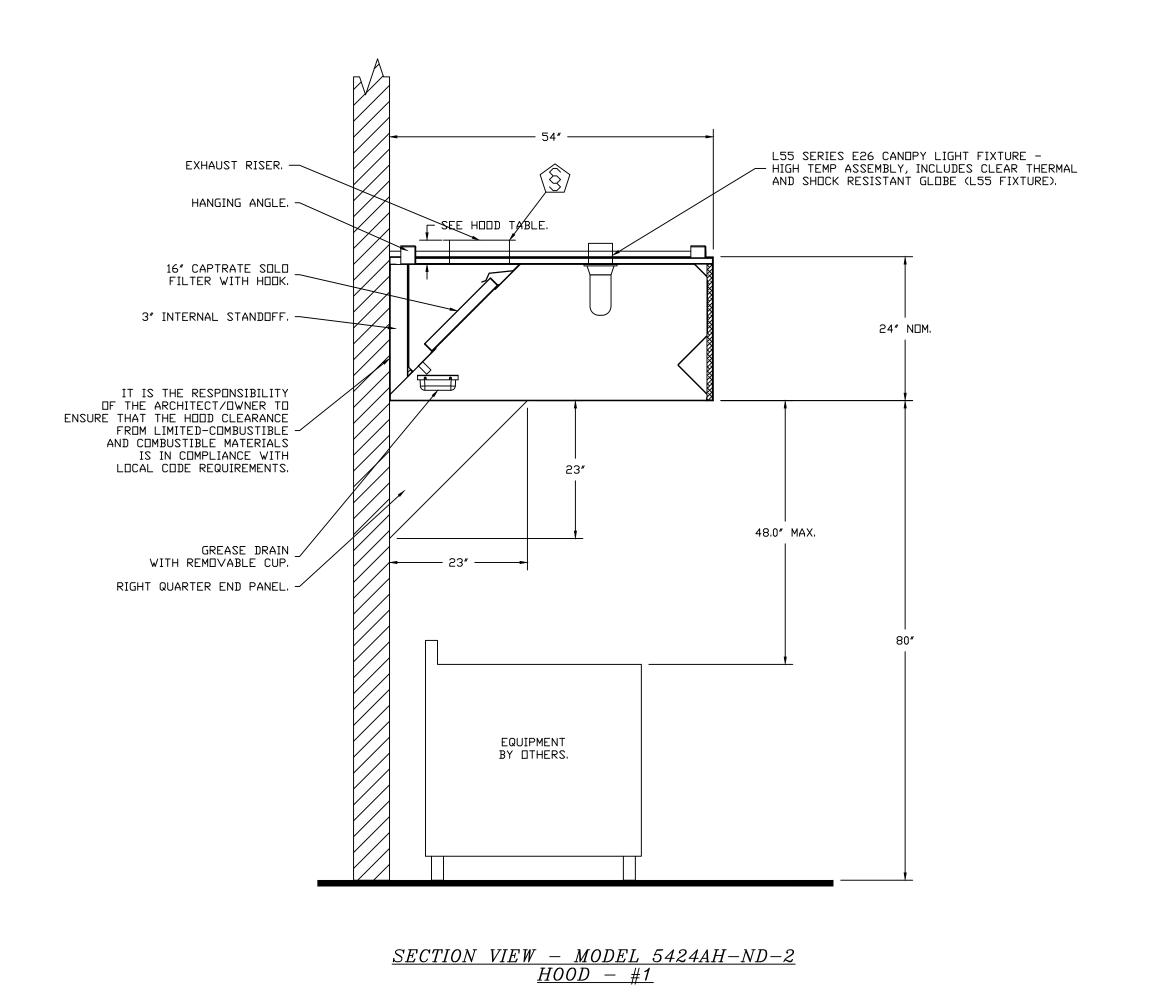

THIS IS A STATE APPROVED & INSPECTED MODULAR BUILDING

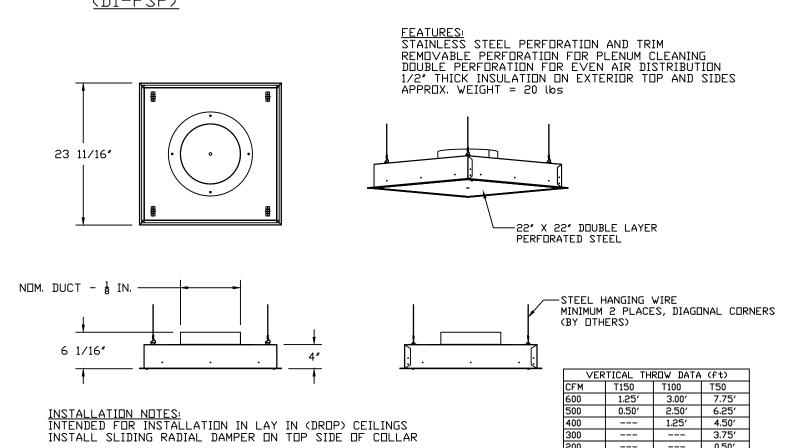






LIDERS $\langle \rangle$

DATE: DWG.#: DRAWN BY:

SCALE: 3/4" = 1'-0" **MASTER DRAWING**

DESCRIPTION DATE:


SHEET NO.

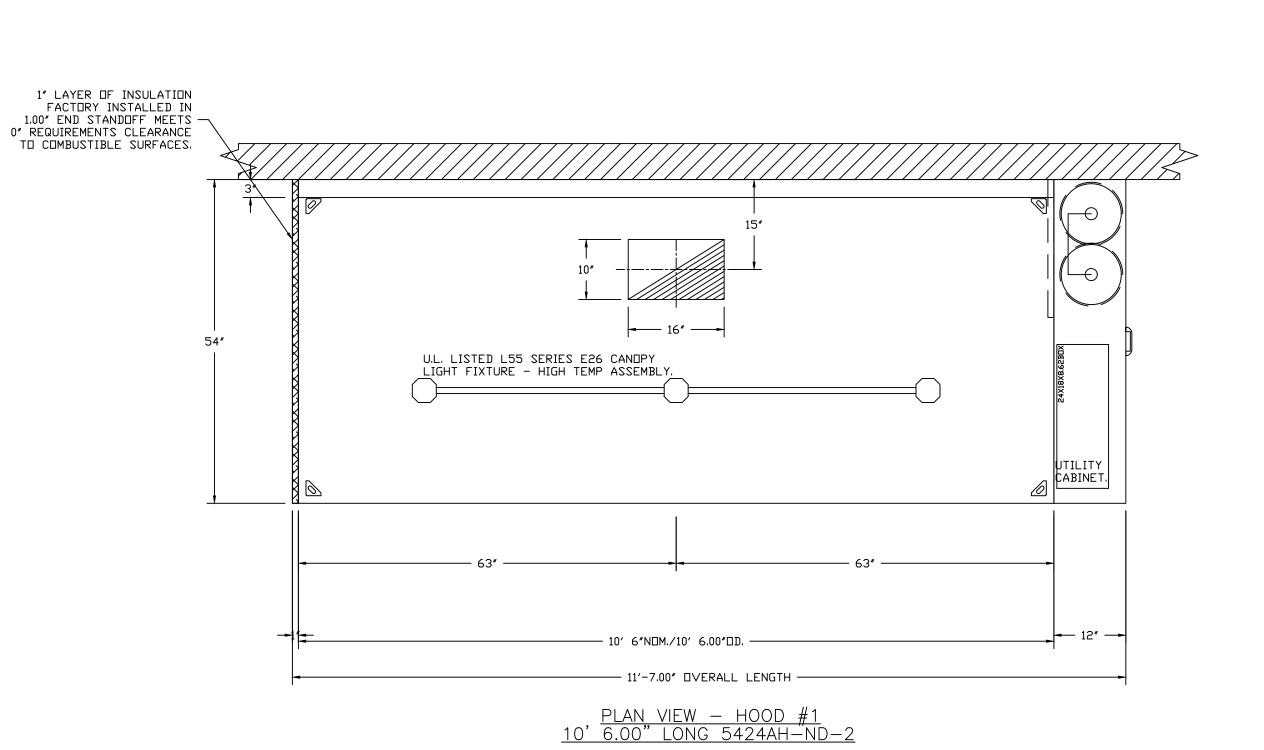

EXHAUST HOOD WELD INSPECTION, 200W LIGHT TEST, INSTALLATION INSPECTION, AND GAS LINE INSPECTION ARE PERFORMED IN THE FACTORY BY: JOSEPH SMALLWOOD FLORIDA FIRE SAFETY INSPECTOR GRADE I #145324

CERTIFICATES REGISTERED WITH PRO BOARD

QTY 7-DROP-IN PERFORATED SUPPLY PLENUM DIFFUSER (DI-PSP)

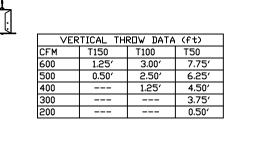



FOR QUESTIONS, CALL THE Advanced Hoods Systems, LLC REGION 140 PHONE: 407-269-4813
EMAIL: scott@advancedhoodsystems.com

DESCRIPTION DATE:

REVISIONS

4. REFRIGERATION PRESSURE MONITORING ON HIGH AND LOW PRESSURE SIDE OF SYSTEM INCLUDED THROUGH DIGITAL INTERFACE 5. EC MOTOR CONDENSING FANS

7. SUCTION LINE ACCUMULATOR 8. FACTORY COMMISSIONING WITH 5 YEAR PARTS WARRANTY, 25 YEAR WARRANTY ON STAINLESS STEEL HEAT EXCHANGER 9. AVERAGING INTAKE, EVAP AND DISCHARGE TEMPERATURE SENSORS (DISCHARGE SENSOR TO BE FACTORY MOUNTED WITHIN UNIT)

10. 2" EXTERIOR DUAL-WALL CONSTRUCTION W/ R-13 INSULATION-MINIMUM 20GA EXTERIOR W/ 14GA BASE 11. 81% EFFICIENT FURNACE, WITH MODULATING INDUCER TO MAINTAIN CONSTANT COMBUSTION EFFICIENCY ACROSS FIRING RANGE. 6:1 TURNDOWN WITH NG AND 5:1 TURNDOWN WITH LP

CURB #2 CRB25.5X4E

SIEEL CONSTRUCTION.

─ 3″ FLANGE.


UNIT ND


12. SUPPLY CFM MONITORING INTEGRAL TO UNIT WITH CFM MEASUREMENT INCLUDED THROUGH DIGITAL INTERFACE


13. FULLY MODULATING HOT GAS REHEAT 14. HAIL GUARD FOR CONDENSING COIL 15. DOWN DISCHARGE/NO RETURN

6. ELECTRONIC EXPANSION VALVE. TXV NOT ACCEPTABLE

FAN	OPTI(1	
UNIT ND	TAG	QTY	DESCRIPTION
		1	UTILITY SET GREASE CUP
1		1	RE18 - DISCHARGE EXTENSION ASSEMBLY WITH HARDWARE
		1	2 YEAR PARTS WARRANTY
		1	INLET PRESSURE GAUGE, 0-35"
		1	MANIFOLD PRESSURE GAUGE, 0 TO 10" WC, 1 FURNACE
		1	SHIP LOOSE GAS STRAINER 3/4"
		1	CASLINK BUILDING MONITORING SYSTEM - INTERNET OR CELLULAR CONNECTION REQUIRED
		1	RTU3 DOWN DISCHARGE
		1	2" MERV 13 FILTERS FOR RTU3 (QTY, 4)
		1	2" MERV 8 FILTERS FOR RTU3 (QTY, 4)
		1	DVERHEAT STAT
		1	RTU FIXED 100% DA INTAKE CONTROL
		1	RTU3 NO RETURN - 100% DA
_		1	REMOTE TEMPERATURE AND HUMIDITY SPACE SENSOR
2		1	120V FIRE INPUT
		1	DCCUPIED SCHEDULING
		1	CLOGGED FILTER SWITCH - NOTIFICATION ON HMI
		1	RTU3 HAIL GUARD
		1	20 TON MODULATING COOLING OPTION, 208/230V. R410A REFRIGERANT, VARIABLE SPEED COMPRESSOR, ECM CONDENSING FANS
		1	20 TON MODULATING REHEAT OPTION - DISCHARGE DEWPOINT CONTROL
		1	UNIT MOUNTED VFD CONFIGURED FOR DCV
		1	COMMERCIAL SMOKE DETECTOR/ALARM INTERLOCK - ALARM SUPPLIED BY OTHERS
		1	5 YEAR ENTIRE UNIT PARTS WARRANTY, 10 YEAR ENTIRE UNIT PARTS WARRANTY WITH REMOTE MONITORING AND CAPTIVEAIRE SERVICE CONTRACT, 25 YEAR STAINLESS STEEL FURNACE PARTS WARRANTY (SEE ADDITIONAL DETAILS)

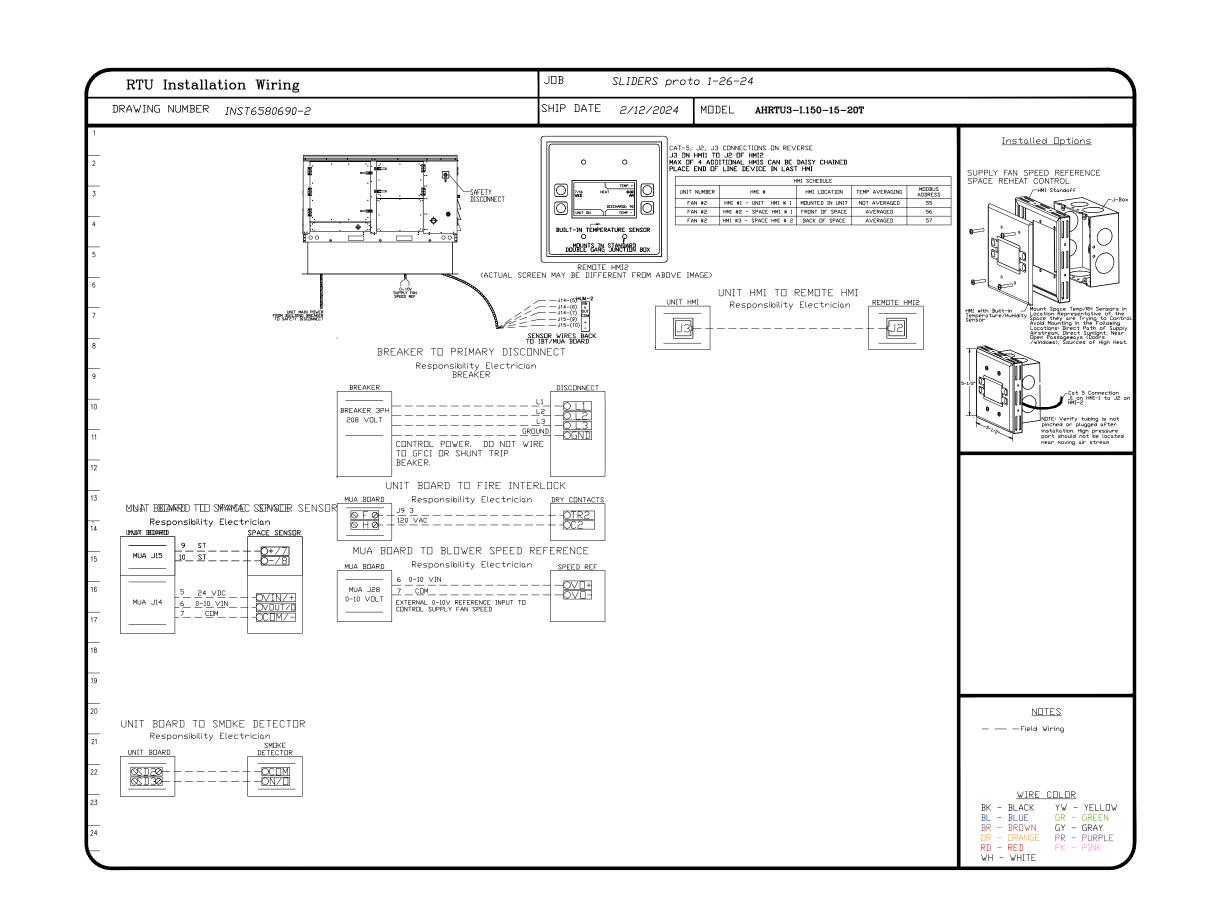

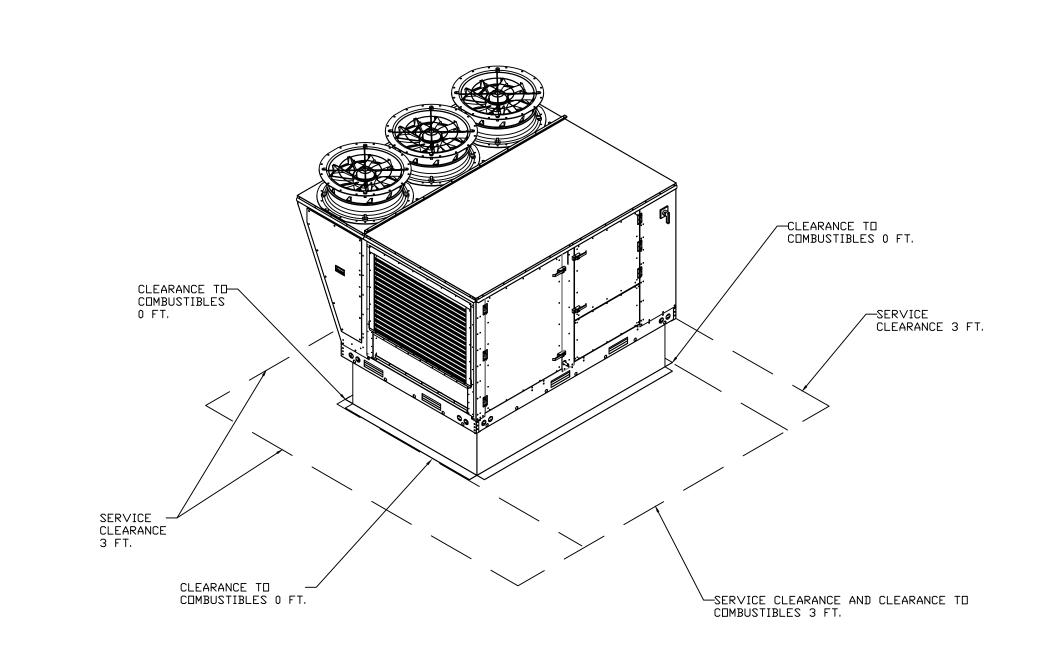

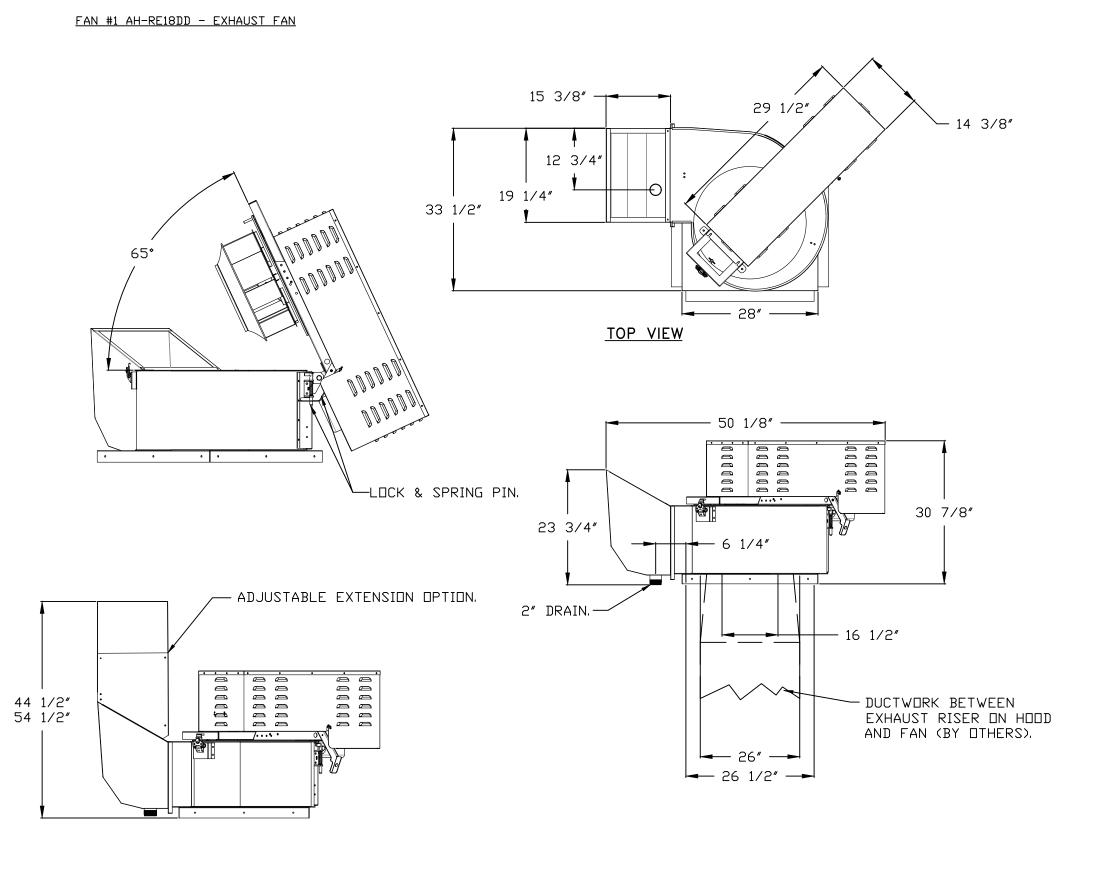

MANUFACTURER |

MOTOR ENCL

ADVANCED HDDD 2000 | 1.000 | 1204 | DDP | 2.000 | 0.9570 | 3 | 208 | 5.9 | 1160 FPM

RPM

ESP

EXHAUST FAN INFORMATION - JOB#6580690

FAN UNIT MODEL #

AH-RE18DD

THIS IS A STATE APPROVED & INSPECTED MODULAR BUILDING

FEATURES:

- ROOF MOUNTED FANS. - RESTAURANT MODEL. - UL762 AND ULC-S645. - HIGH HEAT OPERATION DIRECT DRIVE 300°F (149°C).

- HEAT SLINGER.

- GREASE CLASSIFICATION TESTING. - TILT DUT WHEEL. - LOCKING PIN FOR POWER PACK.

- MOTOR WEATHER COVER. - INTERLOCKED DISCONNECT SWITCH.

- NEMA 4X SAFETY DISCONNECT SWITCH. NORMAL TEMPERATURE TEST DIRECT DRIVE EXHAUST FAN MUST OPERATE CONTINUOUSLY WHILE EXHAUSTING AIR AT 300°F (149°C) UNTIL ALL FAN PARTS HAVE REACHED

THERMAL EQUILIBRIUM, AND WITHOUT ANY DETERIORATING EFFECTS TO THE FAN WHICH WOULD CAUSE UNSAFE OPERATION.

ABNORMAL FLARE-UP TEST BELT & DIRECT DRIVE EXHAUST FAN MUST OPERATE CONTINUOUSLY WHILE EXHAUSTING BURNING GREASE VAPORS AT 600°F (316°C) FOR A PERIOD OF 15 MINUTES WITHOUT THE FAN BECOMING DAMAGED TO ANY EXTENT THAT COULD CAUSE

<u>OPTIONS</u> - UTILITY SET GREASE CUP. - RE18 - DISCHARGE EXTENSION ASSEMBLY WITH HARDWARE. - 2 YEAR PARTS WARRANTY.

WEIGHT

(LBS)

286

15.1

AN UNSAFE CONDITION.

DISCHARGE

VELOCITY






MISSOURI

PUBLIC SERVICE COMMISSION

APPROVED

04/05/2024

MANUFACTURED HOUSING

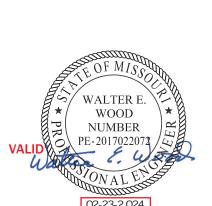

3/4" = 1'-0" **MASTER DRAWING**

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DATE:

DRAWN

DWG.#:

SCALE:


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EMAIL: scott@advancedhoodsystems.com

SHEET NO.

NOTES: 1. DO NOT OBSTRUCT OUTSIDE AIR INLET, OUTSIDE AIR COIL OR OUTSIDE AIR FAN.

2. DENOTES CORNER WEIGHT.
3. CONNECTION FROM BREAKER TO UNITS SAFETY DISCONNECT SWITCH TO BE COPPER WIRE ONLY.

> *NOTE: SUPPLY DUCT MUST BE INSTALLED TO MEET SMACNA STANDARDS, A MINIMUM STRAIGHT DUCT LENGTH MUST BE DUCTWORK, ELBOWS MUST BE RADIUS THROAT, RADIUS BACK WITH TURNING VANES, FLEXIBLE DUCTWORK AND SQUARE THROAT/SQUARE BACK ELBOWS SHOULD NOT BE USED, ANY TRANSITION AND/OR TURNS IN THE DUCTWORK WILL CAUSE SYSTEM EFFECT, SYSTEM EFFECT WILL DRASTICALLY INCREASE STATIC PRESSURE AND REDUCE AIRFLOW, DO NOT RELY ON UNIT TO SUPPORT DUCT IN ANY WAY, FAILURE TO PROPERLY SIZE DUCTWORK MAY CAUSE SYSTEM EFFECTS AND REDUCE PERFORMANCE OF THE EQUIPMENT. SUGGESTED STRAIGHT DUCT SIZE IS 21.5" × 39".

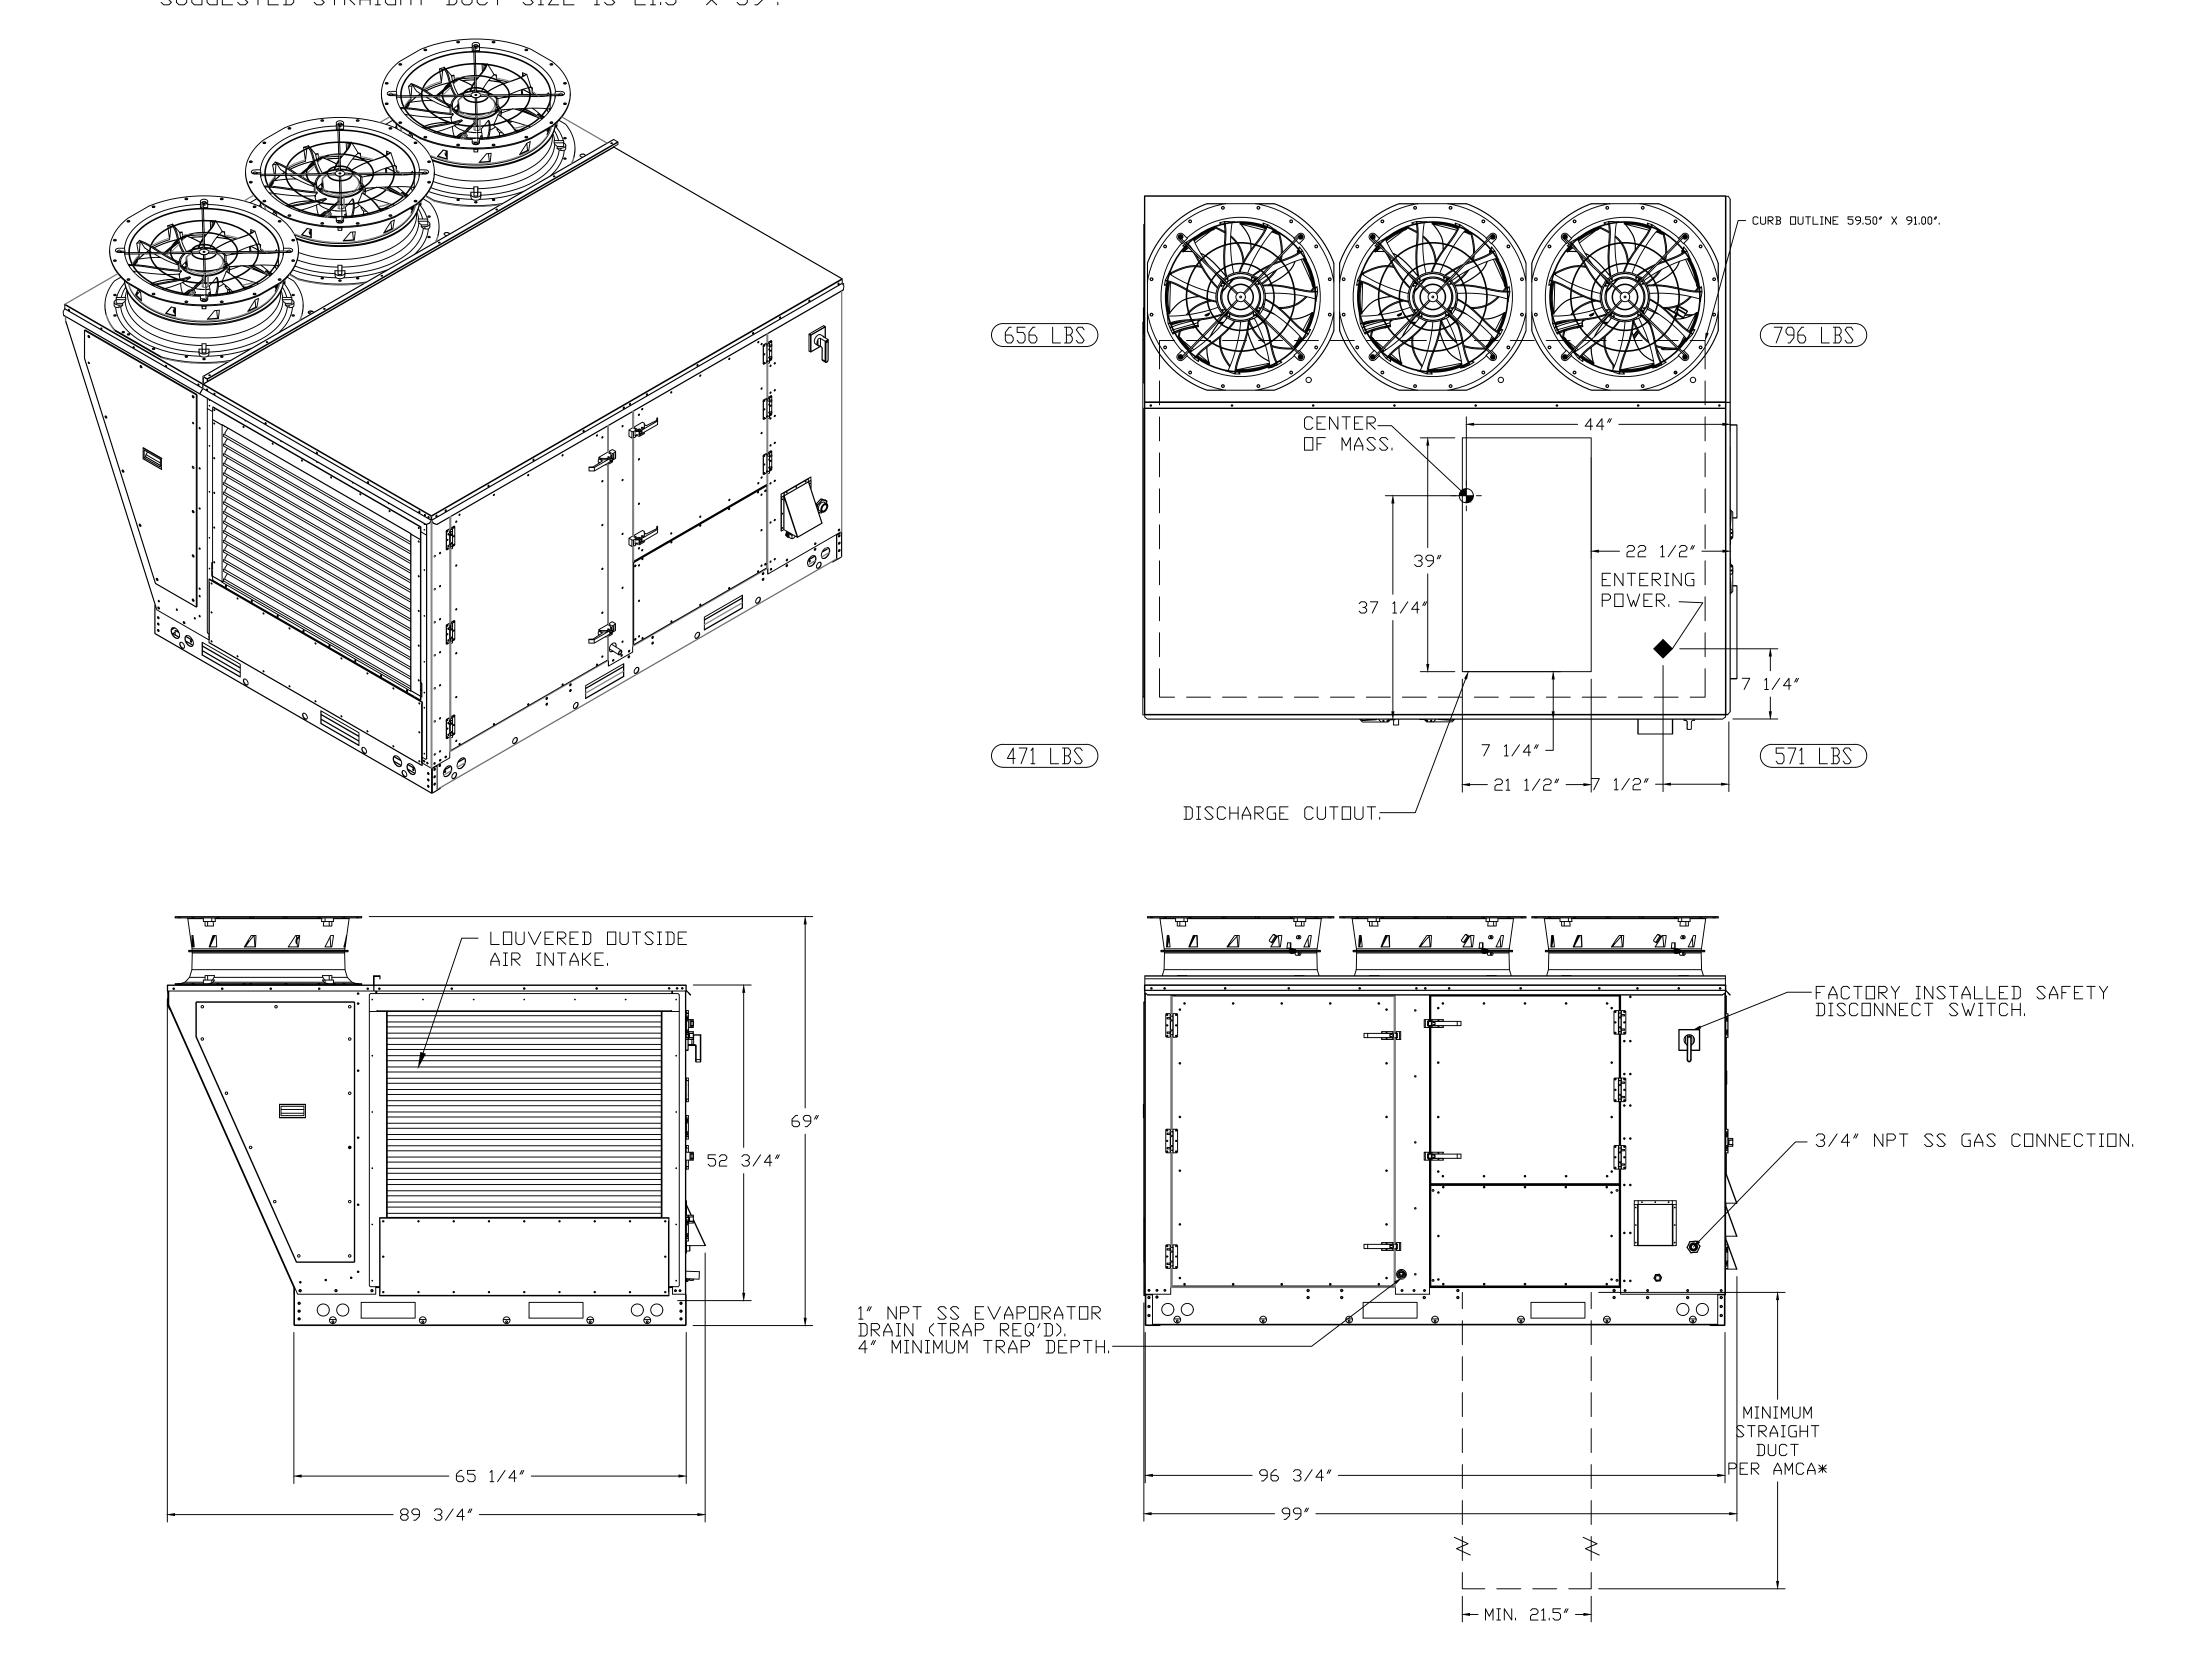

THIS IS A STATE APPROVED & INSPECTED MODULAR BUILDING

> **MISSOURI PUBLIC SERVICE** COMMISSION **APPROVED** 04/05/2024 **MANUFACTURED** HOUSING



∾∕ WALTER E. \ WOOD

IDERS (/)

DATE: DWG.#:

DRAWN BY:


3/4" = 1'-0" **MASTER DRAWING**

SCALE:

REVISIONS

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SHEET NO.

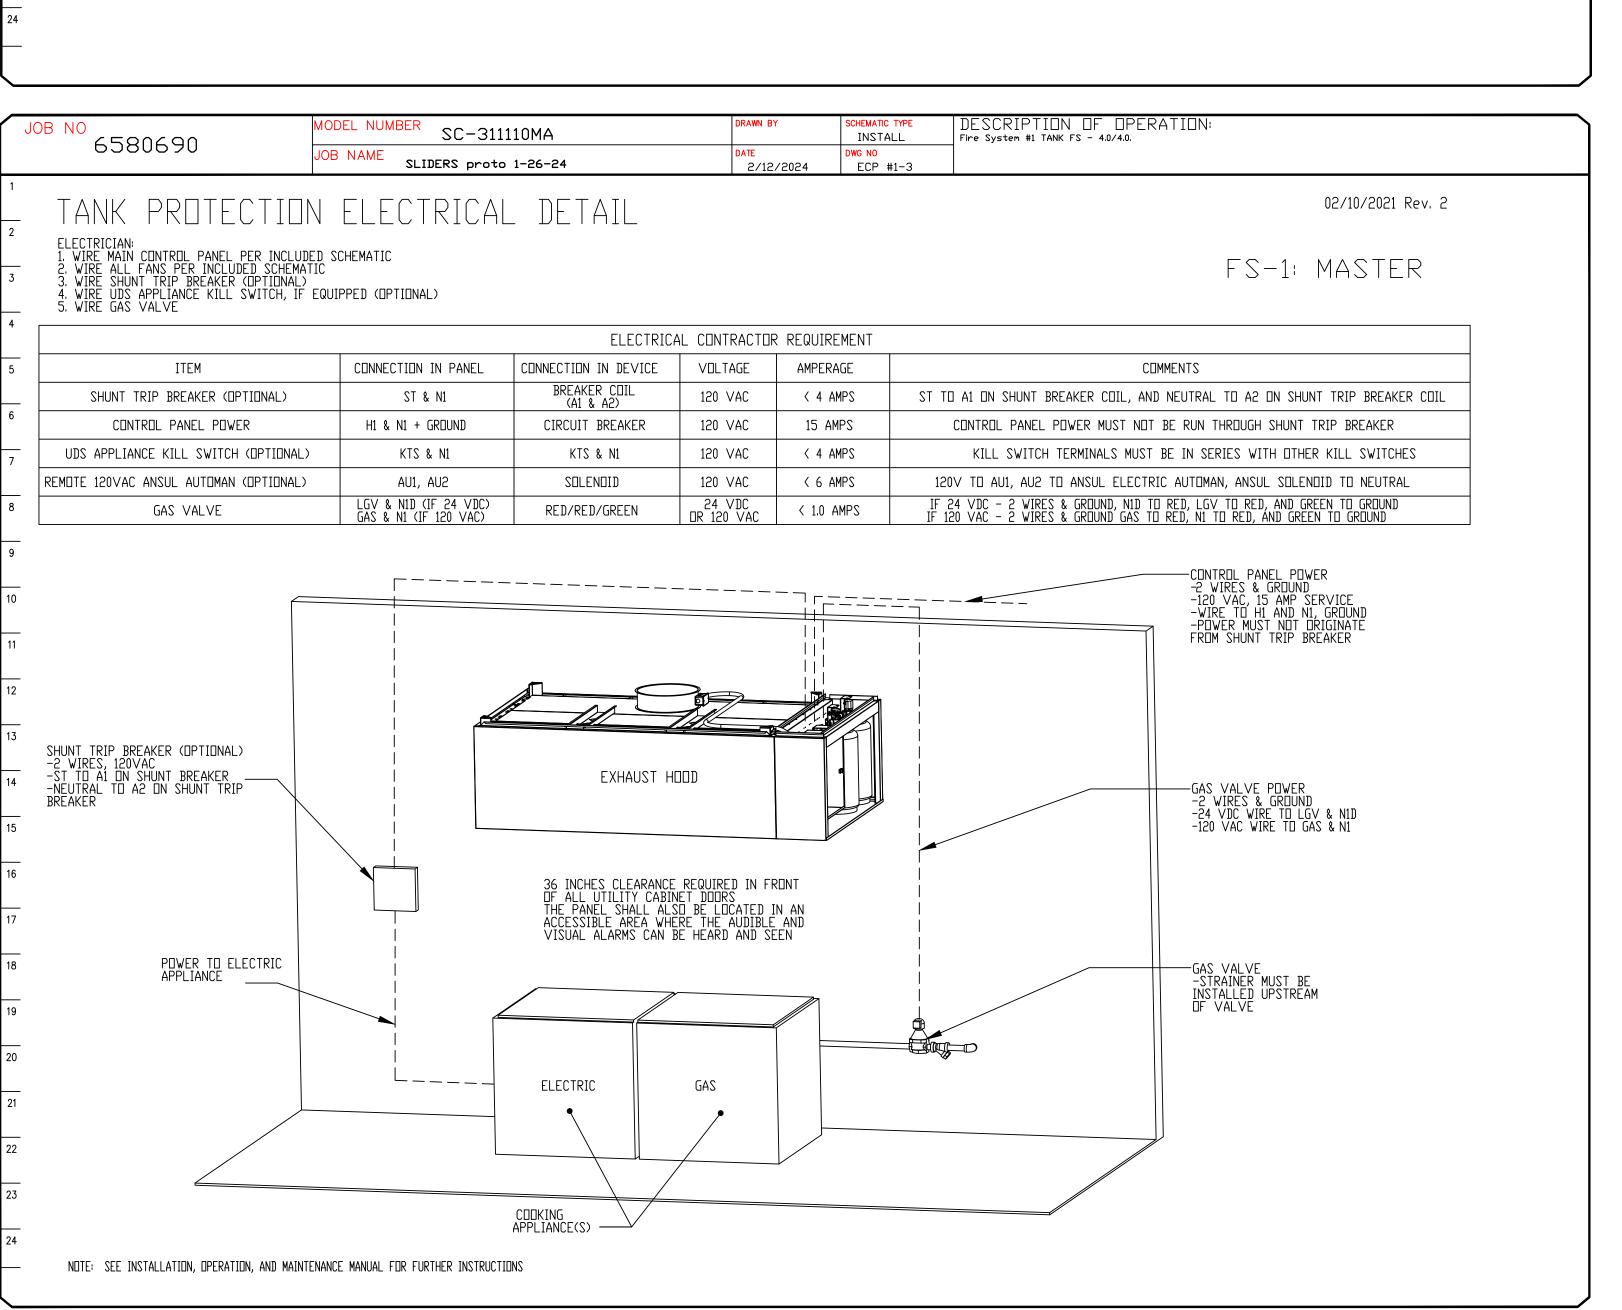

<u> ELECTRICAL PACKAGE - JOB#6580690</u>

PACKAGE #

HOOD LIGHTS 1

INSTALL

CONTROL PANEL TO ACCESSORY ITEMS

Responsibility: Electrician

CONTROL PANEL B1 O WHITE WHITE GREEN

CAT-5 ETHERNET CONNECTION

MODULE, NET REQUIRES 1) DHCP 2)

UDP PORT 1444 & 1445 OPEN FOR

DUTBOUND TRAFFIC ONLY.

OF RTU. SEE CASLINK OWNERS

CONTROL PANEL TIA OH------

TO TIBO WIRE TO CONTROL BOARD, INSTALL ROOM TEMP

CAPTURE VOLUME | SENSOR, MOUNTED IN HOOD CAPTURE | CAPTURE 1

CONTROL PANEL ST O HOT TO SHUNT COIL SHUNT COIL SHUNT COIL SHUNT COIL SHUNT COIL

CONTROL PANEL KS O - _ HOT_TO_CONTACTOR_COIL CONTACTOR_COIL SIGNAL FOR N1 O - NEUTRAL_TO_CONTACTOR_COIL - _ O

KS TERMINAL IS DE-ENERGIZED

MANUAL FOR FURTHER INSTRUCTIONS.

SENSOR IN ROOM AWAY FROM HEAT SOURCES. DO NOT INSTALL SENSOR GROUPS:

ON THE CEILING GRID, SEE MANUAL.

THE FOLLOWING CONNECTIONS
MAY OR MAY NOT BE
REQUIRED BASED ON JOBSITE
SPECIFICATIONS

TO T2BO FACTORY WIRED TEMPERATURE

V□LUME.

EXTERNAL ST TERMINAL IS ENERGIZED

SHUNT TRIP IN FIRE CONDITION.

CONTACTOR COIL | IN FIRE CONDITION.

| | WIRE DIRECTLY TO COMMUNICATION | | | | | | | |

CAT-5 ETHERNET CONNECTION RTU

CONTROL PANEL
TO
CAT-5 CONNECTION

SYMMETRIC STATES ALL SWITCHES FACTORY WIRED
CAT-5 CONNECTION

HOOD LIGHTS GND O WIRE TO J-BOX ON TOP OF HOOD

CONTROL PANEL

SWITCHES

CONTROL PANEL

TO

WORLD WIDE

WEB

CONTROL PANEL

RTU

ROOM TEMP

SENSOR

SENSOR

MODEL NUMBER SC-311110MA

PRIMARY CONTROL PANEL

SLIDERS proto 1-26-24

6580690

BREAKER.

8 MOCP: 15 A EXH-1 SM-1

_____ WIRE TO VFD QUICK CONNECTOR

BREAKER PANEL

BREAKER 1PH

BREAKER PANEL

BREAKER 3PH

PRIMARY PANEL

— CONNECTOR

BREAKER PANEL TO PRIMARY CONTROL PANEL

Responsibility: Electrician

BREAKER SIZE SHOWN IS THE MAXIMUM ALLOWED

15 A CONTROL POWER. DO NOT WIRE TO GND

BREAKER PANEL TO FANS

Responsibility: Electrician

208V _____LINE ___POWER_TO

MCA: 76.4A REMOTE

WIRE DIRECTLY TO FAN DISCONNECT

CONTROL PANEL TO FANS

Responsibility: Electrician

17

Load Wiring

SM-1

VFD QUICK

CONNECTOR

TAN: 01

EXH-1

FAN: 01

EXH-1

FLA:5.9

HP: 2.000

VDLT: 208 V

DO NOT SHARE CONDUIT!

OCCUPIED RTD10- 24 VAC -+ J16-(7)
OVERRIDE SUP-2

ANALOG DUTPUT VOLTAGE WIRED TO ANALOG INPUT OF IBT BOARD.

VDC ANALOG VOTO BLACK PLACK PL UTPUT VI-O-BLACK - J28-(7)

ANALOG OUTPUT VOLTAGE WIRED TO ANALOG INPUT OF MUA BOARD.

MUST HAVE ITS DWN CONDUIT DISCONNECT

WIRE TO

1ST HOOD LIGHT BREAKER SHARED W/

CONTROL POWER, SWITCH #1

| ----- | Neutral | ----- | Ni

Ground OGND

LOCATION

ESCRIPTION OF OPERATION:

GAS VALVE

24V DC ONLY

CONTROL PANEL

SIGNAL FOR

FIRE ALARM

PANEL

CONTROL PANEL

SIGNAL FOR _

TO DUCT

MOUNTED FIRE

ALARM

CONTROL PANEL

BUILDING

CONTROL PANEL

SC-311110MA | UTILITY CABINET RIGHT

SWITCHES

QUANTITY

1 LIGHT

1 FAN

BMS SWITCH

GAS SOLENDID

FIRE INPUT

FIRE STATS

SMART CONTROLS THERMOSTATIC CONTROL

W/ RELAY ON/OFF WITH SUPPLY

LOCATION

UTILITY CABINET

HOOD # 1

3 Phase w/ control for 1 Exhaust Fan, 1 Supply Fan, Exhaust on in Fire, Lights out in Fire, Relay On/Off with Supply Fan, Fan(s) On/Off Thermostatically Controlled. Room temperature sensor shipped loose for field installation. INVERTER DUTY 3 PHASE MOTOR REQUIRED FOR USE WITH VFD.

CONTROL PANEL SFCI O ---- COMMON DRY CONTACT SFOI O --- NORMALLY OPEN ---

DN/DFF WITH CSFC2 O

SUPPLY FAN SFOOD SPARE CONTACTS WILL MAKE COMMON TO NORMALLY OPEN WHEN SUPPLY FAN IS ON.

CONTROL PANEL HI OHOLOGO

TO TO SIGNAL SWITCH THROUGH BMS

EXTERNAL WILL ACTIVATE ZONE1 FANS AND LIGHTS

CONTROL PANEL GVO - POSITIVE TO GAS VALVE ONLY ENERGIZED THROUGH LCD

CONTROL PANEL TO FIRE SYSTEM

Responsibility: ALARM CONTRACTOR

CONDITION.

CONDITION.

BUILDING TBC O- ----- COMMON + O TROUBLE TBL O TROUBLE RELAY CONTACTS WILL

MAKE TBC TO TBL IN TROUBLE

CONTROL PANEL TO FIRE SYSTEM Responsibility: CERTIFIED INSTALLER

21 ©

22 ©

FIRE STAT SUPERVISED LOOP

**OL PANEL May be mixed factory and field wiring. See Installation Schematic.

Multiple fire sensors possible.

**Fire Stat*

Supervised Loop wiring in contact
with a hood. All other wiring shall
be PN: 6320UL, Belden or similar.

Fire Stat

Multiple fire sensors possible. HIGH TEMP WIRE (842 F), PN:

SLPCDN-xFT required for all

WIRE DIRECTLY TO CORE CIRCUIT - + -

BOARD. AL1 WILL MAKE AL2 IN FIRE

HMI WHEN FIRE SYSTEM ARMED. (NOT NEEDED IF USING 120V GAS VALVE).


RIGHT

FANS CONTROLLED

TYPE | \$\phi\$ HP VOLT FLA

EXHAUST 3 2.000 208 5.9


SUPPLY | 3 | 2.000 | 208 | 6.1

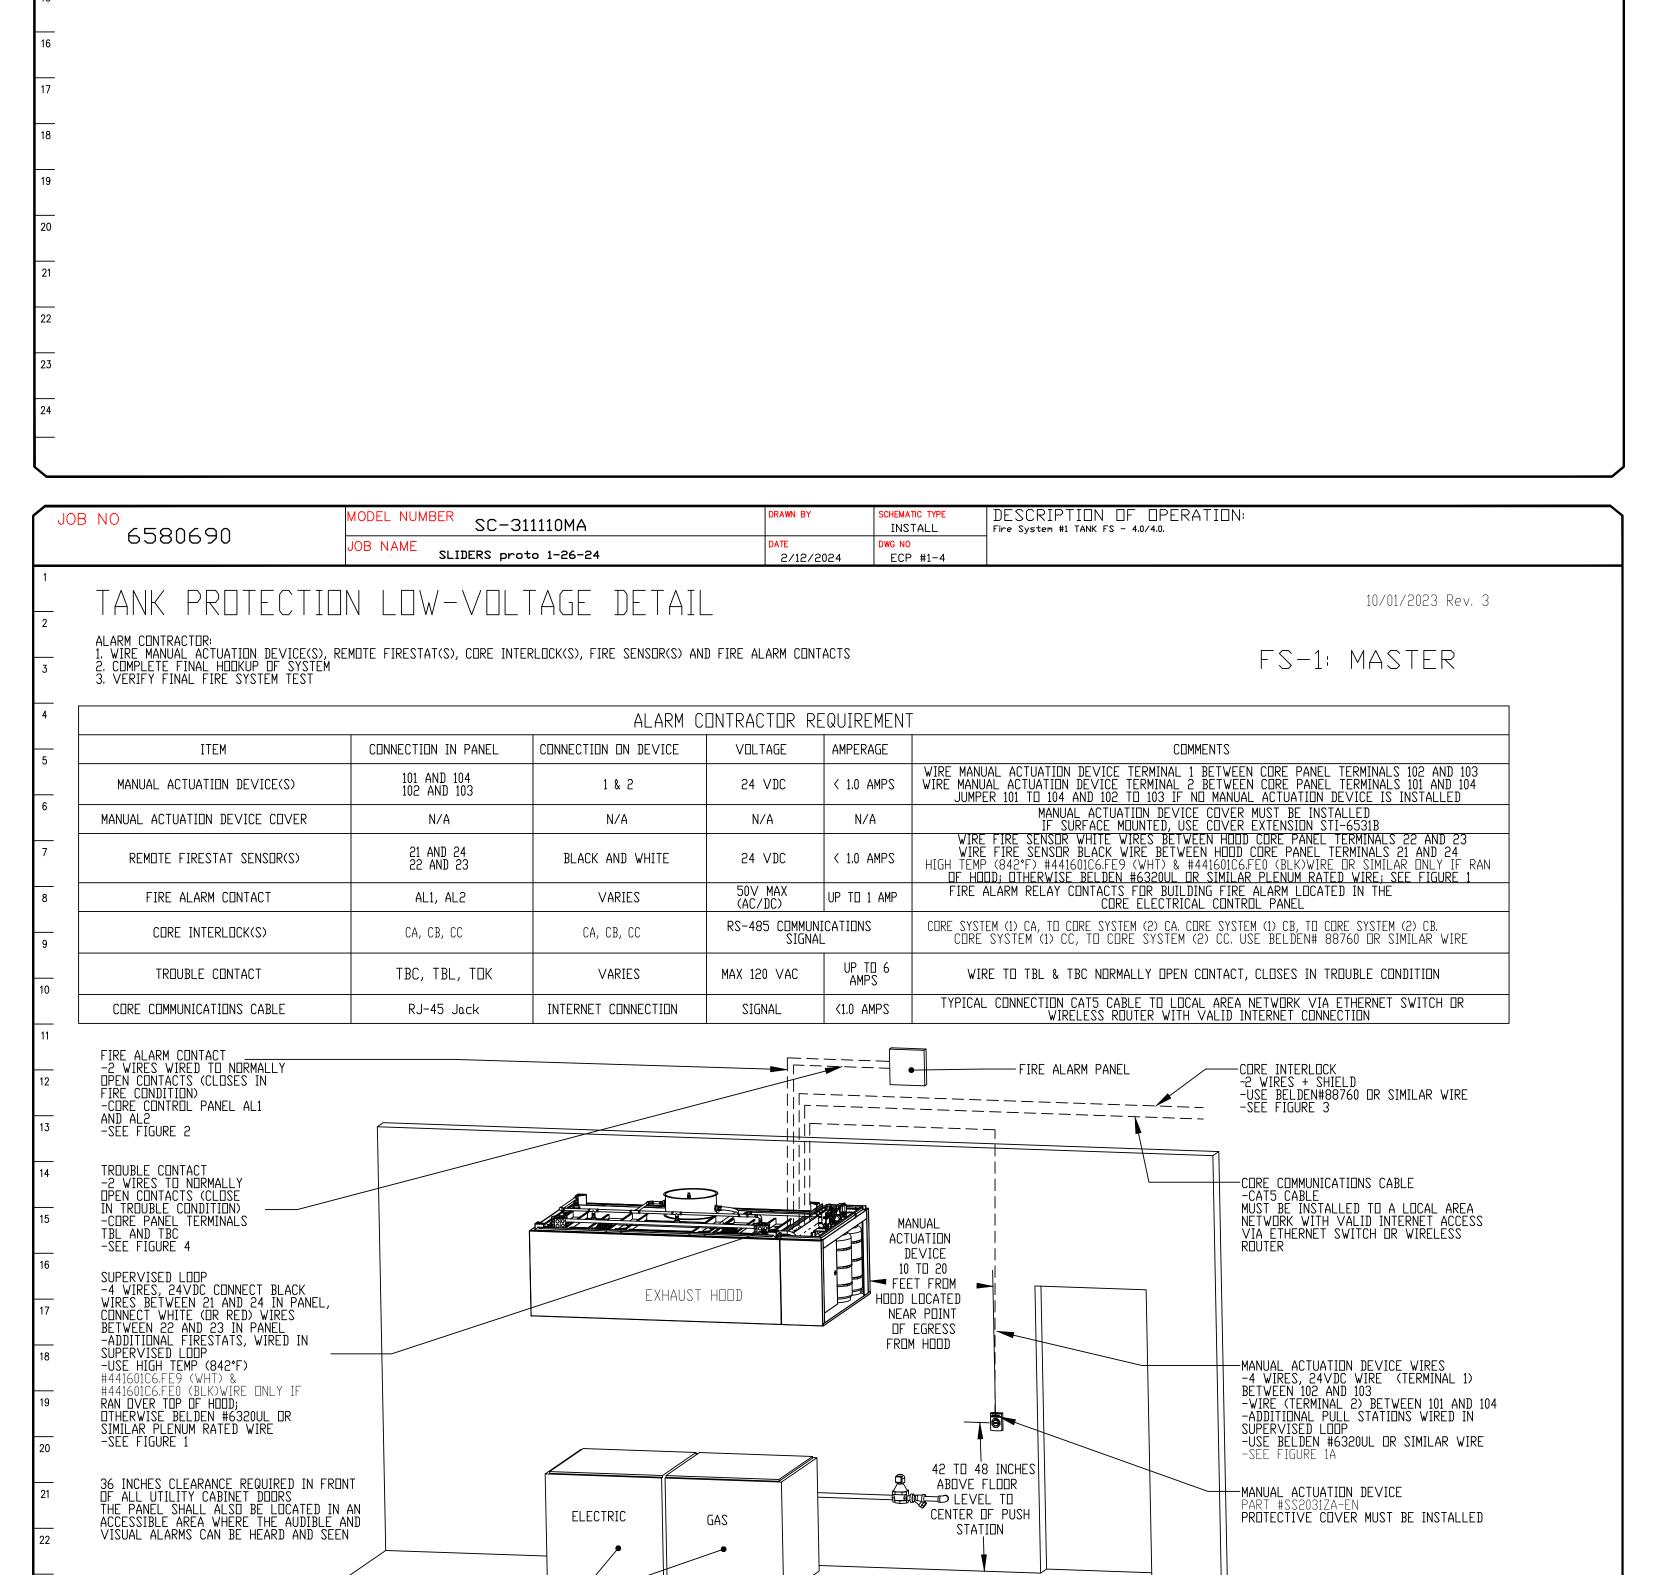

COOKING APPLIANCE(S)

ATTENTION: LOW-VOLTAGE DC OR SIGNALING WIRE SHOULD BE ROUTED IN SEPARATE CONDUIT FROM ALL AC SOURCES

NOTE: SEE INSTALLATION, OPERATION, AND MAINTENANCE MANUAL FOR FURTHER INSTRUCTIONS

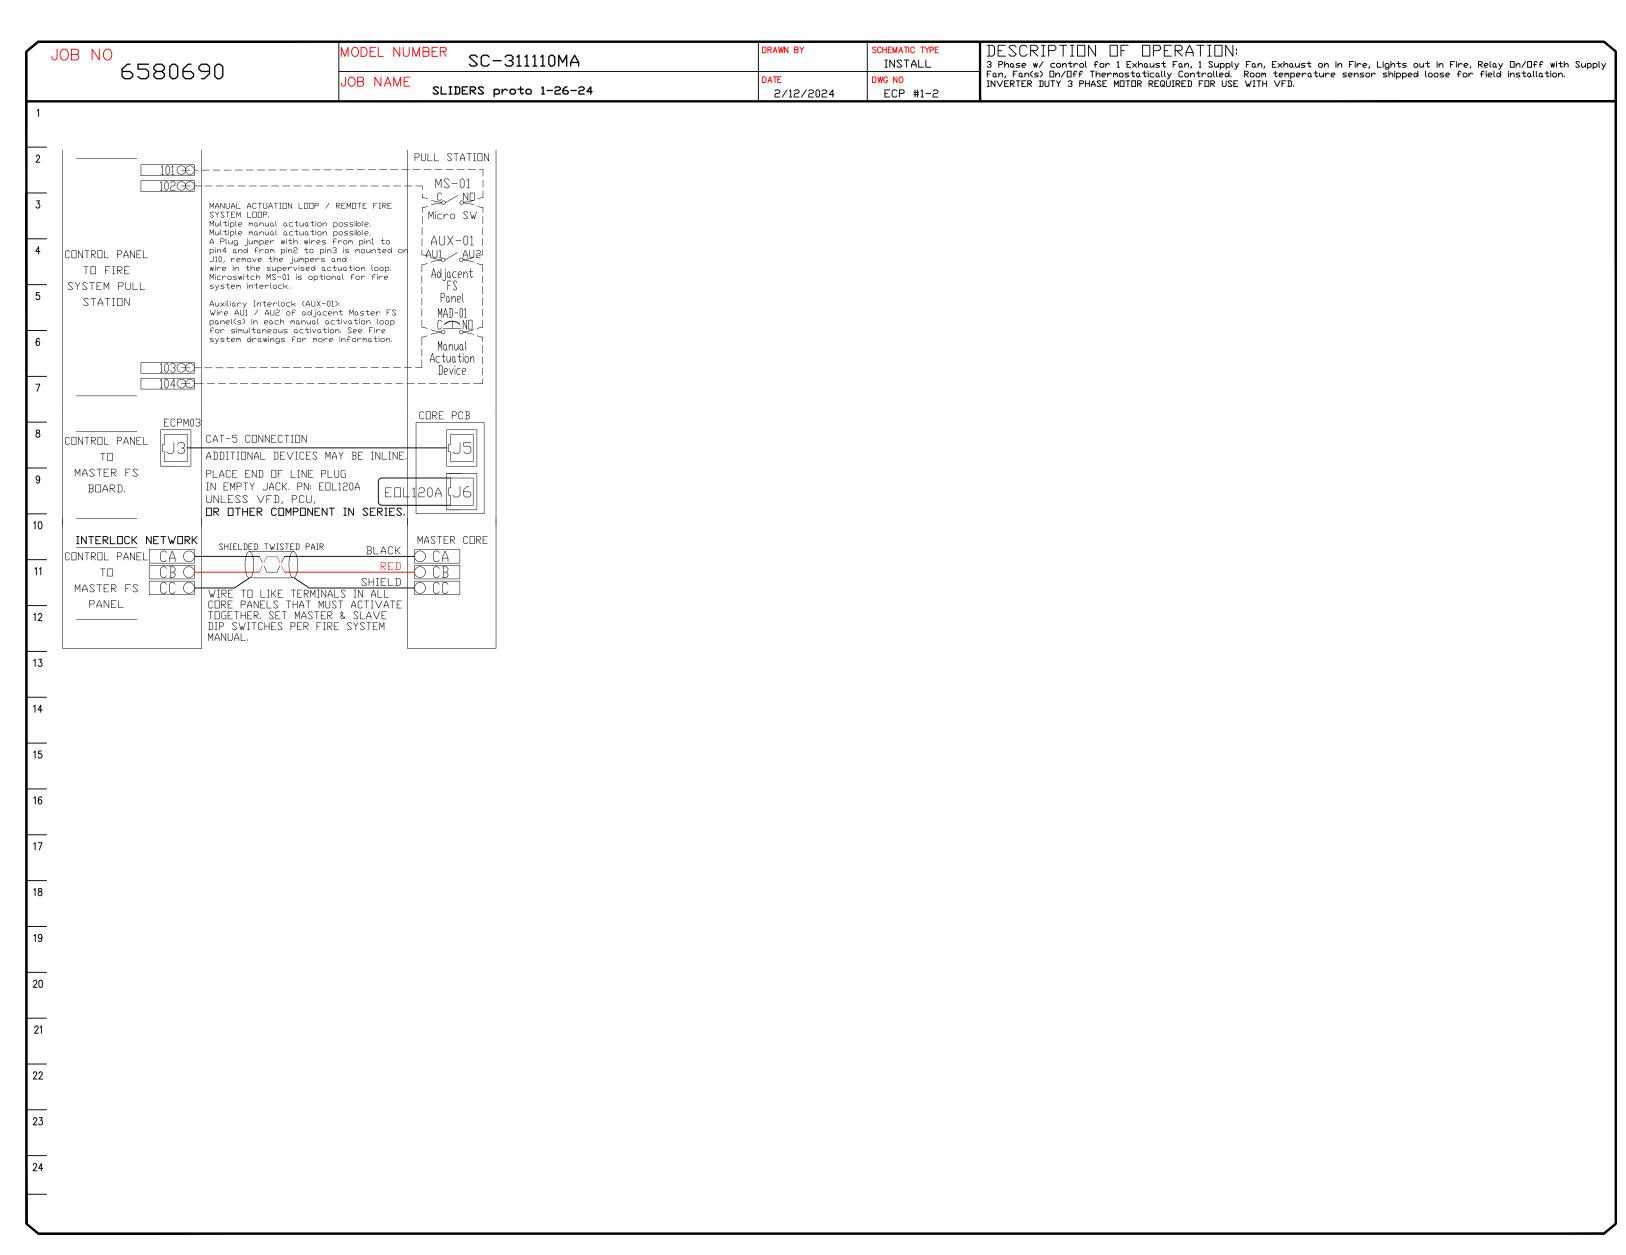

INSPECTI TATE Н 볊

> **MISSOURI PUBLIC SERVICE**

COMMISSION

APPROVED

04/05/2024

MANUFACTURED

HOUSING

ARTER &

WALTER E. WOOD

NUMBER

PE-2017022072 /

H MODUL

REVISIONS

DESCRIPTION DATE:


 $\overline{}$ $\langle \rangle$ DATE:

DWG.#: **DRAWN** SCALE:

3/4" = 1'-0" **MASTER DRAWING**

SHEET NO.

FOR QUESTIONS, CALL THE Advanced Hoods Systems, LLC REGION 140 PHDNE: 407-269-4813 EMAIL: scott@advancedhoodsystems.com

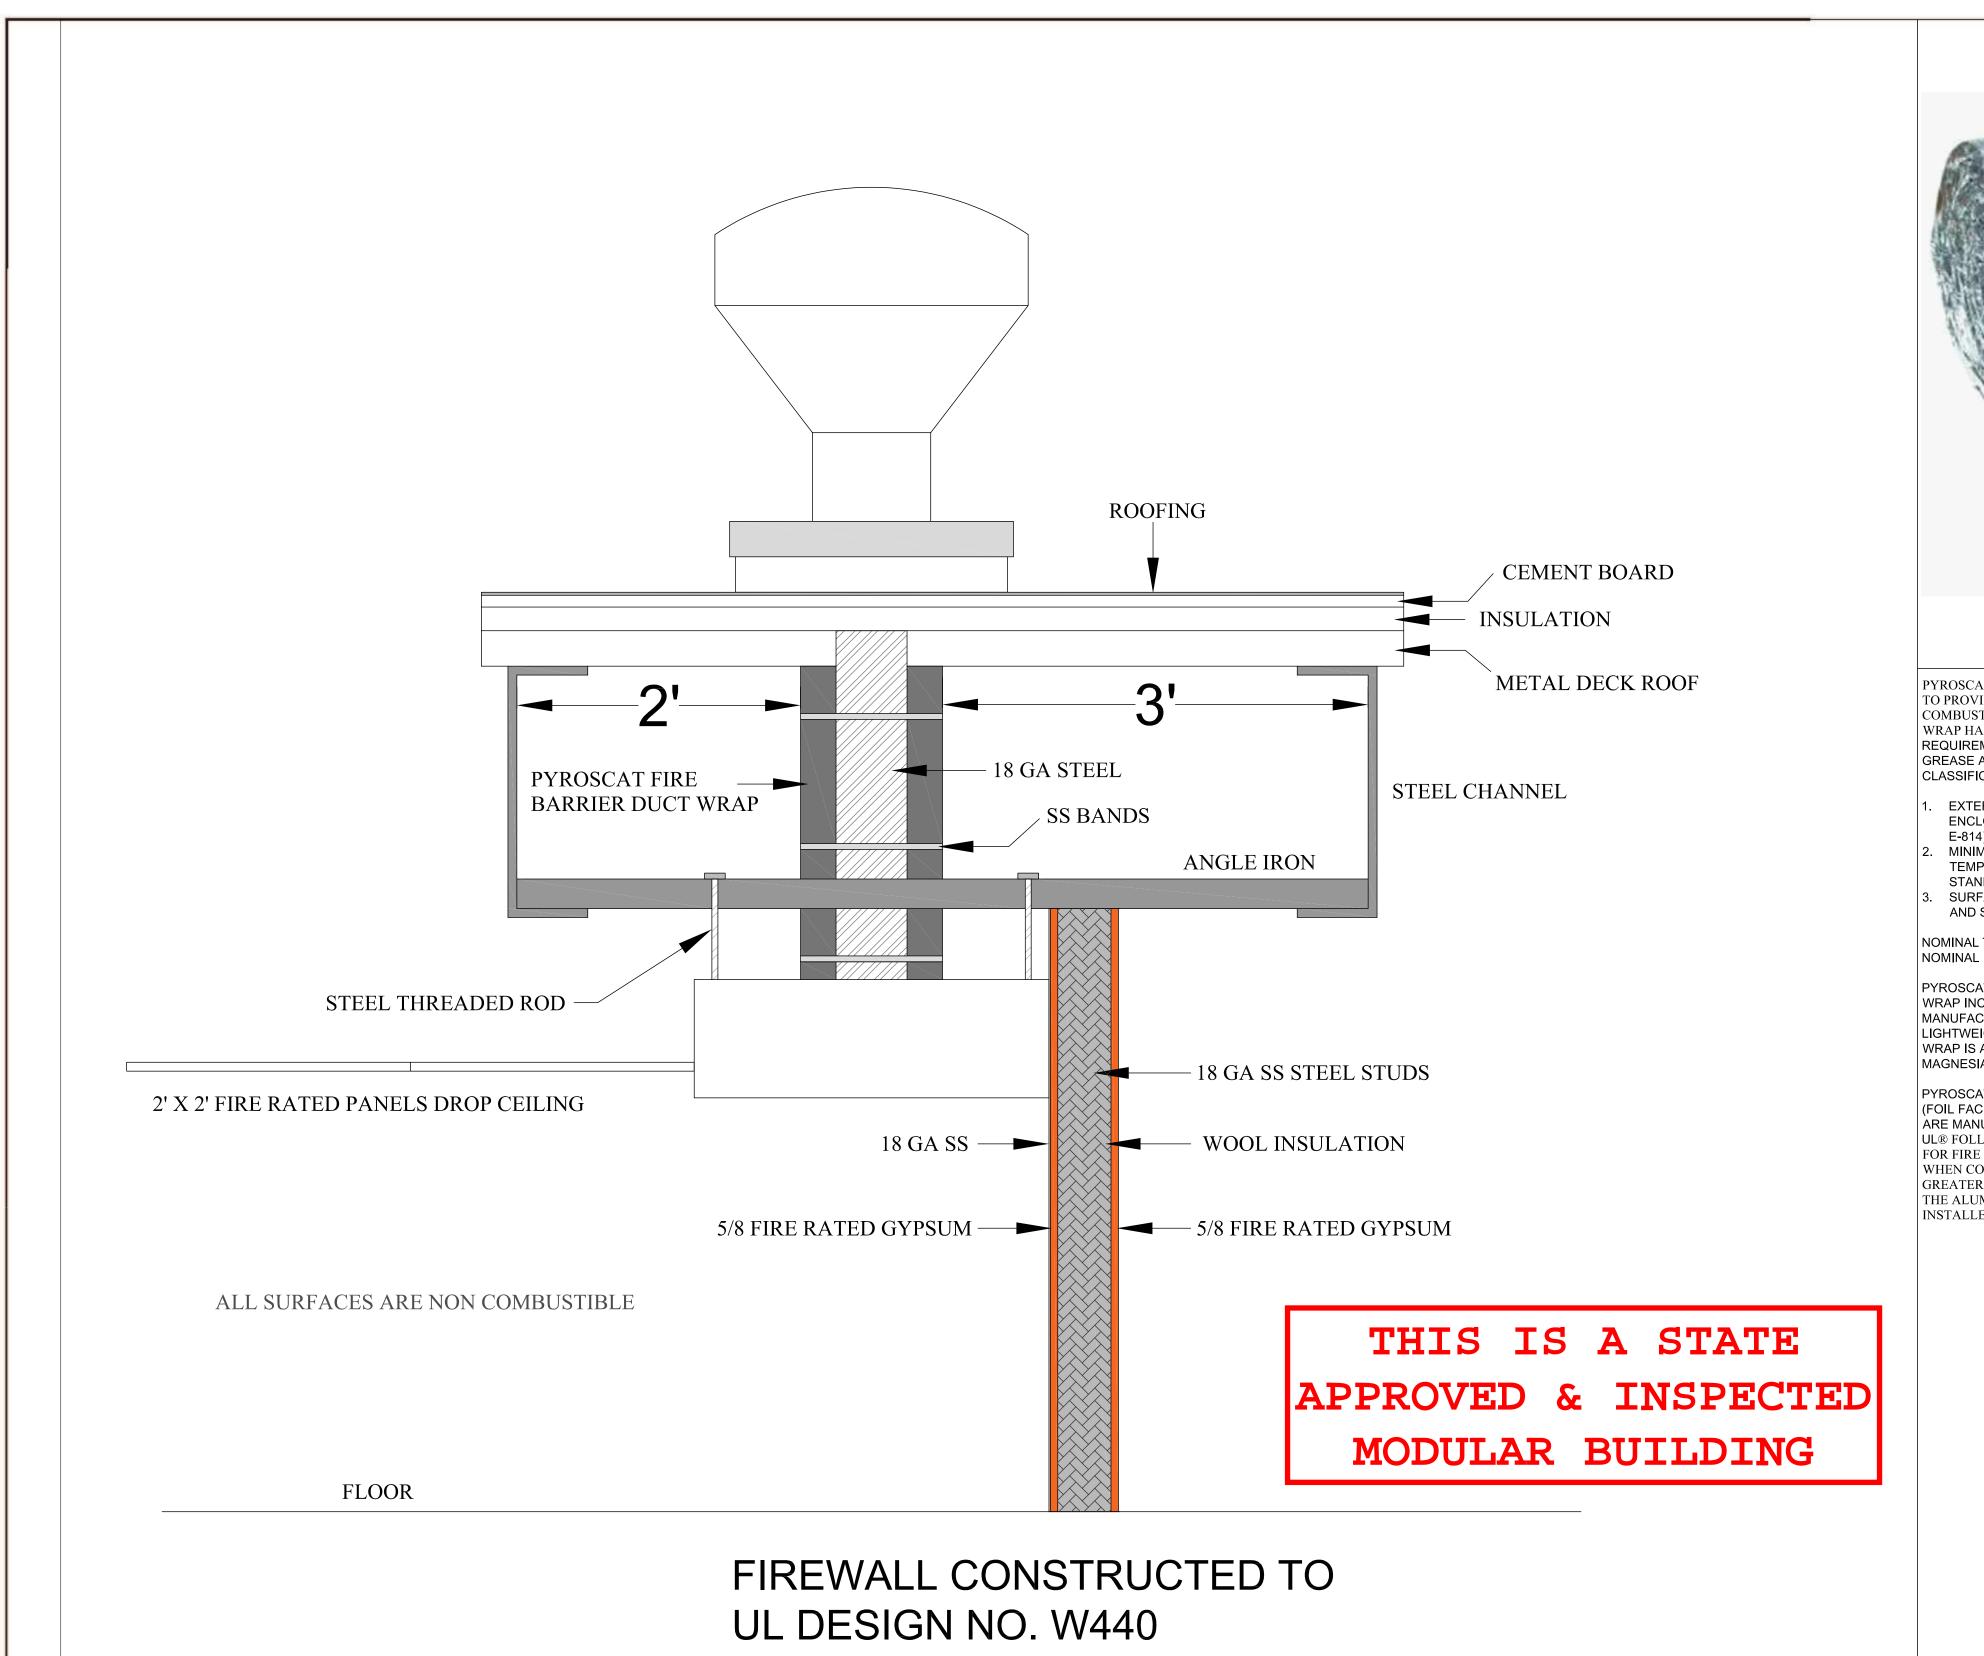



PYROSCAT DUCT WRAP IS A FLEXIBLE, LIGHTWEIGHT FIRE BARRIER SYSTEM DESIGNED TO PROVIDE ONE AND TWO HOUR RATED FIRE PROTECTION AND ZERO CLEARANCE TO COMBUSTIBLE PROTECTION IN GREASE AND AIR DUCT APPLICATION. PYROSCAT DUCT WRAP HAS BEEN TESTED AT UNDERWRITERS LABORATORIES® AND MEETS REQUIREMENTS OF UL UUET CLASSIFICATION FOR GREASE DUCT ENCLOSURES AND ULC GREASE AND VENTILATIONN DUCT ISULATION UNDER FILES FRD-6 AND FRD-7. UL YYET CLASSIFICATION REQUIRES THAT THE SYSTEM MEET THE FOLLOWING:

- 1. EXTERNAL FULL SCALE FIRE TEST FOR 1 AND/OR 2 HR FIRE RESISTANCE DUCT ENCLOSURE AND THROUGHPENETRATION PER UL 263 (ASTM E-119)/ UL 1479 (ATM E-814) WITH HOSE STREAM.
- 2. MINIMUM TEMPERATURE RISE STANDARDS DURING THE 2000° F ABNORMAL TEMPERATURE TEST PER "UL SUBJECT 1978 PROPOSED FIRST EDITION OF THE STANDARD FOR GREASE DUCTS".
- 3. SURFACE BURNING CHARACTERISTICS PER UL 723 (ASTM E-84) WITH FSI NOT OVER 25 AND SDI NOT OVER 50.

NOMINAL THICKNESS: 1 1/2" NOMINAL DENSITY: 6LB/FT3

PYROSCAT DUCT WRAP IS CLASSIFIED IN TWO PRODUCT TYPES. PYROSCAT FP DUCT WRAP INCORPORATES FIRE PROTECTION GRADE CERAMIC FIBER BLANKET MANUFACTURED FROM INORGANIC OXIDES TO FORM A SUPER STRONG, FLEXIBLE, LIGHTWEIGHT PRODUCT THAT IS INHERENTLY FIRE RESISTANT. PYROSCAT CSM DUCT WRAP IS AN ALKALINE EARTH SILICATE(AES) PRODUCT MADE FROM CALCIA, SILICA, AND MAGNESIA RAW MATERIALS.


PYROSCAT DUCT WRAP MATERIALS ARE AVAILABLE IN THREE GRADES - F0 (UNFACED), F1 (FOIL FACING ONE SIDE), AND F2E (TOTALLY ENCAPSULATED). ALL PYROSCAT PRODUCTS ARE MANUFACTURED IN AN ISO 9002 CERTIFIED FACILITY TO CLOSE TOLERANCES PER UL® FOLLOW-UP PROCEDURES TO ENSURE THE HIGHEST QUALITY FINISHED PRODUCTS FOR FIRE CRITICAL APPLICATIONS.

WHEN COMPARED TO OTHER WRAP SYSTEMS, PYROSCAT DUCT WRAP EXHIBITS GREATER PHYSICAL STRENGTH - PLUS IN THE CASE OF THE FOIL FACED GRADES (F1/F2E) THE ALUMINUM FOIL/SCRIM IS BONDED DIRECTLY TO THE FIBER BLANKET. THIS GIVES INSTALLERS A MORE RUGGED, EASIER TO HANDLE, AND FASTER TO INSTALL WRAP.

MISSOURI
PUBLIC SERVICE
COMMISSION
APPROVED
04/05/2024
MANUFACTURED
HOUSING





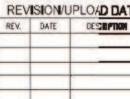




DATE ISSUED:

VALLANT EQUIPMENT, LLC S WEST TOWER CIRCLE, ORMOND BEACH, FL. 3214

Third Party: HWC & Ase, Inc. 1627 SouthMyrtle Ave. Clearwater, Fl. 34616 (717)-584-8151

Project#
DRAWING NUMBER:
FIRE WALL

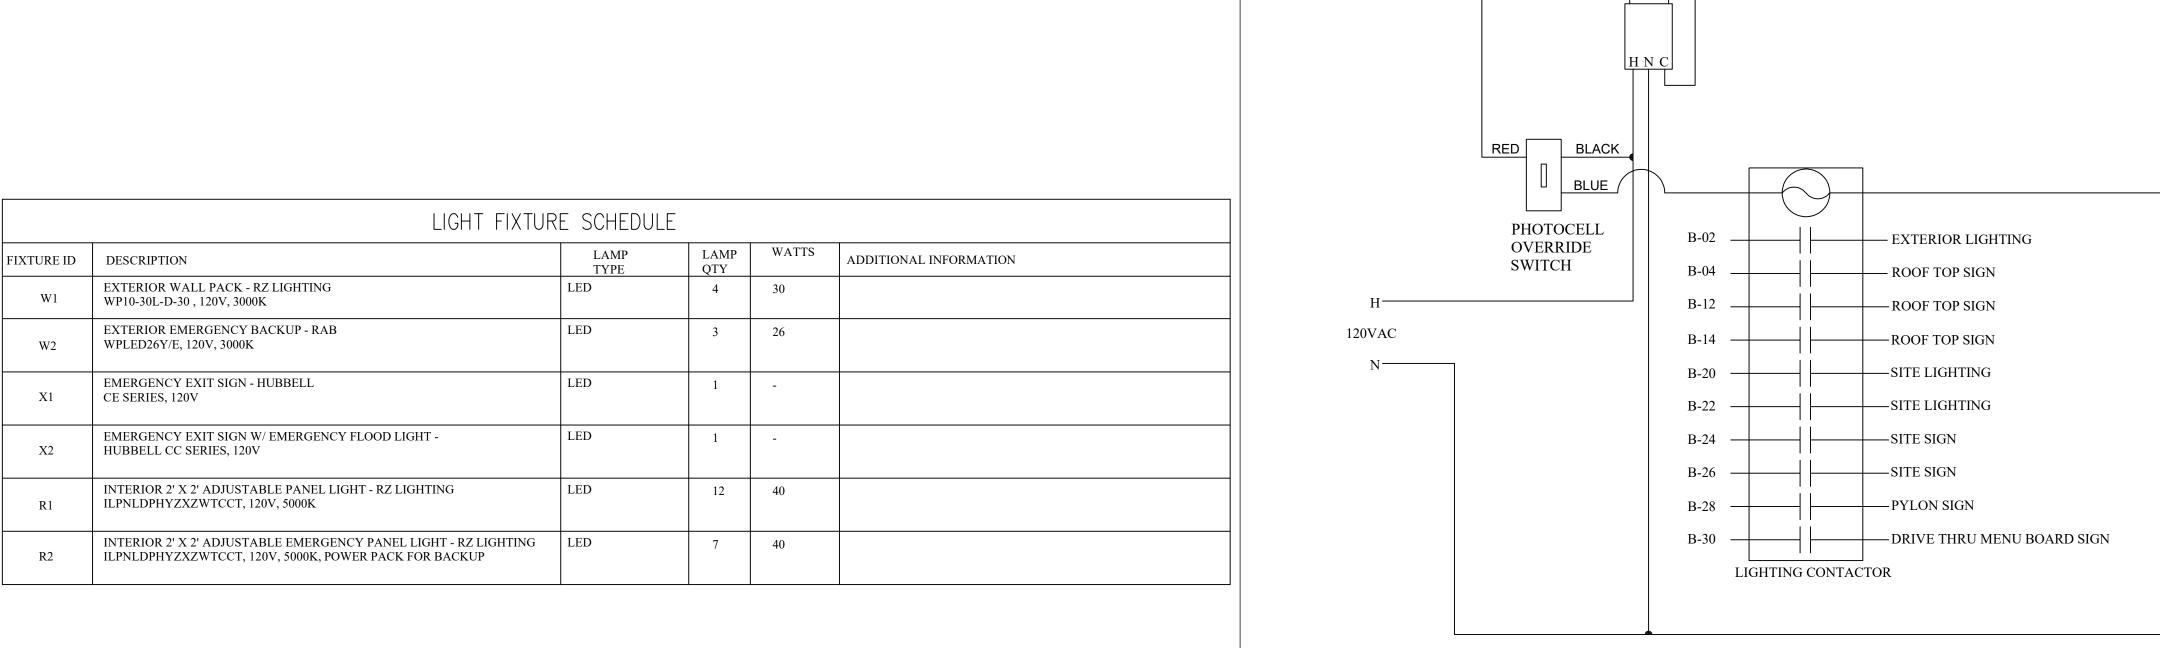



ON NORTH SIDE OF BUILDING IN ACCESSIBLE LOCATION **EXTERIOR LIGHTING**

-120V PHOTOCELL MOUNTED

CONTROL WIRING DIAGRAM



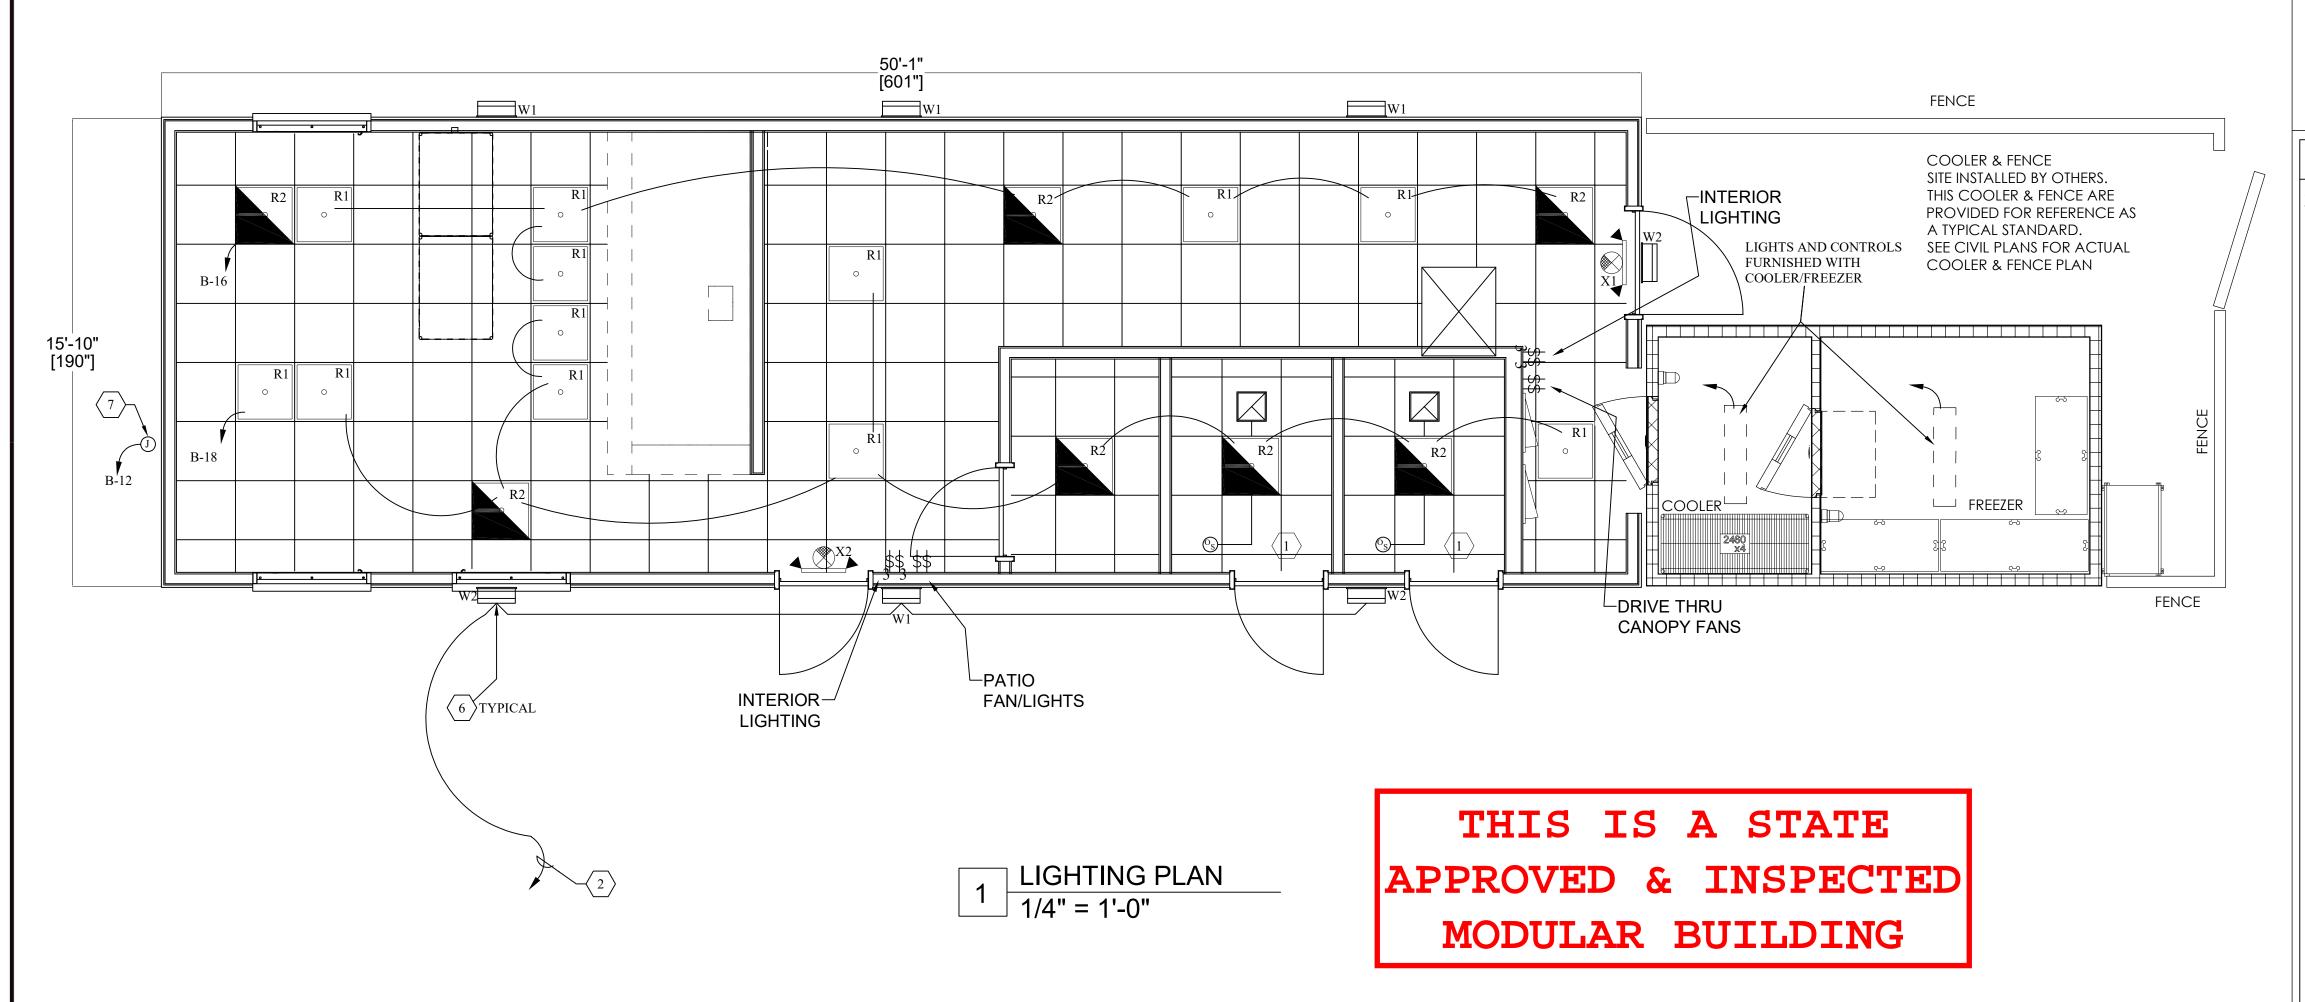

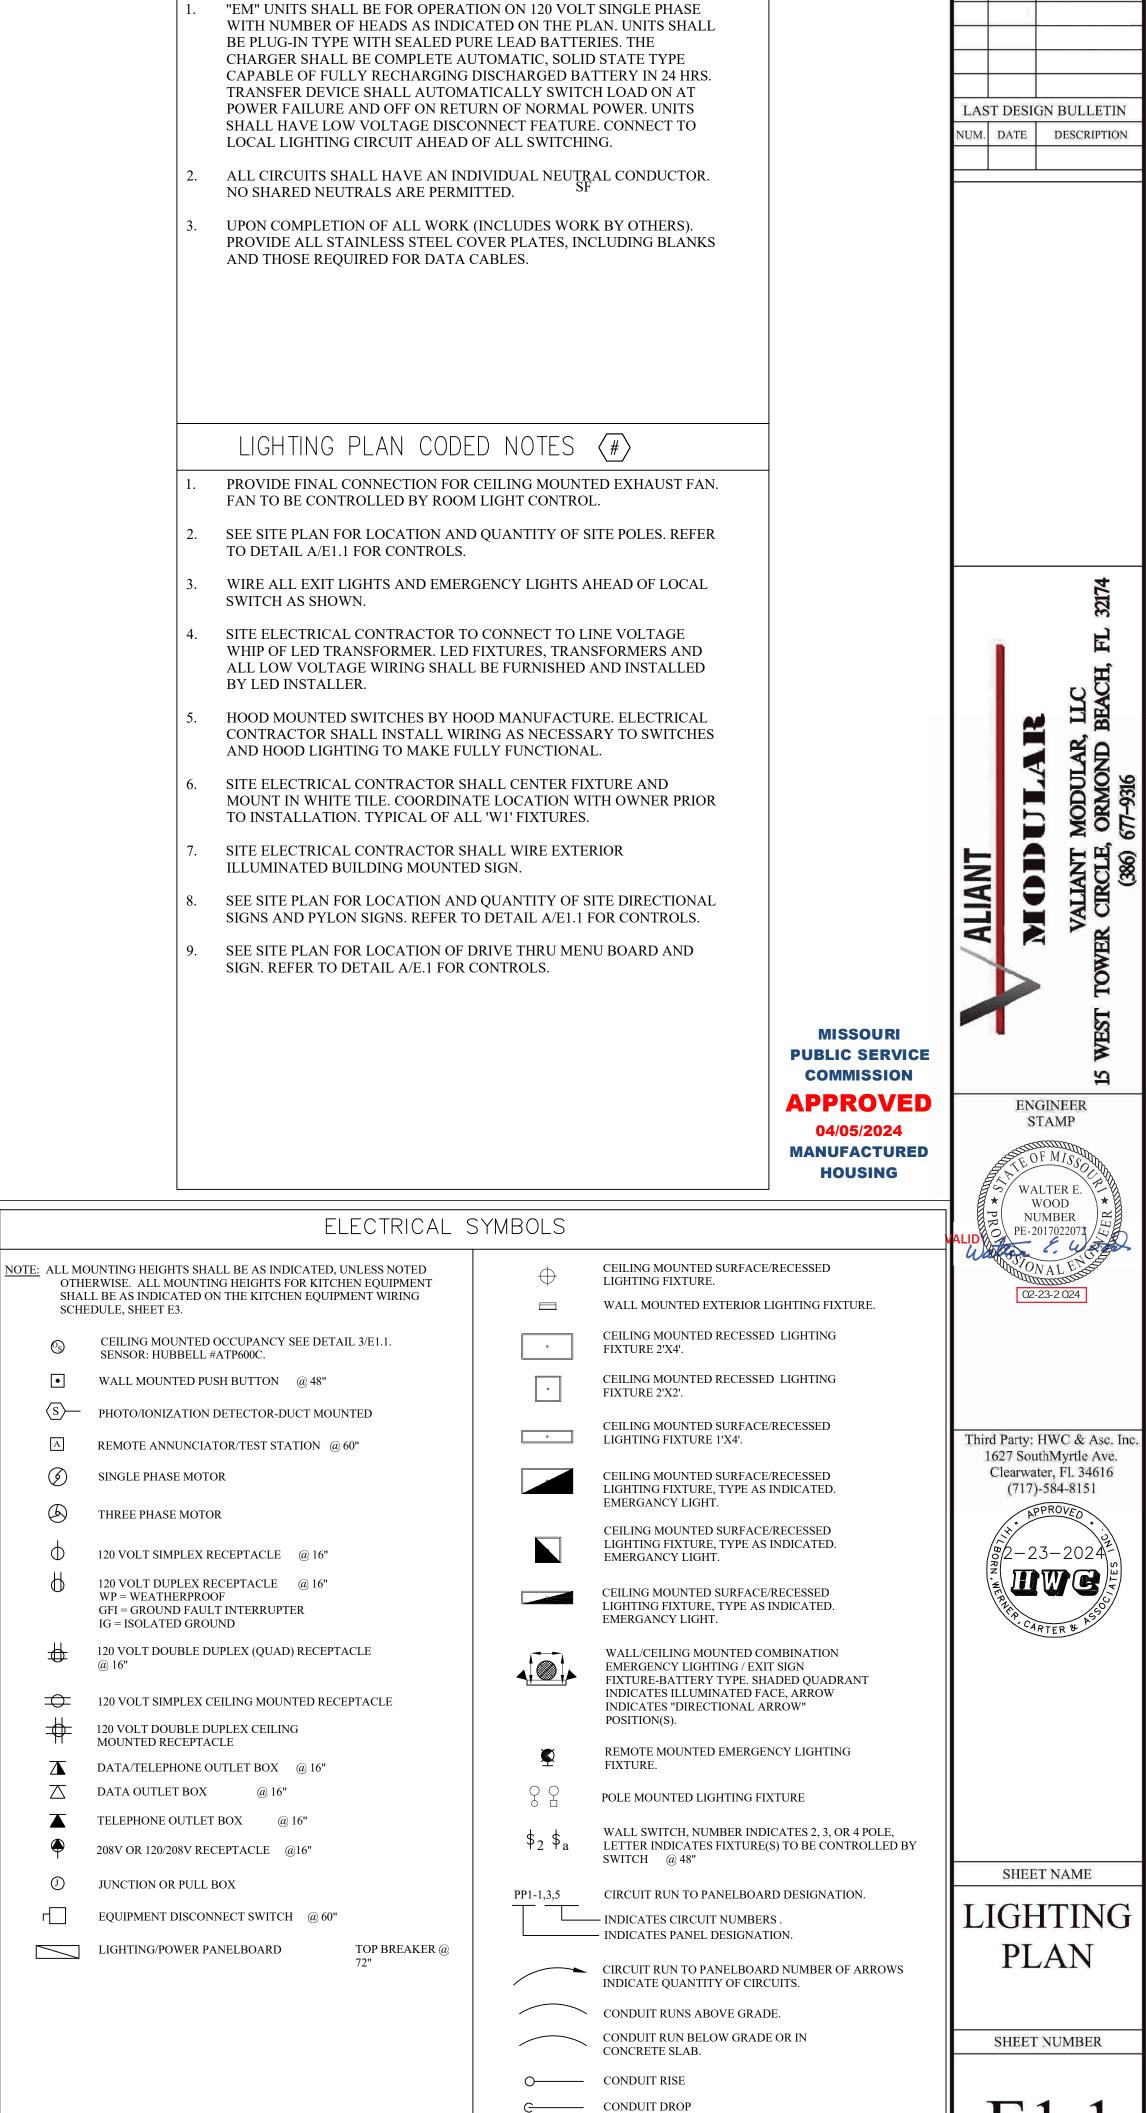


UNSWITCHED LEG


SWITCHED LEG

GENERAL NOTES

REVISION/ UPLOAD DATE

REV. DATE DESCRIPTION

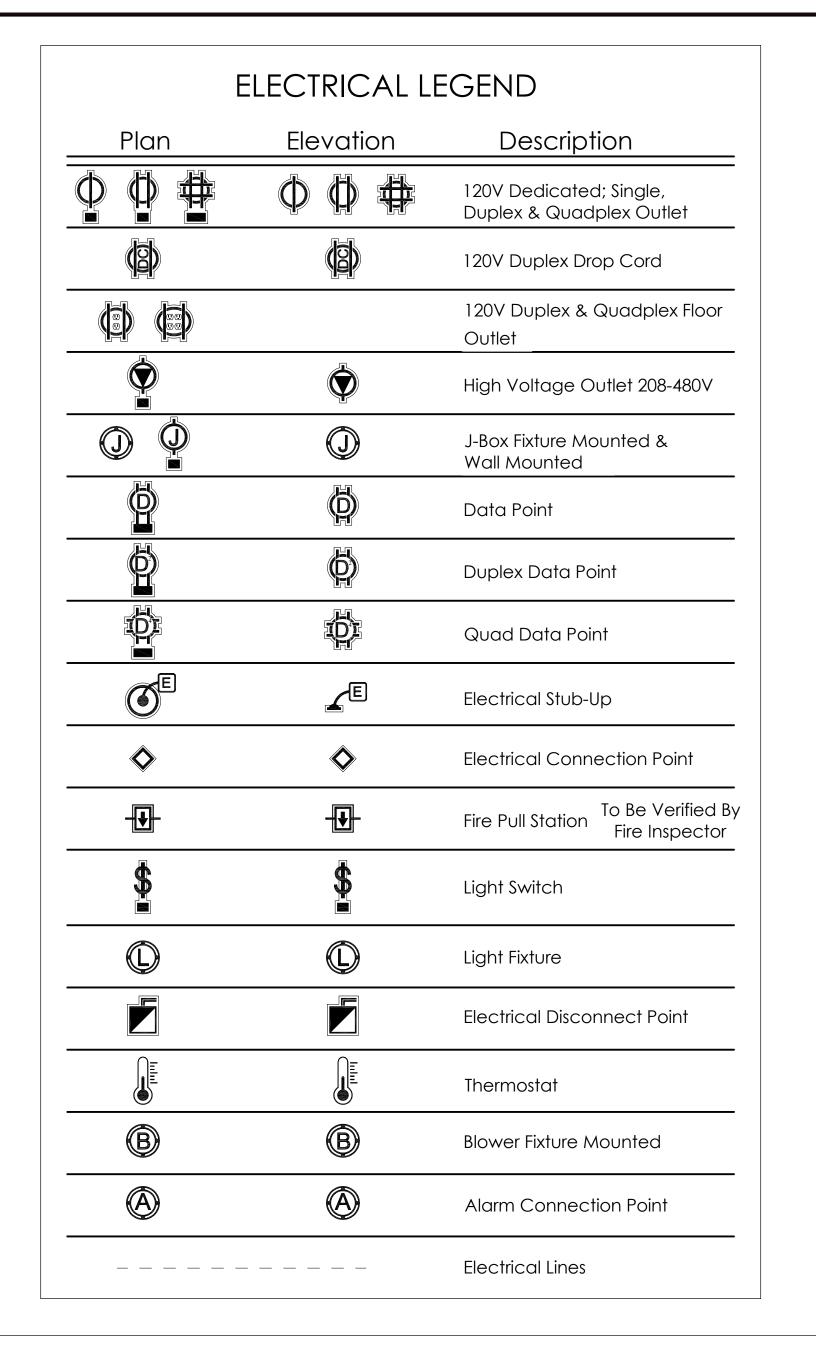

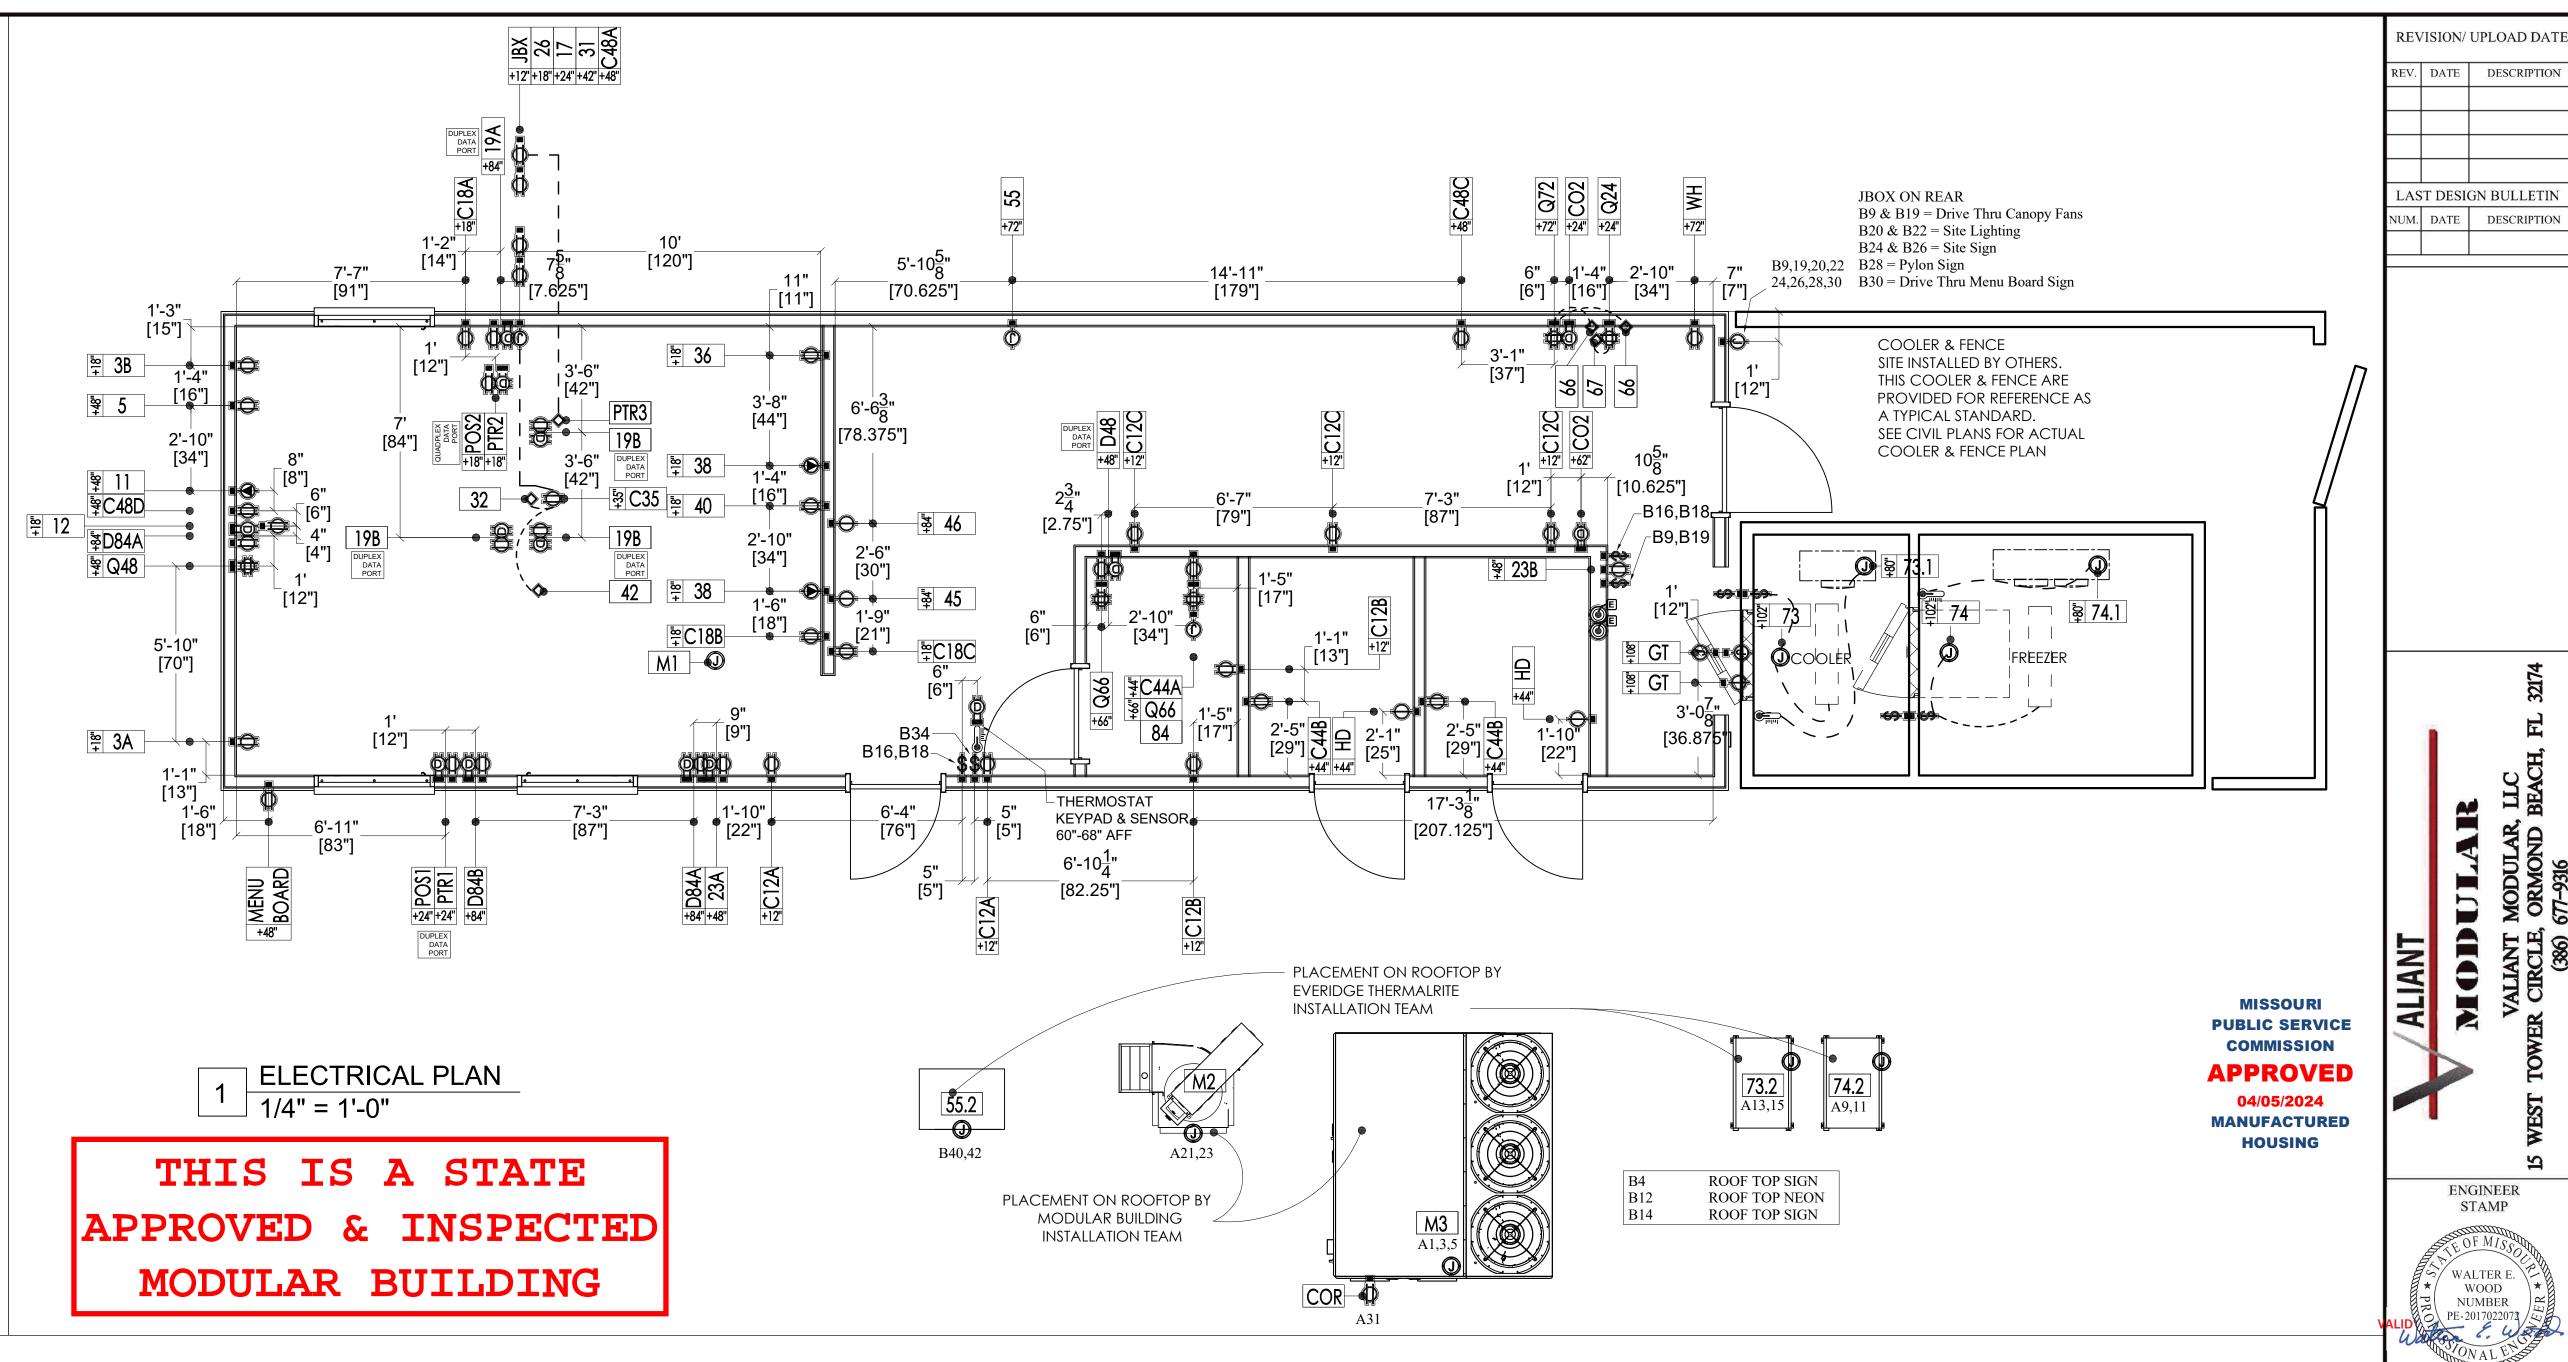

	,					ectrical Sc	JI ICUU			,		
Item Iumber	Circuit Number	Count	Equipment Description	Connection Description	FL Amp	Watts	HP	Volts	Phase	Conn Plug	Elec RI Height	Electrical Remarks
3A	A30	1	Soda Dispenser - Patio	Duplex Outlet	10.0 A			120 V	1	5-15P	18"	E.C. To Verify Loads w/ Vendor Supplied Equipment
3B	A36	1	Soda Dispenser - Drive Thru	Duplex Outlet	10.0 A			120 V	1	5-15P	18"	E.C. To Verify Loads w/ Vendor Supplied Equipment
5	B41	1	Tea Brewer	Duplex Outlet	14.0 A			120 V	1	5-15P	48''	By Owner-Verify w/ Owner
11	A2,A4	1	Shake Machine	High Voltage Outlet	12.0 A	2496 W	1/2	208 V	1	L6-15P	48''	Verify plug connection w/ Vendor
12	A39	1	Refrigerator, Undercounter	Duplex Outlet	3.0 A	345 W	1/5	115 V	1	5-15P	18"	
17	B17	1	Warmer	Duplex Outlet	8.3 A	1000 W		120 V	1	5-15P	24"	3+WIRE
19A	A35	1	Kitchen Display System - Drive Thru	Duplex Outlet & Data				120 V	1	5-20P	84"	By Owner - Verify w/ Owner, Data required
19B	В3	3	Kitchen Display System - Ceiling	Duplex Outlet & Data				120 V	1	5-20P		By Owner - Verify w/ Owner, Data required
23A	B35	1	Phone - Front	Duplex Outlet & Data				120 V	1	5-15P	48''	By Owner - Verify w/ Owner
23B	B25	1	Phone - Rear	Duplex Outlet				120V	1	5-15P	48''	By Owner - Verify w/ Owner
26	B31	1	Freezer, Worktop	Duplex Outlet	3.6 A	414 W	1/5	115 V	1	5-15P	18"	
31	B15	1	Hot Food Holding Station	Duplex Outlet	15.1 A	1820 W		120 V	1	5-20P	42"	
32	B23	1	Food Pan Warmer	Power Connection	4.2 A	500 W		120 V	1	5-15P		Plug into work table outlet
36	A8	1	Fryers	Duplex Outlet	6.0 A			120 V	1	5-15P	18"	
38	A38,A40,A42	1	2 Platen Electric Double-Sided Grill	High Voltage Outlet	48.0 A	16800 W		208 V	3	15-60P	18"	
38	A46,A48,A50	1	2 Platen Electric Double-Sided Grill	High Voltage Outlet	48.0 A	16800 W		208 V	3	15-60P	18"	
40	A16	1	Refrigerated Prep Table	Duplex Outlet	2.3 A	265 W	1/5	115 V	1	5-15P	18"	
42	B23	1	Toaster, Vertical	Power Connection	13.0 A	1500 W		120 V	1	5-15P		Plug into work table outlet
45	A43	1	Freezer, Reach-In	Dedicated Outlet	8.5 A	973 W		115 V	1	5-15P	84"	
46	A41	1	Refrigerator, Reach-In	Dedicated Outlet	5.0 A	575 W		115 V	1	5-15P	84"	
55	B36	1	Ice Cube Machine, Remote w/ 50' Line Set	JBox	2.9 A	334 W		115 V	1	Direct	72"	
55.2	B40,B42	1	Icemaker Condenser, Remote	JBox	15.0 A	3120 W		208 V	1	Direct		208-230V/60/1
66	A51	2	Soda Carbonator	Power Connection	7.0 A		1/3	120 V	1	5-20P		By Vendor - verify requirements
67	B13	2	BIB Rack	Power Connection				120 V	1	5-15P		By Vendor - Verify w/ Vendor
73	A37	1	Walk-In Cooler	JBox		61 W		120 V	1	Direct	102"	See Shop Drawings
73.1	A37	1	Evaporator Coil (Refrigerator), Walk-In	JBox	0.8 A	92 W		115 V	1	Direct	80''	See Shop Drawings
73.2	A13,A15	1	Cooler Condenser, Walk-In	JBox	5.9 A	1227 W		208 V	1	Direct		See Shop Drawings
74	A37	1	Walk-In Freezer	JBox		61 W		120 V	1	Direct	102"	See Shop Drawings
74.1	A17,A19	1	Evaporator Coil (Freezer)	JBox	10.8 A	2246 W		208 V	1	Direct	80''	See Shop Drawings
74.2	A9,A11	1	Freezer Condenser	JBox	12.4 A	2587 W		208 V	1	Direct		See Shop Drawings
84	-	1	Networking Box	JBox						Direct		Data, By Vendor - Verify w/ Vendor

					e	chedule	Electrical Sc	E					
	Electrical Remarks	Elec RI Height	Conn Plug	Phase	Volts	HP	Watts	FL Amp	Connection Description	Equipment Description	Count	Circuit Number	Item Number
Third Party: HWC & Ass	By EC	12"	5-20R	1	120 V				Duplex Outlet	Duplex Convenience Outlet - Front Door	2	B21	C12A
1627 SouthMyrtle Av	By EC	12"	5-20R	1	120 V				Duplex Outlet	Duplex Convenience Outlet - Office	2	В1	C12B
Clearwater, Fl. 3461 (717)-584-8151	By EC	12"	5-20R	1	120 V				Duplex Outlet	Duplex Convenience Outlet - Rear	3	A45	C12C
(,,,,,,,,,,,,,,,,,,,,,,,,,,,,,,,,,,,,,,	By EC	18"	5-20R	1	120 V				Duplex Outlet	Duplex Convenience Outlet - Drive Thru	1	B29	C18A
APPROVED	By EC	18"	5-20R	1	120 V				Duplex Outlet	Duplex Convenience Outlet - Hood	1	A12	C18B
	By EC	18"	5-20R	1	120 V				Duplex Outlet	Duplex Convenience Outlet - Rear Hood	1	A33	C18C
(° /2-23-202 ²	By EC	35"	5-20R	1	120 V				Duplex Outlet	Duplex Convenience Outlet - Work Table	1	-	C35
■ <i>∞</i>	By EC	44"	5-20R	1	120 V				Duplex Outlet	Duplex Convenience Outlet - Office	1	B1	C44A
	By EC	44"	5-20R	1	120 V				Duplex Outlet	Duplex Convenience Outlet - Bathrooms	2	B37	C44B
TATES SE	By EC		5-20R	1	120 V				Duplex Outlet	Duplex Convenience Outlet - Drive Thru	1	В33	C48A
CARTER & A	By EC		5-20R	1	120 V				Duplex Outlet	Duplex Convenience Outlet - Rear	1	A47	C48C
	By EC		5-20R	1	120 V				Duplex Outlet	Duplex Convenience Outlet - Front		A39	C48D
1	By EC		Data						Data	Data Outlet - CO2 Sensor		-	CO2
1	By EC		5-20R	1	120 V				Duplex Outlet	Duplex Convenience Outlet - Roof	1	A31	COR
1	By EC		5-20R	1	120 V			ita	Duplex Outlet & Data	Duplex Convenience Outlet & Data - Office		В1	D48
1	By EC		5-15P	1	120 V		+	ita	Duplex Outlet & Data	Duplex Convenience Outlet & Data - Front & Patio	2	B27	D84A
	By EC		5-15P	1	120 V		+		Duplex Outlet & Data	Duplex Convenience Outlet & Data - Patio	1	A35	D84B
	By EC		Direct	1	120 V				JBox	Grease Tank - Used Cooking Oil	2	A6	GT
	By EC		Direct	1	120 V				JBox	Hand Dryer - Bathrooms		A27	HD
	By EC		Direct	1	120 V				JBox	Extended MC Cable JBox		-	JBX
CHEET NAME	See Shop Drawings		Direct	1	120 V				JBox	Hood System Controls		A7	M1
SHEET NAME	See Shop Drawings		Direct	3	208 V	2.00	2126 W	5.9 A	JBox	Exhaust Fan - Hood		A21,A23,A25	M2
	See Shop Drawings		Direct	3	208 V		27524 W	76.4 A	JBox	Dedicated Outside Air System RTU	1	A1,A3,A5	M3
ELECTRICA	By Owner - Verify w/ Owner, Data required	24"	5-15P	1	120 V				Pwr & Data	POS - Patio		B5	POS1
	By Owner - Verify w/ Owner, Data required		5-15P	1	120 V		+	a	Pwr & Duplex Data	POS - Drive Thru	1	B5	POS2
POWER	By Owner - Verify w/ Owner, Data required		5-15P	1	120 V				Pwr & Data	PTR - Patio		B5	PTR1
PLAN	By Owner - Verify w/ Owner, Data required		5-15P	1	120 V			a	Pwr & Duplex Data	PTR - Drive Thru		B5	PTR2
7 0 - 000 M000 =	By Owner - Verify w/ Owner, Data required		5-15P	1	120 V				Pwr Connection & Data	PTR - Work Table		B33	PTR3
SHEET NUMBER	By EC		5-15P	1	120 V				Quadplex Outlet	QCO - BIB Rack		-	Q24
SHELT NONDER	By EC		5-15P	1	120 V		+		Quadplex Outlet	QCO - Front		A29	Q48
	By EC		5-15P	1	120 V				Quadplex Outlet	QCO - Office		B7	Q66
	By EC		5-15P	1	120 V				Quadplex Outlet	QCO - Soda Carbonator		-	Q72
L i')	By Vendor - Verify w/ Vendor		5-15P	1	120 V		98 W	4.0 A	Duplex Outlet	Water Heater		B11	WH

ENGINEER

S WALTER E.

NUMBER

										PANE	LBOA	RD SC	HEDULE										
			PANI	EL: "A"		RATIN	G: 600	AMP M	CBW/ 20	0 AMP N	ILO SI	JB BRE	AKER		AI.C.: 4	2KAIC		MOUNT	NG: SU	RFACE			
			LOCA	ATION:	REARIN	TERIOR		SERMO	CE: 120/2	208V, 3¢	, 4W		TYPE: S	Q-DTLI	NE OR EC	DAL.		LUGLO	CATION	:TOP			
										ı													
_					3/0			8854			-	-	-			-	-	-	-	-	-	-	
_	-	200 AMP SUB PANEL	200	3	3/0	208			12760		-	-		-		-	-	-	-	-	-	-	<u> </u>
-				<u> </u>	3/0					9932	-	-			-	-	-	-	-	-	-	-	
σĪ	EQUIPMENT		BKR	I	WIRE		Ι	LEET DE	HASE LO	ΛD Λ/Λ\	CKT.	CKT	DICH	TPHASE	LOVD			WIRE		BKR		EQUIPM EN	πГα
0.	#	DESCRIPTION	AMP	POLE	NO.	VOLTS	KW	Δ	B	C (VA)	NO.		Δ	B	C	KW	VOLTS	NO.	POLE	AMP	DESCRIPTION	#	N
1	"		80		4			9174			1	2	1248		•			12		20		"	
3	M3	DOASRTU (H)	80	3	4	208	27.5		9174		3	4		1248		2.5	208	12	2	20	(K) FROZEN BEVERAGE MACHINE	11	
5		• •	80	i	4					9174	5	6			1800	1.8	120	12	1	20	(O) GREASETANK	GT	(
7	M1	HOOD SYSTEM CONTROLS (K)	15	1	12	120	1.4	1350			7	8	720			0.7	120	12	1	20	(K) FRYER	36	
)	74.2	WALK-IN FREEZER CONDENSER (K)	20	2	12	208	2.6		1294		9	10						-		-	SHUNT	-	1
1	14.2	WALKIN FREEZER CONDENSER (N)	20	2	12	200	2.0			1294	11	12			360	0.4	120	12	1	20	(R) DUPLEXCON VENIENCE OUTLET-HOOD	C18B	1
3	73.2	WALK-IN COOLER CONDENSER (K)	20	2	12	208	1.2	614			13	14	_			-	-	-	_	-	SHUNT	-	1
5	10.2	TIPE CONTENT OF THE PROPERTY O	20	_	12	200	1		614		15	16		265		0.3	120	12	1	20	(K) PREP FRIDGE	40	1
7	74.1	EVAPORATOR COIL (FREEZER) (K)	20	2	12	208	2.2			1123	17	18			-	-	-	-	-	-	SHUNT	-	1
9		7,13	20		12			1123			19	20	-			-	120	-	1	20	SPARE	-	- 1
1		U005 FM W075W 40	15	_	12				709		21	22		-		-	120	-	1	20	SPARE	-	4
3	M2	HOOD EXHAUST FAN (K)	15	3	12	208	2.1	700		709	23	24			-	-	120	-	1	20	SPARE	-	- 1
5	UB	II AND DESCRIPTION (C)	15		12	400		709	4000		25	26	-			-	120	-	1	20	SPARE	-	-
7 9	HD O48	HAND DRYER-BATHROOM (O)	20	1	12	120 120	1.8 0.7		1800	720	27	28 30		-	1200	- 40	120	40	1	20 20	SPARE	- 24	3
1	Q48 COR	QUAD CONVENIENCE OUTLET- FRONT(R) DUPLEXCONVENIENCE OUTLET- ROOF (R)	20	1	12 12	120	0.7	360		720	29 31	32			1200	1.2	120 120	12	1	20	(K) SODADISPEN SER - PATIO SPARE	3A	
+	COR	DUPLEX CONVENIENCE OUTLET - REAR	20		12	120	0.4	300			JI	32				-	120	-	-	20	STARL	-	+
3	C18C	HOOD (R)	20	1	12	120	0.4		360		33	34		-		-	120	-	1	20	SPARE	-	3
5	19A, D84B	KDS-DRIVE THRU, DUPLEX CONVENIENCE OUTLET-PATIO (K)	20	1	12	120	0.5			540	35	36			1200	1.2	120	12	1	20	(K) SODADISPENSER - DRIVE THRU	3B	3
7	73, 74, 73.1	EVAPORATOR COIL (COOLER), WALK-IN (K)	20	1	12	120	0.2	214			37	38	5600					6		60			3
9	12, C48D	UN DERCOUNTER FRIDGE, DUPLEX CONVENIENCE OUTLET (K)	20	1	12	120	0.7		705		39	40		5600		16.8	208	6	3	60	(K) CLAMSHELL GRILL	38	4
1	46	REACH-IN FRIDGE (K)	20	1	12	120	0.6			575	41	42			5600			6		60			4
3	45	REACH-IN FREEZER (K)	20	1	12	120	1.0	973			43	44	_				_	-	_	-	SHUNT	-	4
5	C12C	DUPLEX CONVENIENCE OUTLET - REAR (R)	20	1	12	120	1.1		1080		45	46		5600				6		60			-
7	C48C	DUPLEX CONVENIENCE OUTLET - REAR (R)	20	1	12		0.4			360	47	48			5600	16.8	208	6	3	60	(K) CLAMSHELL GRILL	38	4
9	-	SPARE	20	1	-	120	-	-			49	50	5600					6		60			
1	Q72(66)	SODACARBONATOR (O)	20	1	12	120	1.6		1610		51			-		-	-	-	-	-	SHUNT	-	
3	-	SPARE	20	1	-	120	-	00074	00400	-	53	54	40400	10710	-	-	120	-	1	20	SPARE	-	5
					SUBTOTA	AL		23371	30106	2442/			13168	12713	15/60								
				1	TOTAL-1	VΑ		36539															
					TAL-A			304	357	335													
					AL PANE			119545															
				TOTAL	.PANEL	- AMPS		332															

										PANE	LBOA	RD SC	HEDULE										
			PAN	EL: "B"				RATI	NG: 200	AMP M L	.0				AI.C.: 4	2KAC		MOUNT					
						NTERIOR				208V, 3¢	•			Q-DILI		QUAL			CATION				
KT. NO.	EQUIPMENT #	DESCRIPTION	BKR AMP	DOLE	WIRE NO.	VOLTS	ĸw	LEFT PH A	IASE LO. B	AD (VA)	CKT. NO.	1 1	RIGHT A	TPHASE B	LOAD C	KW	VOLTS	WIRE NO.	POLE	BKR AMP	DESCRIPTION	EQUIPMENT #	T CK
1	C12B, C44A, D48	DUPLEX CONVENIENCE OUTLET-OFFICE (R)	20	1	12	120	1.4	1440			1	2	500			0.5	120	12	1	20	(L) EXTERIOR LIGHTING (C)		2
3	19B	KDS-CEILING (K)	20	1	12	120	0.5		540		3	4		500		0.5	120	12	1	20	(L) ROOF TOP SIGN (C)		4
5	PTR1, PTR2, POS1, POS2	POS - DRIVE THRU & PATIO, PTR - DRIVE THRU & PATIO (K)	20	1	12	120	0.7			720	5	6			-	-	120	-	1	20	SPARE	-	6
7	Q66	QUAD CONVENIENCE OUTLET - OFFICE (R)	20	1	12	120	1.4	1440			7	8	-			-	120	_	1	20	SPARE	-	8
9	-	CAN OPYFANS - DRIVE THRU (O)	20	1	12	120	1.8		1800		9	10		1440		1.4	120	12	1	20	(R) DUPLEXWP OUTLET-EXTERIOR		10
11	WH	WATER HEATER (K)	20	1	12	120	0.1			98	11	12			500	0.5	120	12	1	20	(L) ROOFTOP SIGN (C)		12
13	024(67)	BIB (BAG-IN-BOX) RACK (K)	20	1	12	120	0.4	360			13	14	500			0.5	120	12	1	20	(L) ROOF TOP SIGN (C)		14
15	31	HOT FOOD HOLDING STATION (K)	20	1	12	120	1.8		1820		15	16		500		0.5	120	12	1	20	(L)INTERIOR LIGHTING		16
17	17	WARMER (K)	20	1	12	120	1.0			1000	17	18			500	0.5	120	12	1	20	(L)INTERIOR LIGHTING		18
19	-	CAN OPYFANS - DRIVE THRU (O)	20	1	12	120	1.8	1800			19	20	500			0.5	120	12	1	20	(L) SITE LIGHTING (C)		20
21	C12A	CONVENIENCE OUTLET - FRONT DOOR (R)	20	1	12	120	0.7		720		21	22		500		0.5	120	12	1	20	(L) SITE LIGHTING (C)		22
23	C35 (32 & 42)	FOOD PAN WARMER & VERTICAL TOASTER (K)	20	1	12	120	2.0			2000	23	24			500	0.5	120	12	1	20	(L) SITE SIGN (C)		24
25	23B	PHONE - REAR (K)	20	1	12	120	0.2	180			25	26	500			0.5	120	12	1	20	(L) SITE SIGN (C)		26
27	D84A	DUPLEX CONVENIENCE OUTLET - FRONT & PATIO (R)	20	1	12	120	0.7		720		27	28		500		0.5	120	12	1	20	(L) PYLON SIGN (C)		28
29	C18A	DUPLEX CONVENIENCE OUTLET - DRIVE TH RU (R)	20	1	12	120	0.4			360	29	30			500	0.5	120	12	1	20	(L) MENU BOARD (C)		30
31	26	FREEZER, WORKTOP (K)	20	1	12	120	0.4	414			31	32	500			0.5	120	12	1	20	(L) PHOTO CELL FEED		32
33	C48A	DUPLEX CONVENIENCE OUTLET - DRIVE TH RU (R)	20	1	12	120	0.4		360		33	34		1800		1.8	120	12	1	20	(L) PATIO LIGHTS & FANS		34
35	23A	PHONE - FRONT (K)	20	1	12	120	0.2			180	35	36			334	0.3	120	12	1	20	(K) ICE CUBE MACHINE	55	36
37	C44B	DUPLEXCONVENIENCE OUTLET- BATHROOM (R)	20	1	12	120	0.7	720			37	38	-			-	120	-	1	20	SPARE	-	38
39	-	SPARE	20	1	-	120	-		-		39	40		1560		3.1	200	12	2	20 20	(K) ICEMAKER CONDENSER	55.2	40
41	5	TEABREWER (K)	20	1	12	120	1.7			1680	41	42			1560	3.1	208	12	2	20	(K) ICEMANER CONDENSER	55.2	42
					SUBTOT	AL		6354	5960	6038			2500	6800	3894								
					ANELB			8854	12760														
					NELB-			74	106	83]												
				TOTA	LPANE	LB-VA		31546 88															

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WIREWAY (SITE INSTALLED BY OTHERS) NEEDED TO CONNECT THE FOLLOWING THROUGH THE JBOX ON THE REAR. B9, B19, B20, B22, B24, B26, B28, & B30

MISSOURI
PUBLIC SERVICE
COMMISSION
APPROVED
04/05/2024
MANUFACTURED
HOUSING

ALIANT

ENGINEER

WALTER E.

WOOD

NUMBER

Third Party: HWC & Asc. Inc

1627 SouthMyrtle Ave.

Clearwater, Fl. 34616

(717)-584-8151


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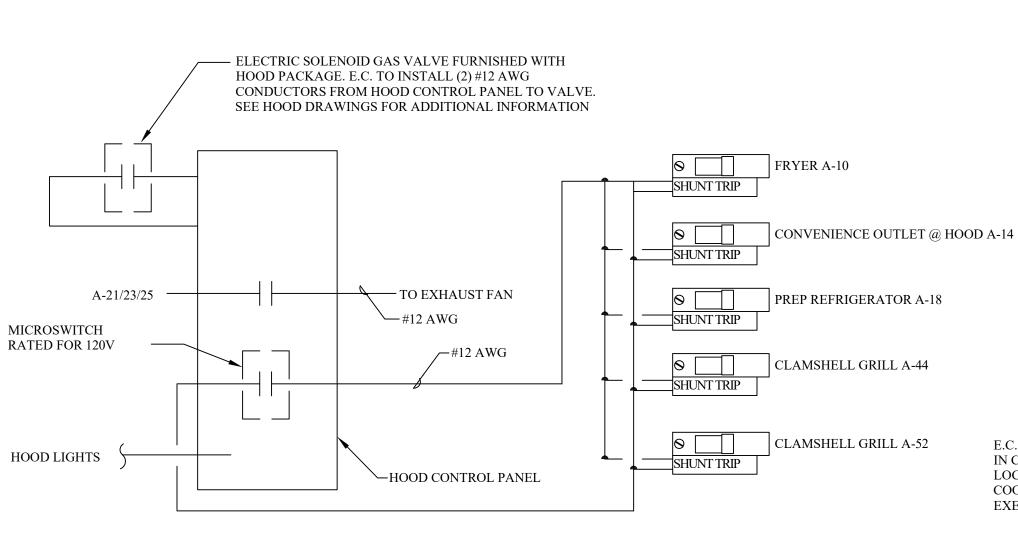
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SCHEDULE

SHEET NUMBER


LAST DESIGN BULLETIN
NUM. DATE DESCRIPTION



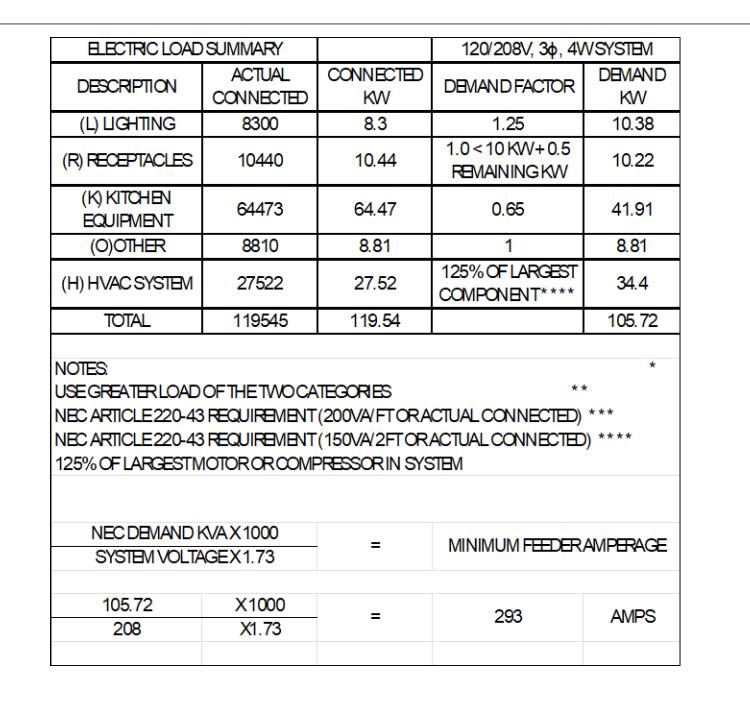

WIRING NOTES:

- 1. E.C. TO WIRE HOOD CONTROL PANEL WHICH WILL AUTOMATICALLY DE-ENERGIZE MAKE-UP AIR FAN, RTU-1, FANS, AND ENERGIZE THE EXHAUST FAN IN THE EVENT OF FIRE UNDER THE HOOD. THIS WILL ALSO DE-ENERGIZE THE ELECTRICAL EQUIPMENT UNDER THE HOOD VIA THE SHUNT TRIP BREAKERS.
- 2. E.C. TO COORDINATE REQUIREMENTS WITH HAVC CONTRACTOR, IF ANY, FOR A MOTOR STARTER FOR THE NEW ROOF MOUNTED EXHAUST FAN AND MAKE-UP AIR FAN.
- 3. E.C. SHALL FURNISH AND INSTALL ALL WIRING, UNLESS OTHERWISE NOTED, AND MAKE ALL FINAL CONNECTIONS TO EQUIPMENT SHOWN.

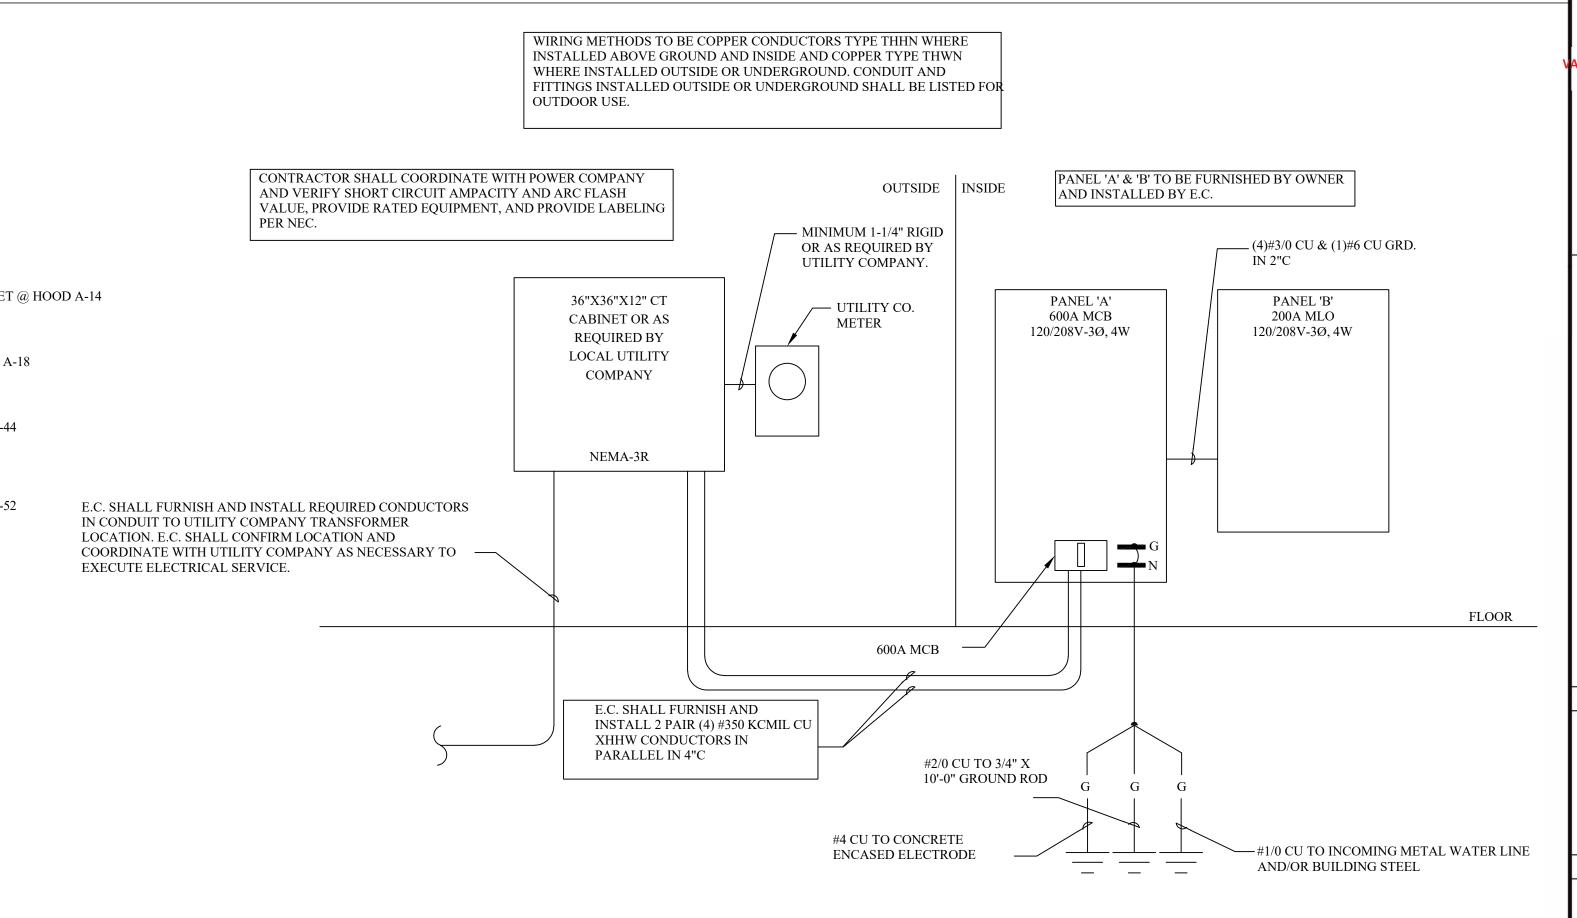



ELECTRICAL RISER DIAGRAM


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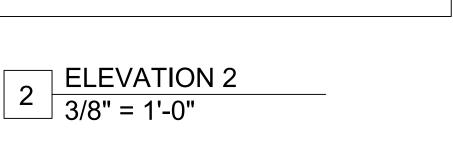
HOOD CONTROL PANEL WIRING DIAGRAM 2


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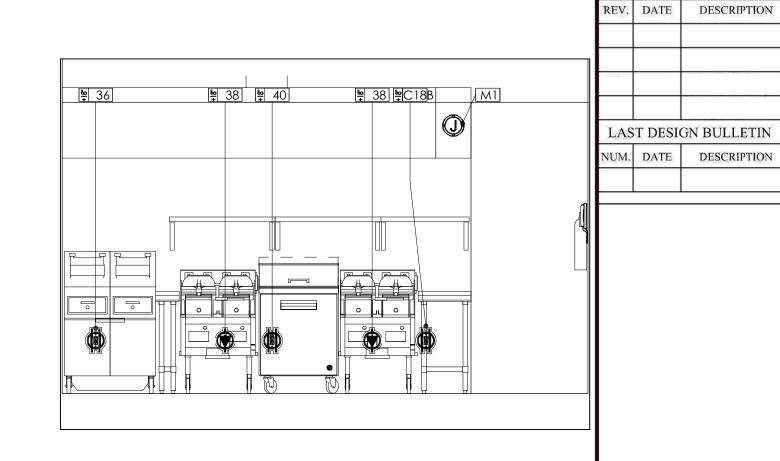




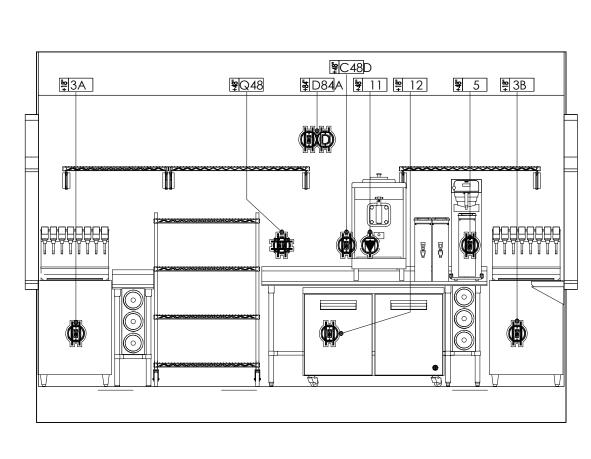


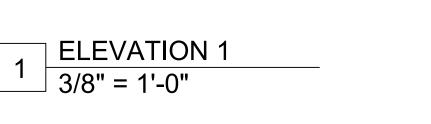


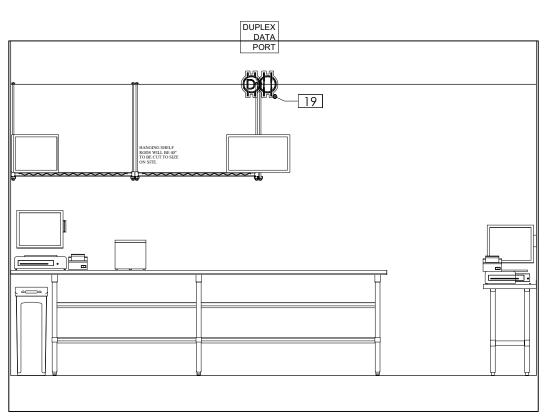
3 ELEVATION 3 3/8" = 1'-0"

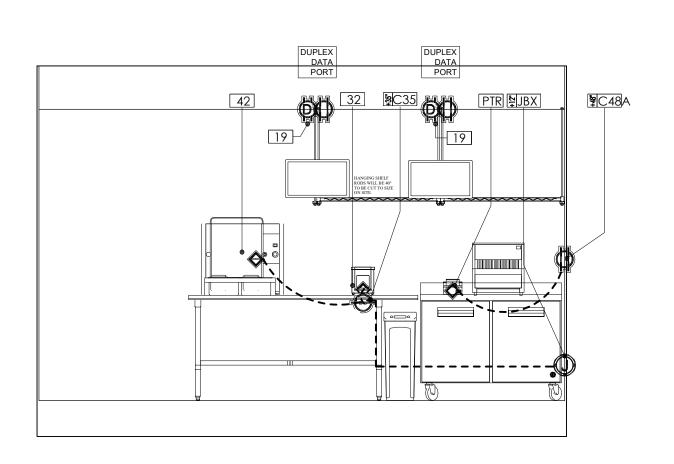


4 ELEVATION 4 3/8" = 1'-0"

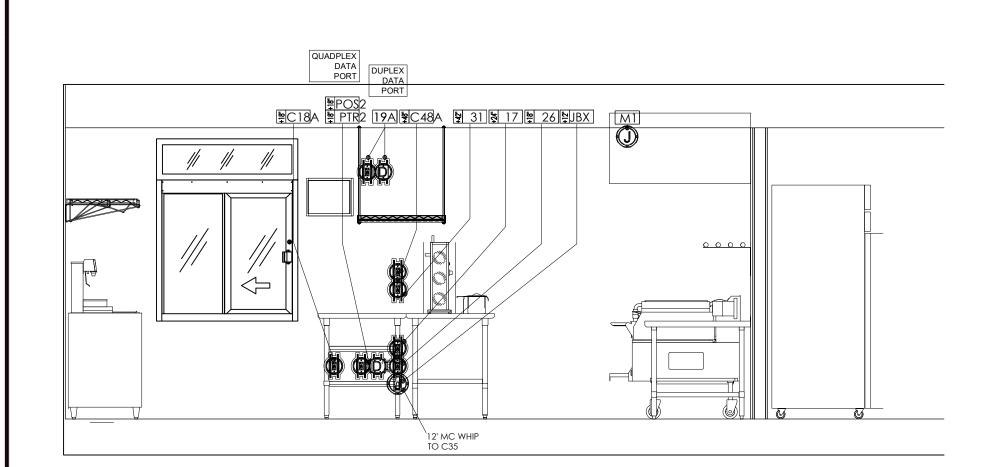


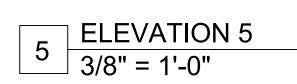

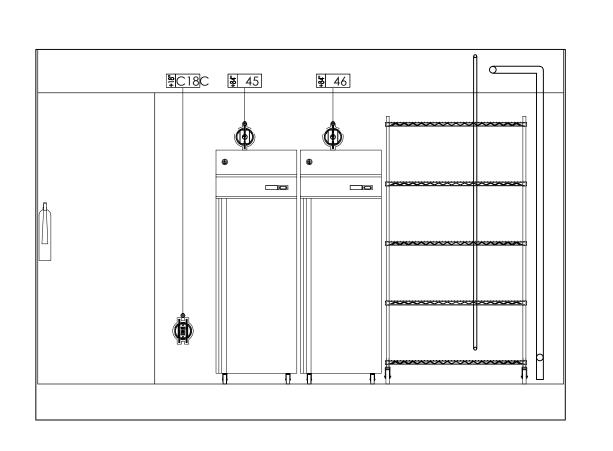

ELEVATION 6
3/8" = 1'-0"

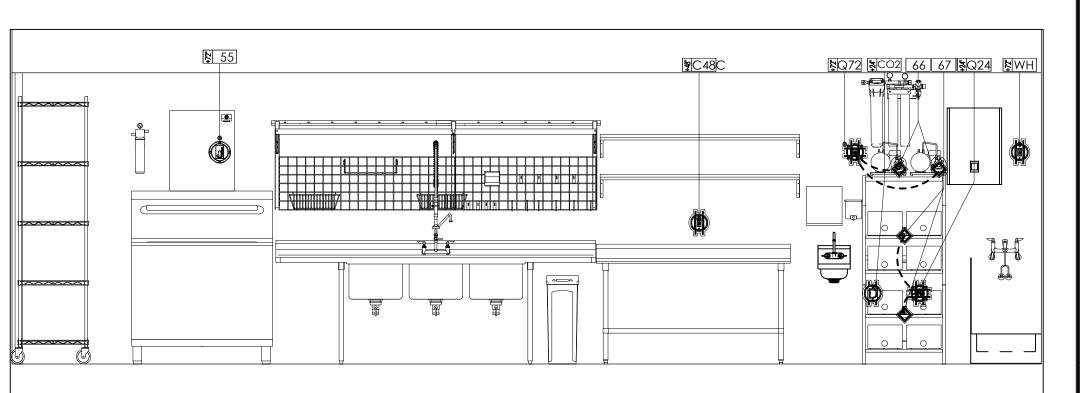

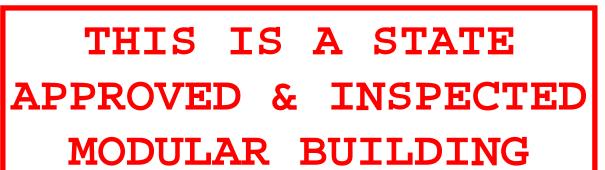

7 ELEVATION 7 3/8" = 1'-0"




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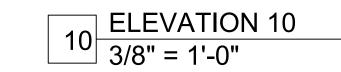
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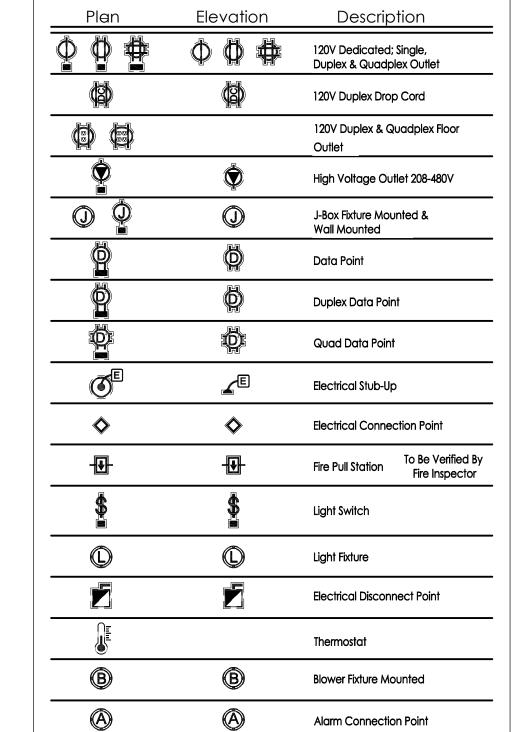
BOX

BOX

BOX







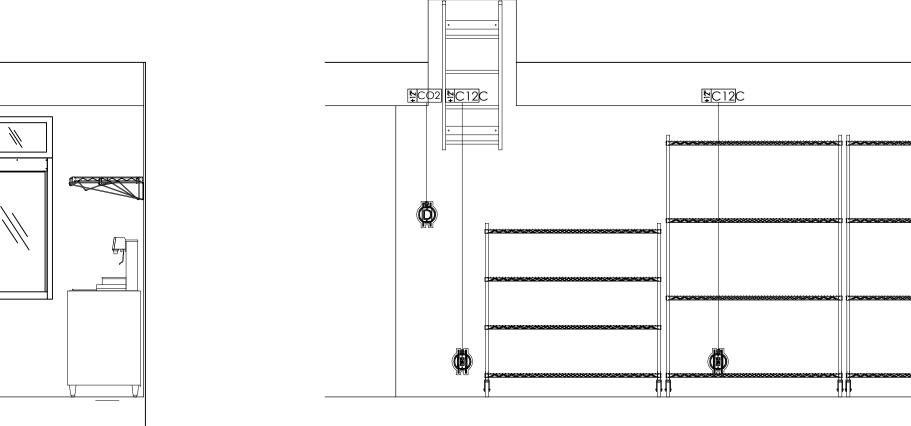


Electrical Lines

ELECTRICAL LEGEND

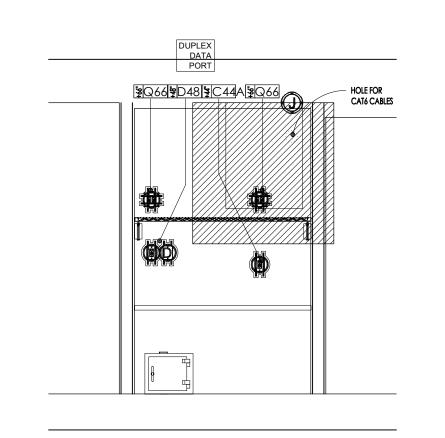

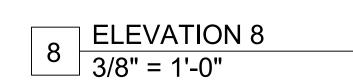

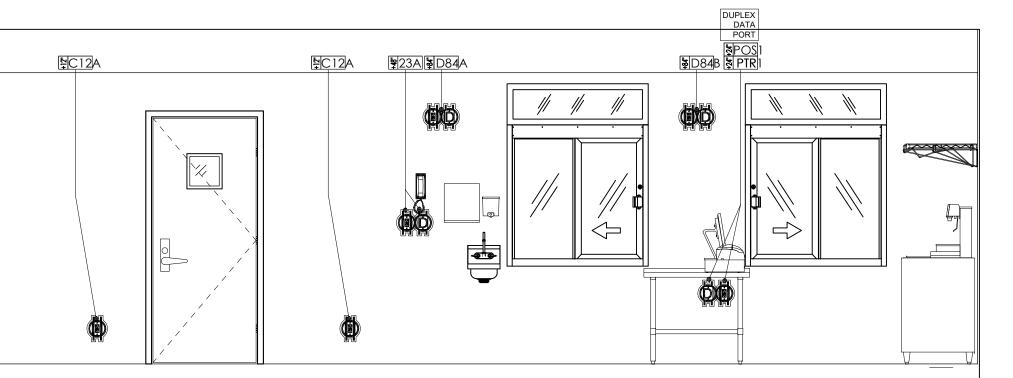

	ELEVATION 9
9	3/8" = 1'-0"

E4.1

ENGINEER STAMP

WALTER E.

WOOD
NUMBER
PE-2017022072

PD-2017022072

O2-23-2 024

MODULAR

ALIANT


REVISION/ UPLOAD DATE


Third Party: HWC & Asc. Inc. 1627 SouthMyrtle Ave. Clearwater, Fl. 34616 (717)-584-8151



SHEET NAME

ELECTRICAL ELEVATIONS

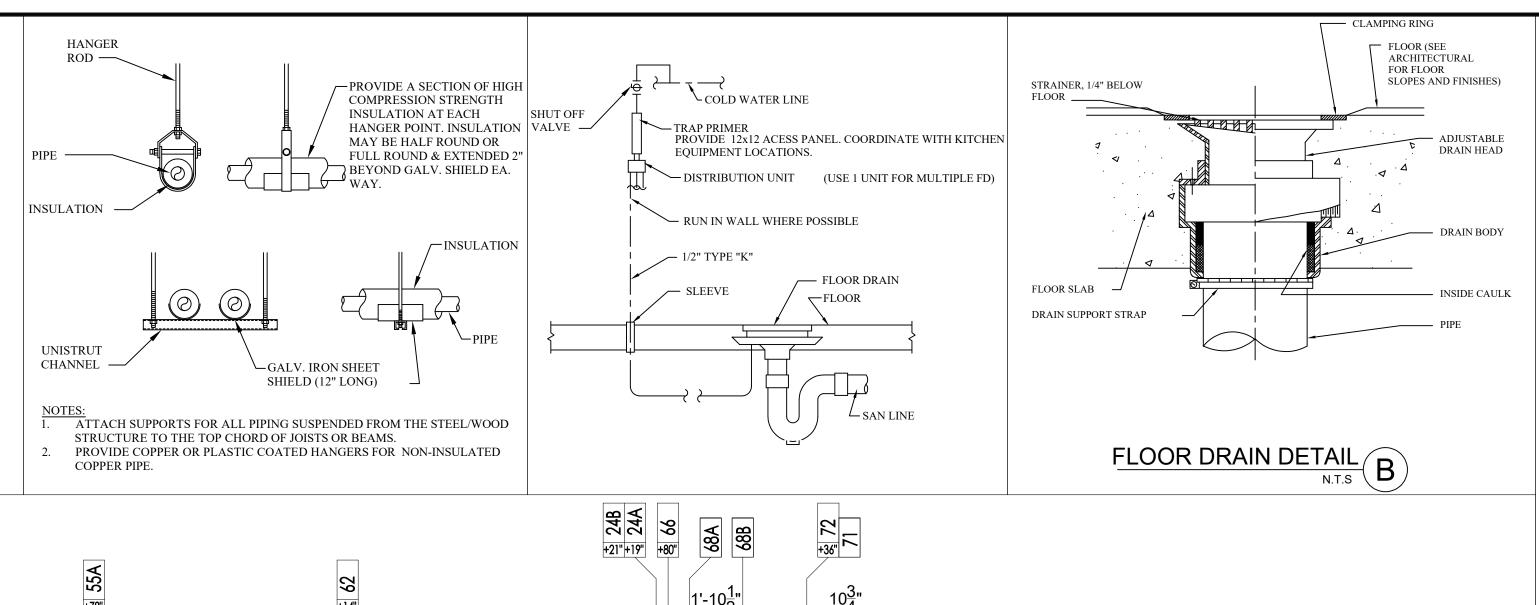

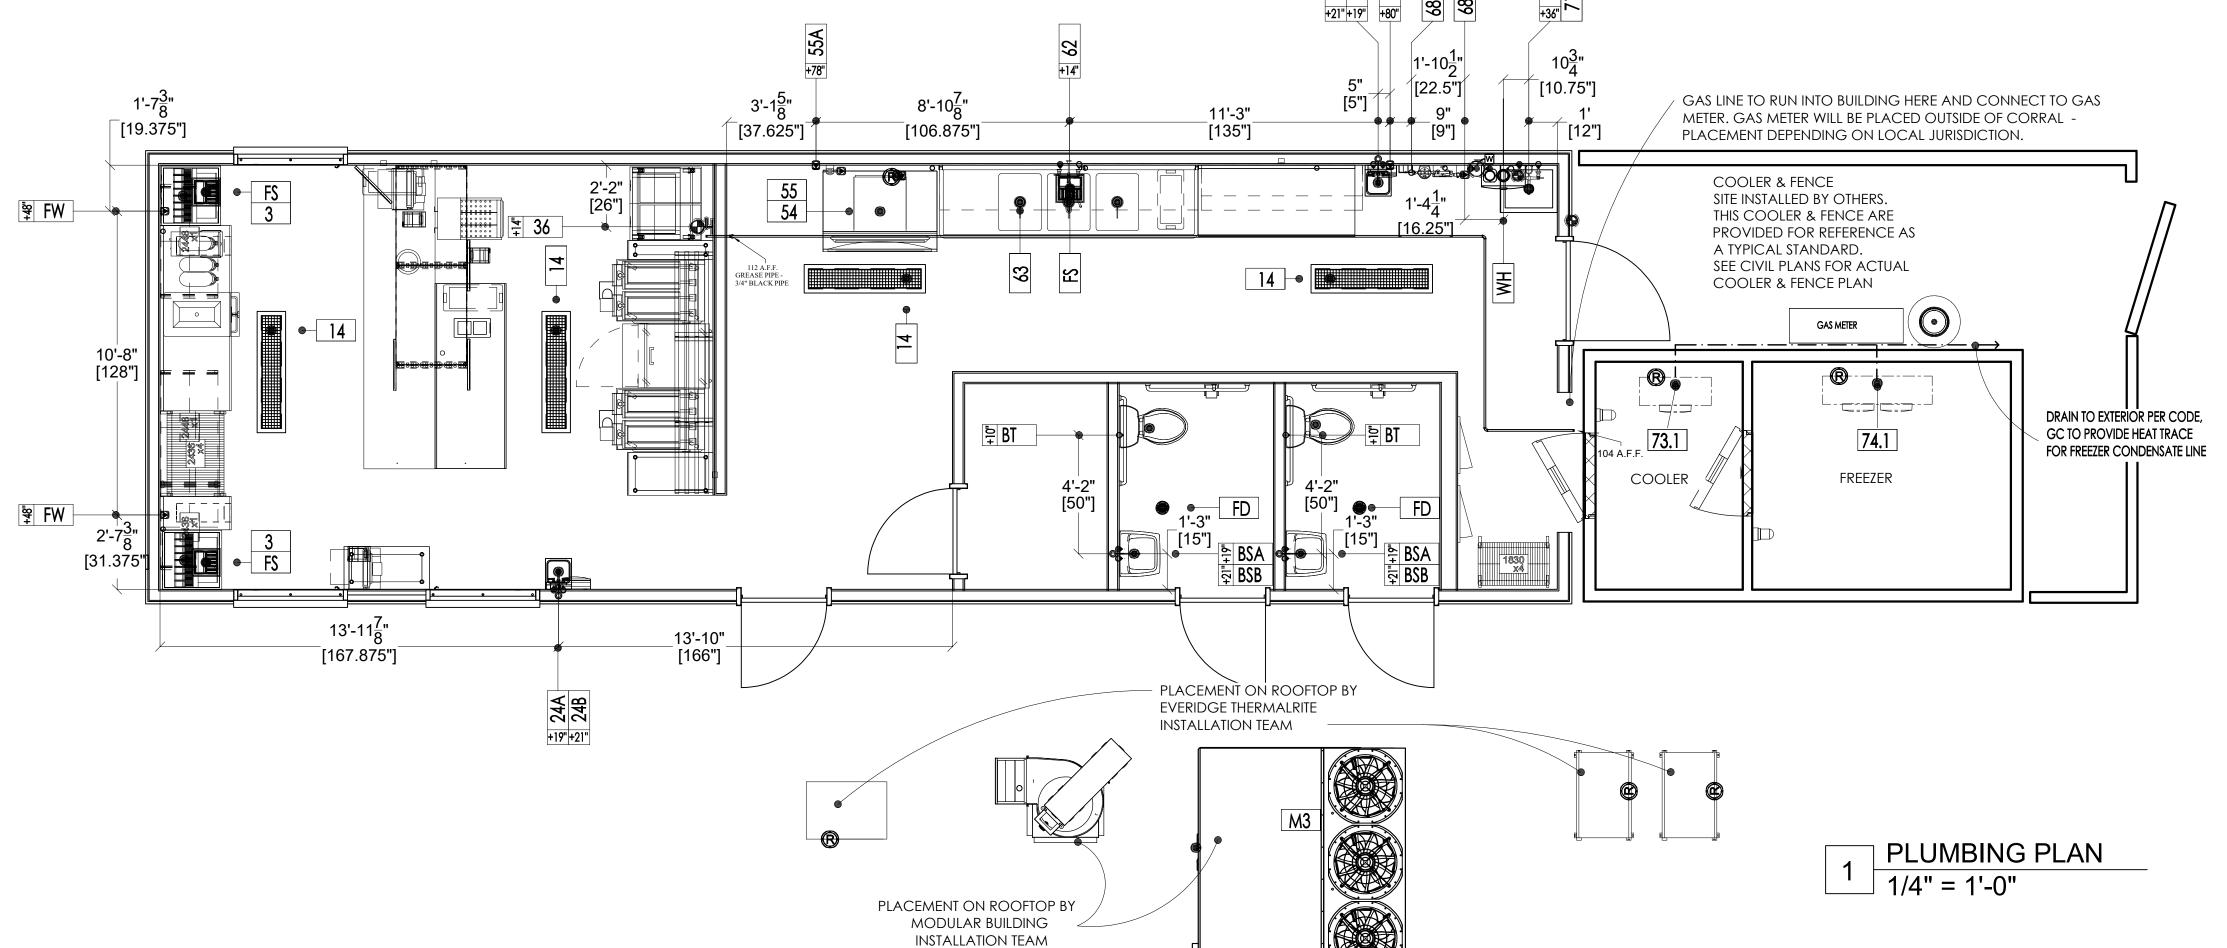

	PLUMBING LEGE	
Plan	Elevation	Description
•	0	Hotwater Connection Point
٥	<i>©</i>	Coldwater Connection Point
o	6	In Wall Direct Drain
	80	Hot&Cold Water w/Direct Drain
		Filtered Water Stub
Ø [₩]	W	Water Stub-Up
Q	©	Plumbing Connection Point
9	©	Gas Supply Line
O G	G	Gas Stub-Up
B	B	Beverage Stub-Up
	\P	Fixture Drain
		Water Lines
		Gas Lines
		Waste Lines
		Floor Drain Round & Square
		Funnel Floor Drain
		Floor Sink; 1/2 Grate, 3/4 Grate, Open Grate & Round

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						Plumb	oing Sch	hedule	Э						
Item Number	Count	Equipment Description	Connection Description	Cold Water Size	Cold Water RI	Hot Water Size	Hot Water RI	Filtered Water Size	Indirect Waste Size	Direct Waste Size	Direct Waste RI	Gas Size	Gas Input Btu/h	⊇ S O O Plumbing Remarks	Item Number
3	2	Soda Dispenser	Fixture Drain Indirect						3/4"					Verify Requirements w/ Owner, By Vendor, Air-Gap To FS	3
14		Floor Trough Drain	Penetration Drain						0, 1	3"	0"			Verify w/ Fabricator	14
24A		Hand Sink	Hot & Cold 4"	1/2"	19"	1/2"	19"			Ü				Telli y Wy Tablicard	24A
24B		Hand Sink	Direct Drain	.,_		.,_				1 1/2"	21"				24B
36		Fryers	Gas Supply							,		1"	140000	14"	36
54		Ice Bin	Fixture Drain Indirect						3/4"					Air-Gap to FS	54
55		Ice Cube Machine, Remote w/ 50' Line Set	Filtered Water					1/2"	-						55
55		Ice Cube Machine, Remote w/ 50' Line Set	Fixture Drain Indirect						3/4"						55
55A	1	Filter System, Ice Maker	Cold Water Stub	3/8"	78"			3/8"						Filtered water to 55	55A
62	1	Pre-Rinse Faucet Assembly, With Add-On Faucet	Hot & Cold 8"	1/2"	14"	1/2"	14"								62
63	1	Three (3) Compartment Sink	Fixture Drain Indirect						2''					Air-Gap To FS	63
66	1	Soda Carbonator	Filtered Water					1/4"						By Vendor - verify requirements	66
68A	1	Water Filtration System	Cold Water Stub	3/4"										Filtered Water To 5 and 66	68A
68B	1	Water Filtration System	Filtered Water					3/4"						Filtered Water To 5 and 66	68B
71	1	Mop Sink	Penetration Drain							2"	0''				71
72	1	Service Faucet	Hot & Cold 8"	1/2"	36"	1/2"	36"								72
73.1	1	Evaporator Coil (Refrigerator)	Fixture Drain Indirect						3/4"					Air-Gap To FS, See Shop Drawings	73.1
74.1	1	Evaporator Coil (Freezer)	Fixture Drain Indirect						3/4"					Air-Gap To FS, See Shop Drawings	74.1
BSA	2	Bathroom Sink	Hot & Cold 4"	1/2"	19"	1/2"	19"								BSA
BSB	2	Bathroom Sink	Direct Drain							1 1/2"	21"				BSB
BT	2	Bathroom Toilet	Cold Water Stub	1/2"	10"										ВТ
BT	2	Bathroom Toilet	Penetration Drain							2"	0''				ВТ
FD	2	Floor Drain	Penetration Drain							3"	0''			Verify w/ Fabricator	FD
FS	3	Floor Sink	Penetration Drain							3"	0''			Verify w/ Fabricator	FS
FW	2	Filtered Water Stub-Out	Filtered Water Stub					1/4"						Filtered Water From 68, By Vendor - Verify w/ Vendor	FW
МЗ	1	Make Up Air Unit	Gas Connection Point									3/4"	150000	See Shop Drawings	МЗ
WH	1	Water Heater	Cold Water Stub	3/4"		3/4"						3/4"	200000	By Vendor-Verify w/ Vendor	WH

GENERAL NOTES

- PROVIDE ALL LABOR, EQUIPMENT, AND MATERIALS NECESSARY TO EXECUTE THE PLUMBING WORK INDICATED ON THE DRAWINGS, AND AS
- REQUIRED BY LOCAL CODES AND ORDINANCES.

 2. PAY ALL FEES AND ARRANGE FOR EXECUTION OF ALL TAPS, METERS WITH
- REQUIRED ENCLOSURES (IF ANY), ETC. INHERENT TO THE INSTALLATION OF NEW PLUMBING SERVICE.

 3. PLUMBING WORK FOR THIS CONTRACT SHALL INCLUDE ALL PIPING FOR
- DOMESTIC HOT AND COLD WATER LINES, VENT AND SANITARY LINES, HOOK-UP OF ALL FIXTURES SCHEDULED ON THE DRAWINGS, AND INSULATION OF DESIGNATED PIPING RUNS. WORK SHALL ALSO INCLUDE ALL GAS PIPING AND EQUIPMENT CONNECTIONS WHERE REQUIRED.
 - ALL ITEMS SUCH AS FITTINGS, ETC. NOT MENTIONED BUT UNDERSTOOD TO BE NECESSARY TO COMPLETE THE PLUMBING SYSTEM SHALL BE INCLUDED.
 - SOIL, WASTE, AND VENT PIPING TO BE OF MATERIAL APPROVED BY LOCAL CODES. PVC, DWV PIPING AND FITTINGS TO BE SCHEDULE 40 AS A MINIMUM.
- 6. PROVIDE CLEANOUTS FOR SOIL AND WASTE LINES AS SHOWN ON DRAWINGS, AND OF TYPE APPROVED BY LOCAL CODES.
- 7. ALL WATER SUPPLY PIPING SHALL BE PEX PIPING UNLESS PROHIBITED BY LOCAL CODES IN WHICH CASE COPPER TUBING SHALL BE USED. (AVOID FITTINGS BELOW SLAB WHENEVER POSSIBLE). PEX PIPING PASSING THROUGH CONCRETE SLABS SHALL BE SLEEVED WITH PVC BEND SUPPORT BY MANUFACTURER. PROVIDE UPONOR/WIRSBO SERIES: A5500500 FOR 1/2", PEX A5500750 FOR 3/4" PEX, A5501000 FOR 1" PEX. PROVIDE CORRUGATED PVC TUBING (1) PIPE DIAMETER LARGER THAN THE PEX TUBING FOR SIZES LARGER THAN 1" PEX.
- 8. PROVIDE FOR DRAINING WATER SYSTEM, AND CAP ALL STUBS UNTIL FINISH WORK IS INSTALLED. INSTALL DRAIN VALVE AT WATER METER WITH 3/4" HOSE THREAD AND VACUUM BREAKER.
- 9. PROVIDE STOPS ON WATER SUPPLIES TO EACH FIXTURE & EQUIPMENT.
- GAS PIPING FOR HEATING SYSTEMS WITH GAS-FIRED EQUIPMENT SHALL BE INCLUDED IN THIS CONTRACT. GAS PIPING SHALL BE STANDARD WEIGHT, BLACK STEEL PIPE, SCHEDULE 40. PIPING EXPOSED TO ATMOSPHERE OR RUN BELOW GRADE SHALL HAVE POLYETHYLENE PLASTIC COATING. ALL GAS PIPING, FITTINGS AND INSTALLATION SHALL BE IN ACCORDANCE WITH REQUIREMENTS OF UTILITY COMPANY AND ALL GOVERNING BODIES.
- IMPORTANT HOLD ALL COLD AND HOT WATER PIPING TO WARM SIDE OF INSULATION TO PREVENT FREEZING. INSULATION SHALL MEET FLAME SPREAD AND SMOKE DEVELOPED RATINGS REQUIRED BY LOCAL CODES.
- 12. PLUMBING FIXTURES SHALL BE FURNISHED AND INSTALLED WHERE SHOWN ON THE DRAWINGS. ALL FIXTURE FITTINGS AND EXPOSED FIXTUR PIPING SHALL BE BRASS CHROMIUM PLATED. ALL TRAPS SHALL BE CAST BRASS. ALL FIXTURES SHALL BE EQUAL IN ALL RESPECTS TO FIXTURES SPECIFIED.
 - WATER METER TYPE IS TO BE PROVIDED AS REQUIRED BY LOCAL UTILITY COMPANY.
 - ROUGH-IN AND FINAL CONNECTIONS OF REQUIRED WASTE, VENT, AND WATER SUPPLY PIPING BY THIS CONTRACTOR. ALL SUPPLY PIPING SHALL BE VALVED.
 - . COORDINATE ALL WORK WITH OTHER CONTRACTORS.
- 16. THIS CONTRACTOR SHALL GUARANTEE ALL WORK INSTALLED UNDER THE CONTRACT TO BE FREE FROM DEFECTIVE WORKMANSHIP AND MATERIALS, (USUAL WEAR IS EXPECTED), AND SHOULD ANY SUCH DEFECTS DEVELOP WITHIN A PERIOD OF ONE YEAR AFTER ACCEPTANCE OF THE BUILDING BY THE OWNER, THIS CONTRACTOR SHALL REPAIR AND/OR REPLACE ANY DEFECTIVE ITEMS AND ALL DAMAGE RESULTING FROM FAILURE OF THESE ITEMS, AT NO EXPENSE WHATSOEVER TO THE OWNER.
- BACKFLOW PREVENTER TO BE INSTALLED WHEN REQUIRED BY LOCAL CODE.
- SEE PLUMBING SHEETS FOR KITCHEN EQUIPMENT SCHEDULE, FIXTURE SCHEDULE, DETAILS AND SANITARY ISOMETRIC.
- THE DIRECTION OF THE SANITARY MAIN AND THE LOCATION OF THE GREASE INTERCEPTOR SHALL BE COORDINATED WITH CIVIL DWGS PRIOR TO ROUGH-IN.
- 20. COORDINATE LOCATION AND ROUGH-IN HEIGHT OF KITCHEN EQUIPMENT WITH OWNER AND MILLWORK PRIOR TO ROUGH-IN.
- 21. MAKE ALL CONNECTIONS TO KITCHEN AND MECHANICAL EQUIPMENT UNLESS OTHERWISE NOTED. USE MILL HARDWOOD 30B35 BRAIDED FLEXIBLE HOSES FOR ALL COUNTERTOP EQUIPMENT.
- 2. PROVIDE SHOCK ABSORBERS AT THE END RUN OF ALL WATER PIPING. SIZE AS RECOMMENDED BY PLUMBING AND DRAINAGE INSTITUTE, AND AS RECOMMENDED BY THE MANUFACTURER.
- 23. ALL PIPING (GAS AND WATER) TO BE CONCEALED IN WALL SPACE WHEN POSSIBLE.
- 24. ALL SHUT-OFF VALVES TO BE 1/4 TURN SHUT-OFF VALVES.
- 25. ANY DAMAGES TO ANY EXISTING WALLS, FLOORS, FINISHES ETC. BY THIS CONTRACTOR ARE TO BE REPAIRED AT THIS CONTRACTOR'S EXPENSE.
- 26. ALL GENERAL USE FLOOR DRAINS NOT INSTALLED UNDER KITCHEN EQUIPMENT TO RECEIVE TRAP PRIMERS.
- 27. HOSE BIBBS HAVE BUILT IN VACUUM BREAKER
- 28. HOSE BIBBS AT THE PATIO & REAR OF THE BUILDING WILL HAVE HOT AND COLD WATER AVAILABLE.
- 29. PROVIDE TRAP PRIMER FOR FLOOR DRAINS. SEE DETAIL ON THIS SHEET FOR

MORE INFORMATION.

GALLONS PER

PLUMBING ABBREVIATIONS

LOIVII		i/ \	7110
AB AFF	ABOVE ABOVE FINISHED FLOOR	GPM	GALLONS PER MINUTE
ARCH	ARCHITECT	HB	HOSE BIBB
BEL BLDG	BELOW BUILDING	НС	HEATING CONTRACTOR
CLG	CEILING	HP	HORSEPOWER
		HW	HOT WATER
CO CONT	CLEAN OUT CONTINUATION	HWR	HOT WATER RETURN
CW	COLD WATER	INV	INVERT
CONTR	CONTRACTOR	LAV	LAVATORY
COORD	COORDINATE	MAX	MAXIMUM
DISC DN	DISCONNECT DOWN	MFR	MANUFACTURER
		MT	MOUNT
EA EC	EACH ELECTRICAL	NTS	NOT TO SCALE
EX	CONTRACTOR EXISTING	PC	PLUMBING CONTRACTOR
EA	EXISTING	DI D.C	
EWC	ELECTRIC WATER COOLER	PLBG	PLUMBING
Fac		RD	ROOF DRAIN
ECO	EXTERIOR CLEAN OUT	RTU	ROOFTOP UNIT
FCO	FLOOR CLEAN OUT	SAN	SANITARY
FD	FLOOR DRAIN	SS	SERVICE SINK
FIXT	FIXTURE	TYP	TYPICAL
FLR	FLOOR	TW UR V	TEMPERED WATER URINAL VENT
FURN	FURNISH	VTR	VENT THRU ROOF
FV	FLUSH VALVE	WC	WATER CLOSET
G	GAS	WCO	WALL CLEAN OUT
GAL GC	GALLON GENERAL CONTRACTOR	WH W/	WATER HEATER WITH

REVISION/ UPLOAD DATE

REV. DATE DESCRIPTION

LAST DESIGN BULLETIN

NUM. DATE DESCRIPTION

ALIANT

MECHIELARE

VALIANT MODULAR, LLC

ST TOWER CIRCLE, ORMOND BEACH, I

ENGINEER

WALTER E.

NUMBER

Third Party: HWC & Asc. Inc 1627 SouthMyrtle Ave. Clearwater, Fl. 34616 (717)-584-8151

MISSOURI
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COMMISSION

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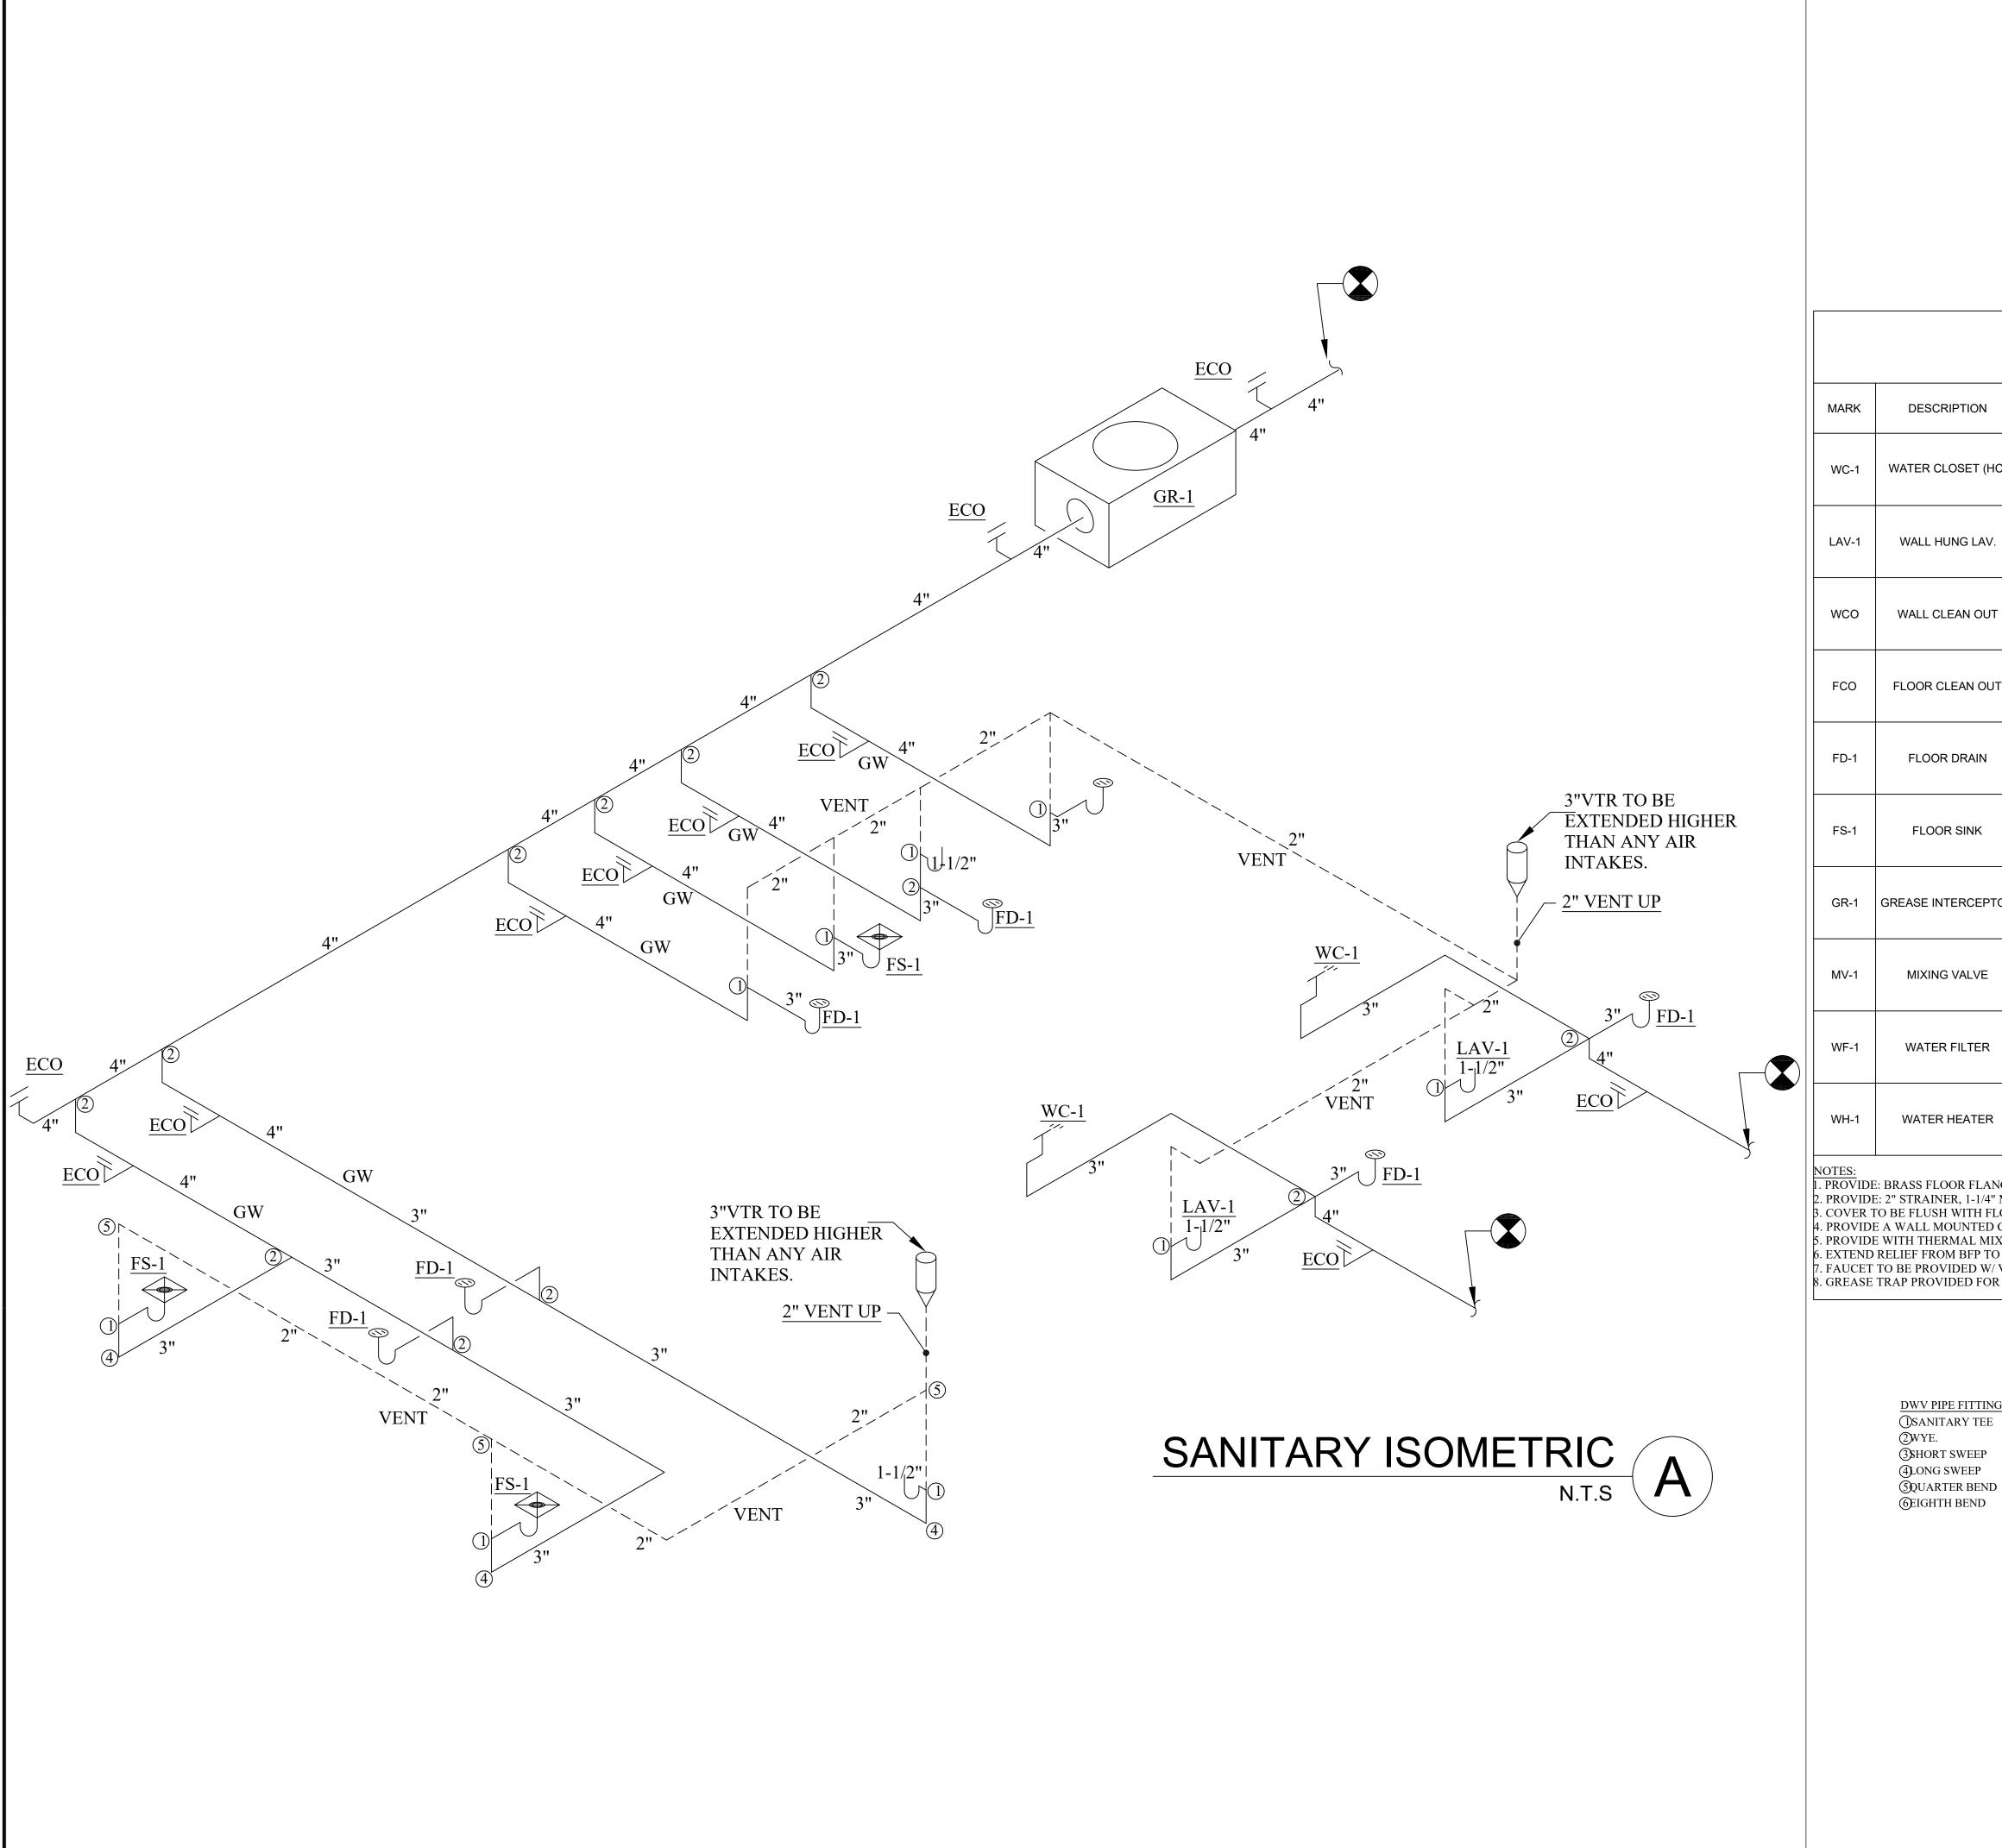
04/05/2024
MANUFACTURED
HOUSING

SHEET NAME

PLUMBING PLAN

SHEET NUMBER

P1.1



PLUMBING FIXTURE SCHEDULE

	DECODIDE: CO.		MFG & MDL #	1 11 4 7	O14:		,	,
MARK	DESCRIPTION	FIXTURE OR EQUAL	ACCESSORY	HW	CW	SAN	VENT	NOTE
WC-1	WATER CLOSET (HC)	K-4199-0 BOWL K-4468-0 TANK	VITREOUS CHINA FREE STANDING PRESSURE ASSIST, ADA ELONGATED WATER CLOSET, FLANGE BOLTS, BOLT CAPS, FLOOR FLANGE & GASKET. (1.6/FLUSH).	-	1/2"	4"	1-1/2"	1
LAV-1	WALL HUNG LAV.	K-1728-0	DELTA AUTO FAUCET LESS POP-UP DRAIN, MODEL # 591LF-LGHGMHDF PROVIDE WITH TRUEBRO LAV-GUARD KIT	1/2"	1/2"	1-1/2"	1-1/2"	2,4
WCO	WALL CLEAN OUT		CAST IRON BODY WITH 6" DIA SS COVER	-	-	3"	-	3
FCO	FLOOR CLEAN OUT	SIOUX CHIEF 822-CF3PNR	PVC BODY WITH SCORIATED BRONZE COVER	-	-	3"	-	3
FD-1	FLOOR DRAIN	SIOUX CHIEF 822-F3PNR	PVC BODY WITH ROUND CAST IRON STRAINER	-	-	3"	-	3
FS-1	FLOOR SINK	SIOUX CHIEF 861-3P		-	-	3"	-	3
GR-1	GREASE INTERCEPTOR	750 GALLON	750 GALLON 48" X 96" GREASE INTERCEPTOR					
MV-1	MIXING VALVE	POWERS LFMM432 (ASSE 1017)	POWERS HYDROGUARD TEMPERING VALVE 3/4" IN 1" OUT	1/2"	1/2"			
WF-1	WATER FILTER	CUNO 260 NSF CERTIFIED	WATER FILTER MOUNTED ABOVE SINK	3/4"	3/4"			
WH-1	WATER HEATER	RINNAI CXP199IN	CONDENSING COMMERCIAL TANKLESS	3/4"	3/4"			

1. PROVIDE: BRASS FLOOR FLANGE, BOLT CAPS, WAX RING, & CHROME SUPPLY STOP.

2. PROVIDE: 2" STRAINER, 1-1/4" MCGUIRE CHROME P-TRAP & CHROME SUPPLY STOPS. 3. COVER TO BE FLUSH WITH FLOOR/GRADE

4. PROVIDE A WALL MOUNTED CONCEALED ARM CARRIER. 5. PROVIDE WITH THERMAL MIXING VALVE BELOW FIXTURE. SET AT 105 DEGREES F.

6. EXTEND RELIEF FROM BFP TO MOP SINK W/ PROPER AIR GAP.

7. FAUCET TO BE PROVIDED W/ VACUUM BREAKER.

8. GREASE TRAP PROVIDED FOR REFERENCE AS A TYPICAL STANDARD, VERIFY WITH CIVIL FOR SIZE.

DWV PIPE FITTING LEGEND: ()SANITARY TEE 3SHORT SWEEP **4**LONG SWEEP

ALLOWABLE DISTANCE	FROM FIXTURE TRAP TO VENT
SIZE OF FIXTURE DRAIN - INCHES	MAXIMUM ALLOWABLE DISTANCE FROM TRAP TO VENT
1 1/4	2 FT 6 IN
1 1/2	3 FT 6 IN
2	4 FT
3	5 FT
4 AND LARGER	6 FT

MISSOURI PUBLIC SERVICE COMMISSION **APPROVED** MANUFACTURED

THIS IS A STATE APPROVED & INSPECTED MODULAR BUILDING

LAST DESIGN BULLETIN
NUM. DATE DESCRIPTION


ENGINEER

Third Party: HWC & Asc. Inc. 1627 SouthMyrtle Ave. Clearwater, Fl. 34616 (717)-584-8151



SHEET NAME

PLUMBING SCHEDULE

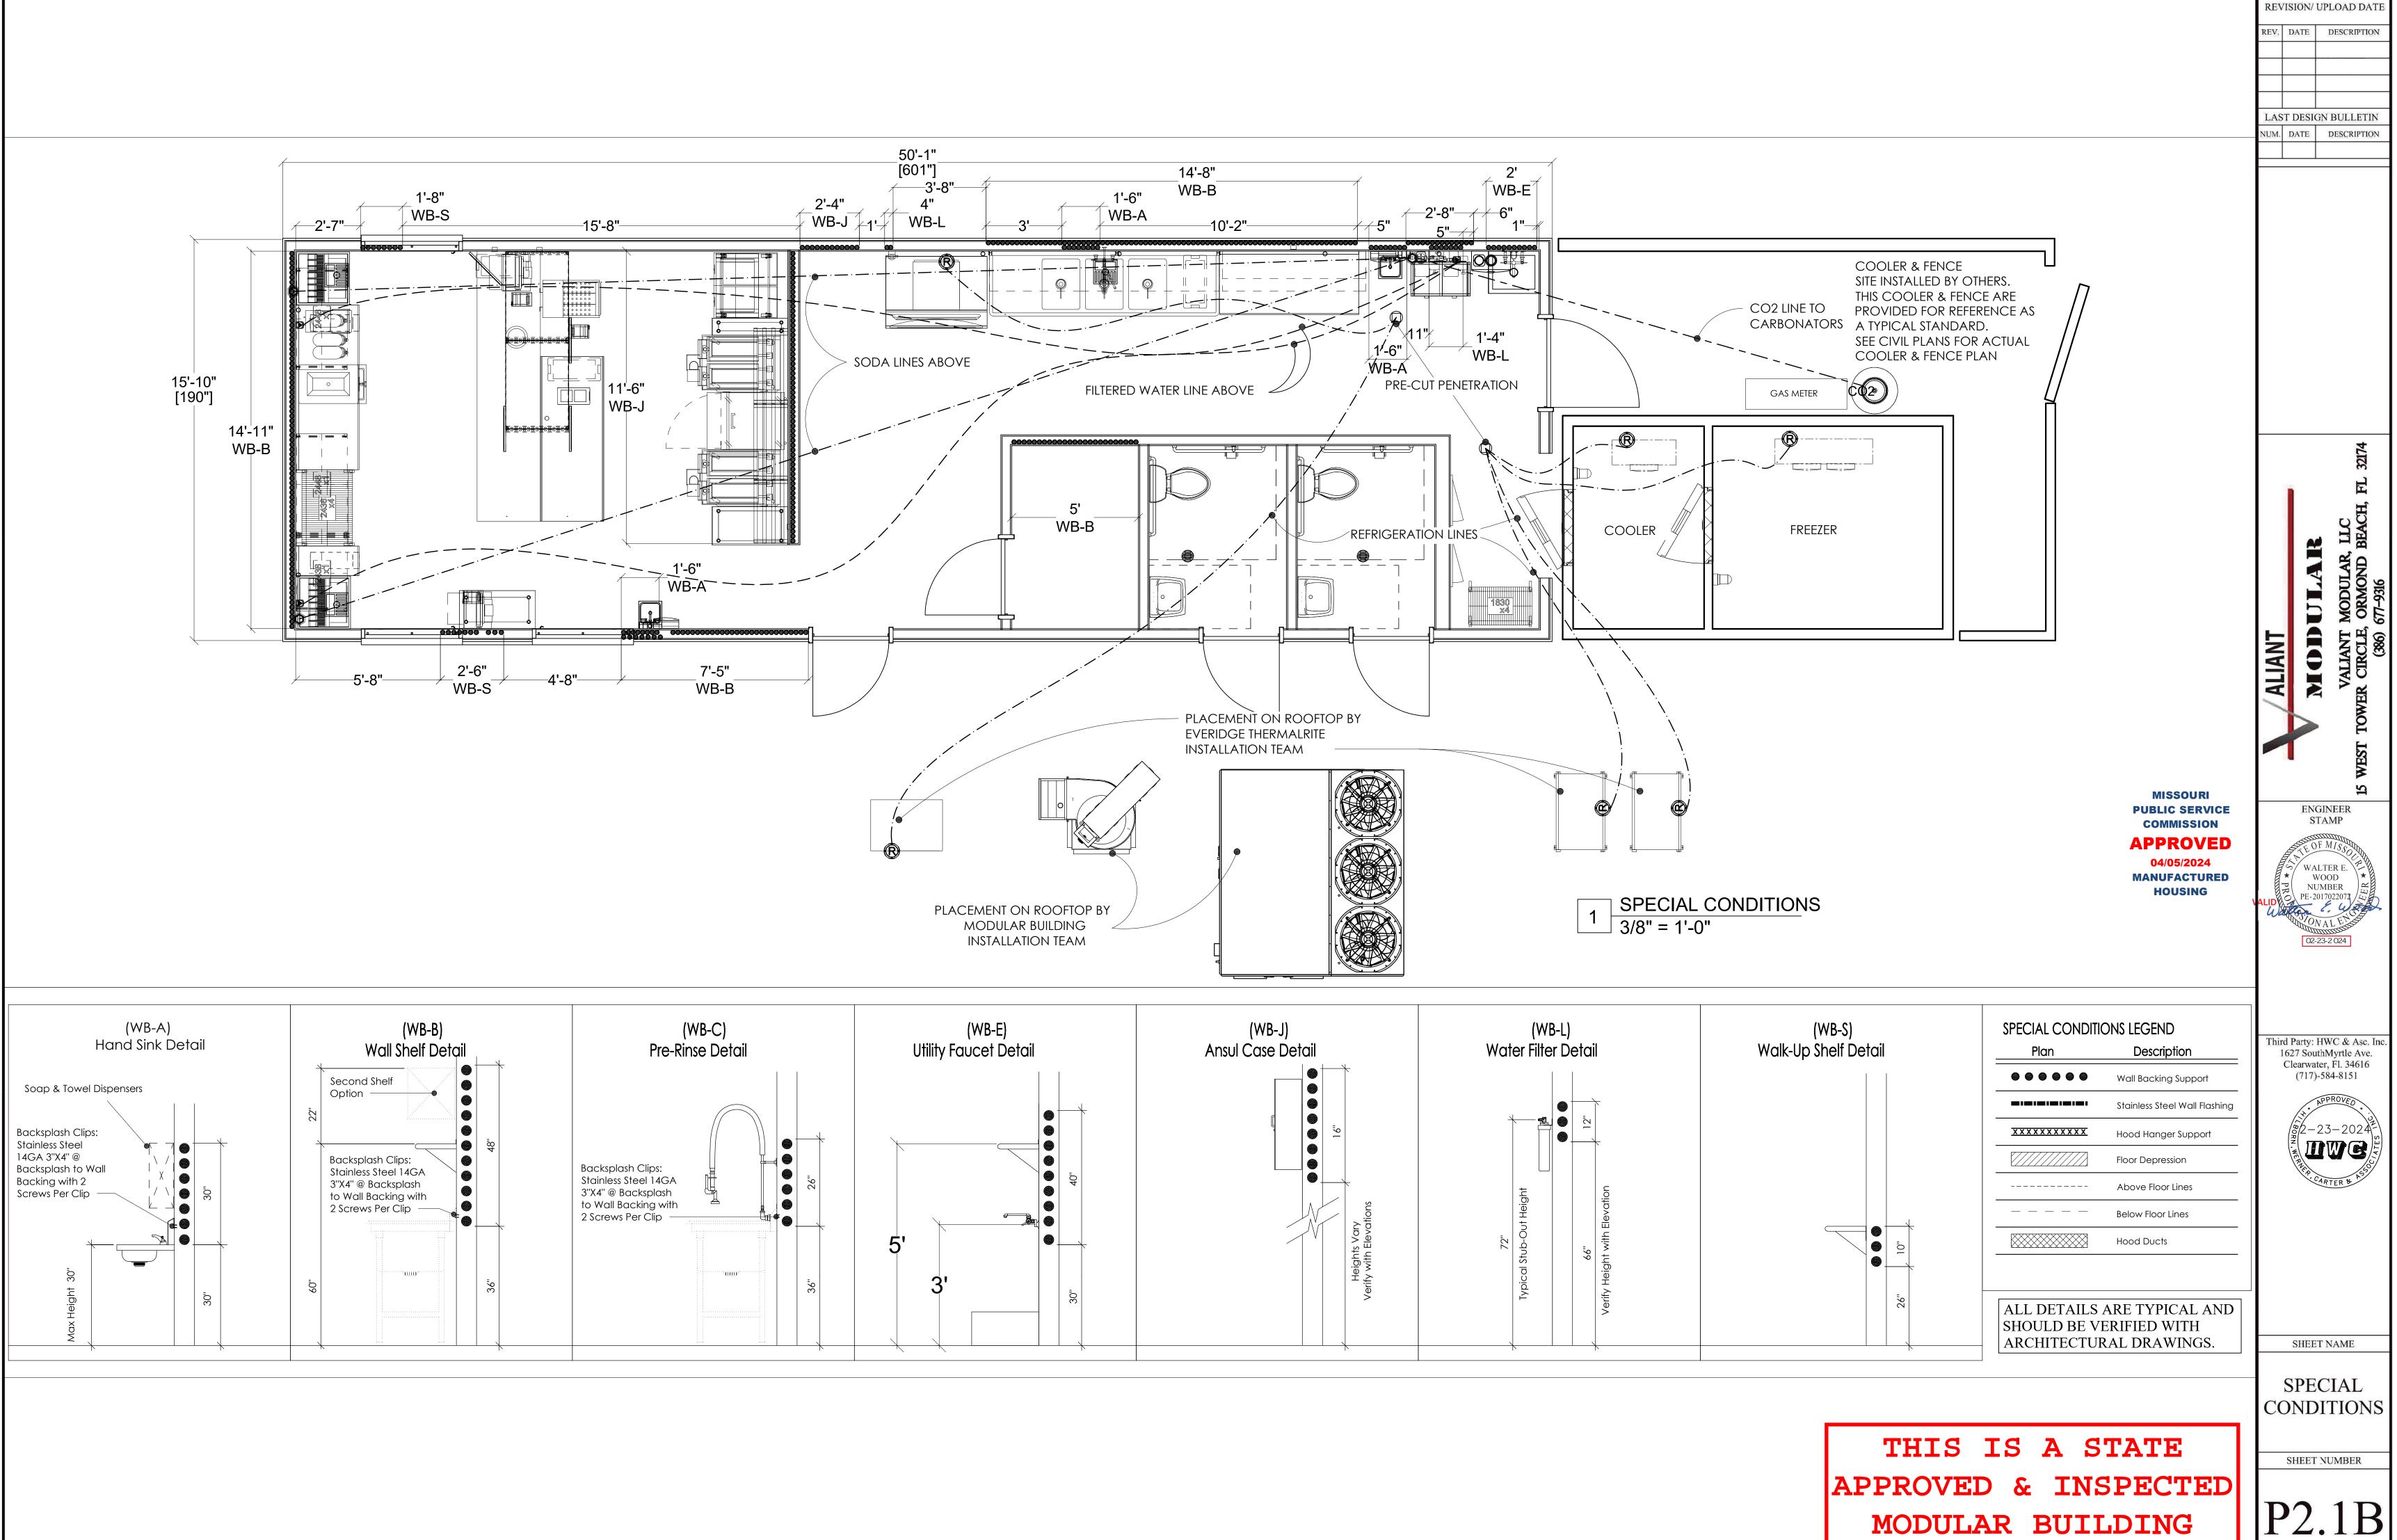


P2.1B

GAS CONNECTION DETAIL


THE INSTALLATION SHOWN ON THIS DRAWING IS FOR THE EZPRESS PURPOSE OF PROVIDING INSTALLATION GUIDLINES ONLY. THE FINAL INSTALLATION APPROVAL IS THE RESPONSIBILITY OF THE SYSTEM DESIGNER/INSTALLER

TYPICAL INSTALLATION FOR A CASTER MOUNTED RANGE (CAN BE USED TO SPECIFY CONNECTOR FOR A RANGE WITH ANY NUMBER OF BURNERS).

INSTALLER MUST VERIFY THE SIZE OF THE GAS CONNECTION TO MATCH EQUIPMENT SUPPLY INLET AND EQUIPMENT MANUFACTURER'S RECOMMENDED BTU'S FOR PEAK

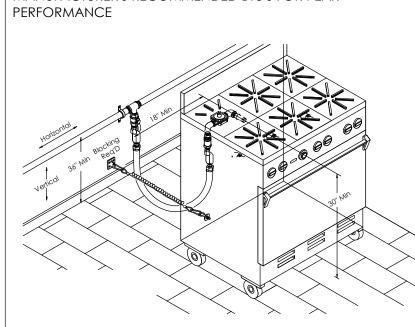

PLUMBING LEGEND		
Plan	Elevation	Description
•	0	Hotwater Connection Point
•	<i>©</i>	Coldwater Connection Point
6	b	In Wall Direct Drain
	80	Hot&Cold Water w/Direct Drain
		Filtered Water Stub
	W	Water Stub-Up
	0	Plumbing Connection Point
9	•	Gas Supply Line
G G	G	Gas Stub-Up
 ■ B	B	Beverage Stub-Up
	Y	Fixture Drain
		Water Lines
		Gas Lines
		Waste Lines
		Floor Drain Round & Square
		Funnel Floor Drain
		Floor Sink; 1/2 Grate, 3/4 Grate, Open Grate & Round

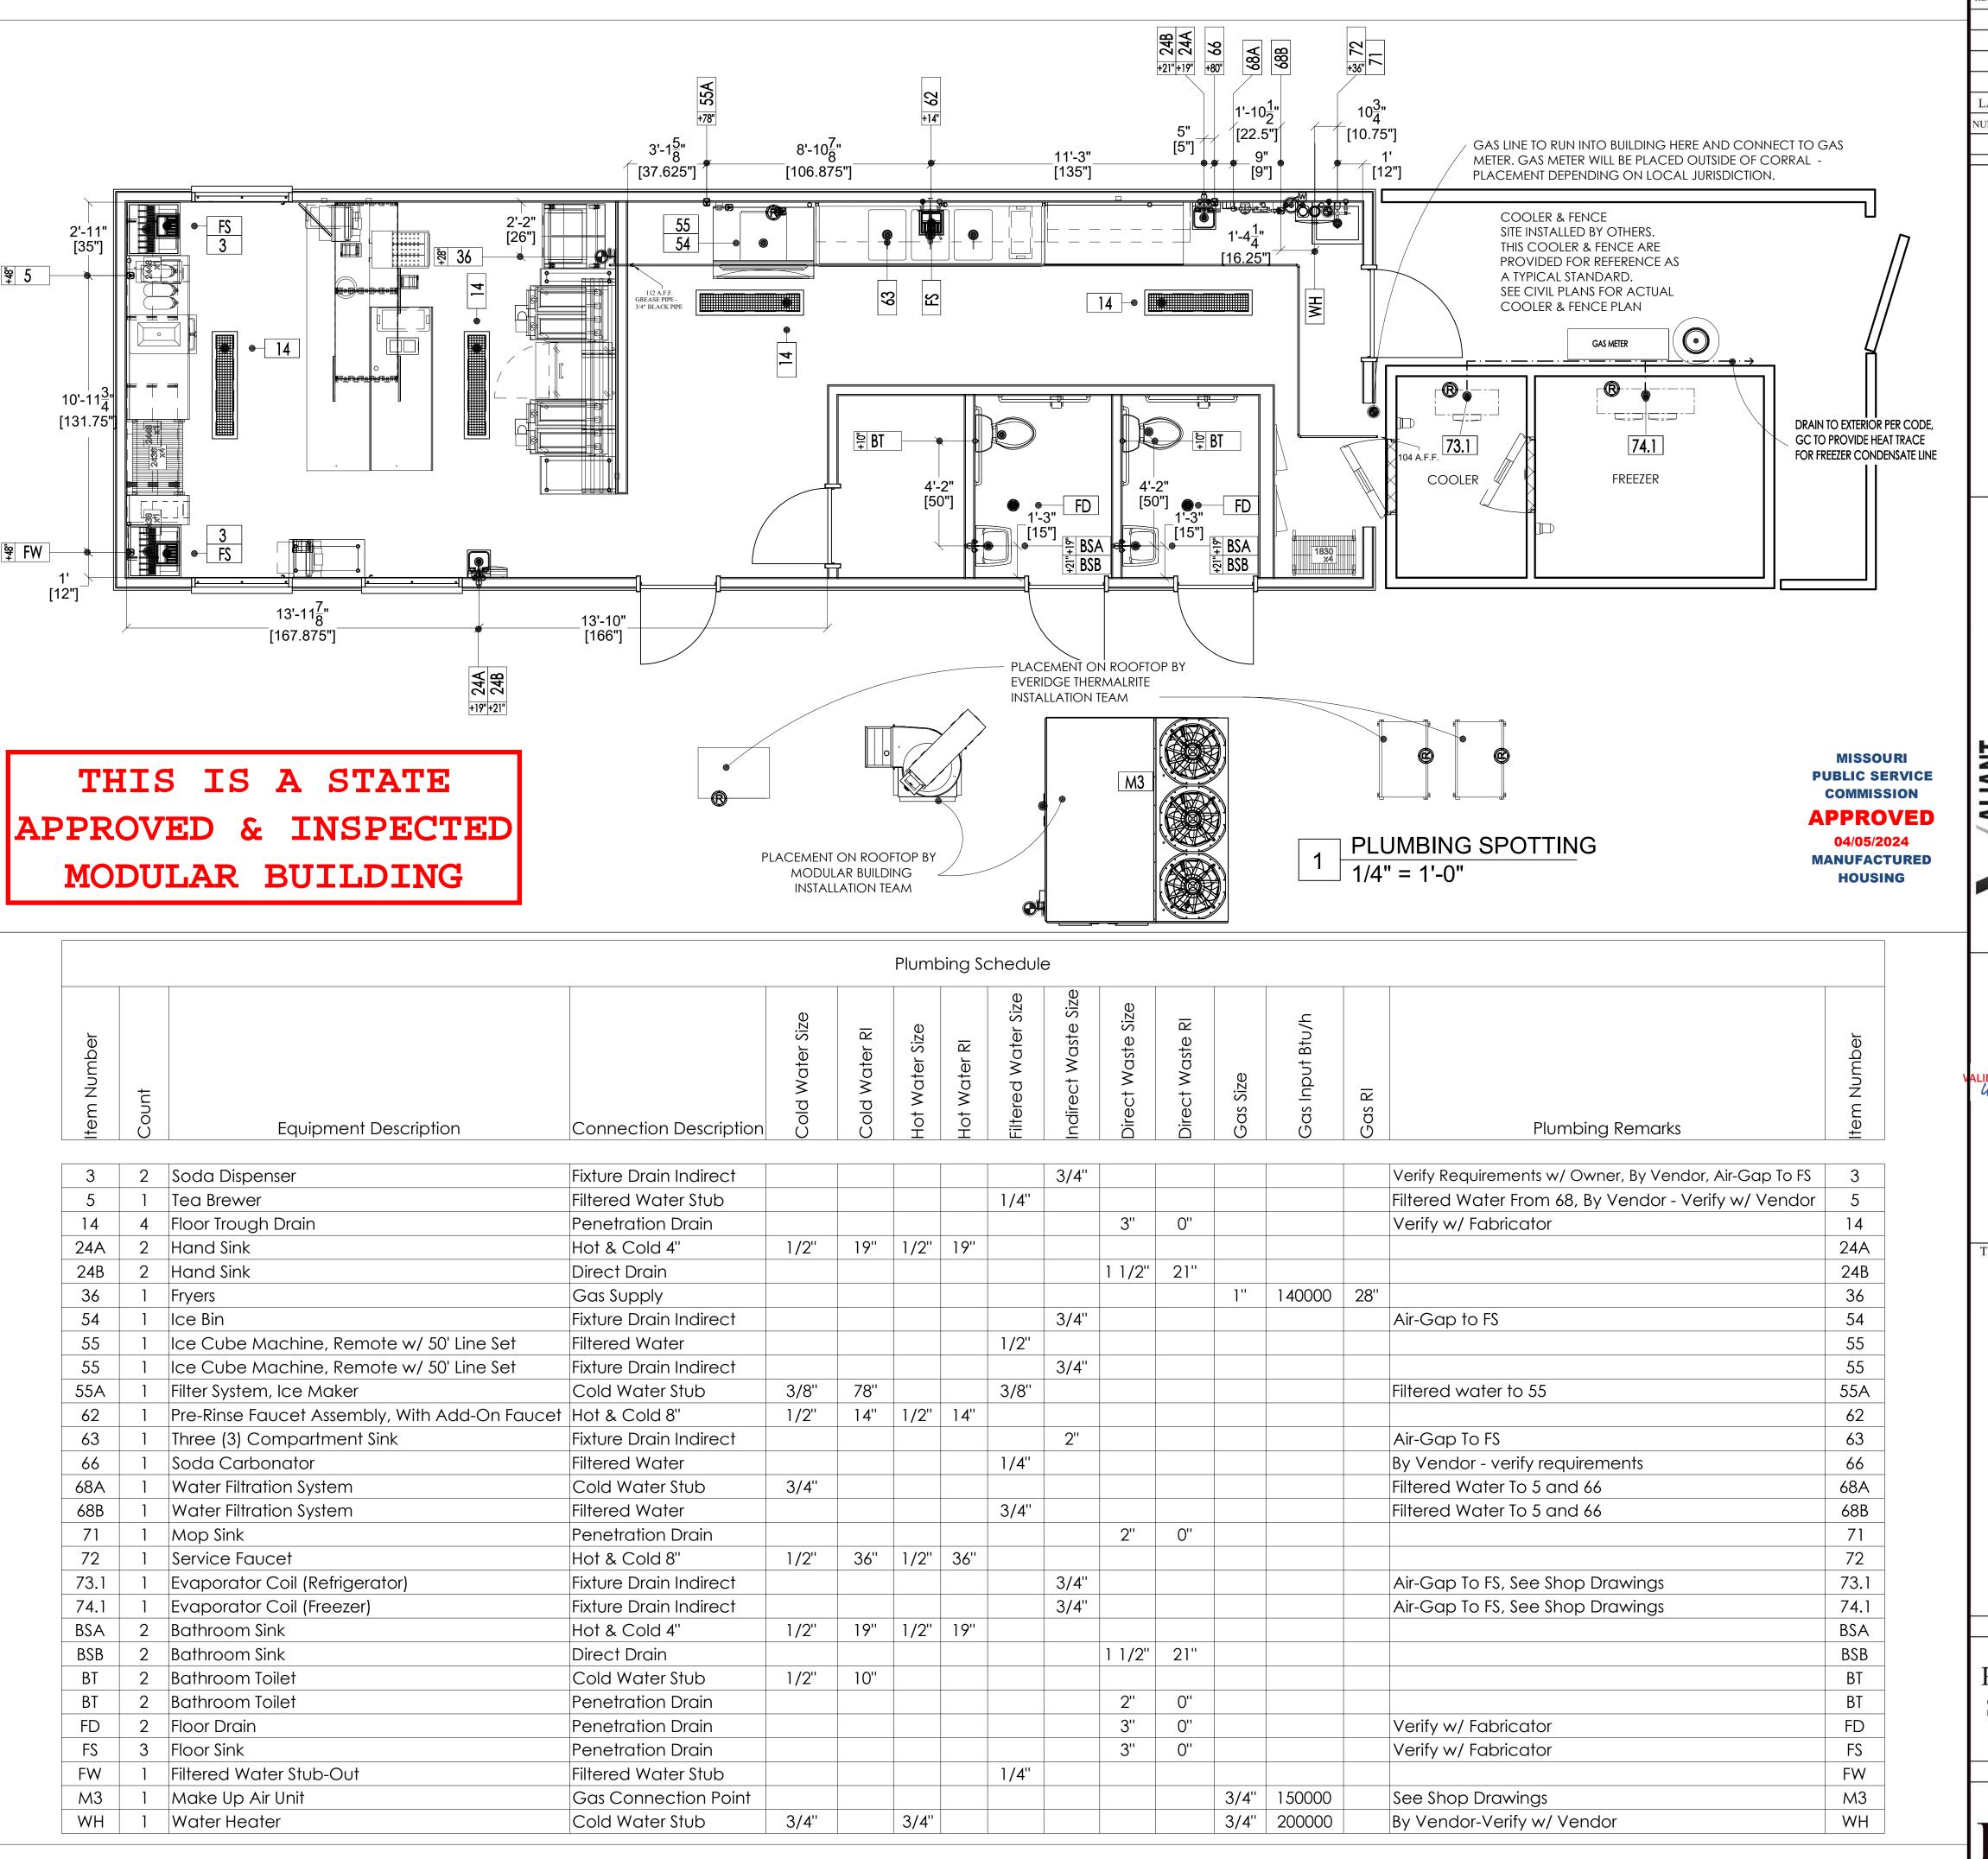

REVISION/ UPLOAD DATE

REV. DATE DESCRIPTION

LAST DESIGN BULLETIN
NUM. DATE DESCRIPTION

ALIANT

WECH TO THE ARE

VALIANT MODULAR, LICE

Third Party: HWC & Asc. Inc 1627 SouthMyrtle Ave. Clearwater, Fl. 34616 (717)-584-8151

ENGINEER

S WALTER E.




SHEET NAME

PLUMBING SPOTTING

SHEET NUMBER

P2.10

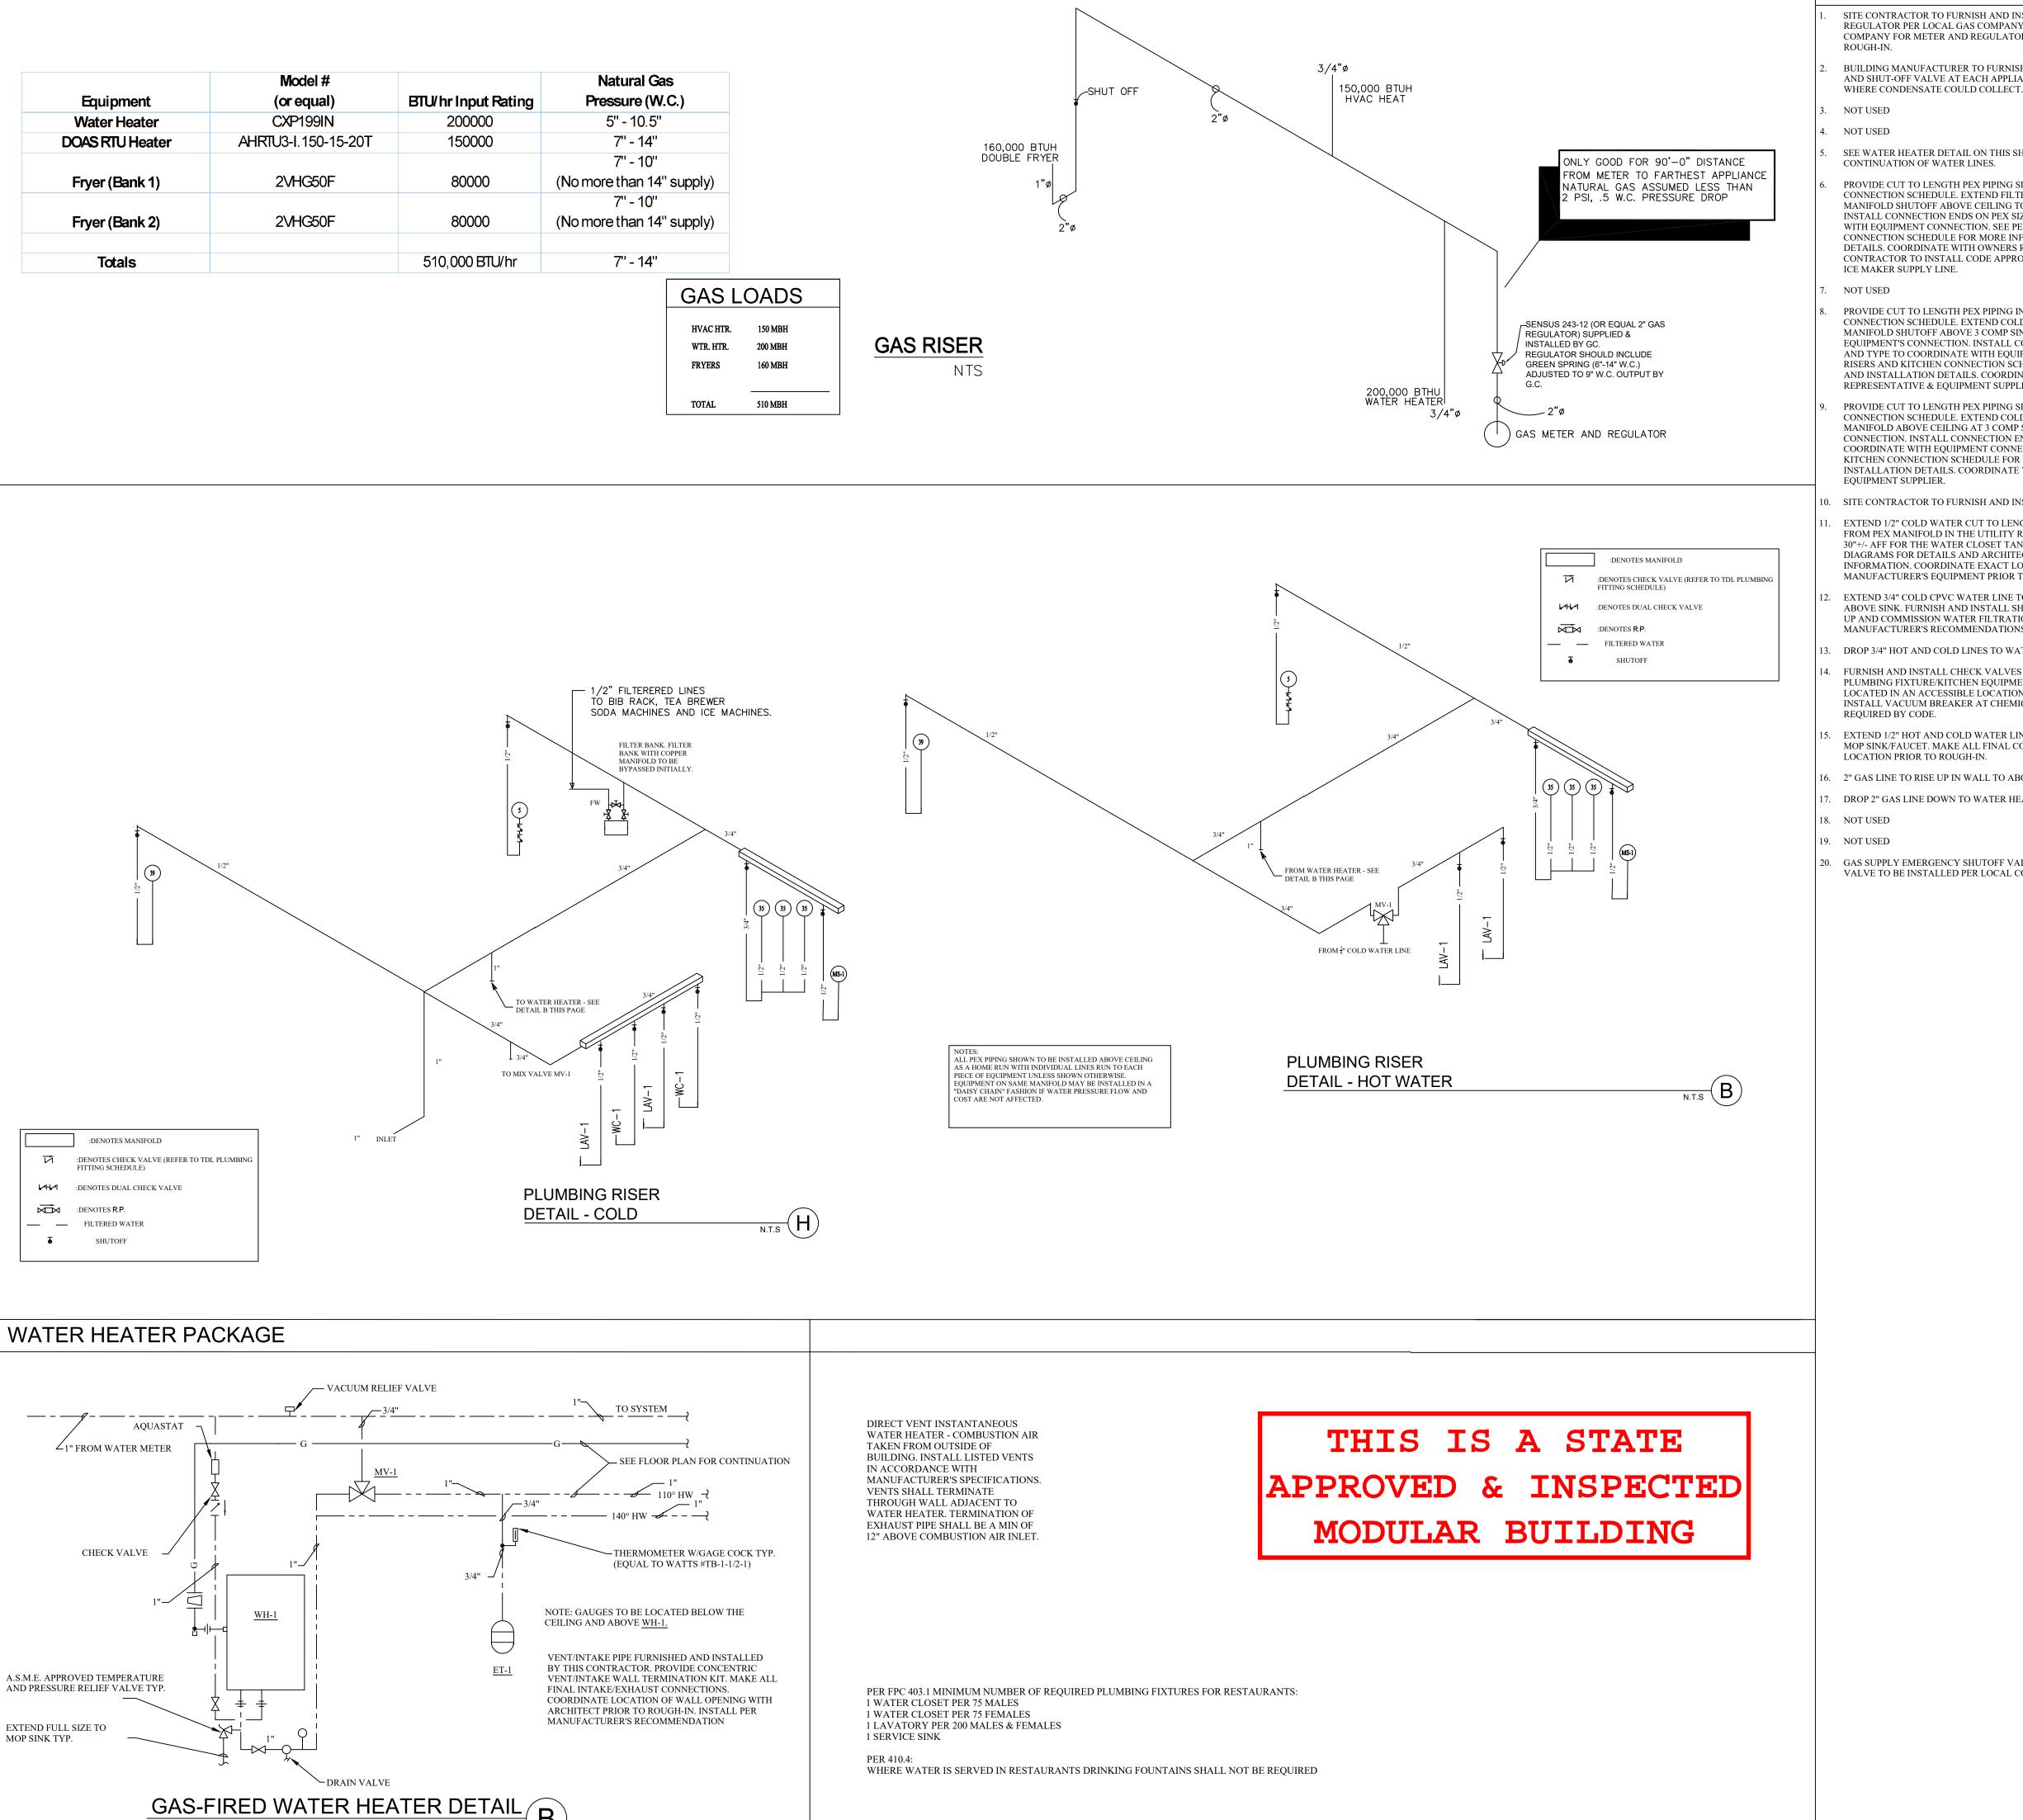

NOTES

SITE CONTRACTOR TO FURNISH AND INSTALL GAS METER AND REGULATOR PER LOCAL GAS COMPANY. COORDINATE WITH LOCAL GAS COMPANY FOR METER AND REGULATOR STANDARDS PRIOR TO

BUILDING MANUFACTURER TO FURNISH AND INSTALL A SEDIMENT TRAP AND SHUT-OFF VALVE AT EACH APPLIANCE. DRIPS SHALL BE PROVIDED

SEE WATER HEATER DETAIL ON THIS SHEET FOR SIZES AND CONTINUATION OF WATER LINES.

PROVIDE CUT TO LENGTH PEX PIPING SIZED PER EQUIPMENT CONNECTION SCHEDULE. EXTEND FILTERED COLD WATER PEX FROM MANIFOLD SHUTOFF ABOVE CEILING TO EQUIPMENT'S CONNECTION. INSTALL CONNECTION ENDS ON PEX SIZE AND TYPE TO COORDINATE WITH EQUIPMENT CONNECTION. SEE PEX RISERS AND KITCHEN CONNECTION SCHEDULE FOR MORE INFORMATION FOR INSTALLATION DETAILS. COORDINATE WITH OWNERS REPRESENTATIVE & MILLWORK CONTRACTOR TO INSTALL CODE APPROVED DOUBLE CHECK VALVE ON ICE MAKER SUPPLY LINE.

PROVIDE CUT TO LENGTH PEX PIPING INSIDE WALL SIZED PER EQUIPMENT CONNECTION SCHEDULE. EXTEND COLD AND 140° HOT WATER PEX FROM MANIFOLD SHUTOFF ABOVE 3 COMP SINK DOWN IN WALL TO EQUIPMENT'S CONNECTION. INSTALL CONNECTION ENDS ON PEX SIZE AND TYPE TO COORDINATE WITH EOUIPMENT CONNECTION. SEE PEX RISERS AND KITCHEN CONNECTION SCHEDULE FOR MORE INFORMATION AND INSTALLATION DETAILS. COORDINATE WITH OWNERS REPRESENTATIVE & EQUIPMENT SUPPLIER.

PROVIDE CUT TO LENGTH PEX PIPING SIZED PER EQUIPMENT CONNECTION SCHEDULE. EXTEND COLD AND HOT WATER PEX FROM MANIFOLD ABOVE CEILING AT 3 COMP SINK TO EOUIPMENT'S CONNECTION. INSTALL CONNECTION ENDS ON PEX SIZE AND TYPE TO COORDINATE WITH EQUIPMENT CONNECTION, SEE PEX RISERS AND KITCHEN CONNECTION SCHEDULE FOR MORE INFORMATION AND INSTALLATION DETAILS. COORDINATE WITH OWNERS REPRESENTATIVE &

SITE CONTRACTOR TO FURNISH AND INSTALL WATER METER.

EXTEND 1/2" COLD WATER CUT TO LENGTH PEX LINE ABOVE CEILING FROM PEX MANIFOLD IN THE UTILITY ROOM DOWN TO APPROXIMATELY 30"+/- AFF FOR THE WATER CLOSET TANK CONNECTION. SEE RISER DIAGRAMS FOR DETAILS AND ARCHITECTURAL SHEETS FOR MORE INFORMATION. COORDINATE EXACT LOCATION WITH THE MANUFACTURER'S EQUIPMENT PRIOR TO ROUGH-IN.

EXTEND 3/4" COLD CPVC WATER LINE TO WATER FILTRATION SYSTEM ABOVE SINK. FURNISH AND INSTALL SHUT-OFF VALVES. INSTALL, HOOK UP AND COMMISSION WATER FILTRATION SYSTEM ITEM PER MANUFACTURER'S RECOMMENDATIONS.

DROP 3/4" HOT AND COLD LINES TO WATER HEATER.

FURNISH AND INSTALL CHECK VALVES IN THE COLD WATER SUPPLY TO PLUMBING FIXTURE/KITCHEN EQUIPMENT INDICATED. VALVES ARE TO BE LOCATED IN AN ACCESSIBLE LOCATION. GENERAL CONTRACTOR TO INSTALL VACUUM BREAKER AT CHEMICAL DISPENSING UNIT WHERE

EXTEND 1/2" HOT AND COLD WATER LINES DOWN TO 30" AFF FOR THE MOP SINK/FAUCET. MAKE ALL FINAL CONNECTIONS. COORDINATE EXACT

6. 2" GAS LINE TO RISE UP IN WALL TO ABOVE CEILING.

DROP 2" GAS LINE DOWN TO WATER HEATER.

GAS SUPPLY EMERGENCY SHUTOFF VALVE BY GENERAL CONTRACTOR. VALVE TO BE INSTALLED PER LOCAL CODE REQUIREMENTS.

GENERAL NOTES

CONNECTIONS WHERE REQUIRED.

OF TYPE APPROVED BY LOCAL CODES.

PROVIDE ALL LABOR, EQUIPMENT, AND MATERIALS NECESSARY TO EXECUTE THE PLUMBING WORK INDICATED ON THE DRAWINGS, AND AS REQUIRED BY LOCAL

CODES AND ORDINANCES. PAY ALL FEES AND ARRANGE FOR EXECUTION OF ALL TAPS, METERS WITH REQUIRED ENCLOSURES (IF ANY), ETC. INHERENT TO THE INSTALLATION OF NEW

> PLUMBING SERVICE. PLUMBING WORK FOR THIS CONTRACT SHALL INCLUDE ALL PIPING FOR DOMESTIC HOT AND COLD WATER LINES, VENT AND SANITARY LINES, HOOK-UP OF ALL FIXTURES SCHEDULED ON THE DRAWINGS, AND INSULATION OF DESIGNATED PIPING RUNS. WORK SHALL ALSO INCLUDE ALL GAS PIPING AND EQUIPMENT

REVISION/ UPLOAD DATE

REV. DATE DESCRIPTION

LAST DESIGN BULLETIN

NUM. DATE DESCRIPTION

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MODE

ENGINEER

WALTER E. WOOD

NUMBER

Third Party: HWC & Asc. Inc

1627 SouthMyrtle Ave. Clearwater, Fl. 34616

(717)-584-8151

ALIANT

SIZE UPDATED

ALL ITEMS SUCH AS FITTINGS, ETC. NOT MENTIONED BUT UNDERSTOOD TO BE NECESSARY TO COMPLETE THE PLUMBING SYSTEM SHALL BE INCLUDED.

SOIL, WASTE, AND VENT PIPING TO BE OF MATERIAL APPROVED BY LOCAL CODES. PVC, DWV PIPING AND FITTINGS TO BE SCHEDULE 40 AS A MINIMUM.

PROVIDE CLEANOUTS FOR SOIL AND WASTE LINES AS SHOWN ON DRAWINGS, AND

WALL WATER SUPPLY PIPING BELOW GROUND SHALL BE PEX PIPING UNLESS PROHIBITED BY LOCAL CODES IN WHICH CASE COPPER TUBING SHALL BE USED. (AVOID FITTINGS BELOW SLAB WHENEVER POSSIBLE). ALL WATER SUPPLY PIPING ABOVE GROUND SHALL BE CPVC TUBING U.N.O. PEX PIPING PASSING THROUGH CONCRETE SLABS SHALL BE SLEEVED WITH PVC BEND SUPPORT BY MANUFACTURER. PROVIDE UPONOR/WIRSBO SERIES: A5500500 FOR 1/2", PEX A5500750 FOR 3/4" PEX, A5501000 FOR 1" PEX. PROVIDE CORRUGATED PVC TUBING (1) PIPE DIAMETER LARGER THAN THE PEX TUBING FOR SIZES LARGER THAN 1"

PROVIDE FOR DRAINING WATER SYSTEM, AND CAP ALL STUBS UNTIL FINISH WORK IS INSTALLED. INSTALL DRAIN VALVE AT WATER METER WITH 3/4" HOSE THREAD AND VACUUM BREAKER.

PROVIDE STOPS ON WATER SUPPLIES TO EACH FIXTURE & EQUIPMENT.

GAS PIPING FOR HEATING SYSTEMS WITH GAS-FIRED EQUIPMENT SHALL BE INCLUDED IN THIS CONTRACT. GAS PIPING SHALL BE STANDARD WEIGHT, BLACK STEEL PIPE, SCHEDULE 40. PIPING EXPOSED TO ATMOSPHERE OR RUN BELOW GRADE SHALL HAVE POLYETHYLENE PLASTIC COATING. ALL GAS PIPING, FITTINGS AND INSTALLATION SHALL BE IN ACCORDANCE WITH REQUIREMENTS OF UTILITY COMPANY AND ALL GOVERNING BODIES

INSULATE ALL COLD AND HOT WATER PIPING WITH ARMSTRONG COMPANY ARMAFLEX "11" PIPE INSULATION. SEAL JOINTS WITH ARMSTRONG 520 ADHESIVE. IMPORTANT - HOLD ALL COLD AND HOT WATER PIPING TO WARM SIDE OF INSULATION TO PREVENT FREEZING. INSULATION SHALL MEET FLAME SPREAD AND SMOKE DEVELOPED RATINGS REQUIRED BY LOCAL CODES.

PLUMBING FIXTURES SHALL BE FURNISHED AND INSTALLED WHERE SHOWN ON THE DRAWINGS. ALL FIXTURE FITTINGS AND EXPOSED FIXTURE PIPING SHALL BE BRASS CHROMIUM PLATED. ALL TRAPS SHALL BE CAST BRASS. ALL FIXTURES SHALL BE EQUAL IN ALL RESPECTS TO FIXTURES SPECIFIED.

WATER METER TYPE IS TO BE PROVIDED AS REQUIRED BY LOCAL UTILITY

ROUGH-IN AND FINAL CONNECTIONS OF REQUIRED WASTE, VENT, AND WATER SUPPLY PIPING BY THIS CONTRACTOR. ALL SUPPLY PIPING SHALL BE VALVED.

HOSE BIBBS SHALL BE FREEZELESS AUTOMATIC DRAINING TYPE AS MANUFACTURED BY WOODFORD.

COORDINATE ALL WORK WITH OTHER CONTRACTORS.

AT NO EXPENSE WHATSOEVER TO THE OWNER.

THIE BUILDING MANUFACTURER SHALL GUARANTEE ALL WORK INSTALLED UNDER THE CONTRACT TO BE FREE FROM DEFECTIVE WORKMANSHIP AND MATERIALS, (USUAL WEAR IS EXPECTED), AND SHOULD ANY SUCH DEFECTS DEVELOP WITHIN A PERIOD OF ONE YEAR AFTER ACCEPTANCE OF THE BUILDING BY THE OWNER, THIS CONTRACTOR SHALL REPAIR AND/OR REPLACE ANY DEFECTIVE ITEMS AND ALL DAMAGE RESULTING FROM FAILURE OF THESE ITEMS

18. BACKFLOW PREVENTER TO BE INSTALLED WHEN REQUIRED BY LOCAL CODE.

SEE PLUMBING SHEETS FOR KITCHEN EQUIPMENT SCHEDULE, FIXTURE SCHEDULE, DETAILS AND SANITARY ISOMETRIC.

THE DIRECTION OF THE SANITARY MAIN AND THE LOCATION OF THE GREASE INTERCEPTOR SHALL BE COORDINATED WITH CIVIL DWGS PRIOR TO ROUGH-IN.

PROVIDE A TRAP PRIMER ON ALL FLOOR DRAINS. LAYOUT TRAP PRIMER DISTRIBUTION TO CONNECT MULTIPLE FLOOR DRAINS TO ONE TRAP PRIMER.

ALL COLD, HOT, AND FILTERED WATER LINES SHALL BE INSTALLED UNDER SLAI UNLESS NOTED OTHERWISE. COORDINATE WITH OTHER TRADES PRIOR TO

ROUGH-IN OF PIPING TO PREVENT CONFLICT. 23. COORDINATE LOCATION AND ROUGH-IN HEIGHT OF KITCHEN EQUIPMENT WITH

OWNER AND MILLWORK PRIOR TO ROUGH-IN.

24. MAKE ALL CONNECTIONS TO KITCHEN AND MECHANICAL EQUIPMENT UNLESS OTHERWISE NOTED. USE MILL HARDWOOD 30B35 BRAIDED FLEXIBLE HOSES FOR ALL COUNTERTOP EQUIPMENT.

NOT USED

26. ALL PIPING (GAS AND WATER) TO BE CONCEALED IN WALL SPACE WHEN POSSIBLE

27. ALL SHUT-OFF VALVES TO BE 1/4 TURN SHUT-OFF VALVES.

28. THIS BUILDING MANUFACTURER TO INSTALL PEX MANIFOLDS UNDER COUNTER SPACE AND SHALL BE MOUNTED AT 12" A.F.F. UNLESS NOTED OTHERWISE. COORDINATE LOCATION WITH OWNER.


29. ANY DAMAGES TO ANY EXISTING WALLS, FLOORS, FINISHES ETC. BY THIS CONTRACTOR ARE TO BE REPAIRED AT THIS CONTRACTOR'S EXPENSE.

> **MISSOURI PUBLIC SERVICE** COMMISSION **APPROVED**

04/05/2024 **MANUFACTURED** HOUSING

SHEET NAME


PLUMBING WATER & **GAS**

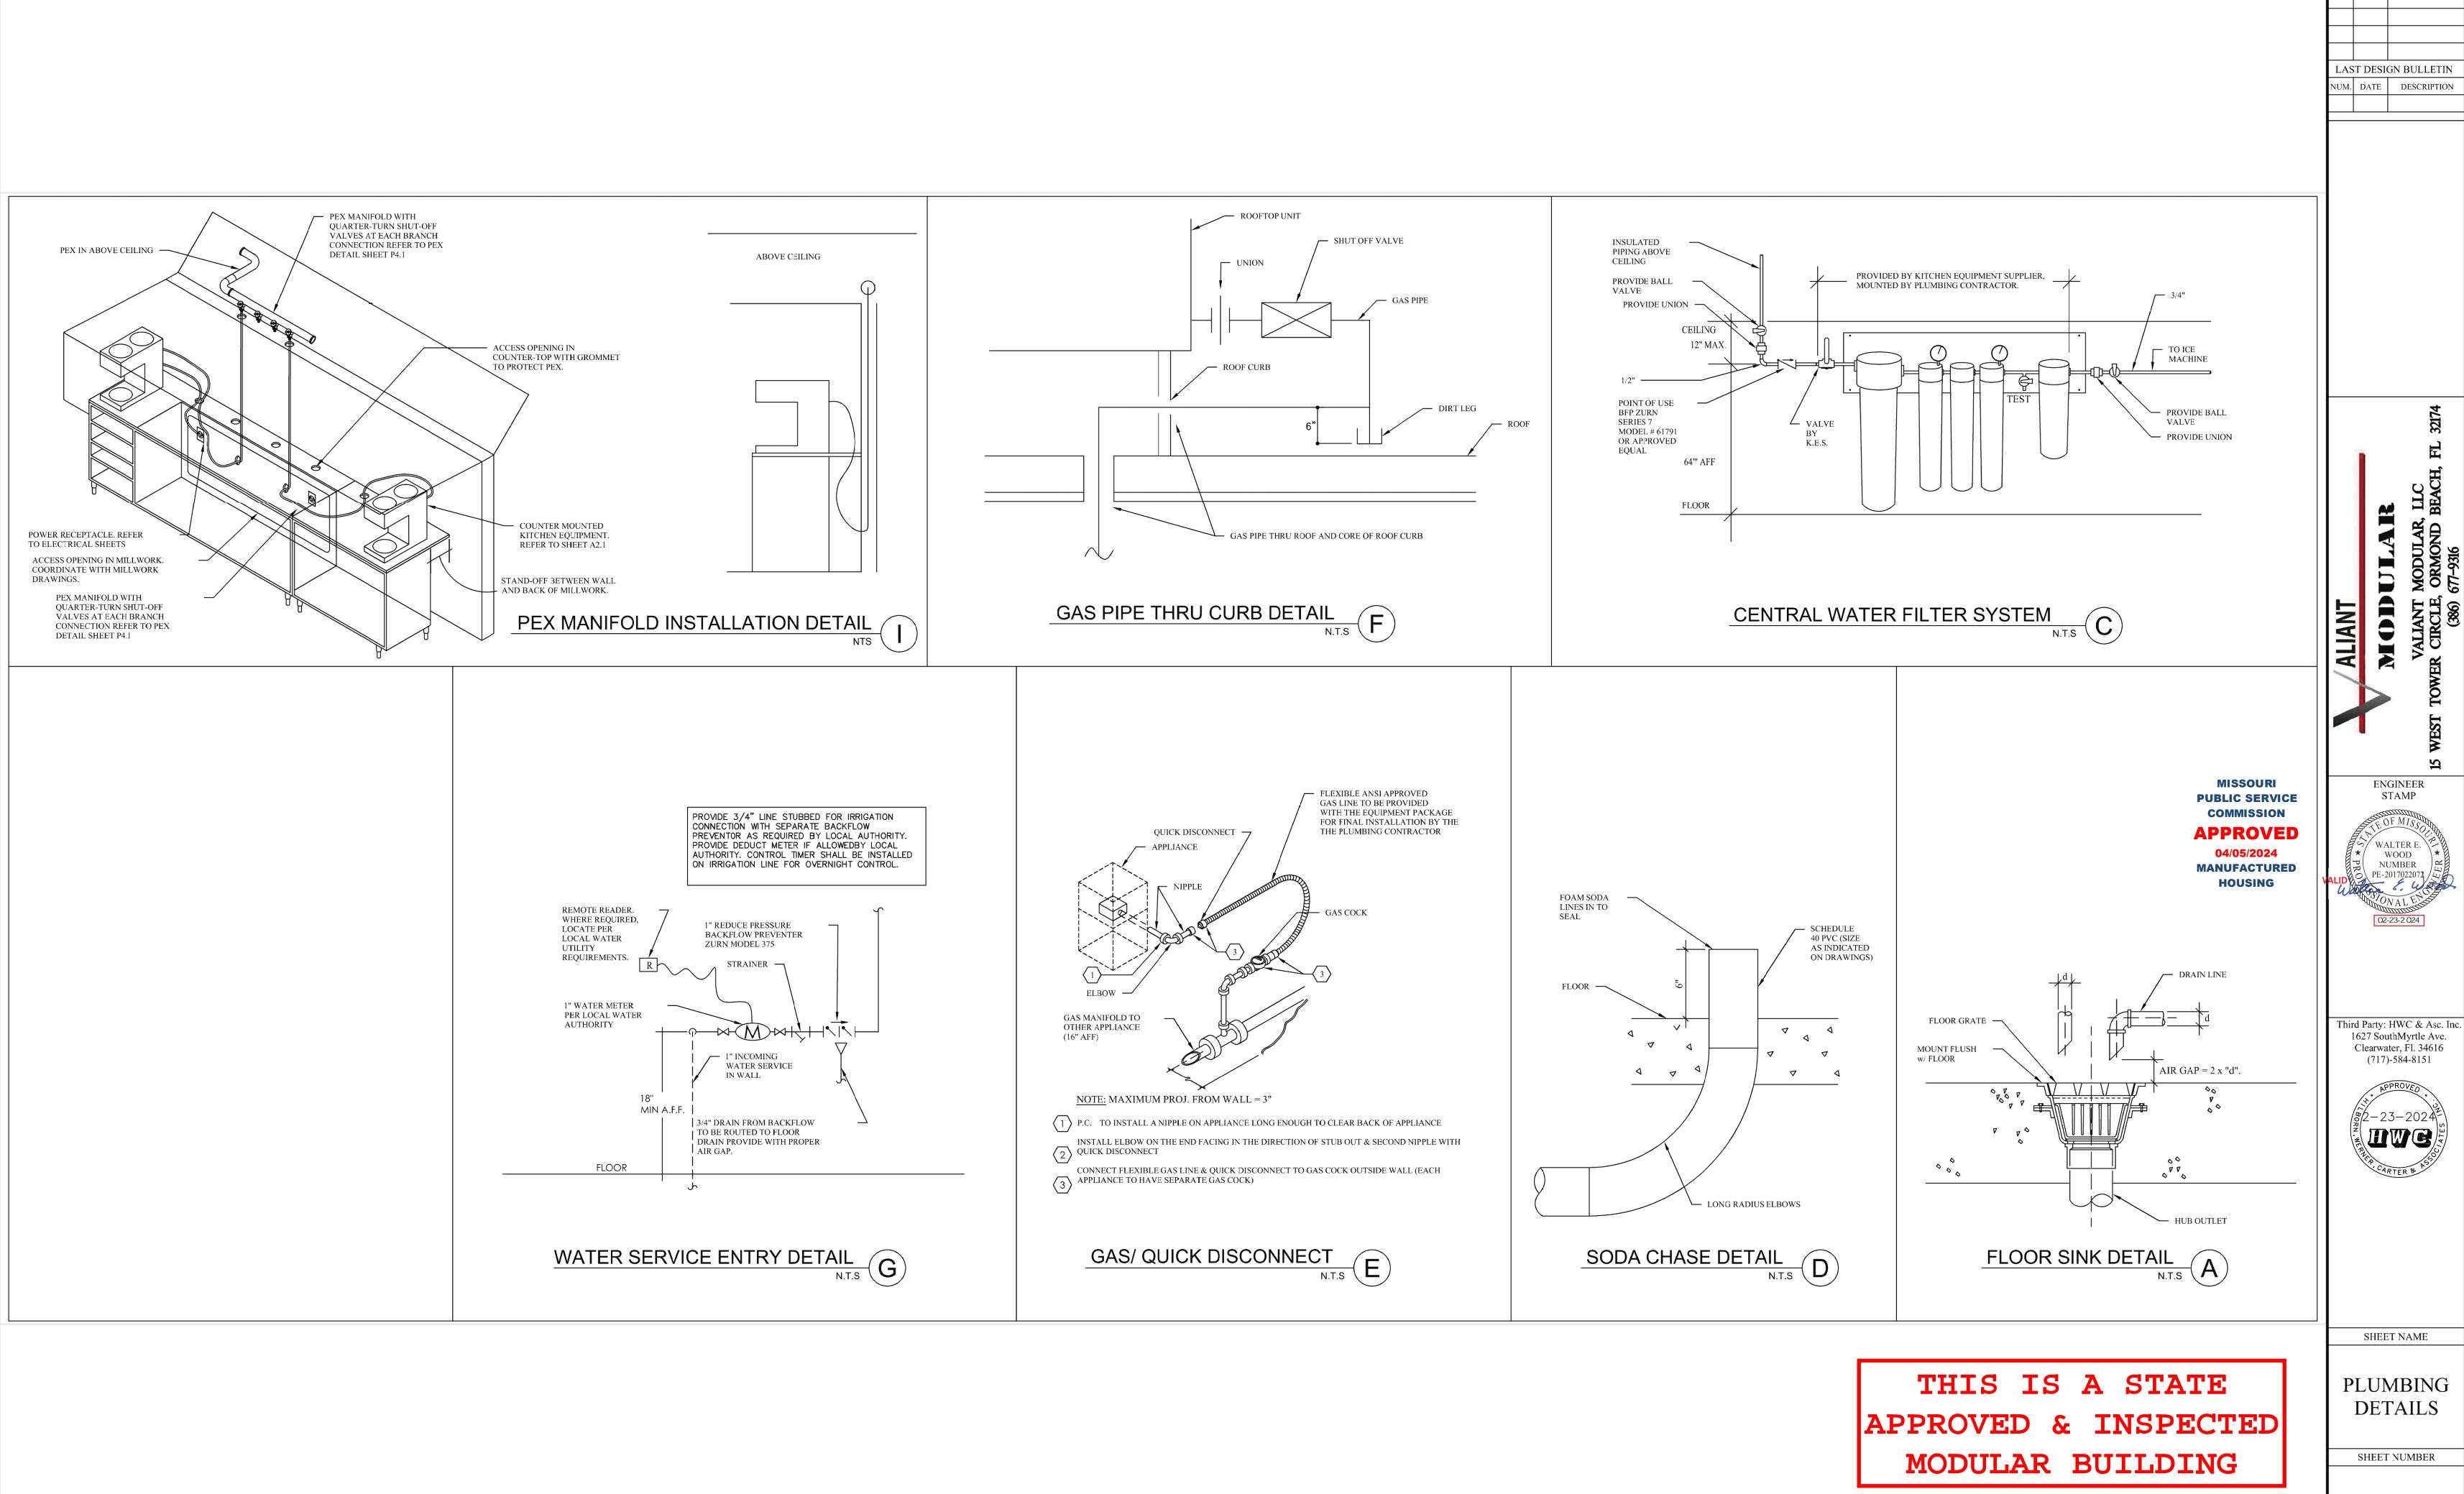



REVISION/ UPLOAD DATE

REV. DATE DESCRIPTION

P4.

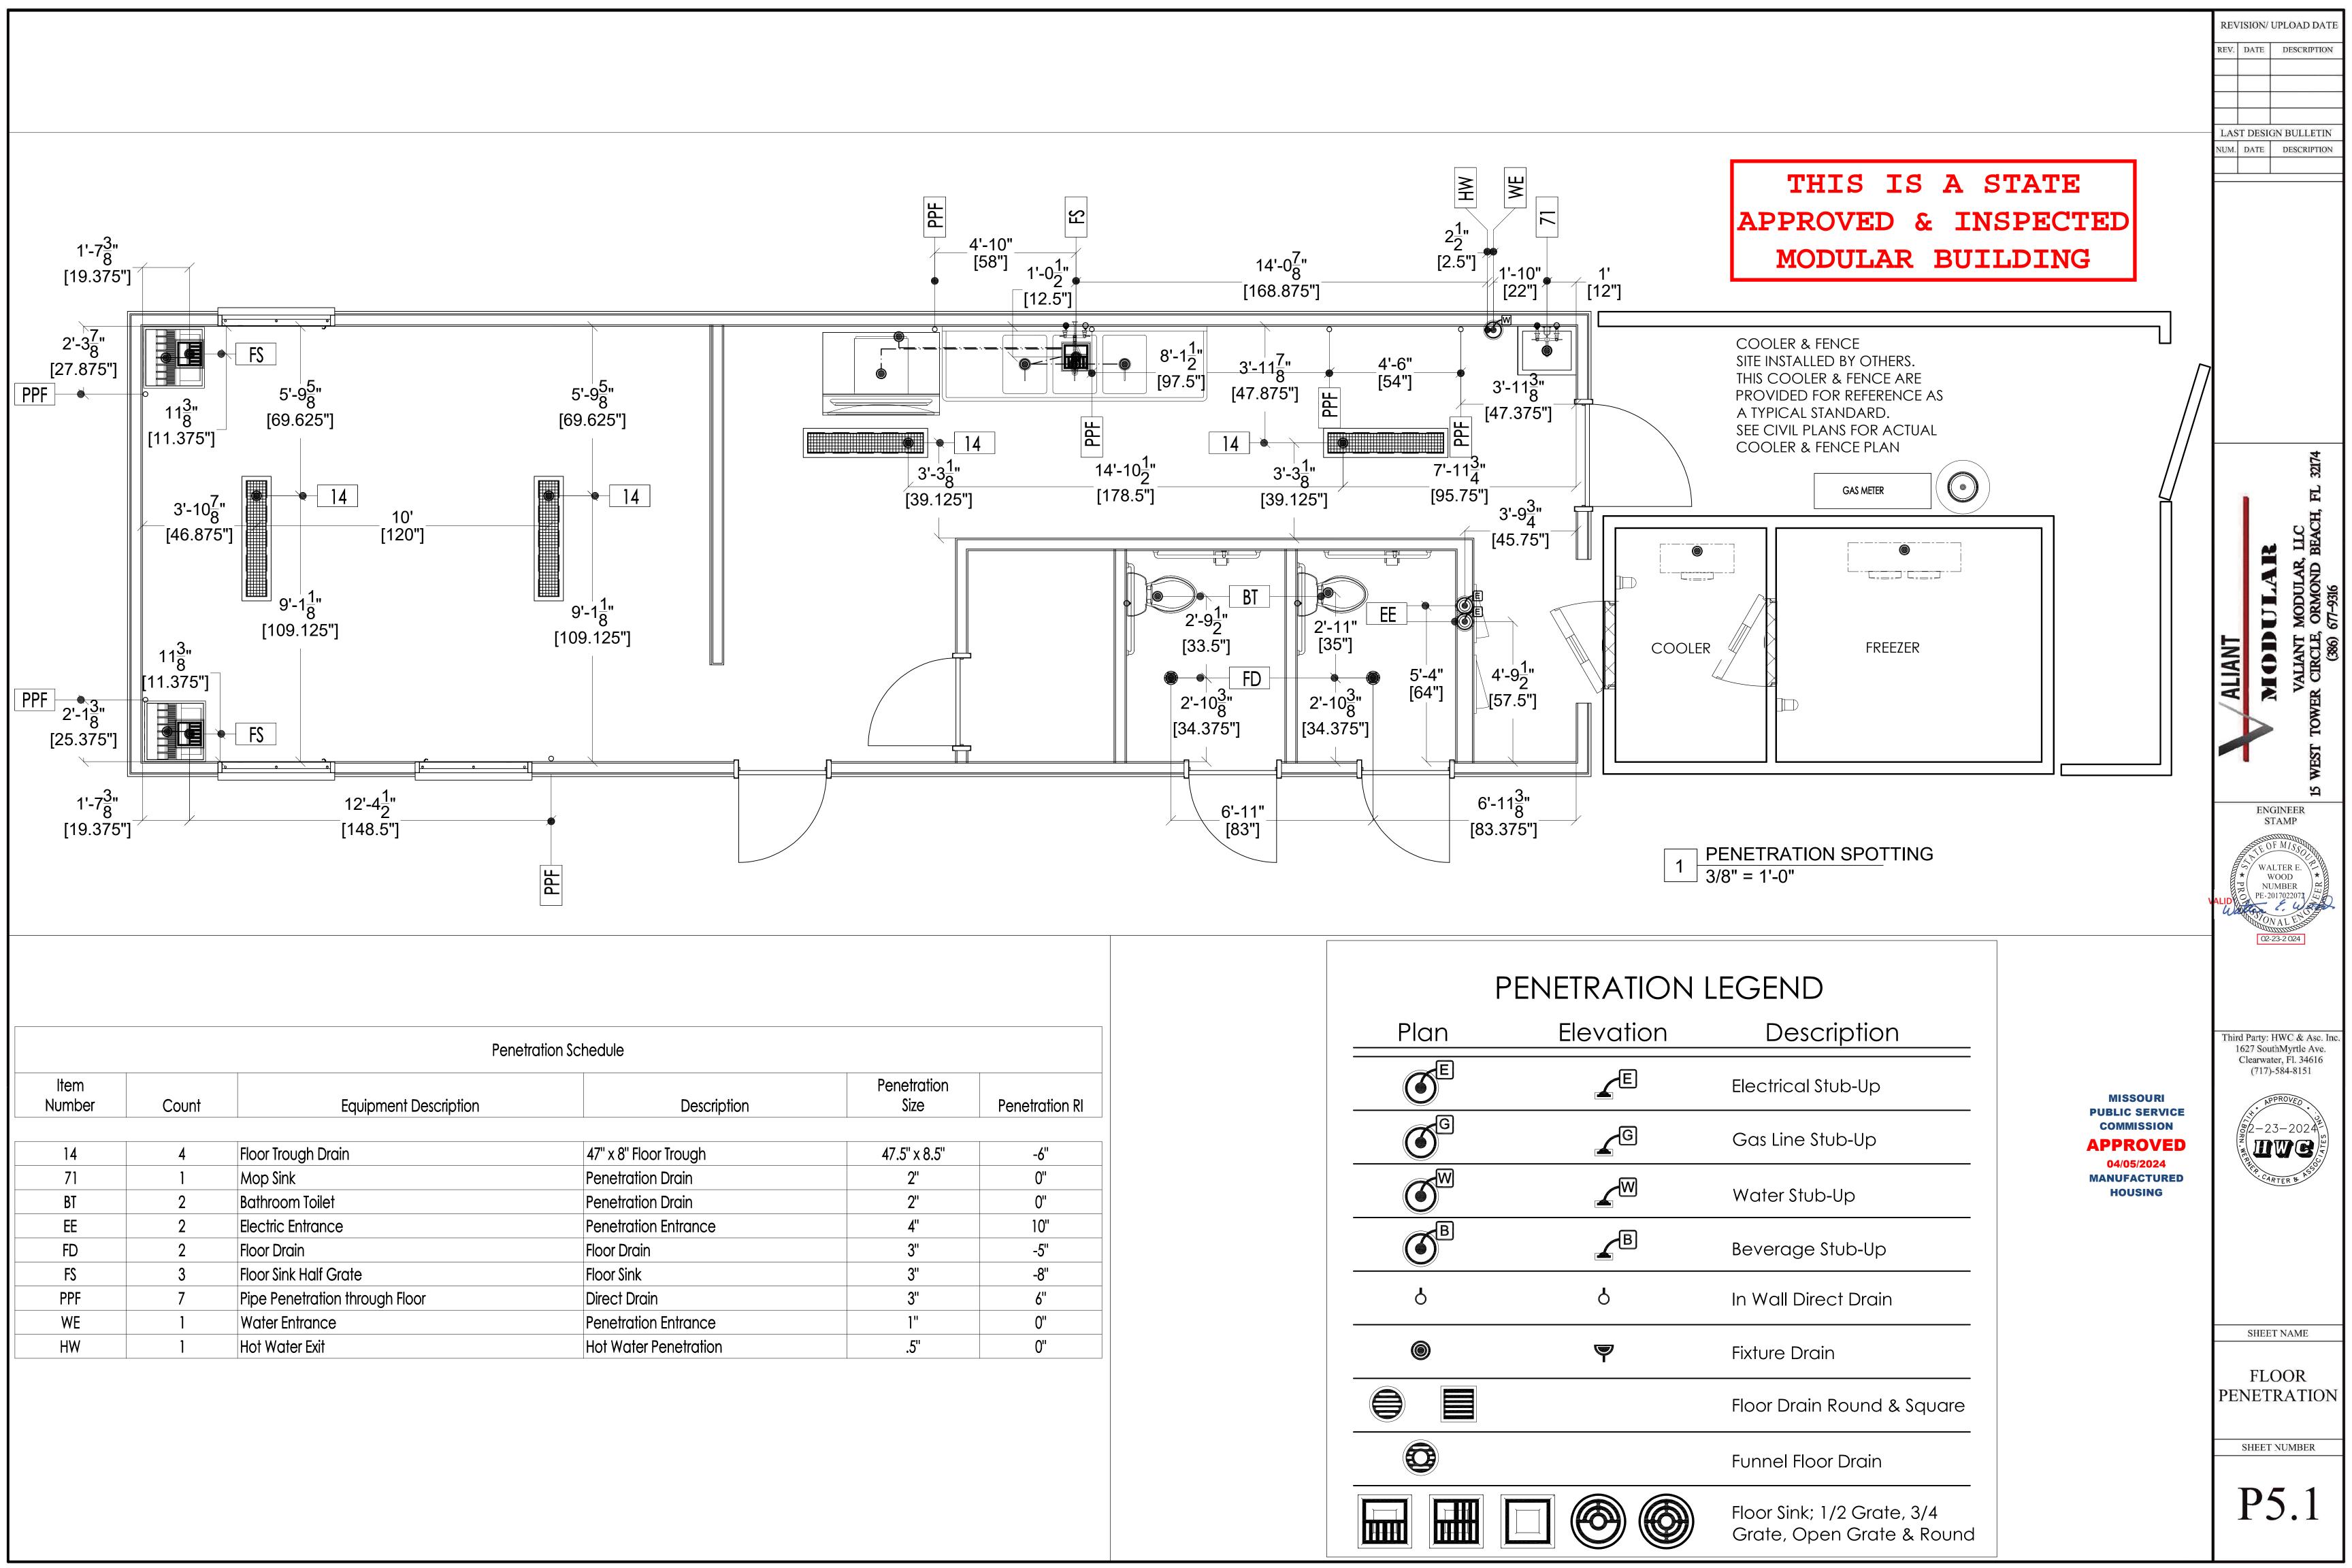

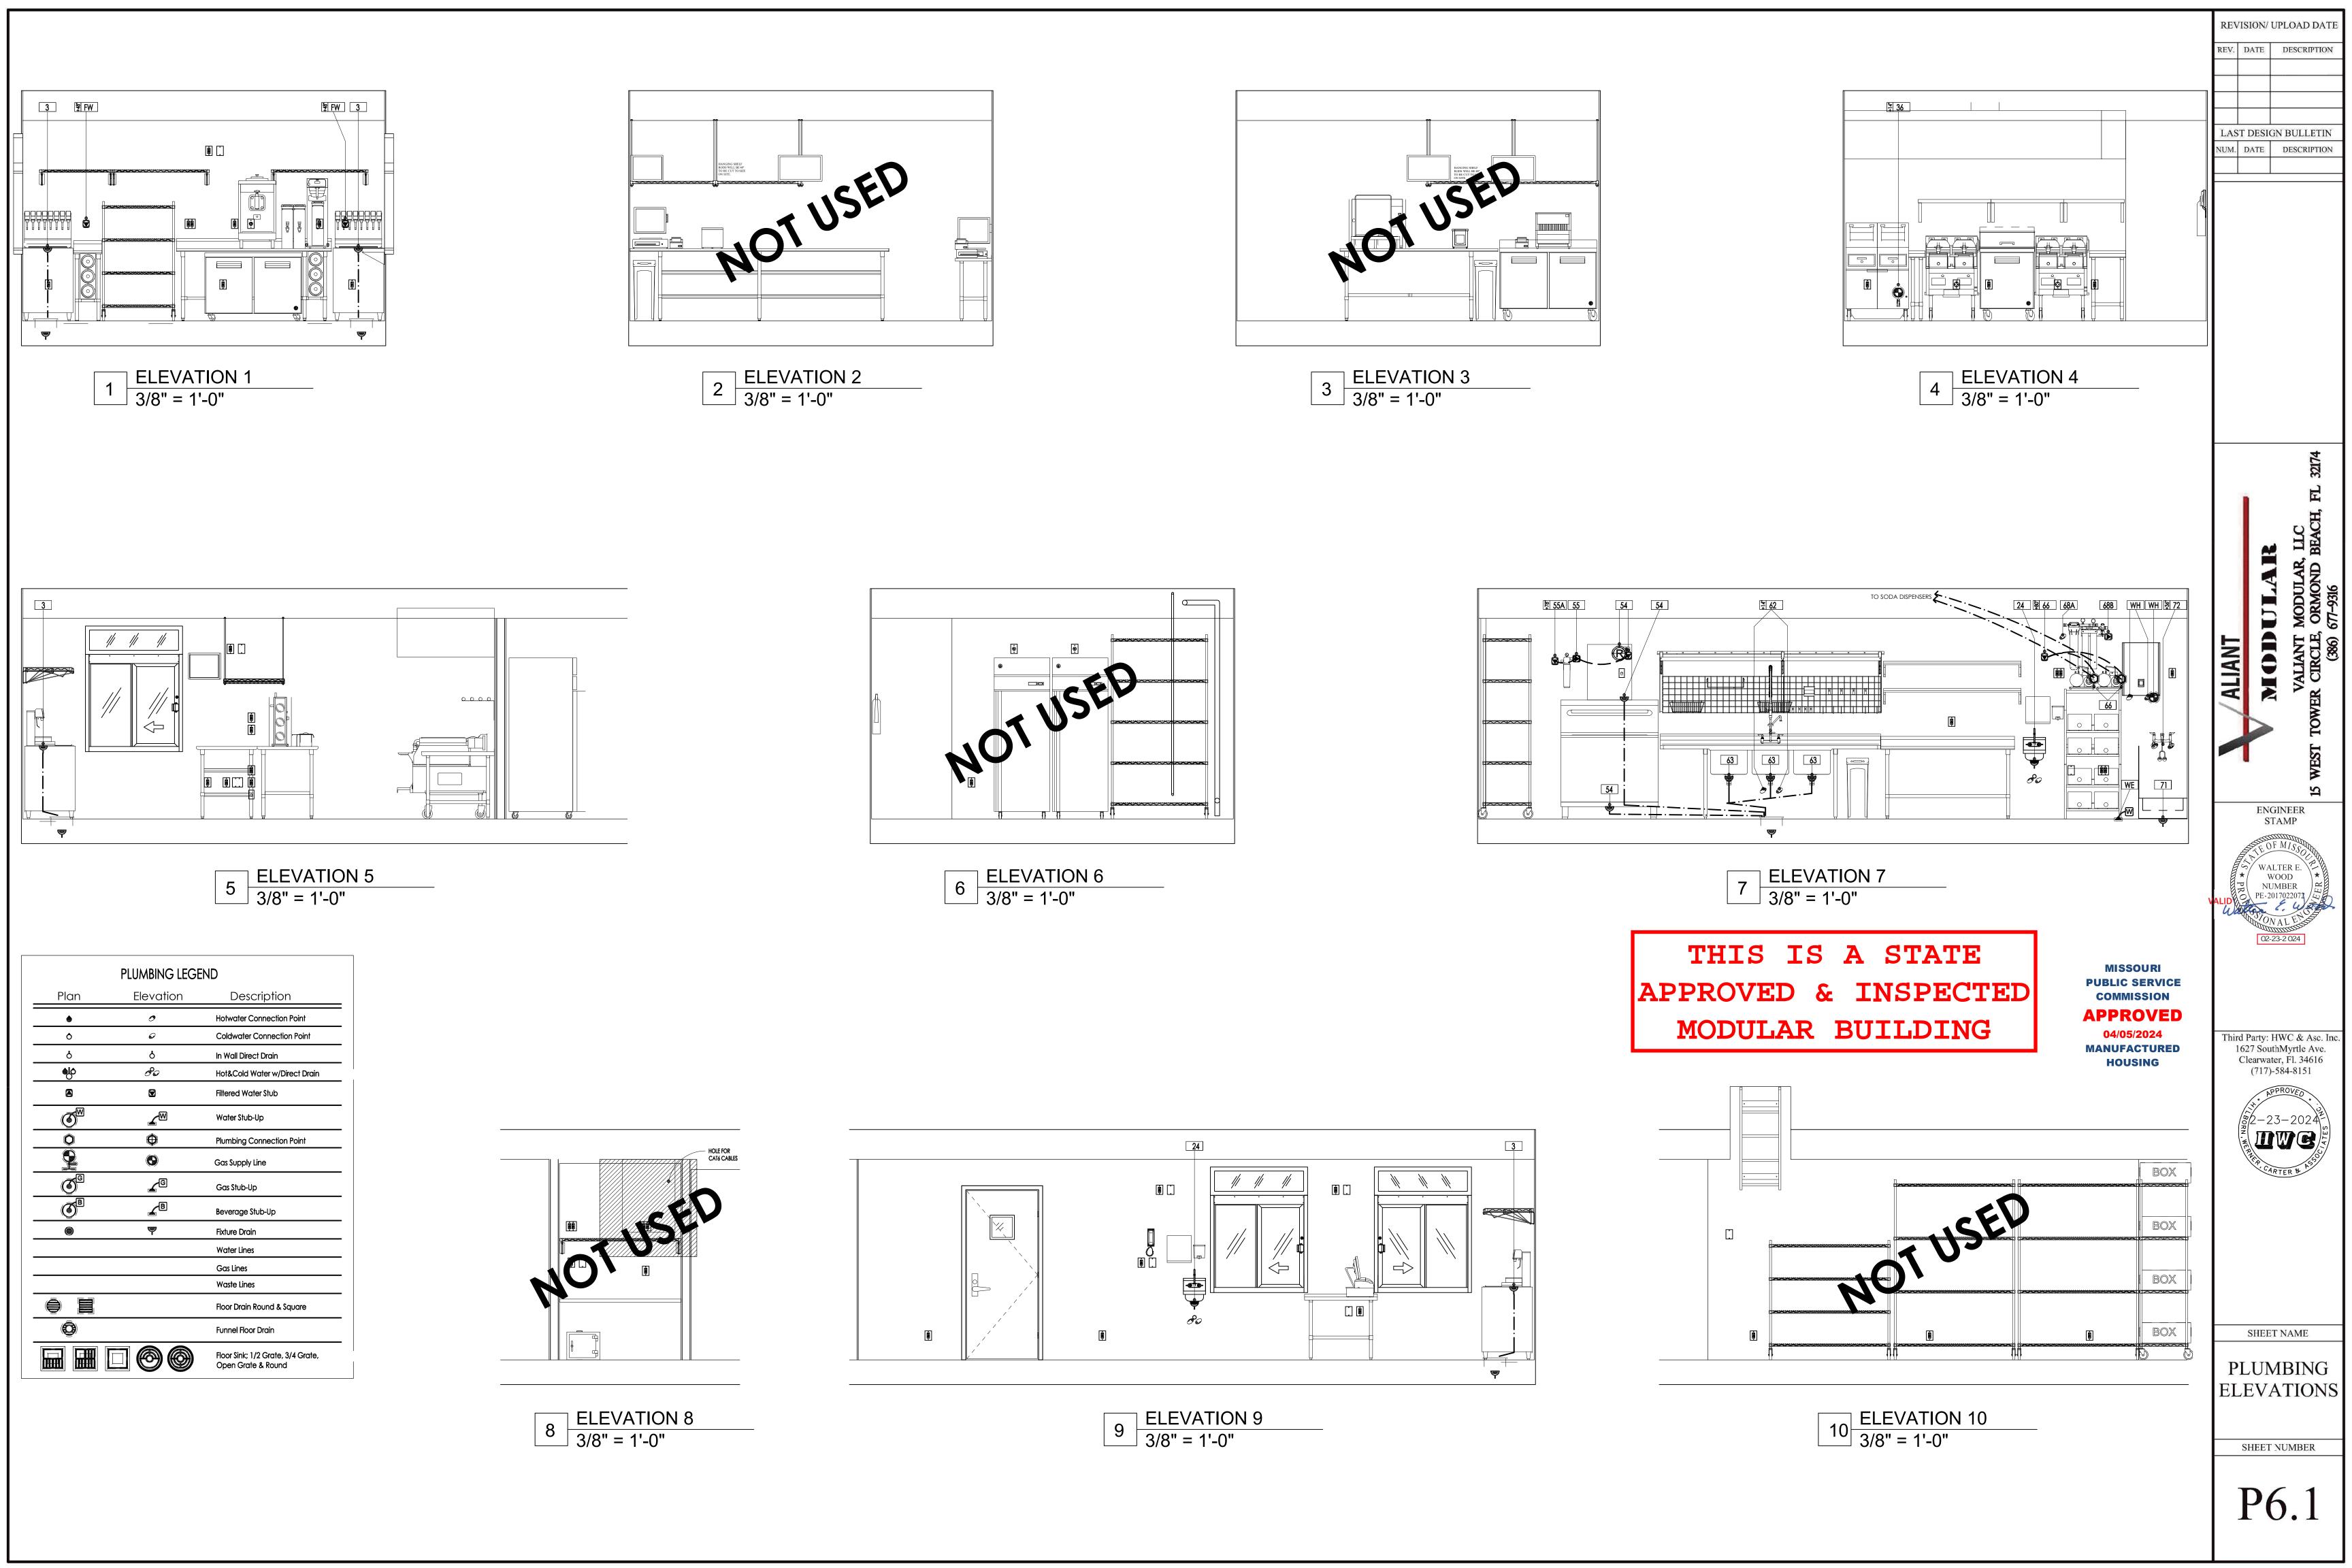

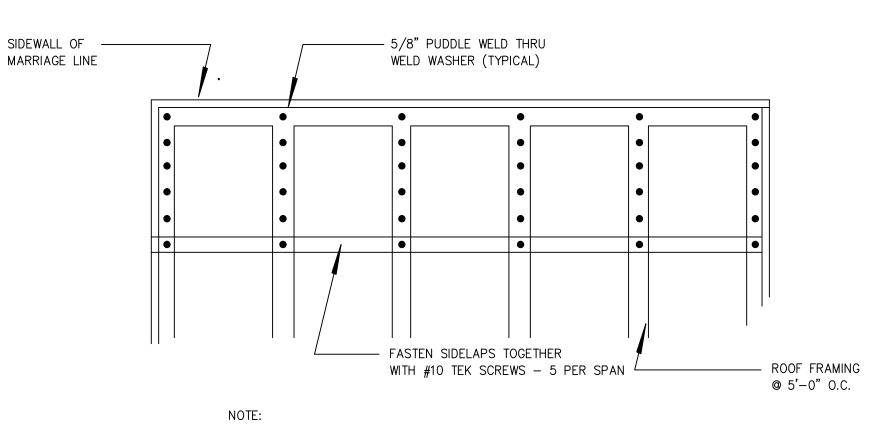

Roof Deck Fasting At All Panels

STRUCTURAL NOTES:

1. ALL LIGHT GAGE STUDS, JOISTS, AND ACCESSORIES SHALL BE FORMED FROM ZINC COATED CORROSION RESISTANT STEEL IN ACCORDANCE WITH ASTM A1003-00 AND THE MANUFACTURER'S SPECIFICATIONS, ALL COLD FORMED MEMBERS SHALL BE BY UNIMAST, INC. OR EQUAL.
12, 14, AND 16 GAGE MINIMUM YIELD STRENGTH SHALL BE 50 KSI. 18 AND 20 GAGE MINIMUM YIELD STRENGTH

2. WALL STUDS SHALL BE LATERALLY BRACED BY ATTACHMENT OF GYPSUM WALL BOARD ON INTERIOR SURFACES AND STRUCTURAL SHEATHING OR EXTERIOR FINISH MATERIAL ON EXTERIOR SURFACES.

3. STEEL TUBES SHALL HAVE A MINIMUM YIELD STRENGTH OF 46 KSI IN ACCORDANCE WITH ASTM A500 GRADE B.
4. HOT ROLLED STEEL SHALL HAVE A MINIMUM YIELD STRENGTH OF 36 KSI IN ACCORDANCE WITH ASTM A36.
5. WELDS ON BASE METALS LESS THAN 1/8 INCH THICK SHALL BE IN ACCORDANCE WITH ANSI/AWS D1.3 ALL OTHER WELDS SHALL BE IN ACCORDANCE WITH ANSI/AWS D1.1.

6. WELDS ON HOT ROLLED STEEL SHALL BE SMAW WITH E70XX ELECTRODES. UNLESS OTHERWISE SPECIFIED FILLET WELDS SHALL BE THE SAME THICKNESS OF THE BASE METAL FOR METALS UP TO 1/4 INCH THICK, AND THE THICKNESS OF THE BASE METAL MINUS 1/16 INCH FOR METALS 1/4 INCH OR MORE IN THICKNESS.

7. ALL BUTT WELDS SHALL BE COMPLETE PENETRATION GROOVE WELDS UNLESS OTHERWISE SPECIFIED.


8. ALL METAL SCREWS SHALL BE TEKS #10 SELF-DRILLING SCREWS BY ITW BUILDEX OR EQUAL UNLESS OTHERWISE SPECIFIED. ALL SCREWS SHALL PENETRATE CONNECTING METAL PARTS BY 3 OR MORE EXPOSED THREADS.

9. ALL METAL DECKING SHALL BE BY VULCRAFT, OR EQUAL. METAL DECKING SHALL BE IN ACCORDANCE WITH THE

"STEEL DECK INSTITUTE" STANDARDS.

10. ALL BOLTS SHALL COMPLY WITH ASTM A325 UNLESS OTHERWISE SPECIFIED. 5/8" SAE GRADE 8 BOLTS ARE AN


ACCEPTABLE ALTERNATIVE.

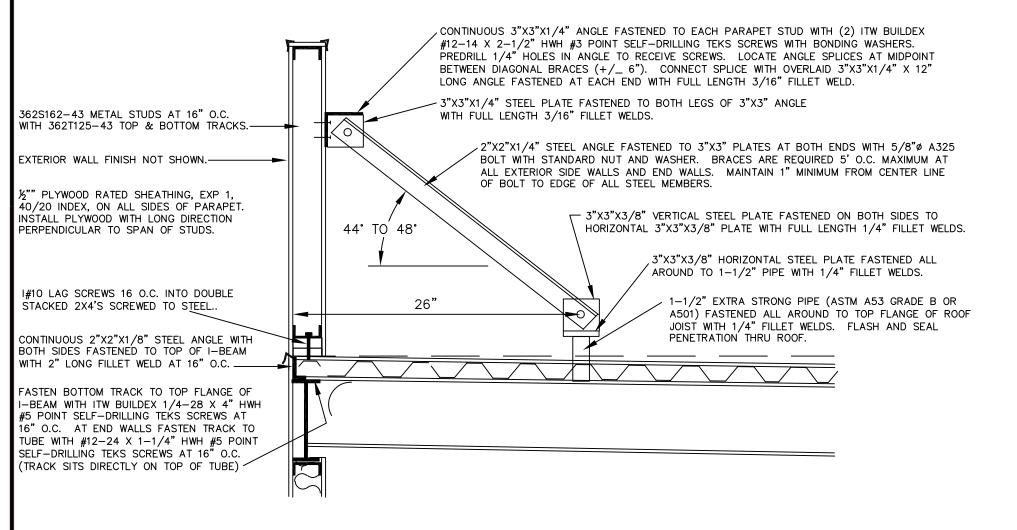

ROOF PARAPET DETAIL

NTS

Dead load of container above = 28.1 psf (9 kip)

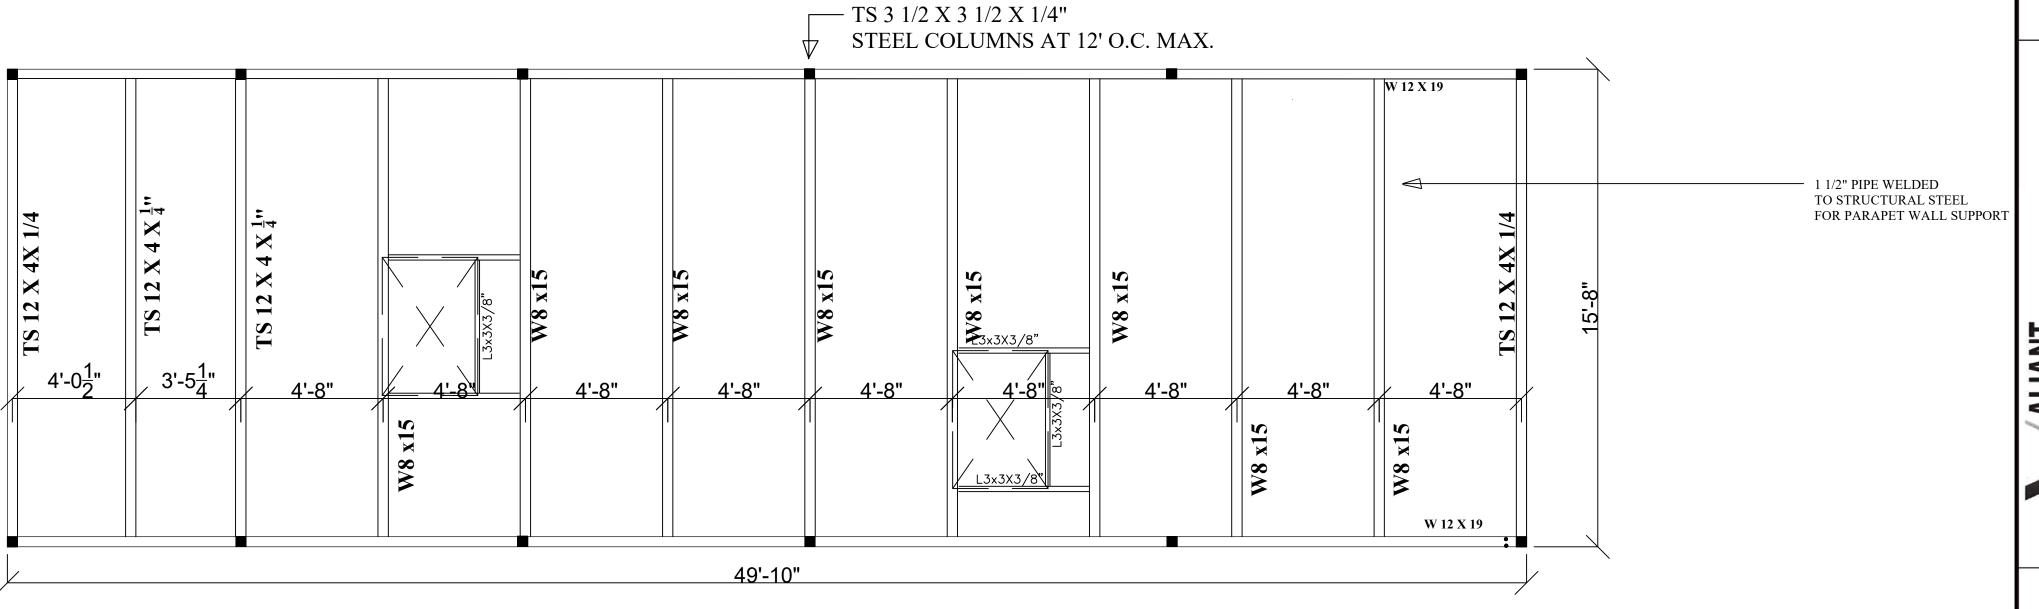

ROOF FRAMING



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MODULAR BUILDING

REVISION/ UPLOAD DATE

REV. DATE DESCRIPTION

LAST DESIGN BULLETIN

NUM. DATE DESCRIPTION

ALIDANT MODULE STAMP

WALLANT MODULE WOOD WALLANT MODULE ORMO


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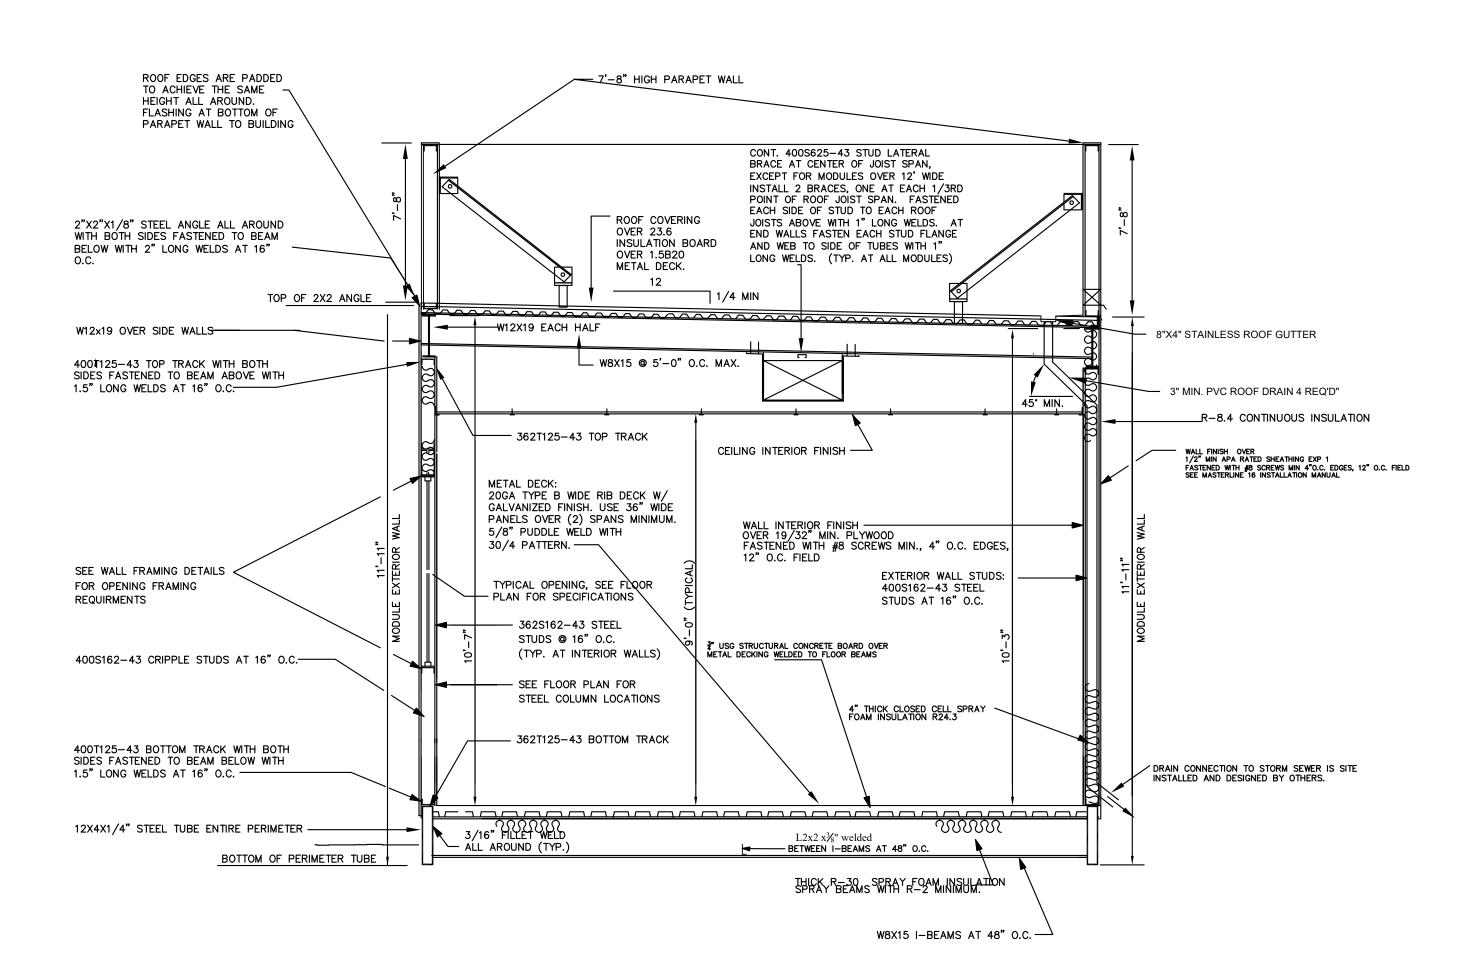
Third Party: HWC & Asc. Inc 1627 SouthMyrtle Ave. Clearwater, Fl. 34616 (717)-584-8151

ROOF
PLAN
STEEL

SHEET NUMBER

S2.1



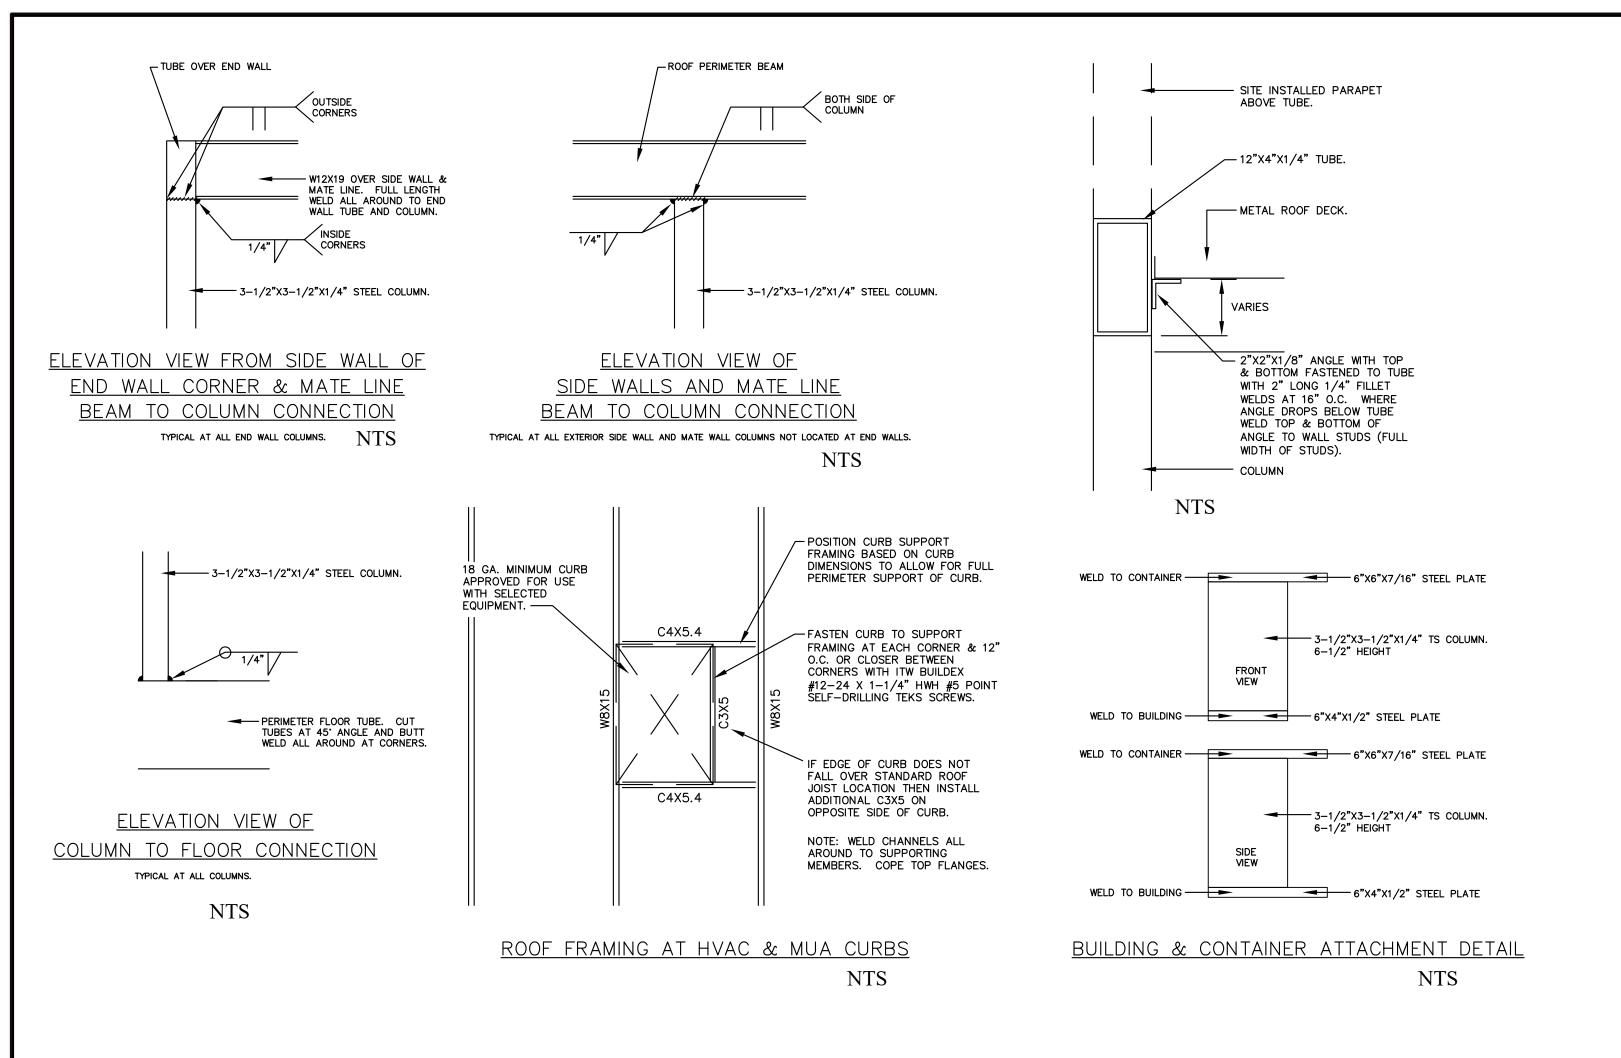


CROSS SECTION - MODULE A SCALE: $3/8" \approx 1'-0"$

WALL AIR BARRIERS — EXTERIOR AND INTERIOR PLYWOOD, CEMENT BOARD AND CLOSED CELL FOAM SPRAY

ROOF AIR BARRIER — STEEL DECK AND MEMBRANE ROOF SEALED

FLOOR AIR BARRIER - STEEL DECK AND CLOSED CELL SPRAY FOAM

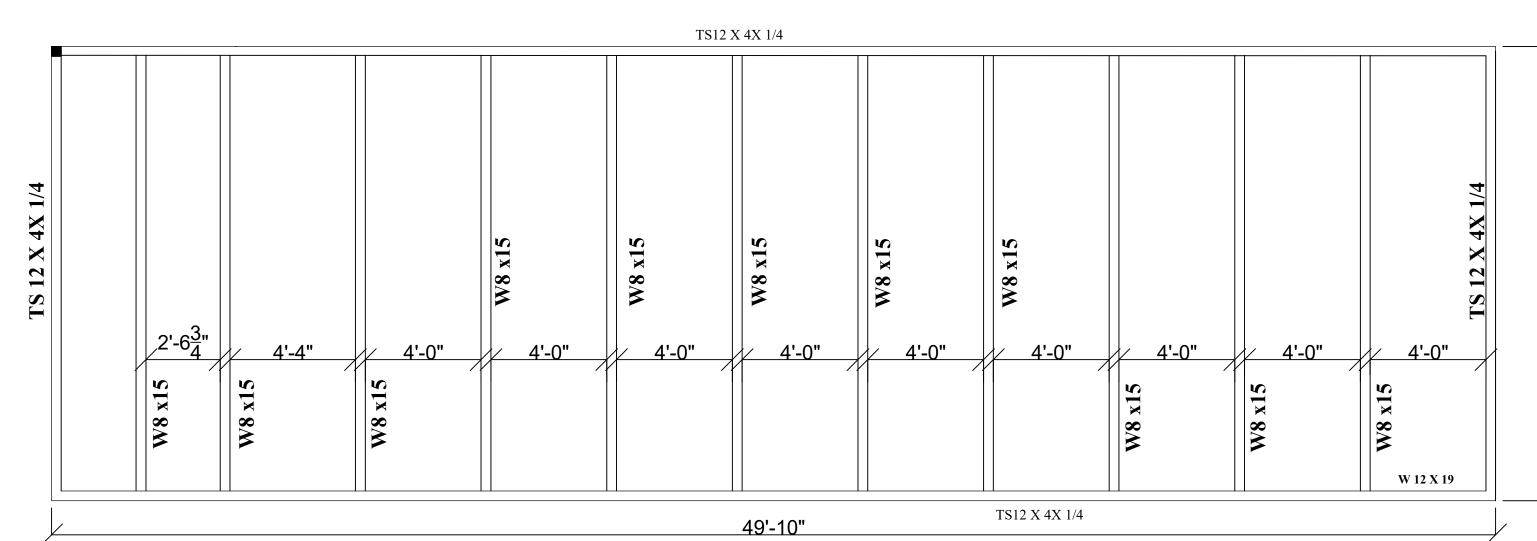

STRUCTURAL NOTES:

1. ALL LIGHT GAGE STUDS, JOISTS, AND ACCESSORIES SHALL BE FORMED FROM ZINC COATED CORROSION RESISTANT STEEL IN ACCORDANCE WITH ASTM A1003-00 AND THE MANUFACTURER'S SPECIFICATIONS, ALL COLD FORMED MEMBERS SHALL BE BY UNIMAST, INC. OR EQUAL.
12, 14, AND 16 GAGE MINIMUM YIELD STRENGTH SHALL BE 50 KSI. 18 AND 20 GAGE MINIMUM YIELD STRENGTH SHALL BE 33 KSI.

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STEEL TUBES SHALL HAVE A MINIMUM YIELD STRENGTH OF 46 KSI IN ACCORDANCE WITH ASTM A500 GRADE B.
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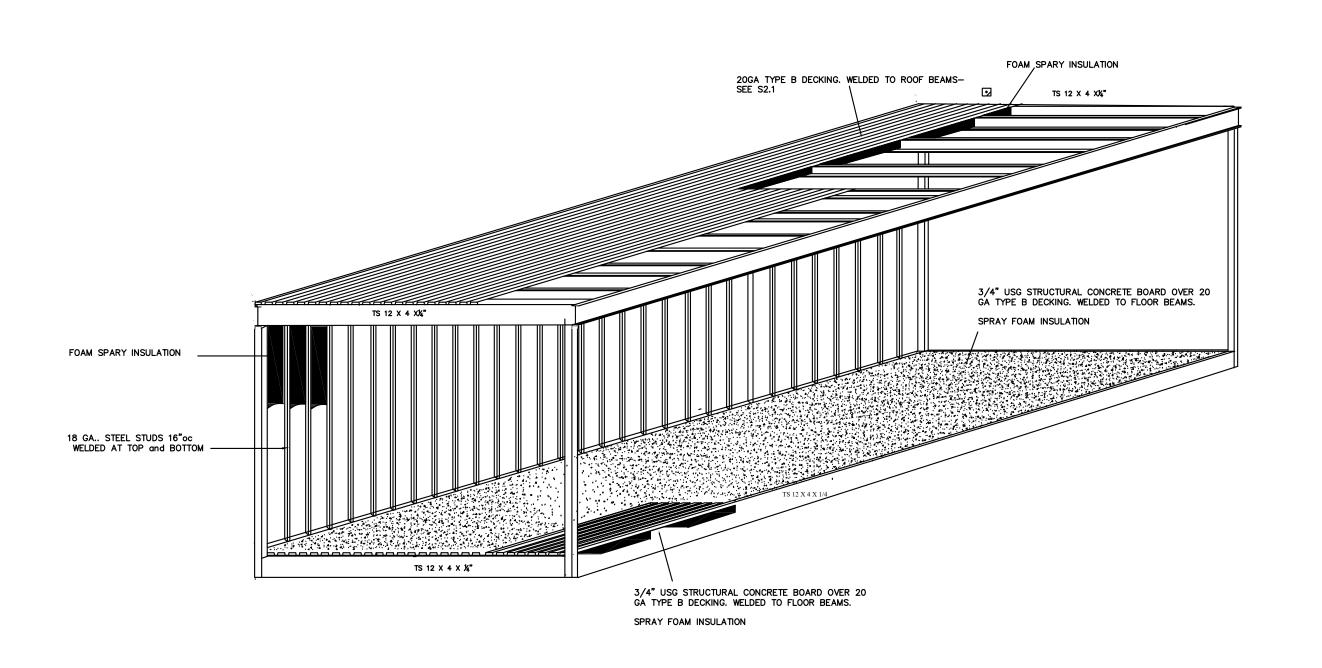
7. ALL BUTT WELDS SHALL BE COMPLETE PENETRATION GROOVE WELDS UNLESS OTHERWISE SPECIFIED.

8. ALL METAL SCREWS SHALL BE TEKS #10 SELF-DRILLING SCREWS BY ITW BUILDEX OR EQUAL UNLESS OTHERWISE SPECIFIED. ALL SCREWS SHALL PENETRATE CONNECTING METAL PARTS BY 3 OR MORE EXPOSED THREADS.

9. ALL METAL DECKING SHALL BE BY VULCRAFT, OR EQUAL. METAL DECKING SHALL BE IN ACCORDANCE WITH THE "STEEL DECK INSTITUTE" STANDARDS.

10. ALL BOLTS SHALL COMPLY WITH ASTM A325 UNLESS OTHERWISE SPECIFIED. 5/8" SAE GRADE 8 BOLTS ARE AN ACCEPTABLE ALTERNATIVE.

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CONTINUOUS AIR BARRIER IN THERMAL ENVELOPE SHALL BE WRAPPED, SEALED WITH FOAM, CAULKED, GASKETED, AND /OR TAPED INCLUDING DOORS WINDOWS.



WALTER E.

WOOD
NUMBER
PE-2017022072

02-23-2 024



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04/05/2024

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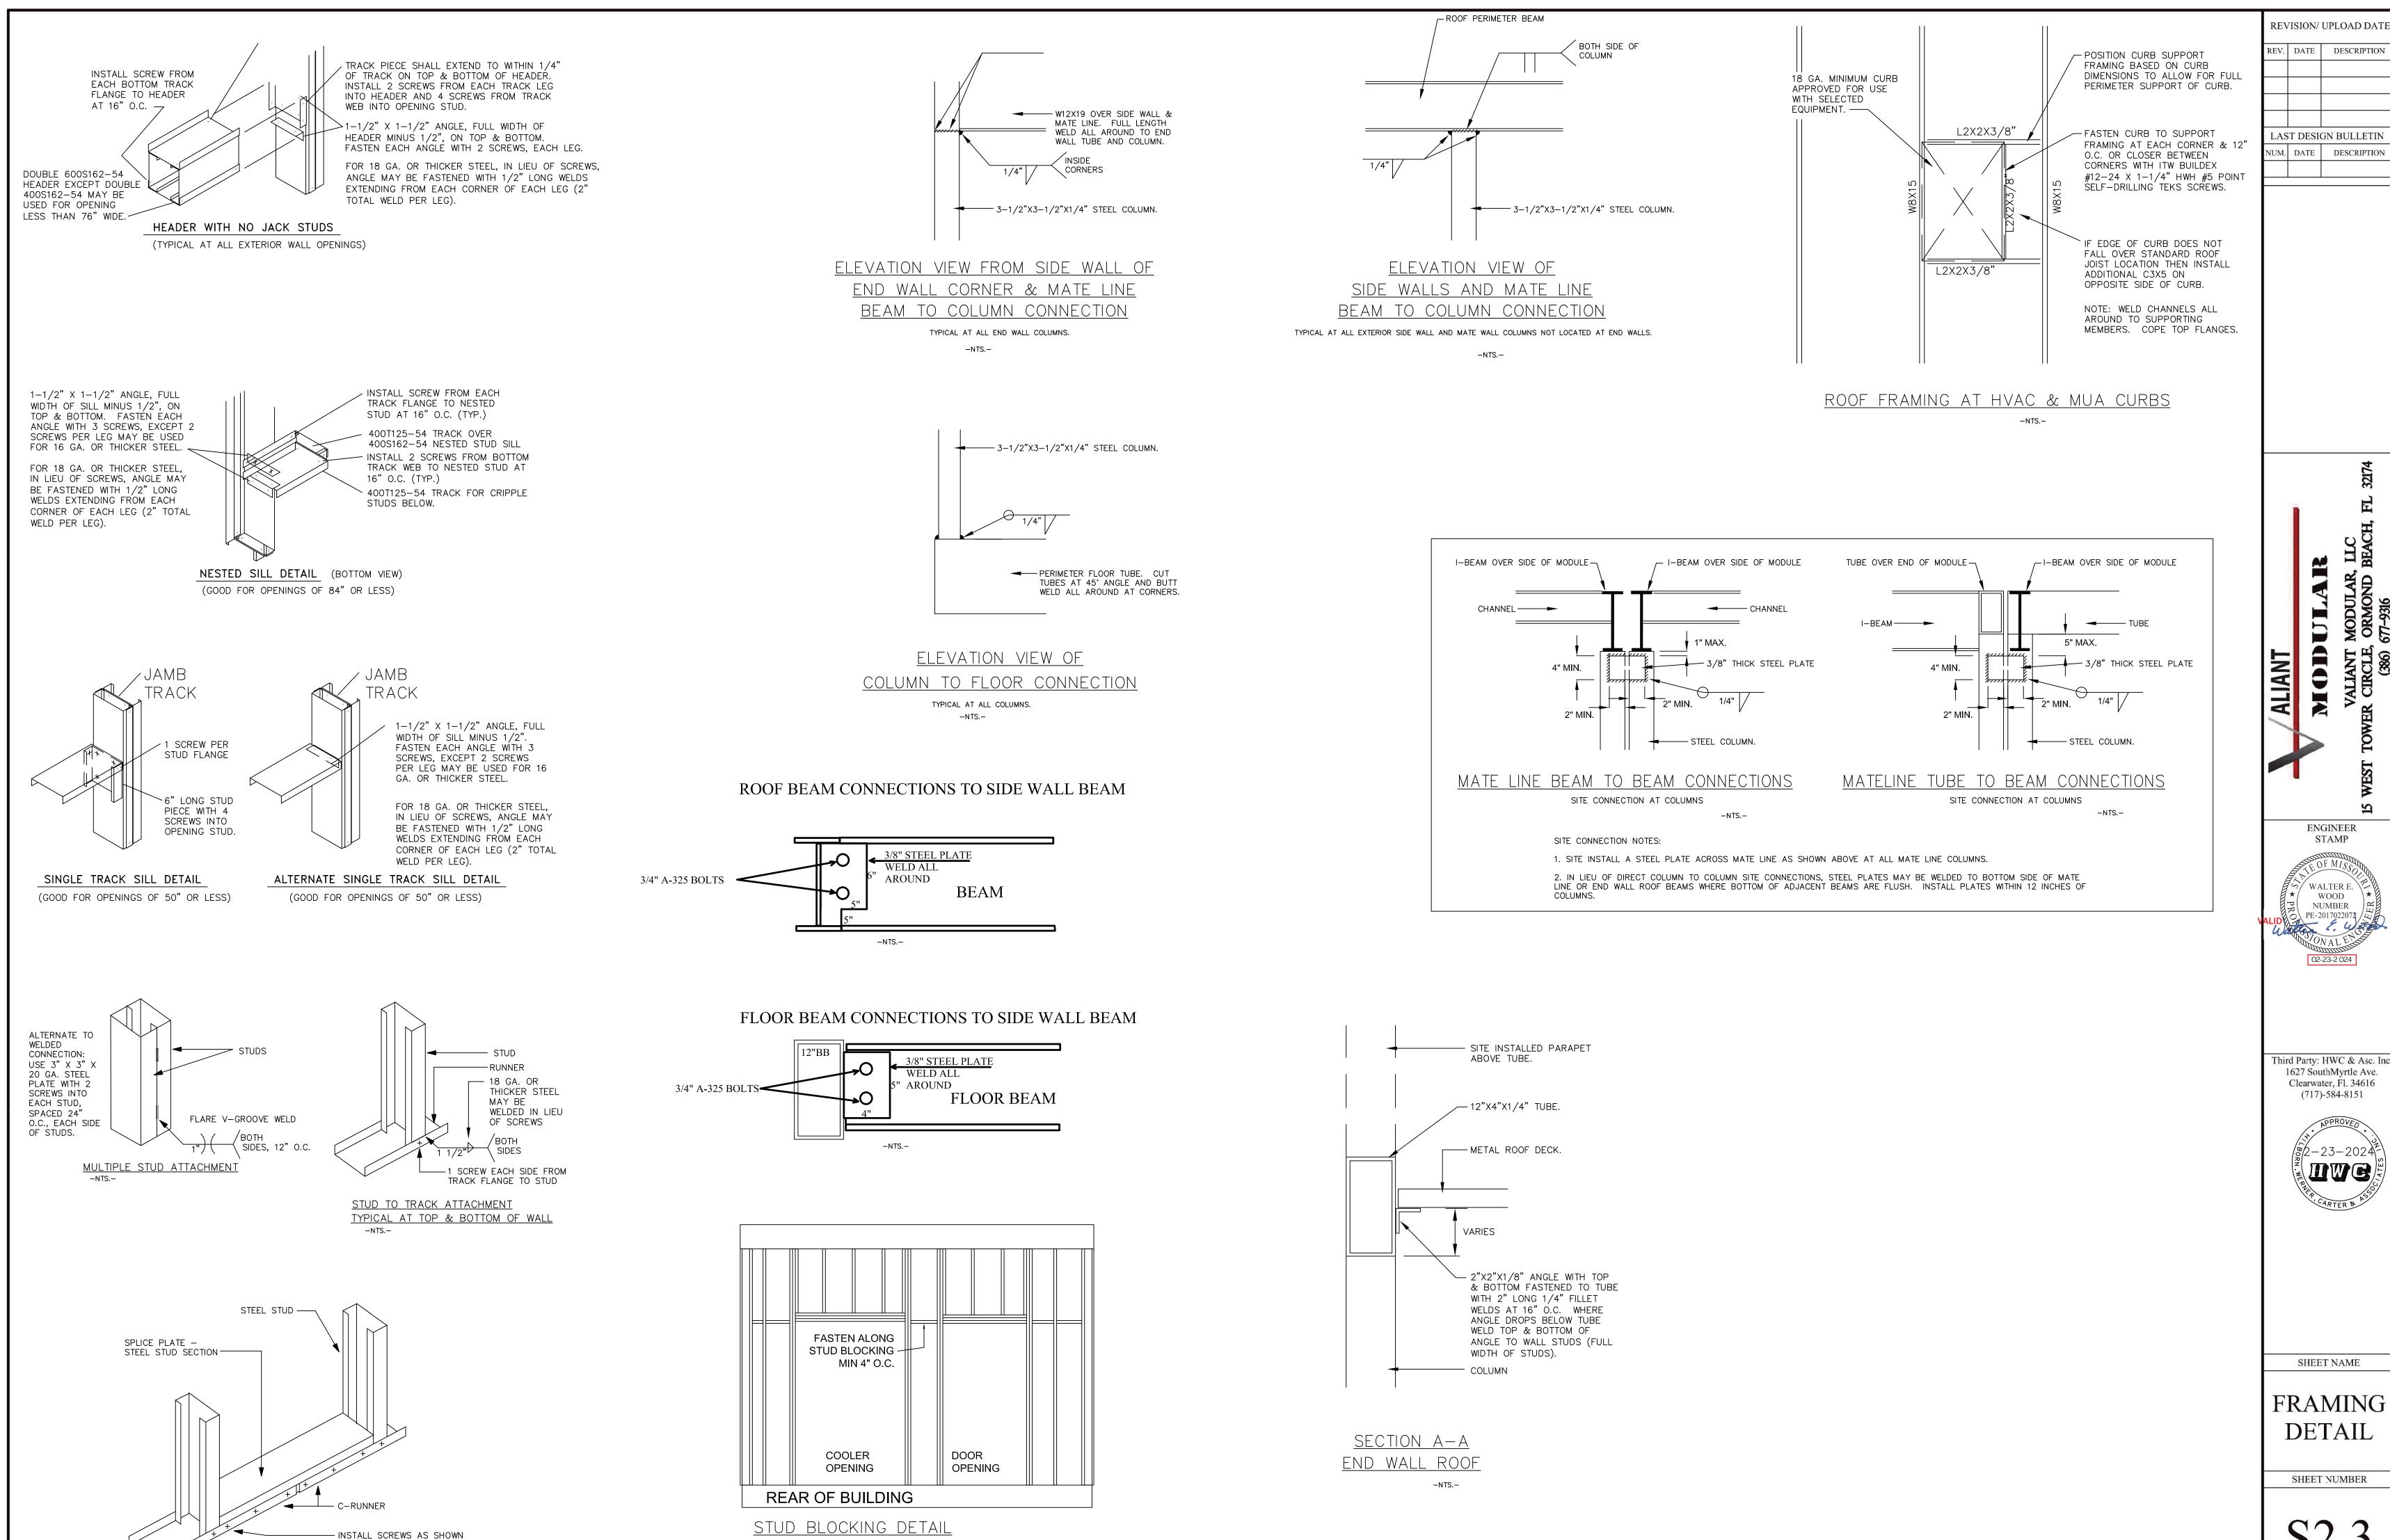
HOUSING

Third Party: HWC & Asc. Inc

FLOOR FRAMING PLAN

S2.2

SHEET NUMBER



REAR OF BUILDING ONLY

-NTS.-

RUNNER SPLICE

TYPICAL AT TOP AND BOTTOM OF WALL

REV. DATE DESCRIPTION

LAST DESIGN BULLETIN NUM. DATE DESCRIPTION

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ENGINEER ℅⁄ WALTER E. ` WOOD NUMBER

Third Party: HWC & Asc. Inc 1627 SouthMyrtle Ave. Clearwater, Fl. 34616 (717)-584-8151

SHEET NAME

FRAMING **DETAIL**

SHEET NUMBER

Envelope Compliance Certificate

Project Information

Energy Code:90.1 (2013) StandardProject Title:Slider Drive-ThruLocation:Saint Louis, Missouri

Climate Zone: 4

Project Type: New Construction

Vertical Glazing / Wall Area: 2%

Performance Sim. Specs: EnergyPlus 8.1.0.009 (EPW: USA_MO_StLouis-LambertIntl.AP.724340_TMY 3.epw)

Construction Site: St Louis, MO

Owner/Agent

Designer/Contractor: Valiant Equipment, LLC 15 West Tower Circle Ormond Beach, FL 32174 386-677-9316

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1 of 18

Page

Building Area Floor Area

1-Dining: Cafeteria/Fast Food : Nonresidential 952

Envelope Assemblies

Assembly	Gross Area or Perimeter	Cavity R-Value	Cont. R-Value	Proposed U-Factor	Budget U- Factor _(a)
Floor 1: Concrete Floor (over unconditioned space), [Bldg. Use 1 - Dining: Cafeteria/Fast Food]	800		30.0	0.030	0.057
Roof 1: Insulation Entirely Above Deck: Cool roof exempt, [Bldg. Use 1 - Dining: Cafeteria/FastFood]	800		23.6	0.041	0.032
NORTH Right Elevation Wall - Tile Finish: Steel-Framed, 16" o.c., [Bldg. Use 1 - Dining: Cafeteria/Fast Food]	600	24.3	8.4	0.053	0.064
Door 101A: Insulated Metal, Swinging, [Bldg. Use 1 - Dining: Cafeteria/Fast Food]	63			0.500	0.500
EAST Front Elevation Wall - Tile Finish: Steel-Framed, 16" o.c., [Bldg. Use 1 - Dining: Cafeteria/Fast Food]	192	24.3	8.4	0.053	0.064
Front Service Window: Metal Frame:Operable, Perf. Specs.: Product ID bb, SHGC 0.27, PF 0.40, VT 0.62, [Bldg. Use 1 - Dining: Cafeteria/Fast Food] (b)	19			0.290	0.500
SOUTH Left Elevation Wall - Tile Finish: Steel-Framed, 16" o.c., [Bldg. Use 1 - Dining: Cafeteria/Fast Food]	600	24.3	8.4	0.053	0.064
Drive Thru Window: Metal Frame:Operable, Perf. Specs.: Product ID aa, SHGC 0.27, PF 1.00, VT 0.62, [Bldg. Use 1 - Dining: Cafeteria/Fast Food] (b)	19			0.290	0.500
WEST Rear Elevation Wall - E.I.F.S. Finish: Steel-Framed, 16" o.c., [Bldg. Use 1 - Dining: Cafeteria/FastFood]	192	24.3	8.4	0.053	0.064

Project Title: Slider Drive-Thru Report date: 02/22/24

Data filename: P:\Valiant Modular\Sliders\Missouri Sliders\Sliders Arkansas.cck

Assembly	Gross Area or Perimeter	,	Cont. R-Value	Proposed U-Factor	Budget U- Factor _(a)
Door 101B: Insulated Metal, Swinging, [Bldg. Use 1 - Dining:	22			0.500	0.500
Cafeteria/Fast Food]					

- (a) Budget U-factors are used for software baseline calculations ONLY, and are not code requirements.
- (b) Fenestration product performance must be certified in accordance with NFRC and requires supporting documentation.

Envelope PASSES: Design 2% better than code

Envelope Compliance Statement

Name - Title

Compliance Statement: The proposed envelope design represented in this accument is consistent with the building plans, specifications, and other calculations submitted with this permit application. The proposed envelope systems have been designed to meet the 90.1 (2013) Standard requirements in COMcheen Version 4.1.5.5 and to comply with any applicable mandatory requirements listed in the Inspection Checklist.

* WOOD NUMBER

gnature PE-2017022072

02-23-2024

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Page

Date

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Project Title: Slider Drive-Thru Report date: 02/22/24

Data filename: P:\Valiant Modular\Sliders\Missouri Sliders\Sliders Arkansas.cck

COMcheck Software Version 4.1.5.5

Interior Lighting Compliance Certificate

Project Information

Energy Code: 90.1 (2013) Standard Project Title: Slider Drive-Thru Project Type: **New Construction**

Construction Site: St Louis, MO

Owner/Agent

Designer/Contractor: Valiant Equipment, LLC 15 West Tower Circle Ormond Beach, FL 32174 386-677-9316

Allowed Interior Lighting Power

Area (A Category	B Floor Area (ft2)	C Allowed Watts /ft2	D Allowed Watts (B X C)
1-Dining: Cafeteria/Fast Food		952	0.90	857
			Total Allowed Watte	OE7

Proposed Interior Lighting Power

A Fixture ID: Description / Lamp / Wattage Per Lamp / Ballast	B Lamps/ Fixture	C # of Fixtures	D Fixture Watt.	(C X D)
1-Dining: Cafeteria/Fast Food				
LED 1: LED Other Fixture Unit 46W:	1	6	45	270
LED 2: LED Other Fixture Unit 46W:	1	3	39	117
LED 3: LED A Lamp 12W:	1	3	12	36
		Total Propos	sed Watts =	423

Interior Lighting PASSES: Design 51% better than code

Interior Lighting Compliance Statement

Compliance Statement: The proposed interior lighting design represented this upcultant is consistent with the building plans, specifications, and other calculations submitted with this permit application. The proposed interior lighting systems have been designed to meet the 90.1 (2013) Standard requirements in COMche Weysion 4.1.5.5 and a comply with any applicable mandatory requirements listed in the Inspection Checklist. WALTER E.

Name - Title

Date

02-23-2024

MISSOURI PUBLIC SERVICE COMMISSION

WOOD

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04/05/2024 **MANUFACTURED** HOUSING

Project Title: Slider Drive-Thru Report date: 02/22/24

Data filename: P:\Valiant Modular\Sliders\Missouri Sliders\Sliders Arkansas.cck

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COM*check* Software Version 4.1.5.5



Exterior Lighting Compliance Certificate

Project Information

Energy Code: 90.1 (2013) Standard
Project Title: Slider Drive-Thru
Project Type: New Construction

Exterior Lighting Zone 2 (Neighborhood business district (LZ2))

Construction Site: St Louis, MO

Owner/Agent

Designer/Contractor: Valiant Equipment, LLC 15 West Tower Circle Ormond Beach, FL 32174 386-677-9316

Allowed Exterior Lighting Power

A Area/Surface Category	B Quantity	C Allowed Watts /Unit	D Tradable Wattage	E Allowed Watts (B X C)
Main entry	2 ft of door	20	Yes	40
Drive-up windows /doors	2 windows	400	No	800
		Total Tradable Watts (a) =		40
	Total Allowed Watts = Total Allowed Supplemental Watts (b) =		840	
			600	

- (a) Wattage tradeoffs are only allowed between tradable areas/surfaces.
- (b) A supplemental allowance equal to 600 watts may be applied toward compliance of both non-tradable and tradable areas./surfaces.

Proposed Exterior Lighting Power

A Fixture ID: Description / Lamp / Wattage Per Lamp / Ballast	B Lamps/ Fixture	C # of Fixtures	D Fixture Watt.	(C X D)
Main entry (2 ft of door width): Tradable Wattage LED 1: LED Linear 22W:	1	2	22	44
Drive-up windows /doors (2 windows or doors): Non-tradable Wattage LED 3: LED Other Fixture Unit 80W:	1	2	75	150
	Total Trac	dable Propos	ed Watts =	44

Exterior Lighting PASSES: Design 93% better than code

Exterior Lighting Compliance Statement

Compliance Statement: The proposed exterior lighting design representes in this polyment is consistent with the building plans, specifications, and other calculations submitted with this permit application. The proposed exterior lighting systems have been designed to meet the 90.1 (2013) Standard requirements in COMcheel Version 4.1.5.5 and to comply with any applicable mandatory requirements listed in the Inspection Checklist.

WOOD

Name - Title



Signature

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COMcheck Software Version 4.1.5.5 Mechanical Compliance Certificate

Project Information

Energy Code: 90.1 (2013) Standard Project Title: Slider Drive-Thru Location: Saint Louis, Missouri

Climate Zone:

Project Type: **New Construction**

Construction Site: St Louis, MO

Owner/Agent

Designer/Contractor: Valiant Equipment, LLC 15 West Tower Circle Ormond Beach, FL 32174 386-677-9316

Mechanical Systems List

Quantity System Type & Description

HVAC System 1 (Single Zone):

Heating: 1 each - Central Furnace, Electric, Capacity = 52 kBtu/h

No minimum efficiency requirement applies

Cooling: 1 each - Single Package DX Unit, Capacity = 78 kBtu/h, Air-Cooled Condenser, Air Economizer

Proposed Efficiency = 11.20 EER, Required Efficiency: 11.20 EER + 12.9 IEER

Fan System: None

Water Heater 3:

Name - Title

Electric Instantaneous Water Heater, Capacity: 2 gallons No minimum efficiency requirement applies

Mechanical Compliance Statement

Compliance Statement: The proposed mechanical design represented in this document is consistent with the building plans, specifications, and other calculations submitted with this permit application. The proposed mechanical systems have been designed to meet the 90.1 (2013) Standard requirements in COMcheck Version 4.1.5.5 and to comply with any applicable

WALTER E. WOOD

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mandatory requirements listed in the Inspection Checklist.

Signature

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Date

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COM*check* Software Version 4.1.5.5 **Inspection Checklist** Energy Code: 90.1 (2013) Standard

Requirements: 100.0% were addressed directly in the COMcheck software

Text in the "Comments/Assumptions" column is provided by the user in the COMcheck Requirements screen. For each requirement, the user certifies that a code requirement will be met and how that is documented, or that an exception is being claimed. Where compliance is itemized in a separate table, a reference to that table is provided.

Section # & Req.ID	Plan Review	Complies?	Comments/Assumptions
4.2.2, 5.4.3.1.1, 5.7 [PR1] ¹	Plans and/or specifications provide all information with which compliance can be determined for the building envelope and document where exceptions to the standard are claimed.	□Complies □Does Not □Not Observable □Not Applicable	Requirement will be met.
4.2.2, 6.4.4.2.1, 6.7.2 [PR2] ¹	Plans, specifications, and/or calculations provide all information with which compliance can be determined for the mechanical systems and equipment and document where exceptions to the standard are claimed. Load calculations per acceptable engineering standards and handbooks.	□Complies □Does Not □Not Observable □Not Applicable	Requirement will be met.
4.2.2, 7.7.1, 10.4.2 [PR3] ¹	Plans, specifications, and/or calculations provide all information with which compliance can be determined for the service water heating systems and equipment and document where exceptions to the standard are claimed. Hot water system sized per manufacturer's sizing guide.	□Complies □Does Not □Not Observable □Not Applicable	Requirement will be met.
4.2.2, 8.4.1.1, 8.4.1.2, 8.7 [PR6] ²	Plans, specifications, and/or calculations provide all information with which compliance can be determined for the electrical systems and equipment and document where exceptions are claimed. Feeder connectors sized in accordance with approved plans and branch circuits sized for maximum drop of 3%.	□Complies □Does Not □Not Observable □Not Applicable	Requirement will be met.
4.2.2, 9.4.3, 9.7 [PR4] ¹	Plans, specifications, and/or calculations provide all information with which compliance can be determined for the interior lighting and electrical systems and equipment and document where exceptions to the standard are claimed. Information provided should include interior lighting power calculations, wattage of bulbs and ballasts, transformers and control devices.	□Complies □Does Not □Not Observable □Not Applicable	Requirement will be met. MISSOURI PUBLIC SERVICE COMMISSION APPROVED 04/05/2024 MANUFACTURED HOUSING

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Section # & Req.ID	Plan Review	Complies?	Comments/Assumptions
9.7 [PR8] ¹	Plans, specifications, and/or calculations provide all information with which compliance can be determined for the exterior lighting and electrical systems and equipment and document where exceptions to the standard are claimed. Information provided should include exterior lighting power calculations, wattage of bulbs and ballasts, transformers and control devices.	□Complies □Does Not □Not Observable □Not Applicable	Requirement will be met.
6.7.2.4 [PR5] ¹	Detailed instructions for HVAC systems commissioning included on the plans or specifications for projects >=50,000 ft2.	☐Complies ☐Does Not ☐Not Observable ☐Not Applicable	Exception: Requirement does not apply.

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Section # & Req.ID	Footing / Foundation Inspection	Plans Verified Value	Field Verified Value	Complies?	Comments/Assumptions
4.2.4 [FO1] ²	Installed below-grade wall insulation type and R-value consistent with insulation specifications reported in plans and COMcheck reports.	R	R	□Complies □Does Not □Not Observable □Not Applicable	See the Envelope Assemblies table for values.
4.2.4 [FO3] ²	Installed slab-on-grade insulation type and R-value consistent with insulation specifications reported in plans and COMcheck reports.	R Unheated Heated	R Unheated Heated	□Complies □Does Not □Not Observable □Not Applicable	See the Envelope Assemblies table for values.
5.5.3.5 [FO5] ²	Slab edge insulation depth/length.	ft	ft	□Complies □Does Not □Not Observable □Not Applicable	See the Envelope Assemblies table for values.
5.8.1.7 [FO6] ¹	Exterior insulation protected against damage, sunlight, moisture, wind, landscaping and equipment maintenance activities.			□Complies □Does Not □Not Observable □Not Applicable	Requirement will be met.
5.8.1.7.3 [FO7] ¹	Insulation in contact with the ground has <=0.3% water absorption rate per ASTM C272.			□Complies □Does Not □Not Observable □Not Applicable	Requirement will be met.
6.4.3.7 [FO9] ³	Freeze protection and snow/ice melting system sensors for future connection to controls.			□Complies □Does Not □Not Observable □Not Applicable	Exception: Requirement does not apply.
6.4.4.1.5 [FO11] ³	Bottom surface of floor structures incorporating radiant heating insulated to >=R-3.5.	R	R	□Complies □Does Not □Not Observable □Not Applicable	Exception: Requirement does not apply. See the Envelope Assemblies table for values.

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Section # & Req.ID	Framing / Rough-In Inspection	Plans Verified Value	Field Verified Value	Complies?	Comments/Assumptions
5.4.3.2 [FR1] ³	Factory-built and site-assembled fenestration and doors are labeled or certified as meeting air			☐Complies ☐Does Not ☐Not Observable	Requirement will be met.
	leakage requirements.			□Not Observable □Not Applicable	
5.5.4.3a [FR8] ¹	Vertical fenestration U-Factor.	U	U	\square Complies \square Does Not	See the Envelope Assemblies table for values.
			 	□Not Observable □Not Applicable	
5.5.4.3b [FR9] ¹	Skylight fenestration U-Factor.	U	U	\square Complies \square Does Not	See the Envelope Assemblies table for values.
			 	□Not Observable □Not Applicable	
5.5.4.4.1 [FR10] ¹	Vertical fenestration SHGC value.	SHGC:	SHGC:	□Complies □Does Not	See the Envelope Assemblies table for values.
			 	□Not Observable □Not Applicable	
5.5.4.4.2 [FR11] ¹	Skylight SHGC value.	SHGC:	SHGC:	\square Complies \square Does Not	See the Envelope Assemblies table for values.
			 	□Not Observable □Not Applicable	
5.8.2.1, 5.8.2.3,	Fenestration products rated (U- factor, SHGC, and VT) in			□Complies □Does Not	Requirement will be met.
5.8.2.4, 5.8.2.5 [FR12] ²	accordance with NFRC or energy code defaults are used.			□Not Observable □Not Applicable	
5.8.2.2 [FR13] ¹	Fenestration and door products are labeled, or a signed and			□Complies □Does Not	Requirement will be met.
	dated certificate listing the U- factor, SHGC, VT, and air leakage rate has been provided by the manufacturer.			□Not Observable □Not Applicable	
5.5.3.6 [FR14] ²	U-factor of opaque doors associated with the building	U Swinging	U Swinging	□Complies □Does Not	See the Envelope Assemblies table for values.
	thermal envelope meets requirements.	☐ Nonswinging	Nonswinging	□Not Observable □Not Applicable	
5.4.3.1 [FR15] ¹	Continuous air barrier is wrapped, sealed, caulked, gasketed, and/or taped in an			☐Complies ☐Does Not	Requirement will be met.
	approved manner, except in semiheated spaces in climate zones 1-6.			□Not Observable □Not Applicable	

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Section # & Req.ID	Mechanical Rough-In Inspection	Plans Verified Value	Field Verified Value	Complies?	Comments/Assumptions
6.4.1.4, 6.4.1.5 [ME1] ²	HVAC equipment efficiency verified. Non-NAECA HVAC equipment labeled as meeting 90.1.	Efficiency:	Efficiency:	□Complies □Does Not □Not Observable □Not Applicable	See the Mechanical Systems list for values.
6.4.3.4.1 [ME3] ³	Stair and elevator shaft vents have motorized dampers that automatically close.			Complies Does Not Not Observable Not Applicable	Exception: Requirement does not apply.
6.4.3.4.2, 6.4.3.4.3 [ME4] ³	Outdoor air and exhaust systems have motorized dampers that automatically shut when not in use and meet maximum leakage rates. Check gravity dampers where allowed.			□Complies □Does Not □Not Observable □Not Applicable	Requirement will be met.
6.4.3.4.5 [ME39] ³	Enclosed parking garage ventilation has automatic contaminant detection and capacity to stage or modulate fans to 50% or less of design capacity.			□Complies □Does Not □Not Observable □Not Applicable	Exception: Requirement does not apply.
6.4.3.4.4 [ME5] ³	Ventilation fans >0.75 hp have automatic controls to shut off fan when not required.			□Complies □Does Not □Not Observable □Not Applicable	Requirement will be met.
6.4.3.8 [ME6] ¹	Demand control ventilation provided for spaces >500 ft2 and >25 people/1000 ft2 occupant density and served by systems with air side economizer, auto modulating outside air damper control, or design airflow >3,000 cfm.			□Complies □Does Not □Not Observable □Not Applicable	Requirement will be met.
6.5.3.2.1 [ME40] ²	DX cooling systems >= 75 kBtu/h (>= 65 kBtu/h effective 1/2016) and chilled-water and evaporative cooling fan motor hp >= ½ designed to vary indoor fan airflow as a function of load and comply with operational requirements.			□Complies □Does Not □Not Observable □Not Applicable	Requirement will be met. See the Mechanical Systems list for values.
6.4.4.1.1 [ME7] ³	Insulation exposed to weather protected from damage. Insulation outside of the conditioned space and associated with cooling systems is vapor retardant.			□Complies □Does Not □Not Observable □Not Applicable	Requirement will be met.
6.4.4.1.2 [ME8] ²	HVAC ducts and plenums insulated. Where ducts or plenums are installed in or under a slab, verification may need to occur during Foundation Inspection.	R	R	□Complies □Does Not □Not Observable □Not Applicable	Requirement will be met.
6.4.4.1.3 [ME9] ²	HVAC piping insulation thickness. Where piping is installed in or under a slab, verification may need to occur during Foundation Inspection.	In. PUBLIC COMM	OVED	□Complies □Does Not □Not Observable □Not Applicable	Exception: Requirement does not apply.

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Section # & Req.ID	Mechanical Rough-In Inspection	Plans Verified Value	Field Verified Value	Complies?	Comments/Assumptions
6.4.4.1.4 [ME41] ³	Thermally ineffective panel surfaces of sensible heating panels have insulation >= R-3.5.			□Complies □Does Not	Exception: Requirement does not apply.
				□Not Observable □Not Applicable	
6.4.4.2.1 [ME10] ²	Ducts and plenums sealed based on static pressure and location.			□Complies □Does Not □Not Observable	Requirement will be met.
				□Not Applicable	1
6.4.4.2.2 [ME11] ³	Ductwork operating >3 in. water column requires air leakage			□Complies □Does Not	Exception: Requirement does not apply.
	testing.			□Not Observable □Not Applicable	
6.5.2.3 [ME19] ³	Dehumidification controls provided to prevent reheating, recooling, mixing of hot and cold			□Complies □Does Not	Requirement will be met.
	airstreams or concurrent heating and cooling of the same airstream.			□Not Observable □Not Applicable	
6.5.2.4.1 [ME68] ³	Humidifiers with airstream mounted preheating jackets have			☐Complies ☐Does Not	Exception: Requirement does not apply.
	preheat auto-shutoff value set to activate when humidification is not required.			□Not Observable □Not Applicable	
6.5.2.4.2 [ME69] ³	Humidification system dispersion tube hot surfaces in the airstreams of ducts or air-			☐Complies ☐Does Not	Exception: Requirement does not apply.
	handling units insulated >= R- 0.5.			□Not Observable □Not Applicable	
6.5.2.5 [ME70] ³	Preheat coils controlled to stop heat output whenever mechanical cooling, including			□Complies □Does Not	Requirement will be met.
	economizer operation, is active.			□Not Observable □Not Applicable	1 1 1 1
6.5.3.3 [ME42] ³	Multiple zone VAV systems with DDC of individual zone boxes			□Complies □Does Not	Exception: Requirement does not apply.
	have static pressure setpoint reset controls.			□Not Observable □Not Applicable	See the Mechanical Systems list for values.
6.5.4.2 [ME25] ³	HVAC pumping systems >10 hp designed for variable fluid flow.			□Complies □Does Not	Requirement will be met.
				□Not Observable □Not Applicable	
6.5.6.1 [ME56] ¹	Exhaust air energy recovery on systems meeting Tables 6.5.6.1-1, and 6.5.6.1-2.			□Complies □Does Not	Requirement will be met.
	1, and 0.5.0.1-2.			□Not Observable □Not Applicable	
6.5.7.1.1 [ME32] ²	Kitchen hoods >5,000 cfm have make up air >=50% of exhaust air volume.			□Complies □Does Not	Requirement will be met.
	an volume.	MISS	OURI	□Not Observable □Not Applicable	
6.5.7.1.5 [ME49] ³	Approved field test used to evaluate design air flow rates	PUBLIC	SERVICE ISSION	□Complies	Requirement will be met.
[[45]	and demonstrate proper capture and containment of kitchen		OVED	□ Does Not □ Not Observable	1 1 1 1 1 1
	exhaust systems.		/2024 CTURED	□Not Applicable	

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Section # & Req.ID	Mechanical Rough-In Inspection	Plans Verified Value	Field Verified Value	Complies?	Comments/Assumptions
6.5.8.1 [ME34] ²	Unenclosed spaces that are heated use only radiant heat.			□Complies □Does Not □Not Observable □Not Applicable	Exception: Requirement does not apply.
6.5.9 [ME35] ¹	Hot gas bypass limited to: <=240 kBtu/h - 15% >240 kBtu/h - 10%			□Complies □Does Not □Not Observable □Not Applicable	Requirement will be met.
7.4.2 [ME36] ²	Service water heating equipment meets efficiency requirements.			☐Complies ☐Does Not ☐Not Observable ☐Not Applicable	
6.4.3.9 [ME63] ²	Heating for vestibules and air curtains include automatic controls that shut off the heating system when outdoor air temperatures > 45F. Vestibule heating systems controlled by a thermostat in the vestibule with setpoint <= 60F.			□Complies □Does Not □Not Observable □Not Applicable	Exception: Requirement does not apply.
6.5.10 [ME73] ³	Doors separating conditioned space from the outdoors have controls that disable/reset heating and cooling system when open.			□Complies □Does Not □Not Observable □Not Applicable	Exception: Building entrances have automatic closing devices.

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Section # & Req.ID	Rough-In Electrical Inspection	Complies?	Comments/Assumptions
8.4.2 [EL10] ²	20-Amp receptacles are controlled by an automatic control device.	□Complies □Does Not	Exception: Space type is not private office, open office, or computer classroom.
		□Not Observable □Not Applicable	
9.4.1.1 [EL1] ²	Automatic control requirements prescribed in Table 9.6.1, for the appropriate space type, are installed. Mandatory lighting controls (labeled as 'REQ') and optional choice controls (labeled as 'ADD1' and 'ADD2') are implemented.	□Complies □Does Not □Not Observable □Not Applicable	Requirement will be met.
9.4.1.1 [EL2] ²	Independent lighting controls installed per approved lighting plans and all manual controls readily accessible and visible to occupants.	□Complies □Does Not □Not Observable □Not Applicable	Requirement will be met.
9.4.1.2 [EL11] ²	Parking garage lighting is equipped with required lighting controls and daylight transition zone lighting.	☐Complies ☐Does Not ☐Not Observable ☐Not Applicable	Exception: Requirement does not apply.
9.4.1.1f [EL13] ¹	Daylight areas under skylights and roof monitors that have more than 150 W combined input power for general lighting are controlled by photocontrols.	□Complies □Does Not □Not Observable □Not Applicable	Exception: Requirement does not apply.
9.4.1.4 [EL3] ²	Automatic lighting controls for exterior lighting installed.	☐Complies ☐Does Not ☐Not Observable ☐Not Applicable	Exception: Covered vehicle entrance/exit areas requiring lighting for safety, security and eye adaptation.
9.4.1.3 [EL4] ¹	Separate lighting control devices for specific uses installed per approved lighting plans.	□Complies □Does Not □Not Observable □Not Applicable	Requirement will be met.
9.6.2 [EL8] ¹	Additional interior lighting power allowed for special functions per the approved lighting plans and is automatically controlled and separated from general lighting.	□Complies □Does Not □Not Observable □Not Applicable	Requirement will be met.
10.4.1 [EL9] ²	Electric motors meet requirements where applicable.	□Complies □Does Not □Not Observable □Not Applicable	Requirement will be met.

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Section # & Req.ID	Insulation Inspection	Plans Verified Value	Field Verified Value	Complies?	Comments/Assumptions
4.2.4 [IN2] ¹	Installed roof insulation type and R-value consistent with insulation specifications reported in plans and COMcheck reports. For some ceiling systems, verification may need to occur during Framing Inspection.	R Above deck Metal Attic	R Above deck Metal Attic	□Complies □Does Not □Not Observable □Not Applicable	See the Envelope Assemblies table for values.
5.8.1.2, 5.8.1.3 [IN3] ¹	Roof insulation installed per manufacturer's instructions. Blown or poured loose-fill insulation is installed only where the ceiling slope is <= 3:12.			□Complies □Does Not □Not Observable □Not Applicable	Requirement will be met.
4.2.4 [IN6] ¹	Installed above-grade wall insulation type and R-value consistent with insulation specifications reported in plans and COMcheck reports.	R Mass Metal Steel Wood	R Mass Metal Steel Wood	□Complies □Does Not □Not Observable □Not Applicable	See the Envelope Assemblies table for values.
5.8.1.2 [IN7] ¹	Above-grade wall insulation installed per manufacturer's instructions.			☐Complies ☐Does Not ☐Not Observable ☐Not Applicable	Requirement will be met.
1.2.4 IN8] ²	Installed floor insulation type and R-value consistent with insulation specifications reported in plans and COMcheck reports.	R Mass Steel Wood	R Mass Steel Wood	□Complies □Does Not □Not Observable □Not Applicable	See the Envelope Assemblies table for values.
5.8.1.2 [IN9] ²	Floor insulation installed per manufacturer's instructions.			☐Complies ☐Does Not ☐Not Observable ☐Not Applicable	Requirement will be met.
5.8.1.1 IN10] ²	Building envelope insulation is labeled with R-value or insulation certificate has been provided listing R-value and other relevant data.			□Complies □Does Not □Not Observable □Not Applicable	Requirement will be met.
5.8.1.9 [N18] ²	Building envelope insulation extends over the full area of the component at the proposed rated R or U value.			□Complies □Does Not □Not Observable □Not Applicable	Requirement will be met.
5.8.1.4 [N11] ²	Eaves are baffled to deflect air to above the insulation.			☐Complies ☐Does Not ☐Not Observable ☐Not Applicable	Requirement will be met.
5.8.1.5 IN12] ²	Insulation is installed in substantial contact with the inside surface separating conditioned space from unconditional space.	PUBLIC	SOURI SERVICE	☐Complies ☐Does Not ☐Not Observable ☐Not Applicable	Requirement will be met.
5.8.1.6 [IN13] ²	Recessed equipment installed in building envelope assemblies does not compress the adjacent insulation.	APPR 04/05 MANUF	COVED 5/2024 ACTURED	□Complies □Does Not □Not Observable □Not Applicable	Requirement will be met.

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Section # & Req.ID	Insulation Inspection	Plans Verified Value	Field Verified Value	Complies?	Comments/Assumptions
5.8.1.7.1 [IN15] ²	Attics and mechanical rooms have insulation protected where adjacent to attic or equipment			□Complies □Does Not	Requirement will be met.
	adjacent to attic or equipment access.			□Not Observable □Not Applicable	
5.8.1.7.2 [IN16] ²	Foundation vents do not interfere with insulation.			□Complies □Does Not	Requirement will be met.
				□Not Observable □Not Applicable	1 1 1 1 1
5.8.1.8 [IN17] ³	Insulation intended to meet the roof insulation requirements			□Complies □Does Not	Requirement will be met.
	cannot be installed on top of a suspended ceiling. Mark this requirement compliant if insulation is installed accordingly.			□Not Observable □Not Applicable	

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Section # & Req.ID	Final Inspection	Complies?	Comments/Assumptions
5.4.3.3 [FI1] ¹		□Complies □Does Not	Exception: Requirement does not apply.
	8.	□Not Observable □Not Applicable	
5.4.3.1.2 FI3] ³	Thermostatic controls have a 5 °F deadband.	□Complies □Does Not	Requirement will be met.
		□Not Observable □Not Applicable	
5.4.3.2 FI20] ³	Temperature controls have setpoint overlap restrictions.	□Complies □Does Not	Requirement will be met.
		□Not Observable □Not Applicable	
5.4.3.3.1 FI21] ³	HVAC systems equipped with at least one automatic shutdown control.	□Complies □Does Not	Requirement will be met.
		□Not Observable □Not Applicable	
5.4.3.3.2 FI22] ³	Setback controls allow automatic restart and temporary operation as	□Complies □Does Not	Requirement will be met.
	required for maintenance.	□Not Observable □Not Applicable	
6.4.3.6 [FI6] ³	When humidification and dehumidification are provided to a	□Complies □Does Not	Requirement will be met.
pronibilea. Humially control pronibils :=		□Not Observable □Not Applicable	
5.7.2.1 FI7] ³	Furnished HVAC as-built drawings submitted within 90 days of system	□Complies □Does Not	Requirement will be met.
acceptance.	acceptance.	□Not Observable □Not Applicable	
5.7.2.2 FI8] ³	Furnished O&M manuals for HVAC systems within 90 days of system acceptance.	□Complies □Does Not	Requirement will be met.
		□Not Observable □Not Applicable	
5.7.2.3 FI9] ¹	An air and/or hydronic system balancing report is provided for HVAC	□Complies □Does Not	Exception: Requirement does not apply.
	systems serving zones >5,000 ft2 of conditioned area.	□Not Observable □Not Applicable	
5.7.2.4 FI10] ¹	HVAC control systems have been tested to ensure proper operation, calibration and adjustment of controls.	□Complies □Does Not	Requirement will be met.
		□Not Observable □Not Applicable	
7.4.4.3 FI11] ³	Public lavatory faucet water temperature <=110°F.	□Complies □Does Not	Requirement will be met.
		□Not Observable □Not Applicable	MISSOURI
3.7.1 FI16] ³		□Complies □Does Not	Requirement will be met. PUBLIC SERVICE COMMISSION
	of system acceptance.	□Not Observable □Not Applicable	APPROVED 04/05/2024
			MANUFACTURED

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2 Medium Impact (Tier 2)

3 Low Impact (Tier 3)

1 High Impact (Tier 1)

Section # & Req.ID	Final Inspection	Complies?	Comments/Assumptions
8.7.2 [FI17] ³	Furnished O&M instructions for systems and equipment to the building owner or designated representative.	\square Complies \square Does Not	Requirement will be met.
		□Not Observable □Not Applicable	
9.2.2.3 [FI18] ¹	[FI18] ¹ lighting power is consistent with what		See the Interior Lighting fixture schedule for values.
is shown on the approved lighting plans, demonstrating proposed watts are less than or equal to allowed watts.		□Not Observable □Not Applicable	
9.4.2 [FI19] ¹	Exterior lighting power is consistent with what is shown on the approved lighting plans, demonstrating proposed watts are less than or equal to allowed watts.	\square Complies \square Does Not	See the Exterior Lighting fixture schedule for values.
		□Not Observable □Not Applicable	
10.4.3 [FI24] ²	Elevators are designed with the proper lighting, ventilation power, and	□Complies □Does Not	Exception: Requirement does not apply.
	standby mode.	□Not Observable □Not Applicable	
7.4.3 [FI45] ²	First 8 ft of outlet piping is insulated	\square Complies \square Does Not	Requirement will be met.
		□Not Observable □Not Applicable	

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1 High Impact (Tier 1) 2 Medium Impact (Tier 2) 3 Low Impact (Tier 3)

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MISSOURI PUBLIC SERVICE COMMISSION

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