

Nabholz Construction - Lenexa 17300 W 116th Street Lenexa, Kansas 66219 P: (913) 393-6500

Project: 08-25-3320 HCA LSMC DIETARY EXPANSION

2100 SE BLUE PARKWAY LEE'S SUMMIT, Missouri 64063

Printed On: Sep 10, 2025 01:42 PM CDT

RFI #034: DietEx - Life Safety Dampers

Revision 0 Status Closed on 09/10/25

To Luke Arbanas (Nabholz Construction Corporation) From Luke Arbanas (Nabholz Construction Corporation)

(Response Required)

Date Initiated Sep 4, 2025 Due Date Sep 11, 2025

 Location
 Interior Building>Dietary
 Project Stage
 Pre-Construction

Cost Impact TBD Schedule Impact TBD

Spec Section

Drawing Number M02-01 Reference

Linked Drawings

Copies To Mark McGrath (P1 CONSTRUCTION LLC), Justin

Sorem (P1 CONSTRUCTION LLC)

Priority

Constraint

Activity

Question

Question from Luke Arbanas Nabholz Construction Corporation on Thursday, Sep 4, 2025 at 02:08 PM CDT

During the BIM coordination meeting on 09.03.25, the question was asked to the EOR if the areas noted in the cloud on the attached drawing required life safety dampers. - P1

Please advise if life safety dampers are needed where ducts pass through fire rated walls in Dietary Expansion. - Nab-LA

Attachments

#002 - Life Safety Dampers-2025.09.04.pdf

Official Response

Response from Luke Arbanas Nabholz Construction Corporation on Wednesday, Sep 10, 2025 at 01:41 PM CDT

Life safety dampers are not required where ducts pass through 1-hour fire-rated walls in the Dietary Expansion area. Fire dampers are only required at penetrations of walls or assemblies with a fire-resistance rating greater than 1 hour or where otherwise

indicated on the contract documents. Sheet AC 101 shows that the walls in question are 1 hour rated fire barriers. William Davis, Assistant Consultant - Mechanical Engineering WSP USA

September 9, 2025

Attachments

RFI-034 - hca_lsmc_dietary_expansion-dietex-life_safety_dampers-WSP Response.pdf

Project: 08-25-3320 HCA LSMC DIETARY EXPANSION

All Replies

Response from Luke Arbanas Nabholz Construction Corporation on Wednesday, Sep 10, 2025 at 01:41 PM CDT

Life safety dampers are not required where ducts pass through 1-hour fire-rated walls in the Dietary Expansion area. Fire dampers are only required at penetrations of walls or assemblies with a fire-resistance rating greater than 1 hour or where otherwise

indicated on the contract documents. Sheet AC 101 shows that the walls in question are 1 hour rated fire barriers. William Davis, Assistant Consultant - Mechanical Engineering WSP USA

September 9, 2025

Attachments

RFI-034 - hca_lsmc_dietary_expansion-dietex-life_safety_dampers-WSP Response.pdf



Nabholz Construction - Lenexa 17300 W 116th Street Lenexa, Kansas 66219 P: (913) 393-6500

Project: 08-25-3320 HCA LSMC DIETARY EXPANSION 2100 SE BLUE PARKWAY

LEE'S SUMMIT, Missouri 64063

Printed On: Sep 4, 2025 02:15 PM CDT

RFI #034: DietEx - Life Safety Dampers

Revision 0 Status Open

To Luke Arbanas (Nabholz Construction Corporation) From Luke Arbanas (Nabholz Construction Corporation)

(Response Required)

Date Initiated Sep 4, 2025 Due Date Sep 11, 2025

Location Interior Building>Dietary Project Stage Pre-Construction

Cost Impact TBD Schedule Impact TBD

Spec Section

Drawing Number M02-01 Reference

Linked Drawings

Copies To Mark McGrath (P1 CONSTRUCTION LLC), Justin

Sorem (P1 CONSTRUCTION LLC)

Priority

Constraint

Activity

Question

Question from Luke Arbanas Nabholz Construction Corporation on Thursday, Sep 4, 2025 at 02:08 PM CDT

During the BIM coordination meeting on 09.03.25, the question was asked to the EOR if the areas noted in the cloud on the attached drawing required life safety dampers. - P1

Please advise if life safety dampers are needed where ducts pass through fire rated walls in Dietary Expansion. - Nab-LA

Attachments

#002 - Life Safety Dampers-2025.09.04.pdf

Awaiting an Official Response

Life safety dampers are not required where ducts pass through 1-hour fire-rated walls in the Dietary Expansion area. Fire dampers are only required at penetrations of walls or assemblies with a fire-resistance rating greater than 1 hour or where otherwise indicated on the contract documents.

Sheet AC 101 shows that the walls in question are 1 hour rated fire barriers.

William Davis, Assistant Consultant - Mechanical Engineering WSP USA

September 9, 2025

RFI detail

#002 Life Safety Dampers



Status	Open In Review
Created on	Sep 4, 2025 by Sam Stewart (P1 Construction LLC)
RFI type	Default RFI workflow
Ball in court	Sam Stewart (P1 Construction LLC)
Due date	Sep 18, 2025

Question

During the BIM coordination meeting on 09.03.25, the question was asked to the EOR if the areas noted in the cloud on the attached drawing required life safety dampers.

Suggested answer

Please advise.

References and Attachments

Files (1)

• MO2-01(Dietary-MedSurg 100 CD Drawings)_Contract Drawings_2025-09-04_11-28-51am.pdf

Impact


Cost impact	Yes
Schedule impact	Yes


Other attributes

Priority	High
Discipline	Mechanical
Category	Design Coordination

Location	-
Location details	-
External ID	-
Co-reviewer(s)	-
Associated Drawing(s)	M02-01
Associated Spec Section(s)	233300 – Air Duct Accessories

Activities	Ву	At
Sam Stewart added a reference to a File MO2-01(Dietary-MedSurg 100 CD Drawings)_Contract Drawings_2025-09-04_11-28-51am.pdf	Sam Stewart	Sep 4, 2025, 6:22 PM UTC
Sam Stewart (P1 Construction LLC) created this RFI in Open In Review status and set Ball in court to Sam Stewart (P1 Construction LLC).	Sam Stewart	Sep 4, 2025, 6:22 PM UTC

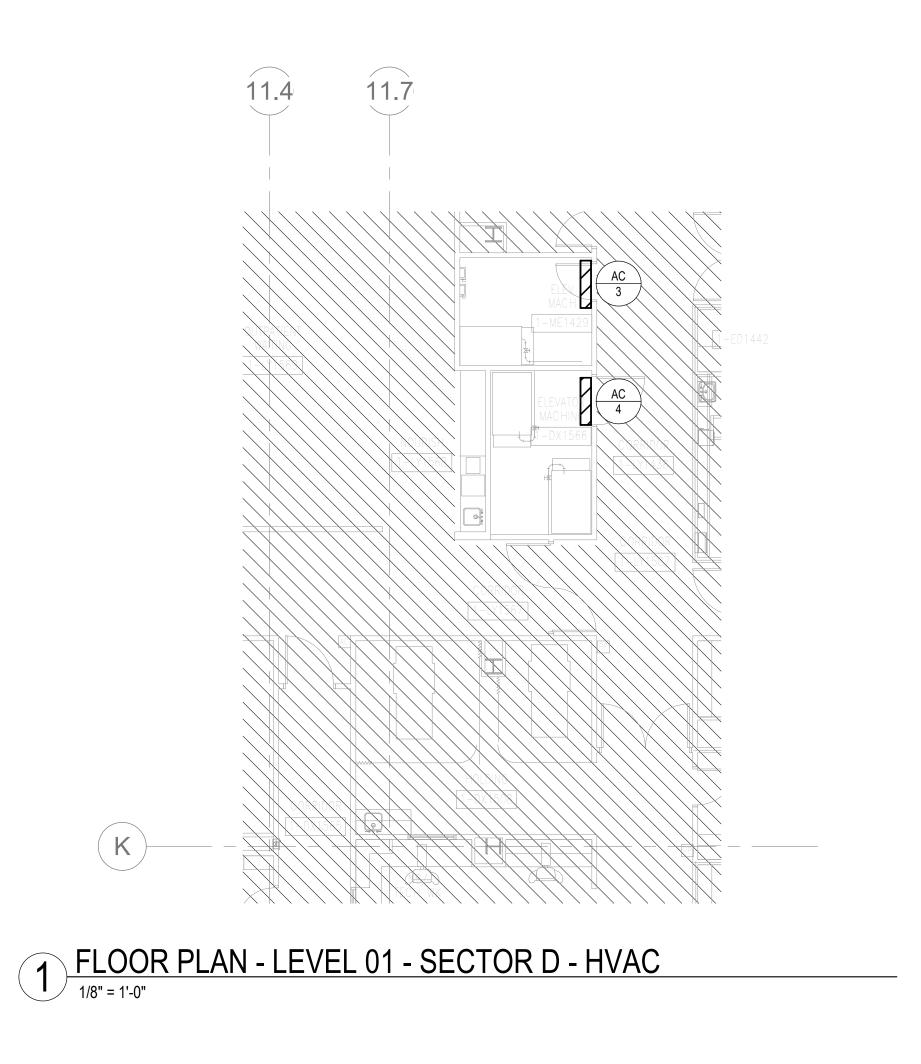

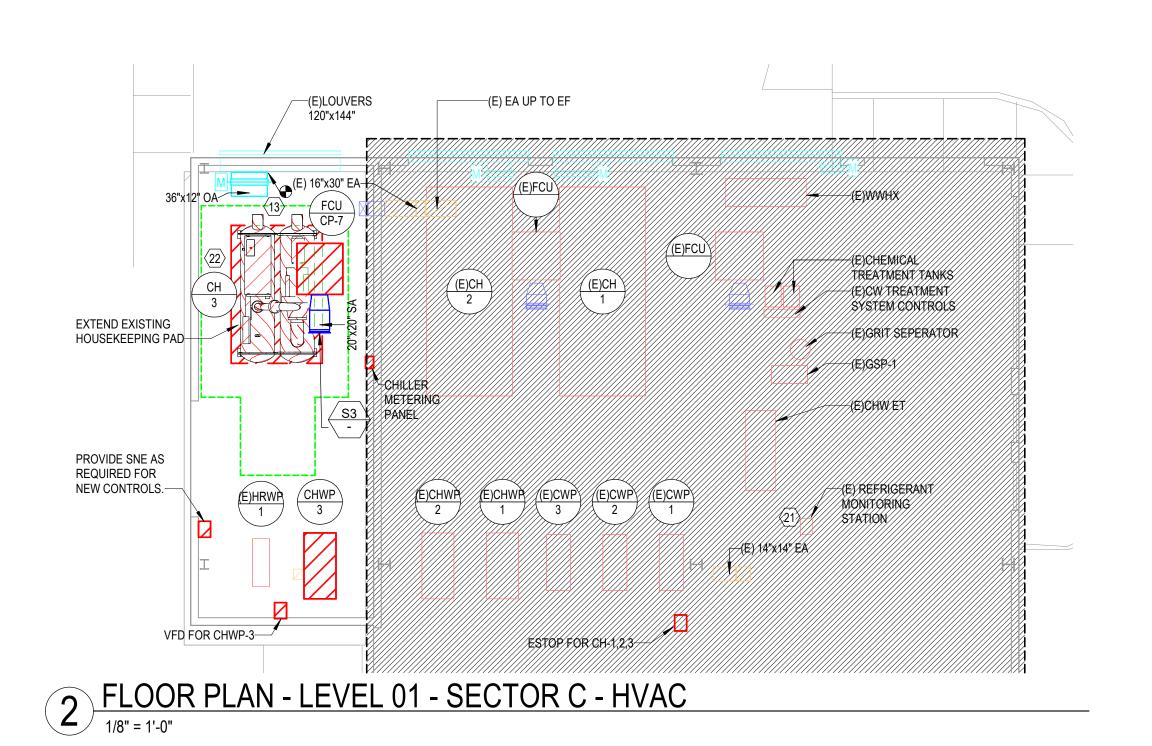



Reference yellow ovals for areas in question. - Nab-LA-09.04.2025

GENERAL NOTES

- A. REFER TO M00-00 FOR GENERAL MECHANICAL NOTES AND SYMBOLS
- B. CONTRACTOR TO VERIFY EXISTING CONDITIONS. EXISTING WORK SHOWN IS APPROXIMATE AND REPRESENTATIVE OF
- EXISTING DESIGN AND AS-BUILT DRAWINGS.
- C. PROVIDE REMOTE ADJUSTABLE DAMPERS FOR ANY BALANCING DAMPERS LOCATED ABOVE HARD CEILINGS.
- D. ACCESS PANELS TO BE PROVIDED FOR ANY MECHANICAL EQUIPMENT OR MECHANICAL DEVICES REQUIRING SERVICE
- LOCATED ABOVE HARD CEILINGS.

 E. CONTRACTOR SHALL PROVIDE TEMPORARY EXHAUST FANS FOR ALL EXHAUST SYSTEMS BEING MODIFIED BY THIS PROJECT. COORDINATE TEMPORARY EXHAUST, PHASING, AND ROOM SHUTDOWN REQUIREMENTS WITH OWNER.

LEGEND NOTES

- 32"x24" SA DUCT UP TO RTU-3 ON ROOF.
 28"x22" RA DUCT UP TO RTU-3 ON ROOF.
- 24"x24" EA DUCT UP TO KEF-2. GREASE EXHAUST TO HAVE TWO HOUR RATED FIRE WRAP.
 22"x14" STAINLESS STEEL EA DUCT UP TO KEF-5.
- 5. 30"x14" EA DUCT UP TO LEF-1.
 6. 10"x8" EA DUCT UP TO GEF-31.
 7. 12"x12" STAINI ESS STEEL EA DUCT UP TO GEF-31.

CONNECTION.

- 12"x12" STAINLESS STEEL EA DUCT UP TO KEF-3.
 (E)16"x14" EXHAUST DUCT UP TO ROOF.
- 9. (E)10"x10" EXHAUST DUCT UP TO ROOF.
 10. 8" EA DUCT DOWN TO DRYER AND UP TO ROOF CAP.
 11. 52"x14" MA DUCT UP TO MAU-1.
- 12. -----NOT USED-----
 13. PROVIDE 36"X12" DUCT WITH MOTORIZED DAMPER. PROVIDE SHEET METAL TO COVER
- REMAINDER OF LOUVER OPENING. CONNECT MOTORIZED DAMPER TO REFRIGERANT MONITORING SYSTEM TO BE CONTROLLED THE SAME AS EXISTING LOUVER DAMPERS.

 14. CONNECT MAKE UP AIR TO KITCHEN HOOD. PROVIDE DUCT SIZE AND BALANCE CFM.

 15. CONNECT GREASE EXHAUST TO KITCHEN HOOD. PROVIDE DUCT SIZE AND BALANCE CF.
- CONNECT MAKE UP AIR TO KITCHEN HOOD. PROVIDE DUCT SIZE AND BALANCE CFM.
 CONNECT GREASE EXHAUST TO KITCHEN HOOD. PROVIDE DUCT SIZE AND BALANCE CFM.
 10"X20" EXISTING EA DUCT UP TO NEW KEF-4. GREASE EXHAUST TO HAVE TWO HOUR
- RATED FIRE WRAP.

 17. CONNECT STAINLESS STEEL EXHAUST TO DISHWASHER.

 18. 1000 CFM OF MAKEUP AIR TO KITCHEN HOOD. CONNECT TO EXISTING MAKEUP AIR
- 19. RELOCATED EXISTING KITCHEN HOOD FIRE SUPPRESSION SYSTEM.20. BALANCE NEW DIFFUSER/GRILLE TO CFM SHOWN.
- BALANCE NEW DIFFUSER/GRILLE TO CFM SHOWN.
 MODIFY OR RECALIBRATE REFRIGERANT MONITORING STATION AS NEEDED FOR NEW SENSOR AT CH-3.
- 22. CONNECT CH-3 TO EXISTING REFRIGERANT MONITORING ALARM SYSTEM. PROVIDE NEW HORNS AND STROBES.
 23. 24"x24" EA DUCT UP TO KEF-1. GREASE EXHAUST TO HAVE TWO HOUR RATED FIRE WRAP.
- 24. VFDS FOR KEF-1, KEF-2, KEF-4, AND KEF-5. REFER TO ELECTRICAL DRAWINGS FOR LOCATIONS AND LABELS.
- 25. PROVIDE SOUND LAGGING FOR 15' OF HORIZONTAL DUCT AND VERTICAL DUCT UP TO RTU AS SHOWN WITH DASHED LINE. REFER TO DETAIL 01/M07-02.
- 26. PROVIDE STATIC PRESSURE SENSOR FOR RTU-3.27. PROVIDE EPO BUTTON FOR RTU-3.




Devenney Group Ltd., Architects

6900 East Camelback Road

Suite 500 Scottsdale, AZ 85251 T: 602.943.8950

www.devenneygroup.com



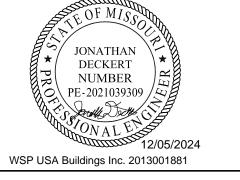

IF THESE PLANS DO NOT BEAR THE SEAL OF A REGISTRANT, THEY ARE TO BE CONSIDERED "PRELIMINARY" AND ARE NOT TO BE USED FOR CONSTRUCTION OR RECORDING. THESE PLANS ARE COPYRIGHTED AND ARE SUBJECT TO COPYRIGHT PROTECTION AS AN "ARCHITECTURAL WORK" UNDER SEC. 102 OF THE COPYRIGHT ACT, 17 U.S.O. AS AMENDED DECEMBER 1990 AND KNOWN AS ARCHITECTURAL WORKS COPYRIGHT PROTECTION ACT OF 1990. THE PROTECTION INCLUDES BUT IS NOT LIMITED TO THE OVERALL FORM AS WELL AS THE ARRANGEMENT AND COMPOSITION OF SPACES AND ELEMENTS OF THE DESIGN. UNDER SUCH PROTECTION, UNAUTHORIZED USE OF THESE PLANS CAN LEGALLY RESULT IN THE CESSATION OF CONSTRUCTION OR BUILDINGS BEING SEIZED AND/OR MONETARY COMPENSATION TO DEVENNEY GROUP LTD.

INPATIENT BED EXPANSION

HCA - LEE'S SUMMIT MEDICAL CENTER 2100 SE BLUE PKWY LEE'S SUMMIT, MO 64063

AUTHORITY HAVING JURISDICTION:
CITY OF LEE'S SUMMIT BUILDING DEPT.
MISSOURI DHSS

AUTHORITY HAVING JURISDICTION'S PROJECT NO:

FACILITY NUMBER: **0972400009**


AGENCY APPROVALS:

REVISIONS

DESCRIPTION

DATE

LEVEL 1 - KEYPLAN

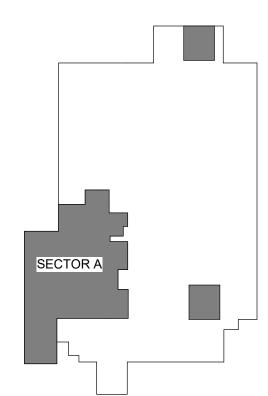

DATE: 2024/12/05
SCALE: 1/8" = 1'-0"
DRAWN: HO
REVIEWED: JD
JOB NUMBER: 6406.24

FLOOR PLAN - LEVEL 1 -SECTOR A - KITCHEN, SERVERY & DINING - HVAC

M02-01