

Greystone - Masterplan

Address: 2618 SW Farm Field Road

Lot: 35 Hook Farms, First Plat, Lee's Summit, MO.

RELEASE FOR CONSTRUCTION AS NOTED FOR PLAN REVIEW DEVELOPMENT SERVICES LEE'S SUMMIT, MISSOURI 09/03/2025

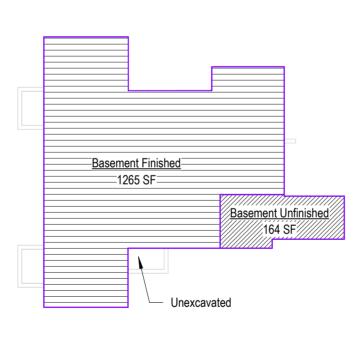

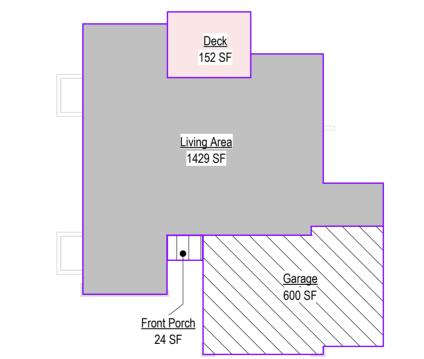

Sheet List			
Sheet No	Sheet Name		
00	Cover Sheet		
A101	Front Elevations		
A102	Front Elevations		
A103	Front Elevations		
A301	Side Elevations - Full Basement		
A302	Side Elevations - Daylight Basement		
A303	Side Elevations - Walkout Basement		
A401	Side Elevations - Full Basement		
A402	Side Elevations - Daylight Basement		
A501	Floor Plan - Main Level		
A502	Floor Plan - Main Level		
A503	Floor Plan - Main Level		
A601	Roof Plan		
A602	Roof Plan		
A701	POD Options		
A702	POD Options		
A703	POD Options		
A704	POD Options		
A705	Floor Plan - Basement		
A706	Front Elevations		
A707	Floor Plan - Basement		
A708	Side Elevations - Full Basement		
A709	Roof Plan		
A710	Floor Plan - Basement		
A711	Side Elevations - Full Basement		
A712	Roof Plan		
A714	POD Options		
A715	Front Elevations		
A716	Cover Sheet		
A801	Details		
A802	Details		
		· · · · · · · · · · · · · · · · · · ·	


A803 Details


E101 RCP/Electrical Plan

P101 RCP/Electrical Plan

E102 RCP/Electrical Plan - Structural Option

M102 Floor Plan - Structural POD Options 24" Extension HVAC

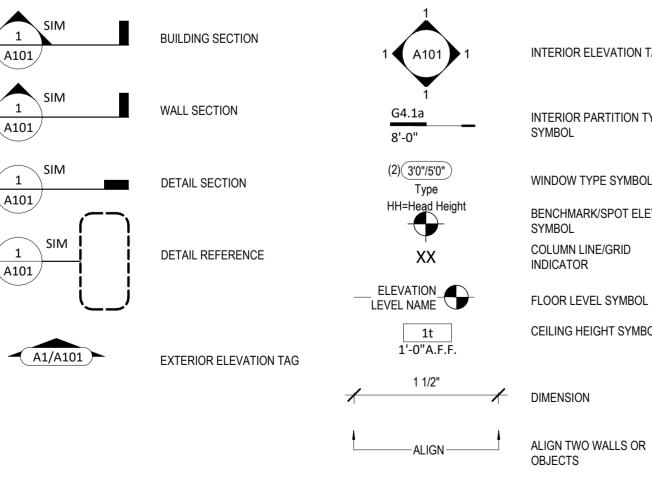

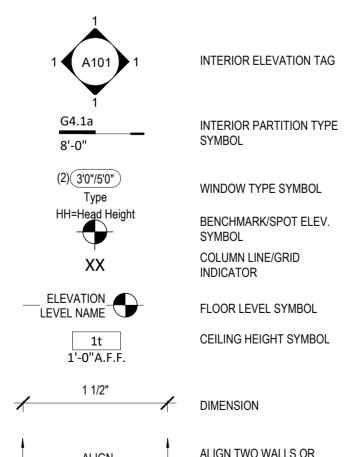

Basement Area - W/ Extended Living	Main Level Area - W/ Extended Living
1/16" = 1'-0"	1/16" = 1'-0"

General Information

Doors & Windows:	U-0.32 MAX
Glazing SHGF:	0.40
Skylights:	U-0.55 MAX
	R-49 MIN
Vaults:	R-38 MIN
Vaults < 500sf:	R-30 MIN
Wood Frame Walls:	R-20 or R-13 + 5 MIN
Basement Walls:	R-13 or R-10 Continuou
Floor (over unconditioned):	R-19 MIN
Slab on Grade:	R-10 for 24" MIN
Ductwork:	R-8 MIN
Fuel Fired Furnace:	
Electic Furnace:	No Minimum
Cooling System:	13 SEER MIN
Water Heater	
Gas Fired Storage:	0.67 EF MIN
Gas Fired Instant:	
Electic Storage:	0.97 EF MIN
Electic Instant:	0.93 EF MIN

An energy efficient certificate is required to be posted in or on the electrical panel before the final inspection. The certificate will be provided with all new residential permits. It is the permit before final inspection -- Owner/Contractor is responsibile for meeting the prescriptive requirments of IRC chapter 11 unless a HER Index Analysis for Performance Compliance based on the plans is submitted to the AHJ for

Topography Effects: Seismic Design Category: Damage From Weather: Winter Design Temperature: 6 F Ice Barrier Underlayment: Air Freezing Index: Mean Annual Temperature: 55.5 F

- is required for any dwelling with air infiltration at a rate of less than 5 air changes per hour (at ACH50 standard R303.4).
- 2. Carbon monoxide detectors required (R315) 3. Steel columns shall be minimum schedule 40
- 4. Deck Ledger attachment to house shall be per Tables 507.9.1.3.
- 5. New provisions for attachment of rafters, trusses and roof beams. (R802.3 and
- 6. Programmable thermostat required

Area - W/ Extended Living

1265 SF

1429 SF

2694 SF

164 SF

152 SF

24 SF

600 SF

152 SF

1091 SF

Basement Finished

Basement Unfinished

Front Porch

- 7. Air handlers shall be rated for Maximum 2% air leakage rate (N1103.2.2.1) 8. Building cavities used as return air plenums
- shall be sealed to prevent leakage across the thermal envelope. (N1103.2.3) 9. Certain hot water pipes shall be insulated
- (N1103.4) 10. All exhaust fans shall terminate to the building
- exterior (M1507.2) 11. Makeup air system required for kitchen
- exhaust hoods that exceed 400 CFM M1503.4 12. Building cavities in a thermal envelope wall (including the wall between the house and garage) shall not be used as return air
- plenums (unless the required insulation and air barrier are maintained) (M1601.1.1,#7.5) 13. An air handling system shall not serve both the living space and the garage (M1601.6) 14. A concrete-Encased grounding electrode
- ('UFER' Ground) connection complies with the requirments of the 2018 IRC Section E3608.1.2 in providing a connection with no less than the required minimum of steel.
- 15. Compliance with the requirments and show connection as needed for roof beam, trus, rafter, and girder connections for uplift per IRC
- 16. Garage Door Rating: DASMA 115 MPH Rated

2018 IRC BUILDING CODE COMPLIANCE THESE DRAWINGS HAVE BEEN PREPARED WITH RESPECT TO COMPLIANCE OF THE 2018 IRC AND NEC 2017 ANY REFERENCES FOUND NOT CORRECTLY IDENTIFIED TO THESE CODES SHALL BE BROUGHT TO THE ATTENTION OF SSIONAL THE DESIGN PROFESSIONAL



Greystone





Permit Set

PLAN DESCRIPTION: Cover Sheet





ne Mareideanse voor ne onestatuuchten
As noted for Plan review
Development services
Lee's summit, missouri
09/03/2025

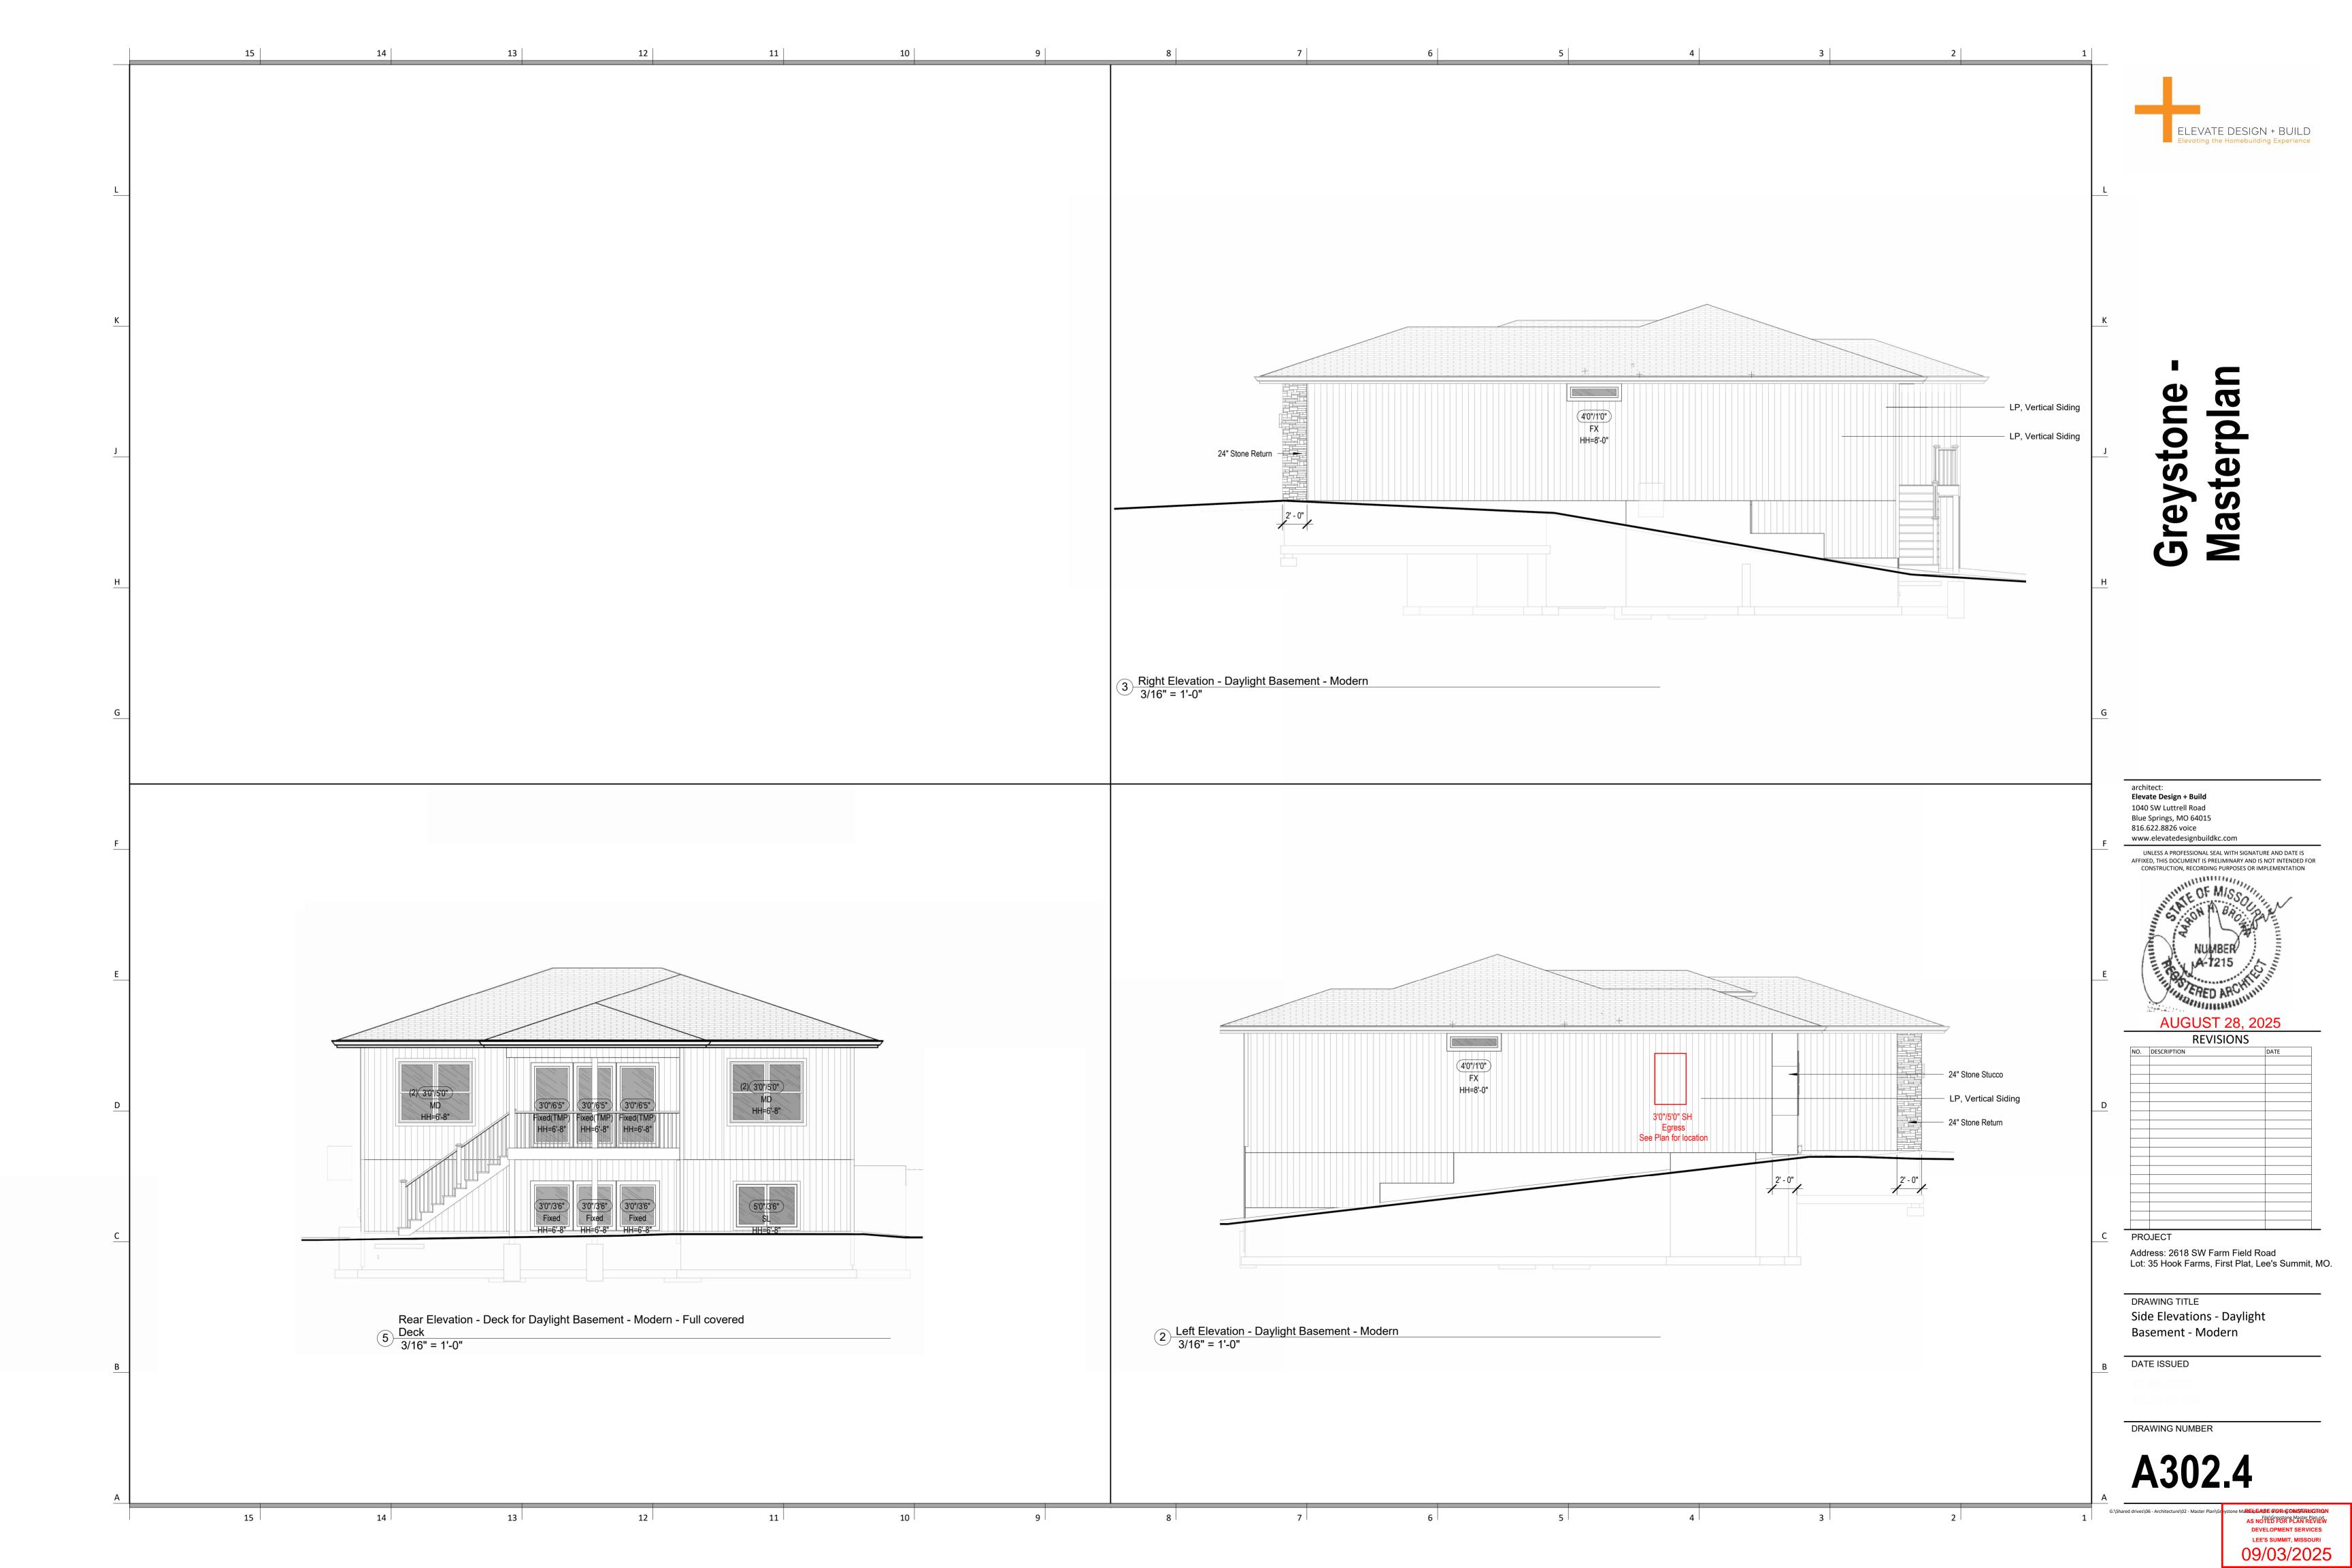


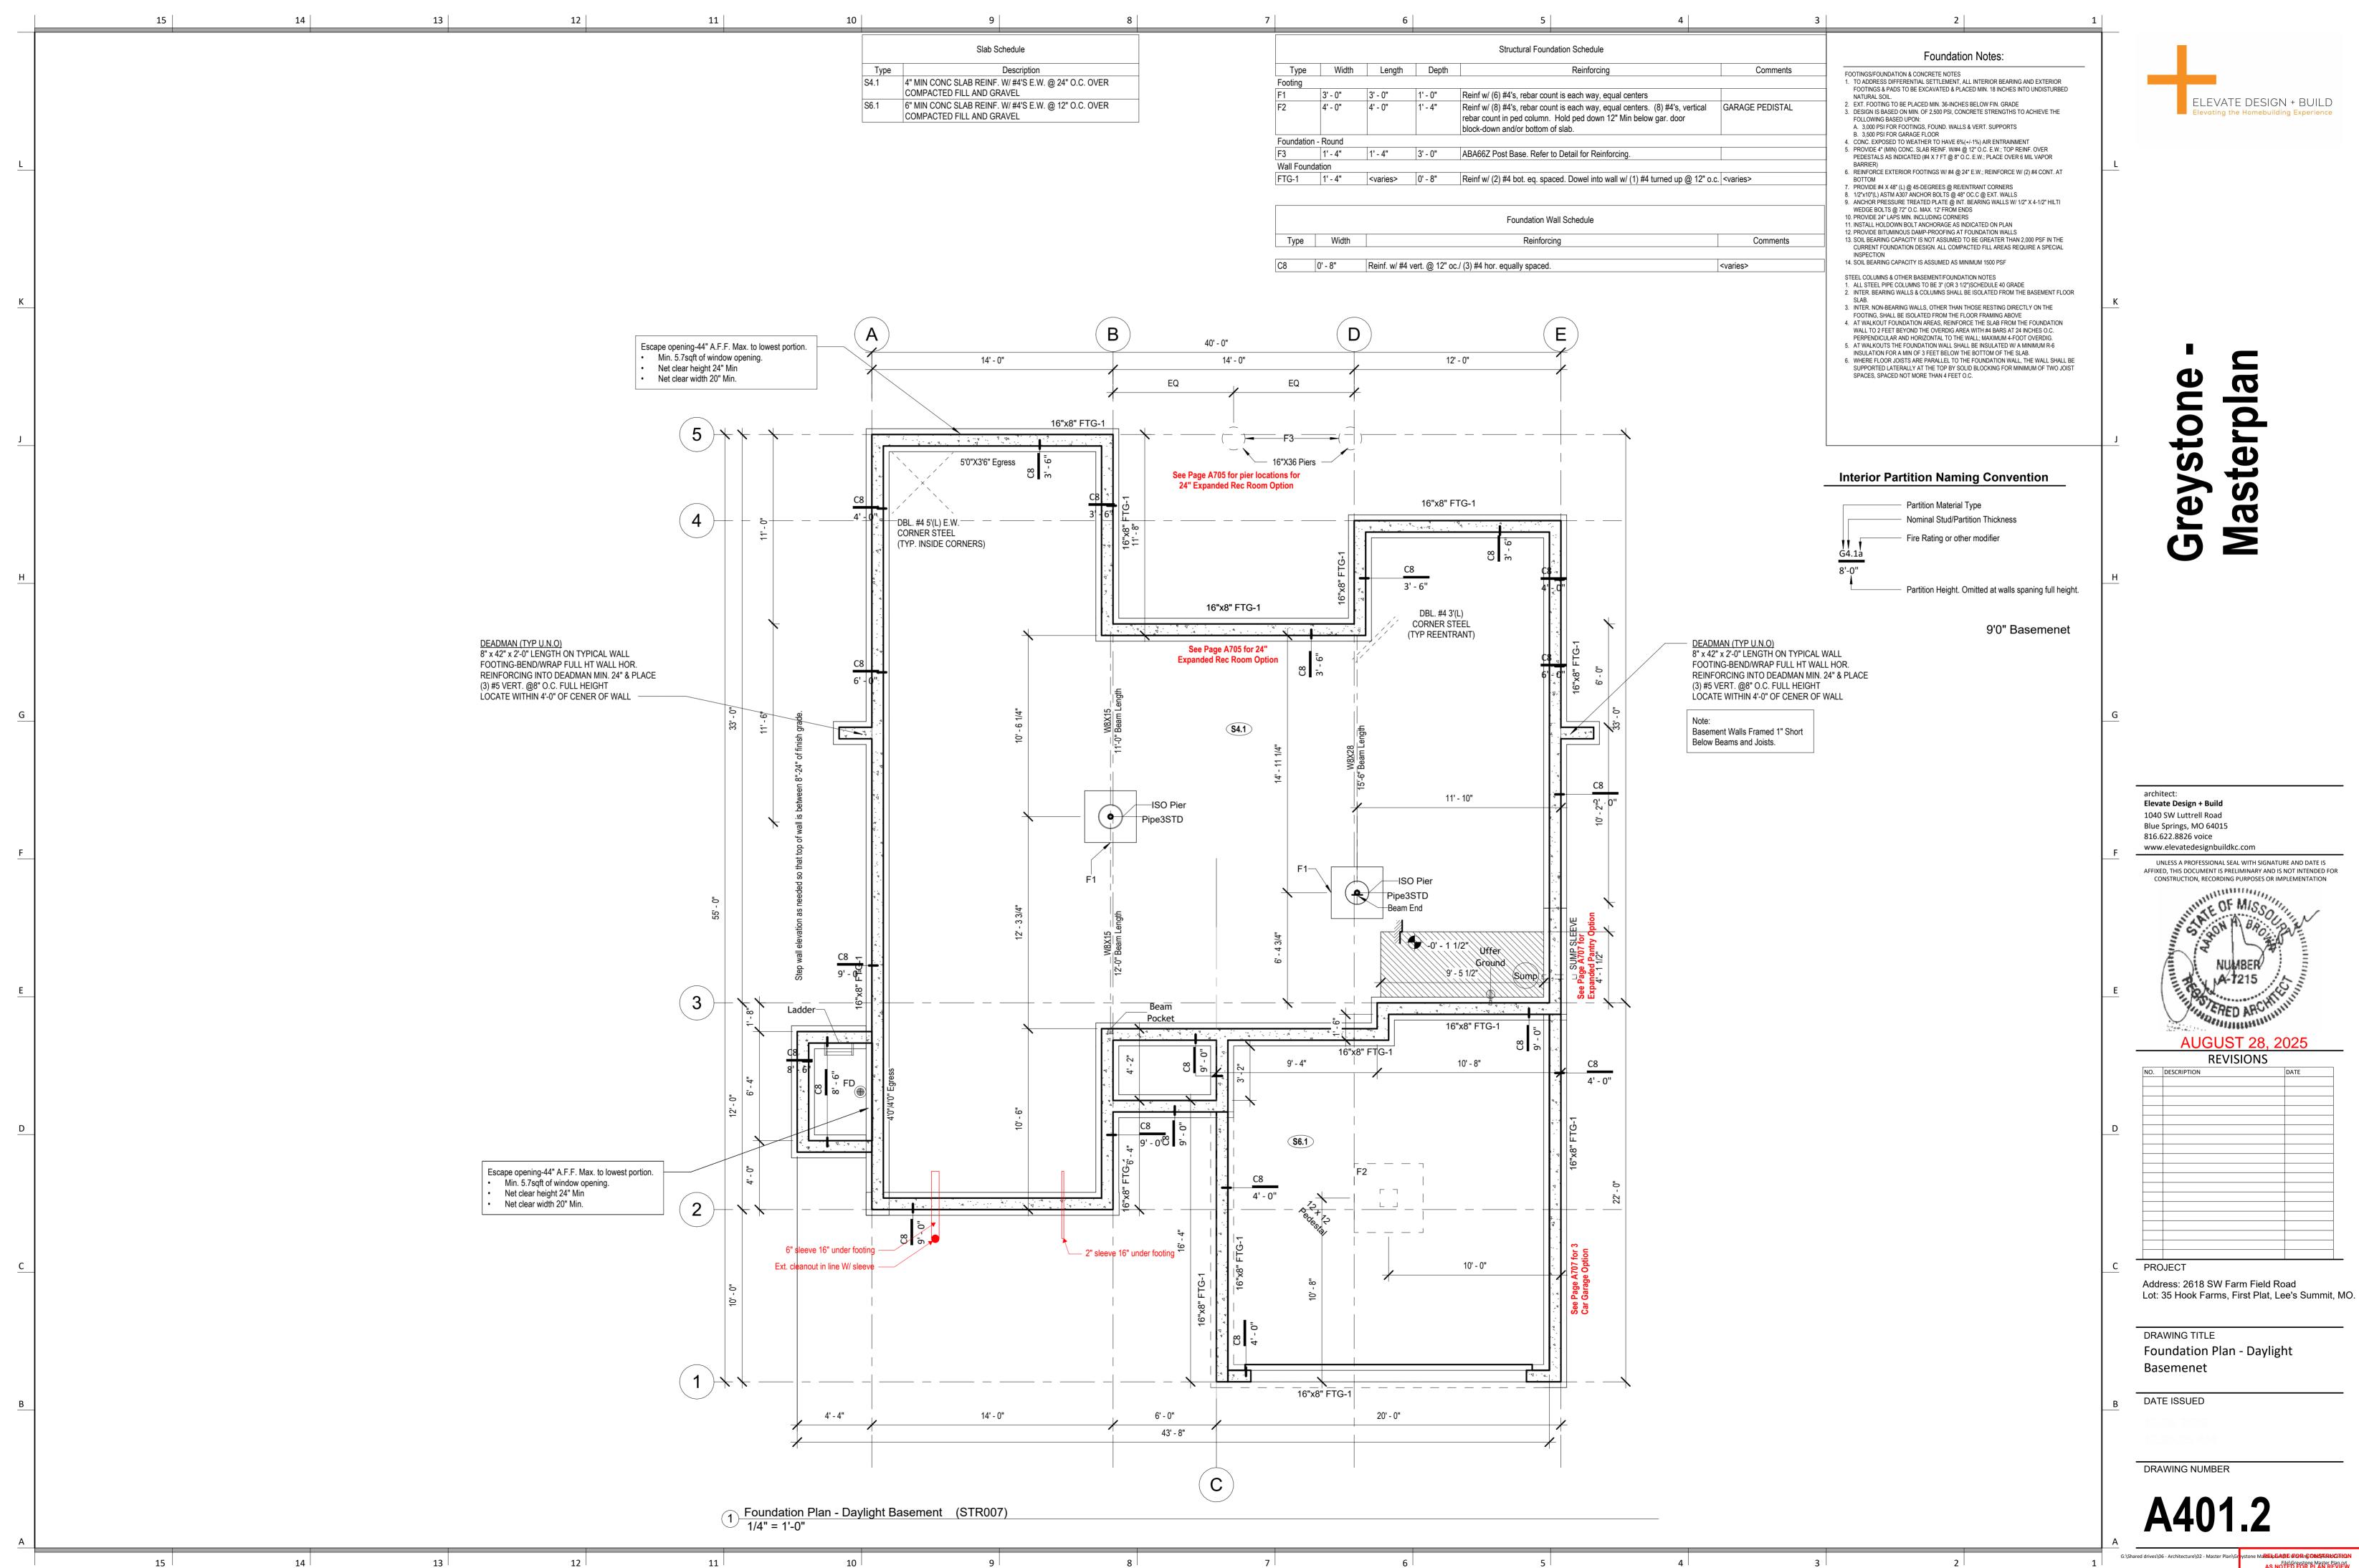



MAREIDE MORIGENISTRADICTION
AS NOTED FOR PLANTEPINOS
DEVELOPMENT SERVICES
LEE'S SUMMIT, MISSOURI
09/03/2025

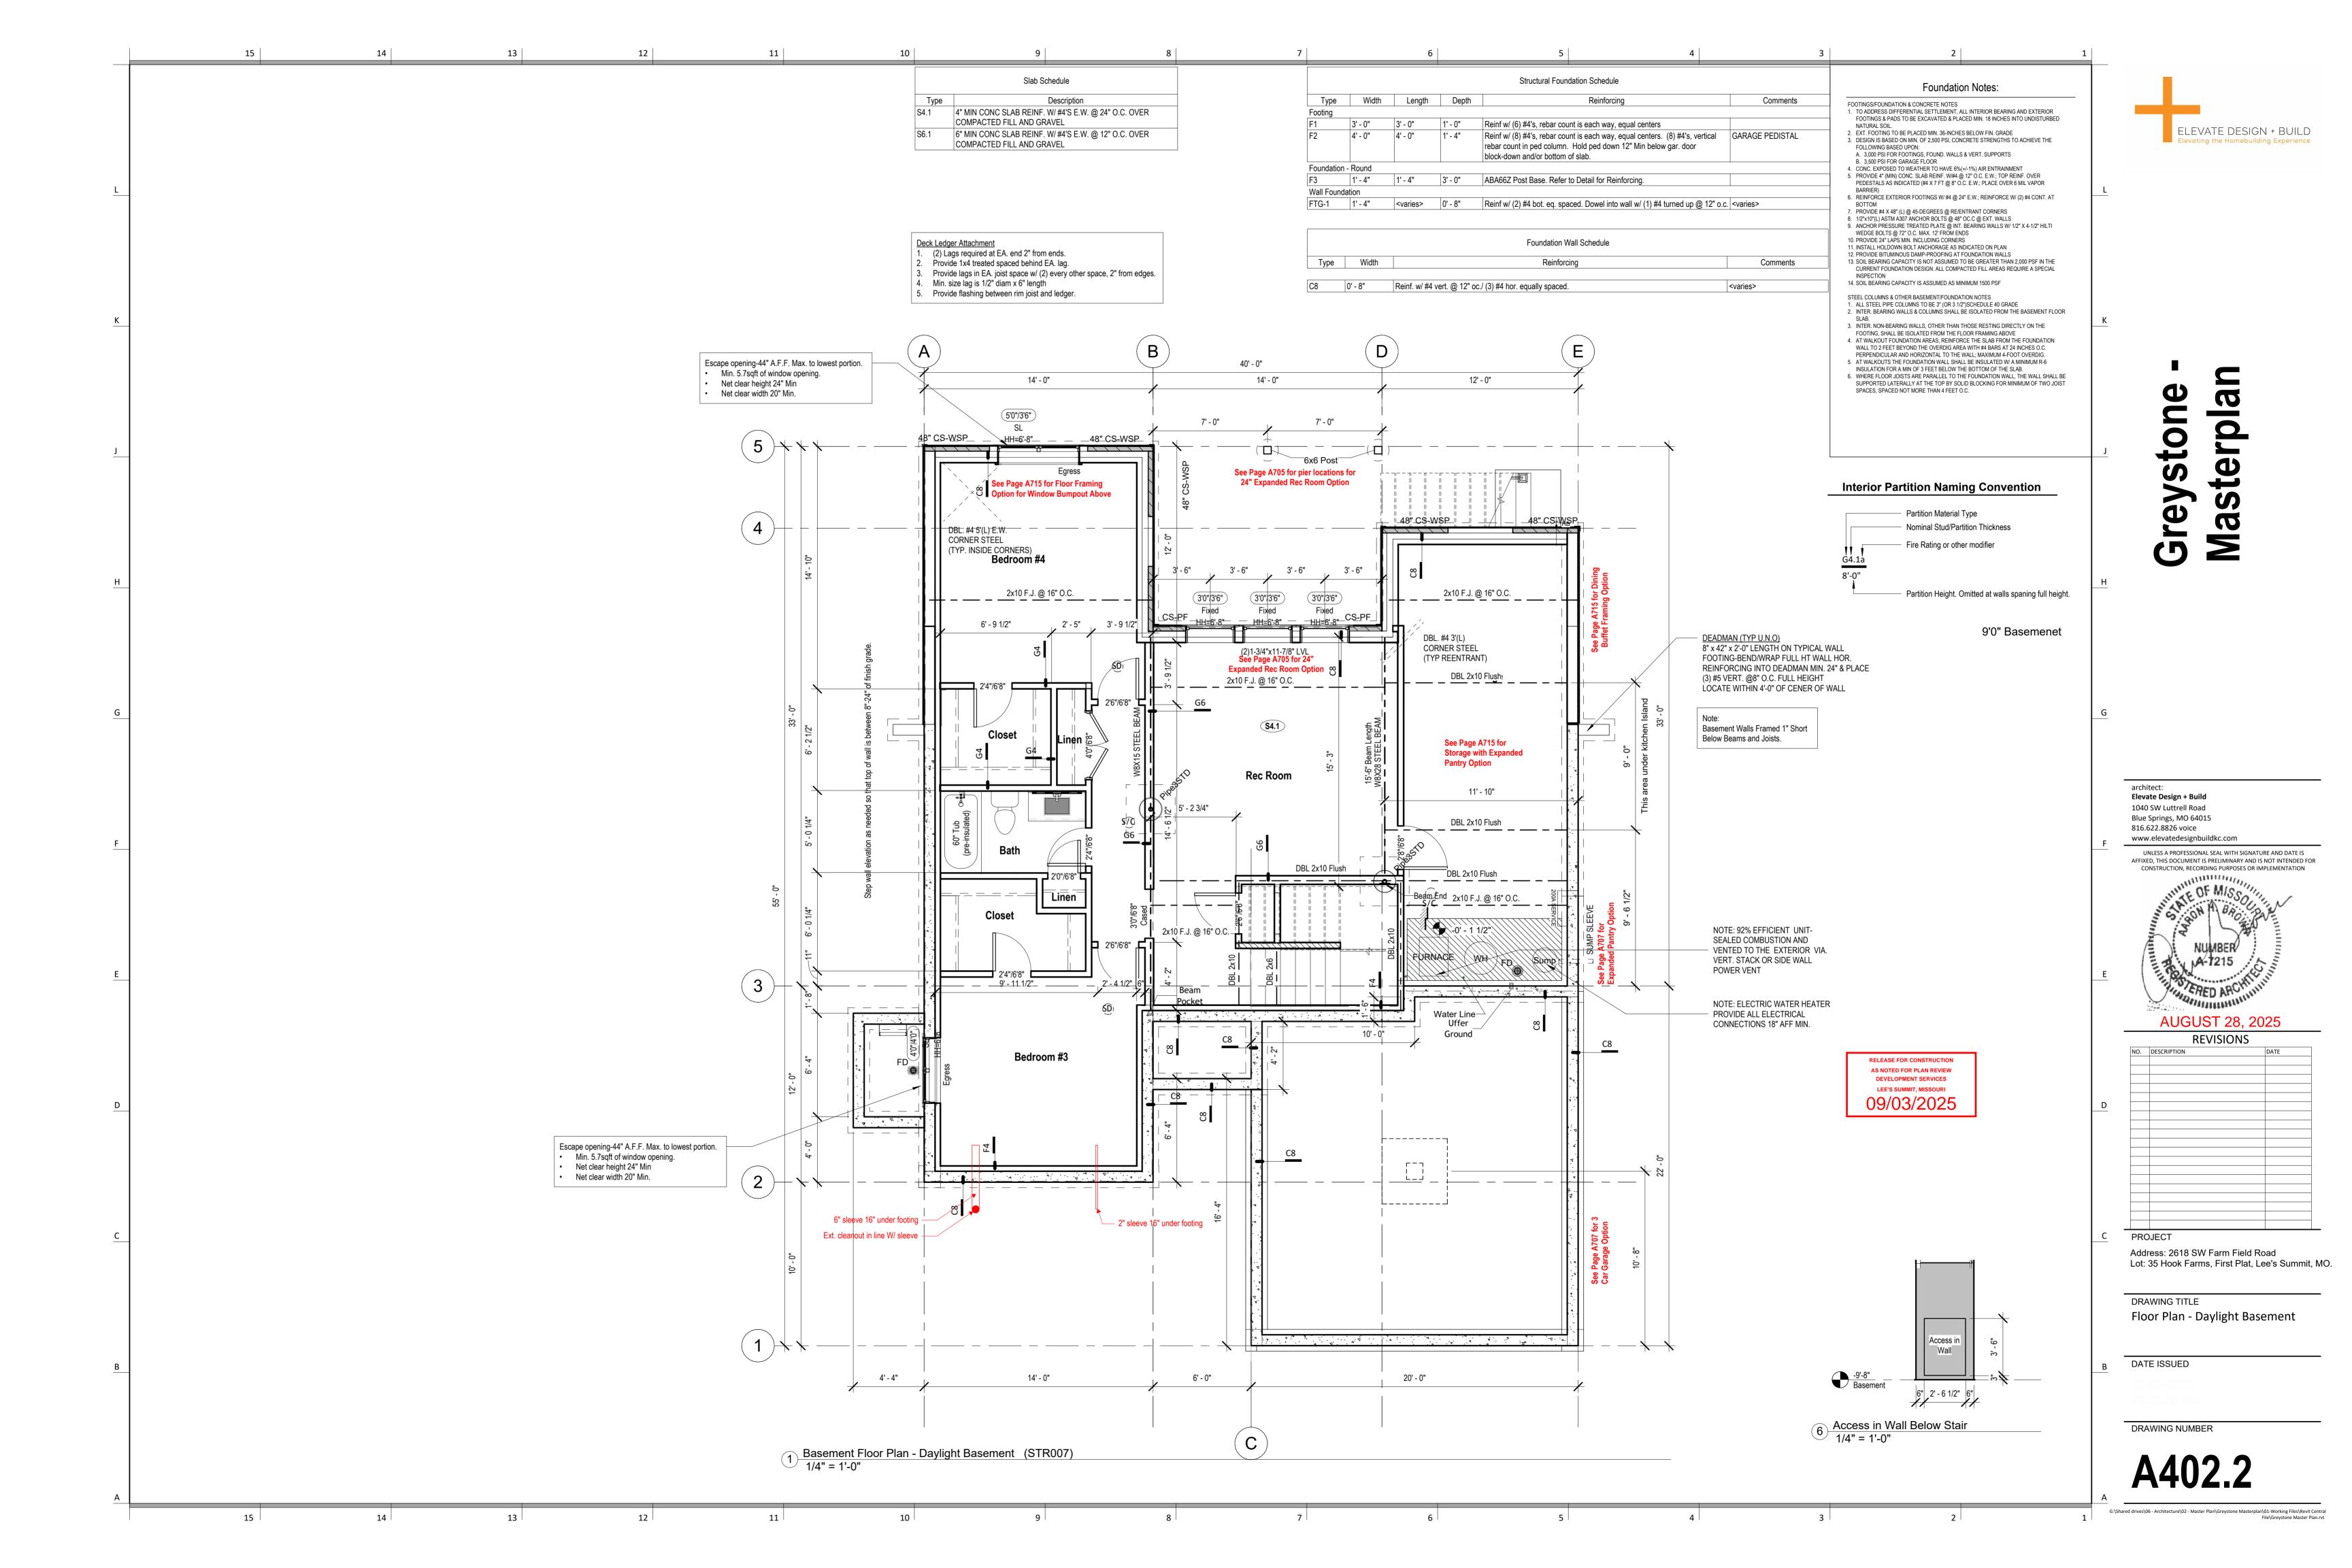

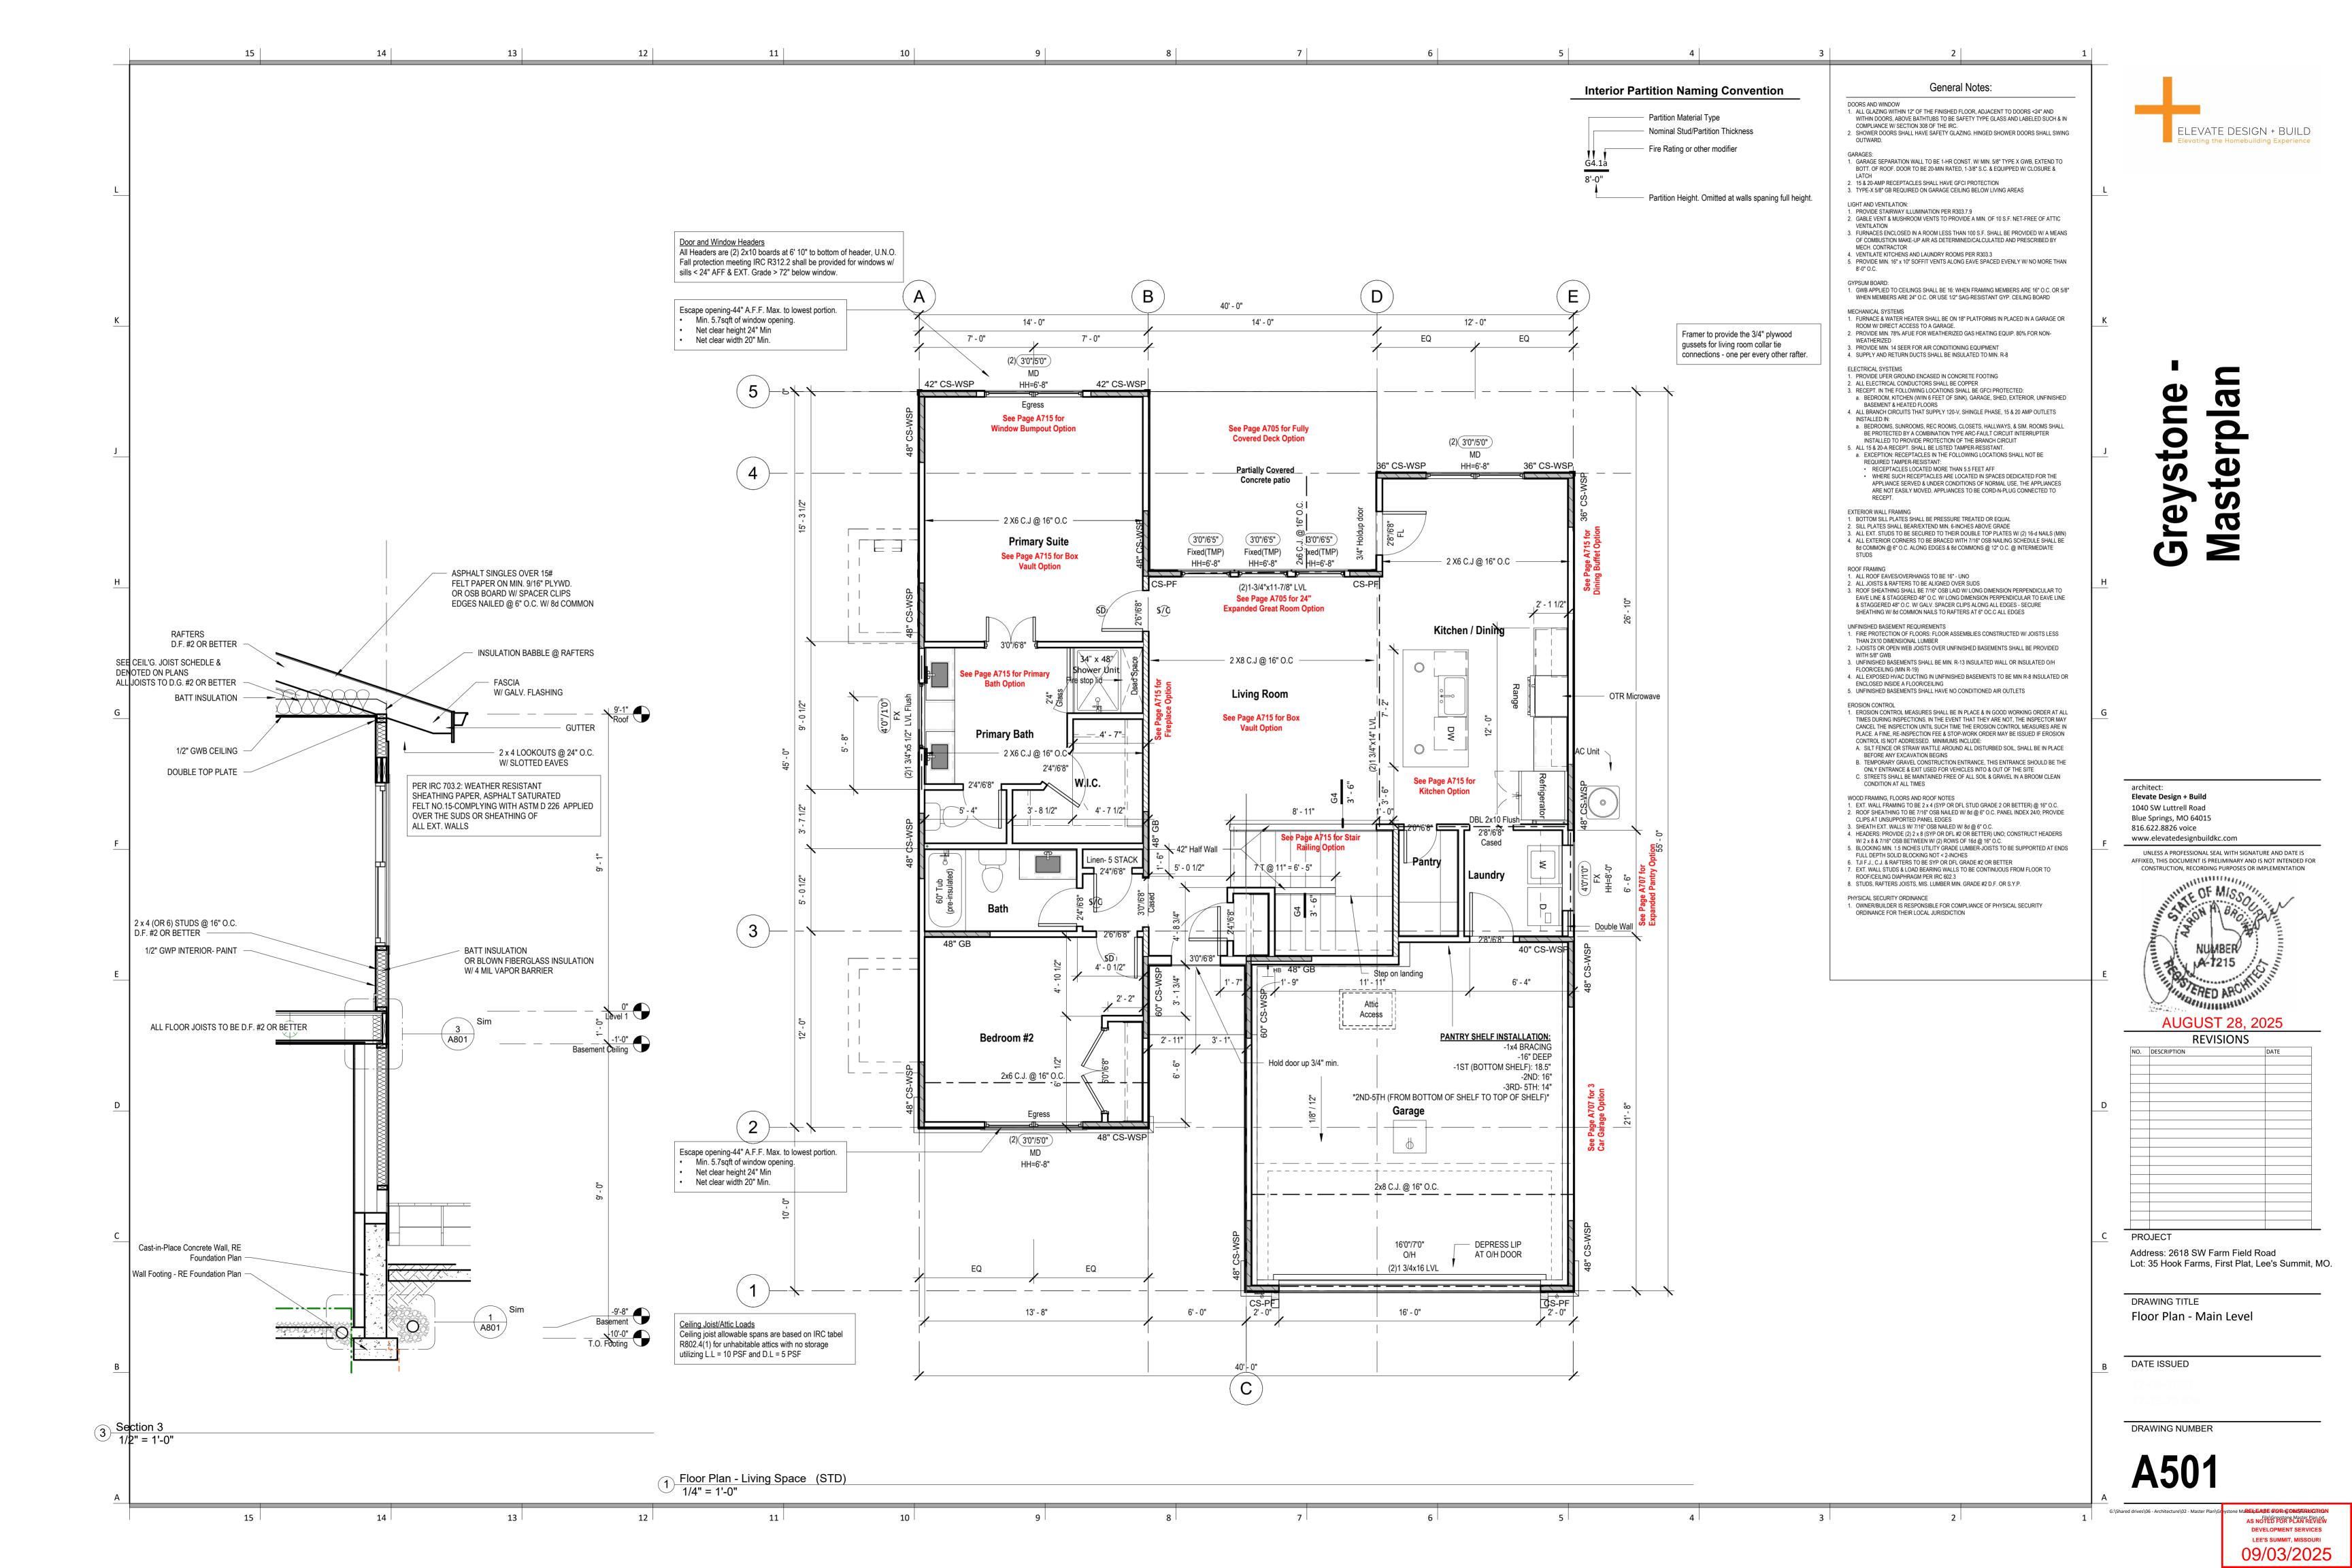


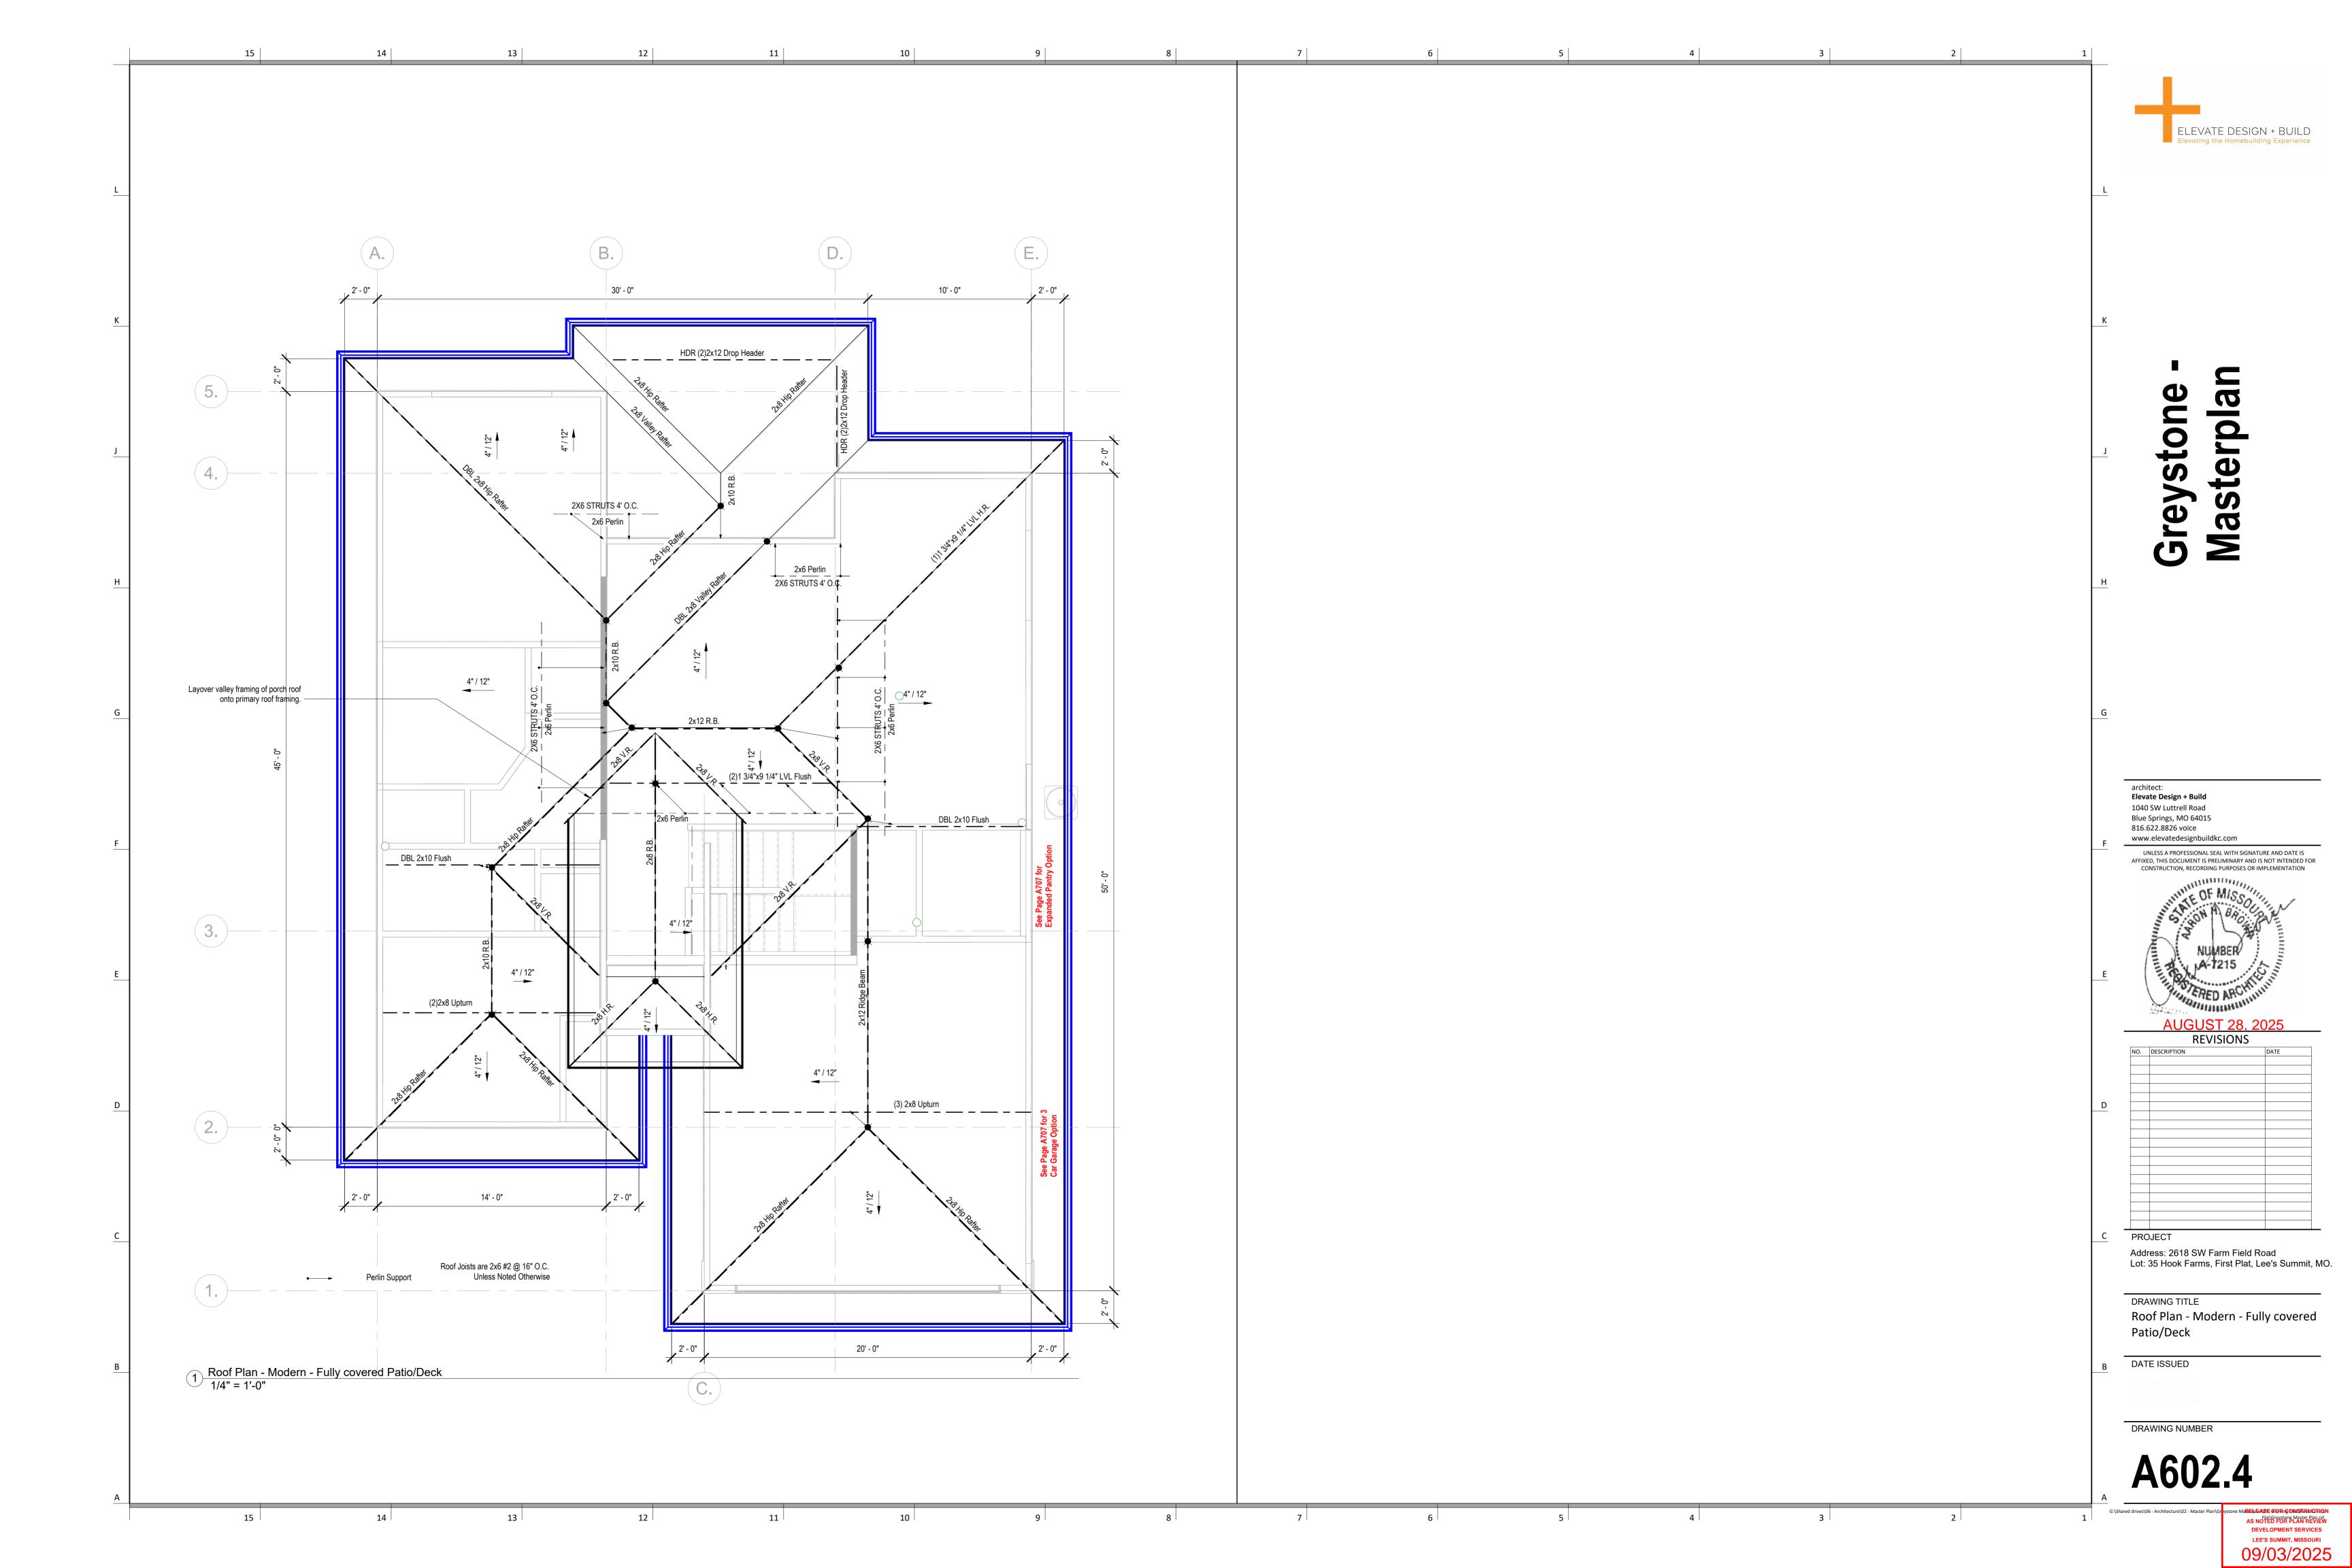

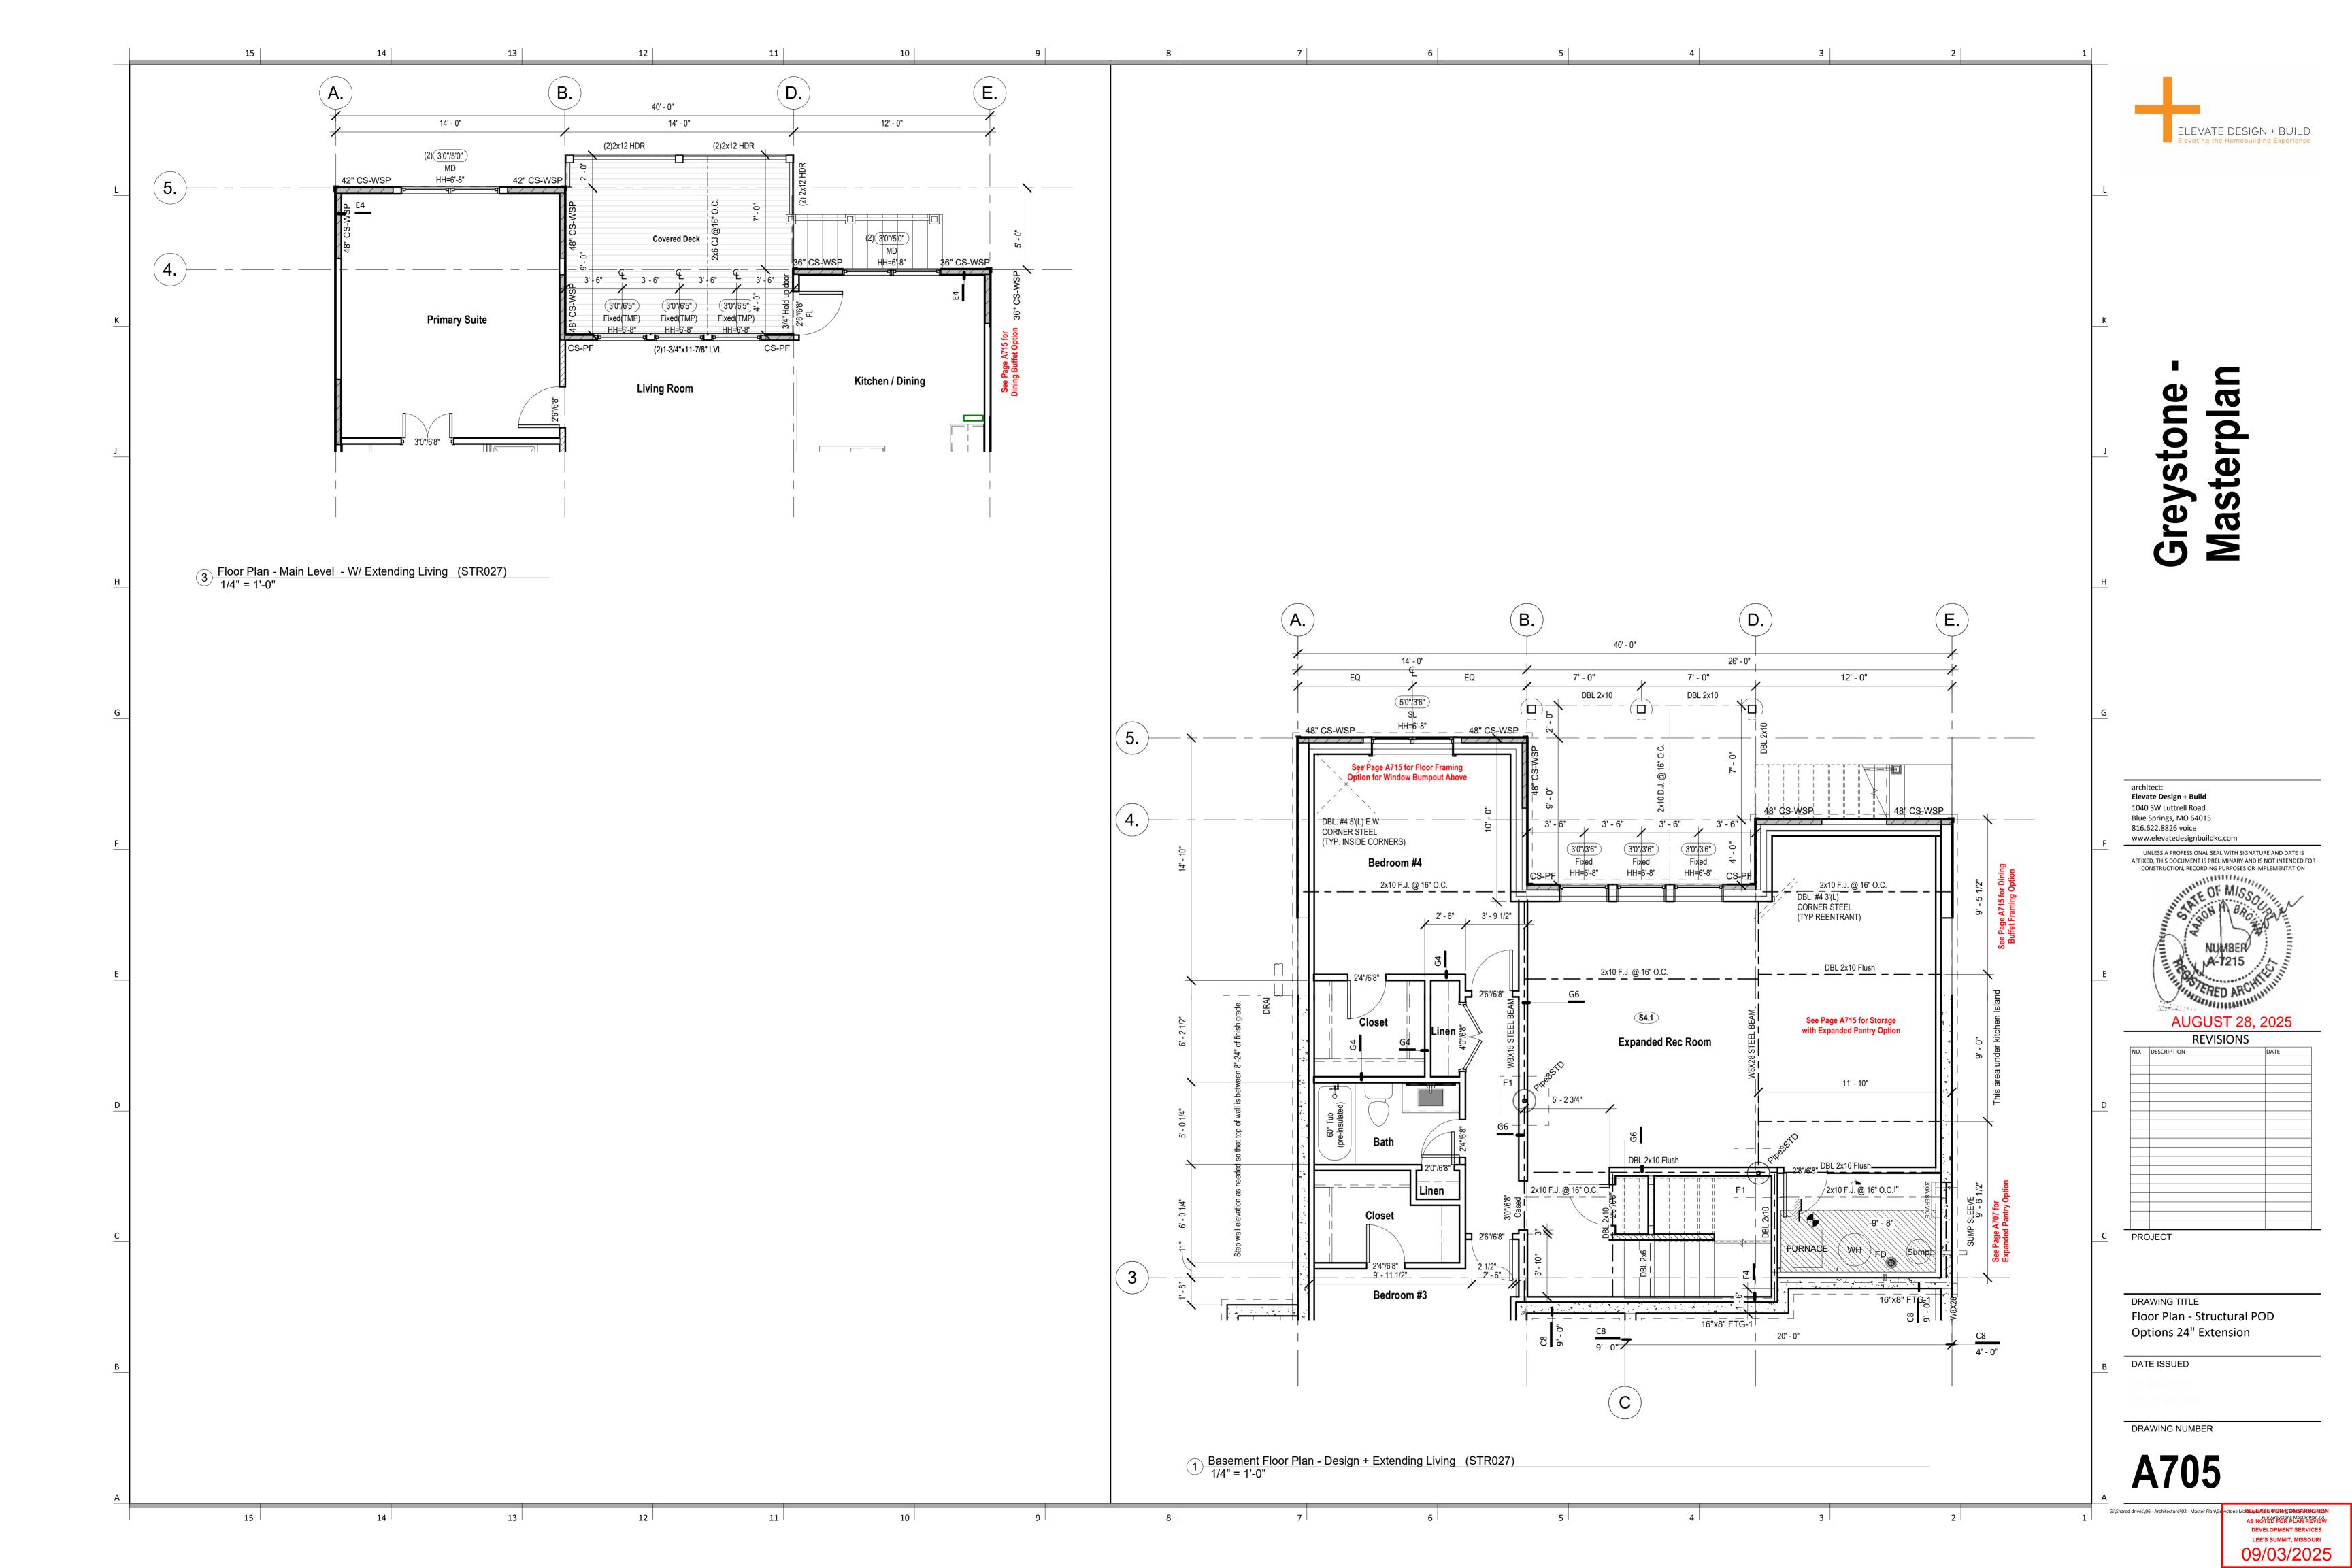


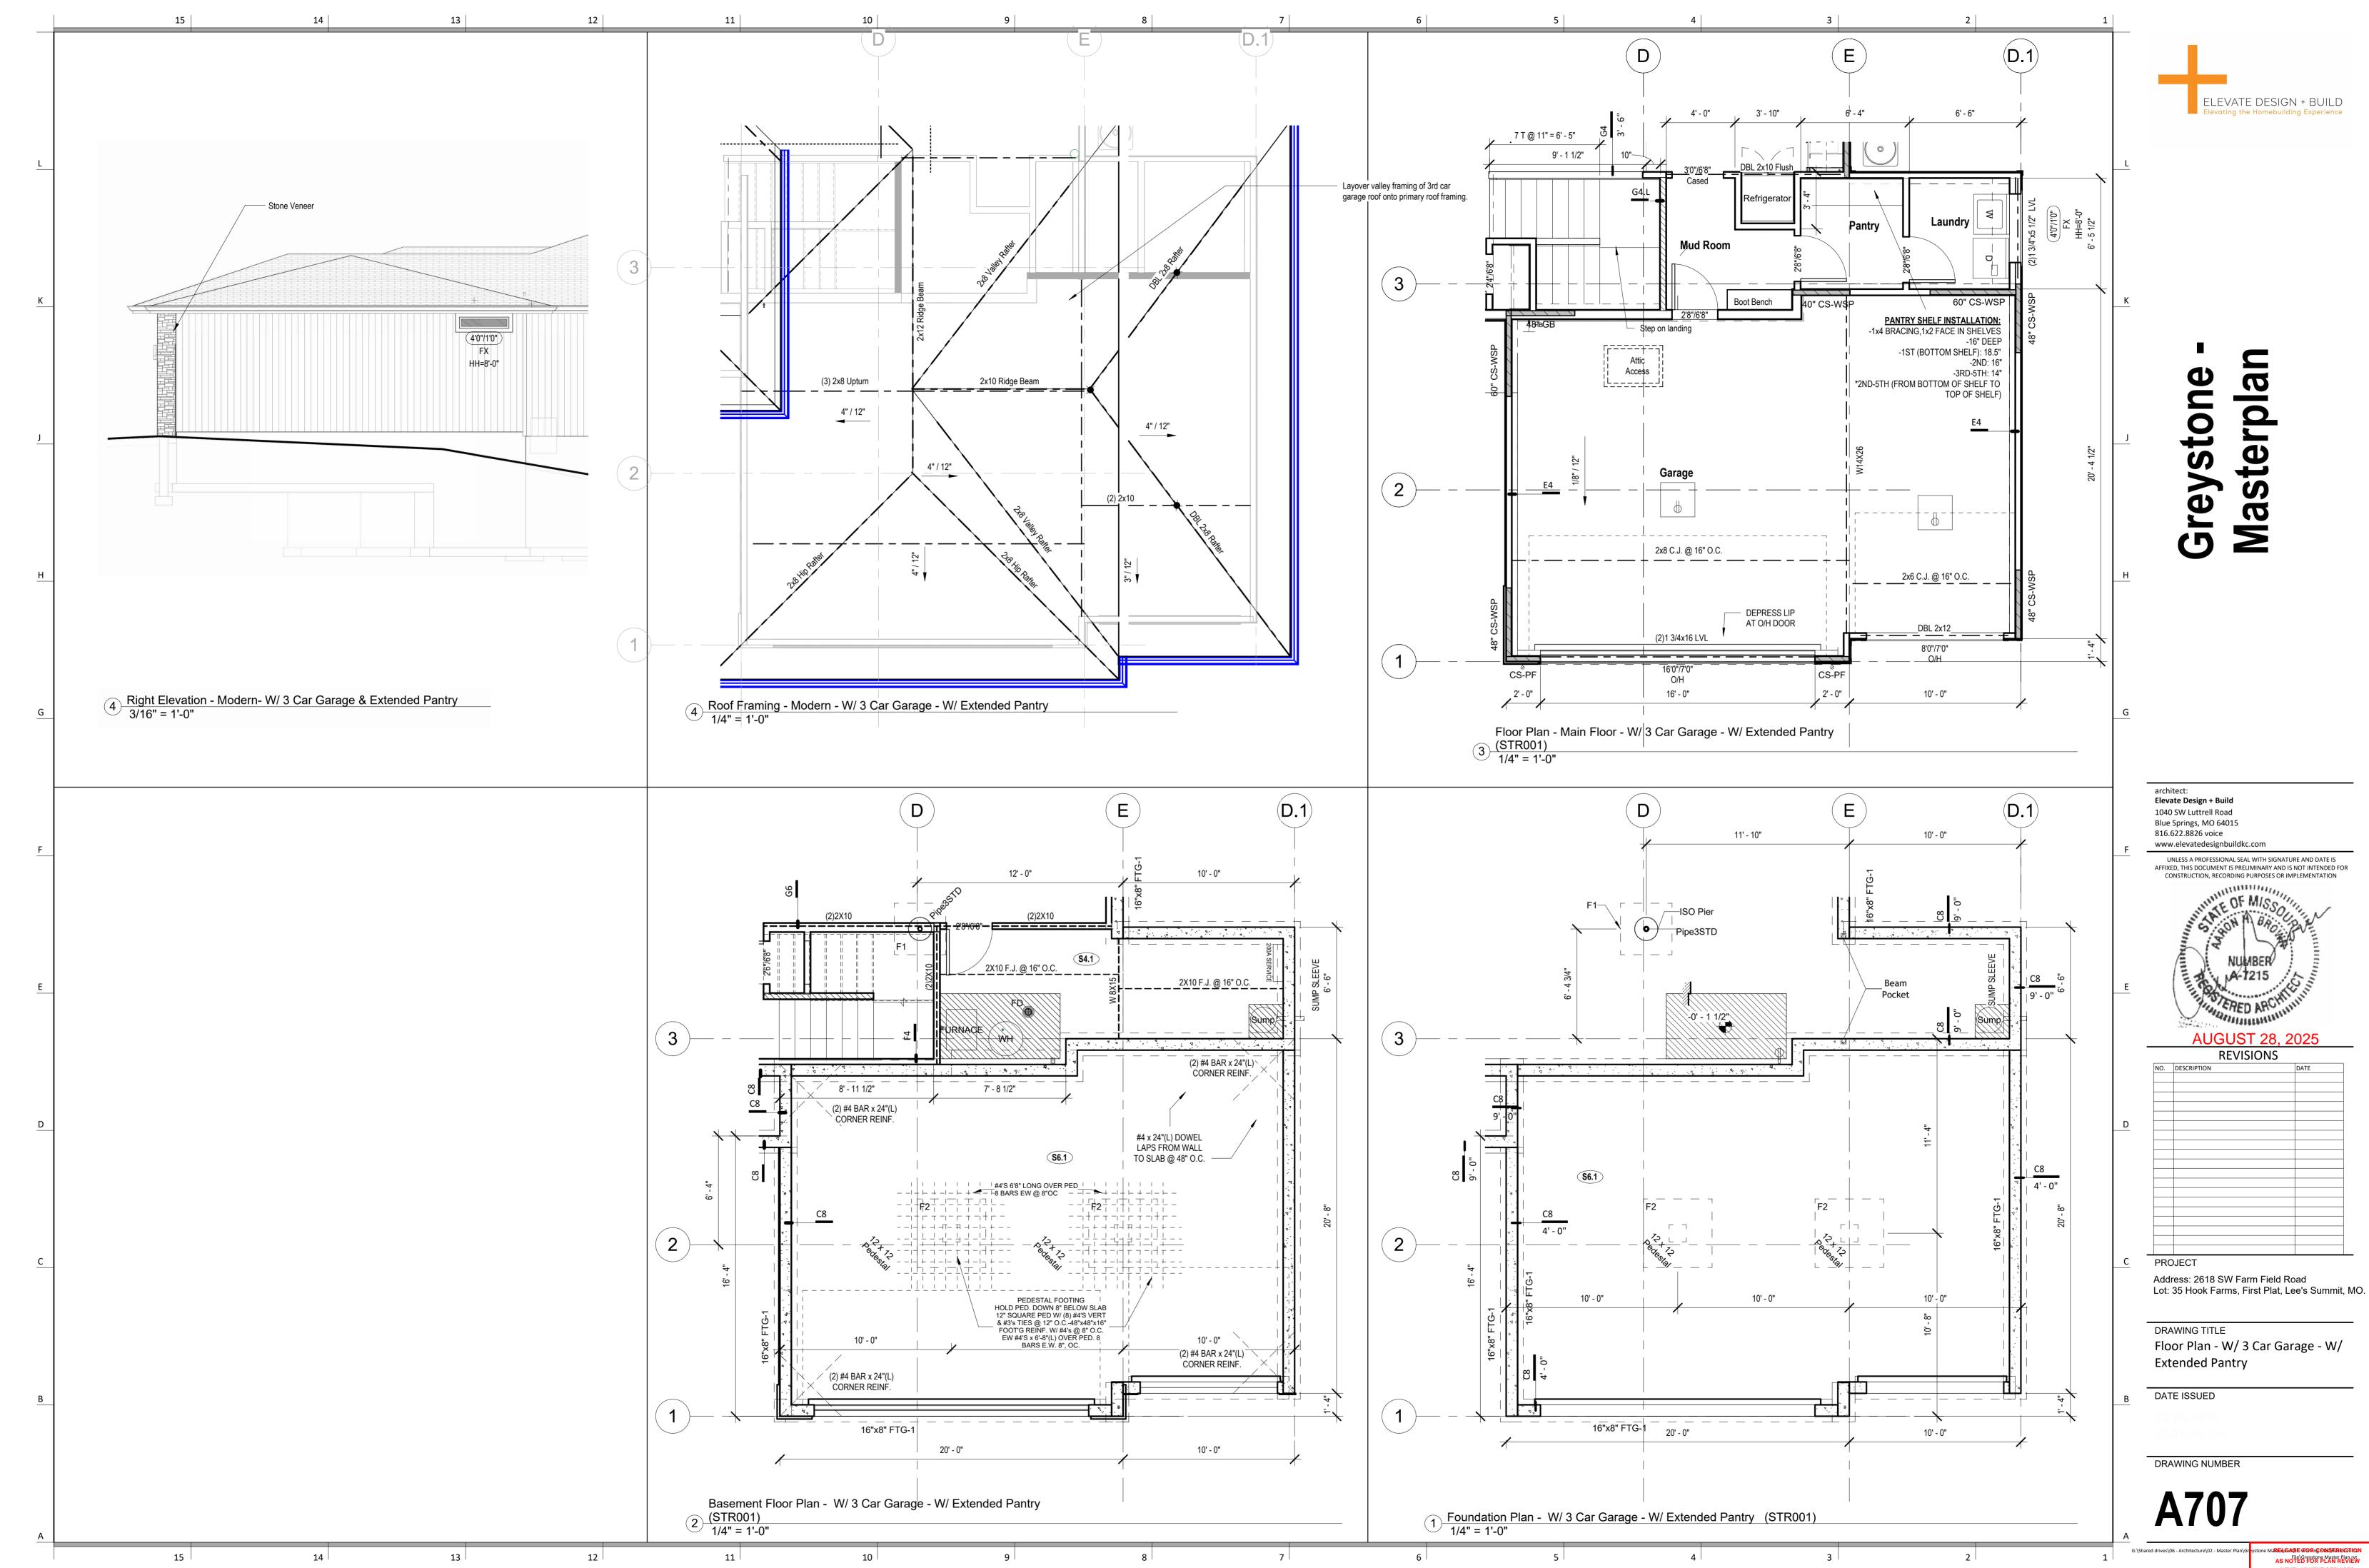

e Marie de Arge vror de Constant Cetton
As noted for plan privit
Development services
Lee's summit, missouri
09/03/2025

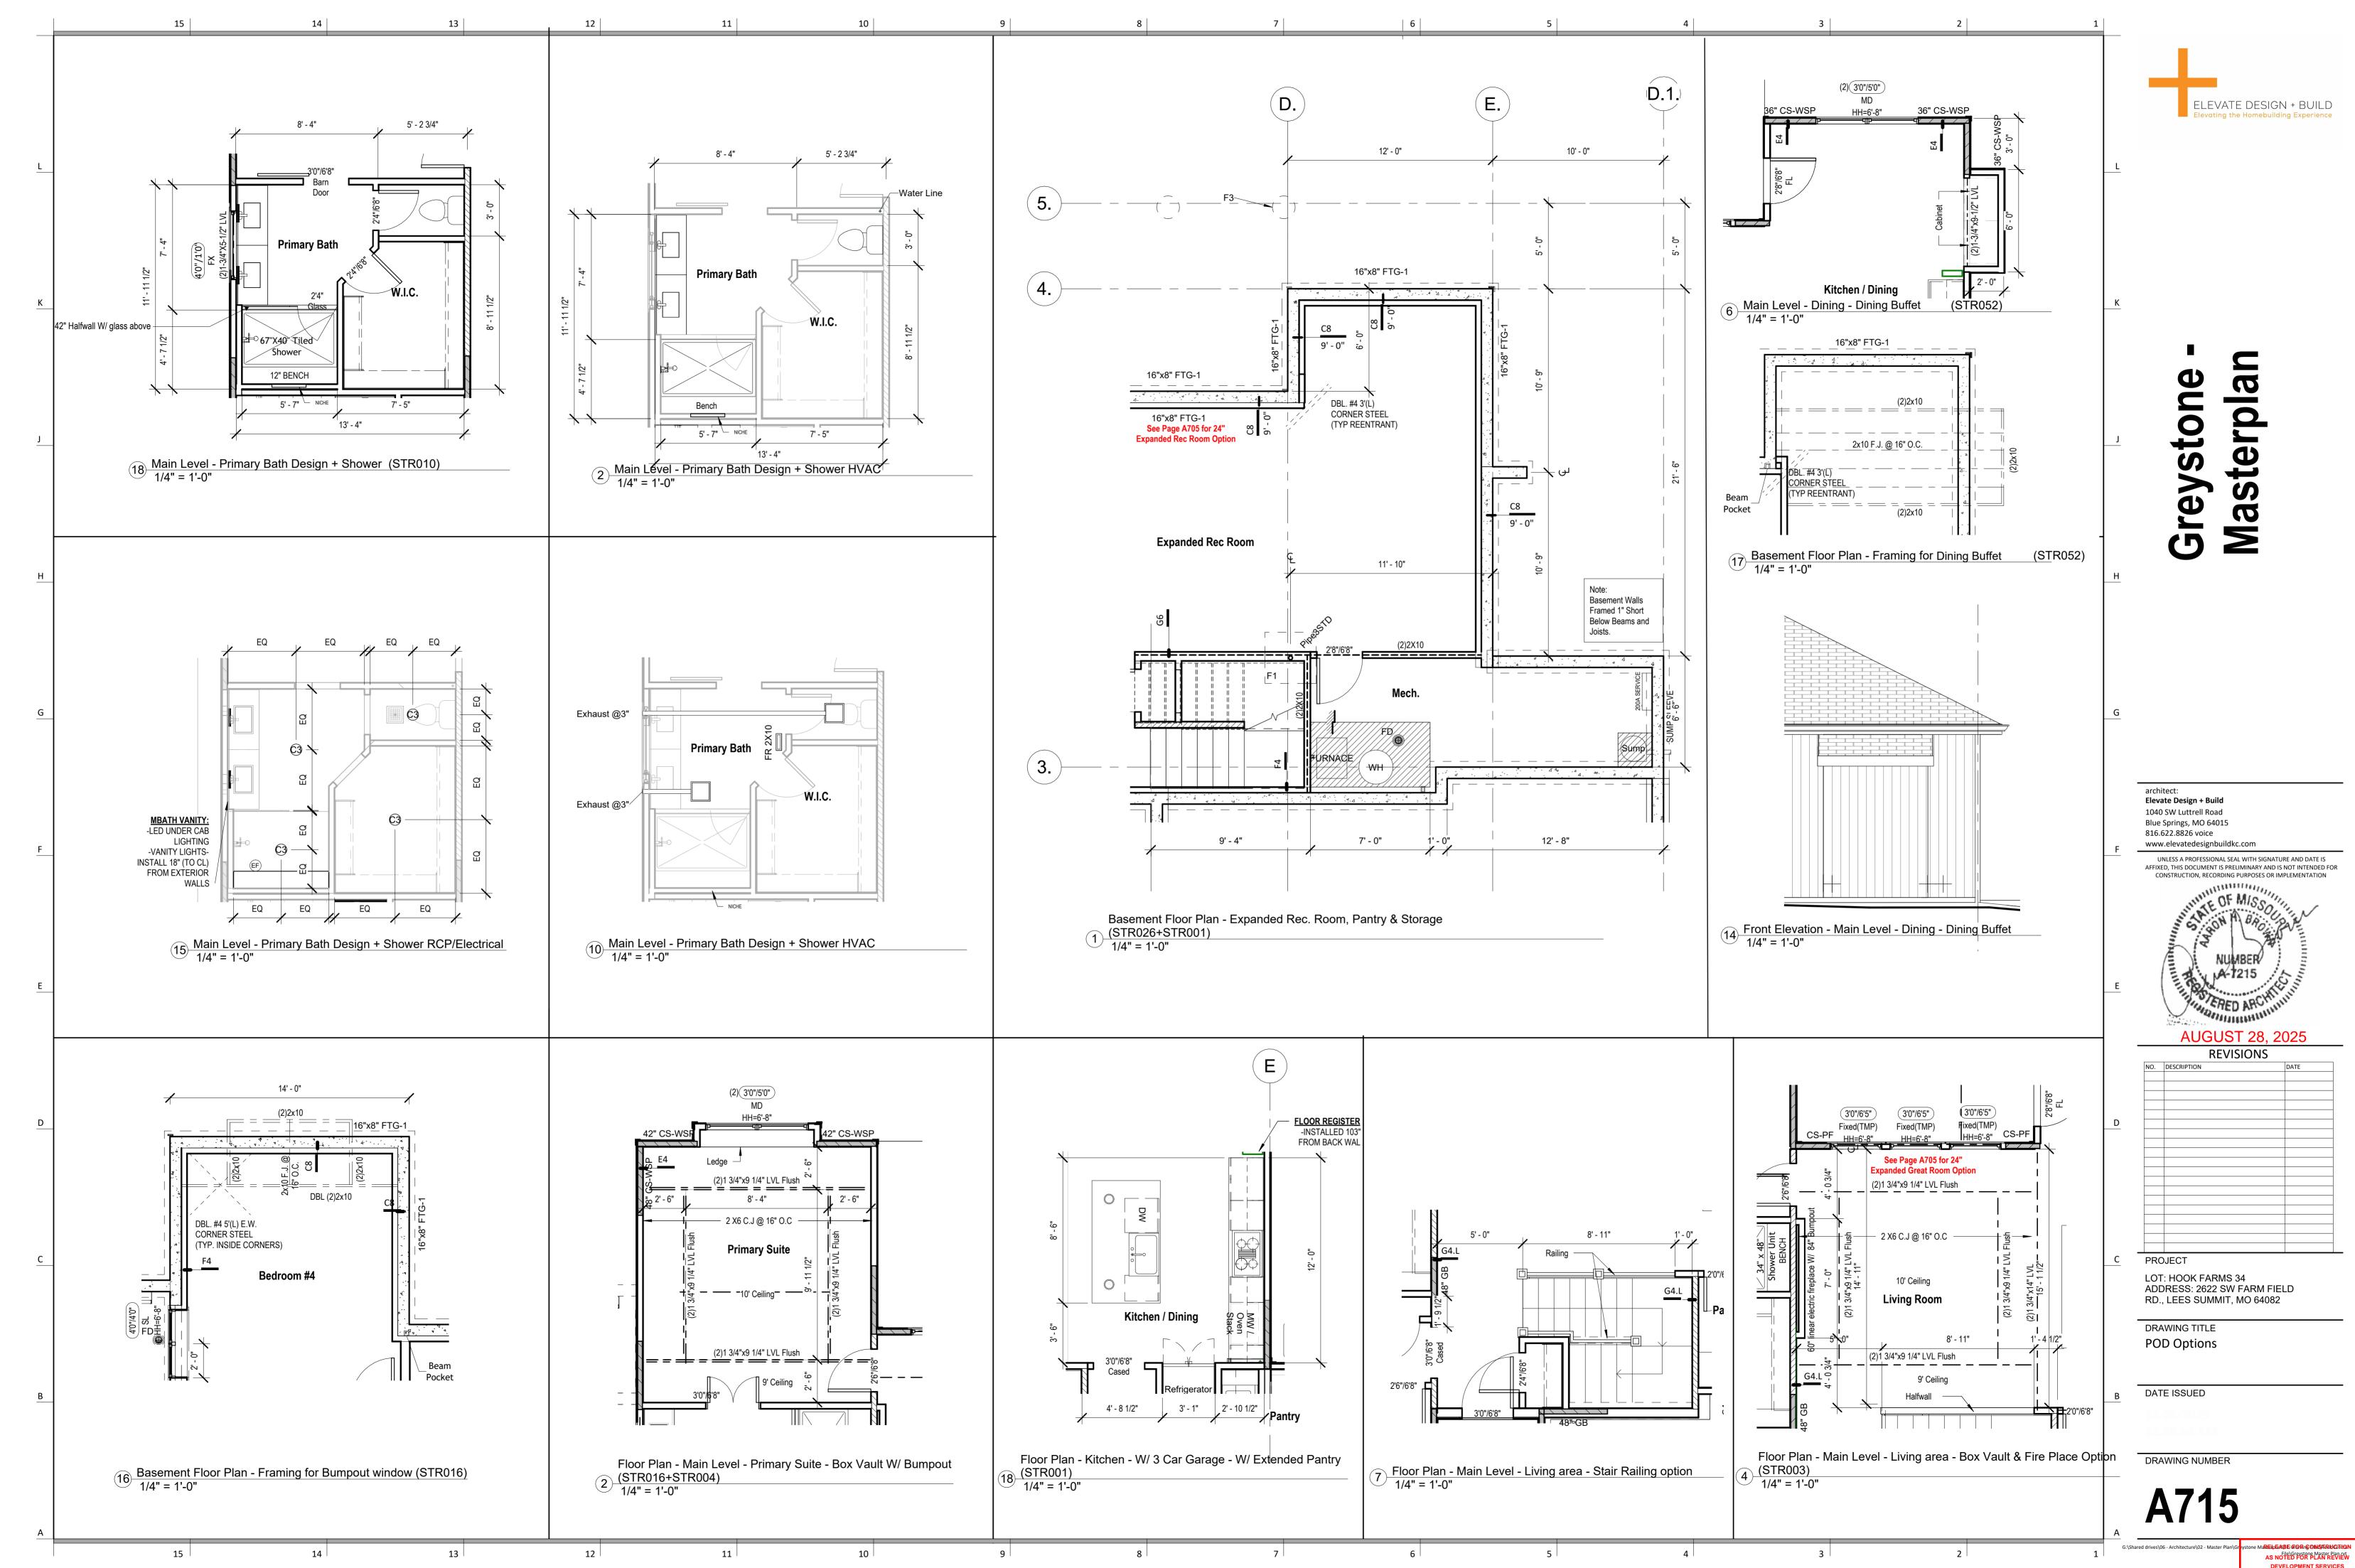

one Mærepembervorgenstrævetign As notted for Plant Review Development services Lee's summit, missouri 09/03/2025

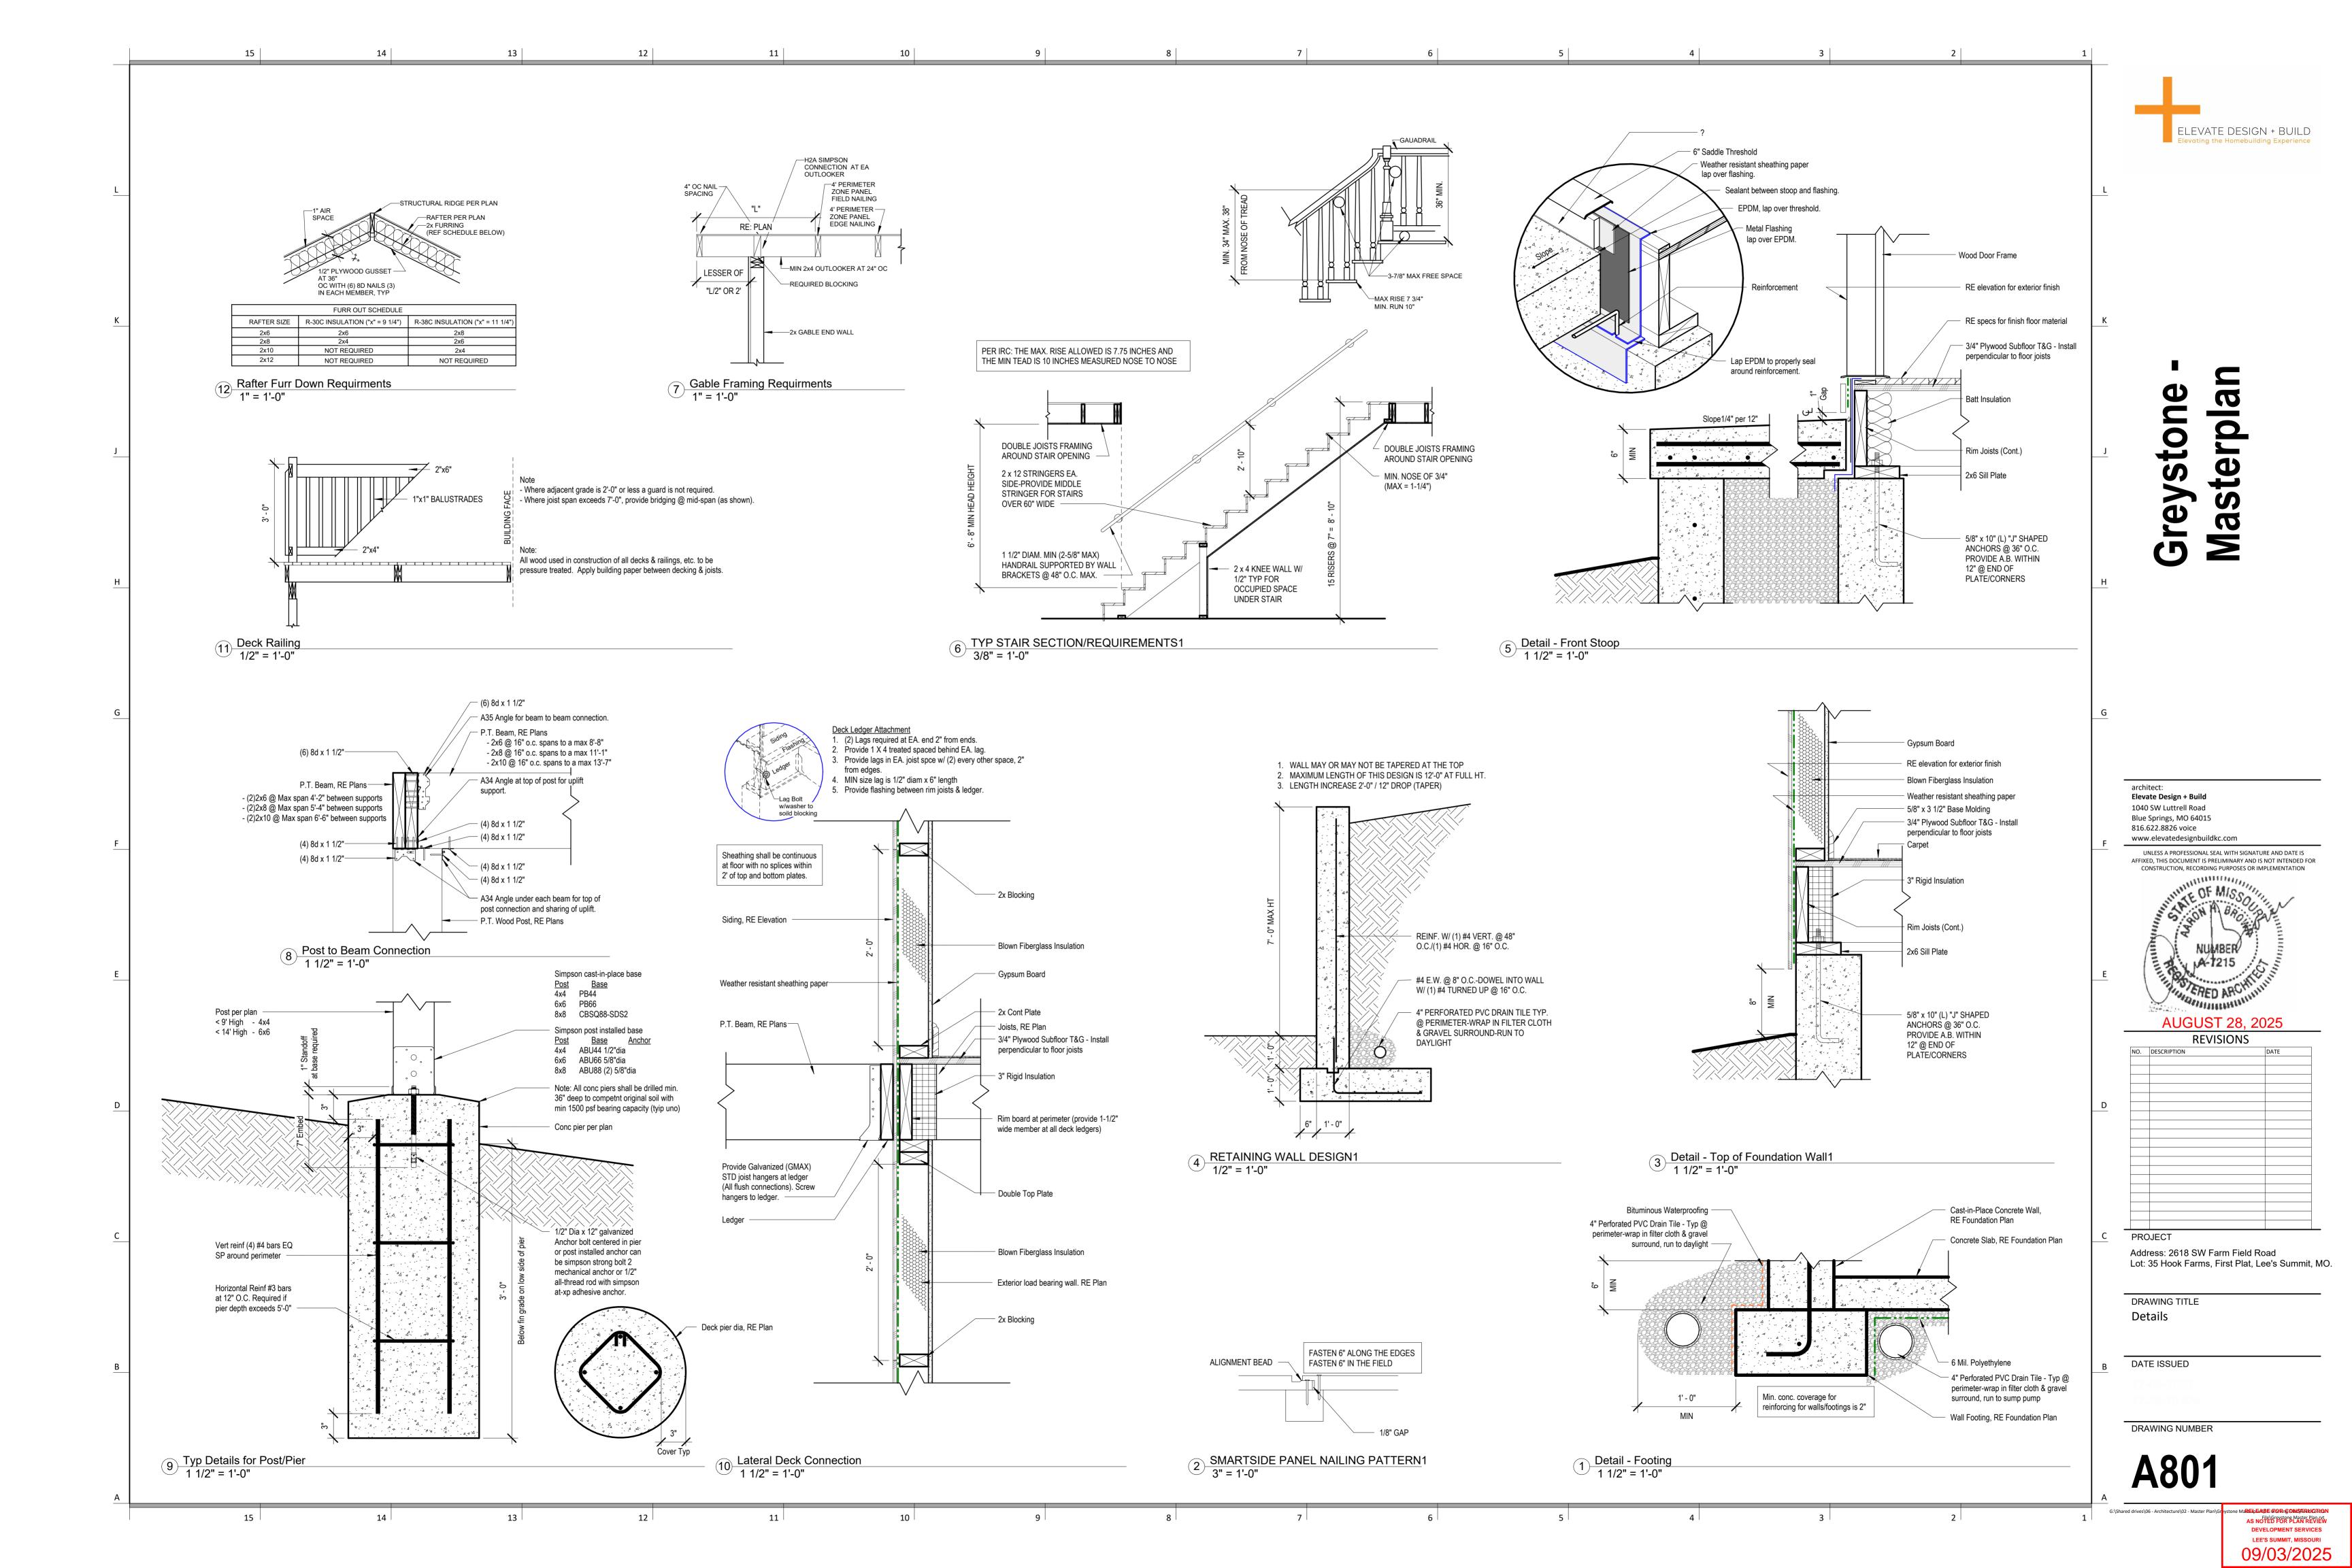


ELEVATE DESIGN + BUILD


Lot: 35 Hook Farms, First Plat, Lee's Summit, MO.

File\Grevstone Master Plan.rvt

AS NOTED FOR PLAN REVIEW DEVELOPMENT SERVICES LEE'S SUMMIT, MISSOURI 09/03/2025

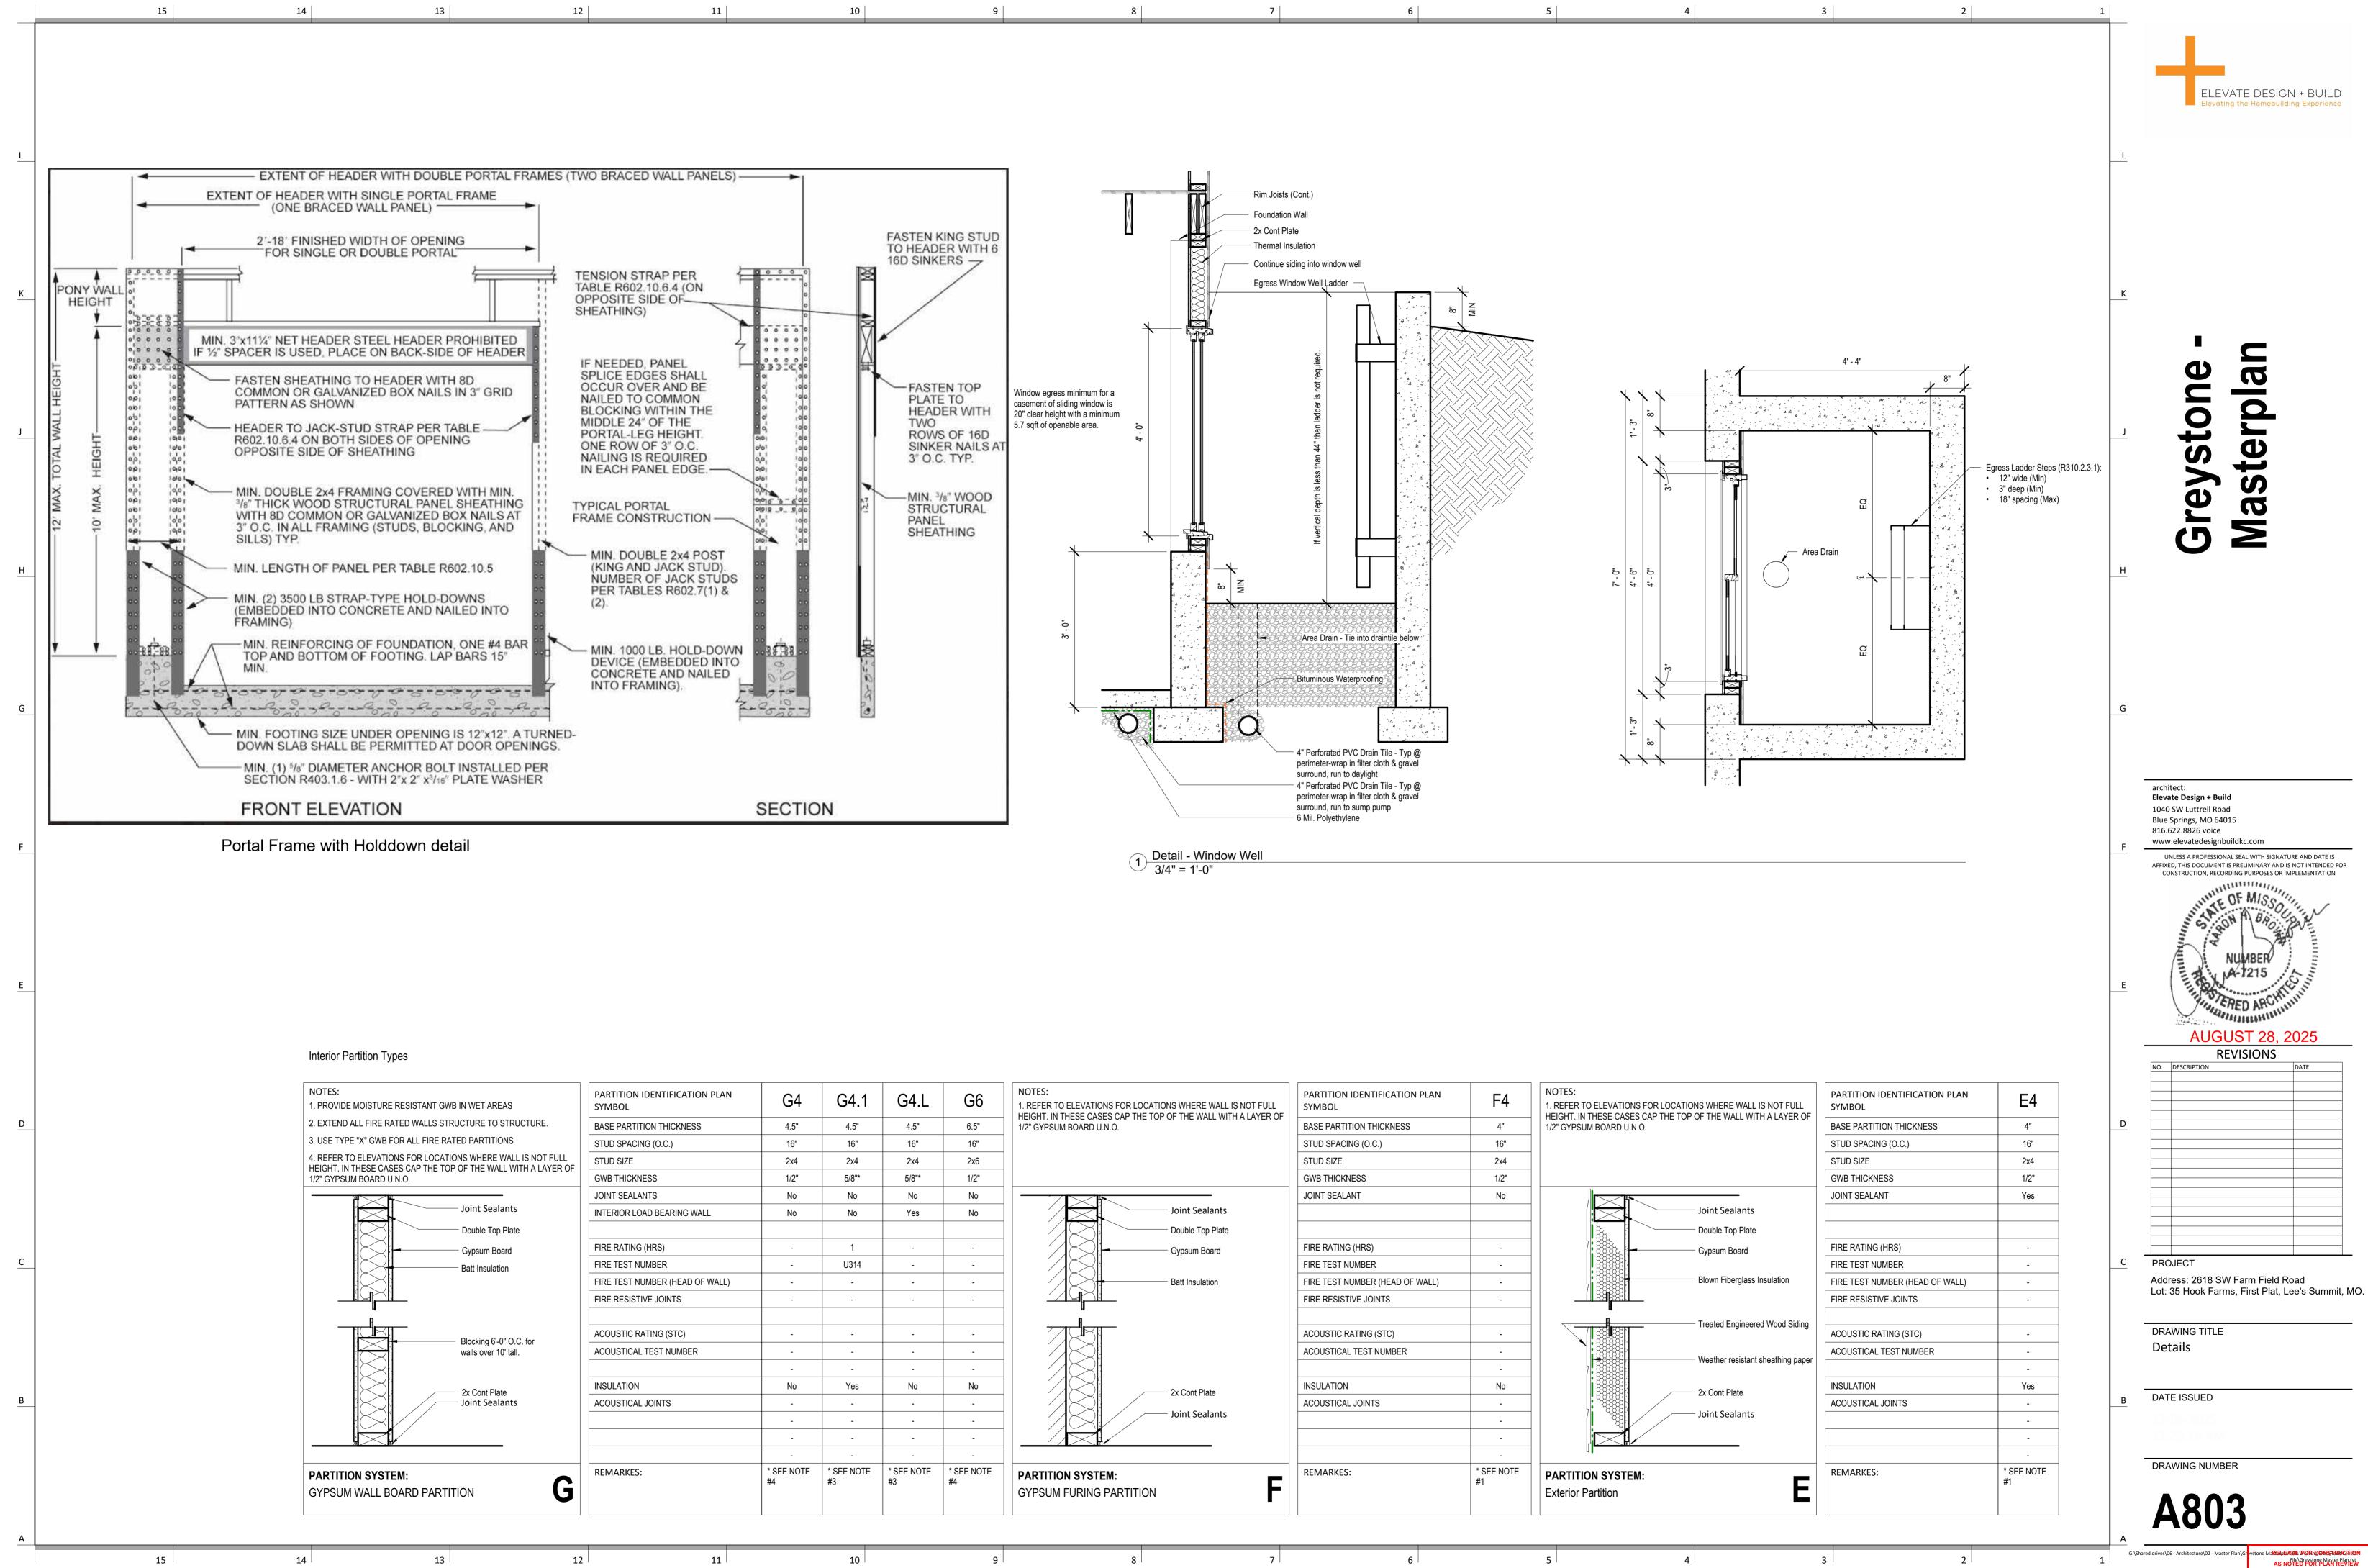

one Marie Marie Marie Plan Marie

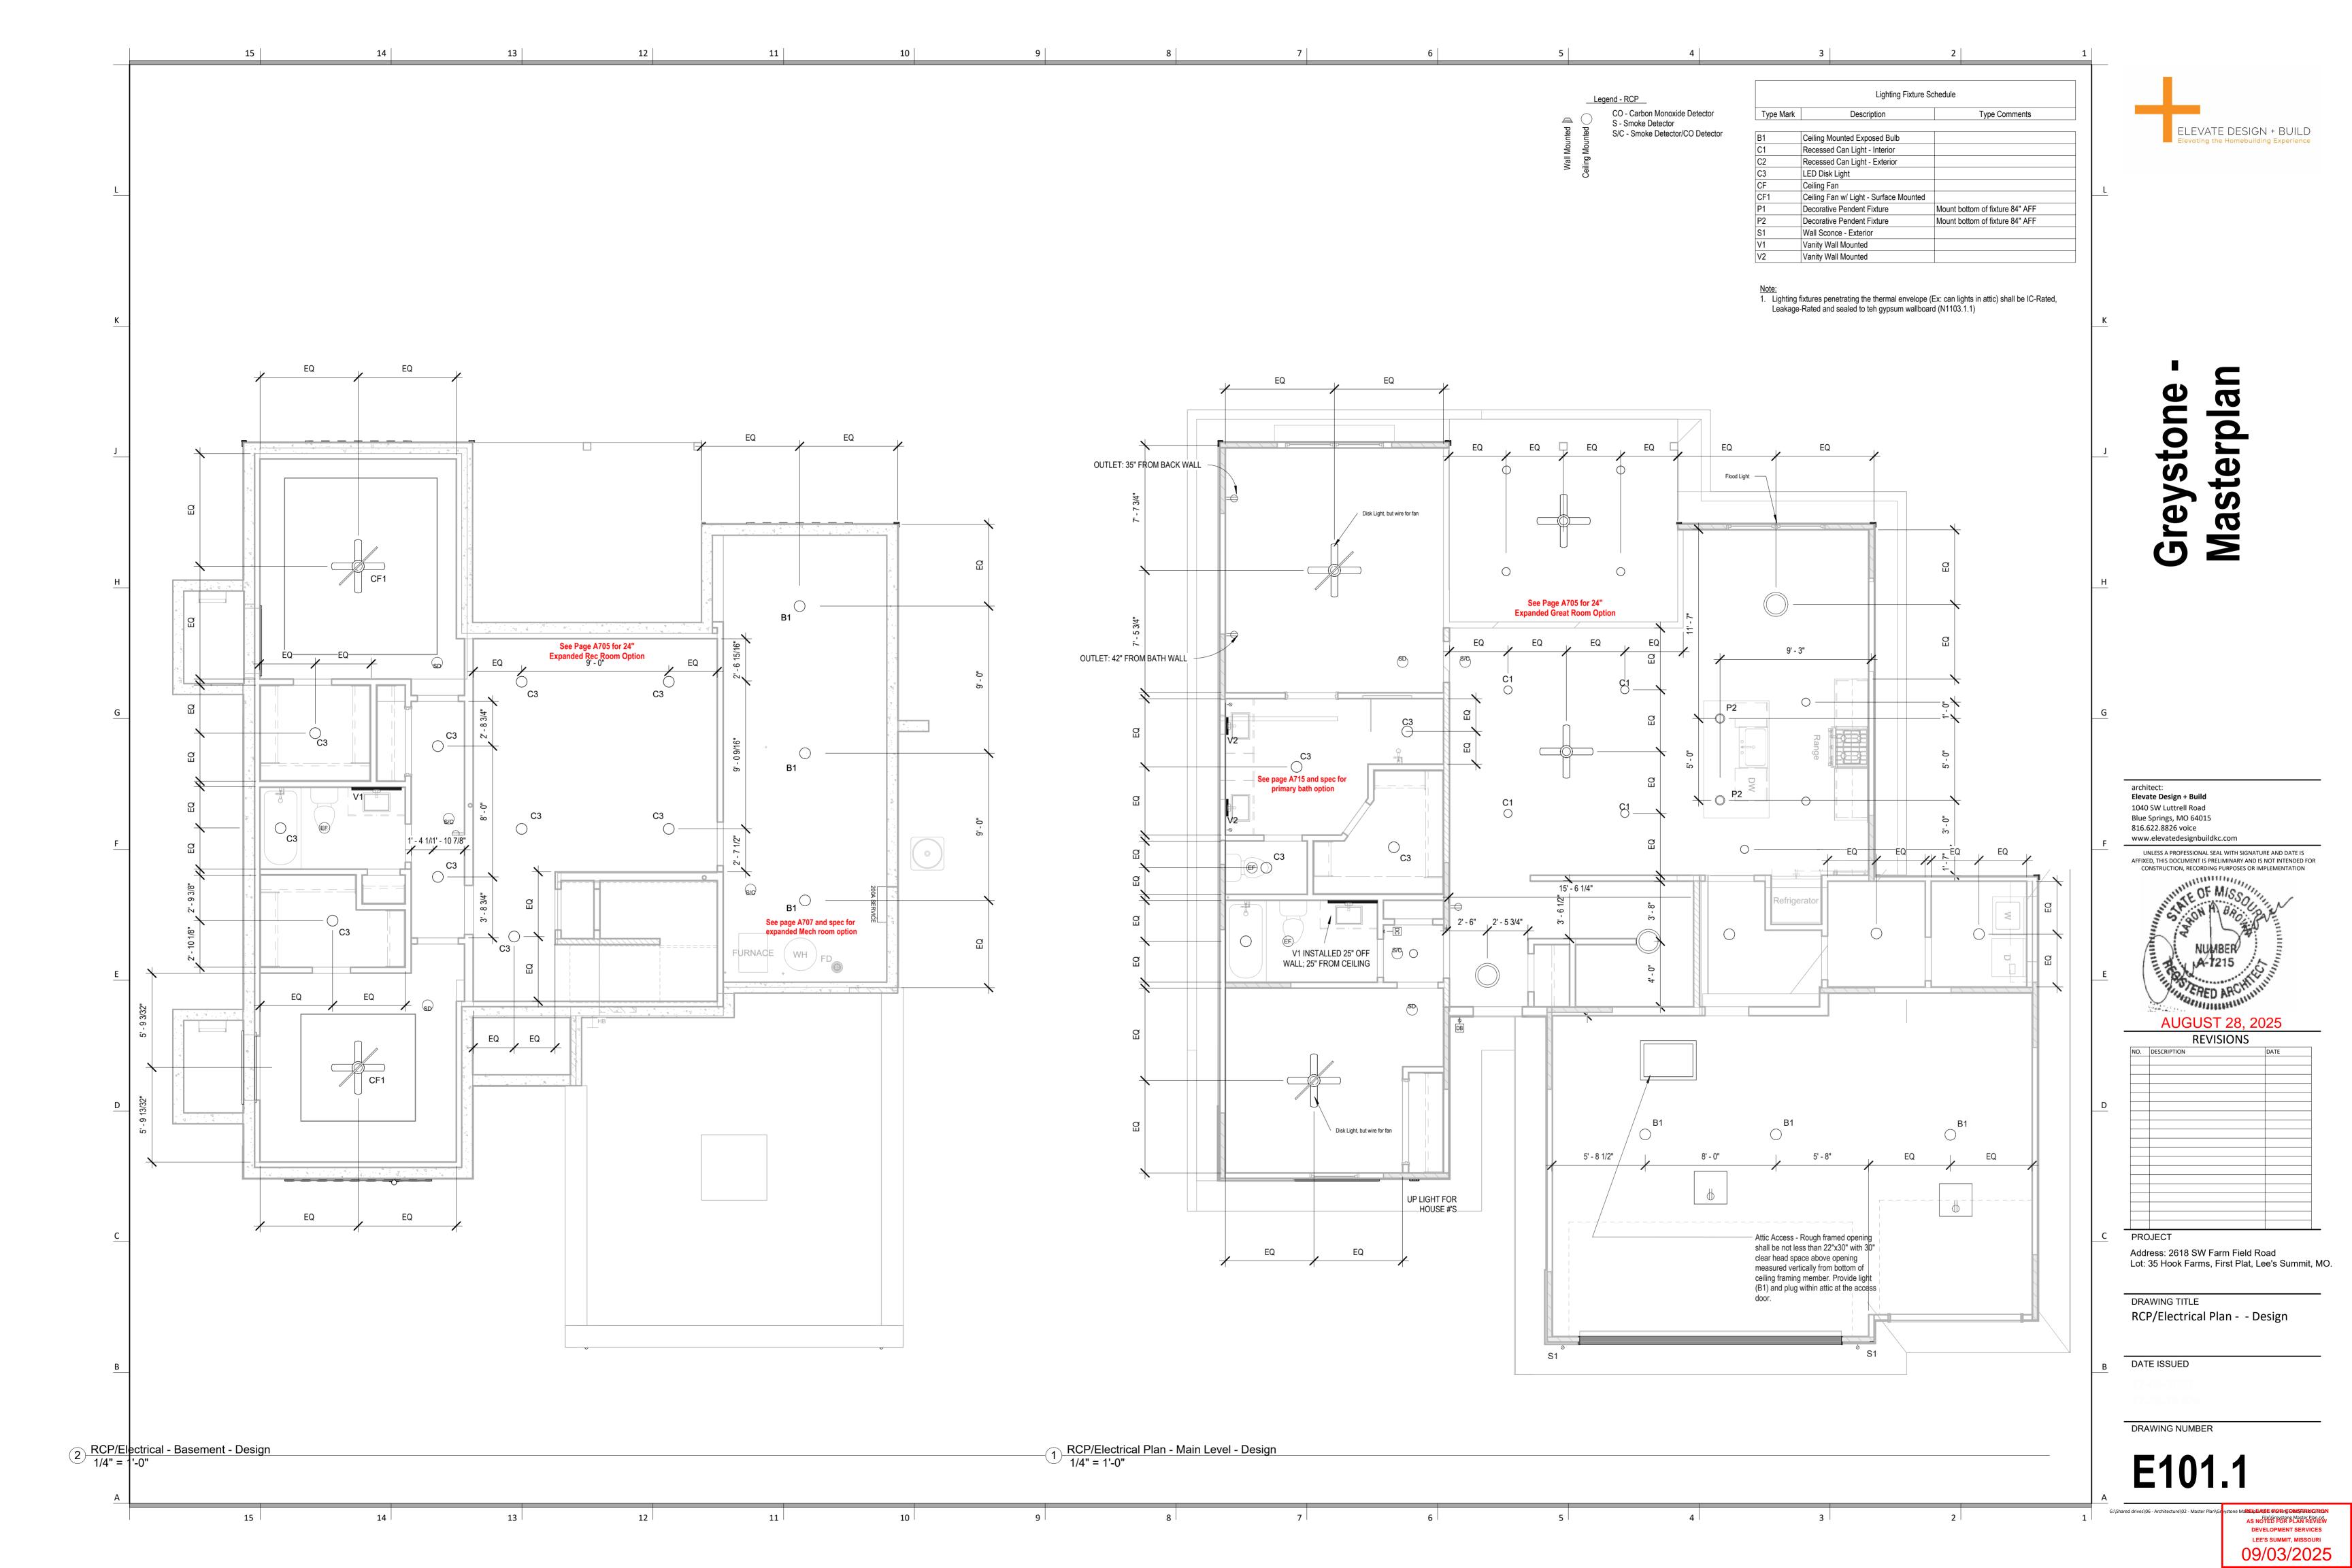



File\Greystone Master Plan.rvt
AS NOTED FOR PLAN REVIEW DEVELOPMENT SERVICES LEE'S SUMMIT, MISSOURI 09/03/2025

