U-0.55 MAX

R-49 MIN

R-38 MIN

R-30 MIN

R-19 MIN

R-10 for 24" MIN

90% AFUE MIN

No Minimum

13 SEER MIN

Doors & Windows: Glazing SHGF: Skylights: Roof

Attic Ceilings:

Vaults < 500sf:

Floor (over unconditioned):

Vaults:

Wood Frame Walls:

Fuel Fired Furnace: Electic Furnace:

Basement Walls:

Slab on Grade: Ductwork:

Cooling System:

An energy efficient certificate is required to be posted in or on the electrical panel before the final inspection. The certificate will be provided with all new residential permits. It is the permit holder/contractor's responsibility to ensure the before final inspection -- Owner/Contractor is responsibile for meeting the prescriptive requirments of IRC chapter 11 unless a HER Index Analysis for Performance Compliance based on the plans is submitted to the AHJ for

Ground Snow Load: Wind Speed: Topography Effects: Seismic Design Category: Damage From Weather: Frost Line Depth: 36 inches Winter Design Temperature: 6 F Ice Barrier Underlayment: Yes Flood Hazard: Air Freezing Index: Mean Annual Temperature: 55.5 F

- Whole House Mechanical Ventilation System is required for any dwelling with air infiltration at a rate of less than 5 air changes per hour (at ACH50 standard R303.4).
- 2. Carbon monoxide detectors required (R315) 3. Steel columns shall be minimum schedule 40
- 4. Deck Ledger attachment to house shall be per
- Tables 507.9.1.3. 5. New provisions for attachment of rafters, trusses and roof beams. (R802.3 and
- 6. Programmable thermostat required
- 7. Air handlers shall be rated for Maximum 2% air leakage rate (N1103.2.2.1)
- 8. Building cavities used as return air plenums shall be sealed to prevent leakage across the thermal envelope. (N1103.2.3) 9. Certain hot water pipes shall be insulated
- (N1103.4) 10. All exhaust fans shall terminate to the building exterior (M1507.2)
- 11. Makeup air system required for kitchen exhaust hoods that exceed 400 CFM M1503.4 12. Building cavities in a thermal envelope wall (including the wall between the house and garage) shall not be used as return air plenums (unless the required insulation and air
- barrier are maintained) (M1601.1.1,#7.5) 13. An air handling system shall not serve both the living space and the garage (M1601.6) 14. A concrete-Encased grounding electrode ('UFER' Ground) connection complies with the
- requirments of the 2018 IRC Section E3608.1.2 in providing a connection with no less than the required minimum of steel. 15. Compliance with the requirments and show connection as needed for roof beam, trus,
- rafter, and girder connections for uplift per IRC 16. Garage Door Rating: DASMA 115 MPH Rated
- 2018 IRC BUILDING CODE COMPLIANCE THESE DRAWINGS HAVE BEEN PREPARED WITH RESPECT TO COMPLIANCE OF THE 2018 IRC AND NEC 2017 ANY REFERENCES FOUND NOT CORRECTLY IDENTIFIED TO THESE CODES SHALL BE BROUGHT TO THE ATTENTION OF SSIONAL THE DESIGN PROFESSIONAL


| | | | Area - W/ Extend | ed pantry |
|-------------|-------------|---------------|---------------------|-----------|
| 3 | | | Name | Area |
| | <u>Deck</u> | _ | Basement Finished | 766 SF |
| | 152 SF | | Living Area | 1401 SF |
| | 102.01 | 12 SF for | Dining Buffet | 12 SF |
| | | Dining Buffet | | 2180 SF |
| | | T v | Basement Unfinished | 399 SF |
| nt Finished | | | Deck | 152 SF |
| 6 SF | Living Area | | Front Porch | 24 SF |
| | 1401 SF | | Garage | 761 SF |
| | | | Deck | 152 SF |
| | | | | 1336 SF |
| | | | | |
| | | | | |

Main Level Area - W/ Extended pantry

1/16" = 1'-0"

| Basement Finished 766 SF | |
|----------------------------|--------------------------|
| | • |
| Bas | sement Unfinished 399 SF |
| Basement Unfinished 236 SF | |


Basement Area - W/ Extended pantry
1/16" = 1'-0"

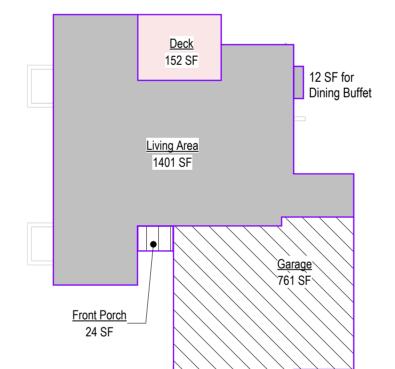

| ront Porch24 SF | 76135 |
|-----------------|-------|
| | |

| 1 A101 | BUILDING SECTION |
|-------------|------------------------|
| SIM A101 | WALL SECTION |
| 1 A101 | DETAIL SECTION |
| SIM A101 | DETAIL REFERENCE |
| A1/A101 | EXTERIOR ELEVATION TAG |

Lot 34 Hook Farms

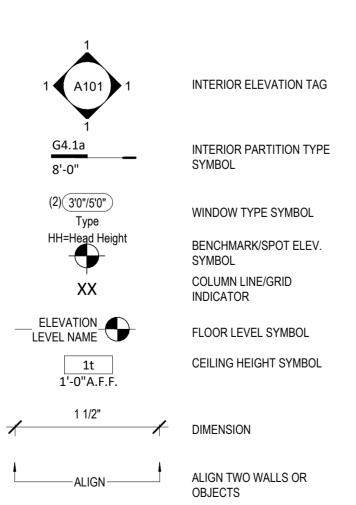

Greystone - Masterplan

Address: 2622 SW Farm Field Road, Lee's Summit, MO.

| ۲ | Change/Revision log: |
|---|---|
| ک | 2025/07/25: |
| > | The Area Chart has been updated per new contract. |
| ۲ | 2. Front elevation changed to Farmhouse (ELV018+STR002+STR043). |
| > | 3. Roof type changed to Farmhouse |
| \ | 4. The Daylight well option has been removed. |
| > | 5. Extended Rec room has been changed to a smaller Rec room finish and a larger storage with expanded mech room under pantry. |
| ≻ | 6. The Primary bath option has been changed to STR010. |
| } | 7. The bedroom #4 in Basement has been removed. |
| > | 8. MEP option references have been updated accordingly. |
| > | 2025/08/07: |
| > | |

1. Changed label for basement bedroom from Bedroom #4 to Bedroom #3

1. Changed the full basement to a daylight basement, and updated all the pages

RELEASE FOR CONSTRUCTION **AS NOTED ON PLANS REVIEW DEVELOPMENT SERVICES** LEE'S SUMMIT, MISSOURI 08/26/2025 8:31:57




Greystone


| | | Permit Set |
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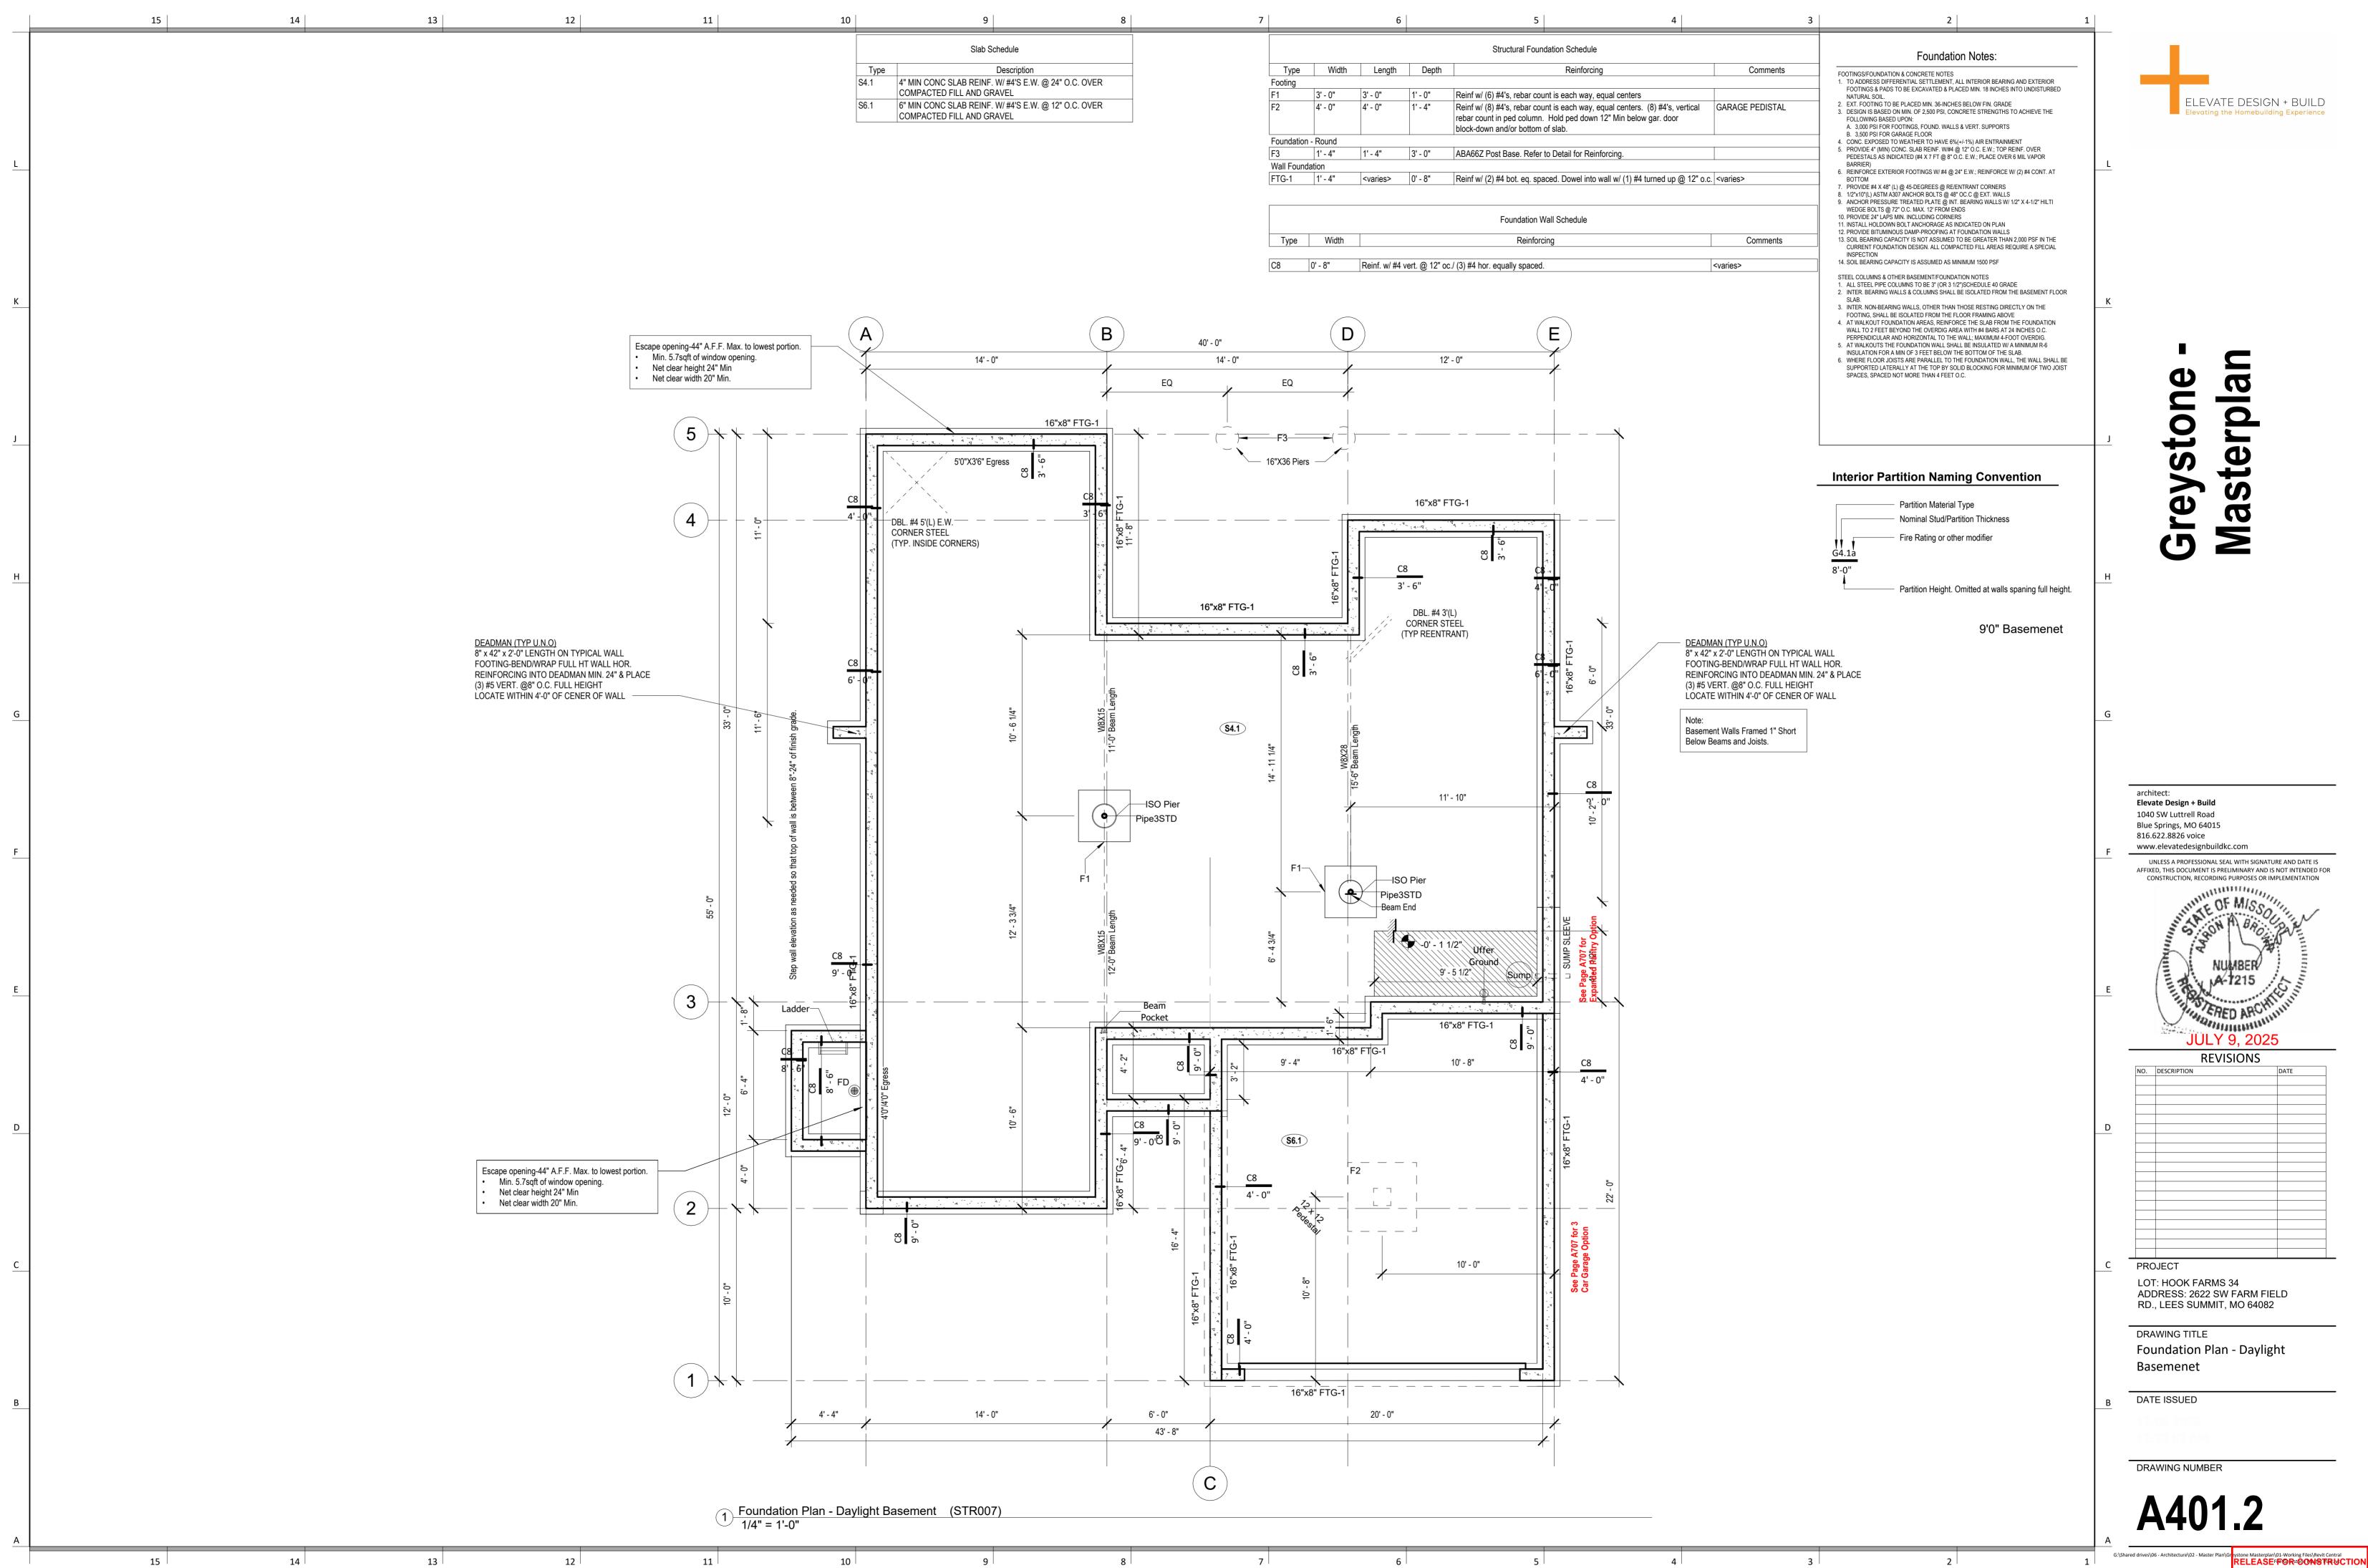
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PLAN DESCRIPTION: Cover Sheet


| | Sheet List |
|----------|--|
| Sheet No | Sheet Name |
| 00 | Cover Sheet |
| A101 | Front Elevations |
| A102 | Front Elevations |
| A103 | Front Elevations |
| A301 | Side Elevations - Full Basement |
| A302 | Side Elevations - Daylight Basement |
| A303 | Side Elevations - Walkout Basement |
| A401 | Side Elevations - Full Basement |
| A402 | Side Elevations - Daylight Basement |
| A501 | Floor Plan - Main Level |
| A502 | Floor Plan - Main Level |
| A503 | Floor Plan - Main Level |
| A601 | Roof Plan |
| A602 | Roof Plan |
| A701 | POD Options |
| A702 | POD Options |
| A703 | POD Options |
| A704 | POD Options |
| A705 | Floor Plan - Basement |
| A706 | Front Elevations |
| A707 | Floor Plan - Basement |
| A708 | Side Elevations - Full Basement |
| A709 | Roof Plan |
| A710 | Floor Plan - Basement |
| A711 | Side Elevations - Full Basement |
| A712 | Roof Plan |
| A714 | POD Options |
| A715 | Front Elevations |
| A716 | Cover Sheet |
| A801 | Details |
| A802 | Details |
| A803 | Details |
| E101 | RCP/Electrical Plan |
| E102 | RCP/Electrical Plan - Structural Option |
| M102 | Floor Plan - Structural POD Options 24" Extension HVAC |
| P101 | RCP/Electrical Plan |






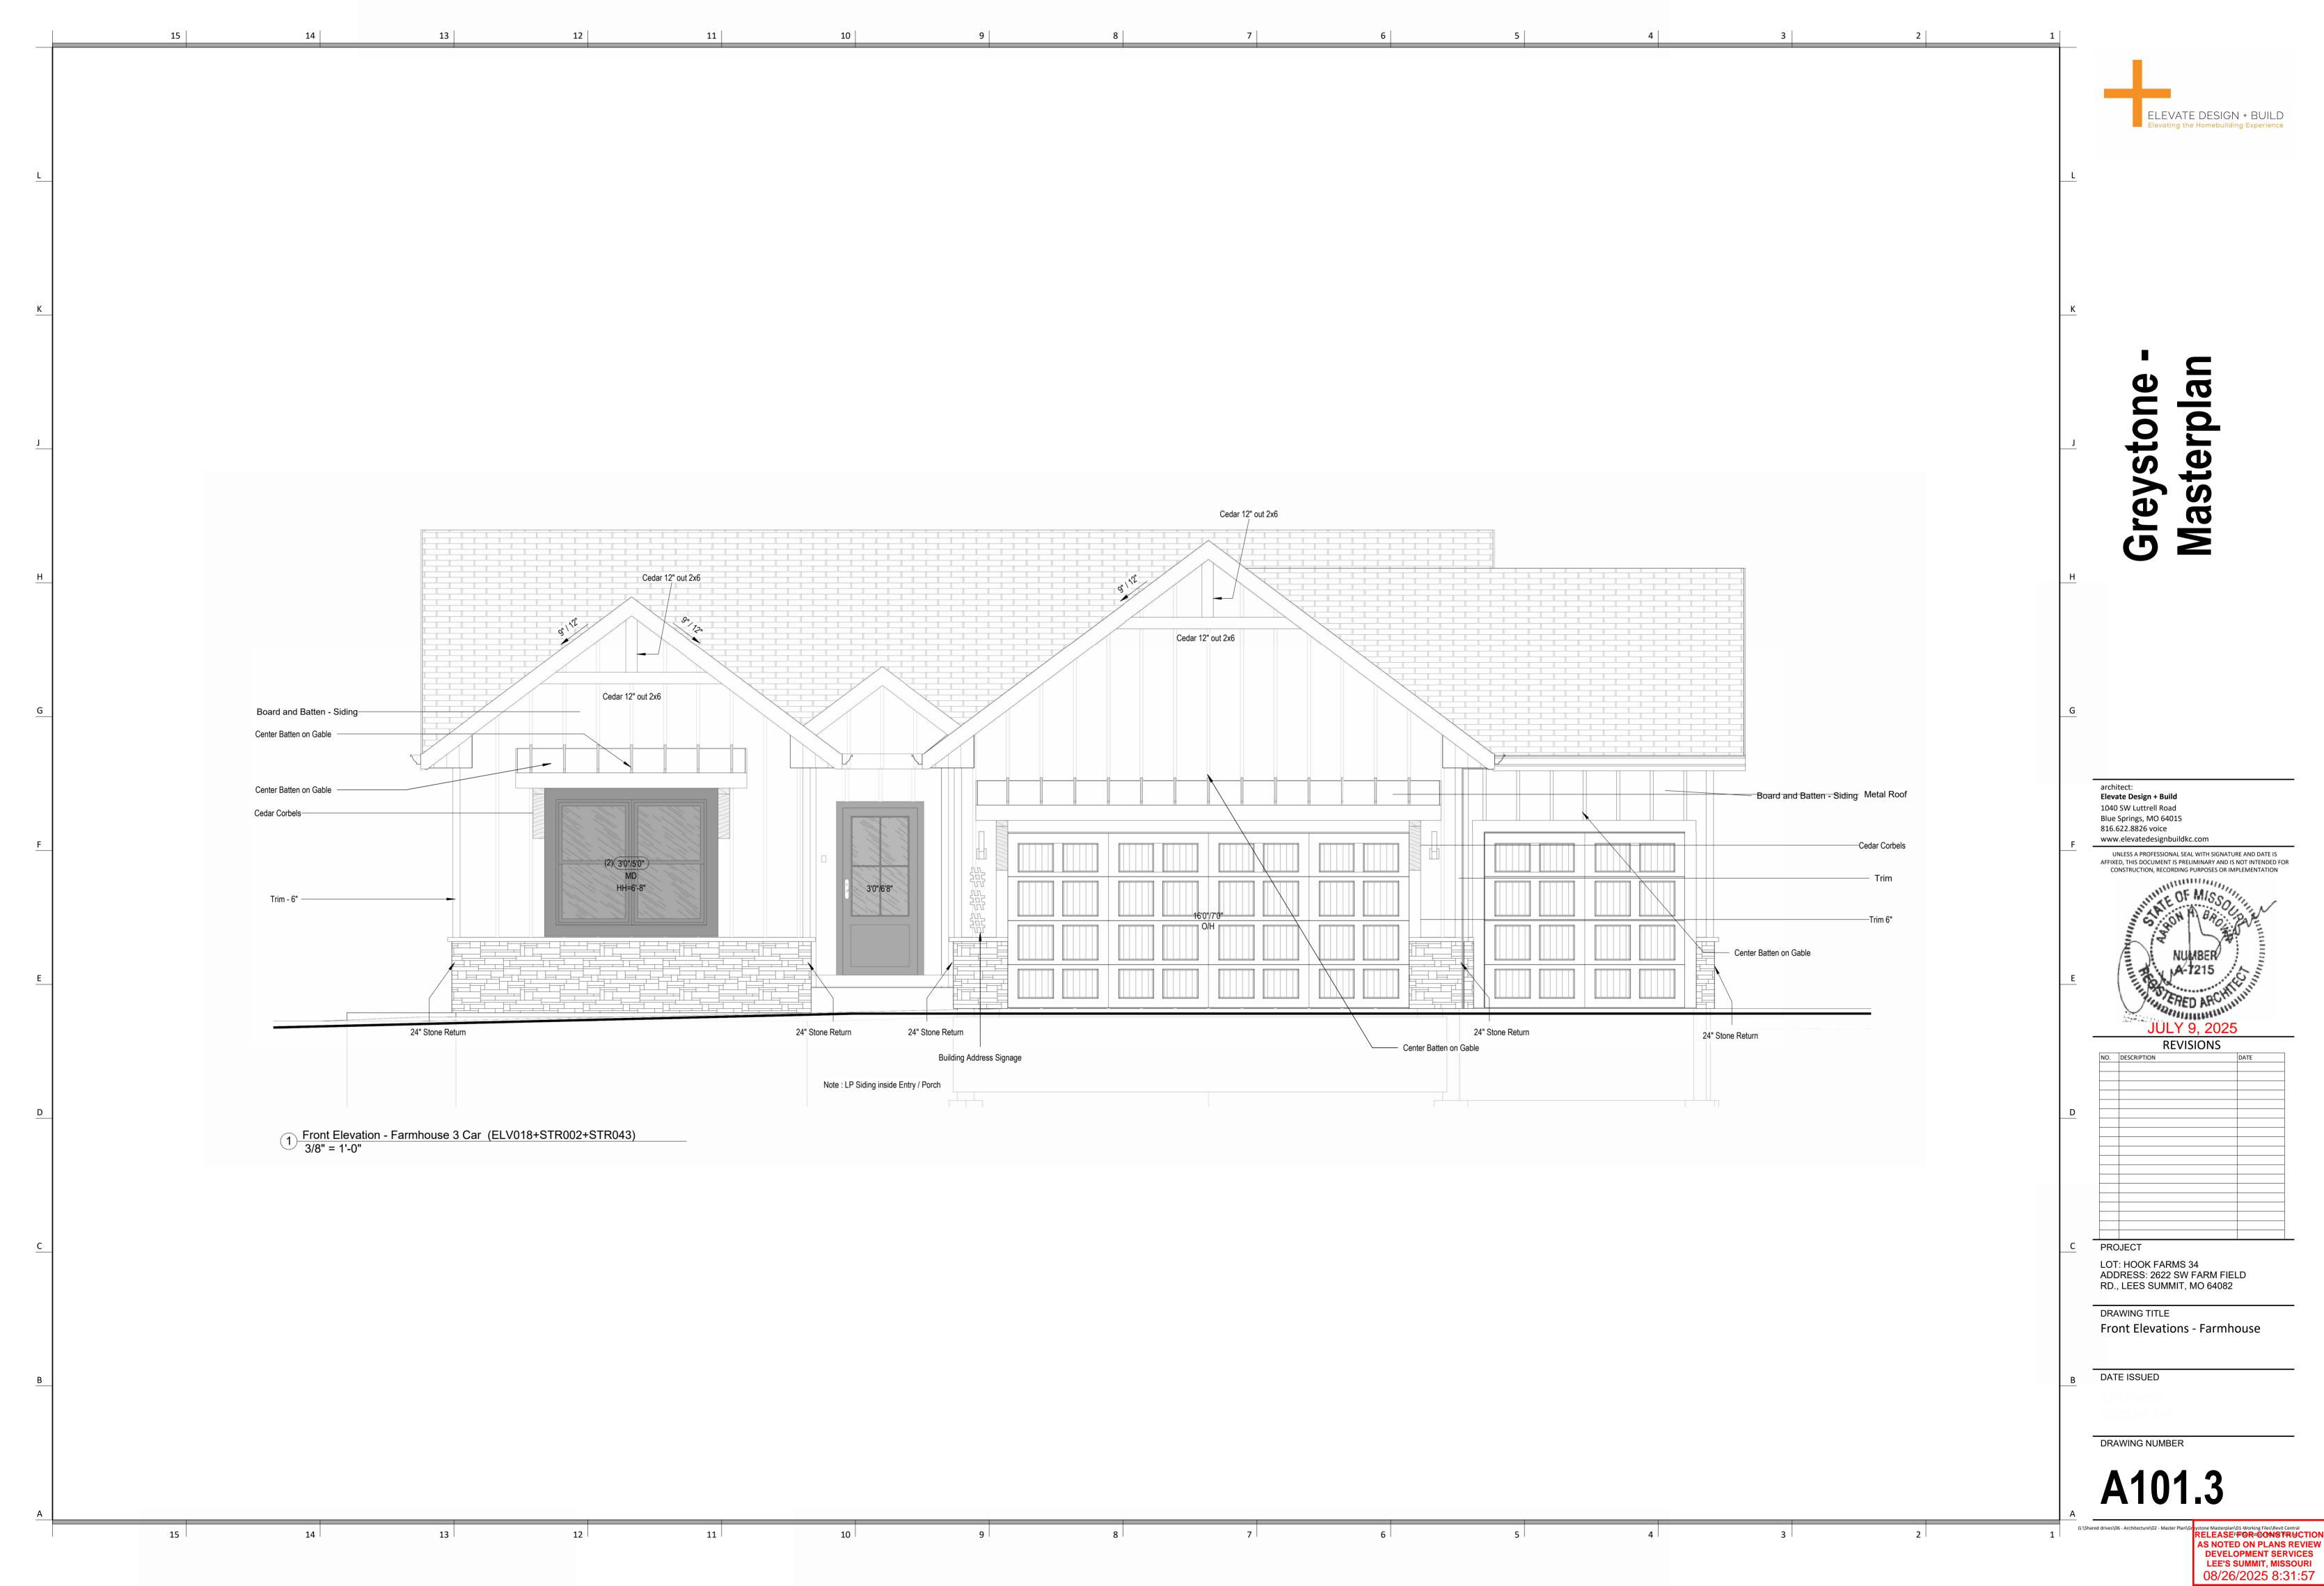


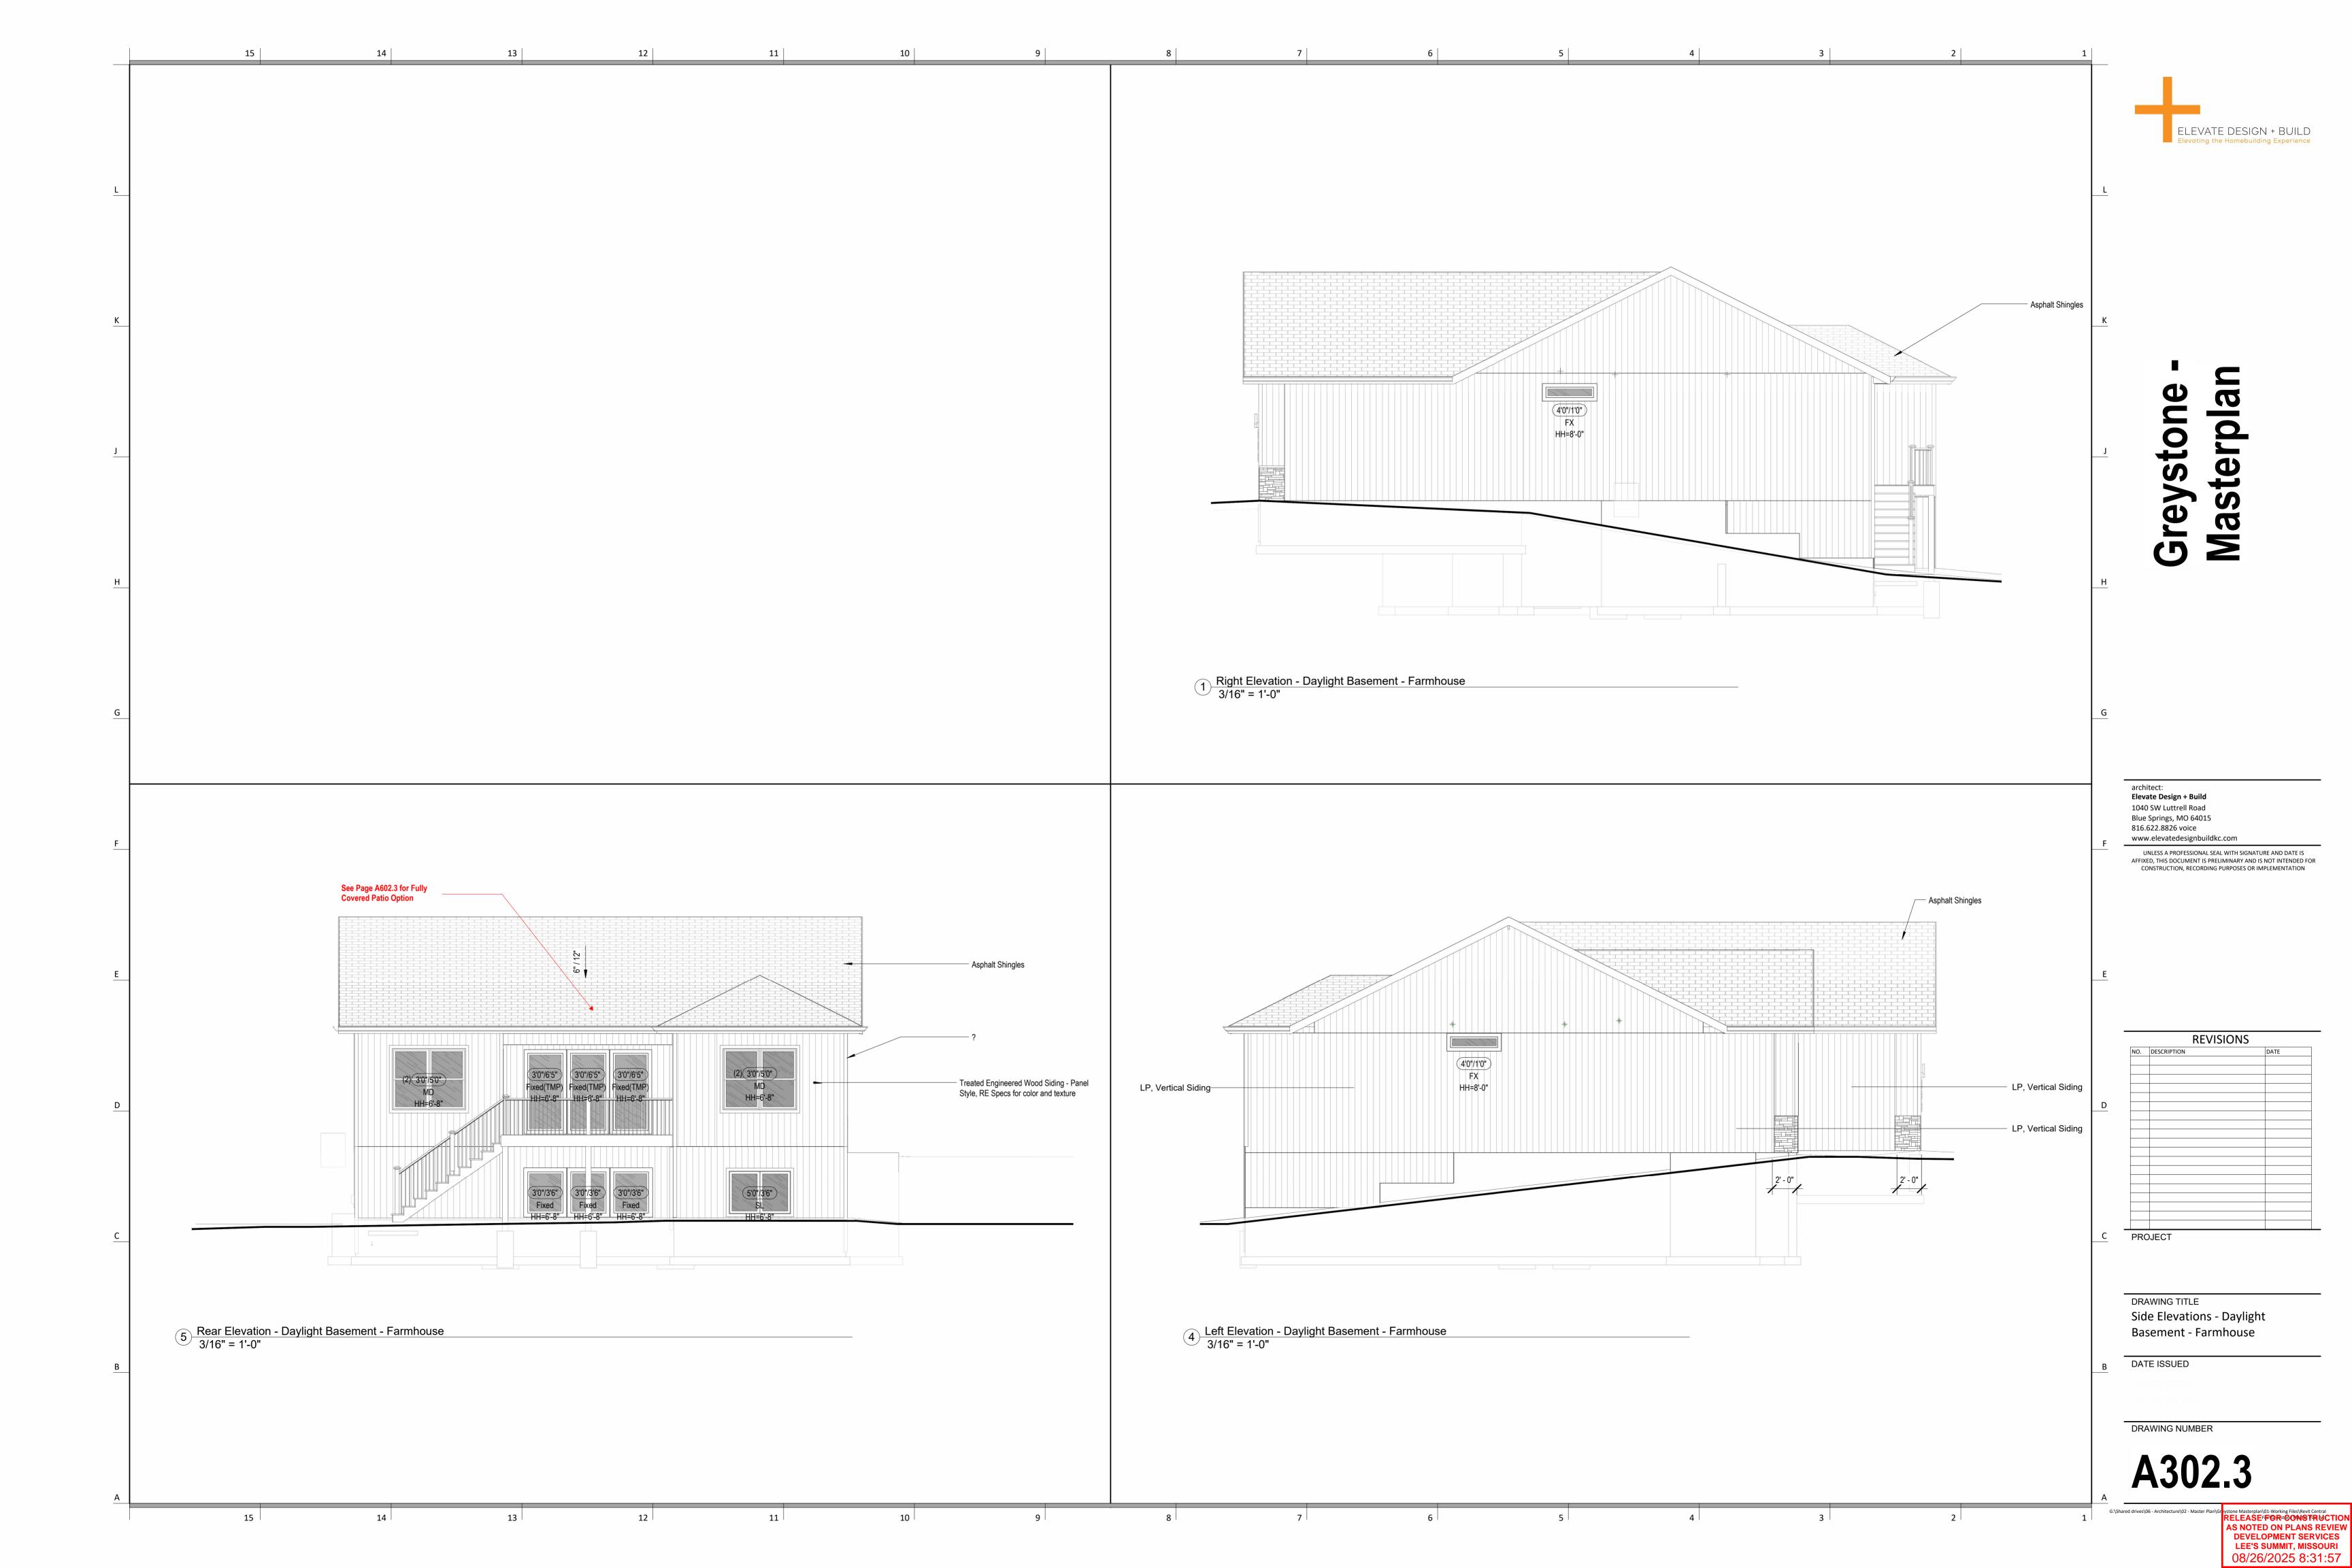
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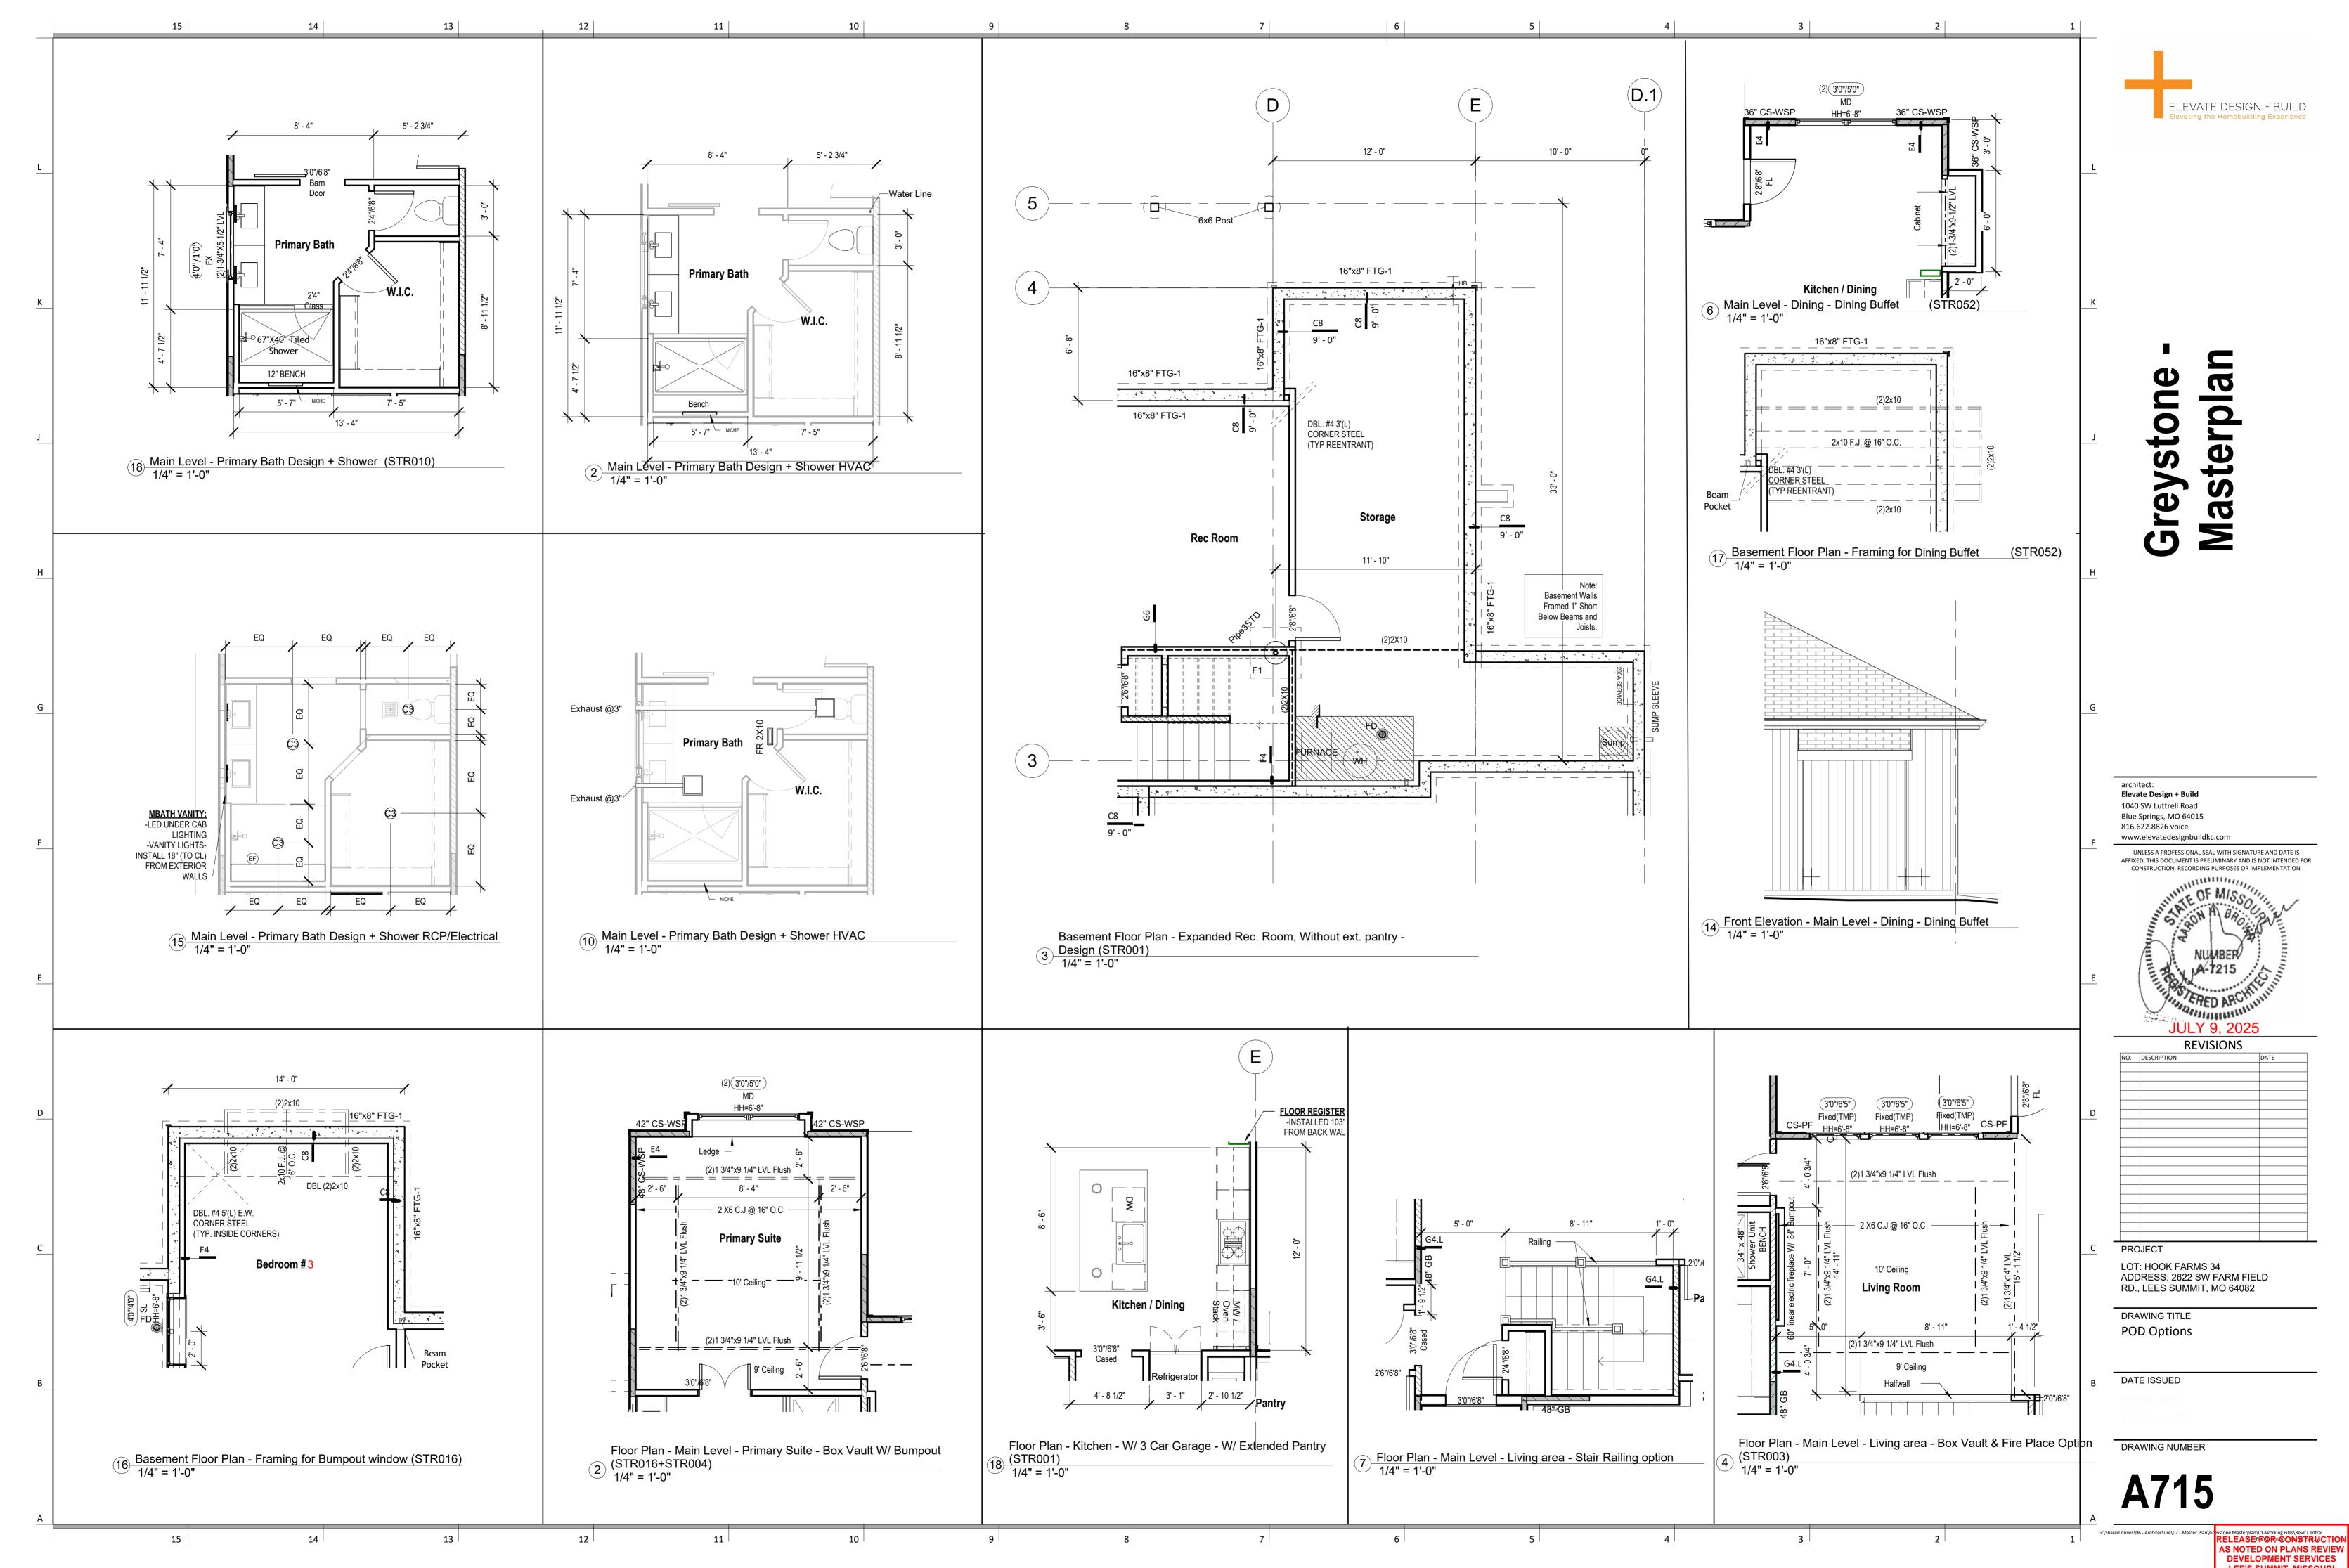

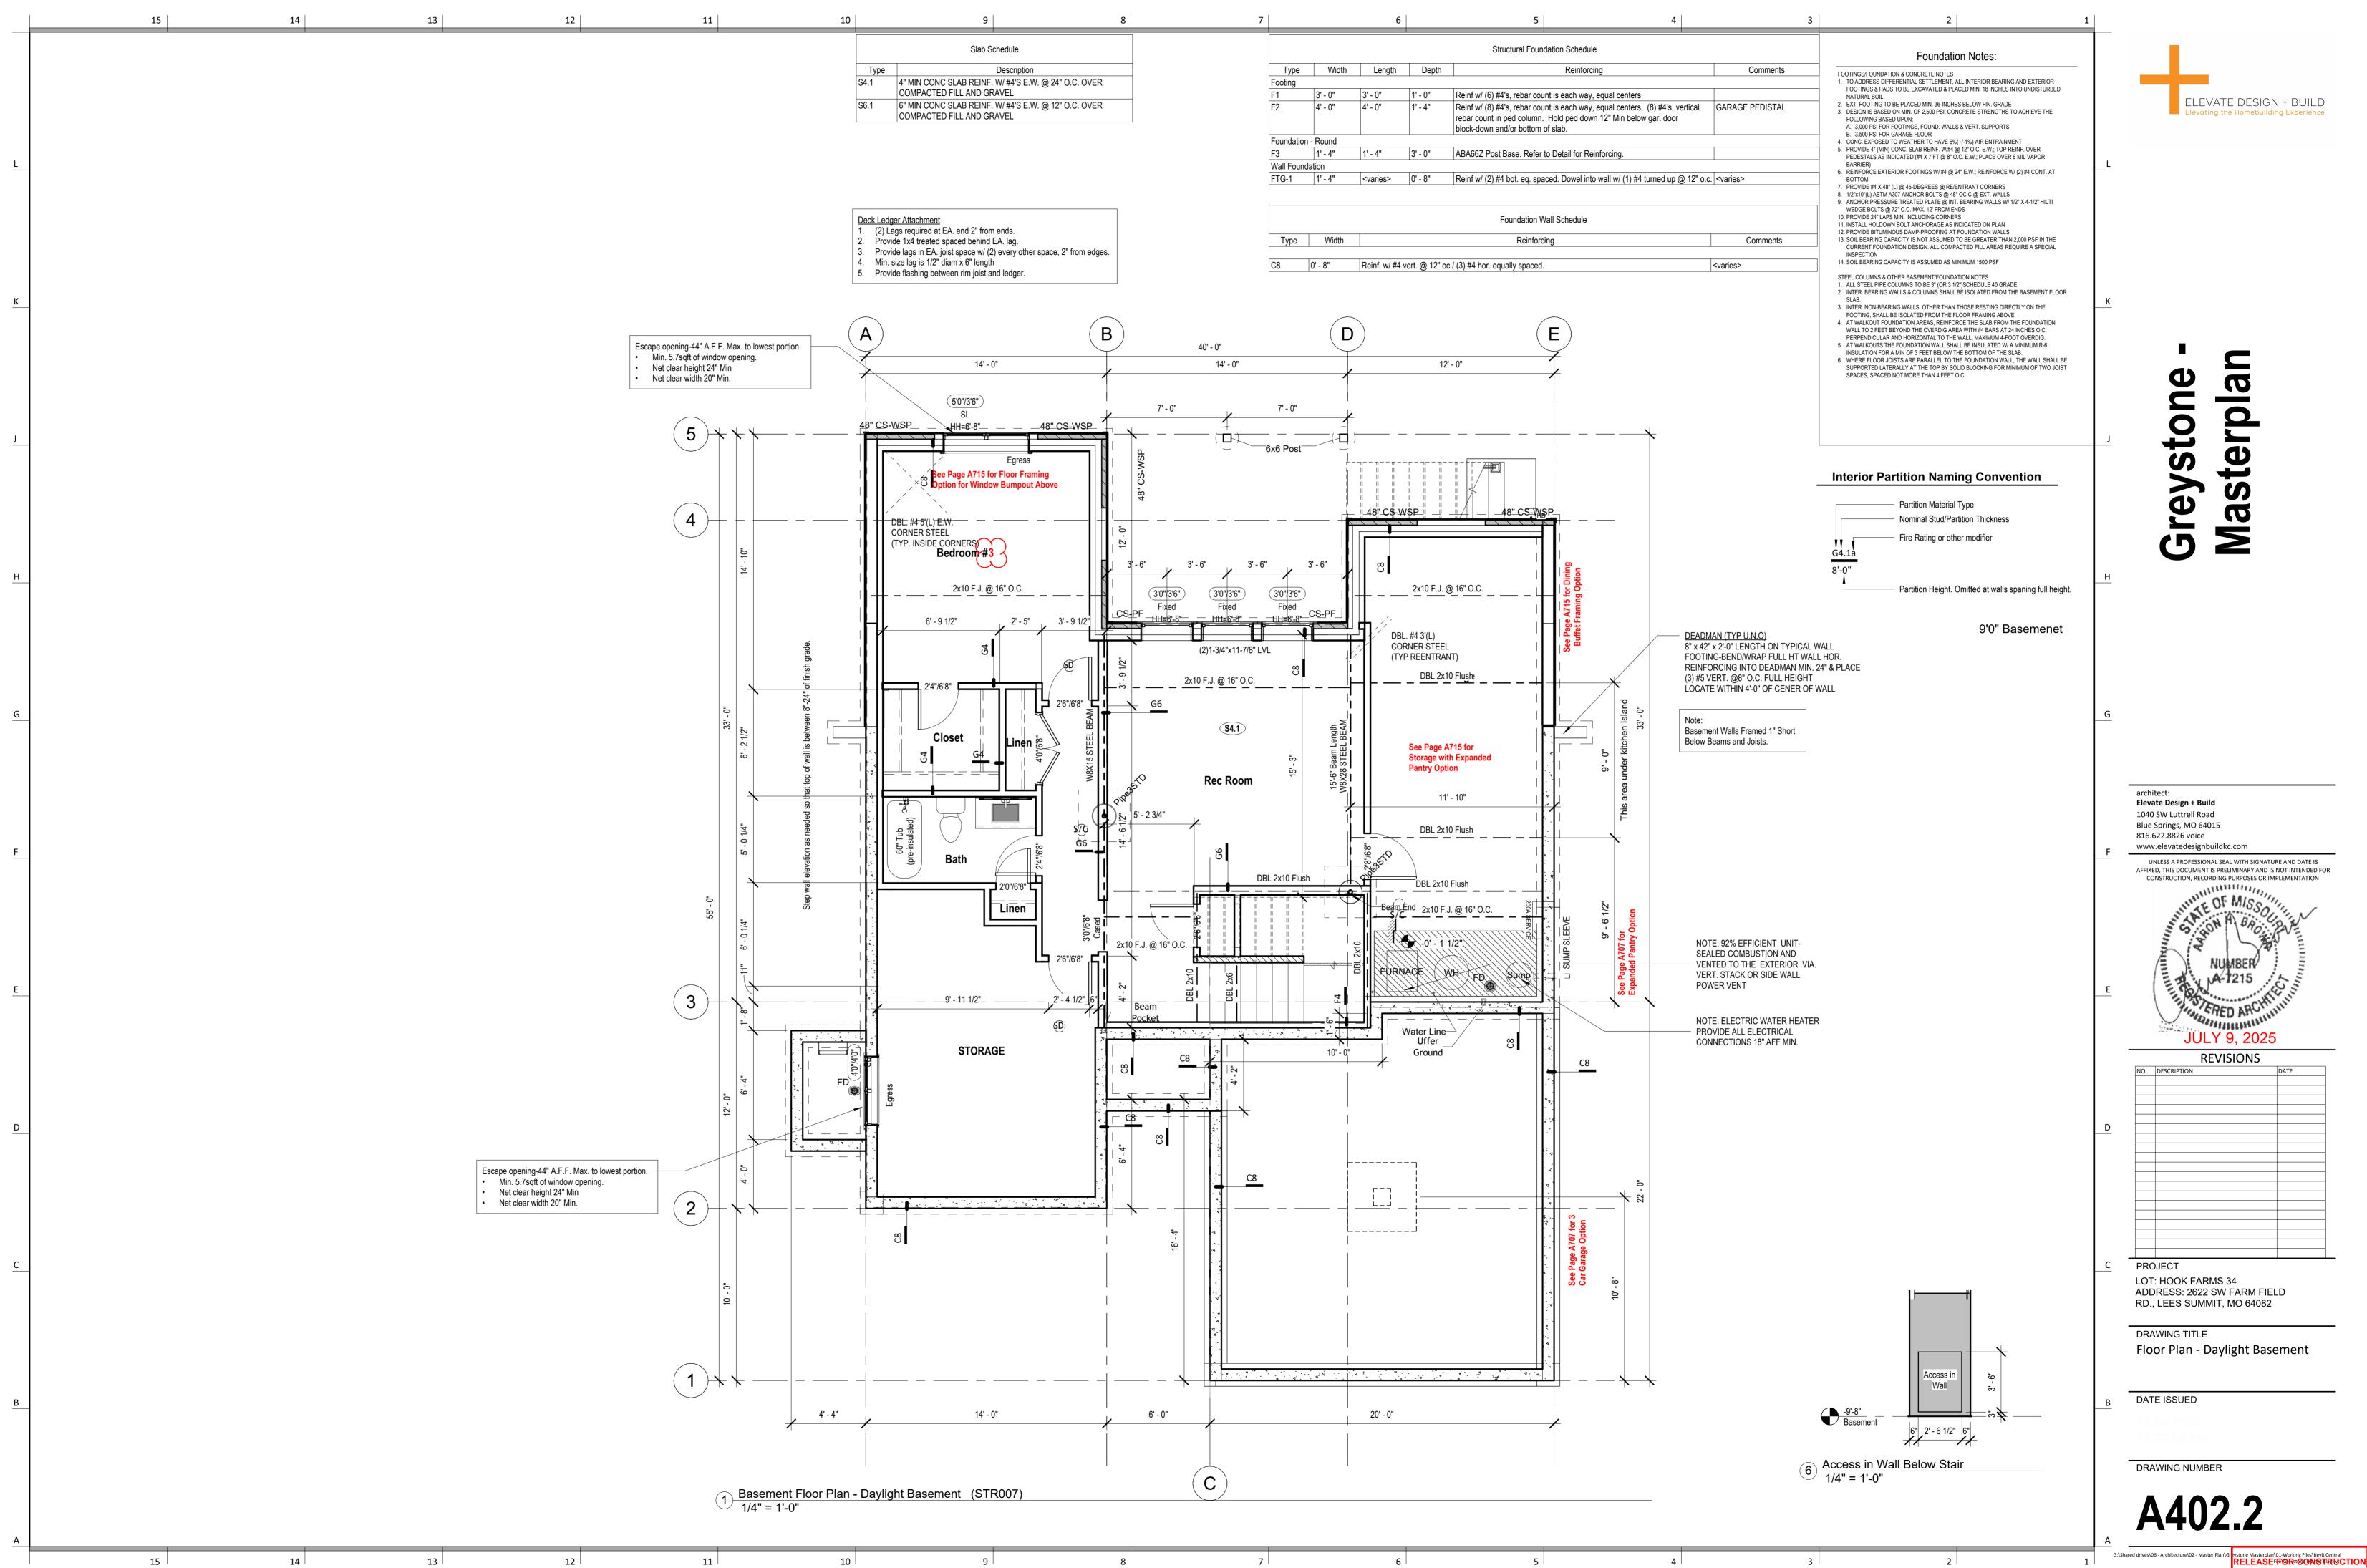
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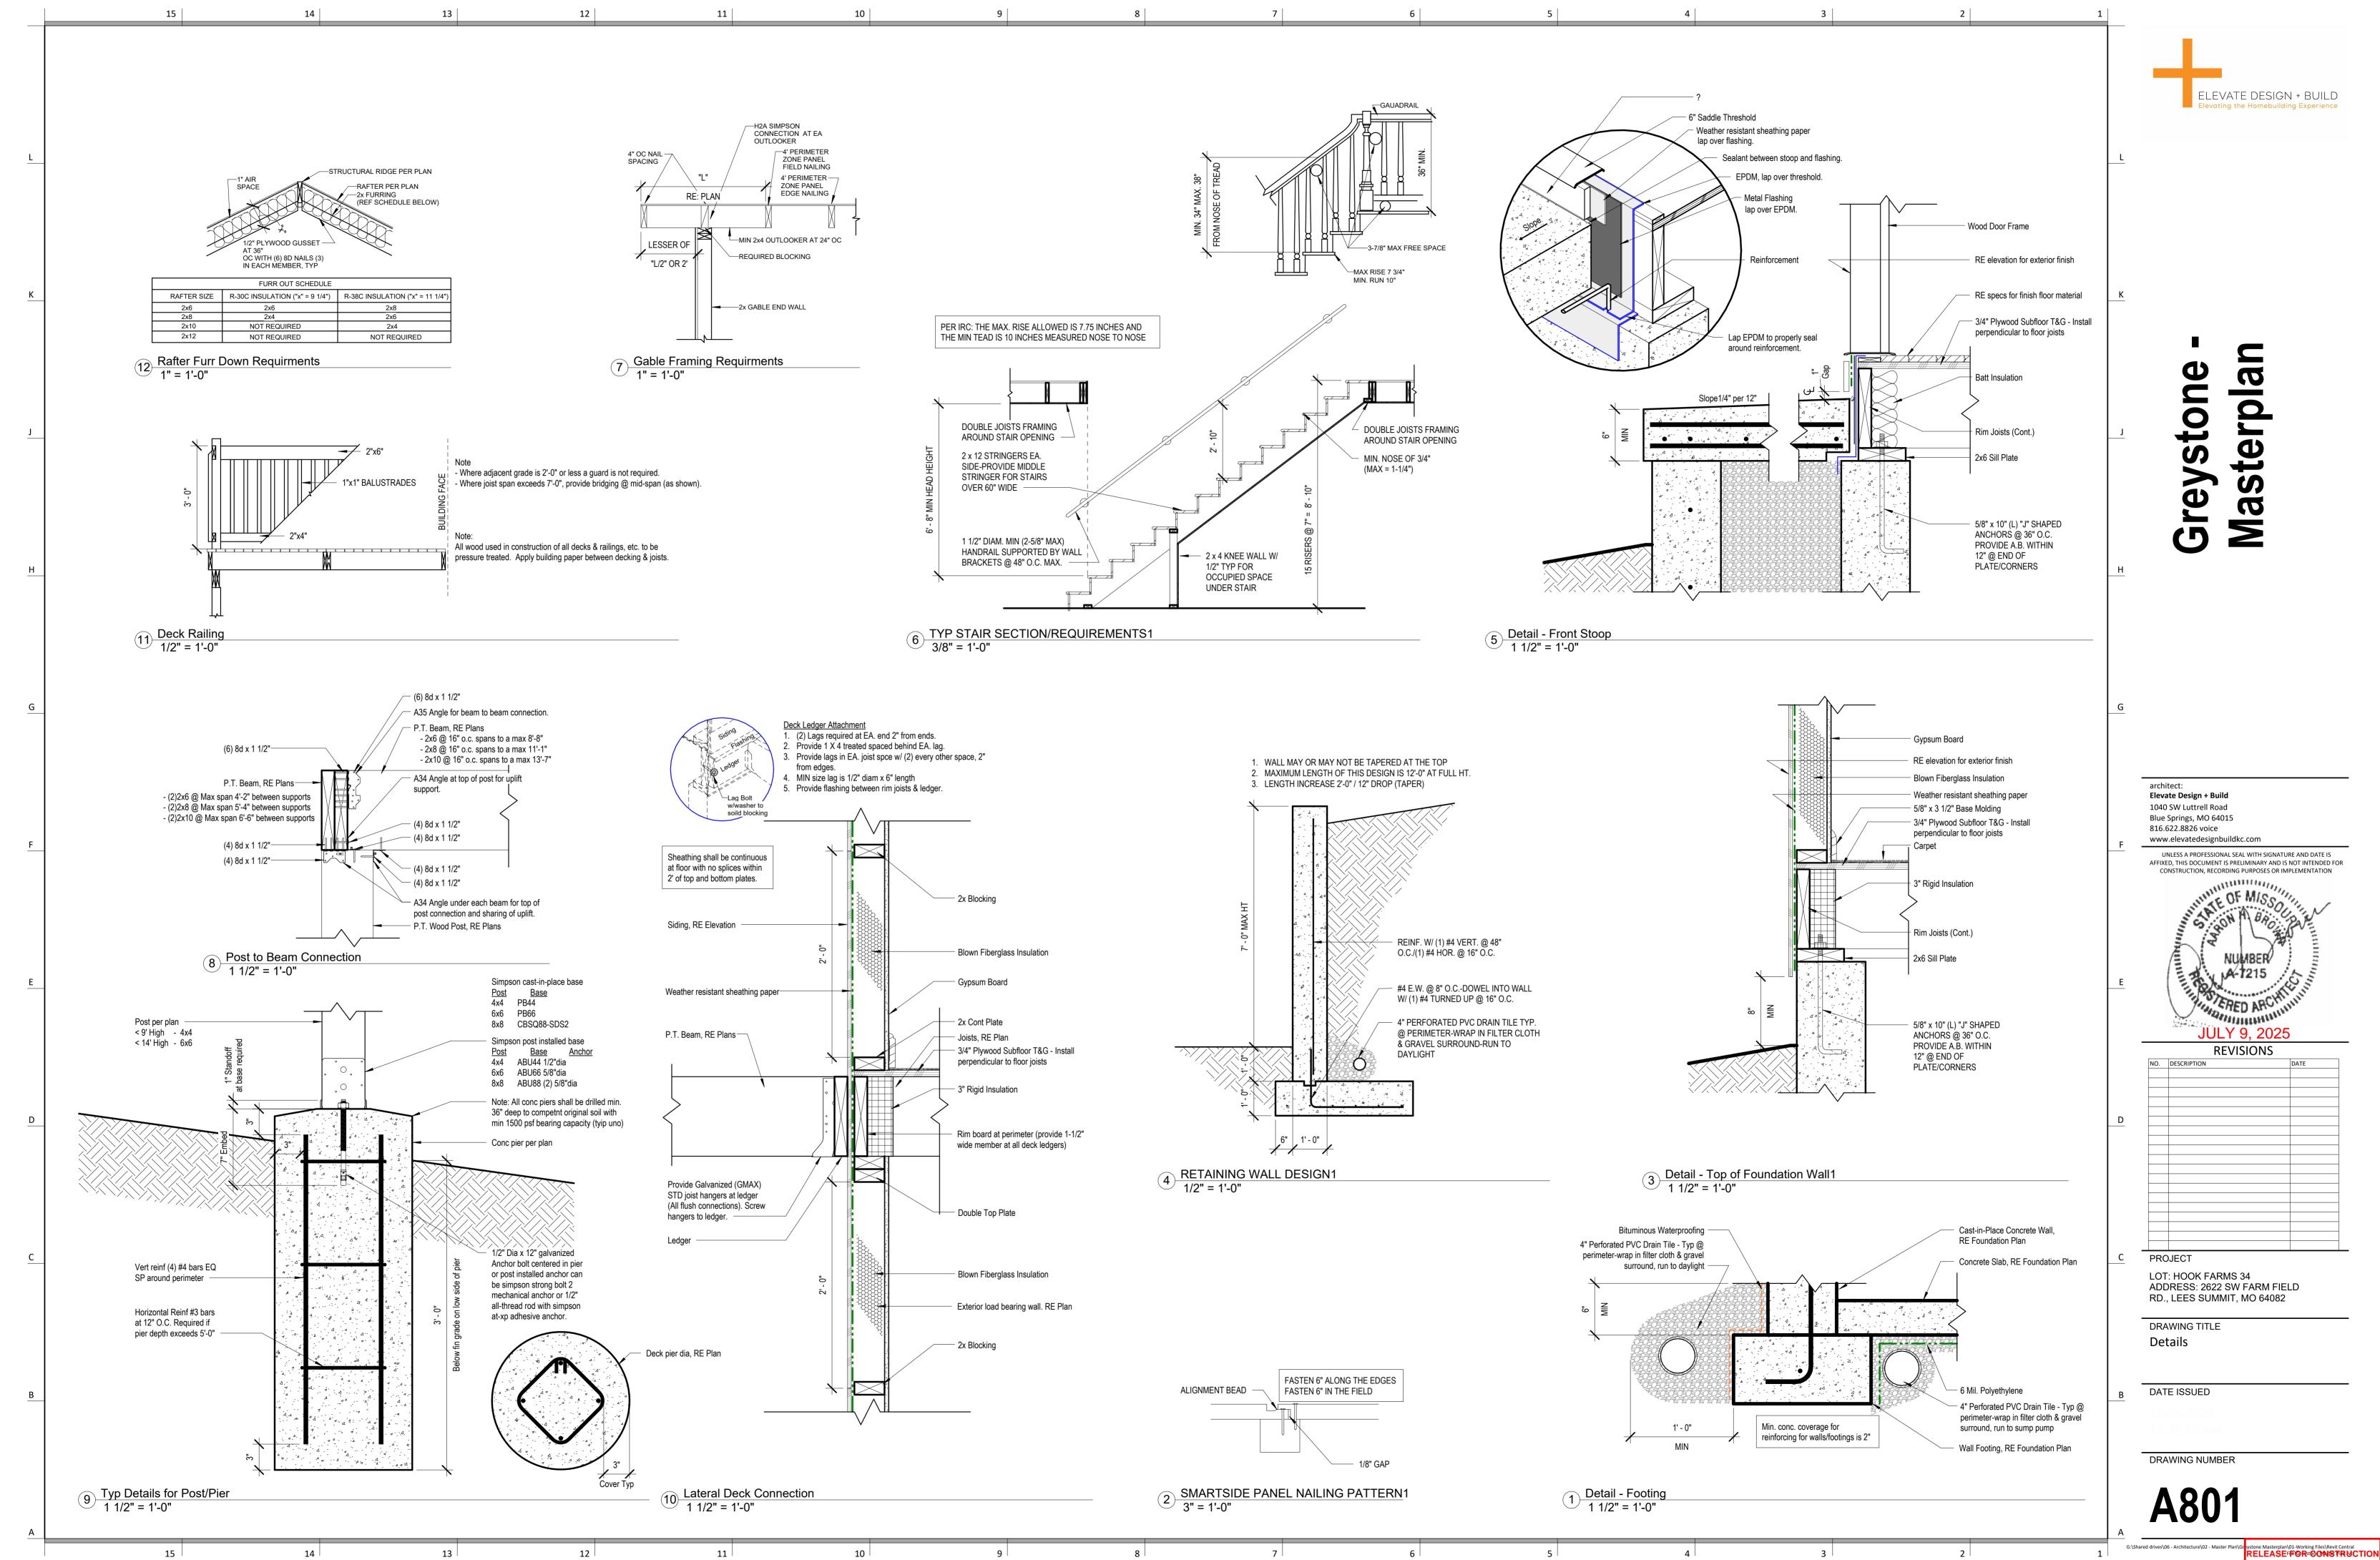




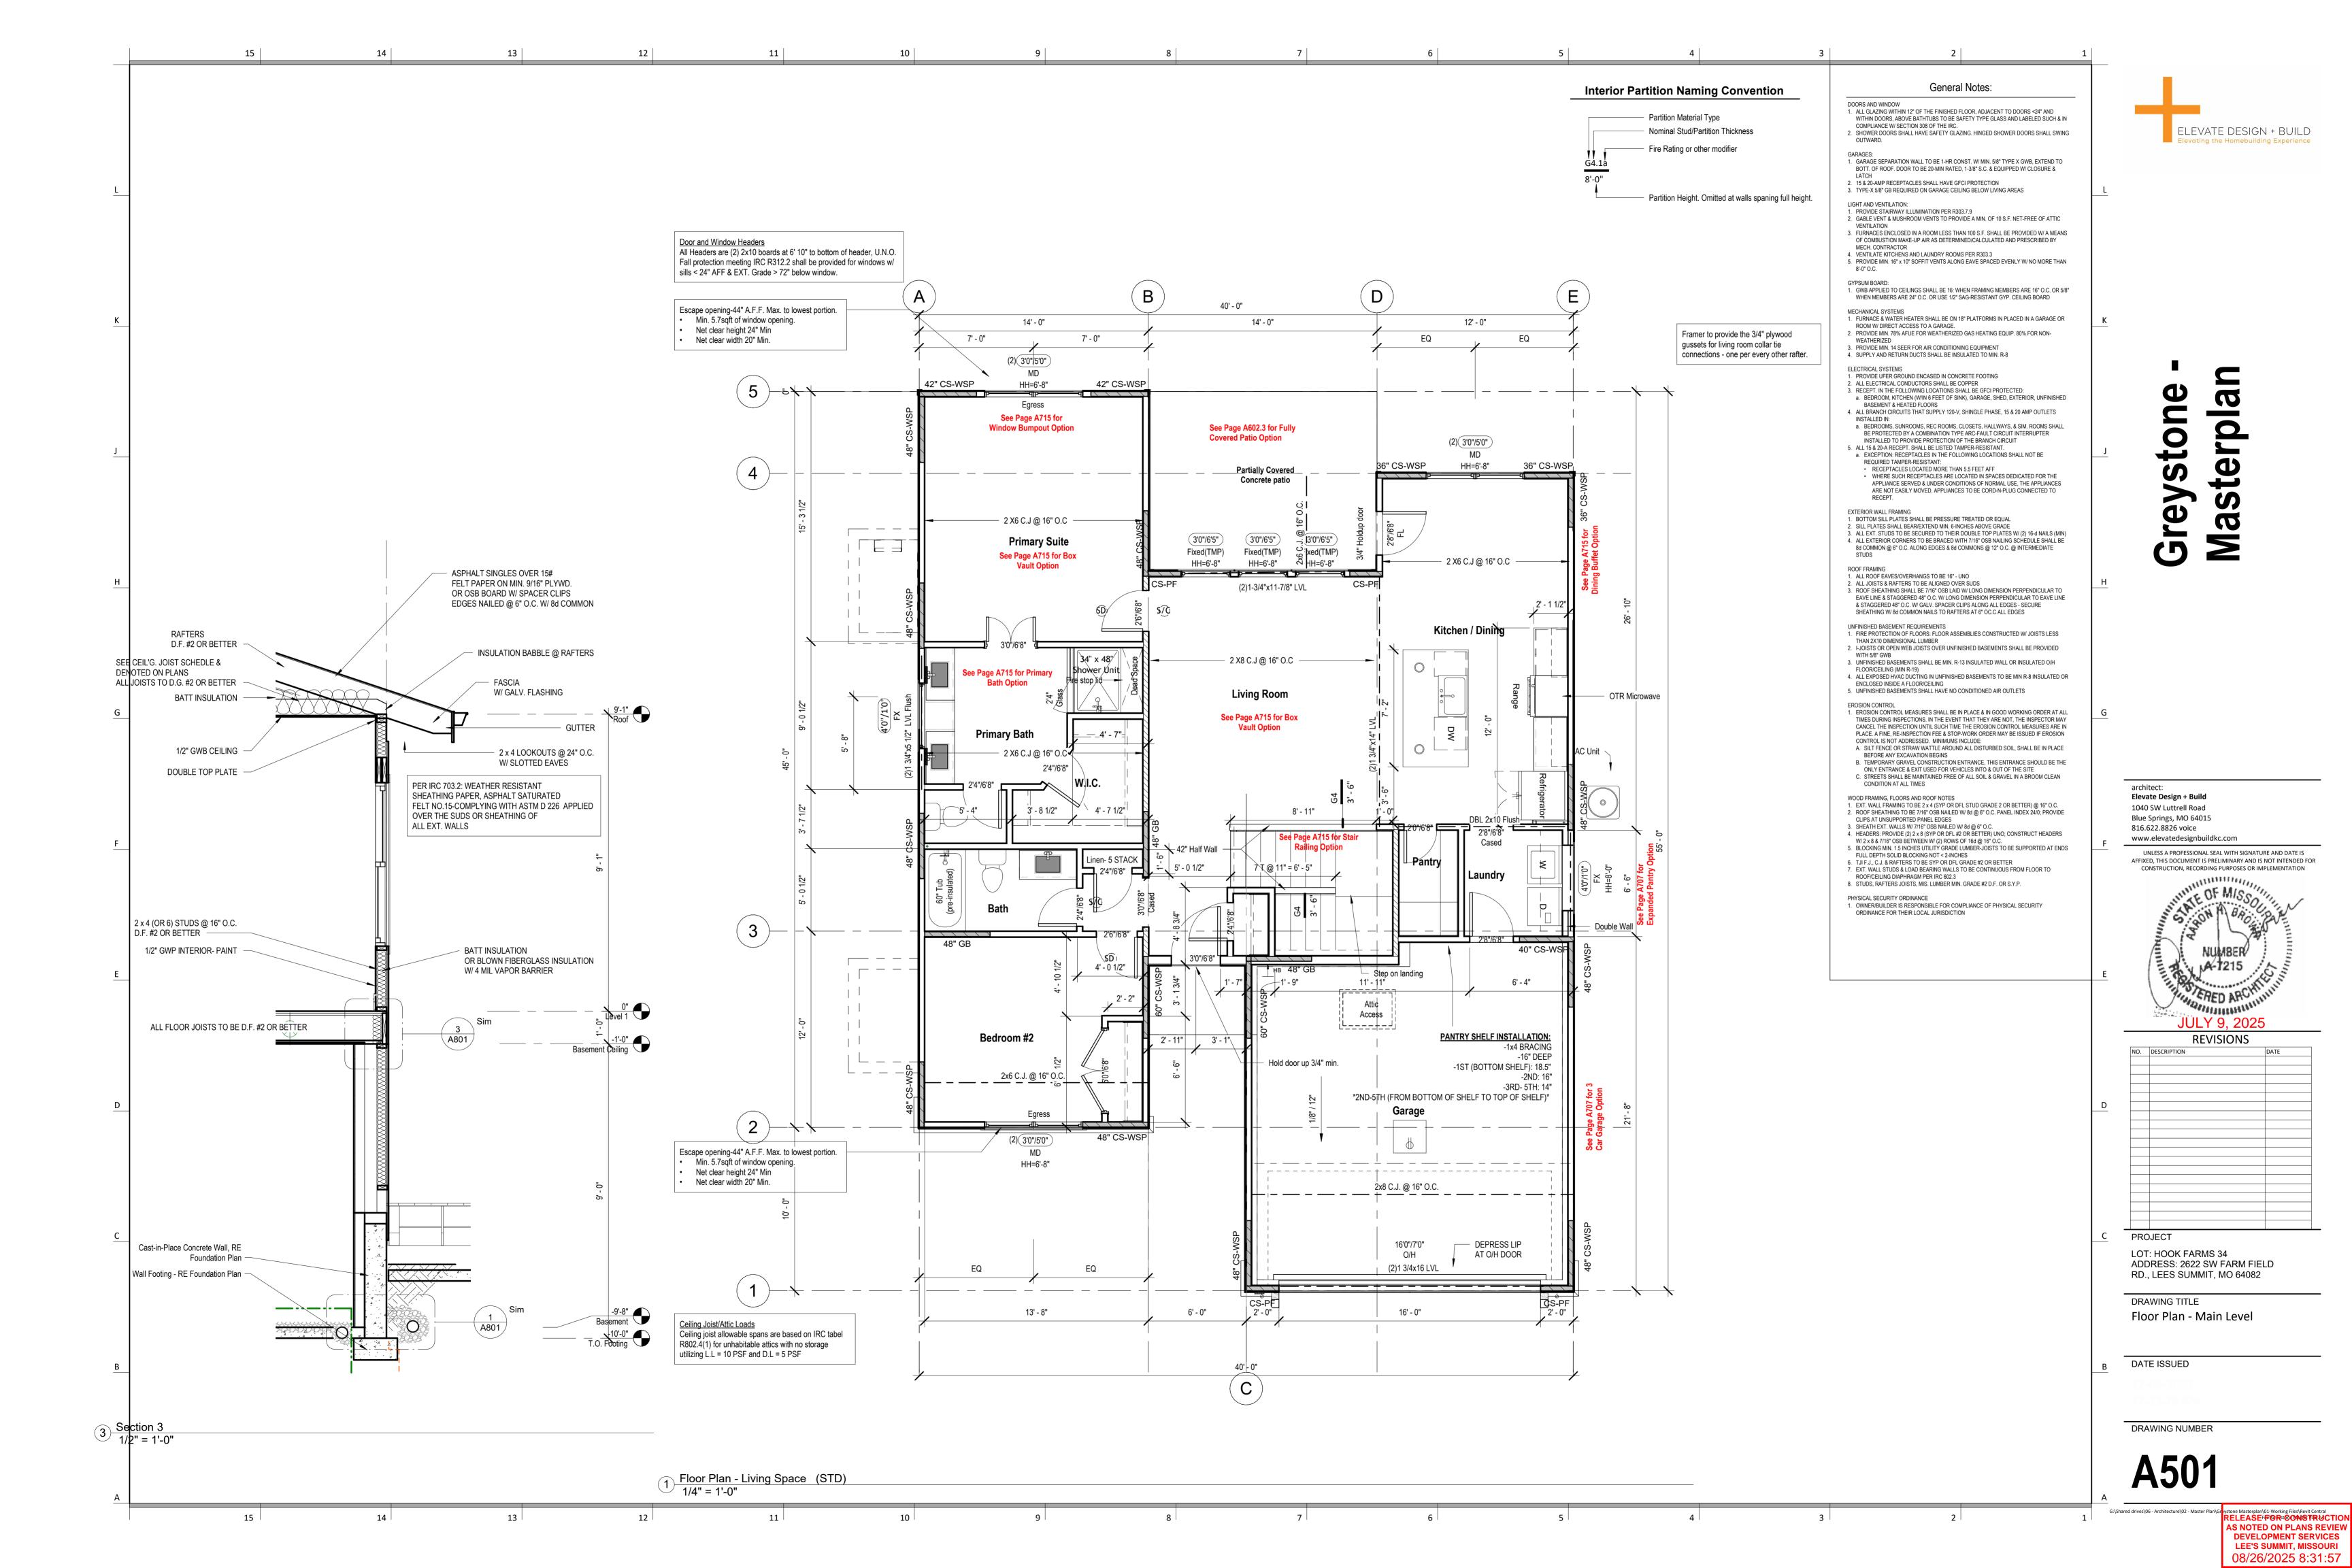

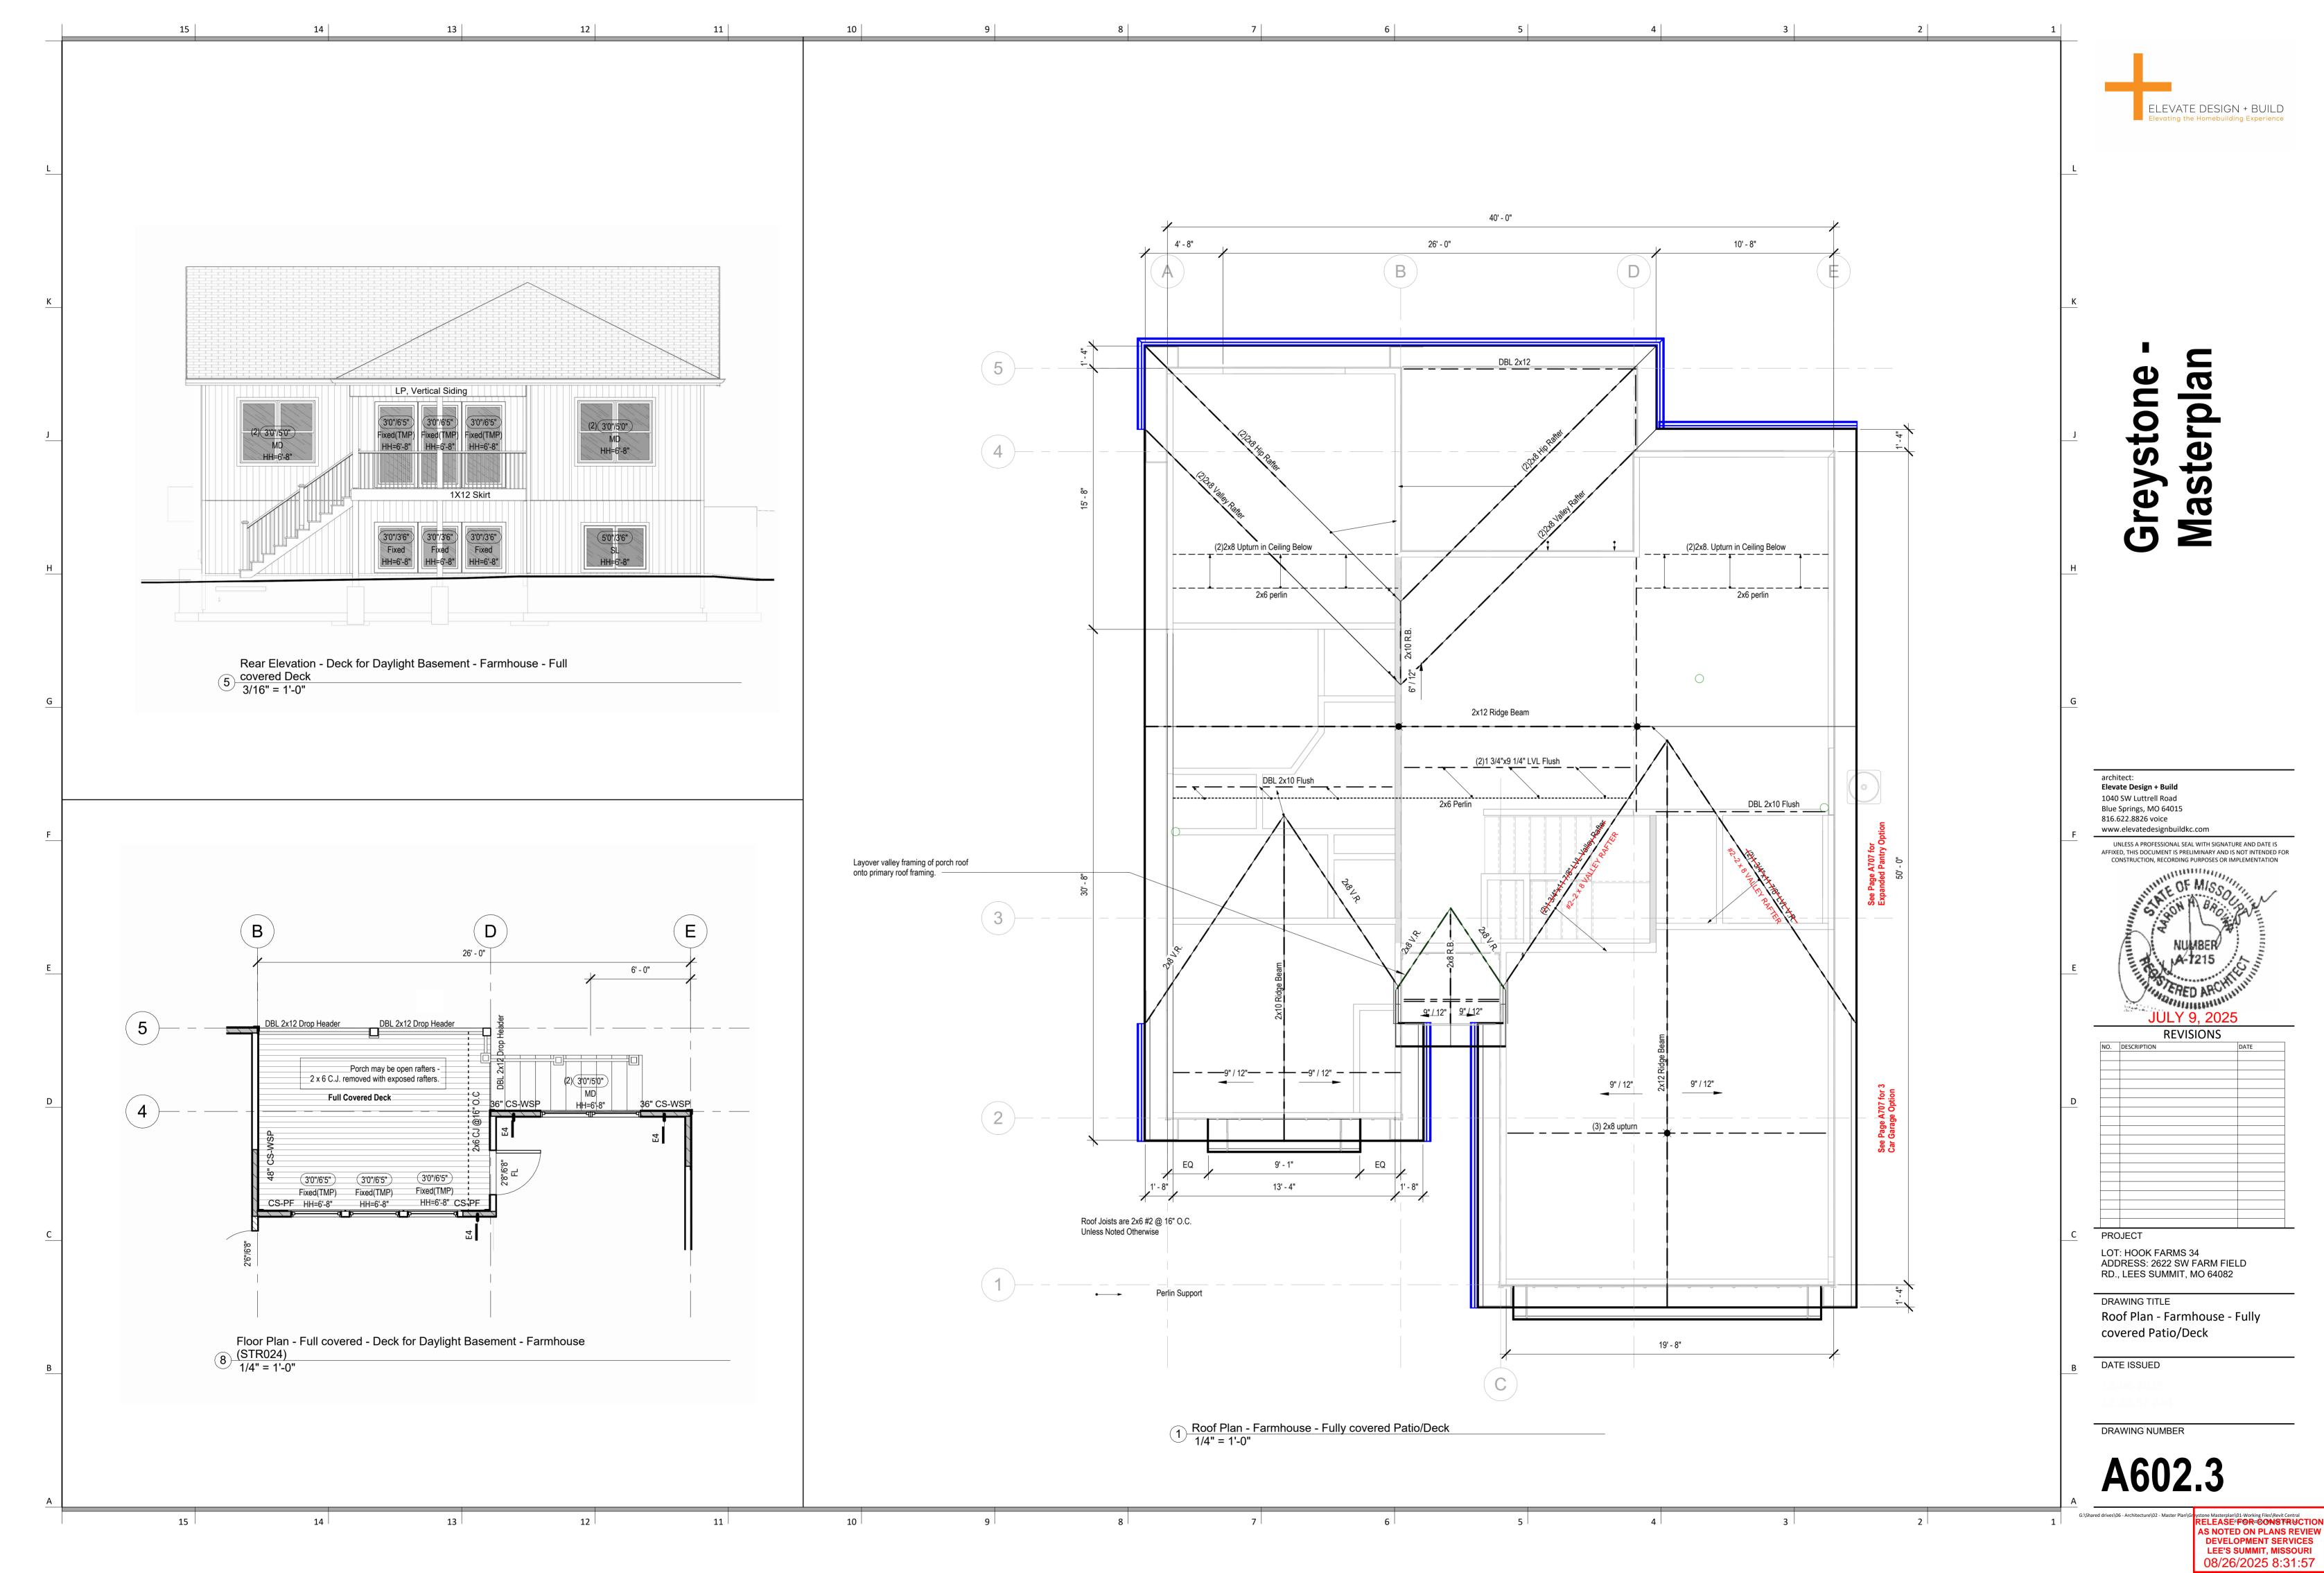
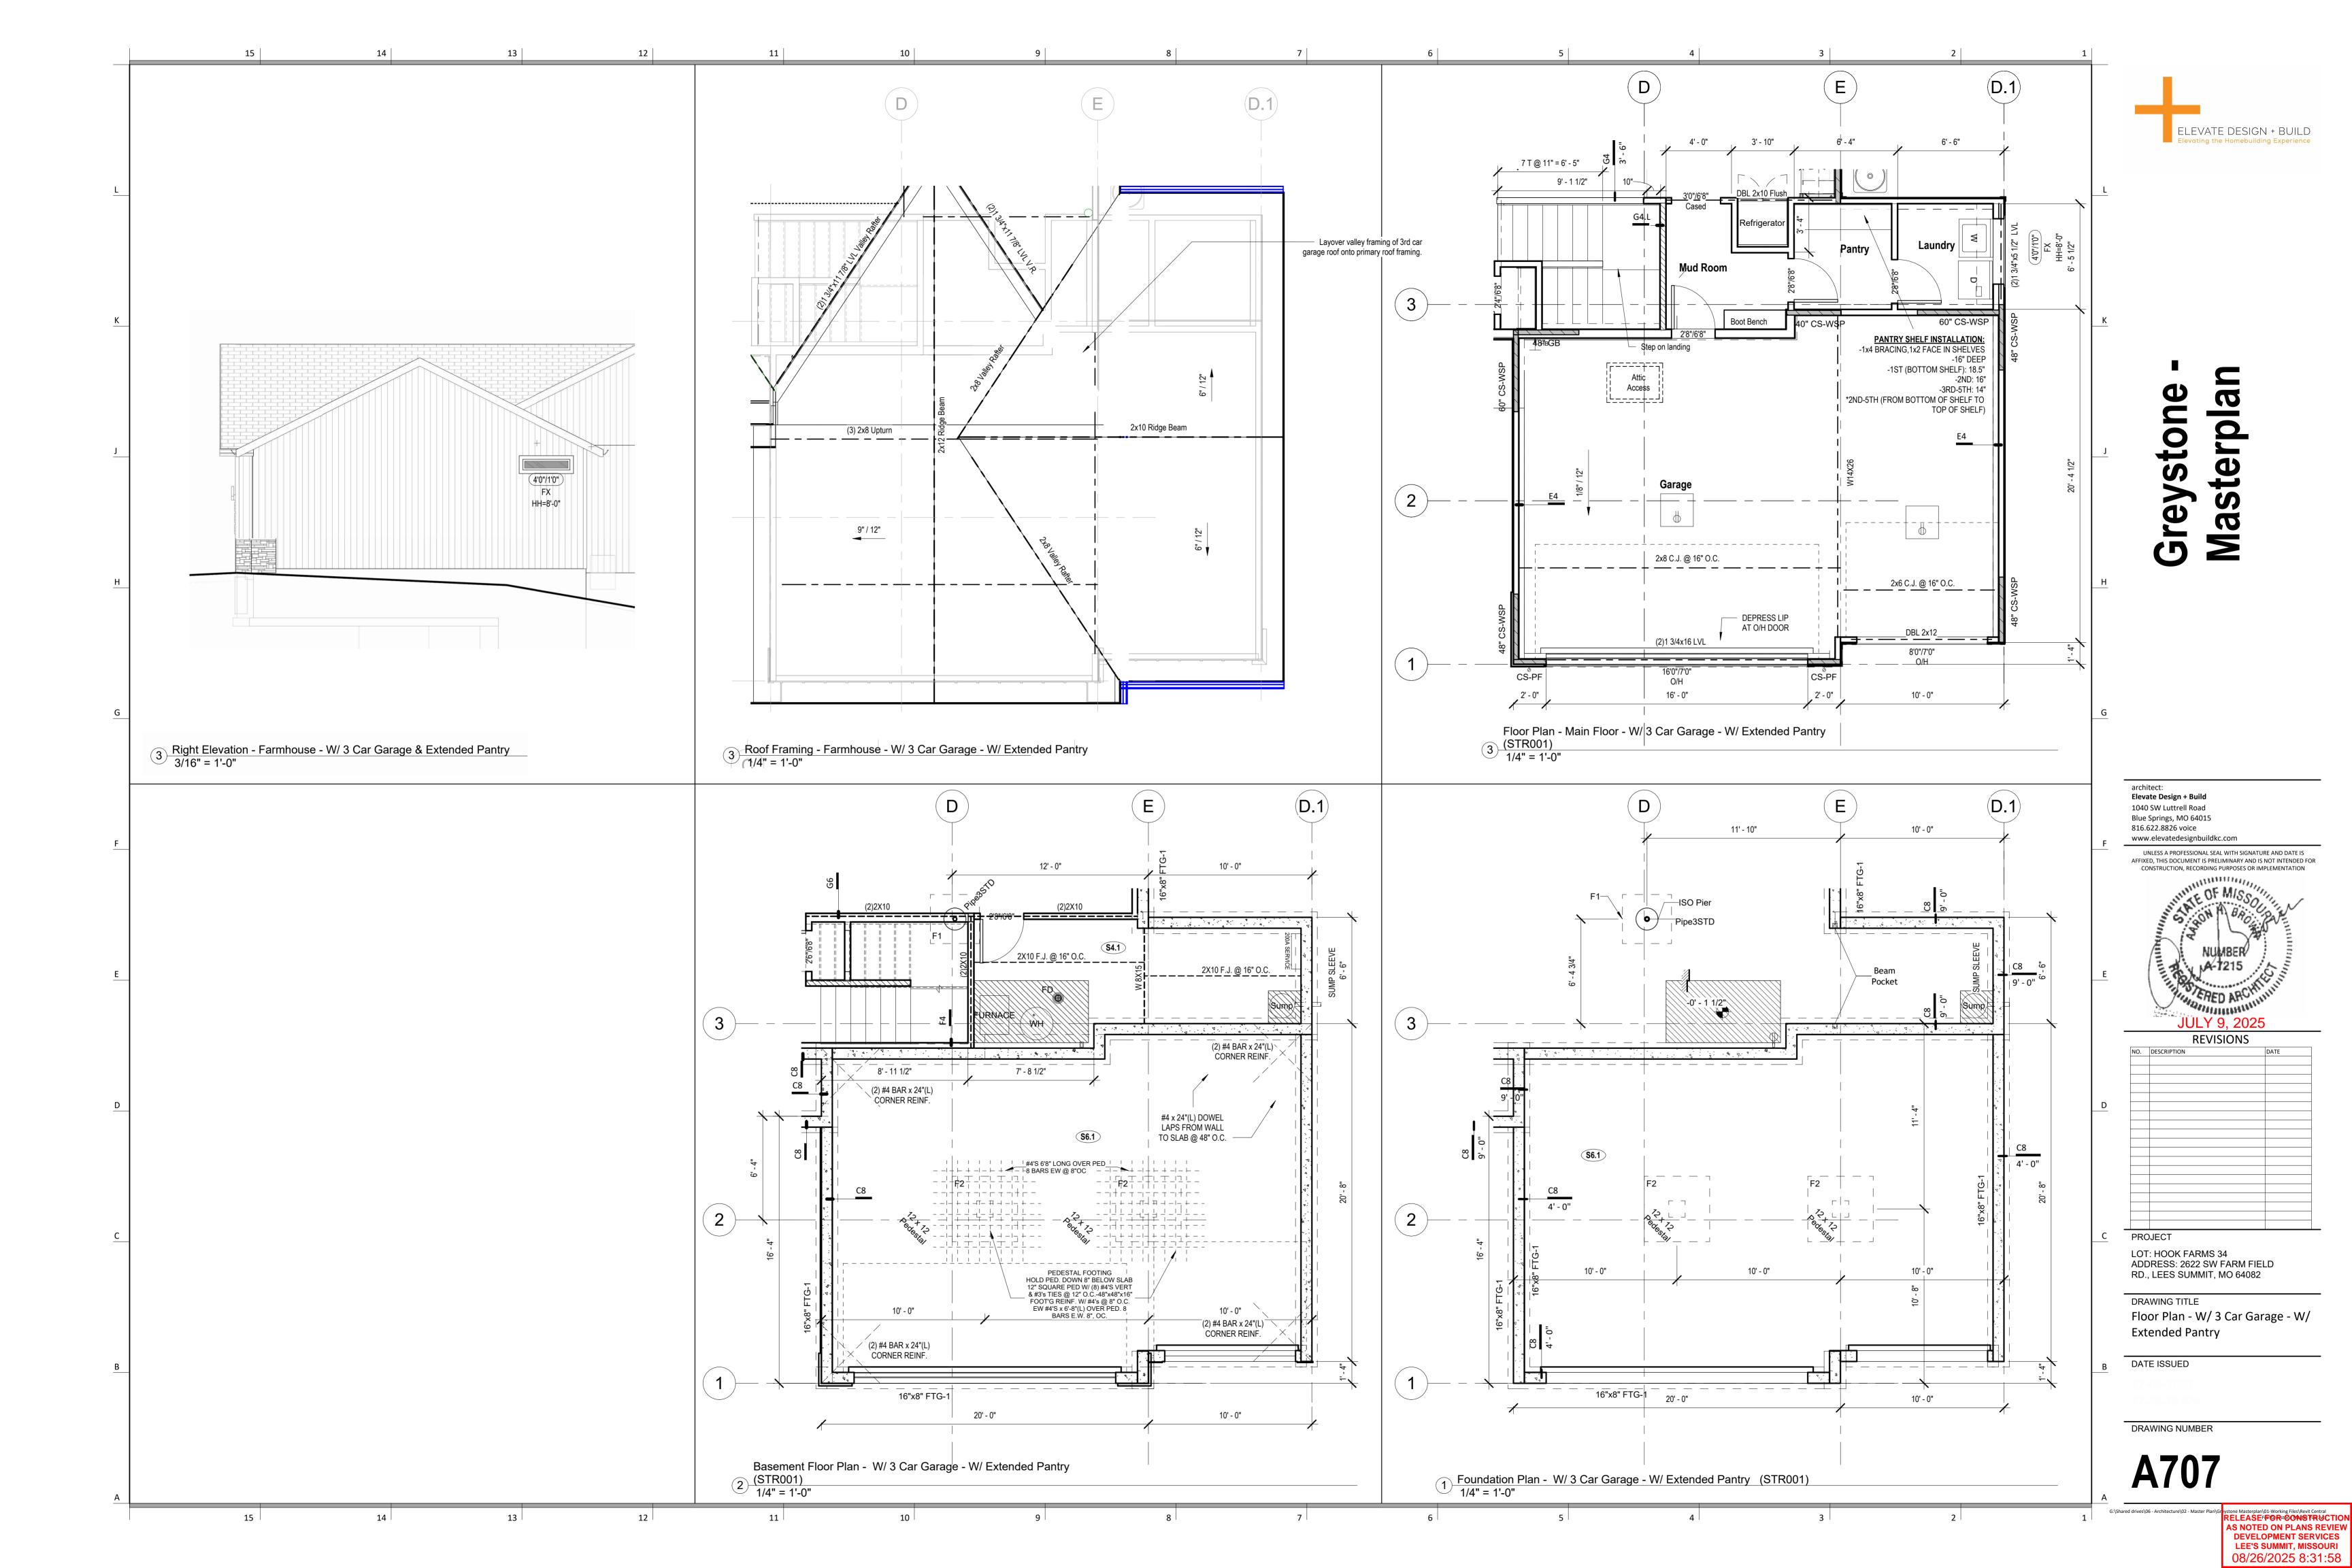
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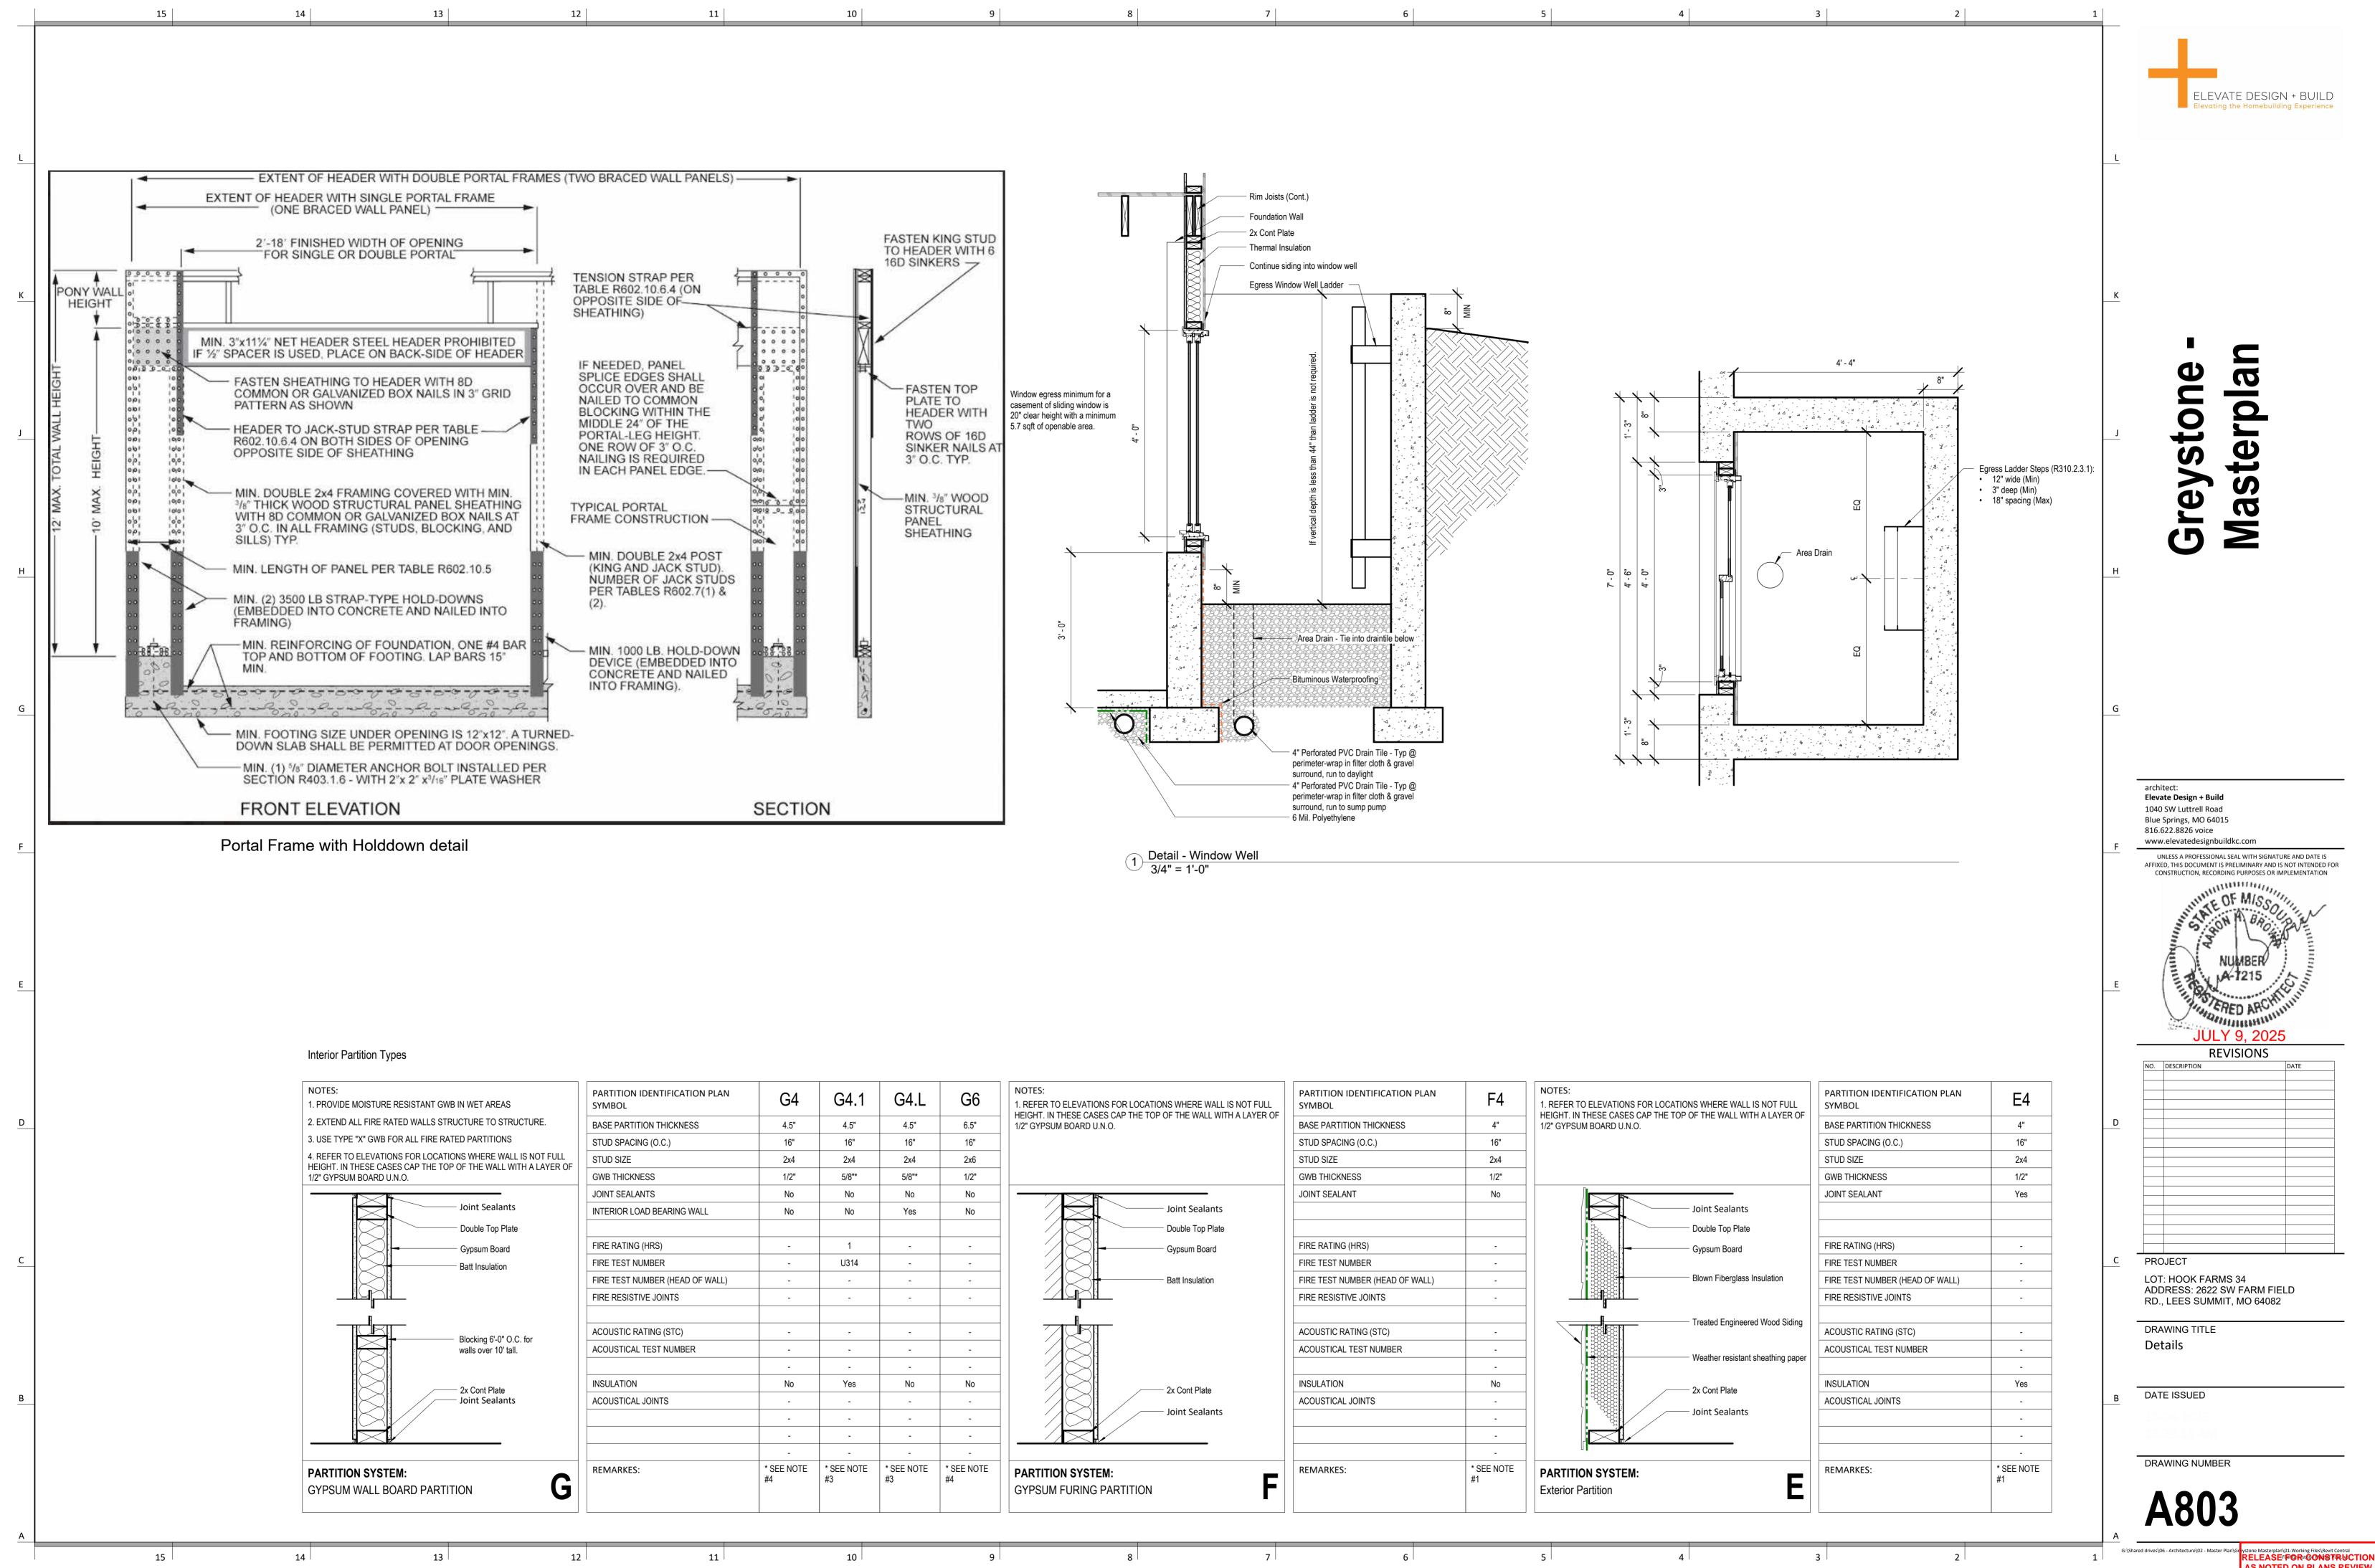
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ELEVATE DESIGN + BUILD

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