Center #: 6685 - Lees Summit, MO

833 SW Lemans Ln, Lees Summit, MO 64082

OWNER:

The UPS Store, Inc.



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319 N. Fourth Street, Suite 1000 St. Louis, MO 63102 P314-231-5700 F314-231-0816

PROJECT DIRECTORY

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store6685@theupsstore.com

General

Contractor:

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To Be Selected

City of Lee's Summit P: 816. 969.1200

DISCLAIMER

PROPERTY CONTAINED WITHIN THESE DOCUMENTS ARE TAKEN DIRECTLY FROM A DESIGN INTENT DRAWING FROM THE TENANT DESIGNER AND THE DESIGN IS NOT NECESSARILY THE PROPERTY OF LAWRENCE GROUP. CONTACT CUSHMAN & WAKEFIELD PROJECT MANAGER AND DESIGNER FOR ANY CLARIFICATIONS ON PROJECT AND DELIVERY SCOPE.


PLAN NORTH VS TRUE NORTH

PLAN NORTH IS BASED ON THE PREDOMINANT AXIS OF THE BUILDING GEOMETRY. FOR THIS PROJECT, PLAN NORTH POINTS TOWARDS THE TOP OF THE DRAWING AREA. ALL VIEWS IN THIS DRAWING SET USE PLAN NORTH AS IT'S ORIENTATION. TRUE NORTH IS THE REAL-WORLD NORTH DIRECTION BASED ON SITE CONDITIONS. TRUE NORTH INFORMATION IS NOT USED OR PROVIDED FOR THESE DOCUMENTS.


NOTE TO CONTRACTOR

IT IS THE CONTRACTOR'S RESPONSIBILITY TO THOROUGHLY REVIEW THE OWNER'S DESIGN INTENT DRAWINGS & NOTIFY THE ARCHITECT IMMEDIATELY WITH ANY MAJOR DISCREPENCIES. THE ARCHITECT SHALL IN NO WAY BE HELD RESPONSIBLE FOR ANY DIFFERENCES BETWEEN THE DESIGN INTENT AND ARCHITECT PROVIDED DRAWINGS.

PROJECT LOCATION

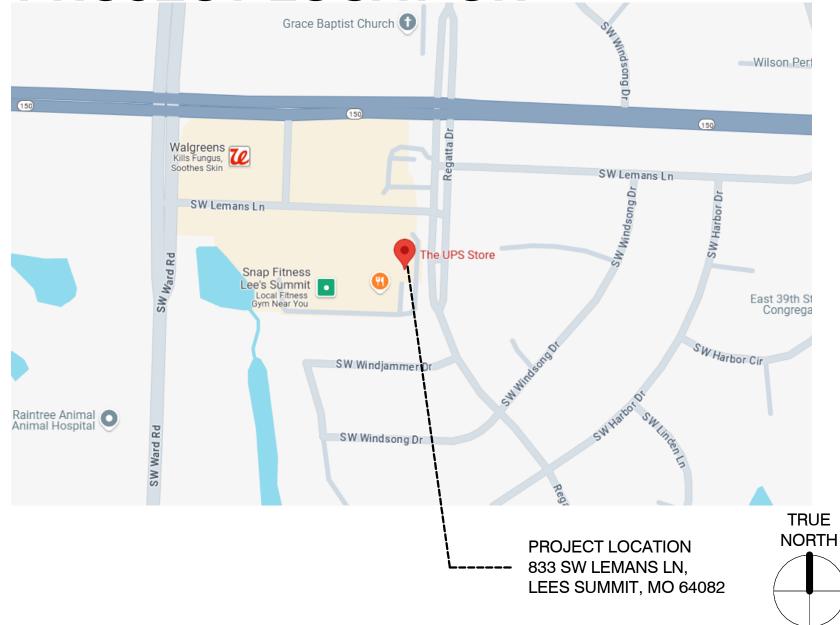

SITE PLAN

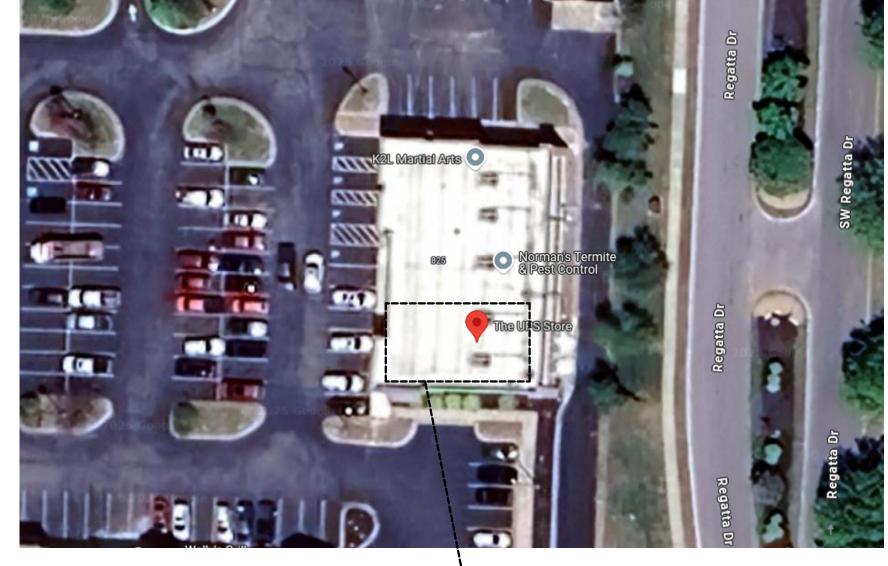

PROJECT LOCATION: (B) - BUSINESS PROFESSIONAL SERVICES


NORTH

LIST OF DRAWINGS

Sneet Number	Sheet Name
Architect	ural
A0	Cover Sheet
A1	Demolition Floor Plan
A2	Construction & Modular Fixture Plan
A3	Reflected Ceiling Plan
A4	Electrical Plan
A5	Finish Plan
A6	Fixture Plan
A7	Graphics Plan & Elevations
A7.1	Graphic & Sign Install Instructions
A8	Interior Elevations
A9	Details
A10	Details

GENERAL NOTES

- GENERAL CONTRACTOR IS RESPONSIBLE TO VISIT THE SITE PRIOR TO BID DATE TO FAMILIARIZE THEMSELVES WITH THE ACTUAL JOB TUPSS DESIGN COORDINATOR IMMEDIATELY. FAILURE TO CONTACT THE TUPSS DESIGN COORDINATOR WILL RESULT IN THE
- RESULT IN THE SPECIFIC CONTRACTOR BEING HELD RESPONSIBLE TO COMPLETE ALL WORK REQUIRED TO MEET THE ORIGINAL DESIGN INTENT DRAWINGS AT HIS/HER OWN COSTS WITH NO ADDITIONAL EXPENSES (EXTRAS) BEING INCURRED BY TENANT.
- SCHEDULE TO TUPSS DESIGN COORDINATOR AND THE UPS STORE BASE DAILY WITH STORE TEAM AT OPENING AND CLOSING TO COORDINATE PHASING/SCOPE OF WORK/REQUIRED STORE PREP FOR THE FOLLOWING DAY.
- ENCLOSURE TO MEET LOCAL AND STATE CODES AND LANDLORD REQUIREMENTS. GENERAL CONTRACTOR TO IMMEDIATELY NOTIFY TUPSS DESIGN COORDINATOR OF ANY DISCREPANCIES, ERRORS OR OMISSIONS DISCOVERED IN THE DESIGN INTENT DRAWINGS ACTUAL WIDTHS, LENGTHS, AVAILABLE CEILING HEIGHTS, COLUMN LOCATIONS, STOREFRONT CONDITIONS, UTILITY LOCATIONS, ETC. BEFORE PROCEEDING WITH RELATED WORK; OTHERWISE, THE CORRECTION OF
- SUCH ITEMS IS THE RESPONSIBILITY OF THE CONTRACTOR.
- LINES FOR STORAGE OF MATERIALS, TOOLS, FIXTURES, ETC., IS PROHIBITED. GENERAL CONTRACTOR TO REMOVE ALL CONSTRUCTION DEBRIS FROM JOB SITE AS DIRECTED BY LANDLORD. ALL CONSTRUCTION
- ALL WOOD FRAMING, BLOCKING AND PLYWOOD TO BE FIRE RETARDANT AND PRESSURE TREATED MILL STAMP, USE SELECT GRADE
- ALL DIMENSIONS ARE TO FINISH FACE OF GYPSUM WALL BOARD OR TO FINISH FACE OF EXISTING CONSTRUCTION UNLESS NOTED
- GENERAL CONTRACTOR IS RESPONSIBLE TO HAVE ENTIRE STORE THOROUGHLY CLEAN AND DUST FREE AT THE TIME OF TURN OVER TENANT'S GENERAL CONTRACTOR TO ASSEMBLE ALL MISCELLANEOUS FLOOR DISPLAYS, RACKS, BRACKETS, HANG RODS, ETC., INCLUDING, BUT NOT LIMITED TO, ROUNDER RACKS, 2 WAY RACKS, 4 WAY RACKS. DISPLAY MERCHANDISE TABLES, NON-SALES AREA TENANT'S GENERAL CONTRACTOR TO ASSEMBLE ALL MISCELLANEOUS NON-SALES OFFICE EQUIPMENT, SHELVES, RACKS, BRACKETS, HANG RODS, ETC. TENANT'S GENERAL CONTRACTOR MUST FILE BURRS SMOOTH BEFORE INSTALLING SNAP-IN END CAPS ANYTIME
- THE UPS STORE CONSTRUCTION REGULATIONS AND LOCAL CODE REQUIREMENTS FOR ANY ADDITIONAL INFORMATION NOT
- THE SPRINKLER SYSTEM SHALL BE FULLY CHARGED AND OPERATIONAL WHEN THE CONTRACTOR IS OFF-SITE
- MATERIALS, EQUIPMENT, AND ASSEMBLIES SHOWN OR SPECIFIED ARE MINIMUM REQUIREMENTS OR PERFORMANCE STANDARDS. CONFLICTS BETWEEN THE DESIGN INTENT DRAWINGS AND LOCAL REQUIREMENTS SHALL BE BROUGHT TO THE OWNER'S ATTENTION AND RESOLVED, BY MUTUAL AGREEMENT, PRIOR TO SUBMISSION OF BID OR HIGHEST PRICED WORK. LOCAL REQUIREMENTS VERSUS
- INCLUDING BUT NOT LIMITED TO LOADING, APPLICATION, FUNCTIONALITY, ETC. PERFORMANCE CRITERIA PROVIDED ELSEWHERE BY A SPECIFIC DISCIPLINE SHOULD BE REGARDED AS THE MINIMUM STANDARDS ACCEPTABLE TO THE CLIENT. EACH SUPPLIER MUST EVALUATE THESE MINIMUMS AGAINST SPECIFIC INDUSTRY STANDARDS AS WELL AS CODES, LAWS, ORDINANCES AND UNDERWRITER REQUIREMENTS GOVERNING HIS PRODUCT AS WELL AS OWNER INSURER REQUIREMENTS. AS APPLICABLE. THE MOST STRINGENT OF THESE CRITERIA SHALL GOVERN.
- 17 LEAVE ALL APPROPRIATE DOCUMENTATION INDEXED IN A BINDER
- 18 LEAVE AS-BUILT SET OF PLANS WITH THE LANDLORDS TENANT COORDINATOR. 19 TURN OVER ALL KEYS TO FRANCHISEE OWNER MARKING EACH KEY FOR IDENTIFICATION
- 20 CONTRACTOR TO PROVIDE CIRICUT DIRECTORY ON ELECTRICAL PANELS, TYP 21 GENERAL CONTRACTOR TO VERIFY ALL DIMENSIONS PRIOR TO CONSTRUCTION. IF ANY DIMENSIONS FROM THE PLAN ARE CONTRADICTORY TO FIELD CONDITIONS, CONTACT TUPSS DESIGN COORDINATOR IMMEDIATELY. FAILURE TO CONTACT TUPSS DESIGN COORDINATOR WILL RESULT IN THE GENERAL CONTRACTOR ABSORBING ANY ADDITIONAL COSTS.

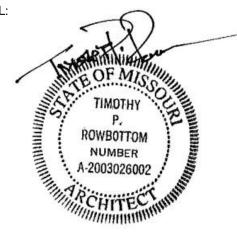

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CODE SUMMARY

APPLICABLE CODES:

2018 INTERNATIONAL BUILDING CODE 2017 NATIONAL ELECTRIC CODE 2018 INTERNATIONAL FIRE CODE 2018 INTERNATIONAL MECHANICAL CODE

2018 INTERNATIONAL PLUMBING CODE 2018 INTERNATIONAL ENERGY CONSERVATION CODE

PROJECT AREA:

PARTIAL 1ST FLOOR: 1461 SF

OCCUPANCY:

PARTIAL 1ST FLOOR OF EXISTING 1-STORY BUILDING PROPOSED: (B) BUSINESS (PROFESSIONAL SERVICES)

CALCULATED OCCUPANT LOAD:

PARTIAL 1ST FLOOR

TOTAL LOAD = 10 OCCUPANTS (150 SF/OCC)

CONSTRUCTION TYPE:

TYPE IIB, UNCOMBUSTIBLE, UNPROTECTED

FIRE PROTECTION:

SPRINKLER SYSTEM: YES

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	project without the writter consent of th	C GIOIIICOL.
No.	Description	Date

Sheet Title:

Cover Sheet

Project Number 2025901.309

Issue Date: 07/21/2025 Sheet Number:

Demolition Floor Plan

A1 1/4" = 1'-0"

DEMOLITION KEYED NOTES Key Value Keynote Text 101 EXISTING STOREFRONT SYSTEM AND GLAZING TO REMAIN. EXISTING DOOR TO REMAIN. INSPECT FOR ANY DAMAGES, IF DAMAGED BRING TO 107 OWNERS ATTENTION. 108 EXISTING STRUCTURE COLUMNS TO REMAIN. 109 EXISTING FLOORING AND WALL BASE TO BE REMOVED. EXISTING RTU TO REMAIN. 111 EXISTING LIGHTING, DUCTS, AND DIFFUSERS TO BE RELOCATED/MODIFIED AS NEEDED TO ACCOMODATE NEW FIXTURE LAYOUT. COORDINATE ALL WORK WITH CONSTRUCTION COORDINATOR. 115 EXISTING RESTROOM WATER AND SEWER LINES TO REMAIN. 116 EXISTING ELECTRICAL PANEL TO REMAIN. 119 EXISTING WALL TO REMAIN. 120 EXISTING RESTROOM FIXTURES TO REMAIN. 121 EXISTING FLOOR DRAIN TO REMAIN. 122 EXISTING EXHAUST FAN TO REMAIN. 123 EXISTING SPRINKLER HEADS TO BE RELOCATED/MODIFIED AS NEEDED. COORDINATE ALL WORK WITH CONSTRUCTION COORDINATOR. EXISTING RESTROOM CEILING MOUNTED LIGHT FIXTURE TO REMAIN. 124 126 REMOVE EXISTING SECURITY GATE AND HEADER. REMOVE EXISTING MODULAR WALLS AND FASCIA COMPONENTS THROUGOUT. 129

LAWRENCE GROUP

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General

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Professional Seal:

ROWBOTTOM NUMBER A-2003026002

07/21/2025

Project Title:

i, INC.

SIORE, IN

Center #: 6685 - Lees 833 SW Lemans Ln, Le

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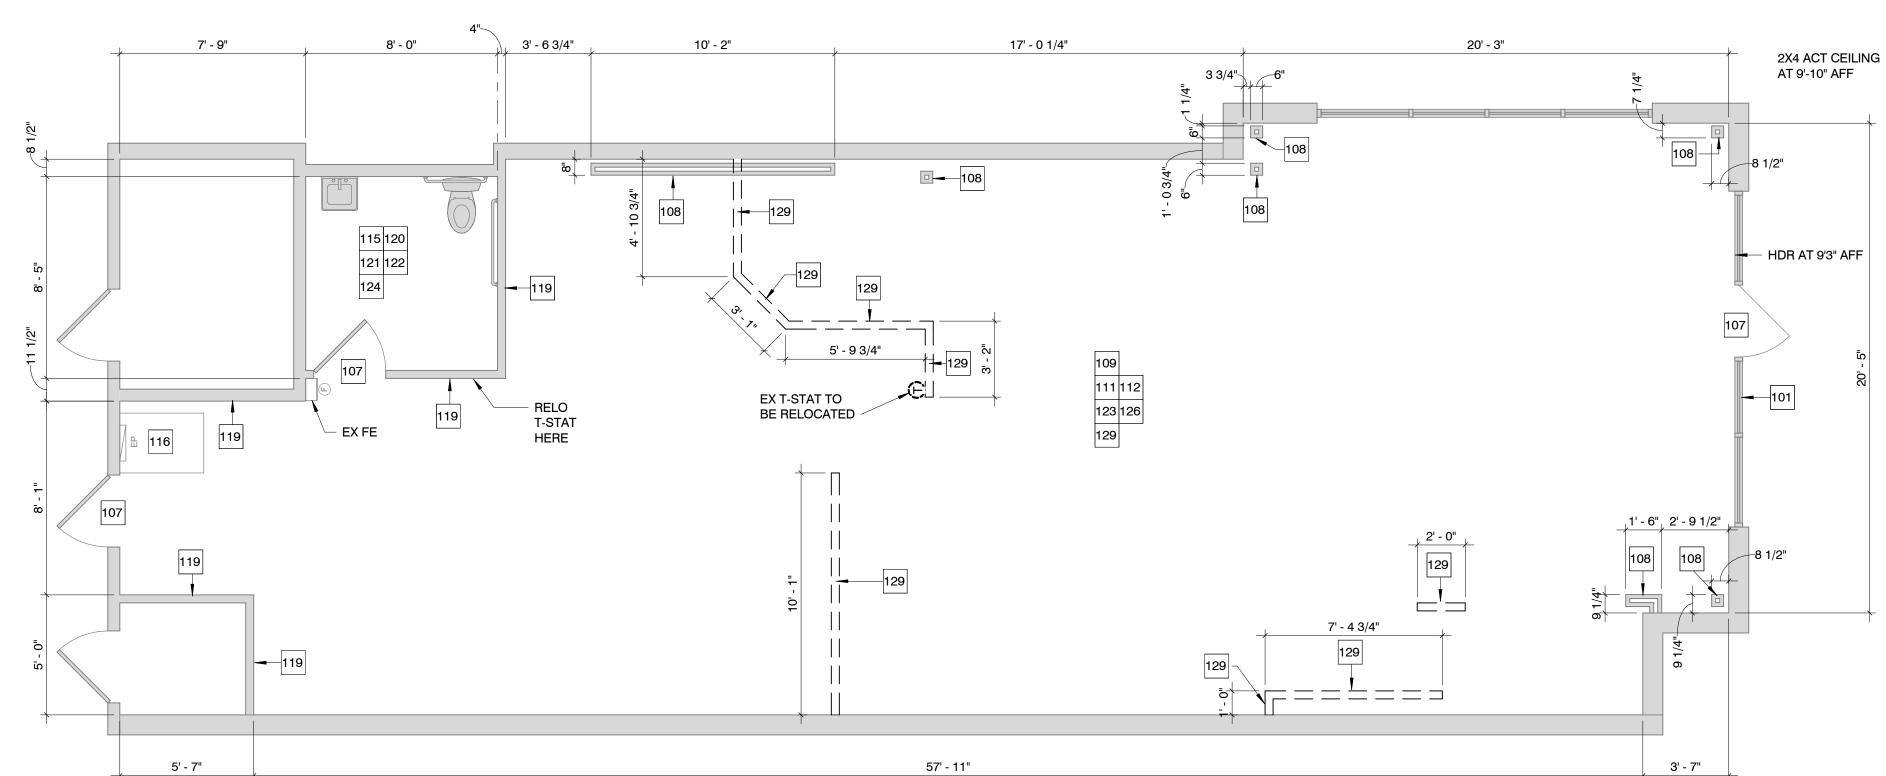
Sheet Title:

Demolition Floor Plan

Project Number:
2025901.309
Drawn By:
RAC
Issue Date:

07/21/2025

Sheet Number:



MODULAR FIXTURE SCHEDULE								
FIXTURE TAG	COUNT	DESCRIPTION	VIRA	3C #				
BH-K1	3	FASCIA PANEL 54"W X 24"H	MPW54437	177				
BH-K5	6	FASCIA CORNER POST 60"H	MPM29965	310				
BH-K6	6	FASCIA U-CHANNEL 96"W	MPP12605	200				
ВН-К7	2	FASCIA H COUPLER 60"H	BH-K7	201				
ВН-К9	3	FASCIA OUTSIDE CORNER 60"H	MPP56614	258				
BH-K10	3	TOP CAP 96"W X 6"D X 0.75"H	MPW23177	259				
BH-K11L	2	FASCIA PANEL 24"W X 96"H	BH-K11L	478				

PLAN NORTH

GRAPHIC LEGEND DEMO WALL **NEW DOOR** EXISTING WALL EXISTING TENANT SEPARATION WALL EXISTING DOOR NEW INSULATED WALL PARTITION TYPE INDICATOR SEE SHEET **NEW TENANT** A9 FOR DETAILS SEPARATION WALL **ELECTRICAL ELEVATION** X X X X REFERENCE MARKER FIRE EXTINGUISHER (2A:10B:C MIN.) - VERIFY FINAL LOCATION WITH FIRE MARSHAL IN FIELD KEYNOTE LEGEND FLOOR PLAN KEYED NOTE XX-XX FF&E TAG **EQUIPMENT TAG** DEMO PLAN KEYED NOTE — / GX-00 / SIGNAGE/GRAPHICS TAG RCP KEYED NOTE LIGHT FIXTURE TAG FINISH PLAN KEYED NOTE POWER KEYED NOTE FIN-00 FINISH TAG MODULAR FIXTURE PLAN GENERAL NOTES

> QUANTITIES PROVIDED. (1) EXTRA BH-K1 / BH-K2, BH-K6, AND BH-K10 TO BE INCLUDED ON ALL ORDERS. CUTS AND REMAINING PARTS OF FASCIA PANEL AND COMPONENTS TO BE REUSED AND INSTALLED AS NEEDED. REFER TO FIXTURE INSTALLATION MANUAL FOR SPECIFIC INSTALL INSTRUCTIONS FOR EACH AREA NEEDED. FASCIA SYSTEM IS NOT APPLIED OVER MODULAR GATE POCKET FIXTURES. NEW INTERIOR CONVENTIONAL WALLS DRAWN AT 4 7/8" W UNLESS NOTED OTHERWISE. FOR CEILING HEIGHTS ABOVE 12'-0" AFF REFER TO DETAIL 11/A9 GC TO SUPPLY AND INSTALL HILTI KWIK BOLT TZ2 WEDGE ANCHOR OR EQUAL TO

MODULAR WALL FASCIA COMPONENTS PROVIDED BY VENDOR AND INSTALLED BY GC. BECAUSE THE FASCIA PANELS (BH-K1, BH-K2), U-CHANNELS (BH-K6), AND TOP CAPS

(BH-K10) ARE TO BE CUT TO FIT, QUANTITIES ON FIXTURE PLAN MAY BE HIGHER THAN

FIXTURE SCHEDULE. REFER TO MODULAR FIXTURE SCHEDULE FOR TOTAL

ACCESSIBILITY NOTES

AT LEAST 5% OF THE MAILBOX MODULES IN THE MAIL ROOM SHALL PROVIDE ACCESSIBLE CLEAR FLOOR SPACE, HEIGHT AND HARDWARE. PER IAC 228.2.

ANCHOR ALL MODULAR WALL BASE PLATE(S) TO FLOOR WHEN MODULAR WALL IS NOT SUPPORTED BY USE OF FIXED CABINETRY SATISFYING A SECURED LATERAL SUPPORT OF WALL(S). LOCAL CODES MAY SUPERSEDE SUGGESTED ANCHOR TYPE AND GC TO

228.2 MAIL BOXES. WHERE MAIL BOXES ARE PROVIDED IN AN INTERIOR LOCATION, AT LEAST 5 PERCENT, BUT NO FEWER THAN ONE, OF EACH TYPE SHALL COMPLY WITH 309.

309 OPERABLE PARTS

309.1 GENERAL. OPERABLE PARTS SHALL COMPLY WITH 309.

ADJUST ACCORDINGLY TO MEET CODE.

309.2 CLEAR FLOOR SPACE. A CLEAR FLOOR OR GROUND SPACE COMPLYING WITH 305 SHALL BE PROVIDED. (30"x48" FORWARD OR PARALLEL APPROACH)

309.3 HEIGHT. OPERABLE PARTS SHALL BE PLACED WITHIN ONE OR MORE OF THE REACH RANGES SPECIFIED IN 308. UNOBSTRUCTED FORWARD REACH (15" MIN. TO 48" MAX. A.F.F.), OBSTRUCTED HIGH FORWARD REACH (48" MAX. WHERE REACH DEPTH IS 20" MAX.; 44" MAX. WHERE REACH DEPTH IS +20" TO 25" MAX.), UNOBSTRUCTED SIDE REACH (15" MIN. TO 48" MAX. A.F.F.), OBSTRUCTED HIGH SIDE REACH (OBSTRUCTION HEIGHT 34" MAX. WITH DEPTH OF OBSTRUCTION 24" MAX. OR 48" MAX. FOR A DEPTH OF 10" MAX.)

309.4 OPERATION. OPERABLE PARTS SHALL BE OPERABLE WITH ONE HAND AND SHALL NOT REQUIRE TIGHT GRASPING, PINCHING, OR TWISTING OF THE WRIST. THE FORCE REQUIRED TO ACTIVATE OPERABLE PARTS SHALL BE 5 POUNDS (22.2 N) MAXIMUM.

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Contractor: To Be Selected

Professional Seal: TIMOTHY ROWBOTTOM NUMBER A-2003026002

07/21/2025

Project Title:

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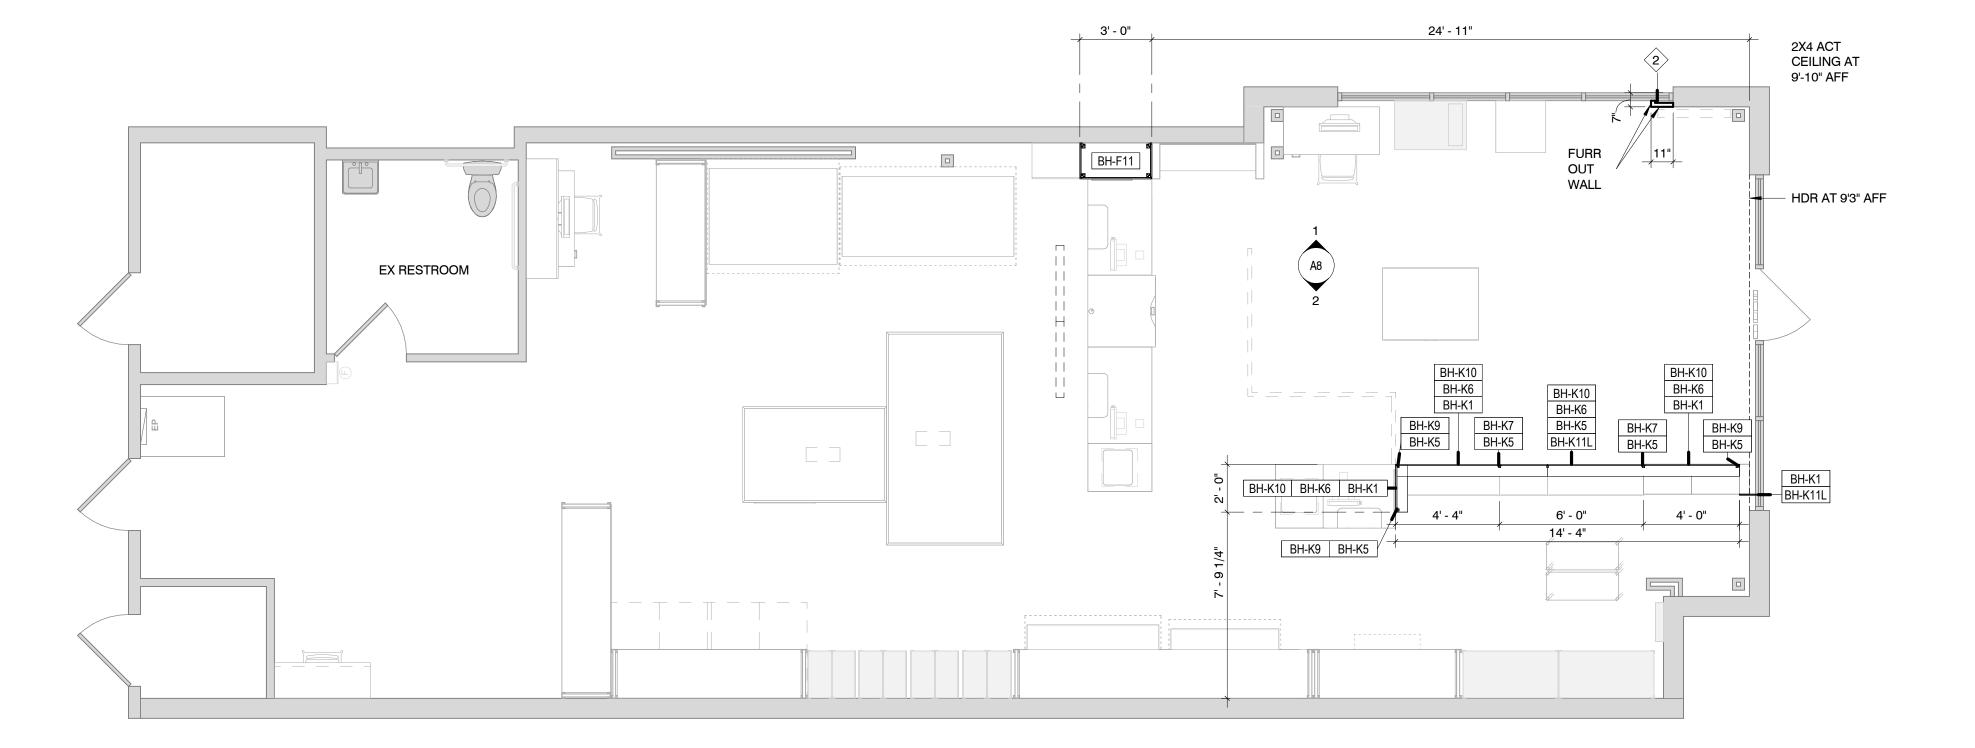
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No.	Description	Date

Construction & Modular Fixture Plan

Project Number: 2025901.309 RAC Issue Date: 07/21/2025

Sheet Number: AZ



LIGHTING FIXTURE SCHEDULE												
LIGHT TAG	COUNT	DESCRIPTION	PART NUMBER	MOUNTING	LAMP	LAMP QTY	WATTS	REMARKS	VOLTAGE	SYMBOL		
BH-L2X4EX	14	EXISTING RECESSED NOMINAL 2'X4' APERTURE INTEGRAL LED ALUMINUM FRAME WITH WHITE PAINTED TRIM AND INTEGRAL LED DRIVER.	LIGHT SIMILAR TO LITELINE FORUM PANEL: LEDP-24-WH								2	
BH-L2X4GC	6	GC TO LOCALLY SOURCE RECESSED NOMINAL 2'X4' APERTURE INTEGRAL LED ALUMINUM FRAME WITH WHITE PAINTED TRIM AND INTEGRAL LED DRIVER.	LIGHT SIMILAR TO LITELINE FORUM PANEL: LEDP-24-WH		INTEGRAL 3500K TO 4000K LED		20W TO 40W				2	
BH-L12	1	OPEN SIGN									+	
											E	
										•	5	
											E	

LEGEND (EX=EXISTING, REL=RELOCATE, N=NEW) DESCRIPTION 2' X 2' SUPPLY AIR DIFFUSER 2' X 2' RETURN AIR GRILLE EXIT SIGN SPRINKLER HEAD **EMERGENCY LIGHT**

MECHANICAL RELOCATION NOTE:

BRANCH LINES ARE NOT ADDED

BH-L2X4EX

REL

BH-L12

(304)

BH-L2X4EX

REL

EX

PLAN NORTH

BH-L2X4EX

BH-L2X4EX

EXISTING MECHANICAL AIR DEVICES (SUPPLY AIR DIFFUSERS & RETURN AIR GRILLES) ARE TO BE LIFTED AND RESET IN APPROXIMATELY THE SAME LOCATION THEY ORIGINATED FROM. MECHANICAL CONTRACTOR SHALL ENSURE EXISTING BRANCH LINES ARE REUSED, NOT EXTENDED & NEW

RCP GENERAL NOTES

GC TO FIELD VERIFY LOCATIONS OF EXISTING DUCTS, SPRINKLERS, PIPING, CONDUITS, ETC AND NOTIFY PROJECT MANAGER OF ANY INTERFERENCES WITH FIXTURE / FASCIA LAYOUT AND/OR GATE HEADER PRIOR TO INSTALLATION.

GC TO INSTALL BH-J26 CEILING MOUNTED PULL DOWN ELECTRICAL REELS WITH THE NARROW PART OF THE REEL FACING TOWARDS THE STOREFRONT / FRONT DOOR.

ACT CEILING GRID TO RUN CONTINUOUSLY SIDE TO SIDE AND FRONT TO BACK. ACT CEILING GRID DOES NOT STOP AT THE FIXTURES. ALL FIXTURES IN THE NIGHT LOBBY TO BE 24 HOUR DEDICATED FIXTURES

AS WELL AS FAX CABINET LIGHTS, AND RETAIL AREA LIGHTS. 24 HR. DEDICATED LIGHT FIXTURES TO BE SWITCHED OFF AT SUB-PANEL.

(0) RCP KEYED NOTES

302 NEW ACT SUSPENSION CEILING TILES NEEDED IF EXISTING ARE DISCOLORED OR DAMAGED. 2X2 OR 2X4 WHITE LAY-IN MINERAL FIBER ACOUSTICAL CEILING TILE PANELS REQUIRED (COMPARABLE TO ARMSTRONG CORTEGA 770, USG RADAR 2210, OR ARMSTRONG DUNE 1772 LAY-IN ACT PANELS). INSTALL PER MANUFACTURERS REQUIREMENTS. NOTIFY CONSTUCTION COORDINATOR OF ANY NOTICEABLE BOWING OR ISSUES WITH EXISTING CEILING GRID. GRID TO BE REPAIRED, PAINTED WHITE OR REPLACED AS NEEDED.

304 EXISTING EXIT SIGNS TO REMAIN. CONTRACTOR TO FURNISH AND INSTALL ANY NEW EXIT SIGNS AS NEEDED TO MEET ALL APPLICABLE BUILDING CODES AND REGULATIONS.

307 DIGITAL MONITOR SUSPENDED FROM CEILING. BLOCKING ABOVE CEILING AS REQUIRED.

ANY NOTICEABLE BOWING OR ISSUES WITH EXISTING CEILING GRID.

308 EXISTING LIGHTING AND EXHAUST FAN TO REMAIN IN RESTROOM. 311 EXISTING CEILING TO REMAIN. NOTIFY CONSTUCTION COORDINATOR OF

EXISTING GRID TO BE REPAIRED OR REPLACED AS NEEDED. DAMAGED OR DISCOLORED CEILING TILES TO BE REPLACED TO MATCH EXISTING. 312 JBOX ABOVE CEILING AND SUSPENDED FROM STRUCTURE ABOVE.

ADJUST PER LOCAL CODE AS REQUIRED. 316 | FLEXIBLE DUCTWORK, GRILLES, DIFFUSERS, CONDUIT, PLUMBING, STRUCTURE, AND/OR FOIL FACED INSULATION TO BE REWORKED AS NEEDED TO ACCOMMODATE NEW CENTER LAYOUT. ALL CEILING WORK TO BE COORDINATED WITH THE CONSTRUCTION COORDINATOR. PRICING TO BE INCLUDED AT TIME OF BID. NOTIFY CONSTRUCTION COORDINATOR OF ANY RIGID DUCTWORK OR OTHER EXISTING INTERFERENCES UNABLE TO RELOCATE.

317 ALL EXISTING CEILING FANS AND/OR TRACK LIGHTING TO BE REMOVED.

320 SPRINKLERS TO BE REWORKED AS NEEDED TO ACCOMMODATE NEW CENTER LAYOUT. ALL CEILING WORK TO BE COORDINATED WITH THE CONSTRUCTION COORDINATOR. PRICING TO BE INCLUDED AT TIME OF BID. NOTIFY CONSTRUCTION COORDINATOR OF ANY RIGID DUCTWORK OR OTHER EXISTING INTERFERENCES UNABLE TO RELOCATE.

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Contractor:

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Professional Seal: TIMOTHY ROWBOTTOM NUMBER A-2003026002

Project Title:

07/21/2025

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Description

Sheet Title:

Project Number: 2025901.309 Drawn By: RAC Issue Date:

07/21/2025

A₃

1 REFLECTED CEILING PLAN

H-L2X4GC

H-L2X4GC

A3 | 1/4" = 1'-0"

308

BH-L2X4E 307) BH-L2X4EX BH-L2X4EX

302 311 316 317 320

EX REL REL

BH-J26 EX • 4' - 7 1/2" EX •

BH-L2X4G H-L2X4G H-L2X4E H-L2X4EX H-L2X4G EX

EX • EX● EX●

LIGHTING IS TO BE REUSED; GC TO LOCALLY SORUCE ADDITIONAL LIGHTING IF NEEDED CEILING GRID/TILES ARE TO BE REUSED

QTY 1 RELOCATED VENT

2X4 ACT CEILING AT 9'-10" AFF

H-L2X4EX

BH-L2X4E REL

H-L2X4EX

BH-L2X4EX

H-L2X4EX

REFER TO FIXTURE INSTALLATION MANUAL FOR FURTHER INFORMATION.
L1/L2 - VOICE TELEPHONE LINE (PRIMARY & ROLL-OVER). L3 - FAX LINE.

ELEC SCOPE NOTES

- IF APPLICABLE; CONTRACTOR TO RELOCATE EXISTING PHONE BOARD TO PATCH PANEL CABINET ABOVE MANAGER'S DESK. REFER TO SHEET A6 FOR SPECIFIC PATCH PANEL CABINET LOCATION BEING USED FOR DATA/NETWORKING. DEDICATED QUAD-PLEX OUTLET AT 84" AFF FOR BH-J35 CABINETS AND AT 65" AFF FOR BH-J36 CABINETS.
- 2 3-WAY SWITCH SHALL BE INSTALLED AT EACH MEANS OF EGRESS FROM DEMISED SPACE IF NOT EXISTING. NO SWITCHES TO BE INSTALLED ON A WALL PAINTED PT-02 CAPRI BLUE. LOBBY LIGHTS TO REMAIN ON AT ALL TIMES.

			ELEC AND EQUIPMENT SCHEDULE
	NO.	COUNT	DESCRIPTION
	EQ-01	3	POS SYSTEM
	EQ-02	3	ELECTRONIC CREDIT CARD READER
	EQ-03	3	SCALE
	EQ-05	1	BACK OFFICE COMPUTER
	EQ-10	1	BLACK AND WHITE COPIER
	EQ-11	1	COLOR COPIER
	EQ-12	1	WIDE FORMAT PRINTER
	EQ-13	1	WIDE FORMAT SCANNER
	EQ-19	1	BUSINESS STATION
	EQ-22a	1	SHRED BIN
	EQ-23	1	PAPER CUTTER
	EQ-24c	2	43" DIGITAL MONITOR (CEILING MOUNT). BOTTOM OF MONITOR TO BE INSTALLED AT 80" AFF.
	EQ-25	3	POS PIN PAD

	0 ELECTRICAL KEYED NOTES
Key Value	Keynote Text
401	ELECTRICAL AT COUNTERS TO BE INSTALLED AT 14" ABOVE FINISHED FLOOR (AFF) (BELOW COUNTERTOPS). ELECTRICAL TO BE CHASED THROUGH MODULAR FIXTURE AT END OF FRONT COUNTER AS APPLICABLE.
402	ELECTRICAL AT MAIN COUNTER TO RUN THROUGH MOUSE HOLES WITHIN THE BASE AREA. ACCESS TO OUTLETS WITH 2" D. HOLES IN COUNTERTOP SURFACES. USE PLASTIC GROMMET COVERS TO HIDE PLUG RUNS. CONTRACTOR TO CONFIRM WITH FRANCHISEE WHICH KNOCKOUTS ARE TO BE CUT OUT ON EACH POS COUNTERTOP. CONTRACTOR TO REFER TO DESIGN TO DETERMINE WHICH KNOCKOUTS SHOULD BE REMOVED FOR ACCESS BETWEEN FRONT COUNTER FIXTURES.
403	JUNCTION BOX FOR RETAIL DISPLAY AT 90" AFF. WIRE TO BE SUPPLIED BY CONTRACTOR. LOW VOLTAGE TRANSFORMER TO BE INSTALLED AS CLOSE TO THE CEILING AS POSSIBLE FOR FUTURE ACCESS.
405	NETFOR COLOR PROCESSING LINE.
406	GC TO CONFIRM WITH FRANCHISEE THE TYPE OF ELECTRICAL RECEPTACLES AND SPECIFIC REQUIREMENTS FOR THE INDIVIDUAL COPIER MODELS BEING USED IN THE CENTER. INSTALL A MINIMUM OF TWO ETHERNET CABLES AT EACH PRINTER (ONE FOR PRINTER AND ONE FOR FUTURE FIERY).
407	JBOX ABOVE CEILING AND SUSPENDED FROM STRUCTURE ABOVE. INSTALL AT CEILING IF REQUIRED PER LOCAL CODE.
412	GC TO INSTALL DUPLEX ELECTRICAL OUTLET AT LOCATION OF DIGITAL MONITORS. GC TO RUN TWO CAT6 ETHERNET CABLES FROM VPN/PATCH PANEL TO ETHERNET PORT AT DIGITAL MONITOR LOCATION. INSTALL PLATE FOR THE MONITORS TO BE MOUNTED ABOVE CEILING AT HEADER PLATE HEIGHT AS ALLOWED PER CODE. IF NOT PERMITTED PER CODE THEN ELECTRICAL OUTLET AND THE PORT FOR THE MONITORS TO BE FLUSH MOUNTED ON CEILING. REFER TO DETAIL 6/A9. GC TO INSERT ETHERNET CABLE INTO THE ICN GATEWAYS FORTINET® DEVICE, DMZ PORT. IF THE ICN GATEWAYS FORTINET® DEVICE IS NOT ON SITE, RUN THE ETHERNET CABLE TO THE LOCATION OF THE VPN AS SHOWN ON THE DESIGN AND TAG THE CAT 6 DIGITAL MONITOR CABLE. DIGITAL MEDIA INSTALLER TO INSTALL PATCH CABLE FROM CEILING MONITORS TO CEILING PORTS. ENSURE CONTINUITY TEST FOR CABLING.
413	OVERHEAD ELECTRICAL / DATA MAIN RUN RUN BE FACILITATED THROUGH THIS FIXTURE INTO THE SERVICE COUNTER RUNS BELOW.
417	ELECTRICAL PULL DOWN REEL LOCATION. CONTRACTOR TO PROVIDE BLOCKING AS NEEDED. REFER TO DETAIL 7/A9. GC TO INSTALL BH-J26 CEILING MOUNTED PULL DOWN ELECTRICAL REELS WITH THE NARROW PART OF THE REEL FACING TOWARDS THE STOREFRONT / FRONT DOOR.



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General
Contractor: To Be Selected

Professional Seal:

OF Mos

TIMOTHY

ROWBOTTOM

NUMBER

A-2003026002

Project Title:

07/21/2025

Center #: 6685 - Lees Summit, I 833 SW Lemans Ln, Lees Summ

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No. Description


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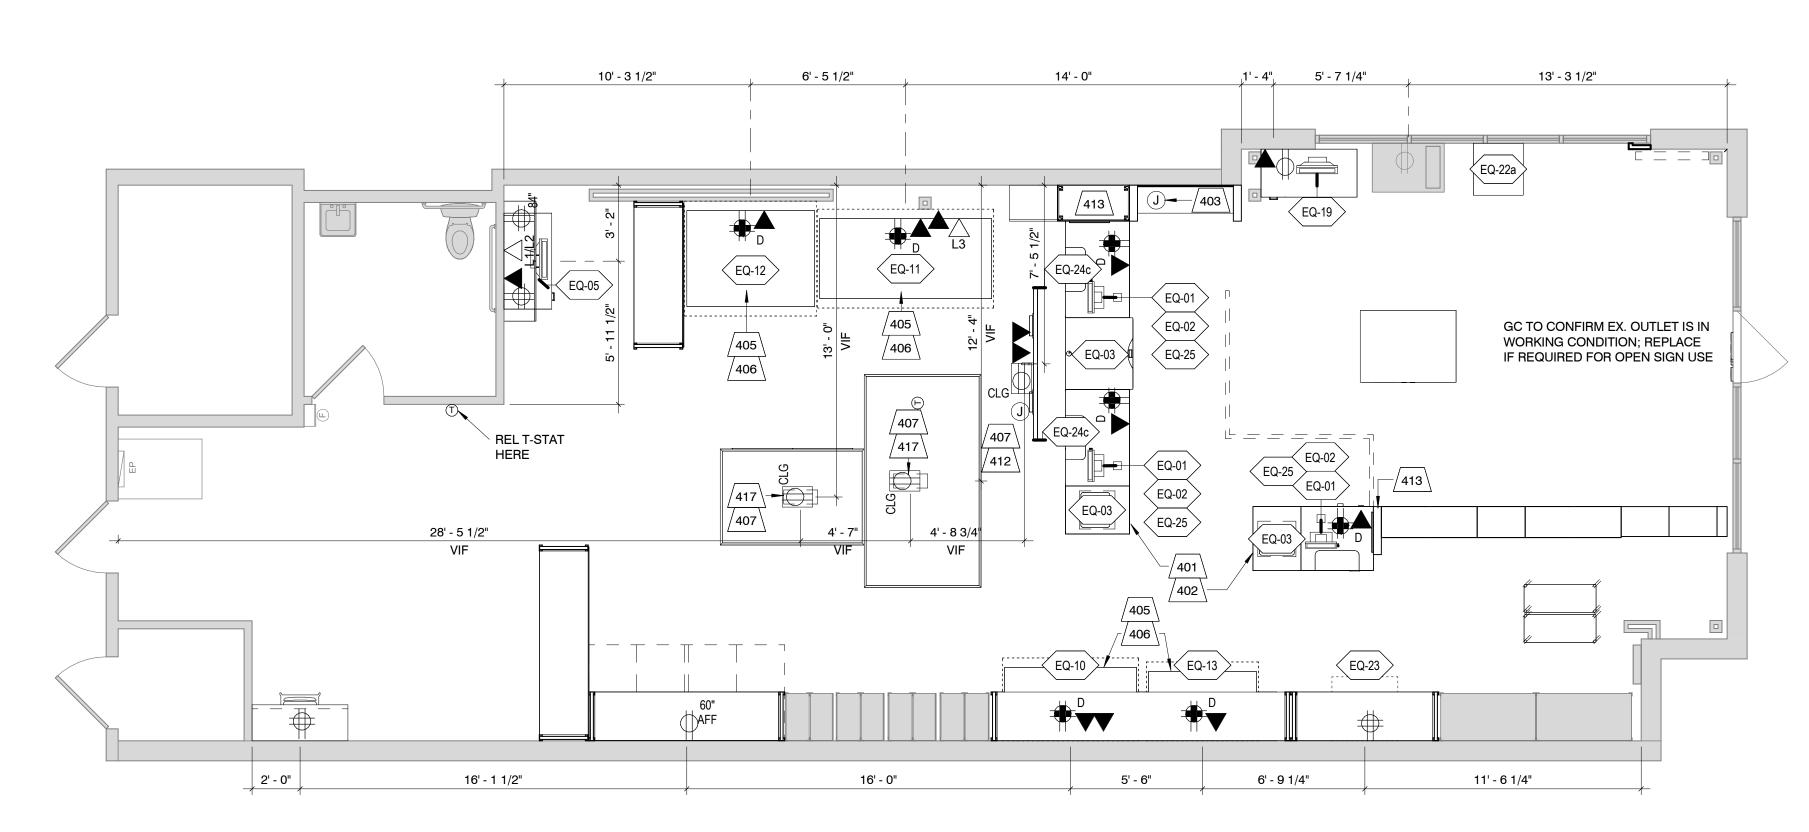
Sheet Title:

Electrical Plan

Project Number:
2025901.309
Drawn By:
RAC
Issue Date:


07/21/2025



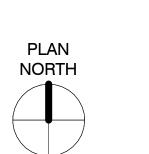

A5 3" = 1'-0"

2 LVT TO SIDEWALK TRANSITION

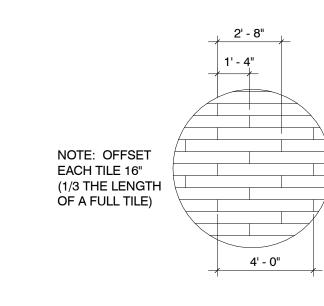

FIN-00 MATERIAL LEGEND

(2) 4'H X 8'W FRP SHEETS WITH TRIM INSTALLED VERTICALLY BY GC

COMMENTS

ANY FIXTURES.

REFER TO PAINT CODES

REFER TO PAINT CODES

RACKING WILL RECEIVE BASE.

PROVIDED BY FIXTURE VENDOR AND SEAMS

PAINT TO BE APPLIED ONLY TO WALL BEHIND PRINT ALCOVE. DOES NOT GET APPLIED TO

BASE TO BE INSTALLED THROUGHOUT

SPACE ON CONVENTIONAL WALLS AND

ALONG THE FOCAL WALL IF APPLICABLE,

REFER TO DESIGN. WB-01 WALL BASE NOT

INSTALLED BEHIND FIXTURES, WALLS WITH

PRODUCT

FRP-01 ITEM: FRP WHITE PANEL

ITEM: PAINT

ITEM: PAINT

COLOR: CAPRI

SCHEEN: EGGSHELL

PRODUCT: 4" COVE

ITEM: VINYL WALL BASE

COLOR: 123 CHARCOAL

MANUFACTURER: ROPPE


GLASBORD® SMOOTH WHITE PEBBLE

MANUFACTURER: BEHR PAINT PRODUCT 066021891212 COLOR: LAMINATE SURF SCHEEN: EGGSHELL

MANUFACTURER: BEHR PAINT

PRODUCT 066021891210

3	TYPICAL LVT INSTALLATION
A 5	1/4" = 1'-0"

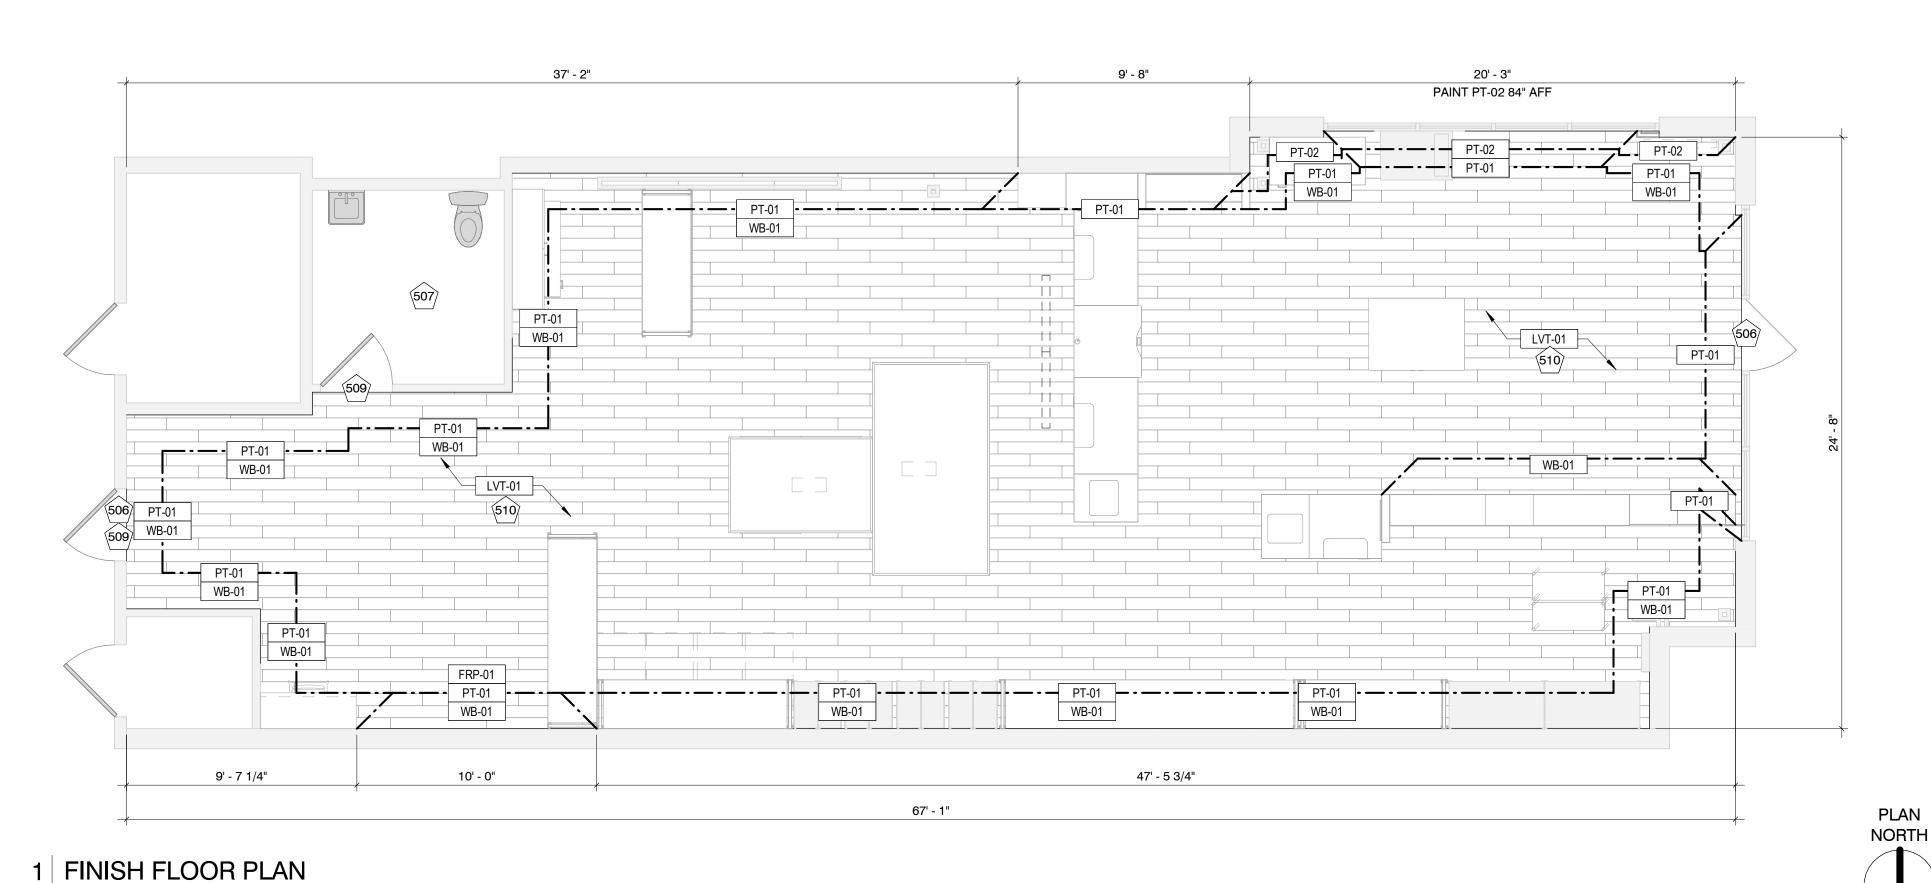

SHERWIN WILLIAMS PAINT CODES

PT-01_LAMINATE S	SURF_	_1 GA	\L		PT-02_CAPRI_1 G/	AL				PT-05_GRAPHIC CI	HARC	COAL_	_1 GA	\L	ALL PAINTS ARE REGISTERED IN SHERWIN WILLIAMS COMPUTER.
CCE COLORANT	oz	32	64	128	CCE COLORANT	OZ	32	64	128	CCE COLORANT	2	32	64	128	ASK AT THE PAINT COUNTER FOR THE UPS STORE, INC. OR USE THE
G2 - NEW GREEN	-	3	-	-	WI - WHITE	2	24	-	1	W1 - WHITE	2	60	-	-	PHONE NUMBER (858) 455-8800 TO RECEIVE A 20% DISCOUNT.
N1 - RAW UMBER	-	22	-	-	L1 - BLUE	4	28	1	-	B1 - BLACK	6	-	1	1	RECEIVE A 20% DISCOUNT.
R4 - NEW RED	-	6	-	-	R3 - MAGENTA	-	6	-	-	N1 - RAW UMBER	-	19	-	1	
					Y1 - YELLOW	-	5	-	1	R2 - MAROON	-	3	-	1	
PROMAR 400 EXTF	PROMAR 400 EXTRA WHITE BASE PROMAR 400 DEEP BASE									PRO INDUSTRIAL E SERIES SEMI GLOS			150		
					HOME) <u> </u>	\mathbf{O}	T /	RE	HR PAINIT		OI	7=	9	

				НО	ME	DEF	POT	/ BE	EHR I	PAIN	1T C	ODES	
PT-01_LA 06602189		E SURF ₋	_1 GAL	PT-02_C 0660218	_	GAL			PT-05_0 SKU #3		CHARC	COAL_1 GAL	ALL PAINTS ARE REGISTERED IN HOME DEPOT COMPUTER. ASK AT THE PAINT COUNTER FOR THE UPS
CLRNT	BL	CL	LL	CLRNT	DL	EL	KXL	TL	CLRNT	BL	KXL	LL	STORE, INC. OR USE THE PHONE NUMBER (858) 455-8800 TO
OZ 384TH	0 5.5	0 12.5	2 126.5	OZ 384TH	0 120	0 276	2 126	0 13	OZ 384TH	3 220	2 330	3 220	RECEIVE À 20% DISCOUNT.
BASE	2750			BASE	2753				BASE	3930	DEEP		

FINISH PLAN GENERAL NOTES

- GC TO LEAVE ALL UNUSED PAINT IN CENTER
- ALL BASE TO BE INSTALLED AFTER FIXTURE INSTALLATION. WB-01 WALL BASE TO BE INSTALLED THROUGHOUT SPACE ON CONVENTIONAL WALLS AND ALONG THE CUSTOMER SIDE OF MODULAR MAILROOM FIXTURES/MODULAR WALLS, REFER TO DESIGN. WB-01 WALL BASE NOT INSTALLED BEHIND FIXTURES, BUT WALLS WITH RACKING WILL RECEIVE BASE. IF POS/SCALE STAND FRONT SERVICE COUNTER FIXTURE LEG LEVELERS ARE VISIBLE, GC TO INSTALL WB-01 WALL BASE TO FRONT OF FIXTURES TO HIDE GAP FROM FIXTURE TO FLOOR AND TO HAVE CONSISTENT COVE BASE HEIGHTS. OPTIONAL COVE BASE MAY BE APPLIED TO SIDE OF SCALE STAND AND PRIVACY PANEL.
- FRP-01 TO 8'-0" AFF. INSTALLED VERTICALLY. WIDTH PER PLAN.
- GENERAL CONTRACTOR TO REFER TO FIXTURE INSTALLATION MANUAL AND SPECIFIC FLOORING VENDOR INSTALLATION AND FLOOR PREPARATION REQUIREMENTS.
- WHEN THERE IS EXISTING LVT, ALL FLOORING PATCH WORK MUST BE COMPLETED SO THAT THERE ARE FULL FLOOR PLANKS INSTALLED. WHEN NEEDED, REMOVE PARTIAL PLANKS AND INSTALL FULL PLANKS. MAINTAIN LVT DIRECTIONAL LAYOUT PER PLAN.

	FINISH KEYED NOTES	Pro
Key Value	Keynote Text	-
506	FLOOR TRANSITION. REFER TO DETAIL 2/A5.	
507	EXISTING RESTROOM TO REMAIN.	=
509	DOOR TO BE PAINTED PT-05 SHERWIN WILLIAMS GRAPHIC CHARCOAL.	
510	EXISTING LVT FLOORING AND TO REMAIN. GC TO CONFIRM IF THE LVT FLOORING RUNS UNDER THE CURRENT RETAIL, MAIL ROOM, FRONT SERVICE COUNTER, AND BACK SERVICE COUNTER. INSTALL NEW LVT AS NEEDED AND MATCH EXISTING SEAM PATTERNS. NEW CHARCOAL WALL BASE TO BE INSTALLED.	




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Project Team:

Franchisee: Pugh, Mary & Melissa P: 816.875.4070 store6685@theupsstore.com

General Contractor: To Be Selected

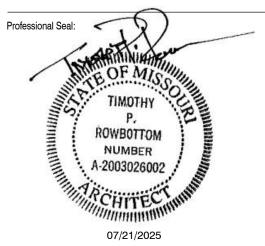

roject Title:

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No.	Description	

Sheet Title:

Finish Plan

Project Number: 2025901.309 RAC Issue Date:

07/21/2025

A5 1/4" = 1'-0"

		FIXTURE SCHEDULE - NEW		
FIXTURE TAG	FIXTURE TAG COUNT DESCRIPTION			
BH-B1L	1	SINGLE REAR LOAD MAIL CABINET	ASY53541	402
BH-B2	2	MODULAR MAIL BOX	BH-B2	136
BH-B3	2	MAIL UPPER CABINET	BH-B3	137
BH-B3L	1	SINGLE MAIL UPPER CABINET	BH-B3L	417
BH-B7	2	MOBILE MAIL STORAGE RACK	BH-B7	222
BH-D2	1	PEG BOARD 40"H X 20"W – CENTER ON FIXTURE/MODULAR WALL, INSTALL VERTICALLY AT 82" AFF	BH-D2	286
BH-D7L	2	MULTI-USE DESK 48"W X 34"H	BH-D7L	404
BH-D9	1	LOBBY ISLAND	BH-D9	502
BH-E1A	1	RETAIL WALL KIT 48"W X 84"H; LIGHT TO REMAIN ON AT ALL TIMES	BH-E1A	019
BH-E20	1	RETAIL SOFFIT 56"W X 60"H WITH LIGHT AND (2) 4"W X 84" H RETAIL MODULAR WALL	BH-E20	369
BH-F1BL	1	POS COUNTER W/ SOLID FRONT 36"W X 32"D X 36"H	BH-F1BL	416
BH-F2BL	2	POS COUNTER W/ SOLID FRONT 48"W X 32"D X 36"H	BH-F2BL	473
BH-F3L	1	SCALE STAND 36"W X 32"D	BH-F3L	466
BH-F4L	2	SCALE STAND 24"W X 32"D	BH-F4L	406
BH-F6	1	ADA PULL OUT SHELF	BH-F6	009
BH-F8	1	PEG BOARD 24"H X 20"W – CENTER ON FIXTURE/MODULAR WALL, INSTALL VERTICALLY AT 78" AFF	BH-F8	059
BH-F11	1	POS MODULAR WALL UNIVERSAL FASCIA KIT (24"H) - GC CUT TO FIT	BH-F11	334
BH-F14				430
BH-F15				431
BH-H4	1	TOOL CABINET W/ DOOR	BH-H4	049
BH-I2	1	MODULAR WALL, POS 36"W X 18"D X 96"H	BH-I2	038
BH-I17L	1	MODULAR WALL 24'W X 4"D X 96"H	BH-I17L	471
BH-I21L	1	MODULAR WALL 144"H x 15"W X 5"D	TBD	TUPS509A
BH-I22L 1 MODULAR MAILROOM CABINET 24"W X 15"D X 96"H		MODULAR MAILROOM CABINET 24"W X 15"D X 96"H	BH-I22L	510

		FIXTURE SCHEDULE - NEW		
FIXTURE TAG	COUNT	DESCRIPTION	VIRA	3C #
BH-I23L	1	MODULAR MAILDROP CABINET W/ MAIL SLOT 24"W X 15"D X 96"H	BH-I23L	511
BH-J1	1	MOBILE PRINT TABLE - CUTTING MAT 106"W X 58"D X 36"H	BH-J1	044
BH-J2	2	PRINT WORKSHOP CABINET W/ SHELVES 42"W X 21"D X 20.5"H	BH-J2	046
BH-J7L	1	MOBILE PACK TABLE - CARPET TOP 72"W X 48"D X 31"H	BH-J7L	492
BH-J8L	3	CORRUGATE WORKSHOP CABINET 30"W X 23"D	BH-J8L	517
BH-J10L	1	CUBBY CABINET	BH-J10L	498
BH-J21	2	METAL STORAGE RACK 72"W X 24"D X 96"H; TOP SHELF TO BE INSTALLED FLUSH WITH CORNER POSTS	ASY53922	252T
BH-J21L	1	PRIVACY PANEL WITH FRP INSTALLED HORIZONTALLY 72"W X 96"H	BH-J21L	474
BH-J21T	1	METAL STORAGE RACK SHELF KIT 72"W X 24"D	BH-J21T	252S
BH-J22	2	METAL STORAGE RACK 96"W X 24"D X 96"H; TOP SHELF TO BE INSTALLED FLUSH WITH CORNER POST; IF INSTALLED WITH J43, TOP SHELF TO BE INSTALLED AT 40" AFF	ASY13578	253T
BH-J22L	1	PRIVACY PANEL WITH FRP INSTALLED HORIZONTALLY 96"W X 96"H	SUB32877	476
BH-J23	1	METAL STORAGE RACK 144"W X 24"D X 96"H; TOP SHELF TO BE INSTALLED FLUSH WITH CORNER POSTS	BH-J23	254T
BH-J26	2	RETRACTABLE EXTENSION CORD REEL - REFER TO SHEET A9 FOR INSTALL INFORMATION - INSTALL WITH NARROW SIDE FACING STOREFRONT	BH-J26	256
BH-J35	1	PATCH PANEL CABINET 60"W X 24"H - PHONE BOARD AND DATA TO BE INSTALLED WITHIN CABINET. TOP OF CABINET TO BE INSTALLED AT 96" AFF. MAINTAIN 18" MIN. CLEARANCE FROM THE CEILING.	BH-J35	052
BH-J37	1	BREAK BAR KIT - INSTALL COUNTERTOP AT 34" AFF	BH-J37	026
BH-J43	1	WALL MOUNTED BUBBLE WRAP		100408-C

FIXTURE SCHEDULE - EXISTING				
FIXTURE TAG	COUNT	DESCRIPTION	VIRA	3C #
BH-B5	1	KEY CABINET; INSTALL BOTTOM OF CABINET AT 34" AFF	4403-V	4403-C
BH-C7	1	TIME SAVING KIOSK 36" X 24"	BH-C7	411L
P7	2	48" STORAGE RACK (24"DEEP)		
P27	1	24" STARTER METAL CARTON RACK (24" DEEP)		
P29	3	24" ADD-ON METAL CARTON RACK (24" DEEP)		

(0) FLOOR PLAN KEYED NOTES Key Value Keynote Text EXISTING DOOR TO REMAIN. EXISTING STOREFRONT TO REMAIN. ELECTRICAL PANEL MAILBOX MODULES PROVIDED BY TUPSS VENDOR. FIBERGLASS REINFORCED PLASTIC PANELS; INSTALLED VERTICALLY (TO BE PROVIDED BY FIXTURE VENDOR AND INSTALLED BY GC) COPIER BINDER COMPUTER LAMINATOR DIGITAL MONITOR WITH CEILING MOUNT. BOTTOM OF MONITOR TO BE INSTALLED AT 80" AFF, REFER TO DETAIL 6/A9. FOR CEILING HEIGHTS OVER 12'-0" OR OPEN CEILING APPLICATIONS REFER TO DETAIL 5/A9. Contractor: INFLATABLE AIR CUSHIONING MACHINE TOP SHELF FLUSH WITH TOP OF CORNER UPLIGHTS AND LOWER SHELF TO BE INSTALLED AT 72" AFF WALL MOUNTED BUBBLE WRAP; IF INSTALLED ABOVE A BH-J22, MOUNT AT 9'-6" AFF AND CENTERED BETWEEN 8' RACK CORNER UPRIGHTS. IF CEILING HEIGHT IS 9'-6" OR LOWER, MOUNT 6" BELOW CEILING. TOP SHELF OF BH-J22 AT 48" AFF. BH-K11L FASCIA PANEL TO FILL SPACE BETWEEN GLASS STOREFRONT AND BH-I21L. REFER TO DETAIL 14/A9. ILLUMINATED OPEN SIGN PRIVACY PANEL FRP TO BE INSTALLED/SEAMED HORIZONTALLY; SEE INSTALL MANUAL FOR DETAILS

CUTTER

635



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> Project Team: Franchisee: Pugh, Mary & Melissa P: 816.875.4070

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General

To Be Selected

TIMOTHY ROWBOTTOM NUMBER A-2003026002 07/21/2025

Project Title:

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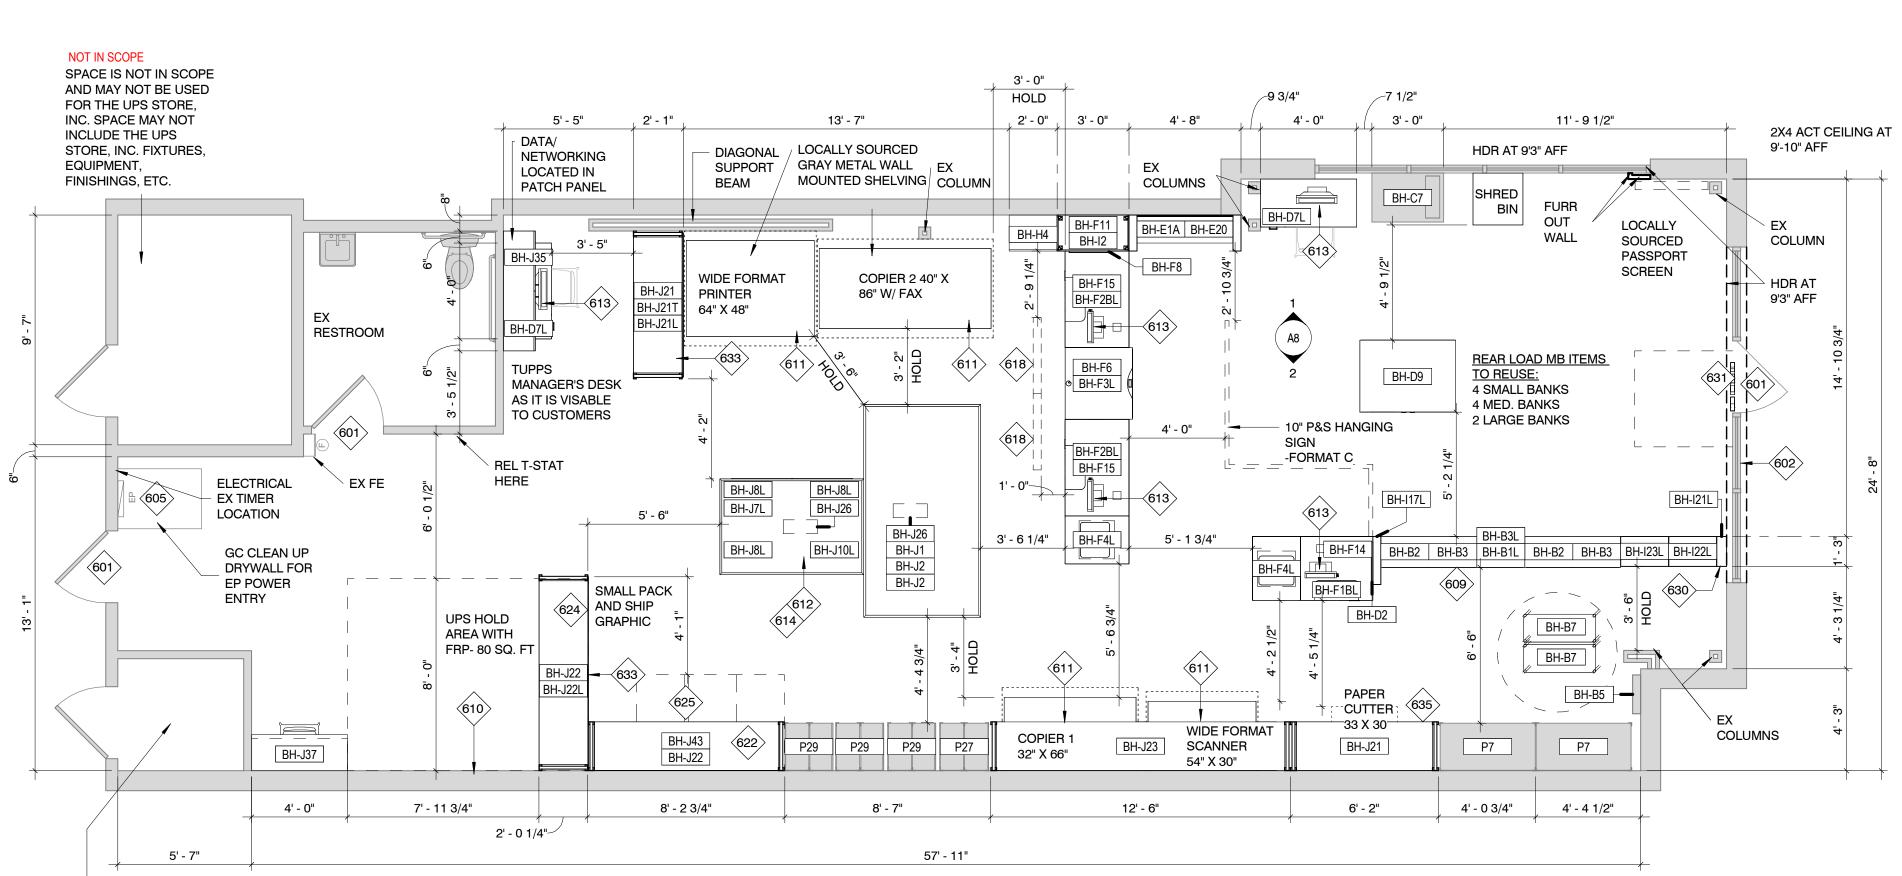
07/21/2025

Fixture Plan

Ab

DIMENSIONS PROVIDED ON PLAN ARE FOR GENERAL REFERENCE ONLY. ACTUAL FINAL MEASUREMENTS OF FIXTURES BOTH NEW AND EXISTING MAY VARY SLIGHTLY. GC TO VERIFY ON SITE AND NOTIFY PROJECT MANAGER OF VARIANCES.

MANAGERS' DESK AND BREAK BAR STOOLS LOCALLY SOURCED



NOT IN SCOPE

SPACE IS NOT IN SCOPE AND MAY NOT BE USED FOR THE UPS STORE, INC. SPACE MAY NOT INCLUDE THE UPS STORE, INC. FIXTURES, EQUIPMENT, FINISHINGS, ETC.

1 FIXTURE FLOOR PLAN

A6 1/4" = 1'-0"

NORTH

PLAN

GRAPHICS PLAN


A7 | 1/4" = 1'-0"


PROFIT CENTER BROCHURES / GX-49 /

GRAPHIC HARDWARE / GX-H1 // GX-H2 // GX-H4 / / GX-H5 // GX-H6 // GX-H9 /

GX-15 & GX-51 APPLIED BY FEE/FC PER PLAN-O-GRAM

IF THE FOLLOWING WINDOW GRAPHIC DOES NOT FIT DUE TO A WINDOWPANE, MULLION, ETC. OMIT GRAPHIC GX-01, GX-02B, GX-33

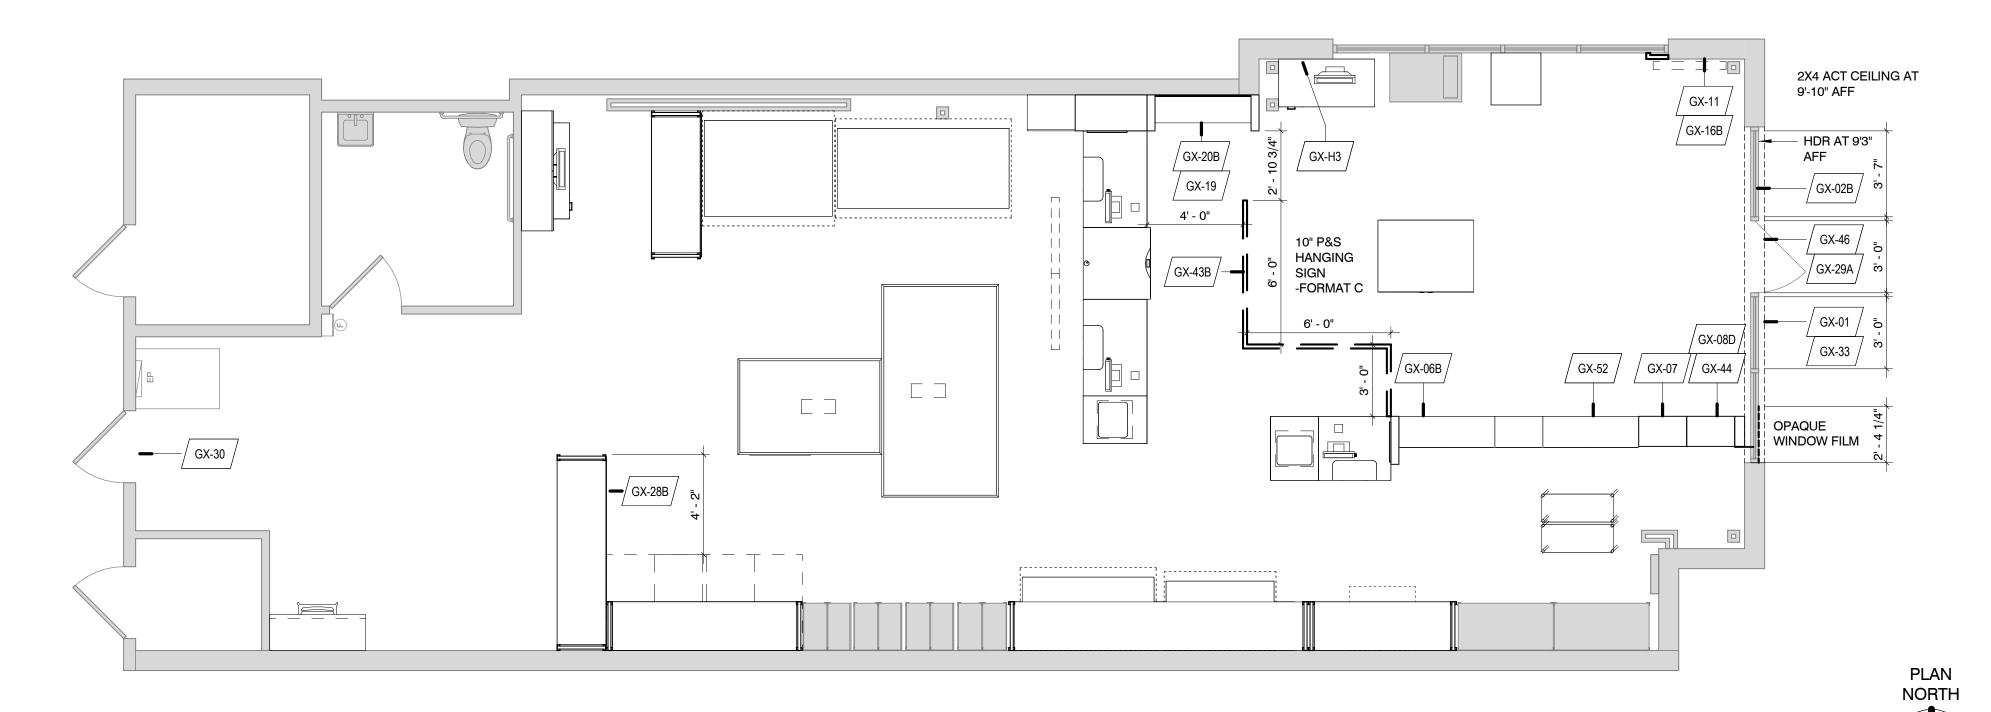

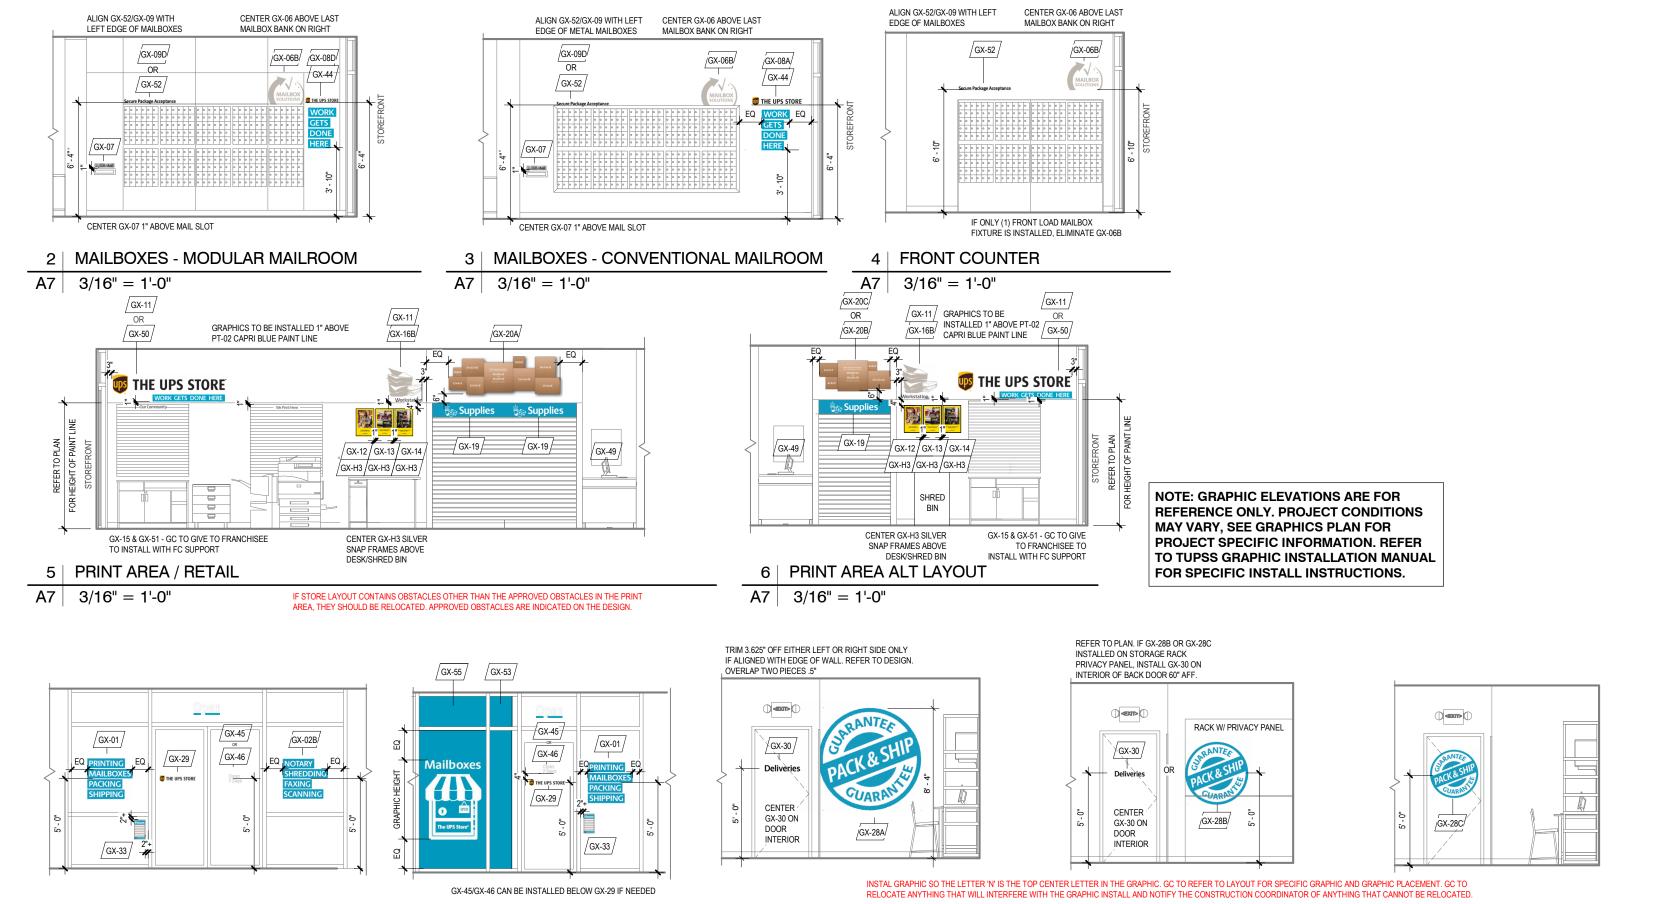

/ GX-00 / GRAPHICS SCHEDULE NO. COUNT DESCRIPTION GX-01 LEFT WINDOW PROMO RIGHT WINDOW PROMO GX-02B GX-06B NON 24 HR CLOCK ICON GX-07 MAILBOX PLAQUE GX-08D 22" WIDE THE UPS STORE LOGO GX-11 WORK STATION ICON GX-12 WALL POSTER KIT - PRINT SERVICES GX-13A WALL POSTER KIT - MAILBOX SERVICES GX-13B WALL POSTER KIT - CERTIFIED PACKING EXPERTS WALL POSTER KIT - PACK & SHIP GUARENTEE GX-14 GX-14A WALL POSTER KIT - SMALL BUSINESS RESOURCES GX-14B WALL POSTER KIT - SHREDDING SERVICES GX-15 OUR COMMUNITY LAMINATED SIGN GX-16B NON 24 HR WORK STATION HEADER GX-19 SUPPLIES RETAIL WALL HEADER (4'-0" OF RETAIL) GX-20B SMALL BOX DISPLAY GX-28B PACK AND SHIP GUARANTEE SEAL - SMALL GX-29A 22"W THE UPS STORE LOGO FRONT DOOR - LARGE GX-30 BOH DOOR DELIVERIES DECAL GX-33 HOURS SIGN GX-43B PACK & SHIP SOLUTIONS HANGING SIGN (10"); INSTALL PER FORMAT TYPE LISTED ON FIXTURE PLAN AND HANGING SIGN INSTRUCTIONS; PLEASE REACH OUT TO CW PM IF NOT IN SPECIFICATION PACKET. GX-44 WORK GETS DONE HERE DECAL GX-46 OPEN 7 DAYS DOOR MESSAGE GX-49 LL BROCHURES GX-51 WE PRINT HERE LAMINATED SIGN GX-52 SECURE PACKAGE ACCEPTANCE GX-H1 CERTIFICATE SNAP FRAMES GX-H2 BROCHURE HOLDERS GX-H3 WALL POSTER SNAP FRAMES (1) GX-H4 MAGNETS GX-H5 MAGNETS W/ CLIPS GX-H6 PACK OF MAGNETIC TAPE GX-H9 "L" BRACKET HARDWARE



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General To Be Selected Contractor:



Project Title:

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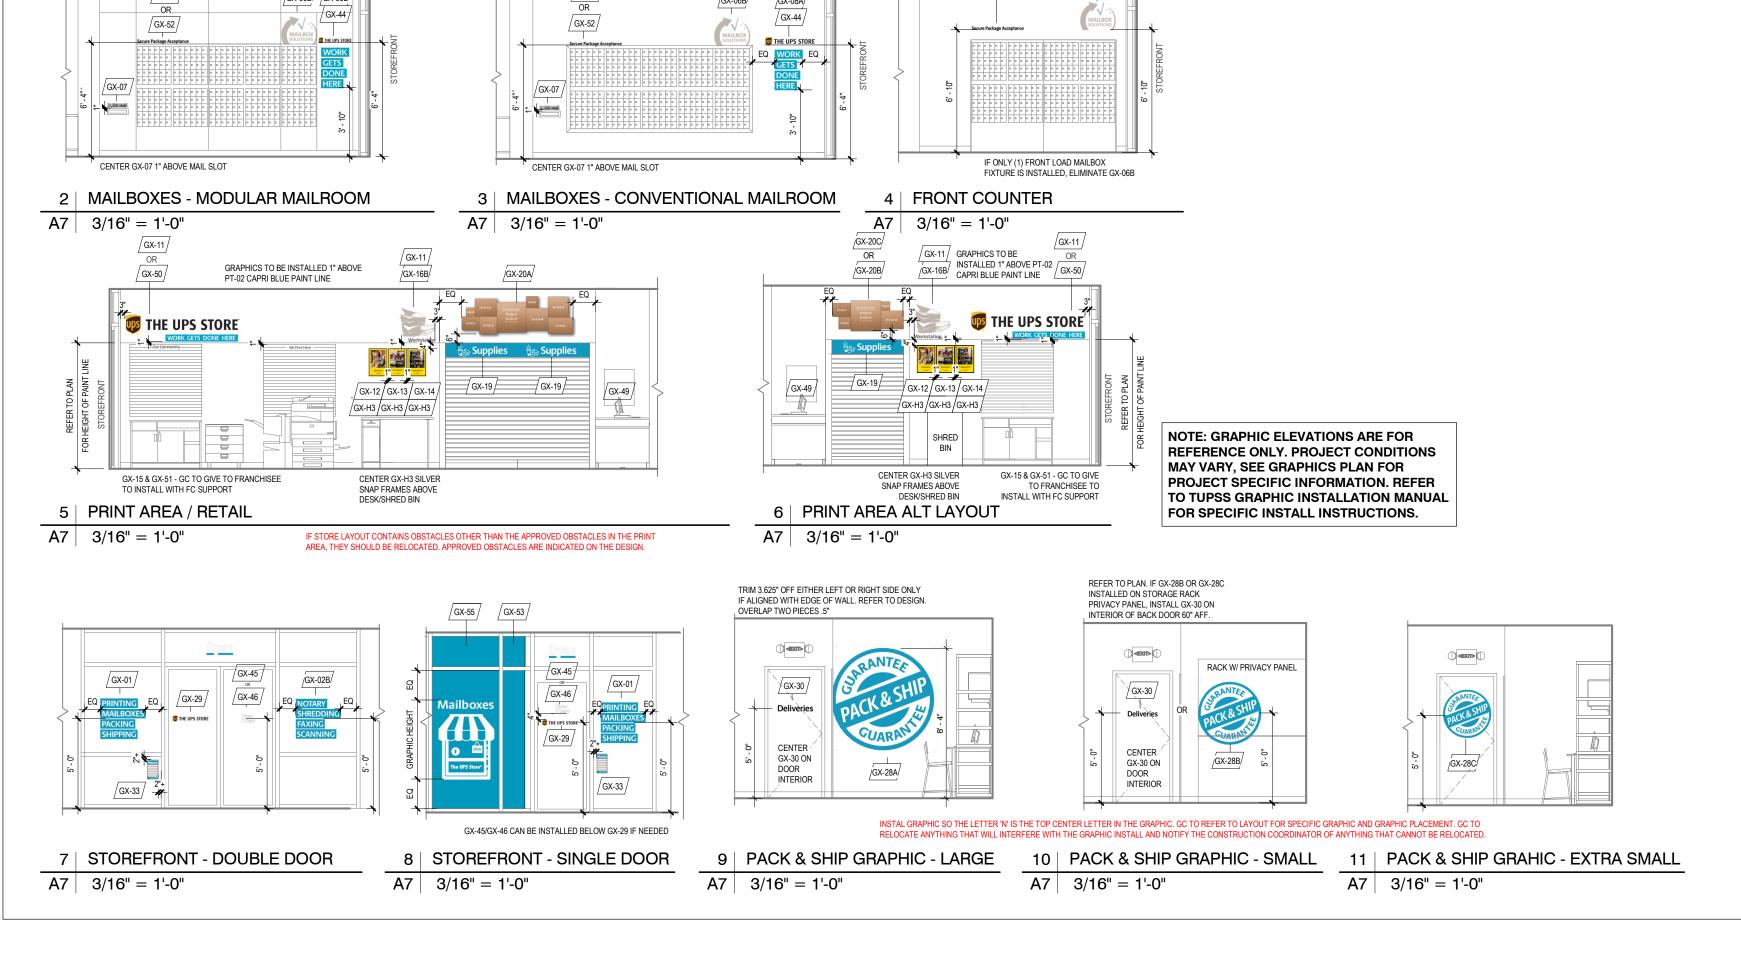
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Graphics Plan & Elevations

2025901.309 RAC Issue Date:

07/21/2025



GRAPHIC INSTALL INSTRUCTIONS WALL DECALS, WINDOWS CLINGS & SMALL BOX DISPLAYS

WALL DECAL INSTALLATION


2. CLEAN SURFACE THOROUGHLY WHERE DECAL IS TO BE APPLIED MAKING SURE SURFACE IS FREE OF ANY INSTALLTION AND 24 HOURS AFTER THE VINYL GRAPHIC IS INSTALLED.

3. PLACE DECAL (WITHOUT REMOVING THE BACKING PAPER) INTO POSITION ON SURFACE AND MAKE REMOVABLE GUIDES ON SURFACE WITH MASKING TAPE ON TOP, AS SHOWN ABOVE. 4. TURN DECAL UPSIDE DOWN ON A FLAT SURFACE, THEN PEEL THE BACKING SHEET APPROXIMATELY 3"

AND FOLD. (IF THE DECAL IS NOT STICKING TO THE PRE-MASK, TURN RIGHT-SIDE-UP AND RUB WITH SQUEEGEE OR STIFF CARD. TRY AGAIN TO PEEL.) 5. PLACE ONE CORNER EDGE OF THE DECAL, WITH PRE-MASK, INTO POSITION.

6. AFTER DECAL IS STRAIGHT AND IN CORRECT POSITION, PRESS THE DECAL SLOWLY AND GENTLY AGAINST THE SURFACE. WORK ACROSS THE DECAL WITH SQUEEGEE NITL ALL AREAS ARE ADHERED. IF 5. PEEP BACKING SHEET OFF OF CLING. SMALL BUBBLES OCCUR, SQUEEGEE DECAL STARTING IN CENTER AND WORKING THEM OUT THE EDGES

7. WHEN ALL BUBBLES ARE REMOVED, BURNISH THE DECAL FIRMLY (WITH PREL-MASK STILL ADHERED) AGAINST THE SURFACE WITH THE SQUEEGEE. 8. PEEL OFF THE PRE-MASK LAYER SLOWLY.

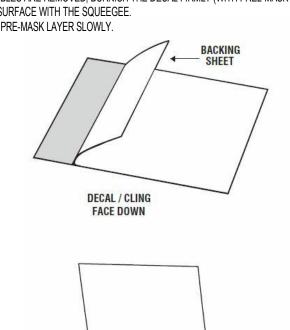



EXTERIOR WINDOWS GRAPHIC INSTALLATION

1. INSTALL WALL GRAPHICS 5-7 DAYS AFTER WALLS HAVE BEEN PAINTED TO ALLOW FOR OFF-GASSING. 1. INSTALL EXTERIOR WINDOW GRAPHICS WHEN WINDOW TEMPURATURE IS 40-85 DEGREES FAHRENHEIT DURING

DUST OR GREASE. FAILURE TO ADEQUATELY CLEAN THE SURFACE MAY RESUTL IN DECAL PEEING OVER 2. INSPECT WINDOWS FOR ANY ADHESIVE REMNANTS, PAINT SPECS, GRIME AND LOOSE SILICONE ON GLASS.

3. CLEAN SURFACE THOROUGHLY WHERE CLING IS TO BE APPLIED MAKING SURE SURFACE IS FREE OF ANY DUST OR GREASE. WIPE DOWN THE WINDOWS WITH 70% ISOPROPYL ALCOHOL PAYING CLOSE ATTENTION TO THE SILICONE EDGES AND SEAMS WHERE THE GLASS MEETS. DIRT TENDS TO ACCUMULATE THE MOST THERE AND WILL CONTAMINATE THE EDGES AND CAUSE LIFTING OF VINYL. • REMOVE ANY LOOSE SILICONE. THESE MAY APPEAR AS "BUBBLES" UNDER THE VINYL AND WILL BE HARD TO

REMOVE AFTER APPLICATION. 4. VERY CAREFULLY SCRAPE OFF ANY CONTAMINATES ON THE INSTALLATION SURFACE BY SPRAYING SOME GLASS

CLEANER (OR SOAPY WATER IF NON AVAILABLE) ONTO THE SURFACE TO AVOID SCRATCHING THE GLASS.

6. PLACE IN LOCATION SO THAT ANY COPY WILL BE READ FROM THE DESIRED DIRECTION. MEASURE OR USE A STRAIGHT EDGE TO MAKE SURE CLING IS STRAIGHT AND PRESS INTO PLACE FROM ONE SIDE TO THE OTHER. • GX-47A, GX-47B, GX-48A, GX 48B AND GRAPHICS WITH PROFIT CENTERS

SHOULD BE CENTERED WITHIN THE WINDOW MULLIONS. THE PLAN BLUE OR WHITE FILL COLOR MUST HAVE EQUAL SPACE ON THE RIGHT AND LEFT AND TOP AND BOTTOM OF THE WORDS AND IMAGE.

7. MAKE SURE NO AIR BUBBLES ARE TRAPPED BENEATH. AS CLING IS BEING APPLIED, LIFT EDGE AND PUSH ANY 8. ONCE APPLICATION OF VINYL IS COMPLETED, THE EXCESS VINYL WILL NEED TO BE CUT. START BY PLACING THE SQUEEGEE WHERE THE GLASS AND SILICONE MEET. NOW PLACE THE KNIFE UP AGAINST THE SQUEEGEE ON THE OPPOSITE SIDE OF THE SILICONE. AS YOU MAKE YOUR CUT, MAKE SURE TO SLIDE THE SQUEEGEE SIMULTANEOUSLY WITH THE KNIFE USING IT AS A GUIDE TO GET AN EVEN CUT. MAKE SURE THE CUTTING GAP IS NO BIGGER THAN AN 1/8TH OF AN INCH (THICKNESS OF THE SQUEEGEE).

9. IF IN THE SCENARIO WHERE THERE IS SILICONE IN BETWEEN GLASS PANES, POKE IN THE TIP OF THE KNIFE ABOUT AN 1/8TH OF AN INCH AND CUT THE EDGE AT A 45 DEGREE ANGLE AS SEEN ON THE GLASS. 10. AFTER CUTTING IS COMPLETED, CAREFULLY REMOVE THE EXCESS VINYL MAKING SURE IT WAS CUT ALL THE WAY THROUGH. CUTS MUST BE STRAIGHT AND CLEAN.


11. SQUEEGEE DOWN EDGES ONCE AGAIN TO ENSURE FULL BOND TO GLASS. 12. USE HEAT GUN TO REMOVE WRINKLES OR OVER STRETCHED AREAS. SUPPLIES NEEDED 70% ISOPROPYL ALCOHOL AMMONIA FREE GLASS CLEANER SQUEEGEE

Bottom of Display

is 10" below bottom of Template

MICROFIBER TOWELS

HEAT GUN

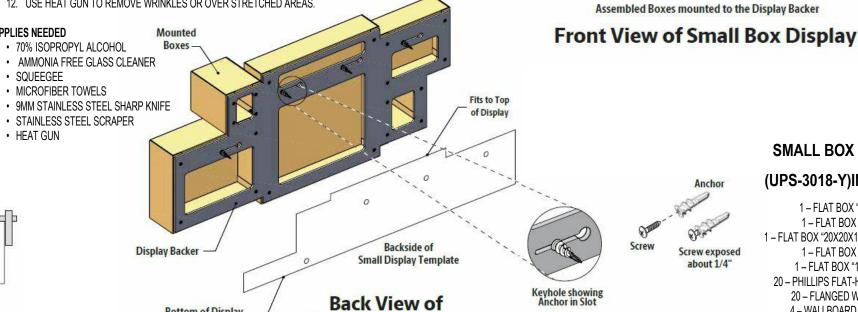

Small Box Display

(when installed)

SMALL BOX DISPLAY

Assembled Boxes mounted to the Display Backer

SMALL BOX DISPLAY INSTALLATION

1. MEASURE TO DETERMINE PLACEMENT OF THE ASSEMBLED BOX DISPLAY ON WALL. MAKING

3. INSTALL ANCHORS WHERE MARKED ON WALL FROM STEP 2. USING A POWER DRILL WITH A

5. ALIGN HOLES IN BACKER OF BOX DISPLAY WITH EXPOSED SCREWS AND HANG PANEL TO

WALL. ONCE THE LARGE HOLE IN THE KEYHOLE SLOT IS LOCATED OVER THE SCREW/ANCHOR.

NOTE: BE SURE NOT TO DRILL WHERE THERE ARE STUDS BEHIND THE DRYWALL. PLASTIC

SURE THE TEMPLATE IS LEVEL, TAPE TO WALL WITH REMOVABLE TAPE.

2. USE A PENCIL TO MARK THE HOLE LOCATIONS ON WALL. REMOVE TEMPLATE.

ANCHORS ARE NOT DESIGNED TO PENETRATE WOOD OR STEEL STUDS.

4. TURN SCREWS INTO ANCHORS LEAVING ABOUT 1/4" OF THE SCREW EXPOSED.

MOUNT THE SMALL BOX DISPLAY TO THE WALL

SLIDE TO THE LEFT.

PHILLIPS BIT, DRIVE ANCHORS INTO WALL.

Sample Flat Box

(UPS-3018-Y)INCLUDES: 1 - FLAT BOX "12X9X3" 1 - FLAT BOX "8X8X8" 1 – FLAT BOX "20X20X12 AND 20X20X20" 1 – FLAT BOX "6X6X6" 1 – FLAT BOX "15X12X10" 20 - PHILLIPS FLAT-HEAD SCREWS 20 - FLANGED WING NUTS 4 - WALLBOARD ANCHORS 4 - PHILLIPS SELF DRILL #8 SCREWS 1 – DISPLAY BACKER (46.5" X 19.5")

1 – INSTALLATION TEMPLATE (46.5" X 10")

Sample Folded Box (back view)


15×12×10

HANGING SIGN INSTALL INSTRUCTIONS


The UPS Store Hanging Sign Install Instructions: Hanging Sign Kits GX-43A 18" or GX-43B 10"

1. GX-43A, 117"W \times 18"H P&S, 72"W \times 18"H RTN, 36"W \times 18"H PS and hardware (see hardware list) 2. GX-43B, 117"W x 10"H P&S, 72"W x 10"H RTN, 36"W x 10"H PS and hardware (see hardware list) F. Qty 12 Panel Bracket A. Qty 12 Hanging Wire 5' Long

G. Qty 16 Post Screws C. Qty 12 Twist Loop for Drop Ceilings **D.** Qty 12 Anchor for Drywall Ceilings

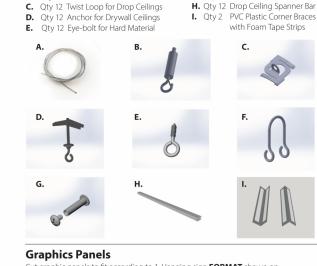

the Center Design 2. Format Measurements Graphic Panels are either GX -43A 18" or GX-43B 10"

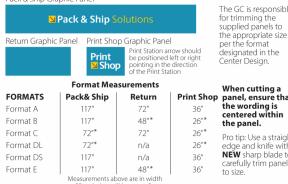




Drop Ceiling Rails - When hanging on drop ceiling rails ,use the twist loop bracket and twist clockwise onto the rail to lock it into position. Clip the J-hook onto the bracket loop. Hard Ceilings - When installing into a hard ceiling like wood, drill a 1/8" pilot hole into the material and screw the eye-bolt directly into the material. Clip the J-hook to the eye-bolt. Drywall Ceilings and Drop Ceiling Panels - When installing into a drywall ceiling or a drop ceiling panel, first drill a 5/8" hole at the desired location. Then, pinch the anchor so and clip a J-hook to the eye-bolt.


Ceiling Fixtures - When hanging on existing ceiling fixtures, like pipes or beams, wrap the wire around the fixture and clip the J-hook to the wire. Drop Ceiling Spanner Bar - When installing on a drop ceiling and needing to put a hanger where there is no ceiling channel, you can add a ceiling channel by rotating the spanner bar into position so that the end catches on the existing channels, as shown. Panel Bracket - This applies to all connections to the panels regardless of the method used to attach the wire to the ceiling. Drill a 1/4" hole 3/4" from the top edge of the panel at the desired location. Install the bracket over the panel and connect it with the supplied post screw. Then, use a J-hook to clip to the wire.

Positioning and Hardware Installation

BEFORE YOU BEGIN: Review your store plan and identify the Format Type assigned to your location. examples of each Store Format can be found on page 2 **1. Position from the front of counter -** Preference of 2′ – 3′ from the front of the counter, but if this doesn't work, move forward versus closer to the counter. (See exceptions for Store Format D) 2. Drill holes for Hardware mounting - Mark the panels and ceiling to align mounting holes as needed.

and connect it with the supplied post screw. Then, use a J-hook to clip to the wire. 3. Position from the floor - The bottom of the sign should be installed 90" from the finished floor. **4. Add corner braces -** Remove the backer on the pre-applied tape strips and affix them to the corners on the back side of the display. The brackets need to be installed on the back of the sign so they are not visible to the customer. After affixing the panel brackets, secure them in place with the provided post screws in the ocations highlighted with the blue dots (illustration 4).

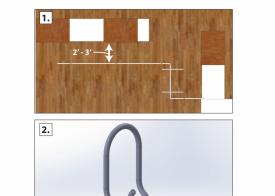

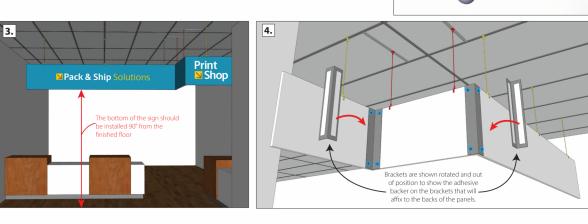





THE UPS STORE HANGING **SIGN EXAMPLES**

 THE UPS STORE DESIGN TEAM DETERMINED THE HANGING SIGN FORMAT TYPE. • HANGING SIGNS ARE REQUIRED TO BE INSTALLED ACCORDING TO

THE CENTER'S THE UPS STORE DESIGN INTENT DRAWINGS AND CONSTRUCTION DOCUMENTS. · SIGN FORMAT MAY NOT BE PLACED ACCORDING TO THE GENERAL

CONTRACTOR/FRANCHISEE. FORMAT DL - L-Shaped Counter

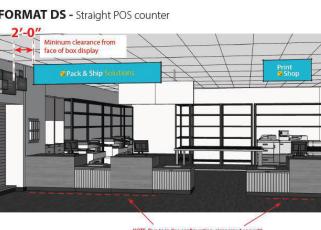

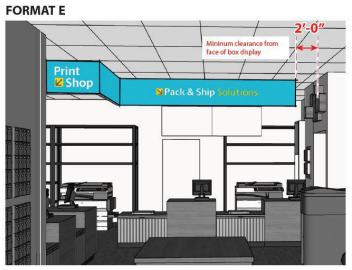

2 HANGING SIGN INSTALL INSTRUCTIONS

Graphic & Sign Install Instructions

LAWRENCE GROUP

P: 816.875.4070

To Be Selected

ROWBOTTOM

Contractor:

'EMEN'

Office: 319 N. Fourth Street, Suite 1000 St. Louis, MO 63102 p 314-231-5700 f 314-231-0816

Project Number: 2025901.309 Drawn By: RAC Issue Date: 07/21/2025

Center 833 SN

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GRAPHIC INSTALL INSTRUCTIONS A7.1 NTS

- FASCIA SOFFIT PANEL SYSTEM PROVIDED BY VENDOR AND FINISHED AS INDICATED. INSTALLED BY GC.
- REFER TO FIXTURE SCHEDULE, FLOOR PLAN KEYED NOTES, AND FIXTURE INSTALLATION MANUAL FOR SPECIFIC MOUNTING HEIGHTS FOR ALL PEG BOARDS AND MONITORS.
- VERIFY CEILING HEIGHT ONSITE AND CUT FASCIA SOFFIT PANEL SYSTEM AND RETAIL SOFFIT FIXTURE TO FIT.

MODULAR FIXTURE SCHEDULE - MERCH					
IXTURE TAG	COUNT	DESCRIPTION	VIRA	3C #	
H-K1	3	FASCIA PANEL 54"W X 24"H	MPW54437	177	
H-K5	6	FASCIA CORNER POST 60"H	MPM29965	310	
H-K6	6	FASCIA U-CHANNEL 96"W	MPP12605	200	
H-K7	2	FASCIA H COUPLER 60"H	BH-K7	201	
H-K9	3	FASCIA OUTSIDE CORNER 60"H	MPP56614	258	

MPW23177 259

478

BH-K11L

TOP CAP 96"W X 6"D X 0.75"H


11" 3' - 2 1/4"

FASCIA PANEL 24"W X 96"H

BH-K10

BH-K11L

20' - 3" PT-02 TO 84" AFF

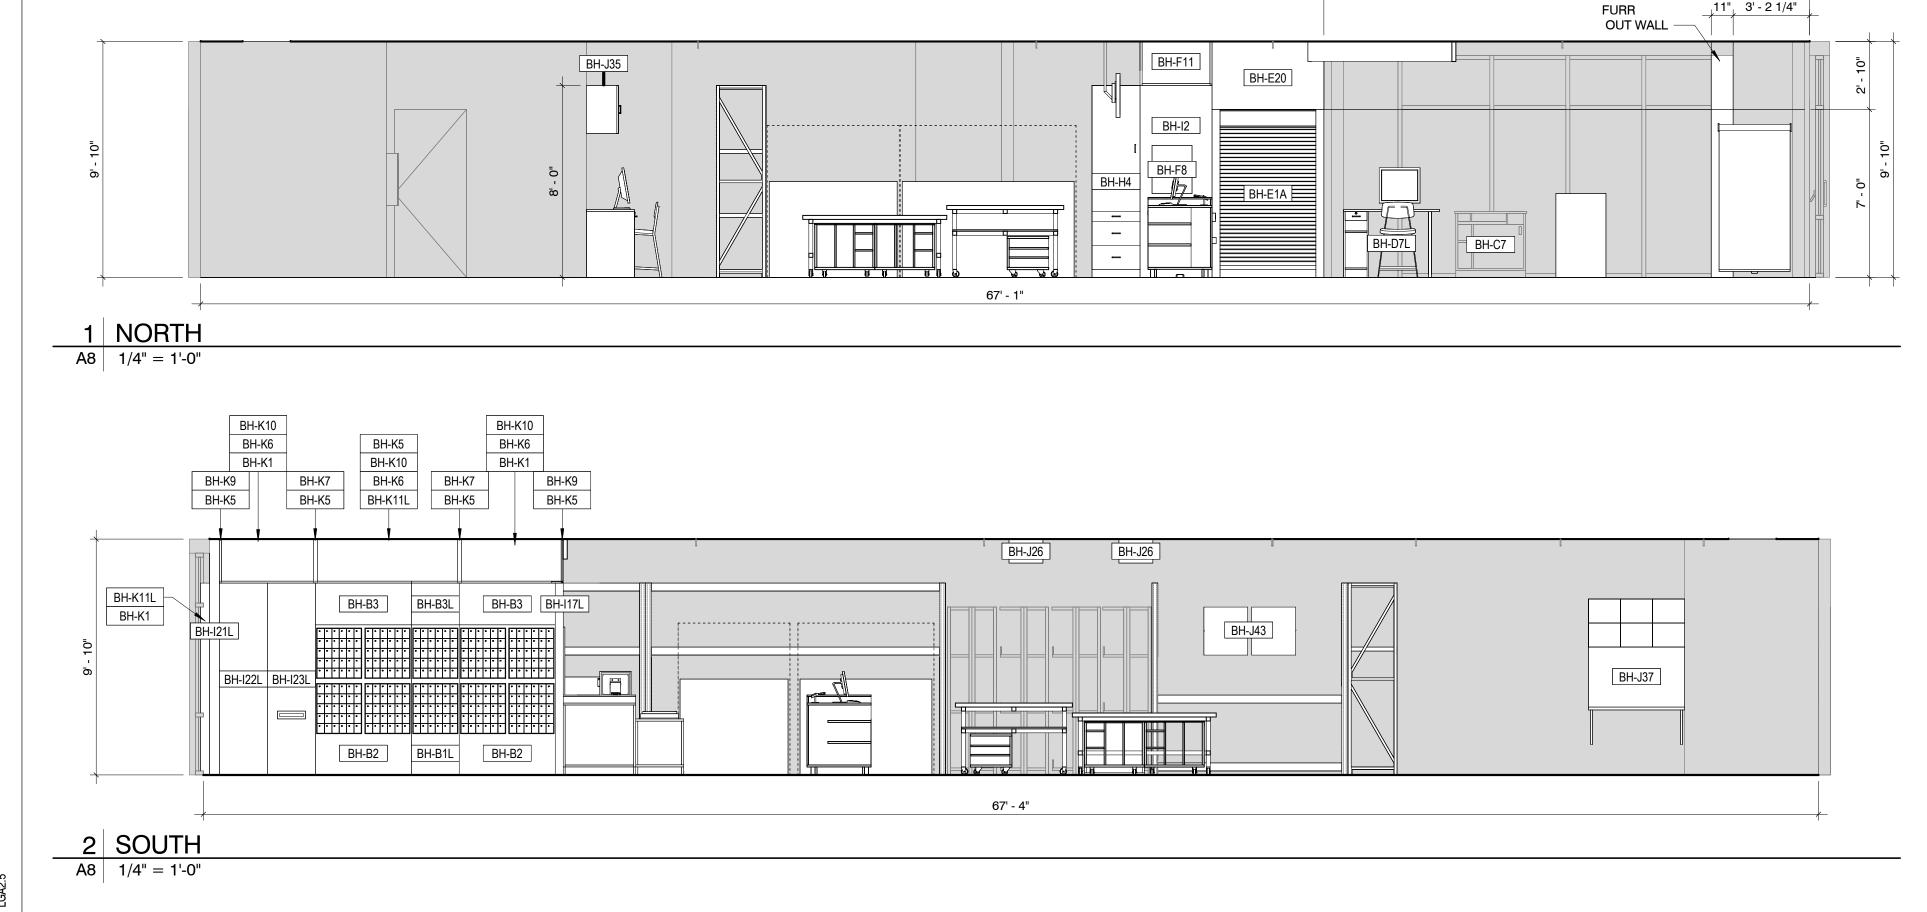

FIXTURE TAG	COUNT	DESCRIPTION	3C #
BH-B1L	1	SINGLE REAR LOAD MAIL CABINET	402
BH-B2	2	MODULAR MAIL BOX	136
BH-B3	2	MAIL UPPER CABINET	137
BH-B3L	1	SINGLE MAIL UPPER CABINET	417
BH-B5	1	KEY CABINET; INSTALL BOTTOM OF CABINET AT 34" AFF	4403-C
BH-B7	2	MOBILE MAIL STORAGE RACK	222
BH-C7	1	TIME SAVING KIOSK 36" X 24"	411L
BH-D2	1	PEG BOARD 40"H X 20"W – CENTER ON FIXTURE/MODULAR WALL, INSTALL VERTICALLY AT 82" AFF	286
BH-D7L	2	MULTI-USE DESK 48"W X 34"H	404
BH-D9	1	LOBBY ISLAND	502
BH-E1A	1	RETAIL WALL KIT 48"W X 84"H; LIGHT TO REMAIN ON AT ALL TIMES	019
BH-E20	1	RETAIL SOFFIT 56"W X 60"H WITH LIGHT AND (2) 4"W X 84" H RETAIL MODULAR WALL	369
BH-F1BL	1	POS COUNTER W/ SOLID FRONT 36"W X 32"D X 36"H	416
BH-F2BL	2	POS COUNTER W/ SOLID FRONT 48"W X 32"D X 36"H	473
BH-F3L	1	SCALE STAND 36"W X 32"D	466
BH-F4L	2	SCALE STAND 24"W X 32"D	406
BH-F6	1	ADA PULL OUT SHELF	009
BH-F8	1	PEG BOARD 24"H X 20"W – CENTER ON FIXTURE/MODULAR WALL, INSTALL VERTICALLY AT 78" AFF	059
BH-F11	1	POS MODULAR WALL UNIVERSAL FASCIA KIT (24"H) - GC CUT TO FIT	334
BH-F14	1	36" POS RISER	430
BH-F15	2	48" POS RISER	431
BH-H4	1	TOOL CABINET W/ DOOR	049
BH-I2	1	MODULAR WALL, POS 36"W X 18"D X 96"H	038
BH-I17L	1	MODULAR WALL 24'W X 4"D X 96"H	471
BH-I21L	1	MODULAR WALL 144"H x 15"W X 5"D	TUPS509/
BH-I22L	1	MODULAR MAILROOM CABINET 24"W X 15"D X 96"H	510
BH-I23L	1	MODULAR MAILDROP CABINET W/ MAIL SLOT 24"W X 15"D X 96"H	511
BH-J1	1	MOBILE PRINT TABLE - CUTTING MAT 106"W X 58"D X 36"H	044
BH-J2	2	PRINT WORKSHOP CABINET W/ SHELVES 42"W X 21"D X 20.5"H	046
BH-J7L	1	MOBILE PACK TABLE - CARPET TOP 72"W X 48"D X 31"H	492
BH-J8L	3	CORRUGATE WORKSHOP CABINET 30"W X 23"D	517
BH-J10L	1	CUBBY CABINET	498
BH-J21	2	METAL STORAGE RACK 72"W X 24"D X 96"H; TOP SHELF TO BE INSTALLED FLUSH WITH CORNER POSTS	252T
BH-J21L	1	PRIVACY PANEL WITH FRP INSTALLED HORIZONTALLY 72"W X 96"H	474
BH-J21T	1	METAL STORAGE RACK SHELF KIT 72"W X 24"D	252S
BH-J22	2	METAL STORAGE RACK 96"W X 24"D X 96"H; TOP SHELF TO BE INSTALLED FLUSH WITH CORNER POST; IF INSTALLED WITH J43, TOP SHELF TO BE INSTALLED AT 40" AFF	253T
BH-J22L	1	PRIVACY PANEL WITH FRP INSTALLED HORIZONTALLY 96"W X 96"H	476
BH-J23	1	METAL STORAGE RACK 144"W X 24"D X 96"H; TOP SHELF TO BE INSTALLED FLUSH WITH CORNER POSTS	254T
BH-J26	2	RETRACTABLE EXTENSION CORD REEL - REFER TO SHEET A9 FOR INSTALL INFORMATION - INSTALL WITH NARROW SIDE FACING STOREFRONT	
BH-J35	1	PATCH PANEL CABINET 60"W X 24"H - PHONE BOARD AND DATA TO BE INSTALLED WITHIN CABINET. TOP OF CABINET TO BE INSTALLED AT 96" AFF. MAINTAIN 18" MIN. CLEARANCE FROM THE CEILING.	052
BH-J37	1	BREAK BAR KIT - INSTALL COUNTERTOP AT 34" AFF	026
BH-J43	1	WALL MOUNTED BUBBLE WRAP	100408-C


FIXTURE SCHEDULE



Office: 319 N. Fourth Street, Suite 1000 St. Louis, MO 63102 p 314-231-5700 f 314-231-0816

Franchisee: Pugh, Mary & Melissa P: 816.875.4070 store6685@theupsstore.com

General Contractor: To Be Selected

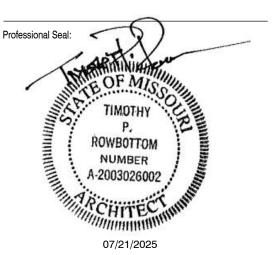

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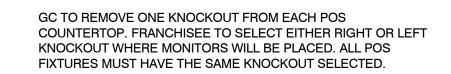
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Interior Elevations

Project Number: 2025901.309 RAC
Issue Date:

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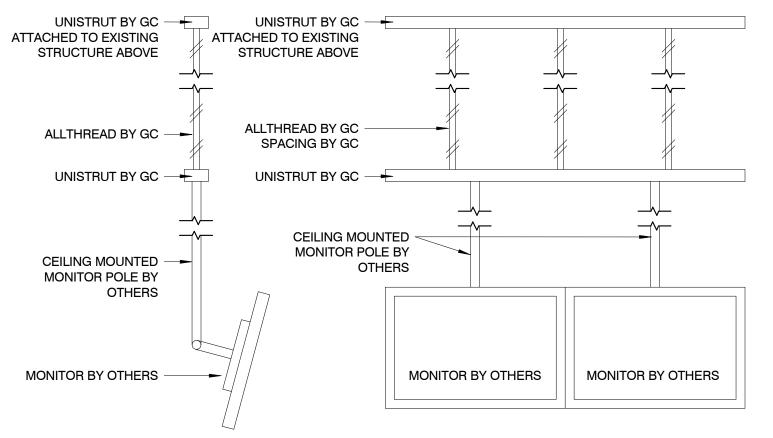
A8



GC TO DRILL THE CENTER OF THE KNOCKOUT USING A 3/8" DRILL BIT. USE A HAND ROUTER WITH FLUSH TRIM BIT AND PLACE IN DRILLED HOLE. ROTATE CLOCKWISE TO GIVE A FLUSH CLEAN EDGE. INSERT GROMMET INTO KNOCKOUT MARKER.

KNOCKOUTS ON SIDE OF FIXTURES TO BE DRILLED OUT WHERE





MONITOR MOUNT DETAIL FOR OPEN 5 CEILINGS OR CEILINGS ABOVE 12'-0"

A9 3/4" = 1'-0"

- DEMISING

1' - 11 1/4" HOLD

GC TO CUT

OPENING

THROUGH

WALL FOR ACCESS TO BH-A4

BEYOND

A9 3/4" = 1'-0"

CONVENTIONAL

9 ELEV - CONV WALL ACCESS FOR BH-A4

7'-11.25" X 1'-11.25"

WALL

ATTACH TO EXIST STRUCTURE **BRACE DIAGONALLY** AS NEEDED **FASTENERS AS REQ'D** BOT OF ACT _ SEE RCP - ACT CEILING 2X6 MOUNTING PLATE -WITH CROSS BRACING - MONITOR POLE TO TO ELIMINATE SWAY GO UP THROUGH OF MONITOR POLE CEILING TILE, SCRIBE TILE ACCORDINGLY CEILING MOUNTED MONITOR POLE BY OTHERS NOTE: VERIFY MOUNTING HEIGHT OF MONITOR / SUSPENDED **CEILING TO DETERMINE 2X6** MOUNTING PLATE LOCATION 6 MONITOR MOUNT DETAIL TYP

DEMISE WALL

GC TO INSTALL BH-J26 CEILING MOUNTED PULL DOWN ELECTRICAL REELS WITH THE NARROW PART OF THE REEL FACING TOWARDS THE STOREFRONT / FRONT DOOR. GC TO PROVIDE **BLOCKING ABOVE CEILING TO SUPPORT** CORD REEL WEIGHT / ATTACHMENT CEILING - CORD REEL

7 RETRACTABLE EXTENSION CORD

A9 3" = 1'-0"

UNISTRUT HS SERIES BH-K6 U-CHANNEL AT TOP -☐ ★ HOLE CHANNEL OF BH-K2 FASCIA PANEL " N1000 HS 12GA -- EXISTING 1/4" NUT / BOLT CEILING FASTENING AT BH-K5 TO UNISTRUT CHANNEL. GC UNISTRUT P2944 TO DRILL BH-K5 POST FOR **BRACKET** 24" X 96" UNISTRUT ATTACHMENT BH-A4 BEYOND BH-K5 POST BH-K2 FASCIA PANEL NOT TO EXCEED 48" PER SPEC PLAN / CABNET BELOW NOTE: THIS DESIGN IS A CUSTOM APPLICATION FOR A CEILING IN EXCESS OF 12'-0" AFF GC TO PROVIDE UNISTRUT / BOLT / NUT AND ATTACHMENTS TO STRUCTURE AND / OR CABINET - CONV. WALL -LOCAL CODE REQUIREMENTS SUPERCEDE THIS DESIGN. GC TO — 2 1/2" - 1/4" DIA. ADJUST AS REQUIRED BOLT / NUT ASSEMBLY (BY GC) BH-K5 TOP CAP BOLT TO BE THROUGH BH-K5 CABINET BELOW -PLATE, BH-K10 TOP PLATE, AND CABINET STRUCTURE BELOW

A9 3/4" = 1'-0"

FASCIA ATTACHMENT DETAIL FOR OPEN 11 CEILINGS OR CEILINGS ABOVE 12'-0" A9 1 1/2" = 1'-0"

3C FIXTURE INSTALL MANUAL: VIRA INSIGHTS FIXTURE INSTALL MANUAL:

12 FIXTURE INSTALL QR CODES A9 3/4" = 1'-0"

PARTITION TYPES

GC TO CUT BH-K11L PANEL TO FILL VOID AT BH-I21L & GLASS AT BH-K11L (CUT TO FIT) BH-I22L STOREFRONT BH-123L TO FILL OPEN SPACE USE 2" WOOD SCREWS @ BH-BH-B2 @ GLASS & BH-I21L I21L & BH-K11L PANEL BH-B1L → ► ATTACHMENT GC TO HAVE FINISHED EDGE OF BH-K11L AT STOREFRONT - EXTERIOR STOREFRONT INTERIOR STORE FRONT @GLA\$S EMPLOYEE SIDE 2" WOOD SCREWS @ BH-K11L GLASS PANEL @ EMPLOYEE SIDE @ 12" O.C. TOP TO BOTTOM -BH-I22L BH-123L GLASS BH-B2 BH-B1L -**EXTERIOR STOREFRONT** BH-I21L STEM WALL @ STOREFRONT LOBBY **TOP VIEW FRONT VIEW**

BH-A4C MAIL SLOT MOUNTING INSTALL -13 CONVENTIONAL WALLS A9 3/4" = 1'-0"

TO PLAN

— CONVENTIONAL WALL

GC TO CUT OUT 11" X 2.3"

ACCESS FOR BH-A4C

GC TO FINISH SHEET

TEXTURE AND PAINT AT

INTERIOR OF MAIL SLOT


ROCK TO INCLUDE

REFER TO

BH-A4C MAIL

SLOT SPEC -

14 STOREFRONT FILLER @ BH-I21L APPLICATION A9 3/4" = 1'-0"

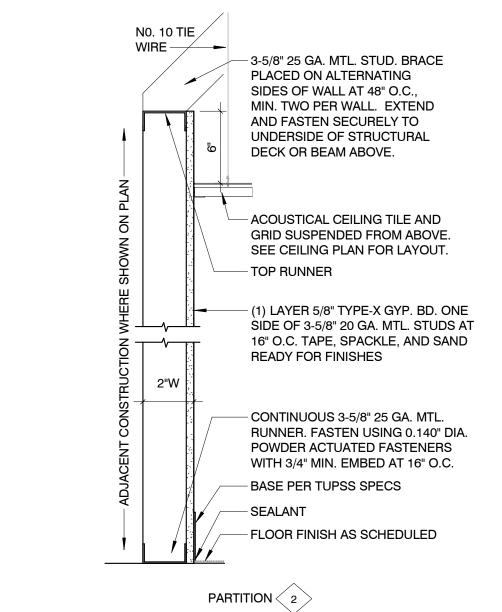

2 2" PARTITION - FURRING

A9 | 1 1/2" = 1'-0"

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Details Project Number: 2025901.309

Sheet Number: A9

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www.thelawrencegroup.com

Office: 319 N. Fourth Street, Suite 1000

Franchisee: Pugh, Mary & Melissa

P: 816.875.4070

To Be Selected

TIMOTHY

ROWBOTTOM

NUMBER

A-2003026002

07/21/2025

store6685@theupsstore.com

St. Louis, MO 63102

p 314-231-5700

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Project Team:

General

Project Title:


Contractor:

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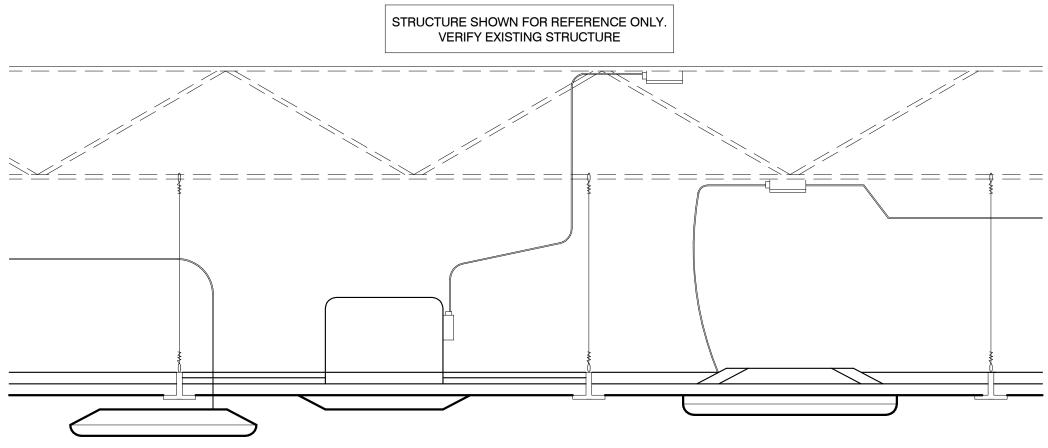
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Drawn By: RAC Issue Date: 07/21/2025



1 KEYLESS ENTRY WIRING DIAGRAM

A10 NTS

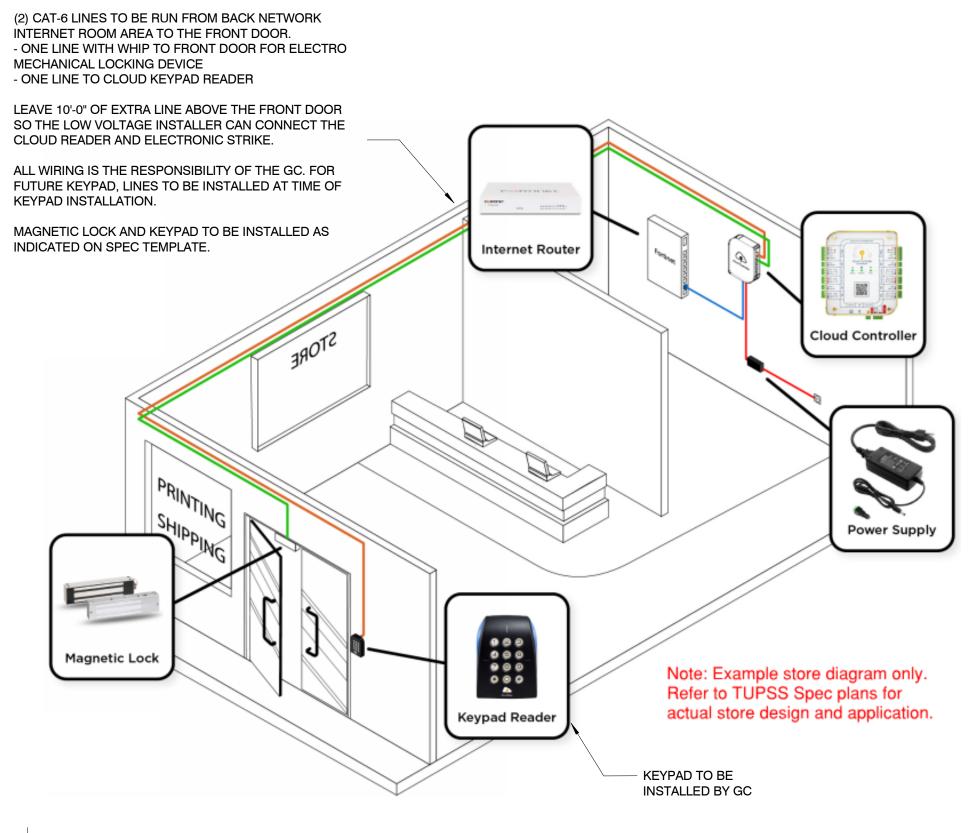

- ALL LIGHT FIXTURES & AIR DIFFUSERS SHALL BE POSITIVELY ATTACHED TO THE SUSPENDED CEILING SYSTEM MAIN RUNNERS. THE ATTACHMENT DEVICE SHALL HAVE A CAPACITY OF 100% OF THE FIXTURE WEIGHT.
- 12 GA. HANGER WIRES SHALL BE ATTACHED TO THE GIRDER MEMBERS WITHIN 3" OF EACH CORNER OF ALL FIXTURES. TANDEM FIXTURES MAY UTILIZE COMMON WIRES. • FIXTURE DIFFUSERS WEIGHING 20 LBS BUT NOT MORE THAN 56 LBS IN ADDITION TO THE ABOVE REQ'S SHALL HAVE (2) 12" GA. HANGER WIRES CONNECTED FROM THE HOUSING TO THE STRUCTURE ABOVE. THESE WIRES MAY BE SLACK.
- FIXTURES & DIFFUSERS WEIGHING MORE THAN 56 LBS SHALL BE SUPPORTED DIRECTLY FROM THE STRUCTURE BY APPROVED HANGERS. • CEILING AREAS EXCEEDING 2500 SQ. FT. MUST HAVE A SEISMIC SEPARATION JOINT OR FULL HEIGHT PARTITION TO BREAK THE CEILING INTO AREAS NOT EXCEEDING
- 2500 SQ. FT. THE RATIO OF LONG TO SHORT SIDE DIMENSION FOR EACH CEILING AREA SHALL NOT EXCEED 4.
- LIGHT FIXTURES (ALL TYPES) SHALL BE MECHANICALLY ATTACHED TO THE GRID PER NEC 410-16. • RIGID LAY-IN OR CAN LIGHT FIXTURES SHALL BE SUPPORTED FROM THE STRUCTURE ABOVE AS FOLLOWS:
- LESS THAN 10 LBS ONE 12 GA. WIRE (MAY BE SLACK).
- 10 TO 56 LBS TWO 12 GA WIRES (MAY BE SLACK).
- OVER 56 LBS SUPPORTED DIRECTLY TO THE STRUCTURE BY APPROVED HANGERS
- PENDANT HUNG FIXTURES SHALL BE SUPPORTED FROM THE STRUCTURE ABOVE USING #9 GA. WIRE
- CABLE TRAYS AND ELECTRICAL CONDUIT SHALL BE SUPPOSED AND BRACED INDEPENDENT OF THE SUSPENDED CEILING SYSTEM.

2 SUSPENSION DIAGRAM

A10 NTS

LOCALLY SOURCED GRAY METAL SHEVING TO BE SIMILAR OR LIKE TO ULINE STAINLESS WALL-MOUNT SHELVING. GC TO SOURCE AND INSTALL. SHELVING NOT TO EXCEED LENGTH OF EQUIPMENT SHELVING IS MOUNTED OVER.



5 LOCALLY SOURCED - GRAY METAL SHELF A10 3/4" = 1'-0"

COMPRESSION STRUTS SHOULD EXTEND FROM THE T-BAR GRID TO THE STRUCTURE ABOVE AND BE 1" Ø EMT - RUN TIGHT TO STRUCTURE FASTENED AT BOTH ENDS ABOVE (4'-0" MAX. FOR 1/2" Ø) 12 GA. VERTICAL HANGER WIRE COMPRESSION STRUT REQUIRED @ EACH SEISMIC RESTRAINT 12'-0" O.C. EACH WAY AND WITHIN 6'-0" OF EACH WALL VERTICAL - 12 GA. HANGER WIRE @ 4'-0" O.C.

- 1 1/4" Ø EMT - BUTT TIGHT TO 1 5/8" METAL JOIST FRAMING

- DRILL 5/32" HOLE FOR 1/8" BOLT AND LOCKNUT AFTER CEILING SYSTEM IS LEVELED

- SECURE SUPPORT WIRES TO STRUCTURAL STEEL MEMBERS
- ABOVE NOT TO ROOF DECK WIRES MORE THAN 1 IN 6 OUT-OF-PLUMB ARE NOT ALLOWED
- UNLESS COUNTER SLOPING WIRES ARE PROVIDED
- OBSTRUCTIONS TO DIRECT SUSPENSION:
- A TRAPEZE OR EQUIVALENT DEVICE SHALL BE USED FOR TRAPEZE SPANS OVER 48" - USE BACK-TO-BACK 1-1/4" COLD-ROLLED CHANNELS (OR EQUIVALENT) MIN.
- (3) TURNS MIN. IN 1 1/2" (TYP.)
 - TYPICAL INSTALLATION SHOWN FOR REFERENCE ONLY. GC RESPONSIBLE TO INSTALL NEW CEILING PER ALL LOCAL CODES AND REQUIREMENTS.
- (4) 12 GA. SPLAYING WIRES SPLAYED 90° FROM EACH OTHER AND 45° FROM CEILING PLANE

(SPACED 12'-0" O.C. IN BOTH DIRECTIONS - FIRST POINT STARTS WITHIN 6'-0" FROM EACH WALL)

3 ACOUSTICAL SUSPENSION DIAGRAM

MAIN RUNNER

— CROSS TEE

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General Contractor: To Be Selected

ROWBOTTOM NUMBER A-2003026002

07/21/2025

Project Title:

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